

STATE OF FLORIDA


COUNTY OF MANATEE

CONTRACT PLAN COMPONENTS

ROADWAY PLANS  
SIGNING & MARKING PLANS  
SIGNALIZATION PLANS

PLANS FOR PROPOSED  
WHITFIELD AVENUE  
AT SEMINOLE GULF COAST RAILROAD  
BRADENTON, FLORIDA

LOCATION  
OF PROJECT

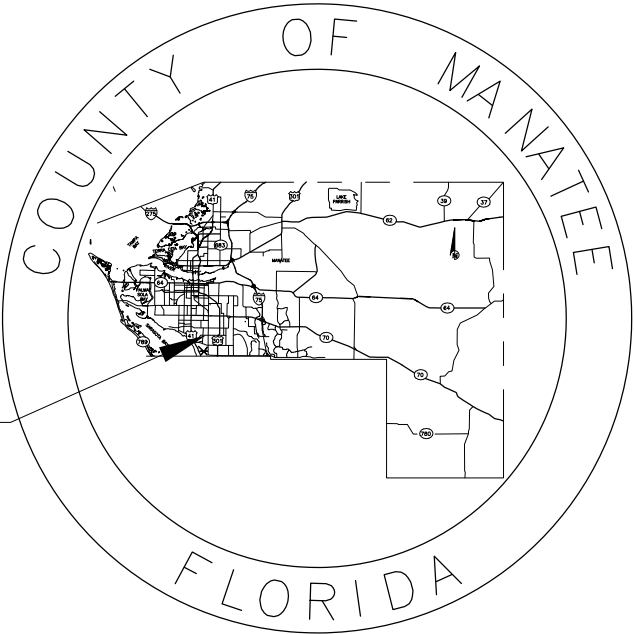

INDEX OF ROADWAY PLANS

SHEET NO.	DESCRIPTION
1	KEY SHEET
2	SUMMARY OF PAY ITEMS
3-4	GENERAL NOTES & LEGEND
5	TYPICAL SECTIONS
6	RAILROAD DETAIL
7-8	PLAN
9	PROFILE
10	HORIZONTAL AND VERTICAL CONTROL
11-12	UTILITY ADJUSTMENT SHEET
13-18	CROSS SECTION
19-20	EROSION CONTROL PLAN
21	EROSION CONTROL DETAILS
22-23	GENERAL DETAILS
24	EXISTING SURVEY

MANATEE COUNTY PROJECT No: 307-6098560  
MAY 2020



BEGIN PROJECT  
STA. 9+60.00

END PROJECT  
STA. 15+00.00

N.T.S  
PROJECT LENGTH IS BASED ON  $\frac{1}{4}$  OF CONSTRUCTION

90% PLANS

WITH NO UTILITY  
COORDINATION



Know what's below  
Call before you dig

GOVERNING DESIGN STANDARDS:

FLORIDA DEPARTMENT OF TRANSPORTATION, FY 2017-18 DESIGN STANDARDS  
eBOOK (DSeB) AND APPLICABLE DESIGN STANDARDS REVISIONS (DSRs) AT  
THE FOLLOWING WEBSITE:  
<http://www.fdot.gov/rddesign/DesignStandards/Standards.shtm>

GOVERNING STANDARD SPECIFICATIONS:

FLORIDA DEPARTMENT OF TRANSPORTATION, JANUARY 2018 STANDARD  
SPECIFICATIONS FOR ROAD AND BRIDGE CONSTRUCTION AT THE  
FOLLOWING WEBSITE:  
<http://www.fdot.gov/programmanagement/Implemented/SpecBooks>

LENGTH OF PROJECT

	LINEAR FEET	MILES
ROADWAY	270.00	0.05
EXCEPTIONS	0.00	0.00
GROSS LENGTH OF PROJECT	270.00	0.05

KEY SHEET REVISIONS


DATE	DESCRIPTION

ROADWAY PLANS  
PROFESSIONAL OF RECORD: GRIGORY BERIKHMAN, P.E.  
FLORIDA P.E. # 76896

CONSTRUCTION CONTRACT NO.	FISCAL YEAR	SHEET NO.
T0000	19	01

H:\Highway Engineering\PROJ\ROADS\Whitfield Ave at Railroad Crossing\DWG\Production Drawings\Whitfield RR Crossing COVER.dwg [11/11/2019 7:10 AM]

LINE	FDOT ITEM		EST.	
NO.	NO.	DESCRIPTION	QTY	U/M
1.	101-1	MOBILIZATION	1.00	LS
2.	102-1	MAINTENANCE OF TRAFFIC	1.00	LS
		SUBTOTAL MOBILIZATION AND MOT		
3.	104-10-3	SEDIMENT BARRIER	900	LF
4.	104-11	FLOATING TURBIDITY BARRIER	40	LF
5.	110-2-1	CLEARING & GRUBBING	0.55	AC
6.	120-1	REGULAR EXCAVATION	240	CY
7.	120-4	SUBSOIL EXCAVATION	50	CY
8.	120-6	EMBANKMENT (REGULAR)	160	CY
9.	160-MC	12" TYPE B STABILIZATION (LBR 60)	110	SY
10.	285-701	4" OF OPTIONAL BASE GROUP 1	140	SY
11.	285-709	10" OF OPTIONAL BASE GROUP 9	85	SY
12.	327-70-1	MILLING EXIST ASPH PAVT, 1 " AVG DEPTH	460	SY
13.	327-70-4	MILLING EXIST ASPH PAVT, 3 " AVG DEPTH	320	SY
14.	334-MC	TYPE S-I ASPHALT CONCRETE (INCL TACK COAT)	87	TN
15.	337-MC	TYPE S-III ASPHALT CONCRETE (INCL TACK COAT)	26	TN
16.	425-MC	JUNCTION BOX (TRAFFIC BEARING)	3	EA
17.	430-174-118	PIPE STORM SEWER CULV (RCP)(18")	50	LF
18.	430-174-124	PIPE STORM SEWER CULV (RCP)(24")	80	LF
19.	430-174-136	PIPE STORM SEWER CULV (RCP)(36")	58	LF
20.	430-982-125	MITERED END SECTION- RCP-ROUND, 18" CD	1	EA
21.	430-982-129	MITERED END SECTION- RCP-ROUND, 24" CD	2	EA
22.	430-982-138	MITERED END SECTION- RCP-ROUND, 36" CD	3	EA
23.	520-2-4	TYPE D CURB	90	LF
24.	522-1	SIDEWALK CONCRETE 4"	180.00	SY
25.	527-2	DETECTABLE WARNINGS	44	SF
26.	530-3-4	RIP RAP-RUBBLE	15	TN
27.	570-1-2	PERFORMANCE TURF (BAHIA SOD)	1,400.00	SY
		SUBTOTAL ROADWAY		
28.		SIGNING AND PAVEMENT MARKING	1.00	LS

REVISION		DESCRIPTION	DATE					GRIGORY BERIKHMAN, P.E. FLORIDA P.E. # 76896	 PUBLIC WORKS DEPARTMENT ENGINEERING SERVICES 1022 26th Avenue East, Bradenton, FL 34208	WHITFIELD AVENUE AT SEMINOLE GULF COAST RAILROAD SUMMARY OF PAY ITEMS	SHEET NO. 02	
1		ADDITIONAL STRUCTURE ON NE QUADRANT	08/07/19	PROJECT #	307-6098560	SURVEYED	ZNS					02/2019
				SURVEY #	0577-0036	DESIGNED	GB					02/2019
				SEC./TWN./RGE	19 & 30/35S/18E	DRAWN	KHL					02/2019
				SCALE	1"=20'	CHECKED	XXX					XX/XXXX
								Signature & Date				





H:\Highway Engineering\PROJ\ROADS\Whitfield Ave at Railroad Crossing\DWG\Production Drawings\Whitfield RR Crossing COVER.dwg [11/11/2019 7:11 AM]

57. ON SLOPES GREATER THAN 3:1 PEGGING OR PINNING OF SOD MAY BE REQUIRED.
58. STATION LOCATIONS AND OFFSETS FOR STORM DRAIN INLETS AND MANHOLES REFERENCE THE CENTER OF THE SPECIFIED STRUCTURE BOTTOM. STATION LOCATION IS CENTER OF STRUCTURE BOTTOM FOR JUNCTION BOXES, CENTER OF RISER FOR CURB INLETS. FOR PIPES WITH MITERED END SECTIONS, THE PROPOSED LENGTHS SHOWN ON THE PLANS INCLUDE THE LENGTH OF THE MITERED END SECTION. PAYMENT FOR PIPE SHALL NOT INCLUDE THE LENGTH OF THE MITERED END SECTION. AS SPECIFIED BY DIMENSION "F" AS SHOWN IN FDOT INDEX 272 AND 273. PAYMENT SHALL BE FROM INSIDE STRUCTURE WALL TO INSIDE STRUCTURE WALL. ANY EXTRA PIPE LENGTH LISTED SHALL BE CONSIDERED CONTINGENT.
59. ALL CURB INLET AND JUNCTION BOX STORMWATER STRUCTURES SHALL HAVE HEAVY DUTY RING AND COVER MANHOLE ACCESS. ALL DRAINAGE BOX DETAIL SHALL FOLLOW MANATEE COUNTY CURRENT STANDARD 202 UNLESS IT IS DESIGNATED IN THE PLAN. ALL DRAINAGE BOXES SHALL HAVE A WALL THICKNESS OF 6" MINIMUM.
60. DURING DEWATERING OPERATIONS, THE CONTRACTOR SHALL NOT DISCHARGE DIRECTLY TO RECEIVING WATERS, EXISTING CONVEYANCES TO RECEIVING WATERS, OR WETLAND SYSTEMS. TEMPORARY SEDIMENT BASINS, TRAPS, OR SILTATION REDUCTION DEVICES SHALL BE UTILIZED TO COLLECT THE DISCHARGE FROM DEWATERING ACTIVITIES TO ELIMINATE THE POTENTIAL FOR OFFSITE SEDIMENT TRANSPORT AND TO ENSURE THAT DIRECT DISCHARGE DOES NOT OCCUR.

RESTORATION

61. ALL RESTORATION WORK PERFORMED THROUGHOUT THE PROJECT SHALL CONFORM TO EXISTING LINES AND GRADES UNLESS SHOWN OTHERWISE.
62. ALL DISTURBED GRASSED AREAS SHALL BE SODDED. THE TYPE OF SOD USED TO REPLACE OWNER MAINTAINED AREAS IN RIGHT-OF-WAY SHALL BE COORDINATED WITH THE PROPERTY OWNER. ALL EXISTING SHRUBS, TREES, PLANTINGS AND OTHER VEGETATION, OUTSIDE OF RIGHT-OF-WAY DISTURBED DURING CONSTRUCTION SHALL BE REPLACED WITH EQUIVALENT MATERIAL BY THE CONTRACTOR AT NO ADDITIONAL COST TO THE OWNER.
63. CONCRETE DRIVEWAYS OR SIDEWALKS THAT ARE CUT SHALL BE RESTORED TO MATCH EXISTING ACCORDING TO THE CURRENT EDITIONS OF THE F.D.O.T. SPECIFICATIONS FOR ROAD AND BRIDGE DESIGN, SECTION 522, AND SECTION 310 OF THE F.D.O.T. DESIGN STANDARDS LATEST REVISION AND PER MANATEE COUNTY PUBLIC WORKS STANDARDS.
64. WHENEVER A PERMANENT ROADWAY SURFACE IS NOT PLACED IMMEDIATELY AFTER BACKFILLING AND COMPACTION OF THE NEWLY INSTALLED PIPE LINE IN AREAS WHERE TRAFFIC MUST PASS, THE CONTRACTOR SHALL INSTALL A TEMPORARY SURFACE CONSISTING OF NINE INCHES OF COMPACTED LIME ROCK BASE AND A COAT OF ASPHALT EMULSION. PERMANENT ROADWAY REPAIR SHALL BE PERFORMED A MAXIMUM OF TWENTY-ONE CALENDAR DAYS AFTER THE INITIAL OPEN CUTTING.
65. RESTORATION OF CURBS, DRIVEWAYS, SIDEWALKS, AND PLACEMENT OF SOD SHALL BE COMPLETED WITHIN FORTY-FIVE CALENDAR DAYS OF INITIAL DISTURBANCE, OR TWENTY-ONE CALENDAR DAYS OF SUBSTANTIAL COMPLETION, WHICHEVER OCCURS FIRST.

CONSTRUCTION

66. THE EXHAUST SYSTEM OF ALL GASOLINE AND DIESEL ENGINES SHALL BE EQUIPPED WITH MUFFLERS THAT MEET THE EQUIPMENT MANUFACTURER'S REQUIREMENTS FOR NOISE SUPPRESSION. THE CONTRACTOR SHALL INSTALL NOISE ABATEMENT BAFFELS POSITIONED TO BREAK LINE-OF-SITE FROM THE NOISE SOURCE TO AFFECTED RESIDENCES, AS APPROVED BY THE ENGINEER.
67. NO MATERIAL SHALL BE STOCKPILED IN ROADWAYS. ALL DIRT AND DEBRIS SHALL BE REMOVED FROM THE JOB SITE DAILY. ROADS SHALL BE SWEEP DAILY AS PART OF DAILY CLEAN UP.
68. THE CONTRACTOR IS TO CONTROL ALL FUGITIVE DUST ORIGINATING ON THIS PROJECT BY WATERING OR OTHER METHODS AS REQUIRED.
69. INGRESS AND EGRESS TO ALL THE PROPERTIES IN THE CONSTRUCTION AREA SHALL BE MAINTAINED AT ALL TIMES.
70. PRIOR APPROVAL WILL BE REQUIRED FOR REMOVAL OF ANY TREE WITHIN THE CONSTRUCTION AREA, UNLESS OTHERWISE NOTED ON THE PLANS.
71. THE CONTRACTOR SHALL PROVIDE ALL DEWATERING EQUIPMENT NECESSARY TO KEEP ALL EXCAVATIONS DRY. DEWATERING IS REQUIRED TO 18" BELOW TRENCH BOTTOM. THE CONTRACTOR SHALL SUBMIT DEWATERING PLAN TO DISTICT FOR APPROVAL PRIOR TO CONSTRUCTION.
72. ALL PIPING AND FITTINGS USED ON THIS PROJECT SHALL BE AS NOTED ON THE PLANS AND IN THE CONTRACT DOCUMENT AND SHALL BE INSTALLED TO THE LINES AND GRADES SHOWN ON THE PLANS AND PROFILES.
73. ALL PIPE LENGTHS ARE PLUS OR MINUS AND MAY BE ADJUSTED IN THE FIELD AS REQUIRED. PIPE MEASUREMENTS AND STATION OFFSETS ARE TO CENTER OF STRUCTURES OR FITTINGS. REFER TO DETAIL SHEET FOR ALL REFERENCE POINTS.
74. ALL ROCKS OR STONES LARGER THAN SIX INCH DIAMETER SHALL BE REMOVED FROM THE BACKFILL MATERIAL. BACKFILL MATERIAL PLACED WITHIN ONE FOOT OF PIPING AND APPURTENANCES SHALL NOT CONTAIN ANY STONES LARGER THAN TWO INCH DIAMETER.
75. ALL PENETRATION OF EXISTING STRUCTURES SHALL BE BY THE MECHANICAL ROTARY CORE BORING METHOD.
76. ALL CONCRETE AND REBAR PENETRATED OR DISTURBED SHALL BE COATED WITH TWO COATS OF EPOXY.
77. CONTRACTOR IS RESPONSIBLE FOR ALL UNSUITABLE MATERIAL REMOVAL WITHIN PROJECT LIMITS. EXCAVATION, EMBANKMENT, INCLUDING UTILIZATION, AND UNSUITABLE MATERIAL REMOVAL SHALL BE IN ACCORDANCE WITH FDOT DESIGN STANDARDS, LATEST VERSION.
78. WHERE EXCAVATION IS REQUIRED FOR CONSTRUCTION OF SIDEWALK, ALL STUMPS, ROOTS, ETC. SHALL BE REMOVED COMPLETELY FROM THE SIDEWALK AREA. ALL STUMPS WITHIN THE PROJECT LIMITS SHALL BE REMOVED COMPLETELY AND REPLACED WITH COMPACTED BACKFILL BEFORE THE AREA IS FILLED. TREE ROOTS IN AREA OF PROPOSED SIDEWALK, RAMP, OR DRIVEWAY REPLACEMENT SHALL BE GROUND OUT TO A DEPTH OF 6" BELOW BOTTOM OF NEW SIDEWALK OR DRIVEWAY. ALL PRUNED ROOT DEBRIS SHALL BE REMOVED FROM THE SUB-BASE MATERIAL PRIOR TO POURING CONCRETE, ASPHALT, OR APPLICATION OF OTHER SPECIFIED MATERIALS. THIS WORK SHALL BE INCLUDED IN AND PAID FOR UNDER THE PAY ITEM FOR CLEARING AND GRUBBING.
79. ALL STUMPS, ROOTS, AND OTHER DEBRIS PROJECTING THROUGH OR APPEARING ON THE SURFACE OF THE GROUND SHALL BE REMOVED TO A DEPTH OF 1-FOOT BELOW THE COMPLETED SURFACE. THIS WORK SHALL BE INCLUDED IN AND PAID FOR UNDER THE PAY ITEM FOR CLEARING AND GRUBBING.
80. ALL MATERIALS NOT CLAIMED BY THE COUNTY SHALL BECOME PROPERTY OF THE CONTRACTOR, AND SHALL BE DISPOSED OF BY THE CONTRACTOR IN AREAS PROVIDED BY THE CONTRACTOR. THIS WORK SHALL BE INCLUDED IN AND PAID UNDER THE PAY ITEM CLEARING AND GRUBBING.
81. THE CONTRACTOR SHALL PROVIDE ALL SHEETING, SHORING, AND BRACING REQUIRED TO PROTECT ADJACENT STRUCTURES OR TO MINIMIZE TRENCH WIDTH. WHERE A SEPARATE PAY ITEM IS NOT PROVIDED, THE COST OF ALL SHEETING, SHORING, AND BRACING REQUIRED SHALL BE INCLUDED IN THE CONTRACT PRICE FOR THE ITEM OF WORK FOR WHICH SHEETING, SHORING, AND BRACING IS REQUIRED.
82. THE CONTRACTOR SHALL DISTURB NO MORE GROUND THAN WHAT IS NECESSARY FOR CONSTRUCTION. NO OPEN EXCAVATED TRENCH, OR OTHER UNSAFE CONDITION WILL BE LEFT OVERNIGHT. ALL WORK SITES WILL BE COMPLETELY RESTORED WITHIN SEVEN (7) CALENDAR DAYS OF THE CONCRETE POUR FOR SIDEWALK.THE INTENT OF THIS PROVISION IS TO "SAFE-UP" THE PROJECT SITE AS WORK PROGRESSES, AND SHALL INCLUDE REMOVING FORMS, FILLING HOLES, GRADING, AND REMOVAL OF DEBRIS.
83. ALL EXISTING SIGNS WITHIN THE PROJECT LIMITS SHALL REMAIN UNLESS OTHERWISE NOTED IN THE PLANS, OR AS DIRECTED BY THE ENGINEER.
84. ANY EXISTING SIGN TO REMAIN THAT IS DISTURBED OR RELOCATED DURING CONSTRUCTION SHALL BE RESET TO CURRENT STANDARDS FOR HEIGHT, OFFSET, AND METHOD OF INSTALLATION AT NO ADDITIONAL COST TO THE COUNTY.
85. ALL EXISTING SWALES NOT DESIGNATED FOR RECONSTRUCTION SHALL BE REGRADED TO PROMOTE POSITIVE DRAINAGE AND MATCH PROPOSED CENTERLINE SWALE ELEVATION AND ALIGNMENT.
86. ALL STORM DRAINS AND STRUCTURES TO REMAIN SHALL BE CLEANED OF DEBRIS, DIRT, VEGETATION AND OTHER MATERIAL. STORM SEWER INLETS SHALL BE MODIFIED (RAISED/LOWERED) TO MATCH PROPOSED FINISHED GRADE.
87. ALL EXISTING FENCES DISTURBED DURING CONSTRUCTION SHALL BE REPAIRED OR REPLACED AND REINSTALLED BY THE CONTRACTOR AT NO ADDITIONAL COST. (EXISTING FENCES WITHIN R/W TAKING LIMITS SHALL BE RECONSTRUCTED TO THE NEW R/W LINE AND ARE TO BE REIMBURSED UNDER THE MISCELLANEOUS BID ITEM).

88. ALL EXISTING TREES LOCATED WITHIN CONSTRUCTION LIMITS SHALL REMAIN UNLESS OTHERWISE NOTED.
89. THE EXISTING STORM DRAINAGE STRUCTURES WITHIN CONSTRUCTION LIMITS SHALL REMAIN UNLESS OTHERWISE NOTED.
90. ALL EXISTING BUILDINGS SHALL REMAIN UNLESS OTHERWISE NOTED.











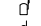

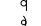

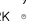











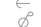









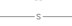


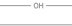


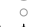


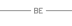


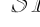




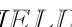

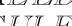

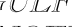

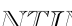
VERTICAL DATUM  
NAVD 88

EMERGENCY CONTACTS

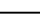





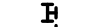


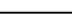


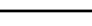


MANATEE COUNTY PUBLIC WORKS DEPT. INFRASTRUCTURE ENGINEERING SCOTT MAY, P.E. 1022 26TH AVENUE EAST BRADENTON, FL 34208 (941) 708-7450 EXT. 7650 FAX: (941) 708-7431	FLORIDA POWER & LIGHT DISTRIBUTION GREG COKER 1253 12TH AVENUE EAST PALMETTO, FL 34221 (941) 723-4430 FAX: (941) 723-4444 EMERGENCY: 1-800-4-OUTAGE Greg_Coker@fpl.com	SOUTHWEST FLORIDA WATER MANAGEMENT DISTRICT SARASOTA SERVICE OFFICE STEVE LOPES, P.E. 6750 FRUITVILLE ROAD SARASOTA, FL 34240 (941) 377-3722 FAX: (941) 373-7660	DEPARTMENT OF ENVIRONMENTAL PROTECTION ED WATSON 13051 N. TELECOM PKWY TEMPLE TERRACE, FL 33637 PHONE: (813) 470-5875 FAX: (813) 470-5993
TECO/PEOPLES GAS CO. DAN SHANAHAN 8261 VICO COURT SARASOTA, FL 34240 (941) 342-4030 FAX: (941) 342-4011 EMERGENCY: 1-877-832-6911 dshanahan@tecoenergy.com	FLORIDA POWER & LIGHT TRANSMISSION DALIANA AMADOR 15430 ENDEAVOR DRIVE JUPITER, FL 33478 (941)804-3665 Gary.n.peterson@fpl.com	FLORIDA GAS TRANSMISSION SAFETY HARBOR TEAM 7804 ANDERSON RD. TAMPA, FL 33634 CHRIS LEE (941) 466-3327 (863) 767-4660 christopher.lee@fug.com	PEACE RIVER ELECTRIC COOPERATIVE, INC. P.O. BOX 1310 WACHULA, FL 33873 DAVID MCCLINTOCK KENDELL COKER (863) 767-4622 (863) 767-4660 david.mcclintock@preco.coop kendell.coker@preco.coop
SUNSHINE STATE ONE CALL OF FLORIDA 1-(800) 432-4770	FRONTIER COMMUNICATIONS DENISE HUTTON 1701 RINGLING BLVD. SARASOTA, FL 34236 (941) 330-9203 denise.hutton@frc.com	MANATEE COUNTY HEALTH DEPT. HANS C. ROESE 410 6TH AVENUE EAST BRADENTON, FL 34208 (941) 748-0747 EXT. 1342 FAX: (941) 750-0364 hans_roese@doh.state.fl.us	MANATEE COUNTY PUBLIC WORK DEPT. TRAFFIC ENGINEERING MUKUNDA GOPALAKRISNA, P.E. (941) 749-3500 EXT. 7813 FAX: (941) 749-3571
		CROWN CASTLE UTILITY COMPANY LOUIS A. SIMONE 4511 N HINES AVE #210 TAMPA, FL 33614 (941) 579-8956 losimone@cncomm.com	MCI FIBER COMMUNICATIONS BLACK & VEATCH / OVERLAND CONTRACTING GREG REES 5206 EAGLE TRAIL DRIVE TAMPA, FL 33607 (813) 207-7909 rees@bvc.com


LEGEND

EXISTING

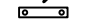	ABBREVIATIONS
BM 	R/W RIGHT OF WAY
CM 	CONC CONCRETE
IP 	ASPH ASPHALT
IR 	DRWY DRIVEWAY
HUB 	SWK SIDEWALK
N&D 	EP EDGE OF PAVEMENT
ELEVATION 	BOC BACK OF CURB
PARCEL ID NO. 	
PARCEL ID NO. 	
LOT NO. 	
GW 	EDGE OF VEGETATION 
PP 	CHAIN LINK FENCE 
LP 	WOOD FENCE 
MB 	BARBED WIRE FENCE 
SN 	FORCE MAIN 
REF 	PW POTABLE WATER 
SPRK 	RCW RECLAIMED WATER 
GM 	SS SANITARY SEWER 
BFP 	S STORM DRAIN 
BO 	GAS GAS LINE 
FH 	OHTV OVERHEAD TV 
WV 	UGTV UNDERGROUND TV 
ARV 	OE OVERHEAD ELECTRIC 
WM 	BE UNDERGROUND ELECTRIC 
SMH 	OH VER OVERHEAD VERIZON 
CO 	UG VER UNDERGROUND VERIZON 
SB#1 	VER VERIZON 
TEL 	UG UNDERGROUND UTILITY 
UTB 	OH OVERHEAD UTILITY 
UTR 	RAIL ROAD TRACKS 
FD 	EDGE OF CONCRETE 
GI 	EDGE OF ROAD 
MI 	TOE OF SLOPE 
SM 	TOP OF BANK 
	PROPERTY LINE 
	RIGHT OF WAY 


PROPOSED

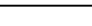	MAIN
	SERVICE LINE
	PROPOSED EASEMENT
	FIRE HYDRANT
	VALVE
	SANITARY SEWER MANHOLE
	BLOW OFF ASSEMBLY
	REDUCER
	TEE
	HORIZONTAL BEND
	VERTICAL BEND
	PLUG
	MASTER METER ASSEMBLY
	SERVICE LINE & METER
	DOUBLE SERVICE

REVISION		DESCRIPTION	DATE					GRIGORY BERIKHMAN, P.E. FLORIDA P.E. # 76896		PUBLIC WORKS DEPARTMENT ENGINEERING SERVICES 1022 26th Avenue East, Bradenton, FL 34208	WHITFIELD AVENUE AT SEMINOLE GULF COAST RAILROAD GENERAL NOTES & LEGEND CONTINUED	SHEET NO. 04	
1		ADDITIONAL STRUCTURE ON NE QUADRANT	08/07/19	PROJECT #	307-6098560	SURVEYED	ZNS						02/2019
				SURVEY #	0577-0036	DESIGNED	GB						02/2019
				SEC./TWN./RGE	19 & 30/35S/18E	DRAWN	KHL						02/2019
				SCALE	1"=20'	CHECKED	XXX						XX/XXXX
				Signature & Date									





H:\Highway Engineering\PROJ\ROADS\Whitfield Ave at Railroad Crossing\DWG\Production Drawings\Whitfield RR Crossing COVER.dwg [11/11/2019 7:11 AM]

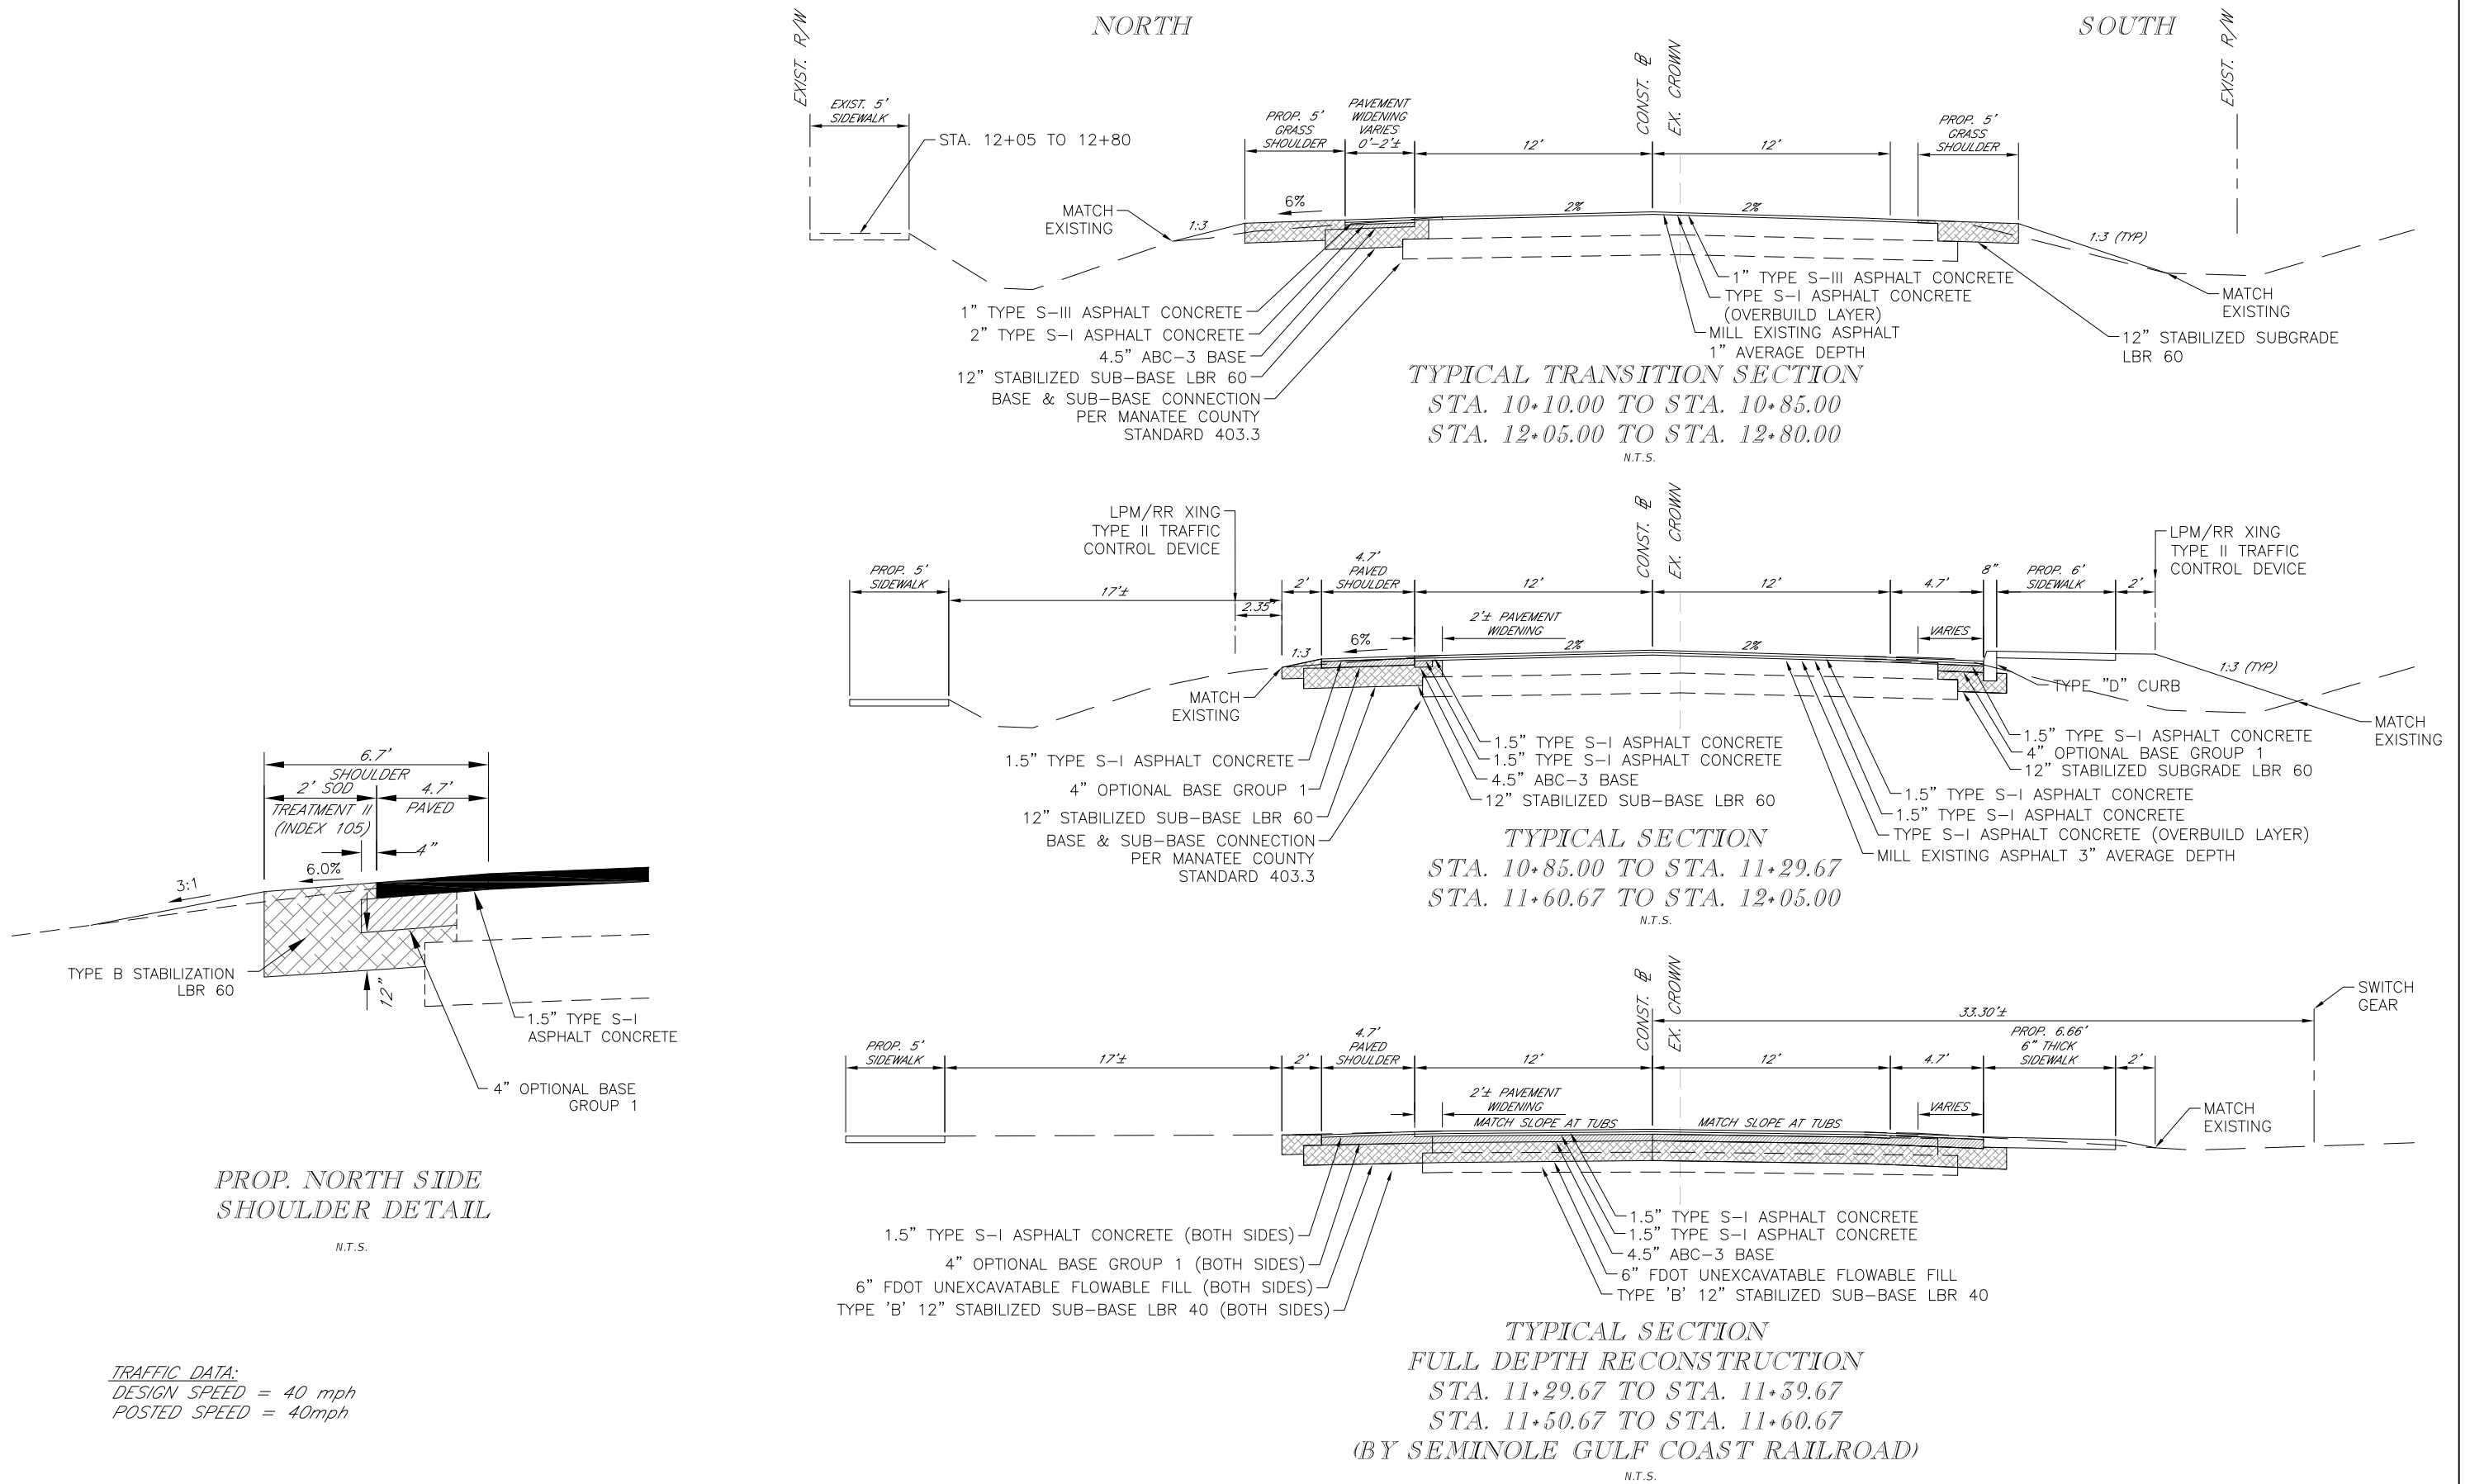

REVISION	DESCRIPTION	DATE	PROJECT #	307-6098560	SURVEYED	ZNS	02/2019	GRIGORY BERIKHMAN, P.E. FLORIDA P.E. # 76896	Manatee County FLORIDA	PUBLIC WORKS DEPARTMENT ENGINEERING SERVICES 1022 26th Avenue East, Bradenton, FL 34208	WHITFIELD AVENUE AT SEMINOLE GULF COAST RAILROAD TYPICAL SECTION	SHEET NO. 05
1	ADDITIONAL STRUCTURE ON NE QUADRANT	08/07/19	SURVEY #	0577-0036	DESIGNED	GB	02/2019	Signature & Date				
			SEC./TWN./RGE	19 & 30/35S/18E	DRAWN	KHL	02/2019					
			SCALE	N.T.S.	CHECKED	XXX	XX/XXXX					

SEMINOLE GULF COAST RAILROAD

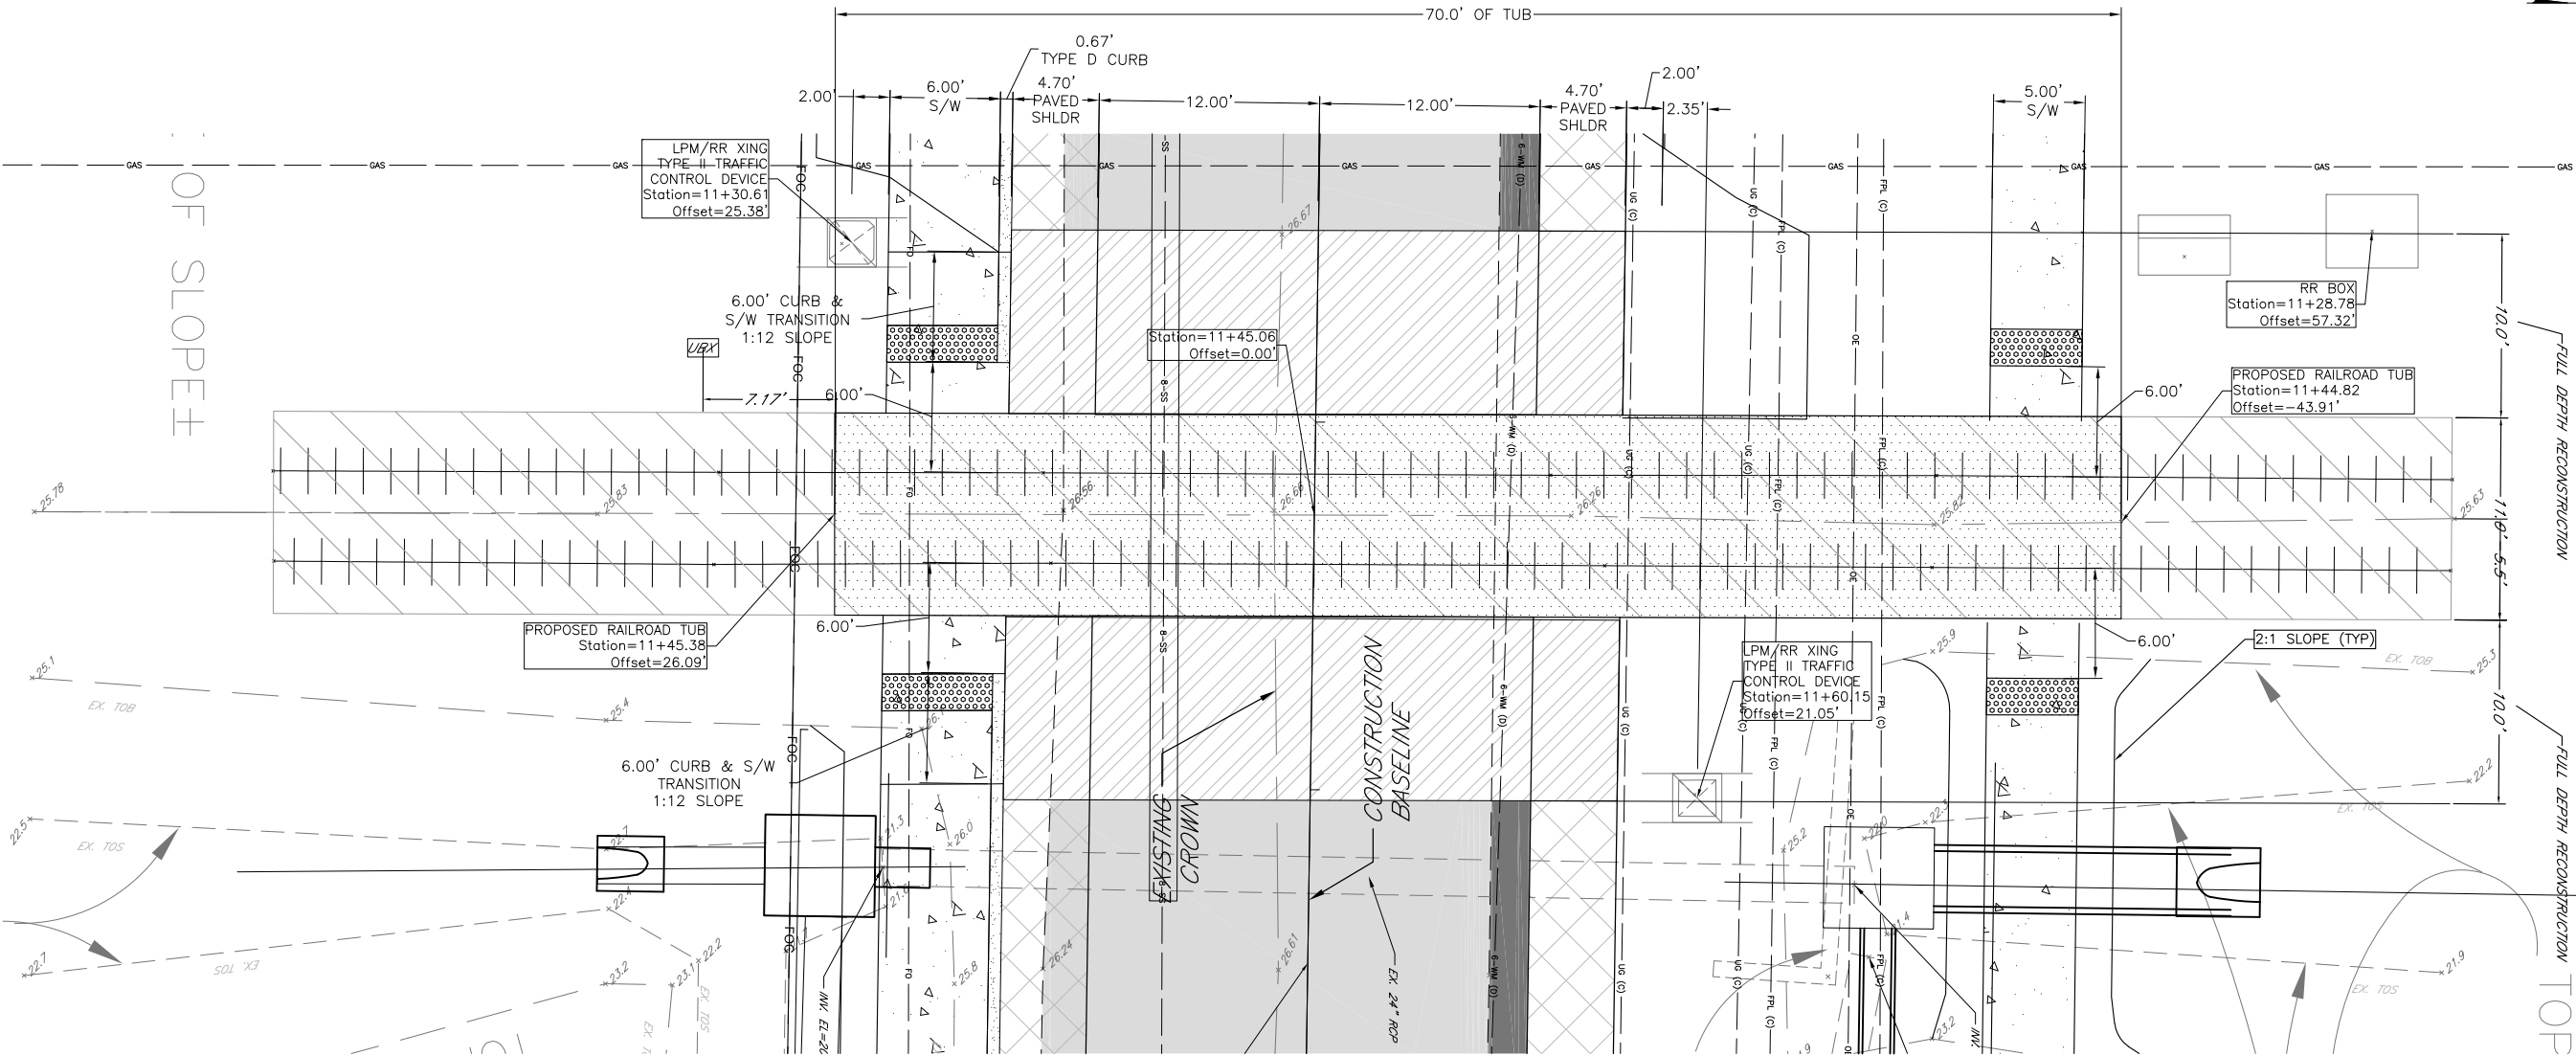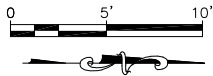

- FULL DEPTH RECONSTRUCTION
- PROPOSED SIDEWALK
- RAILROAD TUB
- PROPOSED PAVED SHOULDER
- PROPOSED ASPHALT
- EXISTING ASPHALT MILLING
- TO BE DESIGNED AND CONSTRUCTED SEMINOLE GULF COAST RAILROAD

REVISION	DESCRIPTION	DATE	PROJECT #	307-6098560	SURVEYED	ZNS	02/2019
1	ADDITIONAL STRUCTURE ON NE QUADRANT	08/07/19	SURVEY #	0577-0036	DESIGNED	GB	02/2019
			SEC./TWN./RGE	19 & 30/35S/18E	DRAWN	KHL	02/2019
			SCALE	AS SHOWN	CHECKED	XXX	XX/XXXX

GRIGORY BERIKHMAN, P.E.  
FLORIDA P.E. # 76896


Signature & Date



PUBLIC WORKS DEPARTMENT  
ENGINEERING SERVICES  
1022 26th Avenue East, Bradenton, FL 34208

WHITFIELD AVENUE  
AT SEMINOLE GULF COAST RAILROAD  
RAILROAD PLAN DETAIL


SHEET NO.  
06

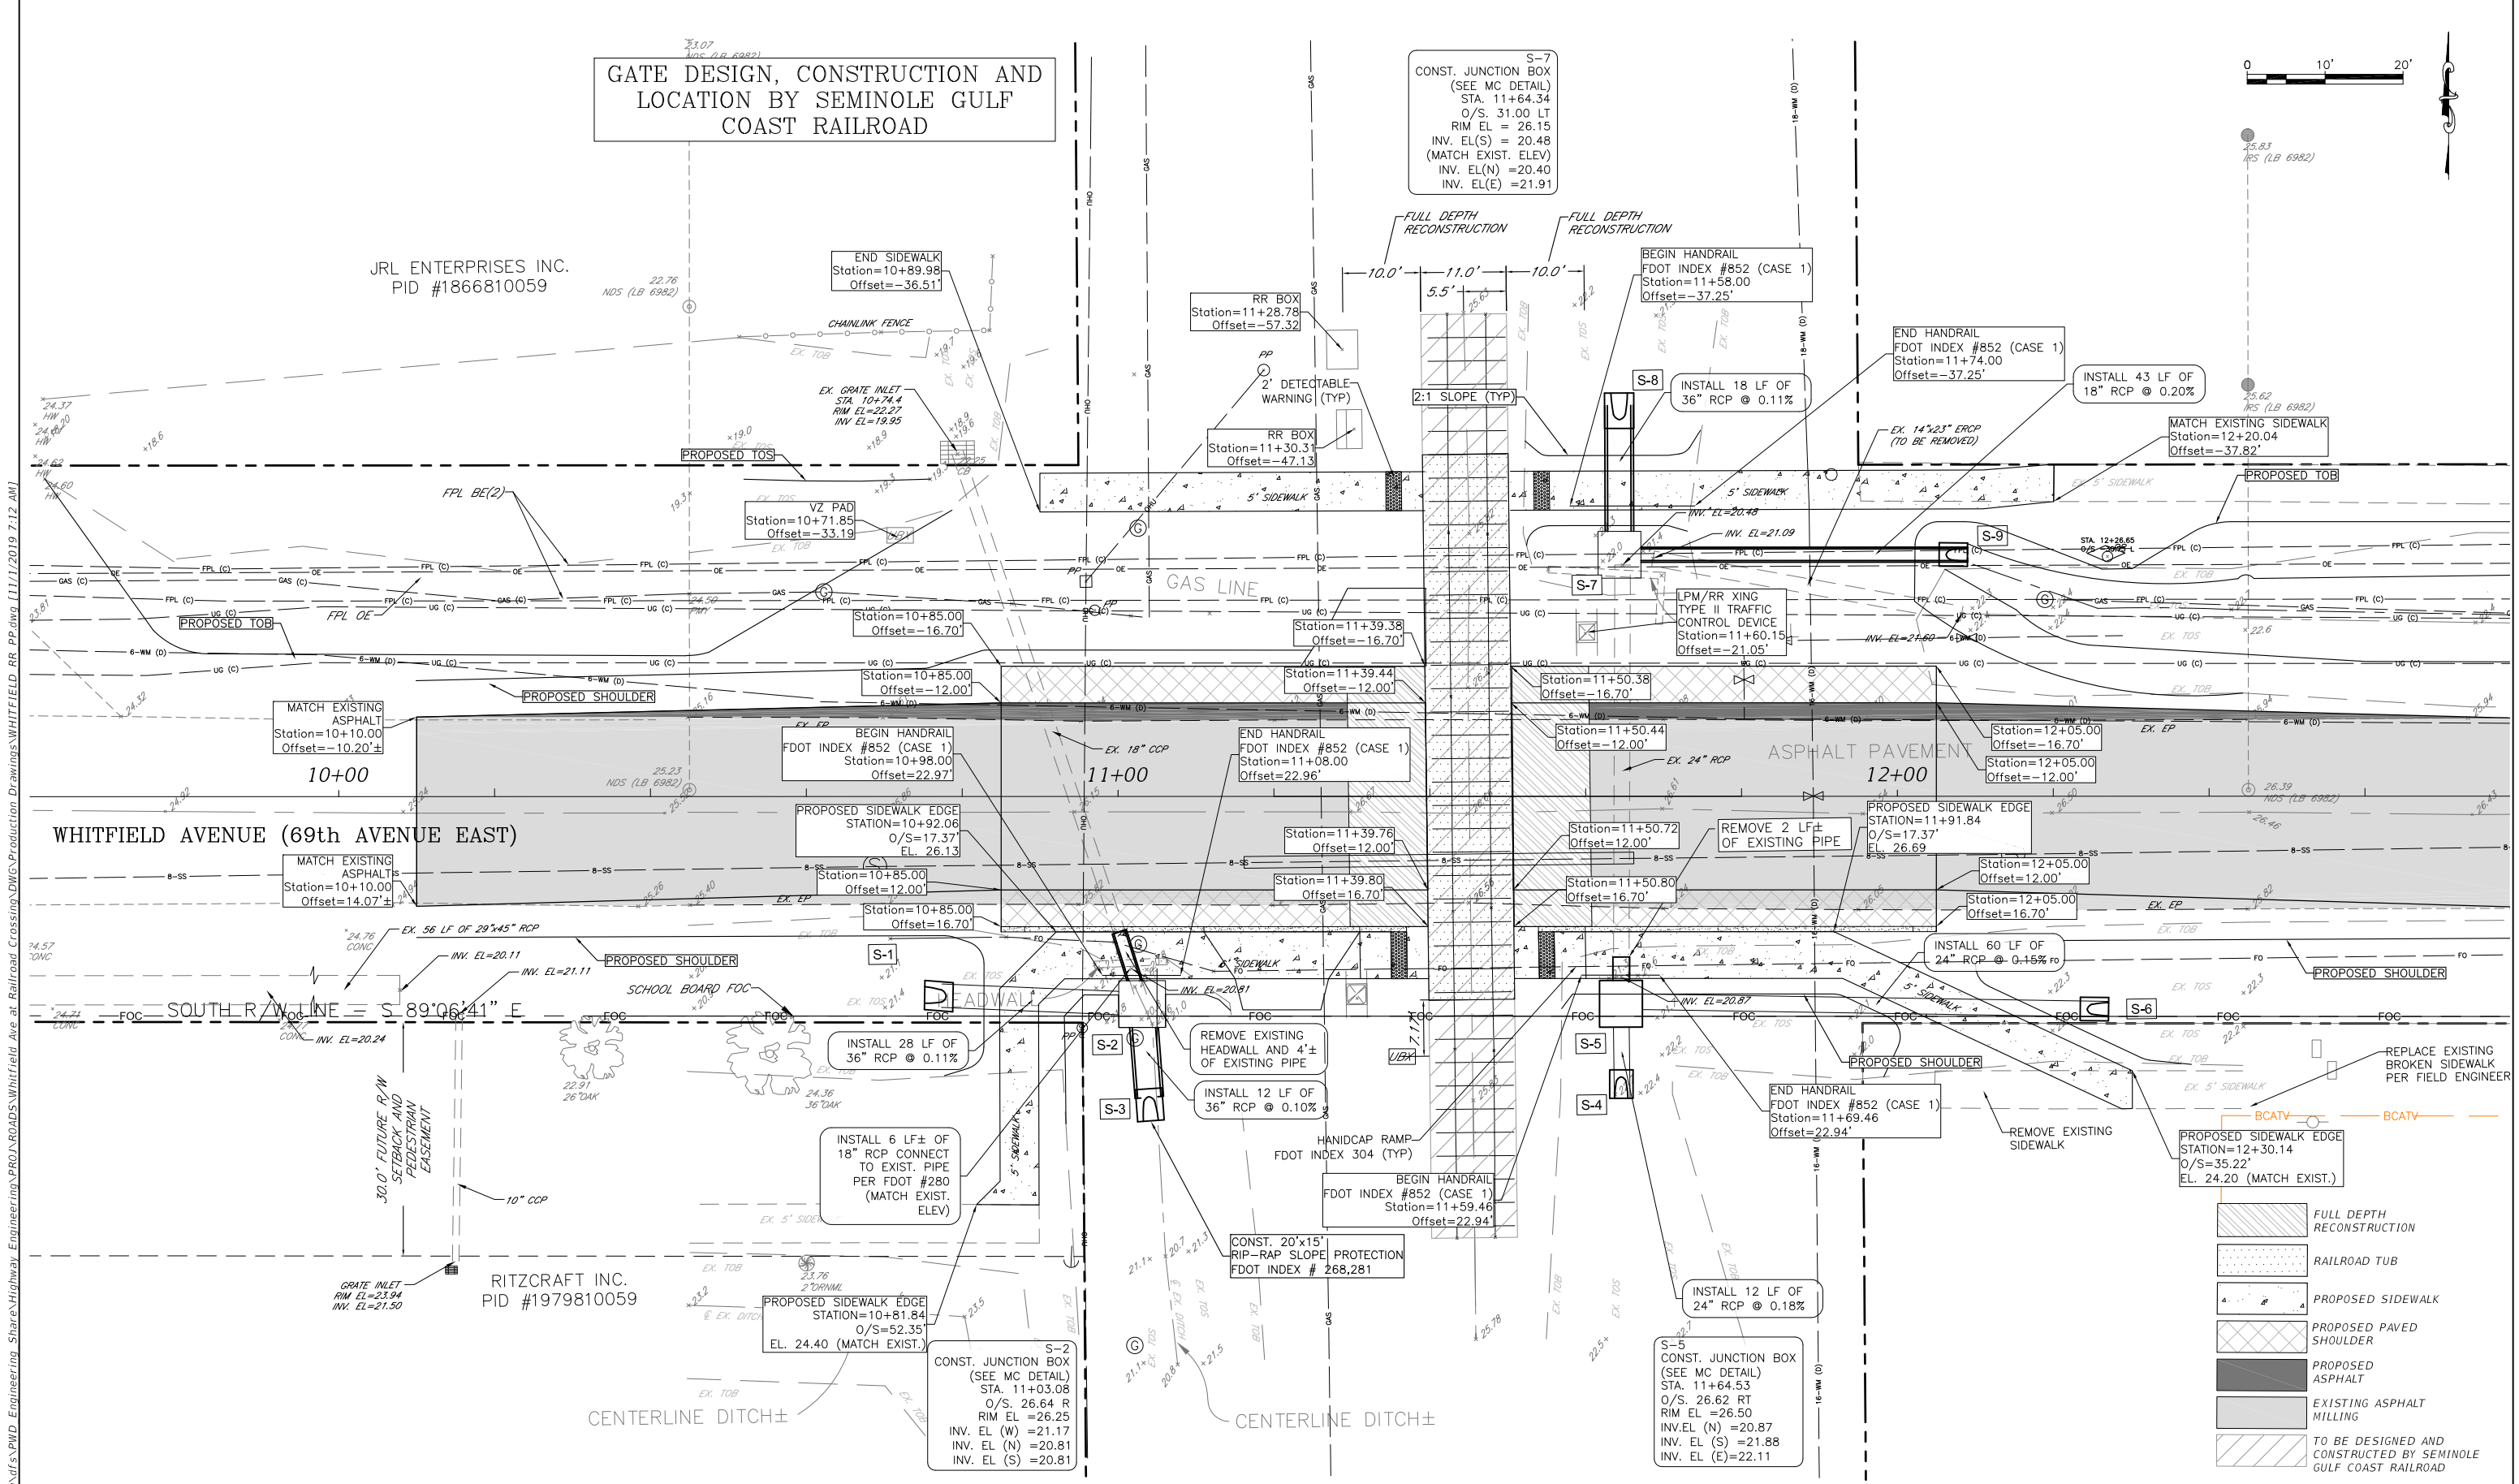

REVISION	DESCRIPTION	DATE	PROJECT #	307-6098560	SURVEYED	ZNS	02/2019
1	ADDITIONAL STRUCTURE ON NE QUADRANT	08/07/19	SURVEY #	0577-0036	DESIGNED	GB	02/2019
			SEC./TWN./RGE	19 & 30/35S/18E	DRAWN	KHL	02/2019
			SCALE	AS SHOWN	CHECKED	XXX	XX/XXXX

GRIGORY BERIKHMAN, P.E.  
FLORIDA P.E. # 76896

Signature & Date



**Manatee County**  
FLORIDA

**PUBLIC WORKS DEPARTMENT**  
**ENGINEERING SERVICES**  
1022 26th Avenue East, Bradenton, FL 34208


\\bcccad.myanatee.org\dfs\pwwd Engineering\Share\Highway Engineering\PROJ\ROADS\Whitfield Ave at Railroad Crossing\DWG\Production Drawings\WHITFIELD.RR.PP.dwg [11/11/2019 7:13 AM]

GATE DESIGN, CONSTRUCTION AND  
LOCATION BY SEMINOLE GULF  
COAST RAILROAD

0 10' 20'



SIDEWALK PROPERTIES 2 LLC.  
PID #1868700004

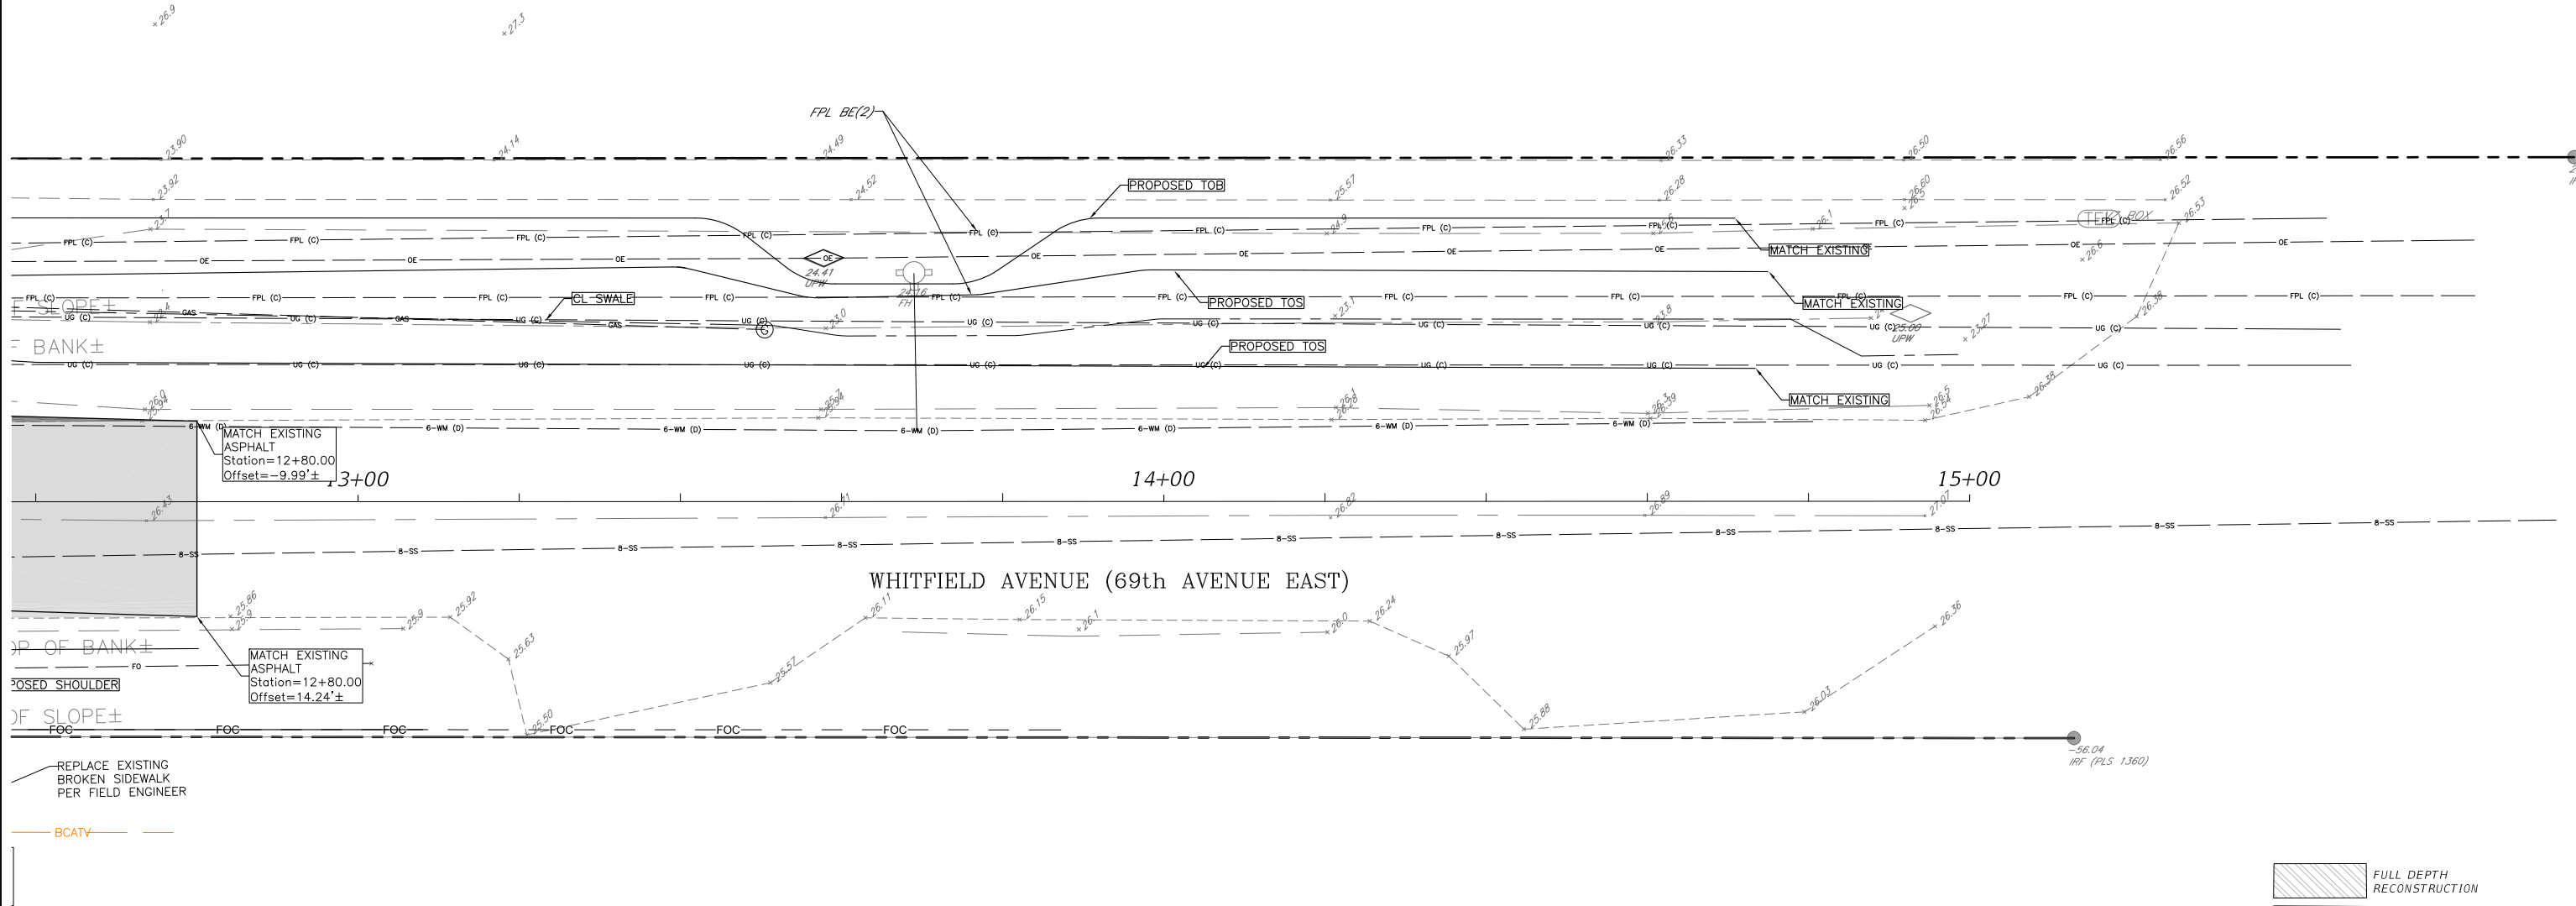

REPLACE EXISTING  
BROKEN SIDEWALK  
PER FIELD ENGINEER

BCATV

- FULL DEPTH RECONSTRUCTION
- RAILROAD TUB
- PROPOSED SIDEWALK
- PROPOSED PAVED SHOULDER
- PROPOSED ASPHALT
- EXISTING ASPHALT MILLING
- TO BE DESIGNED AND CONSTRUCTED BY SEMINOLE GULF COAST RAILROAD

REVISION	DESCRIPTION	DATE	PROJECT #	307-6098560	SURVEYED	ZNS	02/2019
1	ADDITIONAL STRUCTURE ON NE QUADRANT	08/07/19	SURVEY #	0577-0036	DESIGNED	GB	02/2019
			SEC./TWN./RGE	19 & 30/35S/18E	DRAWN	KHL	02/2019
			SCALE	AS SHOWN	CHECKED	XXX	XX/XXXX

GRIGORY BERIKHMAN, P.E.  
FLORIDA P.E. # 76896

Signature & Date





PUBLIC WORKS DEPARTMENT  
ENGINEERING SERVICES  
1022 26th Avenue East, Bradenton, FL 34208

WHITFIELD AVENUE  
AT SEMINOLE GULF COAST RAILROAD  
PLAN


SHEET NO.  
08




WHITFIELD AVENUE (69th AVENUE EAST)

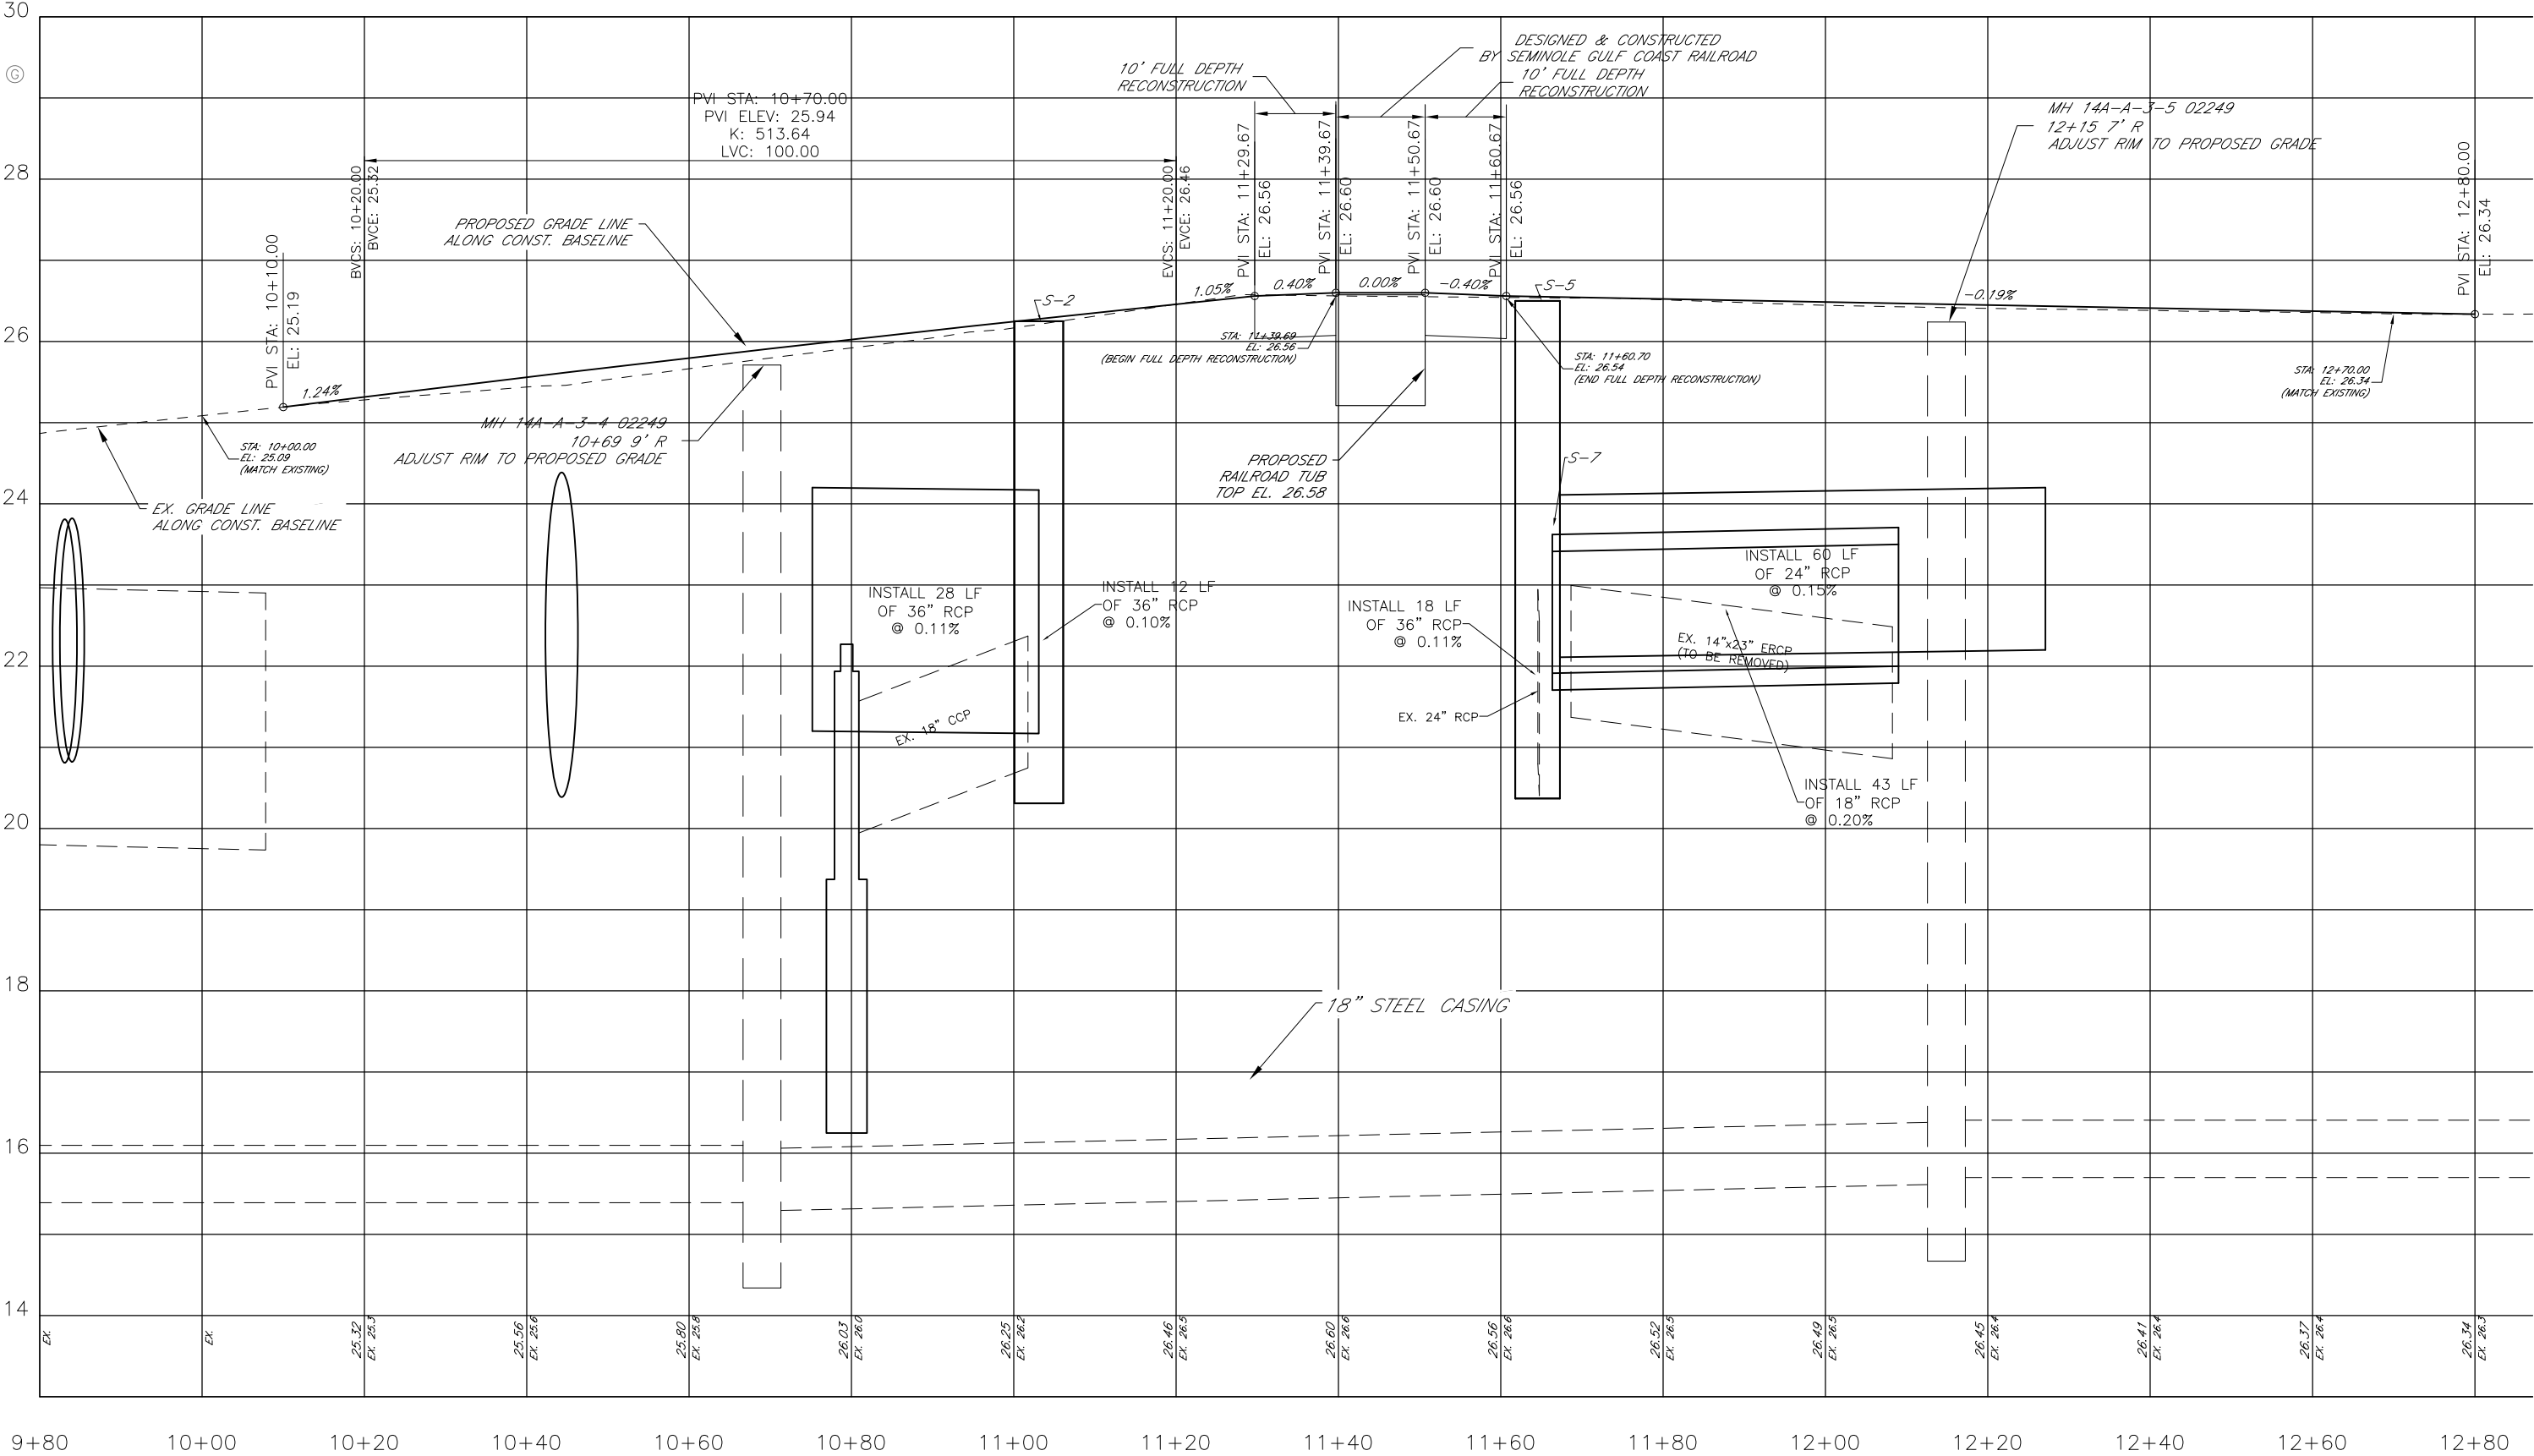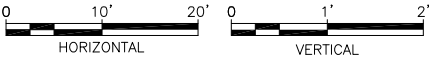


\\bcccad.myanatee.org\dfs\pvd Engineering\Share\Highway Engineering\PROJ\ROADS\Whitfield Ave at Railroad Crossing\DWG\Production Drawings\WHITFIELD RR PP.dwg [11/11/2019 7:13 AM]

REVISION		DESCRIPTION	DATE					GRIGORY BERIKHMAN, P.E. FLORIDA P.E. # 76896		PUBLIC WORKS DEPARTMENT ENGINEERING SERVICES 1022 26th Avenue East, Bradenton, FL 34208	WHITFIELD AVENUE AT SEMINOLE GULF COAST RAILROAD PROFILE	SHEET NO. 09	
1		ADDITIONAL STRUCTURE ON NE QUADRANT	08/07/19	PROJECT #	307-6098560	SURVEYED	ZNS						02/2019
				SURVEY #	0577-0036	DESIGNED	GB						02/2019
				SEC./TWN./RGE	19 & 30/35S/18E	DRAWN	KHL						02/2019
				SCALE	AS SHOWN	CHECKED	XXX	XX/XXXX					
									Signature & Date				


WHITFIELD AVENUE (69th AVENUE EAST)

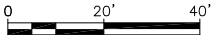


- FULL DEPTH RECONSTRUCTION
- RAILROAD TUB
- PROPOSED SIDEWALK
- PROPOSED PAVED SHOULDER
- PROPOSED ASPHALT
- EXISTING ASPHALT MILLING
- TO BE DESIGNED AND CONSTRUCTED BY SEMINOLE GULF COAST RAILROAD

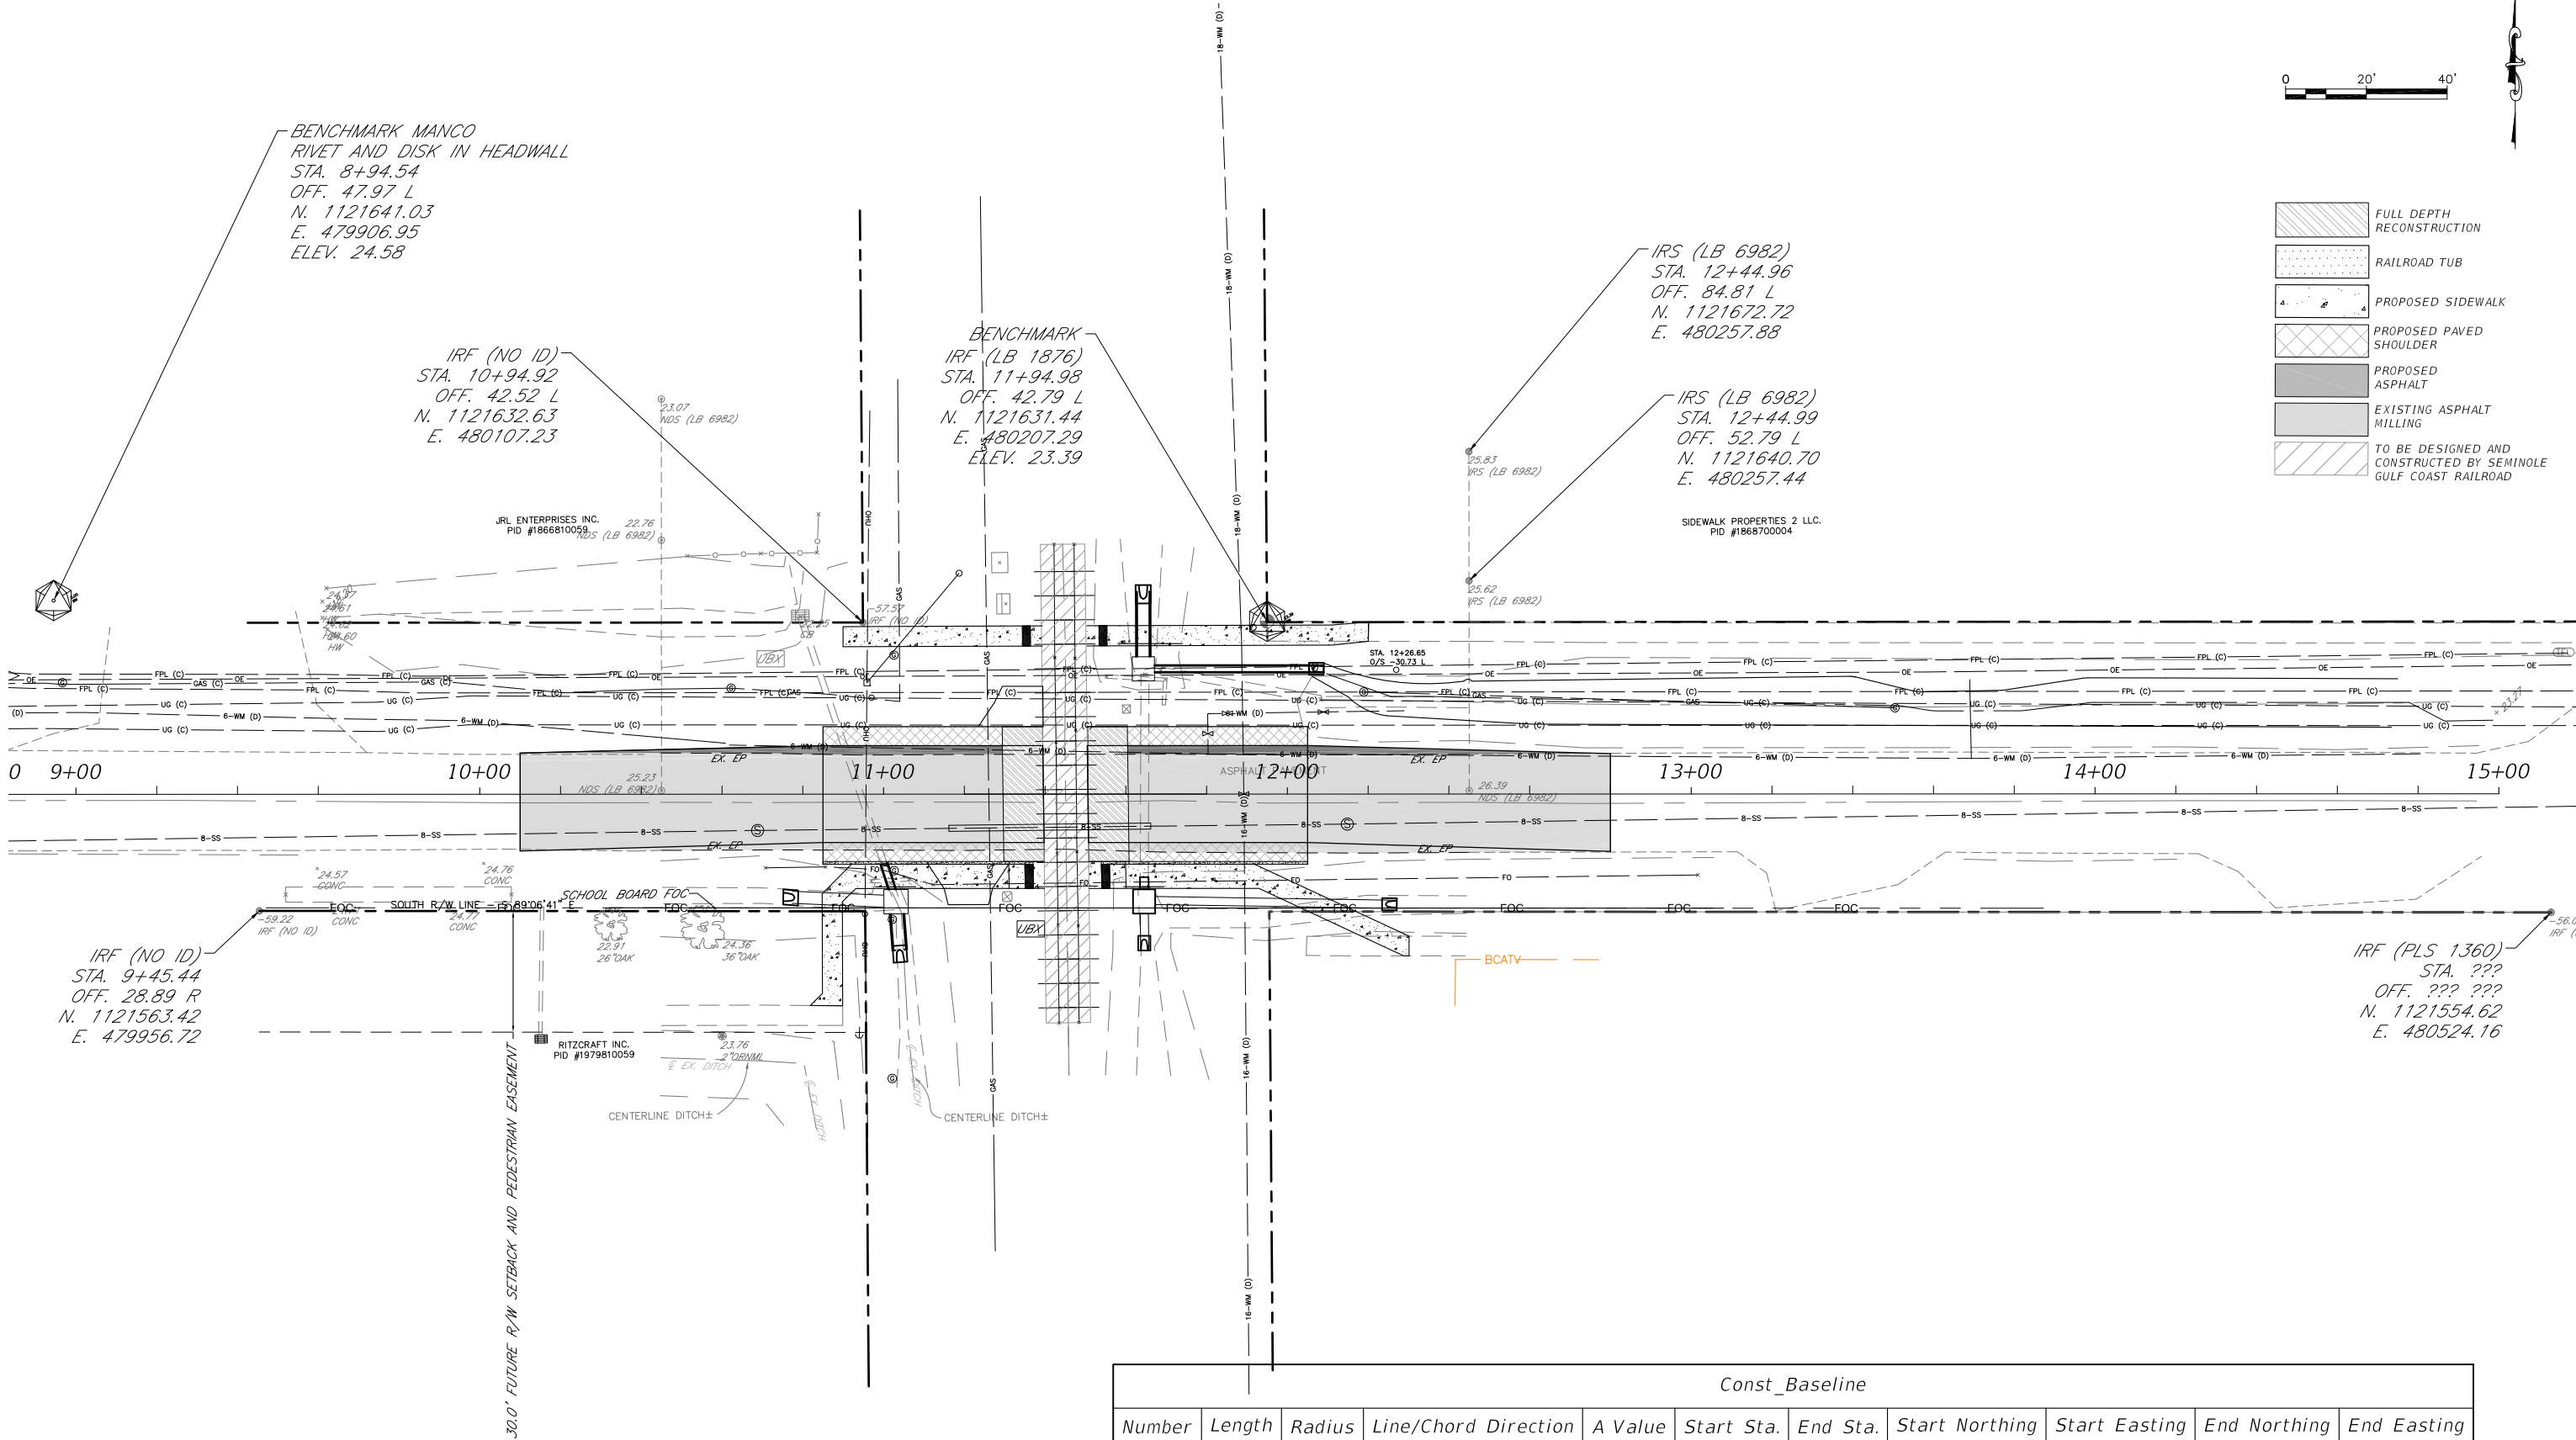

Const_Baseline										
Number	Length	Radius	Line/Chord Direction	A Value	Start Sta.	End Sta.	Start Northing	Start Easting	End Northing	End Easting
L1	620.000		S89° 09' 38.26"E		8+80.00	15+00.00	1121593.27	479891.71	1121584.19	480511.65

REVISION	DESCRIPTION	DATE	PROJECT #	307-6098560	SURVEYED	ZNS	02/2019	GRIGORY BERIKHMAN, P.E. FLORIDA P.E. # 76896		PUBLIC WORKS DEPARTMENT ENGINEERING SERVICES 1022 26th Avenue East, Bradenton, FL 34208	WHITFIELD AVENUE AT SEMINOLE GULF COAST RAILROAD HORIZONTAL AND VERTICAL CONTROL	SHEET NO. 10
1	ADDITIONAL STRUCTURE ON NE QUADRANT	08/07/19	SURVEY #	0577-0036	DESIGNED	GB	02/2019					
			SEC./TWN./RGE	19 & 30/35S/18E	DRAWN	KHL	02/2019					
			SCALE	AS SHOWN	CHECKED	XXX	XX/XXXX					
								Signature & Date				

H:\Highway Engineering\PROJECTS\Whitfield Ave At Railroad Crossing\DWG\Production Drawings\WHITEFIELD\_RR\_UAS.dwg Dec 10 19 8:48 AM

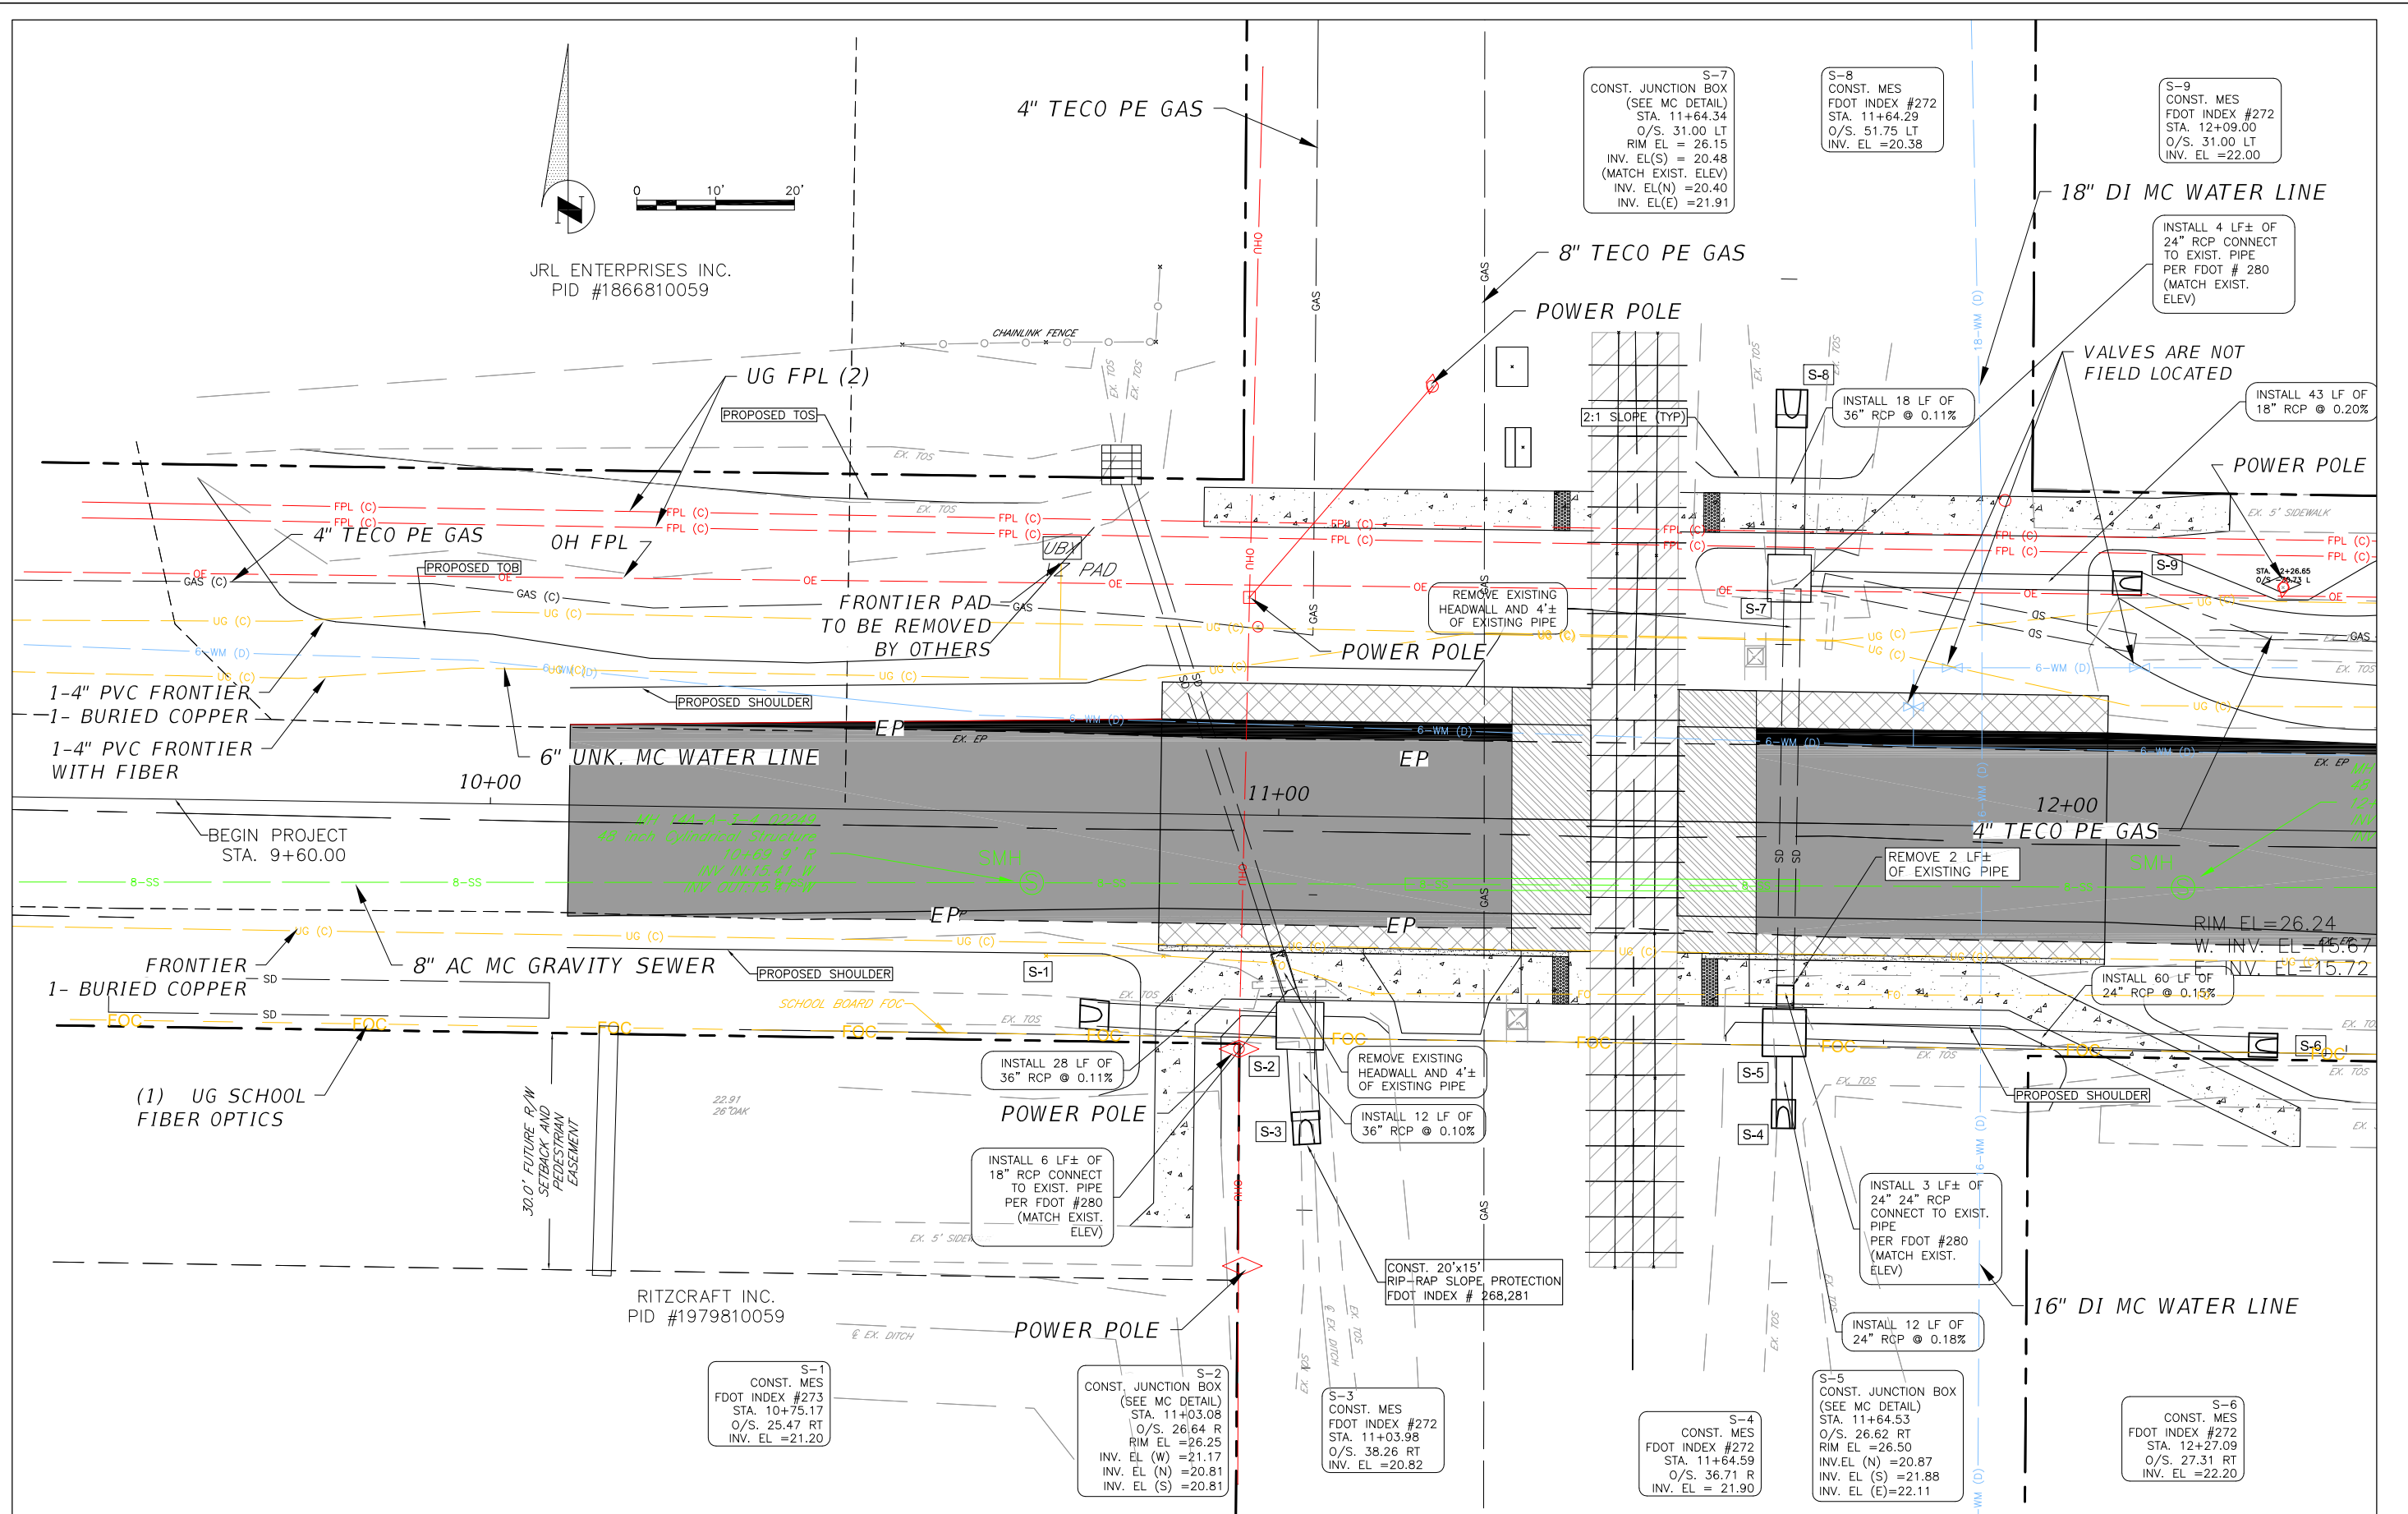

DATE	DESCRIPTION	DATE	PROJECT #	---	SURVEYED	MCPM	06/2018
			SURVEY #	N/A	DESIGNED	JEA/SF	06/2018
			SEC./TWN./RGE	35/35/20	DRAWN	JEA	06/2018
			SCALE		CHECKED	SF	06/2018

FLORIDA P.E. # 76896  
GRIGORY BERIKHMAN

Signature & Date





PUBLIC WORKS DEPARTMENT  
ENGINEERING SERVICES  
1022 26th Avenue East, Bradenton, FL 34208

WHITFIELD AVENUE  
AT SEMINOLE GULF COAST RAILROAD  
UAS





SHEET NO.  
11



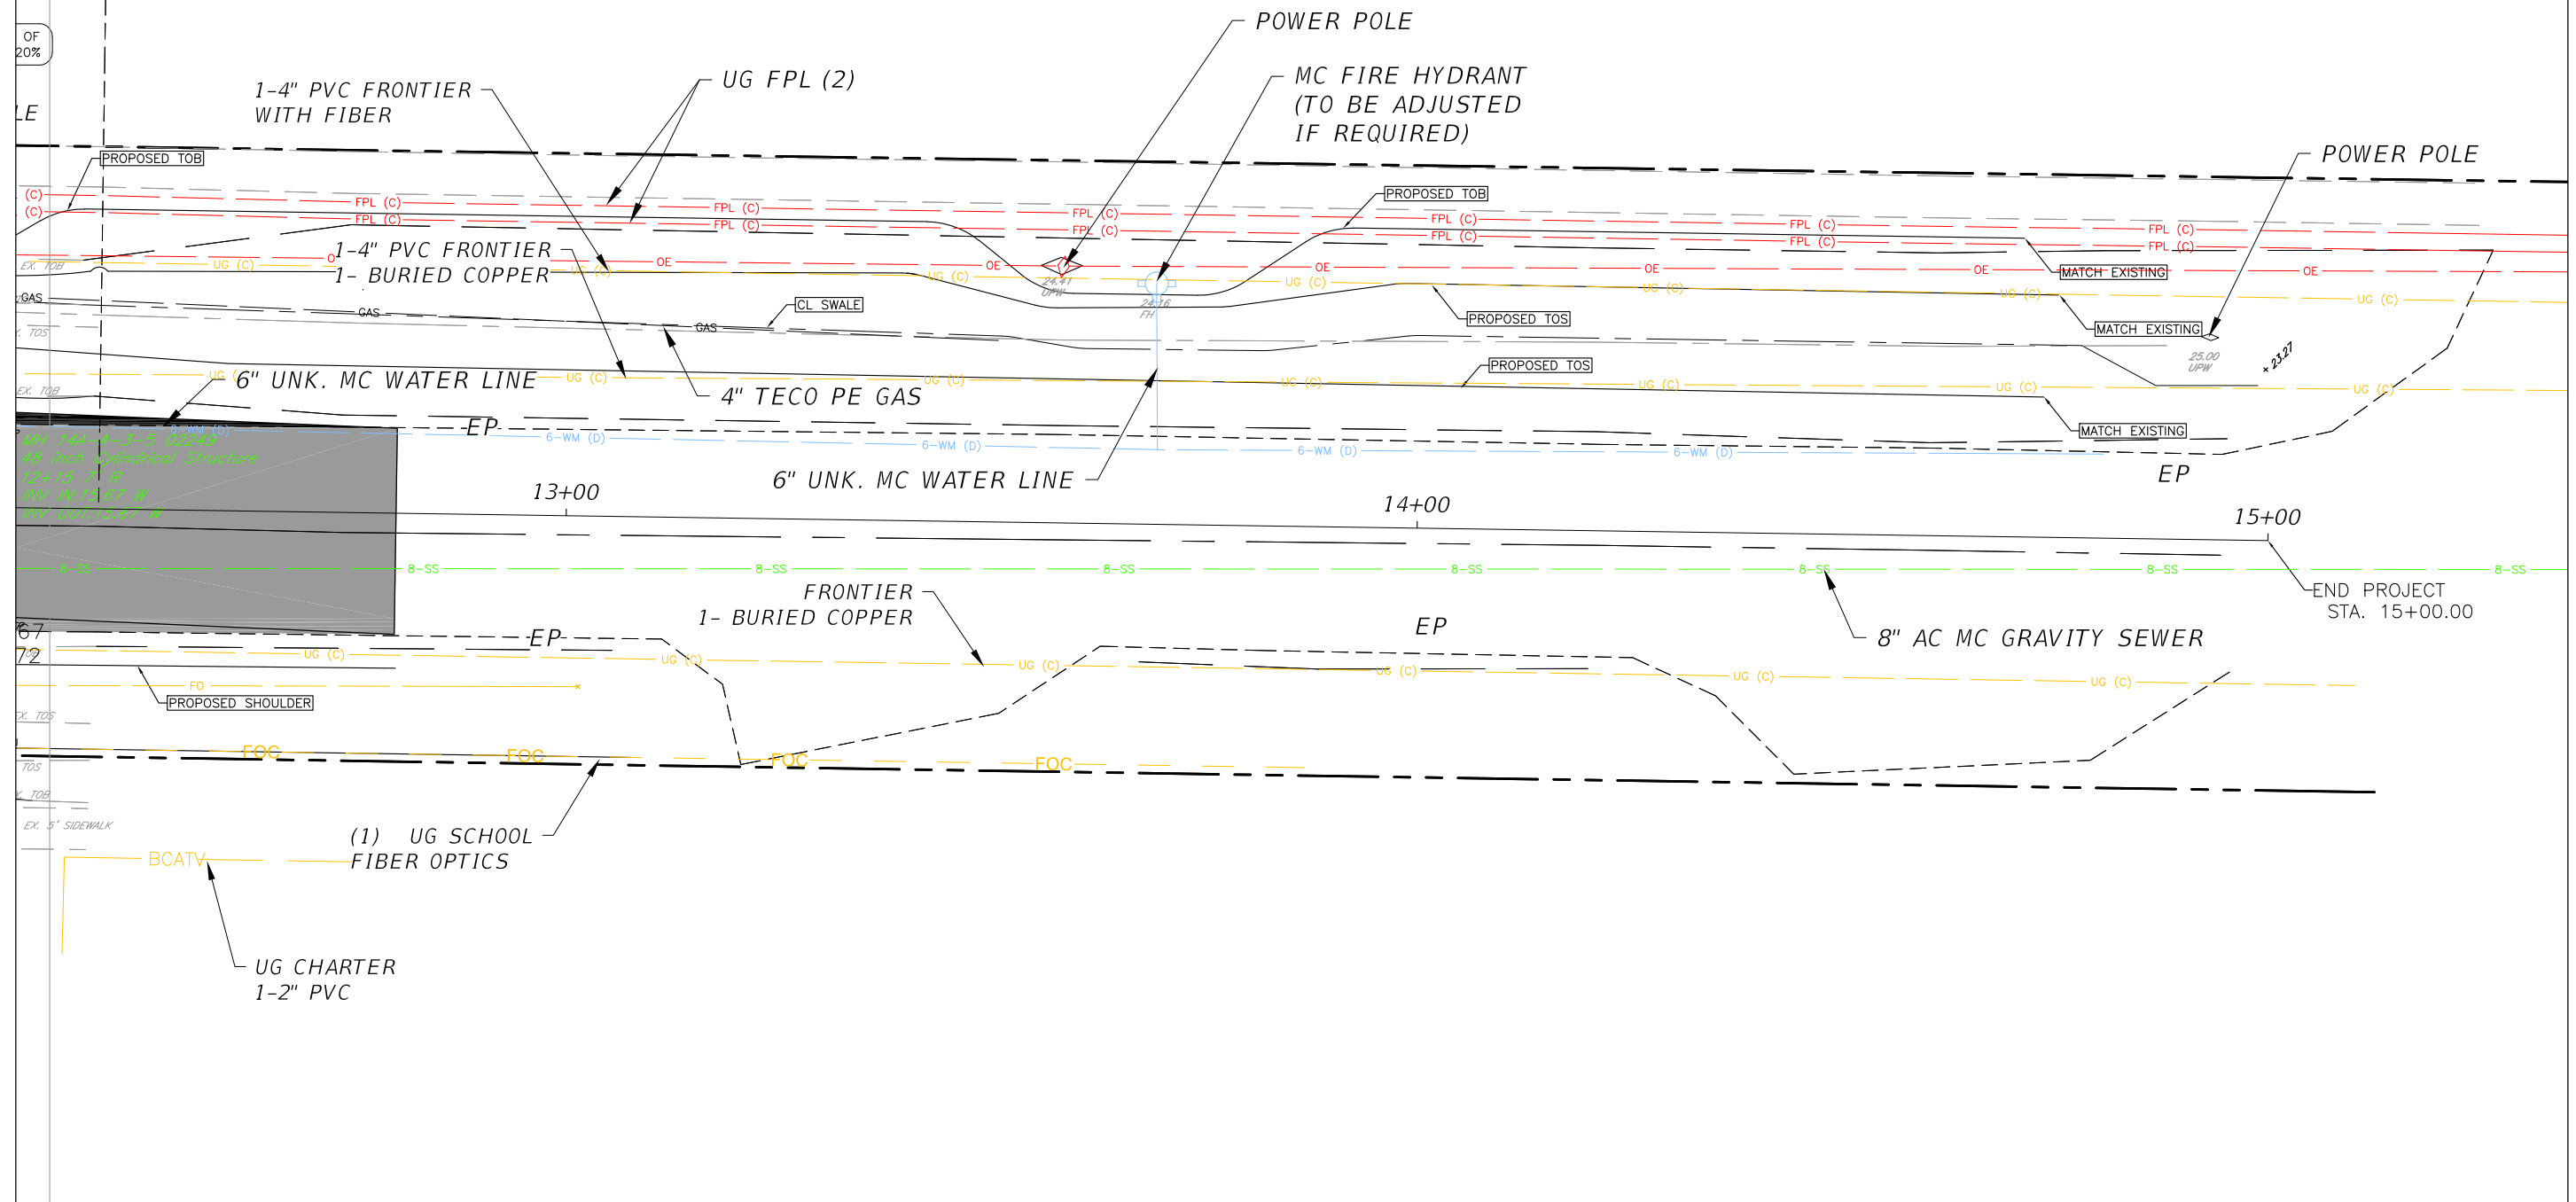

								FLORIDA P.E. # 76896 GRIGORY BERIKHMAN		 <p><b>PUBLIC WORKS DEPARTMENT ENGINEERING SERVICES</b> 1022 26th Avenue East, Bradenton, FL 34208</p>	<p><i>WHITFIELD AVENUE AT SEMINOLE GULF COAST RAILROAD UAS</i></p>		<p>SHEET NO. 12</p>
DATE	DESCRIPTION	DATE	PROJECT #	----	SURVEYED	MCPM	06/2018						
			SURVEY #	N/A	DESIGNED	JEA/SF	06/2018						
			SEC./TWN./RGE	35/35/20	DRAWN	JEA	06/2018						
			SCALE		CHECKED	SF	06/2018						
								Signature & Date					

H:\Highway Engineering\PROJECTS\Whitfield Ave At Railroad Crossing\DWG\Production Drawings\WHITEFIELD\_RR\_PP.DWG Nov 4 19 9:43 AM

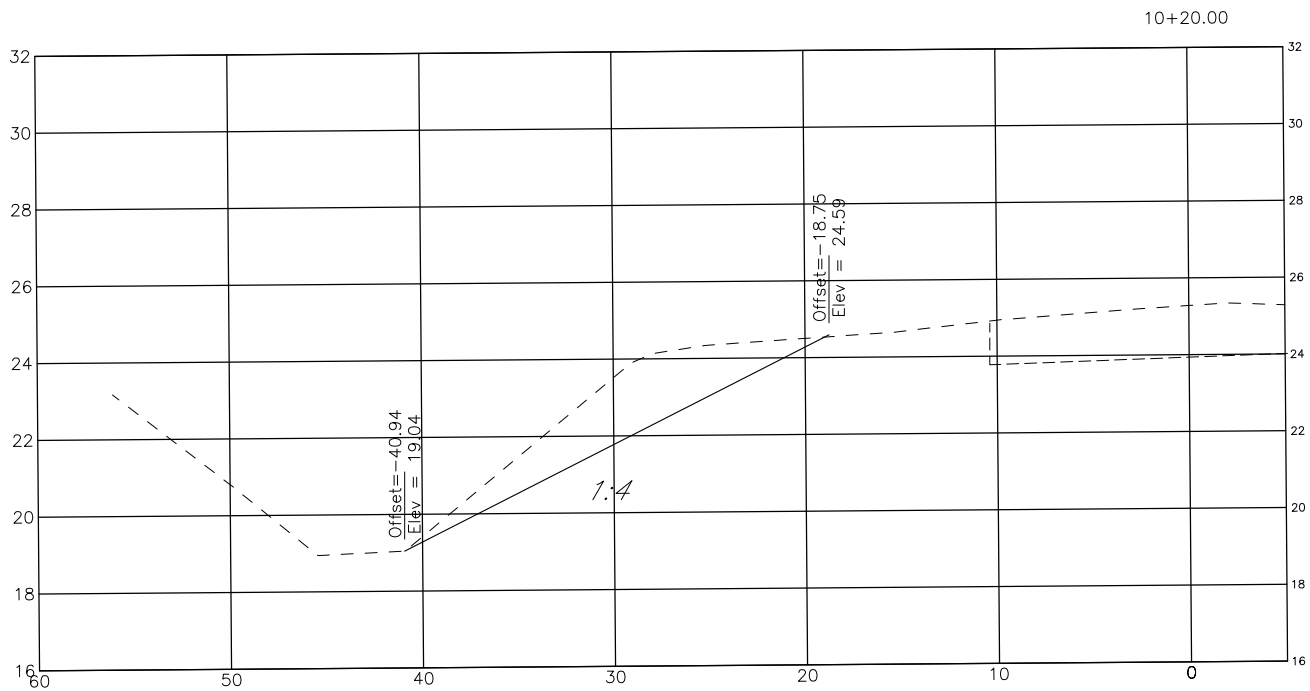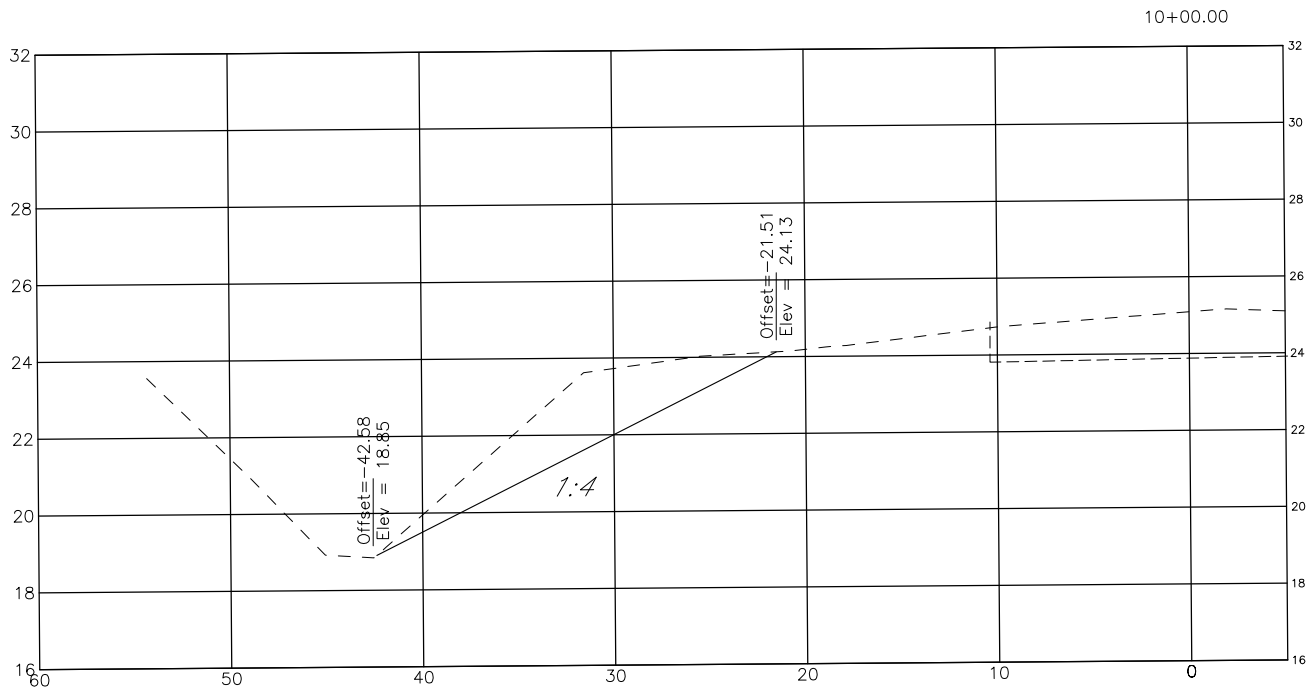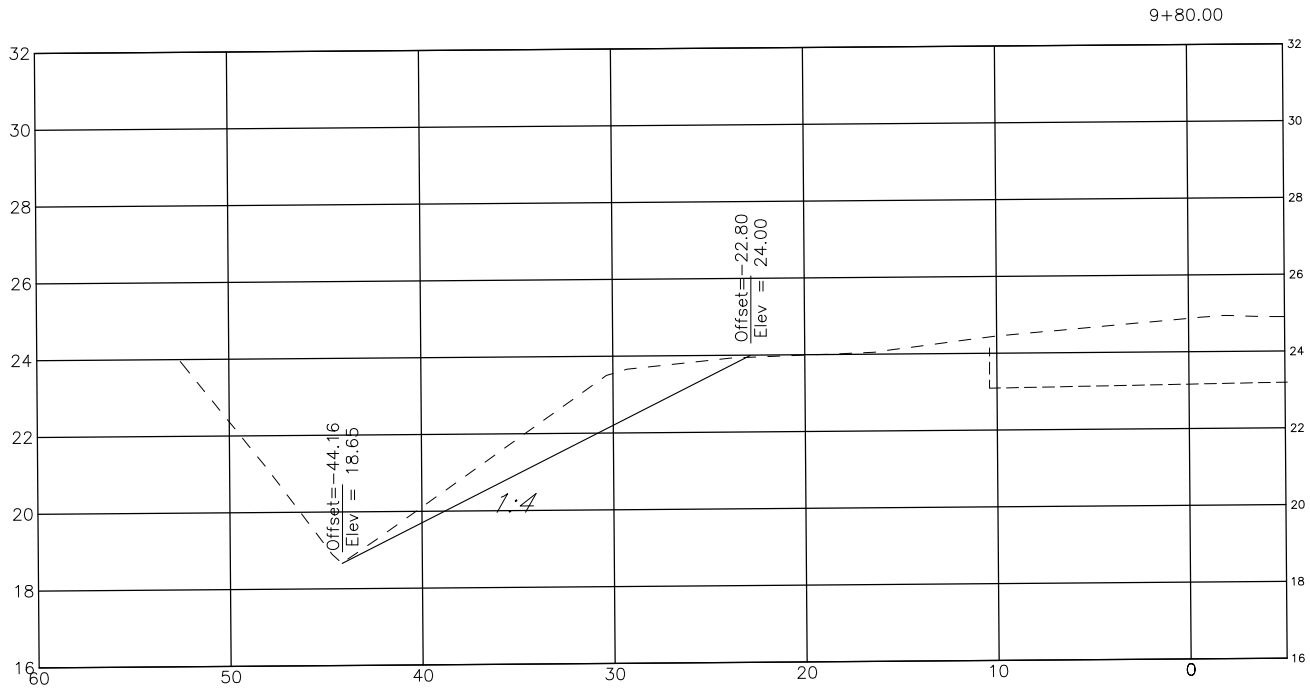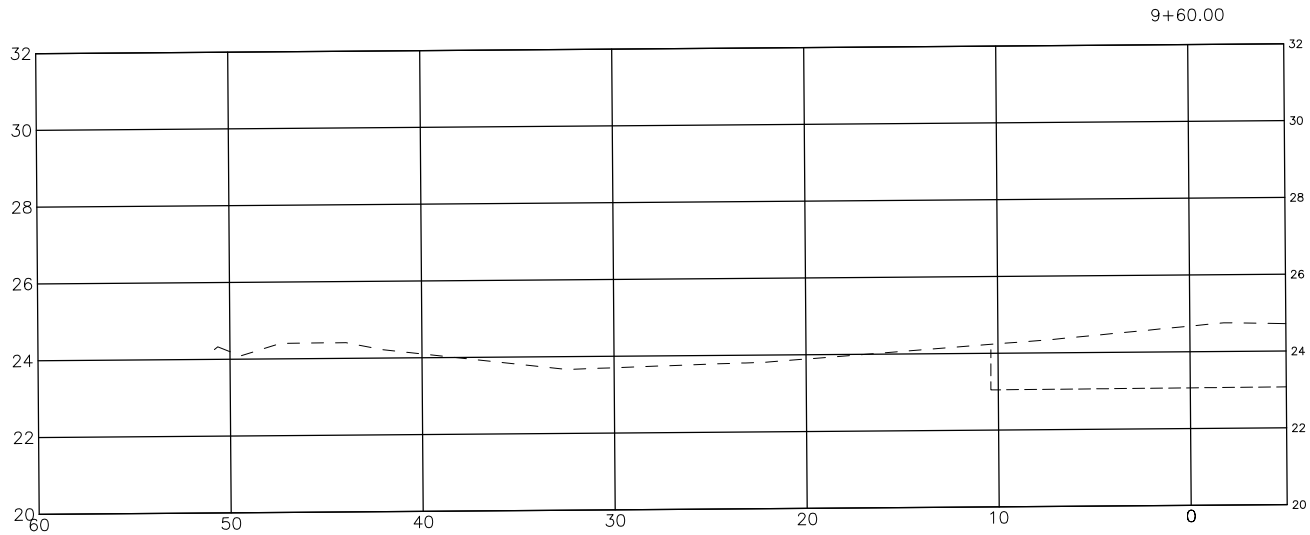

1" = 10' Horizontal  
1" = 5' Vertical

DATE	DESCRIPTION	DATE	PROJECT #	----	SURVEYED	MCPM	06/2018
			SURVEY #	N/A	DESIGNED	JEA/SF	06/2018
			SEC./TWN./RGE	35/35/20	DRAWN	JEA	06/2018
			SCALE		CHECKED	SF	06/2018

FLORIDA P.E. # 76896  
GRIGORY BERIKHMAN

Signature & Date






PUBLIC WORKS DEPARTMENT  
ENGINEERING SERVICES  
1022 26th Avenue East, Bradenton, FL 34208

WHITFIELD AVENUE  
PLAN AND PROFILE  
XSECT 9+60 TO 10+20

SHEET NO.  
13

H:\Highway Engineering\PROJECTS\Whitfield Ave At Railroad Crossing\DWG\Production Drawings\WHITEFIELD\_RR\_PP.DWG Nov 4 19 9:44 AM

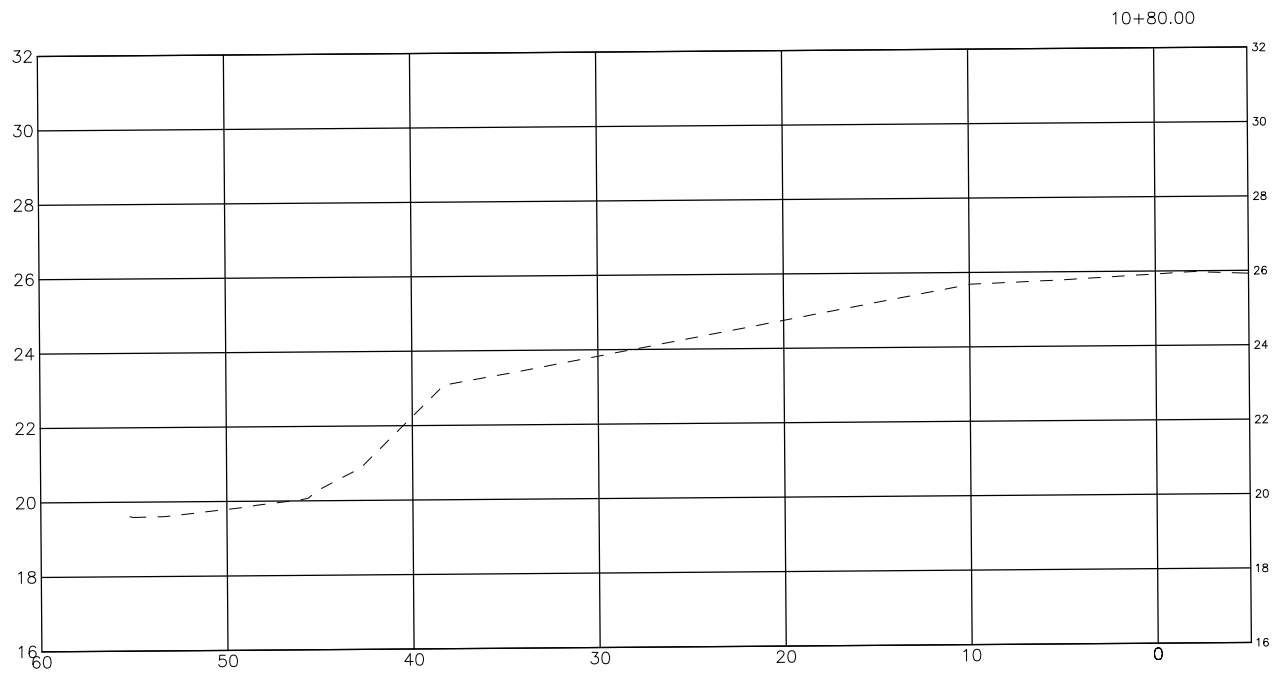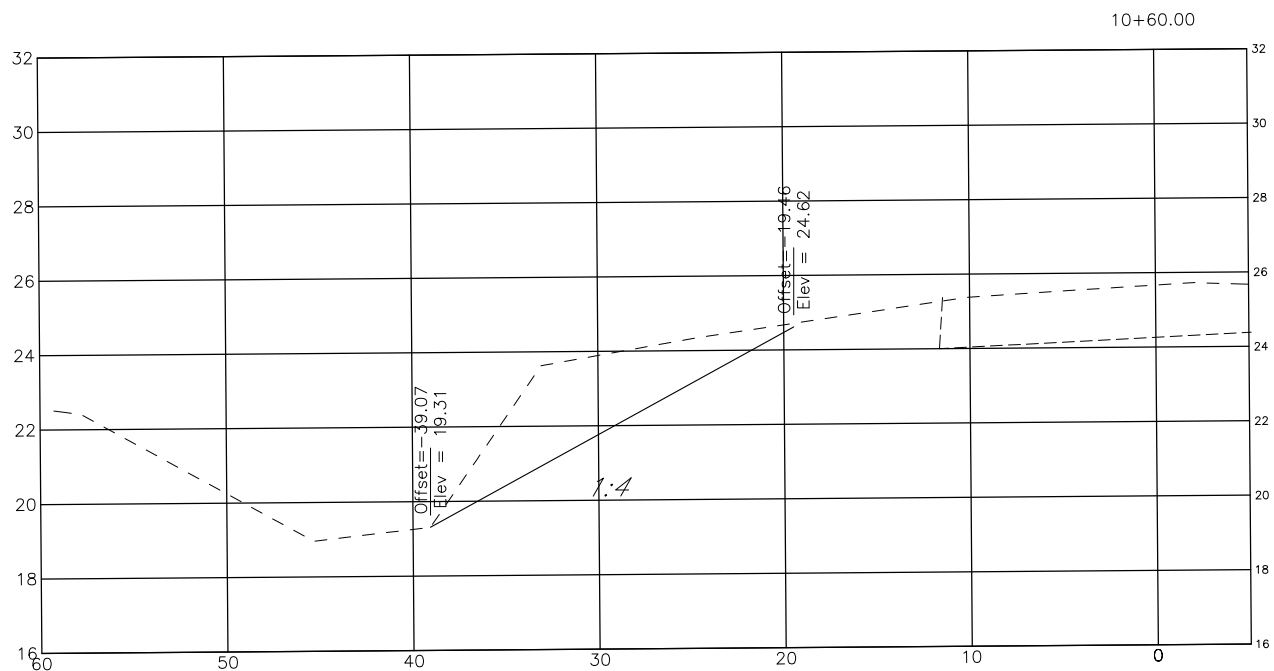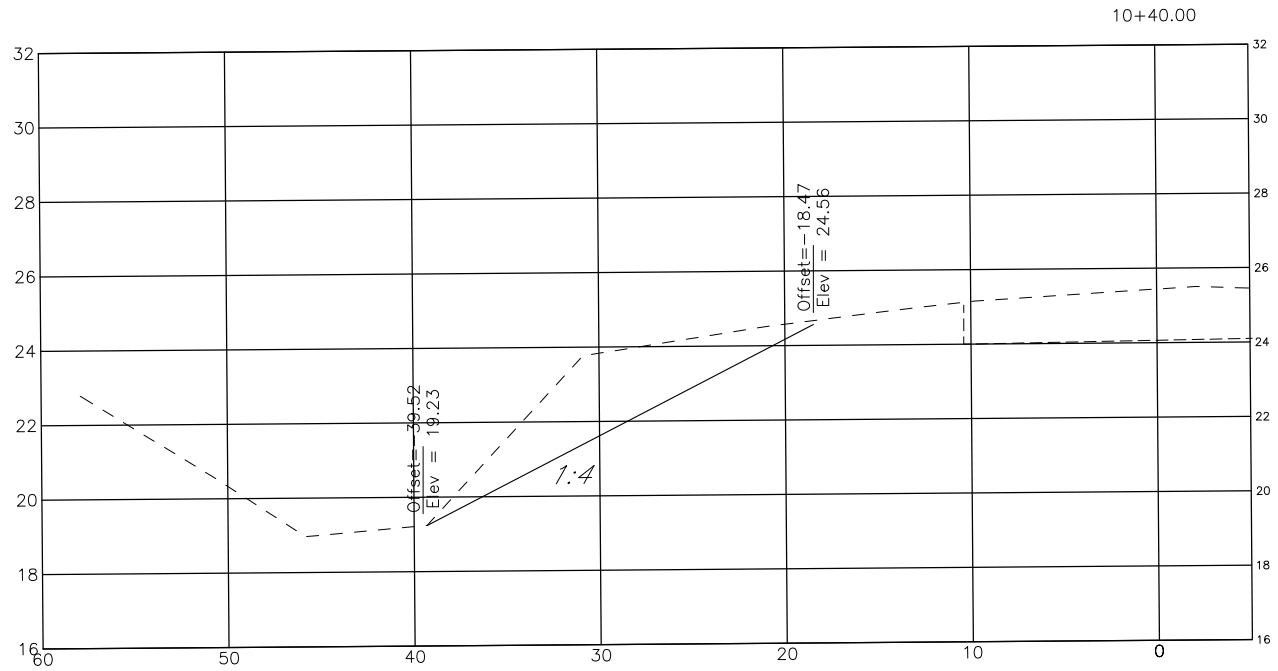

1" = 10' Horizontal  
1" = 5' Vertical

1" = 40' Horizontal  
1" = 10' Vertical

DATE	DESCRIPTION	DATE	PROJECT #	----	SURVEYED	MCPM	06/2018
			SURVEY #	N/A	DESIGNED	JEA/SF	06/2018
			SEC./TWN./RGE	35/35/20	DRAWN	JEA	06/2018
			SCALE		CHECKED	SF	06/2018

FLORIDA P.E. # 76896  
GRIGORY BERIKHMAN

Signature & Date







PUBLIC WORKS DEPARTMENT  
ENGINEERING SERVICES  
1022 26th Avenue East, Bradenton, FL 34208

WHITFIELD AVENUE  
PLAN AND PROFILE  
XSECT 9+60 TO 10+20

SHEET NO.  
14



H:\Highway Engineering\PROJECTS\Whitfield Ave At Railroad Crossing\DWG\Production Drawings\WHITEFIELD\_RR\_PP.DWG Nov 4 19 9:44 AM

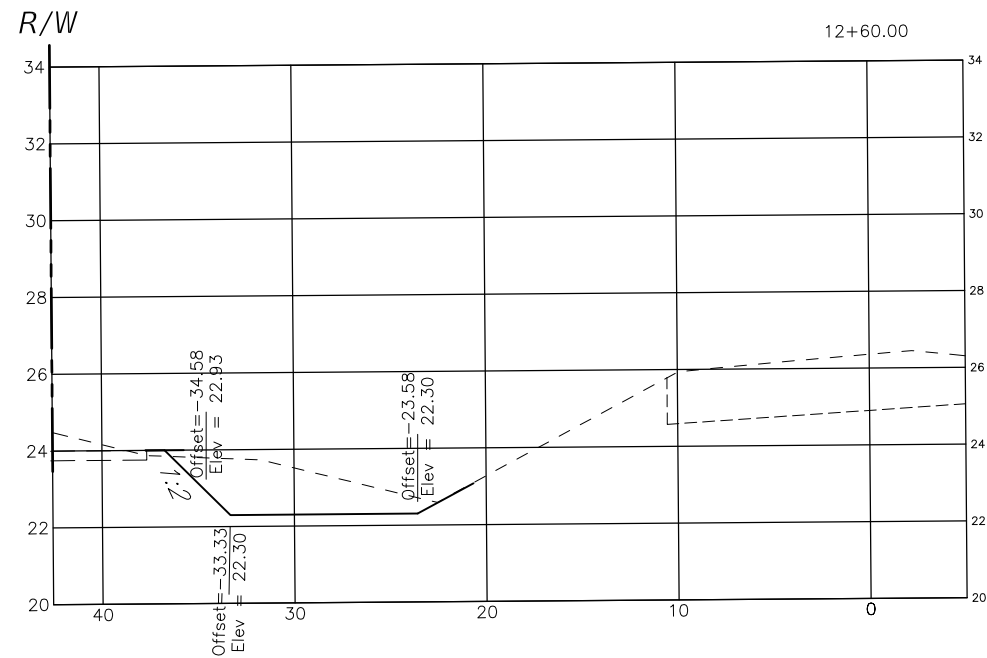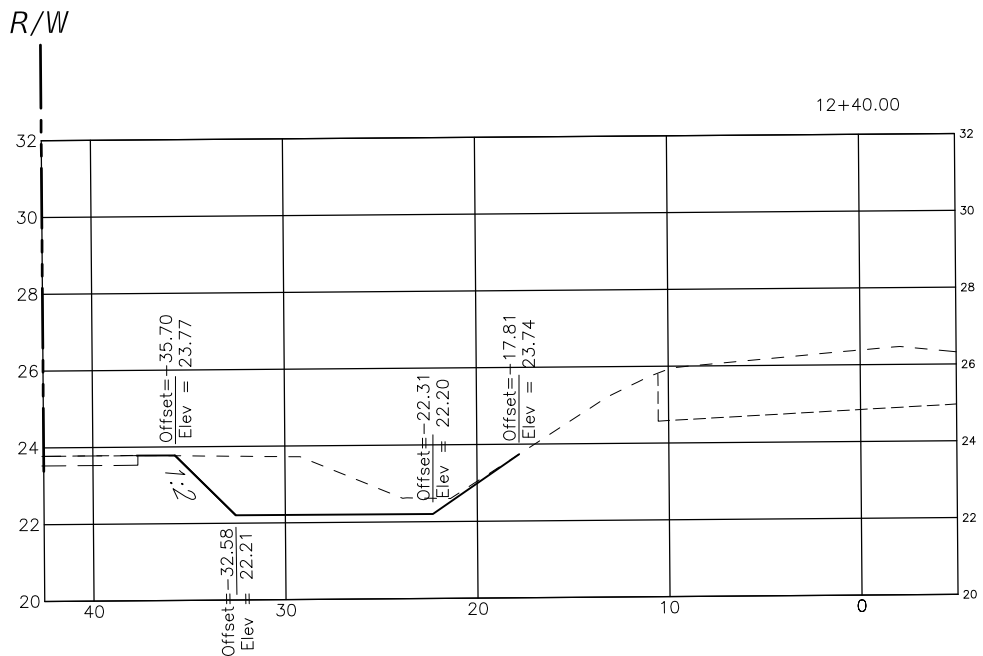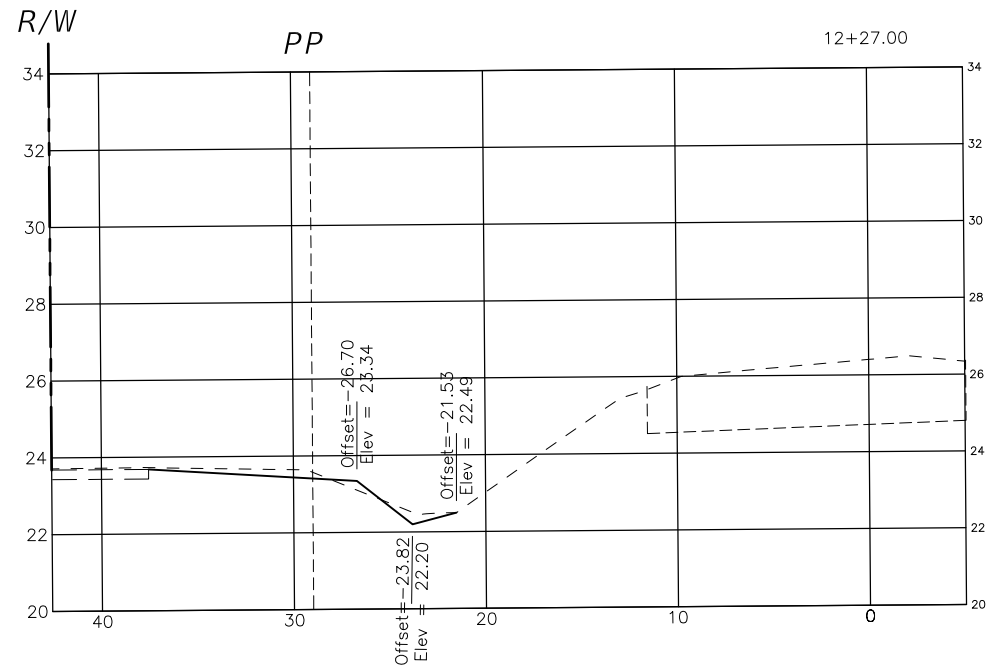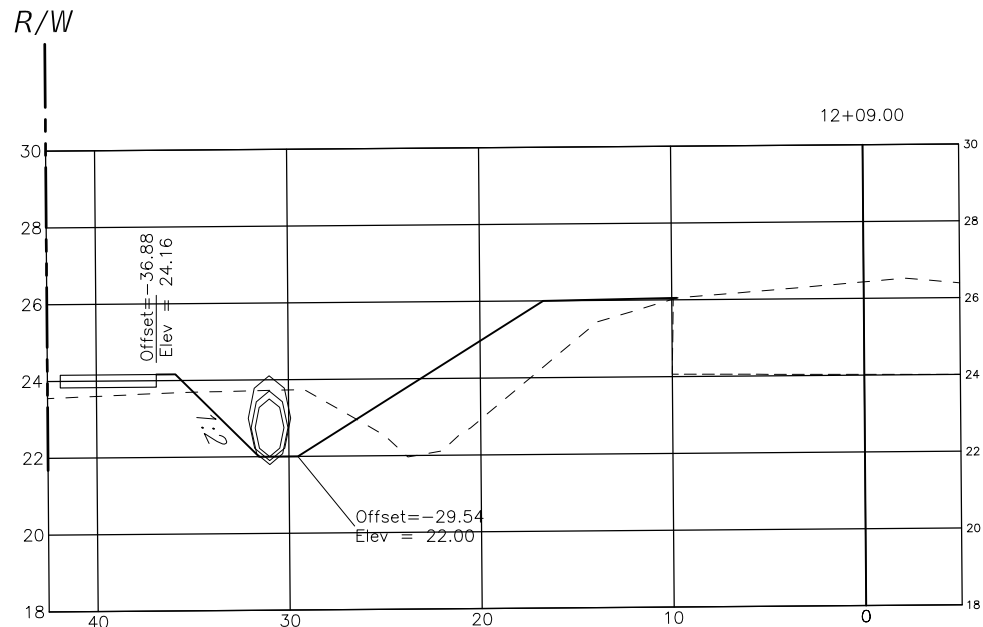

1" = 10' Horizontal  
1" = 5' Vertical

DATE	DESCRIPTION	DATE	PROJECT #	----	SURVEYED	MCPM	06/2018
			SURVEY #	N/A	DESIGNED	JEA/SF	06/2018
			SEC./TWN./RGE	35/35/20	DRAWN	JEA	06/2018
			SCALE		CHECKED	SF	06/2018

FLORIDA P.E. # 76896  
GRIGORY BERIKHMAN

Signature & Date







PUBLIC WORKS DEPARTMENT  
ENGINEERING SERVICES  
1022 26th Avenue East, Bradenton, FL 34208

WHITFIELD AVENUE  
PLAN AND PROFILE  
XSECT STA 12+00 TO 12+60

SHEET NO.  
15

H:\Highway Engineering\PROJECTS\Whitfield Ave At Railroad Crossing\DWG\Production Drawings\WHITEFIELD\_RR\_PP.DWG Nov 4 19 9:45 AM

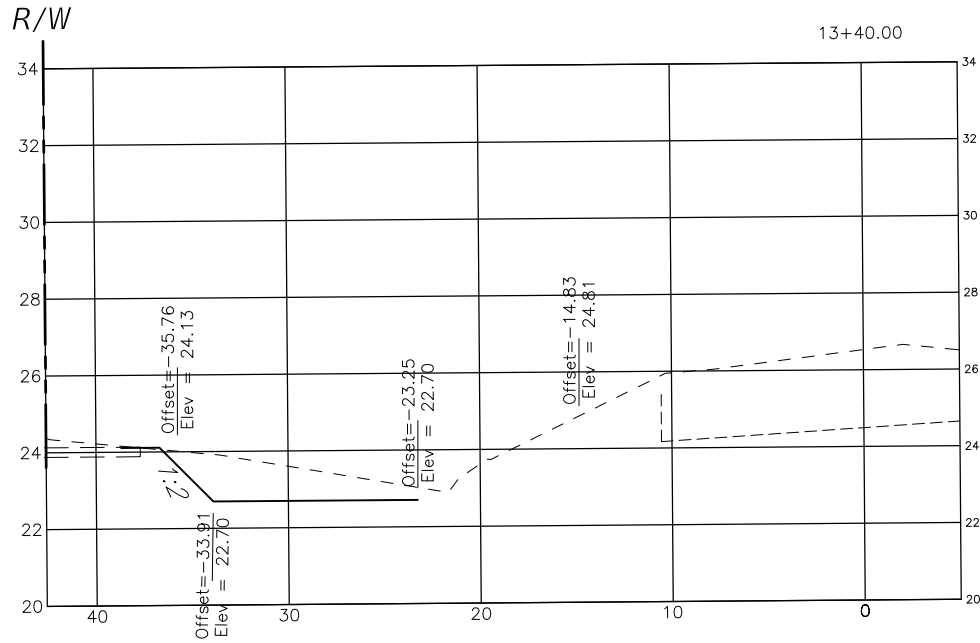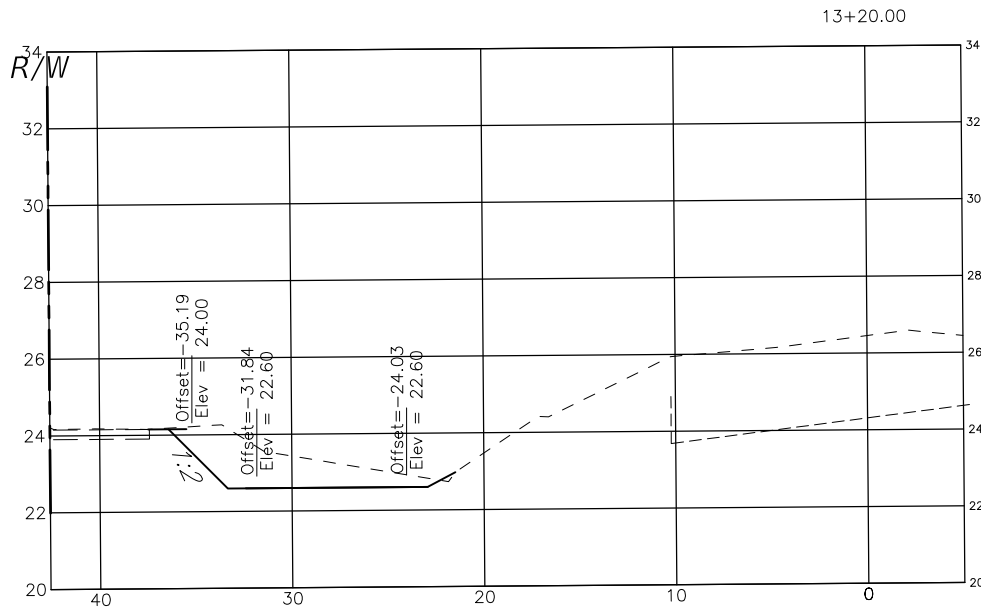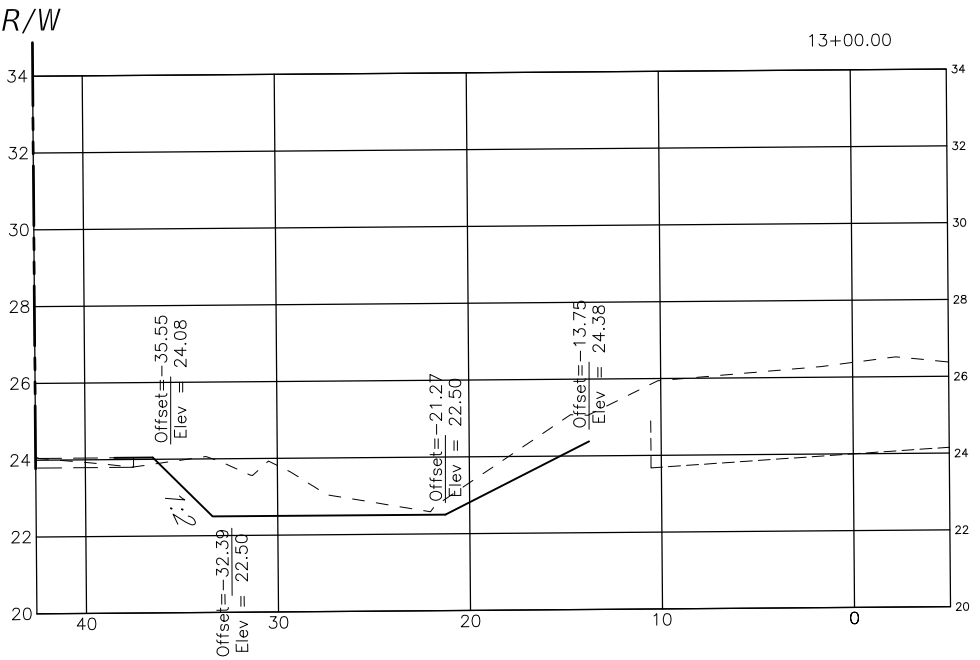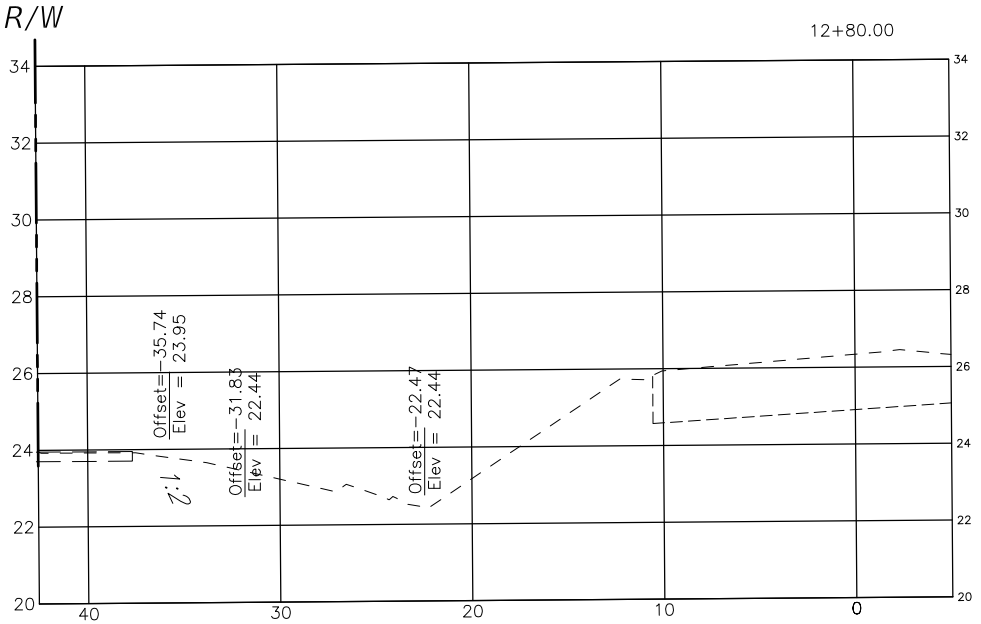

1" = 10' Horizontal  
1" = 5' Vertical

DATE	DESCRIPTION	DATE	PROJECT #	----	SURVEYED	MCPM	06/2018
			SURVEY #	N/A	DESIGNED	JEA/SF	06/2018
			SEC./TWN./RGE	35/35/20	DRAWN	JEA	06/2018
			SCALE		CHECKED	SF	06/2018

FLORIDA P.E. # 76896  
GRIGORY BERIKHMAN

Signature & Date







PUBLIC WORKS DEPARTMENT  
ENGINEERING SERVICES  
1022 26th Avenue East, Bradenton, FL 34208


WHITFIELD AVENUE  
PLAN AND PROFILE  
XSECT STA 12+80 TO 13+40

SHEET NO.  
16

H:\Highway Engineering\PROJECTS\Whitfield Ave At Railroad Crossing\DWG\Production Drawings\WHITEFIELD\_RR\_PP.DWG Nov 4 19 9:45 AM

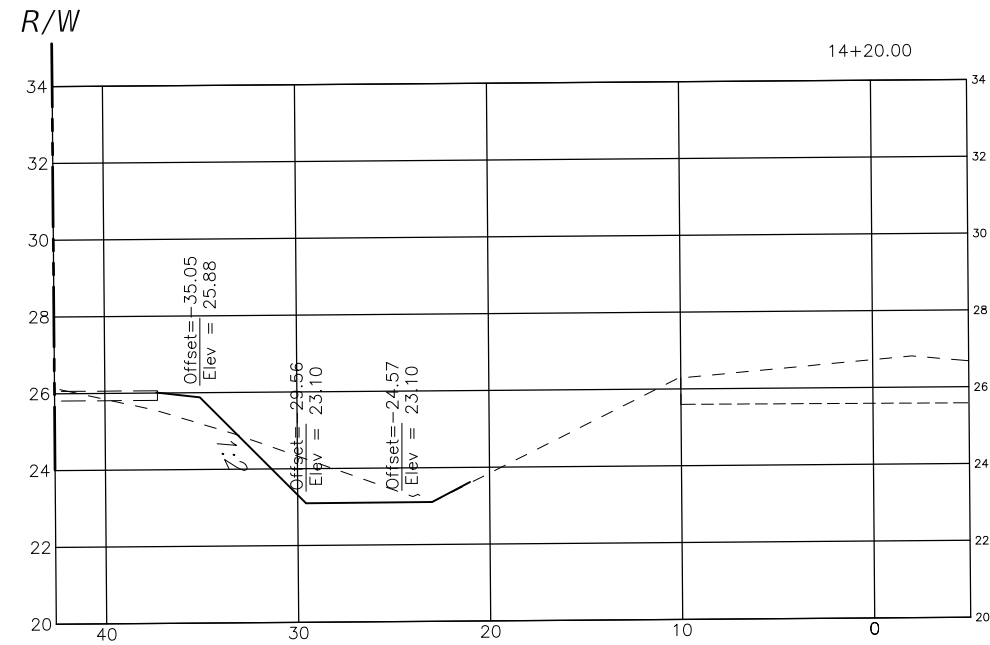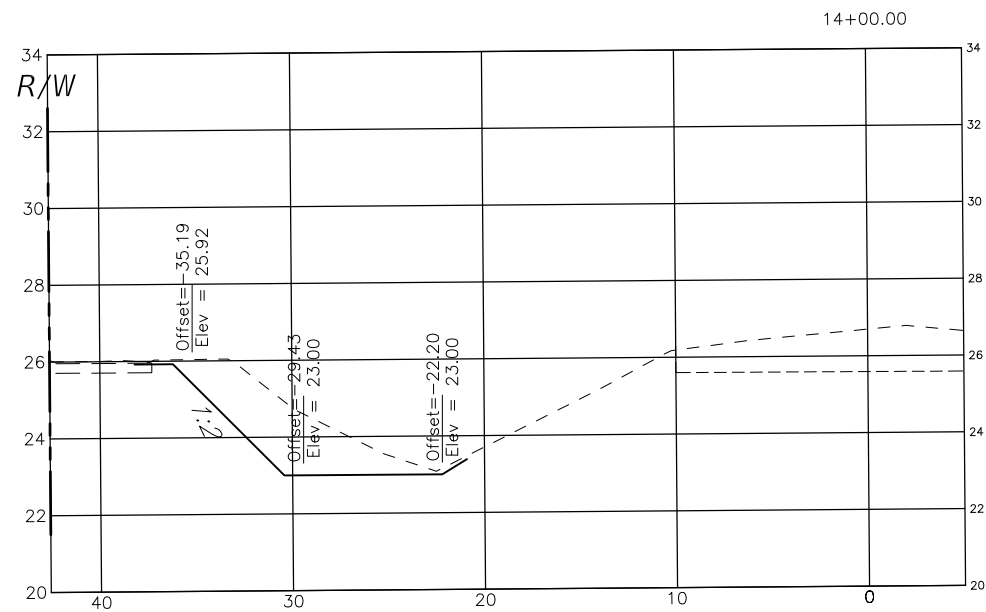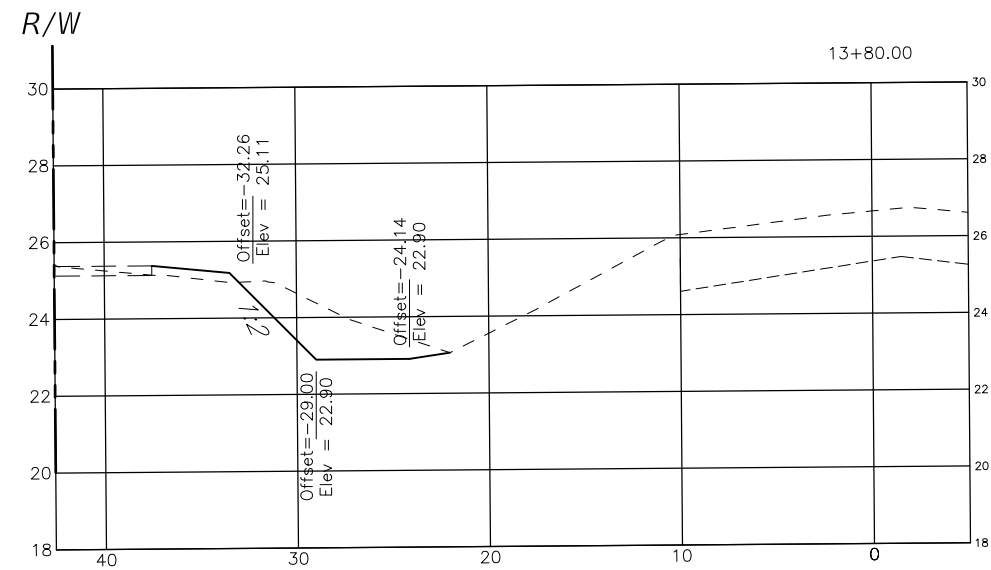
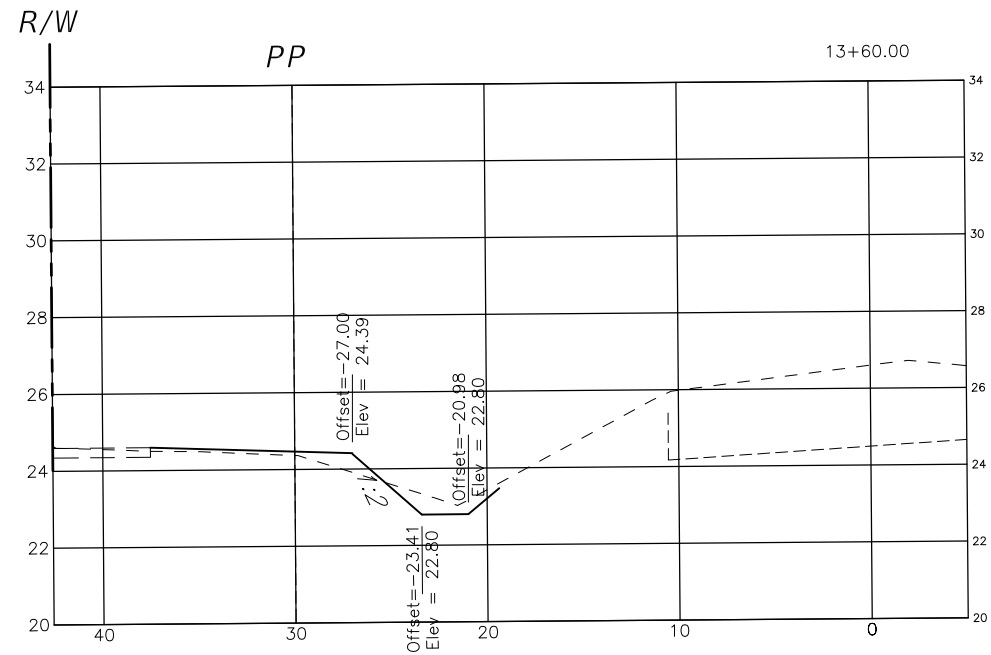


1" = 10' Horizontal  
1" = 5' Vertical

DATE	DESCRIPTION	DATE	PROJECT #	----	SURVEYED	MCPM	06/2018	FLORIDA P.E. # 76896 GRIGORY BERIKHMAN  Signature & Date	 PUBLIC WORKS DEPARTMENT ENGINEERING SERVICES 1022 26th Avenue East, Bradenton, FL 34208	WHITFIELD AVENUE PLAN AND PROFILE XSECT STA 13+60 TO 14+20	SHEET NO. 17
			SURVEY #	N/A	DESIGNED	JEA/SF	06/2018				
			SEC./TWN./RGE	35/35/20	DRAWN	JEA	06/2018				
			SCALE		CHECKED	SF	06/2018				




H:\Highway Engineering\PROJECTS\Whitfield Ave At Railroad Crossing\DWG\Production Drawings\WHITEFIELD\_RR\_PP.DWG    Nov 4 19 9:46 AM

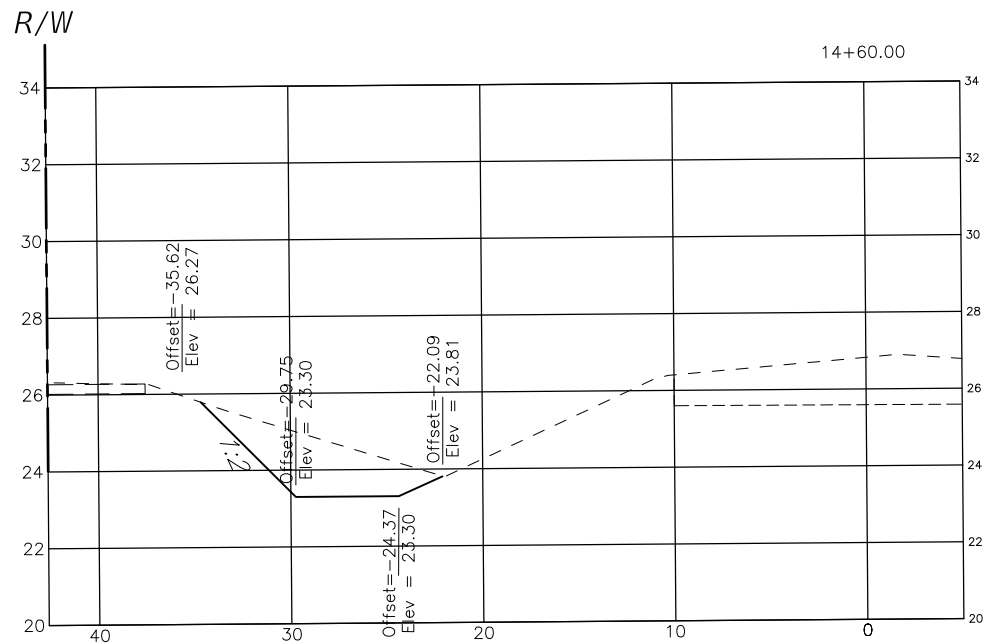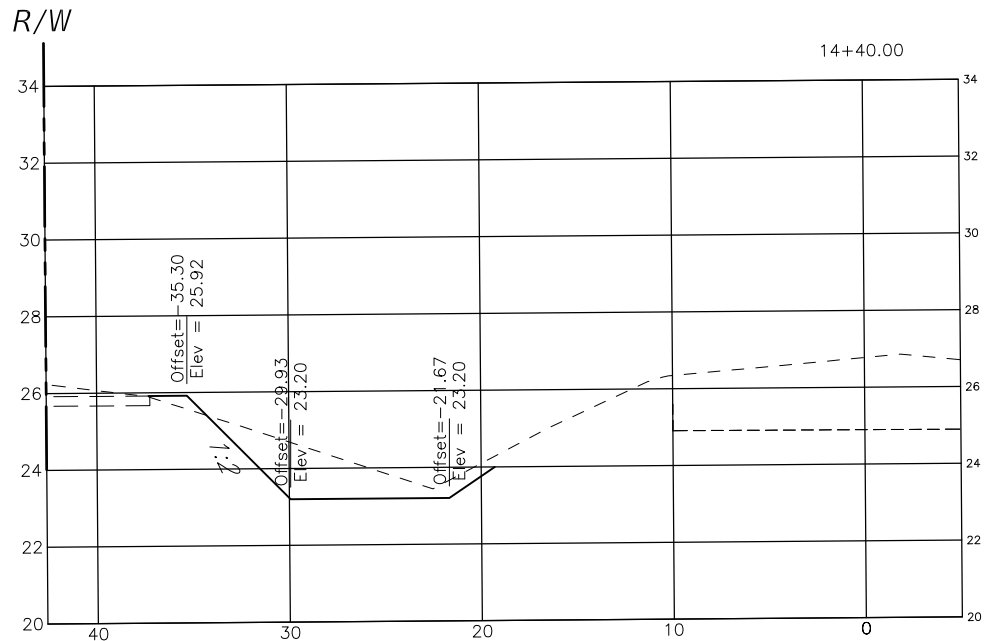

1" = 10' Horizontal  
1" = 5' Vertical

Hwy Highway Engineer	DATE		DESCRIPTION		DATE	PROJECT #				----	SURVEYED	MCPM	06/2018	FLORIDA P.E. # 76896 GRIGORY BERIKHMAN  Signature & Date	 PUBLIC WORKS DEPARTMENT ENGINEERING SERVICES 1022 26th Avenue East, Bradenton, FL 34208	WHITFIELD AVENUE PLAN AND PROFILE XSECT STA 14+40 TO 15+00	SHEET NO. 18
						SURVEY #				N/A	DESIGNED	JEA/SF	06/2018				
						SEC./TWN./RGE				35/35/20	DRAWN	JEA	06/2018				
						SCALE					CHECKED	SF	06/2018				


\\bcccad.myanatee.org\p\dwg\Engineering\Share\Highway Engineering\PROJ\ROADS\Whitfield Ave at Railroad Crossing\DWG\Production Drawings\WHITFIELD RR ECS.dwg [11/11/2019 7:20 AM]

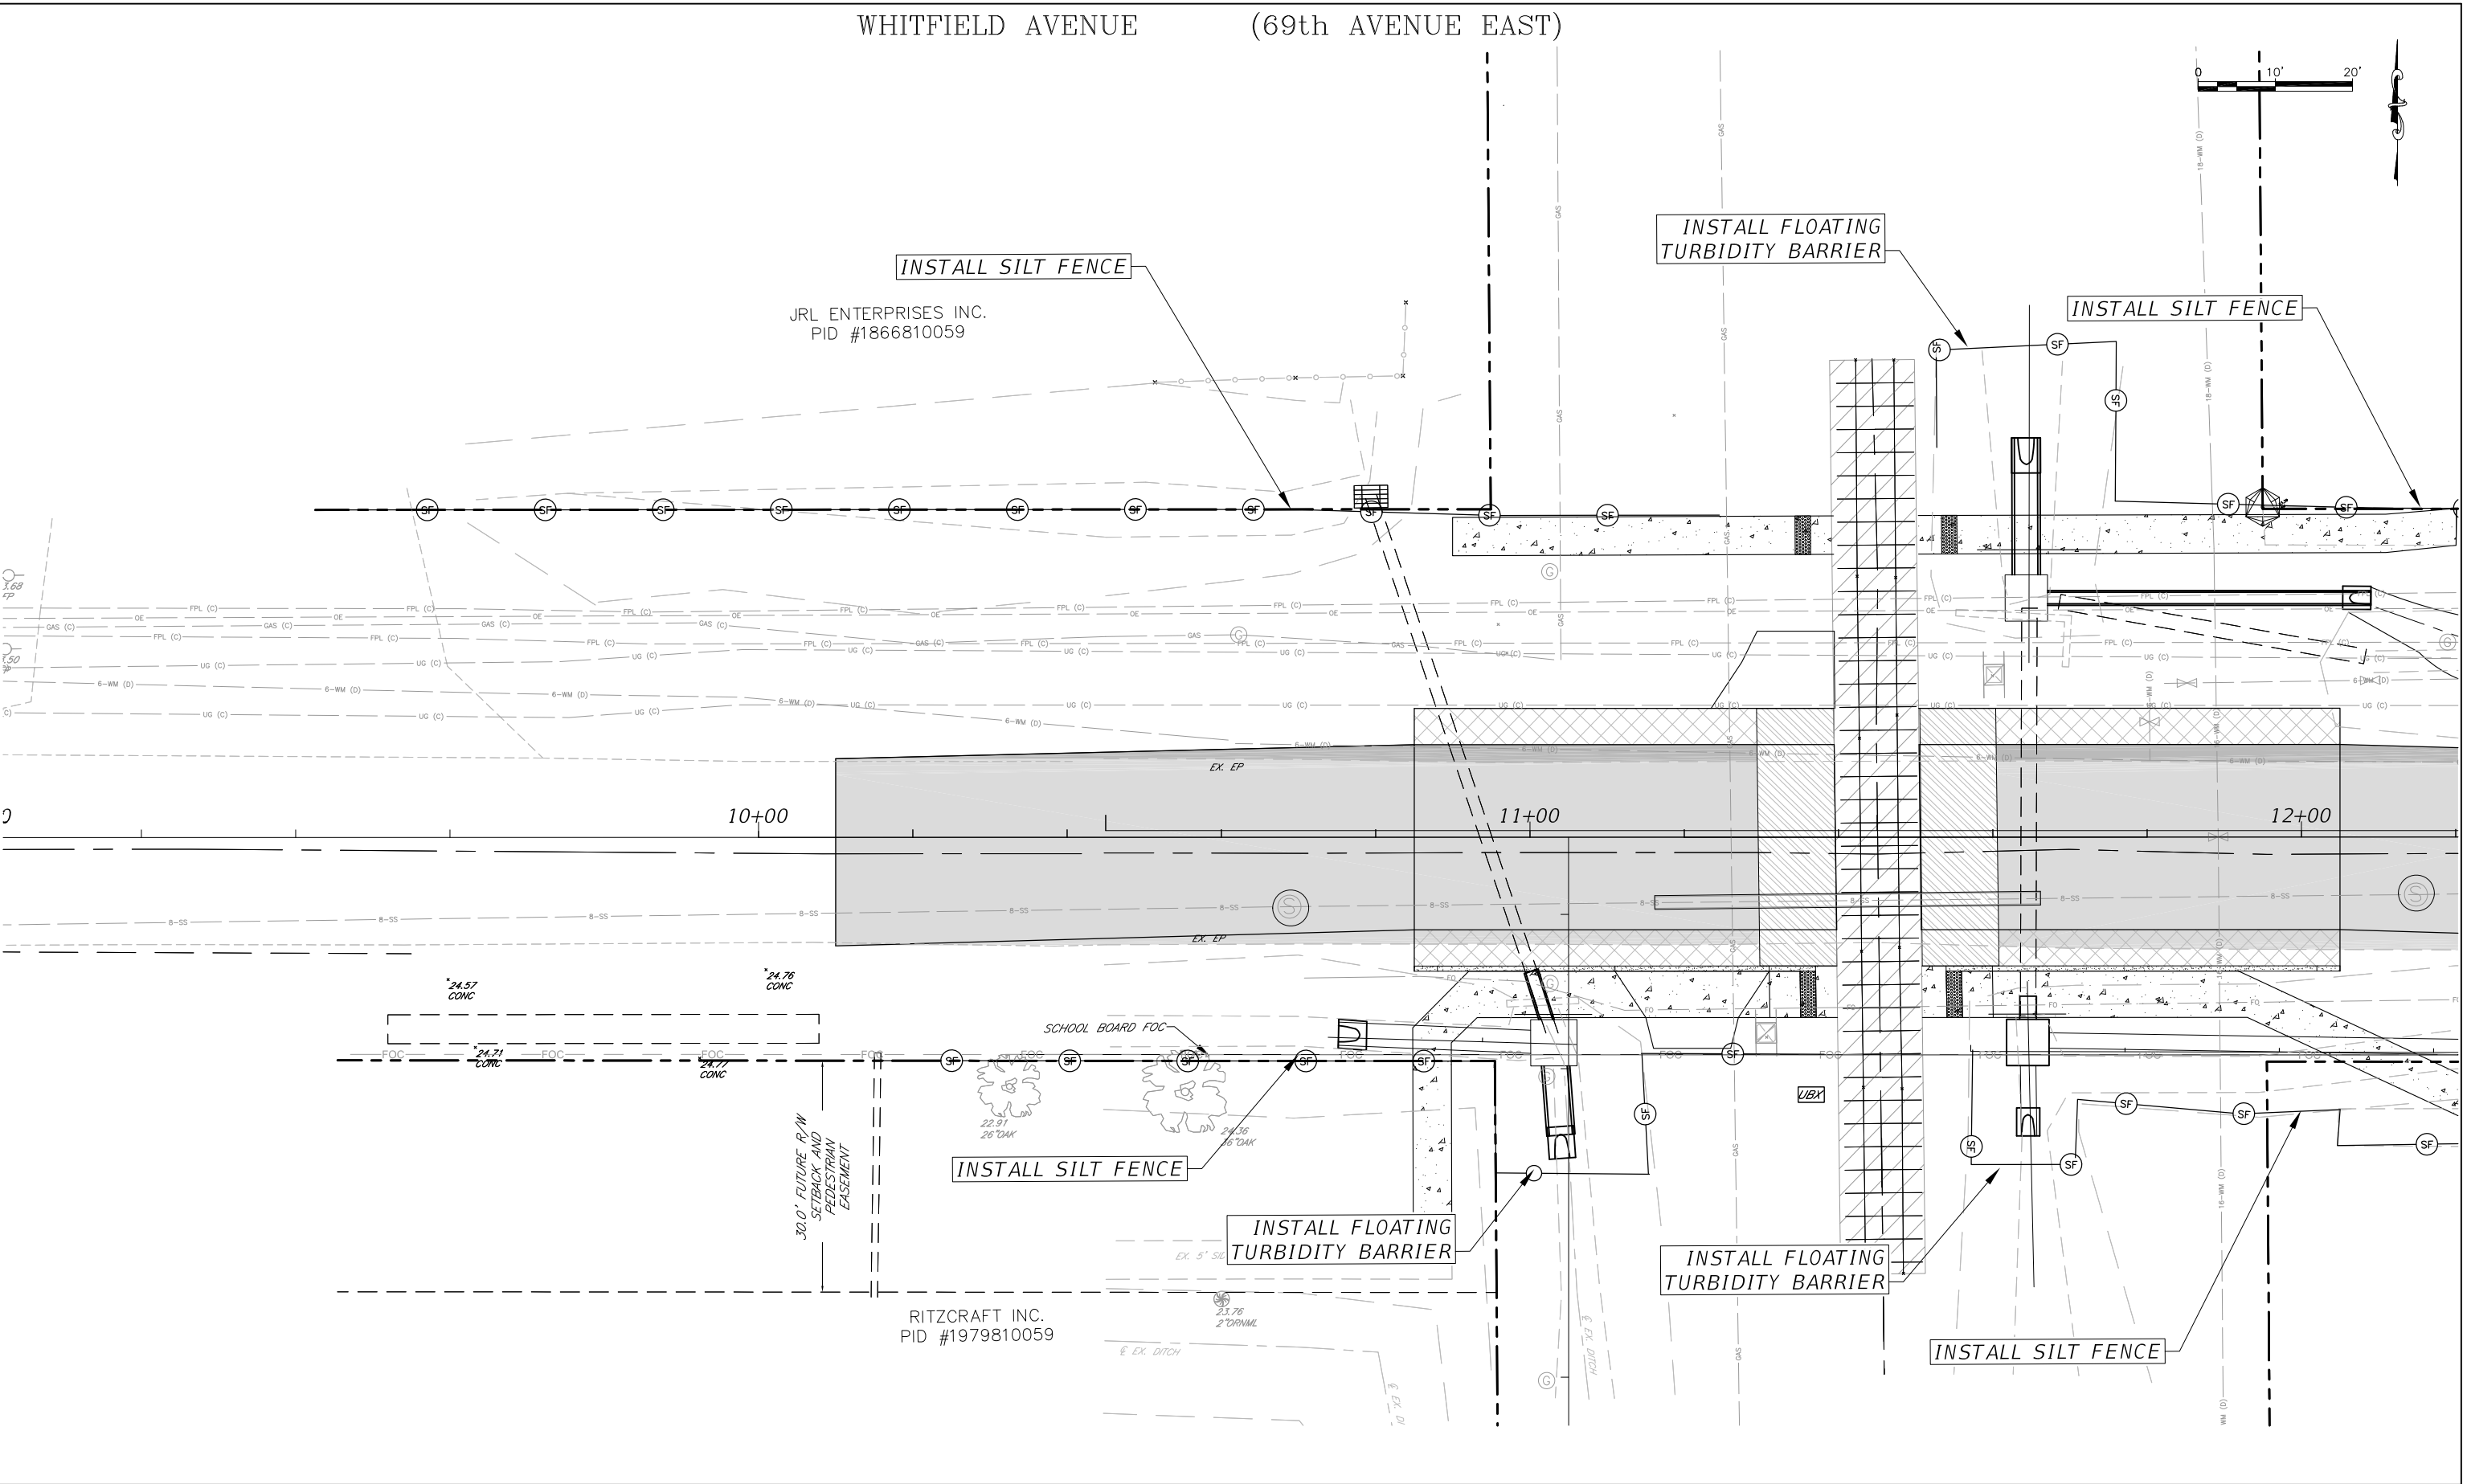

REVISION	DESCRIPTION	DATE	PROJECT #	307-6098560	SURVEYED	ZNS	02/2019
1	ADDITIONAL STRUCTURE IN NE QUADRANT	08/07/19	SURVEY #	0577-0036	DESIGNED	GB	02/2019
			SEC./TWN./RGE	19 & 30/35S/18E	DRAWN	KHL	02/2019
			SCALE	1"=20'	CHECKED	XXX	XX/XXXX

GRIGORY BERIKHMAN, P.E.  
FLORIDA P.E. # 76896

Signature & Date




**Manatee County**  
FLORIDA

**PUBLIC WORKS DEPARTMENT**  
**ENGINEERING SERVICES**  
1022 26th Avenue East, Bradenton, FL 34208

**WHITFIELD AVENUE**  
**AT SEMINOLE GULF COAST RAILROAD**  
**EROSION CONTROL PLAN**


SHEET NO.  
19


WHITFIELD AVENUE (69th AVENUE EAST)

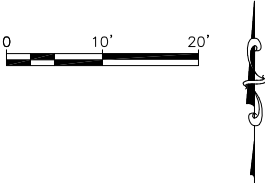


SIDEWALK PROPERTIES 2 LLC.  
PID #1868700004


INSTALL SILT FENCE

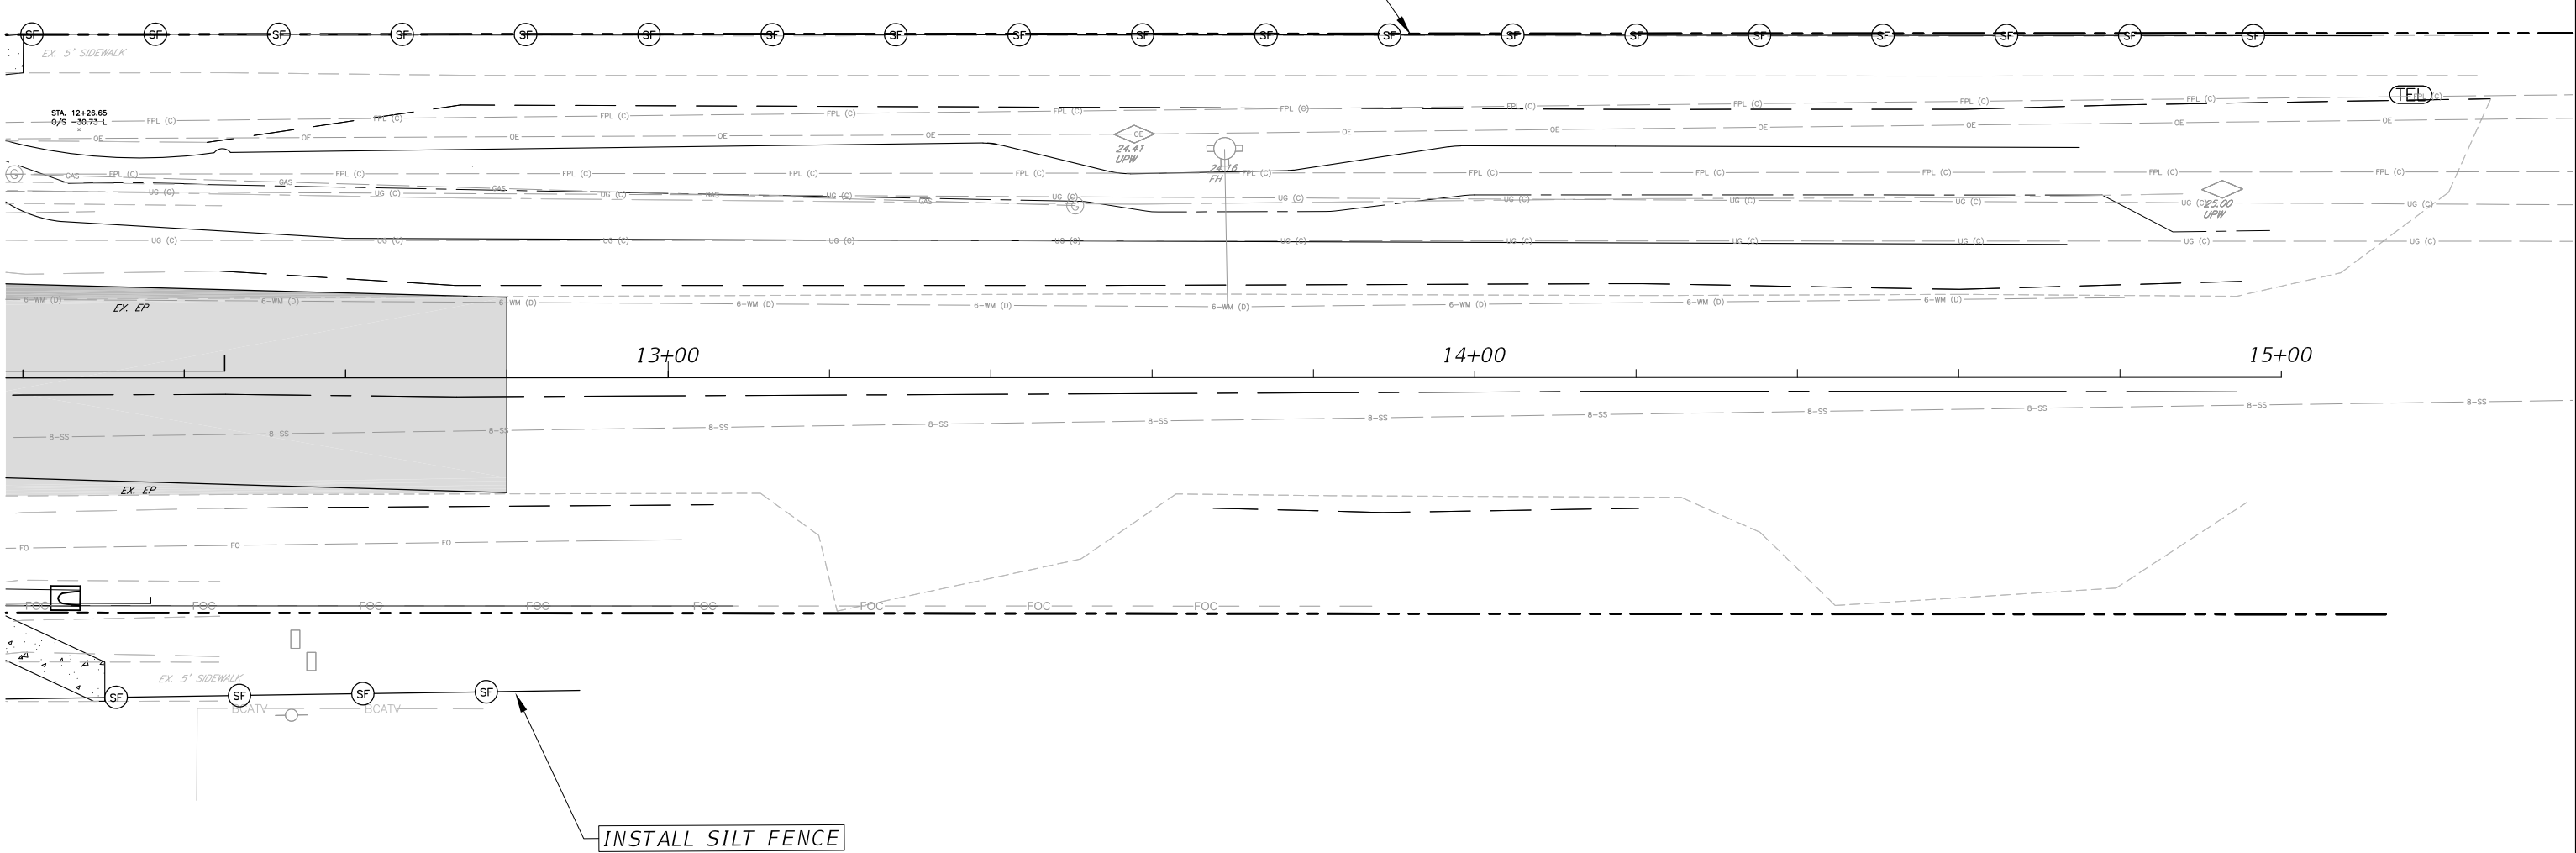


REVISION	DESCRIPTION	DATE	PROJECT #	307-6098560	SURVEYED	ZNS	02/2019	GRIGORY BERIKHMAN, P.E. FLORIDA P.E. # 76896	 PUBLIC WORKS DEPARTMENT ENGINEERING SERVICES 1022 26th Avenue East, Bradenton, FL 34208	WHITFIELD AVENUE AT SEMINOLE GULF COAST RAILROAD EROSION CONTROL PLAN	SHEET NO. 20
1	ADDITIONAL STRUCTURE IN NE QUADRANT	08/07/19	SURVEY #	0577-0036	DESIGNED	GB	02/2019				
			SEC./TWN./RGE	19 & 30/35S/18E	DRAWN	KHL	02/2019				
			SCALE	1"=20'	CHECKED	XXX	XX/XXXX				
								Signature & Date			

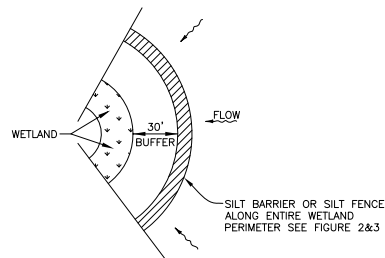


WETLAND BUFFER  
FIGURE 1

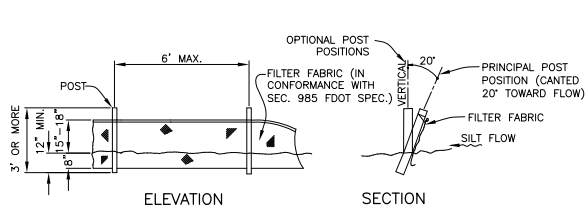


TYPICAL SILT FENCE  
FIGURE 2

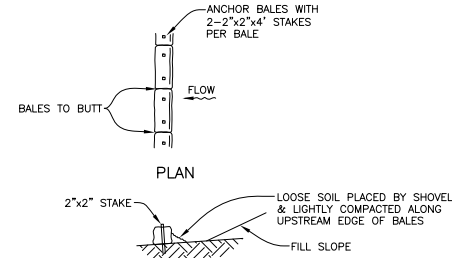


TYPICAL BALE SILT BARRIER  
FIGURE 3

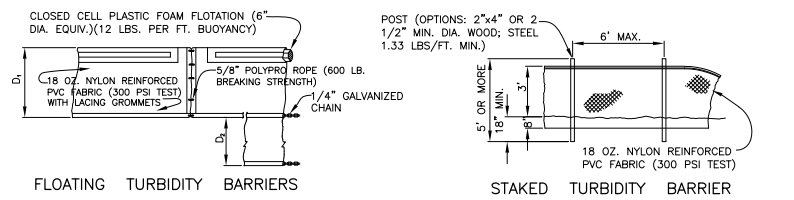


TURBIDITY BARRIERS  
FIGURE 4

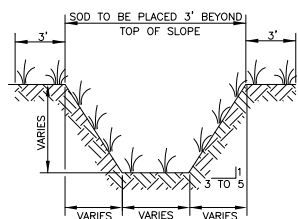


TYPICAL SWALE SECTION  
FIGURE 5

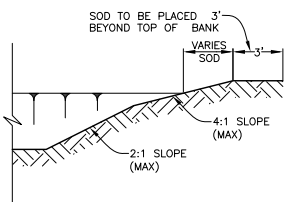

TYPICAL RETENTION/DETENTION POND SECTION  
FIGURE 6

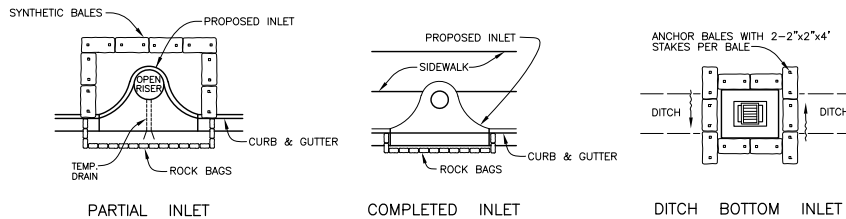


SYNTHETIC BALE PROTECTION AROUND  
INLETS OR SIMILAR STRUCTURES  
FIGURE 7

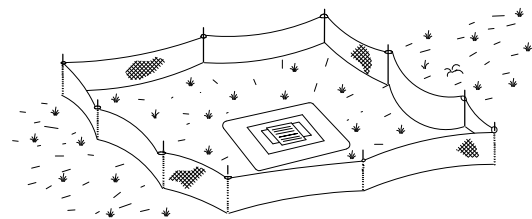


TYPE III SILT FENCE PROTECTION  
AROUND DITCH BOTTOM INLETS


STAKED SILT BARRIER OR SILT FENCE  
PROTECTION AROUND DITCH BOTTOM INLETS  
FIGURE 8

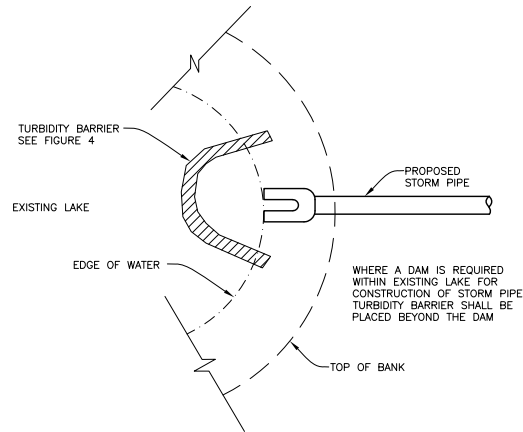


TURBIDITY BARRIER AT CONNECTION OF  
STORM PIPE TO EXISTING LAKE  
FIGURE 9

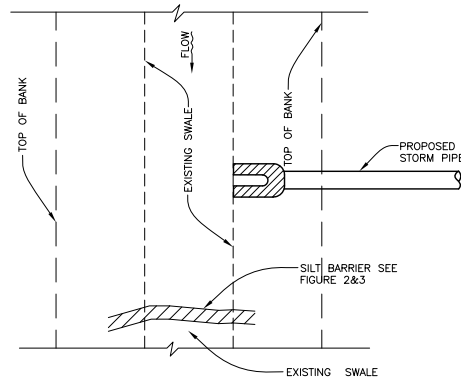


SILT BARRIER AT CONNECTION OF  
STORM PIPE TO EXISTING SWALE  
FIGURE 10

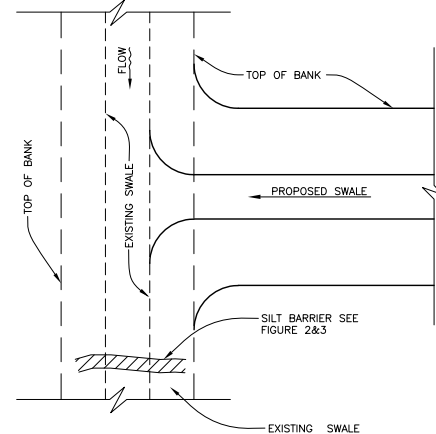


SILT BARRIER AT CONNECTION OF  
SWALE TO EXISTING SWALE  
FIGURE 11

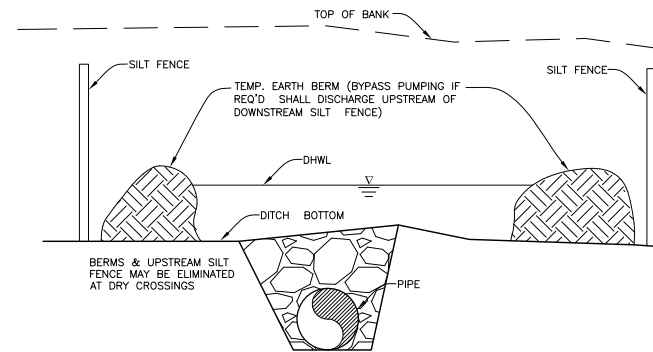


UNDERGROUND PIPE CROSSING  
FIGURE 12

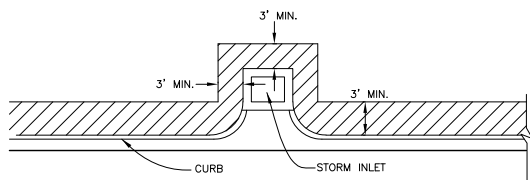


SOD ALONG CURB  
AND AROUND INLET  
FIGURE 14

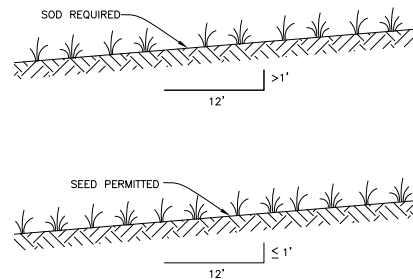

GRASS SLOPES  
FIGURE 13

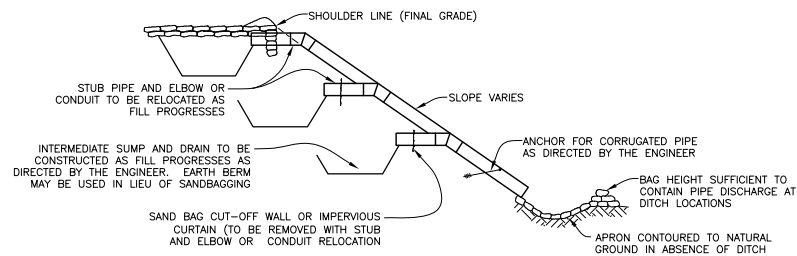


SECTION AA  
TEMPORARY SLOPE DRAIN  
FIGURE 15

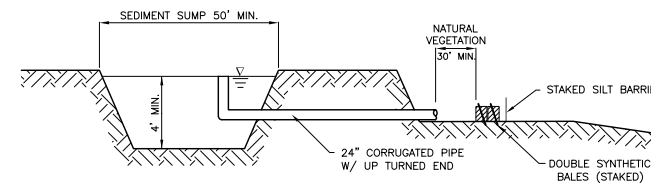

SEDIMENT SUMP SECTION  
FIGURE 16

NOTE:  
REFERENCE THE FDOT DESIGN STANDARDS  
LATEST EDITION FOR ALL TEMPORARY  
EROSION CONTROL MEASURES.


H:\Highway Engineering\PROJ\ROADS\Whitfield Ave at Railroad Crossing\DWG\Production Drawings\Whitfield RR Crossing COVER.dwg [11/11/2019 7:20 AM]


								GRIGORY BERIKHMAN, P.E. FLORIDA P.E. # 76896	 <div>PUBLIC WORKS DEPARTMENT ENGINEERING SERVICES 1022 26th Avenue East, Bradenton, FL 34208</div>	WHITFIELD AVENUE AT SEMINOLE GULF COAST RAILROAD EROSION CONTROL DETAILS	SHEET NO. 21
REVISION	DESCRIPTION	DATE	PROJECT #	307-6098560	SURVEYED	ZNS	02/2019				
1	ADDITIONAL STRUCTURE ON NE QUADRANT	08/07/19	SURVEY #	0577-0036	DESIGNED	GB	02/2019				
			SEC./TWN./RGE	19 & 30/35S/18E	DRAWN	KHL	02/2019				
			SCALE	1"=20'	CHECKED	XXX	XX/XXXX				
Signature & Date											





H:\Highway Engineering\PRO\NR0405\Whitfield Ave at Railroad Crossing\DWG\Production Drawings\Whitfield RR Crossing COVER.dwg [11/11/2019 7:21 AM]


GENERAL NOTES									
1. ALL REFERENCED STANDARDS SHALL BE LATEST REVISION.									
2. CONCRETE SHALL BE CLASS "I" AS SPECIFIED IN SECTION 345 OF F.D.O.T. SPECIFICATIONS									
3. SEE SECTION 425-2.2 "MORTAR" OF FLORIDA D.O.T. SPECIFICATIONS.									
4. IRON CASTING SHALL BE AS SPECIFIED IN SECTION 962-8 OF F.D.O.T. SPECIFICATIONS. SEE SECTION 425-5.									
5. ALL REINFORCEMENT STEEL SHALL BE AS SPECIFIED IN SECTIONS 415 & 931.1 OF F.D.O.T. SPECIFICATIONS.									
6. SEE FLORIDA D.O.T. SPECIFICATIONS FOR GRATINGS.									
7. SEE FLORIDA D.O.T. SPECIFICATIONS FOR SECTION 125 "EXCAVATION FOR STRUCTURES."									
8. PRECAST TOP AND BOTTOM TO BE F.D.O.T. STANDARDS WITH MINIMUM TRAFFIC BEARING 8" THICKNESS.									
9. ALL STORMWATER PIPE SHALL BE INSTALLED BEHIND THE CURB OR EDGE OF PAVEMENT AND WITHIN THE RIGHT OF WAY AND WITHIN THE DRAINAGE EASEMENTS.									
10. THE FOLLOWING IS THE DRAINAGE STRUCTURE WALL MINIMUM THICKNESS:									
<u>PRECAST</u>				<u>BLOCK</u>					
NON-TRAFFIC 6"				8" EITHER WAY					
NOTE: FOR DRAINAGE STRUCTURES WITH PIPE DIAMETERS UP TO AND INCLUDING 24", 6" PRECAST WALLS ARE ACCEPTABLE FOR TRAFFIC BEARING.									
DIMENSION INDEX									
PIPE SIZE	TYPE	"C"	"D"	"E"	"F"	"G"	"H"		
15"	RCP	2'8"	4'	5'	4'	5'4"	6'4"		
12"x18"	RCP	"	"	"	"	"	"		
18"	RCP	"	"	"	"	"	"		
14"x23"	RCP	"	"	"	"	"	"		
24"	RCP	3'4"	4'8"	5'8"	"	"	"		
19"x30"	RCP	4'	5'4"	6'4"	"	"	"		
30"	RCP	"	"	"	"	"	"		
24"x38"	RCP	5'	6'4"	7'4"	"	"	"		
36"	RCP	5'	6'4"	"	"	"	"		
66"	RCP	8'5"	9'9"	10'9"	4'8"	6'0"	7'0"		
MANATEE COUNTY FLORIDA				DRAINAGE CONTROL SHEET				202.0	
REV. BY	DATE	6/12/07		DATE OF B.O.C.C. APPROVAL					

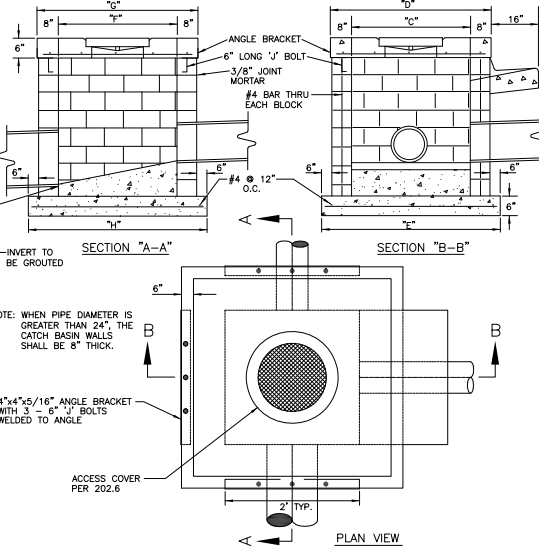	
NOTE: WHEN PIPE DIAMETER IS GREATER THAN 24", THE CATCH BASIN WALLS SHALL BE 8" THICK.	
NOTE: DIMENSIONS PER SECTION 202.0	
A) THE FOLLOWING MATERIALS TO BE AS SPECIFIED IN THE FLORIDA D.O.T. SPEC'S. 1991, SECTION 346 CONCRETE, SECT. 962-8 IRON CASTING, SECT. 931-1 REINFORCEMENT STEEL, SECT. 425 INLETS, MANHOLES & JUNCTION BOXES.	
B) FILL BLOCKS WITH 3,000 PSI CONCRETE, USE #4 ROD IN EACH BLOCK, 16" O/C.	
C) 2" MINIMUM COVER ON ALL REBAR.	
D) USE #4 REBARS ON 6" CENTERS BOTH WAYS ON LID; NO.4 REBARS ON 12" CENTERS BOTH WAYS ON FLOOR SLAB.	
E) SEE SHEET 202.0 FOR GENERAL NOTES AND DIMENSION INDEX.	
F) ALL EXPOSED CORNERS AND EDGES TO BE CHAMFERED 3/4".	
G) PRECAST BOXES AS SPECIFIED IN F.D.O.T. ROADWAY AND TRAFFIC DESIGN STANDARDS (2000) ARE AN ACCEPTABLE ALTERNATIVE AS APPROVED BY THE TRANSPORTATION DIRECTOR OR HIS DESIGNEE.	
H) ALL PIPE ENTRIES TO CATCH BASIN TO BE GROUTED AND SEALED.	
MANATEE COUNTY	FLORIDA
REV. BY	DATE
	6/12/07
	DATE OF B.O.C.C. APPROVAL
TYPICAL CONC. BLOCK BOX	
202.1	

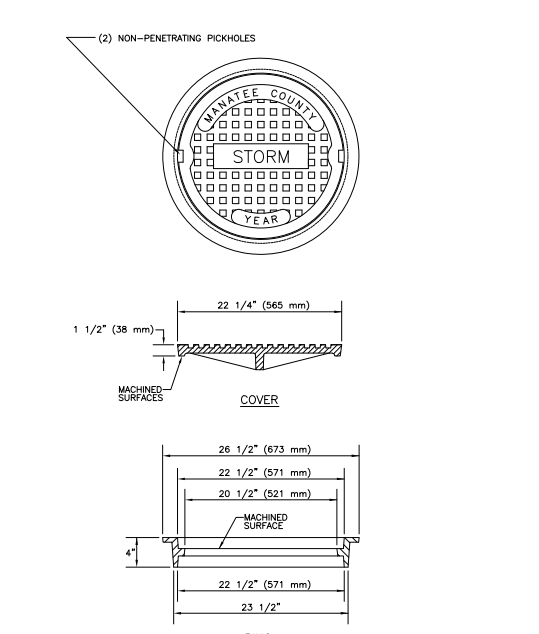
	
USF 1110 RING & PROPOSED COVER	
NOTE:	
1 - MATERIAL: ASTM-A48 CLASS 30B GRAY IRON.	
2 - COVER WEIGHT: 105 LBS. APPROX.	
3 - RING WEIGHT: 90 LBS. APPROX.	
MANATEE COUNTY	FLORIDA
REV. BY	DATE
	6/12/07
	DATE OF B.O.C.C. APPROVAL
ACCESS COVER FOR STORMWATER JUNCTION BOX (PUBLIC)	
203.1	

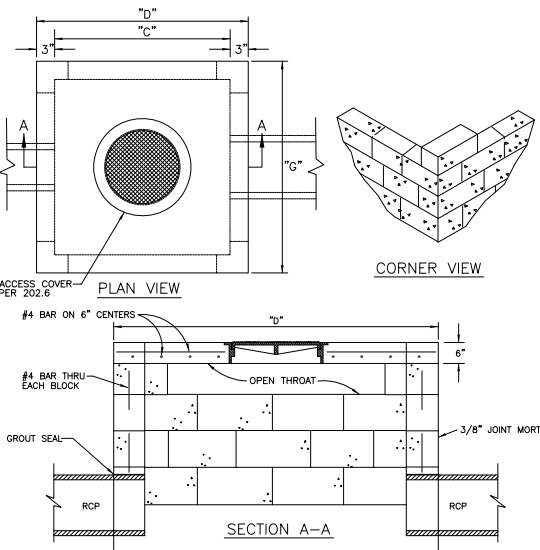
	
A) DROP INLET IS NOT DESIGNED TO BE SUBJECTED TO VEHICULAR TRAFFIC.	
B) NUMBER OF SIDES OPEN FOR DRAINAGE DEPENDS UPON FLOW VOLUME REQUIREMENTS.	
C) THE FOLLOWING MATERIALS SHALL BE AS SPECIFIED IN FLORIDA D.O.T. SPEC'S., 2000. SEC 346 CONCRETE, SEC 962-8 IRON CASTING, SEC 931-1 REINFORCED STEEL.	
D) FILL BLOCKS WITH 3,000 P.S.I. CONCRETE (EACH CELL), USE #4 ROD IN EACH BLOCK, 16" O/C.	
E) USE #4 ROD ON 6" CENTERS BOTH WAYS ON LID.	
F) SEE SHEET # 202.0 GENERAL NOTES AND DIMENSIONS INDEX, ALSO SHEET 202.1 TYP. CONC. BOX.	
G) PRECAST BOXES TO F.D.O.T. SPECIFICATIONS ARE AN ACCEPTABLE ALTERNATE.	
H) INVERT TO BE GROUTED (SEE 202.1).	
I) PRECAST BOXES AS SPECIFIED IN F.D.O.T. ROADWAY AND TRAFFIC DESIGN STANDARDS ARE AN ACCEPTABLE ALTERNATIVE AS APPROVED BY THE TRANSPORTATION DIRECTOR OR HIS DESIGNEE.	
J) ANGLE BRACKETS SHOWN ON 202.1 NOT REQUIRED.	
MANATEE COUNTY	FLORIDA
REV. BY	DATE
	6/12/07
	DATE OF B.O.C.C. APPROVAL
THROAT DETAIL FOR DROP INLET	
202.3	

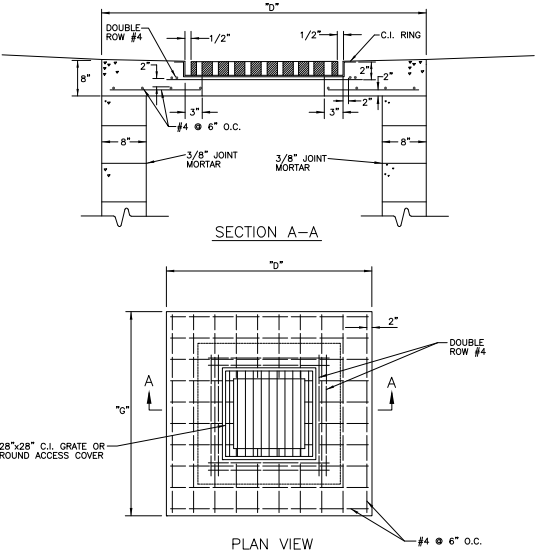
	
NOTE: DIMENSIONS "D" & "O" PER SECTION 202.0	
A) ALTERNATE C.I. GRATES, 18"x 24", 24"x 24", 28"x 36" OR ACCESS COVER (202.6).	
B) 8" TRAFFIC BEARING LID W/ REINFORCING C.I. RING & DOUBLE ROW OF #4 REBAR.	
C) FOLLOWING MATERIALS ARE SPECIFIED IN FLORIDA D.O.T. SPEC'S., 2000. SEC 346 CONCRETE, SEC 962-8 IRON CASTING, SEC 931-1 REINFORCED STEEL.	
D) FILL BLOCKS WITH 3,000 P.S.I. CONCRETE (EACH CELL), USE #4 ROD IN EACH BLOCK, 16" O/C.	
E) USE #4 ROD ON 6" CENTERS BOTH WAYS ON LID. (SEE 202.3 E)	
F) SEE SHEET # 202.0 GENERAL NOTES AND DIMENSIONS INDEX, ALSO SHEET 202.1 TYP. CONC. BOX.	
G) INVERT TO BE GROUTED (SEE 202.1).	
H) PRECAST BOXES AS SPECIFIED IN F.D.O.T. ROADWAY AND TRAFFIC DESIGN STANDARDS ARE AN ACCEPTABLE ALTERNATIVE AS APPROVED BY THE TRANSPORTATION DIRECTOR OR HIS DESIGNEE.	
I) ANGLE BRACKETS SHOWN ON 202.1 NOT REQUIRED.	
MANATEE COUNTY	FLORIDA
REV. BY	DATE
	6/12/07
	DATE OF B.O.C.C. APPROVAL
TRAFFIC BEARING BOX LID	
202.5	

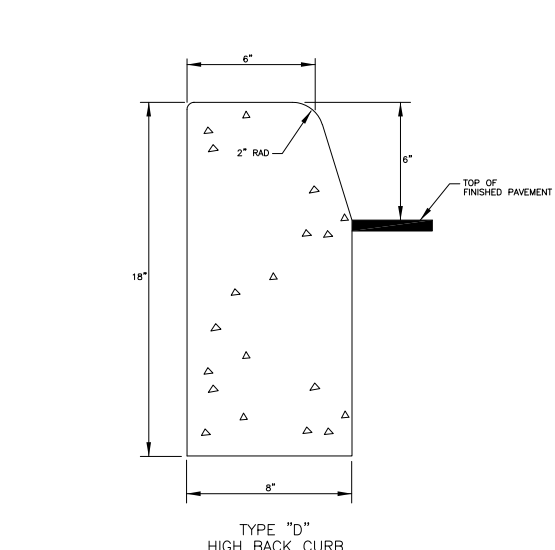
	
TYPE "D" HIGH BACK CURB	
A) CLASS 1 CONCRETE, 3,000 P.S.I. AT 28 DAYS.	
B) CURB SHALL MEET THE SPECIFICATIONS ESTABLISHED BY F.D.O.T. STANDARD SPECIFICATIONS PER F.D.O.T. ROADWAY AND TRAFFIC DESIGN STANDARDS INDEX NO. 300, LATEST REVISION.	
MANATEE COUNTY	TRANSPORTATION DEPARTMENT
REV. BY	DATE
	6/12/07
	DATE OF B.O.C.C. APPROVAL
TYPE D CURB	
201.4	




<p>GENERAL NOTES</p> <p>1. SIDEWALK SHALL BE CONSTRUCTED A MINIMUM OF 4" THICK, USING 3000 PSI CONCRETE. WHERE SIDEWALK BISECTS A DRIVEWAY, THE MINIMUM SHALL BE 6" OF CLASS I CONCRETE REINFORCED WITH 6"x6" #10 WIRE MESH.</p> <p>* SEE SHEETS #101.2 &amp; 101.3.</p> <p>2. ALL SIDEWALKS SHALL BE CONSTRUCTED TO THE SPECIFICATIONS OF THE MANATEE COUNTY LAND DEVELOPMENT CODE, SECTION 722. A MINIMUM (5) FOOT WIDE SIDEWALK SHALL BE INSTALLED ALONG THE NORTH AND WEST SIDES OF ALL NEW LOCAL STREETS WHICH ARE CONSTRUCTED IN CONJUNCTION WITH A NEW RESIDENTIAL DEVELOPMENT. A SIDEWALK A MINIMUM OF (5) FEET IN WIDTH SHALL BE INSTALLED ON BOTH SIDES OF ALL THOROUGHFARES. REFER TO F.D.O.T. ROADWAY AND TRAFFIC STANDARDS, LATEST REVISION FOR CURB CUT RAMP SPECIFICATIONS.</p> <p>3. THE CONCRETE SHALL BE GIVEN A BROOM FINISH. THE SURFACE VARIATIONS SHALL NOT BE MORE THAN 1/4" UNDER A TEN FOOT STRAIGHTEDGE, NOR MORE THAN 1/8" ON A FIVE-FOOT TRAVERSE SECTION. THE EDGE OF THE SIDEWALK SHALL BE CAREFULLY FINISHED WITH AN EDGING TOOL HAVING A RADIUS OF 1/2".</p> <p>4. EXPANSION JOINT: EXPANSION JOINTS BETWEEN THE SIDEWALKS AND THE CURB OR DRIVEWAY OR AT FIXED OBJECTS AND SIDEWALK INTERSECTIONS SHALL BE 1/2" MATERIAL SHALL MEET THE REQUIREMENTS OF AASHTO M153 OR AASHTO M213. FOR LONG POORS, AN EXPANSION JOINT SHALL BE PLACED AT INTERVALS NOT TO EXCEED 120'.</p> <p>5. CONTRACTION JOINTS:</p> <p>OPEN TYPE JOINTS</p> <p>OPEN TYPE CONTRACTION JOINTS SHALL BE FORMED BY STAKING A METAL BULKHEAD IN PLACE AND DEPOSITING THE CONCRETE ON BOTH SIDES. AFTER THE CONCRETE HAS SET SUFFICIENTLY TO PRESERVE THE WIDTH AND THE SHAPE OF THE JOINT, THE BULKHEAD SHALL BE REMOVED. AFTER THE SIDEWALK HAS BEEN FINISHED OVER THE JOINT, THE SLOT SHALL BE FINISHED WITH A TOOL HAVING A 1/2" RADIUS.</p> <p>SAWED JOINTS</p> <p>A SLOT APPROXIMATELY 3/16" WIDE AND NOT LESS THAN 1" DEEP AT 10' CENTERS SHALL BE CUT WITH A CONCRETE SAW AFTER THE CONCRETE HAS SET.</p> <p>6. SIDEWALKS ALONG OTHER STREETS SHALL BE CONSTRUCTED AND DEDICATED AS REQUIRED BY THE APPROVING AUTHORITY WHEN NECESSARY TO CONTINUE AN EXISTING OR PROPOSED SIDEWALK.</p> <p>7. HANDICAP RAMPS SHALL MEET FLORIDA ACCESSIBILITIES STANDARDS, AND SECTIONS 301.0, 301.1 AND 301.2.</p> <p>8. ALL SIDEWALKS ON R/W WITHIN 10' OF AN EXISTING OR PROPOSED TREE THAT WILL EXCEED 6" IN DIAMETER AT MATURITY SHALL BE 5" THICK AND CONTAIN 2-#3 REBAR CENTERED VERTICALLY AND SPACED 3' ON CENTER. PALMS ARE NOT CONSIDERED TREES.</p> <p>*NOTE: FOR COMPLETE SIDEWALK DETAILS, SEE F.D.O.T. DESIGN STANDARDS, 2006 EDITION, INDEX 304, SHEETS 1 THROUGH 6 AND INDEX 310, SHEETS 1 &amp; 2.</p>	
MANATEE COUNTY	FLORIDA
REV. BY	DATE
	6/12/07
	DATE OF B.O.C.C. APPROVAL
SIDEWALKS GENERAL NOTES	
301.0	

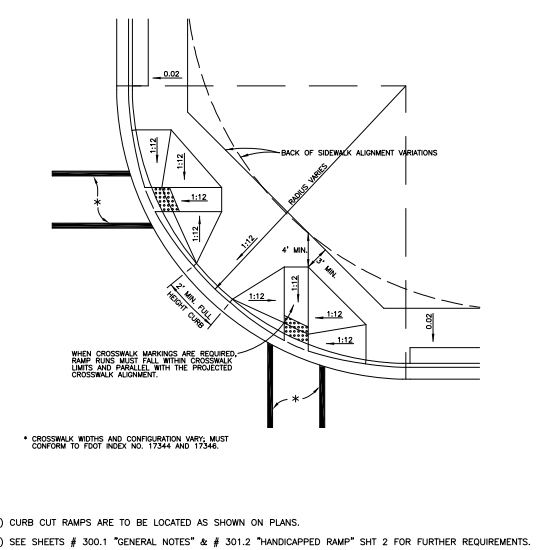	
* CROSSWALK WIDTHS AND CONFIGURATION VARY; MUST CONFORM TO FOOT INDEX NO. 17344 AND 17346.	
1) CURB CUT RAMPS ARE TO BE LOCATED AS SHOWN ON PLANS.	
2) SEE SHEETS # 300.1 "GENERAL NOTES" & # 301.2 "HANDICAPPED RAMP" SHT 2 FOR FURTHER REQUIREMENTS.	
3) RADIUS OF CURB VARIES AS FOLLOWS:	
A) 25' RAD. LOCAL STREET WITH ALLEY.	
B) 25' RAD. LOCAL STREET WITH LOCAL STREET.	
C) 35' RAD. LOCAL STREET WITH THOROUGHFARE OR COLLECTOR.	
D) 50' RAD. THOROUGHFARE WITH THOROUGHFARE	
4) CURB RADIUS SHOULD BE A MINIMUM OF 50' WHERE INDUSTRIAL AND BUS TRAFFIC (5% OR MORE) IS ANTICIPATED ON LOWER CLASSIFICATION ROADWAYS.	
5) BOTH LOCATION OPTIONS FOR HANDICAPPED RAMP ARE SHOWN. ENGINEER MAY SELECT EITHER, WHICHEVER FITS THE SITUATION.	
NOTE: FOR COMPLETE HANDICAP, PUBLIC SIDEWALK AND CURB RAMP DETAILS, SEE F.D.O.T. DESIGN STANDARDS, 2006 EDITION, INDEX 304, SHEETS 1 THROUGH 6.	
MANATEE COUNTY	FLORIDA
REV. BY	DATE
	6/12/07
	DATE OF B.O.C.C. APPROVAL
HANDICAPPED RAMP SHEET 1	
302.1	

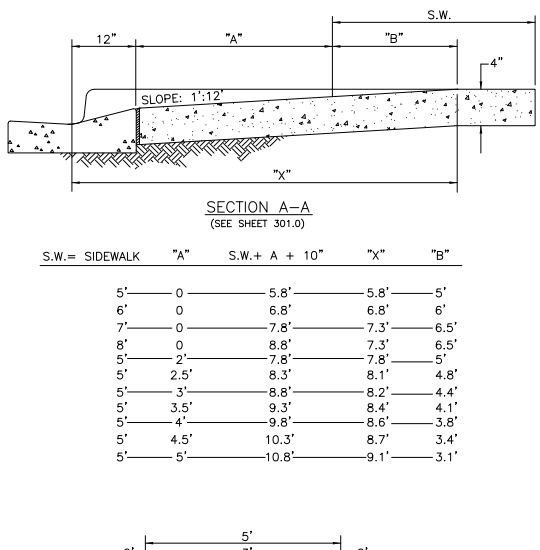	
NOTE: FOR COMPLETE HANDICAP, PUBLIC SIDEWALK AND CURB RAMP DETAILS, SEE F.D.O.T. DESIGN STANDARDS, 2006 EDITION, INDEX 304, SHEETS 1 THROUGH 6.	
MANATEE COUNTY	FLORIDA
REV. BY	DATE
	6/12/07
	DATE OF B.O.C.C. APPROVAL
HANDICAPPED RAMP SHEET 2	
302.2	

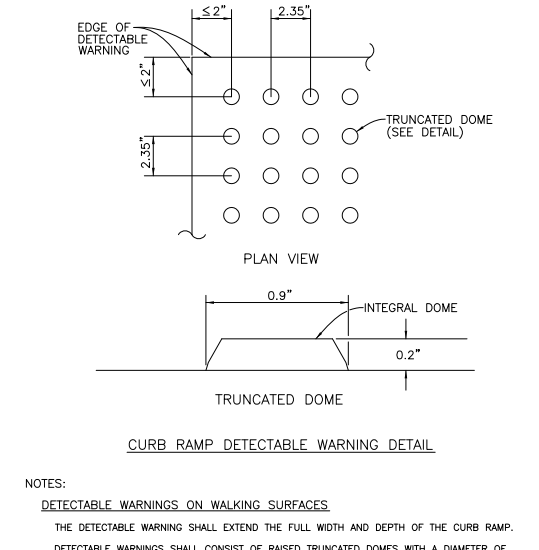	
NOTE: FOR COMPLETE HANDICAP, PUBLIC SIDEWALK AND CURB RAMP DETAILS, SEE F.D.O.T. DESIGN STANDARDS, 2006 EDITION, INDEX 304, SHEETS 1 THROUGH 6.	
NOTE: THE DETECTABLE WARNING SHALL EXTEND THE FULL WIDTH AND DEPTH OF THE CURB RAMP. DETECTABLE WARNINGS SHALL CONSIST OF RAISED TRUNCATED DOMES WITH A DIAMETER OF NOMINAL 0.9 INCH, A HEIGHT OF NOMINAL 0.2 INCH AND A CENTER-TO-CENTER SPACING OF NOMINAL 2.35 INCH AND SHALL CONTRAST VISUALLY WITH ADJOINING SURFACES, EITHER LIGHT-ON-DARK, OR DARK-ON-LIGHT.	
THE MATERIAL USED TO PROVIDE CONTRAST SHALL BE AN INTEGRAL PART OF THE WALKING SURFACE. DETECTABLE WARNINGS USED ON INTERIOR SURFACES SHALL DIFFER FROM ADJOINING WALKING SURFACES IN RESILIENCY OR SOUND-ON-CANE CONTACT.	
THE MATERIAL USED TO PROVIDE CONTRAST SHOULD CONTRAST BY AT LEAST 70%. CONTRAST IN PERCENT IS DETERMINED BY:	
CONTRAST = [(B1-B2)/B1] x 100	
WHERE B1 = LIGHT REFLECTANCE VALUE (LRV) OF THE LIGHTER AREA AND B2 = LIGHT REFLECTANCE VALUE (LRV) OF THE DARKER AREA	
NOTE THAT IN ANY APPLICATION BOTH WHITE AND BLACK ARE NEVER ABSOLUTE; THUS, B1 NEVER EQUALS 100 AND B2 IS ALWAYS GREATER THAN 0.	
MANATEE COUNTY	FLORIDA
REV. BY	DATE
	6/12/07
	DATE OF B.O.C.C. APPROVAL
CURB RAMP DETECTABLE WARNINGS	
302.3	

REVISION		DESCRIPTION	DATE	PROJECT #	307-6098560	SURVEYED	ZNS	02/2019	GRIGORY BERIKHMAN, P.E. FLORIDA P.E. # 76896	 PUBLIC WORKS DEPARTMENT ENGINEERING SERVICES 1022 26th Avenue East, Bradenton, FL 34208	WHITFIELD AVENUE AT SEMINOLE GULF COAST RAILROAD GENERAL DETAILS 1	SHEET NO. 22
1		ADDITIONAL STRUCTURE ON NE QUADRANT	08/07/19	SURVEY #	0577-0036	DESIGNED	GB	02/2019				
				SEC./TWN./RGE	19 & 30/35S/18E	DRAWN	KHL	02/2019				
				SCALE	1"=20'	CHECKED	XXX	XX/XXXX				
								Signature & Date				

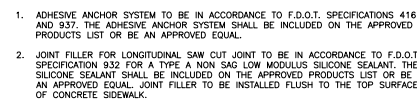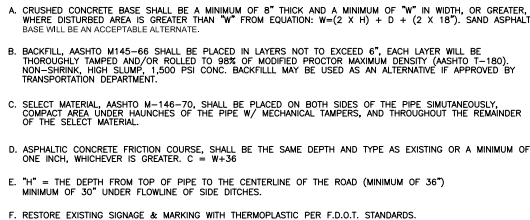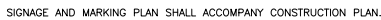AND QUANTITIES

DIMENSIONS	Q.	QUANTITIES
------------	----	------------

TOP VIEW—SINGLE PIPE

SINGL

TOP VIEW—SINGLE PIPE

07

SOD TO BE PLACED 1.5 FT AROUND THE PERIMETER OF THE WALL, SOD TO BE BAHIA; ST. AUGUSTINE SOD WHERE THERE IS TIDAL, HEAVY CONCENTRATION OF SALT, OR SURROUNDING PROPERTY IS ST. AUGUSTINE.


2/07MANATEE COUNTY


6/12/07

SINGL07

	6/12/07
--	---------


SHEET NO.  
23

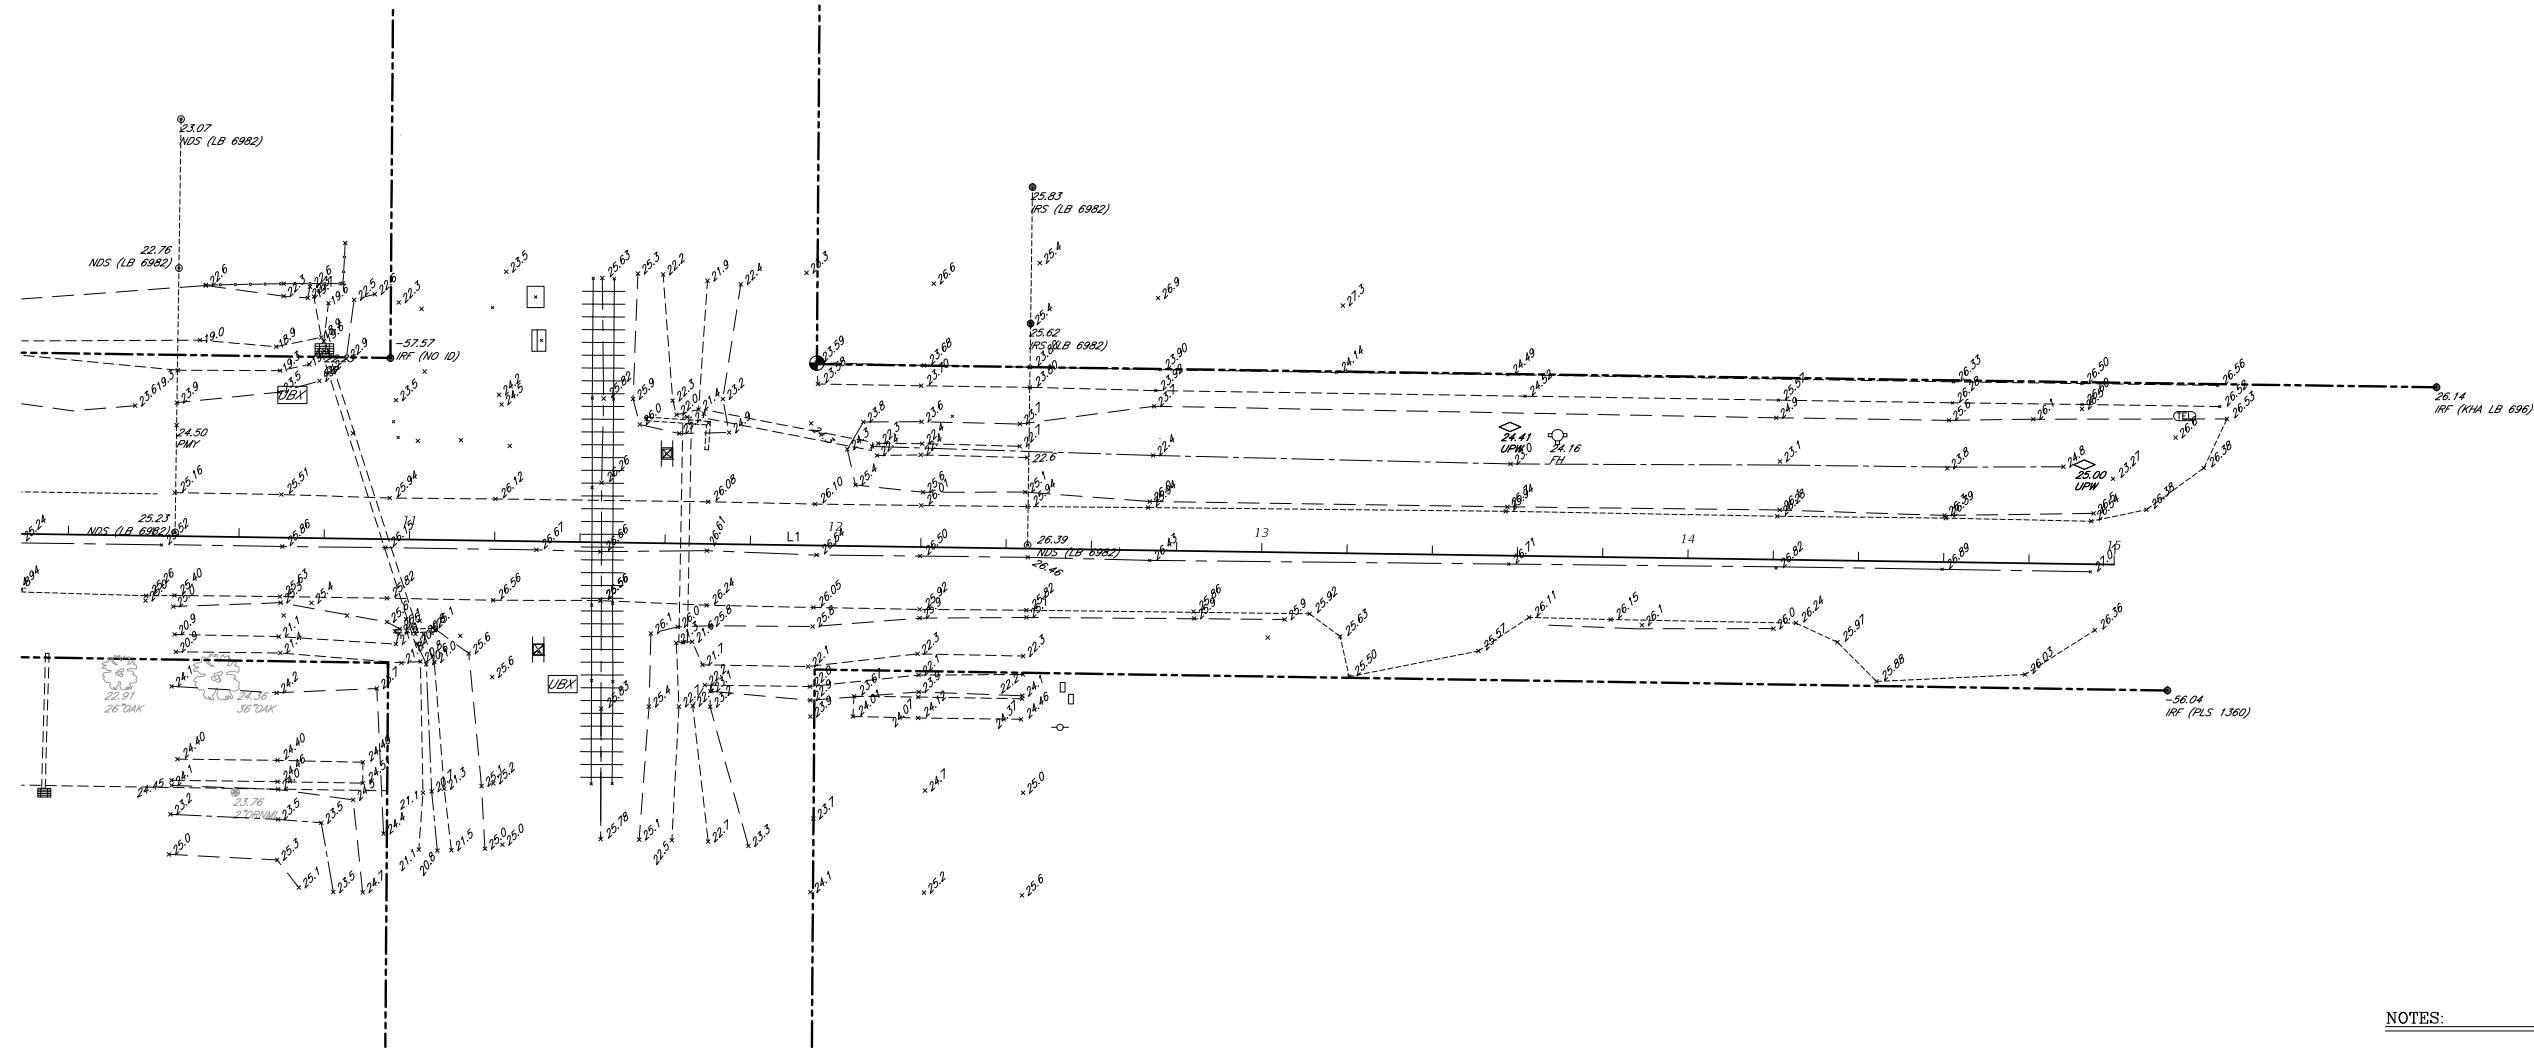

- LEGEND:**
- ⊙ - NAIL & DISK FOUND/SET (AS NOTED)
  - - IRON ROD FOUND/SET (AS NOTED)
  - - 4" x 4" CONCRETE MONUMENT FOUND (AS NOTED)
  - ⊕ - BENCH MARK
  - R/W - RIGHT OF WAY
  - CMF - CONCRETE MONUMENT FOUND
  - IRF - IRON ROD FOUND
  - LB - LICENSED BUSINESS
  - PCP - PERMANENT CONTROL POINT
  - REF. - REFERENCE
  - (P) - PLAT DATA
  - (F) - FIELD DATA
  - STA. - STATION
  - L.T. - LEFT
  - COL. - COLUMN
  - CONC. - CONCRETE
  - WS - WATER SPIGOT
  - COL. - COLUMN
  - GTE - TELEPHONE
  - CATV - CABLE TELEVISION
  - WW - WET WELL
  - LS - SANITARY VAULT
  - TRANS. - TRANSFORMER
  - EM - ELECTRIC METER
  - VZ - VERIZON
  - PVC - POLYVINYL CHLORIDE (PIPE)
  - PMG - SEWER
  - EL - ELEVATION
  - INV. - INVERT
  - RCF - REINFORCED CONCRETE (PIPE)
  - DIA - DIAMETER
  - INV. - INVERT
  - IRR - IRRIGATION

- WM - WATER VALVE
- WM - WATER METER
- BFP - BACK FLOW PREVENTOR
- TELECOM - TELECOMMUNICATION
- PJM - PALM TREE W/SIZE & QUALITY
- OK - OAK TREE W/SIZE & QUALITY
- HIC - HICKORY TREE W/SIZE & QUALITY
- ORMTL - ORNAMENTAL TREE W/SIZE & QUALITY
- FM - FORCE MAIN
- FM - FM AIR RELEASE VALVE
- SDJ - STORM DRAIN JUNCTION BOX
- SM - SANITARY SEWER MANHOLE
- FOC - FIBER OPTICAL CABLE
- HH - HANDHOLE
- UB - UTILITY BOX
- WM - WATER METER
- WM - WATER VALVE
- WM - BACK FLOW PREVENTOR
- ANT - ANTENNA
- LP - LIGHT POLE
- GA - GUY ANCHOR/POLE
- ELU - ELECTRIC/UTILITY POLE
- S - SIGN

- - SANITARY SEWER PIPE
- - STORM WATER PIPE
- - OVERHEAD ELECTRIC/UTILITY LINES

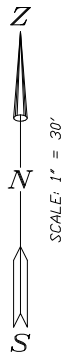

**NOTES:**

- BEARINGS ARE BASED ON THE SOUTH RIGHT-OF-WAY LINE OF WHITFIELD AVENUE, HAVING A BEARING OF S 89°08'41" E AND RELATED TO THE FLORIDA STATE PLANE COORDINATE SYSTEM (WEST ZONE) NAD 83/2011 AND WERE DERIVED USING REAL TIME KINEMATIC METHOD AND THE FLORIDA DEPARTMENT OF TRANSPORTATION PERMANENT REFERENCE NETWORK. THE PUBLISHED VALUES OF WALTON (OPUS PID 001577) AND MANATEE COUNTY (117-88-11) WERE USED TO VALIDATE THE PROJECT.
- IMPROVEMENTS SUCH AS, BUT NOT LIMITED TO, FOUNDATIONS, SUBSURFACE IMPROVEMENTS AND LANDSCAPE FEATURES, ETC., HAVE NOT BEEN LOCATED EXCEPT AS SHOWN.
- THE PROPERTY LIES WITHIN FLOOD ZONE, "X" (OTHER AREAS) AS SHOWN ON FLOOD INSURANCE RATE MAP PANEL NO. 12081C0316E, MARCH 17, 2014.
- THIS SURVEY HAS BEEN PREPARED WITHOUT THE BENEFIT OF A CURRENT TITLE REPORT OR ABSTRACT AND THEREFORE DOES NOT NECESSARILY INDICATE ALL THE ENCUMBRANCES ON THE PROPERTY.
- ELEVATIONS ARE BASED ON N.A.V.D. 1988 DATUM, BENCH MARK "WALTON", ELEVATION 29.63 AS PUBLISHED.

**SPECIFIC PURPOSE SURVEY**  
OF  
**WHITFIELD AVENUE at**  
**SEABOARD COAST LINE RAILROAD**  
WORK #57 - PROJECT #6092960  
LOCATED IN  
SECTIONS 19 & 30, TOWNSHIP 35 SOUTH, RANGE 18 EAST  
MANATEE COUNTY, FLORIDA

NOTE: THIS SURVEY IS NOT VALID WITHOUT THE SIGNATURE AND ORIGINAL RAISED SEAL OF A FLORIDA LICENSED SURVEYOR AND MAPPER.

K:\Plot Files\Projects\MANATEE County\Whitfield RR Xing\Whitfield-RR--PAGE1.plt (.pdf)

**CERTIFICATE OF SURVEYOR**

I, THE UNDERSIGNED PROFESSIONAL SURVEYOR & MAPPER, HEREBY CERTIFY THAT THIS RECORD OF LAND SURVEY WAS PREPARED UNDER MY DIRECT SUPERVISION THAT TO THE BEST OF MY KNOWLEDGE, INFORMATION AND BELIEF IS A TRUE AND CORRECT REPRESENTATION OF THE LAND AS SHOWN AND DESCRIBED HEREON, AND THAT IT MEETS THE "STANDARDS OF PRACTICE FOR LAND SURVEYING IN THE STATE OF FLORIDA", CHAPTER 5J-17, OF THE FLORIDA ADMINISTRATIVE CODE.

FLORIDA CERTIFICATE No. PLS 4295  
DATE OF CERTIFICATION 10/03/2018  
DATE OF FIELD SURVEY 09/11/2018  
BY: J. N. Gatch, Jr., P.S.M.

**ZNS ENGINEERING**  
Land Planning & Surveying Landscape Architecture  
EP 0027476 LB 0006962 LC 0000365  
E-MAIL: ZNS@ZNSENGINEERING.COM OR ZNS@ZNSENGINEERING.COM FAX 941.746.0366

DRAWING: T:\MANATEE\Whitfield RR Xing\Whitfield-RR.dwg DATE FEBRUARY 2019 SCALE 1" = 20'  
DRAWN: bernie JOB NO. 00-44740 FIELD BOOK PAGE SHEET 1 OF 1

© ZNS ENGINEERING, L.C.  
THIS DOCUMENT IS PROTECTED BY SECTION 106 OF THE "UNITED STATES COPYRIGHT ACT". REPRODUCTION OR ALTERATION OF THIS DOCUMENT OR THE INFORMATION CONTAINED HEREON BY ANY MEANS WHATSOEVER IS STRICTLY PROHIBITED WITHOUT THE PRIOR WRITTEN CONSENT OF ZNS ENGINEERING, L.C. CONSENT IS HEREBY GRANTED SPECIFICALLY TO GOVERNMENTAL AGENCIES TO REPRODUCE THIS DOCUMENT IN COMPLIANCE WITH F.S. CHAPTER 119.