



No.	REVISIONS	DATE	BY	

Kimley» Horn

© 2016 KIMLEY-HORN AND ASSOCIATES, INC.
655 NORTH FRANKLIN STREET, SUITE 150, TAMPA, FL 33602
PHONE: 813-620-1460
WWW.KIMLEY-HORN.COM CA 00000696

KHA PROJECT 148400012	
DATE 2/17/2017	
SCALE AS SHOWN	
DESIGNED BY WWW	
DRAWN BY JRT	
CHECKED BY WEW	MANATEE COUNTY




LICENSED PROFESSIONAL	
W. WADE WOOD, P.E	
FL LICENSE NUMBER	


FL DATE:

IMPERIAL HOUSE SITE PLAN

GENERAL NOTES:

- 1. CONTRACTOR SHALL FIELD VERIFY EXISTING CONDITIONS PRIOR TO BEGINNING CONSTRUCTION AND ORDERING EQUIPMENT. CONTRACTOR SHALL NOTIFY ENGINEER OF DISCREPANCIES.
- 2. CONTRACTOR SHALL TAKE ALL PRECAUTIONARY MEASURES NECESSARY TO PROTECT EXISTING EQUIPMENT, UTILITIES, STRUCTURES, AND PERSONNEL FROM DAMAGE OR INJURY DURING CONSTRUCTION.
- 3. CONSTRUCTION SEQUENCE SHALL BE COORDINATED TO AVOID ANY FLOW INTERRUPTION.
- 4. ALL EXISTING MECHANICAL PIPING AND EQUIPMENT SHALL BE REMOVED AND SALVAGED PER SPECIFICATION 01030.
- 5. CONTRACTOR IS RESPONSIBLE FOR DISPOSAL OF DEMOLISHED MATERIAL. DISPOSAL SHALL BE IN ACCORDANCE WITH ALL LOCAL, STATE AND FEDERAL REGULATIONS.
- 6. CONTRACTOR TO FOLLOW SPECIFICATION 09900 BEFORE COATING THE EXISTING WET WELL AND VALVE VAULT.
- 7. REFER TO COUNTY STANDARDS FOR PUMP STATION REQUIREMENTS SHEET 47.

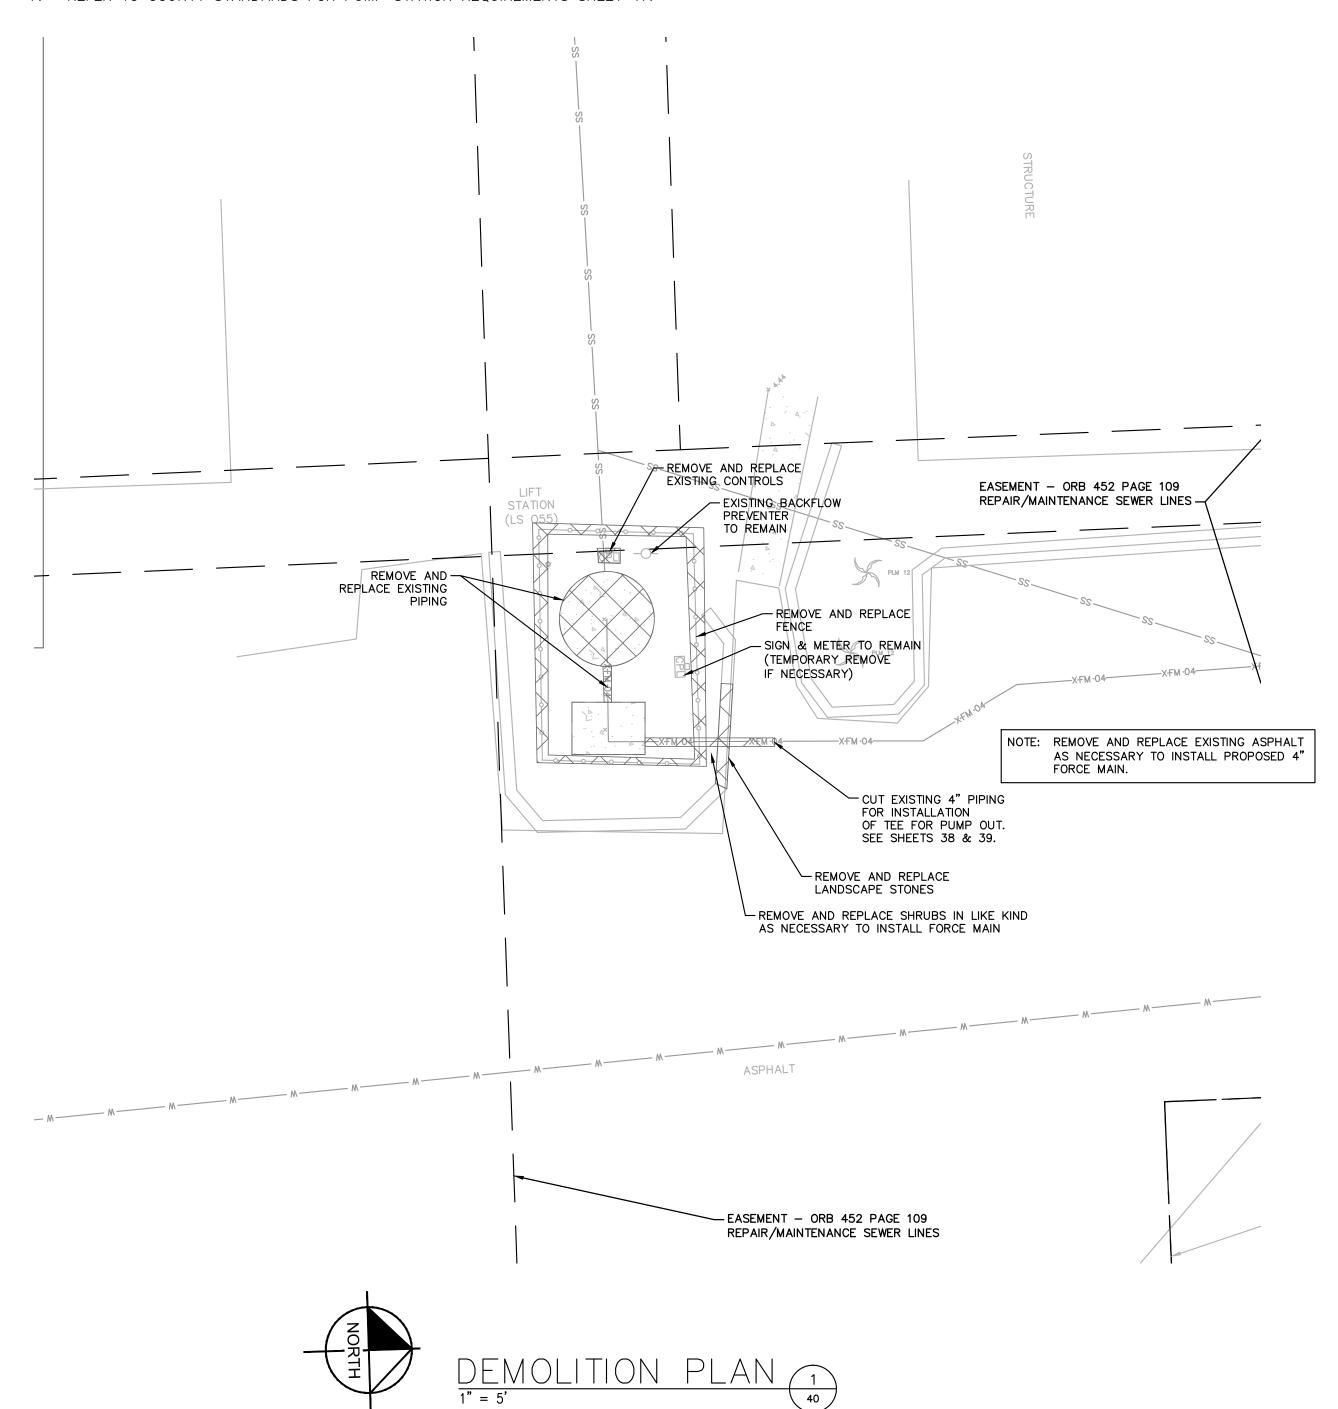

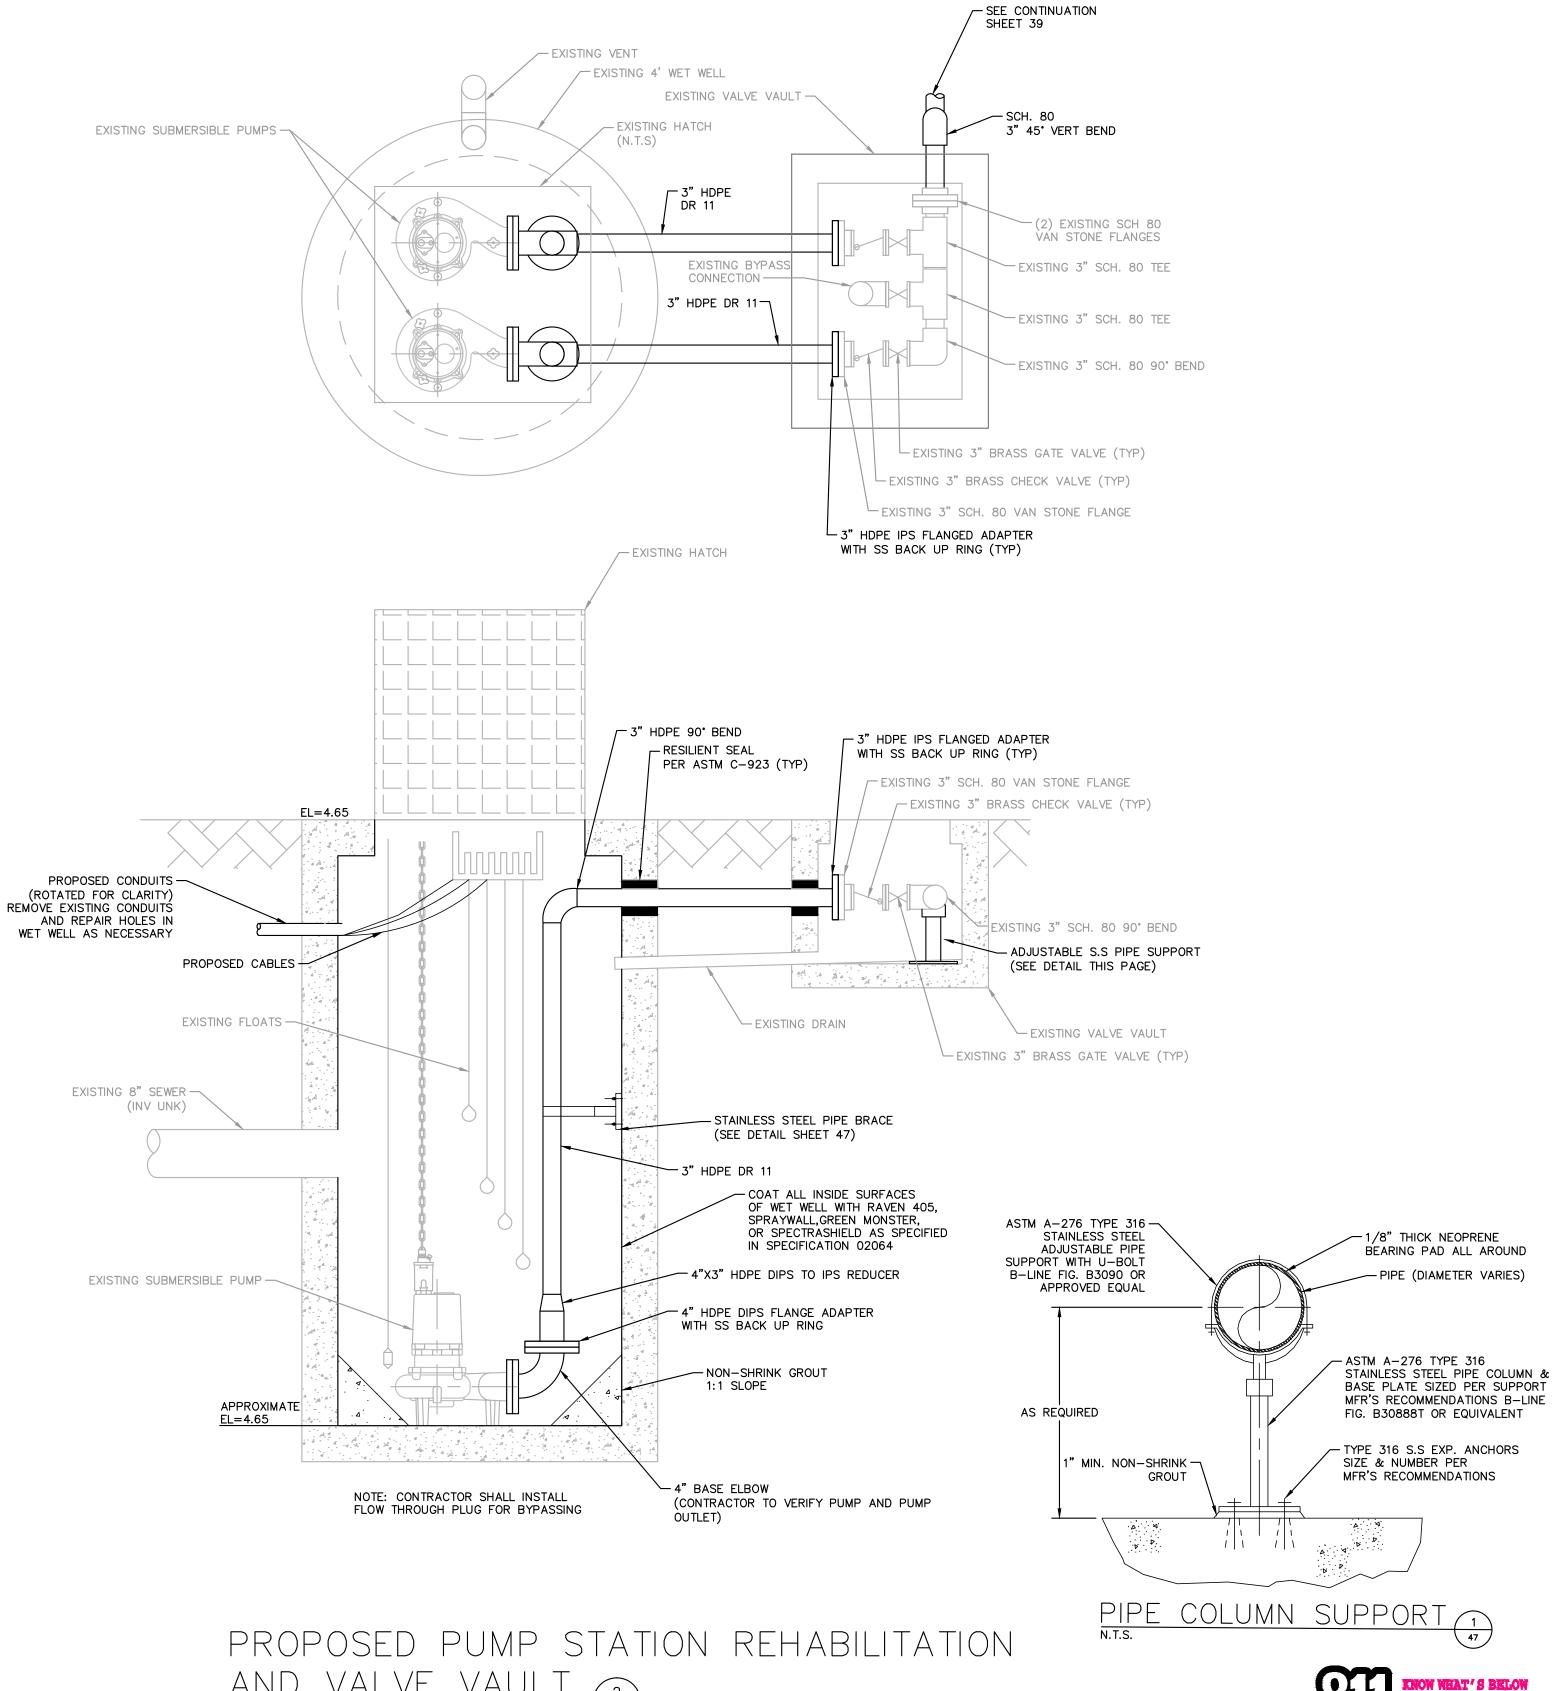

AND VALVE VAULT (2)



REVISIONS DATE BY

© 2016 KIMLEY-HORN AND ASSOCIATES, INC. 655 NORTH FRANKLIN STREET, SUITE 150, TAMPA, FL 33602 PHONE: 813-620-1460 WWW.KIMLEY-HORN.COM CA 00000696

KHA PROJECT 148400012 DATE 2/17/2017 SCALE AS SHOWN ESIGNED BY WWV



LICENSED PROFESSIONAL W. WADE WOOD, P.E FL LICENSE NUMBER 69051

IMERIAL HOUSE DEMOLITION & PROPOSED PLAN

SHEET NUMBER

40

sala akamani ENPARENT ANDRES INTRE Saa Sittle Will brawnies REDUCATION STATES PLENTIN WAS SEEN ON -PIPE RISER (NEVER CONSTRUCTED)

REVISIONS

DATE

EXISTING LIFT STATION 5 WET WELL SECTION


1/4" = 1' - 0"

Kimley» Horn

© 2016 KIMLEY-HORN AND ASSOCIATES, INC.

GENERAL NOTES:

- 1. CONTRACTOR SHALL FIELD VERIFY EXISTING CONDITIONS PRIOR TO BEGINNING CONSTRUCTION. CONTRACTOR SHALL NOTIFY ENGINEER OF DISCREPANCIES.
- 2. CONTRACTOR SHALL TAKE ALL PRECAUTIONARY MEASURES NECESSARY TO PROTECT EXISTING EQUIPMENT, UTILITIES, STRUCTURES, AND PERSONNEL FROM DAMAGE OR INJURY DURING CONSTRUCTION.
- 3. CONTRACTOR SHALL SUBMIT A CONSTRUCTION SEQUENCE SCHEDULE AS PART OF HIS SUBMITTALS FOR REVIEW AND APPROVAL FROM OWNER/ENGINEER TO MINIMIZE FLOW INTERRUPTIONS.
- 4. THE COUNTY RESERVES THE RIGHT FOR FIRST RIGHT OF REFUSAL. ANY TAGGED EQUIPMENT SHALL BE REMOVED AND STORED IN A SAFE PLACE PRIOR TO HANDING OVER TO THE COUNTY.
- 5. CONTRACTOR IS RESPONSIBLE FOR DISPOSAL OF DEMOLISHED MATERIAL. DISPOSAL SHALL BE IN ACCORDANCE WITH ALL LOCAL, STATE AND FEDERAL REGULATIONS.

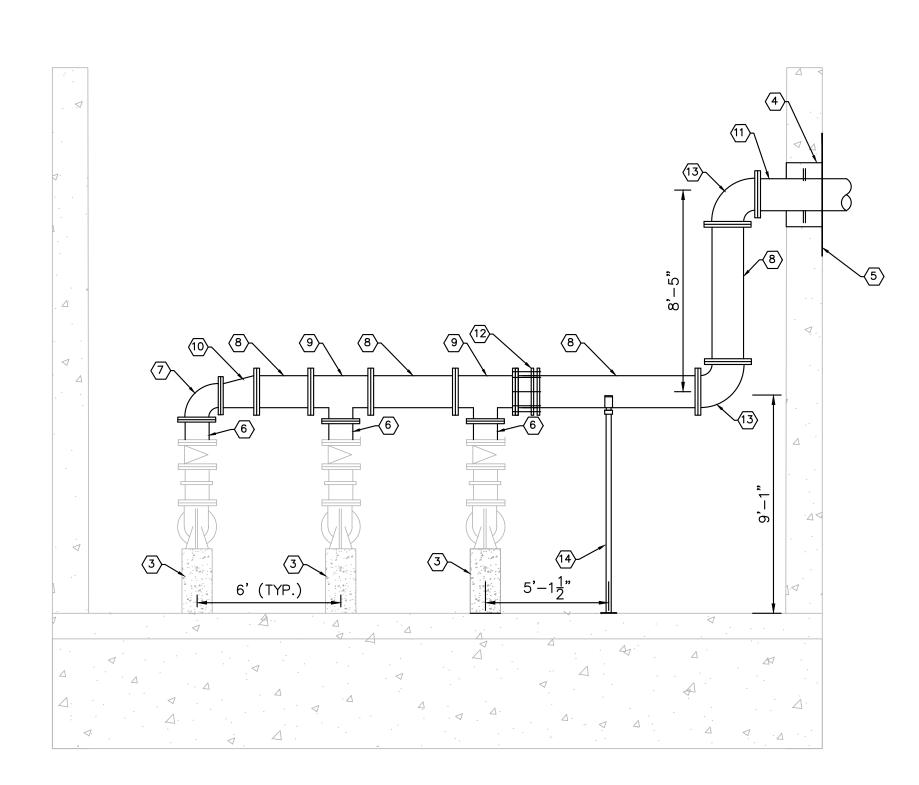

PROPOSED DISCHARGE HEADER PIPING

69051

KEY NOTES

- EXISTING PIPING TO BE REMOVED AND REPLACED
- 2 EXISTING 12" PLUG VALVE TO REMAIN
- (3) EXISTING CONCRETE PEDESTAL
- 4 CONTRACTOR SHALL CHIP OUT CONCRETE FROM AROUND EXISTING FM AT BUILDING IN ORDER TO REMOVE AND REINSTALL PIPING. REMOVE PIPING AND INSTALL NEW PIPING INTO THE BUILDING, SECURE TO EXISTING HEADER PIPING IN DRYWELL AND MUD UP AROUND NEW FM PIPING WITH NON-SHRINK GROUT INSIDE AND OUT.
- 5 PREPARE AND PAINT SURROUNDING CONCRETE WITH COAL TAR-EPOXY (SYSTEM NO. 46-31) PER THE SPECIFICATIONS

(6) PROPOSED 12" D.I. SPOOL PIECE, FLG

- 7 PROPOSED 12" D.I. 90° BEND, FLG
- (8) PROPOSED 16" D.I. SPOOL PIECE, FLG
- 9 PROPOSED 16" X 12" D.I. TEE, FLG
- PROPOSED 16" X 12" D.I. ECCENTRIC REDUCER, FLG
- PROPOSED 16" D.I. SPOOL PIECE, FLG X (11) PE (SEE SHEETS 34 AND 34A FOR CONTINUATION)
- PROPOSED 16" FLANGED COUPLING ADAPTOR
- (13) PROPOSED 16" D.I. 90° BEND, FLG
- (14) PIPE SUPPORT PER DETAIL SHEET 39

GROUNDWATER DEWATERING NOTE THE PRESENCE OF GROUNDWATER SHOULD BE ANTICIPATED ON THIS PROJECT. CONTRACTOR'S BID SHALL INCLUDE CONSIDERATION FOR THIS INCLUDE CONSIDERATION FOR THIS
ISSUE. WHEN PERFORMING GRADING
OPERATIONS DURING PERIODS OF WET
WEATHER, PROVIDE ADEQUATE
DEWATERING, DRAINAGE AND GROUND
WATER MANAGEMENT TO CONTROL



LICENSED PROFESSIONAL W. WADE WOOD, P.E FORCE MAIN 5 FL LICENSE NUMBER

REHABILITATION

HEADER PIPING MODIFICATIONS SHEET NUMBER


41

KHA PROJECT

148400012

DATE 2/14/2017

SCALE AS SHOWN

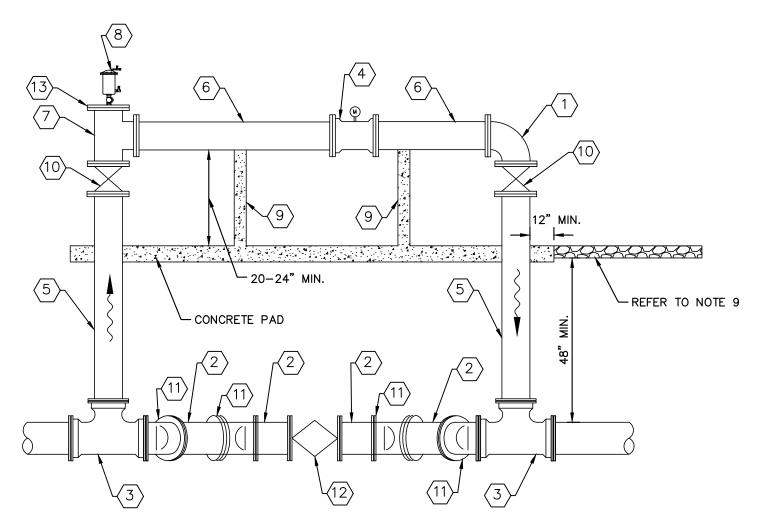

MAG METER DETAIL

1. ABOVE GROUND PIPING SHALL BE IRON BODY FLANGED FITTINGS.

- 2. ALL PIPING SHALL BE COLOR CODED IN ACCORDANCE W/ MANATEE COUNTY
- 3. PIPE THROUGH SLAB AND ABOVE GROUND SHALL BE D.I. PIPE AND FITTINGS.
- 4. ALL METAL APPURTENANCES INCLUDING BOLTS, NUTS, AND WASHERS SHALL BE STAINLESS STEEL (TYPE 316) UNLESS OTHERWISE NOTED. ALL STAINLESS STEEL BOLTS SHALL BE TREATED WITH NEVER-SIÉZE PRIOR TO ASSEMBLY.
- 5. CONTRACTOR TO PROVIDE REQUIRED LENGTH OF PIPE DOWNSTREAM AND UPSTREAM OF THE PROPOSED METER IN ACCORDANCE WITH MANUFACTURER'S RECOMMENDATIONS.
- 6. ALL BELOW GROUND PIPING SHALL BE RESTRAINED ACCORDINGLY.

1/8" THICK NEOPRENE

ASTM A-276 TYPE 316 -

SUPPORT WITH U-BOLT

B-LINE FIG. B3090 OR APPROVED EQUAL

AS REQUIRED

STAINLESS STEEL ADJUSTABLE PIPE

NON-SHRINK

BEARING PAD ALL AROUND

PIPE (DIAMETER VARIES)

ASTM A-276 TYPE 316 STAINLESS STEEL PIPE

COLUMN & BASE PLATE

SIZED PER SUPPORT MFR'S

RECOMMENDATIONS B-LINE

TYPE 316 S.S EXP. ANCHORS

MFR'S RECOMMENDATIONS


SIZE & NUMBER PER


FIG. B30888T OR EQUIVALENT

- 7. CONTRACTOR TO REMOVE/ABANDON EXISTING VAULTS AND FORCE MAIN AS NECESSARY TO PROPERLY INSTALL PROPOSED METER ASSEMBLY. ALL VOIDED AREAS SHALL BE REFILLED WITH FLOWABLE FILL.
- 8. ALL BELOW GROUND D.I. PIPE AND FITTINGS SHALL BE POLYETHYLENE WRAPPED.
- 9. INSTALL 6" OF COMPACTED 1", WASHED, CRUSHED SHELL OVER ONE LAYER OF WEED BARRIER OVER ALL EXPOSED GROUND SURFACES. THE WEED BARRIER SHALL BE MIRASCAPE MANUFACTURED BY MIFAFI OR APPROVED EQUAL. ALL FINISHED GRADE SURFACES SHALL SLOPE AWAY FROM THE CONCRETE SLABS AT A MINIMUM SLOPE OF 2%, EXTENDING 6 FEET OUTSIDE OF CONCRETE PAD. ALL DISTURBED GROUND SHALL BE COMPACTED TO 95% MAX DENSITY, AASHTO T-180, BEFORE INSTALLING THE WEED BARRIER.

PIPING LEGEND

- (1) 14" D.I. 90' ELBOW (COMPACT), FLG
- $\langle 2 \rangle$ 16" D.I. SPOOL PIECE, MJ
- (3) 16" X 14" D.I. TEE, MJ
- 4 14" D.I. MAG METER, FLG (ABB MAG METER, MODEL FEW325)
- (5) 14" D.I. SPOOL PIECE, MJ X FLG
- (6) 14" D.I. SPOOL PIECE, FLG
- 〈7〉 14" X 14" D.I. TEE, FLG
- (8) 2" ARV (REFER TO DETAIL US-10)
- CONCRETE PIPE SUPPORT (REFER TO DETAIL THIS PAGE)
- 14" GATE VALVE, FLG
- (11) 16" 45' BEND, MJ
- (13) 14" BLIND FLANGE FOR ARV

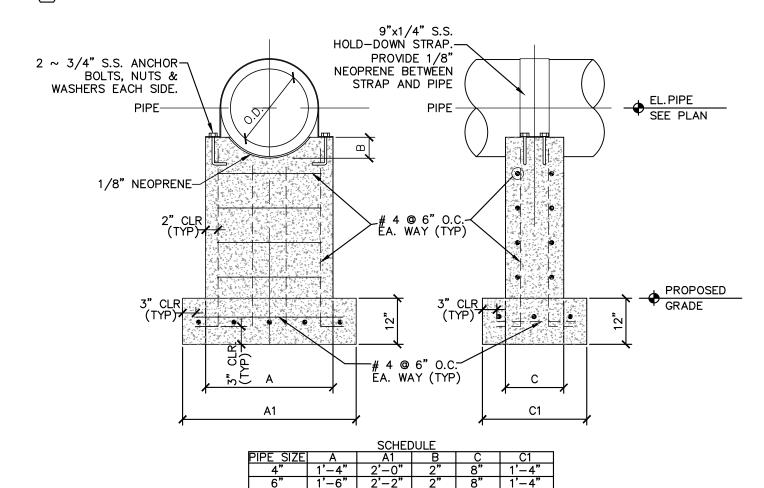

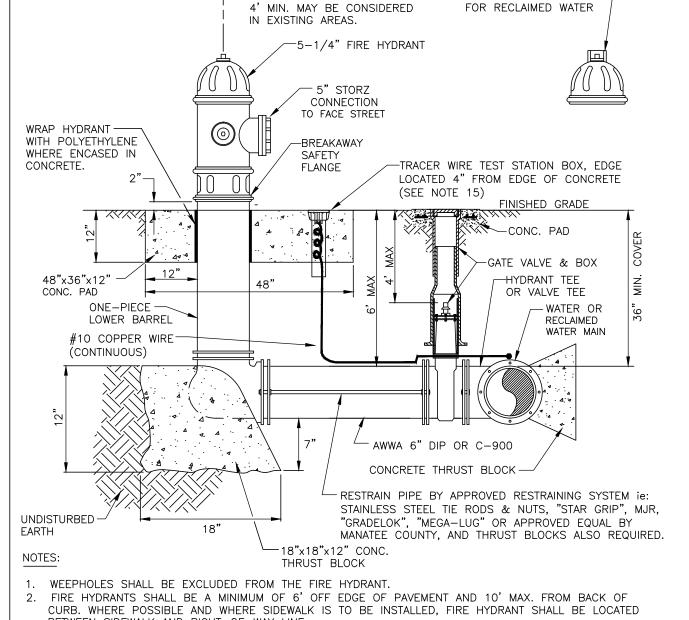

10' MAX. TO BACK OF CURB. HYDRANT NUT GUARD -

- BETWEEN SIDEWALK AND RIGHT-OF-WAY LINE.
- HYDRANTS SHALL BE FUSION BONDED EPOXY COATED SAFETY YELLOW FOR WATER AND PURPLE (PANTONE 522C) FOR RECLAIMED WATER. HYDRANT SHALL BE DUCTILE IRON CONSTRUCTION. 4. FIRE HYDRANTS SHALL BE PLACED SO THAT STORM WATER FLOWS AWAY FROM THE HYDRANT.
- 5. FIRE HYDRANTS SHALL BE CONSTRUCTED WITH "GROUND LINE" SET TO FINISHED GRADES AS ESTABLISHED IN THE FIELD. NORMAL BURY IS 3 FEET OF COVER FOR ALL WATER LINES.
- 6. FIRE HYDRANTS MAY BE CONSTRUCTED WITH "GRADELOK" OFFSET FITTING. 7. RAISED REFLECTIVE PAVEMENT MARKER (BLUE) FOR POTABLE WATER (PURPLE) FOR RECLAIMED WATER. SHALL BE INSTALLED AT CENTERLINE OF PAVEMENT ADJACENT TO EACH HYDRANT.
- 8. PRECAST CONCRETE THRUST BLOCKS & PADS SHALL NOT BE USED.
- 9. ALL EXPOSED EDGES OF CONCRETE SHALL HAVE 1/2" CHAMFER. 10. FIRE HYDRANT VALVE SHALL BE FASTENED DIRECTLY TO TEE.

14. SEE STANDARD DETAIL GATE VALVE, BOX, LID AND TAG

MAY 10. 2011

DATE OF APPROVAL

MANATEE COUNTY

PUBLIC WORKS DEPARTMENT

REV.BY DATE

- IN-LINE VALVES SHOULD BE LOCATED AT HYDRANT TEES. HYDRANTS SHALL BE LOCATED ON SAME SIDE OF ROAD AS WATER MAIN UNLESS OTHERWISE APPROVED.
- THERE MUST BE A CLEARANCE OF 7 1/2 FEET FROM FRONT AND BOTH SIDES, AND FOUR FEET TO THE REAR OF THE HYDRANT, TO ABOVE GRADE OBSTRUCTIONS INCLUDING POSTS, FENCES, TREES, ETC, PER THE FLORIDA FIRE PREVENTION CODE.

FIRE HYDRANT

ASSEMBLY

- 15. SHOULD THE FIRE HYDRANT'S CONCRETE PAD OVERLAP THE SIDEWALK, THE TRACER WIRE TEST STATION BOX SHALL NOT BE LOCATED WITHIN THE SIDEWALK.
 - 6. SEE GATE VALVE, BOX, LID AND TAG STANDARD DETAIL. CENTERING COLLAR IS NOT REQUIRED ON 2" GATE VALVES. MANATEE COUNTY PUBLIC WORKS DEPARTMENT REV.BY DATE CLB/KE 11/10 MAY 10, 2011 PAGE 123 DATE OF APPROVAL

SPECIFICALLY INDICATED ON THE PLAN.

RECOMMENDATION FOR WATER MAIN SIZE.

4. ALL PIPE THREADS TO BE SEALED AIR TIGHT.

2'-4" SQUARE

PLAN VIEW

(2) 1/2" SS OR BRASS ELLS (FIP) (2) 1/2" SS OR BRASS NIPPLES (MIP)

& TAG

CONC. PAD -

VALVE BOX W/

STAINLESS STÉEI

2"R.S. GATE

OPERATING NUT

EXTENSION STEM

VALVE, FIP, FPDM

RUBBER. W/AWWA

WATER OR RECLAIMED -

WATER MAIN

AIR RELEASE ASSEMBLY UW - 10FOR 16-INCH AND LARGER MAINS PAGE 128

- ALLIED MOLDED PRODUCTS CABINET

RESIN WITH POLYESTER INFUSED

S.S.

S.S. QUAD

DOOR-

LOCKABLE

LATCH WITH

WING DRIVER

(2 REQ'D) —

6" THICK

VARIES

2% MINIMUM SLOPE

(1) 2" STREET ELL

2" CORP. STOP

2. ARV VENT ORIFICE TO BE SIZED IN ACCORDANCE WITH MANUFACTURER'S

SMITH-BLAIR 325 BRONZE

SERVICE SADDLE 2" IP TAP

WITH EXTRA-WIDE STAINLESS

STEEL OR BRASS STRAP OR EQUAL

APPROVED BY MANATEE COUNTY

1. AIR RELEASE VALVES TO BE INSTALLED AT HIGH POINTS ALONG WATER MAINS WHERE

3. ALL INCIDENTAL FITTINGS AND HARDWARE TO BE STAINLESS STEEL, BRASS OR COPPER.

5. VENT PIPE TO BE LAID ACCURATELY ON SLOPE, WITHOUT HIGH OR LOW POINTS.

CAST-IN-PLACE

CONCRETE PAD —

TRACER WIRE TEST BOX -

#10 COPPER WIRE

CONTINUOUS ---

22" SQUARE BY 24" TALL FIBERGLASS/

AGGREGATE PROTECTIVE COATING COLOR

PANTONE BLUE 288C (POTABLE WATER)

PANTONE PURPLE 522C (RECLAIMED)

- 2" G.A. INDUSTRIES FIG.

920 COMPOUND LEVER

-1" BRONZE SHUT-OFF

BALL VALVE

∠2" CORP. STOP

 $-\frac{1}{2}$ CHAMFER (TYP.)

·5/16"x5"x1"x1¹/₂" S.S.

ANCHOR BOLT, NUT &

└─ (4) #3 REBAR EA. WAY

- POLYETHYLENE WRAP

OR 316 SS SCH 40

-(1) 2" STREET ELL

(1) 2" ELL

OR SDR 9 HDPE TUBE

OR 316 SS SCH 40

-2" SCH. 40 BRASS PIPE

OR TYPE "K" COPPER TUBE

-2" SCH. 40 BRASS PIPE

OR TYPE "K" COPPER TUBE

(2 LAYERS)

WASHER (4 EA. REQ'D)

(8 TOTAL)


AIR RELEASE VALVE

CONCRETE PIPE SUPPORT

18" 2'-6" 3'-2" 6" 1'-0" 1'-8" 2'-8" 3'-8" 6" 1'-6" 2'-6"

 24"
 3'-0"
 4'-0"
 6"
 1'-6"
 2'-6"


 30"
 3'-6"
 4'-6"
 9"
 1'-6"
 2'-6"

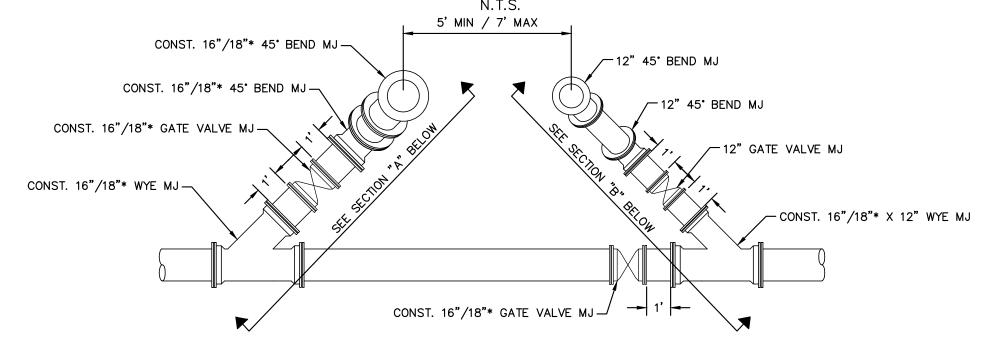

PIG PORT LAUNCHING/RECIEVING STATION SCALE: 1/4" = 1'-0"

NOTES:

- 1. THE ABOVE DETAIL IS FOR A TYPICAL PIG RECOVERY STATION. PIG RECOVERY STATION WILL BE REVERSE TO FLOW.
- 2. THE CONTAINMENT AREA SHALL BE COVERED WITH 8 INCHES OF #57 STONE OVER FILTER FABRIC AS SPECIFIED IN FDOT STANDARD INDEX NO. 199. CONTAINMENT AREA SHALL BE 6.0'X6.0'
- 3. *CONTRACTOR TO CONFIRM PIPE SIZE BEFORE CONSTRUCTION.

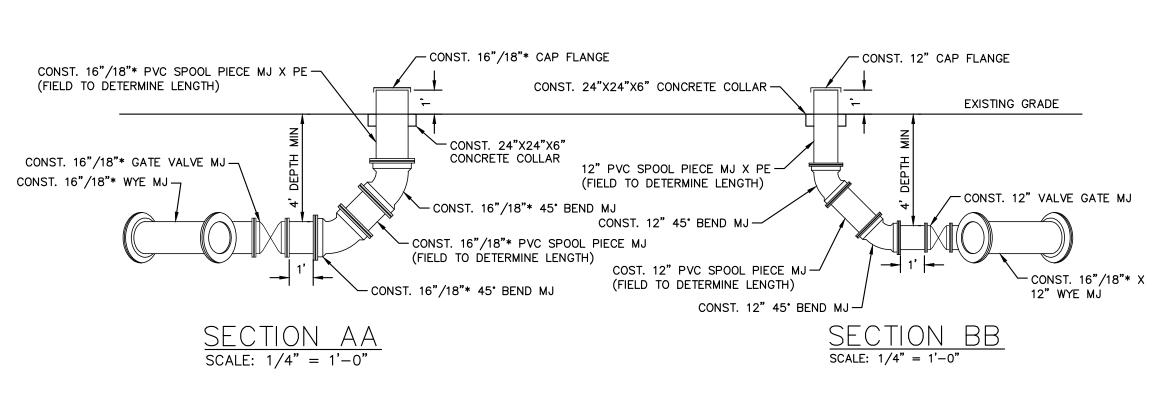

1. *CONTRACTOR TO CONFIRM PIPE SIZE BEFORE CONSTRUCTION

GROUNDWATER EWATERING NOTE THE PRESENCE OF GROUNDWATER SHOULD BE ANTICIPATED ON THIS PROJECT. CONTRACTOR'S BID SHALL INCLUDE CONSIDERATION FOR THIS ISSUE. WHEN PERFORMING GRADING OPERATIONS DURING PERIODS OF WET WEATHER, PROVIDE ADEQUATE DEWATERING, DRAINAGE AND GROUND WATER MANAGEMENT TO CONTROL MOISTURE OF SOILS.



REVISIONS DATE

PIPE SUPPORT DETAIL


© 2016 KIMLEY-HORN AND ASSOCIATES, INC. 655 NORTH FRANKLIN STREET, SUITE 150, TAMPA, FL 33602 PHONE: 813-620-1460 WWW.KIMLEY-HORN.COM CA 00000696


KHA PROJECT 148400012	
DATE 2/14/2017	
SCALE AS SHOWN	
DESIGNED BY WWW	
DRAWN BY JRT	
CHECKED BY WEW	MANATEE COUNTY


FORCE MAIN 5 **REHABILITATION** LICENSED PROFESSIONAL W. WADE WOOD, P.E. FL LICENSE NUMBER 69051

FL DATE:

CONSTRUCTION DETAILS

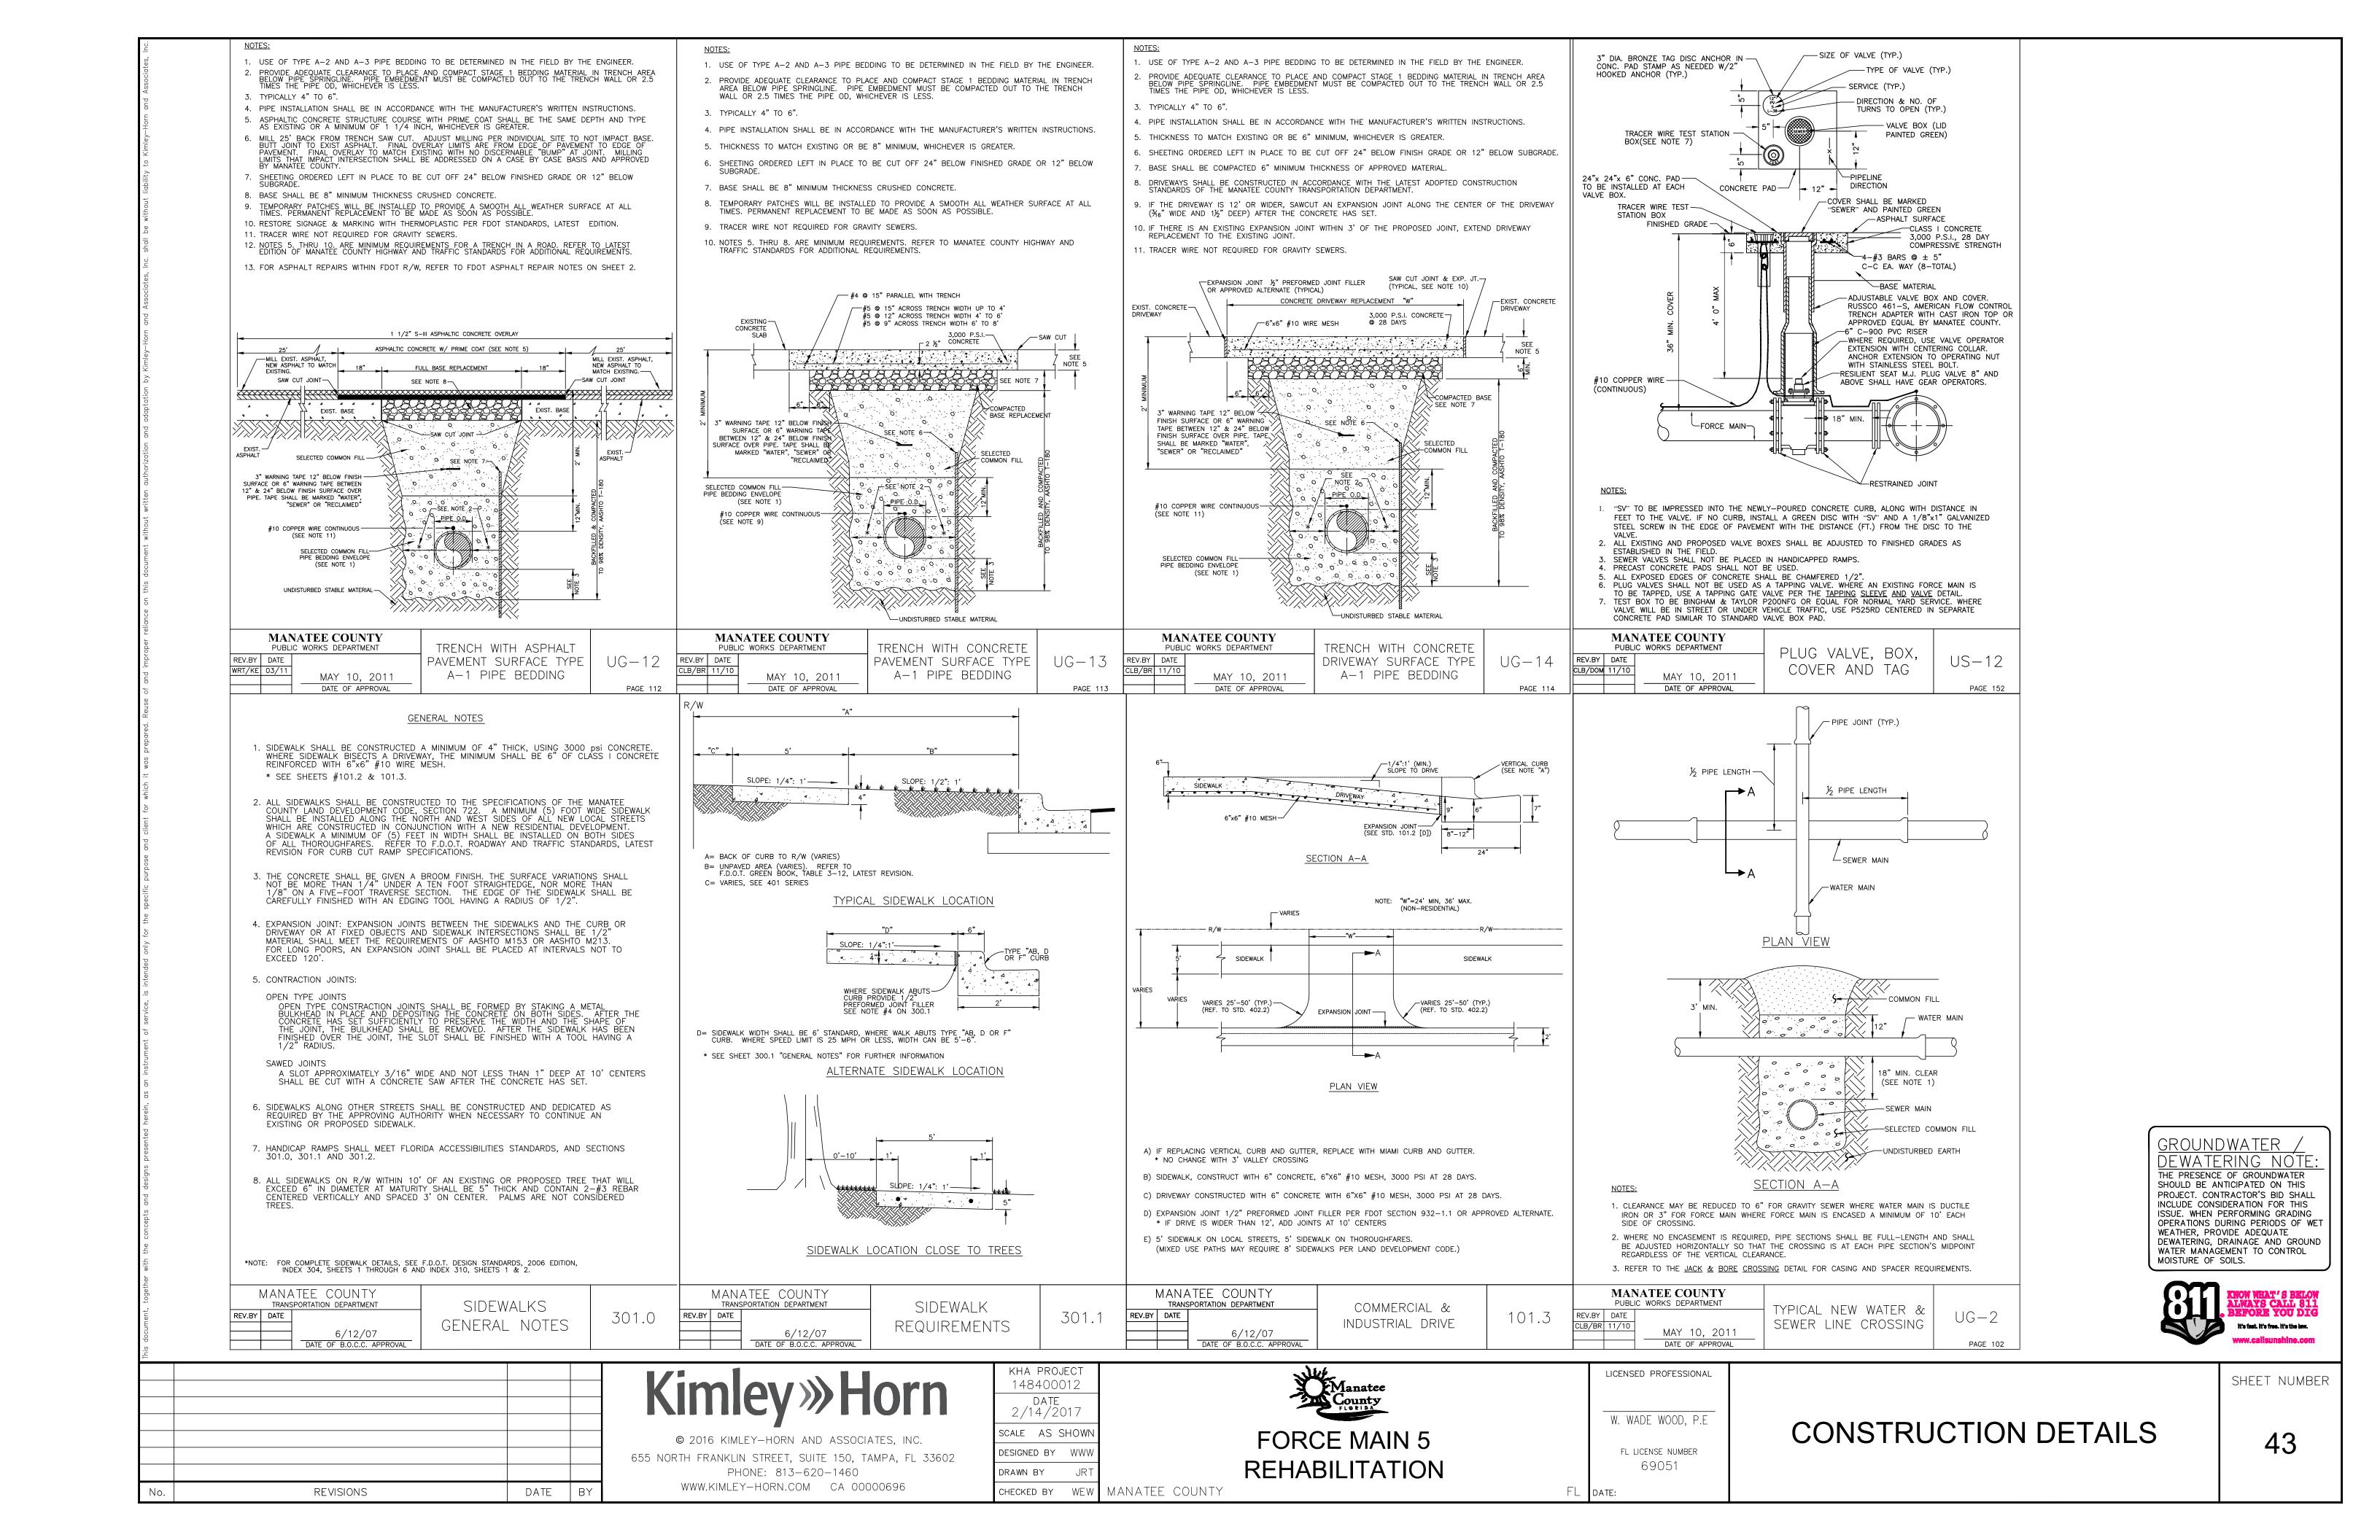

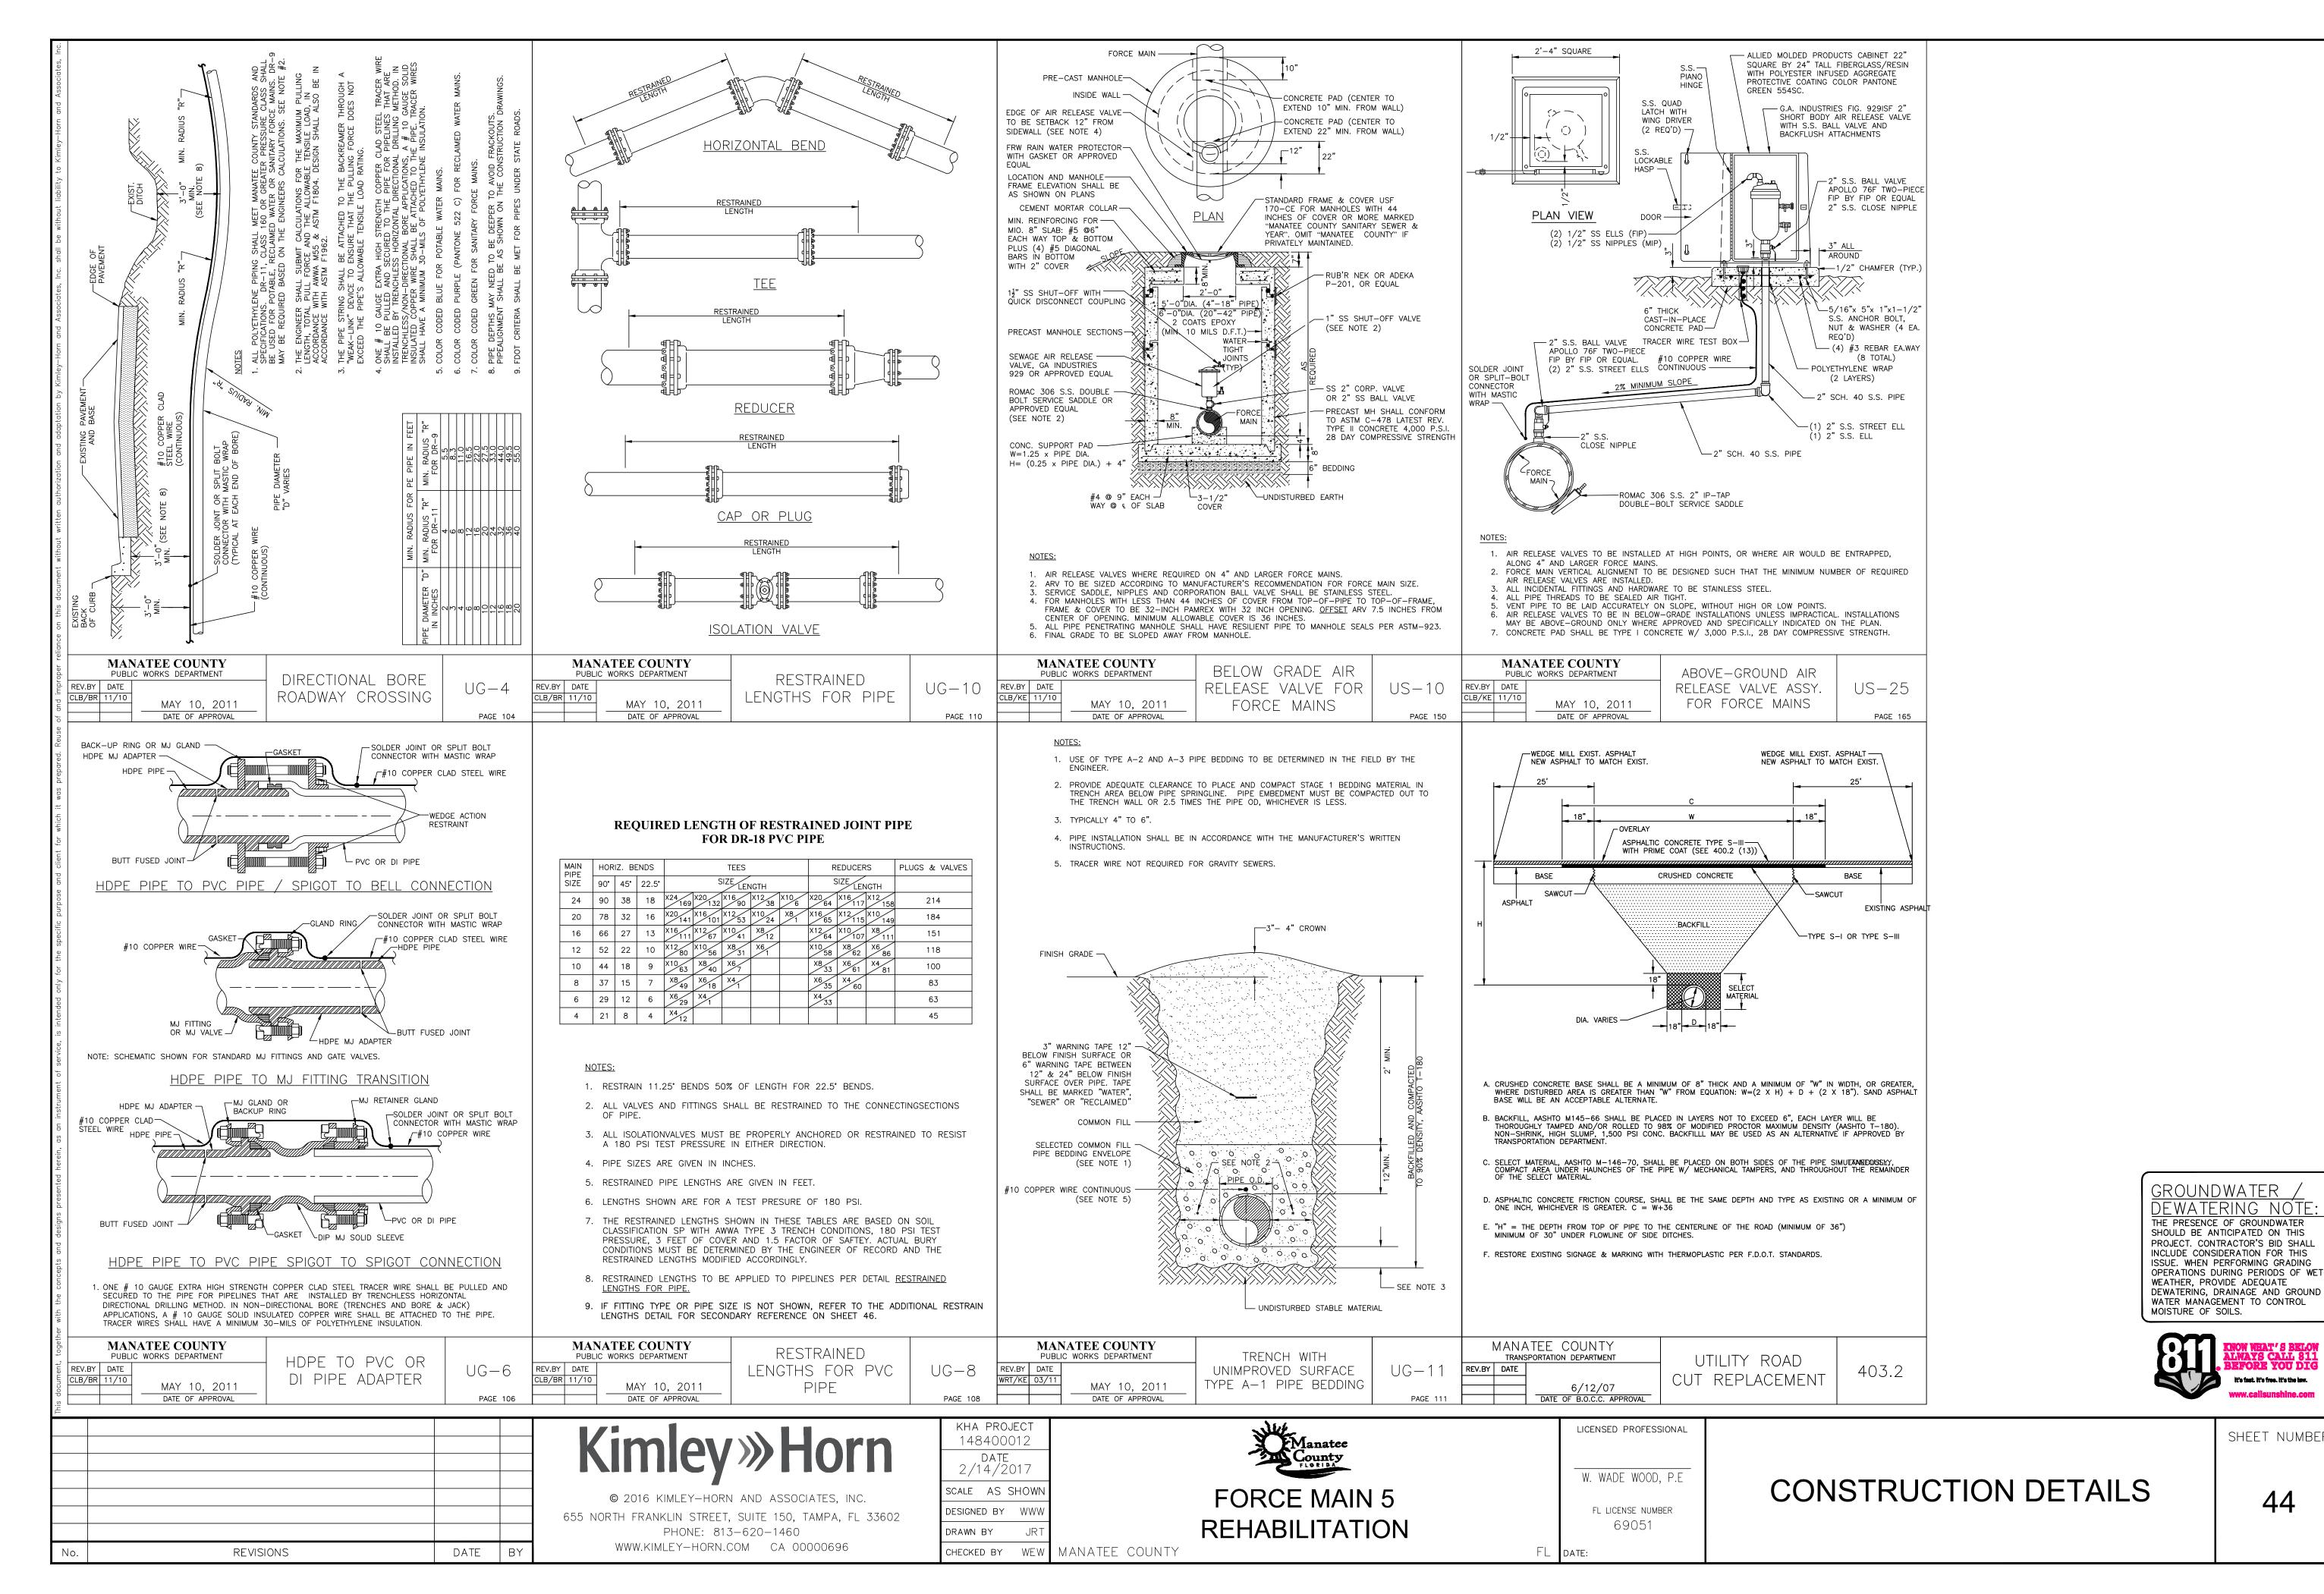

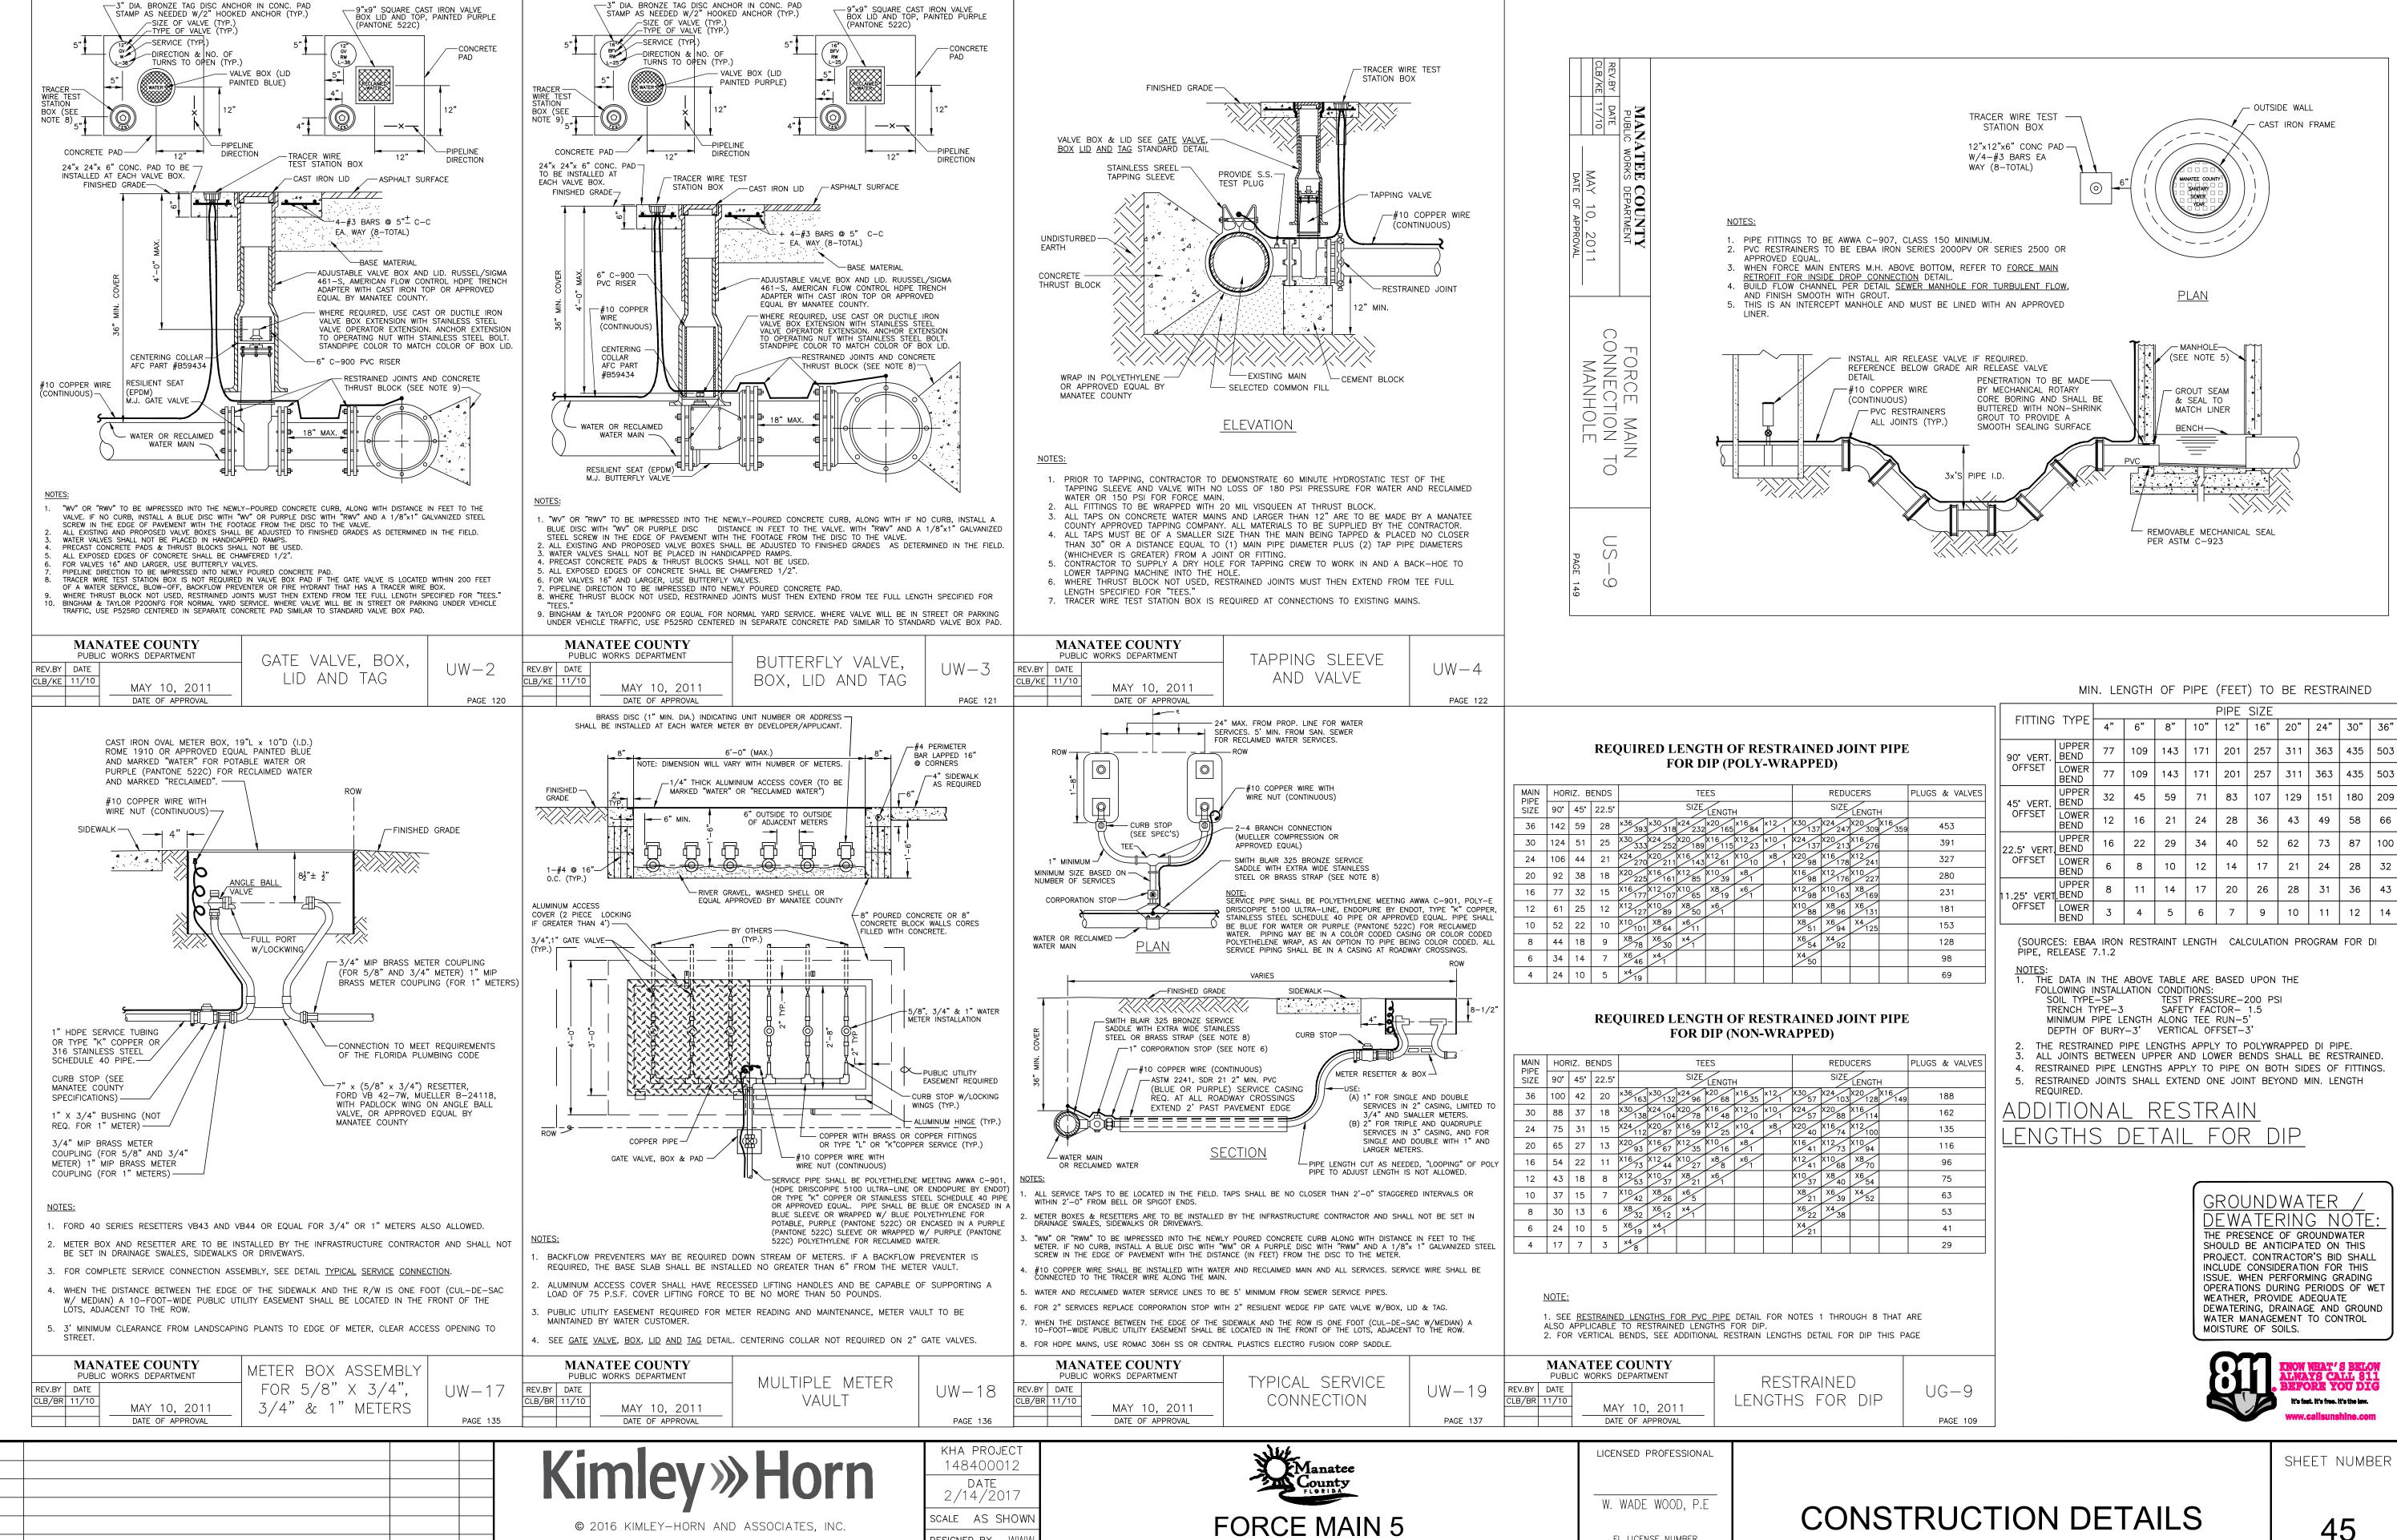

REHABILITATION

ESIGNED BY WWV

HECKED BY WEW

MANATEE COUNTY

RAWN BY

655 NORTH FRANKLIN STREET, SUITE 150, TAMPA, FL 33602

PHONE: 813-620-1460

WWW.KIMLEY-HORN.COM CA 00000696

REVISIONS


DATE

CONSTRUCTION DETAILS

FL LICENSE NUMBER


FL DATE:

69051

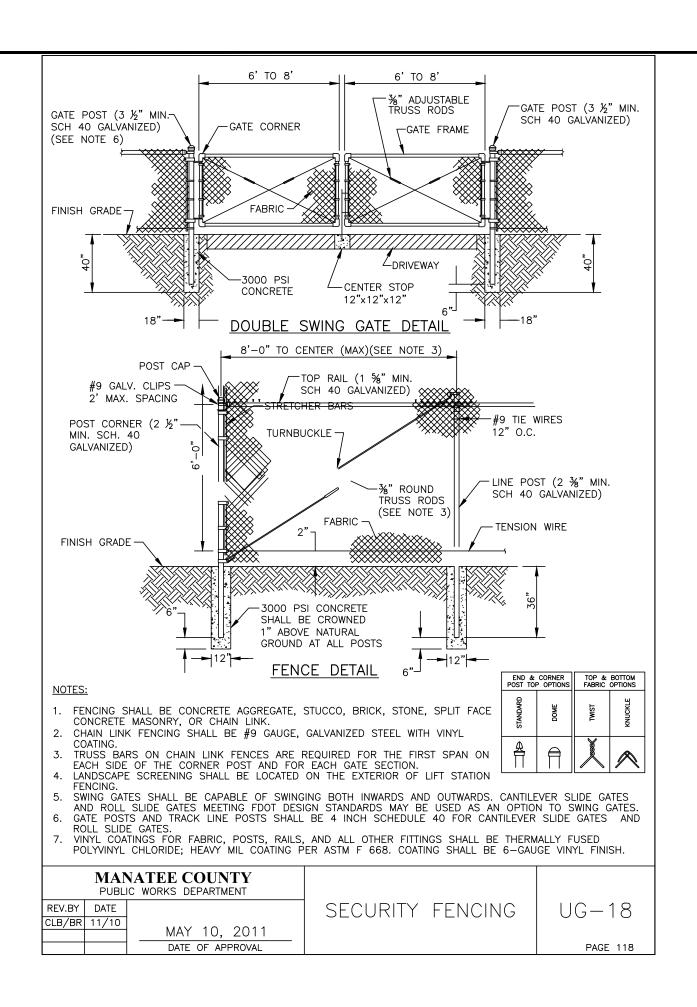

REVISIONS

DATE BY

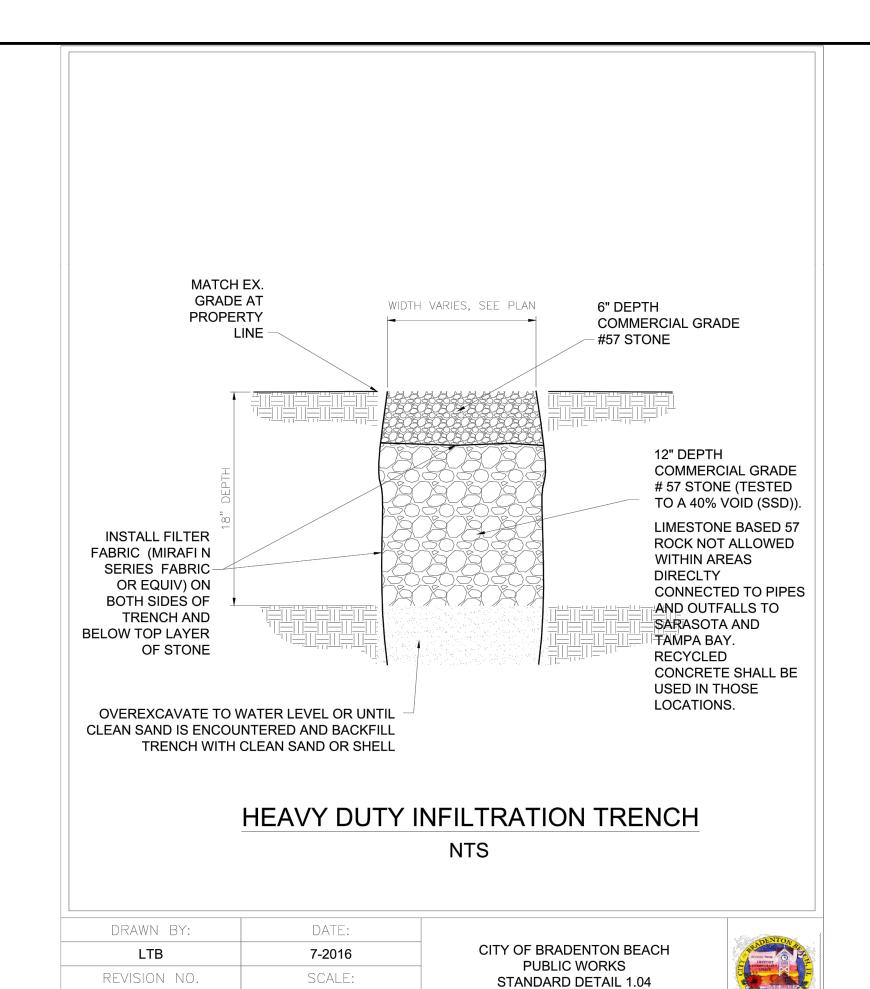


NTS


4" | 6" | 8" | 10" | 12" | 16" | 18" | 20" | 24" 90° HORIZ. BEND 17 | 24 | 31 | 37 | 43 | 55 | 60 | 66 | 76 8 | 10 | 13 | 16 | 18 | 23 | 25 | 28 | 32 45° HORIZ. BEND 4 | 5 | 7 | 8 | 9 | 11 | 12 | 13 | 15 22.5° HORIZ. BEND 11.25° HORIZ. BEND 2 | 3 | 4 | 4 | 5 | 6 | 6 | 7 | 8 38 | 53 | 70 | 84 | 99 | 115 | 140 | 153 | BEND OFFSET OFFSET 4 | 6 | 7 | 9 | 10 | 13 | 14 | 15 | BFND OFFSET 1.25° VERT. OFFSET LOWER PLUG/ IN-LINE VALVE | 38 | 53 | 70 | 84 | 99 | 115 | 140 | 153 | 4"X ø | 20 | - | - | -8"X ø | 2 | 29 | 51 | -10"X ø | 1 | 22 | 46 | 65 | 12"X Ø | 1 | 15 | 41 | 61 | 79 | 18"X Ø | 1 | 1 | 24 | 47 | 68 | 104 | 120 | RÉSTRAINT) 20"X Ø | 1 | 1 | 18 | 42 | 64 | 101 | 117 | 133 | 24"X Ø | 1 | 1 | 5 | 32 | 55 | 95 | 112 | 128 | 158 8"X ø | 50 | 30 | - | -10"X ø | 68 | 52 | 28 | -12"X Ø | 86 | 72 | 52 | 29 | 16"X ø | 117 | 107 | 93 | 75 | 54 | - | | 18"X | ø | 131 | 122 | 110 | 95 | 76 | 29 | 20"X ø | 146 | 138 | 126 | 113 | 96 | 54 | 29 | 24"X Ø | 173 | 166 | 157 | 146 | 132 | 98 | 77 | 54 | -30"X Ø | 279 | 272 | 262 | 251 | 237 | 201 | 179 | 155 | 100 | | 36"X ø | 325 | 320 | 312 | 303 | 291 | 262 | 245 | 225 | 181 | 100 | -*PER DIPRA, AS THE BEND ANGLE APPROACHES 90°, LATERAL MOVEMENT OF


THE OUTER LEGS APPROACHES ZERO. FOR THIS CONDITION, RESTRAIN ALL PIPE BETWEEN THE FITTINGS AND RESTRAIN THE OUTER LEGS AS DEAD ENDS.

ADDITIONAL RESTRAIN LENGTHS DETAIL

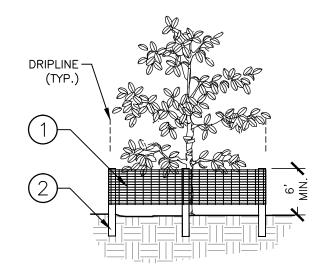

ELEVATION

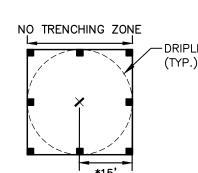

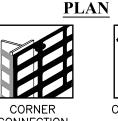

(SEE INSTALLATION NOTE E)

- (1) 6'H "PERIMETER PLUS" CONSTRUCTION FENCE BY CONWED PLASTICS OR OWNER'S REPRESENTATIVE APPROVED EQUAL. SUBMIT PRODUCT INFORMATION FOR APPROVAL PRIOR TO INSTALLATION.
- (2) 8' TALL METAL "T" POSTS OR 2" x 2" X 8' PRESSURE TREATED WOOD POSTS WITH 24" BURIAL BELOW GRADE.

INSTALLATION NOTES:

STRENGTH NEEDS AND THE LENGTH OF TIME FENCE WILL BE IN PLACE. FLEXIBLE FIBERGLASS ROD POSTS ARE RECOMMENDED FOR PARKS, ATHLETIC EVENTS AND CROWD CONTROL INSTALLATIONS. METAL "T" POSTS OR TREATED WOOD POSTS ARE TYPICALLY USED FOR CONSTRUCTION AND OTHER APPLICATIONS.

A. POST SELECTION SHOULD BE BASED ON EXPECTED

- B. POSTS SHOULD BE DRIVEN INTO THE GROUND TO A DEPTH OF 1/3 OF THE HEIGHT OF THE POST. FOR EXAMPLE, A 6' POST SHOULD BE SET AT LEAST 2' INTO THE GROUND.
- C. SPACE POSTS EVERY 6' (MIN.) TO 8' (MAX.).
- D. SECURE FENCING TO POST WITH NYLON CABLE TIES (AVAILABLE FROM CONWED PLASTICS). WOOD STRIPS MAY BE ALSO BE USED TO PROVIDE ADDITIONAL SUPPORT AND PROTECTION BETWEEN TIES AND
- E. FOR PIPELINE CONSTRUCTION ADJACENT TO TREES: EXAMPLE: DIVIDE 30" TRUNK DIAMETER BY 2. (30/2=15) EXCAVATION SHALL BE PROHIBITED WITHIN 15' OF THE TRUNK OR THE LIMITS OF THE DRIPLINE, WHICHEVER IS GREATER.

NOTE: IF WIRE TIES ARE USED, AVOID DIRECT CONTACT WITH FENCE. WIRE MAY DAMAGE FENCE OVER TIME.

DEWATERING NOTE THE PRESENCE OF GROUNDWATER SHOULD BE ANTICIPATED ON THIS PROJECT. CONTRACTOR'S BID SHALL INCLUDE CONSIDERATION FOR THIS ISSUE. WHEN PERFORMING GRADING OPERATIONS DURING PERIODS OF WET WEATHER, PROVIDE ADEQUATE DEWATERING, DRAINAGE AND GROUND WATER MANAGEMENT TO CONTROL MOISTURE OF SOILS.

GROUNDWATER

(SOURCES: EBAA IRON RESTRAINT LENGTH CALCULATION PROGRAM FOR

TEST PRESSURE-150/200 PSI

SAFETY FACTOR - 1.5

ALL JOINTS BETWEEN UPPER AND LOWER BENDS SHALL BE RESTRAINED. RESTRAINED PIPE LENGTHS APPLY TO PIPE ON BOTH SIDES OF FITTINGS. CONTRACTOR TO REFER TO MANATEE COUNTY DETAIL UG-8 FOR PVC RESTRAIN LENGTHS. IF FITTING TYPE OR PIPE SIZE IS NOT SHOWN,

RESTRAINED JOINTS SHALL EXTEND ONE JOINT BEYOND MIN. LENGTH

THE DATA IN THE ABOVE TABLE ARE BASED UPON THE

MINIMUM PIPE LENGTH ALONG TEE RUN-5' DEPTH OF BURY-3' VERTICAL OFFSET-3'

THE RESTRAINED PIPE LENGTHS APPLY TO PVC PIPE.

REFER TO THIS DETAIL FOR SECONDARY REFERENCE.

FOLLOWING INSTALLATION CONDITIONS:

PVC PIPE, RELEASE 7.1.2

TRENCH TYPE-3



	K IMIOV////Horn	
	Kimlev» Horn	

© 2016 KIMLEY-HORN AND ASSOCIATES, INC. 655 NORTH FRANKLIN STREET, SUITE 150, TAMPA, FL 33602 PHONE: 813-620-1460 WWW.KIMLEY-HORN.COM CA 00000696

	KHA PROJECT 148400012 DATE 2/14/2017			
	scale AS S	HOWN		
	DESIGNED BY	WWW		
	DRAWN BY	JRT		
	CHECKED BY	WEW	MANATEE	COUNTY




LICENSED PROFESSIONAL W. WADE WOOD, P.E FL LICENSE NUMBER

FL DATE:

69051

TREE PROTECTION FENCING

CONSTRUCTION DETAILS

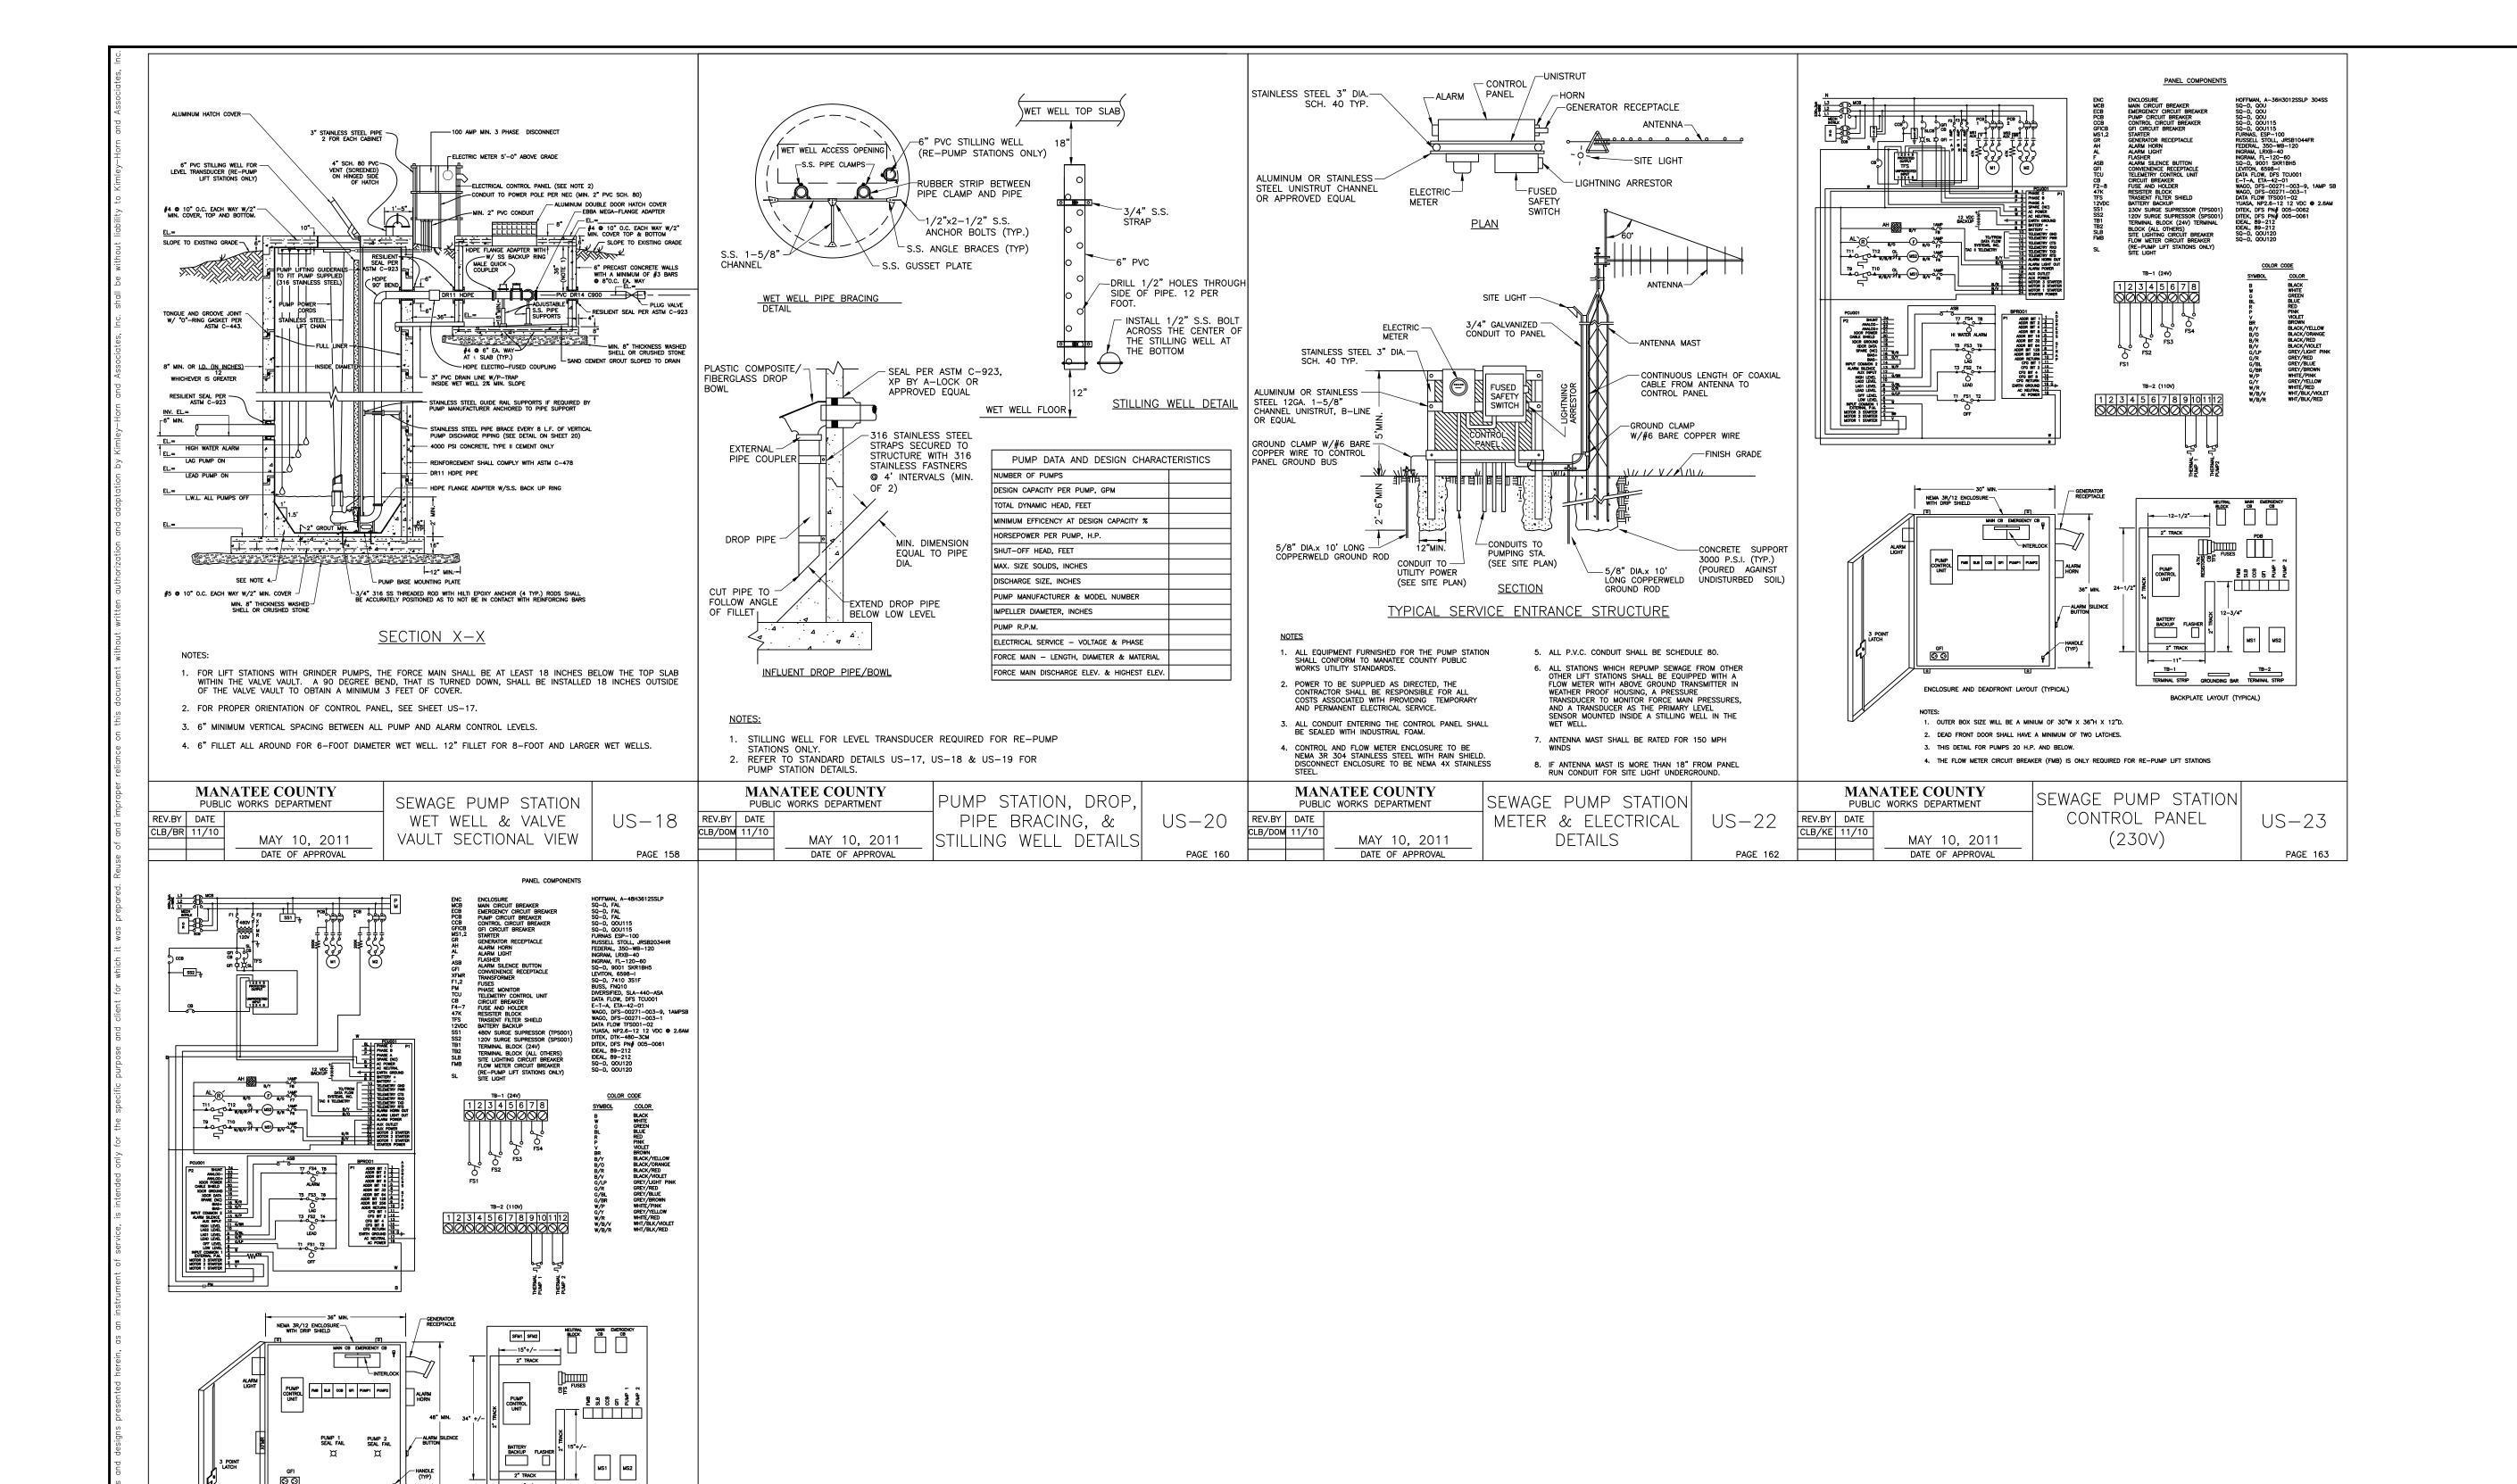



Kimley» Horn

. OUTER BOX SIZE WILL BE A MINIUM OF 30"W X 36"H X 12"D.

REVISIONS

MANATEE COUNTY

MAY 10, 2011

1. OOTER BOX 3624 WILL BE A MINIMUM OF 30 W A 30 H A 125.
2. DEAD FRONT DOOR SHALL HAVE A MINIMUM OF TWO LATCHES.
3. THIS DETAIL FOR PUMPS 21 H.P. AND ABOVE.
4. SIZE 3 AND LARGER MOTOR STARTERS REQUIRE A STARTER COIL ISOLATION RELAY.
5. THE CONTROL TRANSFORMER SHALL BE MOUNTED ON THE EXTERIOR OF THE PANEL.
6. THE FLOW METER CIRCUIT BREAKER (FMB) IS ONLY REQUIRED FOR RE-PUMP LIFT STATIONS.


SEWAGE PUMP STATION CONTROL PANEL

(460V)

US-24

DATE

© 2016 KIMLEY-HORN AND ASSOCIATES, INC.
655 NORTH FRANKLIN STREET, SUITE 150, TAMPA, FL 33602
PHONE: 813-620-1460
WWW.KIMLEY-HORN.COM CA 00000696

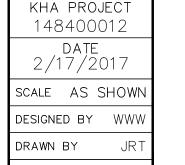



LICENSED PROFESSIONAL	
W. WADE WOOD, P.E	
FL LICENSE NUMBER 69051	

FL DATE:

LIFT STATION DETAILS

SHEET NUMBER

47

