

#### **PLANT LIST**

Symbol	<b>Botanical Name</b>	<b>Common Name</b>	<b>Native</b>	Specification	Quantity
Trees					
PE	Pinus elliotti	Slash Pine	Yes	3" Cal., 10' - 18' Ht. x 4' Spd.	20
QV	Quercus virginiana	Live Oak	Yes	4" Cal., 12' - 22' Ht. x 6.5' Spd.	8
TA	Taxodium distichum	Bald Cypress	Yes	4" Cal., 10' - 22' Ht. x 5' Spd.	16
Palms					
SPX	Sabal palmetto	Sabal Palm	Yes	15' OA Ht., Slick (Clear Wood to 4' below CT Ht., Hurricane Cut	8
Groundo	overs and Shrubs				
MCA	Muhlenbergia capillaris	Muhly Grass	Yes	3 Gal., 24" OA, 36" OC	34
SPB	Spartina bakeri	Sand Cordgrass	Yes	3 Gal., 24" OA, 48" OC	35
VIB	Viburnum obovatum	Walter's Viburnum	Yes	3 Gal., 30" OA, Full, 6' OC	30
Other					
Sod A	Zoysia	Empire Zoysiagrass		Solid Sod, Sand Grown, Laid, Rolled, Free of Weeds and Pests	SF
Sod B	Bahia Sod	Bahia Grass		Solid Sod, Sand Grown, Laid, Rolled, Free of Weeds and Pests	SF
CCGB	Pinebark Mulch			3" Depth, All planting Areas and Tree Rings	CY

#### GENERAL LANDSCAPE NOTES

- 1. ALL PLANTS MUST BE HEALTHY, VIGOROUS MATERIAL, FREE OF PESTS AND DISEASES. ALL PLANT MATERIAL SHALL BE IN FULL AND STRICT ACCORDANCE TO FLORIDA NO. 1 GRADE, ACCORDING TO THE "GRADES AND STANDARD FOR NURSERY PLANTS", PUBLISHED BY FLORIDA DEPARMENT OF AGRICULTURE AND CONSUMER SERVICES. PLANT MATERIALS IN SOME INSTANCES EXCEED NO. 1 GRADE IN ORDER TO MEET THE MINIMUM REQUIREMENTS OF THIS PROJECT.
- 2. CONTRACTOR SHALL BE RESPONSIBLE FOR PLANTS MEETING SPECIFICATION AS NOTED PRIOR TO INSTALLATION. CONTRACTOR SHALL IMMEDIATELY REMOVE ALL PLANT MATERIAL THAT DOES NOT CONFORM TO SPECIFICATIONS.
- 3. ALL ROOTBALLS SHALL CONFORM TO THE SIZE STANDARDS SET FORTH IN "AMERICAN STANDARDS FOR NURSERY STOCK".
- 4. CONTRACTOR TO SUBMIT TO THE LANDSCAPE ARCHITECT THE GROWER'S AND/OR STATE INSPECTION CERTIFICATE FOR PLANT MATERIAL TWO (2) WEEKS BEFORE COMMENCEMENT OF WORK.
- ALL PLANT MATERIAL SHALL BE PROTECTED DURING TRANSPORT AND DELIVERY TO JOB SITE WITH SHADE CLOTH OR OTHER ACCEPTABLE MEANS OF WINDBURN PREVENTION.
- CONTRACTOR SHALL FIELD VERIFY ALL INFORMATION PRIOR TO INITIATING PLANTING INSTALLATION. ALL EXISTING PLANTING SHALL REMAIN INTACT AND UNDISTURBED UNLESS OTHERWISE NOTED ON THE PLANS.
- ANY SUBSTITUTIONS IN SIZE AND/OR PLANT MATERIAL MUST BE APPROVED BY THE LANDSCAPE ARCHITECT. ALL PLANTS WILL BE SUBJECT TO APPROVAL BY LANDSCAPE ARCHITECT BEFORE PLANTING CAN BEGIN.
- 8. LANDSCAPE CONTRACTOR SHALL FIELD STAKE THE LOCATION OF ALL PLANT MATERIAL PRIOR TO INITIATING INSTALLATION FOR THE
- PLANT MATERIAL PRIOR TO INITIATING INSTALLATION FOR THE REVIEW AND APPROVAL OF THE LANDSCAPE ARCHITECT.

  9. ALL TREES MUST BE STRAIGHT TRUNKED, FULL HEADED, AND MEET ALL
- REQUIREMENTS SPECIFIED.

  10. PRIOR TO CONSTRUCTION, THE CONTRACTOR IS RESPONSIBLE FOR LOCATING ALL UNDERGROUND UTILITIES AND SHALL AVOID DAMAGE TO ALL UTILITIES DURING CONSTRUCTION. SHOULD THE CONTRACTOR CAUSE
- DAMAGE TO ANY UTILITIES, NECESSARY REPAIRS SHALL BE MADE
  AS QUICKLY AS PRACTICABLE, AT CONTRACTORS EXPENSE, UNDER
  SUPERVISION OF THE LANDSCAPE ARCHITECT.

  11. INSTALLATION ALL PLANT MATERIAL SHALL BE INSTALLED IN A SOUND,
  WORKMANLIKE MANNER AND ACCORDING TO ACCEPTED GOOD PLANTING
  PROCEDURES WITH THE QUALITY OF PLANT MATERIALS AS HEREINAFTER

DESCRIBED. ALL ELEMENTS OF LANDSCAPING SHALL BE INSTALLED SO

- AS TO MEET ALL APPLICABLE ORDINANCES AND CODE REQUIREMENTS.

  12. TYPICALLY, SHRUB AND GROUNDCOVER PLANTINGS ARE SHOWN (IN PLAN) AS MASS PLANTING BEDS. PLANTS SHALL BE PLACED ON A TRIANGULAR SPACING CONFIGURATION (STAGGERED SPACING) AS SHOWN IN THE PLANTING DETAILS. PLANT CENTER TO CENTER DIMENSIONS (O.C.) ARE LISTED ON THE PLANT LIST.
- 13. CONTRACTOR SHALL ASSURE DRAINAGE AND PERCOLATION OF ALL PLANTING PITS PRIOR TO INSTALLATION OF PLANT MATERIAL. CONTRACTOR SHALL FILL ALL TREE PITS WITH WATER BEFORE PLANTING TO ASSURE THAT PROPER DRAINAGE AND PERCOLATION IS AVAILABLE. CORRECT IF REQUIRED TO ASSURE PERCOLATION. CONTRACTOR IS RESPONSIBLE FOR REPLACEMENT OF ALL PLANTS LOST DUE TO INADEQUATE DRAINAGE CONDITIONS.
- 14. TREES GROWN IN GROW BAGS OR GROW BAG TYPE MATERIAL MUST HAVE THE GROW BAG REMOVED ENTIRELY PRIOR TO PLANTING.
- 15. BALLED AND BURLAPPED MATERIAL SHALL HAVE THE TOP ONE HALF (1/2) OF THE BURLAP AROUND THE BASE OF THE TRUNK CUT AND PULLED BACK. DO NOT REMOVE BURLAP. WIRE CAGES, STRAPS, ETC. MUST BE CUT AND REMOVED PRIOR TO INSTALLATION.
- 16. CONTRACTOR TO REPLACE REJECTED PLANT MATERIAL WITHIN ONE WEEK
- 17. CONTRACTOR SHALL REFER TO THE LANDSCAPE PLANTING DETAILS, PLANTS LIST, GENERAL NOTES AND THE PLANTING SPECIFICATIONS FOR COMPLETE LANDSCAPE PLANTING INSTRUCTIONS.
- 18. FERTILIZATION
- PALMS: 13-3-13 PLUS MINOR ELEMENTS SLOW RELEASE 1/2 LB FERTILIZER PER 1/2 INCH CALIPER
- SHRUBS AND GROUNDCOVERS:

  8-10-10 PLUS MINOR ELEMENTS SLOW RELEASE
  1/2 LB FERTILIZER PER 100 FT2
- TREES: 8-6-6 PLUS MINOR ELEMENTS SLOW RELEASE 1/2 LB FERTILIZER PER 1/2 INCH CALIPER
- 1/2 LB FERTILIZER PER 1/2 INCH CALIPER

  TURF: 16-4-8 PLUS MINOR ELEMENTS SLOW RELEASE
  1 LB FERTILIZER PER 1000 FT2

THE COST FOR LANDSCAPE FERTILIZER AS DESCRIBED ABOVE SHALL BE

INCLUDED IN THE PER PLANT PRICE.

19. SOIL PREPARATION AND SOIL MIX

UPDATE DESIGN/CODE UPDATES FOR REPERMITTING

REVISION

- A. APPLY ROUNDUP (MANUFACTURED BY MONSANTO CORP.) OR APPROVED HERBICIDE EQUAL ACCORDING TO MANUFACTURER'S RATE AND SPECIFICATION WITHIN LIMITS OF ALL AREAS TO BE PLANTED. PROTECT EXISTING PLANTS TO REMAIN FROM OVERSPRAY OR SPRAY WITHIN ROOT ZONE. CONTRACTOR TO ENSURE TOTAL WEED ERADICATION.
- B. BEFORE REPLACING TOPSOIL, RAKE SUBSOIL SURFACE CLEAR OF STONES (1 INCH DIAMETER AND LARGER), DEBRIS, RUBBISH, AND REMAINING FROM REMOVED PLANT MATERIAL.

# PRELIMINARY PLANT MATERIAL CALCULATIONS 10' WIDE, 2 CANOPY TREES AND 33 SHRUBS PER 100 LF

181 L.F. = 4 CANOPY TREES AND 60 SHRUBS

GREENBELT BUFFER 3 CANOPY TREES AND 33 SHRUBS PER 100 LF 543 L.F. = 17 CANOPY TREES AND 179 SHRUBS

- C. SCARIFY SUBSOIL TO A DEPTH OF 3 INCHES.
- D. CONTRACTOR TO APPLY "RONSTAR" OR APPROVED PRE-EMERGENT HERBICIDE IN ACCORDANCE WITH MANUFACTURER'S RATE AND SPECIFICATIONS.
- E. PLANTING SOIL MIX FOR TREES, SHRUBS, AND GROUNDCOVERS SHALL CONSIST OF A THOROUGHLY BLENDED MIXTURE OF:
  - 1. ROYAL PALMS 60% CLEAN D.O.T. SAND
  - 40% APPROVED TOPSOIL/SOLID WASTE COMPOST
    2. ALL OTHER PALMS
  - 90% CLEAN D.O.T. SAND
    10% APPROVED TOPSOIL/SOLID WASTE COMPOST
    3. SHRUBS, AND GROUND COVERS
- 70% CLEAN D.O.T. SAND
  30% APPROVED TOPSOIL/SOLID WASTE COMPOST
  CONTRACTOR TO SUBMIT LABORATORY SOIL TESTS OF THE SOIL MIXTURE
- FOR APPROVAL BY LANDSCAPE ARCHITECT.

  F. COMPOST MIX SHALL BE FREE OF DELETERIOUS MATERIALS THAT WOULD BE HARMFUL TO PLANT GROWTH, SHALL BE FREE OF NEMATODES, SHALL
- BE OF UNIFORM QUALITY AND SHALL HAVE A PH VALUE BETWEEN 5.3
  AND 6.5 (AS DETERMINED IN ACCORDANCE WITH ASTM E70). FLORIDA
  PEAT SHALL BE STERILIZED TO MAKE FREE OF ALL VIABLE NUT GRASS
  AND OTHER UNDESIRABLE WEEDS.

  G. TOPSOIL SHALL BE NATURAL, FERTILE, AGRICULTURAL SOIL CAPABLE OF
  SUSTAINING VIGOROUS PLANT GROWTH. IT SHALL BE OF UNIFORM
- SUSTAINING VIGOROUS PLANT GROWTH. IT SHALL BE OF UNIFORM COMPOSITION THROUGHOUT, WITH ADMIXTURE OF SUBSOIL. IT SHALL BE FREE OF STONES, LUMPS, LIVE PLANTS AND THEIR ROOTS, STICKS, AND OTHER EXTRANEOUS MATTER. SPREAD TOPSOIL MIXTURE TO MINIMUM DEPTH OF 3 INCHES THROUGHOUT ALL AREAS AND 6 INCHES IN ALL SHRUB AND GROUNDCOVER BEDS. REMOVE ALL ROCKS AND OTHER OBJECTS OVER 1 INCH IN DIAMETER.
- H. SMOOTH ALL PREPARED TOPSOIL TO 4 INCHES BELOW TOP OF SURROUNDING PAVEMENT EDGES.
- I. FINISH GRADE ALL PREPARED TOPSOIL AREAS TO A SMOOTH, EVEN SURFACE ASSURING POSITIVE DRAINAGE AWAY FROM THE STRUCTURES AND AND ELIMINATE ANY LOW AREAS WHICH MAY COLLECT WATER.
- SMOOTH TOPSOIL MIXTURE TO 6 INCHES BELOW GRADE IN AREAS TO BE SODDED.
- K. TOPSOIL SHALL NOT BE EXTREMELY ACIDIC OR ALKALINE, NOR CONTAIN TOXIC SUBSTANCES WHICH MAY BE HARMFUL TO PLANT GROWTH. THE PH SHALL BE IN THE RANGE OF 5.5 TO 6.5. IF NECESSARY, THE CONTRACTOR TOPSOIL PH SHALL APPLY THE APPROPRIATE SOIL AMENDMENTS ADJUSTING SOIL PH TO ASSURE A PH RANGE OF 5.5 TO 6.5.
- 20. GUYING / STAKING PRACTICES SHALL NOT PERMIT NAILS, SCREWS, WIRES ETC., TO PENETRATE OUTER SURFACE OF TREE OR PALM. TREES OR PALMS REJECTED DUE TO THIS PRACTICE SHALL BE REPLACED WITH INSPECTOR ON SITE.
- 21. CONTRACTOR SHALL MULCH ALL PLANT MATERIAL THROUGHOUT AND
- 22. THE CONTRACTOR IS RESPONSIBLE FOR MAINTAINING, IN FULL ALL PLANTING AREAS (INCLUDING WATERING, SPRAYING, MULCHING, MOWING, FERTILIZING, ETC.) UNTIL THE JOB IS ACCEPTED, IN FULL, AT THE END OF THE ESTABLISHMENT PERIOD BY THE OWNER AND LANDSCAPE ARCHITECT.

COMPLETELY TO A 3 INCHE DEPTH WITH CLEAN, WEED FREE WOOD CHIPS.

- 23. CONTRACTOR TO GUARANTEE PLANT MATERIAL FOR A 1 (ONE) YEAR ESTABLISHMENT PERIOD FOLLOWING DATE OF SUBSTANTIAL COMPLETION.
- 24. CONTRACTOR TO REQUEST INSPECTION OF PROJECT IN WRITING. IF ALL WORK IS SATISFACTORY AND COMPLETE IN ACCORDANCE WITH CONDITIONS OF CONTRACT DOCUMENTS, THEN THE OWNER AND LANDSCAPE ARCHITECT SHALL DECLARE SUBSTANTIALLY COMPLETE. SUBSTANTIAL COMPLETION CONSTITUTES THE BEGINNING OF THE GUARANTEE PERIOD.
- 25. REMOVAL OF ALL STAKING AND GUYING OF TREES AND PALMS AFTER TIME OF INSTALLATION SHALL BE THE RESPONSIBILITY OF THE OWNER.
- 26. ALL PLANT MATERIAL SHALL BE OF FLORIDA NO. 1 OR BETTER QUALITY AT TIME OF INSTALLATION AND SHALL BE MAINTAINED IN THIS SAME CONDITION UNTIL FINAL ACCEPTANCE. DECLINE IN CONDITION OF PLANT MATERIAL DURING THE MAINTENANCE PERIOD SHALL BE GROUNDS FOR REJECTION AND REPLACEMENT.


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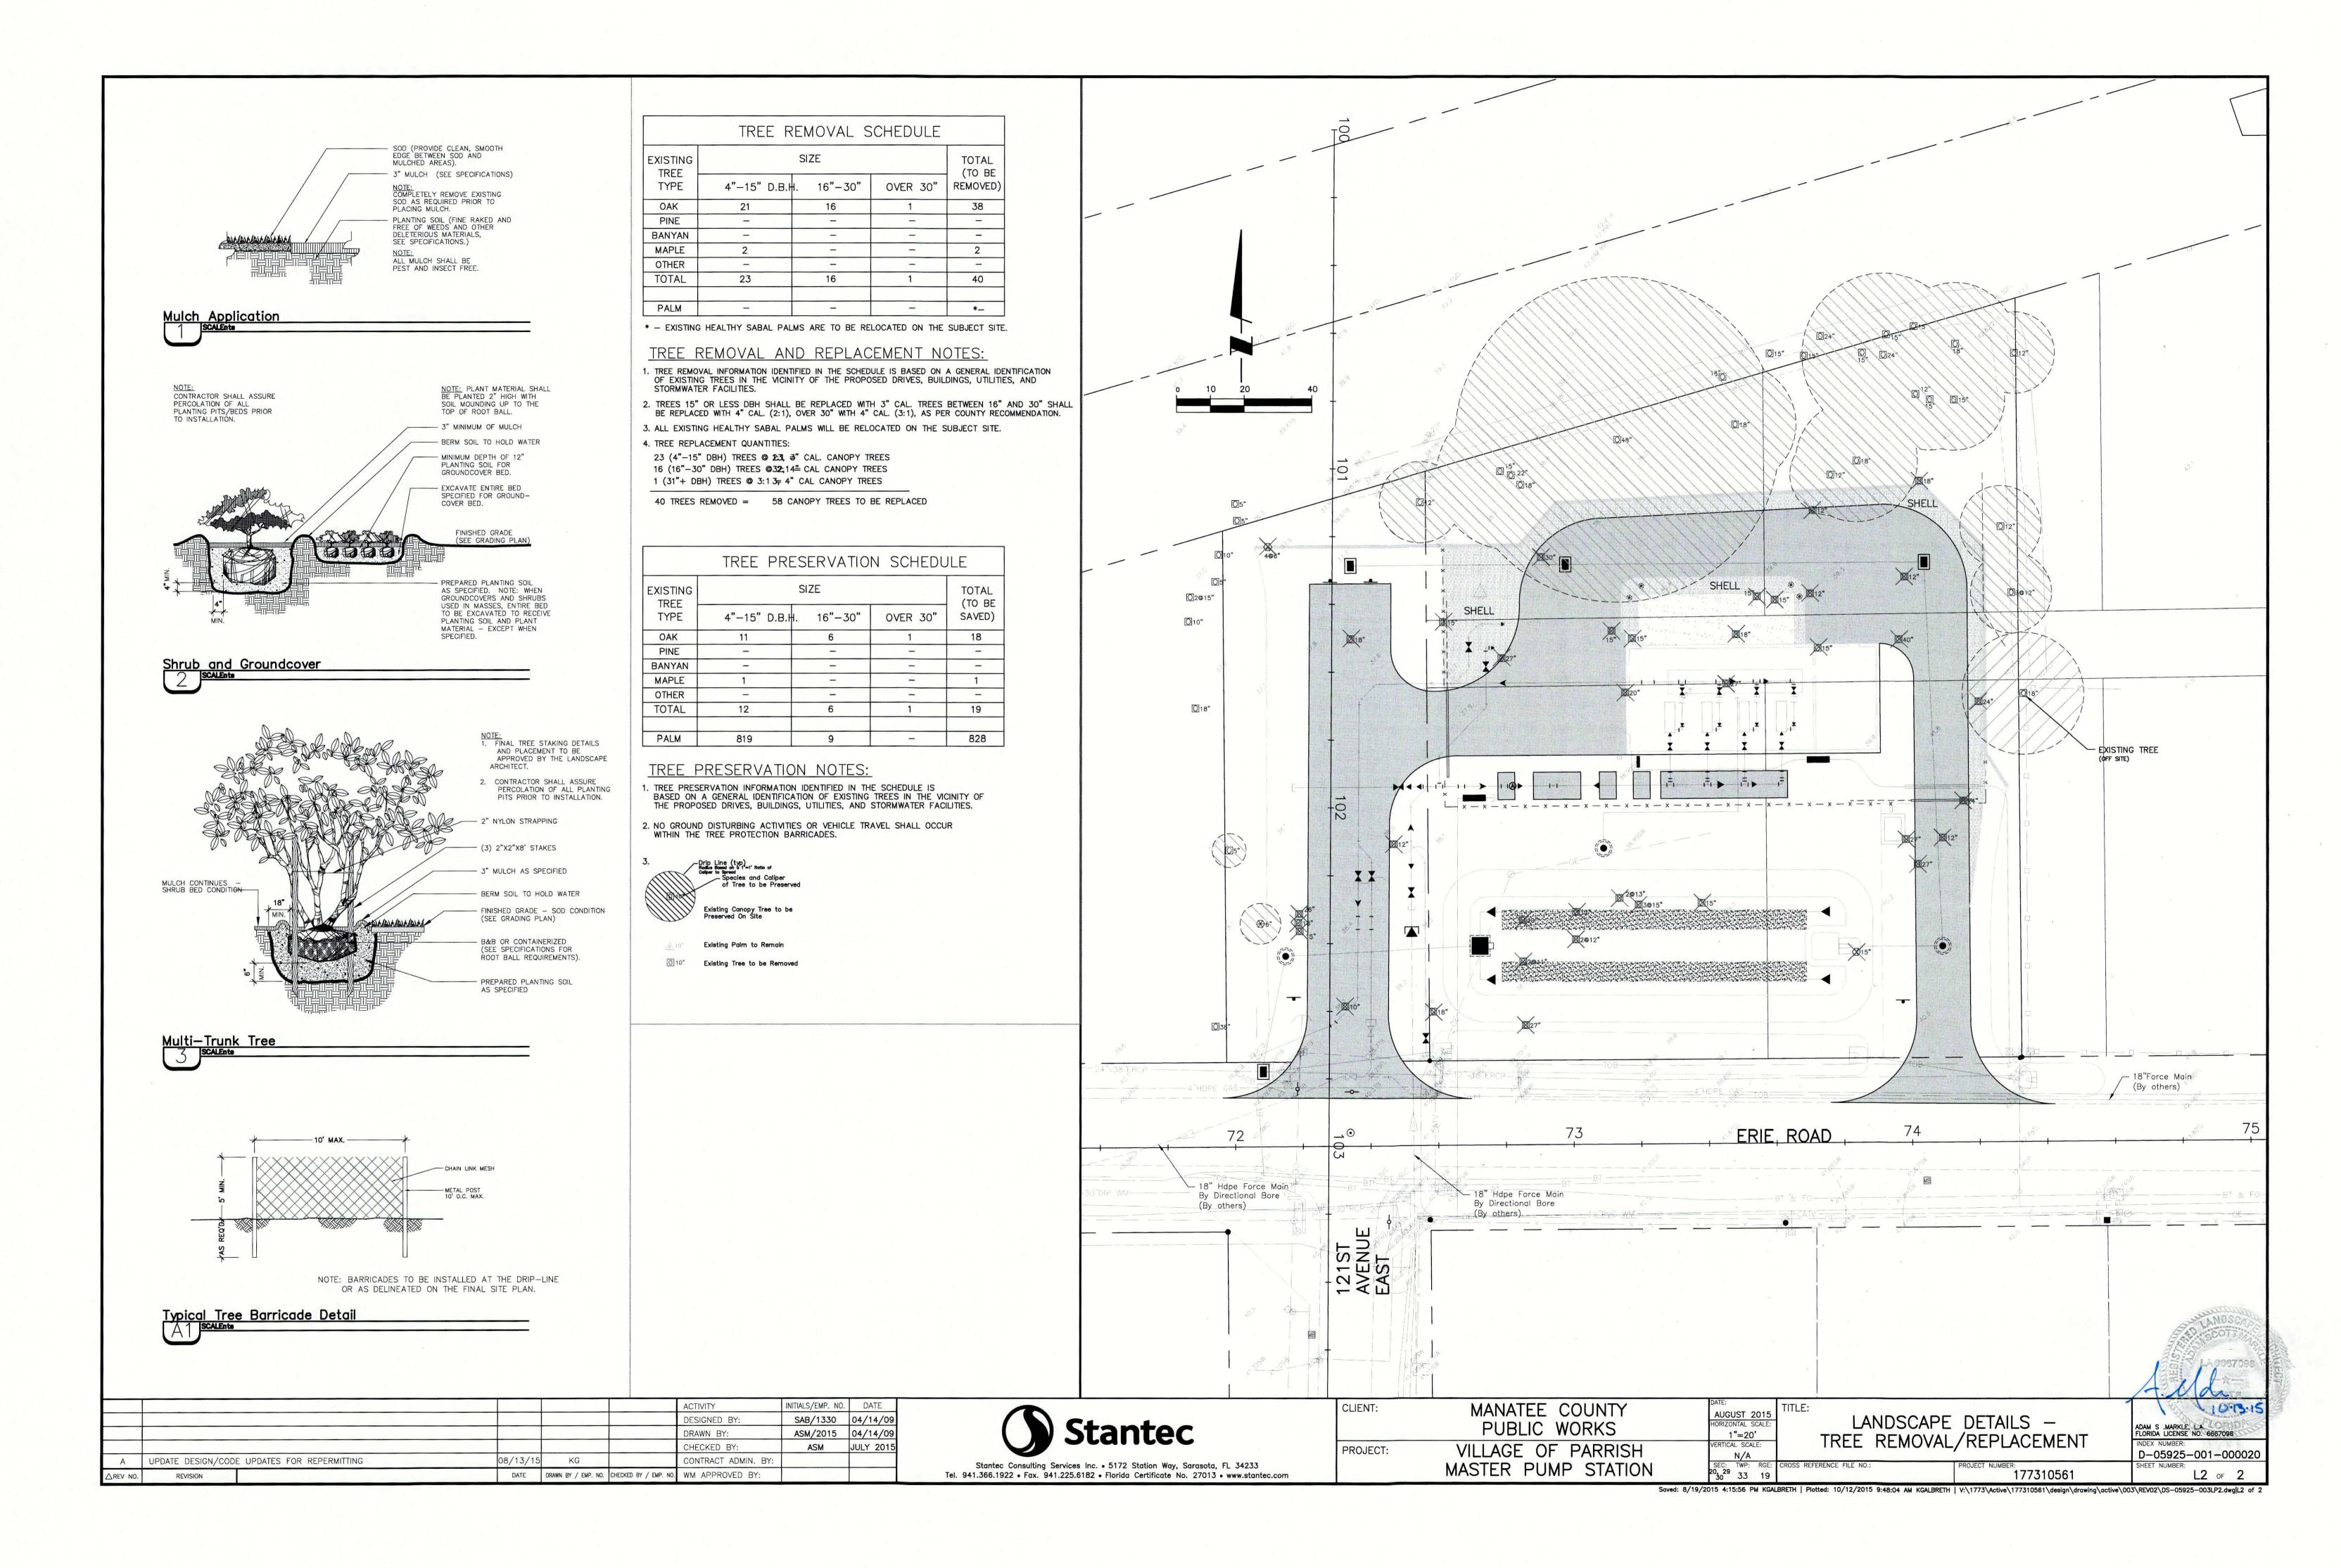
CHECKED BY:

CONTRACT ADMIN. BY

DRAWN BY:

DATE DRAWN BY / EMP. NO. CHECKED BY / EMP. NO. WM APPROVED BY:



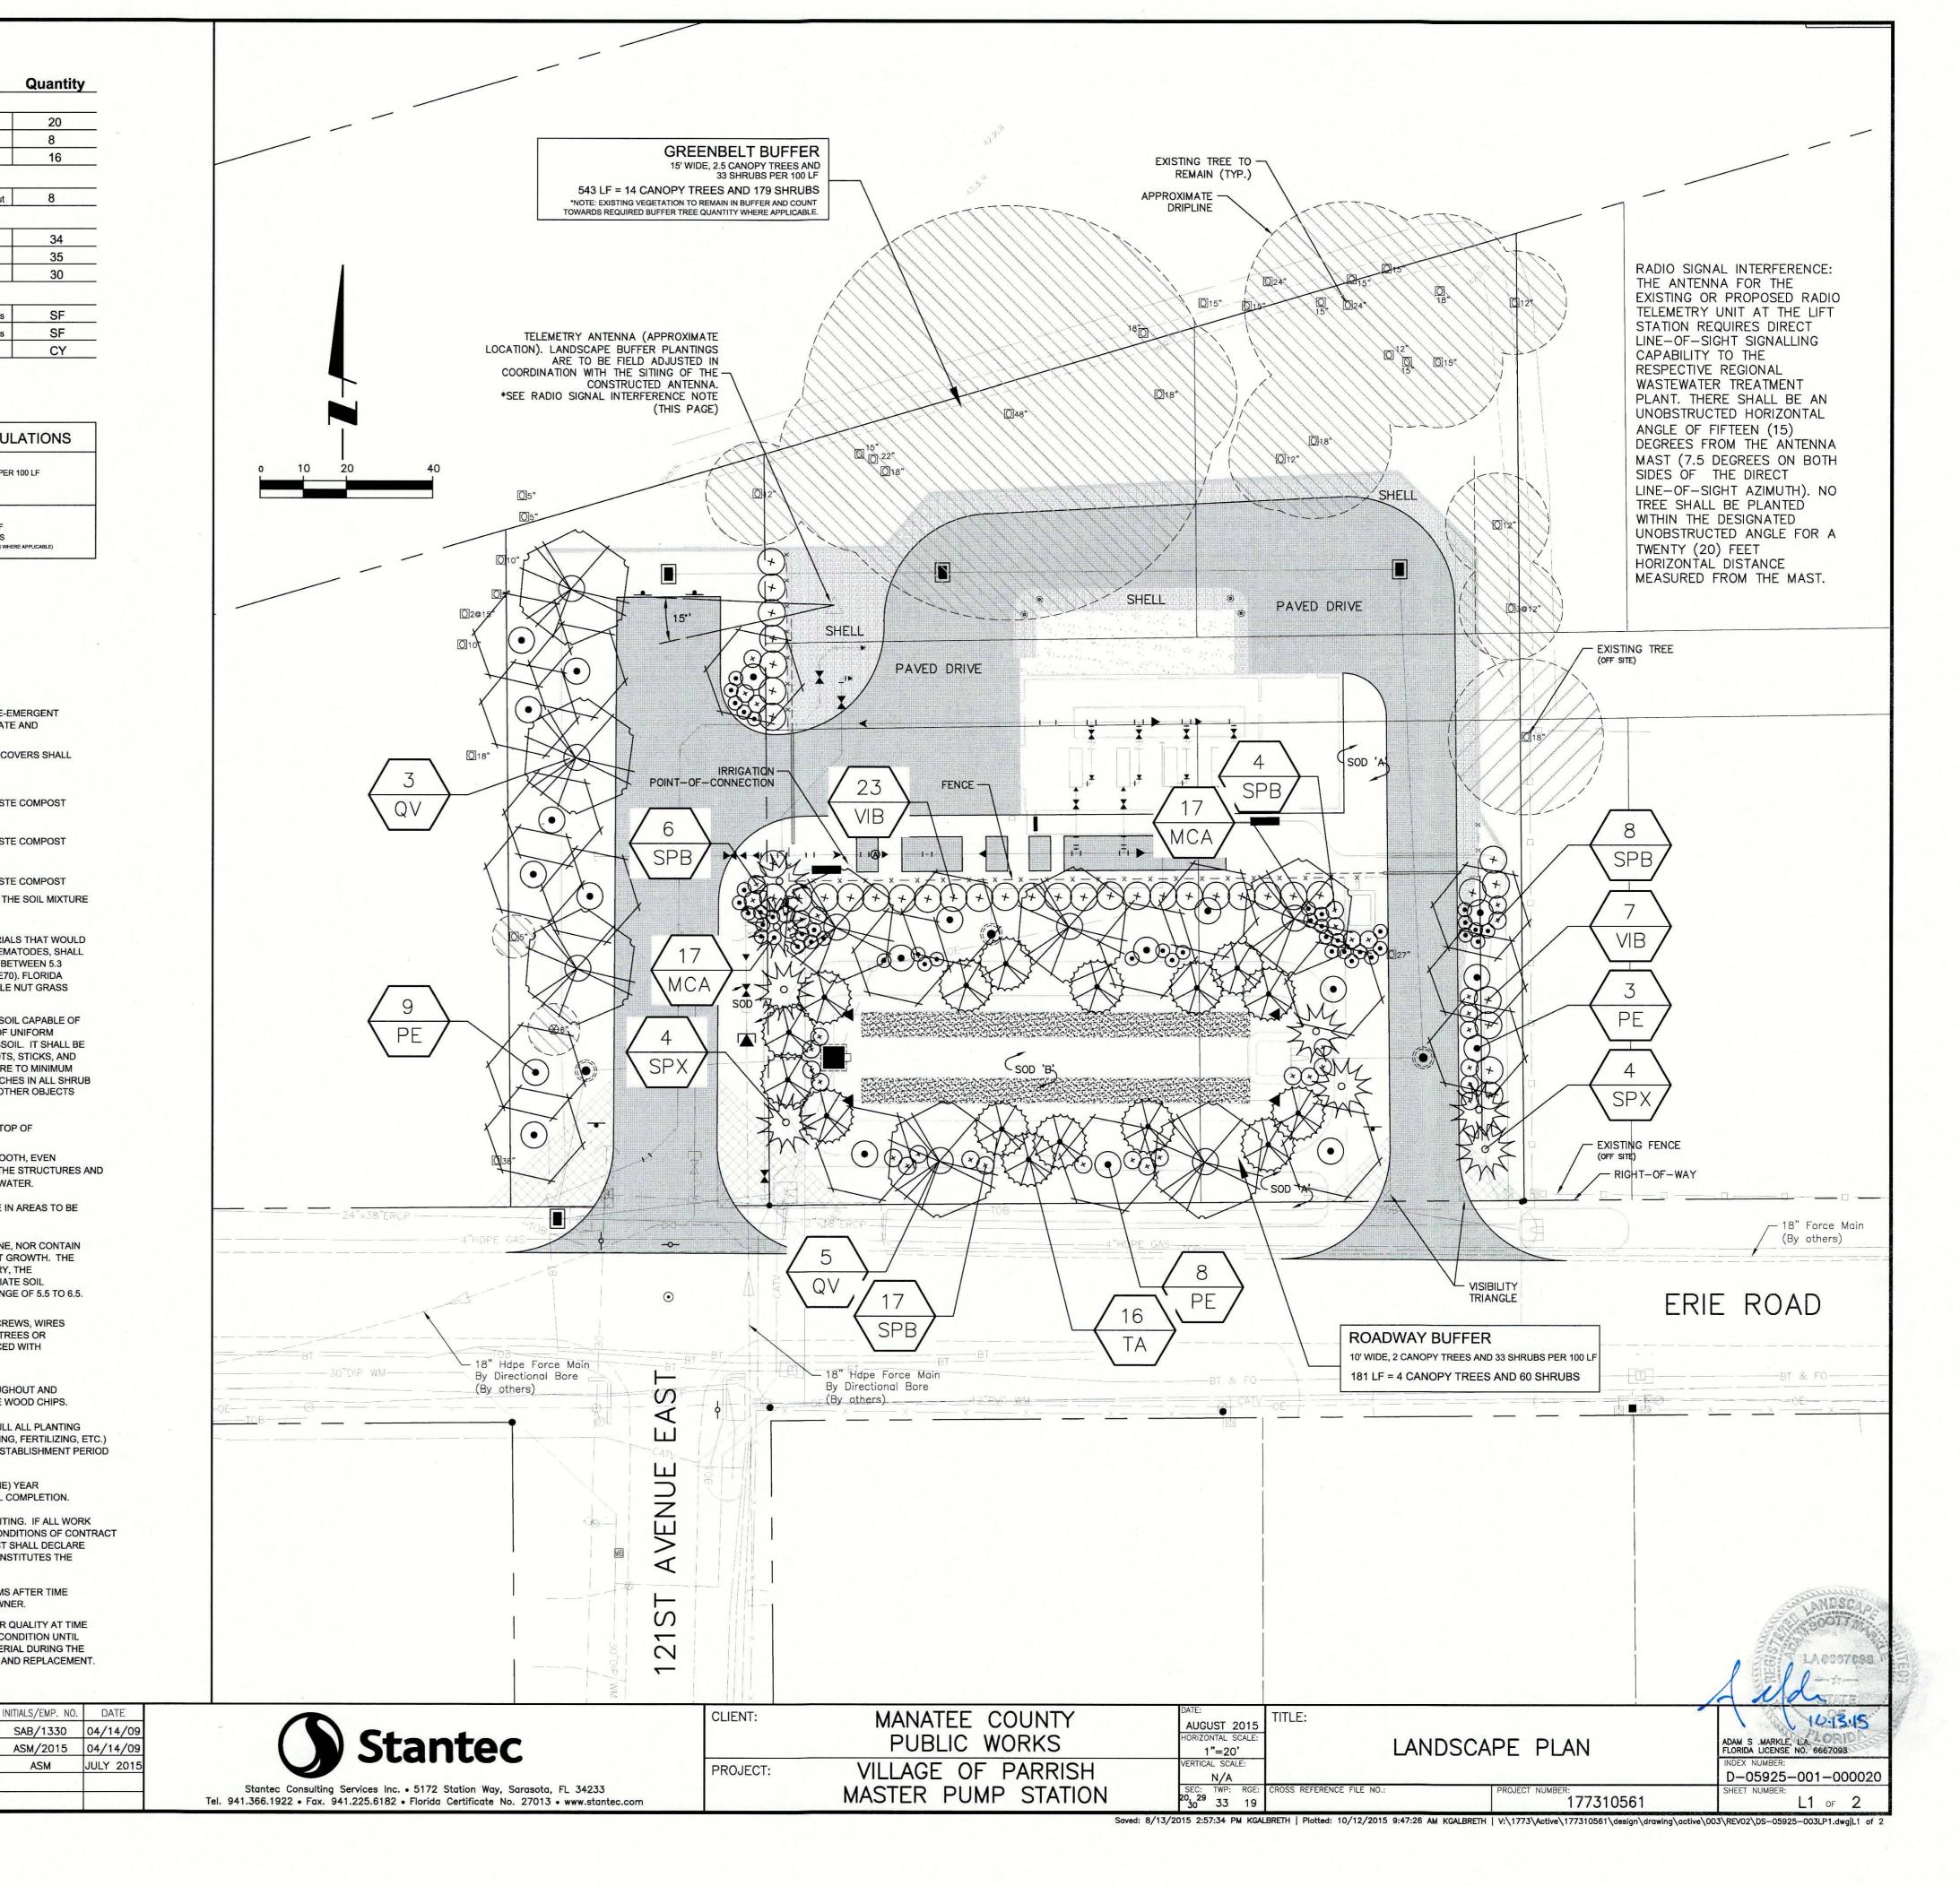

## IRRIGATION NOTES

- 1) THE HEAD LAYOUT HAS BEEN DESIGNED TO PROVIDE 100% COVERAGE. ANY CHANGES MADE IN THE HEAD LAYOUT DUE TO FIELD CONDITIONS SHALL BE IN ACCORDANCE WITH THESE
- 2) SET SPRAY HEADS 3" AND ROTORS 6" IN FROM BACK OF CURB OR 12" IF PAVEMENT HAS NO CURB.
- 3) VERIFY LOCATIONS OF ALL UNDERGROUND UTILITIES PRIOR TO INSTALLATION OF IRRIGATION SYSTEM. MAINLINE SHALL NOT BE LOCATED WITHOUT PRIOR APPROVAL OF THE PROJECT MANAGER AND THE LANDSCAPE ARCHITECT. ALL UTILITIES AND STRUCTURES MAY NOT BE SHOWN ON THESE PLANS-CONTRACTOR SHALL VERIFY.
- 4) ALL PRESSURE MAINLINES UNDER ASPHALT PAVEMENT SHALL BE WITHIN SLEEVES AS NOTED. WHERE ELECTRIC VALVE CONTROL LINES PASS THROUGH A SLEEVE WITH OTHER MAIN OR LATERAL LINES THEY SHALL BE CONTAINED WITHIN A SEPARATE, SMALLER CONDUIT.
- 5) MAINLINE AND VALVES ARE SHOWN IN SCHEMATIC FORM. LOCATE AS NOTED ON PLANS.
- 6) LOCATE ALL VALVES A MINIMUM OF 24" FROM BACK OF CURB OR EDGE OF PAVEMENT, UNLESS NOTED OTHERWISE.
- 7) ALL SLEEVES UTILIZED BY THE IRRIGATION CONTRACTOR, WHETHER INSTALLED BY HIM OR NOT, SHALL BE LOCATED ON THE "AS-BUILT" DRAWINGS. THE DEPTH BELOW FINISH GRADE, TO THE NEAREST FOOT OF EACH END OF EACH SLEEVE SHALL BE NOTED AT EACH SLEEVE LOCATION ON THE "AS-BUILT" DRAWINGS.
- 8) ALL UNSIZED PIPE SHALL BE 3/4" UNLESS OTHERWISE NOTED.
- ALL VALVES SHALL BE INSTALLED IN AN AMETEK PLASTIC VALVE BOX WITH LOCKING LID.
- 10) IRRIGATION CONTRACTOR SHALL SECURE ANY AND ALL NECESSARY PERMITS FOR THE WORK PRIOR TO COMMENCEMENT OF HIS OPERATIONS ON-SITE. COPIES OF THE PERMITS SHALL BE SENT TO THE OWNER/GENERAL CONTRACTOR. WORK IN THE R.O.W. SHALL CONFORM TO THE STANDARDS AND SPECIFICATIONS OF LOCAL AND/OR STATE HIGHWAY JURISDICTION.
- 11) VERIFY POINT OF CONNECTION AND IRRIGATION CONTROLLER LOCATION AT PROJECT SITE WITH OWNER.
- 12) ELECTRIC SERVICE TO THE IRRIGATION CONTROLLER SHALL BE PROVIDED BY THE GENERAL CONTRACTOR.
- 13) ALL 24 VAC WIRING SHALL BE OF DIRECT BURIAL COPPER WIRE AS FOLLOWS: CONTROL WIRES - #14

COMMON WIRES - #14

14) INSTALLATION OF WORK SHALL BE COORDINATED WITH OTHER CONTRACTORS IN SUCH A MANNER AS TO ALLOW FOR A SPEEDY AND ORDERLY COMPLETION OF ALL WORK ON THE SITE.

### IRRIGATION LEGEND

RAIN BIRD 1806 SERIES SPRINKLERS WITH RAINBIRD MPR SPRAY NOZZLES UNLESS NOTED OTHERWISE

□ 15-Q 30° TRAJECTORY

0	15-T	30° TRAJECTORY
	15-H	30° TRAJECTORY
C	15-TQ	30° TRAJECTORY
0	15-F	30° TRAJECTORY
•	12-Q	30° TRAJECTORY
•	12-T	30° TRAJECTORY
	12-H	30° TRAJECTORY
•	12-TQ	30° TRAJECTORY
•	12-F	30° TRAJECTORY
•	10-Q	15° TRAJECTORY
•	10-T	15° TRAJECTORY
	10-H	15° TRAJECTORY
•	10-F	15° TRAJECTORY
Þ	8-Q	10° TRAJECTORY
Ф	8-H	10° TRAJECTORY
	15EST	
	15SST	*
	15CCT	

CONTROLLER SHALL BE A HUNTER PC-600i CONTROLLER.

HUNTER MINI-CLIK RAIN SENOR. HUNTER ICV SERIES ELECTRIC CONTROL VALVE

RAIN BIRD 1400 SERIES PC BUBBLER

(SEE BUBBLER DETAIL FOR MODEL NUMBERS)

RAIN BIRD XPCN QTR (7.4 GPH) PRESSURE COMPENSATING SPRAY NOZZLE

RAIN BIRD XPCN HLF (13.7 GPH) PRESSURE COMPENSATING SPRAY NOZZLE

RAIN BIRD XPCN FUL (27.3 GPH) PRESSURE COMPENSATING SPRAY NOZZLE


CLASS 200 PVC MAINLINE CLASS 200 PVC LATERAL LINE


SCHEDULE 40 PVC SLEEVE

## CONTROLLER SCHEDULE


ZONE	GPM	VALVE SIZE	TYPE
#1	27.8	1 1/2"	SPRAY
#2	22.9	1"	LOW VOLUME SPRAY
#3	30.4	1 1/2"	SPRAY
#4	35.9	1 1/2"	SPRAY
#5	28.5	1 1/2"	SPRAY
#6	SPARE		

IRRIGATION DESIGN BASE: 36 GPM @ 55 PSI.

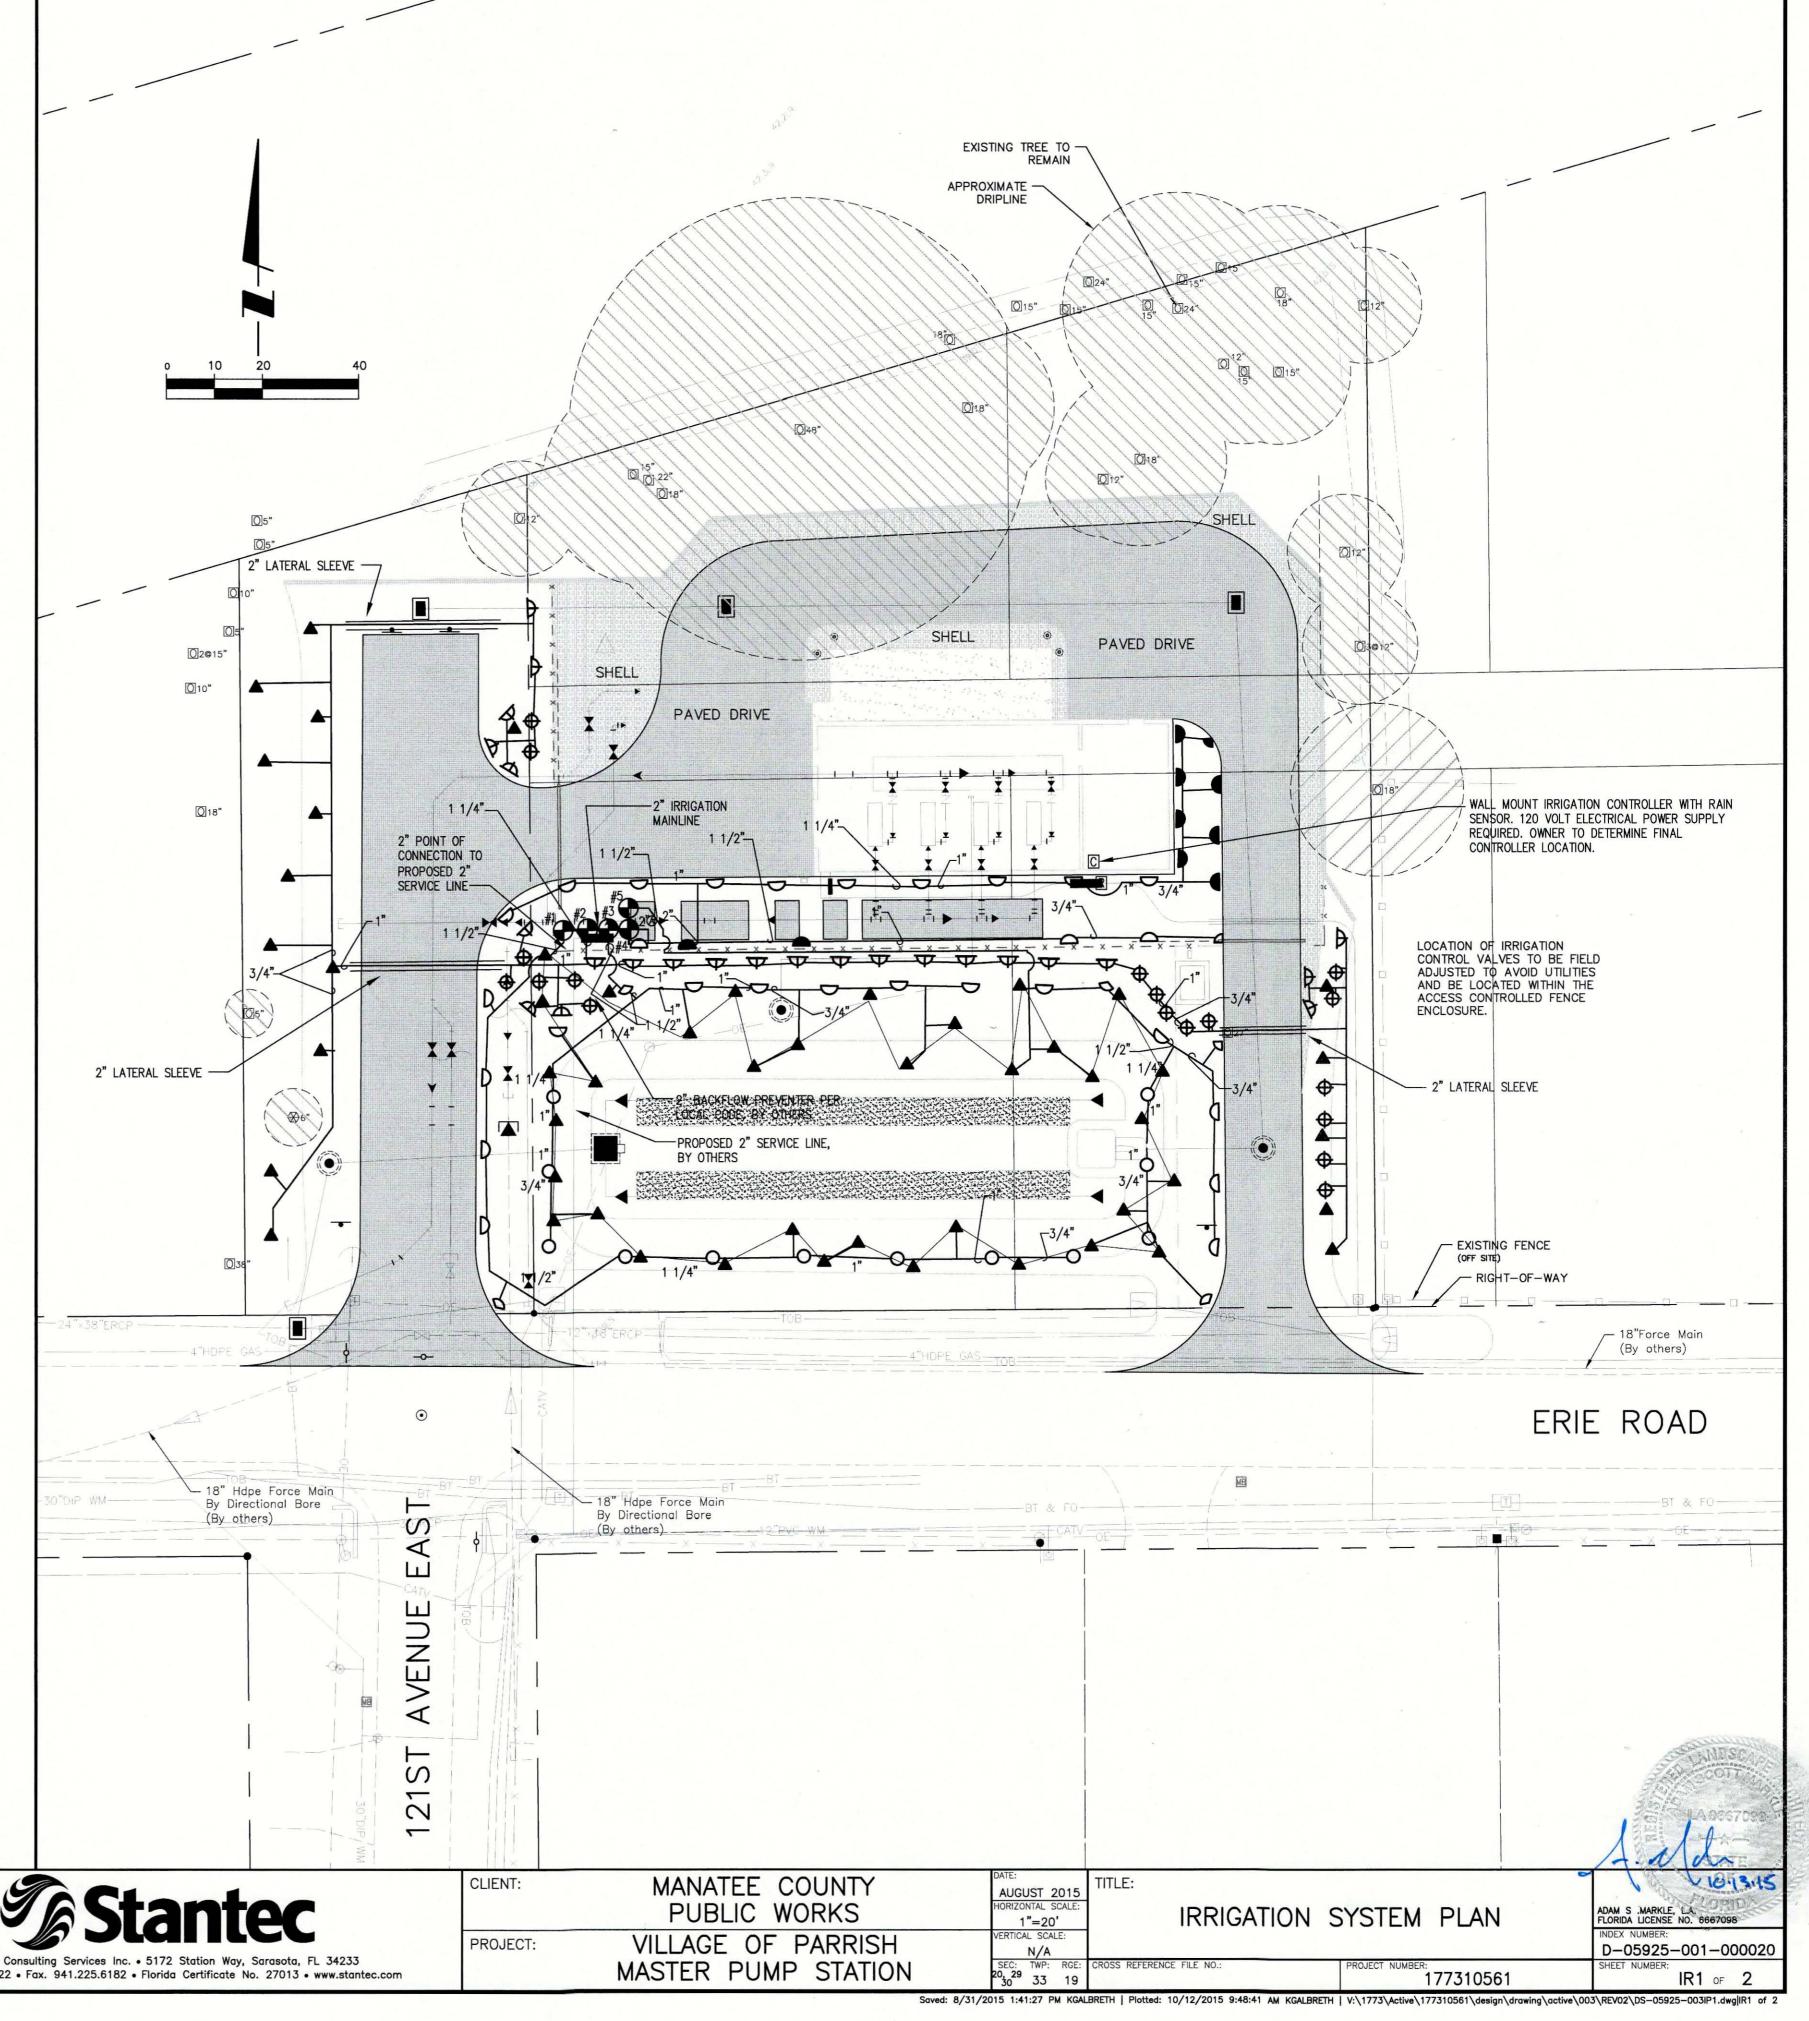

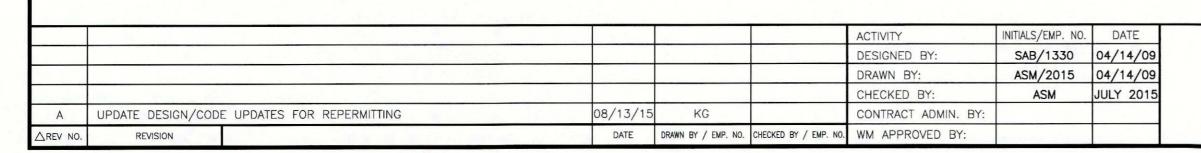

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						ACTIVITY	INITIALS/EMP. NO.	DATE
						DESIGNED BY:	SAB/1330	04/14/09
						DRAWN BY:	ASM/2015	04/14/09
						CHECKED BY:	ASM	JULY 201
Α	UPDATE DESIGN/CO	DDE UPDATES FOR REPERMITTING	08/13/15	KG		CONTRACT ADMIN. BY:		
△REV NO.	REVISION		DATE	DRAWN BY / EMP. NO.	CHECKED BY / EMP. NO.	WM APPROVED BY:		

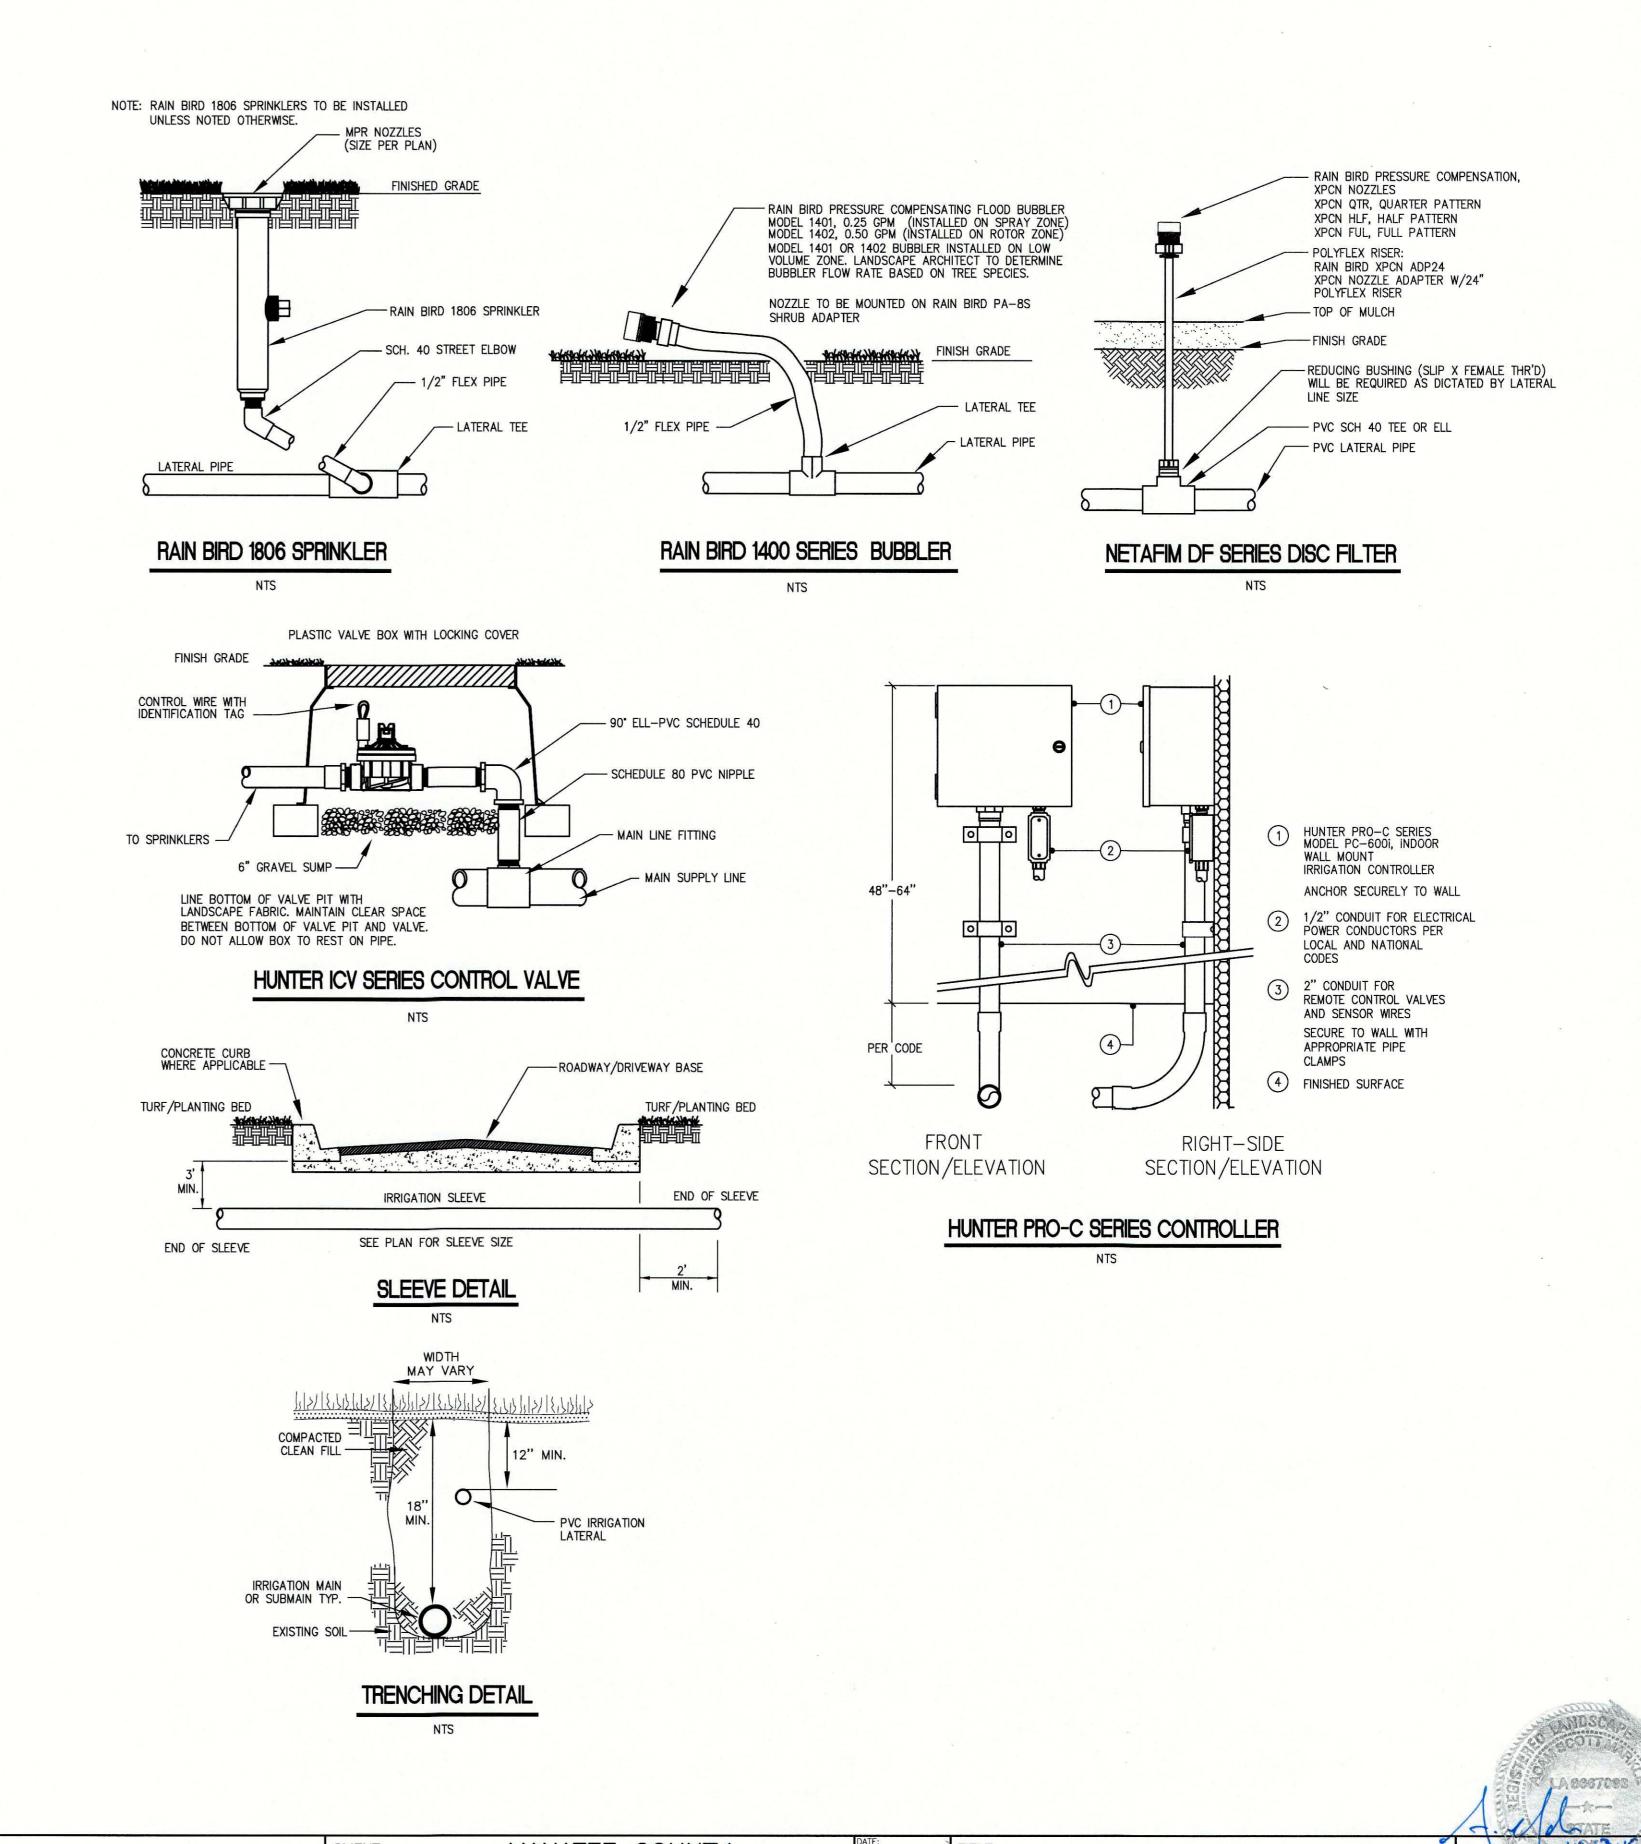

AUGUST 2015 HORIZONTAL SCALE: 1"=20'	IRRIGATION SYSTEM DETAILS	3
VERTICAL SCALE:  N/A		
SEC: TWP: RGE: 20, 29 33 19	CROSS REFERENCE FILE NO.: PROJECT NUMBER: 177310561	

D-05925-001-000020 IR2 of 2 Saved: 8/31/2015 1:41:27 PM KGALBRETH | Plotted: 10/12/2015 9:49:17 AM KGALBRETH | V:\1773\Active\177310561\design\drawing\active\003\REV02\DS-05925-003IP1.dwg|IR2 of 2

EXT

FEC

INV

- POUND

- LINEAR FOOT

PLATE


ARCHITECTURE / INTERIOR ABBREVIATIONS 7

SQUARE FOOT (FEET)


STRUCTURAL TEE

FINISHED WOOD

TILT-UP WALL

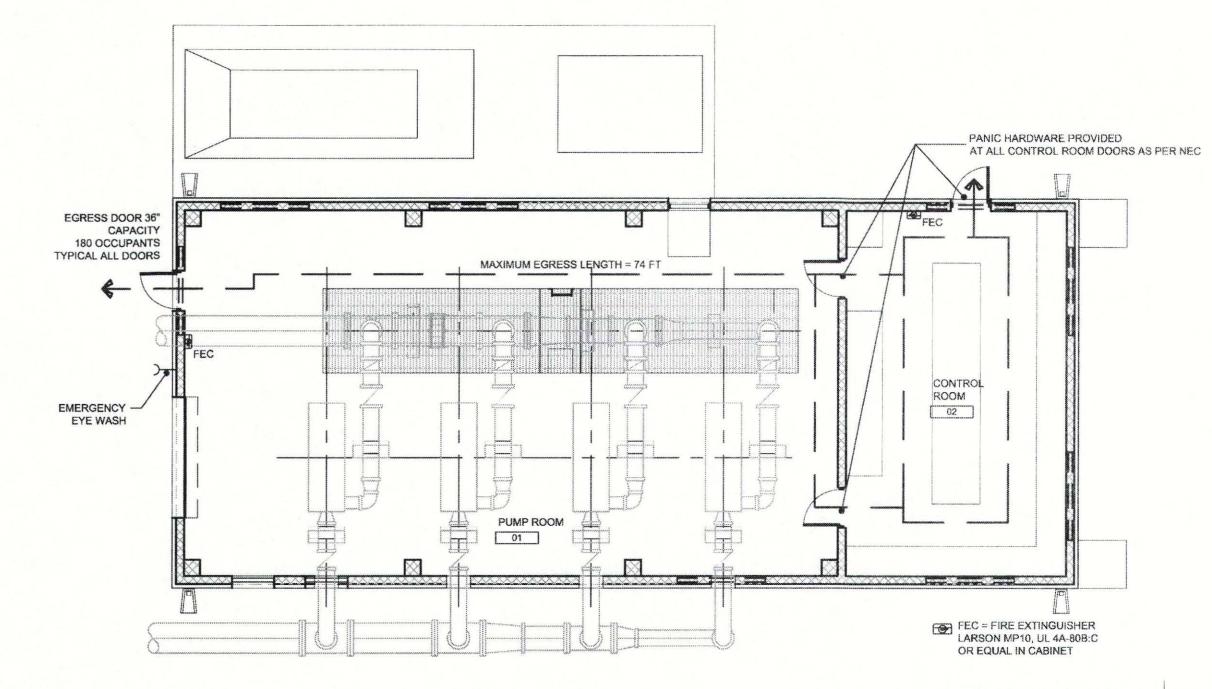

LIFE SAFETY PLAN 2

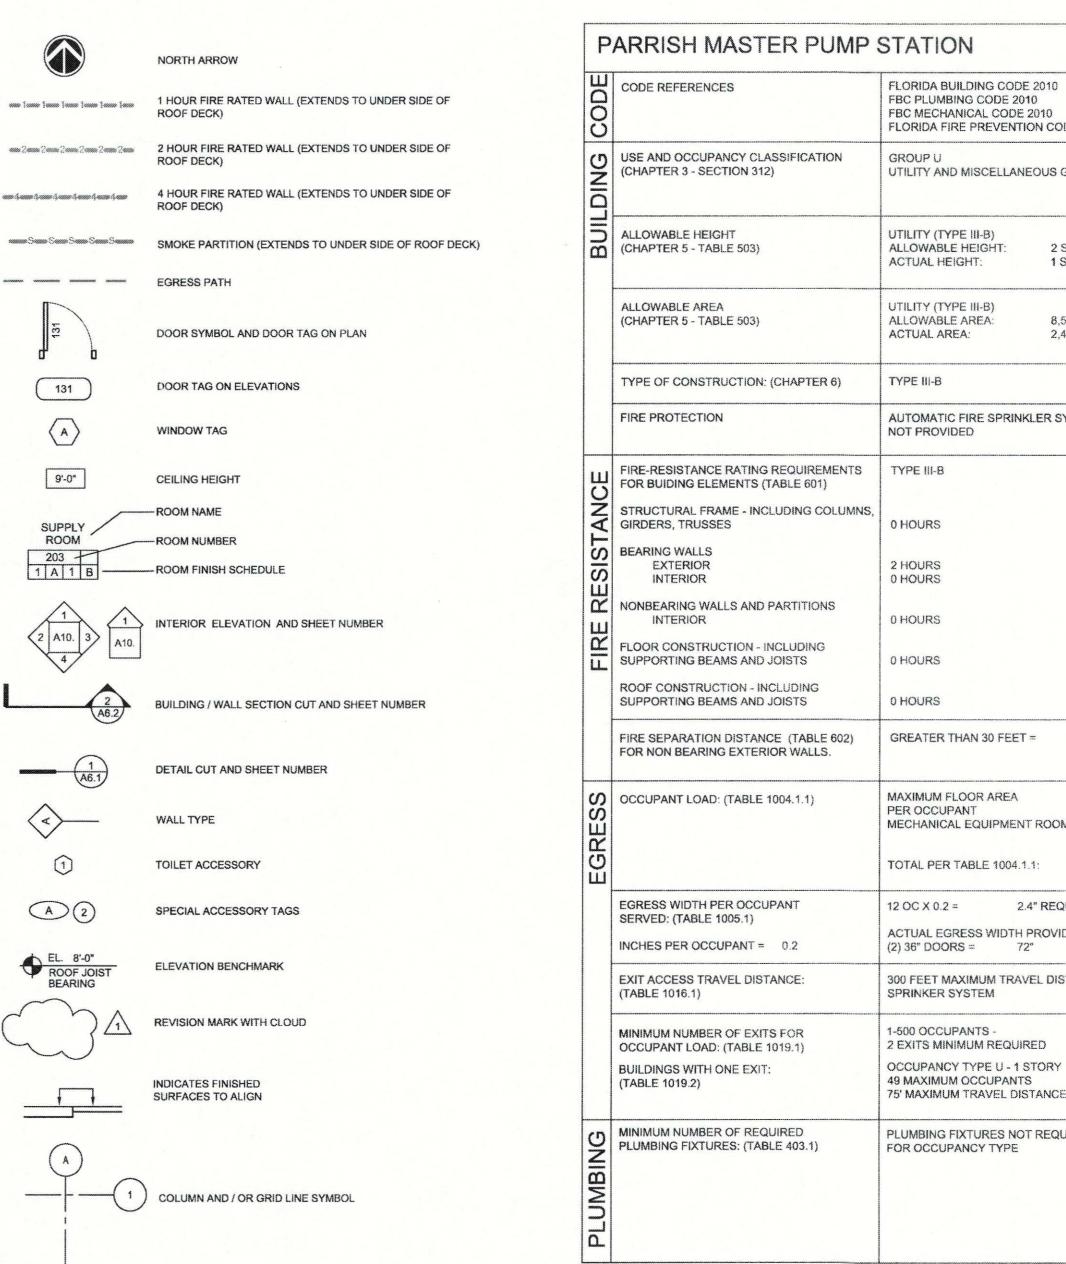

SYMBOLS 3

GYPSUM WALLBOARD

PREPARED SUBGRADE

RIGID INSULATION

WOOD BLOCKING

MATERIAL INDICATIONS 4

SAND, GROUT, MORTAR

IRON, STEEL

PLASTER

FBC MECHANICAL CODE 2010 FLORIDA FIRE PREVENTION CODE 2010 UTILITY AND MISCELLANEOUS GROUP U UTILITY (TYPE III-B) ALLOWABLE HEIGHT: 2 STORIES ACTUAL HEIGHT: 1 STORY UTILITY (TYPE III-B) 2,436 S.F. AUTOMATIC FIRE SPRINKLER SYSTEM GREATER THAN 30 FEET = MAXIMUM FLOOR AREA MECHANICAL EQUIPMENT ROOMS 200 GROSS TOTAL PER TABLE 1004.1.1: 2,436/200 = 12 OCCUPANTS 2.4" REQUIRED ACTUAL EGRESS WIDTH PROVIDED (2) 36" DOORS = 72" 300 FEET MAXIMUM TRAVEL DISTANCE WITHOUT SPRINKER SYSTEM 1-500 OCCUPANTS -2 EXITS MINIMUM REQUIRED OCCUPANCY TYPE U - 1 STORY 49 MAXIMUM OCCUPANTS 75' MAXIMUM TRAVEL DISTANCE PLUMBING FIXTURES NOT REQUIRED FOR OCCUPANCY TYPE

CODE ANALYSIS

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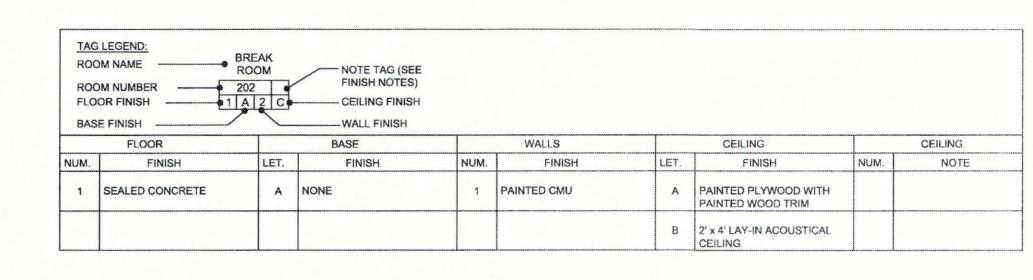
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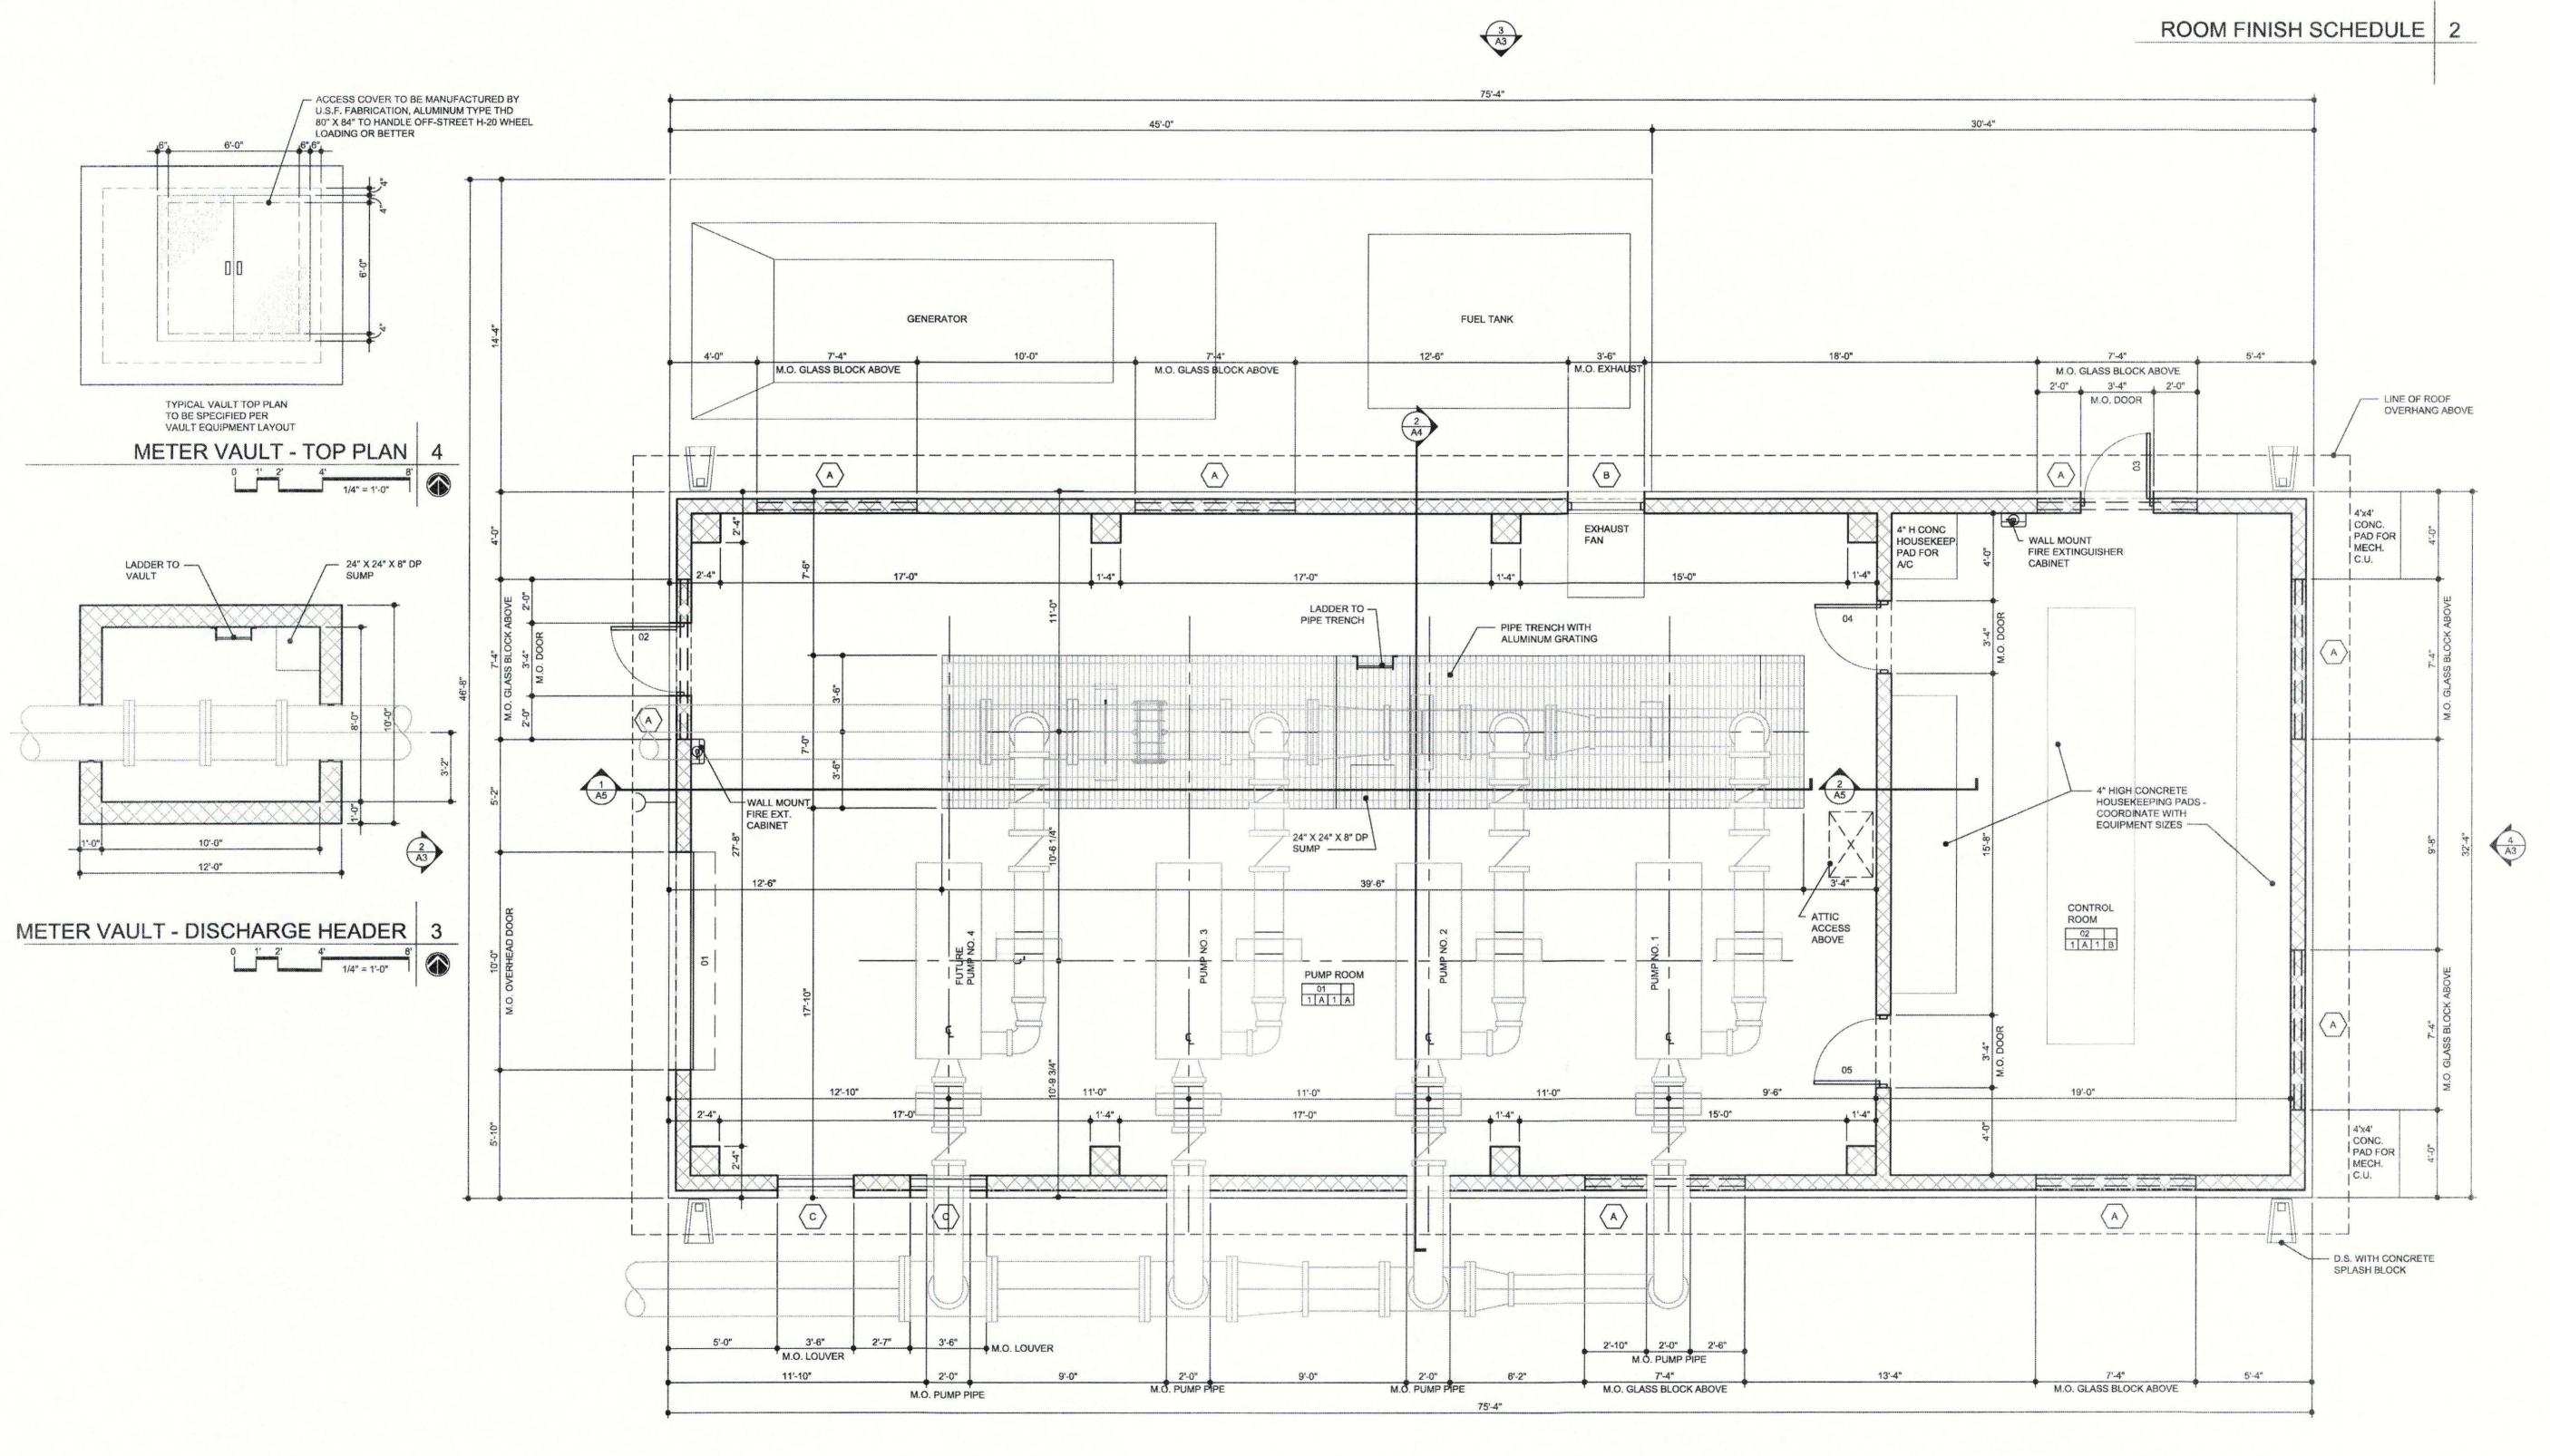
Revisions:

Michael P. Bryant AR 0010462

"To the best of the Architect's or Engineer's knowledge, the plans and specifications comply with the applicable minimum building codes and applicable fire safety standards as determined by local authority in accordance with Chapter 553 and 663 of Florida Statutes."

> CONSTRUCTION DRAWINGS





NOT USED 2

1 3

MASTER PUMP STATION FLOOR PLAN 1

FAWLEY BRYANT ARCHITECTS, INC.
5391 LAKEWOOD RANCH BLVD. NORTH, SUITE 300
SARASOTA, FL. 34240
BH 941 343 4070
EX 941 749 6747

FAWLEY BRYANT AI 5391 LAKEWOOD R. SARASOTA, FL. 3424


PARRISH MASTER PUMP STATIC

Drawn By

Checked By Date

Revisions:

AUG 2015

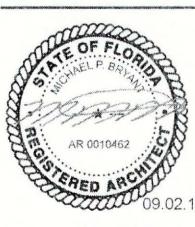

Michael P. Bryant
AR 0010462

"To the best of the Architect's or
Engineer's knowledge, the plans
and specifications comply with the

Engineer's knowledge, the plans and specifications comply with the applicable minimum building codes and applicable fire safety standards as determined by local authority in accordance with Chapter 553 and 663 of Florida Statutes."

CONSTRUCTION DRAWINGS

A-2


AUG 2015


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Engineer's knowledge, the plans
and specifications comply with the
applicable minimum building codes
and applicable fire safety standards
as determined by local authority in
accordance with Chapter 553 and

CONSTRUCTION DRAWINGS

A-3



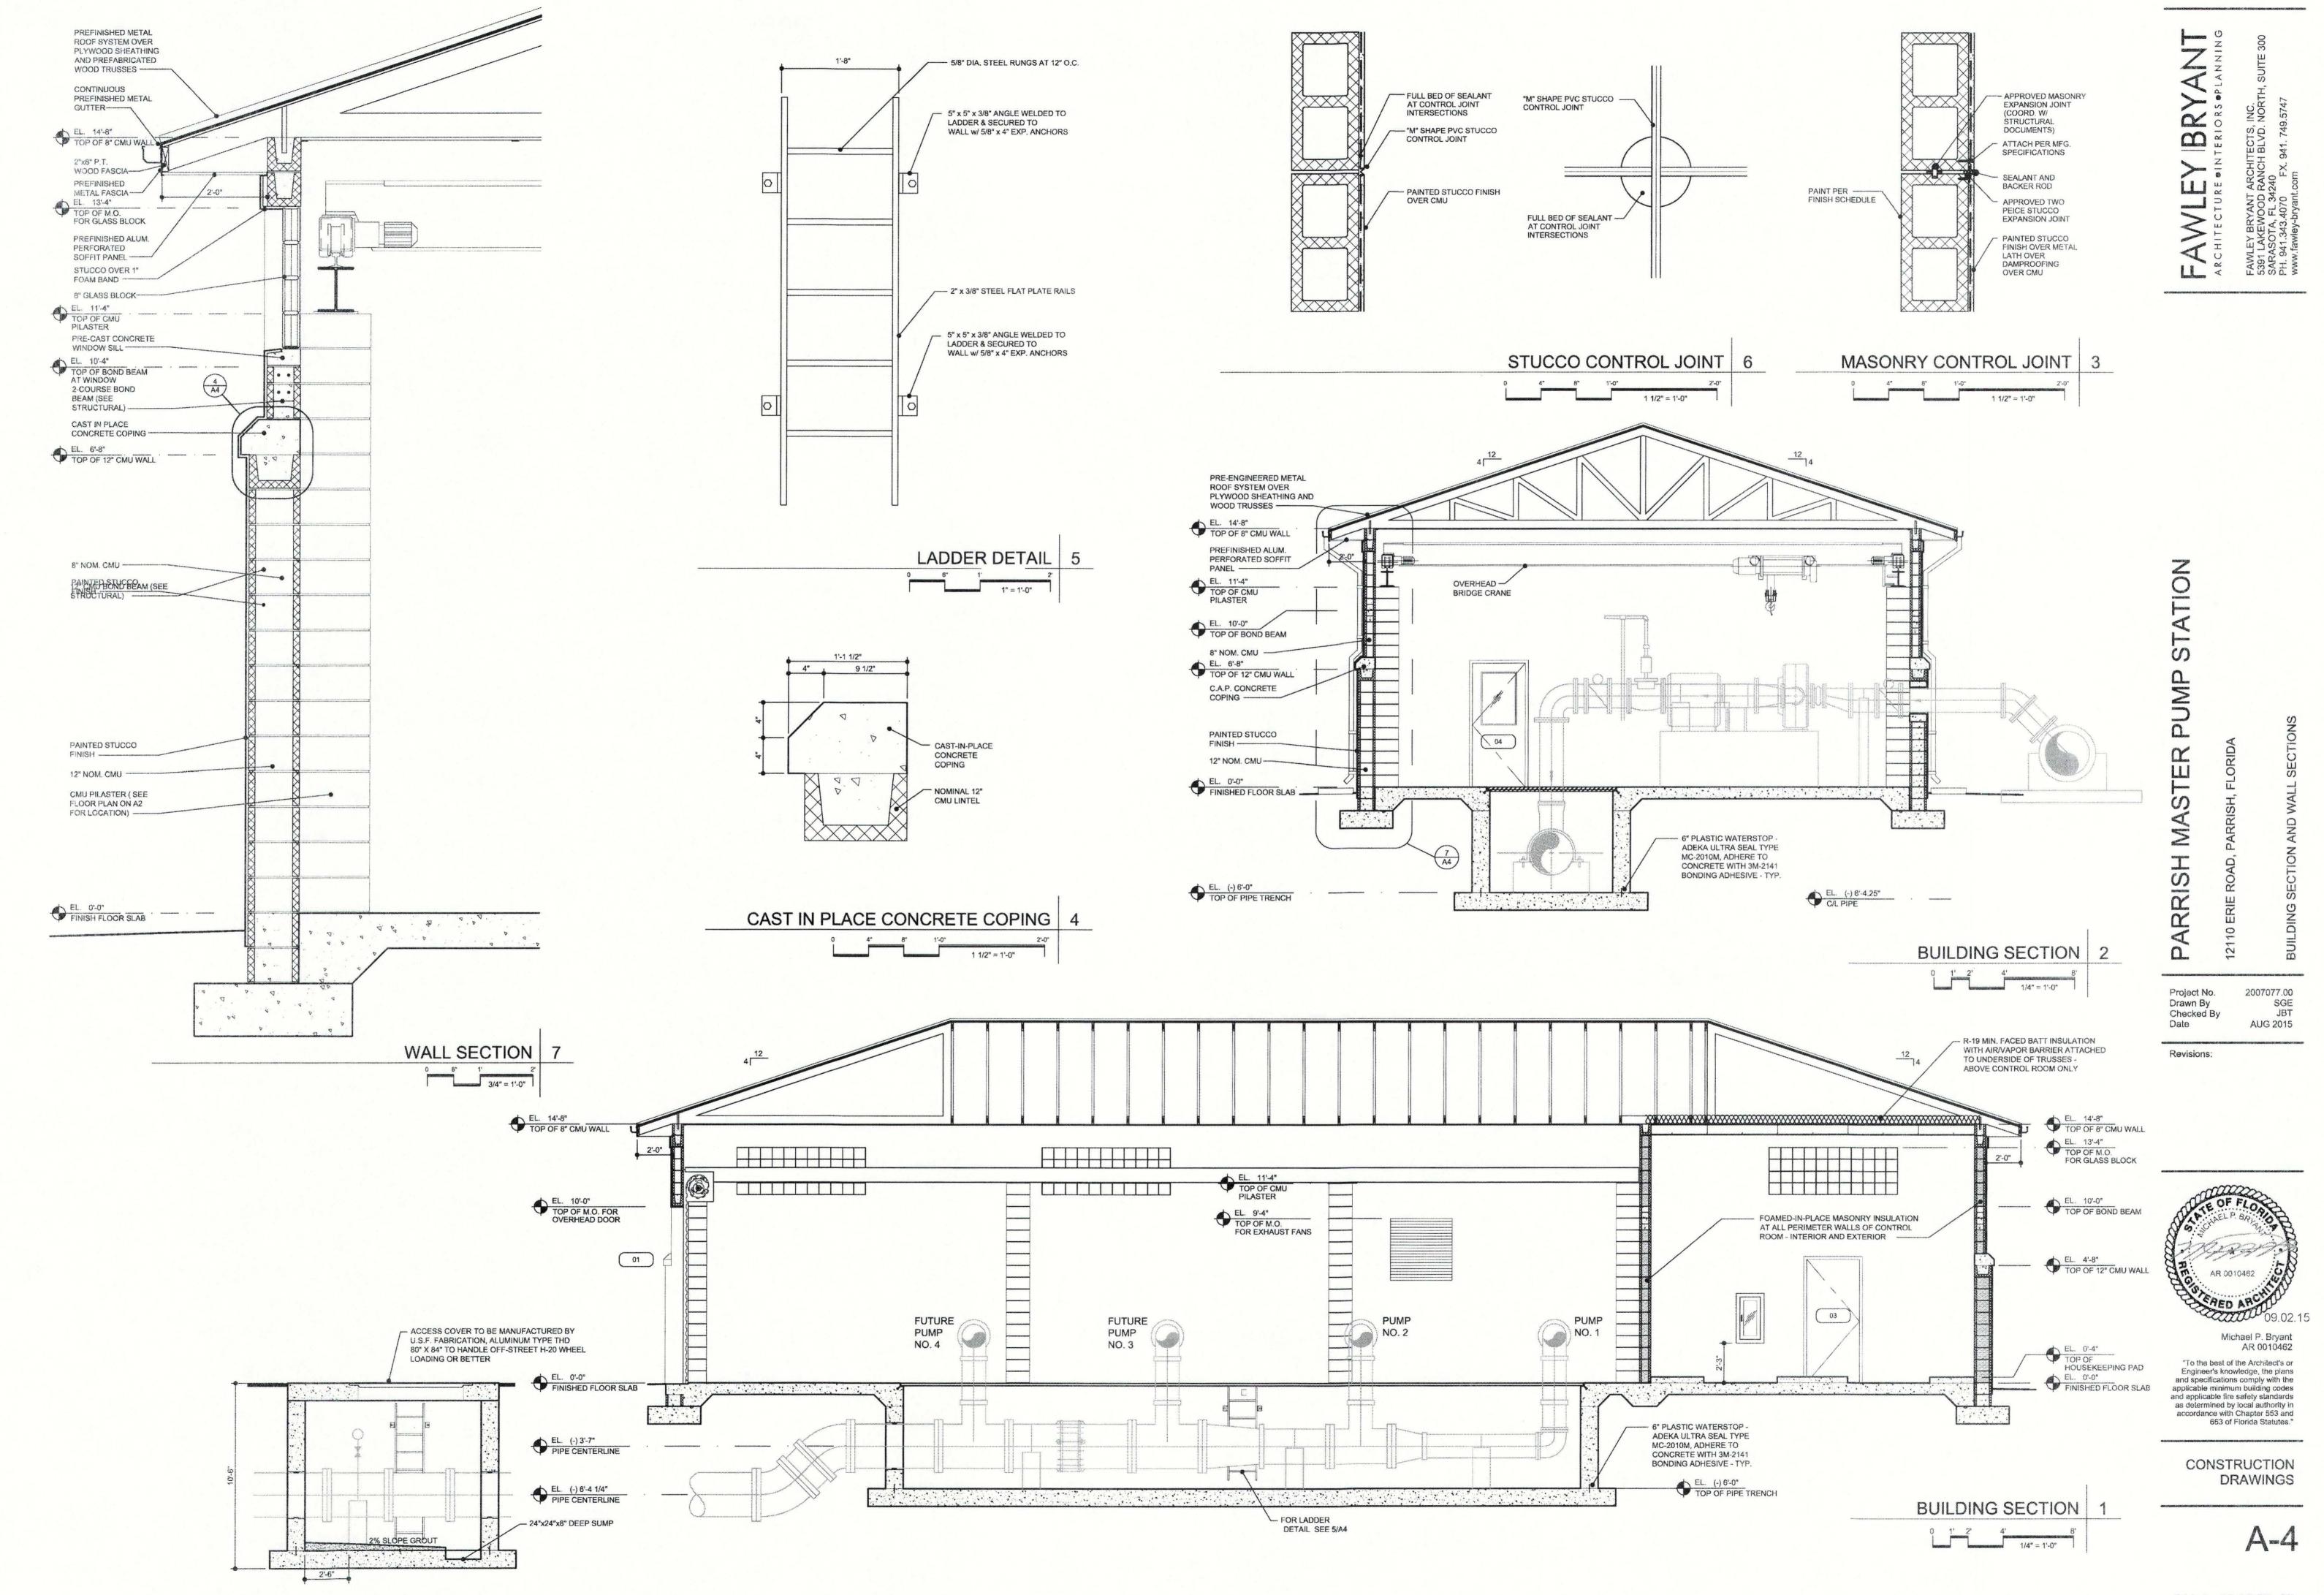

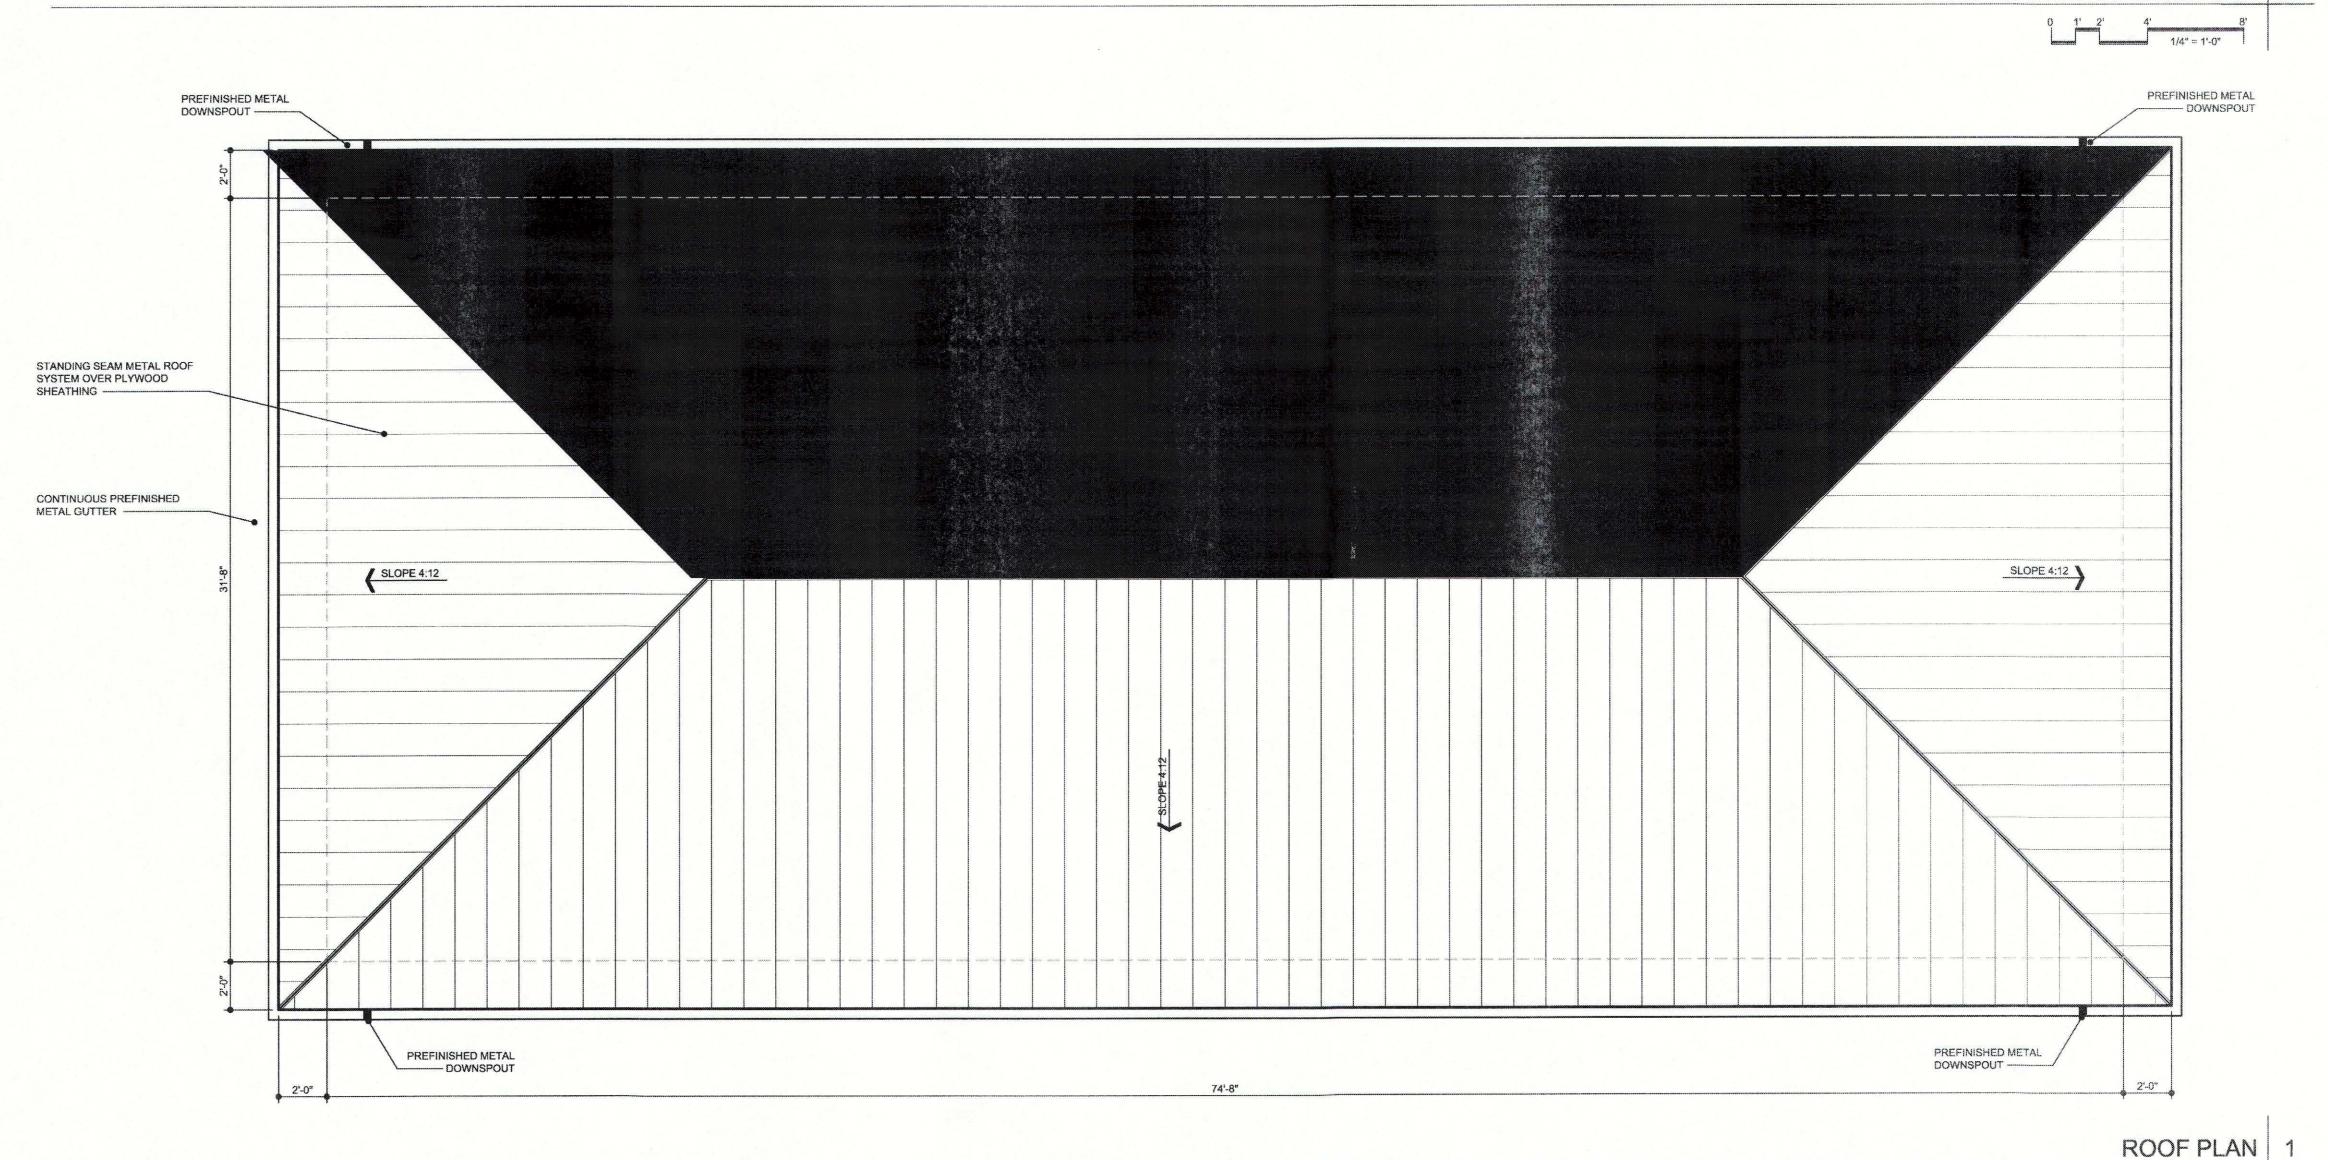FAWLEY BRY ARCHITECTURE .INTERIORS .PL

AUG 2015


SGE JBT

Project No. Drawn By Checked By

Date Revisions:

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> CONSTRUCTION **DRAWINGS**

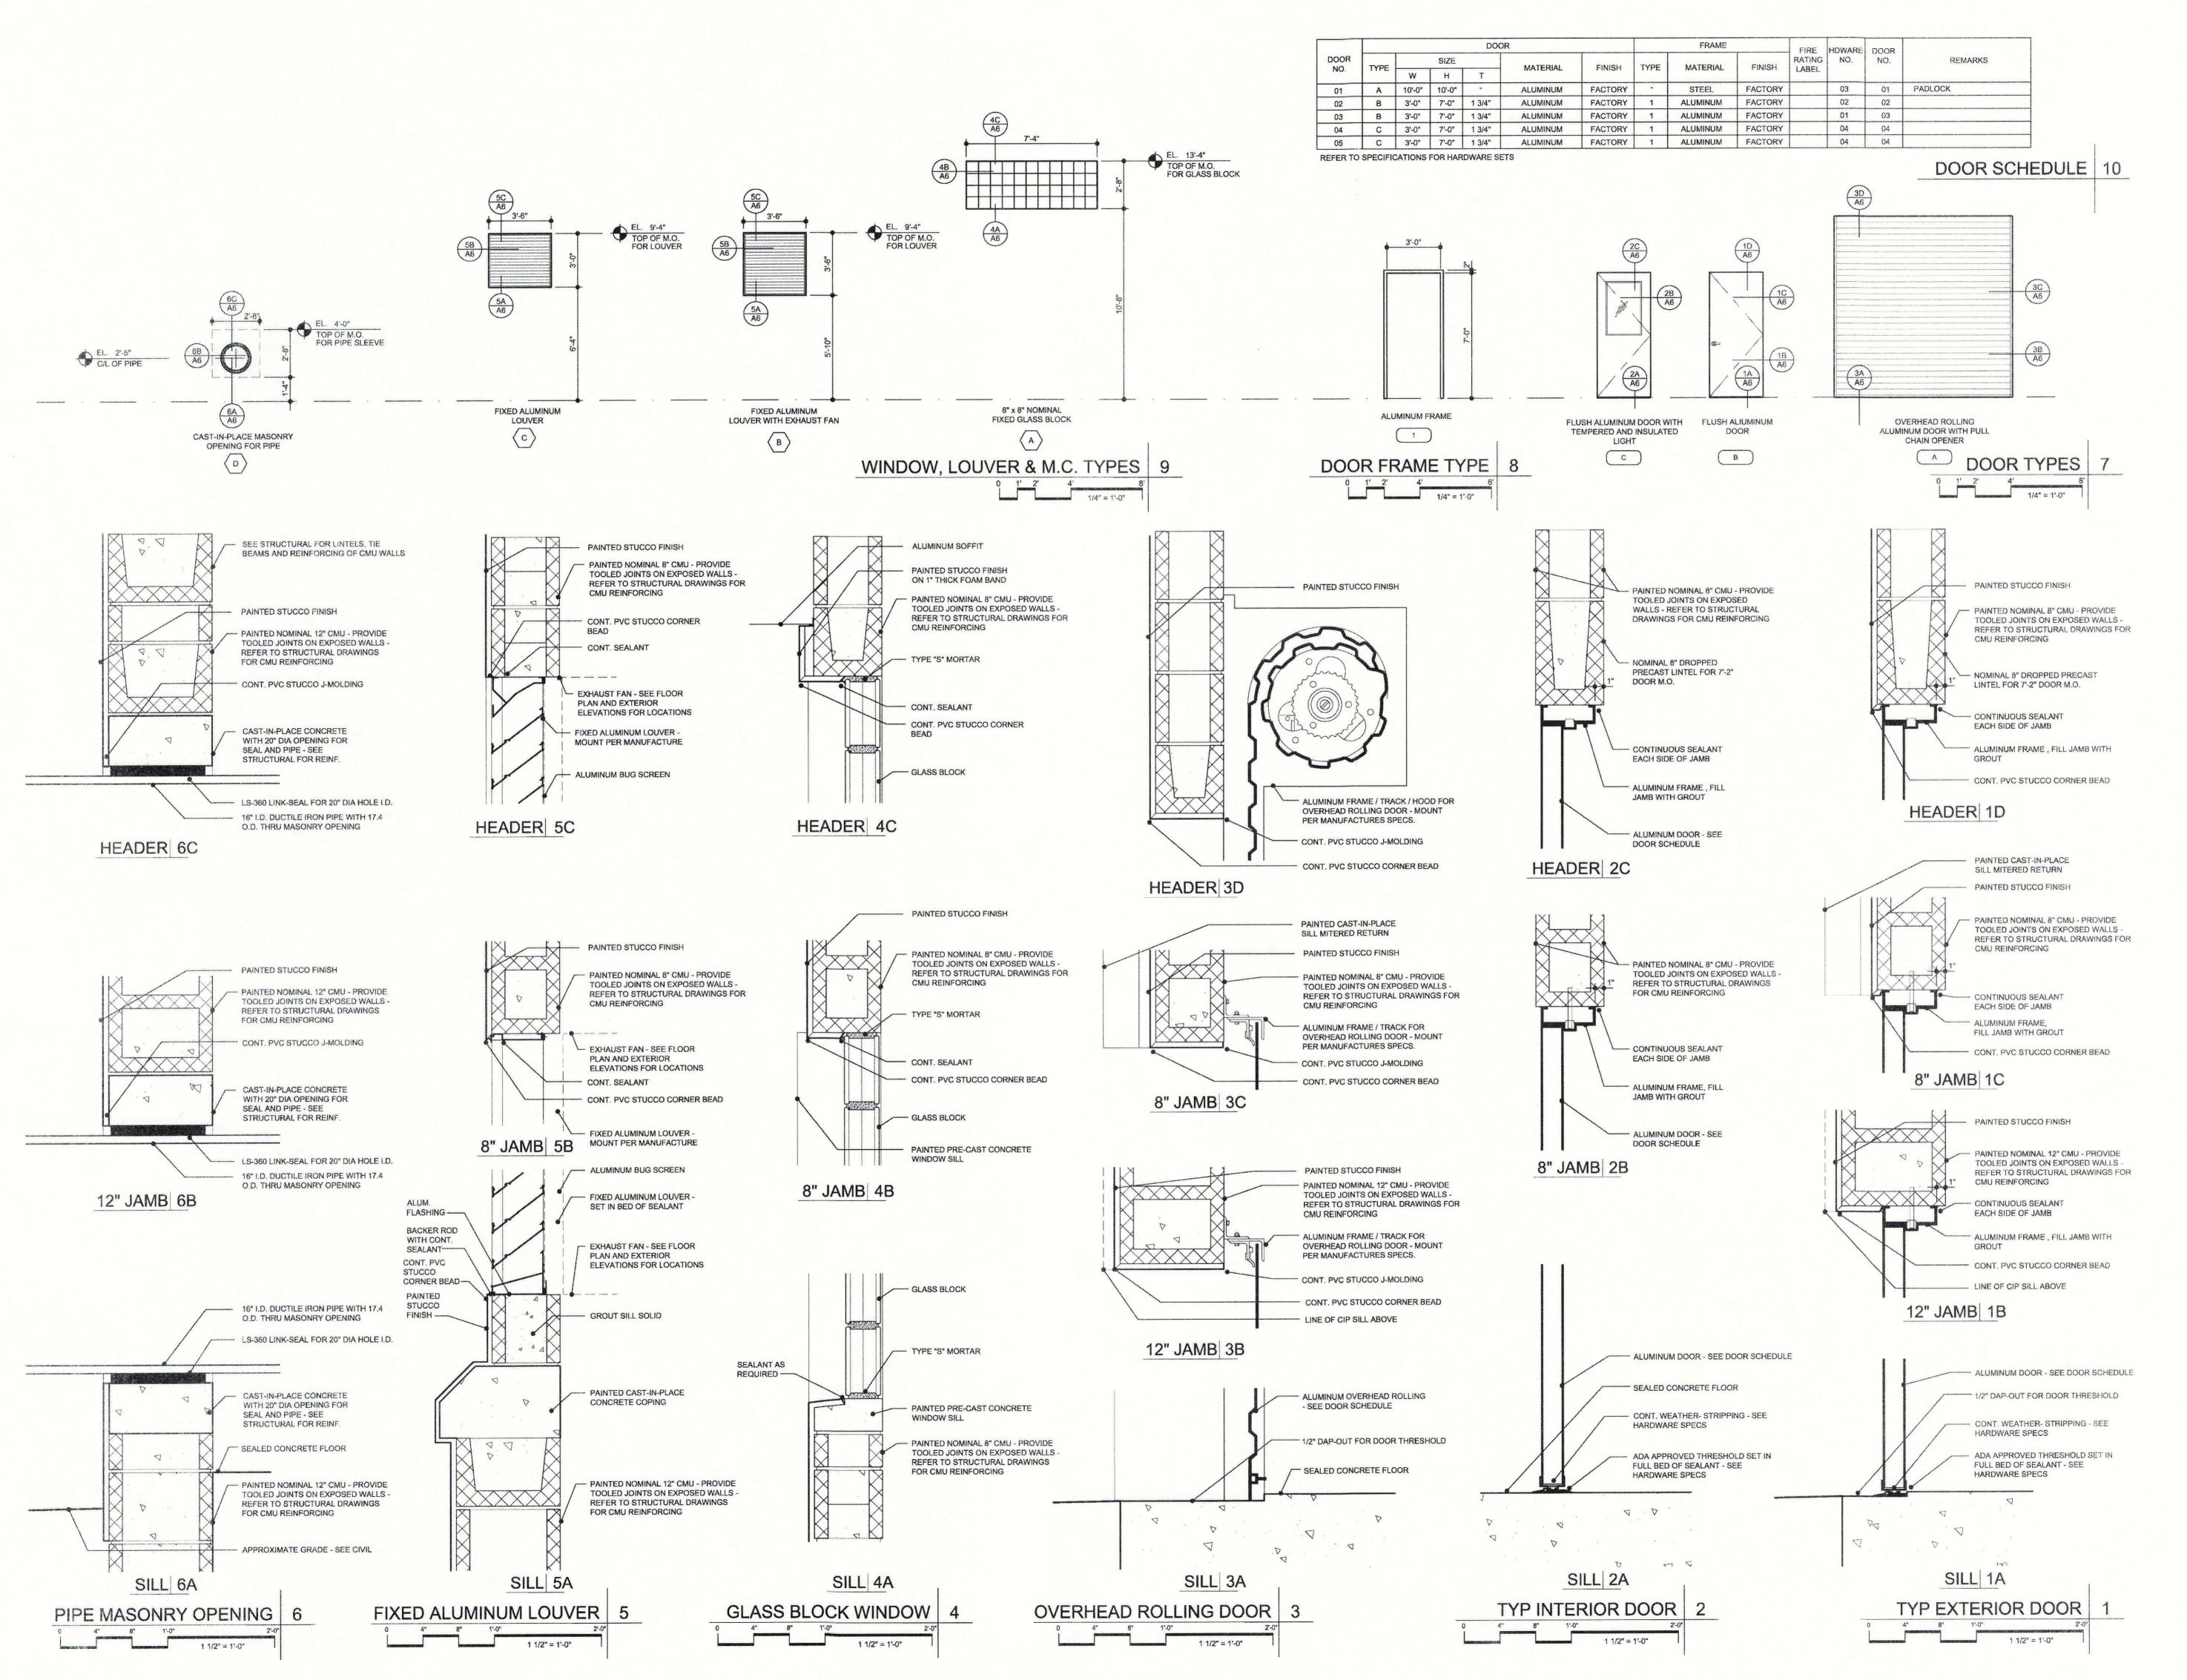

AWLEY BRY

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2007077.00 Project No. Drawn By Checked By AUG 2015 Revisions:

Date

Michael P. Bryant AR 0010462 "To the best of the Architect's or

Engineer's knowledge, the plans and specifications comply with the applicable minimum building codes and applicable fire safety standards as determined by local authority in accordance with Chapter 553 and 663 of Florida Statutes."

CONSTRUCTION **DRAWINGS**