CONTRACT DRAWINGS



MLS 12-A (RTU#139) EMERGENCY GENERATOR REPLACEMENT FOR

MANATEE COUNTY, FLORIDA COUNTY PROJECT NUMBER: 6022384



INDEX OF SHEETS

SHEET NO	SHEET DESCRIPTION
G-1	COVER
G-2	GENERAL NOTES & SYMBOLOGY
C-1	SITE PLAN
C-2	SITE DEMOLITION PLAN
C-3	SITE LAYOUT
C-4	BUILDING DEMOLITION PLAN
C-5	SITE PHOTOS
C-6	DETAIL SHEET
E-1 TO E-7	ELECTRICAL SHEETS
S-1 TO S-3	STRUCTURAL SHEET



UTILITY WARNING NOTE

ABOVE GROUND AND / OR UNDERGROUND UTILITIES MAY BE IN THE AREA OF THIS PROJECT - PROCEED WITH CAUTION - THE CONTRACTOR SHALL CALL SUNSHINE STATE "ONE CALL" AT 1-800-432-4770 AND THE UTILITY OWNERS IN ADVANCE OF BEGINNING WORK, IN ACCORDANCE WITH CHAPTER 556, FLORIDA STATUTES.

ATTENTION IS DIRECTED TO THE FACT THAT THESE PLANS MAY HAVE BEEN REDUCED IN SIZE BY REPRODUCTION. THIS MUST BE CONSIDERED WHEN OBTAINING SCALED DATA

		REVISIONS
DATE	BY.	DESCRIPTION
	l	-





KELLY S. WEHNER, PE ENGINEER OF RECORD

60273 FL. LICENSE NO.

DATE: MAY 2016

FILE J 10019300193009 08'acaddwg112 A_Cover dwg LAST SAVED Wed, 05/04/16-8 49a PLOTTED Fn, 05/05/16-8 46a BY dave shively

GENERAL NOTES

- ALL WORKMANSHIP AND MATERIALS USED IN THE CONSTRUCTION OF THIS PROJECT SHALL BE NEW AND UNUSED AND CONFORM TO, OR EXCEED THE LATEST LOCAL JURISDICTION STANDARDS.
- CONTACT SUNSHINE STATE ONE CALL FOR UTILITY LOCATES A MINIMUM OF 48-HOURS AND A MAXIMUM OF 5-DAYS PRIOR TO START OF CONSTRUCTION AT 1-800-432-4770
- 3. THE CONTRACTOR SHALL NOTIFY UTILITY OWNERS A MINIMUM OF 2-DAYS AND A MAXIMUM OF 5-DAYS PRIOR TO START OF CONSTRUCTION.

UTILITY OWNER	CONTACT NAME	CONTACT NUMBER	
BRIGHT HOUSE NETWORKS	TOM WRIGHT	(941) 345-1348 EXT 2134	
FLORIDA POWER AND LIGHT	TRACY STERN	(800) 868-9554	
TECO PEOPLES GAS	DANNY SHANAHAN	(941) 342-4006	
VERIZON FLORIDA INC	DAVID WYNNS	(813) 978-2164	
MANATEE COUNTY UTILITY OPERATIONS	KATHY McMAHON	(941) 792-8811 EXT 5075	

- 4 IT IS THE RESPONSIBILITY OF THE CONTRACTOR TO CONTACT FPL/GTE FOR RESTRAINING OF POLES DURING CONSTRUCTION. ALL ASSOCIATED COSTS WILL BE AT CONTRACTOR'S EXPENSE
- 5 THE CONTRACTOR'S ATTENTION IS DIRECTED TO THE FACT THAT ALL CONSTRUCTION ACTIVITIES SHALL CONFORM TO THE LOCAL NOISE ORDINANCE
- HOURS OF WORK SHALL BE: NON-FEDERAL HOLIDAYS, MONDAY FRIDAY 7AM 5PM. WORK OUTSIDE THESE HOURS MUST BE SCHEDULED 48 HOURS IN ADVANCE AND MAY BE SUBJECT TO REIMBURSEMENT FOR ADDITIONAL INSPECTION SERVICES.
- THE CONTRACTOR SHALL OBTAIN ALL REQUIRED PERMITS PRIOR TO CONSTRUCTION. THESE MAY INCLUDE. BUT ARE NOT LIMITED TO.
 - . UTILITY CONSTRUCTION PERMIT
 - . ROW USE PERMIT
 - . EPA NPDES PERMIT
 - DEWATERING PERMIT
 - TREE REMOVAL PERMIT
- 8. THESE DRAWINGS DO NOT INCLUDE NECESSARY COMPONENTS FOR CONSTRUCTION SAFETY AND THE CONTRACTOR IS SOLELY RESPONSIBLE FOR CONSTRUCTION SAFETY. SPECIAL PRECAUTIONS MAY BE REQUIRED IN THE VICINITY OF POWER LINES AND OTHER UTILITIES.
- 9. THE CONTRACTOR SHALL FURNISH, ERECT AND MAINTAIN ALL NECESSARY TRAFFIC CONTROL AND SAFETY DEVICES, IN ACCORDANCE WITH THE US DEPARTMENT OF TRANSPORTATION, "MANUAL ON UNIFORM TRAFFIC CONTROL DEVICES" AND THE LATEST FLORIDA DEPARTMENT OF TRANSPORTATION "ROADWAY AND TRAFFIC DESIGN STANDARDS", LATEST EDITION AND CONTRACT SPECIFICATIONS.
- 10. THE CONTRACTOR SHALL PROVIDE, ERECT AND MAINTAIN EFFECTIVE BARRICADES, DANGER SIGNALS, SIGNS AND PEDESTRIAN DETOURS IN ALL AREAS WHERE REQUIRED FOR THE PROTECTION OF THE WORK AND THE SAFETY OF THE PUBLIC.
- 11. THE CONTRACTOR SHALL PROVIDE ACCESS FOR TRAFFIC AT ALL TIMES DURING CONSTRUCTION.
 CONSTRUCTION SHALL BE CONDUCTED IN SUCH A MANNER THAT RESIDENTS RETAIN ACCESS TO THEIR DRIVEWAYS AT ALL TIMES.
- 12 REFERENCES TO FDOT INDEXES REFER TO THE MOST RECENT EDITION OF THE FDOT "ROADWAY AND TRAFFIC DESIGN STANDARDS."
- 13 IT IS THE RESPONSIBILITY OF THE CONTRACTOR TO CONTROL AND PREVENT EROSION AND THE TRANSPORTATION OF SEDIMENT TO SURFACE DRAINS AND OUTFALLS.
- 14. THE CONTRACTOR SHALL TAKE ALL REASONABLE MEANS TO ELIMINATE THE TRANSPORT OF DUST FROM THE PROJECT SITE. SPECIAL MEASURES, SUCH AS PERIODICALLY APPLYING WATER TO THE WORK SITE TO PREVENT DUST SHALL BE INCORPORATED INTO THE CONTRACTORS WORK PLAN.
- 15. THE CONTRACTOR SHALL BE RESPONSIBLE TO MAKE A REVIEW OF THE SITE TO DETERMINE EXISTING CONDITIONS AND ANYTHING NOT SHOWN ON THESE PLANS SHALL BE BROUGHT TO THE ATTENTION OF THE ENGINEER AND SHALL NOT CONSTITUTE AN EXTRA UNLESS APPROVED BY THE ENGINEER.
- 16 THE CONTRACTOR SHALL BE RESPONSIBLE FOR REPAIRING OR REPLACING ANY DAMAGED ITEMS INCLUDING, BUT NOT LIMITED TO, DRIVEWAYS, IRRIGATION SYSTEMS, MAILBOXES, SIDEWALKS, STREET SIGNS, AND PRIVATE FENCES AS REQUIRED BY E.O.R./OTHER GOVERNING ENTITIES
- 17. ALL SECTION CORNERS OR PROPERTY CORNERS DISLOCATED OR DISTURBED BY THE CONSTRUCTION ACTIVITIES SHALL BE RESET BY A REGISTERED LAND SURVEYOR AT THE CONTRACTORS EXPENSE.
- 18. ALL DISTURBED AREAS SHALL BE RESTORED TO THEIR ORIGINAL CONDITION OR BETTER UNLESS OTHERWISE NOTED. FINAL GRADE IS TO GENERALLY BE THE SAME AS EXISTING GRADE, RESTORE UNIFORMLY AND FOR PROPER DRAINAGE GRADE TOWARD ROADWAY.
- 19. THE CONTRACTOR IS RESPONSIBLE FOR THE DISPOSAL OF ALL CLEARED VEGETATION WITHIN FIVE (5) DAYS OF CLEARING AND GRUBBING WORK

BY DATE

- 20 ALL EXCESS SOIL RESULTING FROM CONSTRUCTION ACTIVITIES THAT IS NOT CLAIMED BY THE OWNER SHALL BECOME THE PROPERTY OF THE CONTRACTOR AND PROPERLY DISPOSED OF BY THE CONTRACTOR
- 21. ALL VOIDS AFTER PLACEMENT OF SOD SHALL BE FILLED WITH PREPARED SOIL MIX. THE SOD SHALL BE ROLLED TO MEET THE PROPOSED GRADES SOD PLACED ON SLOPES (3:1 OR STEEPER) SHALL BE PEGGED.
- 22. AREAS OF EXPOSED EARTH RESULTING FROM CONSTRUCTION SHALL BE SODDED IN KIND AS DIRECTED BY THE ENGINEER UNLESS OTHERWISE NOTED ON PLANS.
- 23 LOCATIONS, ELEVATIONS AND DIMENSIONS OF EXISTING UTILITIES, STRUCTURES AND OTHER FEATURES ARE SHOWN ACCORDING TO THE BEST INFORMATION AVAILABLE AT THE TIME OF THE PREPARATION OF THESE PLANS, BUT DO NOT PURPORT TO BE ABSOLUTELY CORRECT. THE CONTRACTOR SHALL VERIFY THE LOCATION, ELEVATIONS AND DIMENSIONS OF ALL EXISTING UTILITIES, STRUCTURES AND OTHER FEATURES AFFECTING HIS WORK PRIOR TO CONSTRUCTION
- 24. THE CONTRACTOR SHALL VERIFY IN THE FIELD THE LOCATION AND ELEVATION OF ALL EXISTING UTILITY CONNECTION POINTS PRIOR TO STARTING CONSTRUCTION AND SHALL IMMEDIATELY NOTIFY THE ENGINEER AND OWNER OF ANY DISCREPANCIES FOUND.
- 25 THE CONTRACTOR'S ATTENTION IS CALLED TO THE FACT THAT THERE MAY BE SOME CONFLICTS IT SHALL BE THE CONTRACTOR'S RESPONSIBILITY TO LOCATE, PROTECT, AND REPLACE (IF DAMAGED) ANY AND ALL EXISTING UTILITIES ON THIS PROJECT AT THEIR OWN EXPENSE.
- 26. THE CONSTRUCTION LIMITS INDICATED IN THESE PLANS ARE APPROXIMATE. ACTUAL LIMITS MAY BE SET IN THE FIELD AS DIRECTED BY THE ENGINEER.
- 27. ALL POTABLE WATER, FIRE, IRRIGATION SYSTEM, SANITARY SYSTEM, STORM SYSTEM AND OTHER UTILITIES COMPONENTS SHALL BE PROTECTED AND SHALL REMAIN OPERATIONAL DURING CONSTRUCTION. THE CONTRACTOR SHALL IMMEDIATELY REPAIR ANY DAMAGE TO THESE SYSTEMS
- 28. CONTRACTOR SHALL ENSURE THAT EXCAVATIONS ARE FREE OF DEBRIS PRIOR TO BACKFILLING
- 29. THE CONTRACTOR SHALL NOT ENTER OR OCCUPY ANY LAND OUTSIDE THE RIGHTS-OF-WAY OR PRIVATE PROPERTY WITHOUT THE WRITTEN CONSENT OF THE PROPERTY OWNER.
- 30 WHERE REFERENCED STANDARDS CONFLICT. THE MORE STRINGENT STANDARD SHALL APPLY
- 31. CONTRACTOR SHALL SUPPORT AND PROTECT ALL EXISTING UTILITIES AS REQUIRED. THIS SHOULD INCLUDE BY-PASS PUMPING IF REQUIRED.
- 32 CONTRACTOR SHALL BE MADE AWARE THAT OTHER CONSTRUCTION ACTIVITIES MAY BE UNDER WAY AT THE TIME OF THIS WORK IT IS THE CONTRACTORS RESPONSIBILITY TO COORDINATE ALL ACTIVITIES WITH COUNTY PERSONNEL AND OTHER CONTRACTORS THAT MAY IMPACT OTHER SITE CONSTRUCTION
- 33. THE EXISTING AUTOMATIC TRANSFER SWITCH SHALL BE DISCONNECTED, REMOVED AND DELIVERED TO THE OWNER.
- 34. ACCORDING TO THE FEDERAL EMERGENCY MANAGEMENT AGENCY (FEMA) FLOOD MAP THE SITE IS LOCATED WITHIN FLOOD ZONE AE WITH A BASE FLOOD ELEVATION OF 12 0.



SURVEYOR'S NOTES & SYMBOLOGY

NOTE: EXISTING FEATURES ARE SHOWN LIGHT-LINED AND DASHED

LEGEND

	SITE BENCHMARK		CONCR	RETE MONUMENT
X	WOOD UTILITY POLE	•		BOUNDARY MARKER
	GRATE INLET	×¹,'nì	SPOT	ELEVATION (TYP)
₩	LIGHT POLE	^ _	GUY W	MRE
\bowtie	WATER VALVE	0	UTILIT	Y MANHOLE
\$	FIRE HYDRANT	S	SANITA	ARY MANHOLE
þ	SIGN	0	FIBER	OPTIC MARKER
CD	UTILITY BOX	0	IRRIGA	TION HEAD
0	STORM MANHOLE	P	GEOTE	CH BORINGS AND PAVEMENT CORES
W.	B3-	_		
和	TREE	PB	- 1	PLAT BOOK
Ĩ	CINIC TOCK	ORE	3 (OFFICIAL RECORDS BOOK
X	PINE TREE	PG		PAGE
X	PALM TREE	DB	ı	DEED BOOK
Exc.		MES	5 1	MITERED END SECTION
543	OAK TREE	INV		INVERT
0	MAPLE TREE	EL	ı	ELEVATION

- 1. THE FOLLOWING NGS NAVD88 VERTICAL CONTROL MONUMENTS WERE RECOVERED AND UTILIZED FOR THE ELEVATIONS SHOWN HEREIN; MELROSE PARK PID; DO1578 ELEVATION 18 18 FEET AND MIRAMAR PID; DO1579 ELEVATION 14 57 FEET.
- 2. THIS SURVEY IS REFERENCED TO A PROJECTION OF THE FLORIDA STATE PLANE COORDINATE SYSTEM (WEST ZONE NAD 1983/2011)

SURVEY PROVIDED BY:

Hyatt Survey Services, Inc.
LB No.: 7203 Geographic Data Specialists
11007 8th Avenue East Bradenton, Florida 34212
Phone: (941) 748–4693 Fax: (941) 744–1643

LINE WORK & SYMBOLOGY

	ASPHALT ROADWAY		CHAIN LINK FENCE
water summers oppositely specificate bywarded delineates which	BACK OF CURB		BUILDING BOUNDARY
	SHELL DRIVEWAY	of PTP file blacked in child file and	TOP OF BANK
	CONCRETE DRIVEWAY		WETLAND LINE
	RIGHT-OF-WAY/PROPERTY LINE		GUARDRAIL
	PROPERTY LINE	12	CONTOUR LINE AND ELEV

EXISTING UTILITY LINE WORK SYMBOLOGY

NOTE: PIPES 12-INCHES AND LARGER SHOWN WITH DOUBLE LINES.

	WATER MAIN	θξ	BURIED ELECTRIC
— FOC — FOC — FOC —	BURIED FIBER OPTIC	UGT UGT	BURIED TELEPHONE
GAS GAS	GAS MAIN	fm fm fm	SANITARY FORCE MAIN
	BURIED CABLE TV	RW RW	RECLAIMED WATER MA
UNK	UNKNOWN UTILITY	€ TH1-1	TEST HOLE LOCATION

NOTE

KELLY S. WEHNER, PE LIC. NO.: 60273

THE LEGEND LISTED REPRESENT A COMPREHENSIVE STANDARD GUIDE INTENDED FOR GENERAL USE. THEREFORE, NOT ALL OF THE SYMBOLS AND ABBREVIATIONS CONTAINED ON THIS SHEET ARE NECESSARILY USED ON THIS PARTICULAR CONTRACT.

DESIGNED KSW
DRAWN
DES

DATE

GENERAL NOTES & SYMBOLOGY

PROJECT NO:
00193009 08


DATE:
MAY 2016
SHEET NO:
G-2

MANATEE COUNTY


MLS 12-A EMERGENCY GENERATOR REPLACEMENT

Shaping the Future
380 PARK PLACE BLVD, STE 300, CLEARWATER, FL 33759
TEL (727) 531-5305 (800) 861-8314
www.cartho.com (Cefficale of Authorization No. 29015



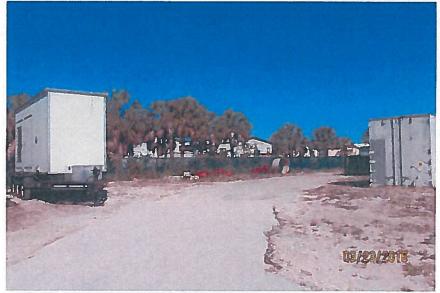



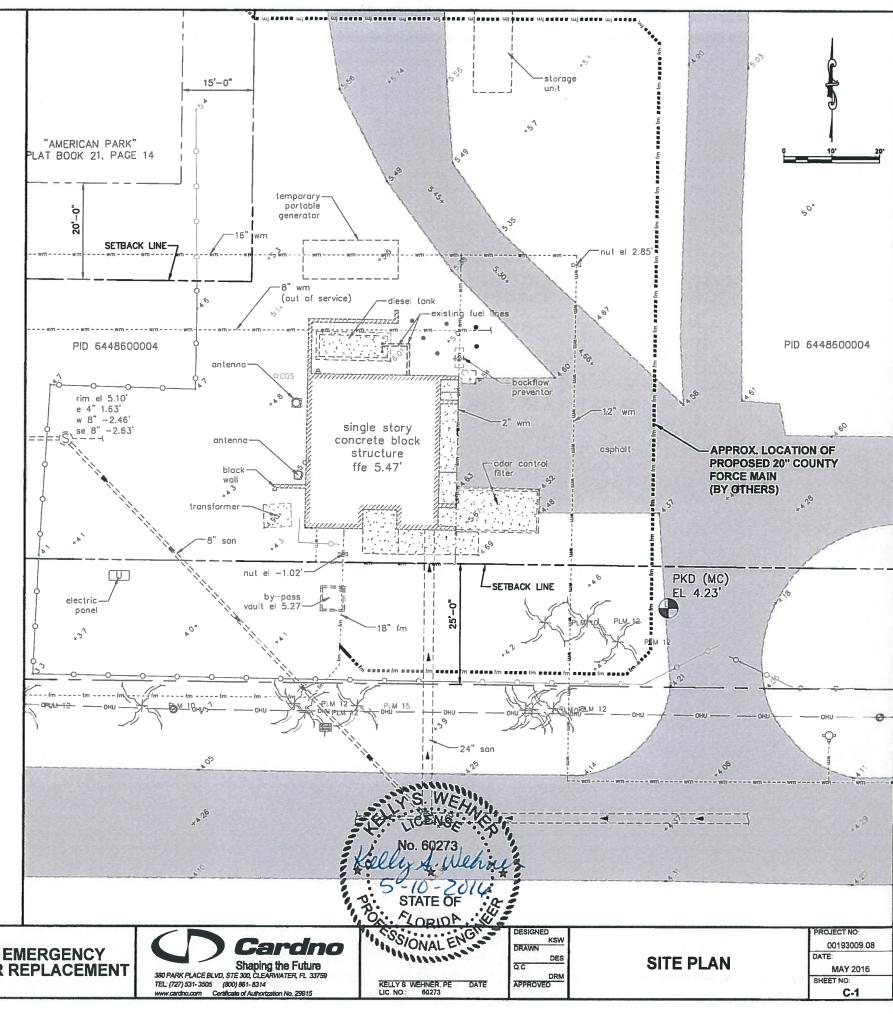



MANATEE COUNTY


MLS 12-A EMERGENCY GENERATOR REPLACEMENT


BY DATE

DESCRIPTION

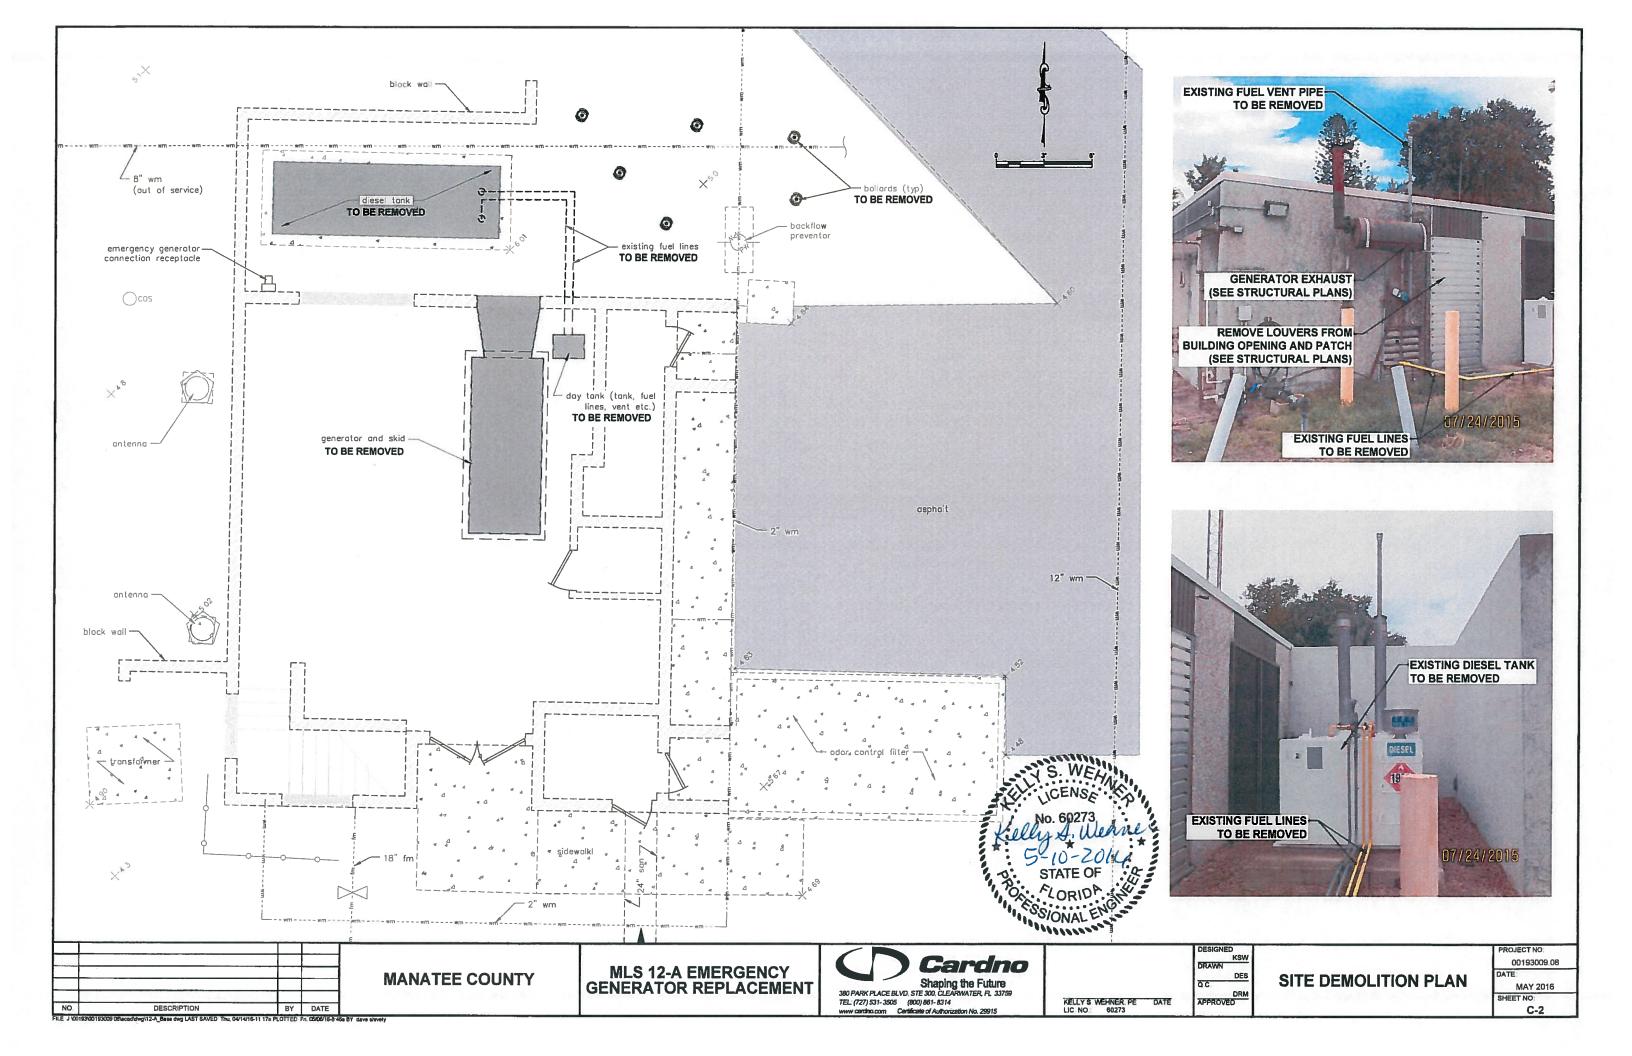

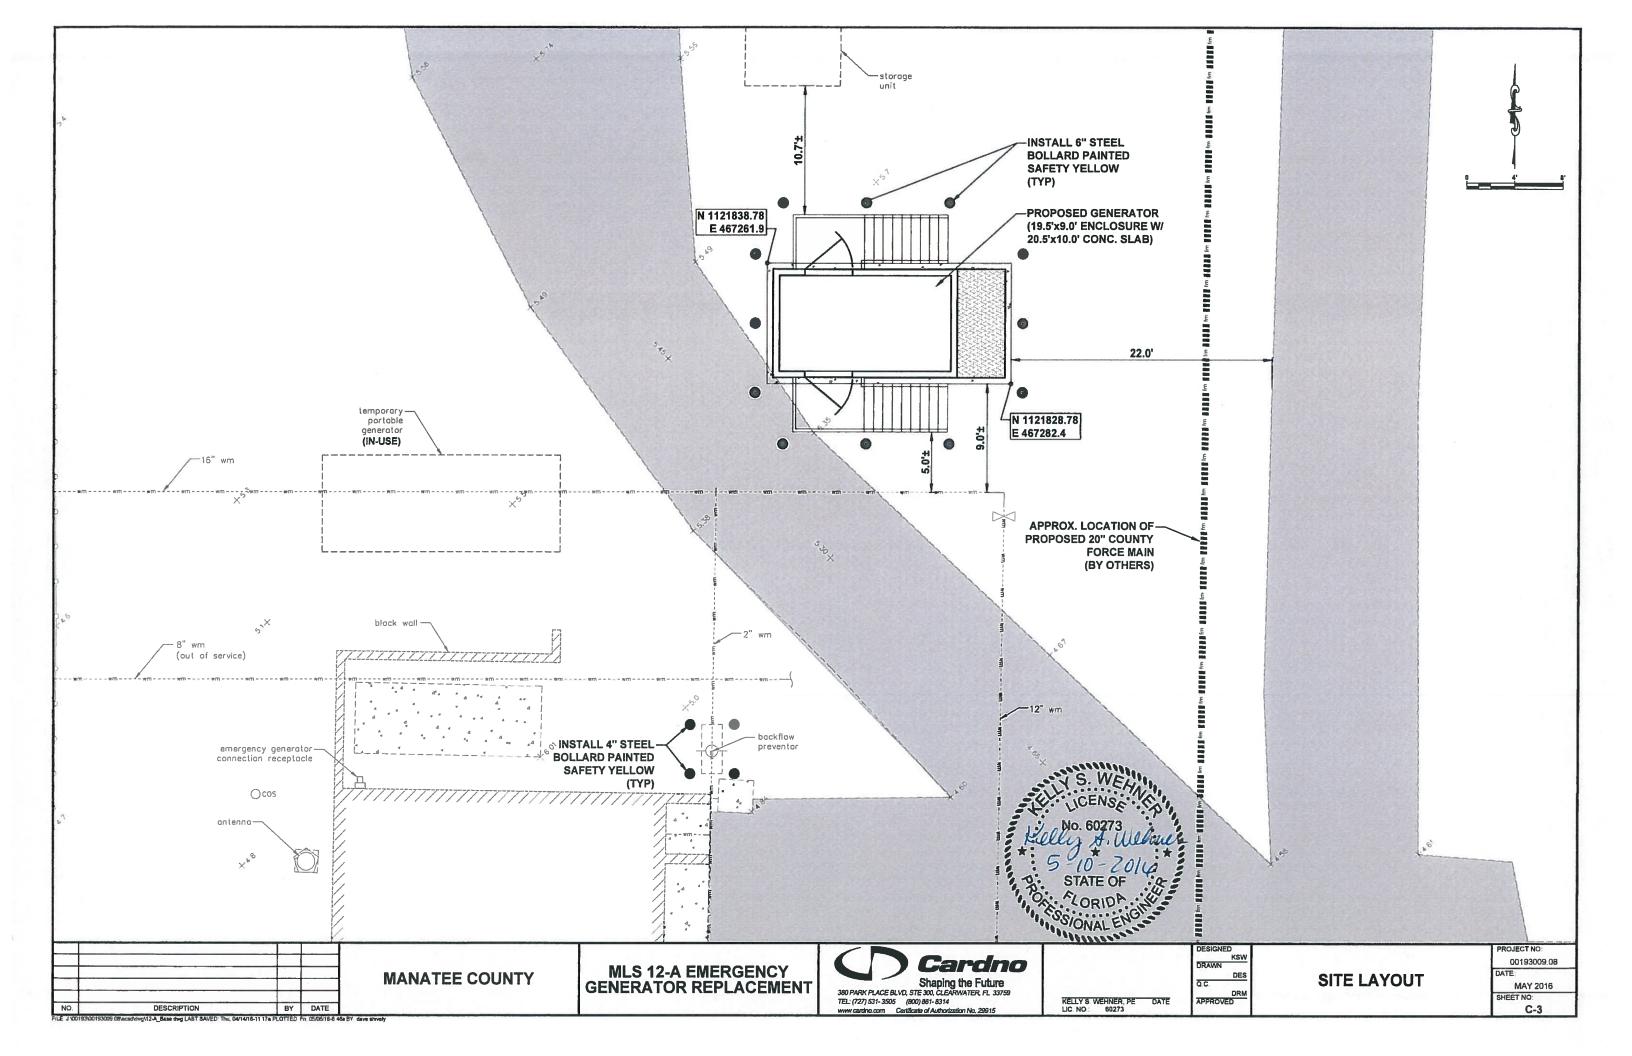

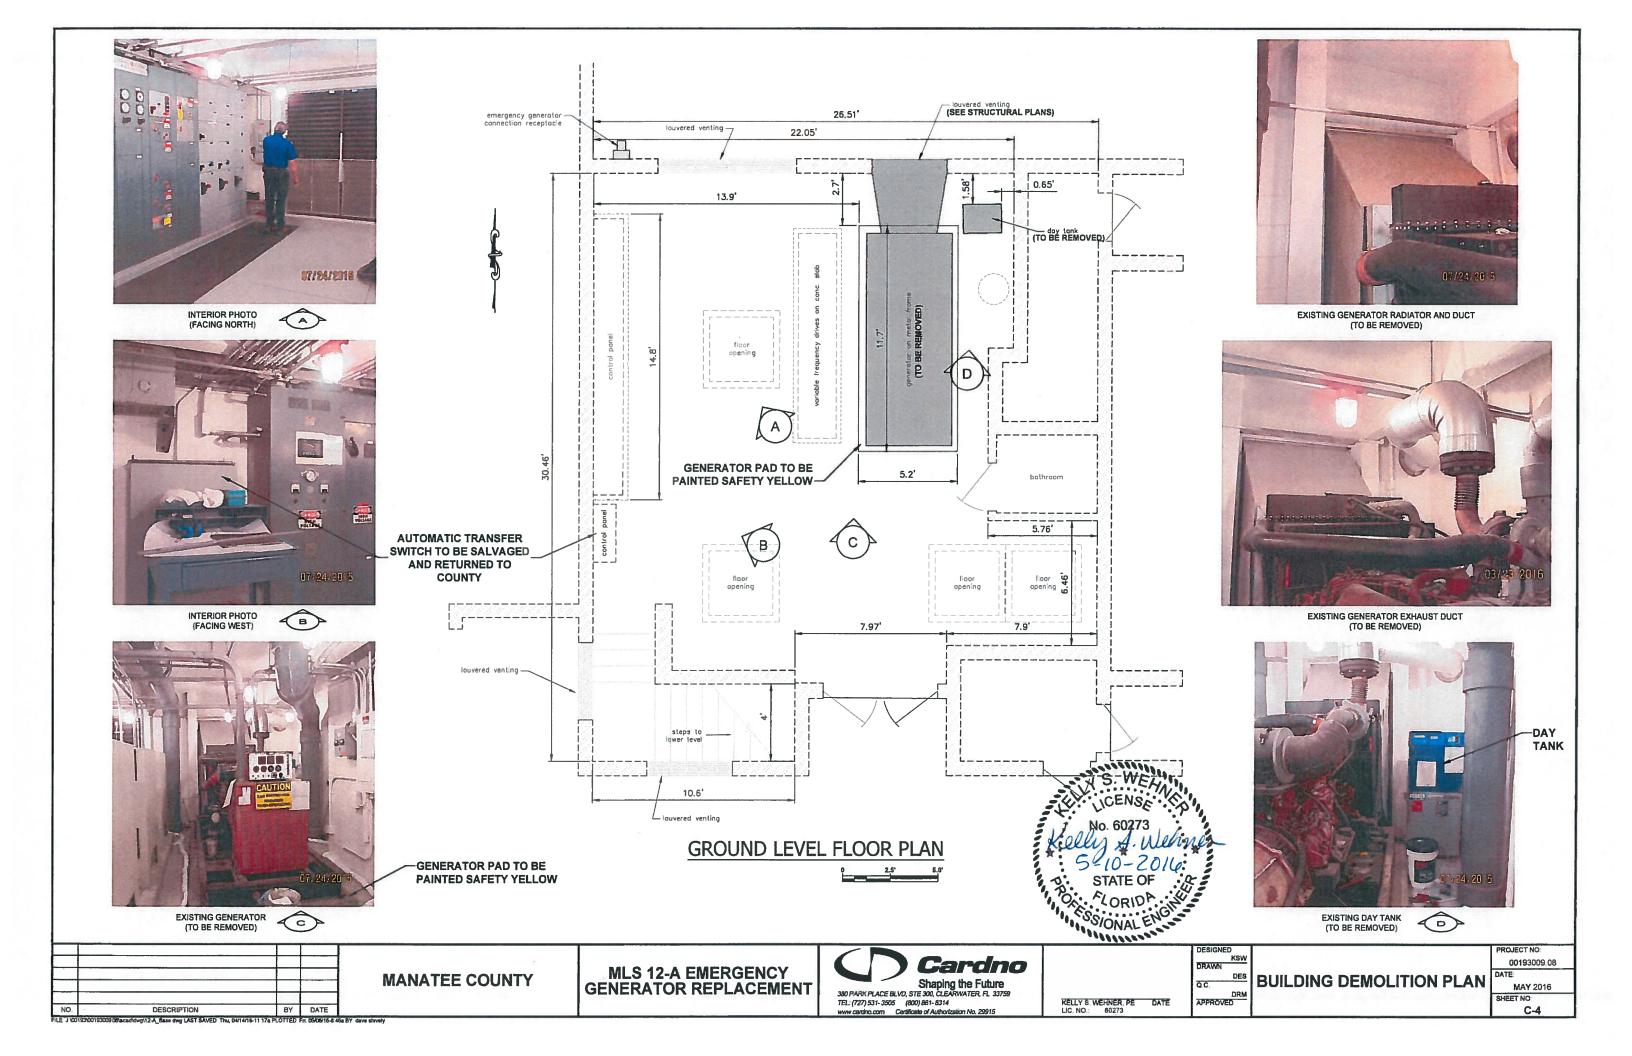

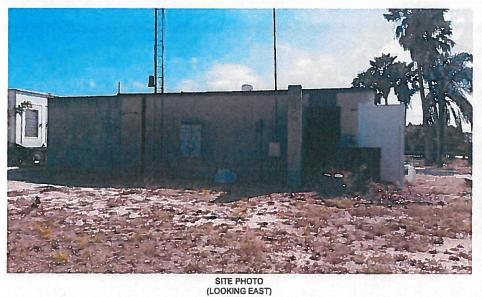

SITE PHOTO (LOOKING SOUTHWEST)

EXISTING DIESEL TANK - TO BE REMOVED (LOOKING SOUTHWEST)







SITE PHOTO (LOOKING SOUTHEAST)

ODOR CONTROL (LOOKING SOUTHWEST)

EXISTING GENERATOR MUFFLER - TO BE REMOVED (LOOKING SOUTH)



BY DATE





ODOR CONTROL (LOOKING NORTH)



ROOSED GENERATOR LOCATION (LOOKING NORTH)

MANATEE COUNTY

MLS 12-A EMERGENCY GENERATOR REPLACEMENT




Shaping the Future
380 PARK PLACE BLVD, STE 300, CLEARWATER, FL. 33759
TEL: (727) 531-3905 (800) 861-8314
www.cardno.com Cartificate of Authorization No. 29915


ONALEN

ROJECT NO: 00193009.08 SITE PHOTOS


MAY 2016 SHEET NO: C-5

DESCRIPTION

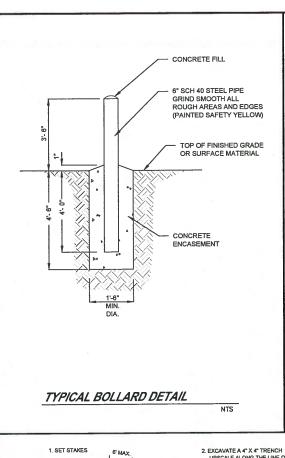

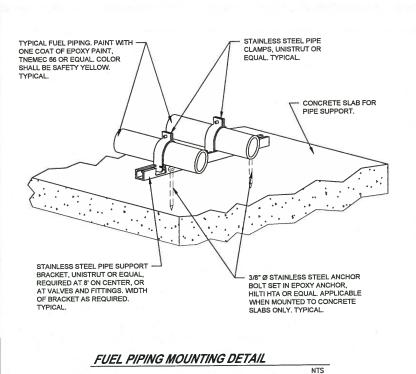

SPACING OF POSTS TO BE 6-10 FEET AP

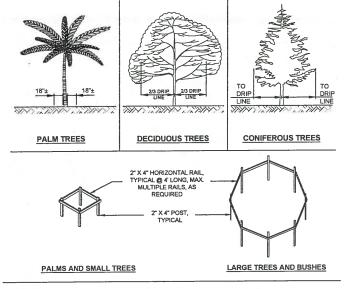


- NOTES:

 1. NO TRUCKS OR HEAVY EQUIPMENT ALLOWED WITHIN BARRIERS, ONLY HAND LABOR ALLOWED. NO CONSTRUCTION MATERIALS, SOILS DEPOSITS, OR SOLVENTS SHALL BE ALLOWED WITHIN BARRIERS.
- BARRIERS ARE TO BE IN PLACE PRIOR TO ANY CONSTRUCTION ACTIVITIES WITHIN TREE AREA.
 BARRIERS ARE TO STAY IN PLACE UNTIL ALL PAVING, CONSTRUCTION, AND HEAVY EQUIPMENT IS
- REMOVED FROM THE AREA.

TREE PROTECTION BARRIERS DETAIL

EXTRA STRENGTH FILTER FABRIC NEEDED WITHOUT WIRE MESH SUPPORT

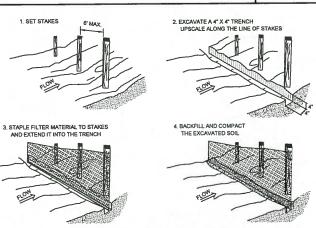


SHEET FLOW INSTALLATION (PERSPECTIVE VIEW)

NOTES:


- IT IS THE RESPONSIBILITY OF THE CONTRACTOR TO CONTROL AND PREVENT EROSION AND THE TRANSPORTATION OF SEDIMENT TO SURFACE DRAINS AND OUTFALLS. (REFER TO CONSTRUCTION PLANS, DETAILS, SPECIFICATIONS, AND APPROVED PERMITS FOR DETAILS.)
- DURING CONSTRUCTION THE CONTRACTOR SHALL PLACE GEOBALE BARRIERS AROUND SUCH STRUCTURES TO
 PREVENT EROSION AND THE MIGRATION OF SEDIMENT TO POINTS OUTSIDE THE CONSTRUCTION AREA. THE
 BARRIERS SHALL BE PLACED IN ACCORDANCE WITH THE REQUIREMENTS OF FDOT INDEX NO. 102 OR AS DIRECTED BY
- THE CONTRACTOR SHALL PROVIDE SILT BARRIERS AS DIRECTED BY THE ENGINEER TO CONTROL EROSION AND SEDIMENTATION FROM TAKING PLACE OUTSIDE THE LIMITS OF THE PROJECT. THE SILT BARRIERS HALL BE PLACED IN ACCORDANCE WITH THE REQUIREMENTS OF FDOT INDEX NO. 102, 103 AND 104 OR AS DIRECTED BY THE OWNER.
- REQUIRED FROSION CONTROL MEASURES MUST REMAIN INTACT THROUGHOUT CONSTRUCTION, FAILURE TO INSTALL OR PROPERLY MAINTAIN REQUIRED EROSION CONTROL WILL RESULT IN ENFORCEMENT ACTION WHICH MAY INCLUDE CITATIONS AS PROVIDED BY APPLICABLE LOCAL ORDINANCE AND CHAPTERS 40D-4 AND 40D-40, F.A.C. INITIATION OF CIVIL PENALTY PROCEDURES PURSUANT TO SECTION 373.129, F.A.C. CAN RESULT IN A PENALTY NOT TO EXCEED \$10,000 PER OFFENSE WITH EACH DATE DURING WHICH SUCH VIOLATION OCCURS CONSTITUTING A SEPARATE
- 5. ALL WORK PERFORMED SHALL COMPLY WITH THE REGULATIONS AND ORDINANCES OF THE VARIOUS GOVERNMENTAL AGENCIES HAVING JURISDICTION OVER THE WORK.



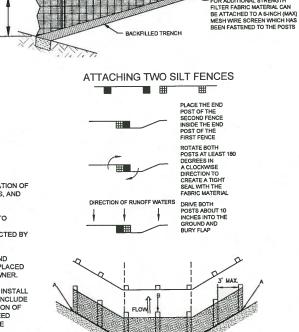

POINTS A SHOULD BE HIGHER THAN POINT B DRAINAGE INSTALLATION


(FRONT ELEVATION)

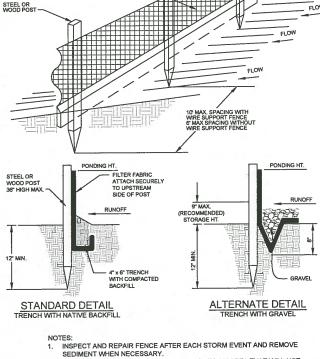

- SELIMENT WHEN NECESSART.

 REMOVED SEDIMENT SHALL BE DEPOSITED TO AN AREA THAT WILL NOT CONTRIBUTE SEDIMENT OFF-SITE AND CAN BE PERMANENTLY STABILIZED.

 SILT FENCE SHALL BE PLACED ON SLOPE CONTOURS TO MAXIMIZE PONDING

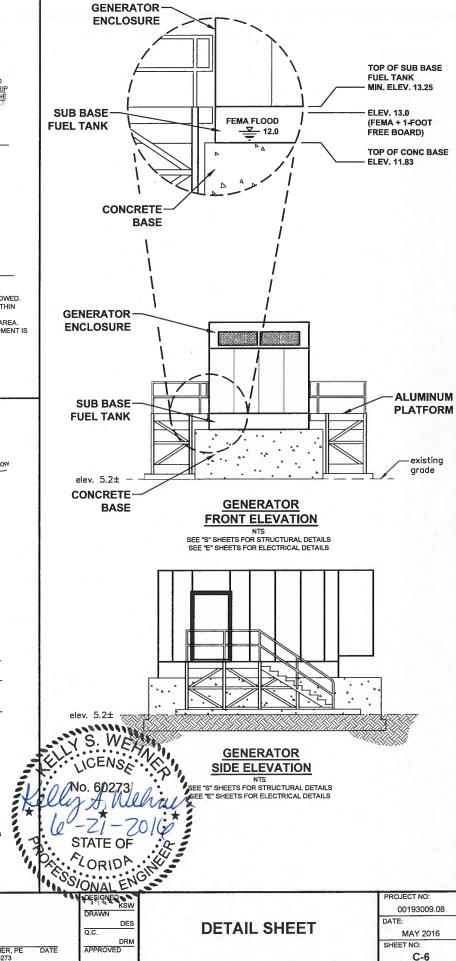

MANATEE COUNTY


MLS 12-A EMERGENCY GENERATOR REPLACEMENT

FOR ADDITIONAL STRENGTH



TEL: (727) 531-3505 (800) 861-8314 www.cardno.com Certificate of Authorization No. 29915

KELLY S. WEHNER, PE DATE

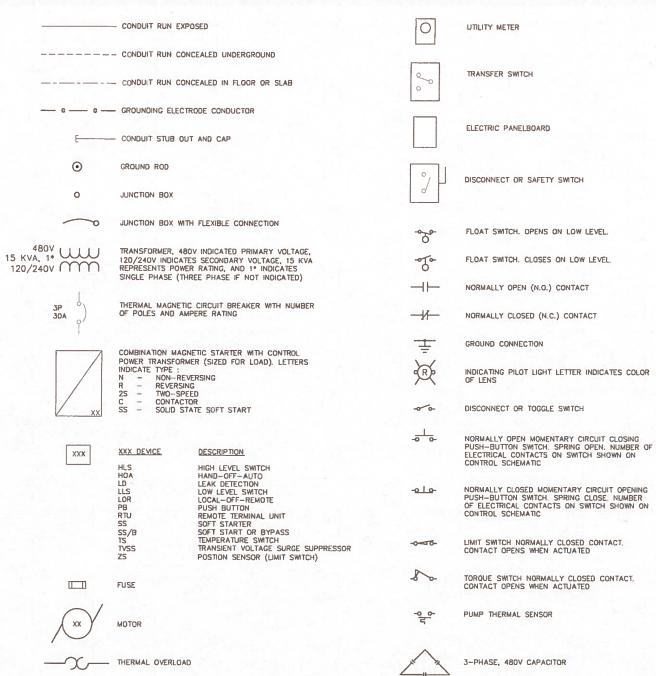

MANATEE COUNTY



NO.


ABBREVIATIONS:

ABOVE FINISHED FLOOR ABOVE FINISHED GRADE ACROSS-THE-LINE AFG ATL C CU EX ELEC EXP FU GFI GND HP IG KVA CONDUIT COPPER ELECTRICAL EXPLOSION PROOF FUSE GROUND FAULT INTERRUPTER GROUNDING CONDUCTOR HORSEPOWER HERTZ ISOLATED GROUND KILOVOLT AMPERES KILOWATTS MAXIMUM KW MAX MIN N/A PH RECP MINIMUM NOT APPLICABLE PHASE RECEPTACLE RPM RTU SPD TYP REVOLUTIONS PER MINUTE REMOTE TERMINAL UNIT SURGE PROTECTION DEVICE TYPICAL

VOLTS

WEATHERPROOF

EXAMPLE OF SECTION CUT AND DETAIL

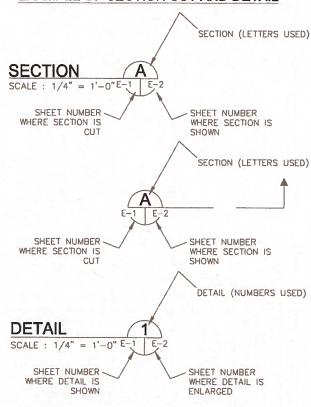

GENERAL NOTES

THE WORK CONSIST OF FURNISHING ALL LABOR, MATERIALS, EQUIPMENT, AND TECHNICAL SUPERVISION TO INSTALL A NEW GENERATOR, TRANSFER SWITCH AND ASSOCIATED EQUIPMENT AS INDICATED AND SHOWN, THE WORK INCLUDES, BUT IS NOT LIMITED TO, THE FOLLOWING:

- 1. CONTRACTOR SHALL SUBMIT SHOP DRAWINGS FOR APPROVAL PRIOR TO PURCHASING EQUIPMENT OR COMMENCING CONSTRUCTION
- 2. CONTROL CONDUCTORS SHALL BE STRANDED COPPER, 14 AWG MINIMUM, WITH THWN INSULATION, UNLESS OTHERWISE NOTED.
- 3. ALL WIRING SHALL BE IDENTIFIED WITH NUMBERS AT ALL TERMINALS AND ON WIRING DIAGRAMS
- FIELD VERIFY ALL EQUIPMENT LOCATIONS AND CONNECTIONS PRIOR TO COMMENCING CONSTRUCTION.
- 6. ALL NEW EQUIPMENT SHALL BE PERMANENTLY IDENTIFIED WITH A BLACK ON WHITE LAMACOID TAG ENGRAVED WITH MINIMUM 3/16 INCH LETTERING.
- 6. ALL CIRCUITS SHALL HAVE A GROUNDING CONDUCTOR ROUTED INSIDE EACH CONDUIT WITH POWER CONDUCTORS.
- 7. ALL CONDUCTOR LENGTHS SHALL BE CONTINUOUS. NO SPLICES OR CONDUCTOR TERMINATIONS SHALL BE PERMITTED UNLESS SPECIFICALLY DESIGNATED IN THE DRAWINGS.
- 8. ALL EXISTING INSTALLATIONS DENOTED ON THE DRAWINGS ARE FOR THE CONTRACTORS REFERENCE ONLY. ALL EXISTING INSTALLATIONS SHALL BE FIELD VERIFIED PRIOR TO SUBMITTING A BID AND PRIOR TO COMMENCING CONSTRUCTION.
- 9. CONDUITS SHALL BE RIGID HEAVY WALL ALUMINUM. FLEXIBLE CONDUITS SHALL BE NONMETALLIC LIQUID TIGHT.
- O. MAKE MODIFICATIONS TO THE EXISTING MOTOR CONTROL CENTER AS SHOWN AND SPECIFIED.
- 11. PROVIDE AND INSTALL GENERATOR WITH WEATHER-PROOF, SOUND ATTENUATED ENCLOSURE AS SHOWN AND SPECIFIED.
- 12. MAKE REQUIRED INTERCONNECTIONS BETWEEN MOTOR CONTROL CENTER COMPONENTS AND NEW GENERATOR AS SHOWN AND SPECIFIED.
- 13. PROVIDE AND INSTALL STAINLESS STEEL CHANNEL ERECTOR SYSTEMS TO MOUNT AND SUPPORT ENCLOSURES, BOXES, CONDUITS AND OTHER EQUIPMENT. ALL MOUNTING HARDWARE SHALL BE 316 SS.
- 14. ALL ELECTRICAL WORK SHALL BE PERFORMED IN ACCORDANCE WITH THE 2014 NATIONAL ELECTRICAL CODE (NEC)
- 15. AFTER COMPLETING THE EQUIPMENT INSTALLATION, THE SYSTEM SHALL BE TESTED TO SHOW FUNCTIONALITY.
- 5. TEST AND START-UP REPORTS FOR THE GENERATOR SYSTEM AND WIRE SHALL BE INCLUDED IN THE OPERATION AND MAINTENANCE (0&M) MANUALS PROVIDED UNDER THIS CONTRACT.

NO 47079

NO 47079

NO 47079

APPROVED

TOT

APPROVED

APPROVED

ELECTRICAL LEGEND AND ABBREVIATIONS

PROJECT NO: 00193009.08 DATE: APRIL 2016 SHEET NO:

E-1

MLS 12-A EMERGENCY GENERATOR REPLACEMENT Cardno
Shaping the Future

MENT


380 PARK PLACE BLVD, STE 300, CLEARWATER FL 33759

TEL: (727) 531-3505 (800) 861-8314

WANN CRIPTON CONT. CARTISTING of Authoritoration No. 29915

DESCRIPTION BY DATE

Update231600127 TBS N1817/scon12A1005112-A Elec SAS dwg LAST SAVED FM QASSWILD-SAS PLOTTED FA QASSWILD-SA

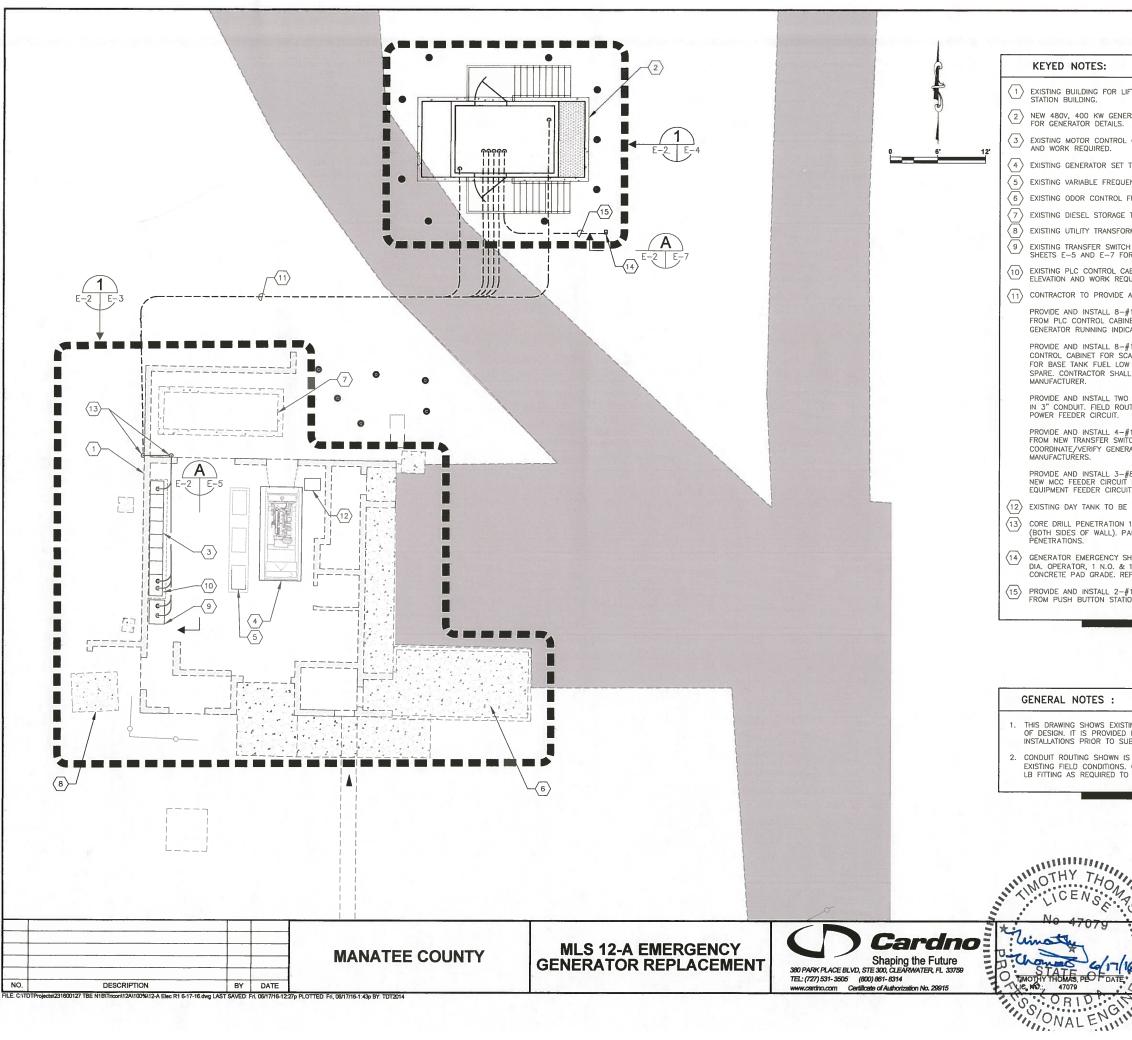

- (1) EXISTING BUILDING FOR LIFT STATION 12-A. REFER TO SHEET E-3 FOR WORK REQUIRED WITHIN THE LIFT
- 2 NEW 480V, 400 KW GENERATOR IN WEATHER-PROOF, SOUND ATTENUATED ENCLOSURE. REFER TO SHEET E-4 FOR GENERATOR DETAILS.
- 3 EXISTING MOTOR CONTROL CENTER (MCC) FOR LIFT STATION 12-A. REFER TO SHEET E-5 FOR MCC ELEVATION AND WORK REQUIRED.
- (4) EXISTING GENERATOR SET TO BE REMOVED. REFER TO CIVIL/MECHANICAL SHEETS FOR DETAILS.
- 5 EXISTING VARIABLE FREQUENCY DRIVES (VFD'S) NO WORK REQUIRED.
- \langle 6 \rangle EXISTING ODOR CONTROL FILTER. NO WORK REQUIRED.
- EXISTING DIESEL STORAGE TANK. REFER TO CIVIL/MECHANICAL SHEETS FOR ANY WORK REQUIRED.
- EXISTING UTILITY TRANSFORMER. NO WORK REQUIRED.
- (9) EXISTING TRANSFER SWITCH FOR LIFT STATION 12-A. EXISTING TRANSFER SWITCH TO BE REPLACED. REFER TO SHEETS E-5 AND E-7 FOR WORK REQUIRED.
- (10) EXISTING PLC CONTROL CABINET FOR LIFT STATION 12-A. REFER TO SHEET E-5 FOR PLC CONTROL CABINET
- $\overline{\langle 11 \rangle}$ CONTRACTOR TO PROVIDE AND INSTALL THE FOLLOWING :

PROVIDE AND INSTALL 8-#12 THWN CU + 1-#12 THWN CU GND IN 3/4" CONDUIT. FIELD ROUTE CONDUIT FROM PLC CONTROL CABINET TO NEW GENERATOR FOR SCADA MONITORING OF GENERATOR. 2-#12 FOR GENERATOR RUNNING INDICATION, 2-#12 FOR GENERATOR FAIL INDICATION AND 4-#12 SPARE.

PROVIDE AND INSTALL 8-#12 THWN CU + 1-#12 THWN CU GND IN 3/4" CONDUIT TO EXISTING PLC CONTROL CABINET FOR SCADA MONITORING OF BASE TANK. 2-#12 BASE TANK LEAK DETECTION ALARM, 2-#12 FOR BASE TANK FUEL LOW LEVEL ALARM, 2-#12 FOR BASE TANK FUEL HIGH LEVEL ALARM AND 2-#12 SPARE. CONTRACTOR SHALL COORDINATE/VERIFY CONNECTION LOCATION AND TYPE WITH ENCLOSURE

PROVIDE AND INSTALL TWO (2) PARALLEL RUNS CONSISTING OF 3-350kcmil THWN CU + 1-#1 THWN CU GND IN 3" CONDUIT. FIELD ROUTE CONDUIT FROM NEW TRANSFER SWITCH TO NEW GENERATOR FOR 480V STANDBY POWER FEEDER CIRCUIT.

PROVIDE AND INSTALL 4-#12 THWN CU + 1-#12 THWN CU GND IN 3/4" CONDUIT. FIELD ROUTE CONDUIT FROM NEW TRANSFER SWITCH TO NEW GENERATOR FOR GENERATOR START SIGNAL. CONTRACTOR TO COORDINATE/VERIFY GENERATOR STARTER CONTROL REQUIREMENTS WITH GENERATOR AND TRANSFER SWITCH MANUFACTURERS.

PROVIDE AND INSTALL 3-#8 THWN CU + 1-#10 THWN CU GND IN 1" CONDUIT. FIELD ROUTE CONDUIT FROM NEW MCC FEEDER CIRCUIT BREAKER TO NEW GENERATOR DISCONNECT SWITCH FOR 480V ANCILLARY EQUIPMENT FEEDER CIRCUIT.

- (12) EXISTING DAY TANK TO BE REMOVED. REFER TO CIVIL/MECHANICAL SHEETS FOR DETAILS.
- CORE DRILL PENETRATION 1/4" LARGER THAN CONDUIT DIAMETER. FILL VOID WITH PAINTABLE SILICONE CHALK (BOTH SIDES OF WALL). PAINT WITH COLOR TO MATCH EXISTING WALL. TYPICAL FOR ALL EXTERIOR WALL
- GENERATOR EMERGENCY SHUT DOWN PUSH BUTTON STATION. MAINTAINED 2 POSITION SWITCH WITH 1-5/8" DIA. OPERATOR, 1 N.O. & 1 N.C. CONTACT MOUNTED IN A NEMA 4X SS ENCLOSURE, 4'-6" ABOVE FINSIHED CONCRETE PAD GRADE. REFER TO SHEET E-7 FOR DETAILS.
- PROVIDE AND INSTALL 2-#12 THWN CU + 1-#12 THWN CU GND IN 3/4" CONDUIT. FIELD ROUTE CONDUIT FROM PUSH BUTTON STATION TO NEW GENERATOR FOR SHUT DOWN SIGNAL.

GENERAL NOTES:

MOTHY THOM

DRAWN


- THIS DRAWING SHOWS EXISTING CONDITIONS USING THE BEST AS-BUILT INFORMATION AVAILABLE AT THE TIME OF DESIGN. IT IS PROVIDED FOR REFERENCE ONLY. THE CONTRACTOR SHALL FIELD VERIFY ALL EXISTING INSTALLATIONS PRIOR TO SUBMITTING A BID AND PRIOR TO COMMENCING CONSTRUCTION.
- 2. CONDUIT ROUTING SHOWN IS DIAGRAMMATICAL. CONTRACTOR SHALL FIELD ROUTE CONDUIT BASED ON EXISTING FIELD CONDITIONS. CONTRACTOR SHALL PROVIDE JUNCTION BOXES, PULL BOXES AND/OR CONDUIT LB FITTING AS REQUIRED TO MEET THE REQUIREMENTS OF THE NATIONAL ELECTRICAL CODE.

O TIMOTHY THOMAS PEO DATE (PPPROVED

ELECTRICAL SITE PLAN

00193009.08

APRII 2016 SHEET NO: E-2

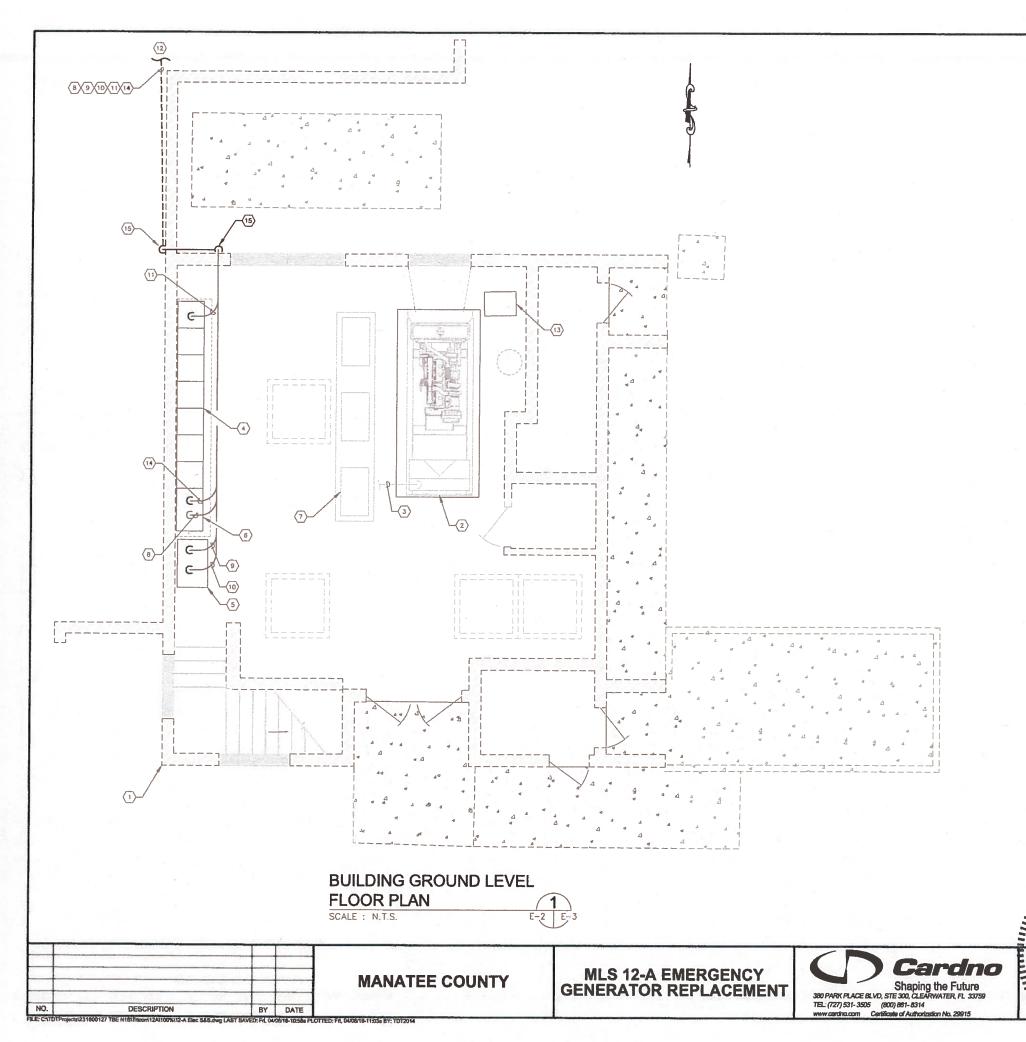

- 1) EXISTING BUILDING FOR LIFT STATION 12-A.
- (2) EXISTING GENERATOR SET TO BE REMOVED, REFER TO CIVIL/MECHANICAL SHEETS FOR DETAILS.
- SUSTING GENERATOR 480V FEEDER TO BE REMOVED. FEEDER CONDUCTORS ARE ROUTED TO EXISTING TRANSFER SWITCH VIA EXISTING NCC AND WIREWAY. CONTRACTOR SHALL REMOVE ENTIRE LENGTH OF CONDUCTORS AND CONDUIT. CONTRACTOR SHALL ALSO REMOVE ALL ANCILLARY EQUIPMENT CONDUCTORS AND CONDUIT CHARGER CIRCUIT, GENERATOR STARTER CIRCUIT, ETC., NOT SHOWN FOR
- EXISTING MOTOR CONTROL CENTER (MCC) FOR LIFT STATION 12-A. REFER TO SHEET E-5 FOR MCC ELEVATION AND WORK REQUIRED.

- (7) EXISTING VARIABLE FREQUENCY DRIVE (VFD). TYPICAL OF THREE (3). NO WORK REQUIRED FOR ANY
- (B) PROVIDE AND INSTALL 8-#12 THWN CU + 1-#12 THWN CU GND IN 3/4" CONDUIT, FIELD ROUTE CONDUIT FROM PLC CONTROL CABINET TO NEW GENERATOR FOR SCADA MONITORING OF GENERATOR. 2-#12 FOR GENERATOR RUNNING INDICATION, 2-#12 FOR GENERATOR FAIL INDICATION AND 4-#12 SPARE.
- PROVIDE AND INSTALL 4-#12 THWN CU + 1-#12 THWN CU GND IN 3/4" CONDUIT. FIELD ROUTE CONDUIT FROM NEW TRANSFER SWITCH TO NEW GENERATOR FOR GENERATOR START SIGNAL. CONTRACTOR TO COORDINATE/NERFY GENERATOR STARTER CONTROL REQUIREMENTS WITH GENERATOR AND TRANSFER SWITCH MANUFACTURERS.
- (1) PROVIDE AND INSTALL 3-#8 THWN CU + 1-#10 THWN CU GND IN 1" CONDUIT. FIELD ROUTE CONDUIT FROM NEW MCC FEEDER CIRCUIT BREAKER TO NEW GENERATOR DISCONNECT SWITCH FOR 480V ANGILLARY EQUIPMENT FEEDER CIRCUIT.
- (12) FOR CONTINUATION OF CONDUITS TO GENERATOR REFER TO SHEET E-4.
- (13) EXISTING DAY TANK TO BE REMOVED. REFER TO CIVIL/MECHANICAL SHEETS FOR DETAILS.
- PROVIDE AND INSTALL 8-\$12 THWN CU + 1-\$12 THWN CU GND IN 3/4" CONDUIT TO EXISTING PLC CONTROL CABINET FOR SCADA MONITORING OF BASE TANK 2-\$12 BASE TANK LEAK DETECTION ALARM, 2-\$12 FOR BASE TANK FUEL LOW LEVEL ALARM, 2-\$12 FOR BASE TANK FUEL HIGH LEVEL ALARM AND 2-\$12 SPARE. CONTRACTOR SHALL COORDINATE/VERIFY CONNECTION LOCATION AND TYPE WITH ENCLOSURE MANUFACTURER.
- (TS) CORE DRILL PENETRATION 1/4" LARGER THAN CONDUIT DIAMETER. FILL VOID WITH PAINTABLE SILCONE CHALK (BOTH SIDES OF WALL). PAINT WITH COLOR TO MATCH EXISTING WALL. TYPICAL FOR ALL EXTERIOR WALL PENETRATIONS.

GENERAL NOTES :

- CONDUIT ROUTING SHOWN IS DIAGRAMMATICAL CONTRACTOR SHALL FIELD ROUTE CONDUIT BASED ON EXISTING FIELD CONDITIONS. CONTRACTOR SHALL PROVIDE JUNCTION BOXES, PULL BOXES AND/OR CONDUIT LB FITTING AS REQUIRED TO MEET THE REQUIREMENTS OF THE NATIONAL ELECTRICAL CODE.

00193009.08

APRIL 2016

E-3


SHEET NO:

No 47079

WONAL THE ONAL

HINNING THE THE

BUILDING LAYOUT GROUND LEVEL

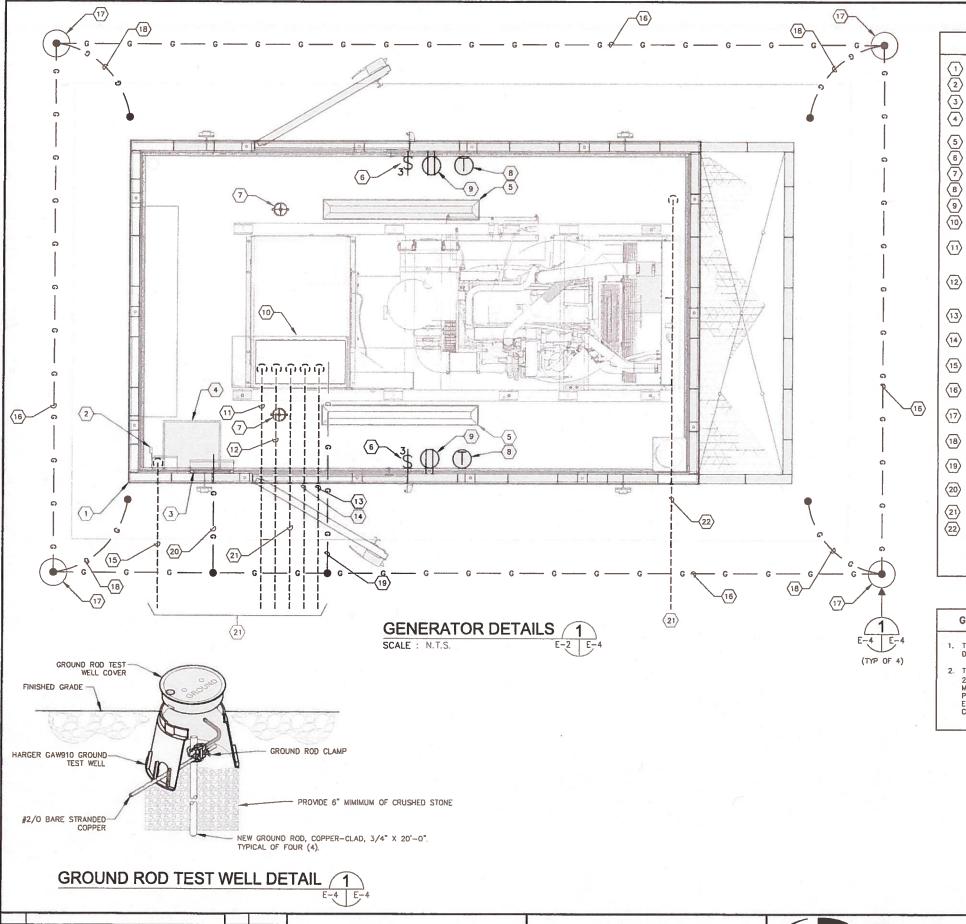

- $\stackrel{\textstyle (1)}{}$ NEW 480V, 400 KW GENERATOR IN WEATHER-PROOF, SDUND ATTENUATED ENCLOSURE. REFER ALSO TO SPECIFICATIONS,
- (2) 60 AMPERE FUSED DISCONNECT SWITCH PROVIDED AND INSTALLED AS PART OF THE ENCLOSURE PACKAGE.
- (3) 100 AMPERE, 120/208V, 30, MCB LOADCENTER PROVIDED AND INSTALLED AS PART OF THE ENCLOSURE PACKAGE.
- 4 25 KVA, 480V-120/208V, 39, TRANSFORMER PROVIDED AND INSTALLED AS PART OF THE ENCLOSURE PACKAGE. TRANSFORMER LOCATED ABOVE DISCONNECT AND LOADCENTER.
- (5) DUAL TUBE FLUORESCENT LIGHT FIXTURE PROVIDED AND INSTALLED AS PART OF THE ENCLOSURE PACKAGE.
- 3-WAY SWITCHES PROVIDED AND INSTALLED AS PART OF THE ENCLOSURE PACKAGE.
- DC LIGHT FIXTURES PROVIDED AND INSTALLED AS PART OF THE ENCLOSURE PACKAGE.
- (B) 60 MINUTE TIMER SWITCHES FOR DC LIGHT FIXTURES PROVIDED AND INSTALLED AS PART OF THE ENCLOSURE PACKAGE.
- 9 20A, 125V DUPLEX GFCI RECEPTACLE PROVIDED AND INSTALLED AS PART OF THE ENCLOSURE PACKAGE.
- TO STUBUP LOCATION FOR 480V FEEDER CIRCUIT, GENERATOR STARTER CIRCUIT, GENERATOR SHUT DOWN AND SCADA I/O. COORDINATE/VERIFY EXACT LOCATION WITH ENCLOSURE MANUFACTURER.
- (11) PROVIDE AND INSTALL 8-#12 THWN CU + 1-#12 THWN CU GND IN 3/4" CONDUIT TO EXISTING PLC CONTROL CABINET FOR SCADA MONITORING OF GENERATOR. 2-#12 FOR GENERATOR RUNNING INDICATION, 2-#12 FOR GENERATOR FAIL INDICATION AND 4-#12 SPARE.
- PROVIDE AND INSTALL 4-#12 THWN CU + 1-#12 THWN CU GND IN 3/4" CONDUIT TO EXISTING TRANSFER SWITCH FOR GENERATOR START SIGNAL. CONTRACTOR TO COORDINATE/VERIFY GENERATOR STARTER CONTROL REQUIREMENTS WITH GENERATOR AND TRANSFER SWITCH MANUFACTURERS
- PROVIDE AND INSTALL 2-#12 THWN CU + 1-#12 THWN CU GND IN 3/4" CONDUIT TO NEW EMERGENCY SHUT DOWN PUSH BUTTON STATION FOR SHUT DOWN SIGNAL.
- PROVIDE AND INSTALL TWO (2) PARALLEL RUNS CONSISTING OF 3-350 kcmil THWN CU + 1-#1 THWN CU GND IN 3" CONDUIT TO EXISTING TRANSFER SWITCH FOR 480V STANDBY POWER FEEDER CIRCUIT.
- 15) PROVIDE AND INSTALL 3-#8 THWN CU + 1-#10 THWN CU GND IN 1" CONDUIT TO NEW MCC FEEDER CIRCUIT BREAKER FOR 480V ANCILLARY EQUIPMENT FEEDER CIRCUIT.
- (16) CONTRACTOR TO PROVIDE AND INSTALL GROUND RING CONSISTING OF #2/0 BARE STRANDED COPPER DIRECT BURIED IN SOIL A MINIMUM OF 24" BELOW GRAVEL BASE.
- CONTRACTOR TO PROVIDE AND INSTALL NEW GROUND ROD, COPPER-CLAD, 3/4" X 20'-0" AND GROUND ROD TEST WELL. REFER ALSO TO GROUND ROD DETAIL ON THIS SHEET. TYPICAL OF FOUR (4).
- (18) CONTRACTOR TO PROVIDE AND INSTALL A #2/O AWG BARE COPPER CONDUCTOR BETWEEN THE GROUND ROD AND THE REINFORCING STEEL EMBEDDED IN THE GENERATOR CONCRETE PAD. PROVIDE EXOTHERMIC WELDS.
- (19) CONTRACTOR TO PROVIDE AND INSTALL #2/O BARE STRANDED COPPER GROUNDING ELECTRODE CONDUCTOR FOR GENERATOR FRAME, PROVIDE EXOTHERMIC WELD TO GROUNDING GRID.
- (20) CONTRACTOR TO PROVIDE AND INSTALL #8 BARE STRANDED COPPER GROUNDING ELECTRODE CONDUCTOR FOR ANCILLARY TRANSFORMER GROUNDING PROVIDE EXOTHERMIC WELD TO GROUNDING GRID.
- 21) FOR CONTINUATION OF CONDUITS TO PUMP STATION 12-A BUILDING REFER TO SHEET E-3.

No 47079

STONALE

(22) PROVIDE AND INSTALL 8-#12 THWN CU + 1-#12 THWN CU GND IN 3/4" CONDUIT TO EXISTING PLC CONTROL CABINET FOR SCADA MONITORING OF BASE TANK. 2-#12 BASE TANK LEAK DETECTION ALARM, 2-#12 FOR BASE TANK FUEL LOW LEVEL ALARM, 2-#12 FOR BASE TANK FUEL LOW LEVEL ALARM, AND 2-#12 SPARE. CONTRACTOR SHALL COORDINATE/VERIFY CONNECTION LOCATION AND TYPE WITH ENCLOSURE MANUFACTURER.

GENERAL NOTES :

- THIS DRAWING SHOWS LAYOUTS AND DIMENSIONS BASED ON A PARTICULAR MANUFACTURER, THE CONTRACTOR SHALL COORDINATE DIMENSIONS, STUBUP LOCATIONS AND EQUIPMENT LOCATIONS WITH THE MANUFACTURER SUBMITTED/PROVIDED.
- 2. THE GENERATOR ENCLOSURE SHALL BE PROVIDED WITH A 60 AMPERE DISCONNECT SWITCH, 120/208V, 30, MCB LOADCENTER, 25 KVA, 480V-120/208V, 30, TRANSFORMER, FLUORESCENT LIGHTING FIXTURES, 3-WAY SWITCHES, DC LIGHTING FIXTURES, 60 MINUTE TIMER SWITCHES FOR DC LIGHT FIXTURES, DUPIEX GFCI RECEPTACLES, BASE TANK, BASE TANK SUPPLY AND RETURN PUMPS AND BASE TANK CONTROLLER AS NOTED AND SPECIFIED. ALL EQUIPMENT PROVIDED BY THE SUPPLIER OF THE ENCLOSURE PACKAGE SHALL BE PROVIDED AND INSTALLED WITH ALL ASSOCIATED CONDUIT AND CONDUCTORS FOR POWER AND CONTROLS AS REQUIRED FOR A COMPLETE AND FUNCTIONING UNIT.

TRICON ENGINEERING IT I NOW STORY IN THE PARTY IS NOW IT IN

NO. DESCRIPTION BY DATE

FILE CATO I Projects 231600127 TRE N18/I doors 12/A1009/12/A Fine SAS than I AST SAVET- Ed OA

MANATEE COUNTY

MLS 12-A EMERGENCY GENERATOR REPLACEMENT




Shaping the Future 380 PARK PLACE BLVD, STE 300, CLEARWATER, FL 33759 TEL (727) 531-3505 (800) 861-8314

GENERATOR DETAILS

PROJECT NO: 00193009.08

> APRIL 2018 SHEET NO: E-4

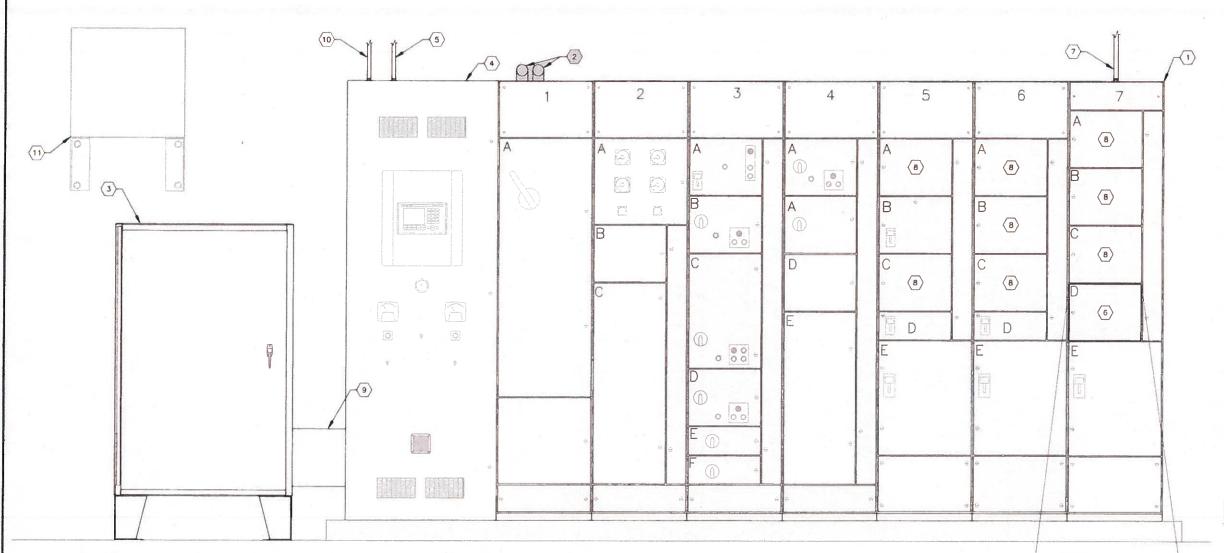


- EXISTING GE 7700 LINE MOTOR CONTROL CENTER FOR LIFT STATION 12-A.
- (2) EXISTING FEEDERS FROM EXISTING GENERATOR. EXISTING GENERATOR TO BE REMOVED. CONTRACTOR SHALL REMOVE EXISTING FEEDER (CONDUITS AND CONDUCTORS) FROM EXISTING AUTOMATIC TRANSFER SWITCH (ATS) TO EXISTING GENERATOR.
- (4) EXISTING PLC CONTROL CABINET.
- 5 PROVIDE AND INSTALL 8-#12 THWN CU + 1-#12 THWN CU GND IN 3/4" CONDUIT. FIELD ROUTE CONDUIT FROM PLC CONTROL CABINET TO NEW GENERATOR FOR SCADA MONITORING OF GENERATOR. 2-#12 FOR GENERATOR RUNNING INDICATION, 2-#12 FOR GENERATOR FAIL INDICATION AND 4-#12 SPARE.
- EXISTING SPARE 12" SPACE IN GE 7700 LINE MCC (AT 7D). CONTRACTOR SHALL PROVIDE NEW 480V, 3—POLE, 40A CIRCUIT BREAKER FOR THE NEW GENERATOR 480V ANCILLARY EQUIPMENT FEEDER CIRCUIT. CONTRACTOR SHALL PROVIDE CIRCUIT BREAKER AND ALL ASSOCIATED EQUIPMENT (BUCKET, CIRCUIT BREAKER DOOR, CIRCUIT BREAKER THROUGH—DOOR OPERATING HANDLE, CIRCUIT BREAKER STABS, ETC.) FOR COMPLETE INSTALLATION.
- 7 PROVIDE AND INSTALL 3-#8 THWN CU + 1-#10 THWN CU GND IN 1" CONDUIT. FIELD ROUTE CONDUIT FROM NEW MCC FEEDER CIRCUIT BREAKER TO NEW GENERATOR DISCONNECT SWITCH FOR 480V ANCILLARY EQUIPMENT FEEDER CIRCUIT.
- (8) ALTERNATE SPARE 12" BUCKETS IN GE 7700 LINE MCC.
- EXISTING WIREWAY AND CONDUIT USED AS RACEWAY FOR CONDUCTORS FROM EXISTING MCC TO NEW ATS, CONDUCTORS FOR EXISTING GENERATOR (GENERATOR TO BE REMOVED) SHALL BE REMOVED. REFER ALSO TO SHEET E-7.
- (10) PROVIDE AND INSTALL B-#12 THWN CU + 1-#12 THWN CU GND IN 3/4" CONDUIT TO EXISTING PLC CONTROL CABINET FOR SCADA MONITORING OF DAY TANK. 2-#12 DAY TANK LEAK DETECTION ALARM, 2-#12 FOR DAY TANK FUEL LOW LEVEL ALARM, 2-#12 FOR DAY TANK FUEL HIGH LEVEL ALARM AND 2-#12 SPARE. CONTRACTOR SHALL COORDINATE/VERIFY CONNECTION LOCATION AND TYPE WITH ENCLOSURE MANUFACTURER.
- EXISTING TRANSFORMER MOUNTED ON WALL ABOVE EXISTING TRANSFER SWITCH. NO WORK REQUIRED.

LIFT STATION 12-A MCC ELEVATION

SCALE : N.T.

GENERAL NOTES:

- THE CONTRACTOR SHALL PROVIDE FOR THE NEW SCADA INPUT/OUTPUTS (I/O) AS REQUIRED FOR THE NEW GENERATOR INSTALLATION. THE NEW SCADA I/O SHALL CONSIST OF THE FOLLOWING:
- DISCRETE INPUT GENERATOR RUNNING INDICATION
 DISCRETE INPUT GENERATOR FAIL INDICATION
 DISCRETE INPUT BASE TANK LEAK DETECTION ALARM
 DISCRETE INPUT BASE TANK FUEL LOW LEVEL ALARM
 DISCRETE INPUT BASE TANK FUEL HIGH LEVEL ALARM
- 2. THE CONTRACTOR SHALL PROVIDE NEW CONDUCTORS AND CONDUIT AS INDICATED ON THE DRAWINGS FOR THE NEW SCADA I/O. THE CONTRACTOR SHALL TERMINATE ALL NEW CONDUCTORS ON THE EXISTING CONTROLLER AND PROVIDE FOR THE PROGRAMMING OF THE EXISTING CONTROLLER IN ORDER TO INTEGRATE THE NEW I/O INTO THE COUNTY'S EXISTING SCADA SYSTEM. THE CONTRACTOR SHALL COORDINATE THIS WORK WITH MANATEE COUNTY.

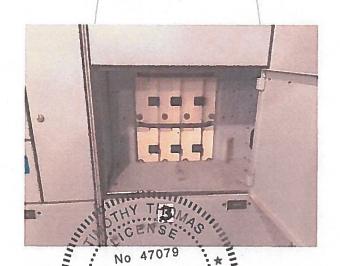

TRICOR ENGINEERING 1715. Person benefiled STE 28 TABLEY, P.J. 813, 227, 9190 FAX, 813, 222, 9

NO. DESCRIPTION BY DATE

FLE: CNDTProtects/236900127 TRE MIDIT description State Flat Revenue ART CAMER DE AUGUSTES, STOCKE DE C

MANATEE COUNTY

MLS 12-A EMERGENCY GENERATOR REPLACEMENT




STIADING 410 FULUTO
380 PARK PLACE BLVD, STE 300, CLEARWATER, FL 33759
TEL: (727) 531-3505 (800) 881-8314
www.cardno.com Certificate of Authorization No. 29915


THE OF THE TOT OT OTHER THE TOT OF THE TOT OT OTHER TOT OF THE TOT OF THE TOT OF THE TOT OT OTHER THE TOT OT OTHER TOT OTHER TOT OTHER TOT OTHER TOT OTHER TOT OTHER TOT OTH OTHER TOT OTHER


LIFT STATION 12-A MCC ELEVATON

PROJECT NO: 00193009.08 DATE:

APRIL 2016 SHEET NO: E-5

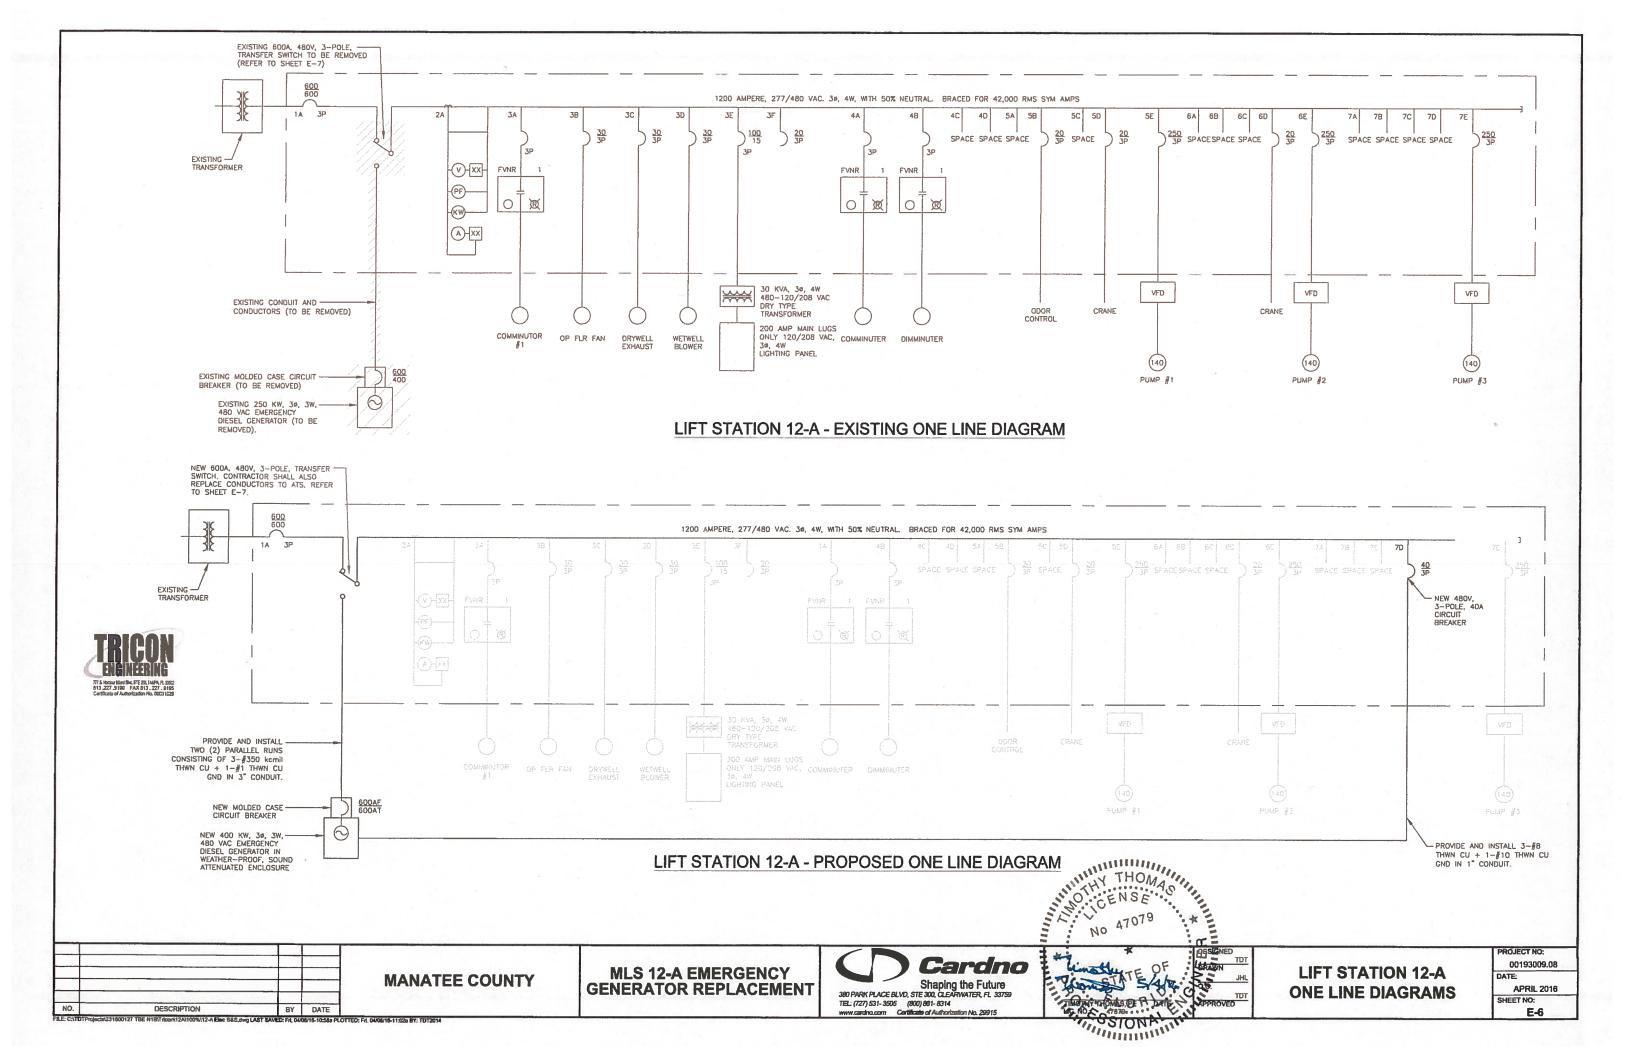

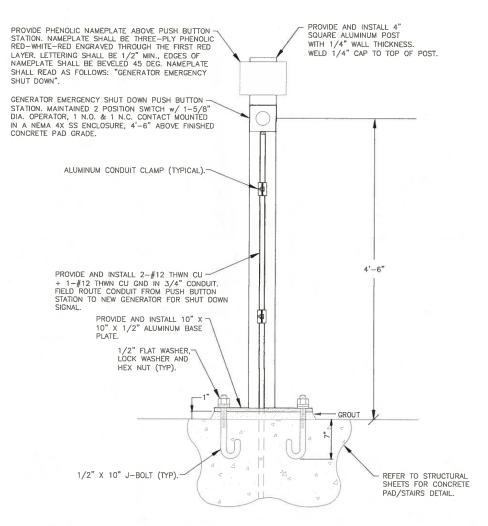

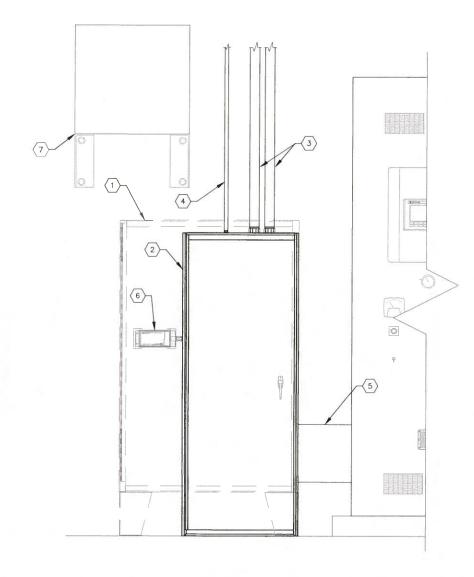

NEW ATS INSTALLATION ELEVATION NO SCALE

KEYED NOTES:

- EXISTING ATS TO BE SALVAGED AND RETURNED TO MANATEE COUNTY.
- NEW 600A, 480V, 3-POLE, ATS WITH SOLID NEUTRAL IN FREE-STANDING ENCLOSURE. REFER ALSO TO SPECIFICATIONS. NEW TRANSFER SWITCH DIMENSIONS ARE APPROXIMATELY 24"W x 63"H x 17"D.
- PROVIDE AND INSTALL TWO (2) PARALLEL RUNS CONSISTING OF 3-350 kcmil THWN CU + 1-#1 THWN CU GND IN 3" CONDUIT TO NEW GENERATOR. FIELD ROUTE CONDUIT FROM NEW TRANSFER SWITCH TO NEW GENERATOR FOR 480V STANDBY POWER FEEDER CIRCUIT.
- PROVIDE AND INSTALL 4-#12 THWN CU + 1-#12 THWN CU GND IN 3/4" CONDUIT. FIELD ROUTE CONDUIT FROM NEW ATS TO NEW GENERATOR FOR GENERATOR START SIGNAL. CONTRACTOR TO COORDINATE/VERIFY GENERATOR STARTER CONTROL REQUIREMENTS WITH GENERATOR AND TRANSFER SWITCH MANUFACTURERS.
- 5) EXISTING WIREWAY AND CONDUIT USED AS RACEWAY FOR EXISTING CONDUCTORS. CONTRACTOR SHALL —

REMOVE EXISTING WIREWAY AND PROVIDE NEW WIREWAY OF THE SAME MATERIALS/DIMENSIONS TO EXTEND TO NEW ATS.

REMOVE EXISTING NORMAL POWER CONDUCTORS FROM EXISTING MAIN CIRCUIT BREAKER TO EXISTING ATS AND REPLACE WITH TWO (2) PARALLEL RUNS CONSISTING OF 3-350 kcmil CU + 1/0 THWN CU NEUTRAL + 1-#1 THWN

REMOVE EXISTING ATS LOAD SIDE CONDUCTORS TO MCC AND REPLACE WITH TWO (2) PARALLEL RUNS CONSISTING OF 3-350 kemil THWN CU \pm 1/0 THWN CU NEUTRAL + 1-#1 THWN CU GND.

- (6) CONTRACTOR TO PROVIDE AND INSTALL NEW SURGE PROTECTION DEVICE (SPD). 480V, 3ø, 4-WIRE + GROUND. ADVANCED PROTECTION TECHNOLOGIES (APT) CAT# TEO4XCS10. PROVIDE AND INSTALL 3-#10 XHHW-2 CU + 1-#10 XHHW-2 CU GND IN 3/4" CONDUIT FROM NEW SURGE PROTECTION DEVICE TO LOAD SIDE OF NEW ATS. MOUNT SPD ON WALL WITH 1-5/8" X 1-5/8"
- 7) EXISTING TRANSFORMER MOUNTED ON WALL ABOVE EXISTING TRANSFER SWITCH. NO WORK REQUIRED.

ATS GENERAL NOTES:

- THE CONTRACTOR SHALL PROVIDE LUGS AS REQUIRED TO ACCOMMODATE THE NEW CONDUCTORS TO BE INSTALLED
- THE CONTRACTOR SHALL CONNECT ALL EQUIPMENT GROUND CONDUCTORS (NOT SHOWN FOR CLARITY).
- CONTRACTOR TO REMOVE ALL EXISTING CONTROL CONDUCTORS FROM EXISTING GENERATOR (TO BE REMOVED) TO EXISTING ATS (TO BE REMOVED). PROVIDE NEW CONTROL CONDUCTORS/CONDUIT AS INDICATED ON THIS
- REFER TO SPECIFICATION SECTION 00800 FOR TEMPORARY POWER REQUIREMENTS.
- CONTRACTOR SHALL DUPLICATE ALL EXISTING CONDUCTOR
 ROUTES/SIZES/QUANTITIES. CONTRACTOR TO FIELD VERIFY ALL EXISTING CONDITIONS PRIOR TO ORDERING MATERIALS/EQUIPMENT OR COMMENCING

EMERGENCY SHUTOFF PUSH BUTTON ELEVATION (A



DESCRIPTION BY DATE

MANATEE COUNTY

MLS 12-A EMERGENCY GENERATOR REPLACEMENT



www.cardno.com Certificate of Authorization No. 29915

THIRMOTHY THOMAS No 47079 DRAWN TIMOTHY THOMAS, PE D. ",,ONAL ENGIN

LIFT STATION 12-A ATS REPLACEMENT **DETAILS**

00193009.08

77 S. Hestour Island Blad, STE 250, TANPA, PL 33502 313 . 227 . 9190 FAX 813 , 227 . 9195

APRIL 2016 SHEET NO: E-7

cdst231600127 TBE N1B\Tricon\12A\100%\12-A Elec R1 6-17-16.dwg LAST SAVED: Fri, 06/17/16-12-27p PLOTTED: Fri, 06/17/16-1:42p BY: TDT2014

GENERAL STRUCTURAL NOTES

CODES

2014 FLORIDA BUILDING CODE

REINFORCED CONCRETE: "BUILDING CODE REQUIREMENTS FOR STRUCTURAL

MASONRY: "BUILDING CODE REQUIREMENTS FOR MASONRY STRUCTURES" (TMS 402-11/ACI 530-11/ASCE 5-11)

ALUMINUM: ALUMINUM DESIGN MANUAL: PART 1 - A SPECIFICATION FOR ALUMINUM STRUCTURES (ADM1-2010)

DESIGN LIVE LOADS:

- PROCESS RELATED STRUCTURES

WALKWAYS, STAIRWAYS AND LANDINGS ELEVATED SLABS

156 MPH 121 MPH

PARTIALLY ENCLOSED ±0.55

SUPERIMPOSED DEADLOADS

-	ROOFS	AS	NOTED
-	FLOORS	AS	NOTED

WIND LOADS:

- ULTIMATE DESIGN WIND SPEED, V_{ULT} (3-SECOND GUST)
 NOMINAL DESIGN WIND SPEED, V_{ASD}
 RISK CATEGORY
- EXPOSURE CATEGORY ENCLOSURE CLASSIFICATION
- INTERNAL PRESSURE COEFFICIENT, GCpi
 DESIGN PRESSURES: PER ASCE 7-10

FOUNDATIONS

- ALLOWABLE BEARING PRESSURE FOR MAT FOOTINGS OVER SUBSURFACE PREPARED AS PER DRAWINGS: 2500 PSF

ALL STRUCTURAL DRAWINGS SHALL BE USED IN CONJUNCTION WITH THE MECHANICAL, CIVIL, ELECTRICAL, AND SHOP DRAWINGS AND SPECIFICATIONS.

THE CONTRACTOR SHALL REVIEW AND VERIFY DIMENSIONS SHOWN IN ALL PLANS AND REVIEW ALL FIELD CONDITIONS THAT MAY AFFECT THE INSTALLATION OF THE WORK SHOWN. SHOULD DISCREPANCIES APPEAR, THE CONTRACTOR SHALL NOTIFY THE ENGINEER IN WRITING TO OBTAIN

FOR ALL ITEMS EMBEDDED IN OR PASSED THOUGH CONCRETE, THE CONTRACTOR SHALL INITIALLY REFER TO MECHANICAL, HEATING, AND VENTILATION DRAWINGS FOR TYPE, SIZE, LOCATION, AND SPECIAL INSTALLATION REQUIREMENTS FOR THESE ITEMS.

THE CONTRACTOR SHALL TAKE ANY AND ALL NECESSARY MEASURES TO PROTECT EXISTING STRUCTURES FROM DAMAGE WHEN WORKING IN AND AROUND EXISTING STRUCTURES PERFORMING WORK SUCH AS DEMOLITION, FOUNDATION EXCAVATION, AND OTHERS.

SIZE AND LOCATION OF EQUIPMENT PADS AND ANCHOR BOLTS SHALL BE PER EQUIPMENT MANUFACTURERS REQUIREMENTS.

ANY EQUIPMENT THAT MAY INDUCE VIBRATION TO THE STRUCTURE SHALL BE ADEQUATELY ISOLATED FROM THE STRUCTURES.

ALL DETAILS AND SECTIONS SHOWN ON THE DRAWINGS ARE INTENDED TO BE TYPICAL AND SHALL BE CONSTRUED TO APPLY TO ANY SIMILAR SITUATION ELSEWHERE ON THE PROJECT, EXCEPT WHERE A DIFFERENT DETAIL IS SHOWN.

STANDARD DETAILS APPLY TO ALL SIMILAR SITUATIONS ON THE PROJECT EXCEPT WHERE A DIFFERENT DETAIL IS SHOWN.

REINFORCEMENT SHALL CONFORM TO ASTM A615, GRADE 60 REQUIREMENTS. WELDED WIRE FABRIC, ASTM A185. ALL ACCESSORIES SHALL BE IN CONFORMANCE WITH ACI 315 REQUIREMENTS. REINFORCING STEEL SHALL HAVE THE FOLLOWING CLEAR COVER UNLESS OTHERWISE NOTED:

- CONCRETE CAST AGAINST EARTH

- FORMED SURFACES

LAP SPLICES SHALL BE AS SHOWN ON THE DRAWINGS. FOR LAP SPLICES NOT SHOWN ON THE DRAWINGS, THE CONTRACTOR SHALL OBTAIN ENGINEERS

THE CONTRACTOR SHALL PREPARE PLACING DRAWINGS AND SCHEDULES IN CONFORMANCE WITH ACI 315 REQUIREMENTS.

UNLESS OTHERWISE NOTED, THE MINIMUM REINFORCING FOR ALL CONCRETE WALLS AND SLABS SHALL BE AS FOLLOWS:

MINIMUM REINFORCING						
THICKNESS	6*	8"	10"	12"-16"	18"-22"	24"
REINF. EACH WAY	#4AT12"	#5AT12"	#4AT12"	#5AT12"	#6AT12"	#7AT12"
LOCATION	CENTER	CENTER	EF	EF	EF	EF

MASONRY

- DESIGN COMPRESSIVE STRENGTH OF MASONRY AT 28 DAYS
- ALLOWABLE STEEL STRESS

f'm = 1500 PSI fs = 24,000 PSI

SPECS SS STD STL REINF TB T&B

T&B
T/STRUCTURE
TYP
UNO
VERT
WWF
SJ

MATERIALS:

- BLOCK: CONFORM TO ASTM C90 LOAD BEARING, NORMAL WEIGHT TWO-CELL 8"x8"x16", 12"x8"x16".
- MORTAR: CONFORM TO ASTM C270, TYPE S, MINIMUM COMPRESSIVE STRENGTH AT 28 DAYS 1800 PSI. UTILIZE TYPE II CEMENT AND TYPE S LIME. MASONRY CEMENT WILL NOT BE CONSIDERED.
- GROUT: CONFORM TO C476, COURSE GROUT, MINIMUM COMPRESSIVE STRENGTH AT 28 DAYS 2500 PSI
- STEEL: BOND BEAM AND FILLED CELL REINFORCEMENT AS NOTED ON DRAWINGS (ASTM A615, GRADE 60). DUR-O-WALL OR EQUAL JOINT REINFORCEMENT AT EVERY OTHER COURSE (16" O.C.).

- THE CONCRETE FOR FILLED CELLS SHALL BE RODDED OR PUDDLED DURING PLACEMENT TO INSURE COMPLETE FILLING TO THE BLOCK CORE.
- PROVIDE CLEAN OUT AND INSPECTION BLOCK OUT IN CELLS CONTAINING REINFORCEMENT FOR GROUT LIFTS EXCEEDING 5'-0"

CONCRETE

ABBREVIATIONS STRUCTURAL ABBREVIATIONS APPLY TO "S" SHEETS ONLY

MAT'L MAX MIN MO MISC NTS OC PLF PT

EXPANSION JOINT

EACH WAY EXPANSION FIRE EXTINGUISHER FAR FACE

HORIZONTAL HIGH POINT INSIDE DIAMETER

JOINT LOW POINT

FIBER REINFORCED PLASTIC FOOTING

FI EVATIONS

ALL MATERIALS AND METHODS OF CONSTRUCTION SHALL BE IN ACCORDANCE WITH ACI 318 REQUIREMENTS (LATEST EDITION)

ALL CONCRETE SHALL BE AIR-ENTRAINED WITH $\underline{4000}$ PSI COMPRESSIVE STRENGTH AT 28 DAYS UNLESS OTHERWISE NOTED.

WATER REDUCING AGENT SHALL BE IN ACCORDANCE WITH ASTM C494

ALL CONCRETE SURFACES EXPOSED TO AIR, UNLESS OTHERWISE NOTED IN SPECIFICATIONS, SHALL BE TREATED WITH AN APPROPRIATE CURING COMPOUND AS SOON AS CEMENT FINISHING IS COMPLETED OR FORMS ARE

THE CONTRACTOR SHALL OBTAIN ENGINEER'S APPROVAL FOR THE LOCATIONS OF CONSTRUCTION JOINTS THAT ARE NOT SHOWN ON THE DRAWINGS.

MANUFACTURER

MASONRY OPENING
MISCELLANEOUS
NOT TO SCALE
ON CENTER
POUNDS PER LINEAR FOOT
PRESSURE TREATED
PROJECTION
POUNDS PER SQUARE FOOT
POUNDS PER SQUARE INCH

GENERATOR EXHAUST OPENING GENERATOR LOUVER 11/1/1/1/1/1


EXISTING SITE

PLAN 3/16"=1'-0



REMOVE EXISTING _
GENERATOR LOUVER AND

PHOTOGRAPH #1 - TYPICAL VIEW OF EXTERIOR OF BUILDING SHOWING LOUVER AND EXHAUST MUFFLER.

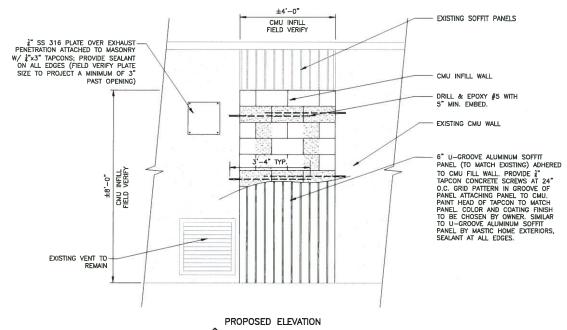

OH VINCEN **ELEVATION** No. 71407

GENERAL NOTES.

00193009.08 DATE: JUNE 2016 SHEET NO

S-1

DEMOLITION PLAN AND WALL ELEVATION

ENGINEERING

AL, ALU, ALUM ADDT'L BTWN BLD BOT CJ CMU CONST JT CONT DIA DO DWG EF

TECHNOLOGIES, INC.

ALUMINUM

BETWEEN BUILDING BOTTOM

DIAMETER

EACH FACE

CONTROL JOINT

CONCRETE MASONRY UNIT

FRP FTG HORIZ HP ID JT LP

ADDITIONAL

3551 W. LAKE MARY BLVD., SUITE 210 LAKE MARY, FL 32746

PHONE: (407) 322-0500 FAX: (407) 322-0023 ET PROJECT No. - 15-161 DESCRIPTION BY DATE

MANATEE COUNTY

MLS 12-A EMERGENCY GENERATOR REPLACEMENT

SPECIFICATIONS STAINLESS STEEL STANDARD STEEL REINFORCEMENT

REINFORCEMENT
TIE BEAM
TOP AND BOTTOM
TOP OF STRUCTURE
TYPICAL
UNLESS NOTED OTHERWISE
VERTICAL
WELDED WIRE FABRIC
SAWCUT JOINT



CLEARWATER PARK PLACE BLVD, STE 300, CLEARWATER, FL. 33759

STATE OF BOT DALE DATE AND VALE PROPERTY.

