
CONTRACT DRAWINGS



# MLS 1-M (RTU#203) EMERGENCY GENERATOR REPLACEMENT FOR

MANATEE COUNTY, FLORIDA COUNTY PROJECT NUMBER: 6022383

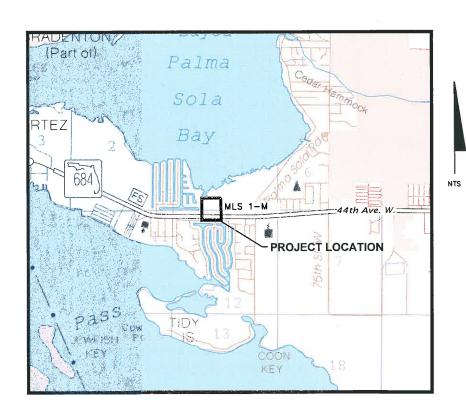

# **INDEX OF SHEETS**

SHEET NO	SHEET DESCRIPTION
G-1	COVER
G-2	GENERAL NOTES & SYMBOLOG
C-1	SITE PLAN
C-2	SITE DEMOLITION PLAN
C-3	SITE LAYOUT
C-4	BUILDING DEMOLITION PLAN
C-5	SITE PHOTOS
C-6	DETAIL SHEET
C-7	DETAIL SHEET
E-1 TO E-7	ELECTRICAL SHEETS
S-1 TO S-3	STRUCTURAL SHEET




48 HOURS BEFORE DIGGING
"CALL SUNSHINE"
1-800-432-4770

# **UTILITY WARNING NOTE**

ABOVE GROUND AND / OR UNDERGROUND UTILITIES MAY BE IN THE AREA OF THIS PROJECT - PROCEED WITH CAUTION - THE CONTRACTOR SHALL CALL SUNSHINE STATE "ONE CALL" AT 1-800-432-4770 AND THE UTILITY OWNERS IN ADVANCE OF BEGINNING WORK, IN ACCORDANCE WITH CHAPTER 556, FLORIDA STATUTES.

ATTENTION IS DIRECTED TO THE FACT THAT THESE PLANS
MAY HAVE BEEN REDUCED IN SIZE BY REPRODUCTION.
THIS MUST BE CONSIDERED WHEN OBTAINING SCALED DATA.

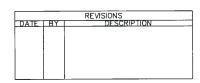





KELLY S. WEHNER, PE ENGINEER OF RECORD FL. LICENSE NO.

DATE: MARCH 2016
SHEET: G-1

# GENERAL NOTES

- ALL WORKMANSHIP AND MATERIALS USED IN THE CONSTRUCTION OF THIS PROJECT SHALL BE NEW AND UNUSED AND CONFORM TO, OR EXCEED THE LATEST LOCAL JURISDICTION STANDARDS.
- CONTACT SUNSHINE STATE ONE CALL FOR UTILITY LOCATES A MINIMUM OF 48-HOURS AND A MAXIMUM OF 5-DAYS PRIOR TO START OF CONSTRUCTION AT 1-800-432-4770.
- THE CONTRACTOR SHALL NOTIFY UTILITY OWNERS A MINIMUM OF 2-DAYS AND A MAXIMUM OF 5-DAYS
  PRIOR TO START OF CONSTRUCTION.

UTILITY OWNER		CONTACT NAME	CONTACT NUMBER
	BRIGHT HOUSE NETWORKS	TOM WRIGHT	(941) 345-1348 EXT 21348
	FLORIDA POWER AND LIGHT	TRACY STERN	(800) 868-9554
	TECO PEOPLES GAS	DANNY SHANAHAN	(941) 342-4006
	VERIZON FLORIDA INC.	DAVID WYNNS	(813) 978-2164
	MANATEE COUNTY TRANSPORTATION	KATHY McMAHON	(941) 792-8811 EXT 5002
	MANATEE COUNTY UTILITY OPERATIONS	KATHY McMAHON	(941) 792-8811 EXT 5002

- IT IS THE RESPONSIBILITY OF THE CONTRACTOR TO CONTACT FPL/GTE FOR RESTRAINING OF POLES DURING CONSTRUCTION, ALL ASSOCIATED COSTS WILL BE AT CONTRACTOR'S EXPENSE.
- 5. THE CONTRACTOR'S ATTENTION IS DIRECTED TO THE FACT THAT ALL CONSTRUCTION ACTIVITIES SHALL CONFORM TO THE LOCAL NOISE ORDINANCE.
- HOURS OF WORK SHALL BE: NON-FEDERAL HOLIDAYS, MONDAY FRIDAY 7AM 5PM. WORK OUTSIDE THESE HOURS MUST BE SCHEDULED 48 HOURS IN ADVANCE AND MAY BE SUBJECT TO REIMBURSEMENT FOR ADDITIONAL INSPECTION SERVICES.
- 7. THE CONTRACTOR SHALL OBTAIN REQUIRED PERMITS PRIOR TO CONSTRUCTION. THESE MAY INCLUDE:
  - UTILITY CONSTRUCTION PERMIT.
  - R.O.W. USE PERMIT
  - EPA NPDES PERMIT
  - DEWATERING PERMIT (AS REQUIRED)
  - TREE REMOVAL PERMIT
- 8. THESE DRAWINGS DO NOT INCLUDE NECESSARY COMPONENTS FOR CONSTRUCTION SAFETY AND THE CONTRACTOR IS SOLELY RESPONSIBLE FOR CONSTRUCTION SAFETY. SPECIAL PRECAUTIONS MAY BE REQUIRED IN THE VICINITY OF POWER LINES AND OTHER UTILITIES.
- 5. THE CONTRACTOR SHALL FURNISH, ERECT AND MAINTAIN ALL NECESSARY TRAFFIC CONTROL AND SAFETY DEVICES, IN ACCORDANCE WITH THE US DEPARTMENT OF TRANSPORTATION, "MANUAL ON UNIFORM TRAFFIC CONTROL DEVICES" AND THE LATEST FLORIDA DEPARTMENT OF TRANSPORTATION "ROADWAY AND TRAFFIC DESIGN STANDARDS". LATEST EDITION AND CONTRACT SPECIFICATIONS.
- 10. THE CONTRACTOR SHALL PROVIDE, ERECT AND MAINTAIN EFFECTIVE BARRICADES, DANGER SIGNALS, SIGNS AND PEDESTRIAN DETOURS IN ALL AREAS WHERE REQUIRED FOR THE PROTECTION OF THE WORK AND THE SAFETY OF THE PUBLIC.
- 11. THE CONTRACTOR SHALL PROVIDE ACCESS FOR TRAFFIC AT ALL TIMES DURING CONSTRUCTION. CONSTRUCTION SHALL BE CONDUCTED IN SUCH A MANNER THAT RESIDENTS RETAIN ACCESS TO THEIR DRIVEWAYS AT ALL TIMES.
- 12. REFERENCES TO FDOT INDEXES REFER TO THE MOST RECENT EDITION OF THE FDOT "ROADWAY AND TRAFFIC DESIGN STANDARDS."
- 13. IT IS THE RESPONSIBILITY OF THE CONTRACTOR TO CONTROL AND PREVENT EROSION AND THE TRANSPORTATION OF SEDIMENT TO SURFACE DRAINS AND OUTFALLS.
- 14. THE CONTRACTOR SHALL BE RESPONSIBLE TO MAKE A REVIEW OF THE SITE TO DETERMINE EXISTING CONDITIONS AND ANYTHING NOT SHOWN ON THESE PLANS SHALL BE BROUGHT TO THE ATTENTION OF THE ENGINEER AND SHALL NOT CONSTITUTE AN EXTRA APPROVED BY THE ENGINEER.
- 15. THE CONTRACTOR SHALL BE RESPONSIBLE FOR REPAIRING OR REPLACING ANY DAMAGED ITEMS INCLUDING, BUT NOT LIMITED TO, DRIVEWAYS, IRRIGATION SYSTEMS, MAILBOXES, SIDEWALKS, STREET SIGNS, AND PRIVATE FENCES AS REQUIRED BY E.O.R./OTHER GOVERNING ENTITIES.
- 6. ALL SECTION CORNERS OR PROPERTY CORNERS DISLOCATED OR DISTURBED BY THE CONSTRUCTION ACTIVITIES SHALL BE RESET BY A REGISTERED LAND SURVEYOR AT THE CONTRACTORS EXPENSE.
- 17. ALL DISTURBED AREAS SHALL BE RESTORED TO THEIR ORIGINAL CONDITION OR BETTER UNLESS OTHERWISE NOTED. FINAL GRADE IS TO GENERALLY BE THE SAME AS EXISTING GRADE. RESTORE UNIFORMLY AND FOR PROPER DRAINAGE GRADE TOWARD ROADWAY.
- 18. THE CONTRACTOR IS RESPONSIBLE FOR THE DISPOSAL OF ALL CLEARED VEGETATION WITHIN FIVE (5) DAYS OF CLEARING AND GRUBBING WORK.
- 19. ALL EXCESS SOIL RESULTING FROM CONSTRUCTION ACTIVITIES THAT IS NOT CLAIMED BY THE OWNER SHALL BECOME THE PROPERTY OF THE CONTRACTOR AND PROPERLY DISPOSED OF BY THE CONTRACTOR

BY DATE


- ALL VOIDS AFTER PLACEMENT OF SOD SHALL BE FILLED WITH PREPARED SOIL MIX. THE SOD SHALL
  BE ROLLED TO MEET THE PROPOSED GRADES. SOD PLACED ON SLOPES (3:1 OR STEEPER) SHALL BE
  PEGGED.
- 21. AREAS OF EXPOSED EARTH RESULTING FROM CONSTRUCTION SHALL BE SODDED IN KIND AS DIRECTED BY THE ENGINEER UNLESS OTHERWISE NOTED ON PLANS.
- 22. LOCATIONS, ELEVATIONS AND DIMENSIONS OF EXISTING UTILITIES, STRUCTURES AND OTHER FEATURES ARE SHOWN ACCORDING TO THE BEST INFORMATION AVAILABLE AT THE TIME OF THE PREPARATION OF THESE PLANS, BUT DO NOT PURPORT TO BE ABSOLUTELY CORRECT. THE CONTRACTOR SHALL VERIFY THE LOCATION, ELEVATIONS AND DIMENSIONS OF ALL EXISTING UTILITIES, STRUCTURES AND OTHER FEATURES AFFECTING HIS WORK PRIOR TO CONSTRUCTION.
- 23. THE CONTRACTOR SHALL VERIFY IN THE FIELD THE LOCATION AND ELEVATION OF ALL EXISTING UTILITY CONNECTION POINTS PRIOR TO STARTING CONSTRUCTION AND SHALL IMMEDIATELY NOTIFY THE ENGINEER AND OWNER OF ANY DISCREPANCIES FOUND.
- 24. THE CONTRACTOR'S ATTENTION IS CALLED TO THE FACT THAT THERE MAY BE SOME CONFLICTS. IT SHALL BE THE CONTRACTOR'S RESPONSIBILITY TO LOCATE, PROTECT, AND REPLACE (IF DAMAGED) ANY AND ALL EXISTING UTILITIES ON THIS PROJECT AT THEIR OWN EXPENSE.
- 5. THE CONSTRUCTION LIMITS INDICATED IN THESE PLANS ARE APPROXIMATE. ACTUAL LIMITS MAY BE SET IN THE FIELD AS DIRECTED BY THE ENGINEER.
- 26. ALL POTABLE WATER, FIRE, IRRIGATION SYSTEM, SANITARY SYSTEM, STORM SYSTEM AND OTHER UTILITIES COMPONENTS SHALL BE PROTECTED AND SHALL REMAIN OPERATIONAL DURING CONSTRUCTION. THE CONTRACTOR SHALL IMMEDIATELY REPAIR ANY DAMAGE TO THE SYSTEMS.
- 27. CONTRACTOR SHALL ENSURE THAT EXCAVATIONS ARE FREE OF DEBRIS PRIOR TO BACKFILLING.
- 28. THE CONTRACTOR SHALL NOT ENTER OR OCCUPY ANY LAND OUTSIDE THE RIGHTS-OF-WAY OR PRIVATE PROPERTY WITHOUT THE WRITTEN CONSENT OF THE PROPERTY OWNER.
- 29. THE CONTRACTOR SHALL TAKE ALL REASONABLE MEANS TO ELIMINATE THE TRANSPORT OF DUST FROM THE PROJECT SITE. SPECIAL MEASURES, SUCH AS PERIODICALLY APPLYING WATER TO THE WORK SITE TO PREVENT DUST SHALL BE INCORPORATED INTO THE CONTRACTORS WORK PLAN.
- 80. WHERE REFERENCED STANDARDS CONFLICT, THE MORE STRINGENT STANDARD SHALL APPLY.
- 31. CONTRACTOR SHALL SUPPORT AND PROTECT ALL EXISTING UTILITIES AS REQUIRED. THIS SHOULD INCLUDE BY-PASS PUMPING IF REQUIRED.

# S. WEAR No. 60273 Kielly J. Webwer 3-18-16 STATE OF OF STATE OF OF STATE OF OF STATE OF OF SS/ONAL ENGINE

# SURVEYOR'S NOTES & SYMBOLOGY

NOTE: EXISTING FEATURES ARE SHOWN LIGHT-LINED AND DASHED

# **LEGEND**

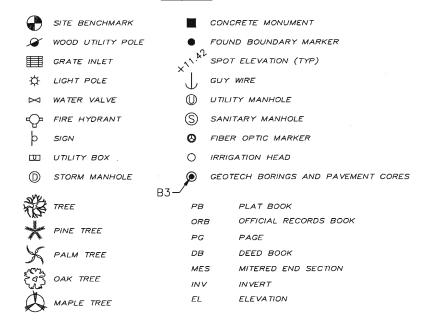

- 1. THE FOLLOWING NGS NAVD88 VERTICAL CONTROL MONUMENTS WERE RECOVERED AND UTILIZED FOR THE ELEVATIONS SHOWN HEREIN: MELROSE PARK PID: DO1578 ELEVATION 18.18 FEET AND MIRAMAR PID: DO1579 ELEVATION 14.57 FEET.
- 2. THIS SURVEY IS REFERENCED TO A PROJECTION OF THE FLORIDA STATE PLANE COORDINATE SYSTEM (WEST ZONE NAD 1983/2011).

SURVEY PROVIDED BY:

# Hyatt Survey Services, Inc.

LB No.: 7203 Geographic Data Specialists 11007 8th Avenue East Bradenton, Florida 34212 Phone: (941) 748-4693 Fax: (941) 744-1643

# LINE WORK & SYMBOLOGY

ASPHALT ROADWAY		CHAIN LINK FENCE
BACK OF CURB	.71.1.17.1	BUILDING BOUNDARY
SHELL DRIVEWAY		TOP OF BANK
 CONCRETE DRIVEWAY		WETLAND LINE
 RIGHT-OF-WAY/PROPERTY LINE		GUARDRAIL
 PROPERTY LINE	12	CONTOUR LINE AND ELE

# **EXISTING UTILITY LINE WORK SYMBOLOGY**

NOTE: PIPES 12-INCHES AND LARGER SHOWN WITH DOUBLE LINES.

### #################################	
FOC — FOC — FOC — BURIED FIBER OPTIC — UGT — UGT — UGT — BURIED TELEPHO  GAS — GAS — GAS — GAS — GAS MAIN — fm fm fm SANITARY FORCE	DLE LOCATION
FOC	IED WATER MAI
	RY FORCE MAIN
WATER MAIN BE BONES ELECTRIC	TELEPHONE
wmwm	ELECTRIC

NOTE:

THE LEGEND LISTED REPRESENT A COMPREHENSIVE STANDARD GUIDE INTENDED FOR GENERAL USE. THEREFORE, NOT ALL OF THE SYMBOLS AND ABBREVIATIONS CONTAINED ON THIS SHEET ARE NECESSARILY USED ON THIS PARTICULAR CONTRACT.

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	Q.C.	
	DRM	
KELLY S. WEHNER, PE	DATE APPROVED	ı
LIC. NO.: 60273		1

GENERAL NOTES & SYMBOLOGY

PROJECT NO:
00193009.05

DATE:
MARCH 2016
SHEET NO:
G-2

MANATEE COUNTY

MLS 1M EMERGENCY GENERATOR REPLACEMENT

DESCRIPTION

NO.














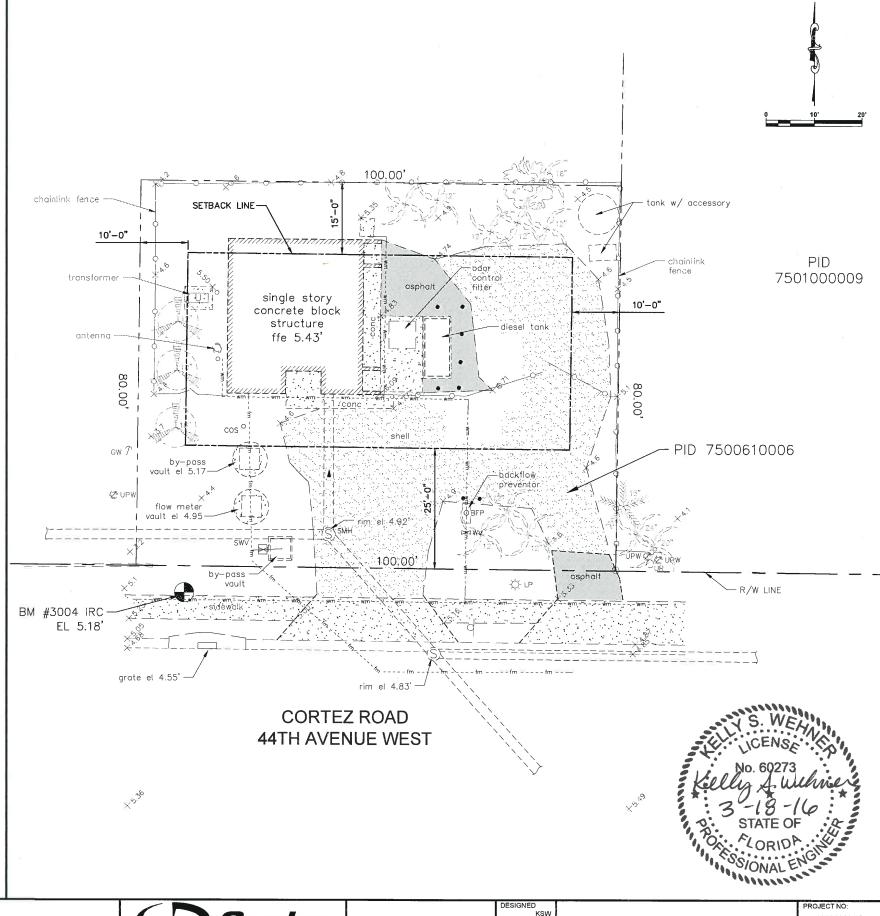

NO. DESCRIPTION BY DATE

**MANATEE COUNTY** 


MLS 1M EMERGENCY GENERATOR REPLACEMENT Carcino
Shaping the Future
380 PARK PLACE BLVD, STE 300, CLEARWATER, FL 33759
TEL: (727) 531-3505 (800) 861-8314
www.cardno.com Certificate of Authorization No. 29915


KELLY S. WEHNER, PE DATE LIC. NO.: 60273

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SITE PLAN

PROJECT NO: 00193009.05 DATE: MARCH 2016 SHEET NO: C-1




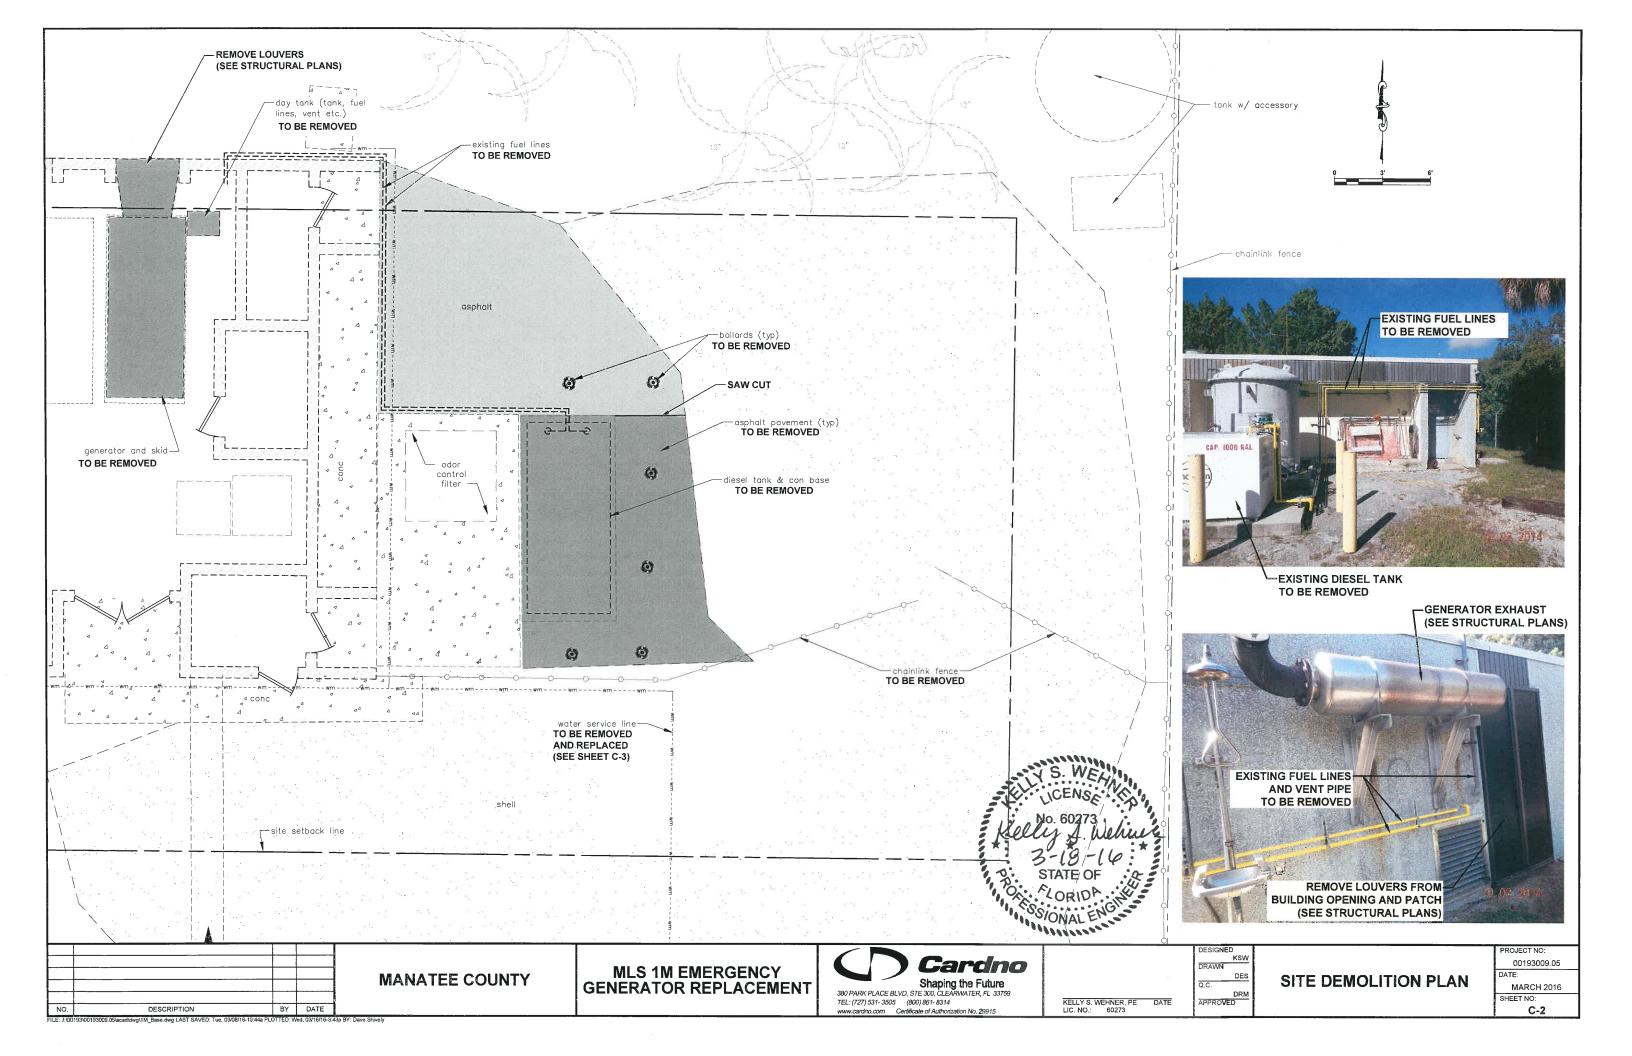


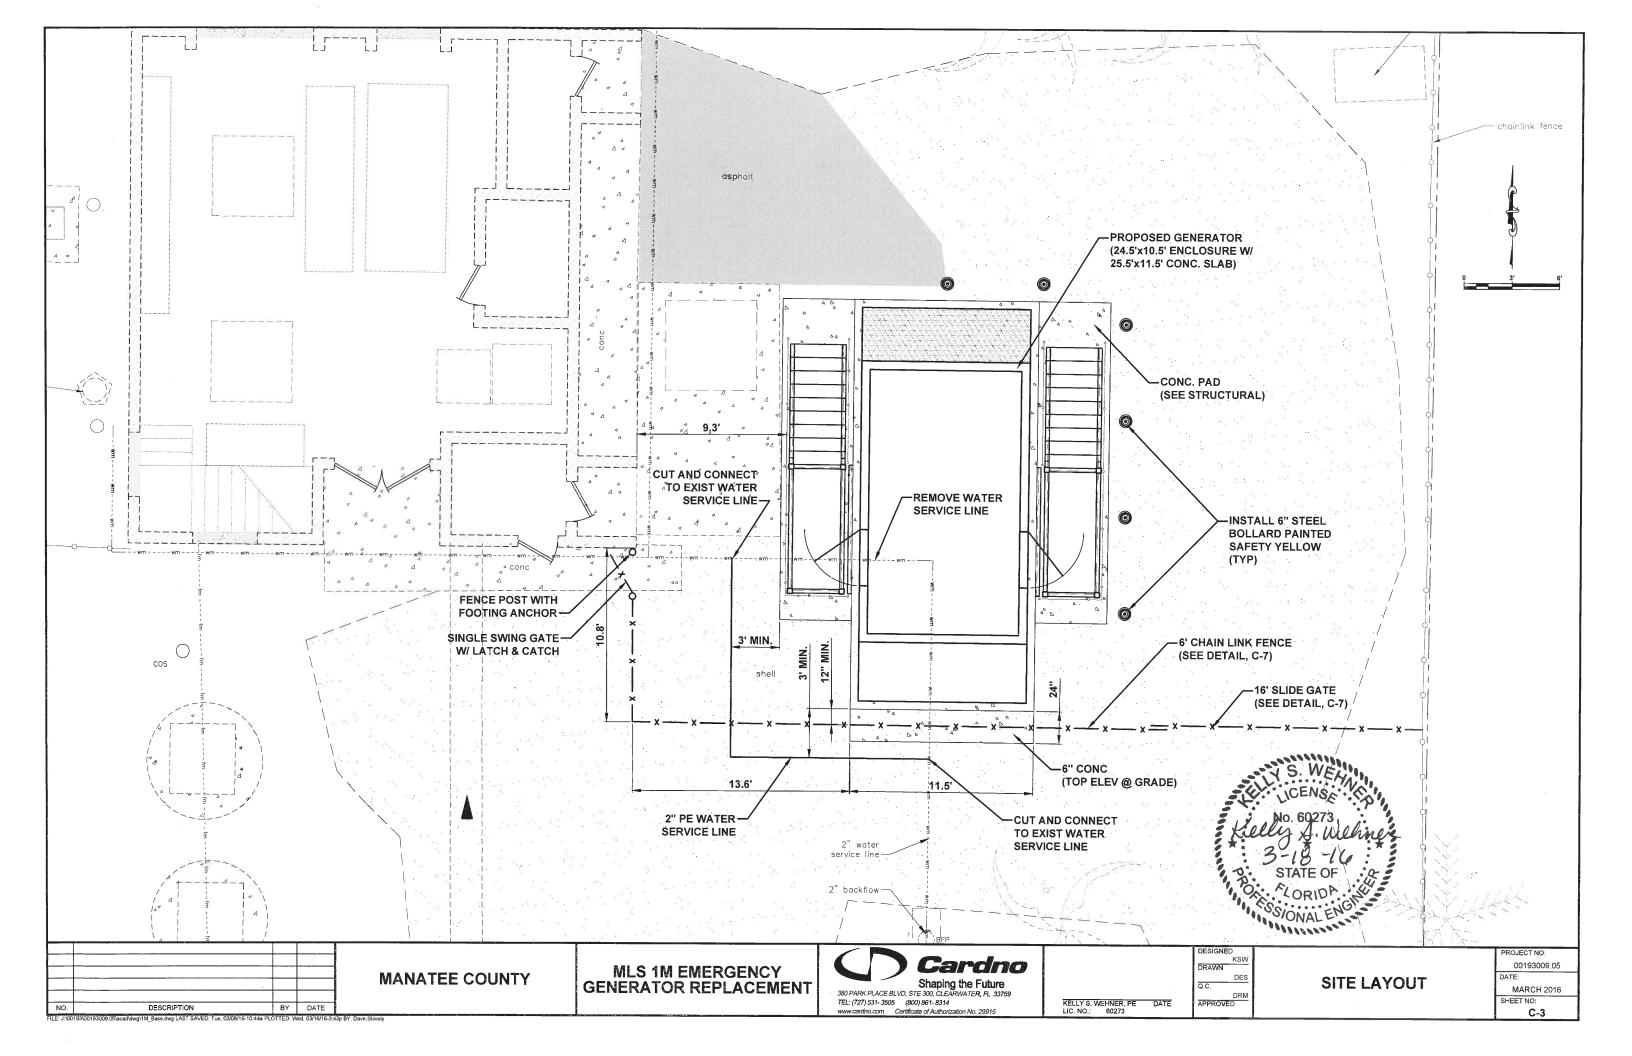





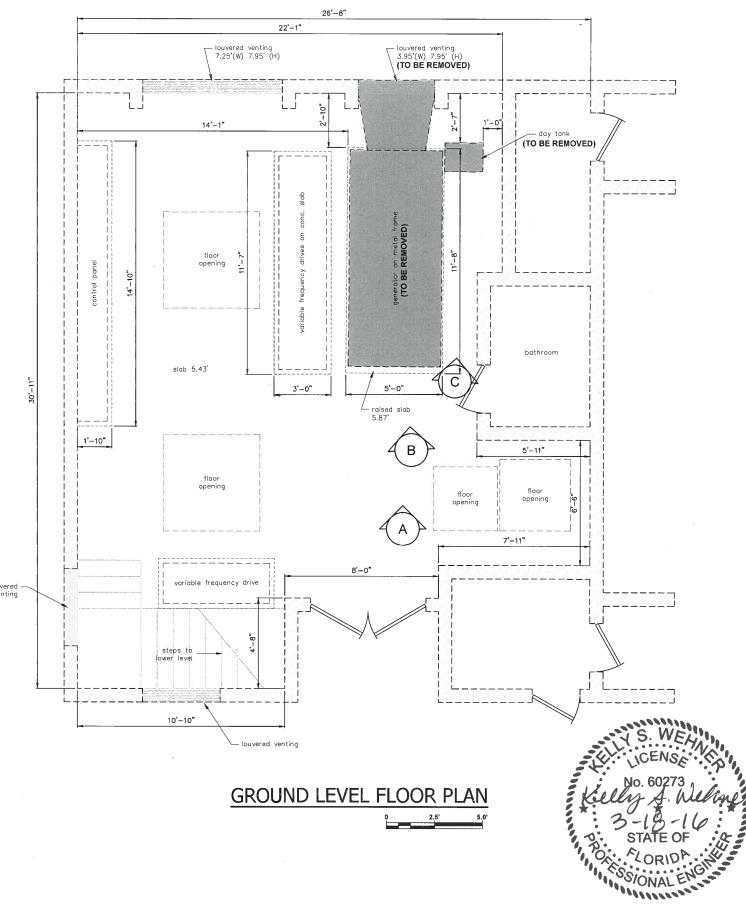

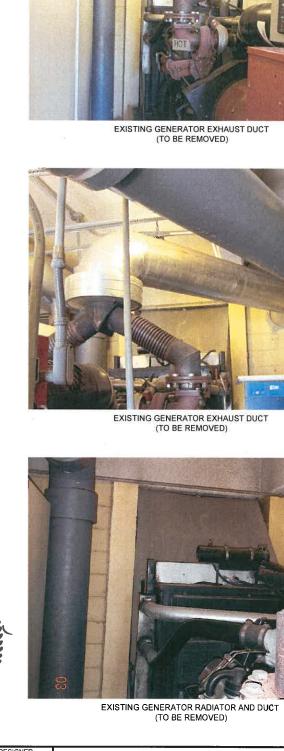

DESCRIPTION

**MANATEE COUNTY** 

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KSW DRAWN DRM APPROVED

KELLY S. WEHNER, PE LIC. NO.: 60273

**BUILDING DEMOLITION PLAN** 

00193009.05 MARCH 2016

C-4

SHEET NO:

BY DATE







EXISTING CHEMICAL TANK W/ ACCESSORY (FACING NORTHEAST)



SITE PHOTO (FACING NORTH)




SITE PHOTO (FACING SOUTHWEST)



BUILDING MAIN ENTRY (FACING NORTH)



EXISTING DIESEL TANK - TO BE REMOVED (FACING WEST)

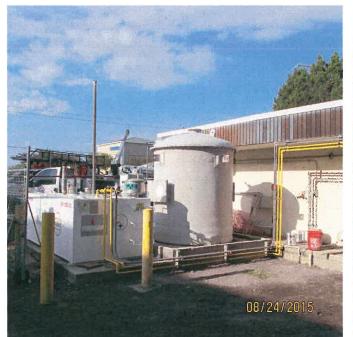

PROPOSED GENERATOR LCCA (FACING SOUTHWAST)



EXISTING GENERATOR MUFFLER - TO BE REMOVED (FACING SOUTH WEST)

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NO.	DESCRIPTION	BY	DATE	

**MANATEE COUNTY** 

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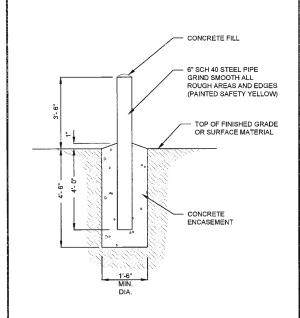
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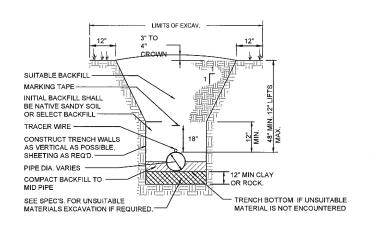
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SITE PHOTOS

PROJECT NO: 00193009.05

MARCH 2016 SHEET NO: C-5





# **UNPAVED AREAS**


TYPICAL BOLLARD DETAIL

NTS

PIPE BEDDING & TRENCH DETAILS

NTS

2. EXCAVATE A 4" X 4" TRENCH

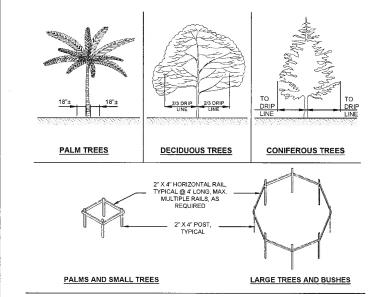

- NOTES: 1. NO TRUCKS OR HEAVY EQUIPMENT ALLOWED WITHIN BARRIERS, ONLY HAND LABOR ALLOWED. 2. NO CONSTRUCTION MATERIALS, SOILS DEPOSITS, OR SOLVENTS SHALL BE ALLOWED WITHIN
- BARKIERS.


  3. BARRIERS ARE TO BE IN PLACE PRIOR TO ANY CONSTRUCTION ACTIVITIES WITHIN TREE AREA.

  4. BARRIERS ARE TO STAY IN PLACE UNTIL ALL PAVING, CONSTRUCTION, AND HEAVY EQUIPMENT IS REMOVED FROM THE AREA.

# TREE PROTECTION BARRIERS DETAIL


ALTERNATE DETA


KELLY S. WEHNER, PE LIC. NO.: 60273

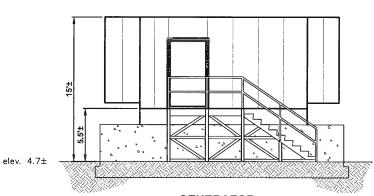

# **GENERATOR** SIDE ELEVATION


SEE "S" SHEETS FOR STRUCTURAL DETAILS.

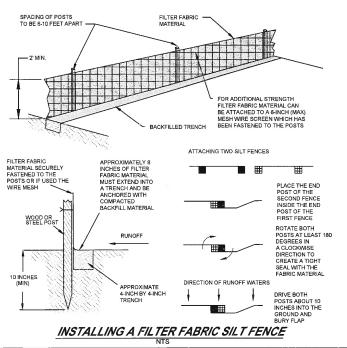

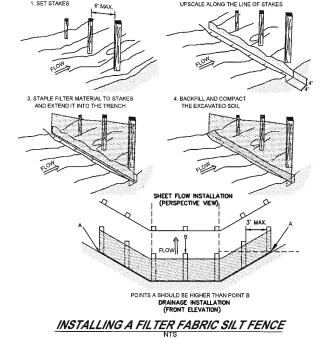

# **EROSION CONTROL NOTES**

- 1. IT IS THE RESPONSIBILITY OF THE CONTRACTOR TO CONTROL AND PREVENT EROSION AND THE TRANSPORTATION OF SEDIMENT TO SURFACE DRAINS AND OUTFALLS (REFER TO CONSTRUCTION PLANS, DETAILS, SPECIFICATIONS, AND APPROVED PERMITS FOR DETAILS.)
- 2. DURING CONSTRUCTION THE CONTRACTOR SHALL PLACE GEOBALE BARRIERS AROUND SUCH STRUCTURES TO PREVENT EROSION AND THE MIGRATION OF SEDIMENT TO POINTS OUTSIDE THE CONSTRUCTION AREA. THE BARRIERS SHALL BE PLACED IN ACCORDANCE WITH THE REQUIREMENTS OF FDOT INDEX NO. 102 OR AS DIRECTED BY THE ENGINEER.
- PROJECT. THE SILT BARRIERS SHALL BE PLACED IN ACCORDANCE WITH THE REQUIREMENTS OF FDOT INDEX NO. 102, 103 AND 104 OR AS DIRECTED BY THE OWNER.
- REQUIRED EROSION CONTROL MEASURES MUST REMAIN INTACT THROUGHOUT CONSTRUCTION. FAILURE TO INSTALL OR PROPERLY MAINTAIN REQUIRED EROSION CONTROL WILL RESULT IN ENFORCEMENT ACTION WHICH MAY INCLUDE CITATIONS AS PROVIDED BY APPLICABLE LOCAL ORDINANCE AND CHAPTERS 40D-4 AND 40D-40. F.A.C. INITIATION OF CIVIL PENALTY PROCEDURES PURSUANT TO SECTION 373.129, F.A.C. CAN RESULT IN A PENALTY NOT TO EXCEED \$10,000 PER OFFENSE WITH EACH DATE DURING WHICH SUCH VIOLATION OCCURS CONSTITUTING A SEPARATE OFFENSE.
- 5. ALL WORK PERFORMED SHALL COMPLY WITH THE REGULATIONS AND ORDINANCES OF THE VARIOUS GOVERNMENTAL AGENCIES HAVING JURISDICTION OVER THE WORK

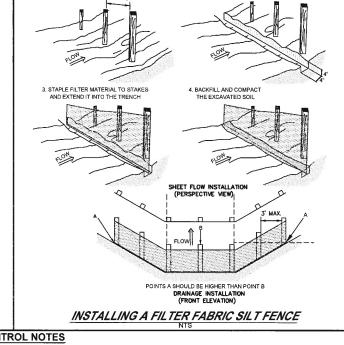

# INSTALLING A FILTER FABRIC SILT FENCE

INSPECT AND REPAIR FENCE AFTER EACH STORM EVENT AND REMOVE SEDIMENT WHEN NECESSARY.

2. REMOVED SEDIMENT SHALL BE DEPOSITED TO AN AREA THAT WILL CONTRIBUTE SEDIMENT OFF-SITE AND CAN BE PERMANENTLY ST

3. SILT FENCE SHALL BE PLACED ON SLOPE CONTOURS TO MAXIMIZ

EXTRA STRENGTH FILTER FABRIC NEEDED WITHOUT WIRE MESH SUPPORT STEEL OR WOOD POST PONDING HT. RUNOFF 4" x 6" TRENCH

MINIMUM FINISHED FLOOR ELEV. 10.25 existina elev. 4.7±

# **GENERATOR** FRONT ELEVATION

SEE "S" SHEETS FOR STRUCTURAL DETAILS SEE "E" SHEETS FOR ELECTRICAL DETAILS

GENERATOR ENCLOSURE DETAILS NTS INCOME

KSW

DES

DRAWN

APPROVED

S

**DETAIL SHEET** 

00193009.05 MARCH 2016 SHEET NO: C-6

MANATEE COUNTY


**MLS 1M EMERGENCY GENERATOR REPLACEMENT** 



STANDARD DETAIL


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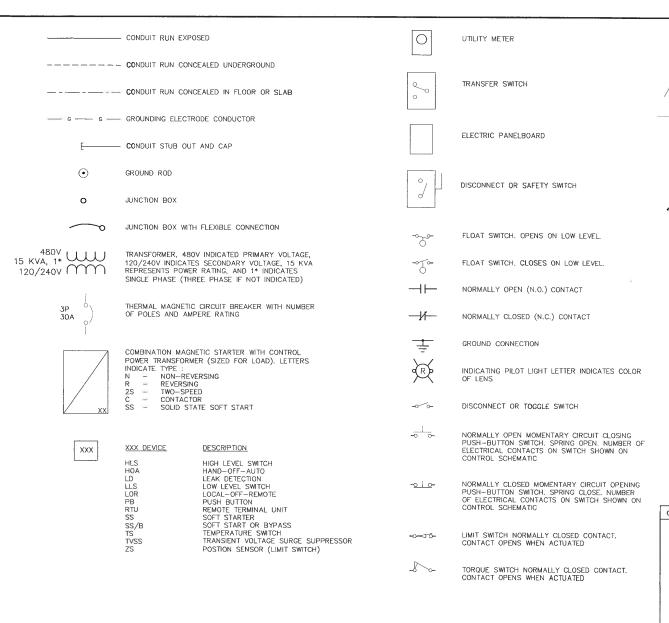
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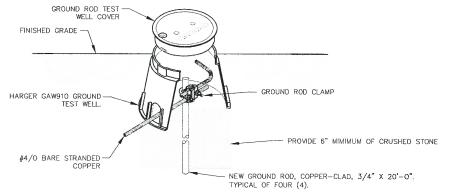


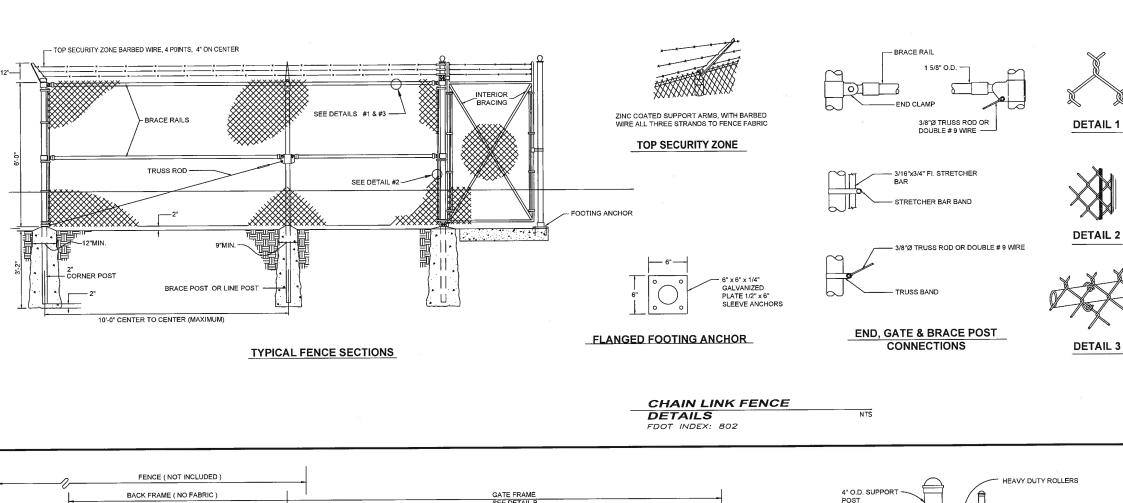

- I. FOR SUPPLEMENTAL INFORMATION REFER TO FDOT INDEX 802 (TYPE B).
- 2. FENCE SHALL HAVE 3 STRANDS BARB WIRE.
- END, CORNER, AND PULL POSTS TO BE TUBULAR, 3-INCH ASA SCH. 40 LINE POSTS TO BE TUBULAR, 2-1/2-INCH ASA SCH. 40.
- LINE AND CORNER POSTS MAY BE OF A SECTION OF EQUIVALENT STRUCTURAL STRENGTH AS TUBULAR SECTIONS.
- CHAIN LINK FABRIC SHALL BE 9 GAUGE GALVANIZED WIRE, WITH 2-INCH MESH FABRIC TO BE TWISTED AND BARBED BOTH TOP AND BOTTOM
- FABRIC TO BE TIED TO SUPPORT RAILS, 24" O.C. USING STANDARD NO. 13 GAUGE ALUMINUM.
- ALL FENCE COMPONENTS (I.E. RAILS, FITTINGS, POSTS, GATES, FABRIC, ETC.) SHALL BE GALVANIZED COATED.
- ALL FENCING SHALL HAVE A #7 GAUGE GALVANIZED BOTTOM TENSION WIRE OR APPROVED EQUAL WOVEN ALONG THE BOTTOM EDGE OF THE CHAIN LINK FABRIC.
- TENSION WIRE SHALL BE LOOPED AROUND THE BOTTOM OF ALL LINE OR BRACE POSTS AND SECURED WITH A STRETCHER BAR BAND TO ALL CORNER POSTS.





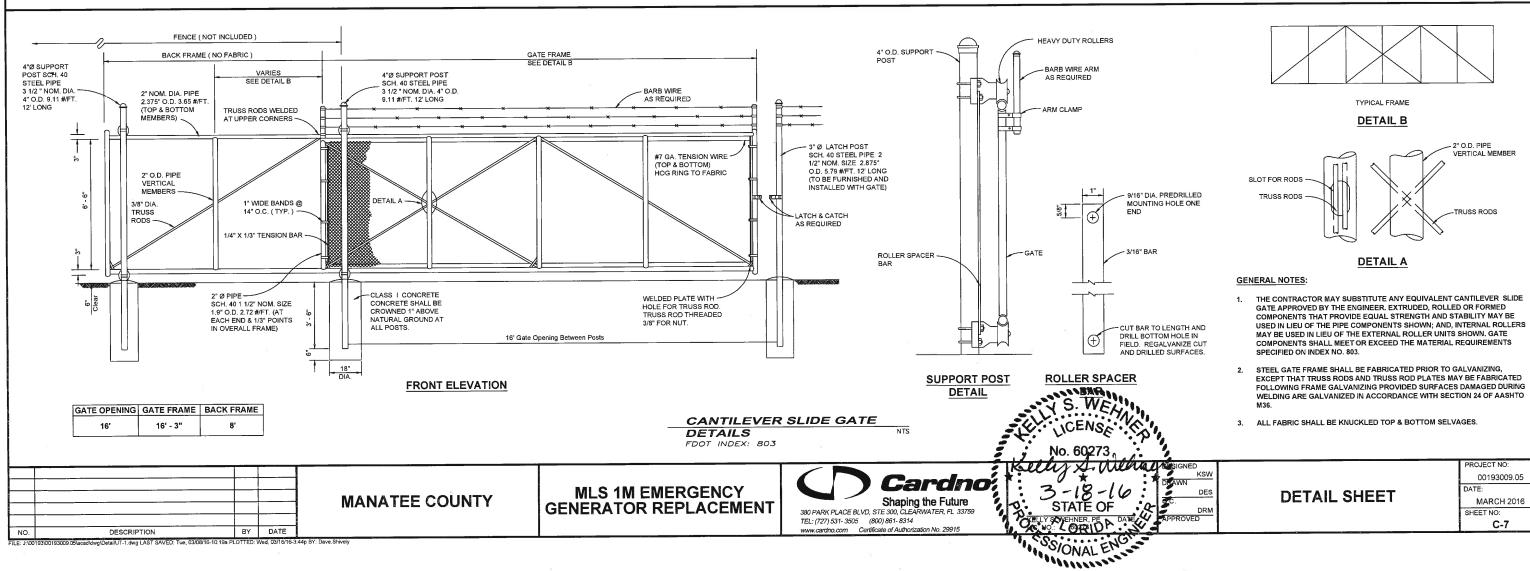

# GROUND ROD TEST WELL DETAIL 1 SCALE: N.T.S. E-2 E-1



XX X

MOTOR

THERMAL OVERLOAD

→ ⊶ PUMP THERMAL SENSOR


3-P

3-PHASE, 480V CAPACITOR

# ABBREVIATIONS:

AFF AFG ATL ABOVE FINISHED FLOOR ABOVE FINISHED GRADE ACROSS—THE—LINE CONDUIT CU EX ELEC EXP FU GFI GND HP HZ IG KVA KW MAX COPPER FLECTRICA EXPLOSION PROOF FUSE GROUND FAULT INTERRUPTER GROUNDING CONDUCTOR HORSEPOWER ISOLATED GROUND KILOVOLT AMPERES KILOWATTS MAXIMUM MIN N/A PH RECP RPM RTU SPD TYP MINIMIIM NOT APPLICABLE PHASE RECEPTACLE REVOLUTIONS PER MINUTE REMOTE TERMINAL UNIT SURGE PROTECTION DEVICE TYPICAL VOLTS WEATHERPROOF

# **EXAMPLE OF SECTION CUT AND DETAIL**

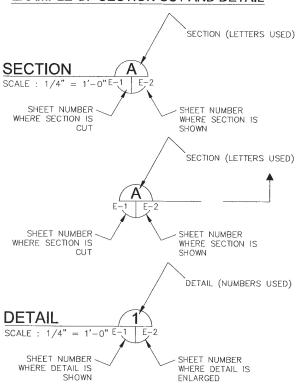

# GENERAL NOTES

THE WORK CONSIST OF FURNISHING ALL LABOR, MATERIALS, EQUIPMENT, AND TECHNICAL SUPERVISION TO INSTALL A NEW GENERATOR AND ASSOCIATED EQUIPMENT AS INDICATED AND SHOWN. THE WORK INCLUDES, BUT IS NOT LIMITED TO, THE FOLLOWING:

- 1. CONTRACTOR SHALL SUBMIT SHOP DRAWINGS FOR APPROVAL PRIOR TO PURCHASING EQUIPMENT OR COMMENCING CONSTRUCTION.
- 2. CONTROL CONDUCTORS SHALL BE STRANDED COPPER, 14AWG MINIMUM, WITH THWN INSULATION, UNLESS OTHERWISE NOTED.
- 3. ALL WIRING SHALL BE IDENTIFIED WITH NUMBERS AT ALL TERMINALS AND ON WIRING DIAGRAMS.
- 4. FIELD VERIFY ALL EQUIPMENT LOCATIONS AND CONNECTIONS PRIOR TO COMMENCING CONSTRUCTION.
- 5. ALL NEW EQUIPMENT SHALL BE PERMANENTLY IDENTIFIED WITH A BLACK ON WHITE LAMACOID TAG ENGRAVED WITH MINIMUM 3/16 INCH LETTERING.
- 6. ALL CIRCUITS SHALL HAVE A GROUNDING CONDUCTOR ROUTED INSIDE EACH CONDUIT WITH POWER CONDUCTORS.
- 7. ALL CONDUCTOR LENGTHS SHALL BE CONTINUOUS. NO SPLICES OR CONDUCTOR TERMINATIONS SHALL BE PERMITTED UNLESS SPECIFICALLY DESIGNATED IN THE DRAWINGS.
- 8. ALL EXISTING INSTALLATIONS DENOTED ON THE DRAWINGS ARE FOR THE CONTRACTORS REFERENCE ONLY. ALL EXISTING INSTALLATIONS SHALL BE FIELD VERIFIED PRIOR TO SUBMITTING A BID AND PRIOR TO COMMENCING CONSTRUCTION.
- 9. CONDUITS SHALL BE RIGID HEAVY WALL ALUMINUM. FLEXIBLE CONDUITS SHALL BE NONMETALLIC LIQUID TIGHT.
- 10. MAKE MODIFICATIONS TO THE EXISTING MOTOR CONTROL CENTER AS SHOWN AND SPECIFIED.
- 11. PROVIDE AND INSTALL GENERATOR WITH WEATHER-PROOF, SOUND ATTENUATED ENCLOSURE AS SHOWN AND SPECIFIED.
- 12. MAKE REQUIRED INTERCONNECTIONS BETWEEN MOTOR CONTROL CENTER COMPONENTS AND NEW GENERATOR AS SHOWN AND SPECIFIED.
- 13. PROVIDE AND INSTALL STAINLESS STEEL CHANNEL ERECTOR SYSTEMS TO MOUNT AND SUPPORT ENCLOSURES, BOXES, CONDUITS AND OTHER EQUIPMENT. ALL MOUNTING HARDWARE SHALL BE 316 SS.
- 14. ALL ELECTRICAL WORK SHALL BE PERFORMED IN ACCORDANCE WITH THE 2014 NATIONAL ELECTRICAL CODE (NEC).
- 5. AFTER COMPLETING THE EQUIPMENT INSTALLATION, THE SYSTEM SHALL BE TESTED TO SHOW FUNCTIONALITY.
- 16. TEST AND START-UP REPORTS FOR THE GENERATOR SYSTEM AND WIRE SHALL BE INCLUDED IN THE OPERATION AND MAINTENANCE (O&M) MANUALS PROVIDED UNDER THIS CONTRACT.



MANATEE COUNTY

MLS 1M EMERGENCY GENERATOR REPLACEMENT



DESIGNATION OF THE DATE OF THE

PROJECT NO: 00193009.05 DATE: JANUARY 2016


SHEET NO:

E-1

NO. DESCRIPTION BY DATE

FILE: NO migric Projects 2015/026-0501715027711M1M.Generalize Final 1-15-16 days LAST SAVED: Two 01/12/16 E-22a RI OTTED: The 01/14/16 10-14/a RV. TDT00

ELECTRICAL LEGEND AND ABBREVIATIONS

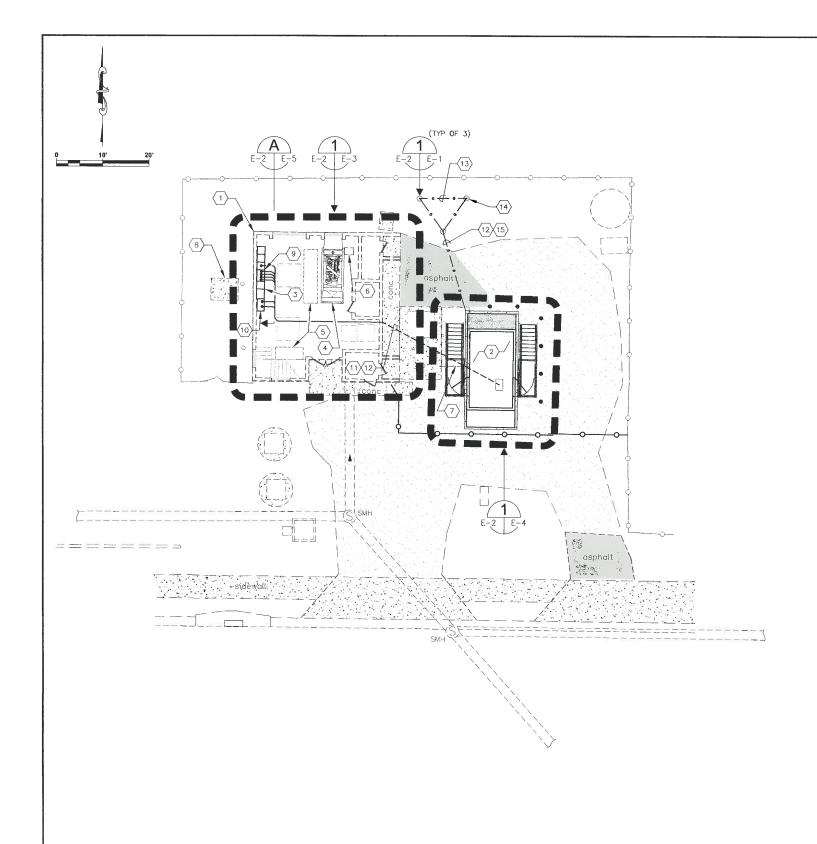

# **KEYED NOTES:**

- (1) EXISTING BUILDING FOR LIFT STATION 1M. REFER TO SHEET E-3 FOR WORK REQUIRED WITHIN THE LIFT
- 2 NEW 480V, 600 KW GENERATOR IN WEATHER-PROOF, SOUND ATTENUATED ENCLOSURE. REFER TO SHEET E-4 FOR GENERATOR DETAILS.
- $\stackrel{\textstyle <}{\scriptstyle 3}$  Existing motor control center (MCC) for Lift station 1m. Refer to sheet E-5 for MCC elevation and Work Required.
- 4 EXISTING GENERATOR SET TO BE REMOVED. REFER TO CIVIL/MECHANICAL SHEETS FOR DETAILS.
- (5) EXISTING VARIABLE FREQUENCY DRIVES (VFD'S) NO WORK REQUIRED.
- 6 EXISTING DAY TANK TO BE REMOVED. REFER TO CIVIL/MECHANICAL SHEETS FOR DETAILS.
- EXISTING DIESEL STORAGE TANK TO BE REMOVED. REFER TO CIVIL/MECHANICAL SHEETS FOR WORK REQUIRED.
- 8 EXISTING UTILITY TRANSFORMER, NO WORK REQUIRED.
- EXISTING TRANSFER SWITCH FOR LIFT STATION 1M TO BE REPLACED. REFER TO SHEET E-5 FOR TRANSFER SWITCH ELEVATION AND WORK REQUIRED.
- $\overleftarrow{\text{(10)}}$  Existing PLC control cabinet for lift station 1m. Refer to sheet E-5 for PLC control cabinet elevation and work required.
- (11) CONTRACTOR TO PROVIDE AND INSTALL THE FOLLOWING :

PROVIDE AND INSTALL 8-#12 THWN CU + 1-#12 THWN CU GND IN  $3/4^\circ$  CONDUIT. FIELD ROUTE CONDUIT FROM PLC CONTROL CABINET TO NEW GENERATOR FOR SCADA MONITORING OF GENERATOR. 2-#12 FOR GENERATOR RUNNING INDICATION, 2-#12 FOR GENERATOR FAIL INDICATION AND 4-#12 SPARE.

PROVIDE AND INSTALL 8-#12 THWN CU + 1-#12 THWN CU GND IN 3/4" CONDUIT TO EXISTING PLC CONTROL CABINET FOR SCADA MONITORING OF GENERATOR BASE TANK. 2-#12 BASE TANK LEAK DETECTION ALARM, 2-#12 FOR BASE TANK LOW LEVEL ALARM, 2-#12 FOR BASE TANK HIGH LEVEL ALARM AND 2-#12SPARE. CONTRACTOR SHALL COORDINATE/VERIFY CONNECTION LOCATION AND TYPE WITH ENCLOSURE

PROVIDE AND INSTALL THREE (3) PARALLEL RUNS CONSISTING OF 3-#350 kcmil Thwn CU + 1-#2/0 Thwn CU GND IN 3" CONDUIT. FIELD ROUTE CONDUIT FROM EXISTING TRANSFER SWITCH TO NEW GENERATOR FOR 480V STANDBY POWER FEEDER CIRCUIT.

PROVIDE AND INSTALL 4-#12 THWN CU + 1-#12 THWN CU GND IN  $3/4^\circ$  CONDUIT. FIELD ROUTE CONDUIT FROM EXISTING TRANSFER SWITCH TO NEW GENERATOR FOR GENERATOR START SIGNAL. CONTRACTOR TO COORDINATE/VERIFY GENERATOR STARTER CONTROL REQUIREMENTS WITH GENERATOR AND TRANSFER SWITCH

PROVIDE AND INSTALL 3-#8 THWN CU + 1-#10 THWN CU GND IN 1" CONDUIT. FIELD ROUTE CONDUIT FROM NEW MCC FEEDER CIRCUIT BREAKER TO NEW GENERATOR DISCONNECT SWITCH FOR 480V ANCILLARY EQUIPMENT FEEDER CIRCUIT.

- (12) CONTRACTOR TO CUT ASPHALT OR CONCRETE AS REQUIRED TO INSTALL CONDUIT AND GROUNDING ELECTRODE CONDUCTORS. ASPHALT AND CONCRETE SHALL BE REPAIRED/REPLACED TO MATCH EXISTING.
- (13) CONTRACTOR TO PROVIDE AND INSTALL #4/O BARE COPPER GROUNDING ELECTRODE CONDUCTOR FOR NEW GENERATOR. CONNECT GROUNDING ELECTRODE CONDUCTOR TO GROUND GRID CONSISTING OF THREE (3) 3/4" X 20'-0" COPPER-CLAD GROUND RODS (SPACED A MINIMUM OF 10'-0" APART).
- (14) CONTRACTOR TO PROVIDE AND INSTALL GROUND ROD TEST WELL. REFER TO SHEET E $^-$ 1 FOR DETAIL.
- (5) CONTRACTOR TO PROVIDE AND INSTALL GROUNDING ELECTRODE CONDUCTOR CONSISTING OF #4/O BARE STRANDED COPPER DIRECT BURIED IN SOIL A MINIMUM OF 24" BELOW ASPHALT OR CONCRETE.

# GENERAL NOTES:

- THIS DRAWING SHOWS EXISTING CONDITIONS USING THE BEST AS-BUILT INFORMATION AVAILABLE AT THE TIME OF DESIGN. IT IS PROVIDED FOR REFERENCE ONLY. THE CONTRACTOR SHALL FIELD VERIFY ALL EXISTING INSTALLATIONS PRIOR TO SUBMITTING A BID AND PRIOR TO COMMENCING CONSTRUCTION.
- CONDUIT ROUTING SHOWN IS DIAGRAMMATICAL. CONTRACTOR SHALL FIELD ROUTE CONDUIT BASED ON EXISTING
  FIELD CONDITIONS. CONTRACTOR SHALL PROVIDE JUNCTION BOXES, PULL BOXES AND/OR CONDUIT LB FITTINGS
  AS REQUIRED TO MEET THE REQUIREMENTS OF THE NATIONAL ELECTRICAL CODE.
- 3. NOT ALL CONDUIT/CONDUCTORS SHOWN FOR CLARITY. REFER TO SHEETS  $E\!-\!3$  AND  $E\!-\!4$  FOR ADDITIONAL REQUIREMENTS.

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NO. DESCRIPTION BY DATE

**MANATEE COUNTY** 

**MLS 1M EMERGENCY** GENERATOR REPLACEMENT




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**ELECTRICAL SITE PLAN** 


ROJECT NO: 00193009.05

JANUARY 2016

SHEET NO: E-2

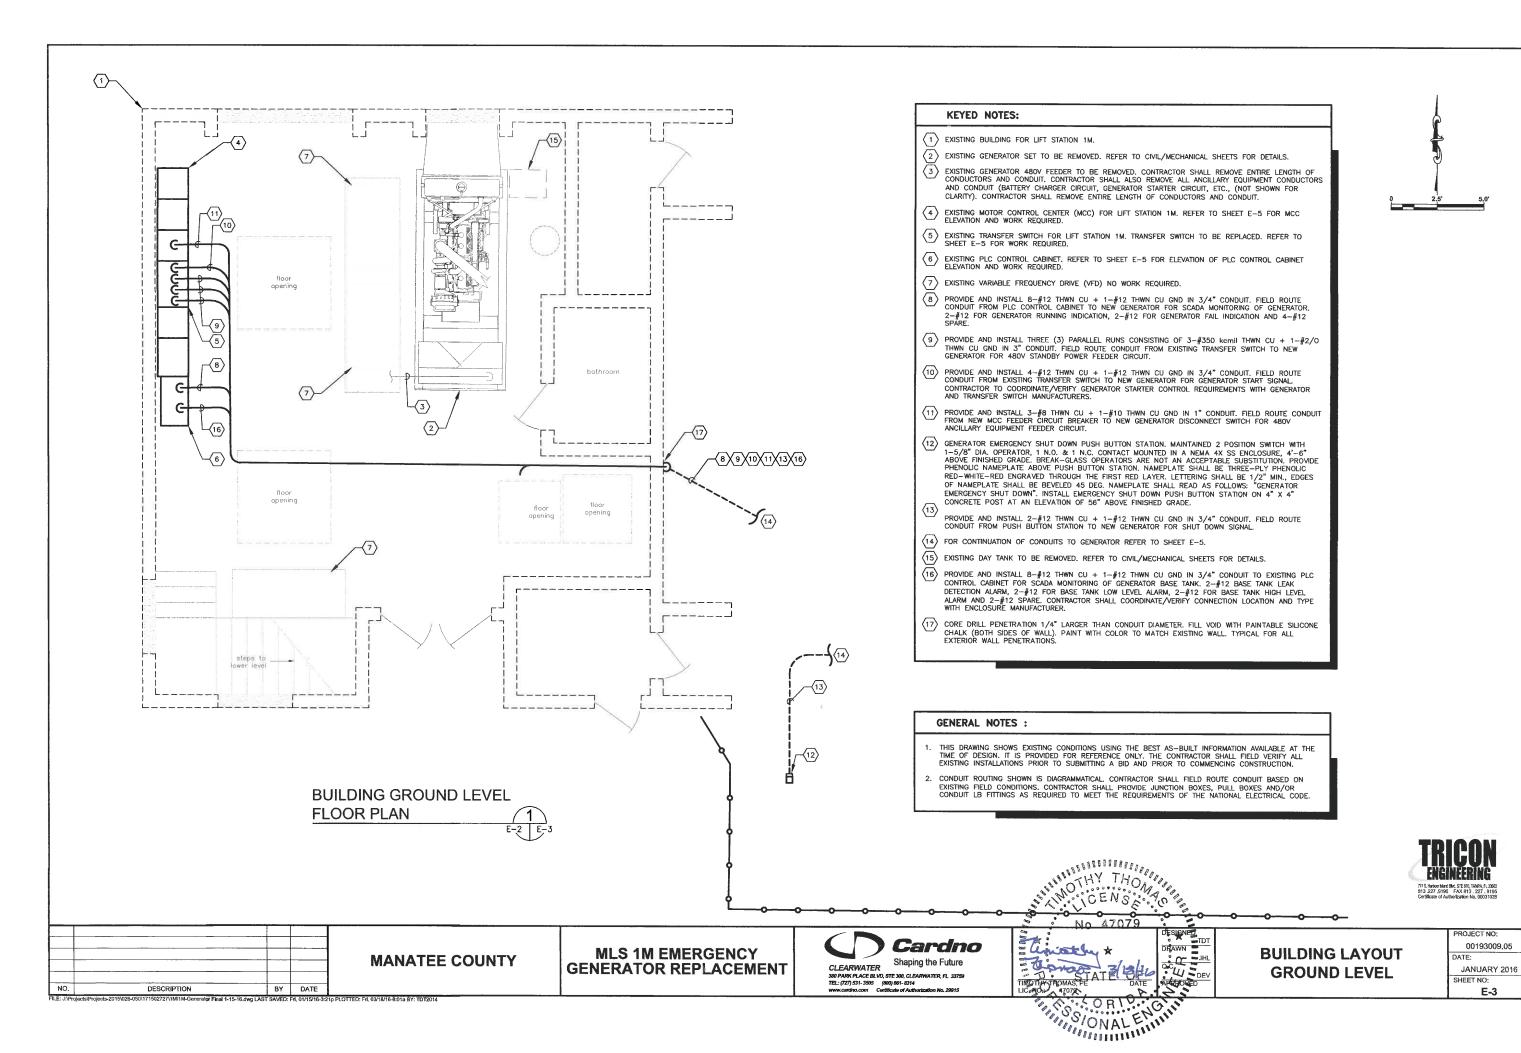

E-3

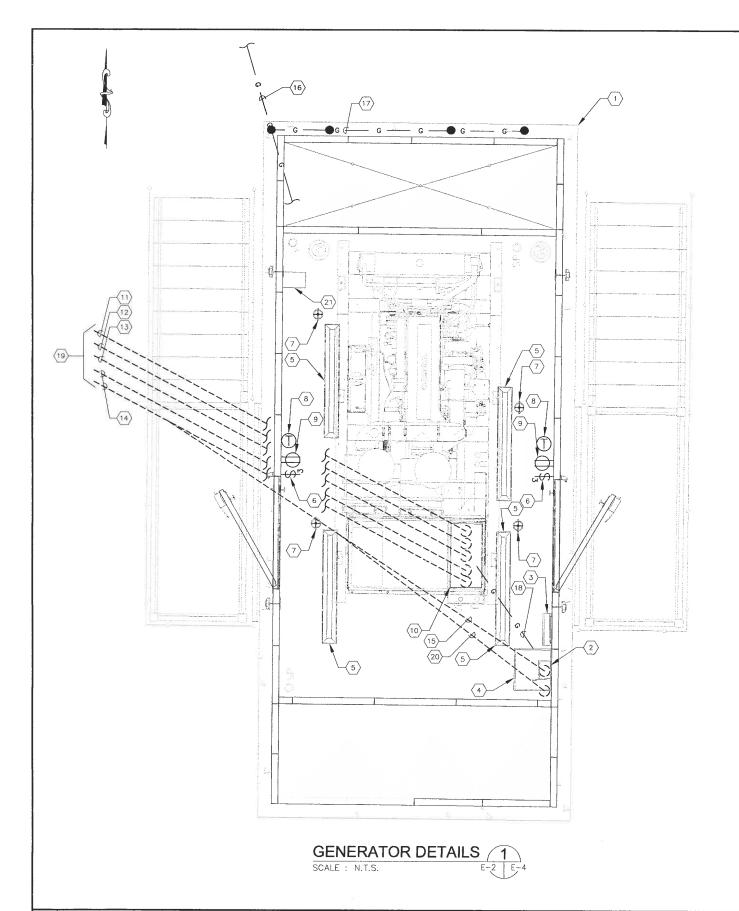

BY DATE

# **KEYED NOTES:**

- NEW 480V, 600 KW GENERATOR IN WEATHER-PROOF, SOUND ATTENUATED ENCLOSURE. REFER ALSO TO SPECIFICATIONS. GENERATOR TO BE INSTALLED ON NEW CONCRETE SLAB. REFER TO CIVIL DRAWINGS FOR SLAB HEIGHT.
- (2) 60 AMPERE FUSED DISCONNECT SWITCH PROVIDED AS PART OF THE ENCLOSURE PACKAGE.
- 3 100 AMPERE, 120/208V, 30, MCB LOADCENTER PROVIDED AS PART OF THE ENCLOSURE PACKAGE.
- 4 25 KVA, 480V-120/208V, 3Ø, TRANSFORMER PROVIDED AS PART OF THE ENCLOSURE PACKAGE. TRANSFORMER LOCATED ABOVE DISCONNECT AND LOADCENTER.
- (5) DUAL TUBE FLUORESCENT LIGHT FIXTURE PROVIDED AS PART OF THE
- $\langle$  6  $\rangle$  3--WAY SWITCHES PROVIDED AS PART OF THE ENCLOSURE PACKAGE.
- 7) DC LIGHT FIXTURES PROVIDED AS PART OF THE ENCLOSURE PACKAGE.
- 60 MINUTE TIMER SWITCHES FOR DC LIGHT FIXTURES PROVIDED AS PART OF THE ENCLOSURE PACKAGE.
- 9 20A, 125V DUPLEX GFCI RECEPTACLE PROVIDED AS PART OF THE ENCLOSURE
- (10) STUBUP LOCATION FOR 480V FEEDER CIRCUIT, GENERATOR STARTER CIRCUIT, GENERATOR SHUT DOWN AND SCADA I/O. COORDINATE/VERIFY EXACT LOCATION WITH ENCLOSURE MANUFACTURER.
- (11) PROVIDE AND INSTALL 8-#12 THWN CU + 1-#12 THWN CU GND IN 3/4" CONDUIT TO EXISTING PLC CONTROL CABINET FOR SCADA MONITORING OF GENERATOR. 2-#12 FOR GENERATOR RUNNING INDICATION, 2-#12 FOR GENERATOR FAIL INDICATION AND 4-#12 SPARE.
- \$\langle\$12\$ PROVIDE AND INSTALL 4-#12 THWN CU + 1-#12 THWN CU GND IN 3/4" CONDUIT TO EXISTING TRANSFER SWITCH ENCLOSURE FOR GENERATOR START SIGNAL. CONTRACTOR TO COORDINATE/VERIFY GENERATOR STARTER CONTROL REQUIREMENTS WITH GENERATOR AND TRANSFER SWITCH MANUFACTURERS.
- PROVIDE AND INSTALL 2-#12 THWN CU + 1-#12 THWN CU GND IN 3/4"
  CONDUIT TO NEW EMERGENCY SHUT DOWN PUSH BUTTON STATION FOR SHUT
- (14) PROVIDE AND INSTALL THREE (3) PARALLEL RUNS CONSISTING OF 3-#350 kemil THWN CU + 1-#2/0 THWN CU GND IN 3" CONDUIT TO EXISTING TRANSFER SWITCH ENCLOSURE FOR 480V STANDBY POWER FEEDER CIRCUIT. NOT ALL CONDUITS SHOWN FOR CLARITY
- \$\leq\$ PROVIDE AND INSTALL 3-#8 THWN CU + 1-#10 THWN CU GND IN 1" CONDUIT TO NEW MCC FEEDER CIRCUIT BREAKER FOR 480V ANCILLARY EQUIPMENT FEEDER CIRCUIT.
- (16) CONTRACTOR TO PROVIDE AND INSTALL GROUNDING ELECTRODE CONDUCTOR CONSISTING OF #4/O BARE STRANDED COPPER DIRECT BURIED IN SOIL A MINIMUM OF 24" BELOW ASPHALT OR CONCRETE. REFER TO SHEET E-2 FOR CONTINUATION TO NEW GROUND RODS. THIS #4/O BARE STRANDED COPPER GROUNDING ELECTRODE CONDUCTOR SHALL CONTINUE TO THE GENERATOR
- CONTRACTOR TO EXOTHERMICALLY WELD A #2/O AWG BARE COPPER CONDUCTOR TO THE GROUNDING ELECTRODE CONDUCTOR IN NOTE #16. THE #2/O CONDUCTOR SHALL BE EXOTHERMICALLY WELDED, AT A MINIMUM OF 4 POINTS, TO THE REINFORCING STEEL EMBEDDED IN THE NEW GENERATOR CONCRETE PAD. PROVIDE A MINIMUM 20'-O" OF #2/O AWG BARE COPPER CONDUCTOR WITHIN THE CONCRETE \$1 AR. CONDUCTOR WITHIN THE CONCRETE SLAB.
- (18) CONTRACTOR TO PROVIDE AND INSTALL #8 BARE STRANDED COPPER GROUNDING ELECTRODE CONDUCTOR FOR ANCILLARY TRANSFORMER GROUNDING, PROVIDE EXOTHERMIC WELD TO #4/0 GROUNDING ELECTRODE CONDUCTOR IN A PAGE TO THE PROVIDE CONDUCTOR IN NOTE #16.
- (19) FOR CONTINUATION OF CONDUITS TO BUILDING REFER TO SHEET E-3.
- PROVIDE AND INSTALL 8-#12 THWN CU + 1-#12 THWN CU GND IN 3/4" CONDUIT TO EXISTING PLC CONTROL CABINET FOR SCADA MONITORING OF CENERATOR BASE TANK. 2-#12 BASE TANK LEAK DETECTION ALARM, 2-#12 FOR BASE TANK HOW LEVEL ALARM AND 2-#12 SPARE. CONTRACTOR SHALL COORDINATE/VERIFY CONNECTION LOCATION AND TYPE WITH ENCLOSURE MANUFACTURER.
- (21) BATTERY CHARGER PROVIDED AS PART OF THE ENCLOSURE PACKAGE.

# GENERAL NOTES:

- THIS DRAWING SHOWS LAYOUTS AND DIMENSIONS BASED ON A PARTICULAR MANUFACTURER. THE CONTRACTOR SHALL COORDINATE DIMENSIONS, STUBUP LOCATIONS AND EQUIPMENT LOCATIONS WITH THE MANUFACTURER SUBMITTED/PROVIDED.
- 2. THE GENERATOR ENCLOSURE SHALL BE PROVIDED WITH A 60 AMPERE DISCONNECT SWITCH, 120/208V, 30, MCB LOADCENTER, 25 KVA, 480V-120/208V, 30, TRANSFORMER, FLUORESCENT LIGHTING FIXTURES, 3-WAY SWITCHES, DC LIGHTING FIXTURES, 60 MINUTE TIMER SWITCHES FOR DC LIGHT FIXTURES, DUPLEX GFCI RECEPTACLES AND BASE TANK AS NOTED AND SPECIFIED. ALL EQUIPMENT PROVIDED BY THE SUPPLIER OF THE ENCLOSURE PACKAGE SHALL BE PROVIDED AND INSTALLED WITH ALL ASSOCIATED CONDUIT AND CONDUCTORS FOR POWER AND CONTROLS AS PEQUIPMENT OR A COMPTETE AND FINETCHNING UNIT CONTROLS AS REQUIRED FOR A COMPLETE AND FUNCTIONING UNIT.

777 S, Herbourleien: Blvd, STE 670, TAMPA, FL 33602 B13 .227 .9190 FAX 813 . 227 . 9195 Certificate of Authorization, No. 00031028

**MANATEE COUNTY** 

**MLS 1M EMERGENCY** GENERATOR REPLACEMENT



Shaping the Future

S80 PARK PLACE BLVD, STE 300, CLEARWATER, FL 33759
TEL: (7277) 531-3305 (800) 861-8314
www.cardino.com Certificate of Authorization No. 29915

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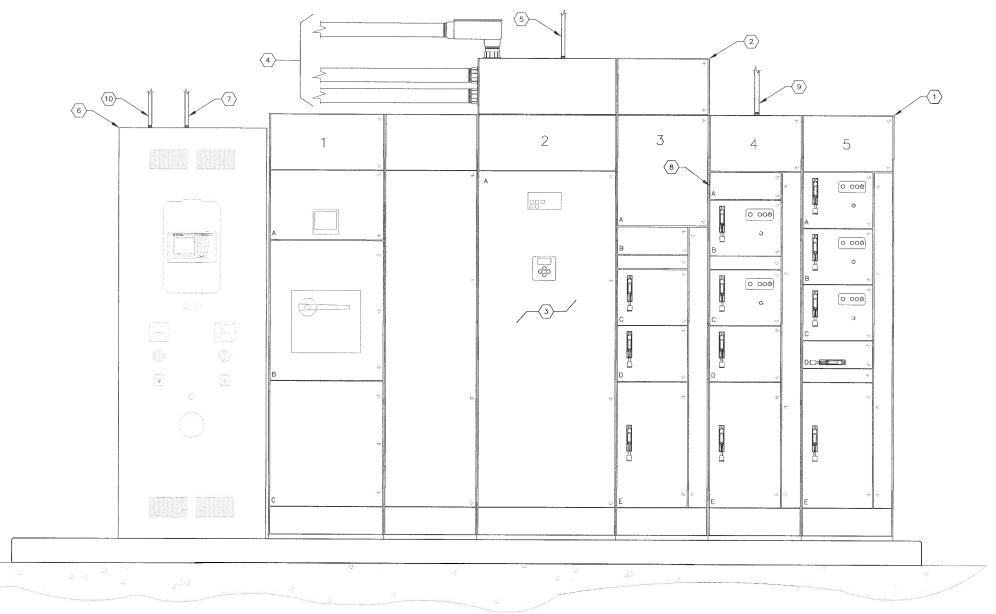
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**GENERATOR DETAILS** 

ROJECT NO: 00193009.05

> JANUARY 2016 SHEET NO: E-4





# LIFT STATION 1M MCC ELEVATION



# **KEYED NOTES:**

- 1 EXISTING SQUARE D MODEL 6 MOTOR CONTROL CENTER FOR LIFT STATION 1M.
- 2 EXISTING TOP HAT ON MOTOR CONTROL CENTER. CONTRACTOR MAY UTILIZE TOP HAT AS REQUIRED TO INSTALL NEW GENERATOR FEEDERS.
- $\fbox{3}$  EXISTING 1200A, 480V, 3—POLE, TRANSFER SWITCH TO BE REPLACED. REFER TO DETAILS ON SHEET E-7.
- (4) PROVIDE AND INSTALL THREE (3) PARALLEL RUNS CONSISTING OF 3-#350 kcmii THWN CU + 1-#2/O THWN CU GND IN 3" CONDUIT, FIELD ROUTE CONDUIT FROM EXISTING TRANSFER SWITCH ENCLOSURE TO NEW GENERATOR FOR 480V STANDEY POWER FEEDER CIRCUIT. PROVIDE AND INSTALL 4-#12 THWN CU + 1-#12 THWN CU GND IN 3/4" CONDUIT. FIELD ROUTE CONDUIT FROM EXISTING TRANSFER SWITCH ENCLOSURE TO NEW GENERATOR FOR GENERATOR START SIGNAL. CONTRACTOR TO

COORDINATE/VERIFY GENERATOR STARTER CONTROL REQUIREMENTS WITH GENERATOR AND TRANSFER SWITCH MANUFACTURERS.

- 6 EXISTING PLC CONTROL CABINET.
- 7) PROVIDE AND INSTALL 8-#12 THWN CU + 1-#12 THWN CU GND IN 3/4" CONDUIT. FIELD ROUTE CONDUIT FROM PLC CONTROL CABINET TO NEW GENERATOR FOR SCADA MONITORING OF GENERATOR. 2-#12 FOR GENERATOR RUNNING INDICATION, 2-#12 FOR GENERATOR FAIL INDICATION AND 4-#12
- (8) EXISTING SPARE 6" BUCKET IN SQUARE D MODEL 6 MCC (AT 6C).
  CONTRACTOR SHALL PROVIDE NEW 480V, 3-POLE, 40A CIRCUIT BREAKER FOR
  THE NEW GENERATOR 480V ANCILLARY EQUIPMENT FEEDER CIRCUIT.
  CONTRACTOR SHALL PROVIDE CIRCUIT BREAKER AND ALL ASSOCIATED EQUIPMENT (BUCKET, CIRCUIT BREAKER DOOR, CIRCUIT BREAKER THROUGH-DOOR OPERATING HANDLE, CIRCUIT BREAKER STABS, ETC.) FOR COMPLETE INSTALLATION.
- PROVIDE AND INSTALL 3-#8 THWN CU + 1-#10 THWN CU GND IN 1" CONDUIT. FIELD ROUTE CONDUIT FROM NEW MCC FEEDER CIRCUIT BREAKER TO NEW GENERATOR DISCONNECT SWITCH FOR 480V ANCILLARY EQUIPMENT FEEDER CIRCUIT.
- PROVIDE AND INSTALL 8-#12 THWN CU + 1-#12 THWN CU GND IN 3/4"
  CONDUIT TO EXISTING PLC CONTROL CABINET FOR SCADA MONITORING OF
  GENERATOR BASE TANK. 2-#12 BASE TANK LEAK DETECTION ALARM, 2-#12 FOR BASE TANK LOW LEVEL ALARM, 2-#12 FOR BASE TANK HIGH LEVEL ALARM AND 2-#12 SPARE. CONTRACTOR SHALL COORDINATE/VERIFY CONNECTION LOCATION AND TYPE WITH ENCLOSURE MANUFACTURER. pertunothy.

# **GENERAL NOTES:**

THE CONTRACTOR SHALL PROVIDE FOR THE NEW SCADA INPUT/OUTPUTS (I/O) AS REQUIRED FOR THE NEW GENERATOR INSTALLATION. THE NEW SCADA I/O SHALL CONSIST OF THE FOLLOWING

DISCRETE INPUT — GENERATOR RUNNING INDICATION
DISCRETE INPUT — GENERATOR FAIL INDICATION
DISCRETE INPUT — FUEL TANK LEAK DETECTION ALARM
DISCRETE INPUT — FUEL TANK HIGH LEVEL ALARM
DISCRETE INPUT — FUEL TANK HIGH LEVEL A

THE CONTRACTOR SHALL PROVIDE NEW CONDUCTORS AND CONDUIT AS INDICATED ON THE DRAWINGS FOR THE NEW SCADA I/O. THE CONTRACTOR SHALL TERMINATE ALL NEW CONDUCTORS ON THE EXISTING CONTROLLER AND PROVIDE FOR THE PROGRAMMING OF THE EXISTING CONTROLLER IN AND PROVIDE FOR THE PROGRAMMING OF THE EXISTING CONTROLLER IN ORDER TO INTEGRATE THE NEW I/O INTO THE COUNTY'S EXISTING SCADA SYSTEM. THE CONTRACTOR SHALL COORDINATE THIS WORK WITH MANATEE COUNTY. NHON SO

NO. DESCRIPTION BY DATE

**MANATEE COUNTY** 

**MLS 1M EMERGENCY GENERATOR REPLACEMENT** 



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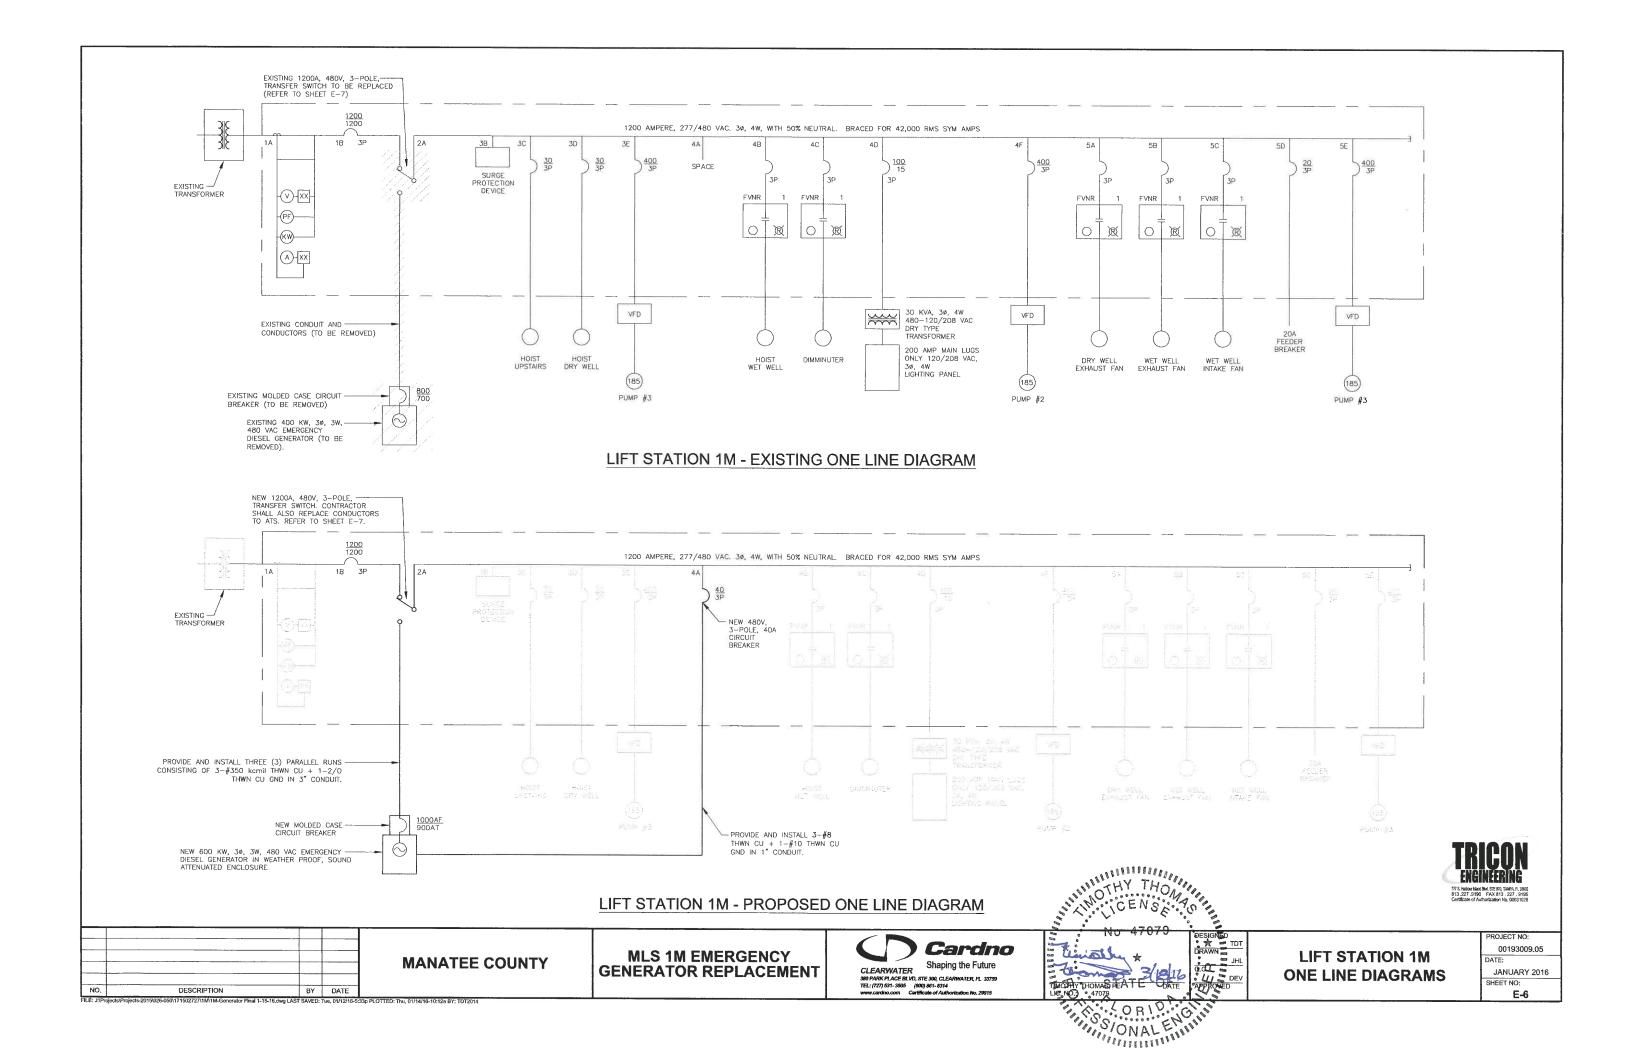
**LIFT STATION 1M** MCC ELEVATON

ROJECT NO 00193009.05 JANUARY 2016


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inal 1-15-16.dwg LAST SAVED: Tue, 01/12/16-5:33p PLOTTED: Thu, 01/14/16-10:17a BY: TDT2014








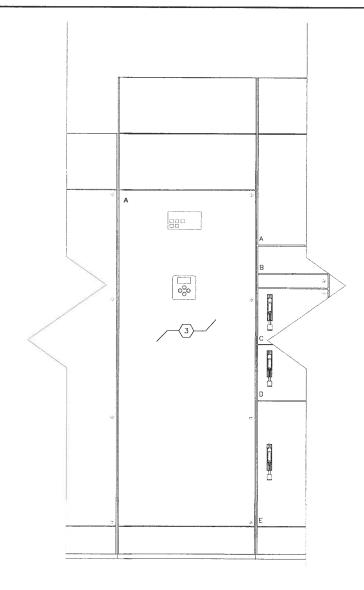

NO SCALE

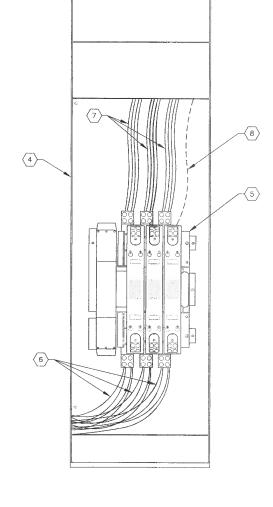

# **EXISTING ATS INTERIOR ELEVATION**

NO SCALE

# KEYED NOTES:

- (1) EXISTING AUTOMATIC TRANSFER SWITCH (ATS) ENCLOSURE. ENCLOSURE IS INTEGRAL TO SQUARE D MODEL 6 MOTOR CONTROL CENTER FOR LIFT STATION 13A. EXISTING ENCLOSURE FOR 1200A, 480V, 3-POLE, S/N TRANSFER SWITCH TO REMAIN.
- 2 EXISTING USER INTERFACE FOR ATS CONTROL PANEL. USER INTERFACE AND CONTROL PANEL SHALL BE REPLACED. REFER ALSO TO SPECIFICATIONS.
- (3) EXISTING USER CONTROLS AND INDICATORS. USER CONTROLS AND INDICATORS SHALL BE REPLACED. REFER ALSO TO SPECIFICATIONS.
- $\overline{\langle 4 \rangle}$  EXISTING ATS ENCLOSURE SHOWN WITH DOOR OPEN.
- 5 EXISTING 1200A, 480V, 3-POLE, S/N TRANSFER SWITCH TO BE REPLACED.
- 6 EXISTING NORMAL POWER CONDUCTORS FROM EXISTING MAIN CIRCUIT BREAKER. CONTRACTOR SHALL REMOVE ALL EXISTING NORMAL POWER CONDUCTORS AND REPLACE WITH FOUR (4) PARALLEL RUNS CONSISTING OF 3-#350 kcmil THWN
- (7) EXISTING LOAD SIDE CONDUCTORS. LOAD SIDE CONDUCTORS CONTINUE TO MCC BUS. CONTRACTOR SHALL REMOVE ALL EXISTING LOAD SIDE CONDUCTORS AND REPLACE WITH FOUR (4) PARALLEL RUNS CONSISTING OF 3-#350 kemil THWN CU.
- (8) EXISTING EMERGENCY POWER CONDUCTORS FROM EXISTING GENERATOR (NOT ALL CONDUCTORS SHOWN FOR CLARITY. CONTRACTOR SHALL REMOVE ALL EXISTING EMERGENCY POWER CONDUCTORS AND REPLACE WITH THREE (3) PARALLEL RUNS CONSISTING OF 3-#350 kemil THWN CU + 1-2/0 THWN CU CONDUCTORS AND REPLACE WITH THE CONDUCTORS AND REPLACE WITH THE CONDUCTOR AND REPLACE WITH THE CONDUCTOR CO

# ATS GENERAL NOTES:

- WITH THE EXCEPTION OF THE ATS ENCLOSURE AND SUPPORTS, THE ENTIRE AUTOMATIC TRANSFER SWITCH SHALL BE REPLACED. THE REPLACEMENT SHALL INCLUDE NOT ONLY THE ATS, BUT THE CONTROL PANEL (AND USER INTERFACE), USER CONTROLS AND INDICATORS, WIRING HARNESSES, ETC.
- 2. THE CONTRACTOR SHALL PROVIDE LUGS AS REQUIRED TO ACCOMMODATE THE NEW CONDUCTORS TO BE INSTALLED.
- 3. THE CONTRACTOR SHALL CONNECT ALL EQUIPMENT GROUND CONDUCTORS (NOT SHOWN FOR CLARITY).
- 4. CONTRACTOR TO REMOVE ALL EXISTING CONTROL CONDUCTORS FROM EXISTING GENERATOR (TO BE REMOVED) TO EXISTING ATS (TO BE REMOVED). REFER TO OTHER SHEETS FOR CONTROL WIRING REQUIRED BETWEEN NEW ATS AND NEW GENERATOR.
- 5. REFER TO SPECIFICATION SECTION 00800 FOR TEMPORARY POWER REQUIREMENTS.
- 6. CONTRACTOR SHALL DUPLICATE ALL EXISTING CONDUCTOR ROUTES/SIZES/QUANTITIES. CONTRACTOR TO FIELD VERIFY ALL EXISTING CONDITIONS PRIOR TO ORDERING MATERIALS/EQUIPMENT OR COMMENCIAL CONTRACTOR TO FIELD VERIFY ALL EXISTING CONDITIONS.

NO. DESCRIPTION BY DATE

**MANATEE COUNTY** 

MLS 1M EMERGENCY GENERATOR REPLACEMENT



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O R. C. M. C. M.

LIFT STATION 1M ATS REPLACEMENT DETAILS PROJECT NO: 00193009.05 DATE: JANUARY 2016

E-7

SHEET NO:

FILE: J:\Projects\Projects-2015\026-050\171502727\1M\1M-Generator Final 1-15-16.dwg LAST SAVED: Thu, 01/14/16-10:18a PLOTTED: Fri, 01/15/16-2:20p BY: TDT2014

# GENERAL STRUCTURAL NOTES

# DESIGN CRITERIA

#### CODES:

2014 FLORIDA BUILDING CODE

REINFORCED CONCRETE:

WATER RETAINING STRUCTURES: ACI 318-11

MASONRY: "BUILDING CODE REQUIREMENTS FOR MASONRY STRUCTURES" (ACI 530-08/ASCE 5-08/TMS 402-08)

STRUCTURAL STEEL: AISC MANUAL OF STEEL CONSTRUCTION 13TH EDITION

THE ALUMINUM ASSOCIATION, ALUMINUM DESIGN MANUAL 2005

# DESIGN LIVE LOADS:

- PROCESS RELATED STRUCTURES

WALKWAYS, STAIRWAYS AND LANDINGS ELEVATED SLABS 100 PSF 200 PSF

# CURERINARIOSER READIOARS

SUPERIMPUSED DEADLOADS:	
- ROOFS	AS NOTED
- FLOORS	AS NOTED

# WIND LOADS:

- ULTIMATE DESIGN WIND SPEED, V<sub>IUT</sub> (3-SECOND GUST)
   NOMINAL DESIGN WIND SPEED, V<sub>ASD</sub>
   RISK CATEGORY
   EXPOSURE CATEGORY
   ENCLOSURE CLASSIFICATION
   INTERNAL PRESSURE COEFFICIENT, GCpi
   DESIGN PRESSURES: PER ASCE 7-10 156 MPH 121 MPH PARTIALLY ENCLOSED

#### FOUNDATIONS

ALLOWABLE BEARING PRESSURE FOR MAT FOOTINGS OVER SUBSURFACE PREPARED AS PER SPECIFICATIONS: 2500 PSF

# GENERAL CONDITIONS

AL. ALU. ALUM

AL, ALU,
ADDT'L
BTWN
BLD
BOT
CJ
CMU
CONST JT
CONT
DIA
DO
DWG
EF

ALL STRUCTURAL DRAWINGS SHALL BE USED IN CONJUNCTION WITH THE MECHANICAL, CIVIL, ELECTRICAL, AND SHOP DRAWINGS AND SPECIFICATIONS.

THE CONTRACTOR SHALL REVIEW AND VERIFY DIMENSIONS SHOWN IN ALL PLANS AND REVIEW ALL FIELD CONDITIONS THAT MAY AFFECT THE INSTALLATION OF THE WORK SHOWN. SHOULD DISCREPANCIES APPEAR, THE CONTRACTOR SHALL NOTIFY THE ENGINEER IN WRITING TO OBTAIN ENGINEER'S CLARIFICATION BEFORE COMMENCING WITH THE WORK.

FOR ALL ITEMS EMBEDDED IN OR PASSED THOUGH CONCRETE, THE CONTRACTOR SHALL INITIALLY REFER TO MECHANICAL, HEATING, AND VENTILATION DRAWINGS FOR TYPE, SIZE, LOCATION, AND SPECIAL INSTALLATION REQUIREMENTS FOR THESE ITEMS.

THE CONTRACTOR SHALL TAKE ANY AND ALL NECESSARY MEASURES TO PROTECT EXISTING STRUCTURES FROM DAMAGE WHEN WORKING IN AND AROUND EXISTING STRUCTURES PERFORMING WORK SUCH AS DEMOLITION, FOUNDATION EXCAVATION, AND OTHERS.

SIZE AND LOCATION OF EQUIPMENT PADS AND ANCHOR BOLTS SHALL BE PER EQUIPMENT MANUFACTURERS REQUIREMENTS.

ANY EQUIPMENT THAT MAY INDUCE VIBRATION TO THE STRUCTURE SHALL BE ADEQUATELY ISOLATED FROM THE STRUCTURES.

ALL DETAILS AND SECTIONS SHOWN ON THE DRAWINGS ARE INTENDED TO BE TYPICAL AND SHALL BE CONSTRUED TO APPLY TO ANY SIMILAR SITUATION ELSEWHERE ON THE PROJECT, EXCEPT WHERE A DIFFERENT DETAIL IS SHOWN.

STANDARD DETAILS APPLY TO ALL SIMILAR SITUATIONS ON THE PROJECT EXCEPT WHERE A DIFFERENT DETAIL IS SHOWN.

CONCRETE MASONRY UNIT CONSTRUCTION JOINT

#### REINFORCING STEEL

REINFORCEMENT SHALL CONFORM TO ASTM A615, GRADE 60 REQUIREMENTS. WELDED WIRE FABRIC, ASTM A185. ALL ACCESSORIES SHALL BE IN CONFORMANCE WITH ACI 315 REQUIREMENTS. REINFORCING STEEL SHALL HAVE THE FOLLOWING CLEAR COVER UNLESS OTHERWISE NOTED:

- CONCRETE CAST AGAINST EARTH

- FORMED SURFACES

3"

LAP SPLICES SHALL BE AS SHOWN ON THE DRAWINGS. FOR LAP SPLICES NOT SHOWN ON THE DRAWINGS, THE CONTRACTOR SHALL OBTAIN ENGINEERS APPROVAL.

THE CONTRACTOR SHALL PREPARE PLACING DRAWINGS AND SCHEDULES IN CONFORMANCE WITH ACI 315 REQUIREMENTS.

UNLESS OTHERWISE NOTED, THE MINIMUM REINFORCING FOR ALL CONCRETE WALLS AND SLABS SHALL BE AS FOLLOWS:

MINIMUM REINFORCING						
THICKNESS	6"	8"	10"	12"-16"	18"-22"	24"
REINF. EACH WAY	#4AT12"	#5AT12"	#4AT12"	#5AT12"	#6AT12"	#7AT12"
LOCATION	CENTER	CENTER	EF	EF	EF	EF

#### MASONRY

- DESIGN COMPRESSIVE STRENGTH OF MASONRY AT 28 DAYS

f'm = 1500 PSI

- ALLOWABLE STEEL STRESS

fs = 24,000 PSI

SPECS SS STD STL REINF TB T&B

T&B
T/STRUCTURE
TYP
UNO
VERT
WWF
SJ

#### MATERIALS:

- BLOCK: CONFORM TO ASTM C90 LOAD BEARING, NORMAL WEIGHT TWO-CELL, 8"x8"x16", 12"x8"x16".
- MORTAR: CONFORM TO ASTM C270, TYPE S, MINIMUM COMPRESSIVE STRENGTH AT 28 DAYS 1800 PSI. UTILIZE TYPE II CEMENT AND TYPE S LIME. MASONRY CEMENT WILL NOT BE CONSIDERED.
- GROUT: CONFORM TO C476, COURSE GROUT, MINIMUM COMPRESSIVE STRENGTH AT 28 DAYS 2500 PSI
- STEEL: BOND BEAM AND FILLED CELL REINFORCEMENT AS NOTED ON DRAWINGS (ASTM A615, GRADE 60). DUR-O-WALL OR EQUAL JOINT REINFORCEMENT AT EVERY OTHER COURSE (16" O.C.).

- THE CONCRETE FOR FILLED CELLS SHALL BE RODDED OR PUDDLED DURING PLACEMENT TO INSURE COMPLETE FILLING TO THE BLOCK CORE.
- PROVIDE CLEAN OUT AND INSPECTION BLOCK OUT IN CELLS CONTAINING REINFORCEMENT FOR GROUT LIFTS EXCEEDING 5'-0"

# CONCRETE

**ABBREVIATIONS** STRUCTURAL ABBREVIATIONS APPLY TO "S" SHEETS ONLY

ELEVATIONS EACH WAY

FF FRP FTG HORIZ HP ID J

BY DATE

EACH WAY
EXPANSION
FIRE EXTINGUISHER
FAR FACE
FIBER REINFORCED PLASTIC
FOOTING
HORIZONTAL
HIGH POINT
INSIDE DUMMETER
JOINT
LOW POINT

ALL MATERIALS AND METHODS OF CONSTRUCTION SHALL BE IN ACCORDANCE WITH ACI 31B REQUIREMENTS (LATEST EDITION)

ALL CONCRETE SHALL BE AIR-ENTRAINED WITH 4000 PSI COMPRESSIVE STRENGTH AT 28 DAYS UNLESS OTHERWISE NOTED.

WATER REDUCING AGENT SHALL BE IN ACCORDANCE WITH ASTM C494

ALL CONCRETE SURFACES EXPOSED TO AIR, UNLESS OTHERWISE NOTED IN SPECIFICATIONS, SHALL BE TREATED WITH AN APPROPRIATE CURING COMPOUND AS SOON AS CEMENT FINISHING IS COMPLETED OR FORMS ARE REMOVED.

ALL EXPOSED CORNERS SHALL HAVE A MINIMUM CHAMFER OF  $\cdet{\sharp}^{\omega}$  UNLESS OTHERWISE NOTED.

THE CONTRACTOR SHALL OBTAIN ENGINEER'S APPROVAL FOR THE LOCATIONS OF CONSTRUCTION JOINTS THAT ARE NOT SHOWN ON THE DRAWINGS.

MANUFACTURER

MANUFACTURER
MATERIAL
MAXIMUM
MINIMUM
MASONRY OPENING
MISCELLANEOUS
NOT TO SCALE
ON CENTER
POUNDS PER LINEAR FOOT
PRESSURE TREATED
PROJECTION

PROJECTION
POUNDS PER SQUARE FOOT
POUNDS PER SQUARE INCH


# GENERATOR EXHAUST OPENING GENERATOR LOUVER 14/1/11

EXISTING SITE INDICATES ITEMS TO BE REMOVED PLAN 3/16"=1'-0"



PHOTOGRAPH #1 - TYPICAL VIEW OF EXTERIOR OF BUILDING SHOWING LOUVER AND EXHAUST MUFFLER.

GENERATOR LOUVER AND

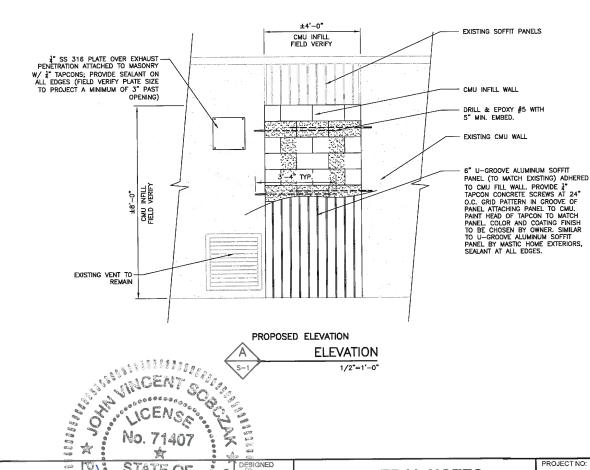



ADDITIONAL BETWEEN BUILDING

CONTINUOUS DIAMETER

FACH FACE

TECHNOLOGIES, INC. 3551 W. LAKE MARY BLVD., SUITE 210

DESCRIPTION

MISC NTS OC PLF

PT PROJ PSF PSI

**MLS 1-M EMERGENCY GENERATOR REPLACEMENT** 

SPECIFICATIONS

STEEL STEEL REINFORCEMENT TIE BEAM TOP AND BOTTOM

STAINLESS STEEL STANDARD

TOP AND BOTTOM
TOP OF STRUCTURE
TYPICAL
UNLESS NOTED OTHERWISE
VERTICAL
WELDED WIRE FABRIC
SAWCUT JOINT



CLEARWATER, 83756
380 PARK PLACE BLVD, STE 300, CLEARWATER, R. 33756
TEL: (727) 531-3505 (800) 861-8314
www.cardno.com Certificate of Authorization No. 28915



**GENERAL NOTES DEMOLITION PLAN AND WALL ELEVATION** 


1/2"=1'-0"


ROJECT NO: 00193009.05 MARCH 2016 SHEET NO:

S-1


MANATEE COUNTY


CLEARWATER

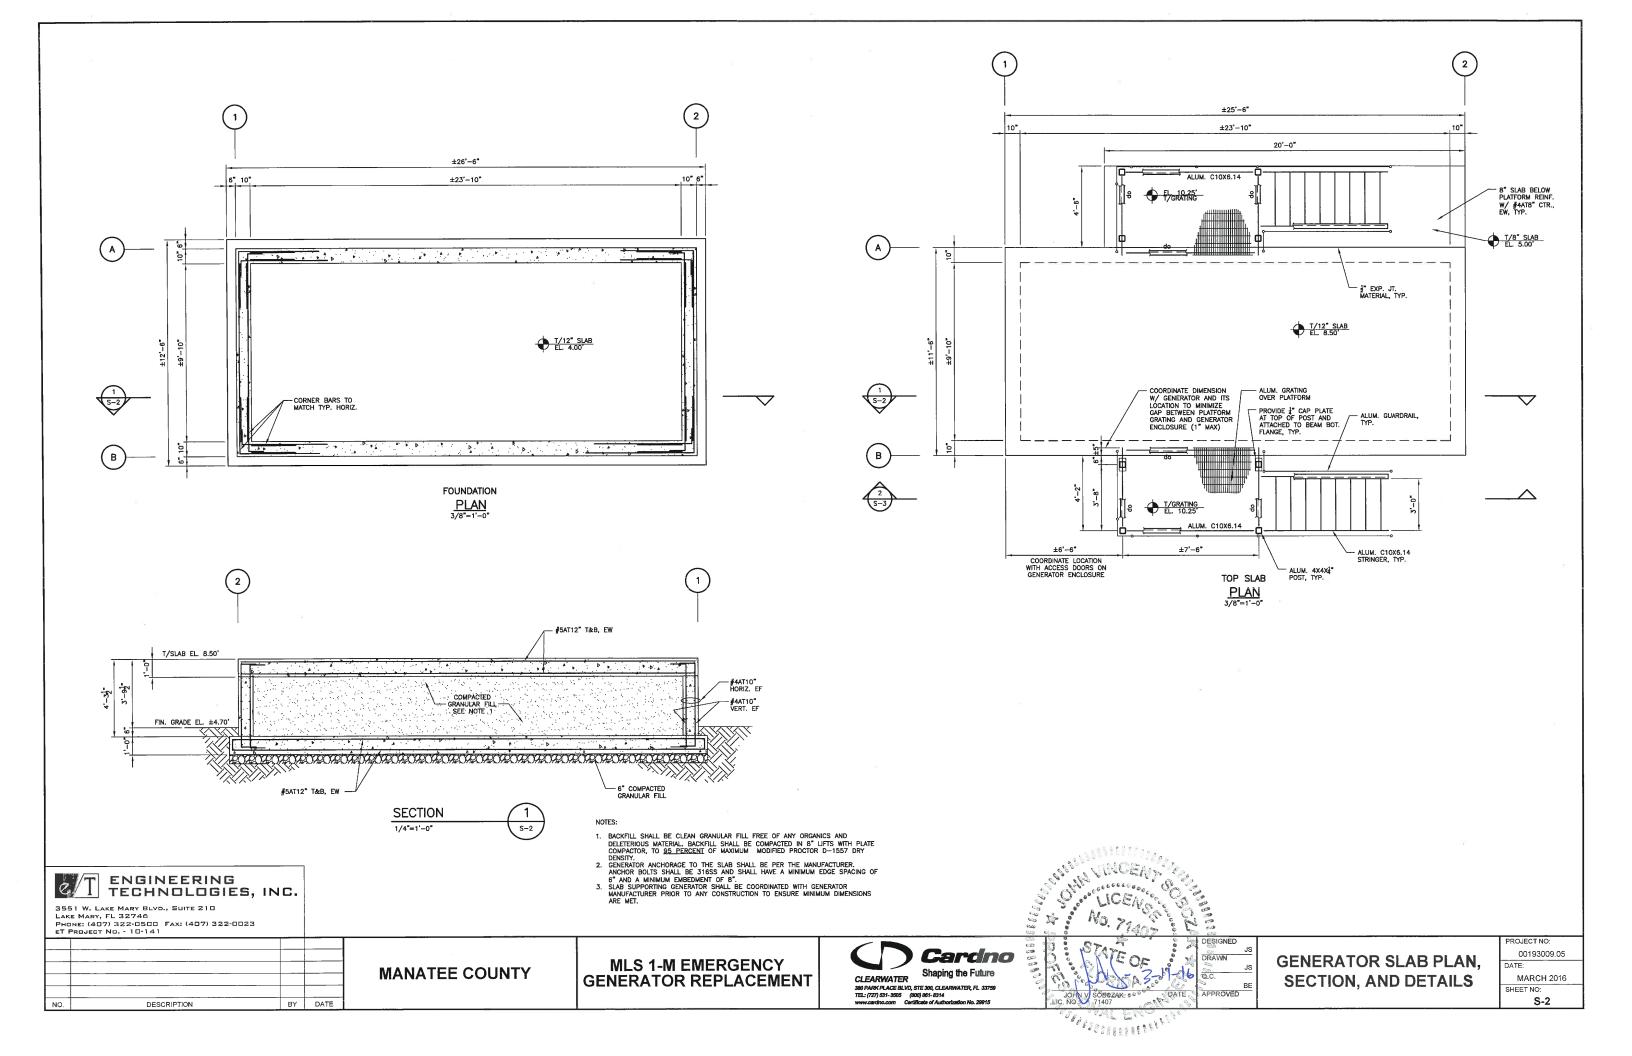

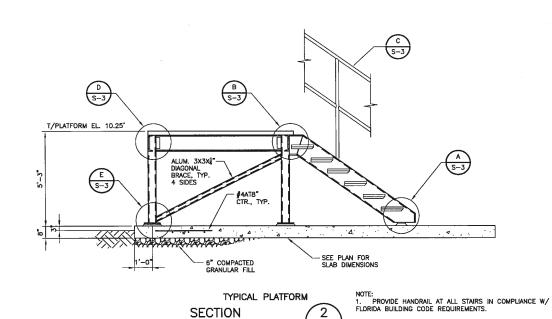

1/4"=1'-0"

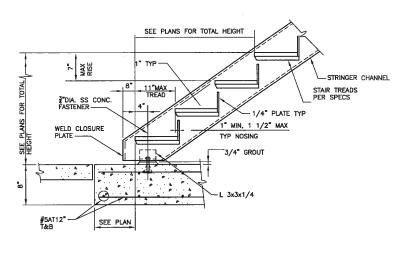


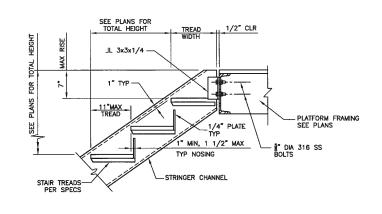



ALUM STAIR STRINGER TO CONCRETE PLATFORM

DETAIL A



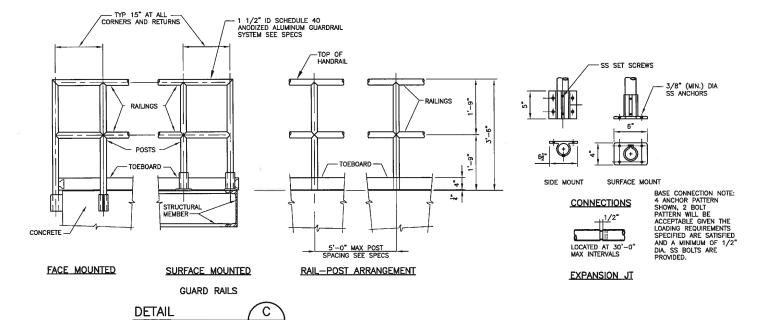


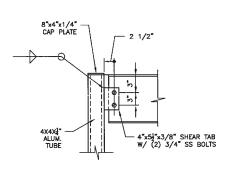

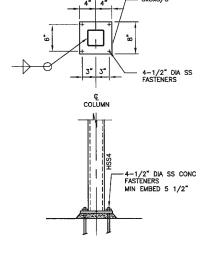

TYPICAL FRAMING CONNECTION

DETAIL D

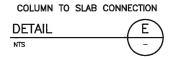



LAKE MARY, FL 32746
PHONE: (407) 322-0500 FAX: (407) 322-0023
ET PROJECT No. - 10-141

No. DESCRIPTION BY DATE

**MANATEE COUNTY** 

MLS 1-M EMERGENCY GENERATOR REPLACEMENT



NO. 7140

PESIGNED

BRAWN

O.C.

JOHN V. SOBCZAK O DATE

C. NO. 71407

Will Establish the

GENERATOR SLAB PLAN, SECTION, AND DETAILS

PROJECT NO: 00193009.05 DATE: MARCH 2016 SHEET NO: \$-3