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A3.1	FINISH SCHEDULE, OPENING SCHEDULE, SIGNAGE SCHEDULE, DOOR AND FRAME ELEVATIONS, SIGNAGE DETAILS AND OPENING DETAILS
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FP-1	FIRE PROTECTION PLANS AND SITE PLAN
FP-2	FIRE PROTECTION NOTES, DETAILS & SCHEDULES

# FINAL SITE PLAN / CONSTRUCTION PLANS FOR


# BLACKSTONE PARK EXPANSION

PART OF SECTION 11, TOWNSHIP 34 SOUTH, RANGE 17 EAST, CITY OF PALMETTO MANATEE COUNTY, FLORIDA

# A PROJECT BY

# MANATEE BOARD OF COUNTY COMMISSIONERS


1112 MANATEE AVENUE, SUITE 803 BRADENTON, FLORIDA 34205 PHONE: (941) 748-4501

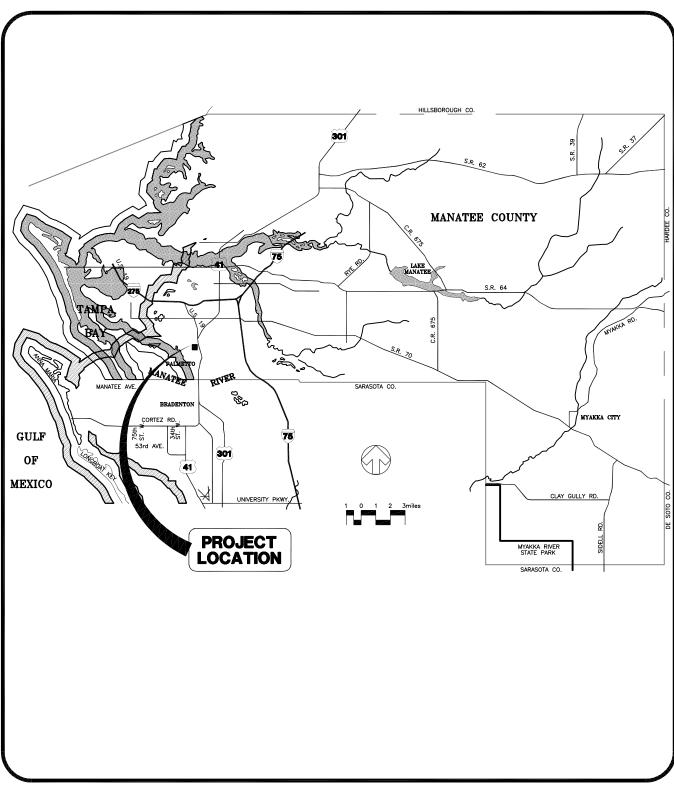

LOCATION MAP

**BEFORE YOU DIG** CALL SUNSHINE STATE ONE CALL OF FLORIDA

DJB/89366

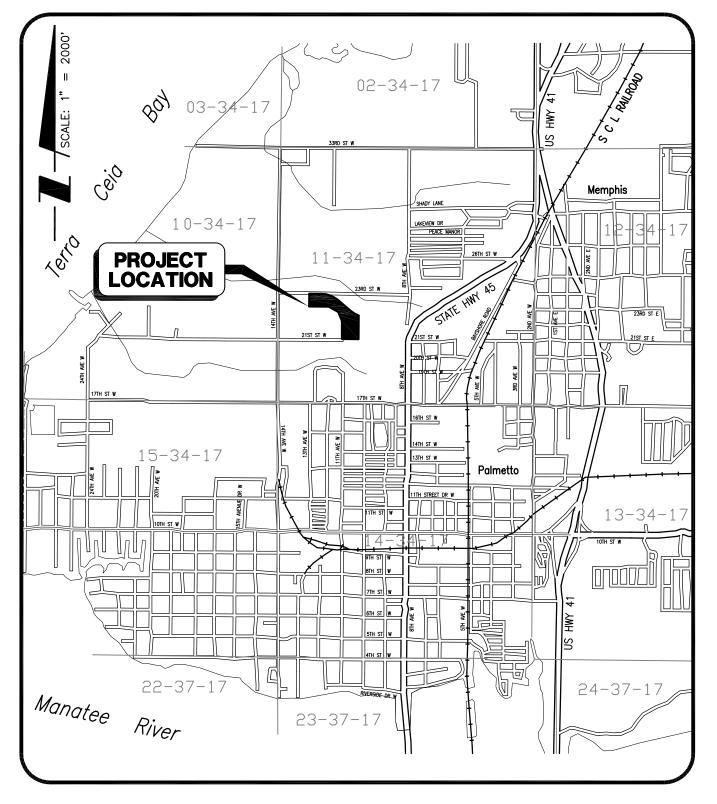

SITE MAP

# WilsonWiller & Stantec

6900 Professional Parkway East, Sarasota, FL 34240 *Phone* 941-907-6900 • *Fax* 941-907-6910 Certificate of Authorization #43 • FL Lic. # LC-C000170 • www.stantec.com

# NOTES

- TOTAL PROPERTY BOUNDARY AREA: 31.09± AC
- 2. TOTAL SWFWMD ERP PROJECT AREA =  $9.92\pm$  AC
- 3. BOUNDARY DATA SHOWN IS FOR INFORMATIONAL PURPOSES ONLY AND DOES NOT CONSTITUTE A
- 4. THE PROJECT WILL CONSIST OF A PUBLIC RECREATIONAL/PARK FACILITY.
- 5. PRESENT ZONING IS PUBLIC (P). THE EXISTING LAND USE IS VACANT/RECREATIONAL
- THE PROJECT IS 100% OPEN SPACE/RECREATIONAL
- 7. THERE ARE NO WETLANDS OR OTHER SURFACE WATERS LOCATED WITHIN THE PROJECT AREA.
- 8. PROJECT IS LOCATED WITHIN FLOOD ZONE B AS PER LATEST FEMA FIRM. COMM. PANEL NO
- 9. THERE ARE NO PERENNIAL STREAMS ON OR ADJACENT TO THE PROJECT SITE.
- IO. DRAINAGE AND UTILITY EASEMENTS WILL BE PROVIDED AS REQUIRED BY THE CITY OF PALMETTO

- PROPOSED ADDITIONAL GROSS FLOOR AREA RATIO 2,030 S.F./1,354,193 S.F. = 0.0015

- MAXIMUM SEATING CAPACITY OF BLEACHERS
- TOTAL NUMBER OF BLEACHERS MAXIMUM SEATING CAPACITY PROPOSED

- 21. ALL EXISTING FEATURES ARE LABELED AS EXISTING ON THE SITE PLAN SHEETS. ALL OTHER FEATURES N
- 22. ALL PROPOSED SETBACKS AND BUFFERS ARE SHOWN ON THE SITE PLAN.
- 24. SOLID WASTE WILL BE STORED IN A DUMPSTER ENCLOSURE ON-SITE AND COLLECTED BY THE CITY OF


# STATUS: REVISIONS


	PROJECT MANAGI J. MICHAEL BELL, I FLORIDA LICENSE NO.	P.E.	ENGINEER TECHNICIAN CARLOS L. LUGO	D	ROJECT ENGINEER ANIEL J. BOND, P.E. ORIDA LICENSE NO. 57969
	DRC Member	OK	Signature		Date
	Deputy Director of Operations				
	City Planner				
	Fire Marshall				
	City Engineer				
	DRC Coordinator				
			Yes		
	Stipulations		***		
Supulduons			No		


PROJECT NUMBER 215611237 210


DATE DECEMBER 2012


INDEX NUMBER D-215611237-001

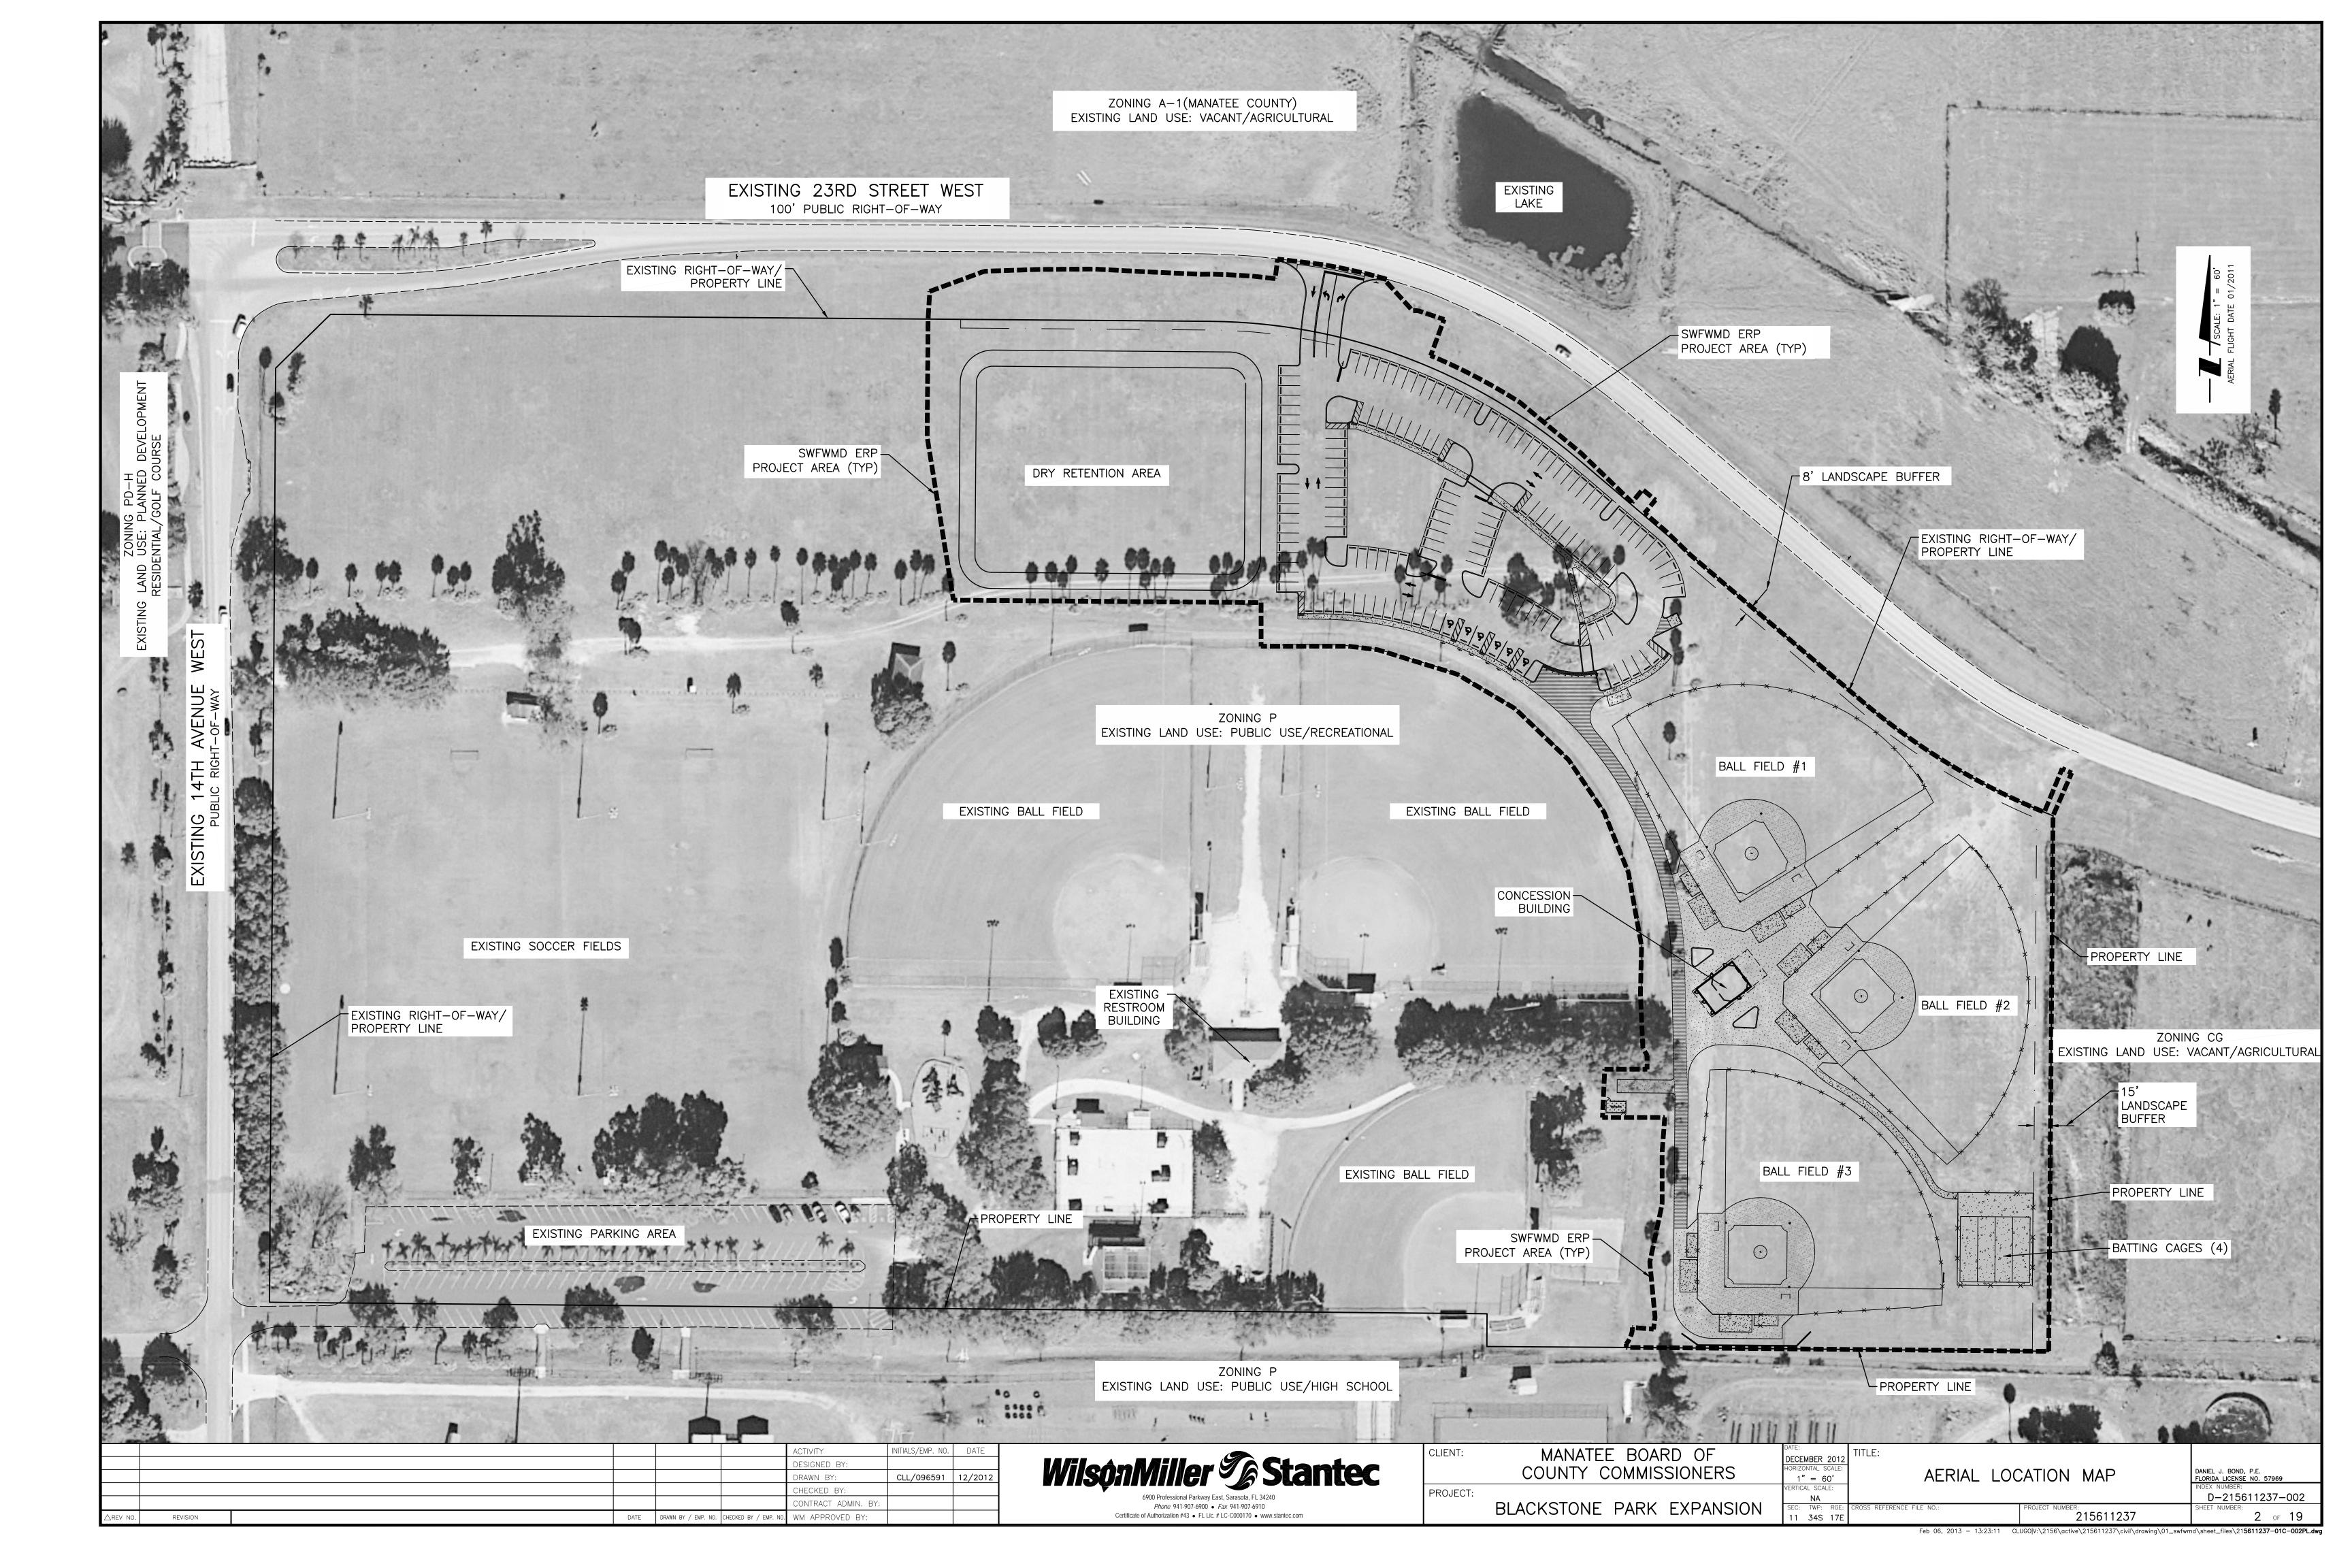


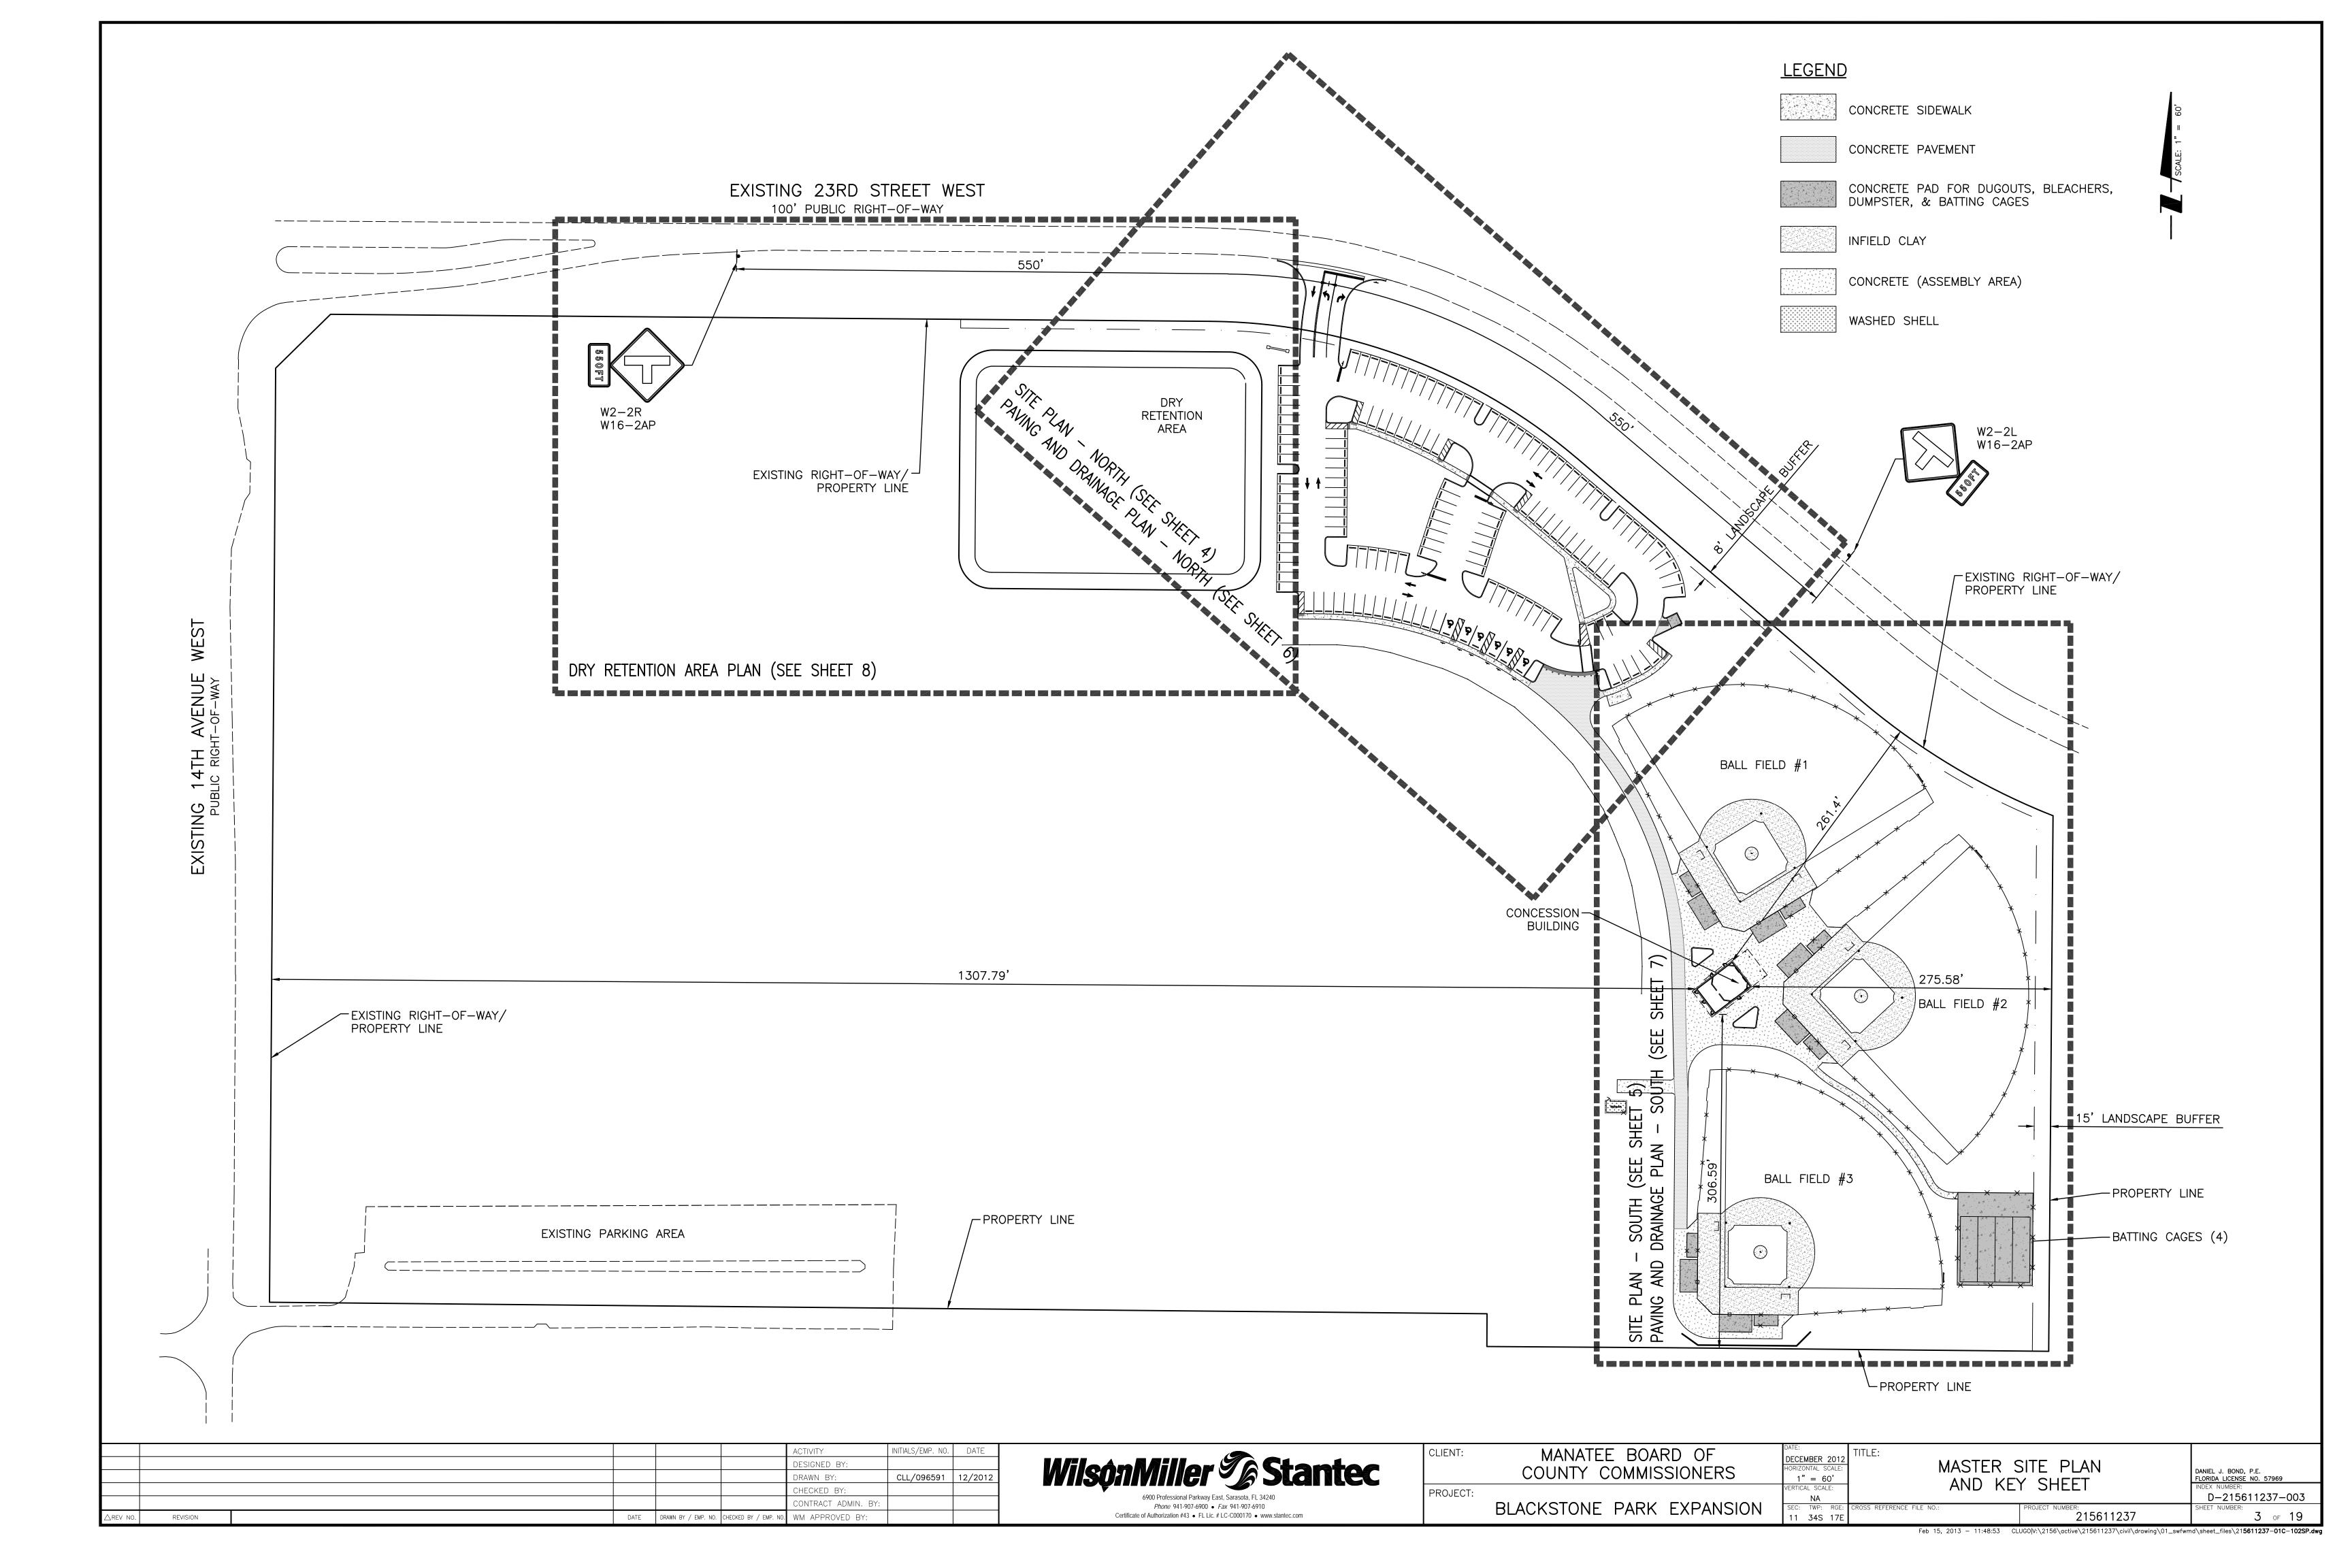


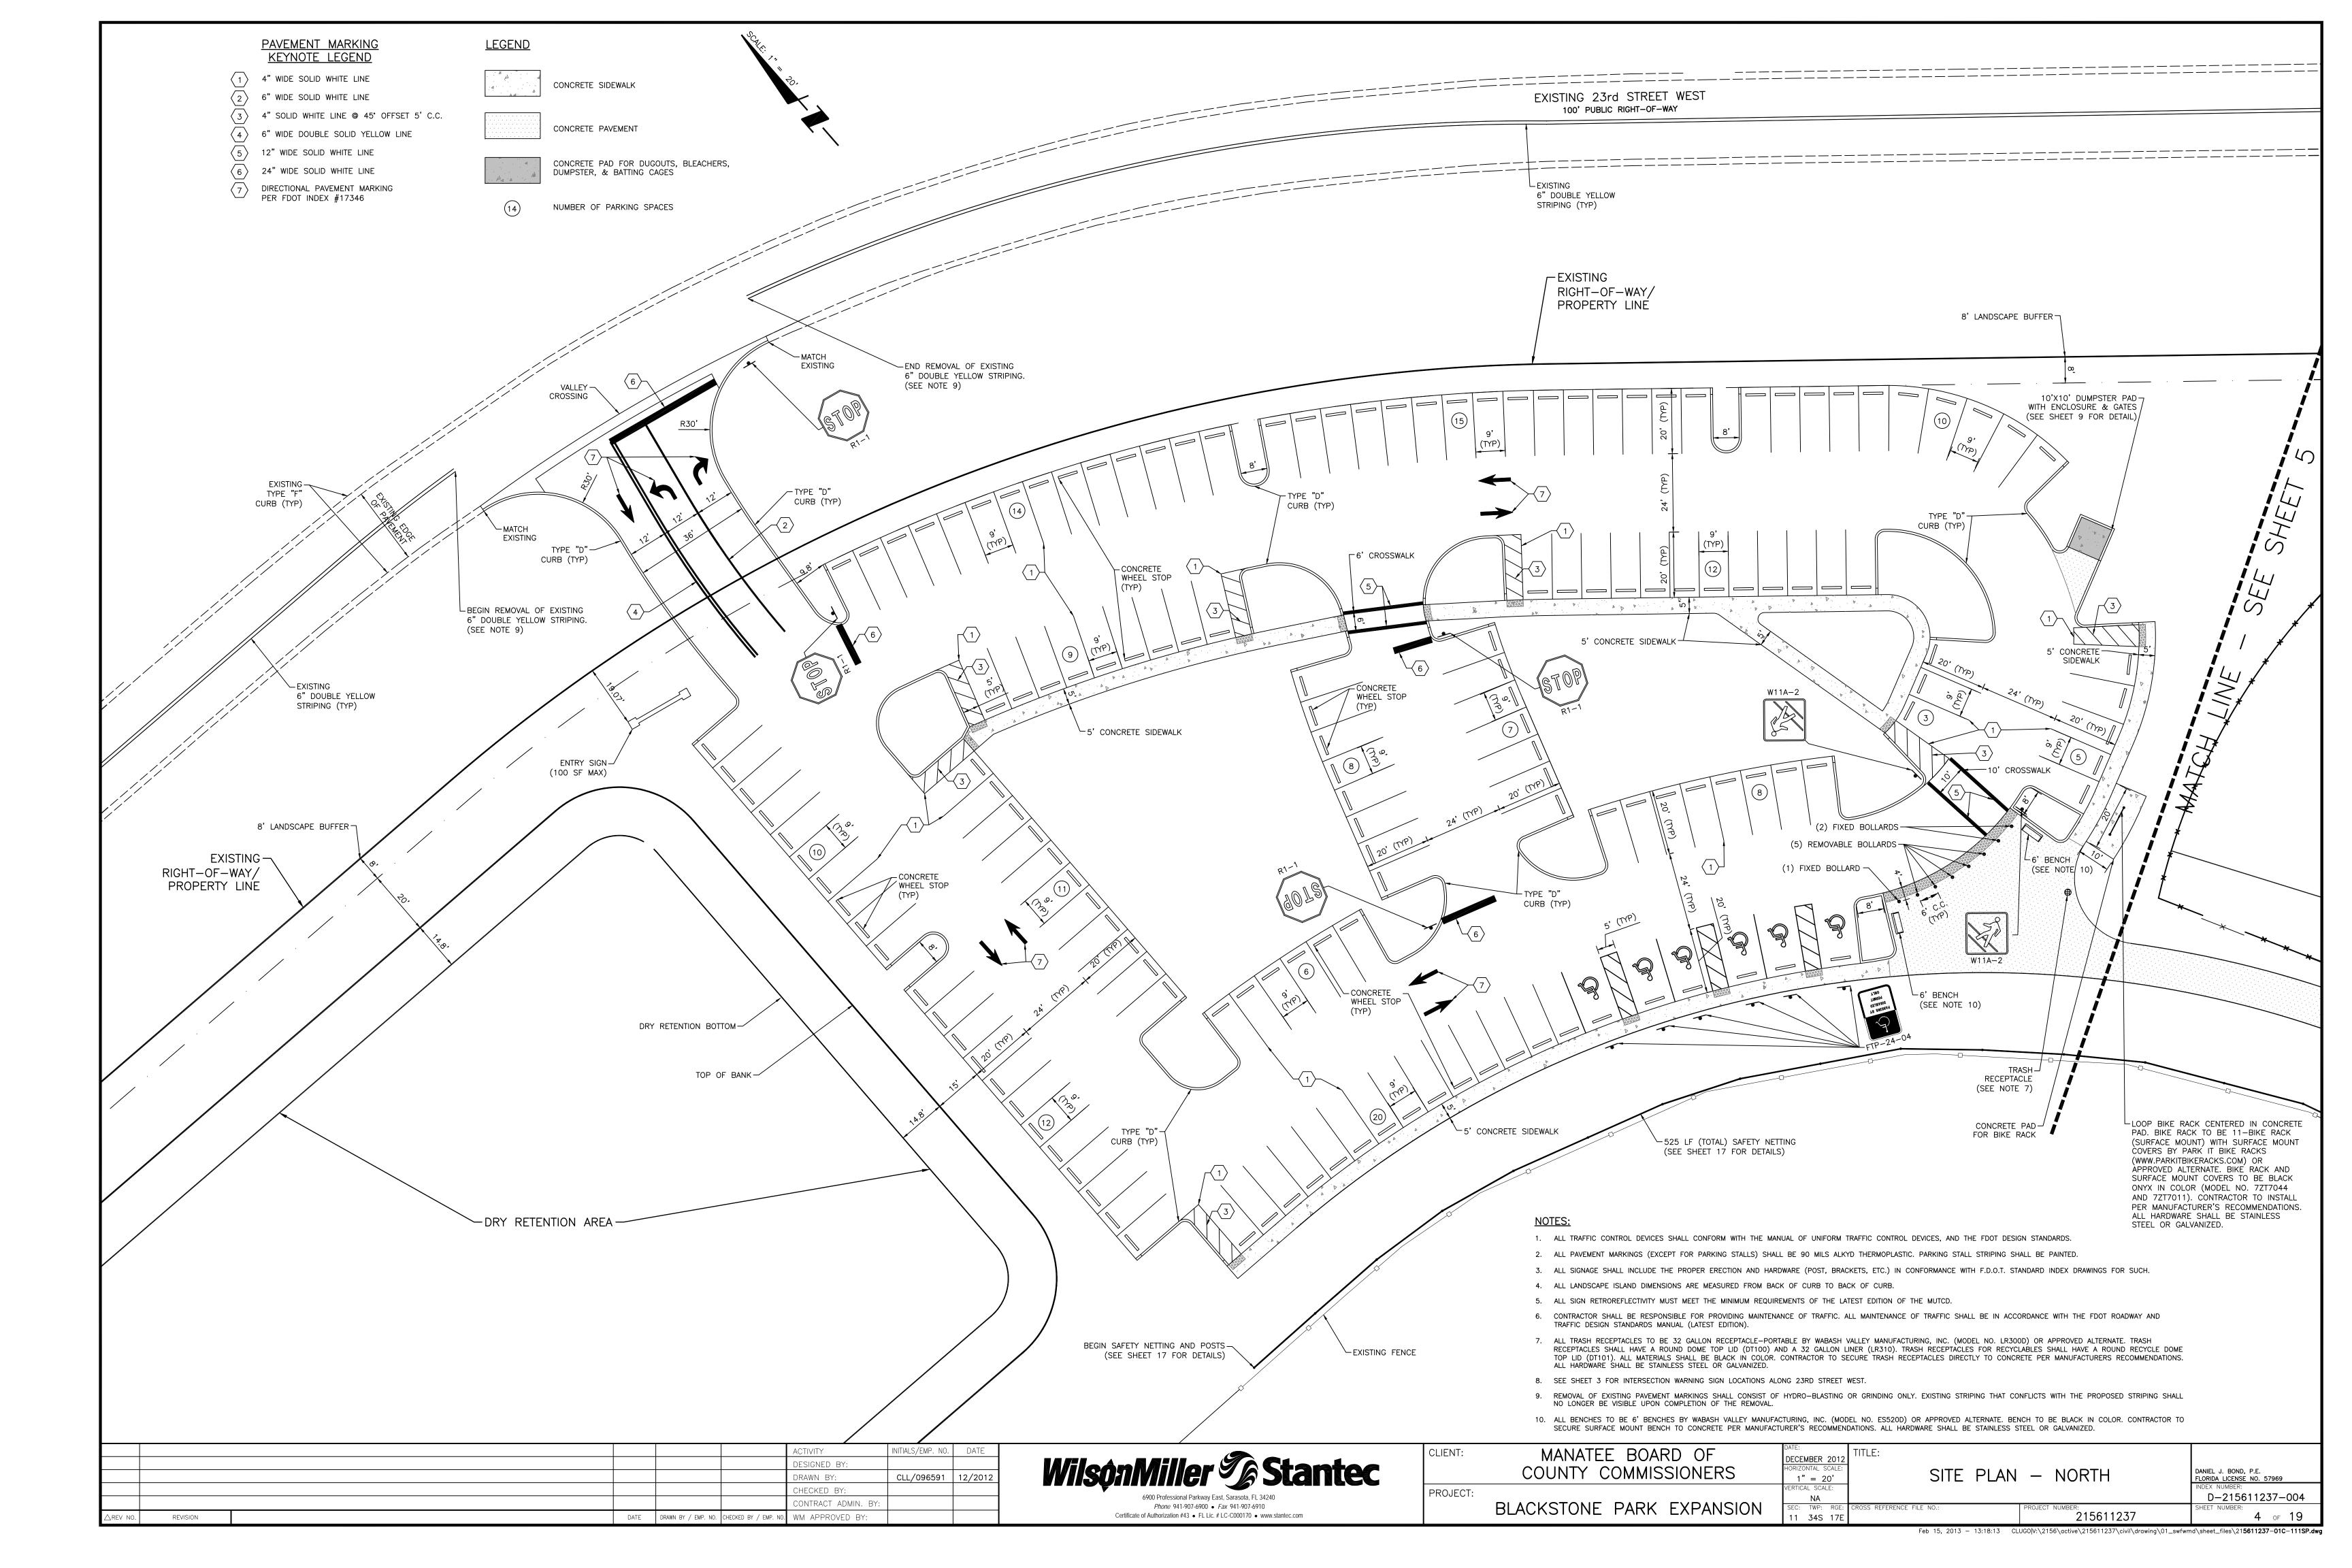

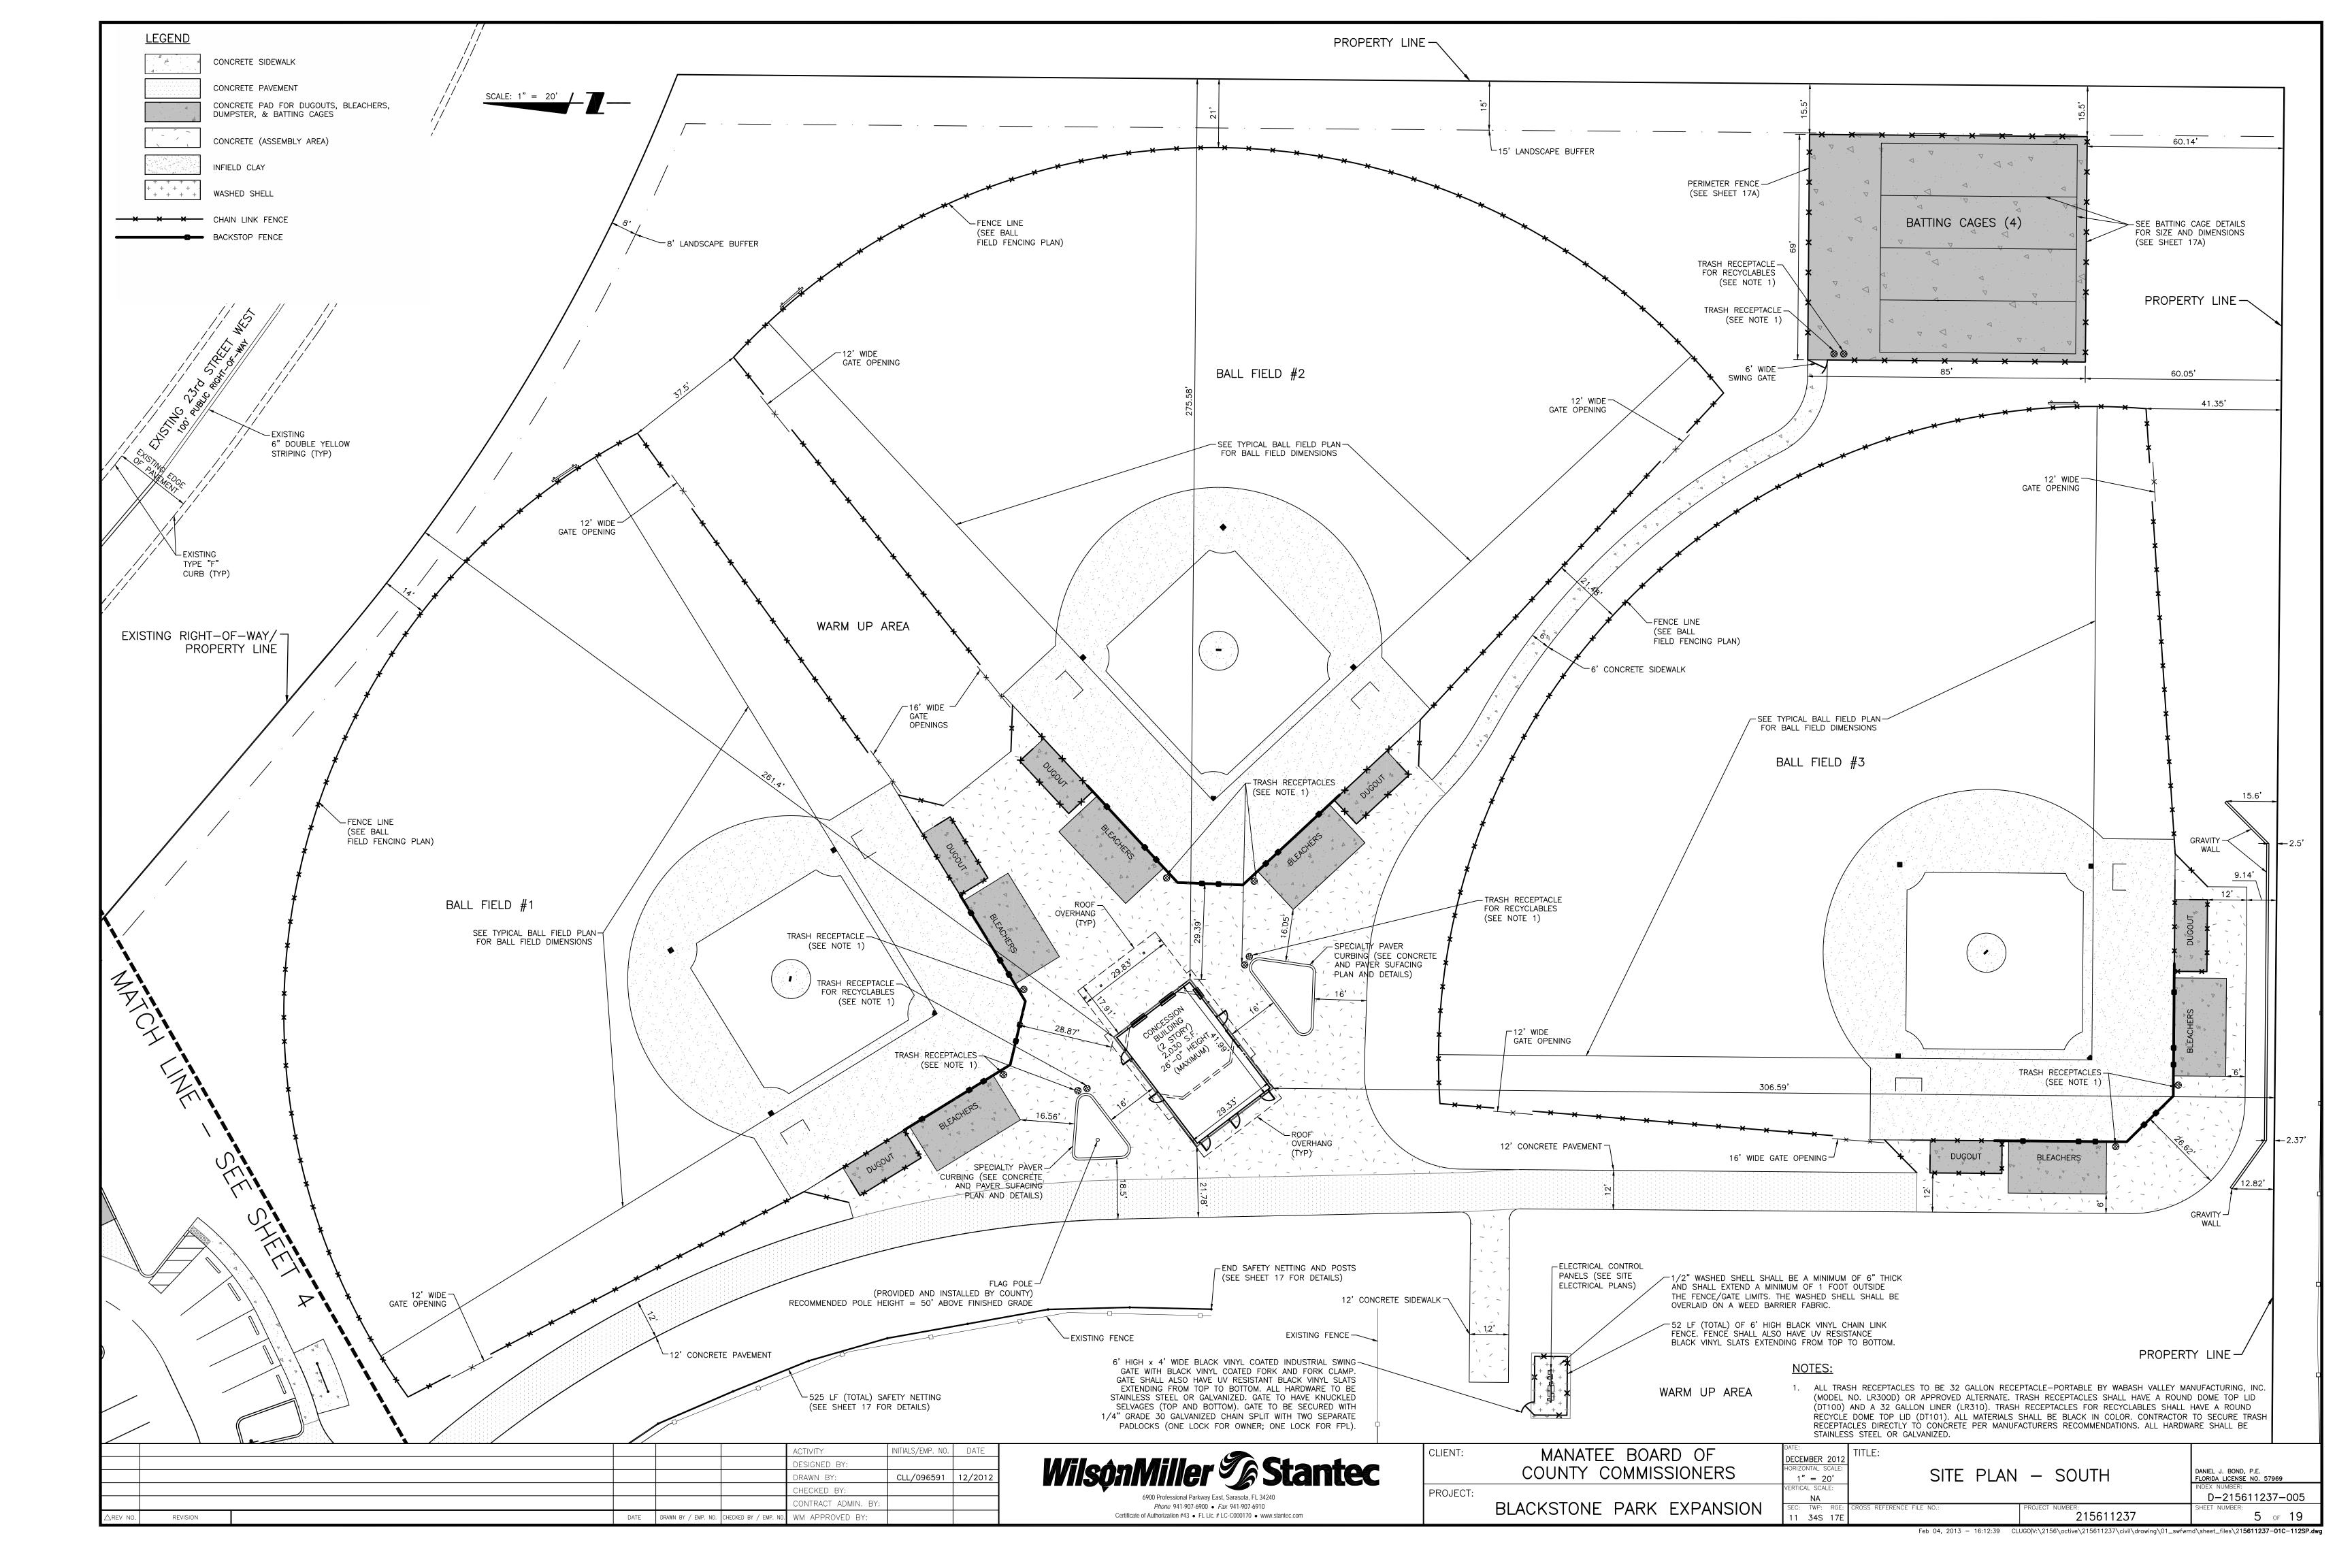

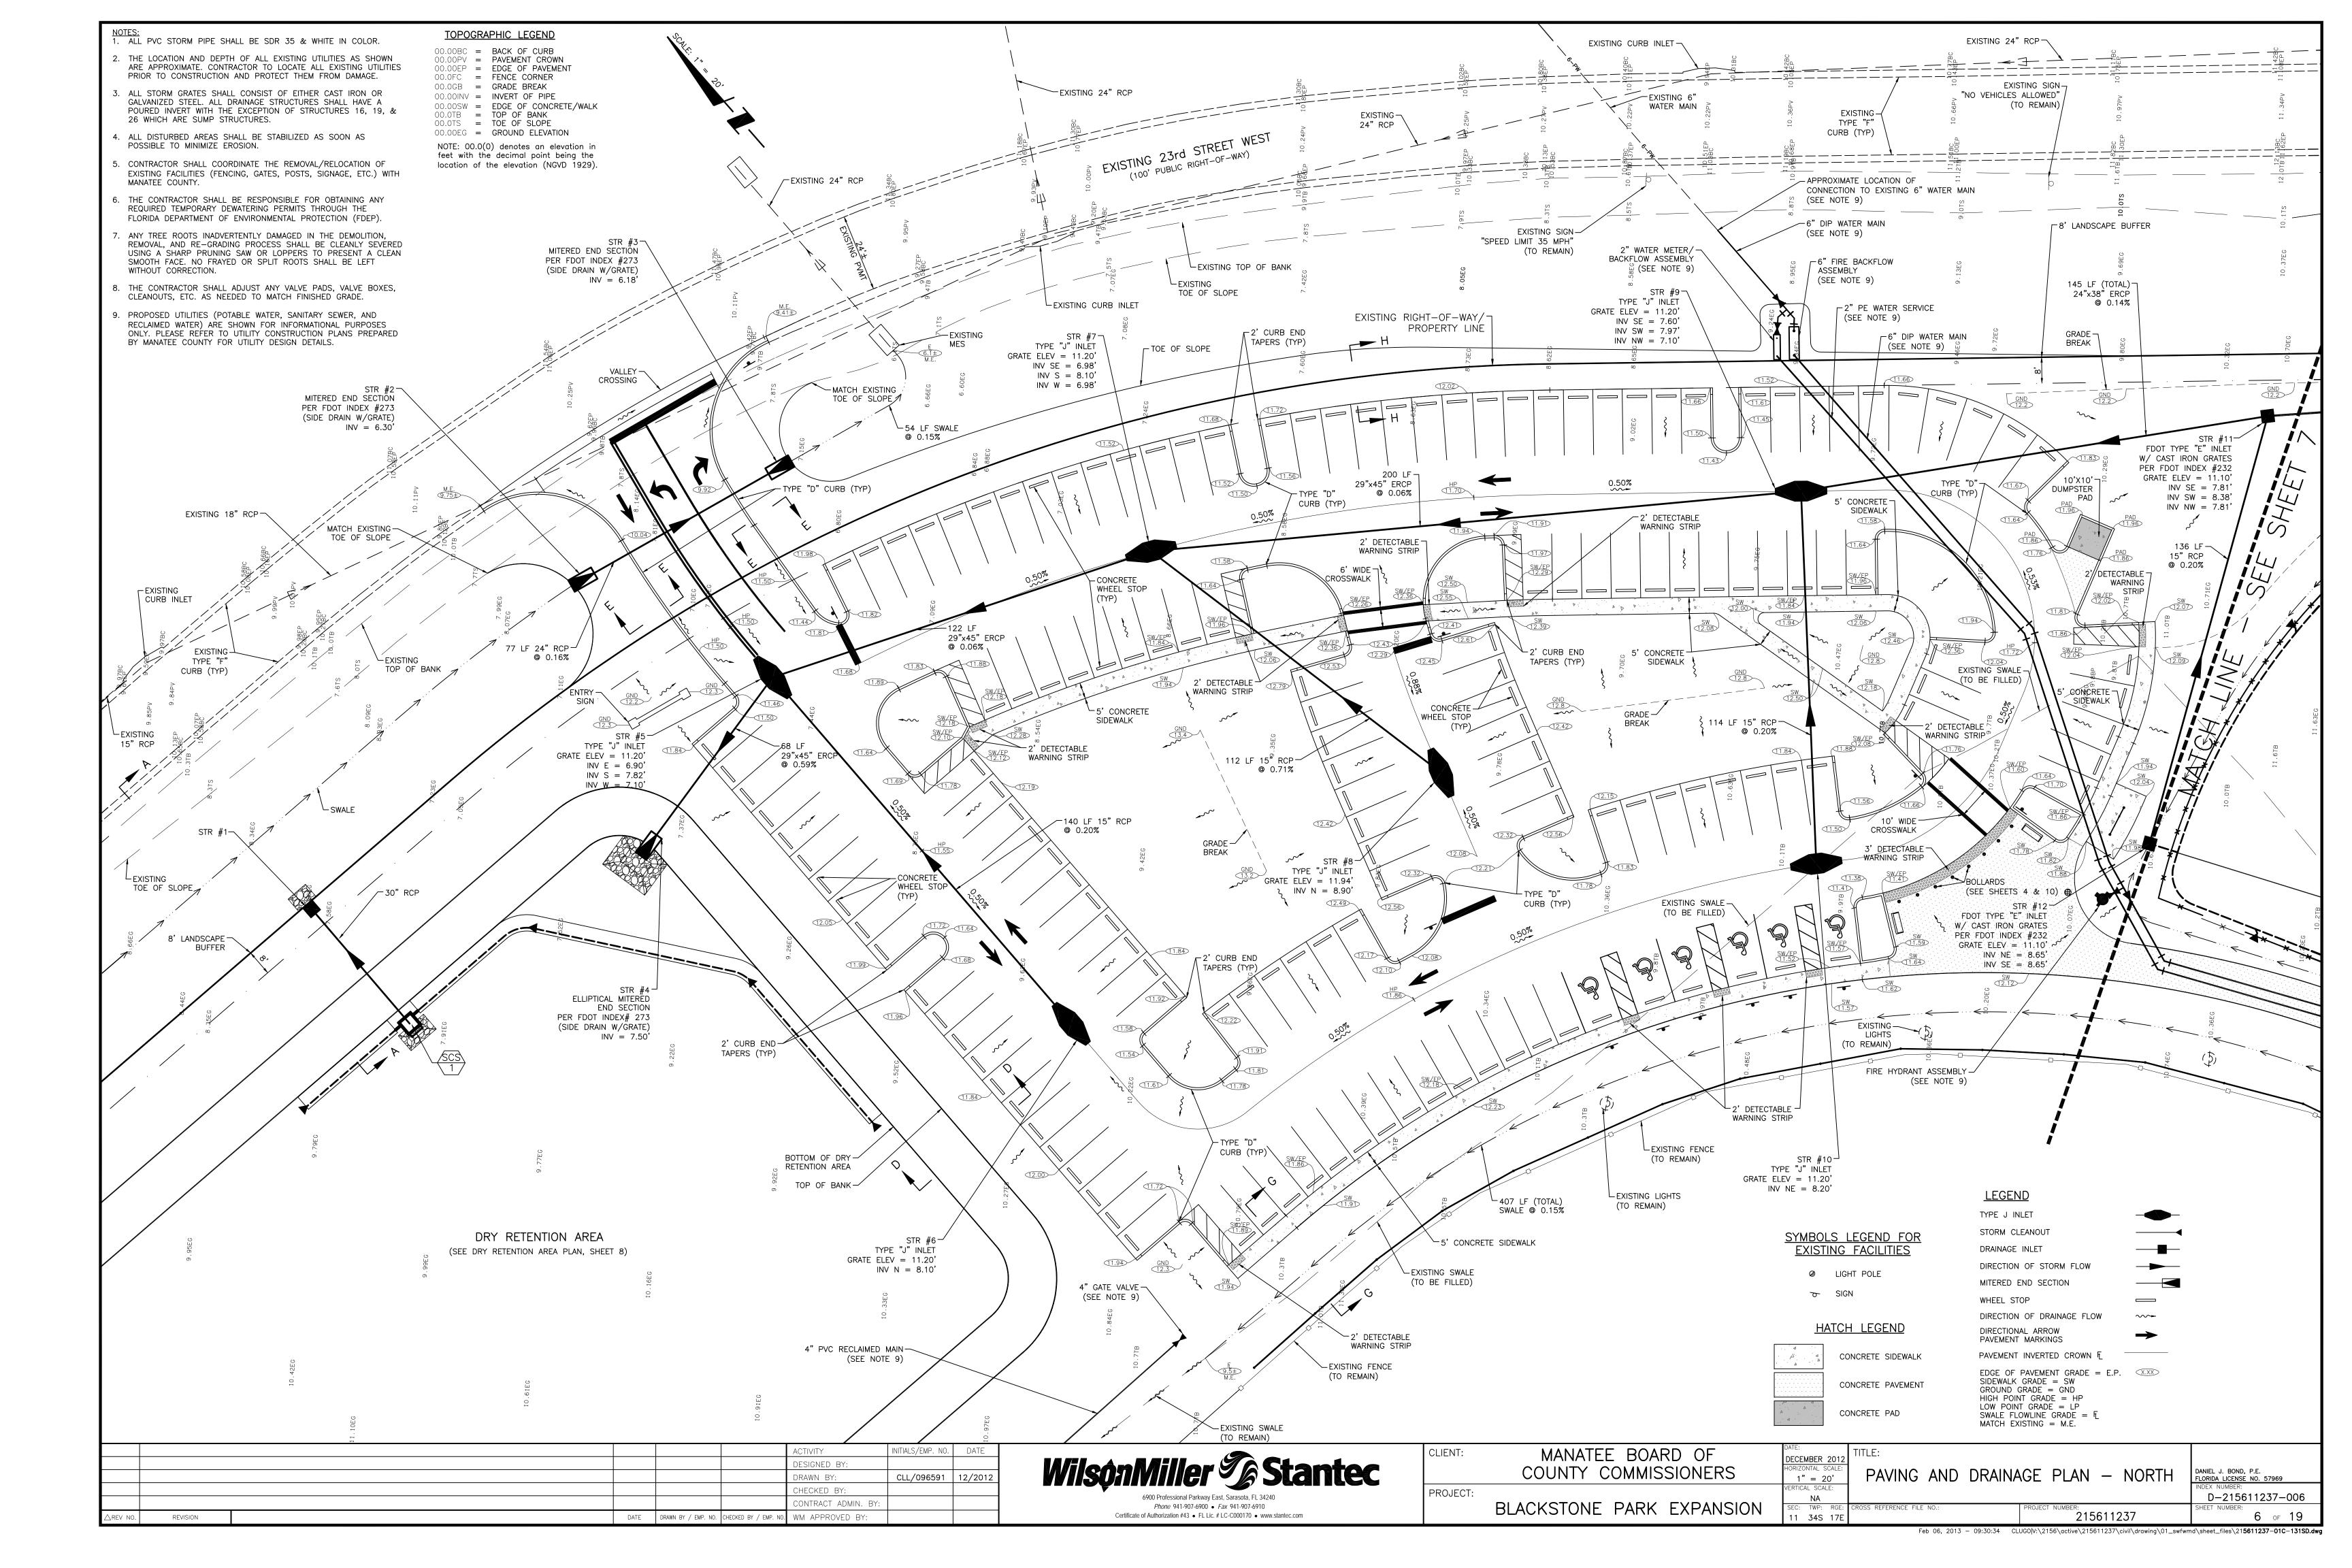


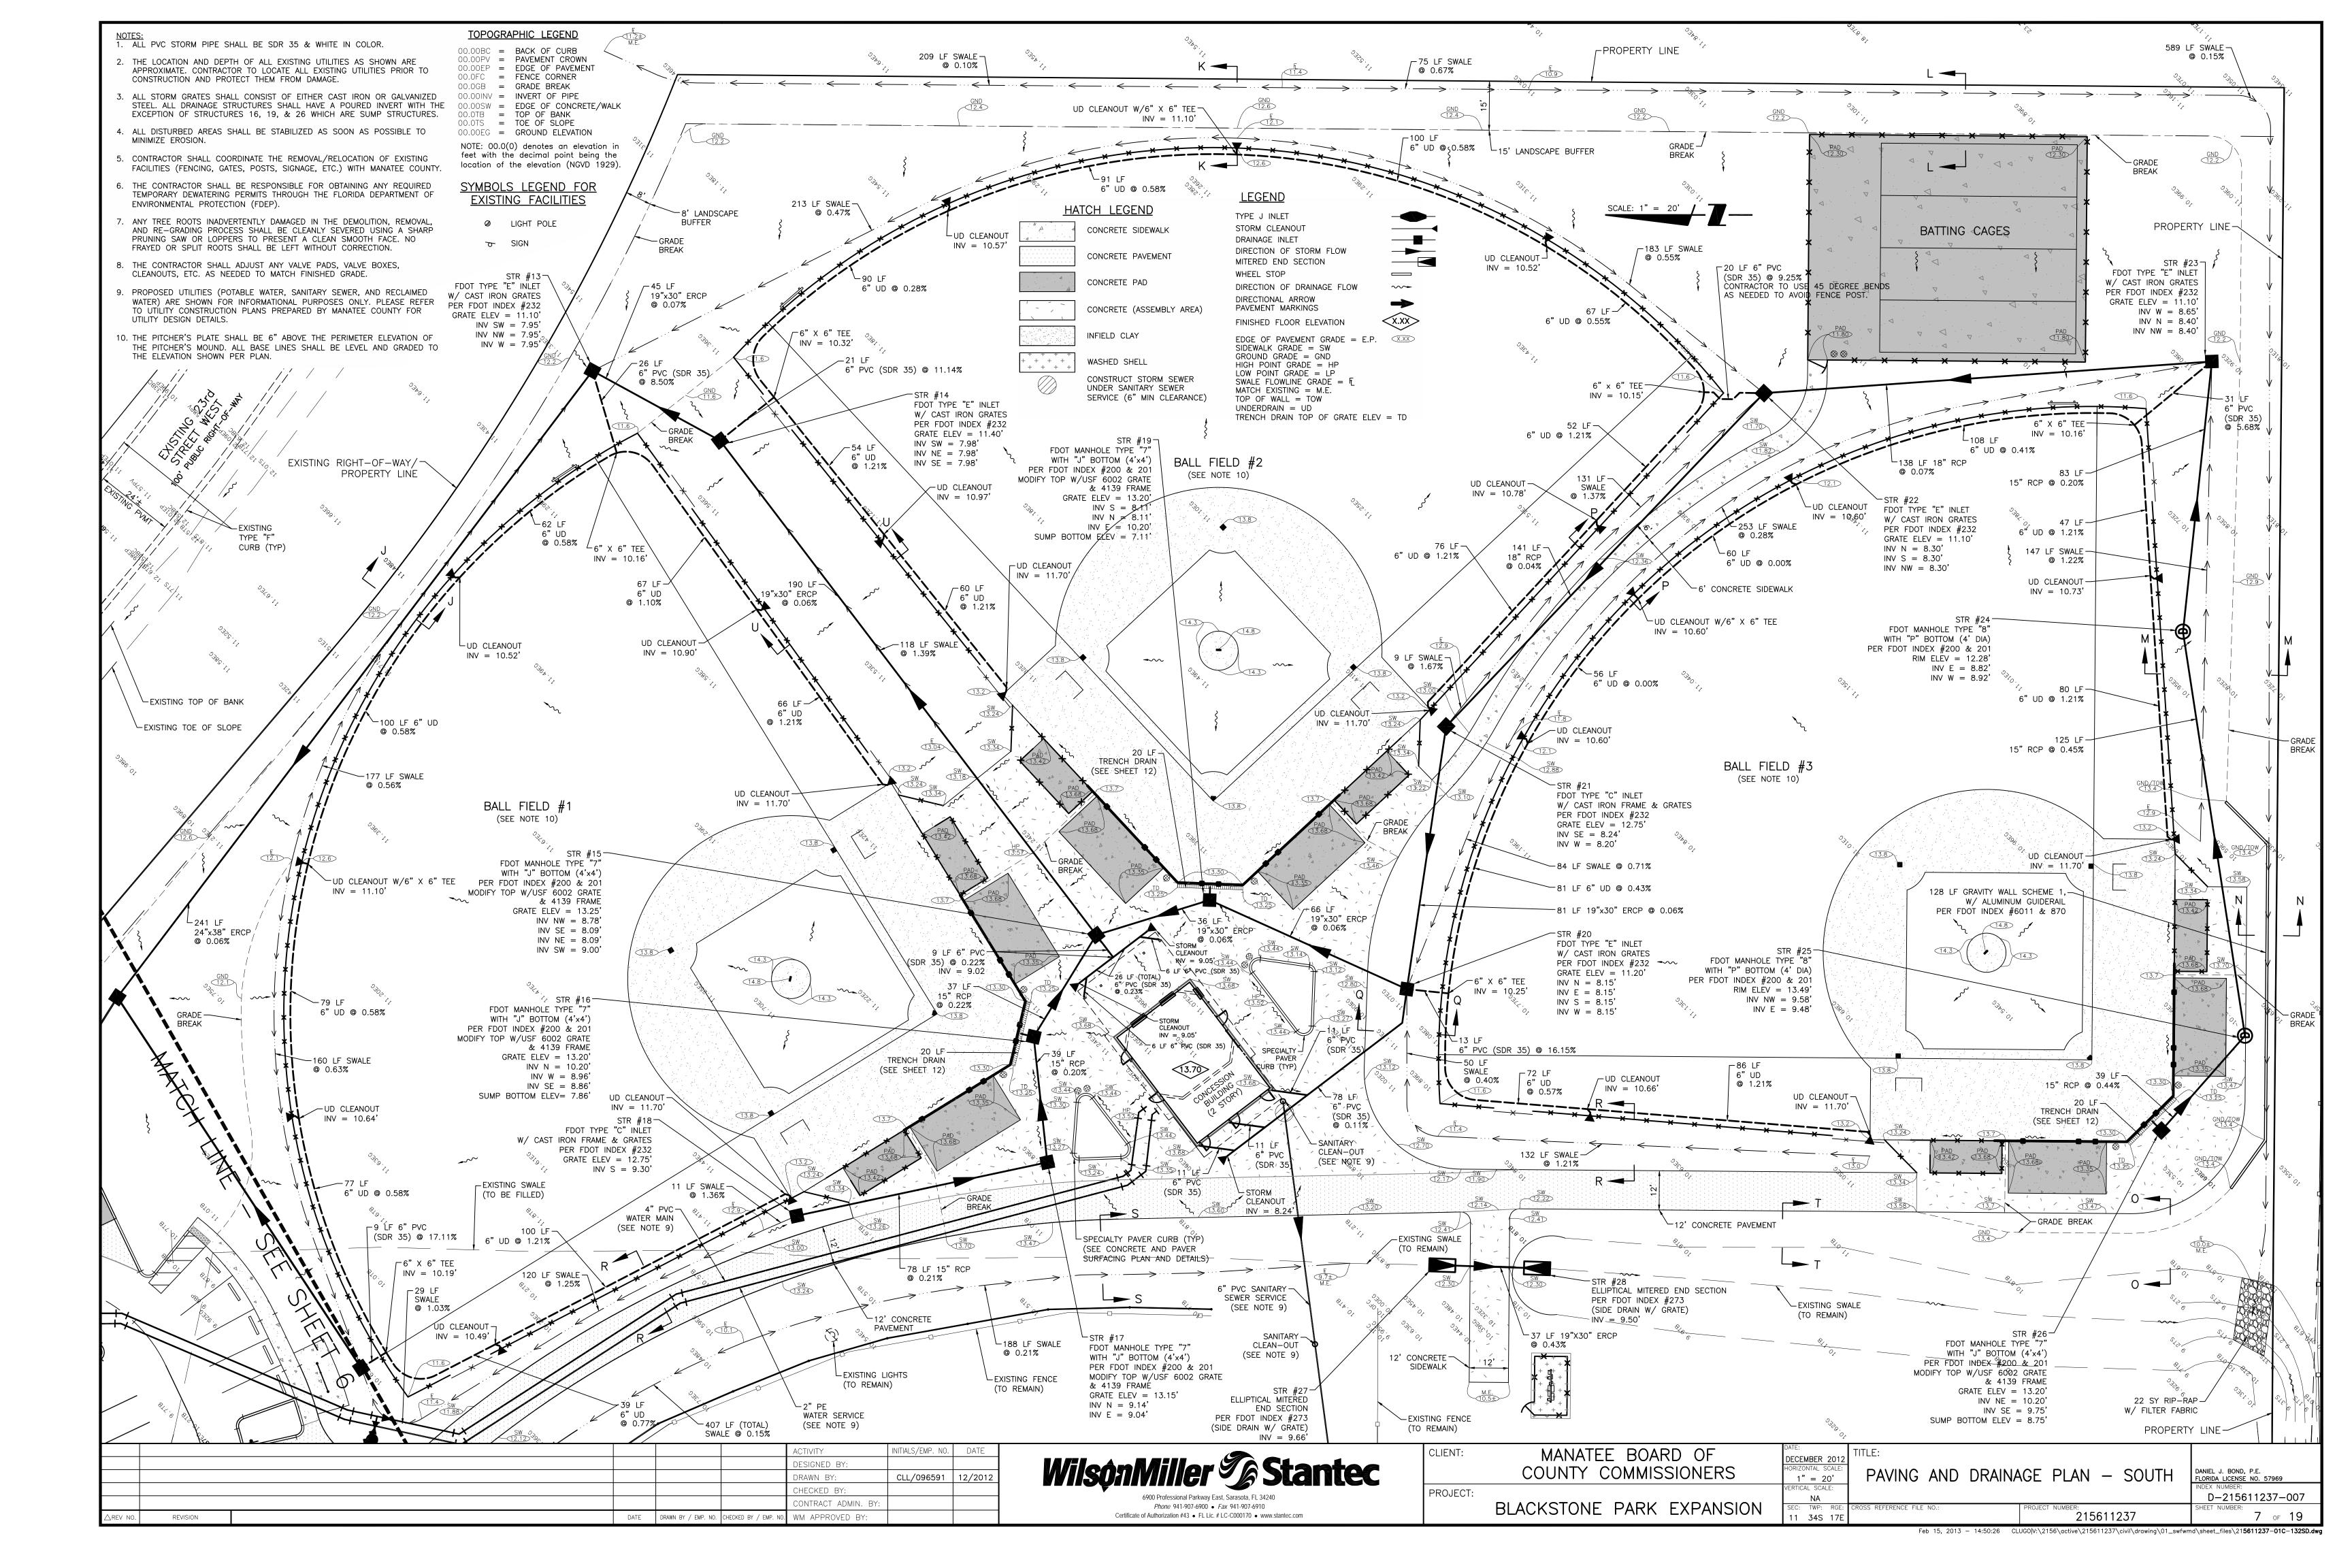


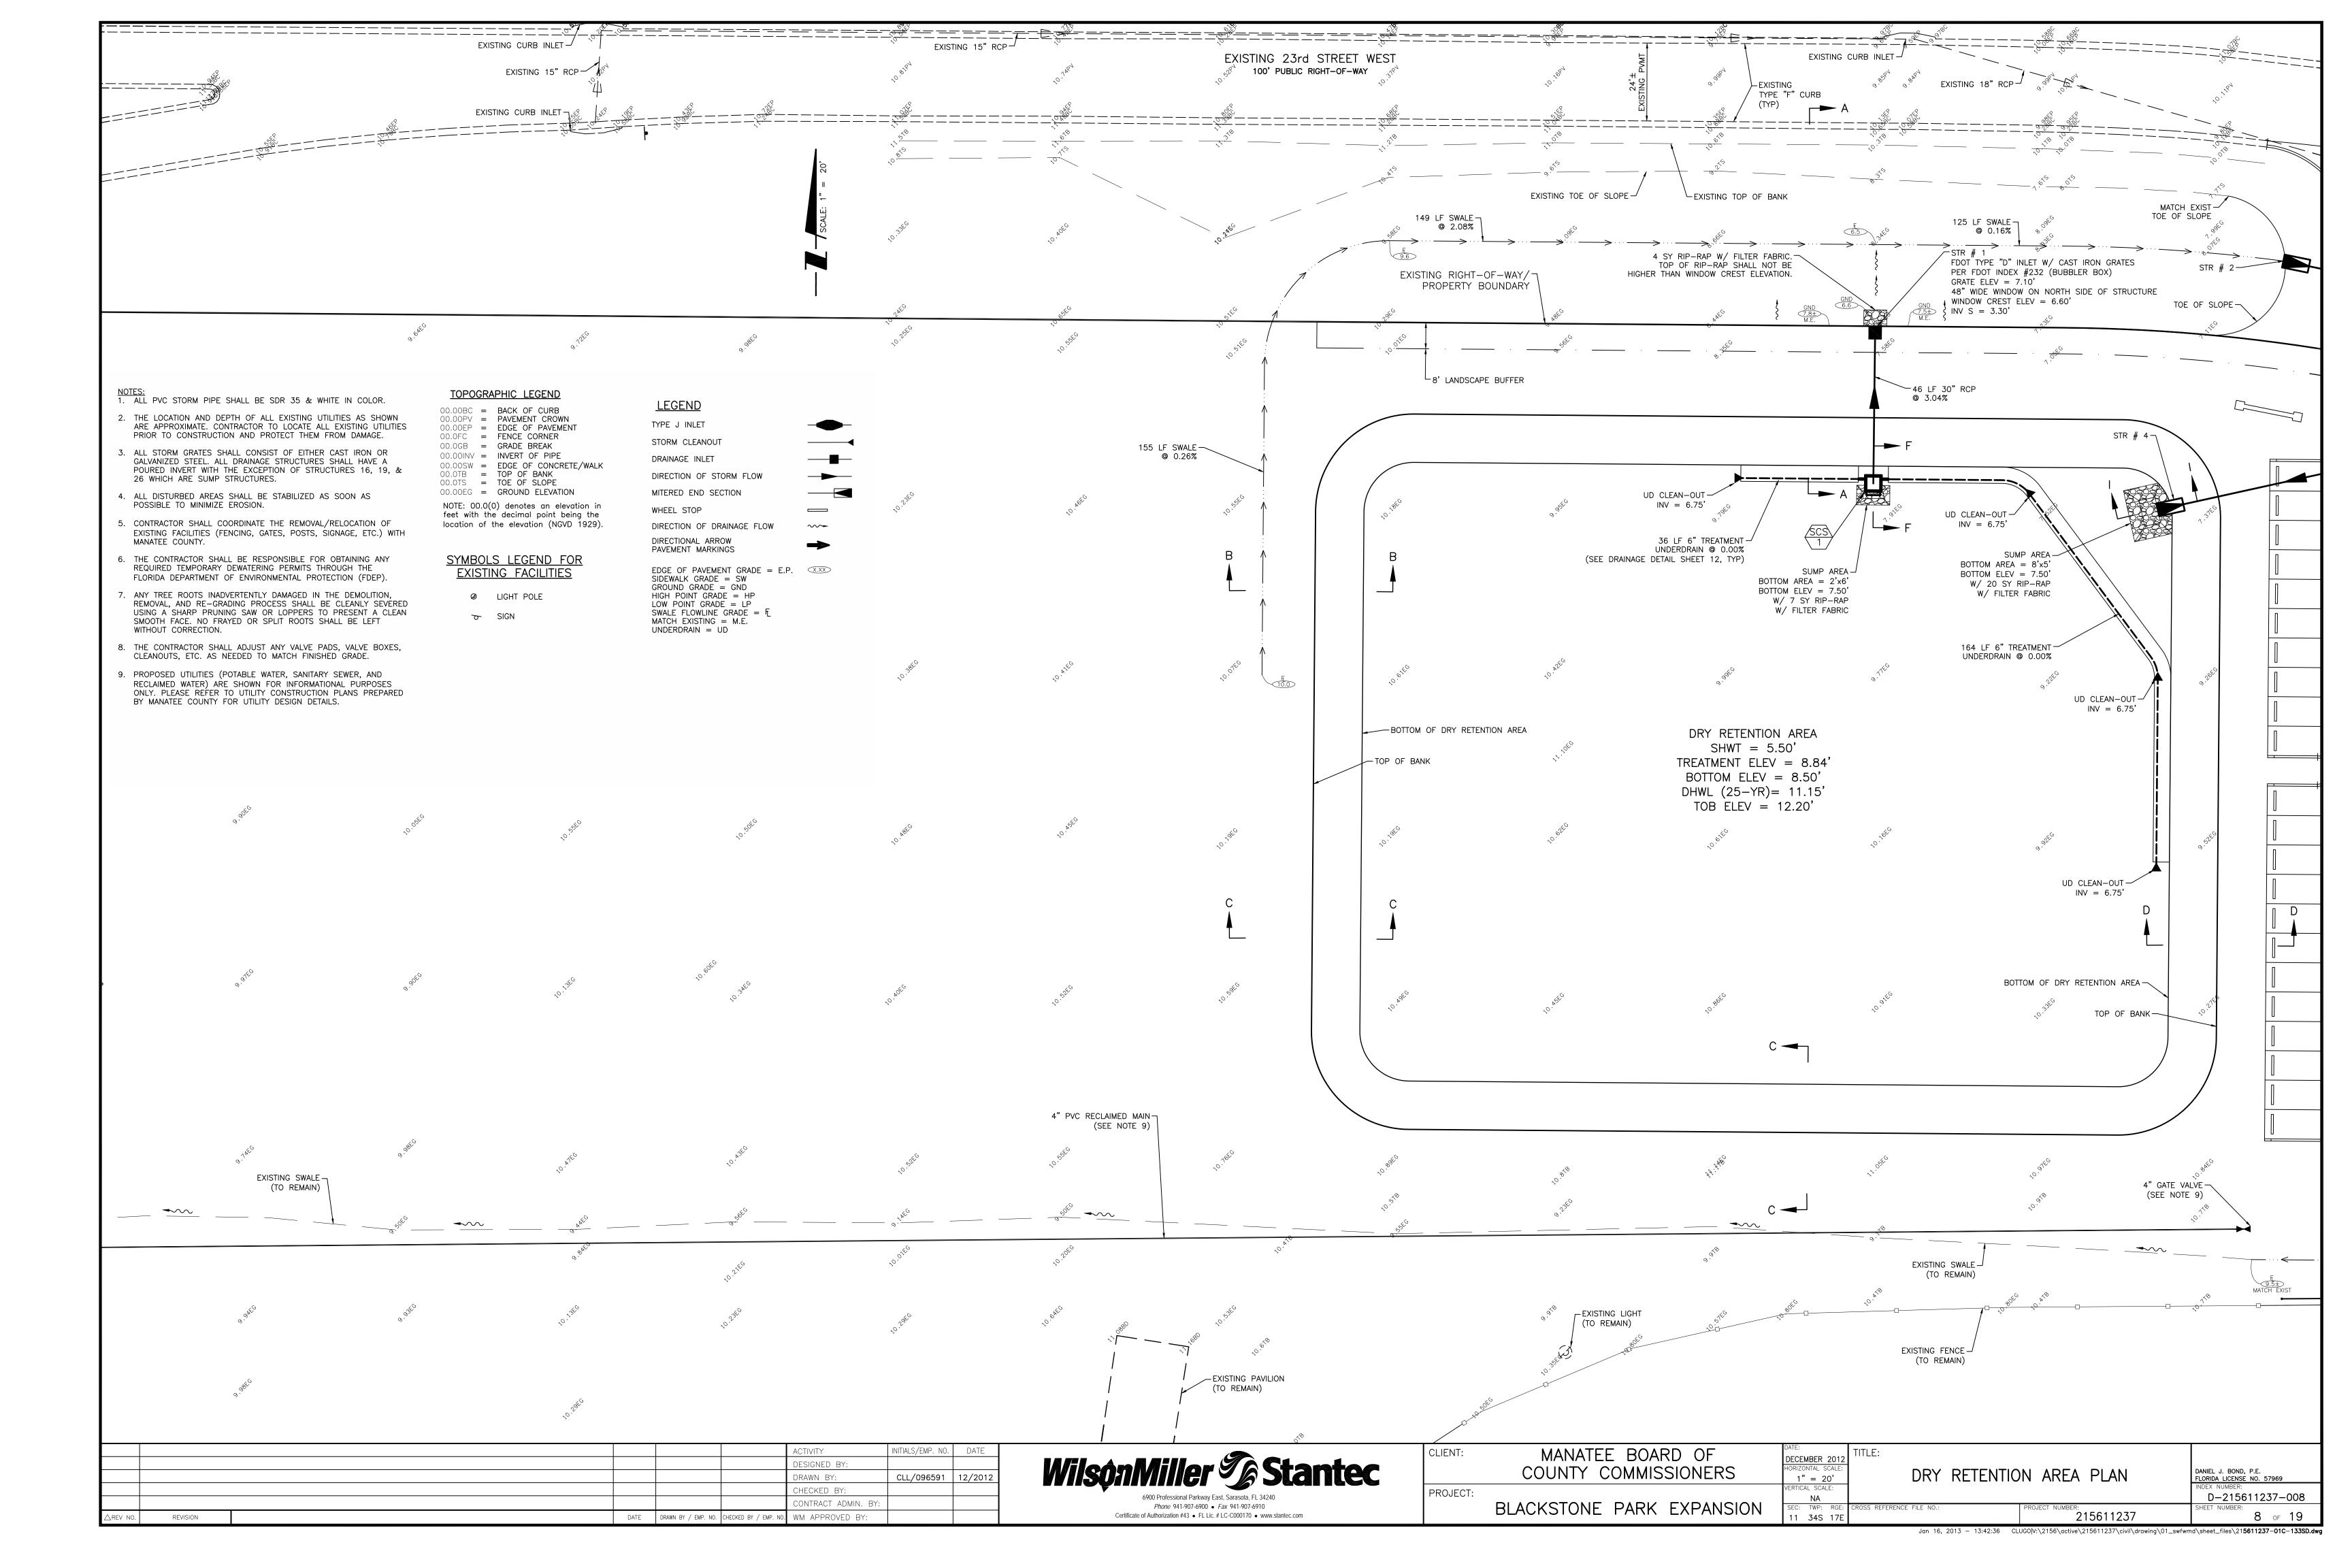



ENTRY SIGN PHOTO EXAMPLE ENTRY SIGN REFERENCE EXAMPLE LOCATED AT TOM BENNETT PARK ADDRESS: 400 CYPRESS CREEK BOULEVARD, BRADENTON, FL. 34208. SIGN BY LCM GROUP SERVICES, LLC.

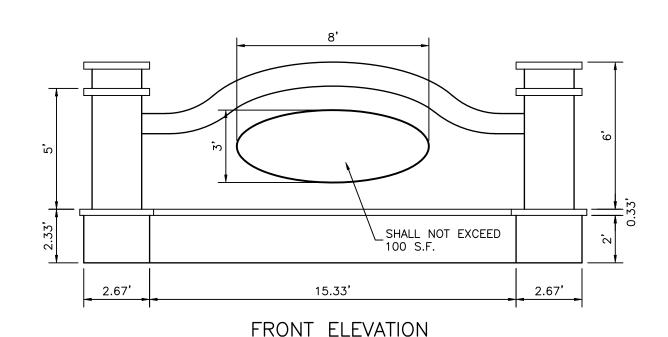


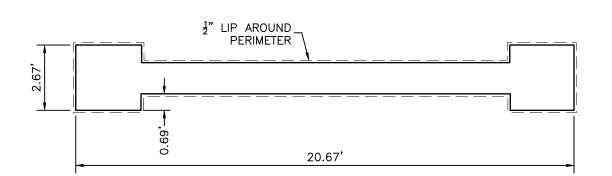

PLAN VIEW

- ENTRY SIGN DETAILS ARE SHOWN FOR INFORMATIONAL PURPOSES ONLY AND ARE PROVIDED FOR BASIS OF BID ONLY. CONTRACTOR SHALL PROVIDE FINAL DESIGN/SHOP DRAWINGS FOR ENTRY SIGN, INCLUDING SIGNED AND SEALED STRUCTURAL PLANS.
- 2. CONTRACTOR SHALL BE RESPONSIBLE FOR ALL PERMITTING RELATED TO THE ENTRY SIGN AS REQUIRED BY THE CITY OF PALMETTO, INCLUDING ANY APPLICABLE PERMIT FEES.
- 3. ENTRY SIGN FOR BLACKSTONE PARK SHALL MATCH ALL MATERIALS, FINISHES, COLORS, AND DIMENSIONS AS THE TOM BENNETT PARK SIGN. PARK NAME SHALL READ "BLACKSTONE PARK" INSTEAD OF "TOM BENNETT PARK"


# ENTRY SIGN SCHEMATIC DETAIL

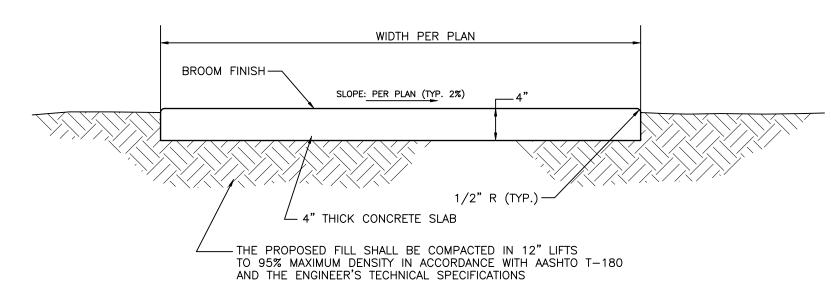


# SIDEWALK NOTES:

- 1. CONCRETE SHALL HAVE A COMPRESSIVE STRENGTH OF 3000 P.S.I. IN 28 DAYS UNLESS OTHERWISE NOTED.
- 2. SEE CONCRETE AND PAVER SURFACING PLAN FOR CONTROL JOINT AND EXPANSION JOINT LOCATIONS AND DETAILS. MINIMUM SAW CUT DEPTH SHALL BE 1.5".
- 3. ALL SIDEWALKS AND SIDEWALK CROSSINGS SHALL BE CONSTRUCTED IN ACCORDANCE WITH THE AMERICANS WITH DISABILITIES ACT (ADA).

# TYPICAL CONCRETE SIDEWALK DETAIL

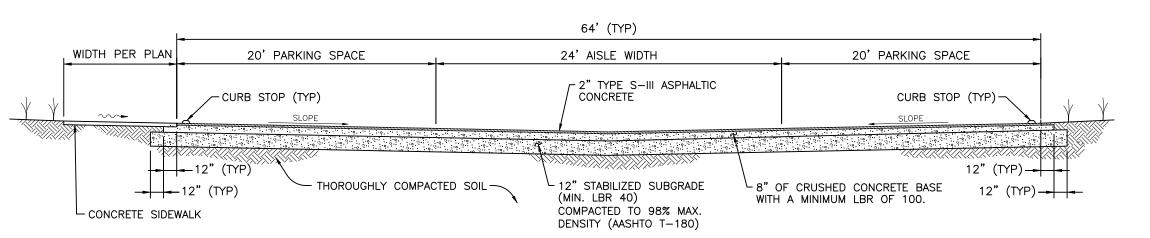

# TYPICAL FLEXIBLE PAVEMENT SECTION

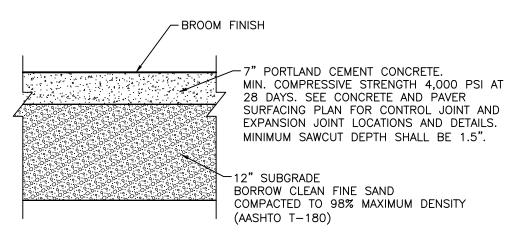

- 1. SUBGRADE SOILS SHOULD BE DENSIFIED TO AT LEAST 98% OF MODIFIED PROCTOR TEST MAXIMUM DRY DENSITY (ASTM D1557, AASHTO T-180) TO A DEPTH OF AT LEAST 1 FEET PRIOR TO PLACEMENT OF CONCRETE.
- 2. THE SURFACE OF THE SUBGRADE SOILS SHOULD BE SMOOTH, AND ANY DISTURBANCES OR WHEEL RUTTING CORRECTED PRIOR TO PLACEMENT OF CONCRETE. 3. THE SUBGRADE SOILS SHOULD BE MOISTENED PRIOR TO PLACEMENT OF CONCRETE. 4. CONCRETE PAVEMENT THICKNESS SHOULD BE UNIFORM THROUGHOUT.
- 5. SEE SITE PLAN FOR CONCRETE PAVEMENT LOCATIONS. 6. ALL CONCRETE AREAS SHALL NOT EXCEED 2% CROSS SLOPE IN ACCORDANCE WITH THE AMERICAN WITH DISABILITIES ACT (ADA).
- 7. ALL EDGES SHALL HAVE A 0.5" RADIUS. 8. THE RIGID PAVEMENT SHALL BE DOWELED IN ACCORDANCE WITH FDOT STANDARD INDEX #305.

CONCRETE

10' X 10' CONCRET

10'-0"

DUMPSTER

AS REQUIRED TO ENCLOSE 10'x10' DUMPSTER PAD

7/8"x6" TONGUE & GROOVE

OPAQUE PICKETS WITH-

LOCKING MECHANISM

1-1/2"x5-1/2"

POCKET RAIL (TYP)

FINISH GRADE WWW WW

INITIALS/EMP. NO. DATE


7/8"x6" TONGUE & GROOVE

OPAQUE PICKETS WITH

LOCKING MECHANISM


\PAVEMENT/

# PORTLAND CEMENT CONCRETE RIGID PAVEMENT SECTION

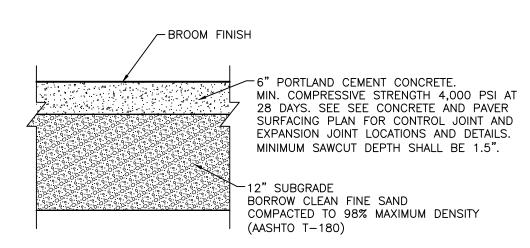


- 1. SUBGRADE SOILS SHOULD BE DENSIFIED TO AT LEAST 98% OF MODIFIED PROCTOR TEST MAXIMUM DRY DENSITY (ASTM D1557, AASHTO T-180) TO A DEPTH OF AT LEAST 1 FEET PRIOR TO PLACEMENT OF CONCRETE
- 2. THE SURFACE OF THE SUBGRADE SOILS SHOULD BE SMOOTH, AND ANY DISTURBANCES OR WHEEL RUTTING CORRECTED PRIOR TO PLACEMENT OF CONCRETE. . THE SUBGRADE SOILS SHOULD BE MOISTENED PRIOR TO PLACEMENT OF CONCRETE.
- . CONCRETE THICKNESS SHOULD BE UNIFORM THROUGHOUT.
- 5. SEE SITE PLAN FOR CONCRETE (ASSEMBLY AREA) LOCATIONS. 6. ALL CONCRETE AREAS SHALL NOT EXCEED 2% CROSS SLOPE IN ACCORDANCE WITH THE
- AMERICAN WITH DISABILITIES ACT (ADA). 7. ALL EDGES SHALL HAVE A 0.5" RADIUS.

# TYPICAL CONCRETE SECTION FOR ASSEMBLY AREAS

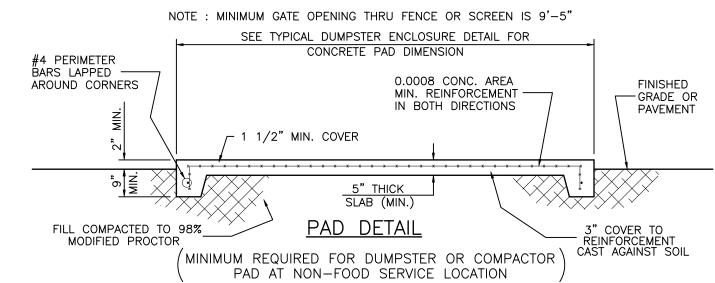

MIN. CONC. STRENGTH f'c= 3000 P.S.I. MIN. REINFORCEMENT STRENGTH fy= 60,000 P.S.I.

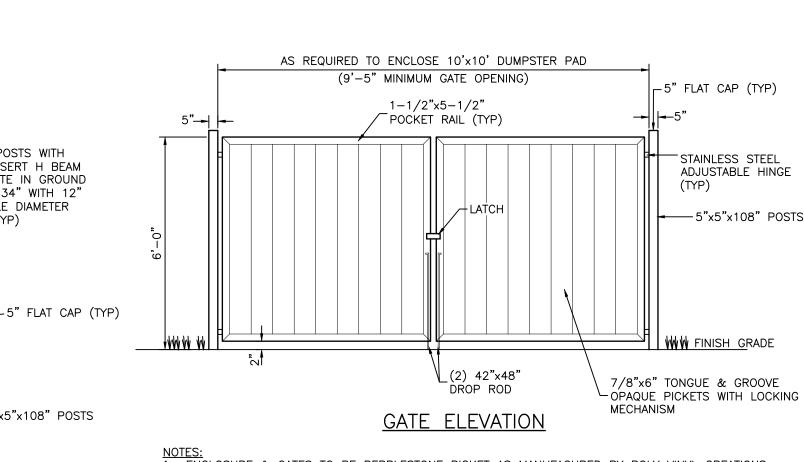

NOTES:

1. ENCLOSURE & GATES TO BE PEBBLESTONE PICKET AS MANUFACURED BY POLY VINYL CREATIONS (OR APPROVED EQUAL). FINAL COLOR TO BE APPROVED BY COUNTY.

- 2. CONTRACTOR TO SUBMIT TO THE COUNTY/ENGINEER SHOP DRAWINGS AND SIGNED & SEALED WINDLOAD CALCULATIONS MEETING BUILDING CODE REQUIREMENTS.
- 3. CONTRACTOR SHALL INCLUDE ANY BUILDING PERMITTING REQUIRED FOR DUMPSTER PAD, ENCLOSURE, & GATES IN THEIR BID PRICE.
- 4. ALL GATE POSTS TO BE 5"x5"x108" WITH ALUMINUM INSERT H BEAM AND CONCRETE IN GROUND MINIMUM OF 34" WITH 12" DIAMETER HOLE. CONCRETE TO BE FILLED UP TO FINISHED GRADE.
- FLUSH W/GRADE FOR DROP FOR HARDWARE: PADLOCKABLE DROP ROD, LOCK LATCH DELUXE WITH 6 PIN KEY SYSTEM AND STAINLESS STEEL ADJUSTABLE HINGES.

# TYPICAL DUMPSTER ENCLOSURE DETAIL

(2) GAL. STEEL SLEEVES

ROD ANCHORING (TYP)

## ESIGNED BY: CLL/096591 12/201: RAWN BY: HECKED BY: ONTRACT ADMIN. BY DATE DRAWN BY / EMP. NO. CHECKED BY / EMP. NO. WM APPROVED BY REVISION

GAL. STEEL SLEEVES

FLUSH W/GRADE FOR DROP ROD ANCHORING (TYP)

5"x5"x108" POSTS WITH

ALUMINUM INSERT H BEAM

AND CONCRETE IN GROUND MINIMUM OF 34" WITH 12"

— 5"x5"x108" POSTS

-42"-48"

DROP ROD

/—1/2" EX. JT.

CONCRETE

PAVFMFNT

MINIMUM HOLE DIAMETER

FOR POST (TYP)

OPAQUE VINYL GATE

CLIENT: COUNTY COMMISSIONERS AS SHOWN

**GENERAL SITE CONSTRUCTION NOTES:** 

PRIOR APPROVAL BY THE ENGINEER.

TO ALLOW FOR SOD THICKNESS.

REQUIRED TO REMOVE SAID TREE(S).

1. THERE SHALL BE NO CHANGE OR DEVIATION FROM THESE PLANS WITHOUT

2. ALL CLEARING AND GRUBBING DEBRIS TO BE BURNED OR REMOVED FROM

FINISH EARTHWORK GRADING SHALL BE 0.2 FEET BELOW ELEVATIONS SHOWN

4. SODDING INCLUDES MAINTAINING SLOPES AND SOD UNTIL COMPLETION AND

COMES LAST. UNTIL THEN, ALL EROSION, SILTATION, AND MAINTENANCE OF GRADES AND GRASS IS THE RESPONSIBILITY OF THE CONTRACTOR.

5. CERTAIN TREES ARE DESIGNATED BY THE OWNER TO BE SAVED AND

ACCEPTANCE OF TOTAL PROJECT OR GROWTH IS ESTABLISHED, WHICHEVER

PROTECTED BY THE CONTRACTOR. IT IS ASSUMED THESE TREES ARE HEALTHY AND ARE EXPECTED TO BE PART OF THE LANDSCAPE DEVELOPMENT. THEREFORE, IF ANY TREE(S) ARE DAMAGED BY CONSTRUCTION OPERATIONS OR BY OTHER MEANS (EXCLUDING LIGHTNING, WINDSTORM AND OTHER ACTS

OF GOD) AND PERISHES WITHIN THE CONSTRUCTION PERIOD, IT SHALL BE THE

RESPONSIBILITY OF THE CONTRACTOR TO REMOVE AND DISPOSE OF THOSE TREES. CITY OF PALMETTO APPROVAL IS REQUIRED PRIOR TO REMOVAL OF ANY TREES DESIGNATED TO REMAIN. NO ADDITIONAL COMPENSATION SHALL BF MADE BY THE OWNER FOR THE LABOR, MATERIAL, OR MACHINERY

6. WHERE EXCAVATIONS ARE IN CLOSE PROXIMITY OF TREES, THE CONTRACTOR

WITHIN THE DRIP LINE OF TREES TO REMAIN AND BE PRESERVED. IT SHALL BE THE RESPONSIBILITY OF THE CONTRACTOR TO INFORM ALL OF HIS EMPLOYEES

8. NOTIFY "SUNSHINE STATE ONE CALL (1-800-432-4770), MANATEE COUNTY PUBLIC WORKS

DEPARTMENT, CITY OF PALMETTO PUBLIC WORKS DEPARTMENT, FLORIDA POWER & LIGHT, VERIZON AND ANY OTHER UTILITIES (GAS COMPANIES, CABLE TV, ETC.) PRIOR TO

SHALL USE EXTREME CARE IN NOT DAMAGING THE ROOT SYSTEM. NO

AND SUBCONTRACTORS OF THIS REQUIREMENT AND TO ENFORCE SAME.

7. LAY SOD AROUND ALL INLETS, MITERED ENDWALLS, HEADWALLS, SWALES, LAKE SLOPES, ADJACENT TO EDGE OF PAVEMENT AND ADJACENT TO BACK OF CURB

CONSTRUCTION AND PRIOR TO ANY CONNECTION TO EXISTING UTILITIES. IT IS

9. ALL UTILITY LINES, STORM DRAIN LINES AND ACCESSORIES SUCH AS, BUT NOT

LIMITED TO, MANHOLES, CLEANOUTS, SEWER AND WATER SERVICES, VALVES,

LOCATIONS SHOWN ON PLANS UNLESS OTHERWISE DIRECTED BY THE ENGINEER.

10. CLEARING, GRUBBING, STRIPPING, AND COMPACTION SHALL BE INSPECTED BY THE

FIRE HYDRANTS AND INLETS SHALL BE CONSTRUCTED TO ALIGNMENT AND

ENGINEER OR HIS DULY APPOINTED REPRESENTATIVE PRIOR TO FILLING.

SILT BARRIERS SHALL BE CONSTRUCTED IN

WETLAND/BUFFER.

PERMIT FOR THE PROJECT ON SITE.

HAVE ALL JOINTS WRAPPED.

CITY OF PALMETTO.

600 INDICES.

23. LANDSCAPE SOIL

COLLECT WATER.

11. PRIOR TO THE START OF CONSTRUCTION ACTIVITIES, PRESERVE AREAS WITHIN

AND ADJOINING THE AREA OF CONSTRUCTION ACTIVITY SHALL BE PROTECTED BY ERECTION OF TREE PROTECTION BARRICADES AND/OR SILT BARRIERS.

ACCORDANCE WITH THE BEST MANAGEMENT PRACTICES DETAIL DRAWING. THE

THE APPROVAL OF SWFWMD & THE CITY OF PALMETTO. THE CONTRACTOR SHALL NOTIFY THE ENGINEER & THE CITY OF PALMETTO WHEN PRESERVE AREA BARRICADES AND BARRIERS ARE IN PLACE. THE CONTRACTOR IS RESPONSIBLE TO

OBTAIN ANY REQUIRED TREE REMOVAL PERMIT FROM THE CITY OF PALMETTO.

SWALE SHALL BE STAKED PRIOR TO ANY CONSTRUCTION WITHIN THE LAKES OR WETLAND/BUFFERS. APPROVAL FROM THE ENGINEER, AND THE OWNER IS REQUIRED

BEFORE EQUIPMENT CAN BE USED WITHIN THE LAKE OR WETLAND/BUFFER. THE

12. ALL LIMITS OF CONSTRUCTION FOR THE OUTFALL PIPE/STRUCTURE/SPREADER

ENGINEER SHALL BE ON SITE DURING CONSTRUCTION WITHIN THE LAKE OR

13. LOCATION OF ALL STORM STRUCTURES (WEIR, MITERED END, CONTROL STRUCTURE,

ENGINEER OR HIS REPRESENTATIVE AFTER SURVEY STAKE OUT AND PRIOR TO

GRATE INLET, ETC.) ADJACENT TO A WETLAND SHALL BE APPROVED BY THE

14. FILLING, EXCAVATING OR REMOVAL OF NATIVE VEGETATION SHALL BE PROHIBITED IN THE PRESERVATION AREA, UNLESS APPROVED BY THE CITY OF PALMETTO.

16. ALL CONCRETE PIPE SHALL HAVE A FILTER FABRIC JACKET MINIMUM 12" EACH

AREAS TO CONTROL BOTH SIGNIFICANT WIND EROSION AND FUGITIVE DUST.

THE COST OF VALVE RELOCATION IS THE CONTRACTOR'S RESPONSIBILITY.

SHEET SHALL ALSO APPLY TO FORCE MAIN, IRRIGATION & WATER MAINS.

ALSO APPLY TO FORCE MAIN. IRRIGATION & WATER MAINS.

TOP OF SURROUNDING PAVEMENT EDGES.

MAXIMUM OF 6.0%.

• PH SHALL BE 5.5-7.0

AREAS OF PROPOSED LANDSCAPING AS FOLLOWS:

SIDE OF JOINT WITH MINIMUM 24" OVERLAP AT SEAM PER FDOT INDEX #280 & #199

17. CONTRACTOR SHALL SPRINKLE OR OTHERWISE APPLY WATER TO AFFECTED CONSTRUCTION

18. CONTRACTOR SHALL CONSTRUCT ALL VALVES SO THAT NO VALVE BOXES ARE LOCATED IN

19. THRUST BLOCKS AND JOINT RESTRAINTS DETAILS ON THE WATER DISTRIBUTION DETAILS

20. TRENCH DETAILS ON THE WASTEWATER COLLECTION CONSTRUCTION DETAILS SHEET SHALL

REQUIREMENTS OF THE SWFWMD ERP INFORMATION MANUAL, LATEST EDITION AND THE

22. CONTRACTOR SHALL PROVIDE TRAFFIC CONTROL DURING CONSTRUCTION IN ACCORDANCE

DEVICES MILLENNIUM EDITION AND THE FLORIDA DEPARTMENT OF TRANSPORTATION DESIGN STANDARDS, 2006, TRAFFIC CONTROL THROUGH WORK ZONES, SERIES

BE FREE OF STONES, LUMPS, ROOTS, STICKS AND OTHER EXTRANEOUS MATTER.

WITH THE FEDERAL HIGHWAY ADMINISTRATION MANUAL OF UNIFORM TRAFFIC CONTROL

LANDSCAPE SOIL SHALL BE NATURAL, FERTILE, AGRICULTURAL SOIL CAPABLE OF SUSTAINING

UNLESS OTHERWISE NOTED, SMOOTH ALL PREPARED LANDSCAPE SOIL TO 3 INCHES BELOW

FINISH GRADE ALL LANDSCAPE SOIL AREAS TO A SMOOTH, EVEN SURFACE ASSURING POSITIVE DRAINAGE AWAY FROM ALL STRUCTURES AND ANY ELIMINATE ANY LOW AREAS WHICH MAY

SOIL SHALL MEET THE CLASSIFICATION OF COARSE LOAMY SAND TO A DEPTH OF 36" IN ALL

• SAND CONTENT AFTER MIXING SHALL BE A MINIMUM OF 85% SAND HAVING A PARTICLE SIZE OF 0.05-2.00 MM (A MINIMUM OF 25% OF WHICH SHALL BE CLASSIFIED AS

COARSE SAND HAVING A PARTICLE SIZE OF 0.5-1.0 MM AND A MAXIMUM OF 50% OF

ANY OTHER SAND GRADE), 4.0-5.0% SILT HAVING A PARTICLE SIZE OF 0.002-0.05

• ORGANIC MATTER CONTENT OF THE SOIL LAYER SHALL BE A MINIMUM OF 3.0% AND

THE CONTRACTOR SHALL TEST THE PROPOSED SOIL MIXTURE PRIOR TO PLACEMENT OF FILL

UPON COMPLETION OF SITE GRADING, THE CONTRACTOR SHALL SUBMIT LABORATORY TESTS

FROM A MINIMUM OF 8 LOCATIONS AS DETERMINED BY THE ENGINEER/LANDSCAPE ARCHITECT.

TO ENSURE THAT THE ABOVE REFERENCED LANDSCAPE SOIL SPECIFICATIONS ARE MET.

CONTRACTOR IS RESPONSIBLE FOR ALL COSTS ASSOCIATED WITH TESTING.

VIGOROUS PLANT GROWTH. IT SHALL BE OF UNIFORM COMPOSITION THROUGHOUT. IT SHALL

21. THE CONTRACTOR SHALL PROVIDE RECORD DRAWINGS THAT MEET OR EXCEED THE

HANDICAP RAMPS AND/OR CURBING. IF VALVES ARE FOUND TO BE IN THESE LOCATIONS,

& ALL APPLICABLE CITY REQUIREMENTS. IN ADDITION, ALL ELLIPTICAL PÏPE SHALL

15. THE CONTRACTOR SHALL ADHERE TO AND HAVE A COPY OF THE SWFWMD

ENGINEER SHALL DETERMINE THE EXTENT AND TYPE OF PROTECTIVE MEASURES TO BE CONSTRUCTED FOR THE PROTECTION OF PRESERVE AREAS SUBJECT TO

THE CONTRACTORS RESPONSIBILITY TO PROTECT EXISTING UTILITIES FROM DAMAGE.

EQUIPMENT, SUPPLIES, OR VEHICLES SHALL BE STORED OR PARKED

AS SHOWN IN DETAILS OR AS DIRECTED BY THE ENGINEER.

TO BE OBTAINED BY THE CONTRACTOR IF BURNING IS TO OCCUR. 3. ALL PROPOSED GROUND ELEVATIONS ARE FINISHED SOD ELEVATIONS.

SITE AND IS PART OF CLEARING AND GRUBBING ITEM. A BURN PERMIT IS REQUIRED

DANIEL J. BOND, P.E. FLORIDA LICENSE NO. 57969 D-215611237-009


MANATEE BOARD OF ECEMBER 2

TYPICAL SECTIONS AND AS SHOWN CONSTRUCTION DETAILS RTICAL SCALE

34S 17E

215611237 9 of 19 Jan 18, 2013 — 09:55:18 CLUGO|V:\2156\active\215611237\civil\drawing\01\_swfwmd\sheet\_files\215611237—01C—300SC.dw


PROJECT: BLACKSTONE PARK EXPANSION Phone 941-907-6900 • Fax 941-907-6910 Certificate of Authorization #43 • FL Lic. # LC-C000170 • www.stantec.com

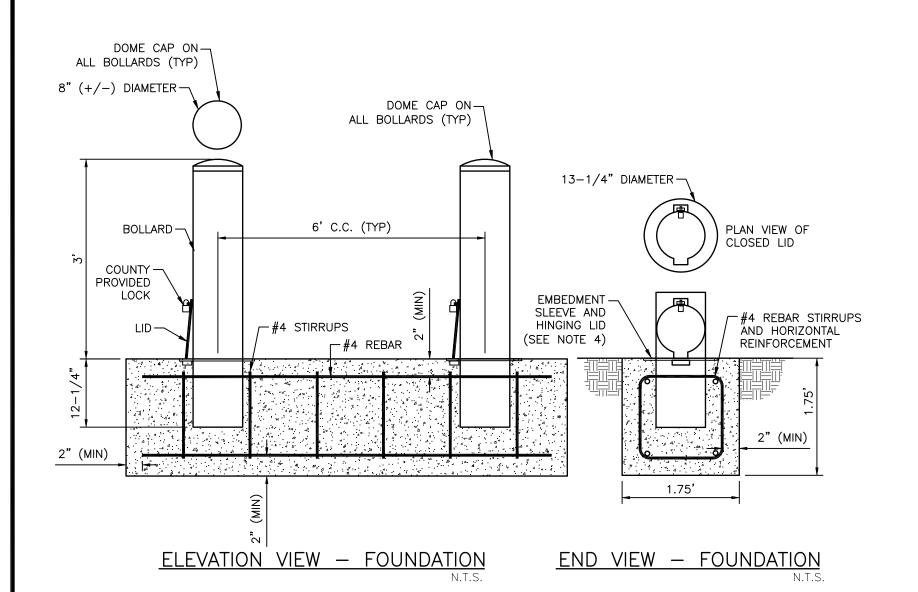

# NOTES

- 1. BOLLARDS TO BE 8" CARBON STEEL (SCH 80) SECURITY BOLLARDS AS MANUFACTURED BY CAL PIPE SECURITY BOLLARDS (IBP08080) OR APPROVED ALTERNATE. ALL BOLLARD TOPS SHALL HAVE A DOME CAP STYLE AND SHALL HAVE A BLACK POWDERCOAT FINISH. THE CONTRACTOR SHALL PROVIDE A COLOR SAMPLE (WITH THE SHOP DRAWINGS) TO THE ENGINEER AND COUNTY FOR REVIEW/APPROVAL PRIOR TO FABRICATION.
- ALL BOLLARDS AND FOOTINGS SHALL BE INSTALLED/CONSTRUCTED PER MANUFACTURER'S SPECIFICATIONS. LOCKS FOR REMOVABLE BOLLARDS TO BE PROVIDED BY THE COUNTY.
- 3. ALL HINGING LIDS FOR THE REMOVABLE BOLLARDS SHALL BE POSITIONED TO OPEN DIRECTLY AWAY FROM THE PARKING LOT DRIVE AISLE.
- 4. EMBEDMENT SLEEVE AND HINGING LID TO BE PROVIDED FOR REMOVABLE BOLLARDS ONLY. PLEASE SEE SHEET 4 FOR THE SPECIFIC LOCATIONS OF THE REMOVABLE BOLLARDS AND FIXED BOLLARDS.

# BOLLARD DETAIL

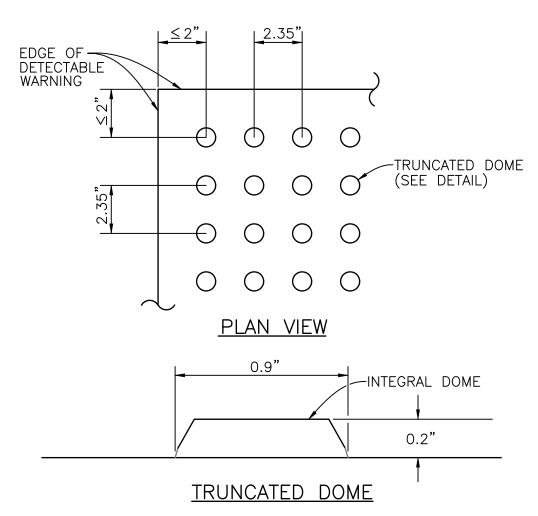

CURB RAMP DETECTABLE WARNING DETAIL

# NOTES: DETECTABLE WARNINGS ON WALKING SURFACES

ALL DETECTABLE WARNINGS SURFACES/TRUNCATED DOMES SHALL BE VANGUARD ADA SYSTEMS (QPL S527-0015) OR APPROVED ALTERNATE. THE ENTIRE DETECTABLE WARNING SURFACE SHALL BE SEAMLESS AND BLACK IN COLOR.

THE DETECTABLE WARNING SHALL EXTEND THE FULL WIDTH AND DEPTH OF THE CURB RAMP.

DETECTABLE WARNINGS SHALL CONSIST OF RAISED TRUNCATED DOMES WITH A DIAMETER OF NOMINAL 0.9 INCH, A HEIGHT OF NOMINAL 0.2 INCH AND A CENTER-TO-CENTER SPACING OF NOMINAL 2.35 INCH AND SHALL CONTRAST VISUALLY WITH ADJOINING SURFACES, EITHER LIGHT-ON-DARK, OR DARK-ON-LIGHT.

THE MATERIAL USED TO PROVIDE CONTRAST SHALL BE AN INTEGRAL PART OF THE WALKING SURFACE. DETECTABLE WARNINGS USED ON INTERIOR SURFACES SHALL DIFFER FROM ADJOINING WALKING SURFACES IN RESILIENCY OR SOUND—ON—CANE CONTACT.


THE MATERIAL USED TO PROVIDE CONTRAST SHOULD CONTRAST BY AT LEAST 70%. CONTRAST IN PERCENT IS DETERMINED BY:  $CONTRAST = [(B1-B2)/B1] \times 100$ 


WHERE B1 = LIGHT REFLECTANCE VALUE (LRV) OF THE LIGHTER AREA AND B2 = LIGHT

REFLECTANCE VALUE (LRV) OF THE DARKER AREA.


NOTE THAT IN ANY APPLICATION BOTH WHITE AND BLACK ARE NEVER ABSOLUTE; THUS, B1 NEVER EQUALS 100 AND B2 IS ALWAYS GREATER THAN 0.


EVERY EQUILES 100 MAD BZ 10 MEMMIO ONEMEN TIMES OF

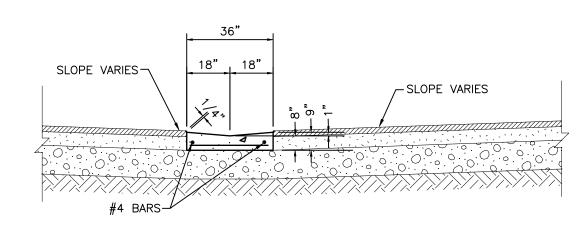


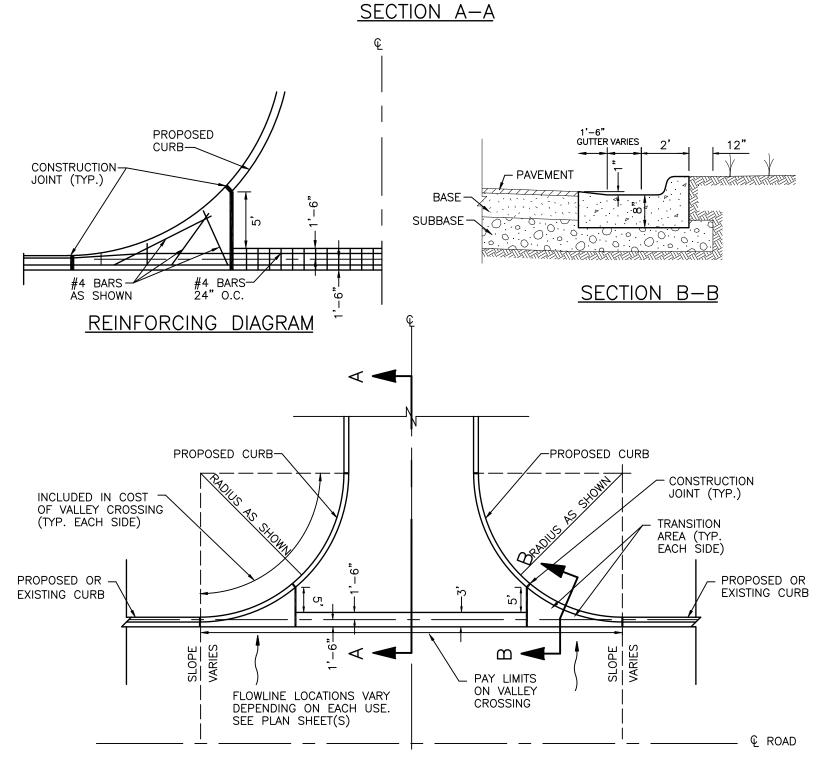


VALLEY CROSSING DETAIL

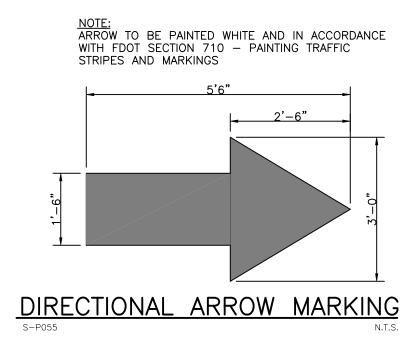


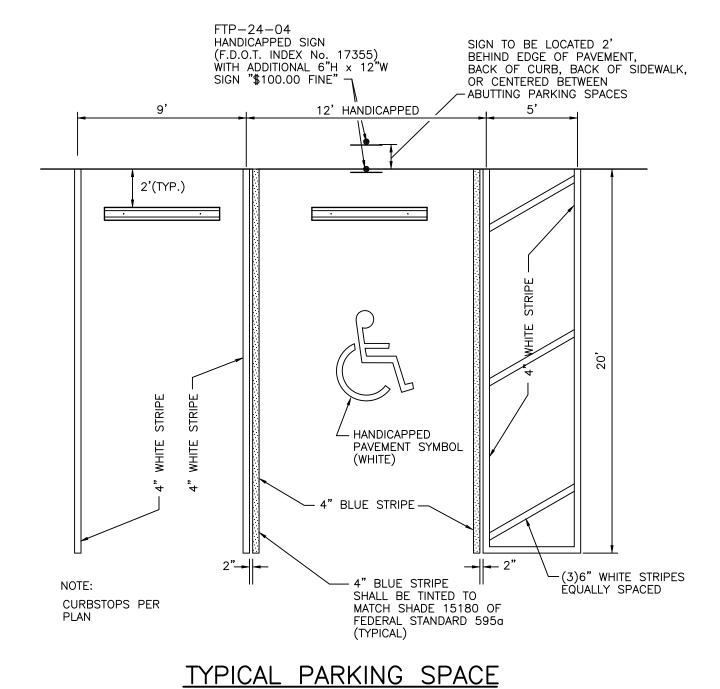

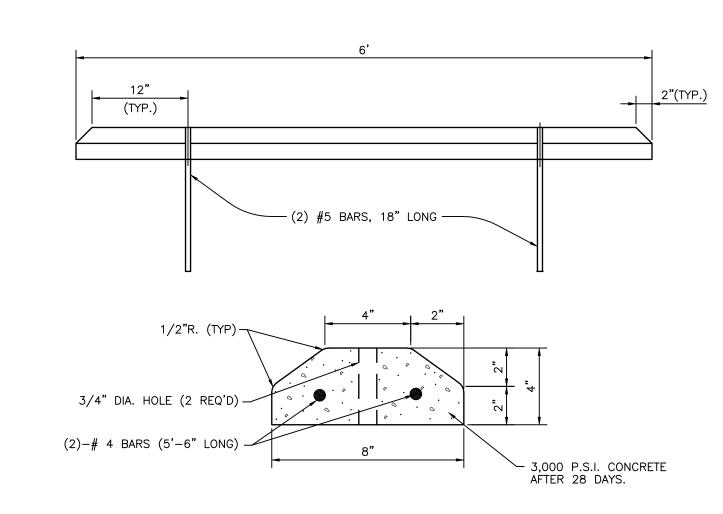


PRECAST CONCRETE WHEEL STOP

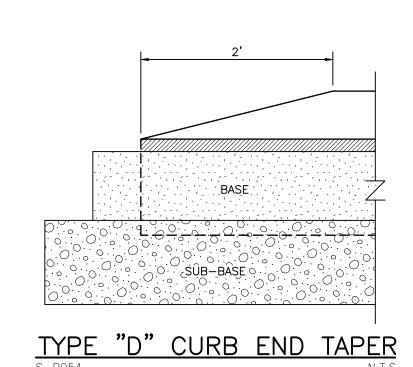

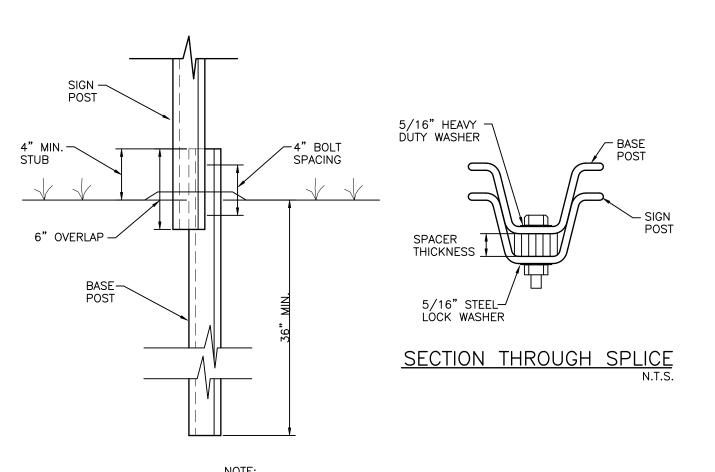


NOTE:
ALL MATERIALS AS PER F.D.O.T.
SPECIFICATIONS, INDEX NO. 11865,
AND ALL APPLICABLE CITY REQUIREMENTS.

SIGN POST BREAKAWAY DETAIL

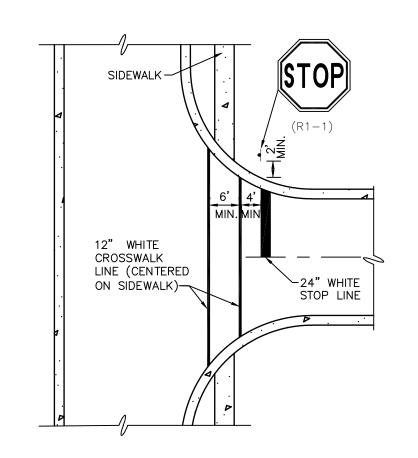


STOP SIGN, STOP LINE AND CROSSWALK LOCATION DETAIL S-P037 (09/07/04)

N.T.S

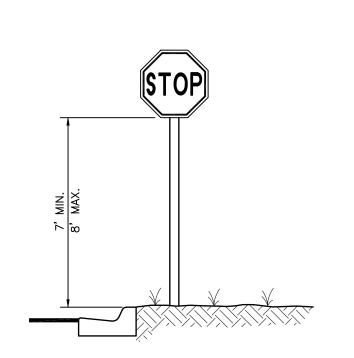

TYPICAL STOP SIGN DETAIL

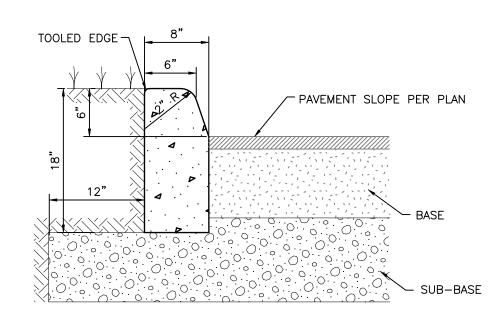

CURB NOTES:

1) CONCRETE SHALL HAVE A COMPRESSIVE STRENGTH OF 3,000 P.S.I. IN 28 DAYS UNLESS OTHERWISE NOTED.

2) AN EXPANSION JOINT WILL BE PLACED AT THE END OF ALL RETURNS AT INTERVALS NOT TO EXCEED 50'. CONTRACTION JOINTS AT A MAXIMUM SPACING OF 10' SHALL BE SAW CUT AT DEPTH PER FDOT INDEX NO. 300

3) EXPANSION JOINTS SHALL BE CONSTRUCTED WITH 1/2" BITUMINOUS IMPREGNATED EXPANSION JOINT MATERIAL.

TYPE "D" CURB

# CURB RAMP DETECTABLE WARNINGS

					ACTIVITY	INITIALS/EMP. NO.	DATE
					DESIGNED BY:		
					DRAWN BY:	CLL/096591	12/2012
					CHECKED BY:		
					CONTRACT ADMIN. BY:		
△REV NO.	REVISION	DATE	DRAWN BY / EMP. NO.	CHECKED BY / EMP. NO.	WM APPROVED BY:		


WilsonMiller S Stantec	
6900 Professional Parkway East, Sarasota, FL 34240	
Phone 941-907-6900 ◆ Fax 941-907-6910	

Certificate of Authorization #43 • FL Lic. # LC-C000170 • www.stantec.com

CLIENT:	MANATEE DOADD OF	DATE:
CLILINI.	MANATEE BOARD OF	DECEMBER 2012
	COUNTY COMMISSIONERS	HORIZONTAL SCALE:
	COUNTY COMMISSIONENS	AS SHOWN
PROJECT:		VERTICAL SCALE:
FROJECT.		AS SHOWN
	BLACKSTONE PARK EXPANSION	SEC: TWP: RGE:
		11 34S 17E


TITLE:		
PAVING	DETAILS	DANIEL J. BOND, P.E. FLORIDA LICENSE NO. 57969
		INDEX NUMBER: D-215611237-010
CROSS REFERENCE FILE NO.:	PROJECT NUMBER: 215611237	SHEET NUMBER: 10 OF 19


 $\label{localized-localiz$ 

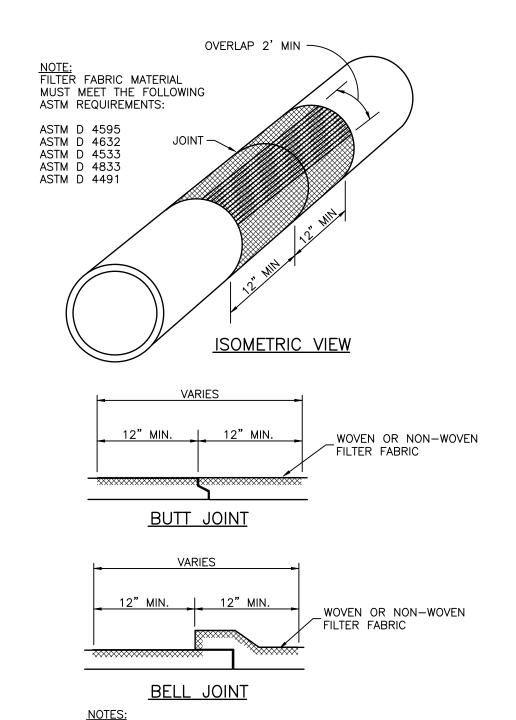

- 1. CENTER FILTER FABRIC ON PIPE JOINT.
- 2. FILTER FABRIC TO OVERLAP A MIN. OF ONE FOOT.
- 3. PRICE OF FILTER FABRIC JACKET TO BE INCLUDED IN PRICE OF PIPE.
- 4. FILTER FABRIC WRAP SHALL ALSO BE PLACED ON THE GROUTED PIPE TO STRUCTURE JOINT PER FDOT INDEX 201

# FILTER FABRIC JACKET

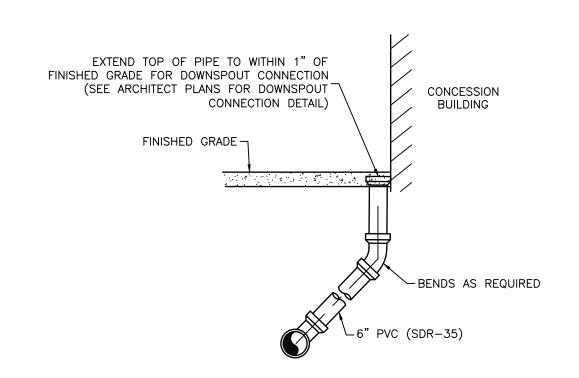


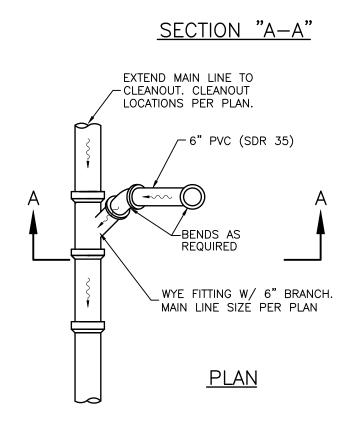



NOTE:

1. CONTRACTOR TO CONFIRM FINAL DOWNSPOUT LOCATIONS PER ARCHITECT'S PLANS. CONTRACTOR TO ADJUST PIPING AS NEEDED TO AVOID BUILDING FOOTER. THE ELBOW PIPE CONNECTOR SHALL BE ABOVE FINISHED GRADE TO ALLOW FOR MAINTENANCE ACCESS TO ROOF DRAIN SERVICE BELOW CONCRETE SLAB.

# TYPICAL ROOF DRAIN SERVICE DETAIL

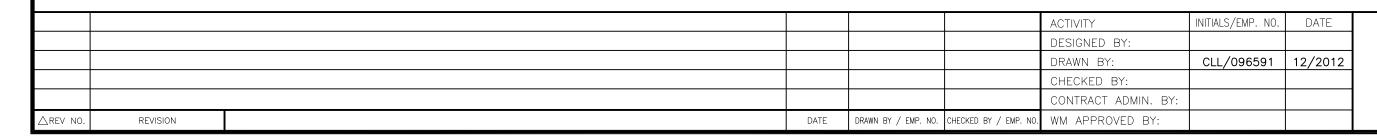

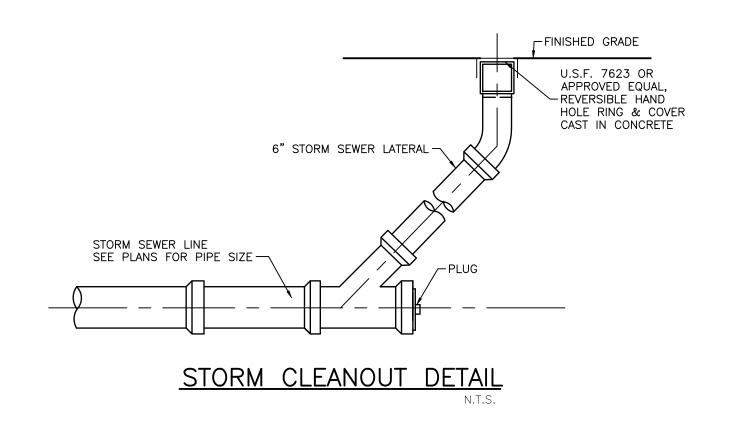

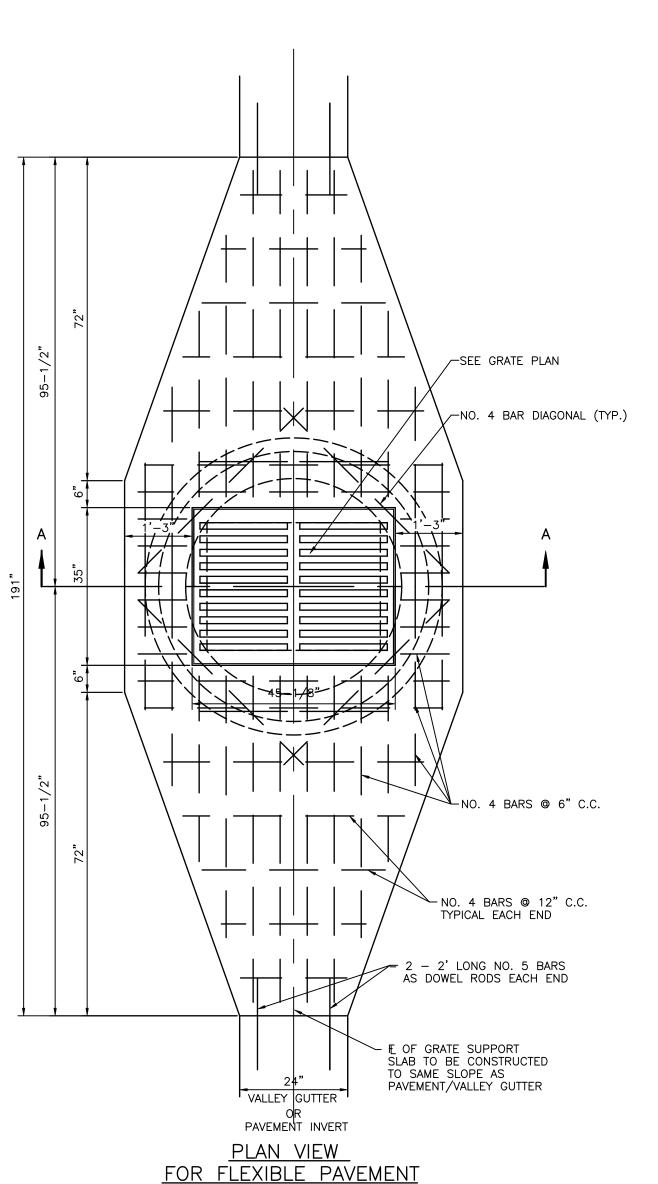


NOTES:


1. MATERIAL; GRATE—CAST IRON, FIELD APPLY ONE COAT OF ASPHALTIC PAINT. FRAME—STEEL, FIELD APPLY ONE COAT OF ASPHALTIC PAINT.

WITH INVERTED CROWN

- 2. SEE DRAINAGE PLANS AND/OR STORMPIPING PLANS FOR PIPE SIZES, FLOWLINES AND DIRECTION. SEE UNDERDRAIN PLANS AND/OR DRAINAGE PLANS FOR UNDERDRAIN SIZES, FLOWLINES AND DIRECTION.
- 3. CONCRETE TEST CYLINDERS (3 MIN) SHALL BE TAKEN FOR EACH DAYS POUR OR EACH 50 YARDS WHICH EVER IS GREATER

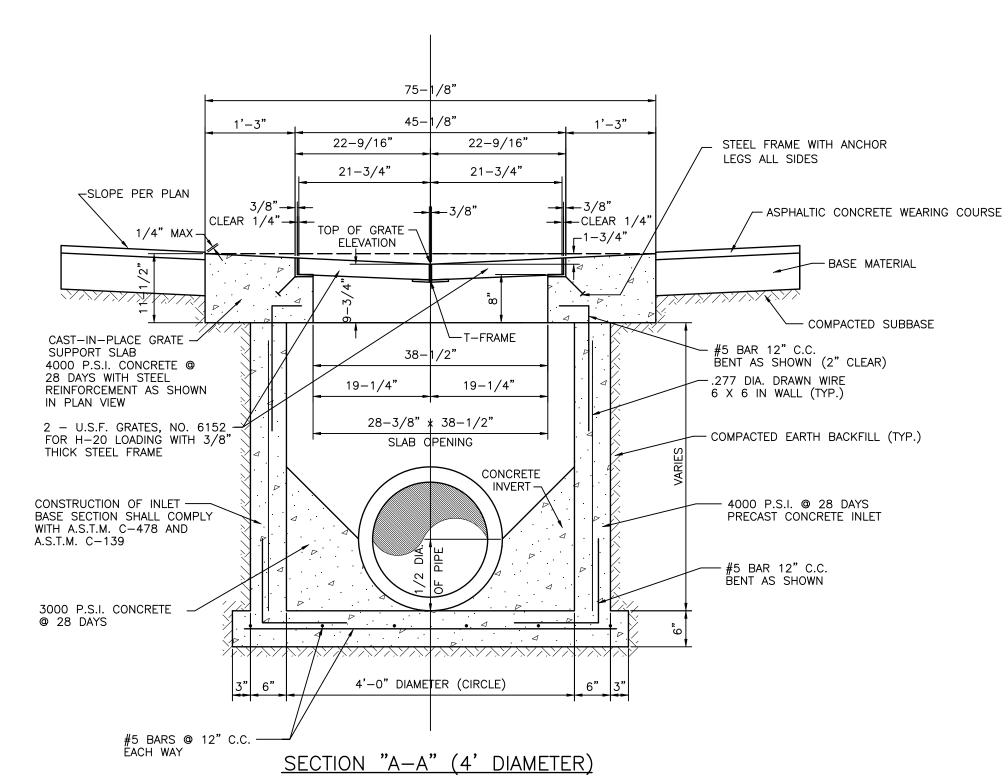

OVERSIZED INLET NOTE: INLETS FOR PIPE LARGER THAN 30" CIRCULAR OR 19" x 30" OVAL SHALL BE CONSTRUCTED AS PER FDOT INDEX #200 ALTERNATE "B". TOP SLAB OF THE FDOT BOX SHALL HAVE A 30" x 40" OPENING. GRATE SUPPORT SHALL BE CONSTRUCTED ABOVE & CENTERED ON THE FDOT INLET BOX AS SHOWN IN THE PLAN VIEW AND SECTION A—A. CONTRACTOR SHALL SUBMIT SHOP DRAWINGS TO ENGINEER FOR APPROVAL. THERE SHALL BE 1/2" OF MORTAR BETWEEN THE GRATE SUPPORT SLAB AND THE TOP SLAB OF THE FDOT INLET BOX.

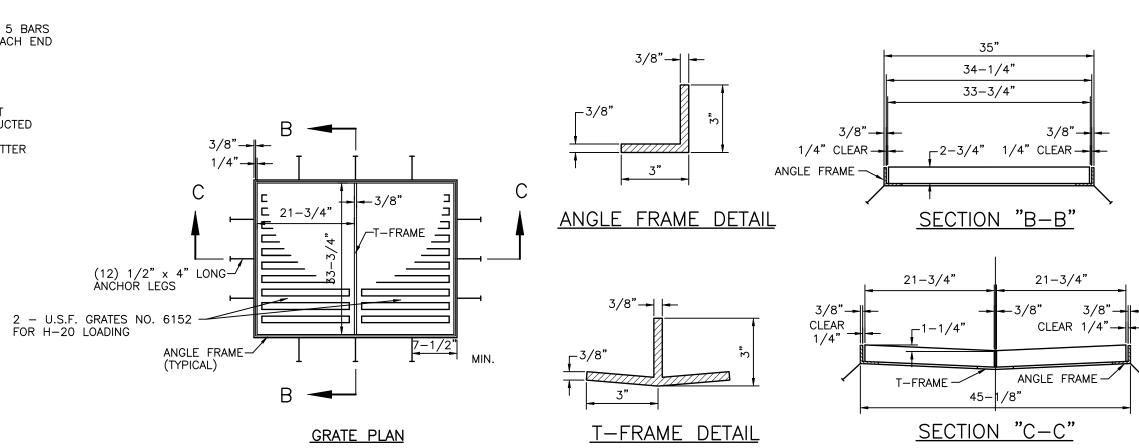


TYPE "J" INLET S-D001(11/18/01) N.T.S.


<i>WilsonMiller S</i> Stantec	CLIENT:
6900 Professional Parkway East, Sarasota, FL 34240  Phone 941-907-6900 • Fax 941-907-6910	PROJECT:

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MANATEE BOARD OF COUNTY COMMISSIONERS	DATE:  DECEMBER 2012  HORIZONTAL SCALE:  AS SHOWN	TITLE:  DRAINAGE	DANIEL J. BOND, P.E. FLORIDA LICENSE NO. 57969				
BLACKSTONE PARK EXPANSION	VERTICAL SCALE:  AS SHOWN  SEC: TWP: RGE:  11 34S 17E	CROSS REFERENCE FILE NO.:	PROJECT NUMBER: 215611237	D-215611237-011  SHEET NUMBER:  11 OF 19			
Jan 17, 2013 - 10:26:52 CLUGO V:\2156\active\215611237\civil\drawing\01_swfwmd\sheet_files\215611237-01C-511DD.dwg							

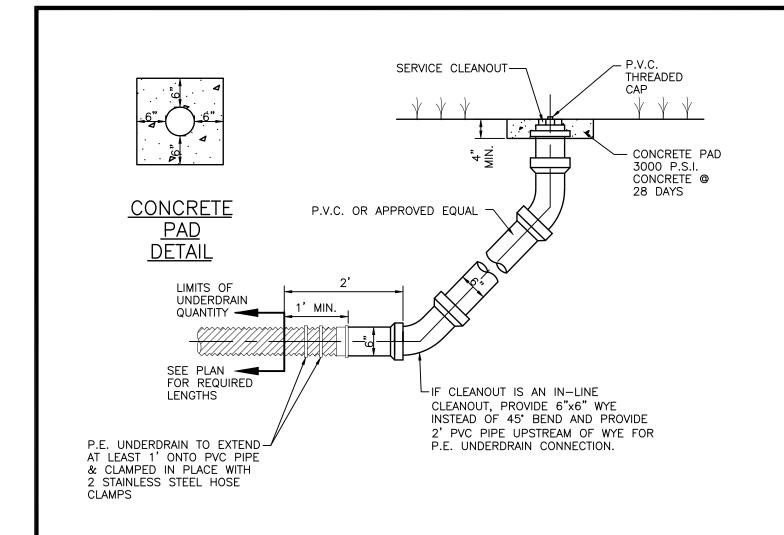

# **CLEANOUT DETAIL** FOR SINGLE UNDERDRAIN FILTER SYSTEM

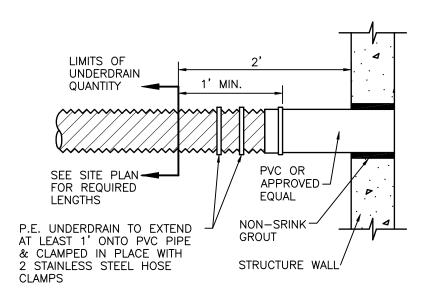

TYPICAL CONNECTION FOR UNDERDRAIN TO STRUCTURE

30 MIL POLYETHYLENE

GROUNDWATER BARRIER OR

APPROVED EQUAL. SEAMS-WELDED SO AS NOT TO

ALLOW WATER LEAKAGE.


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6" POLYETHYLENE

(INV = 6.75 FT-NGVD)

**UNDERDRAIN NOTES:** 

UNDERDRAIN-

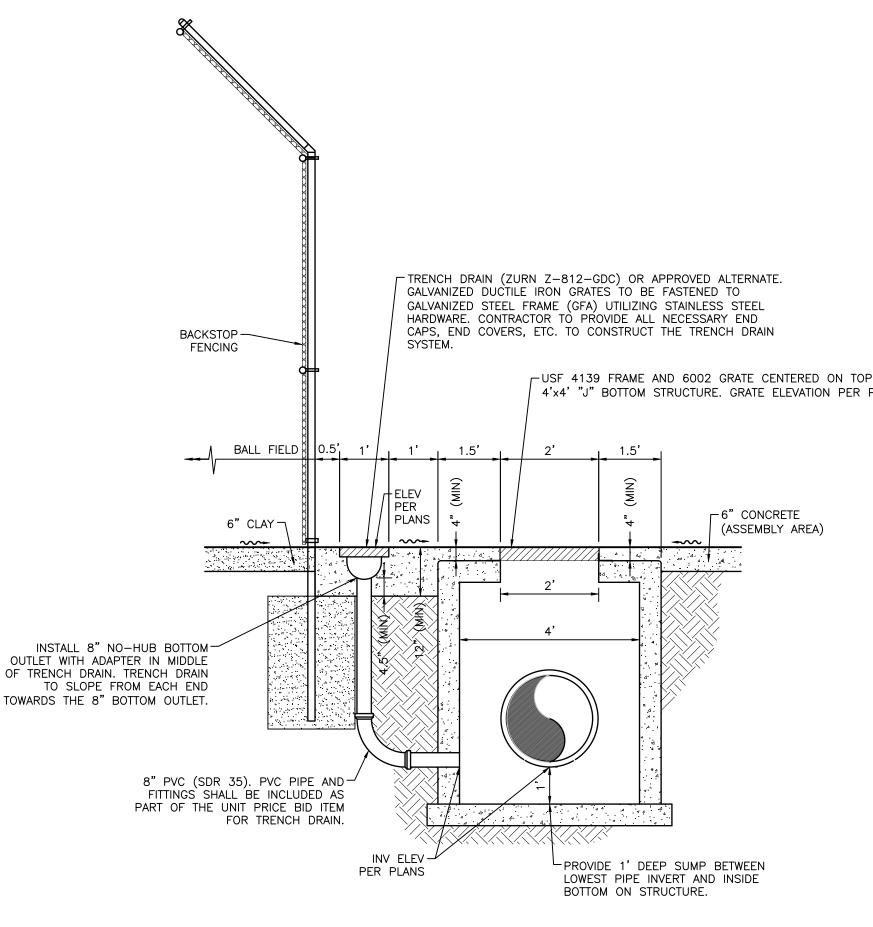

1. ALL CONCRETE SHALL HAVE A COMPRESSIVE STRENGTH OF 4,000 PSI AT 28 DAYS TYPICAL TRENCH DRAIN DETAIL BEHIND BACKSTOP

TYPE "A"

AGGREGATE

2'MIN

30 MIL POLYETHYLENE GROUNDWATER

SEAMS WELDED SO AS NOT TO ALLOW

BARRIER OR APPROVED EQUAL.

WATER LEAKAGE.

TYPE "B"

AGGREGATE

2'MIN

AGGREGATE

TYPE "A" AGGREGATE: FILTER AGGREGATE FOR UNDERDRAINS SHALL CONSIST OF WASHED MATERIAL MEETING FDOT ROAD & BRIDGE SPECIFICATIONS FOR SILICA SAND & QUARTZ GRAVEL CONTAINING LESS

TYPE "B" AGGREGATE: 3/4" TO 1" STONE, RIVER GRAVEL OR EQUAL (NO LIMEROCK, MARL, OR SIMILAR MATERIAL).

FILTER FABRIC: FILTER FABRIC SHALL BE WOVEN GEOTEXTILE, AMOCO 1198 SYNTHETIC INDUSTRIES EROSION 1

UNDERDRAIN: THE UNDERDRAIN SHALL BE SLOTTED POLYETHYLENE CORRUGATED PIPE A.S.T.M F-405-77 OR

OF THE AGGREGATE SHALL BE MINIMUM OF 8 FT/HR.

THAN 1% (BY WEIGHT) OF SILT, CLAY AND ORGANIC MATTER. SAID MATERIAL SHALL HAVE

MILLIMETER AND SIEVE ANALYSIS (IN PERCENT OF TOTAL WEIGHT PASSING) AS FOLLOWS:

3/8" = 95 - 100%

 $\dot{NO}$ . 4 = 95 - 100%

NO. 8 = 85 - 100%

NO. 16 = 65 - 97%NO. 30 = 25 - 70%NO. 50 = 5 - 35%

NO. 100 = 0 - 7%NO. 200 = MAX. 1%THE AGGREGATE SHALL BE FREE OF ORGANIC MATTER AND OTHER DELETERIOUS MATERIALS.

WASHED SHELL & LIMEROCK SHALL NOT BE USED FOR FILTER AGGREGATE. PERMEABILITY

A.A.S.H.T.O. M-252 HAVING A MINIMUM SLOTTED AREA OF 1 SQ. IN./FT. OF PIPE MANUFACTURED

BY A.D.S. OR HANCOR. NO FACTORY INSTALLED SOCK SHALL BE INSTALLED WITH THIS UNDERDAIN.

PERFORMED BY AN INDEPENDENT TESTING LABORATORY PRIOR TO DELIVERY OF THE FILTER AGGREGATE


MATERIAL ON SITE. FAILURE TO MEET THE SPECIFIED PERMEABILITY OR SIEVE ANALYSIS WILL BE CAUSE FOR REJECTION OF THE MATERIAL. THE CONTRACTOR SHALL ALSO PROVIDE THE ENGINEER WITH SIEVE ANALYSIS & PERCOLATION TEST RESULTS OF THE FILTER AGGREGATE RECEIVED AT THE SITE PRIOR TO

IT BEING PUT IN PLACE. THIS TEST SHALL BE PERFORMED BY AN INDEPENDENT TESTING LABORATORY.

TESTING: THE CONTRACTOR SHALL PROVIDE THE ENGINEER WITH SIEVE ANALYSIS & PERCOLATION TEST RESULTS

TYPICAL SHALLOW BOTTOM TREATMENT UNDERDRAIN

UNIFORMITY COEFFICIENT OF 1.5 OR GREATER, AN EFFECTIVE GRAIN SIZE OF 0.20 - 0.55

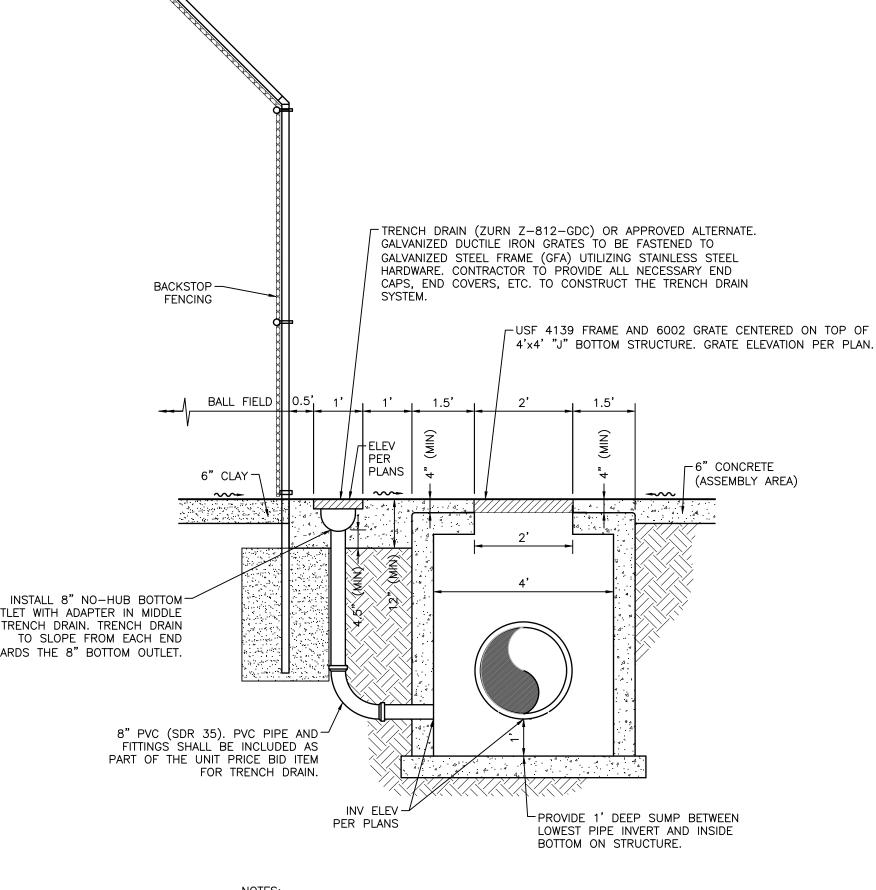


54" 44" MAX.

BALL FIELD I → BALL FIELD FENCING -FENCE POST SEE TYPICAL SECTION-CONCRETE PAD (SEE NOTE 2) FOR BALL FIELD TURF - x -- x -- x -- x -- x --—— × — × — × — × LIMITS OF LIMITS OF UNDERDRAIN UNDERDRAIN CONCRETE PAD QUANTITY -QUANTITY 3,000 PSI CONCRETE @ 28 DAYS SEE PLAN SEE PLAN FOR REQUIRED FOR REQUIRED LENGTHS LENGTHS (SEE NOTE 3) P.E. UNDERDRAIN WITH FACTORY P.E. UNDERDRAIN WITH FACTORY 6" PE UNDERDRAIN WITH-INSTALLED FILTER SOCK TO EXTEND INSTALLED FILTER SOCK TO EXTEND FACTORY INSTALLED FILTER SOCK AT LEAST 1' ONTO PVC PIPE & AT LEAST 1' ONTO PVC PIPE & 6" PVC (SDR 35)-(INV ELEV PER PLAN). PROVIDE CLAMPED IN PLACE WITH 2 CLAMPED IN PLACE WITH 2 6" X 6" WYE OR 6" X 6" TEE STAINLESS STEEL HOSE CLAMPS. STAINLESS STEEL HOSE CLAMPS. WHERE CLEANOUT LOCATIONS ARE PLAN VIEW SHOWN PER PLAN (SEE NOTE 3) PROFILE VIEW

- 1. UNDERDRAIN SHALL BE SLOTTED POLYETHYLENE CORRUGATED PIPE PER ASTM F-405-77 OR AASHTO M-252 HAVING A MINIMUM SLOTTED AREA OF 1 SQ.IN./FT OF PIPE MANUFACTURED BY ADS (OR APPROVED ALTERNATE).
- 2. CONTRACTOR TO FIELD ADJUST CLEANOUT LOCATIONS AS NEEDED TO AVOID FENCE
- 3. 6" X 6" WYE TO BE REPLACED WITH 6" X 6" TEE (TWO WAY CLEANOUT STYLE) ONLY WHERE SPECIFICALLY CALLED FOR ON THE PLANS.

# BALL FIELD UNDERDRAIN/UNDERDRAIN CLEANOUT DETAIL

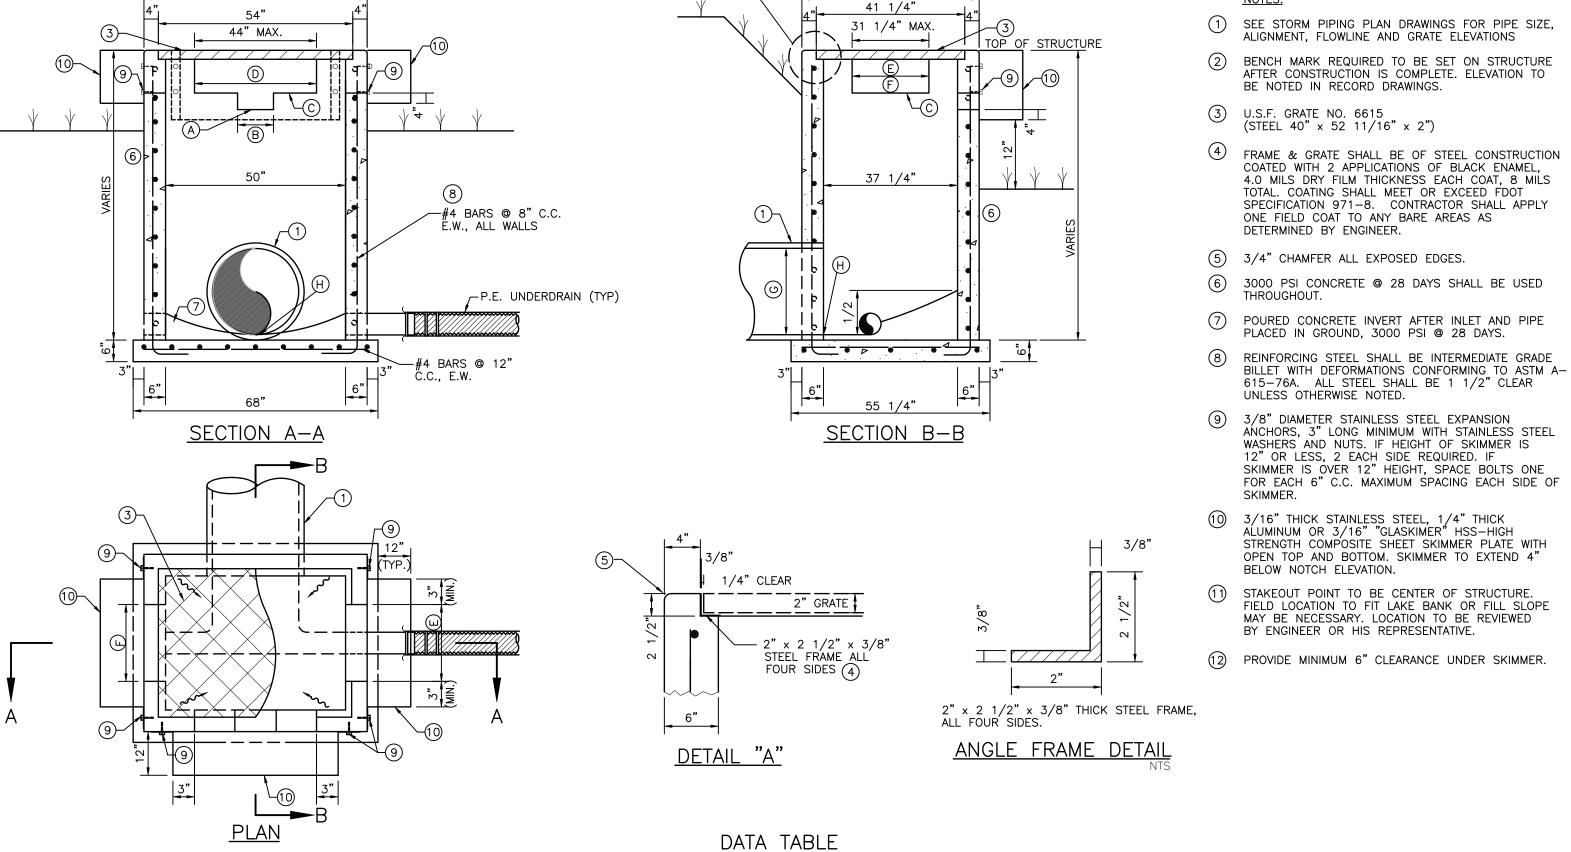

(10) 3/16" THICK STAINLESS STEEL, 1/4" THICK ALUMINUM OR 3/16" "GLASKIMER" HSS-HIGH STRENGTH COMPOSITE SHEET SKIMMER PLATE WITH OPEN TOP AND BOTTOM. SKIMMER TO EXTEND 4" BELOW NOTCH ELEVATION.

STAKEOUT POINT TO BE CENTER OF STRUCTURE. FIELD LOCATION TO FIT LAKE BANK OR FILL SLOPE MAY BE NECESSARY. LOCATION TO BE REVIEWED BY ENGINEER OR HIS REPRESENTATIVE.

(12) PROVIDE MINIMUM 6" CLEARANCE UNDER SKIMMER.

DANIEL J. BOND, P.E. FLORIDA LICENSE NO. 57969

D-215611237-012

12 of 19

-PVC THREADED CAP

| NORMAL<br>WATER<br>LEVEL<br>(FT—NGVD) | TOP<br>GRATE<br>EL.<br>(FT-NGVD) | (A) FL. EL. OF NOTCH (FT-NGVD) | B<br>WIDTH OF<br>NOTCH<br>(FT) | ©<br>FL. EL.<br>WINDOW<br>(FT-NGVD) | © WIDTH OF WINDOW (FT) | E<br>WIDTH OF<br>WINDOW<br>(FT) | F<br>WIDTH OF<br>WINDOW<br>(FT) | G<br>DIAMETER OF<br>OUTFALL PIPE<br>(IN) | H<br>PIPE<br>FL. EL.<br>(FT-NGVD) | SPECIAL REMARKS                                                       |
|---------------------------------------|----------------------------------|--------------------------------|--------------------------------|-------------------------------------|------------------------|---------------------------------|---------------------------------|------------------------------------------|-----------------------------------|-----------------------------------------------------------------------|
| N/A                                   | 11.40                            | N/A                            | N/A                            | 8.84                                | 0.36                   | N/A                             | N/A                             | 30                                       | 4.70                              | SKIMMER REQUIRED ALL WINDOWS UNDERDRAIN REQUIRED (INV = 6.75 FT-NGVD) |
|                                       |                                  | -                              |                                | -                                   | -                      | -                               |                                 | -                                        |                                   |                                                                       |

# TYPE "G" CONTROL STRUCTURE

|                   |      |                     |                       | ACTIVITY            | INITIALS/EMP. NO. | DATE    |
|-------------------|------|---------------------|-----------------------|---------------------|-------------------|---------|
|                   |      |                     |                       | DESIGNED BY:        |                   |         |
|                   |      |                     |                       | DRAWN BY:           | CLL/096591        | 12/2012 |
|                   |      |                     |                       | CHECKED BY:         |                   |         |
|                   |      |                     |                       | CONTRACT ADMIN. BY: |                   |         |
| △REV NO. REVISION | DATE | DRAWN BY / EMP. NO. | CHECKED BY / EMP. NO. | WM APPROVED BY:     |                   |         |

OR APPROVED EQUAL.


WilsonMiller S Stantec Phone 941-907-6900 • Fax 941-907-6910


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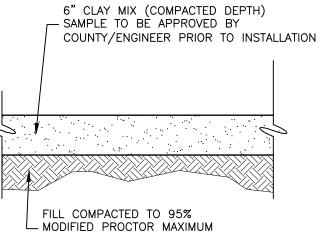
STRUCTURE NUMBER

SCS-1

| CLIENT:  | MANAILE BOARD OF          | DATE: DECEMBER 2012 HORIZONTAL SCALE: AS SHOWN |                           | E DETAILS                 |
|----------|---------------------------|------------------------------------------------|---------------------------|---------------------------|
| PROJECT: |                           | vertical scale:<br>AS SHOWN                    |                           |                           |
|          | BLACKSTONE PARK EXPANSION | SEC: TWP: RGE: 11 34S 17E                      | CROSS REFERENCE FILE NO.: | PROJECT NUMBER: 215611237 |



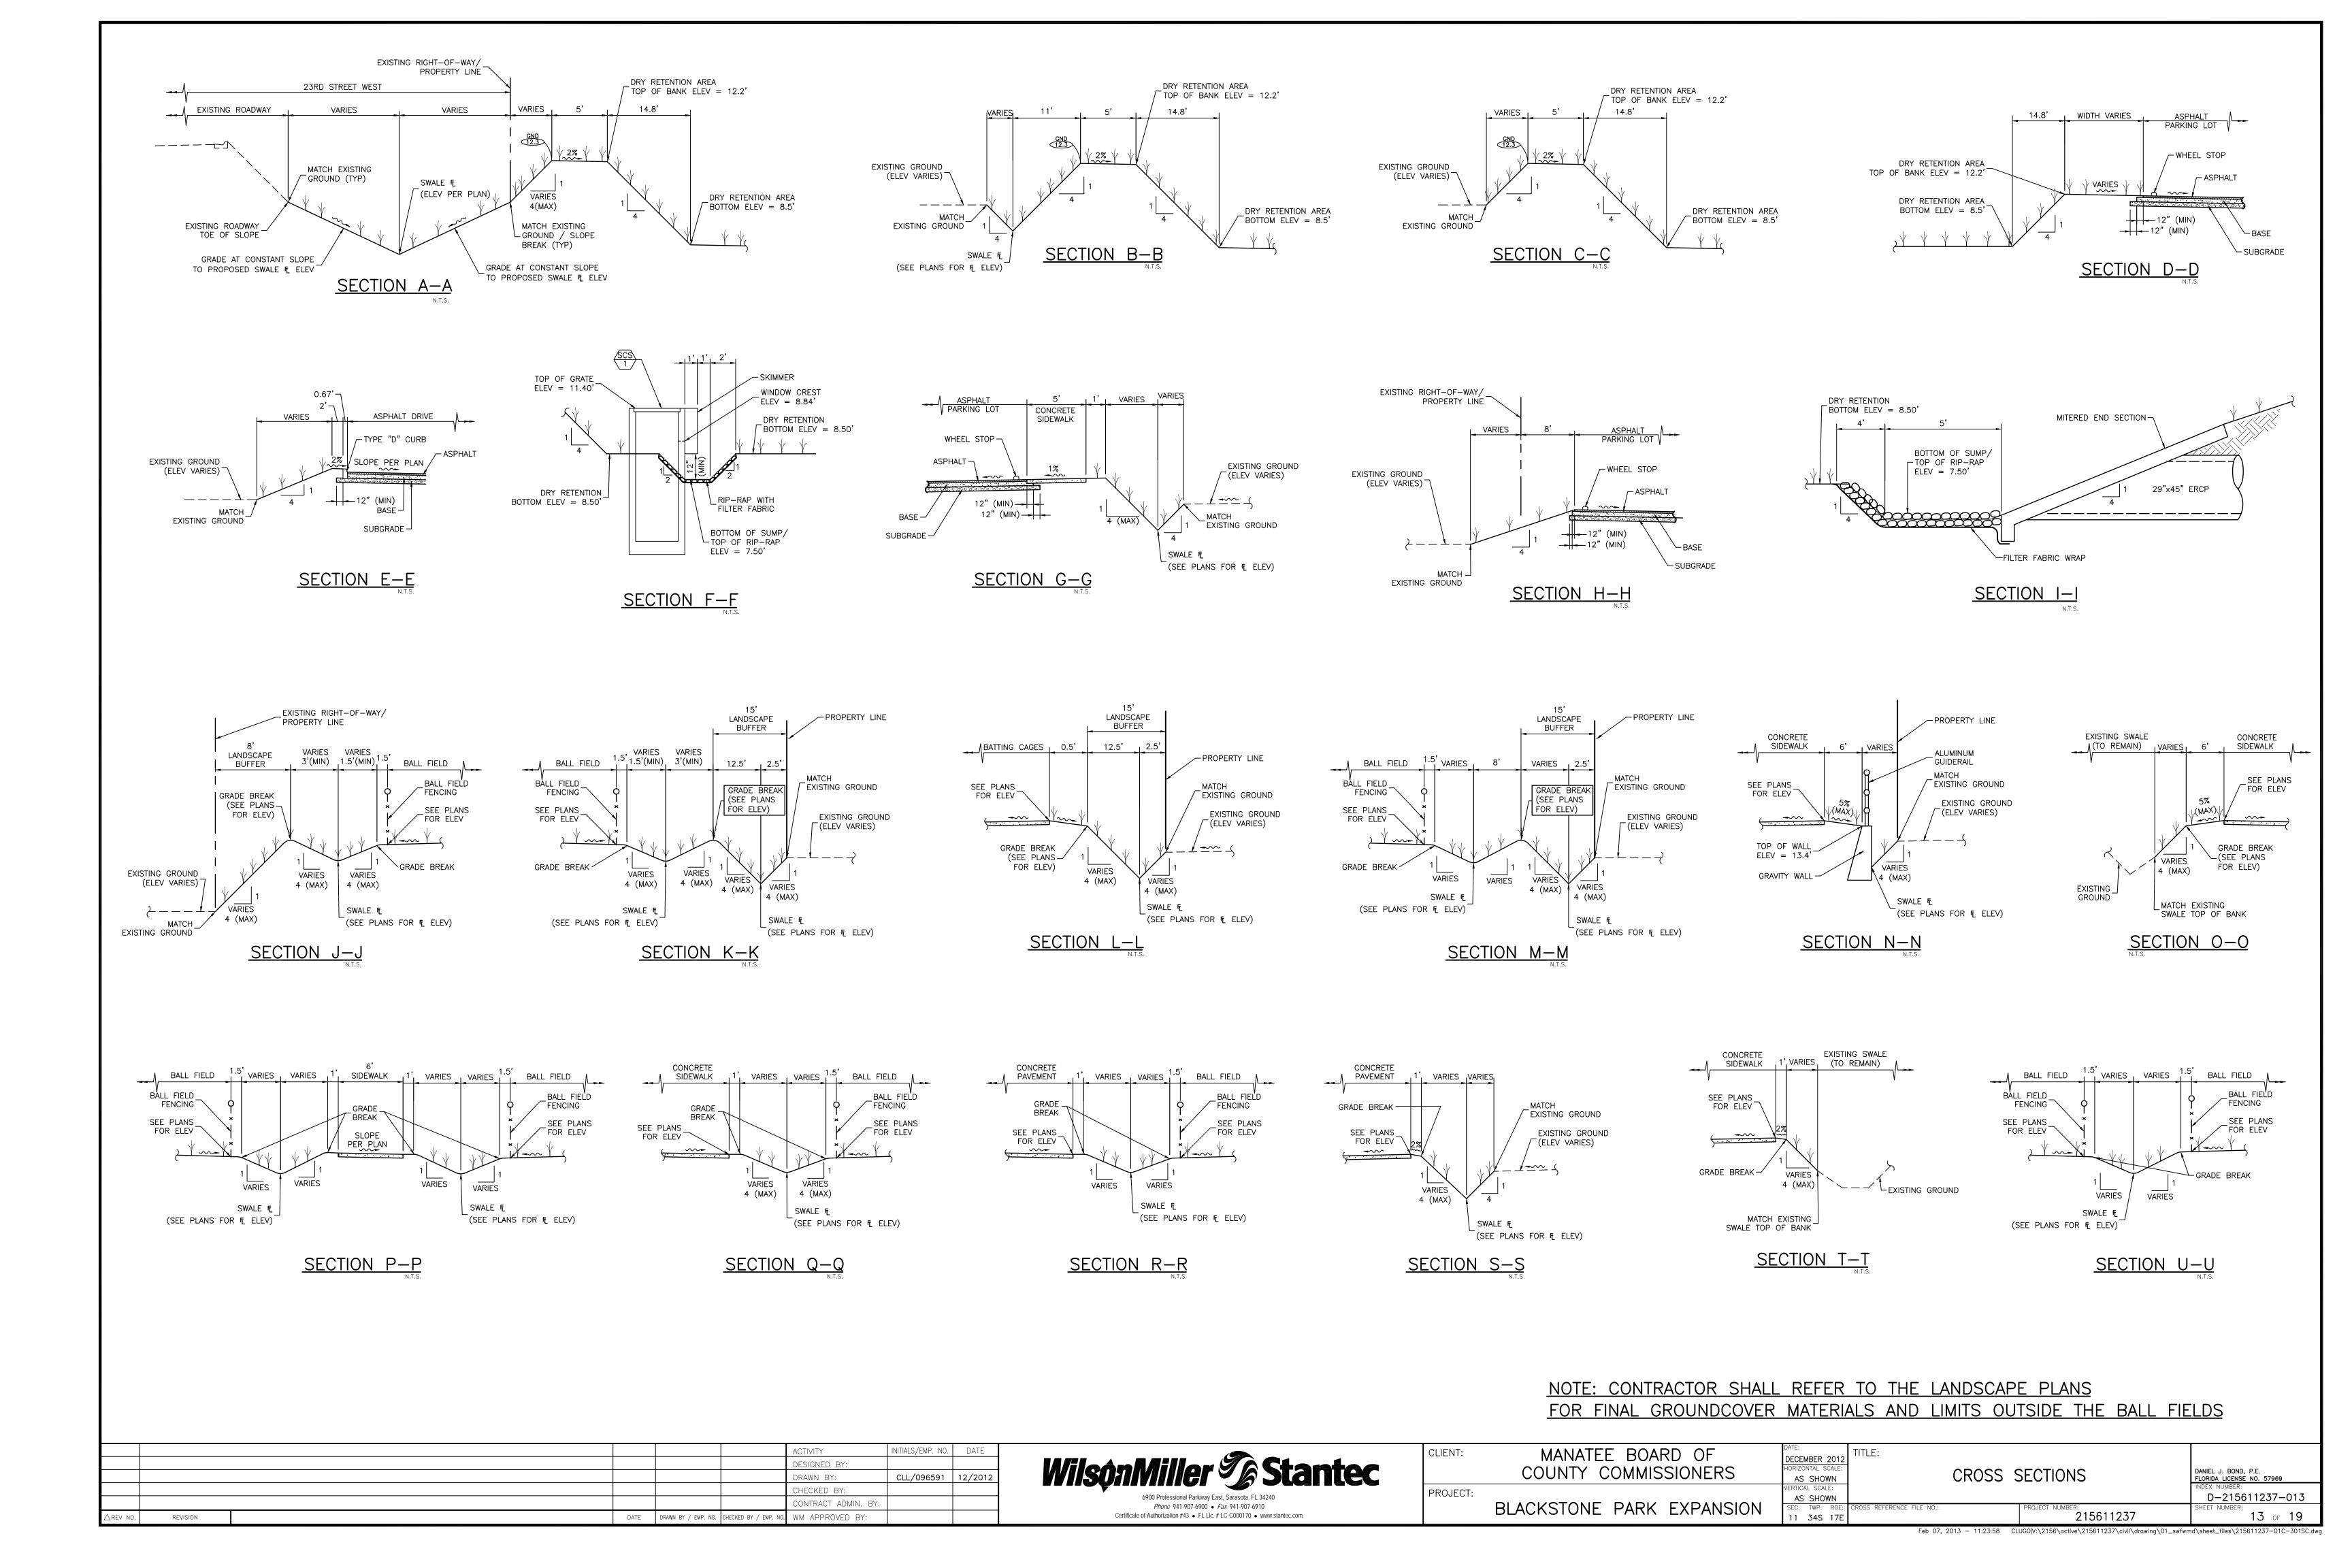

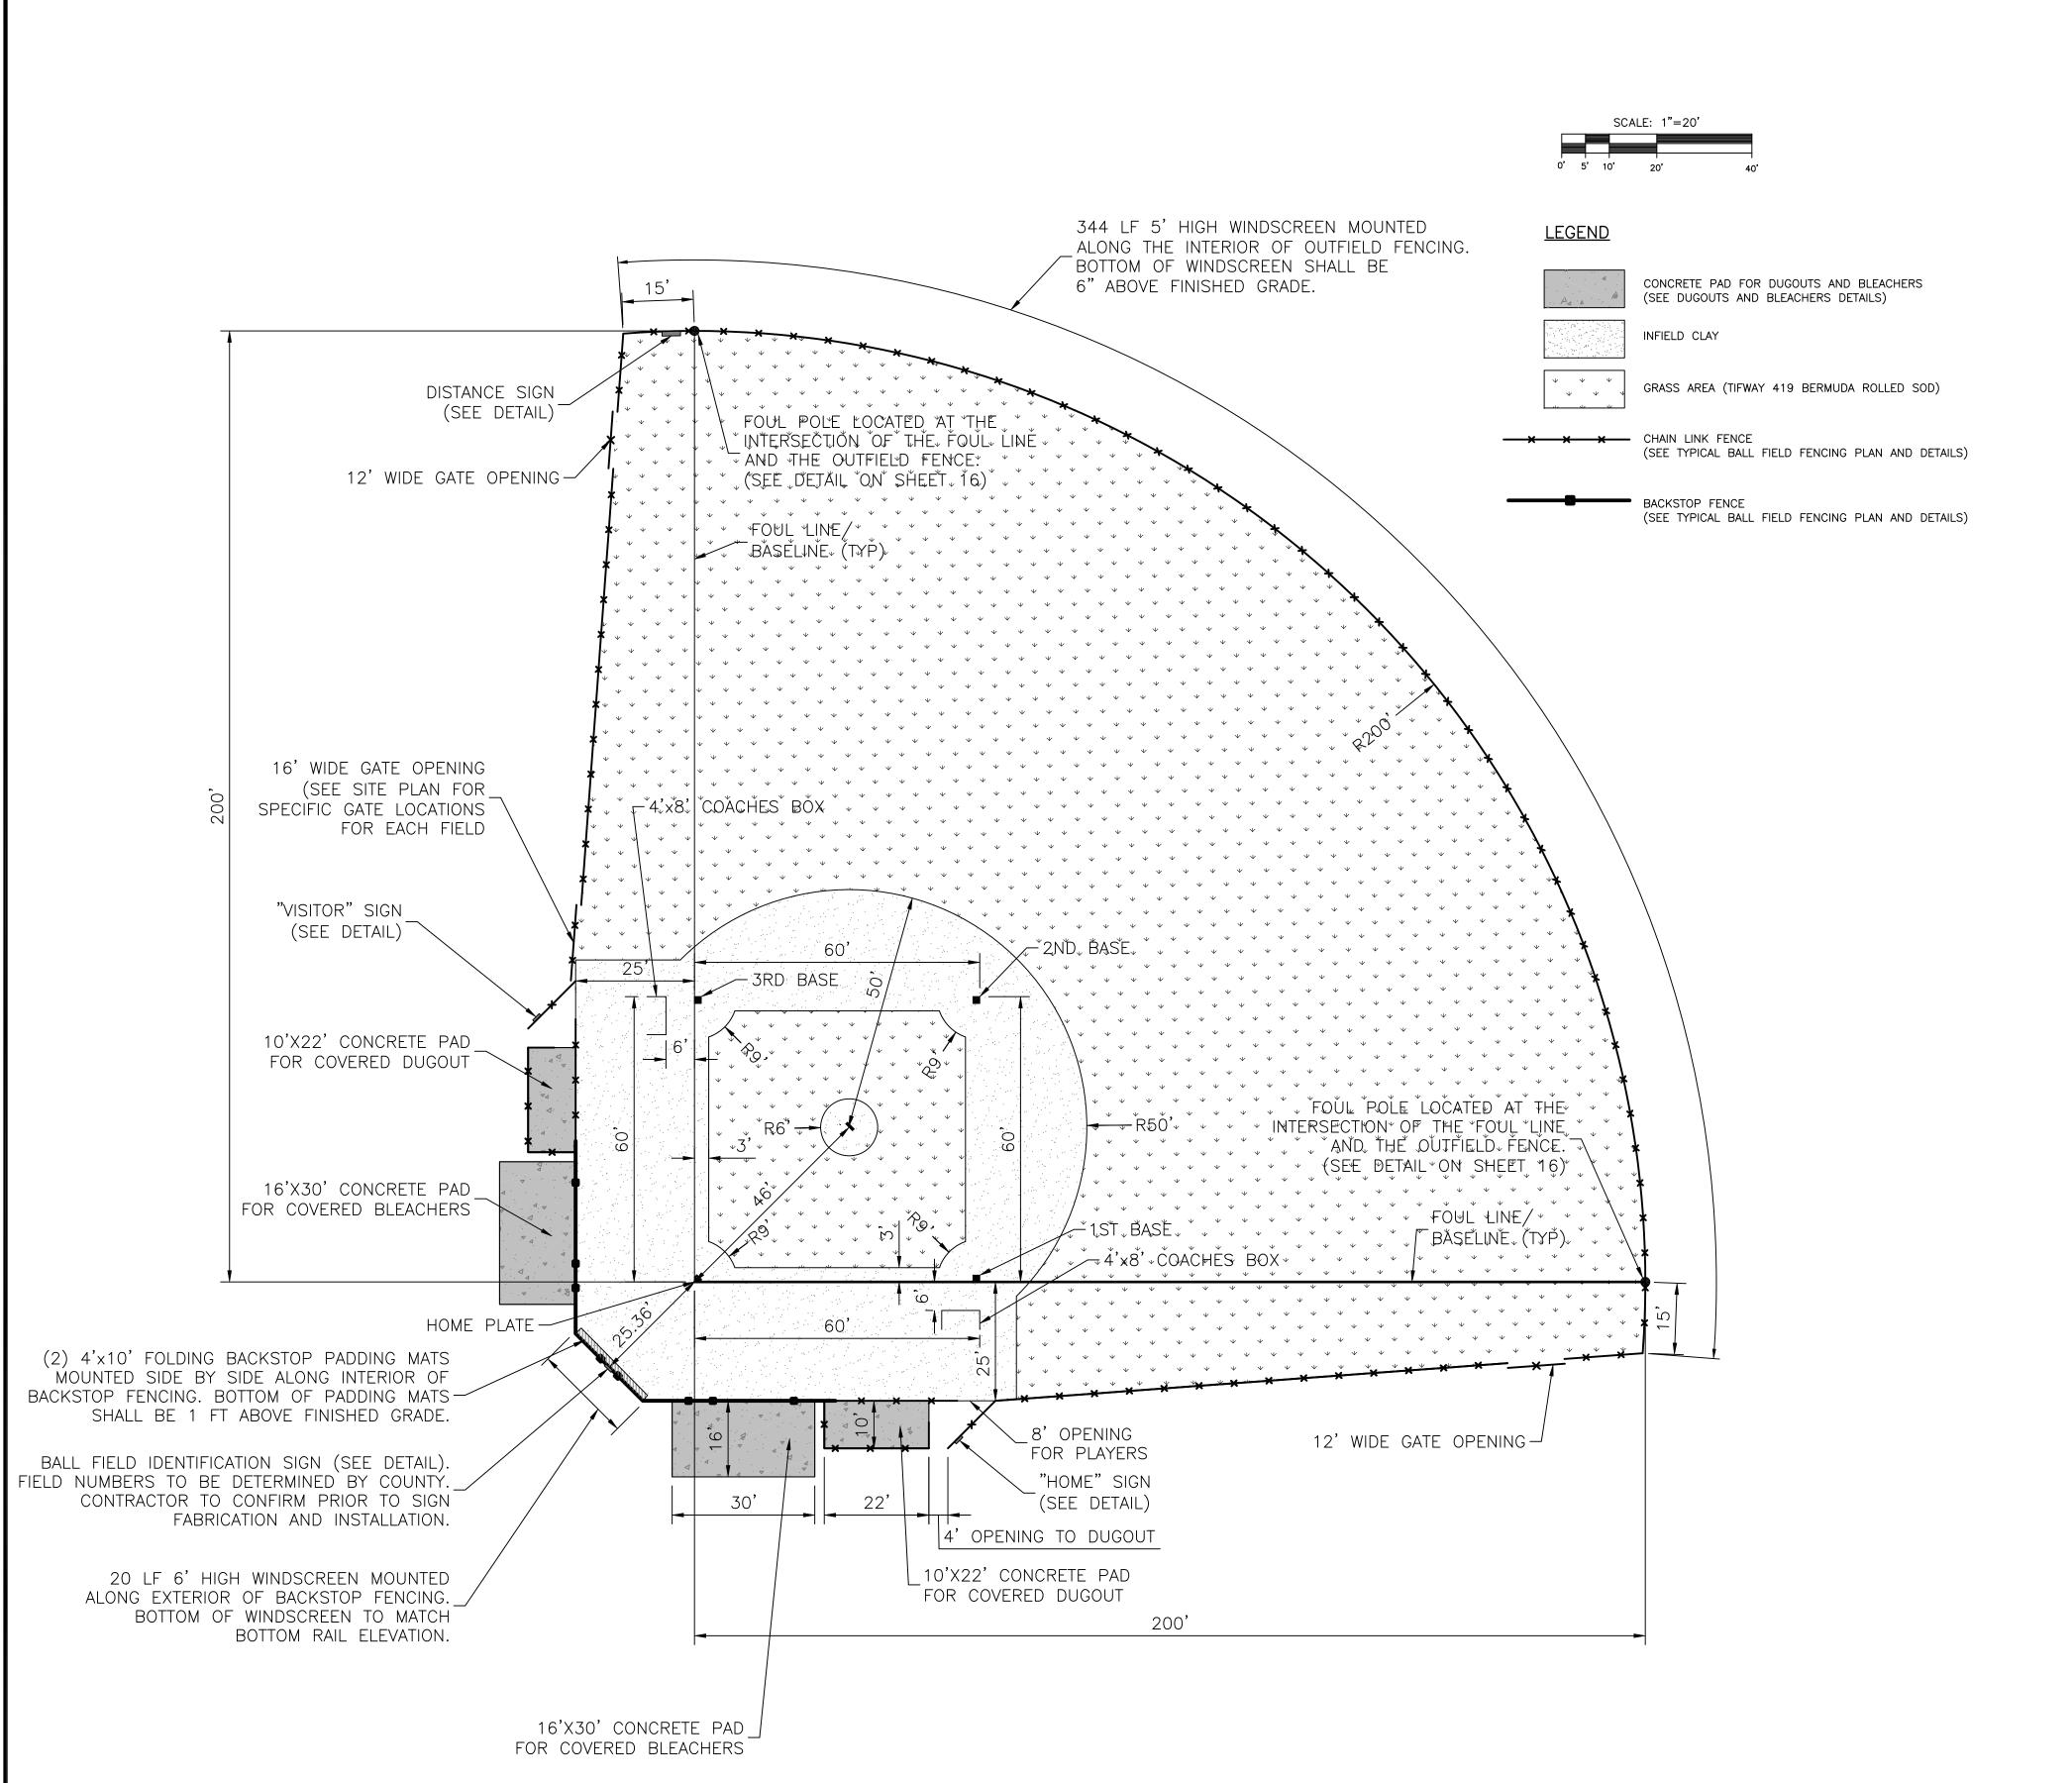

DRY DENSITY (AASHTO T-180)

NOTE: CLAY TO BE ROLLED.


# **CLAY SECTION**

# NOTES:

1. CLAY COMPOSITION SHALL BE NO LESS THAN 80% CLAY/20% SAND, MIX AS SUPPLIED BY TURBO LINK INTERNATIONAL INC. OR APPROVED ALTERNATE. BALL FIELD CLAY SHALL BE WELL GRADED CLAYEY SAND ("SC") WITH BETWEEN 17.5% AND 22.5% OF MATERIAL PASSING A #200 SIEVE. NO MATERIAL TO BE RETAINED ON A #10 SIEVE. SUBMIT 2 GALLON SAMPLE AND SIEVE ANALYSIS (ASTM C136 AND D422) FROM AN INDEPENDENT TESTING COMPANY TO ENGINEER FOR APPROVAL PRIOR TO ORDERING MATERIAL.

2. MATERIALS AND INSTALLATION PROCEDURES SHALL BE SUBJECT TO


- ENGINEERS REVIEW AND APPROVAL PRIOR TO COMMENCEMENT.
- 3. GRADING SHALL BE AS PER PAVING AND DRAINAGE PLAN.

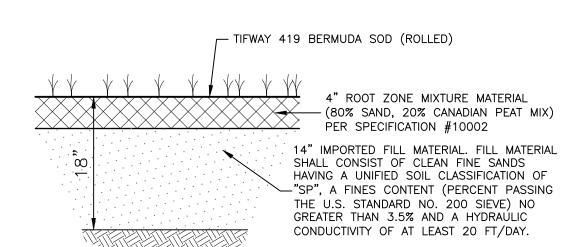

# TYPICAL SECTION FOR BALL FIELD TURF

## TESTING

- 1. THE CONTRACTOR SHALL PROVIDE THE ENGINEER WITH SIEVE ANALYSIS, UNIFIED SOIL CLASSIFICATION, AND PERCOLATION TEST RESULTS PERFORMED BY AN INDEPENDENT TESTING LABORATORY PRIOR TO THE ONSITE DELIVERY OF THE 14" IMPORTED FILL MATERIAL UNDERNEATH THE BALL FIELD TURF. FAILURE TO MEET THE SPECIFIED HYDRAULIC CONDUCTIVITY, SOIL CLASSIFICATION, OR SIEVE ANALYSIS WILL BE CAUSE FOR REJECTION OF THE MATERIAL. THE FREQUENCY OF TESTING SHALL BE A MINIMUM OF 1 TEST REPORT FOR EVERY 450 CY OF FILL MATERIAL TO BE BROUGHT TO THE SITE.
- 2. PRIOR TO INSTALLATION OF THE BALL FIELD SOD, THE CONTRACTOR SHALL PROVIDE THE ENGINEER WITH SIEVE ANALYSIS, UNIFIED SOIL CLASSIFICATION, AND PERCOLATION TEST RESULTS PERFORMED BY AN INDEPENDENT TESTING LABORATORY OF THE IN-PLACE 14" IMPORTED FILL MATERIAL. FAILURE TO MEET THE SPECIFIED HYDRAULIC CONDUCTIVITY, SOIL CLASSIFICATION, OR SIEVE ANALYSIS WILL BE CAUSE FOR REJECTION OF THE MATERIAL. THE FREQUENCY OF TESTING SHALL BE A MINIMUM OF 5 TEST REPORTS FOR EACH BALL FIELD.

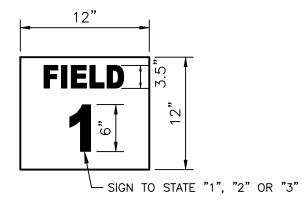


SIGN MATERIAL SHALL BE ALUMINUM. LETTERS AND BACKGROUND SHALL BE OF A REFLECTIVE MATERIAL. LETTERS ARE TO BE DARK GREEN ON A WHITE BACKGROUND. SIGNS SHALL BE MOUNTED ON FENCE WITH BOLTS AND BACK PLATES (EACH CORNER). MOUNTING HEIGHT SHALL BE 11' FROM BOTTOM OF SIGN TO FINISHED GRADE. ALL HARDWARE SHALL BE STAINLESS STEEL OR GALVANIZED. CONTRACTOR TO SUBMIT SHOP DRAWINGS OF SIGN FOR REVIEW AND APPROVAL PRIOR TO FABRICATION.

BALL FIELD IDENTIFICATION SIGN DETAIL


# SPECIFICATIONS:

- 1. PITCHER'S PLATE: JAYPRO SPORTS LITTLE LEAGUE PROFESSIONAL PITCHING RUBBER (6"X18"), PR-618 (OR APPROVED ALTERNATE)
- 2. HOME PLATE: ROGERS ONE TIME HOME PLATE, RHP-1 (OR APPROVED ALTERNATE)
- 3. BASES: ROGERS BREAK AWAY BASE SET YOUTH, RBBS—Y (OR APPROVED ALTERNATE)
- 4. BACKSTOP PADDING: BSN SPORTS FOLDING BACKSTOP PADDING MATS 4'x10'(EACH), 1150964 ROYAL BLUE IN COLOR (OR APPROVED ALTERNATE). PADDING SHALL BE MOUNTED TO BACKSTOP ALONG TOP, BOTTOM, AND SIDES UTILIZING STAINLESS STEEL OR GALVANIZED S—HOOKS IN ACCORDANCE WITH MANUFACTURER RECOMMENDATIONS.
- 5. WINDSCREENS: BSN SPORTS POLYESTER OUTFIELD WINDSCREENS, 5' HIGH (1158670) OR 6' HIGH (1170610) AS SPECIFIED PER PLAN ROYAL BLUE IN COLOR (OR APPROVED ALTERNATE). WINDSCREEN SHALL BE MOUNTED TO FENCING USING 7" SELF—LOCK TIE WRAPS (MTTWRAPS) EVERY 12" TO 18" PER MANUFACTURER RECOMMENDATIONS.

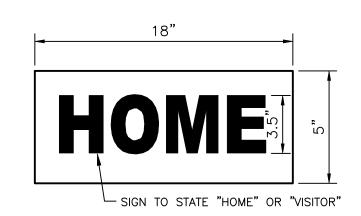


SIGN MATERIAL SHALL BE ALUMINUM. LETTERS AND BACKGROUND SHALL BE OF A REFLECTIVE MATERIAL. LETTERS ARE TO BE DARK GREEN ON A WHITE BACKGROUND. SIGNS SHALL BE MOUNTED ON FENCE WITH BOLTS AND BACK PLATES (EACH CORNER). MOUNTING HEIGHT SHALL BE 5' FROM BOTTOM OF SIGN TO FINISHED GRADE. ALL HARDWARE SHALL BE STAINLESS STEEL OR GALVANIZED. CONTRACTOR TO SUBMIT SHOP DRAWINGS OF SIGN FOR REVIEW AND APPROVAL PRIOR TO FABRICATION.

# HOME/VISITOR SIGN DETAIL

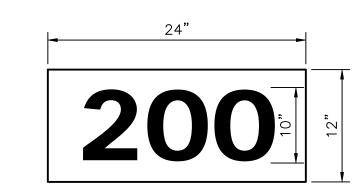

SIGN MATERIAL SHALL BE ALUMINUM. LETTERS AND BACKGROUND SHALL BE OF A REFLECTIVE MATERIAL. LETTERS ARE TO BE WHITE ON A DARK GREEN BACKGROUND. DISTANCES FOR SIGNS ARE AS SHOWN (ONE SIGN PER FIELD). SIGNS SHALL BE MOUNTED ON FENCE WITH BOLTS AND BACK PLATES (EACH CORNER). MOUNTING HEIGHT SHALL BE 4' FROM TOP OF SIGN TO FINISHED GRADE. ALL HARDWARE SHALL BE STAINLESS STEEL OR GALVANIZED. CONTRACTOR TO SUBMIT SHOP DRAWINGS OF SIGN FOR REVIEW AND APPROVAL PRIOR TO FABRICATION.

DISTANCE SIGN DETAIL

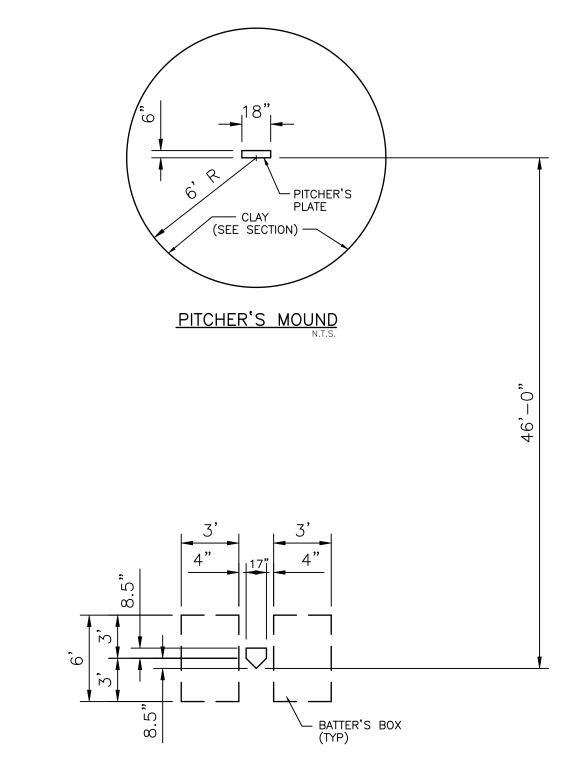

HOME PLATE

Jan 28, 2013 - 14:09:00 CLUGO|V:\2156\active\215611237\civil\drawing\01\_swfwmd\sheet\_files\21**5611237-01C-302SC.dwg** 

HOME PLATE / PITCHER'S MOUND DETAIL

|          |          |      |                     |                       | ACTIVITY            | INITIALS/EMP. NO. | DATE    |
|----------|----------|------|---------------------|-----------------------|---------------------|-------------------|---------|
|          |          |      |                     |                       | DESIGNED BY:        |                   |         |
|          |          |      |                     |                       | DRAWN BY:           | CLL/096591        | 12/2012 |
|          |          |      |                     |                       | CHECKED BY:         |                   |         |
|          |          |      |                     |                       | CONTRACT ADMIN. BY: |                   |         |
| △REV NO. | REVISION | DATE | DRAWN BY / EMP. NO. | CHECKED BY / EMP. NO. | WM APPROVED BY:     |                   |         |


| <i>WilsonMiller S</i> Stantec                                             |
|---------------------------------------------------------------------------|
| 6900 Professional Parkway East, Sarasota, FL 34240                        |
| Phone 941-907-6900 • Fax 941-907-6910                                     |
| Certificate of Authorization #43 • FL Lic. # LC-C000170 • www.stantec.com |


| CLIENT:  | MANATEE BOARD OF COUNTY COMMISSIONERS |
|----------|---------------------------------------|
| PROJECT: | BLACKSTONE PARK EXPANSION             |


| <b>-</b> | DATE:<br>DECEI | MBER    | 2012 | TITLE: |           |      |      |  |  |  |
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| 10.011   | 11             | 34S     | 17E  |        |           |      |      |  |  |  |

| TYPICAL BALL              | FIELD PLAN                |
|---------------------------|---------------------------|
| CROSS REFERENCE FILE NO.: | PROJECT NUMBER: 215611237 |

| DANIEL J. BOND, P.E.<br>FLORIDA LICENSE NO. 57969 |
|---------------------------------------------------|
| INDEX NUMBER:                                     |
| D-215611237-014                                   |
| SHEET NUMBER:                                     |
| 14 of 19                                          |

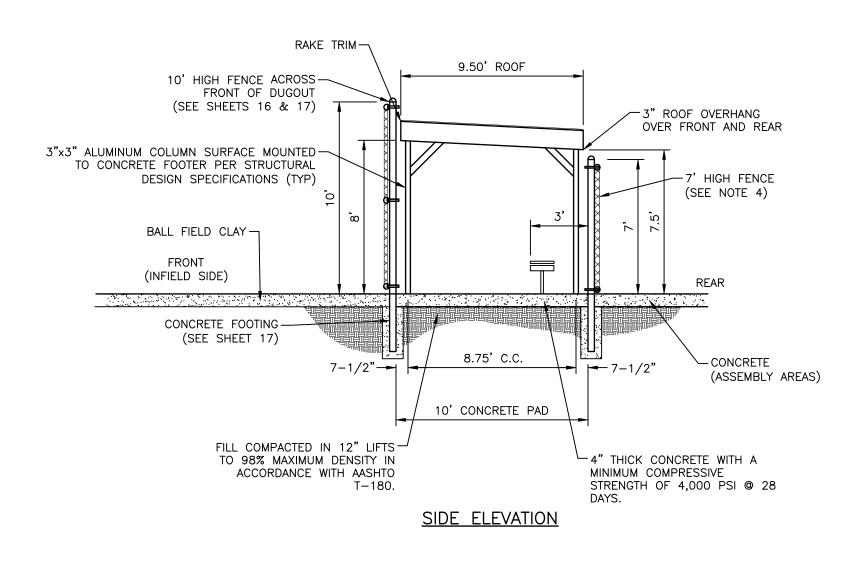

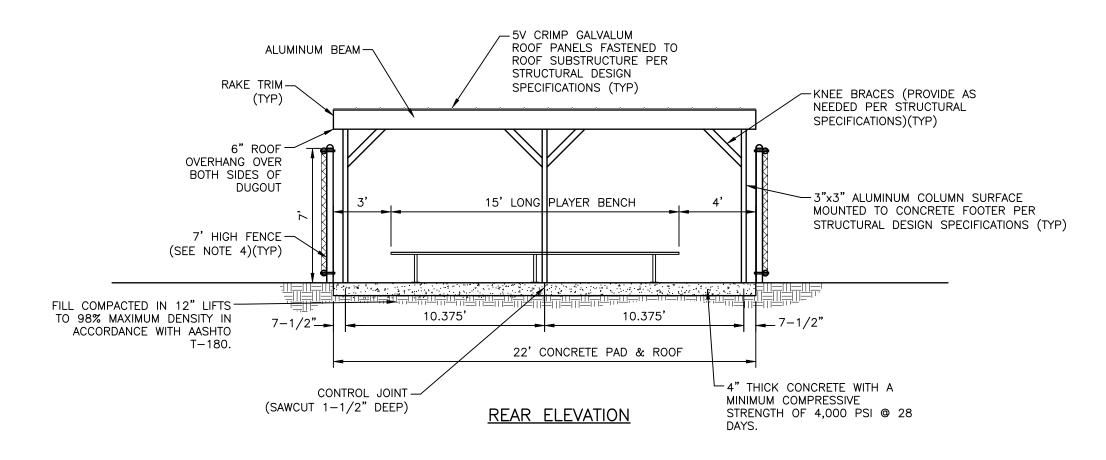


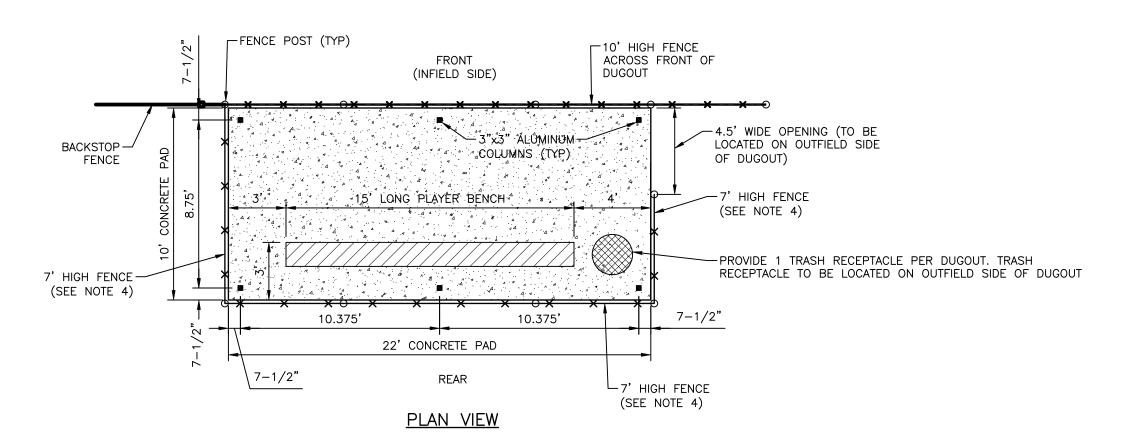



- 1. DUGOUT CANOPY DETAILS ARE PROVIDED FOR INFORMATIONAL PURPOSES ONLY FOR BASIS OF BID. DUGOUT CANOPIES TO CONSIST OF LIGHT ALUMINUM MATERIALS SIMILAR TO A CARPORT/CANOPY STRUCTURE AS MANUFACTURED BY ELLENTON ROOF AND ALUMINUM, INC. (OR APPROVED ALTERNATE). ALL MATERIALS SHALL BE IN WHITE COLOR. CONTRACTOR IS RESPONSIBLE TO PROVIDE SIGNED AND SEALED STRUCTURAL DRAWINGS/DESIGN CALCULATIONS FOR THE CANOPY STRUCTURES AND SHALL INCLUDE PERMITTING THROUGH THE CITY OF PALMETTO (IF REQUIRED). CONTRACTOR TO CONFIRM FOOTING REQUIREMENTS FOR THE DUGOUT CANOPY COLUMNS PRIOR TO POURING THE CONCRETE PAD.
- 2. ALL HARDWARE SHALL BE STAINLESS STEEL OR GALVANIZED.
- 3. REFER TO SHEET 5 FOR DUGOUT PAD LOCATIONS (6 TOTAL).
- 4. CONTRACTOR TO INSTALL 6' HIGH WINDSCREEN MOUNTED ALONG THE EXTERIOR OF THE 7' HIGH DUGOUT FENCING (37 LF TOTAL PER DUGOUT). BOTTOM OF WINDSCREEN SHALL BE 6" ABOVE FINISH GRADE.

# **SPECIFICATIONS:**

- 1. WINDSCREENS: BSN SPORTS POLYESTER OUTFIELD WINDSCREEN (1170610)- ROYAL BLUE IN COLOR (OR APPROVED ALTERNATE). WINDSCREEN SHALL BE MOUNTED TO FENCING USING 7" SELF-LOCK TIE WRAPS (MTTWRAPS) EVERY 12" TO 18" PER MANUFACTURER'S RECOMMENDATIONS.
- 2. ALL TRASH RECEPTACLES TO BE 32 GALLON RECEPTACLE-PORTABLE BY WABASH VALLEY MANUFACTURING, INC. (LR300D) OR APPROVED ALTERNATE. TRASH RECEPTACLES SHALL HAVE A ROUND DOME TOP LID (DT100) AND A 32 GALLON LINER (LR310). ALL MATERIALS SHALL BE BLACK IN COLOR. CONTRACTOR TO SECURE TRASH RECEPTACLES DIRECTLY TO CONCRETE PER MANUFACTURER'S RECOMMENDATIONS. ALL HARDWARE SHALL BE STAINLESS STEEL OR GALVANIZED.
- 3. PLAYER BENCH: 15' PLAYER BENCH WITHOUT BACK SURFACE MOUNT BY WABASH VALLEY MANUFACTURING, INC. (SG443D) OR APPROVED EQUAL. BENCH SHALL HAVE SMALL MOUNTING PLATE COVERS (SC203). ALL MATERIALS SHALL BE BLACK IN COLOR. CONTRACTOR TO SECURE SURFACE MOUNT BENCH TÒ CONCRETE PER MANUFACTURER'S RECOMMENDATIONS. ALL HARDWARE TO BE STAINLESS STEEL OR GALVANIZED.

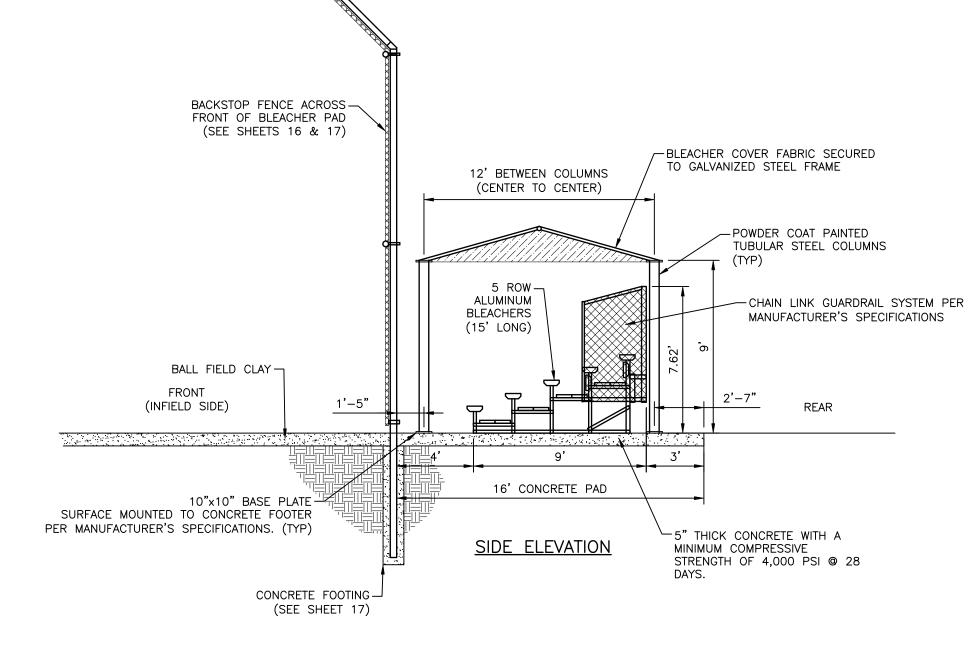

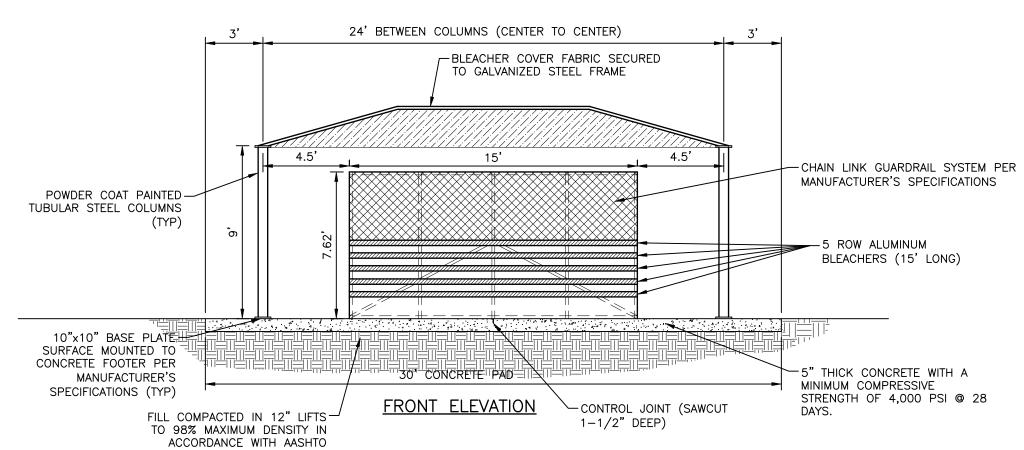

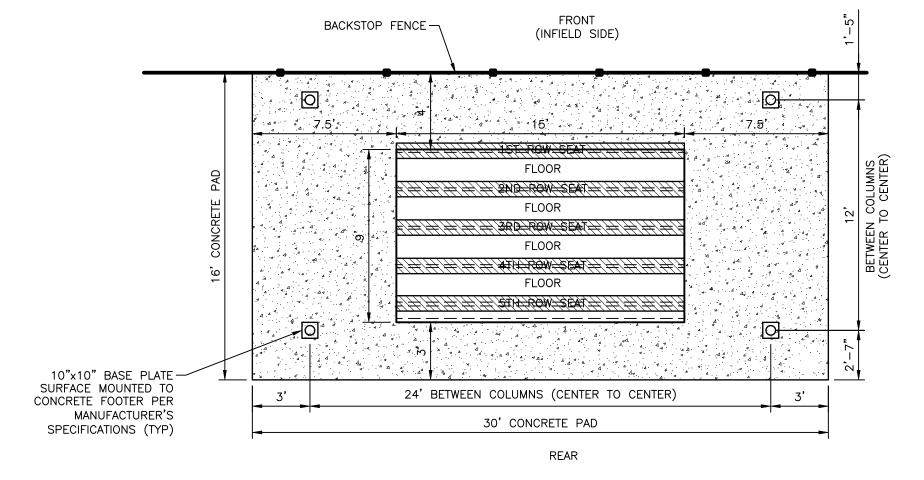

# PLAN VIEW


- 1. INSTALL ALL ITEMS PER MANUFACTURER'S SPECIFICATIONS. CONTRACTOR IS RESPONSIBLE TO PROVIDE SIGNED AND SEALED ENGINEERING DRAWINGS/DESIGN CALCULATIONS FOR THE BLEACHER COVERS AND SHALL INCLUDE PERMITTING THROUGH THE CITY OF PALMETTO (IF REQUIRED). CONTRACTOR TO CONFIRM FOOTING REQUIREMENTS FOR THE BLEACHER COVER COLUMNS PRIOR TO POURING THE CONCRETE PAD.
- 2. ALL HARDWARE SHALL BE STAINLESS STEEL OR GALVANIZED.
- 3. REFER TO SHEET 5 FOR BLEACHER PAD LOCATIONS (6 TOTAL).

# **SPECIFICATIONS:**

- 1. BLEACHERS (50 SEAT CAPACITY): BSN SPORTS 5 ROW 15' PREFERED BLEACHER (NB0515P) OR APPROVED ALTERNATE. BLEACHER TO HAVE DOUBLE FOOT PLANKS AND A RISER BOARD ON ALL ROWS, A CHAIN LINK GUARDRAIL SYSTEM, AND SAFETY END CAPS ON ALL ROWS.
- 2. BLEACHER COVER: 12' WIDE BY 24' LONG BLEACHER COVER BY APOLLO SUNGUARD SYSTEMS, INC. OR APPROVED ALTERNATE. FABRIC COLOR SHALL BE ROYAL BLUE WITH GALVANIZED FRAME. COLUMNS TO BE BLACK POWDER COAT PAINTED TUBULAR STEEL. COLUMNS SHALL BE SURFACE MOUNTED IN ACCORDANCE WITH MANUFACTURER'S SPECIFICATIONS (SEE NOTE 1).

|                   |                         |                        | ACTIVITY           | INITIALS/EMP. NO. | . DATE  |                                                                           | CLIENT:  | MANATEE BOARD OF             | DATE: TITL                       | <br>_E:                      |                                         |
|-------------------|-------------------------|------------------------|--------------------|-------------------|---------|---------------------------------------------------------------------------|----------|------------------------------|----------------------------------|------------------------------|-----------------------------------------|
|                   | <u> </u>                |                        | DESIGNED BY:       |                   |         | WilsonMiller Sa Stantec                                                   |          | COUNTY COMMISSIONERS         | DECEMBER 2012  HORIZONTAL SCALE: | DUCCUIT AND DUCACHED DETAILS | DANIEL J. BOND, P.E.                    |
|                   |                         |                        | DRAWN BY:          | CLL/096591        | 12/2012 | <i>WilsonMiller Se</i> Stantec                                            |          | COUNTY COMMISSIONERS         | AS SHOWN VERTICAL SCALE:         | DUGOUT AND BLEACHER DETAILS  | FLORIDA LICENSE NO. 57969 INDEX NUMBER: |
|                   |                         |                        | CONTRACT ADMIN. BY | /:                |         | 6900 Professional Parkway East, Sarasota, FL 34240                        | PROJECT: | DIACKSTONE DADIK EVDANISIONI | AS SHOWN                         |                              | D-215611237-015                         |
| △REV NO. REVISION | DATE DRAWN BY / EMP. NO | . CHECKED BY / EMP. NO | 0. WM APPROVED BY: |                   |         | Certificate of Authorization #43 • FL Lic. # LC-C000170 • www.stantec.com |          | BLACKSTONE PARK EXPANSION    | 11 34S 17E                       | PROJECT NUMBER:  215611237   | 15 of 19                                |

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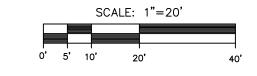

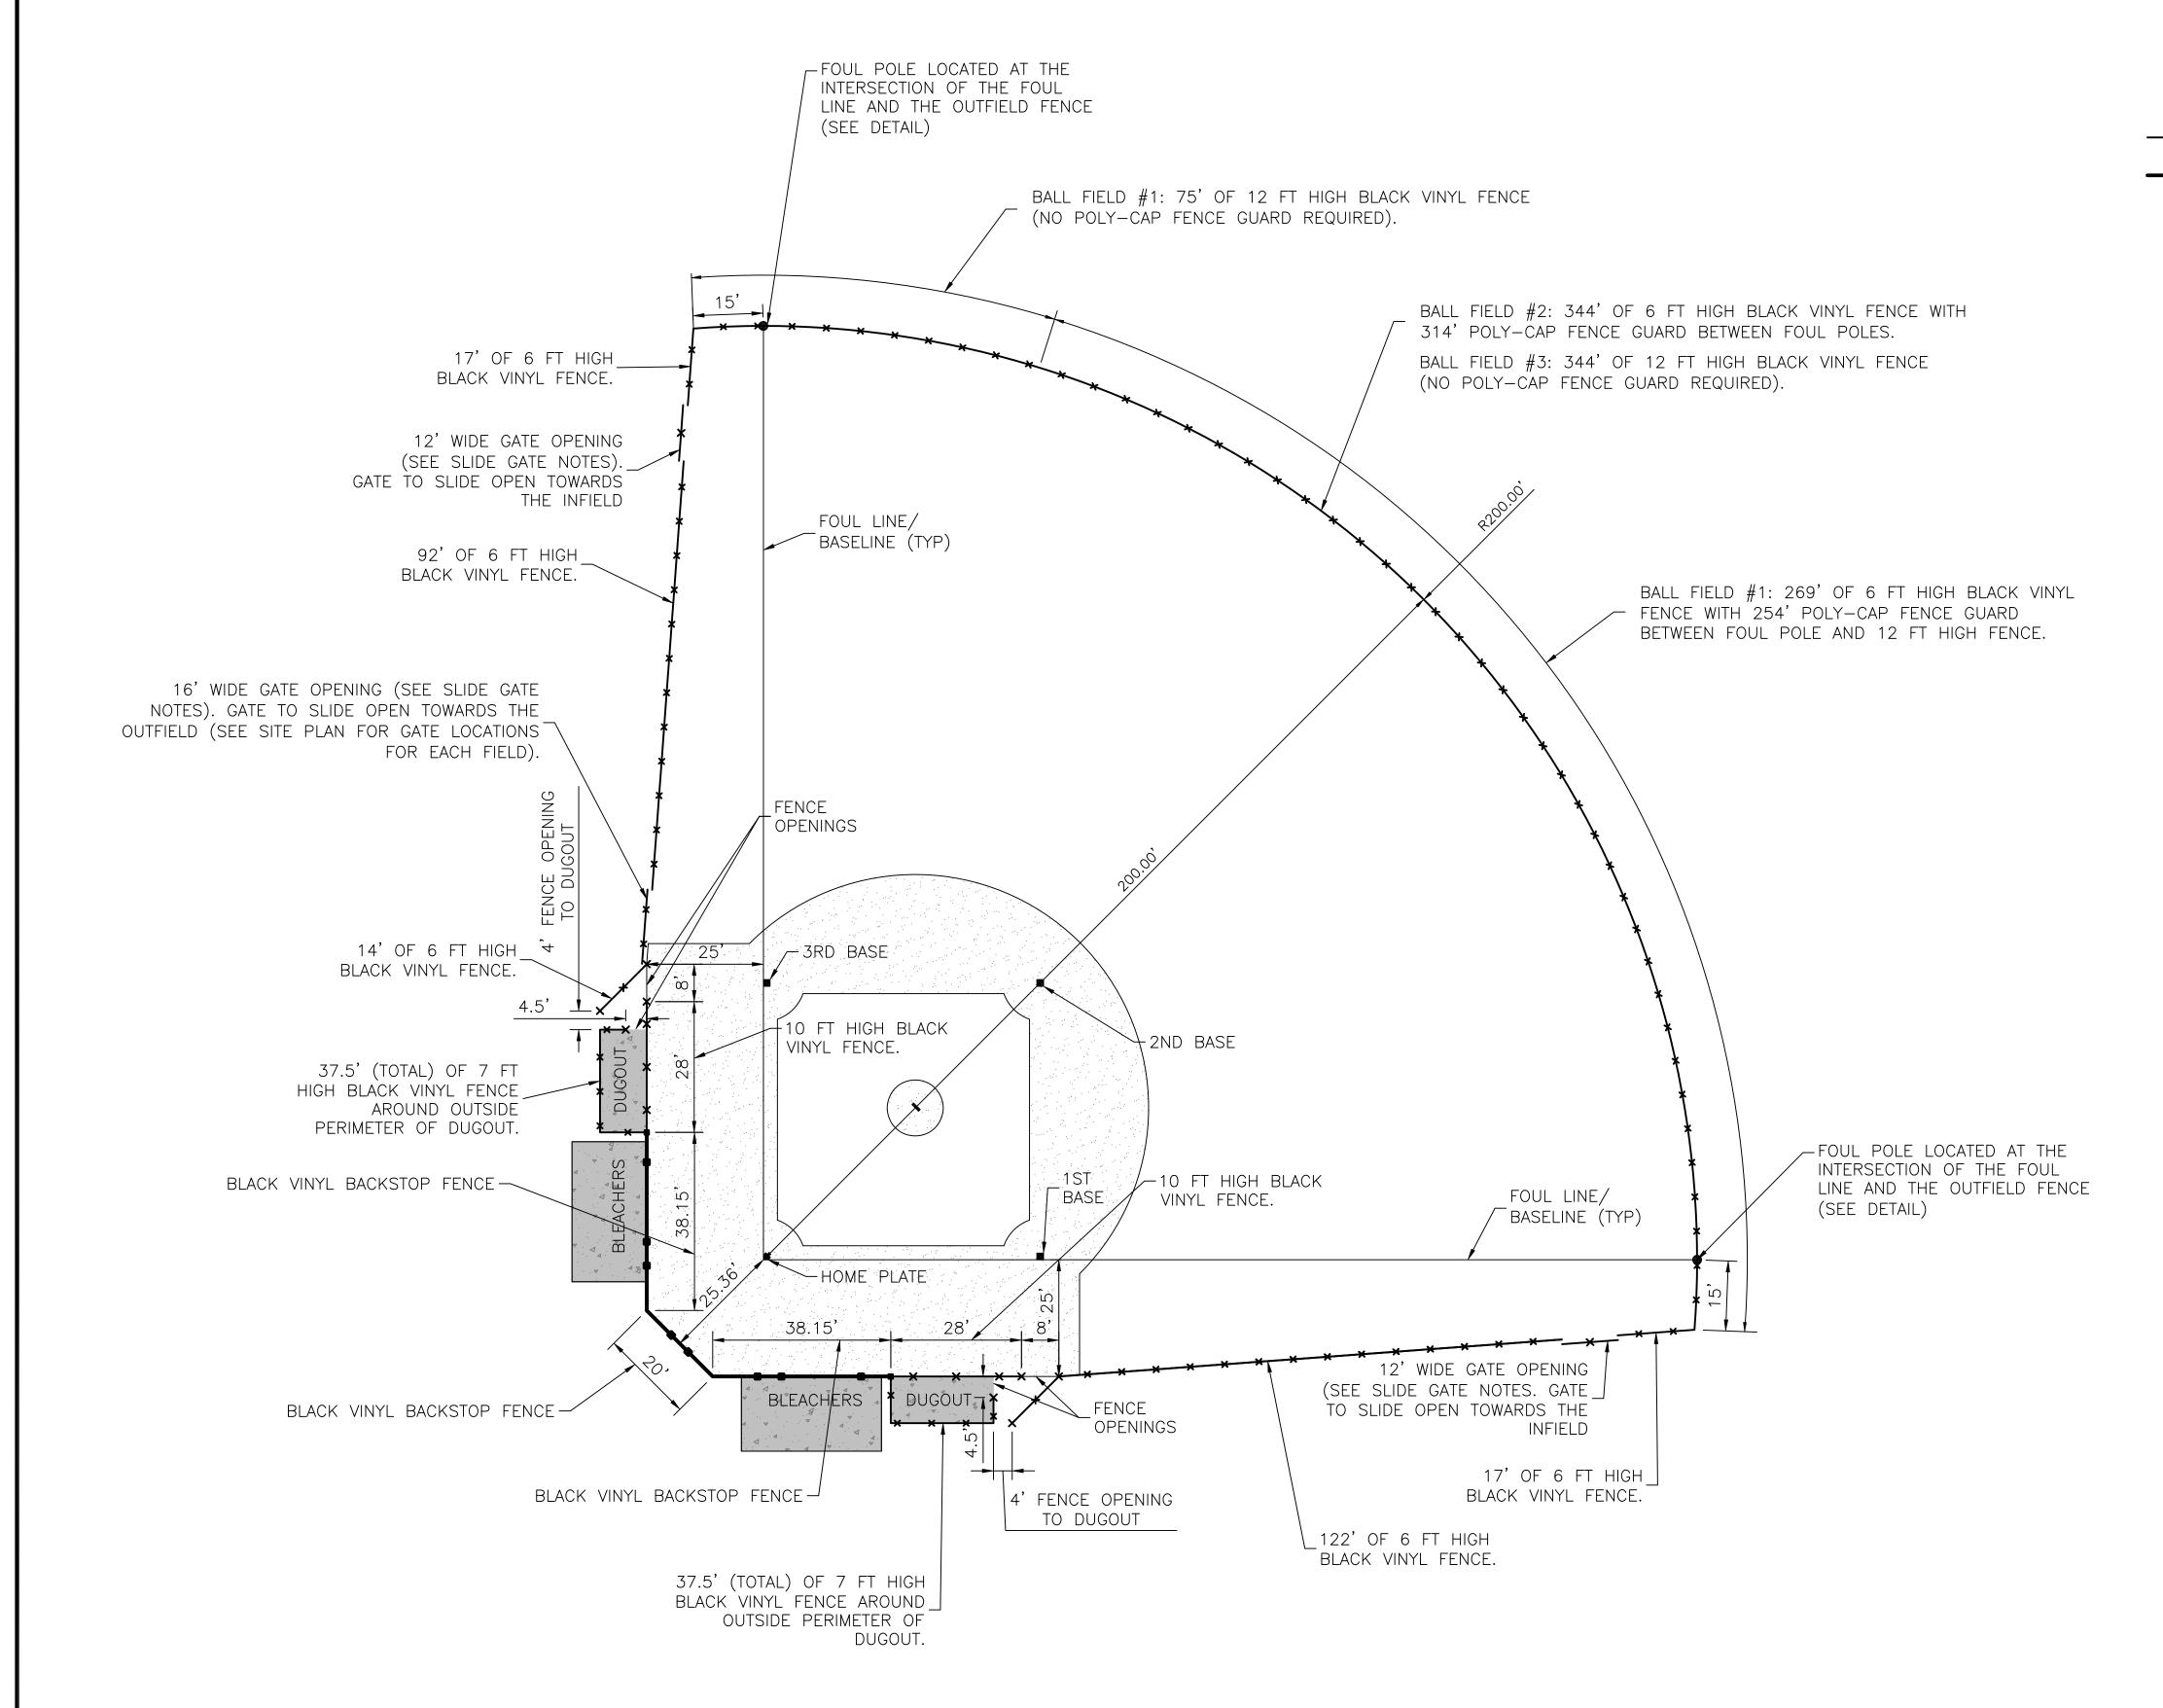
# **LEGEND:**

INFIELD CLAY








BLACK VINYL BACKSTOP FENCE

# **FENCING NOTES:**

- 1. SEE SHEET 17 FOR ALL FENCING DETAILS.
- 2. CONTRACTOR SHALL SUBMIT SHOP DRAWINGS OF ALL FENCING COMPONENTS TO THE ENGINEER AND COUNTY FOR REVIEW. SHOP DRAWINGS TO INCLUDE SIZE AND DIMENSIONS OF ALL FENCING.
- 3. POLY-CAP FENCE GUARD: BSN SPORTS POLY-CAP FENCE GUARD YELLOW, BBPC250X (OR APPROVED ALTERNATE). POLY-CAP FENCE GUARD SHALL BE SECURED TO FENCE USING POLY-CAP YELLOW 18" TIE WRAPS (BBPCTIES) EVERY 3' PER MANUFACTURER'S RECOMMENDATIONS.

# **SLIDE GATE NOTES:**

- 1. GATES FOR ALL GATE OPENINGS SHALL BE CANTILEVER SLIDE GATES PER FDOT INDEX #803. BARB WIRE SHALL NOT BE INSTALLED AS PART OF THE GATE. HEIGHT OF THE GATE TO BE COMPATIBLE WITH 6' HIGH FENCE.
- 2. GATE COMPONENTS SHALL BE GALVANIZED AND BLACK VINYL COATED INCLUDING ALL FABRIC, POSTS, AND OTHER APPURTENANCES.
- 3. UNLESS OTHERWISE SPECIFIED, THE TOP OF ALL CONCRETE FOOTINGS SHALL BE SET A MINIMUM OF 4" BELOW GRADE AND SHALL NOT BE EXPOSED TO THE SURFACE.
- 4. SLIDE GATES SHALL BE SECURED TO FENCE END POSTS UTILIZING AN OFFSET LOK'N LATCH.
- 5. ROLLERS AND BACK FRAMES FOR THE SLIDE GATES SHALL BE LOCATED ON THE EXTERIOR OF THE BALL FIELDS.
- 6. ALL FABRIC SHALL BE KNUCKLED TOP AND BOTTOM SELVAGES.
- 7. CONTRACTOR SHALL SUBMIT SHOP DRAWINGS OF ALL GATE COMPONENTS TO THE ENGINEER AND COUNTY FOR REVIEW. SHOP DRAWINGS TO INCLUDE SIZE AND DIMENSIONS OF ALL GATES.

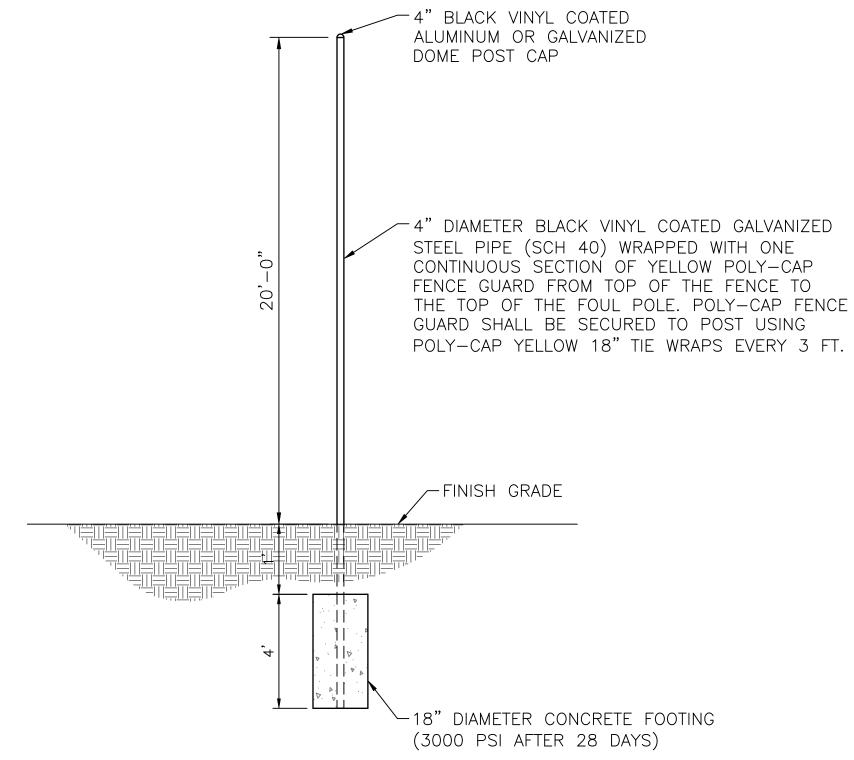

NOTES:

1. FOUL POLE SHALL BE INCLUDED AS ONE OF THE OUTFIELD FENCE POSTS. CONTRACTOR TO ADJUST FENCE POST SPACING ACCORDINGLY.

FOUL POLE DETAIL


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|          |          |      |                     |                       | DRAWN BY:           | CLL/096591        | 12/2012 |  |
|          |          |      |                     |                       | CHECKED BY:         |                   |         |  |
|          |          |      |                     |                       | CONTRACT ADMIN. BY: |                   |         |  |
| △REV NO. | REVISION | DATE | DRAWN BY / EMP. NO. | CHECKED BY / EMP. NO. | WM APPROVED BY:     |                   |         |  |

| WilsonMiller S Stantec                                                    |
|---------------------------------------------------------------------------|
| 6900 Professional Parkway East, Sarasota, FL 34240                        |
| Phone 941-907-6900 ● Fax 941-907-6910                                     |
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| CLIENT:  | MANATEE BOARD OF          | DECEMBER 2012 HORIZONTAL SCALE: AS SHOWN            |
|----------|---------------------------|-----------------------------------------------------|
| PROJECT: | BLACKSTONE PARK EXPANSION | VERTICAL SCALE:  AS SHOWN SEC: TWP: RGE: 11 34S 17E |

| TITLE:                    |                 |                                                   |
|---------------------------|-----------------|---------------------------------------------------|
| BALL FIELD F              | ENCING PLAN     | DANIEL J. BOND, P.E.<br>FLORIDA LICENSE NO. 57969 |
|                           |                 | INDEX NUMBER:                                     |
|                           |                 | D-215611237-016                                   |
| CROSS REFERENCE FILE NO.: | PROJECT NUMBER: | SHEET NUMBER:                                     |
|                           | 215611237       | 16 of 19                                          |

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# 10 FOOT AND 12 FOOT FENCE DETAIL

# GENERAL FENCING NOTES:

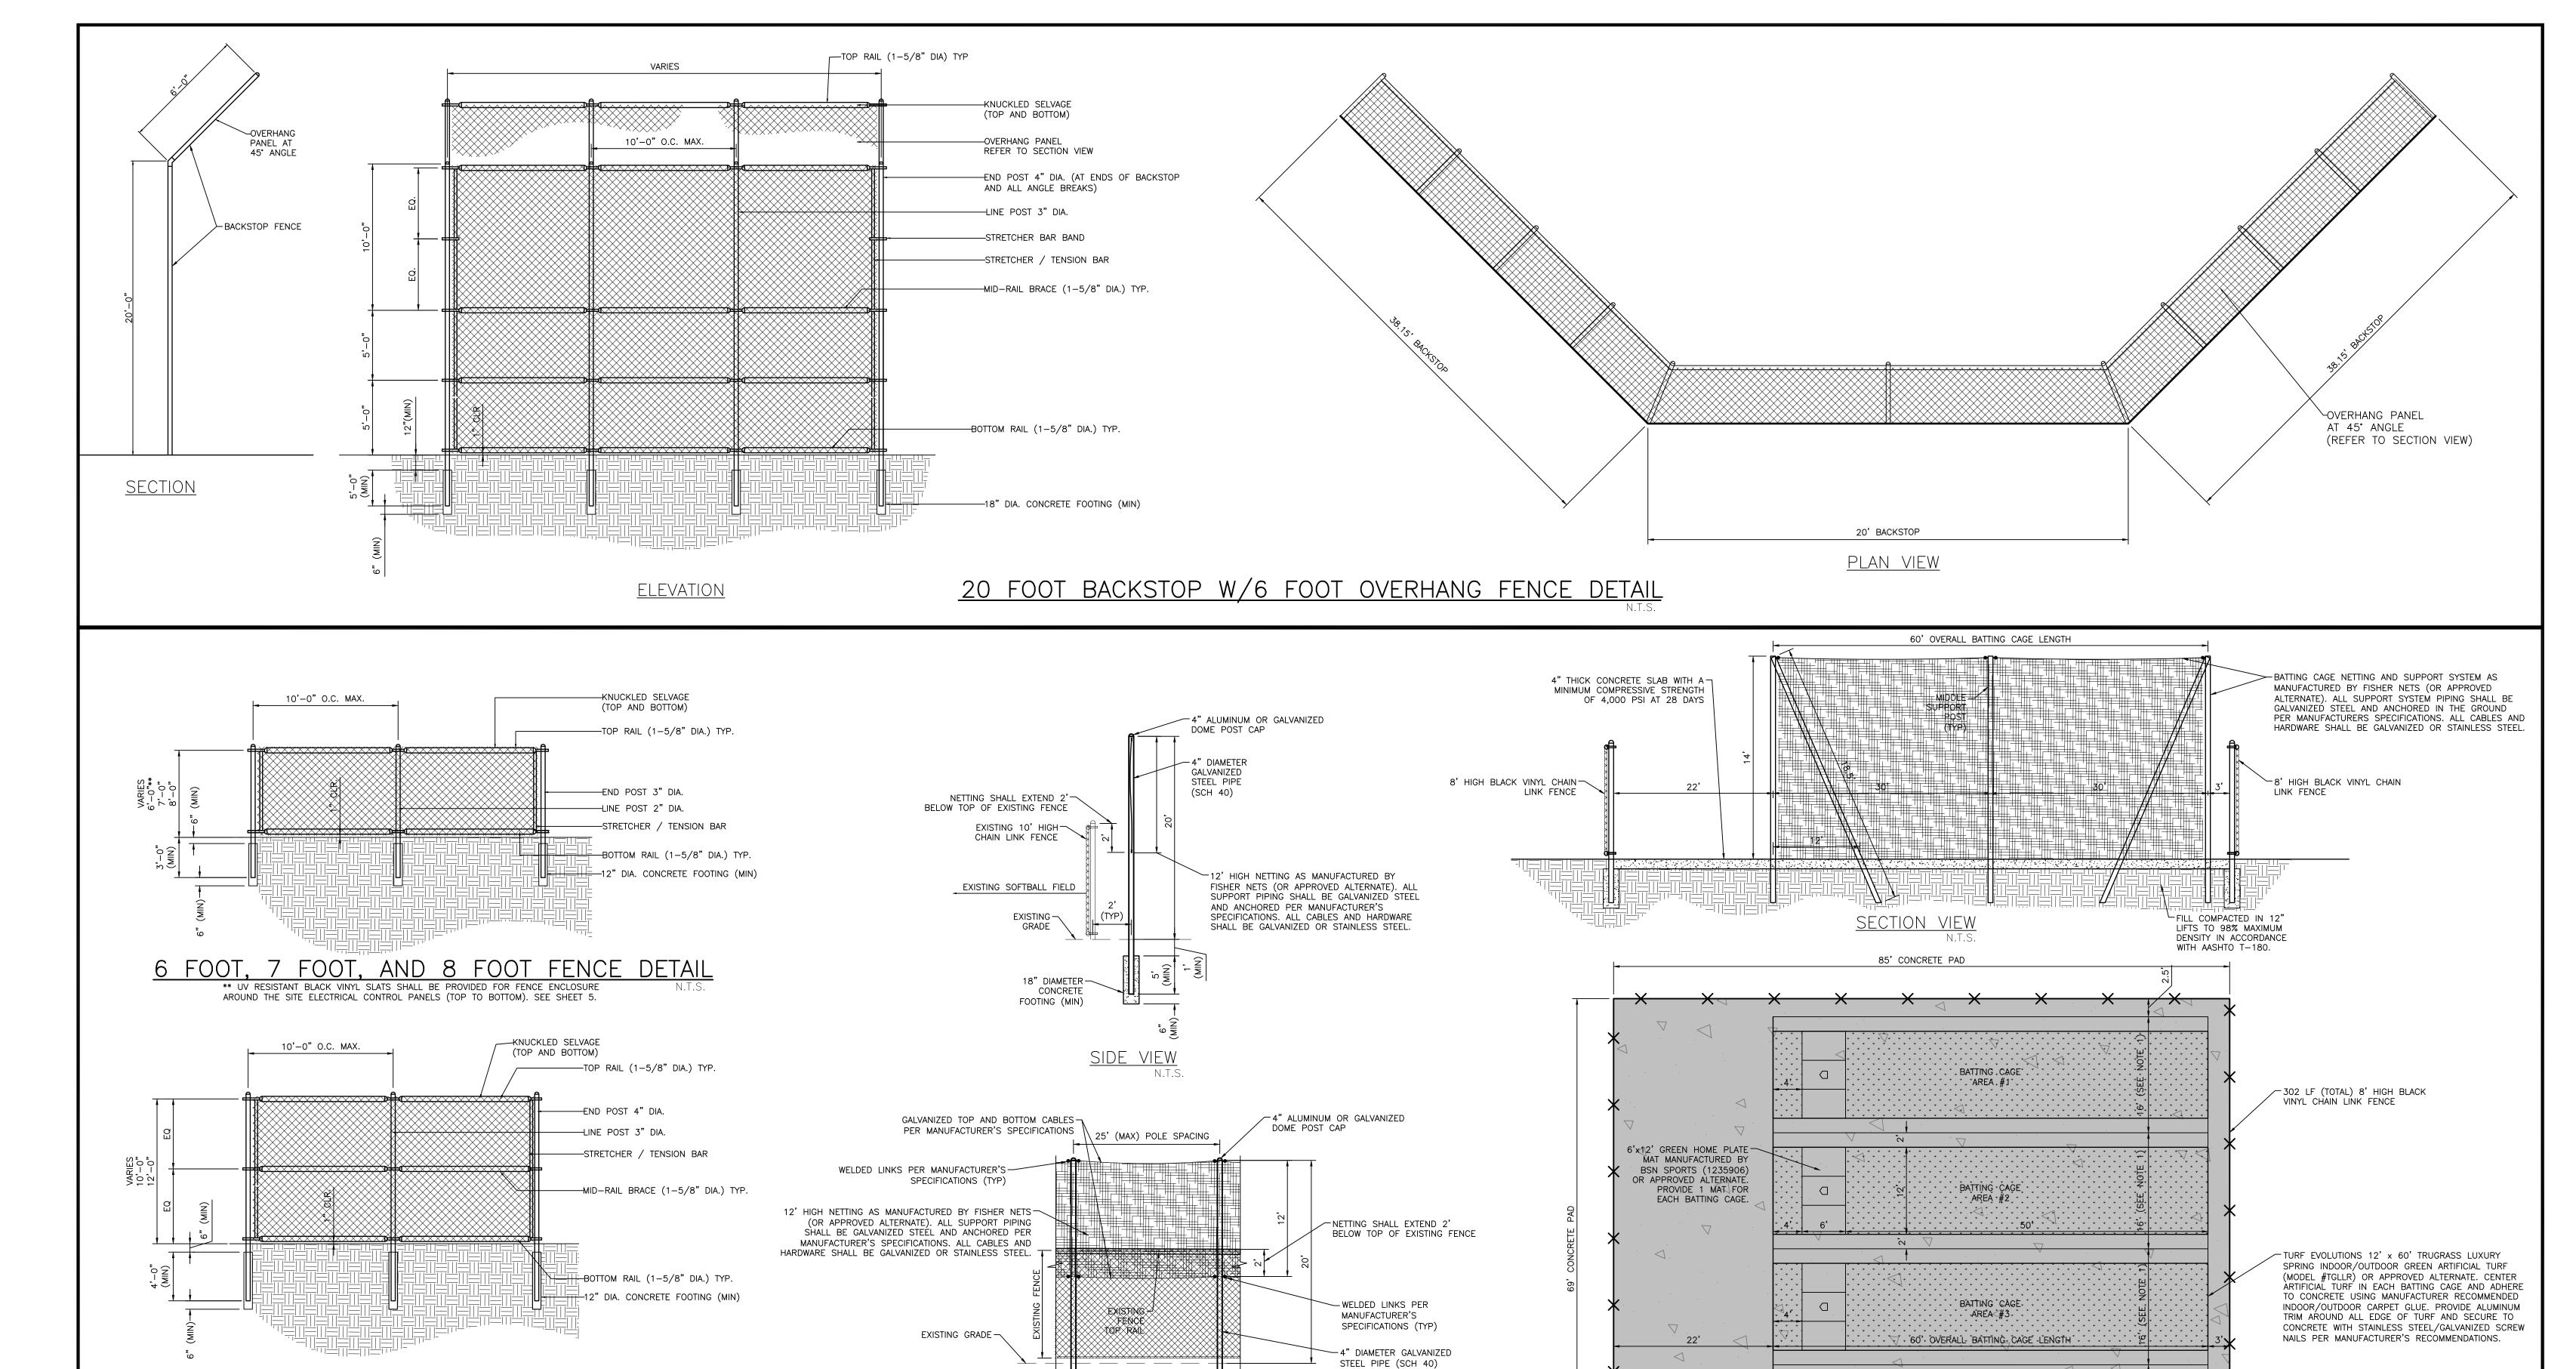воттом).

- 1. ALL FENCE POSTS AND RAILS SHALL BE LOCATED ON THE EXTERIOR SIDE OF THE FABRIC IN RELATION TO THE BALL
- 2. ALL FENCE FABRIC SHALL BE #9 GAUGE WIRE IN TWO INCH DIAMOND MESH PATTERN WITH KNUCKED SELVAGES (TOP AND
- 3. ALL FENCE AND GATE MATERIALS SHALL BE HOT-DIP GALVANIZED AFTER FABRICATION. FABRIC, POSTS, AND ALL OTHER APPURTENANCES SHALL HAVE A MINIMUM ZINC COATING OF 1.2 OUNCES PER SQUARE FOOT OF SURFACE, AND FUSED AND BONDED WITH BLACK VINYL MEETING THE REQUIREMENTS OF ASTM F668-11, CLASS 1. FABRIC TO BE SECURED TO LINE POST WITH #6 GAUGE ALUMINUM TIE WIRES.
- 4. CONCRETE FOR ALL FENCE POST FOOTINGS SHALL HAVE A MINIMUM COMPRESSIVE STRENGTH OF 3,000 PSI AT 28 DAYS.
- 5. CONTRACTOR SHALL SUBMIT SHOP DRAWINGS FOR ALL FENCE/GATE MATERIALS TO ENGINEER AND COUNTY FOR REVIEW.
  6. REFER TO SHEET 16 FOR FENCING LAYOUT AND DIMENSIONS.

|          |          |      |                     |                       | ACTIVITY            | INITIALS/EMP. NO. | DATE    | i |
|----------|----------|------|---------------------|-----------------------|---------------------|-------------------|---------|---|
|          |          |      |                     |                       | DESIGNED BY:        |                   |         | i |
|          |          |      |                     |                       | DRAWN BY:           | CLL/096591        | 12/2012 | i |
|          |          |      |                     |                       | CHECKED BY:         |                   |         | i |
|          |          |      |                     |                       | CONTRACT ADMIN. BY: |                   |         | i |
| △REV NO. | REVISION | DATE | DRAWN BY / EMP. NO. | CHECKED BY / EMP. NO. | WM APPROVED BY:     |                   |         | ı |

# Wilsonviller Stantec 6900 Professional Parkway East, Sarasota, FL 34240 Phone 941-907-6900 • Fax 941-907-6910 Certificate of Authorization #43 • FL Lic. # LC-C000170 • www.stantec.com

SAFETY NETTING DETAIL

| CLIENT:   | MANATEE BOARD OF          | DATE:            |
|-----------|---------------------------|------------------|
|           | WIN WIN THE BONTO OT      | DECEMBER 201     |
|           | COUNTY COMMISSIONERS      | HORIZONTAL SCALE |
|           | COUNTY COMMISSIONERS      | 1" = 30'         |
| DDO IECT. |                           | VERTICAL SCALE:  |
| PROJECT:  |                           | NA NA            |
|           | BLACKSTONE PARK EXPANSION | SEC: TWP: RGE    |
|           | DEACKSTONE TAKK EXTANSION | 11 3/5 17        |

TRASH RECEPTACLE 7

RECEPTACLE

8' HIGH X 6' WIDE BLACK VINYL COATED -

INDUSTRIAL SWING GATE WITH BLACK VINYL COATED FORK AND FORK CLAMP. ALL HARDWARE

HAVE KNUCKLED SELVAGES (TOP AND BOTTOM).

TO BE STAINLESS STEEL OR GALVANIZED. GATE TO

| 2012<br>ALE:<br>' | AND BATTING                | NCING, NETTING,<br>CAGE DETAILS | DANIEL J. BOND, P.E. FLORIDA LICENSE NO. 57969 INDEX NUMBER: D-215611237-017 |
|-------------------|----------------------------|---------------------------------|------------------------------------------------------------------------------|
| RGE:              | CROSS REFERENCE FILE NO .: | PROJECT NUMBER:                 | SHEET NUMBER:                                                                |

, "AREA" ,#4°

11 34S 17E

BATTING CAGE DETAILS

BETWEEN CAGES.

1. THE BATTING CAGE NETTING SHALL BE A MINIMUM


2. THE CONCRETE PAD FOR THE BATTING CAGES


OF 1-1/2" DEEP EVERY 10' C.C.E.W.


WIDTH OF 15' FOR EACH BATTING CAGE. BATTING


CAGE FRAMING SYSTEM TO BE SPACED AT 16' C.C.


SHALL HAVE CONTROL JOINTS SAWCUT A MINIMUM

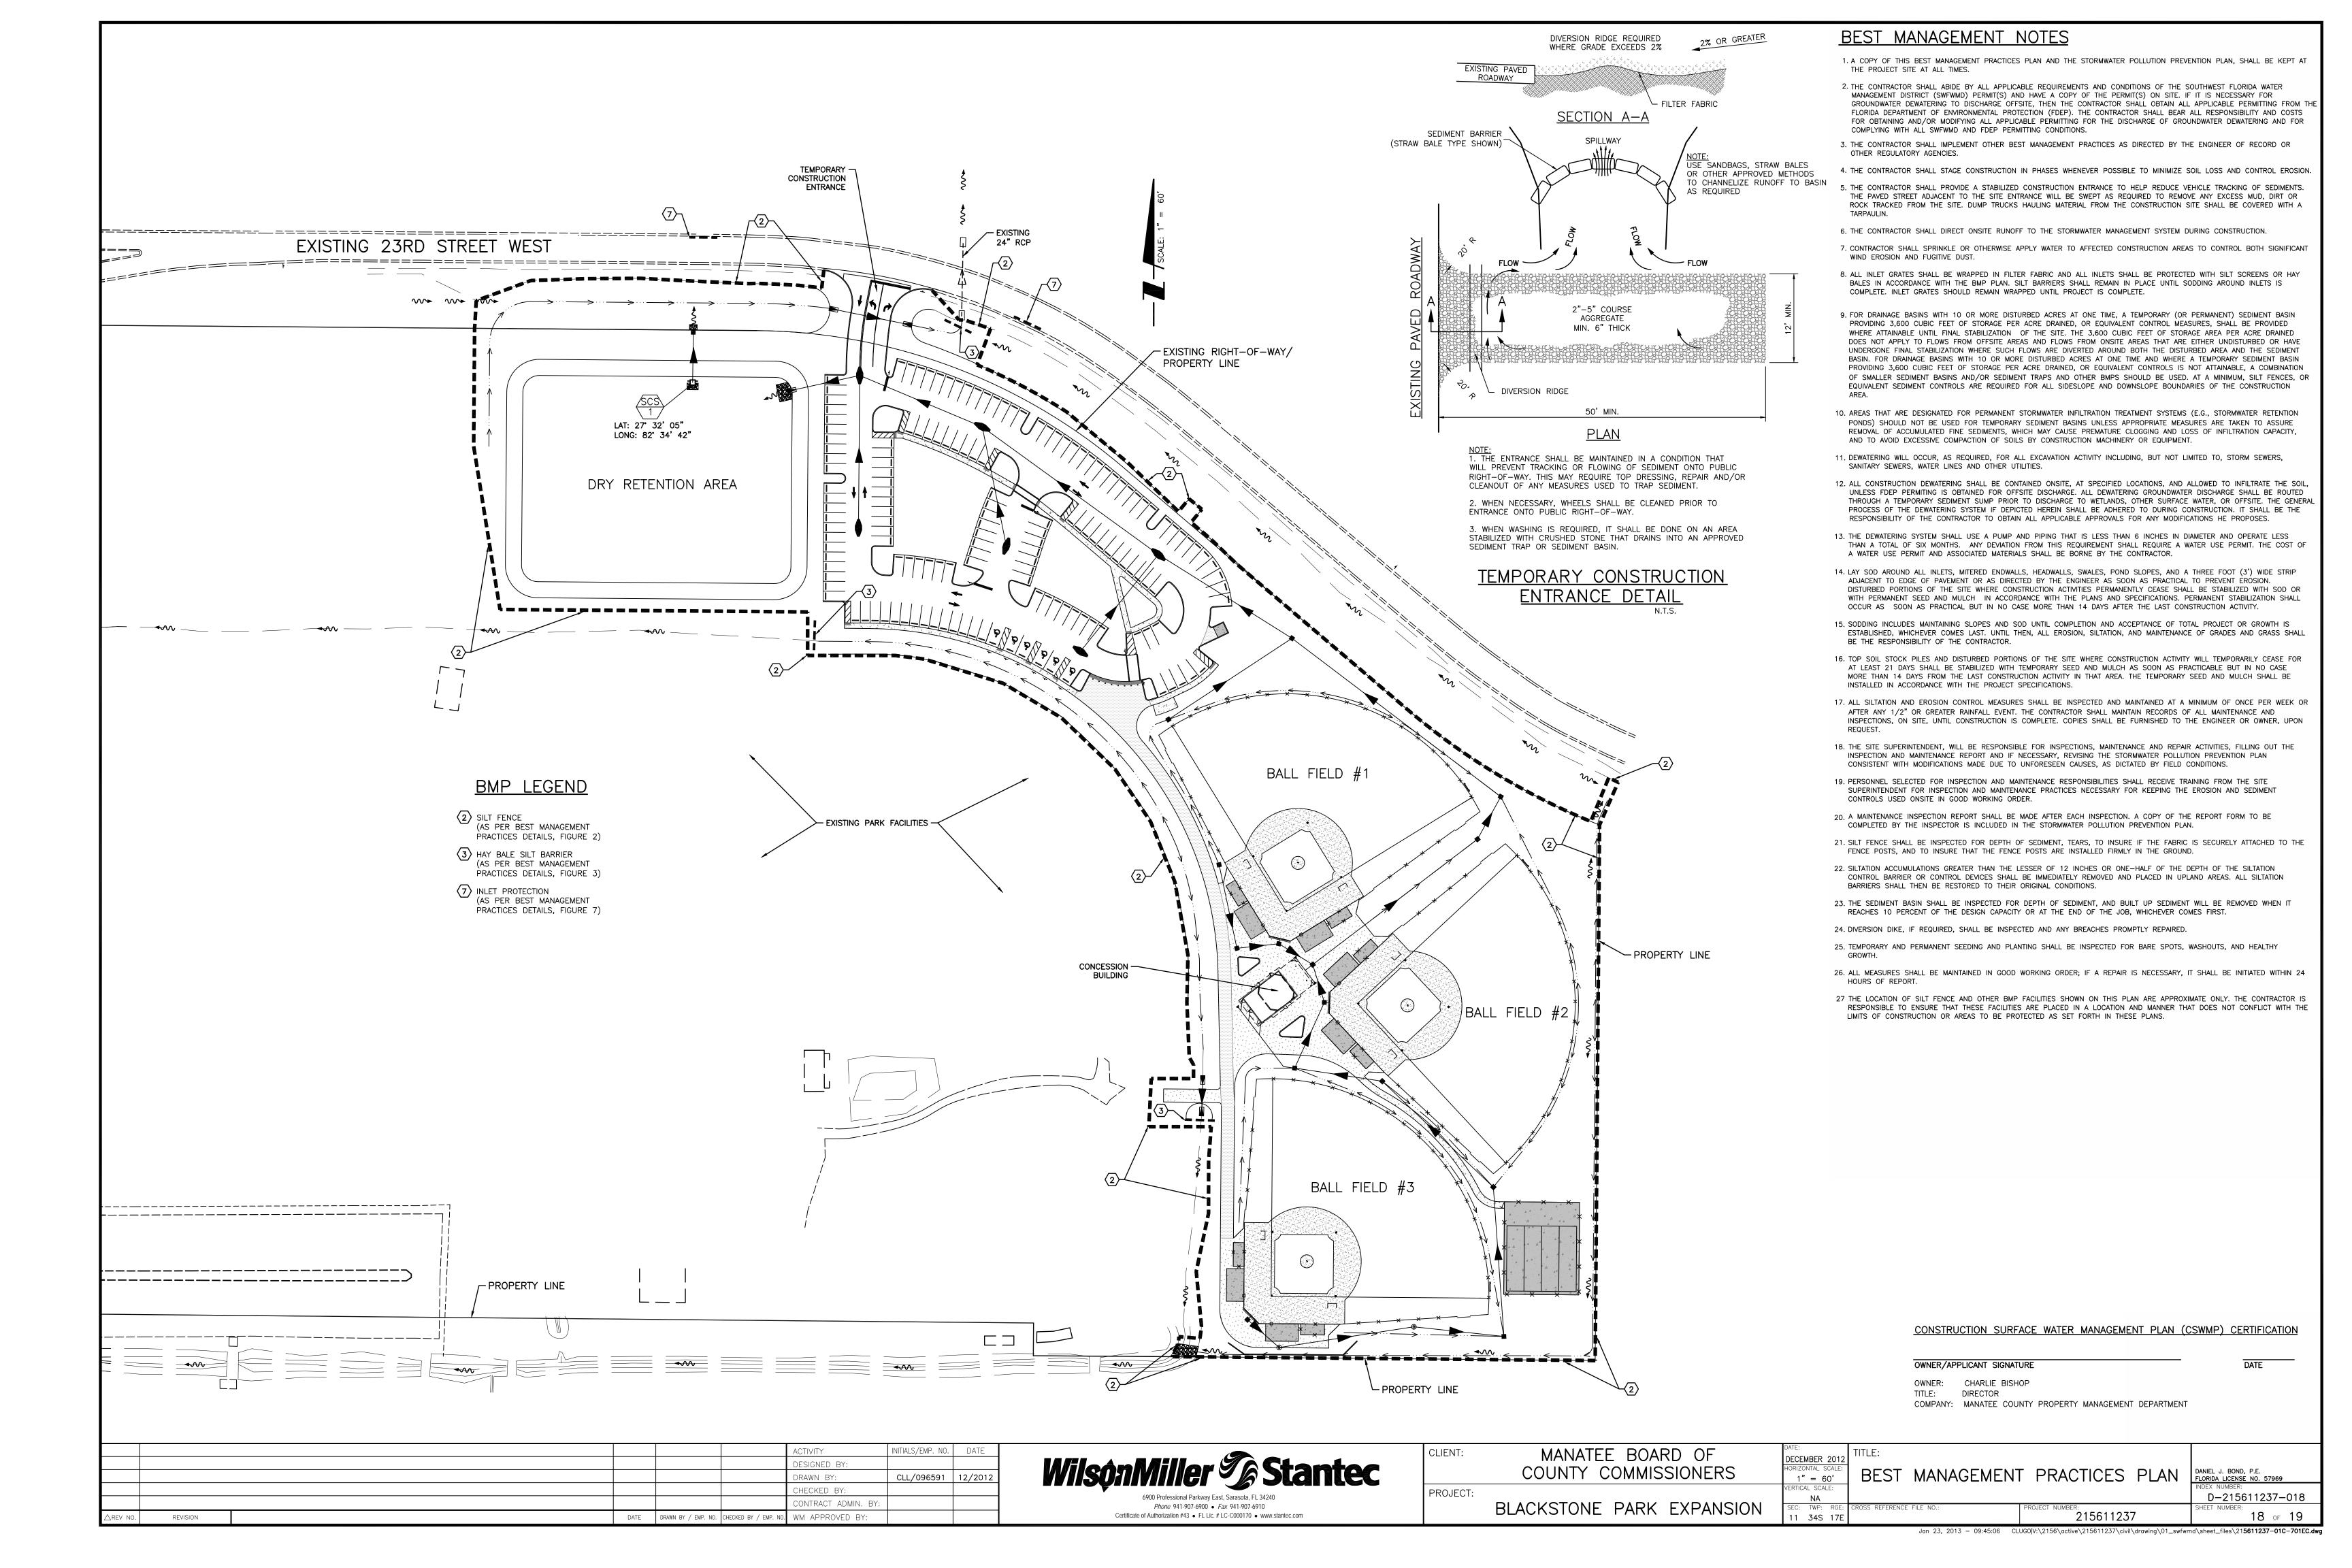


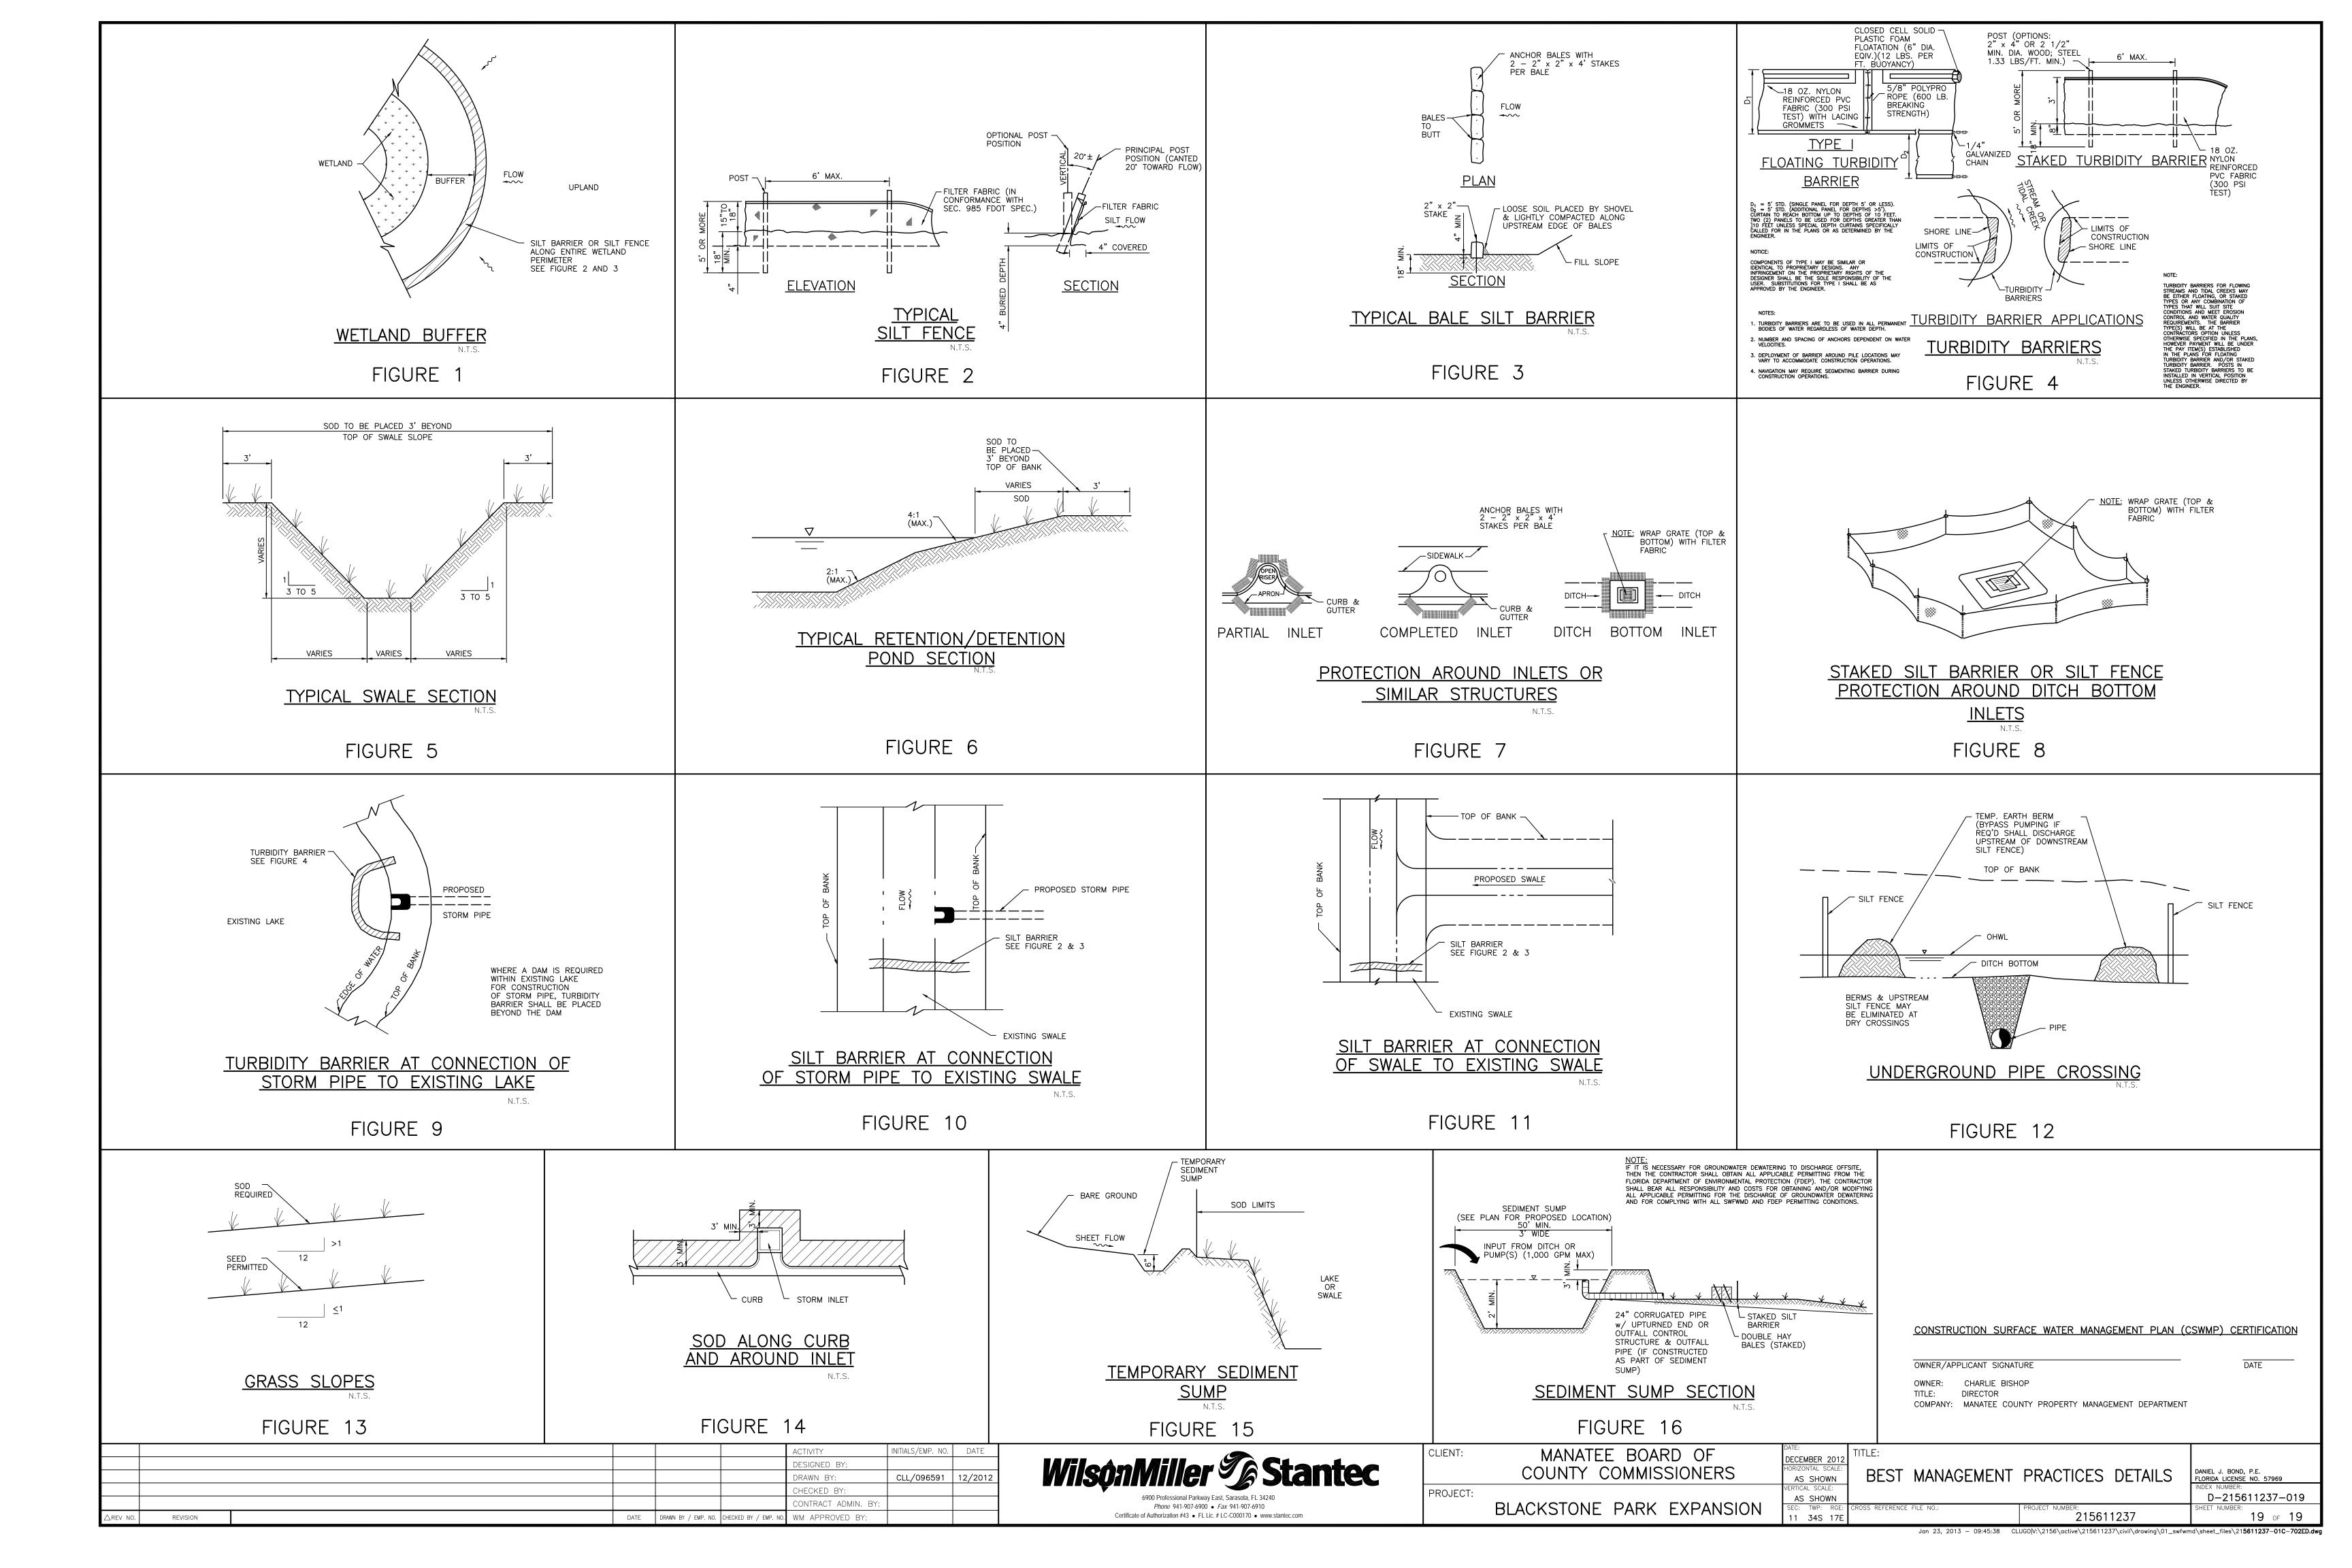


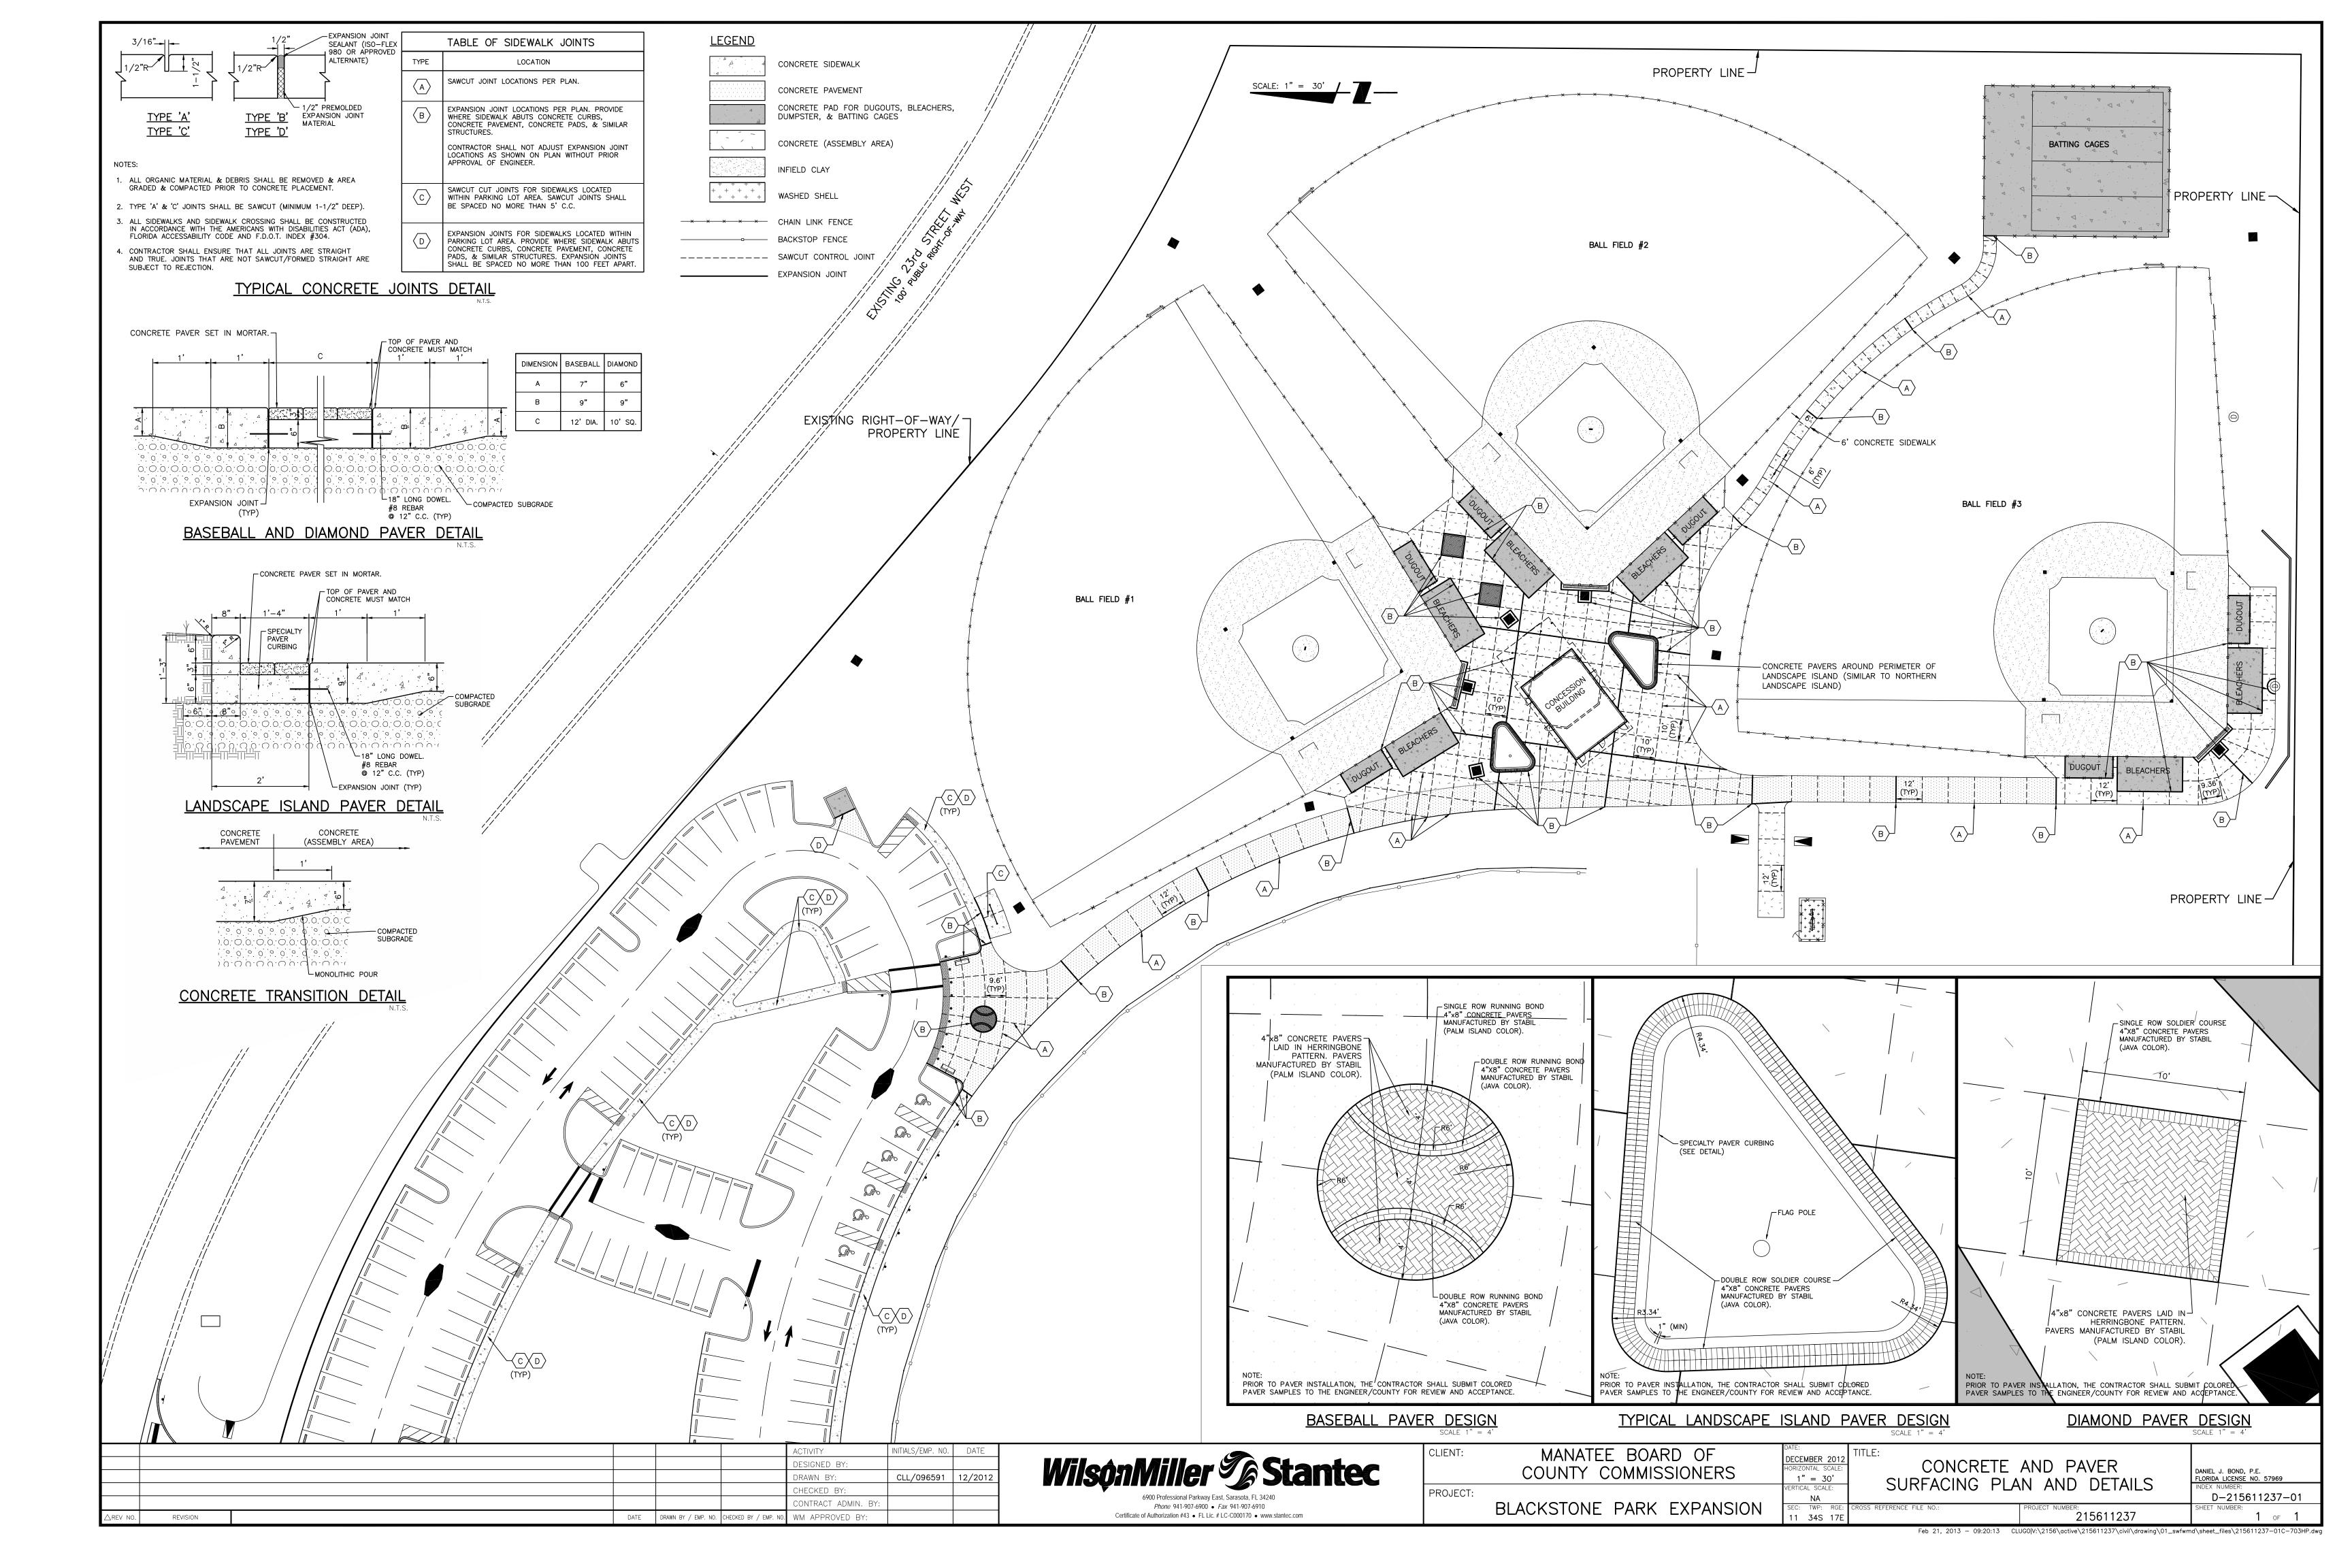


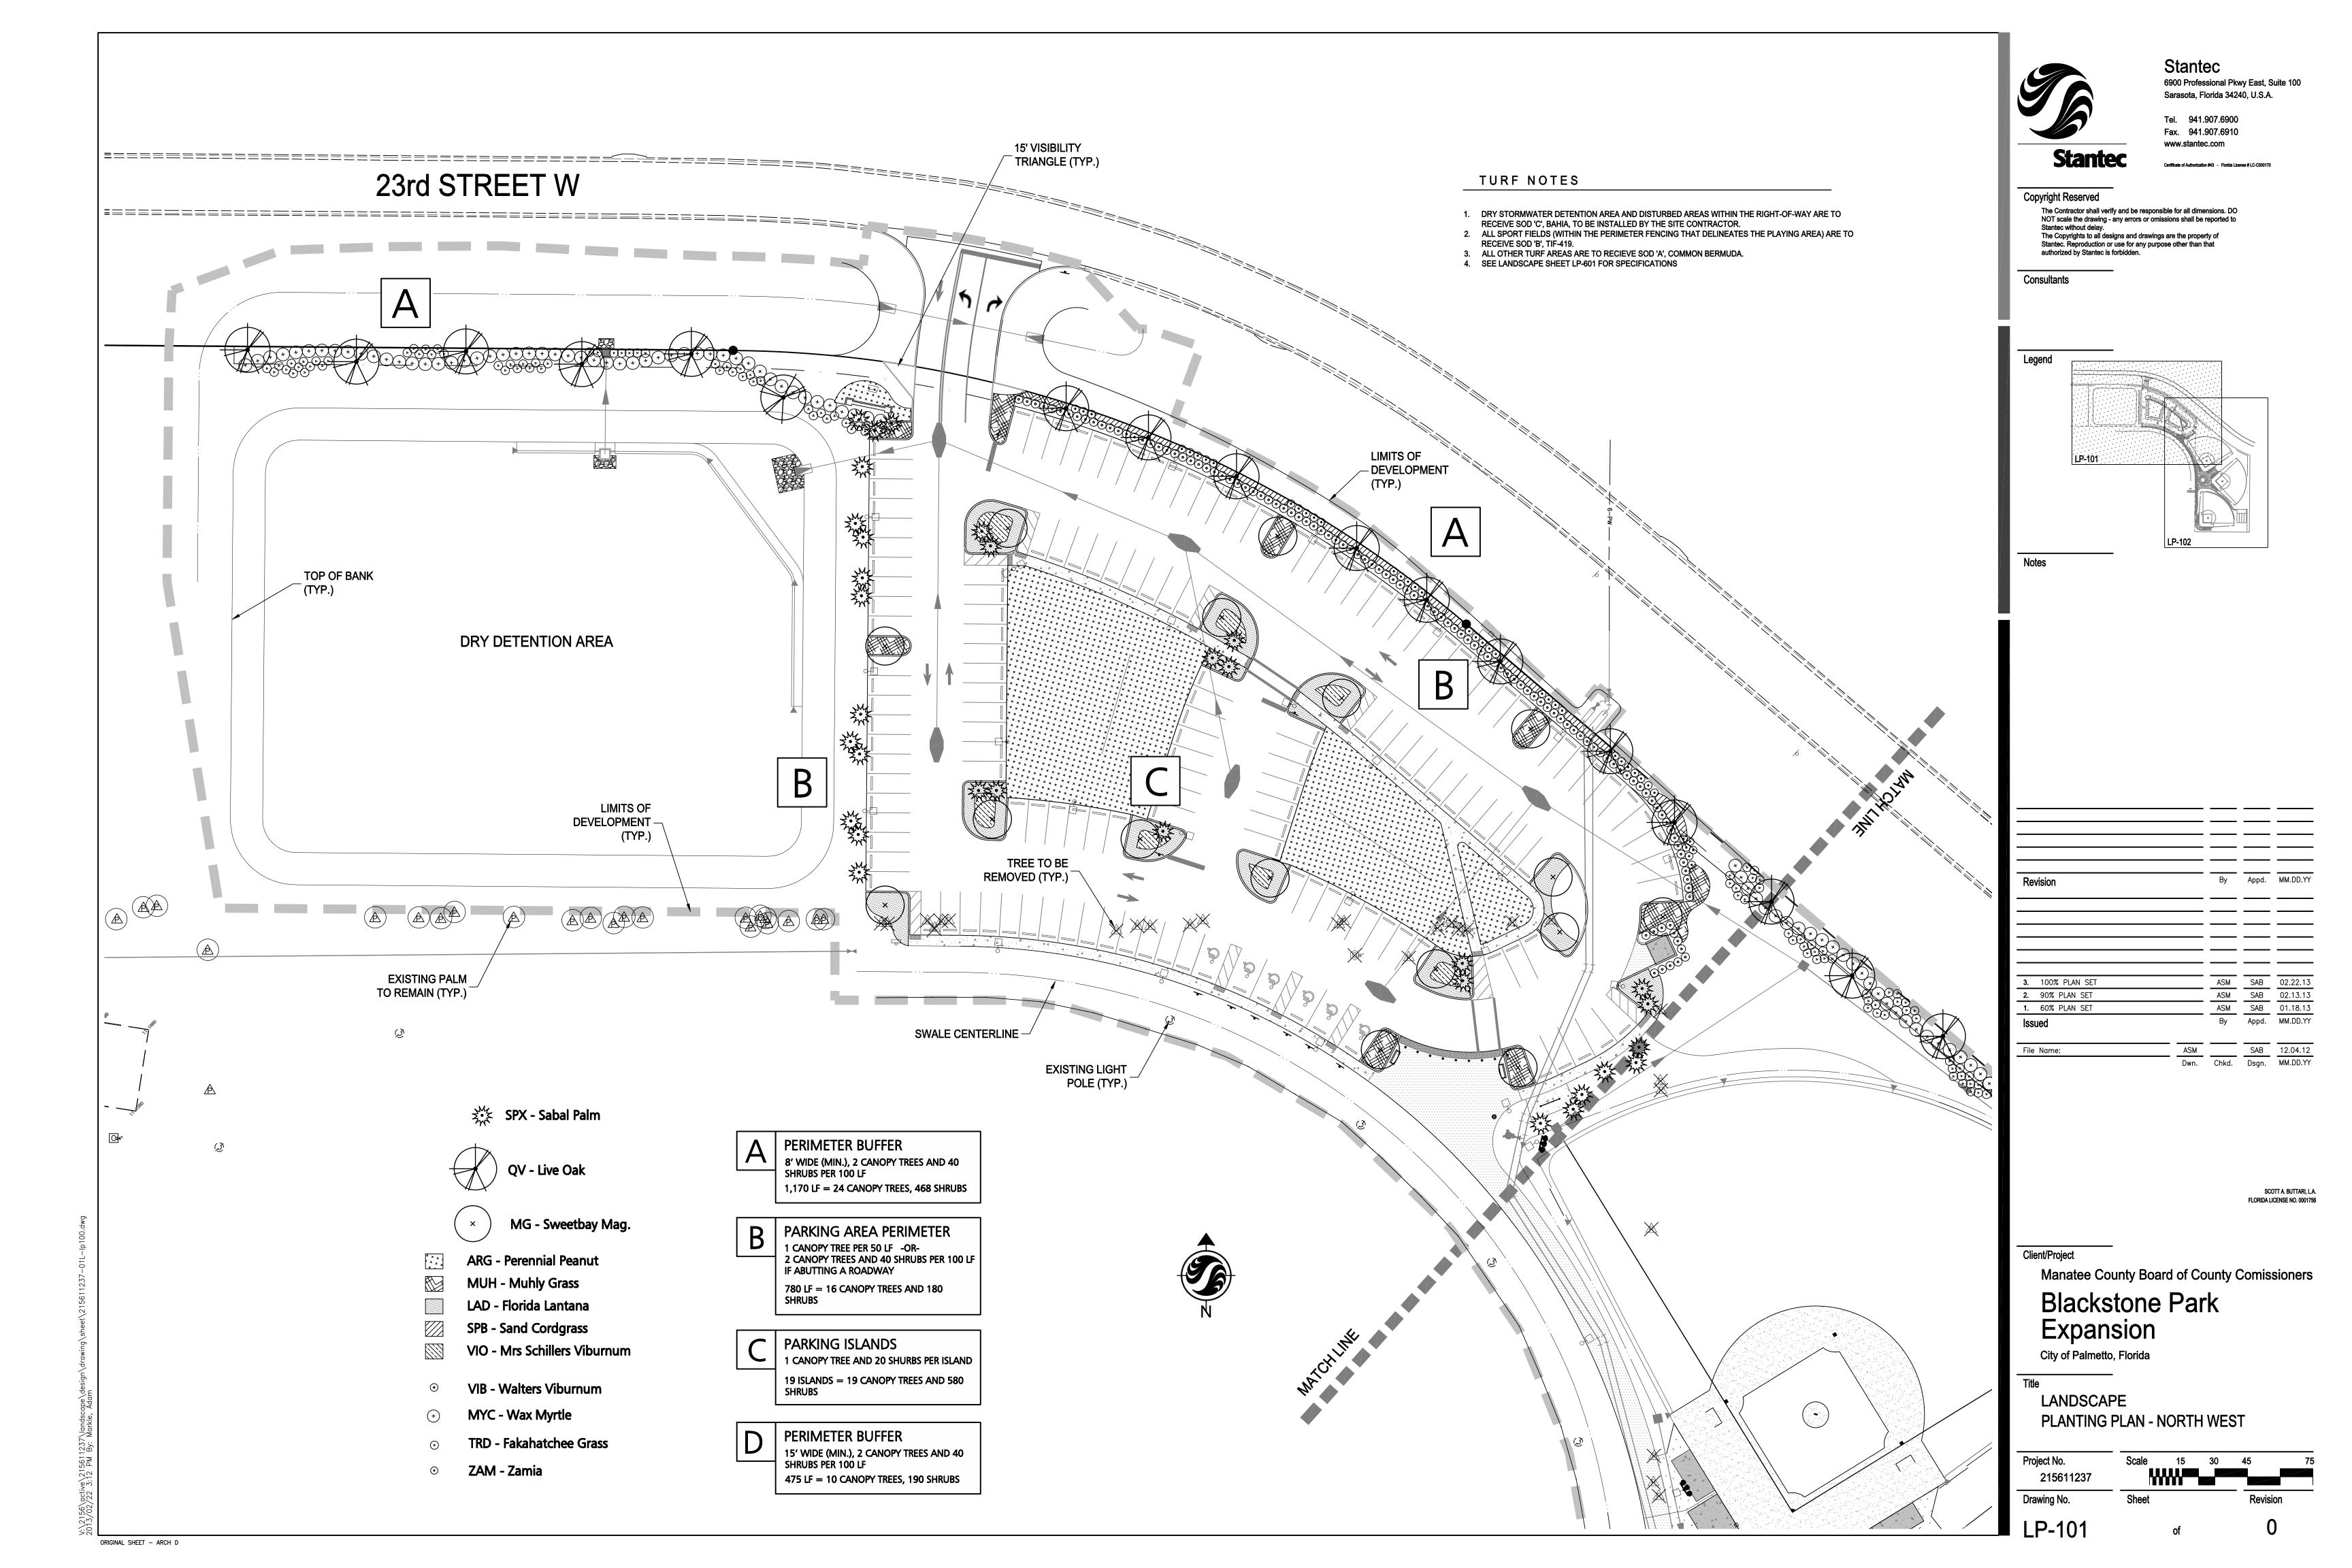


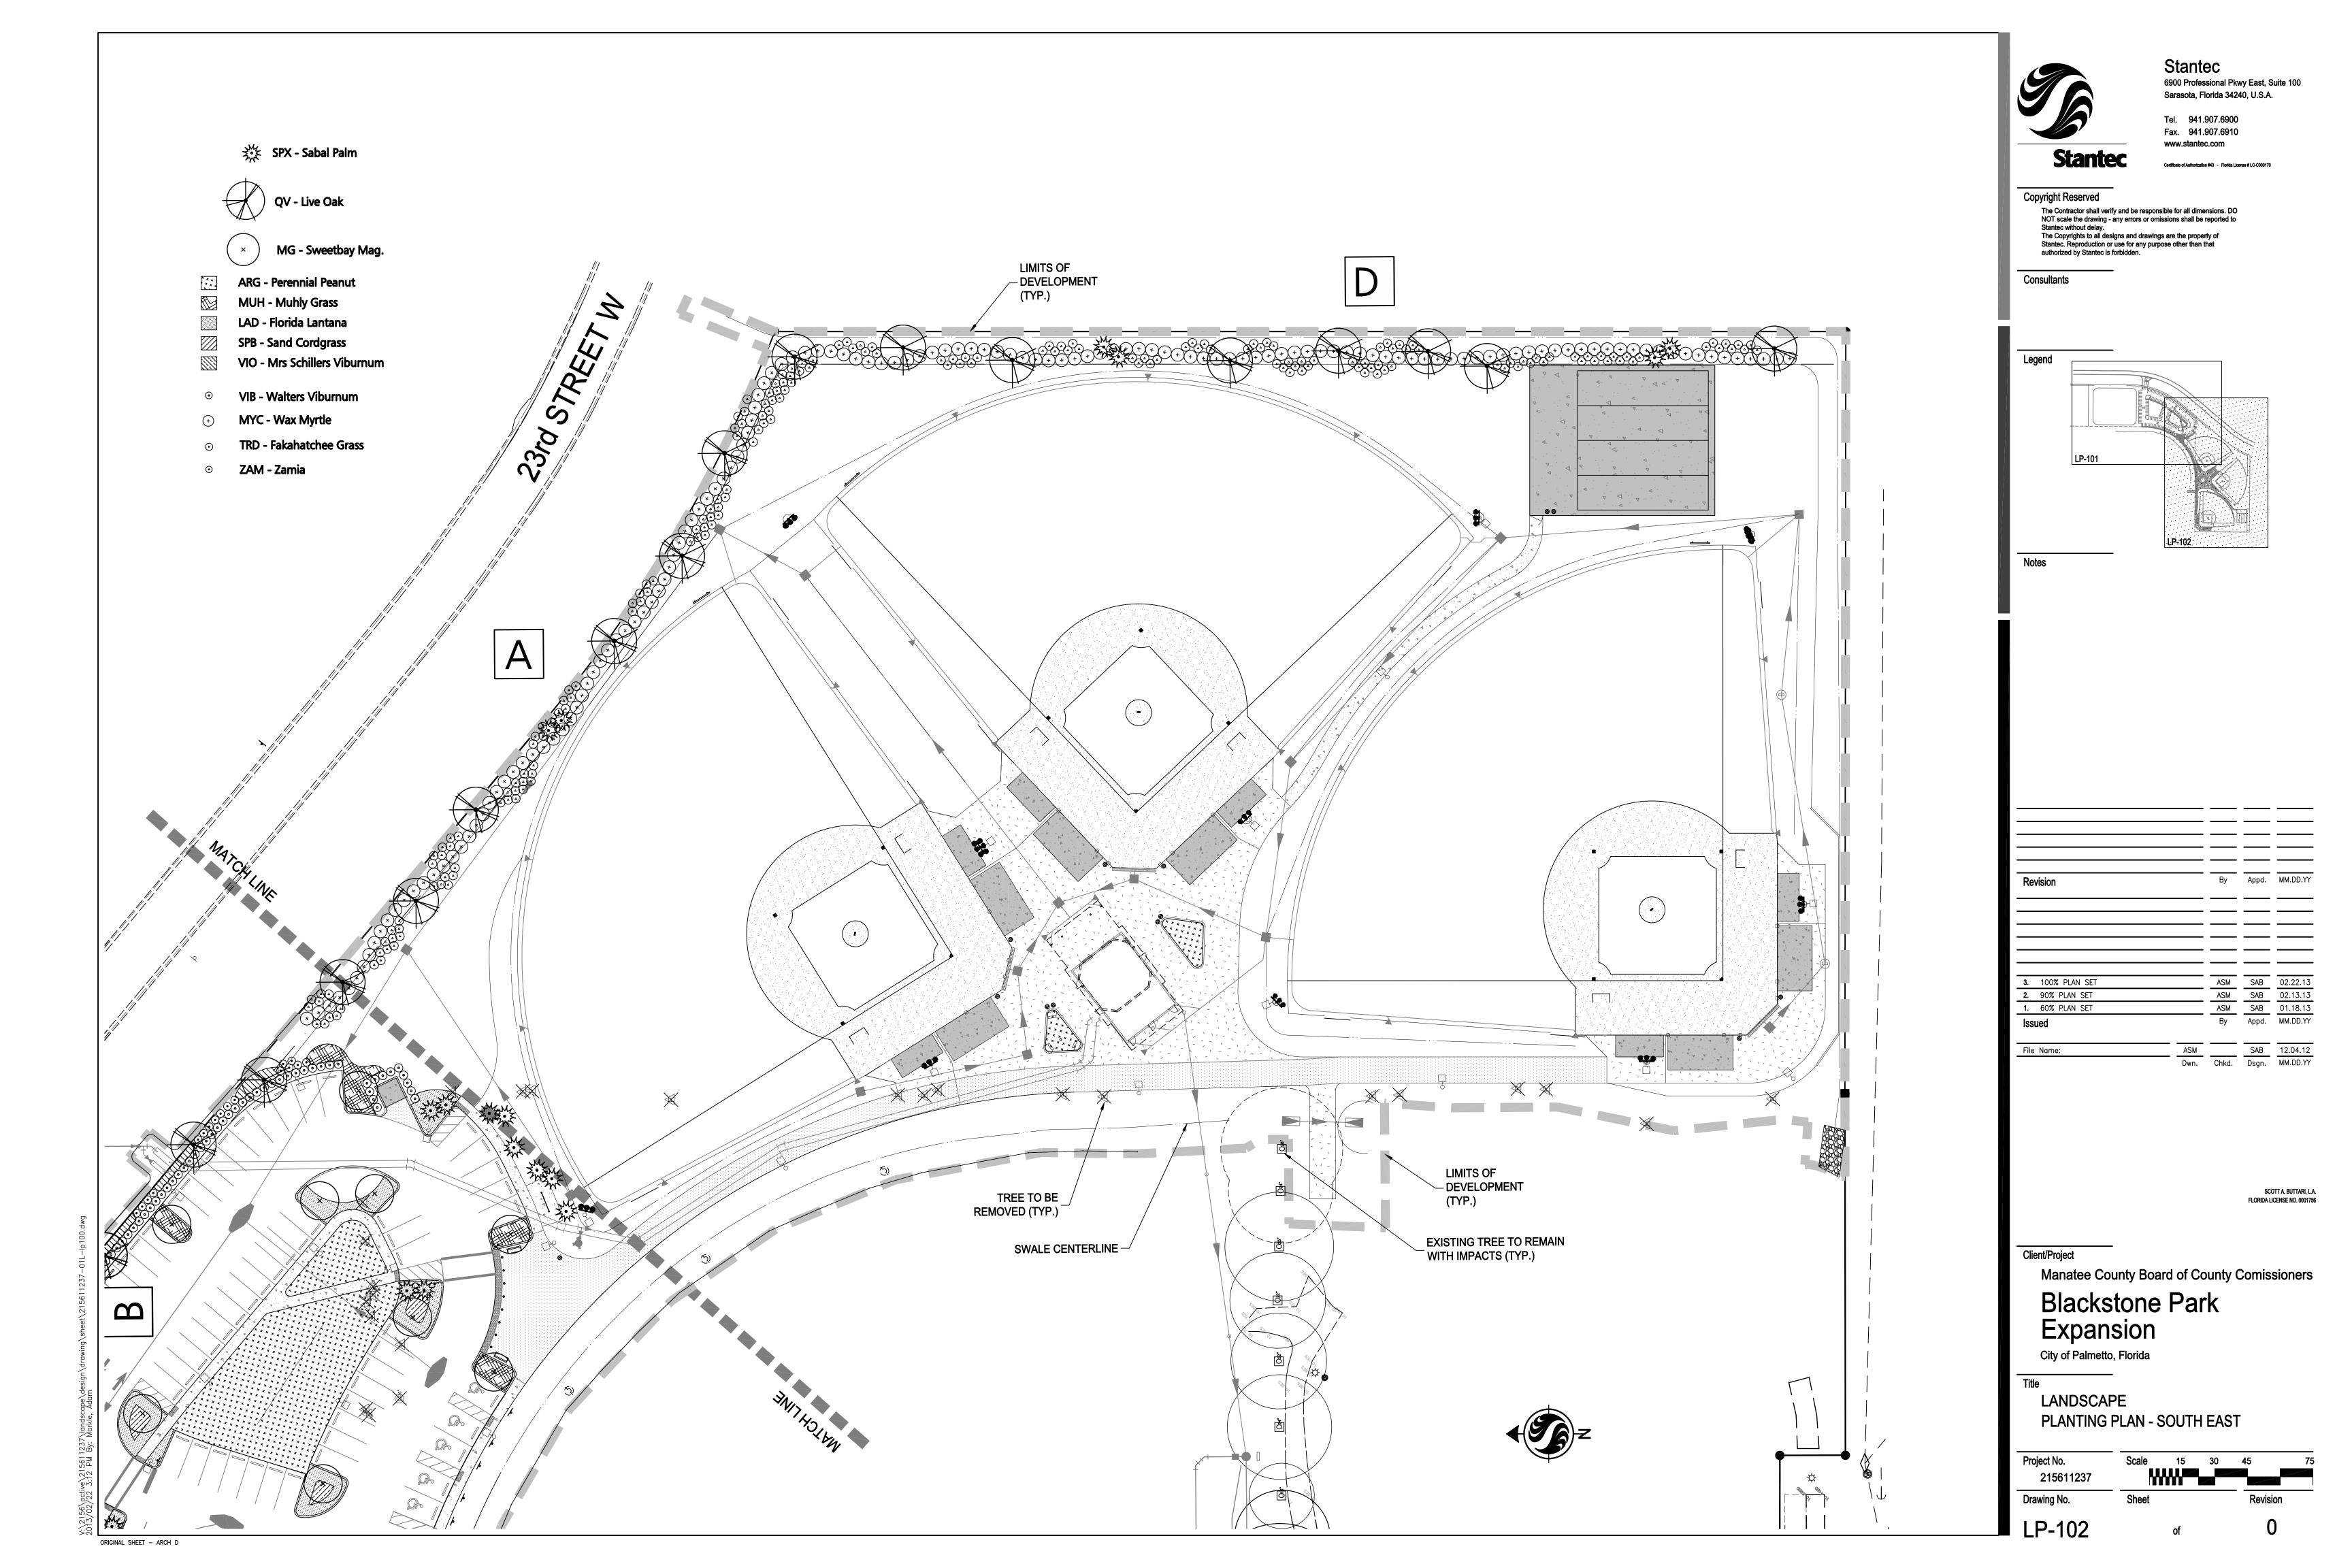


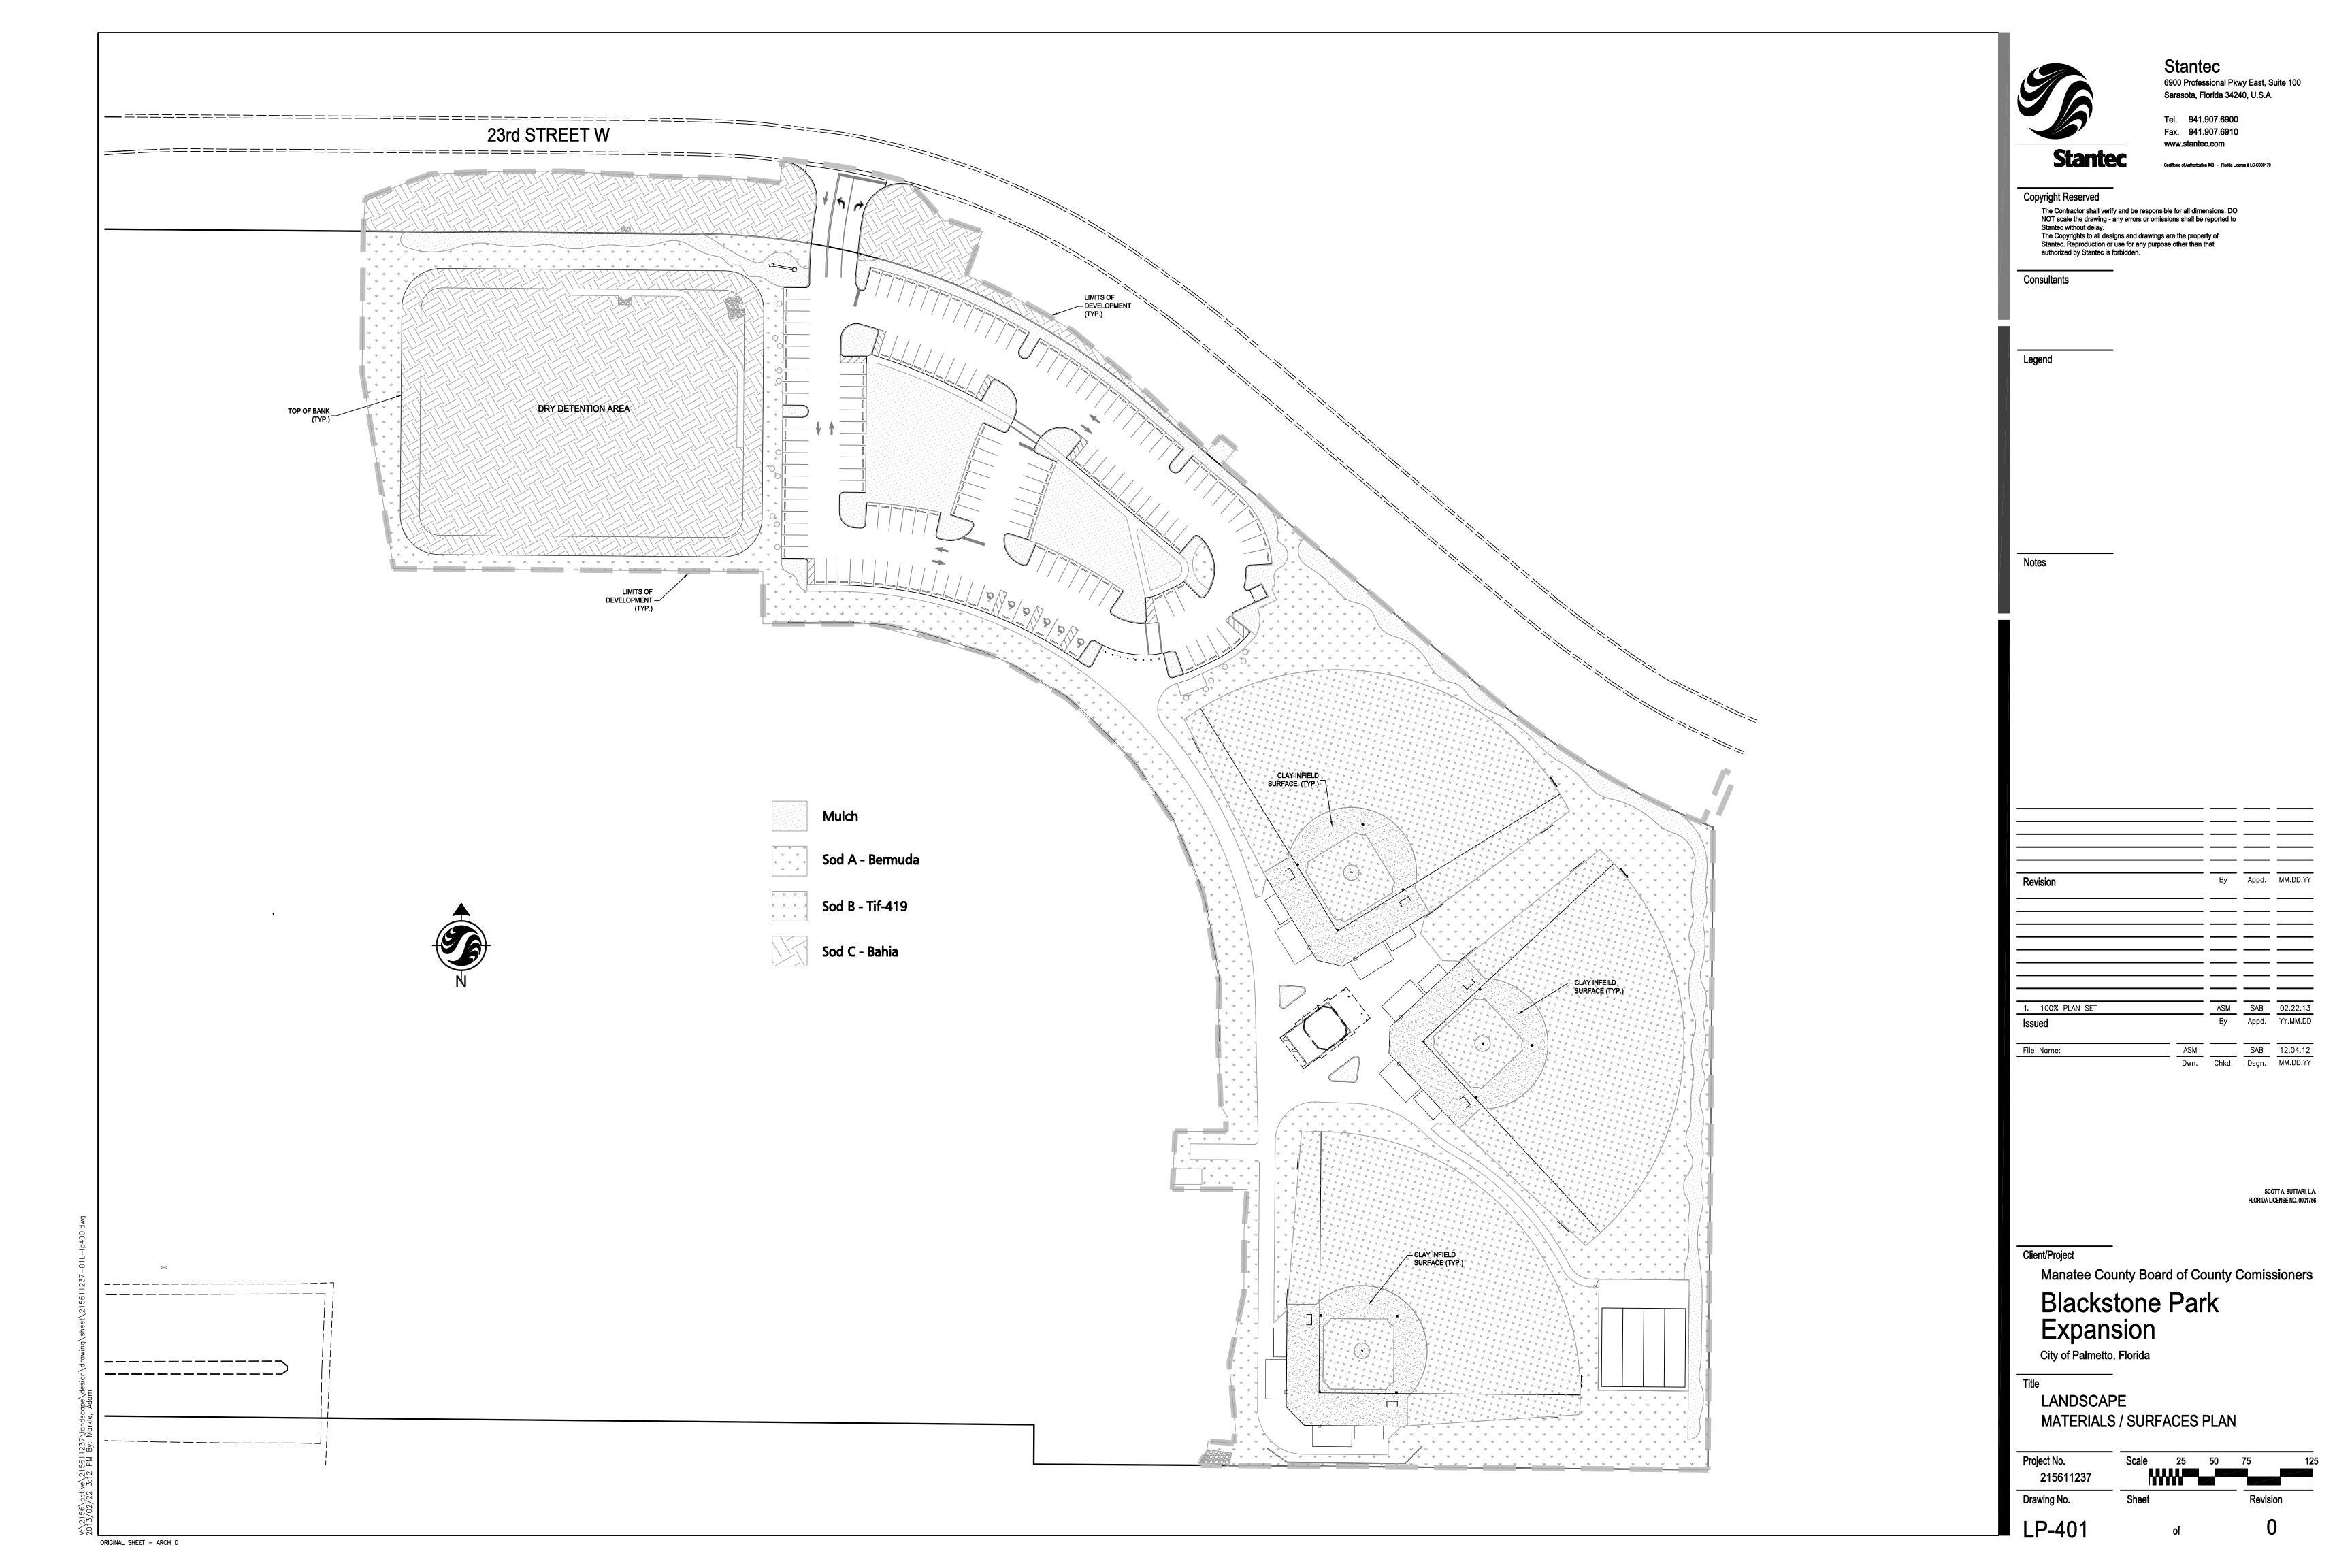

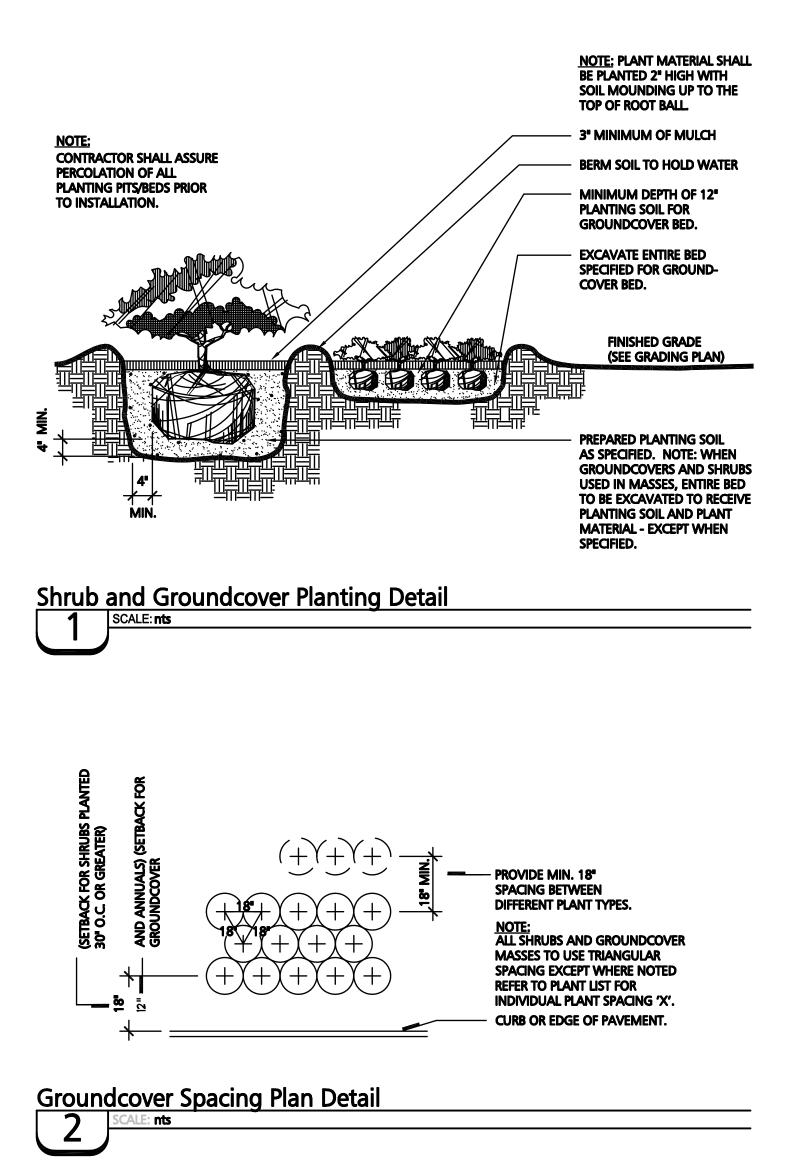

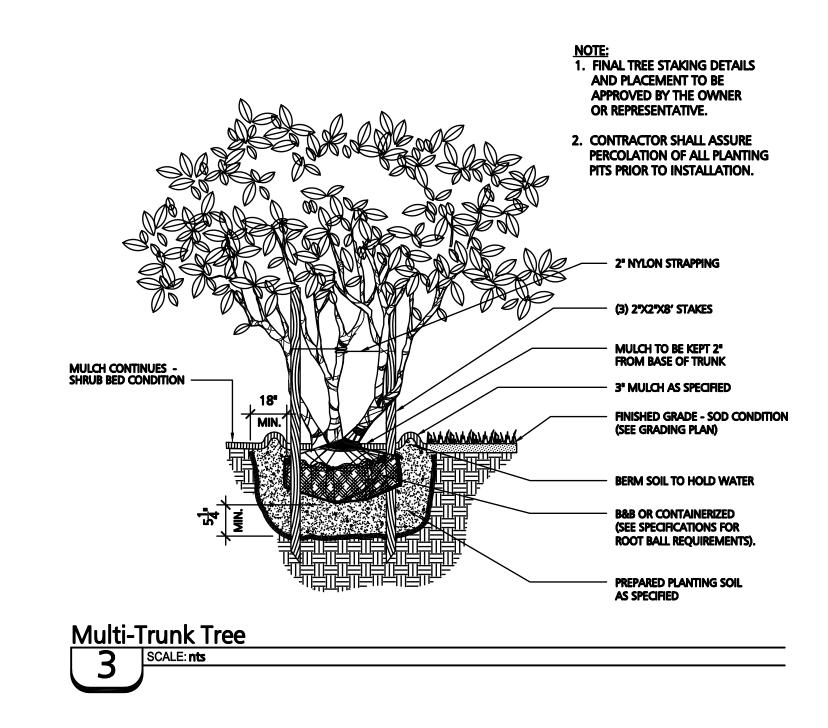

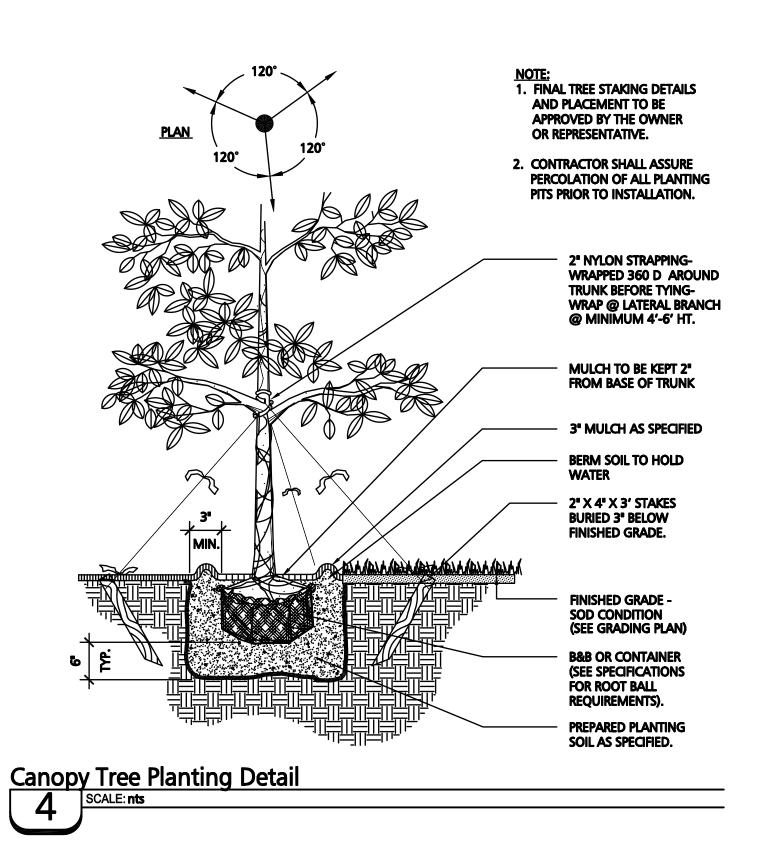

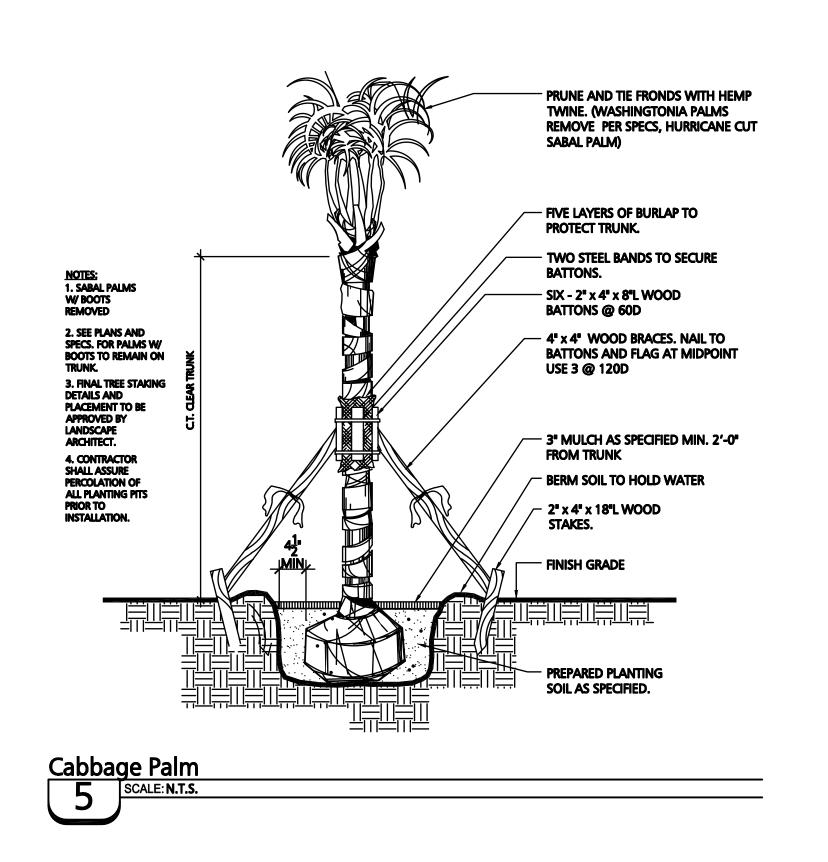



Stantec 6900 Professional Pkwy East, Suite 100 Sarasota, Florida 34240, U.S.A.

Tel. 941.907.6900 Fax. 941.907.6910 www.stantec.com

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Consultants

| Revision         |      | Ву    | Appd. | YY.MM.DD |
|------------------|------|-------|-------|----------|
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|                  |      |       |       |          |
| 2. 100% PLAN SET |      | ASM   | SAB   | 02.22.13 |
| I. 90% PLAN SET  |      | ASM   | SAB   | 02.13.13 |
| ssued            |      | Ву    | Appd. | MM.DD.YY |
| -<br>File Name:  | ASM  |       | SAB   | 12.04.12 |
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SCOTT A. BUTTARI, L.A. FLORIDA LICENSE NO. 0001756

Manatee County Board of County Comissioners

Blackstone Park Expansion

City of Palmetto, Florida

LANDSCAPE PLANTING DETAILS

| Project No. 215611237 | Scale | 15<br>// // | <u> </u> |         |   |
|-----------------------|-------|-------------|----------|---------|---|
| Drawing No.           | Sheet |             |          | Revisio | n |
| LP-501                |       | of          |          | 0       |   |

ORIGINAL SHEET - ARCH D

# LANDSCAPE NOTES

- 1. CONTRACTOR SHALL FIELD VERIFY ALL INFORMATION PRIOR TO INITIATING PLANTING INSTALLATION.
- 2. CONTRACTOR SHALL NOTIFY ALL PERTINENT UTILITY COMPANIES 48 HOURS MINIMUM PRIOR TO DIGGING FOR VERIFICATION OF ALL UNDERGROUND UTILITIES. PLANS ARE PREPARED ACCORDING TO THE BEST INFORMATION AVAILABLE AT THE TIME OF PREPARING THESE DOCUMENTS.
- 3. THE CONTRACTOR SHALL BECOME COMPLETELY FAMILIAR WITH EXISTING SITE CONDITIONS PRIOR TO BEGINNING INSTALLATION. ALL EXISTING SITE IMPROVEMENTS, PAVING, LANDSCAPE, LIGHTING, AND OTHER SITE ELEMENTS TO REMAIN SHALL BE PROTECTED FROM DAMAGE UNLESS OTHERWISE NOTED.
- 4. UNLESS OTHERWISE NOTED, THE LIMITS OF CONSTRUCTION ARE THE CLEARING LIMITS NOTED ON THE PLANS.
- 5. THE CONTRACTOR SHALL REPORT ANY DISCREPANCIES BETWEEN THE CONSTRUCTION DRAWINGS AND ACTUAL FIELD CONDITIONS TO THE OWNER'S REPRESENTATIVE IMMEDIATELY.
- 6. THE CONTRACTOR SHALL COORDINATE ALL WORK WITH RELATED CONTRACTORS AND WITH THE GENERAL CONSTRUCTION OF THE PROJECT IN ORDER TO NOT IMPEDE THE PROGRESS OF WORK OF OTHERS OR THE
- CONTRACTOR SHALL BE RESPONSIBLE TO REMOVE ALL EXISTING GROUND COVERS FOR ALL NEW PLANTING BEDS BY APPROVED MEANS PRIOR TO PLANTING INSTALLATION. CONTRACTOR SHALL BE RESPONSIBLE TO REPLACE ALL PORTIONS OF EXISTING PLANTING OR LAWN AREAS INDICATED TO REMAIN WHILE COMPLETING NEW PLANTING INSTALLATION WORK WITH SAME KIND OF PLANTS OR GRASS TO THE SATISFACTION OF THE OWNER AT NO ADDITIONAL COST.
- 8. THE CONTRACTOR SHALL BEAR ALL COST ASSOCIATED WITH SOIL TESTING AND SOIL AMENDMENTS AS REQUIRED AS A RESULT OF THE SOIL TESTING LABORATORY'S RECOMMENDATIONS. PRIOR TO INITIATING INSTALLATION THE CONTRACTOR SHALL PROVIDE SOIL TEST FOR AT LEAST TWO ON-SITE LOCATIONS.
- 9. ALL PLANT CONTAINER SIZES NOTED ON THE PLANT LIST/MATERIAL SCHEDULE ARE MINIMUM. INCREASE SIZE OF CONTAINERS IF NECESSARY TO CONFORM TO THE PLANT SIZE AND SPECIFICATIONS.
- 10. EROSION CONTROL FABRIC SHALL BE INSTALLED IN ALL SHRUB AND GROUND COVER PLANTING AREAS AS PER THE DETAILS AND/OR SPECIFICATIONS FOR ALL SLOPES THAT ARE GREATER THAN 3:1 (SLOPES 1' VERTICAL FOR EVERY 3' HORIZONTAL). SEE CIVIL ENGINEERING PLANS FOR LOCATIONS WHERE SLOPES ARE GREATER THAN
- 11. SHRUB AND GROUND COVER PLANTINGS ARE TYPICALLY SHOWN ON THE PLANS IN MASS PLANTING BEDS. PLANTS SHALL BE SET IN A TRIANGULAR SPACING PATTERN ( STAGGERED SPACING). PLANT CENTER TO CENTER DIMENSIONS (O.C.) ARE INDICATED IN THE PLANT LIST.
- 12. LANDSCAPE CONTRACTOR SHALL FIELD ADJUST THE LOCATION OF PLANT MATERIAL AS NECESSARY TO AVOID DAMAGE TO EXISTING TREES AND UNDERSTORY VEGETATION TO REMAIN, UNDERGROUND AND ABOVE GROUND UTILITIES AND ALL OTHER ABOVE GROUND ELEMENTS. ALL CHANGES REQUIRED SHALL BE COORDINATED WITH THE OWNER'S REPRESENTATIVE AND THE LANDSCAPE ARCHITECT PRIOR TO INITIATING ANY CHANGES.
- 13. WHEN NECESSARY, PLANTING WITHIN THE DRIPLINE/CANOPY OF EXISTING TREES SHOULD BE DONE IN THE MOST SENSITIVE MANNER POSSIBLE IN ORDER TO AVOID ROOT DAMAGE. ALL NEW PLANTINGS WITHIN THE DRIPLINE/CANOPY SHOULD BE HAND-DUG AND FIELD ADJUSTED TO AVOID ROOTS AS NECESSARY.
- 14. ANY SUBSTITUTIONS TO PLANT MATERIAL SIZE OR TYPE MUST BE APPROVED BY THE LANDSCAPE ARCHITECT PRIOR TO INSTALLATION. LANDSCAPE CONTRACTOR SHALL NOT MAKE ANY SUBSTITUTIONS OR ALTERATIONS TO THE LANDSCAPE PLANTING PLANS OR PLANT LIST & MATERIALS WITHOUT THE PRIOR APPROVAL OF THE LANDSCAPE ARCHITECT AND OWNER'S REPRESENTATIVE. ANY LANDSCAPE PLANTING INSTALLED THAT DOES NOT CONFORM TO THE PLANS, PLANT LIST AND SPECIFICATIONS SHALL BE REPLACED IMMEDIATELY TO THE SATISFACTION OF THE OWNER'S REPRESENTATIVE AND LANDSCAPE ARCHITECT.
- 15. CONTRACTOR SHALL BE RESPONSIBLE FOR WATERING AS REQUIRED TO MAINTAIN AND ESTABLISH ALL PLANTING (NEW, EXISTING TO BE RELOCATED, AND EXISTING PLANTINGS TO REMAIN WHILE IRRIGATION SYSTEM IS BEING INSTALLED OR REPAIRED) TO SUPPLEMENT IRRIGATION AND RAINFALL. THE IRRIGATION SYSTEM IS DESIGNED TO MAINTAIN THE LANDSCAPE PLANTINGS AND NOT ESTABLISH THEM. THE CONTRACTOR IS RESPONSIBLE FOR WATERING IN ALL PLANTING AREAS, REGARDLESS OF THE STATUS OF EXISTING OR PROPOSED IRRIGATION SYSTEMS.
- 16. CONTRACTOR IS RESPONSIBLE FOR MAINTAINING, IN FULL, ALL PLANTING AREAS (INCLUDING WATERING, SPRAYING, MULCHING, MOWING, FERTILIZING, AND WEEDING, ETC.) UNTIL THE JOB IS ACCEPTED.
- 17. CONTRACTOR SHALL ASSURE DRAINAGE AND PERCOLATION OF ALL PLANTING PITS PRIOR TO INSTALLATION OF PLANT MATERIAL. CORRECT IF REQUIRED TO ASSURE PERCOLATION. CONTRACTOR IS RESPONSIBLE FOR REPLACEMENT OF ALL PLANTS LOST DUE TO INADEQUATE DRAINAGE CONDITIONS.
- 18. CONTRACTOR SHALL CLEAN THE WORK AREAS AT THE END OF EACH WORKING DAY. LANDSCAPE RUBBISH AND DEBRIS SHALL BE COLLECTED AND DEPOSITED OR RECYCLED OFF-SITE DAILY. ALL MATERIALS, PRODUCTS, AND EQUIPMENT STORED ON-SITE SHALL BE KEPT IN AN ORGANIZED MANNER DAILY.
- 19. CONTRACTOR SHALL RE-GRADE ALL AREAS DISTURBED BY PLANT REMOVAL, RELOCATION, AND/OR FROM INSTALLATION WORK. THE CONTRACTOR SHALL REPLACE BY EQUAL SIZE AND QUALITY ANY AND ALL EXISTING PLANT MATERIAL DISTURBED OR DAMAGED BY PLANTING REMOVAL, RELOCATION, AND/OR INSTALLATION.
- 20. EXISTING TREES OR OTHER PLANT MATERIAL INDICATED ON THE PLANS TO BE RELOCATED SHALL BE HANDLED, CARED FOR, AND MAINTAINED AS NEW PLANTINGS. THE CONTRACTOR IS RESPONSIBLE FOR ANY REQUIRED ROOT PRUNING, WRAPPING, TREE SPADING OR BALL AND BURLAPPING, ADDITIONAL SUPPLEMENTAL HAND WATERING, IRRIGATION MISTERS INSTALLED AT THE TREE CANOPY, OR ANY OTHER SOUND HORTICULTURAL PRACTICE REQUIRED TO ENSURE THE SURVIVAL OF ALL RELOCATED PLANT MATERIAL.
- 21. THE CONTRACTOR SHALL REFER TO THE LANDSCAPE PLANTING DETAILS, SPECIFICATIONS, PLANT LIST AND PLANS FOR FURTHER AND COMPLETE PLANTING INSTALLATION INSTRUCTIONS.
- 22. LANDSCAPE CONTRACTOR SHALL FULLY FAMILIARIZE HIMSELF / HERSELF WITH THE PROJECT PRIOR TO BIDDING
- 23. FOR SITE GRADING AND CONTOUR INFORMATION, EXISTING VEGETATION TO REMAIN, BUILDINGS AND OTHER SITE FEATURE LOCATIONS AND THE LOCATION OF ALL ABOVE AND BELOW GROUND UTILITIES SEE THE MOST CURRENT AND UP TO DATE ARCHITECTURAL, CIVIL, ELECTRICAL, STRUCTURAL AND MECHANICAL ENGINEERING DRAWINGS AS PROVIDED BY THE OWNER OR OWNER'S REPRESENTATIVE. FIELD LOCATE ALL UNDERGROUND UTILITIES, EXISTING VEGETATION TO REMAIN AND ANY OTHER OBSTRUCTIONS AND COORDINATE WITH OWNER'S REPRESENTATIVE PRIOR TO INITIATING ANY LANDSCAPE PLANTING OR IRRIGATION INSTALLATION WORK. LANDSCAPE CONTRACTOR SHALL BE RESPONSIBLE FOR REPAIRING OR REPLACING ANY DAMAGE COMMITTED TO EXISTING OR PROPOSED ELEMENTS ABOVE OR BELOW GROUND TO ITS ORIGINAL CONDITION AND TO THE SATISFACTION OF THE OWNER AND OWNER'S REPRESENTATIVE.
- 24. LANDSCAPE CONTRACTOR SHALL FIELD STAKE THE LOCATION OF ALL PLANT MATERIAL AND EDGES OF PLANTING BEDS FOR THE REVIEW AND APPROVAL BY THE LANDSCAPE ARCHITECT PRIOR TO INITIATING ANY INSTALLATION OF THE LANDSCAPE PLANTINGS.
- 25. LANDSCAPE CONTRACTOR SHALL COORDINATE WORK WITH THE IRRIGATION CONTRACTOR AND ALL OTHER TRADES AS REQUIRED.
- 26. THE CONTRACTOR SHALL REQUEST INSPECTION OF THE PROJECT IN WRITING. IF ALL WORK IS SATISFACTORY AND COMPLETE IN ACCORDANCE WITH CONDITIONS OF CONTRACT DOCUMENTS, THEN THE OWNER AND LANDSCAPE ARCHITECT SHALL DECLARE THE WORK SUBSTANTIALLY COMPLETE. THE CONTRACTOR IS TO REPLACE REJECTED PLANT MATERIAL WITHIN ONE (1) WEEK OF NOTICE.
- 27. GUYING/STAKING PRACTICES SHALL NOT PERMIT NAILS, SCREWS, WIRES, ETC., TO PENETRATE OUTER SURFACE OF THE TREE OR PALM. PLANT MATERIAL REJECTED DUE TO THIS PRACTICE SHALL BE REPLACED AT THE CONTRACTORS EXPENSE. REMOVAL OF ALL STAKING AND GUYING OF TREES AND PALMS AFTER FINAL ACCEPTANCE SHALL BE THE RESPONSIBILITY OF THE OWNER.
- 28. ALL PLANT MATERIAL SHALL BE FLORIDA NO.1 OR BETTER AT TIME OF INSTALLATION AND SHALL BE MAINTAINED IN THIS SAME CONDITION UNTIL FINAL ACCEPTANCE. THE CONTRACTOR GUARANTEES THE PLANT MATERIAL FOR A PERIOD OF ONE (1) YEAR FOLLOWING DATE OF SUBSTANTIAL COMPLETION.
- 29. ALL PLANTS MUST BE HEALTHY, VIGOROUS MATERIAL, FREE OF PESTS AND DISEASE. ALL PLANT MATERIAL SHALL BE IN FULL AND STRICT ACCORDANCE TO FLORIDA NO.1 GRADE, ACCORDING TO THE GRADES AND STANDARDS FOR NURSERY PLANTS. PUBLISHED BY THE FLORIDA DEPARTMENT OF AGRICULTURE AND CONSUMER SERVICES. PLANT MATERIAL IN SOME INSTANCES EXCEED NO.1 GRADE IN ORDER TO MEET THE MINIMUM REQUIREMENTS OF THIS PROJECT.

# LANDSCAPE PLANT LIST

| Symbol  | Scientific Name                          | Common Name                   | Specification                                                      | Quantity |
|---------|------------------------------------------|-------------------------------|--------------------------------------------------------------------|----------|
|         | CANOPY TREES                             |                               |                                                                    |          |
| MG      | Magnolia virginiana                      | Sweetbay Magnolia             | 14'-16' OA Ht. x 5' Spr., 4" Cal., 6' CT                           | 16       |
| QV      | Quercus virginiana SDLN pp12015          | Cathedral Live Oak            | 12'-14' OA Ht. x 4' Spr., 3" Cal.                                  | 28       |
|         | PALMS                                    |                               |                                                                    |          |
| SPX     | Sabal palmetto                           | Cabbage Palm                  | 10', 12', 14' CT, Mix, HC, Booted                                  | 38       |
|         | SHRUBS / GROUNDCOVERS                    |                               |                                                                    |          |
| ARG     | Arachis glabrata                         | Perennial Peanut              | Liner, 18" OC                                                      | 7,120    |
| LAD     | Lantana depressa                         | Florida Lantana               | 1 Gal., 24" OC                                                     | 977      |
| МИН     | Muhlenbergia capillaris                  | Muhly Grass                   | 1 Gal., 12" OA., 30" OC                                            | 290      |
| MYC     | Myrica cerifera                          | Wax Myrtle                    | 7 Gal., 36" OA, Full, Space as indicated in plan                   | 193      |
| SPB     | Spartina bakerii                         | Sand Cordgrass                | 1 Gal., 12" OA., 30" OC                                            | 140      |
| TRD     | Tripsacum dactyloides                    | Fakahatchee Grass             | 3 Gal., 18" OA, 48" OC, Space as indicated in plan                 | 250      |
| VIO     | Viburnum obovatum 'Mrs Shillers Delight' | Mrs Shillers Delight Viburnum | 3 Gal., 18" OA, 36" OC                                             | 105      |
| VIB     | Viburnum obovatum                        | Walters Viburnum              | 3 Gal., 24" OA, Space as indicated in plan                         | 112      |
| ZAM     | Zamia pumila                             | Coontie                       | 3 Gal., 18" OA, 36" OC                                             | 40       |
|         | OTHER                                    |                               |                                                                    |          |
| Sod 'A' | Cynodon dactylon                         | Common Bermudagrass           | Solid Sod, Sand Grown, Laid, Rolled, Free of Weeds and Pests       | SF       |
| Sod 'B' | Cynodon transvaalensis x C. dactylon     | Tifway 419 Bermudagrass       | Solid Sod, Sand Grown, Laid, Rolled, Free of Weeds and Pests       | SF       |
| Sod 'C' | Paspalum notatum                         | Bahiagrass                    | Per Site Contractor                                                |          |
| Mulch   | Pine Bark Nuggets                        |                               | 3" Depth, All Planting Areas/Tree Rings unless specified otherwise | CY       |

# TREE PROTECTION NOTES

- A. PRUNING OF A GRAND OAK, WITH THE EXCEPTION OF MINOR PRUNING, IS PROHIBITED UNLESS CONDUCTED IN ACCORDANCE WITH THE ANSI A-300 PRUNING STANDARDS, AND PERFORMED BY AN ARBORIST CERTIFIED BY THE INTERNATIONAL SOCIETY OF ARBORICULTURE (ISA) OR A REGISTERED CONSULTING ARBORIST WITH THE AMERICAN SOCIETY OF CONSULTING ARBORISTS (ASCA). MINOR PRUNING IS THE PRUNING OF A TREE BY THE REMOVAL OF BRANCHES NO GREATER THAN THREE (3) INCHES IN DIAMETER AT THE POINT OF CONNECTION TO A SUPPORTING BRANCH AND SHALL BE IN ACCORDANCE WITH THE ANSI A-300 PRUNING STANDARDS. A NOTARIZED AFFIDAVIT AFFIRMING AN ISA CERTIFIED ARBORIST OR AN ASCA REGISTERED CONSULTING ARBORIST WILL CONDUCT OR PROVIDE ONSITE SUPERVISION OF THE PRUNING SHALL BE SUBMITTED TO THE COUNTY PRIOR TO THE PRUNING OF A GRAND OAK. AN ISA CERTIFIED ARBORIST OR AN ASCA REGISTERED CONSULTING ARBORIST CONTRACTED BY A PROPERTY OWNER TO PRUNE A GRAND OAK SHALL ASSUME FULL RESPONSIBILITY FOR ALL PRUNING ACTIVITIES DETERMINED IN NONCOMPLIANCE WITH STANDARDS SPECIFIED WITHIN THE LAND DEVELOPMENT CODE.
- B. ALL TRIMMING UNDERTAKEN ON A TREE PROTECTED BY THE PROVISIONS OF THE LAND DEVELOPMENT CODE SHALL BE IN ACCORDANCE WITH THE AMERICAN NATIONAL STANDARDS INSTITUTE (ANSI) A-300 PRUNING STANDARDS.
- C. PROPOSED LAND ALTERATION ACTIVITIES SHALL NOT UNNECESSARILY REMOVE EXISTING VEGETATION AND ALTER EXISTING TOPOGRAPHY. ADEQUATE PROTECTION MEASURES (I.E., HAY BALES, BAFFLES, SODDING AND SANDBAGGING) SHALL BE PROVIDED, AS NECESSARY, TO MINIMIZE EROSION AND DOWNSTREAM SEDIMENTATION CAUSED BY SURFACE WATER RUN-OFF ON EXPOSED LAND SURFACES.
- D. DURING LAND ALTERATION AND CONSTRUCTION ACTIVITIES, IT SHALL BE UNLAWFUL TO REMOVE VEGETATION BY GRUBBING OR TO PLACE SOIL DEPOSITS, DEBRIS, SOLVENTS, CONSTRUCTION MATERIAL, MACHINERY OR OTHER EQUIPMENT OF ANY KIND WITHIN THE DRIPLINE OF A TREE TO REMAIN ON THE SITE UNLESS OTHERWISE APPROVED BY THE COUNTY.
- ANY AREAS SUBJECT TO EROSION MUST BE ADEQUATELY STABILIZED WITH VEGETATIVE MATERIAL THAT WILL, WITHIN A REASONABLE TIME FRAME, DETER SOIL DISTURBANCE. SODDING, PLUGGING, SPRIGGING OR SEEDING IS ACCEPTABLE FOR STABILIZATION: HOWEVER, SODDING MAY BE REQUIRED IN AREAS OF EROSION-PRONE SOILS OR WHERE SLOPES ARE GREATER THAN 5:1. VEGETATION OTHER THAN GRASS IS ACCEPTABLE UNLESS OTHERWISE SPECIFIED.
- F. INSTALL TREE BARRICADES TO THE FULLEST EXTENT OF THE DRIPLINE OF ALL TREES/PALMS AS POSSIBLE AND/OR TO THE MAXIMUM LIMIT OF IMPROVEMENT(S) AS POSSIBLE (OF COURSE REALIZING THAT THE TREE BARRICADES MAY HAVE TO BE "BACKED OFF" THE IMPROVEMENT(S) BY 1' TO 2' MAXIMUM TO INSTALL THE IMPROVEMENT(S). DO NOT INSTALL TREE BARRICADES (SPECIFICALLY SILT FENCING MATERIAL) BY TRENCHING WITHIN THE DRIPLINE OF EXISTING TREES/PALMS.
- G. LAND ALTERATION AND CONSTRUCTION ACTIVITIES SHALL BE APPROVED WITHIN THE DRIPLINE OF A TREE TO BE RETAINED ON THE SITE PROVIDED DESIGN TECHNIQUES ARE USED THAT MINIMIZE DAMAGE TO THE ROOT SYSTEM OF THE TREE (E.G., RETAINING WALLS, TREE WELLS, ROOT AERATION DEVICES, PERVIOUS PAVERS, PERVIOUS CONCRETE, GREEN SPACE, AS APPROPRIATE). WHERE IT IS NOT PRACTICAL FOR UNDERGROUND UTILITY LINES TO BE ROUTED AROUND THE DRIPLINE, TUNNELING SHALL BE EMPLOYED TO ROUTE THE LINES THROUGH THIS AREA.


# TREE REMOVAL SCHEDULE

PER CITY OF PALMETTO CODE OF ORDINANCES, ARTICLE X. SEC. 7-224(b) 64" CAL. TO BE REMOVED = 64" CAL. TO BE REPLACED (148" PROVIDED) \* EXISTING HEALTHY SABAL PALMS ARE TO BE RELOCATED ON THE SUBJECT SITE.



- 1. TREE REMOVAL INFORMATION IDENTIFIED IN THE SCHEDULE IS BASED ON A GENERAL IDENTIFICATION OF EXISTING TREES IN THE VICINITY OF THE PROPOSED DRIVES, BUILDINGS, UTILITIES, AND
- 2. TREES 15" OR LESS DBH SHALL BE REPLACED WITH 3" CAL. TREES BETWEEN 16" AND 30" SHALL BE REPLACED WITH 4" CAL. (2:1), OVER 30" WITH 4" CAL. (3:1), AS PER COUNTY RECOMMENDATION. 3. ALL EXISTING HEALTHY SABAL PALMS WILL BE RELOCATED ON THE SUBJECT SITE.

# TREE IDENTIFICATION KEY

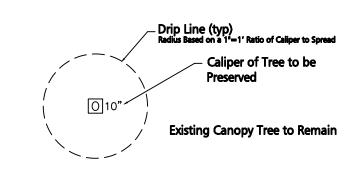

Stantec 6900 Professional Pkwv East, Suite 100 Sarasota, Florida 34240, U.S.A.

Tel. 941.907.6900 Fax. 941.907.6910 www.stantec.com

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2. 100% PLAN SET 1. 90% PLAN SET ASM SAB 02.13.13 Appd. YY.MM.DD Issued SAB 12.04.12 File Name: Dwn. Chkd. Dsgn. MM.DD.YY

> SCOTT A. BUTTARI. L.A. FLORIDA LICENSE NO. 0001756

Manatee County Board of County Comissioners

Blackstone Park


City of Palmetto, Florida

LANDSCAPE PLANTING NOTES


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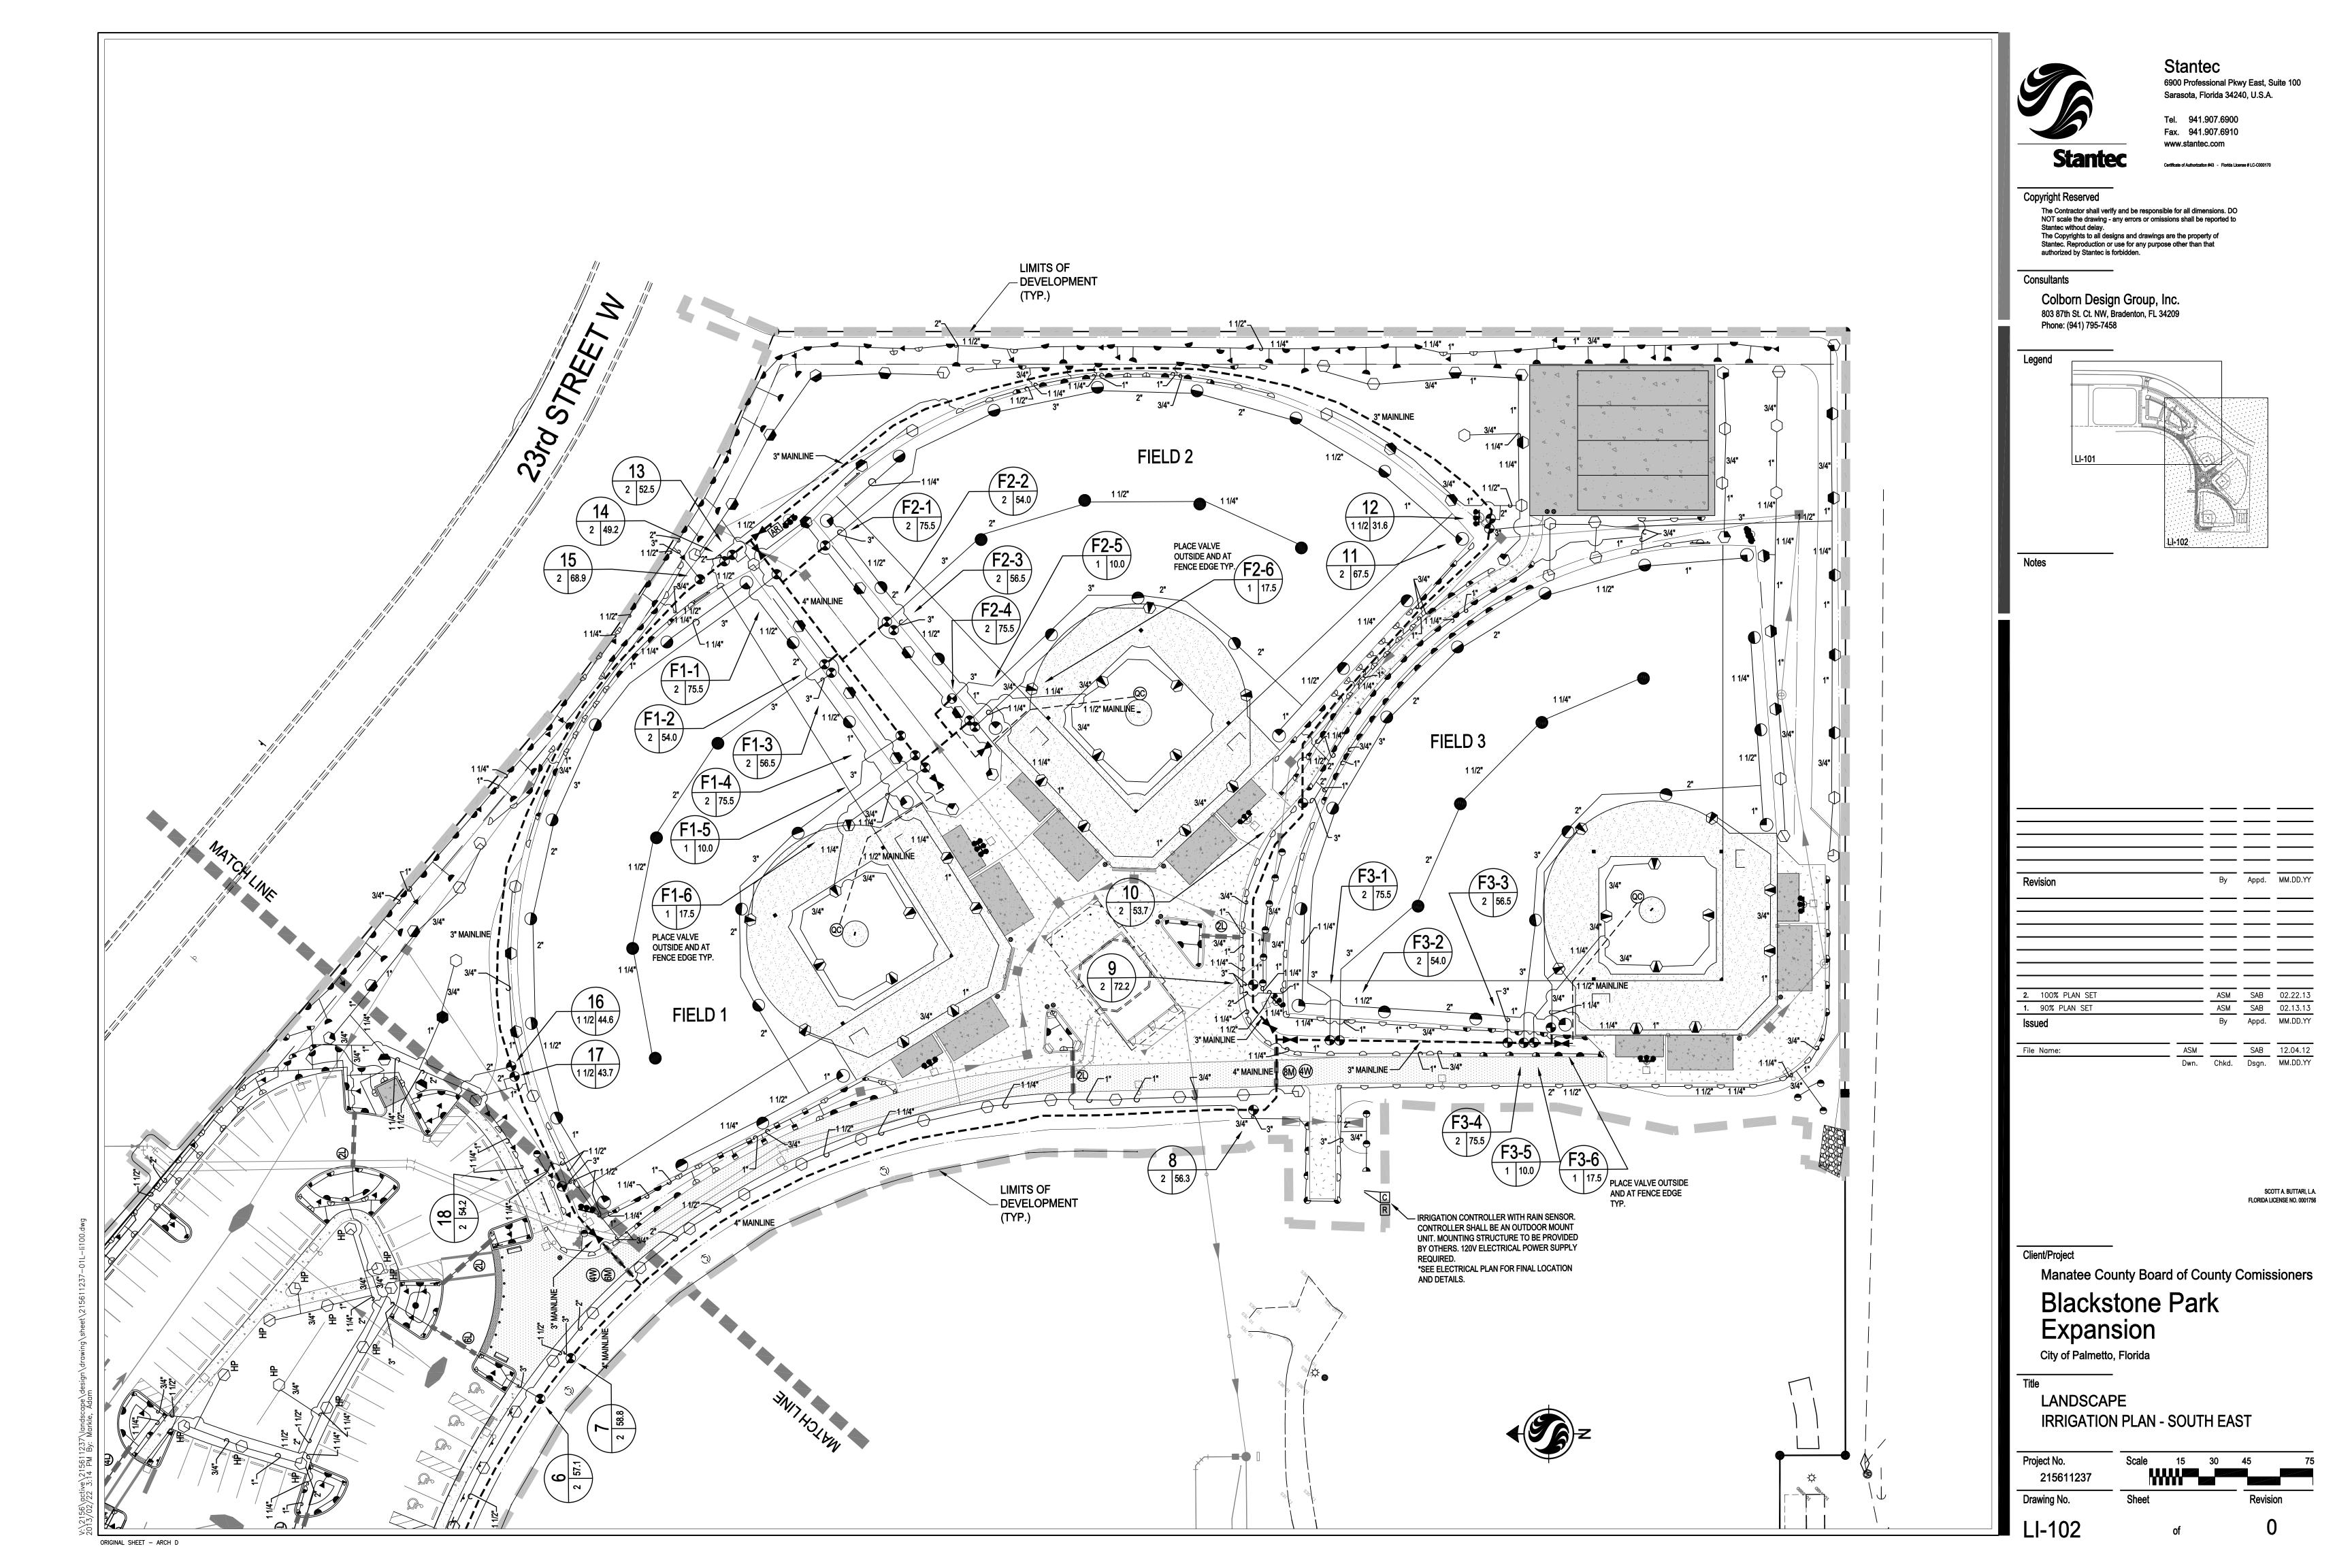
ORIGINAL SHEET - ARCH D




6900 Professional Pkwy East, Suite 100

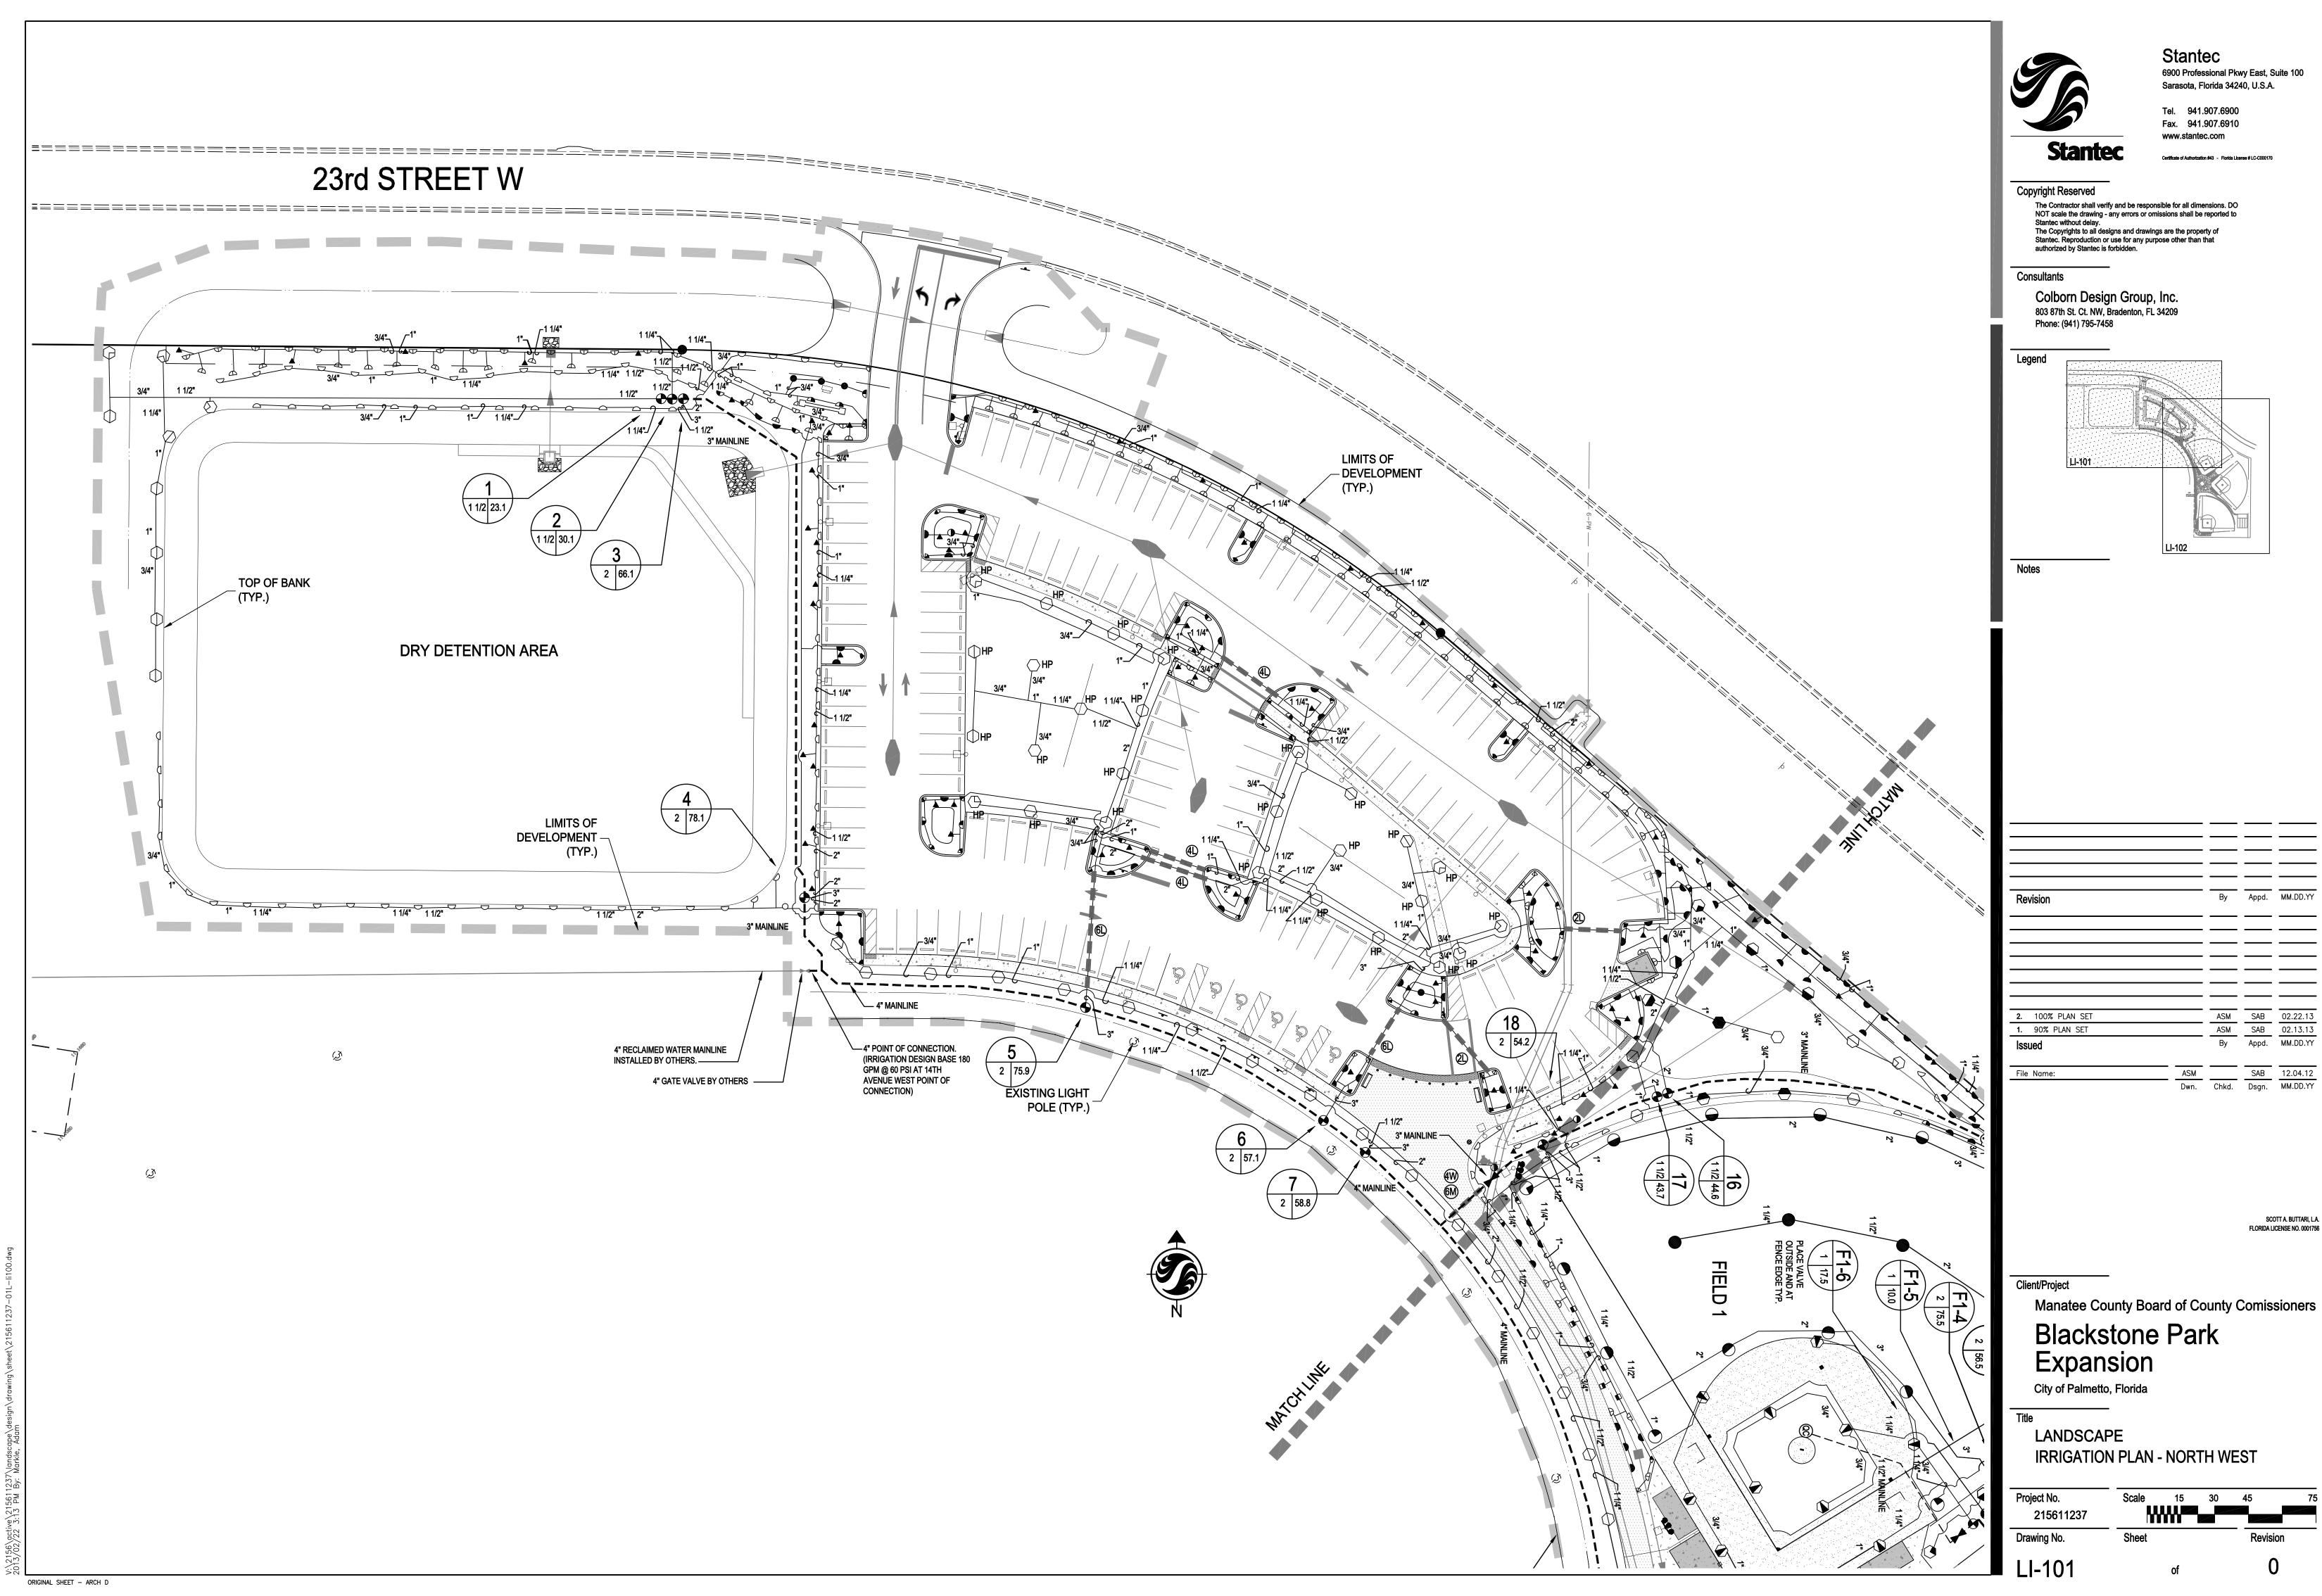

SCOTT A. BUTTARI, L.A. FLORIDA LICENSE NO. 0001756

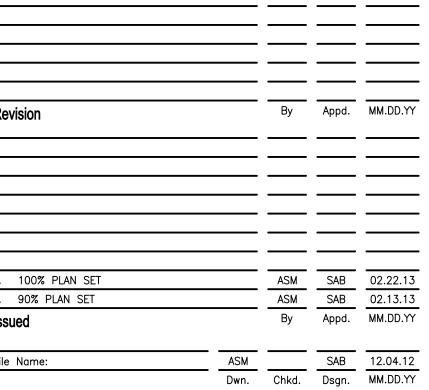

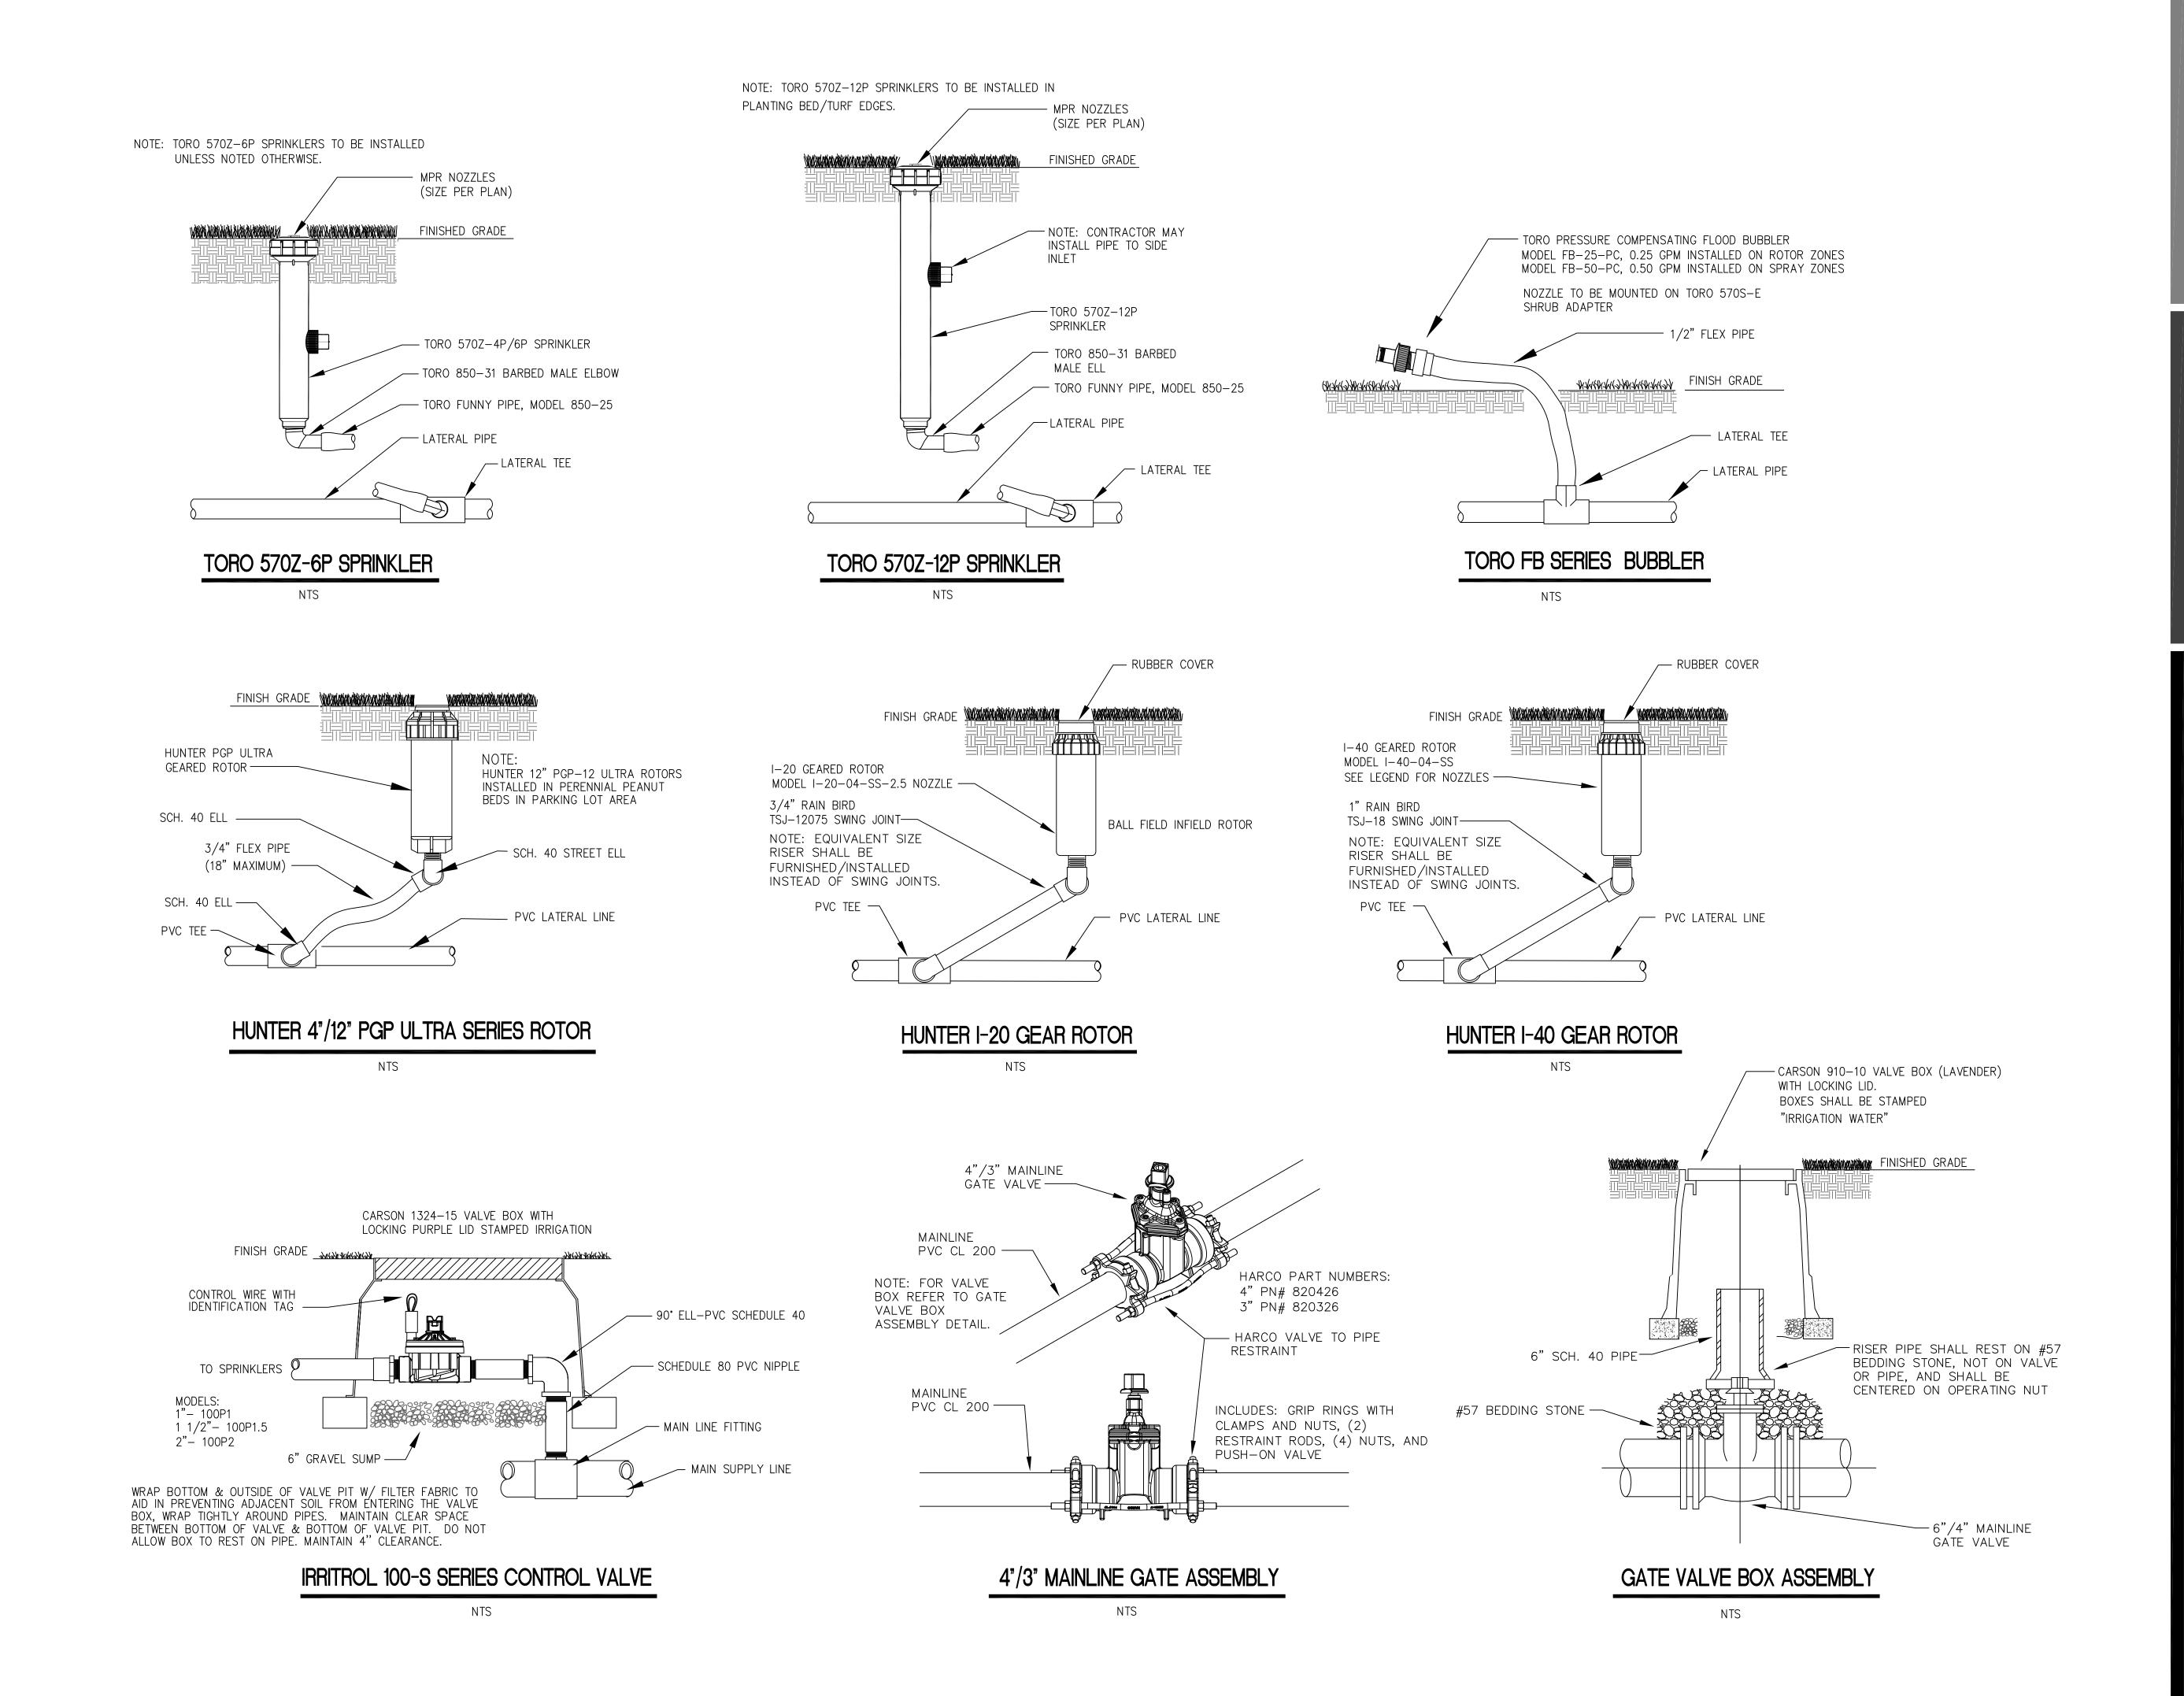

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Colborn Design Group, Inc. 803 87th St. Ct. NW, Bradenton, FL 34209 Phone: (941) 795-7458

3. REVISE SWING JOINT NOTE TO REQUIRE RISER ASM SAB 02.22.13
ASM SAB 02.13.13 2. 100% PLAN SET 1. 90% PLAN SET Appd. MM.DD.YY 
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Manatee County Board of County Comissioners

Blackstone Park Expansion


City of Palmetto, Florida


LANDSCAPE **IRRIGATION DETAILS** 

Project No. 15 30 45 215611237 Drawing No.

ORIGINAL SHEET - ARCH D

LI-501

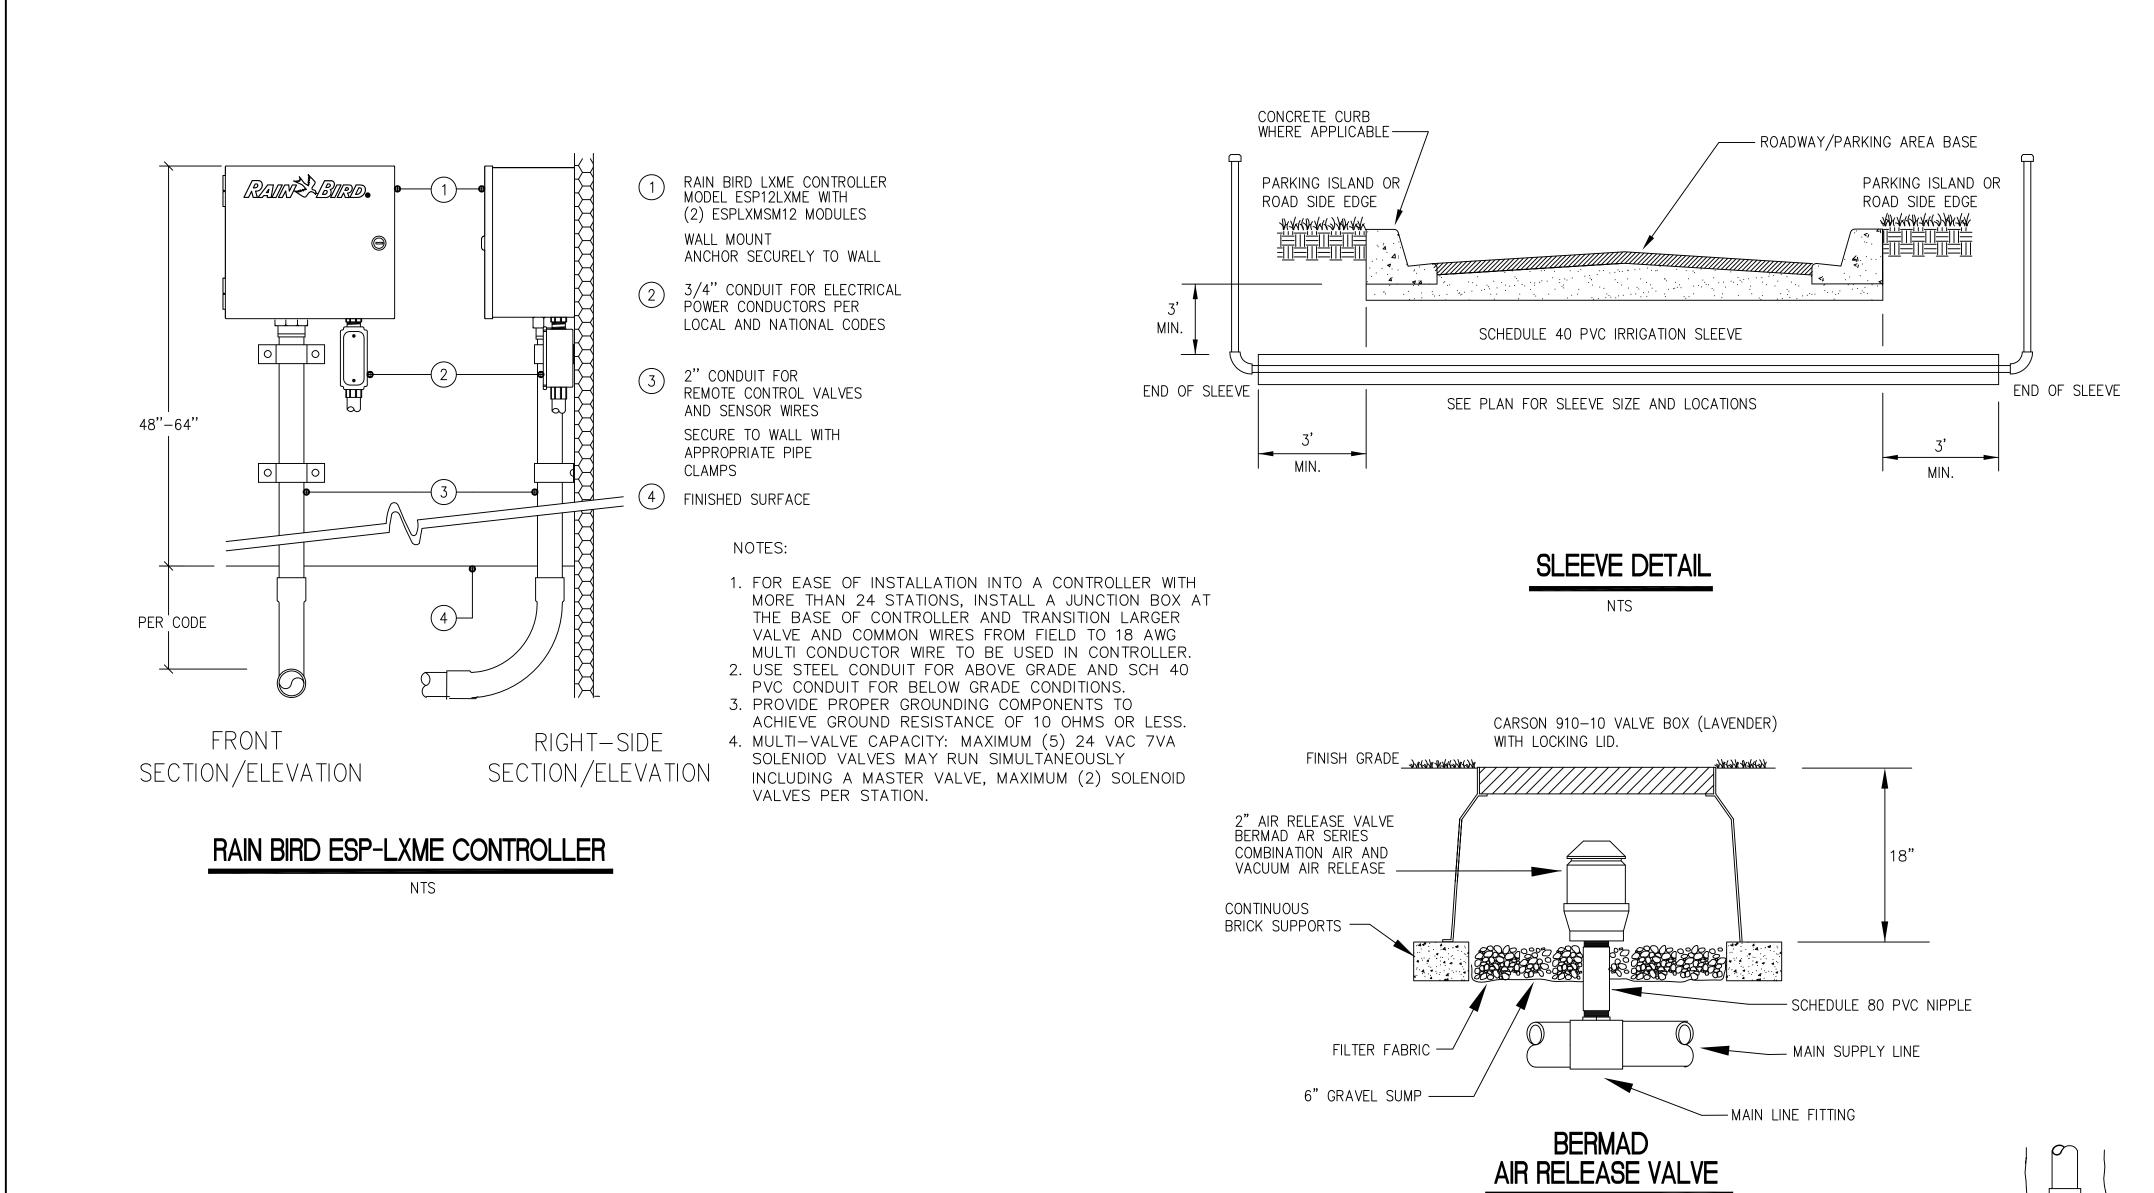

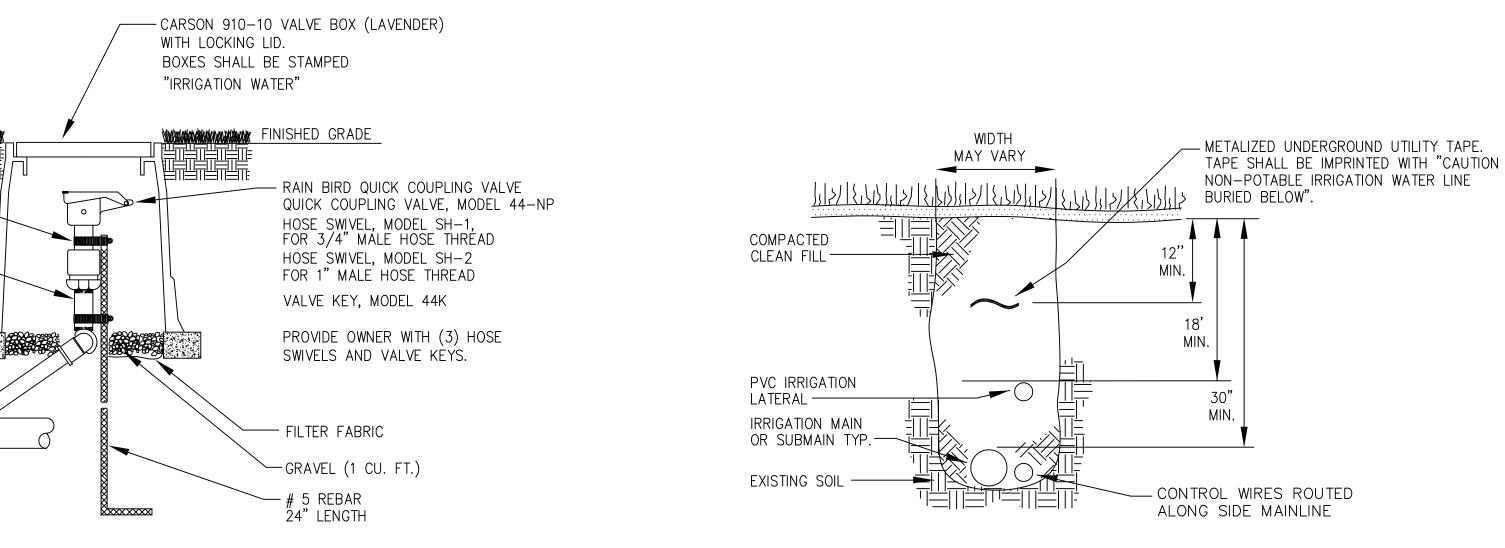

RAIN BIRD QUICK COUPLING VALVE

TRENCHING DETAIL NTS

4. FOR TEES, MINIMUM OF 2 CUBIC FEET OF CONCRETE TO BE USED. THRUST BLOCKS REQUIRED FOR IRRIGATION MAINLINE 2 1/2" AND LARGER. THRUST BLOCK REINFORCEMENT

INSTALLATION NOTES

1. 3000 PSI CONCRETE OR BETTER IS TO BE USED FOR THRUST BLOCKS.

NTS

2. FOR 45°/90° FITTINGS, MINIMUM OF 2 CUBIC FEET OF CONCRETE TO BE USED.

3. FOR 22 1/2° FITTINGS, MINIMUM OF 0.5 CUBIC FEET OF CONCRETE TO BE USED.



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**─**── 18"──

-CAUTION-

WATER SOURCE FOR

IRRIGATION IS REUSE

REUSE WATER SIGN

(NON-POTABLE)

CONTRACTOR TO

INSTALL 2 SIGNS.

LOCATIONS TO BE

MANATEE COUNTY

FINISH GRADE

DETERMINED BY

STAFF.

WHITE LETTERING

PURPLE BACKGROUND -

FURNISH AND

Colborn Design Group, Inc. 803 87th St. Ct. NW, Bradenton, FL 34209 Phone: (941) 795-7458

**VARIES** 

Notes

3. REVISE SWING JOINT NOTE TO REQUIRE RISER ASM SAB 02.22.13 ASM SAB 02.13.13 2. 100% PLAN SET 1. 90% PLAN SET Appd. MM.DD.YY 
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 File Name:

SCOTT A. BUTTARI, L.A.

Manatee County Board of County Comissioners

Project No. 15 30 45 215611237 Drawing No. LI-502

ORIGINAL SHEET - ARCH D

STAINLESS STEEL

SCREW CLAMPS -

CONTINUOUS

DUCTILE IRON SERVICE TEE-

NTS

NOTE: EQUIVALENT SIZE RISER SHALL BE

FURNISHED/INSTALLED

PVC MAIN LINE

INSTEAD OF SWING

JOINTS.

SCH 80 PVC NIPPLE -

BRICK SUPPORTS —

RAIN BIRD SWING JOINT MODEL: TSJ-18

FLORIDA LICENSE NO. 0001756

Blackstone Park

Expansion

City of Palmetto, Florida


LANDSCAPE IRRIGATION DETAILS

# CONTROLLER SCHEDULE

| ZONE GPM                                                                                                                                                                                                                                                                                                                                                                                                                                                                                | VALVE<br>SIZE                                                                      | TYPE                                                                                                                                                                                                                                                                                                                                                                                                                                                                                                                                                                                                                                                                                                                                     |
|-----------------------------------------------------------------------------------------------------------------------------------------------------------------------------------------------------------------------------------------------------------------------------------------------------------------------------------------------------------------------------------------------------------------------------------------------------------------------------------------|------------------------------------------------------------------------------------|------------------------------------------------------------------------------------------------------------------------------------------------------------------------------------------------------------------------------------------------------------------------------------------------------------------------------------------------------------------------------------------------------------------------------------------------------------------------------------------------------------------------------------------------------------------------------------------------------------------------------------------------------------------------------------------------------------------------------------------|
| 1 23.1<br>2 30.1<br>3 66.1<br>4 78.1<br>5 75.9<br>6 57.1<br>7 58.8<br>8 56.3<br>9 72.2<br>10 53.7<br>11 67.5<br>12 31.6<br>13 52.5<br>14 49.2<br>15 68.9<br>16 44.6<br>17 43.7<br>18 64.2<br>F1-1 75.5<br>F1-2 54.0<br>F1-3 56.5<br>F1-4 75.5<br>F1-5 10.0<br>F1-6 17.5<br>F2-1 75.5<br>F2-1 75.5<br>F2-2 54.0<br>F2-3 56.5<br>F2-4 75.5<br>F2-5 10.0<br>F3-6 55.5<br>F3-1 75.5<br>F3-1 75.5<br>F3-2 54.0<br>F3-6 55.5<br>F3-1 75.5<br>F3-1 75.5<br>F3-1 75.5<br>F3-2 54.0<br>F3-6 17.5 | 1 1/2" 1 1/2" 2" 2" 2" 2" 2" 2" 2" 2" 1 1/2" 2" 2" 2" 2" 2" 2" 2" 2" 2" 2" 2" 2" 2 | ROTOR SPRAY PLANTS SPRAY TURF SPRAY TURF ROTOR PLANTS SPRAY TURF ROTOR SPRAY TURF SPRAY TURF SPRAY TURF SPRAY TURF ROTOR ROTOR ROTOR ROTOR SPRAY PLANTS SPRAY PLANTS SPRAY PLANTS SPRAY PLANTS SPRAY PLANTS ROTOR SPRAY PLANTS FIELD 1 ROTOR FIELD 2 ROTOR FIELD 3 ROTOR |

IRRIGATION DESIGN BASE: 180 GPM AT 60 PSI AT POINT OF CONNECTION.
CONTRACTOR HAS OPTION OF PROGRAMMING CONTROLLER TO ALLOW TWO OR MORE ZONES TO RUN SIMULTANEOUSLY. DO NOT EXCEED 180 GPM DESIGN BASE.

\*NOTE: AN ADDITIONAL MODULE (4, 8, OR 12 STATION) CAN BE ADDED FOR FUTURE ZONES.

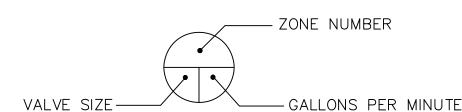

# IRRIGATION NOTES

- 1) THE HEAD LAYOUT HAS BEEN DESIGNED TO PROVIDE 100% COVERAGE. ANY CHANGES MADE IN THE HEAD LAYOUT DUE TO FIELD CONDITIONS SHALL BE IN ACCORDANCE WITH THESE STANDARDS.
- 2) SET SPRAY HEADS 3" AND ROTORS 6" IN FROM BACK OF CURB OR 12" IF PAVEMENT HAS NO CURB.
- VERIFY LOCATIONS OF ALL UNDERGROUND UTILITIES PRIOR TO INSTALLATION OF IRRIGATION SYSTEM. MAINLINE SHALL NOT BE LOCATED WITHOUT PRIOR APPROVAL OF THE PROJECT MANAGER AND THE LANDSCAPE ARCHITECT. ALL UTILITIES AND STRUCTURES MAY NOT BE SHOWN ON THESE PLANS—CONTRACTOR SHALL VERIFY.
- 4) ALL PRESSURE MAINLINES UNDER ASPHALT PAVEMENT SHALL BE WITHIN SLEEVES AS NOTED. IRRIGATION COMMUNICATION CABLE SHALL HAVE ITS OWN SEPARATE SLEEVE. LATERAL LINES SHALL BE CONTAINED WITHIN THEIR OWN SLEEVE WHERE SHOWN ON THE PLAN.
- 5) ALL SLEEVES UTILIZED BY THE IRRIGATION CONTRACTOR, WHETHER INSTALLED BY HIM OR NOT, SHALL BE LOCATED ON THE "AS-BUILT" DRAWINGS. THE DEPTH BELOW FINISH GRADE, TO THE NEAREST FOOT OF EACH END OF EACH SLEEVE SHALL BE NOTED AT EACH SLEEVE LOCATION ON THE "AS-BUILT" DRAWINGS.
- 6) MAINLINE AND VALVES ARE SHOWN IN SCHEMATIC FORM. LOCATE AS NOTED ON PLANS.
- 7) LOCATE ALL VALVES A MINIMUM OF 24" FROM BACK OF CURB OR EDGE OF PAVEMENT, UNLESS NOTED OTHERWISE.
- 8) ALL UNSIZED PIPE SHALL BE 3/4" UNLESS OTHERWISE NOTED.
- 9) ALL VALVES SHALL BE INSTALLED IN A CARSON LAVENDER COLOR VALVE BOX WITH LOCKING LID AND STAMPED "IRRIGATION WATER". SEE DETAILS FOR MODEL NUMBERS.
- 10) IRRIGATION CONTRACTOR SHALL SECURE ANY AND ALL NECESSARY PERMITS FOR THE WORK PRIOR TO COMMENCEMENT OF HIS OPERATIONS ON—SITE. COPIES OF THE PERMITS SHALL BE SENT TO THE OWNER/GENERAL CONTRACTOR. WORK IN THE R.O.W. SHALL CONFORM TO THE STANDARDS AND SPECIFICATIONS OF LOCAL AND/OR STATE HIGHWAY JURISDICTION.
- VERIFY POINT OF CONNECTION AND IRRIGATION CONTROLLER LOCATION AT PROJECT SITE WITH OWNER.
- 12) ELECTRIC SERVICE TO THE IRRIGATION CONTROLLER SHALL BE PROVIDED BY THE GENERAL CONTRACTOR.
- 13) ALL 24 VAC WIRING SHALL BE OF DIRECT BURIAL COPPER WIRE AS FOLLOWS:

  CONTROL WIRES #14

  COMMON WIRES #12
- DURING INSTALLATION AND UPON COMPLETION OF THE IRRIGATION SYSTEM, VALVES SHALL BE WIRED TO THE CONTROLLER AS PER THE IRRIGATION ZONE NUMBERS.
- ALL CONNECTIONS TO THE IRRIGATION MAINLINE SHALL BE ACCOMPLISHED USING HARCO DUCTILE IRON SERVICE TEES. ALL CHANGES IN DIRECTION OF THE MAINLINE SHALL BE ACCOMPLISHED USING HARCO DUCTILE IRON 45 DEGREE ELBOWS.
- 16) CONTRACTOR SHALL INSTALL METALIZED IDENTIFICATION TAPE ABOVE ALL IRRIGATION MAINLINES AS SHOWN ON TRENCHING DETAIL.
- 17) INSTALLATION OF WORK SHALL BE COORDINATED WITH OTHER CONTRACTORS IN SUCH A MANNER AS TO ALLOW FOR A SPEEDY AND ORDERLY COMPLETION OF ALL WORK ON THE SITE.
- 18) IRRIGATION COMPONENTS SHALL BE DESIGNATED FOR RECLAIMED WATER APPLICATION AS REQUIRED PER LOCAL CODE.
- 19) PRODUCTS SHALL BE AS SPECIFIED.

# IRRIGATION LEGEND

TORO MPR PLUS SPRAY NOZZLES
570Z-6P TURF AREAS

570Z-12P TURF AREAS □ 15-Q 27° TRAJECTORY 15-T 27° TRAJECTORY 15-H 27° TRAJECTORY 15-TQ 27° TRAJECTORY 15-F 27° TRAJECTORY 12-Q 23° TRAJECTORY 12-T 23° TRAJECTORY 12-H 23° TRAJECTORY 12-TQ 23° TRAJECTORY 12-F 23° TRAJECTORY 10-Q 12° TRAJECTORY 10-T 12° TRAJECTORY 12° TRAJECTORY 12° TRAJECTORY

8-Q
 5° TRAJECTORY
 8-H
 5° TRAJECTORY
 4-EST

4-SST

■ 4-CST

TORO FB-25-PC BUBBLER, (ROTOR ZONES)

TORO FB-50-PC BUBBLER, (SPRAY ZONES)

→ HUNTER PGP ULTRA ROTOR PGP-04-2.0 NOZZLE, 90° ADJUSTABLE

→ HUNTER PGP ULTRA ROTOR PGP-04-3.0 NOZZLE, 180° ADJUSTABLE
 → HUNTER PGP ULTRA ROTOR PGP-04-5.0 NOZZLE, 270° ADJUSTABLE

HUNTER PGP ULTRA ROTOR PGP-04-6.0 NOZZLE, 360° ADJUSTABLE
 ⊕ HUNTER PGP ULTRA ROTOR PGP-04-2.0 LA NOZZLE, 90° ADJUSTABLE
 ⊕ HUNTER PGP ULTRA ROTOR PGP-04-2.5 LA NOZZLE, 180° ADJUSTABLE
 ⊕ HUNTER PGP ULTRA ROTOR PGP-04-3.5 LA NOZZLE, 270° ADJUSTABLE

○ HUNTER PGP ULTRA ROTOR PGP-04-4.5 LA NOZZLE, 360° ADJUSTABLE
 ○ HP HUNTER PGP ULTRA ROTOR PGP-12-2.0 LA NOZZLE, 90° ADJUSTABLE
 ○ HP HUNTER PGP ULTRA ROTOR PGP-12-2.5 LA NOZZLE, 180° ADJUSTABLE

HUNTER PGP ULTRA ROTOR PGP-12-4.5 LA NOZZLE, 360° ADJUSTABLE

♣ HUNTER I-20 ROTOR I-20-04-SS-2.5 NOZZLE, 180° ADJUSTABLE
 ♣ HUNTER I-40 ROTOR I-40-04-SS-40 NOZZLE, 90° ADJUSTABLE
 ♣ HUNTER I-40 ROTOR I-40-04-SS-43 NOZZLE, 180° ADJUSTABLE

HUNTER I-40 ROTOR I-40-04-SS-43 NOZZLE, 760° ADJUSTABLE
 RAIN BIRD ESP-LXME WALL MOUNT CONTROLLER. SEE DETAIL FOR MODEL COMPONENTS. PROVIDE CONNECTION

RAIN BIRD ESP-LXME WALL MOUNT CONTROLLER. SEE DETAIL FOR MODEL COMPONENTS. PROVIDE CONNECTION & MATERIALS NECESSARY FOR CONTROLLER INSTALLATION AND OPERATION.

R HUNTER MINI-CLIK RAIN SENSOR

IRRITROL 100-S SERIES ELECTRIC CONTROL VALVE

AR BERMAD AR SERIES COMBINATION AIR AND VACUUM RELEASE VALVE

RAIN BIRD MODEL 44-NP 1" QUICK COUPLING VALVE

HARCO RESTRAINT GATE VALVE, INSTALLED PER LINE SIZE AND IN 12" VALVE BOX

CLASS 200 PVC GASKETTED MAINLINE W/DUCTILE IRON FITTINGS, PANTONE PURPLE 522C

CLASS 200 PVC LATERAL LINE, SOLVENT WELD, PANTONE PURPLE 522C

SCHEDULE 40 PVC SLEEVE (SEE PLAN FOR SLEEVE SIZE)

8M) 8" MAINLINE SLEEVE

6M 6" MAINLINE SLEEVE 6L) 6" LATERAL SLEEVE

4 4 LATERAL SLEEVE

2D 2" LATERAL SLEEVE 4W) 4" CONTROL WIRE SLEEVE

Stantec 6900 Professional Pkwy East, Suite 100 Sarasota, Florida 34240, U.S.A.

Tel. 941.907.6900 Fax. 941.907.6910 www.stantec.com

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Consultants

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Legend

Note

 Revision
 By
 Appd.
 MM.DD.YY

 2. 100% PLAN SET
 ASM
 SAB
 02.22.13

 1. 90% PLAN SET
 ASM
 SAB
 02.13.13

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SCOTT A. BUTTARI, L.A. FLORIDA LICENSE NO. 0001756

Client/Project

Manatee County Board of County Comissioners

Blackstone Park Expansion

City of Palmetto, Florida

ANDSCA

LANDSCAPE IRRIGATION NOTES

 Project No.
 Scale
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