



SWWRF LAKE FILTRATION AND NORTH POND IMPROVEMENTS

COUNTY PROJECT #6079180

ISSUE FOR BID
FEBRUARY 2012

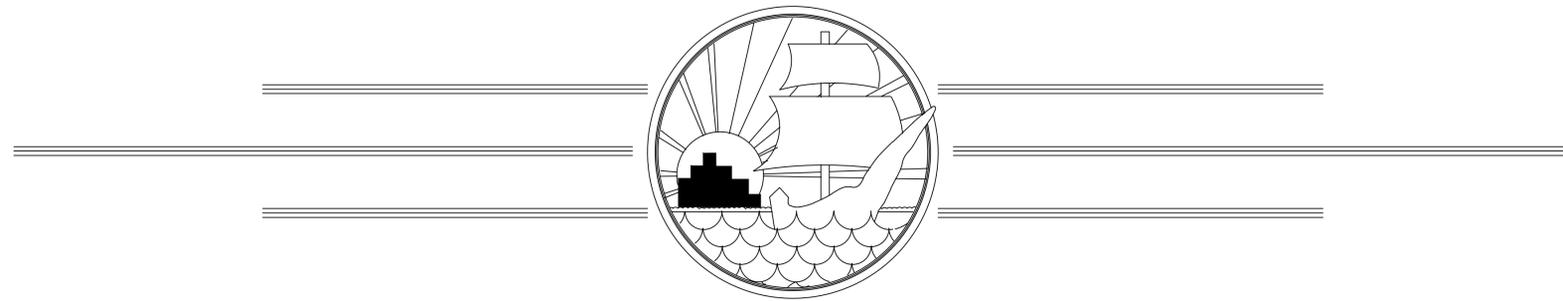

MANATEE COUNTY, FLORIDA

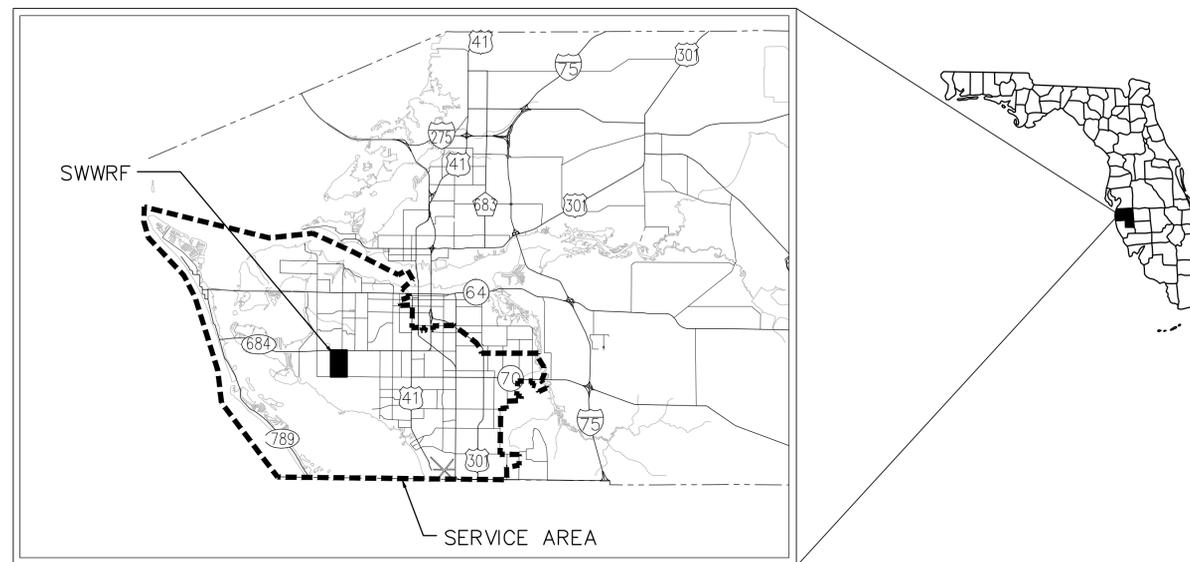


PROJECT VICINITY MAP



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LEGEND:

- PUMP STATION
- NORMALLY OPEN VALVE
- NORMALLY CLOSED VALVE
- BACKPRESSURE SUSTAINING VALVE
- ALTITUDE VALVE
- MOTORIZED VALVE
- FLOW METER
- YARD PIPING
- GRAVITY FLOW
- GATE
- WEIR GATE
- WEIR
- LAKE LEVEL INDICATOR
- SAMPLE POINT
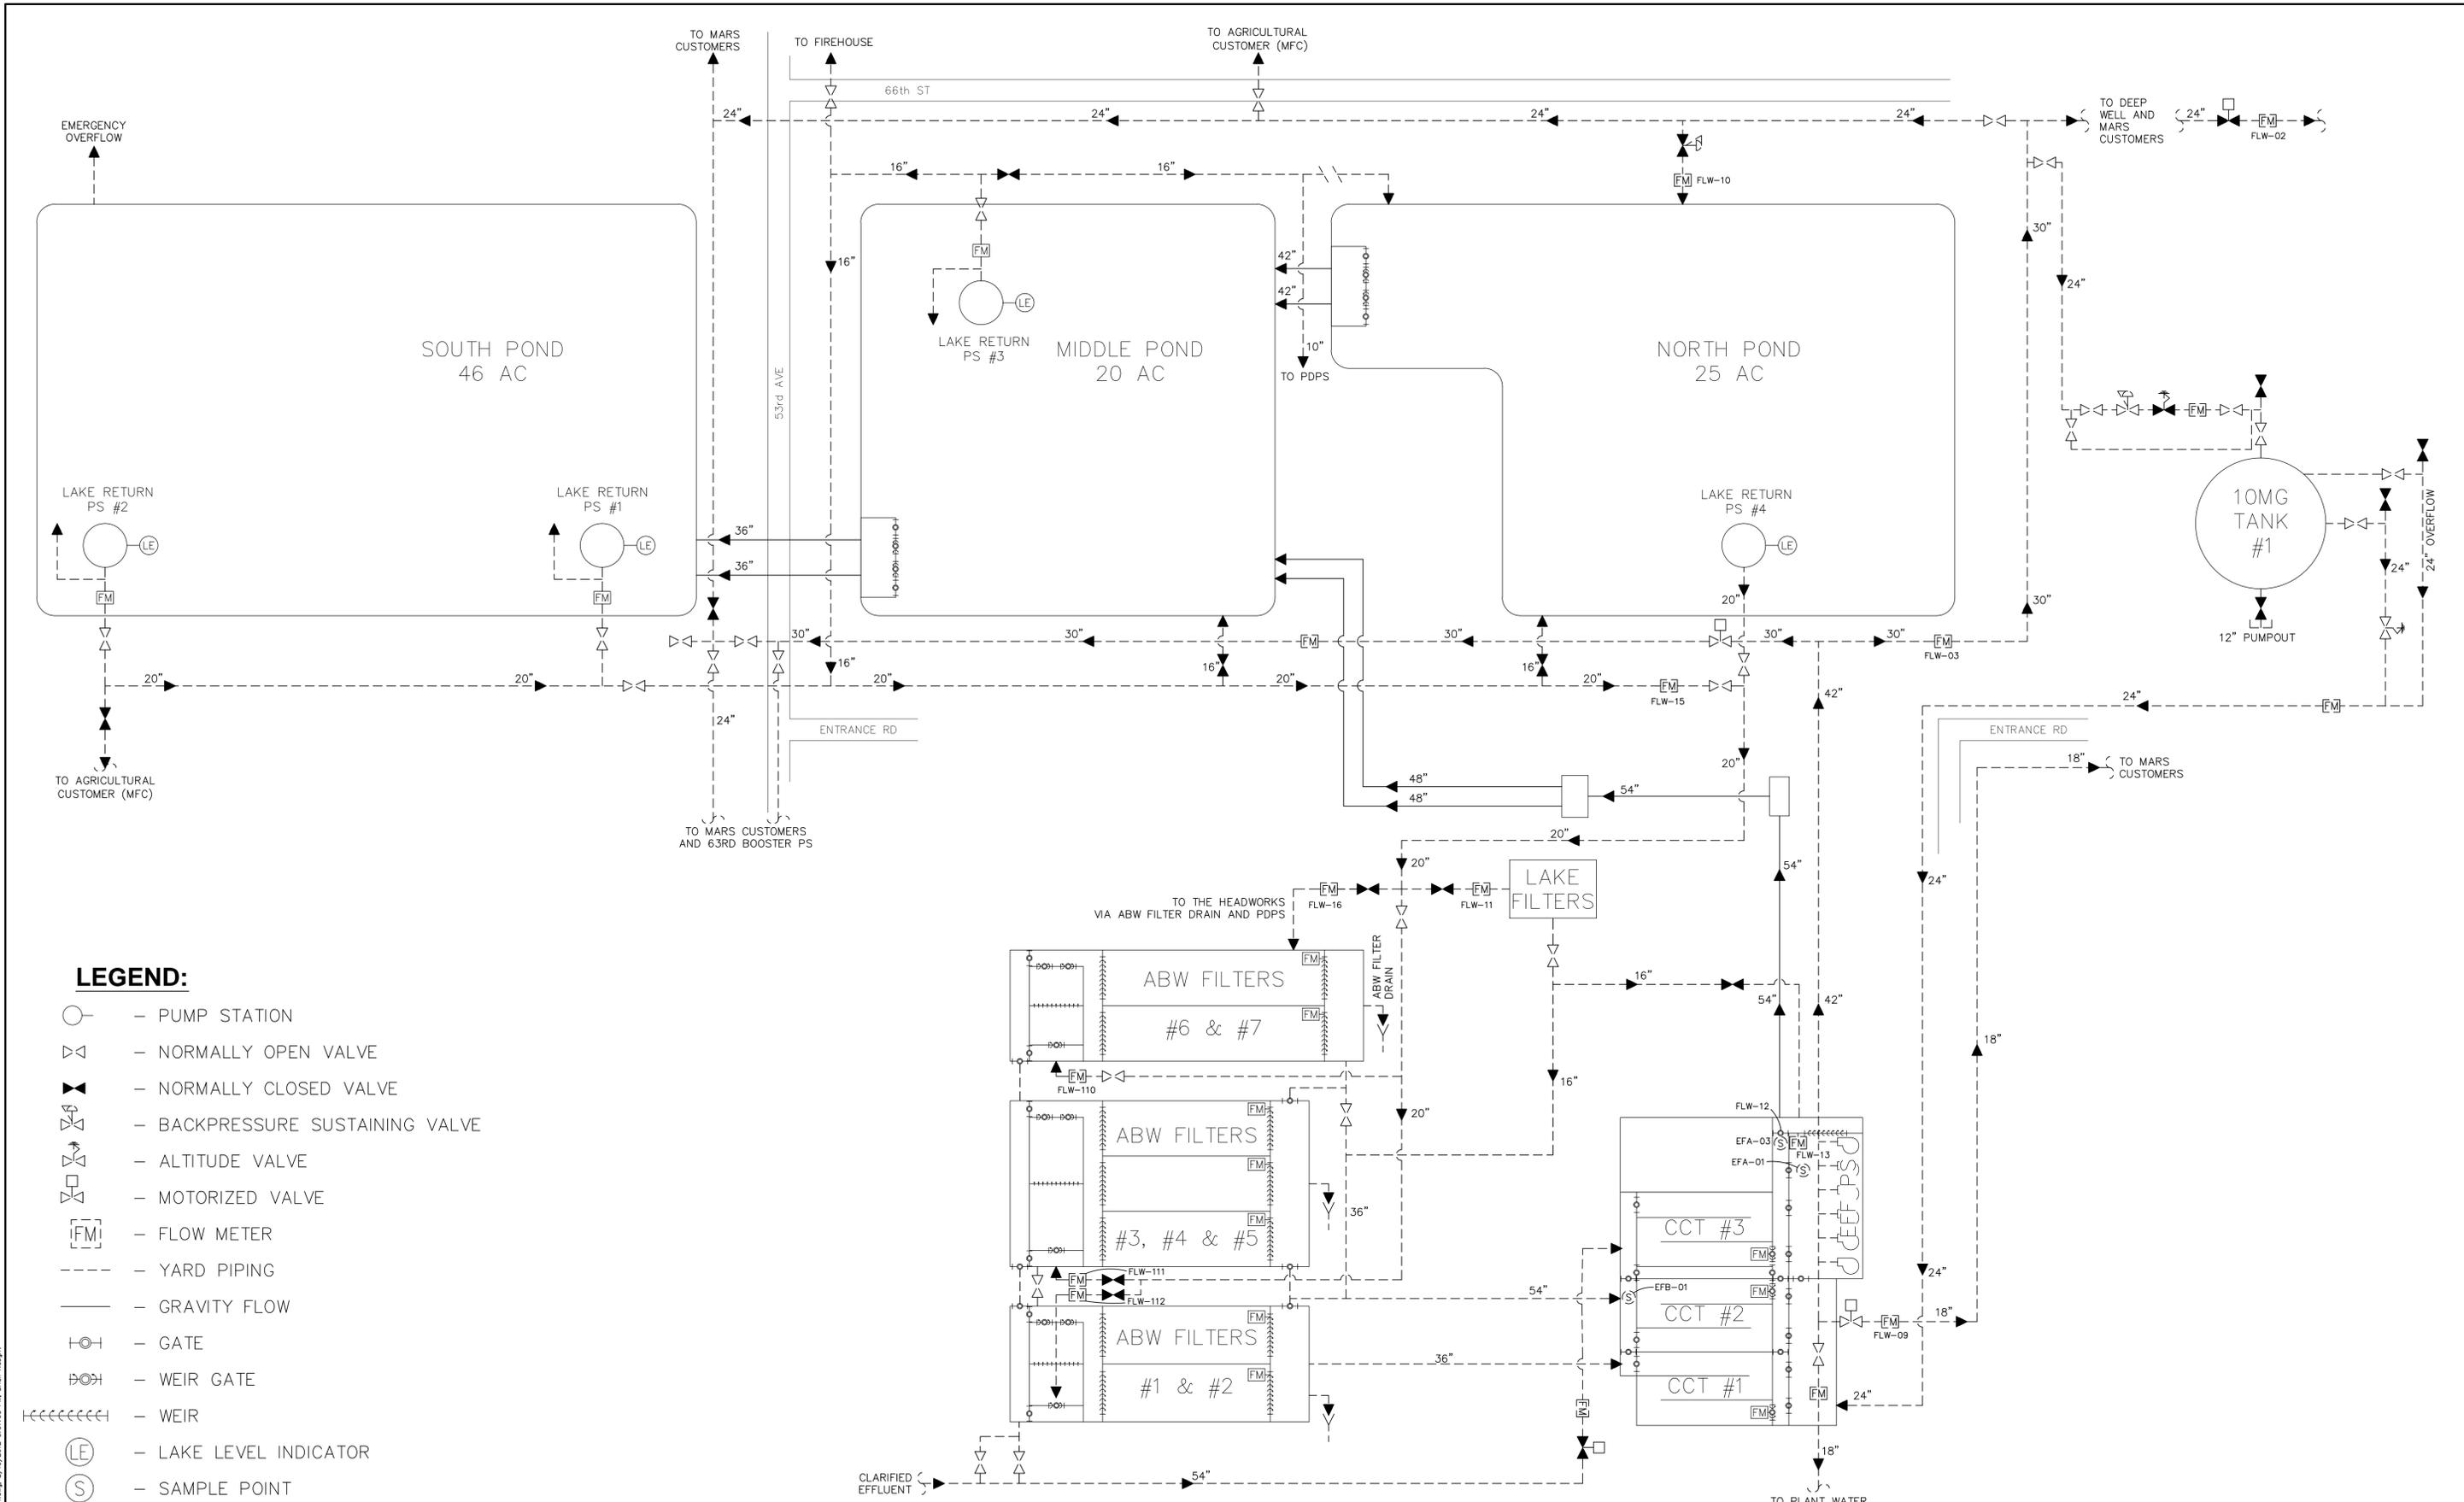
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REV. NO.	DESCRIPTIONS	DATE

SEAL
 MATTHEW S. LOVE, P.E.
 No. 66118

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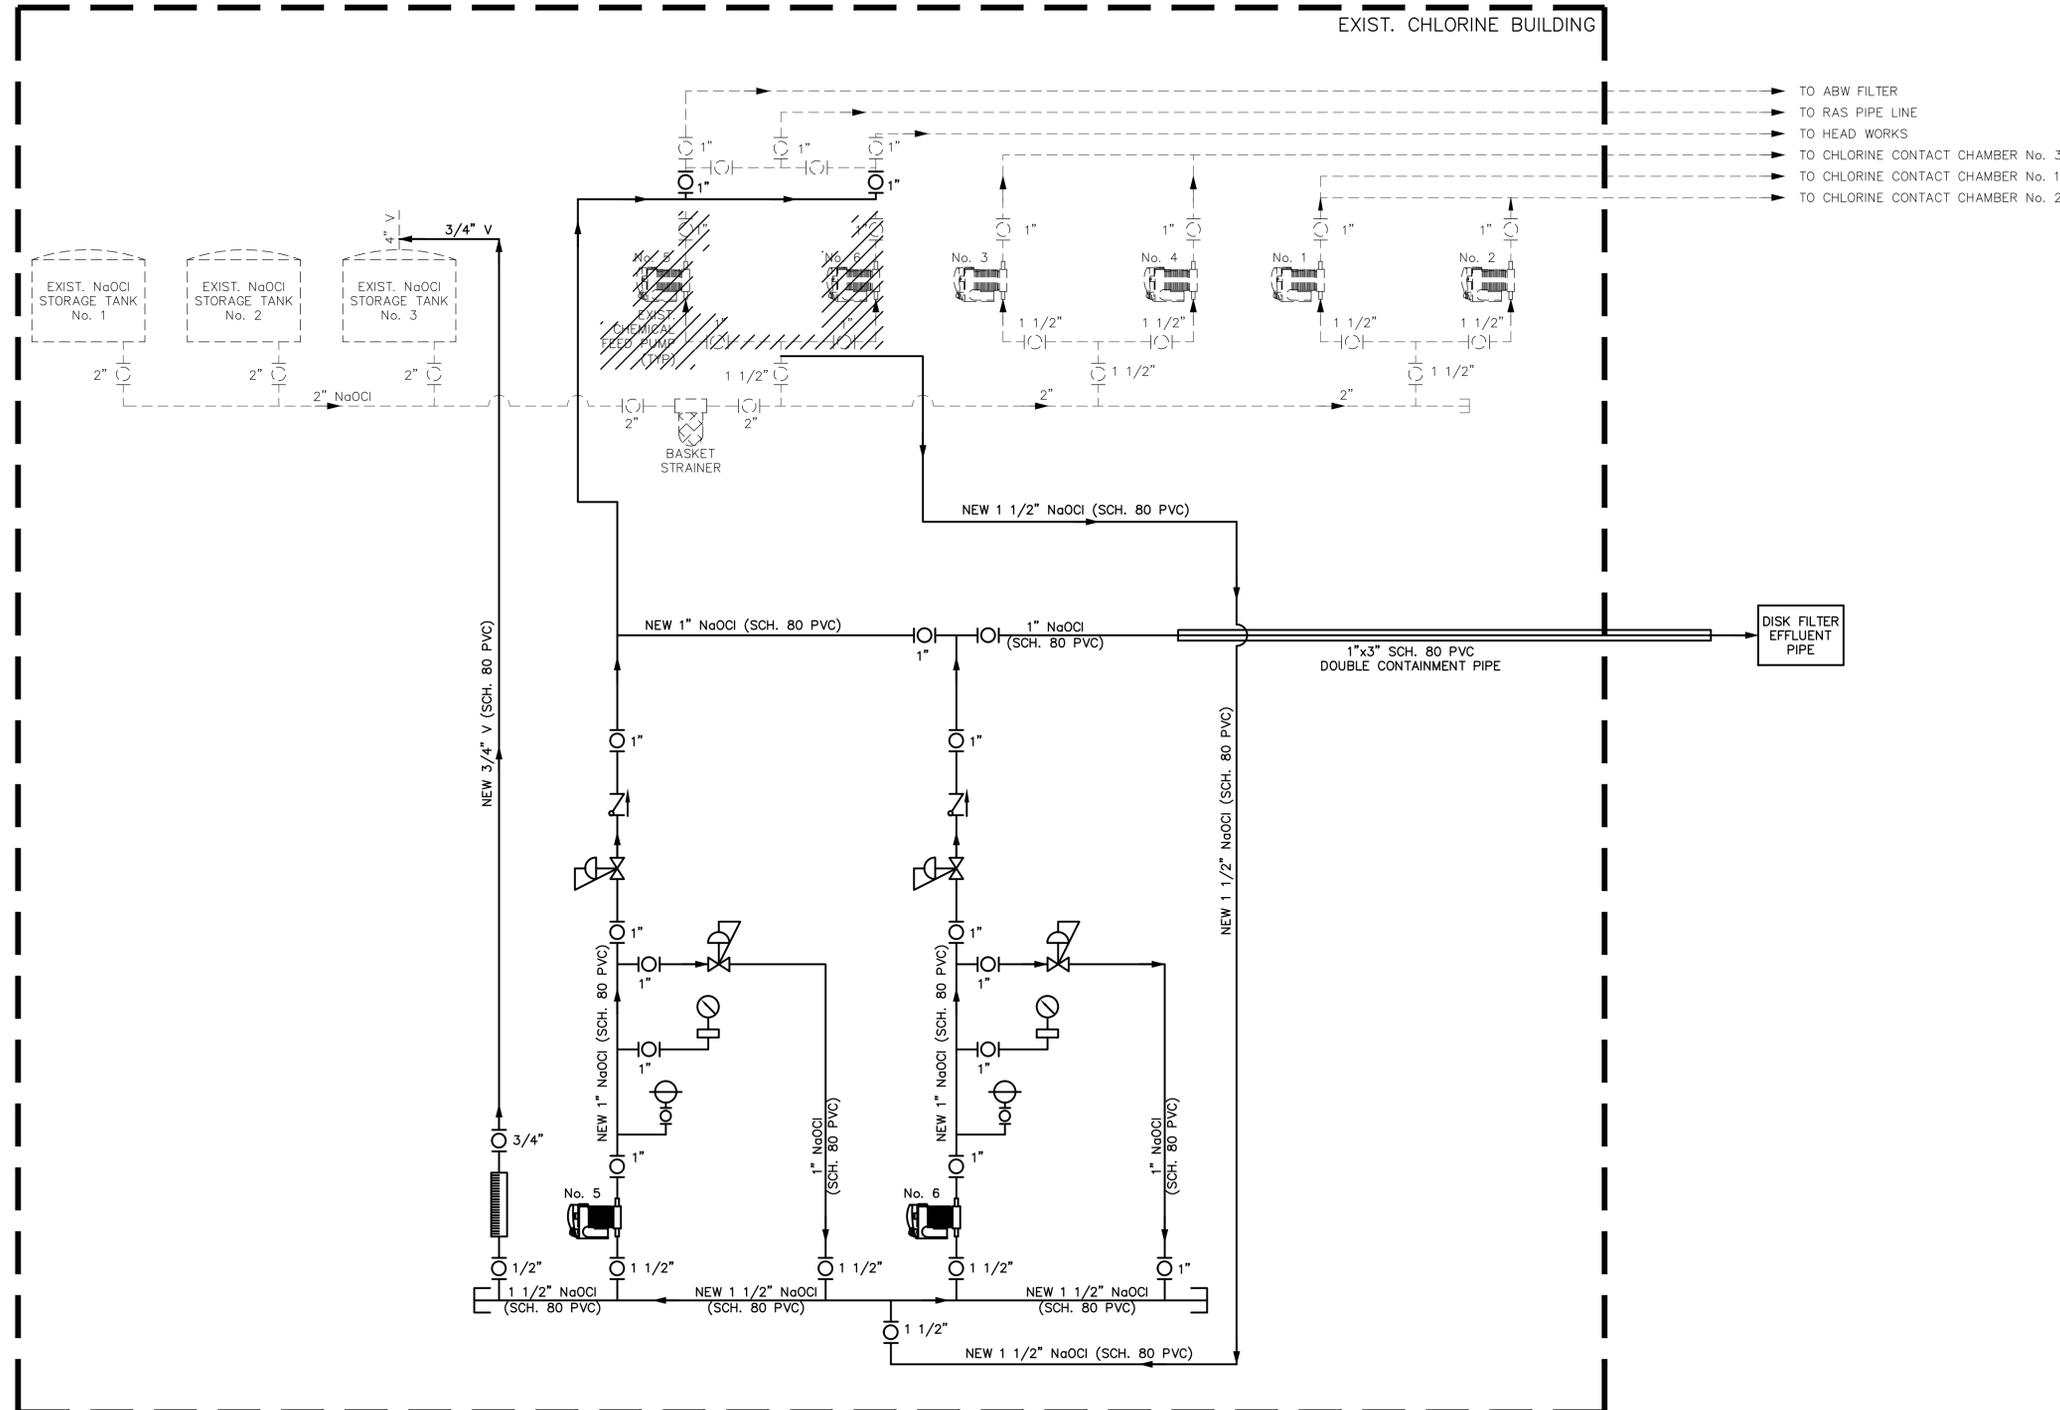
MANATEE COUNTY, FLORIDA

SWRF LAKE FILTRATION AND NORTH POND IMPROVEMENTS
EXISTING PROCESS FLOW SCHEMATIC


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MCE PROJ. # 1024-0147	HORIZONTAL: NA	
DRAWN: DMP	VERTICAL: NA	
DESIGNED: MSL		
CHECKED: JSL		
PROJ. MGR. MSL		

STATUS: **ISSUE FOR BID**

NOTES:
 1. REPLACE CHEMICAL FEED PUMPS 5 AND 6 WITH NEW CHEMICAL FEED PUMPS. REPLACE THE SKID, PIPING AND VALVES ASSOCIATED WITH THE PUMPS. CONNECT TO THE CHLORINE SOLUTION PIPING FOR THE EXISTING ABW FILTERS, RAS PIPELINE, AND HEADWORKS. CONNECT TO THE NEW DISK FILTER EFFLUENT PIPE. SEE SODIUM HYPOCHLORITE CHEMICAL FEED PLANS AND DETAILS ON DRAWING Nos. C-6.1 AND C-6.2.



- TO ABW FILTER
- TO RAS PIPE LINE
- TO HEAD WORKS
- TO CHLORINE CONTACT CHAMBER No. 3
- TO CHLORINE CONTACT CHAMBER No. 1
- TO CHLORINE CONTACT CHAMBER No. 2

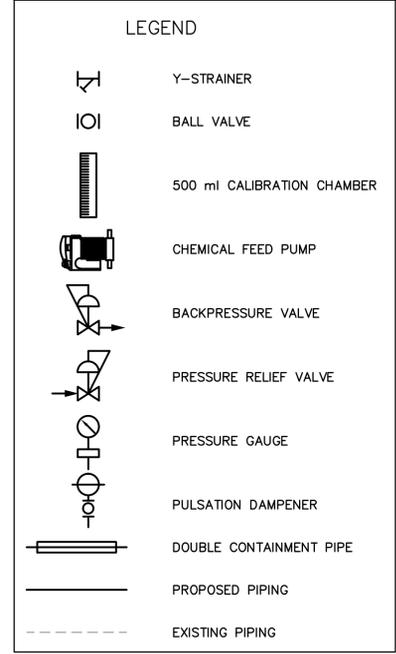

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REV. NO.	DESCRIPTIONS	DATE

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NORMAN J. SCALLY, P.E.
 No. 41338

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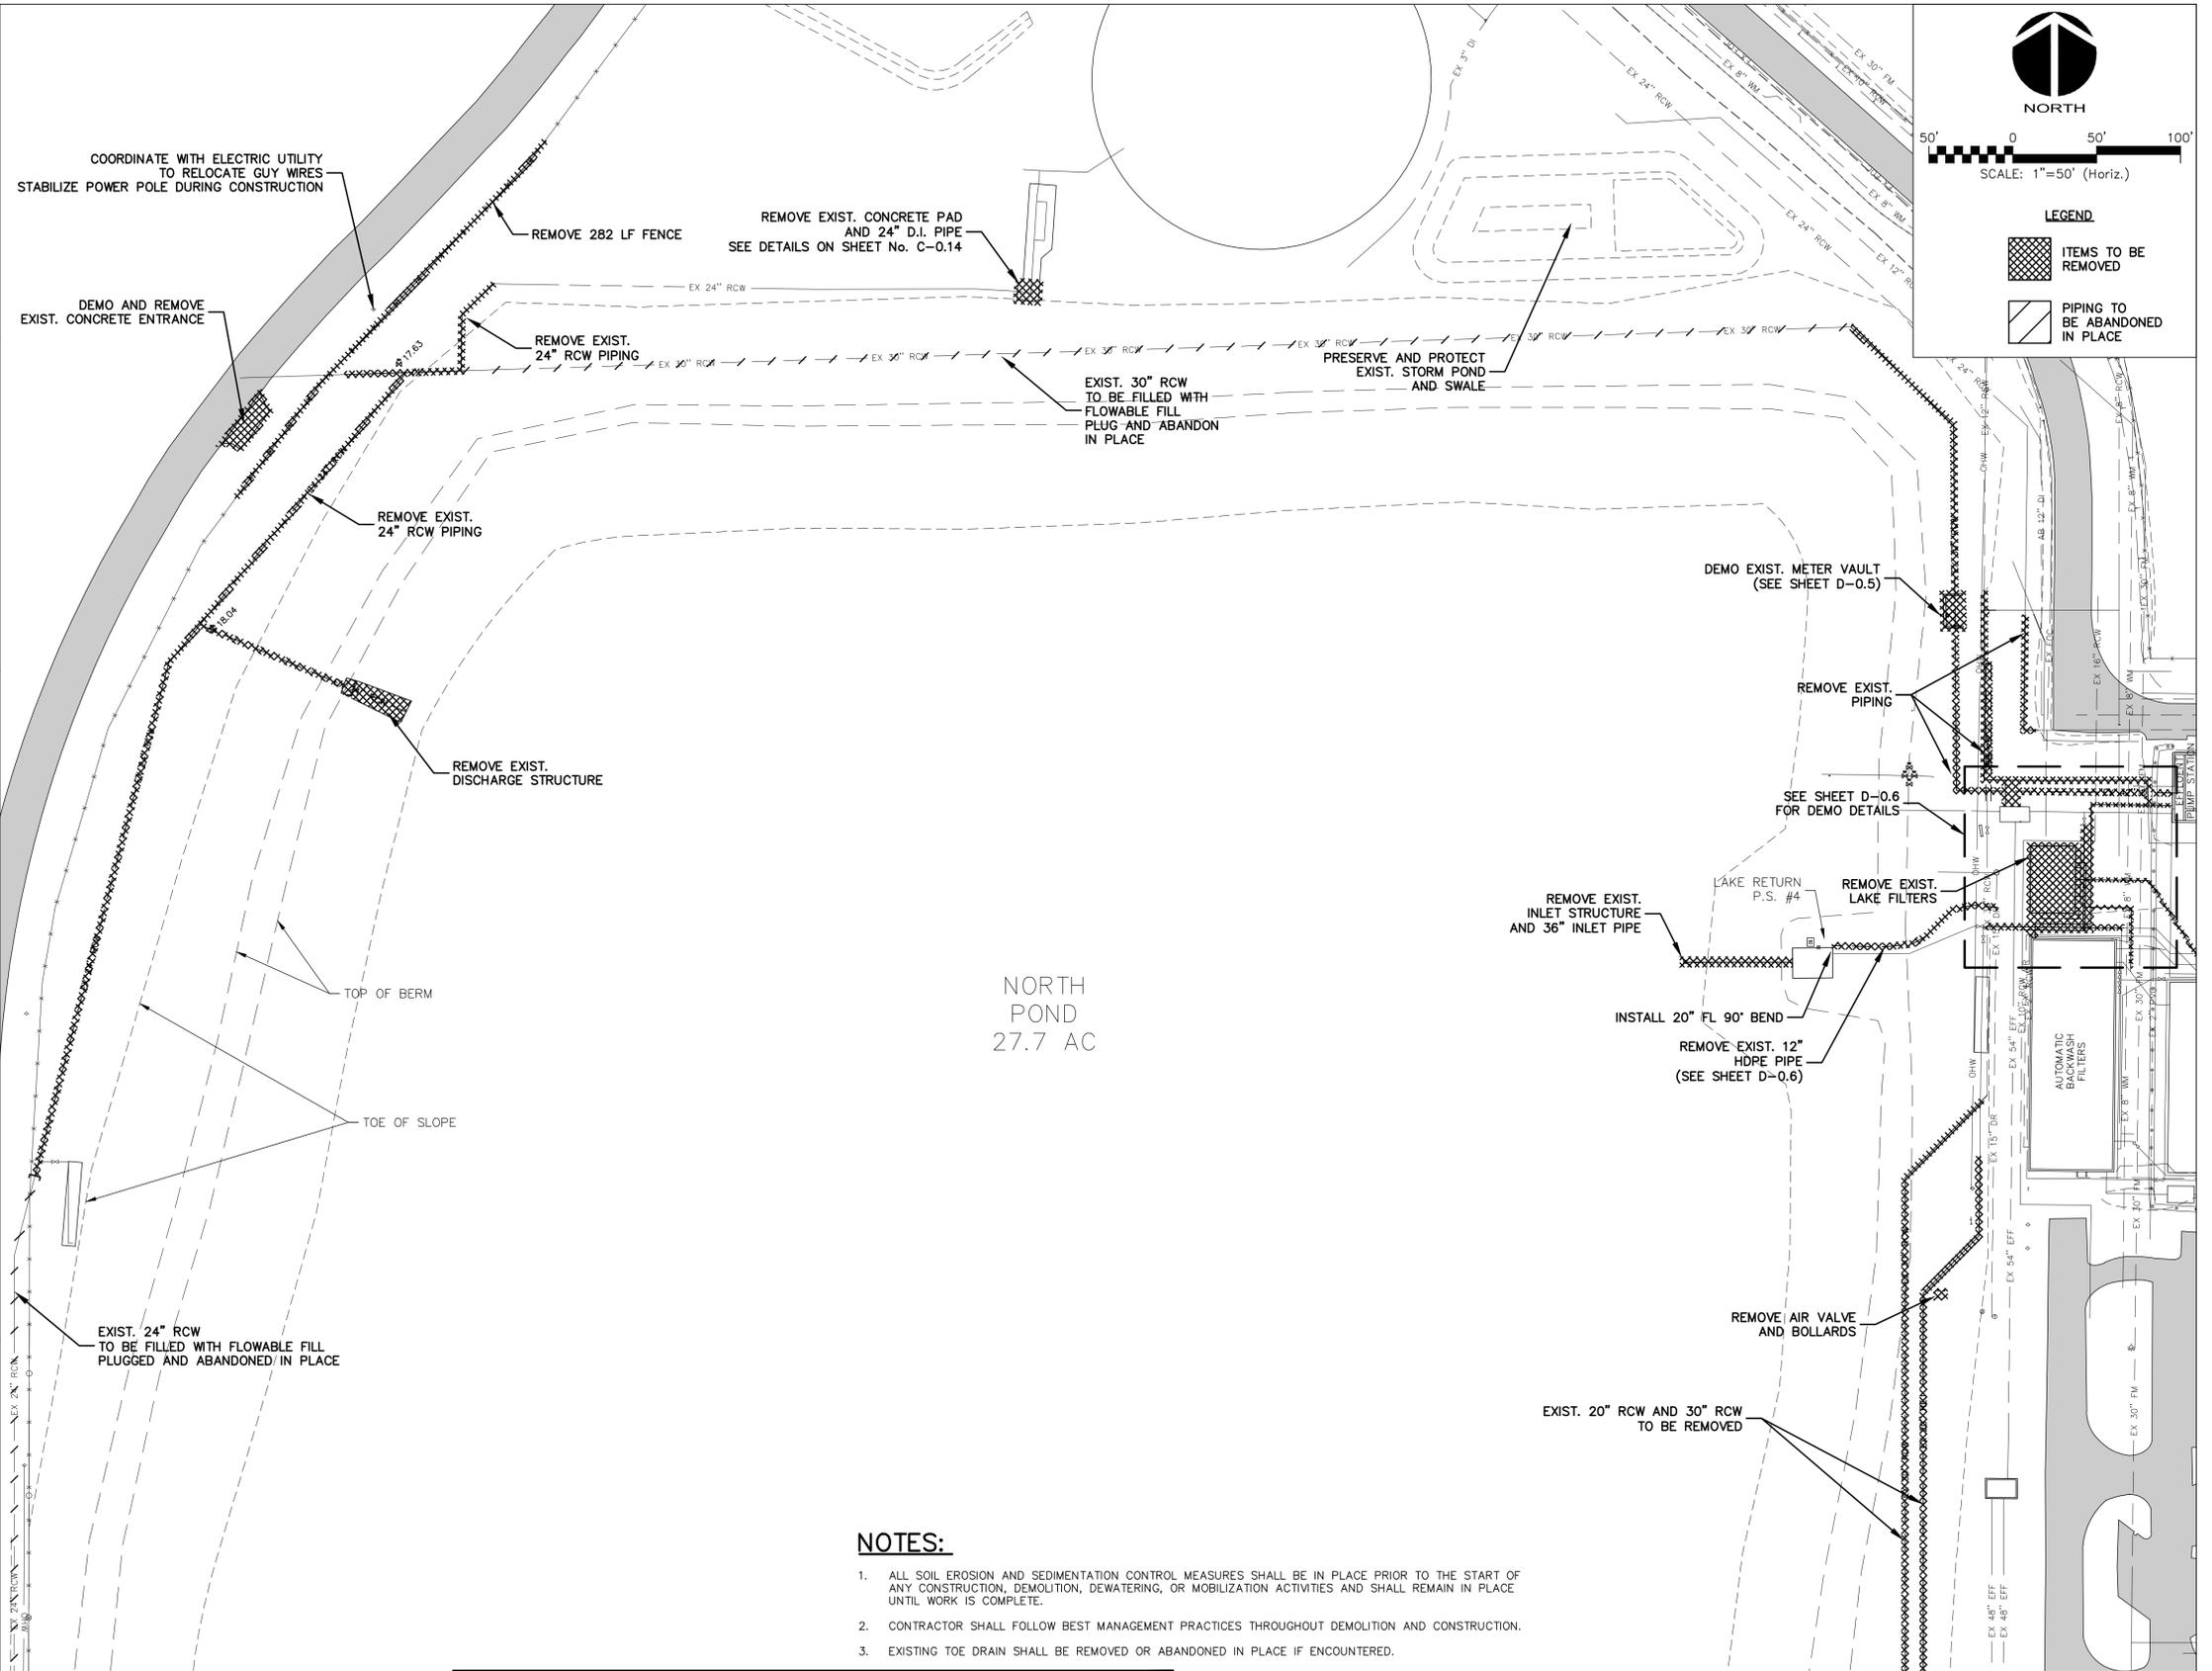
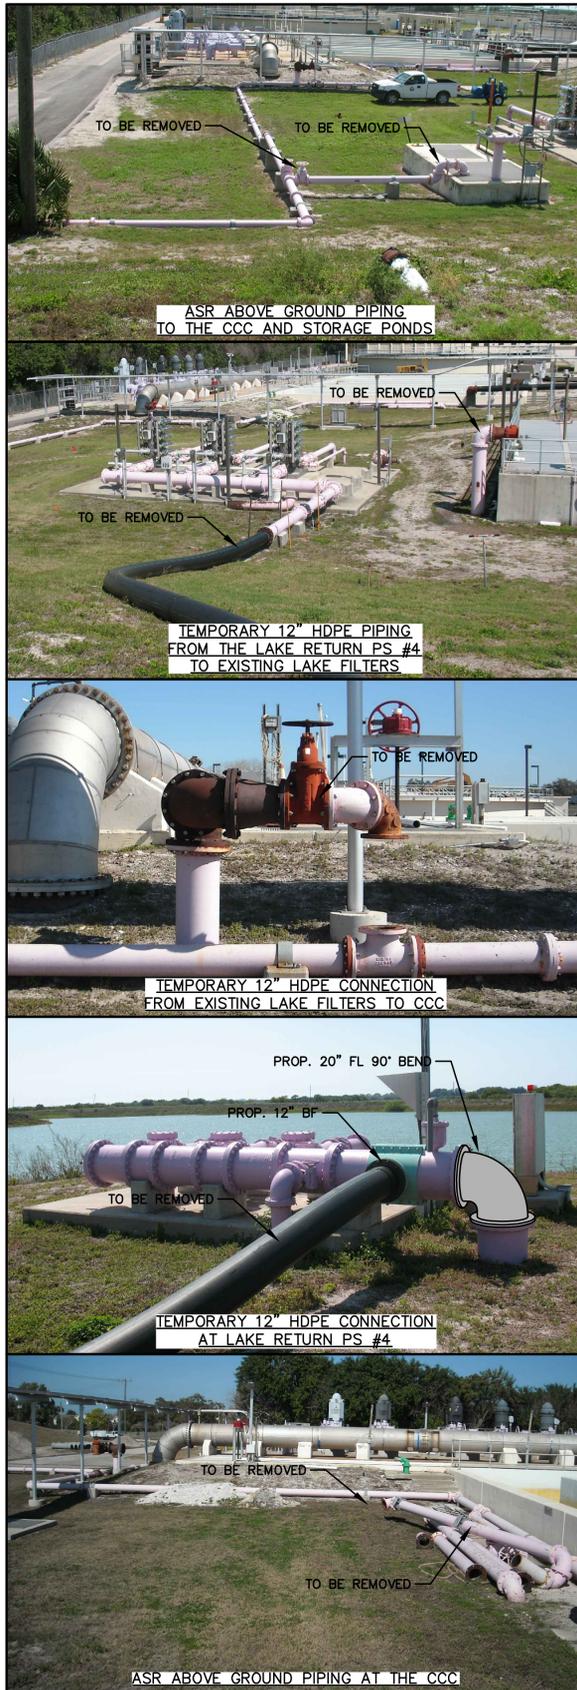
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MANATEE COUNTY, FLORIDA

SWWRF LAKE FILTRATION AND
 NORTH POND IMPROVEMENTS

PROPOSED SODIUM HYPOCHLORITE
 CHEMICAL FEED FACILITIES
 PIPING SCHEMATIC

DATE: FEBRUARY 2012	SCALE: NA	DRAWING NUMBER: G-0.6
MCE PROJ. # 1024-0147	HORIZONTAL: NA	
DRAWN: BFN	VERTICAL: NA	
DESIGNED: NJS		
CHECKED: JSL		
PROJ. MGR: MSL		
STATUS: ISSUE FOR BID		



NORTH

50' 0 50' 100'

SCALE: 1"=50' (Horiz.)

LEGEND

ITEMS TO BE REMOVED

PIPING TO BE ABANDONED IN PLACE

NOTES:

1. ALL SOIL EROSION AND SEDIMENTATION CONTROL MEASURES SHALL BE IN PLACE PRIOR TO THE START OF ANY CONSTRUCTION, DEMOLITION, DEWATERING, OR MOBILIZATION ACTIVITIES AND SHALL REMAIN IN PLACE UNTIL WORK IS COMPLETE.
2. CONTRACTOR SHALL FOLLOW BEST MANAGEMENT PRACTICES THROUGHOUT DEMOLITION AND CONSTRUCTION.
3. EXISTING TOE DRAIN SHALL BE REMOVED OR ABANDONED IN PLACE IF ENCOUNTERED.

MATCHLINE SEE SHEET D-0.2

REV. NO.	DESCRIPTIONS	DATE

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MANATEE COUNTY, FLORIDA

SWWRF LAKE FILTRATION AND NORTH POND IMPROVEMENTS

DEMOLITION PLAN No. 1



DATE: FEBRUARY 2012
MCE PROJ. # 1024-0147
DRAWN: BFN
DESIGNED: MSL
CHECKED: JSL
PROJ. MGR: MSL

SCALE: HORIZONTAL: 1" = 50'
VERTICAL: NA

DRAWING NUMBER: D-0.1

STATUS: ISSUE FOR BID

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NOTES:

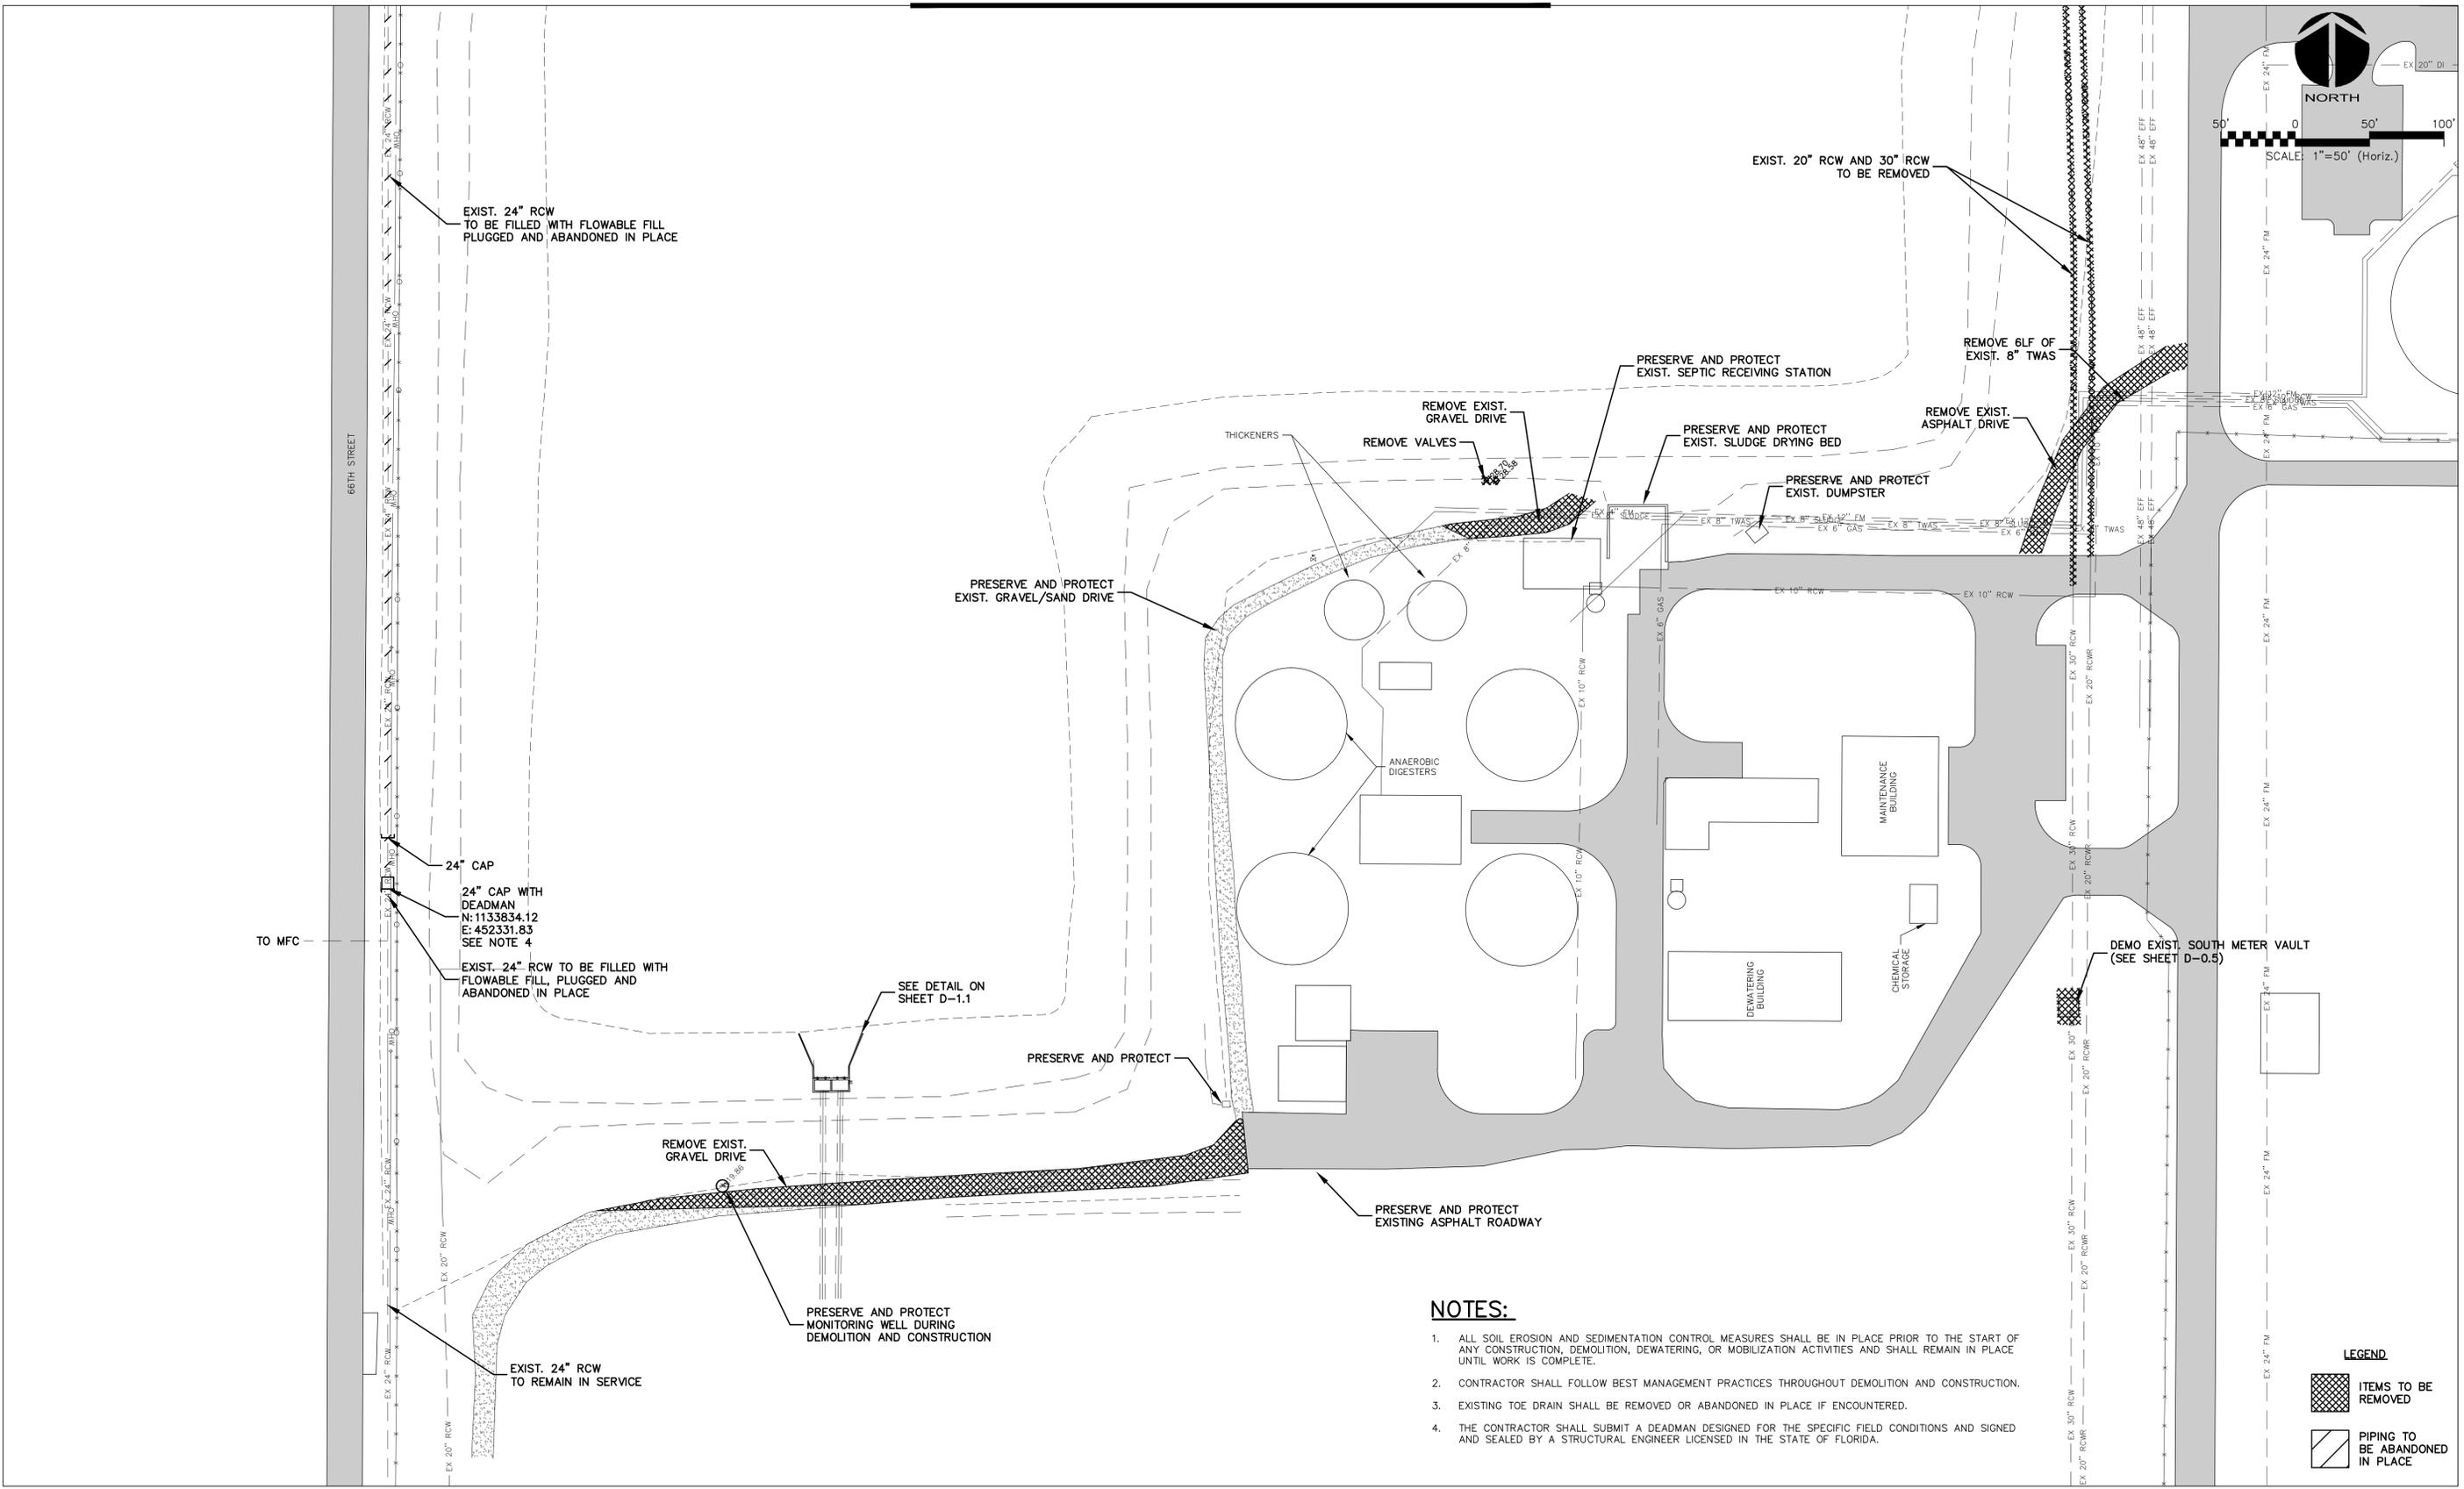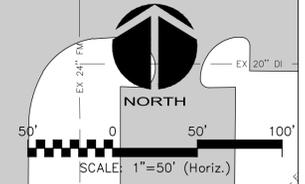1. ALL SOIL EROSION AND SEDIMENTATION CONTROL MEASURES SHALL BE IN PLACE PRIOR TO THE START OF ANY CONSTRUCTION, DEMOLITION, DEWATERING, OR MOBILIZATION ACTIVITIES AND SHALL REMAIN IN PLACE UNTIL WORK IS COMPLETE.
2. CONTRACTOR SHALL FOLLOW BEST MANAGEMENT PRACTICES THROUGHOUT DEMOLITION AND CONSTRUCTION.
3. EXISTING TOE DRAIN SHALL BE REMOVED OR ABANDONED IN PLACE IF ENCOUNTERED.
4. THE CONTRACTOR SHALL SUBMIT A DEADMAN DESIGNED FOR THE SPECIFIC FIELD CONDITIONS AND SIGNED AND SEALED BY A STRUCTURAL ENGINEER LICENSED IN THE STATE OF FLORIDA.



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MANATEE COUNTY, FLORIDA

SWWRF LAKE FILTRATION AND NORTH POND IMPROVEMENTS


DEMOLITION PLAN No. 2

DATE:	FEBRUARY 2012
MCE PROJ. #	1024-0147
DRAWN	BFN
DESIGNED	MSL
CHECKED	JSL
PROJ. MGR.	MSL

SCALE	DRAWING NUMBER
HORIZONTAL: 1" = 50'	D-0.2
VERTICAL: NA	REVISION
STATUS: ISSUE FOR BID	


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LEGEND

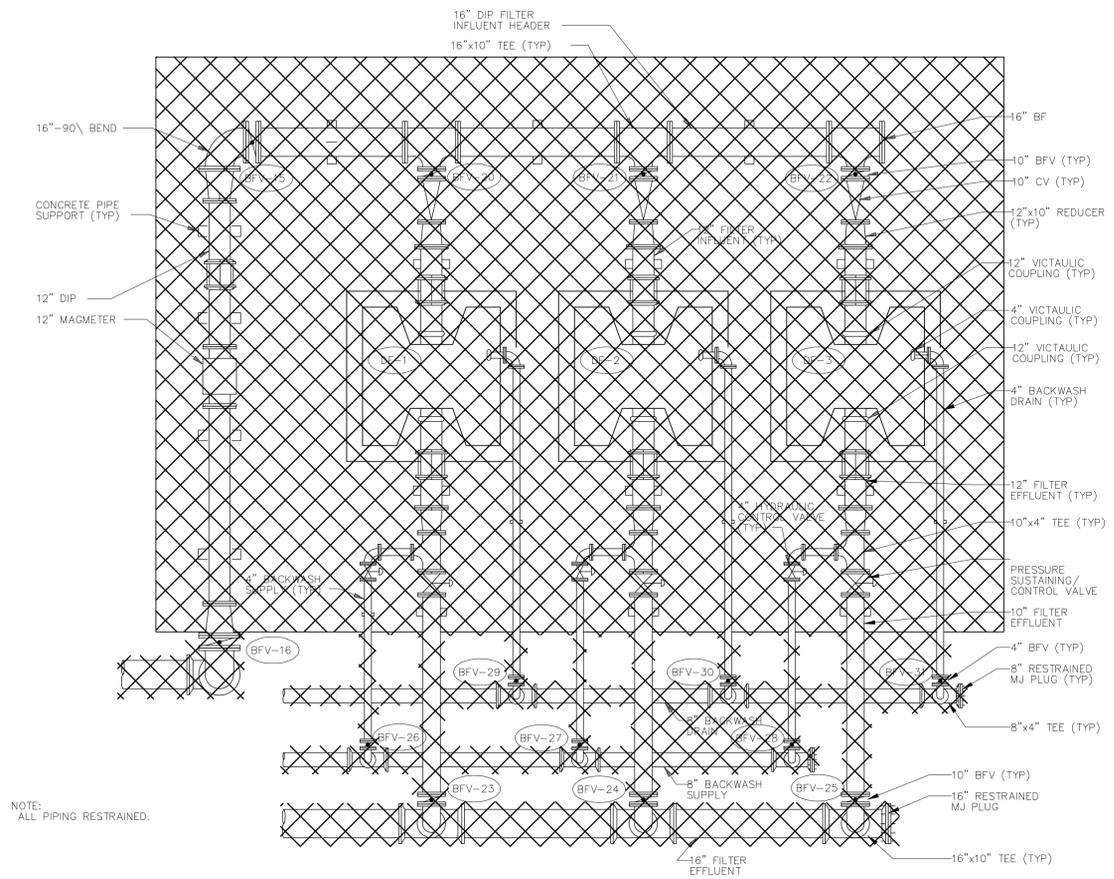

EXISTING LAKE FILTRATION SYSTEM PLAN

- NOTES:
- EXISTING LAKE FILTRATION SYSTEM TO BE REMOVED IN ITS ENTIRETY, INCLUDING, BUT NOT LIMITED TO: PIPING; EQUIPMENT; CONDUITS; AND CONCRETE PAD. EQUIPMENT TO BE TURNED OVER TO THE COUNTY SHALL BE CLEANED, CLEARLY IDENTIFIED AND DELIVERED TO THE COUNTY AT A DESIGNATED STORAGE AREA ON THIS TREATMENT PLANT SITE. SEE SHEET D-0.1 FOR LOCATION.
 - BACKGROUND IMAGE FROM RECORD DRAWINGS DATED MAY 1996 FOR "AUTOMATIC BACKWASH FILTER ADDITION".

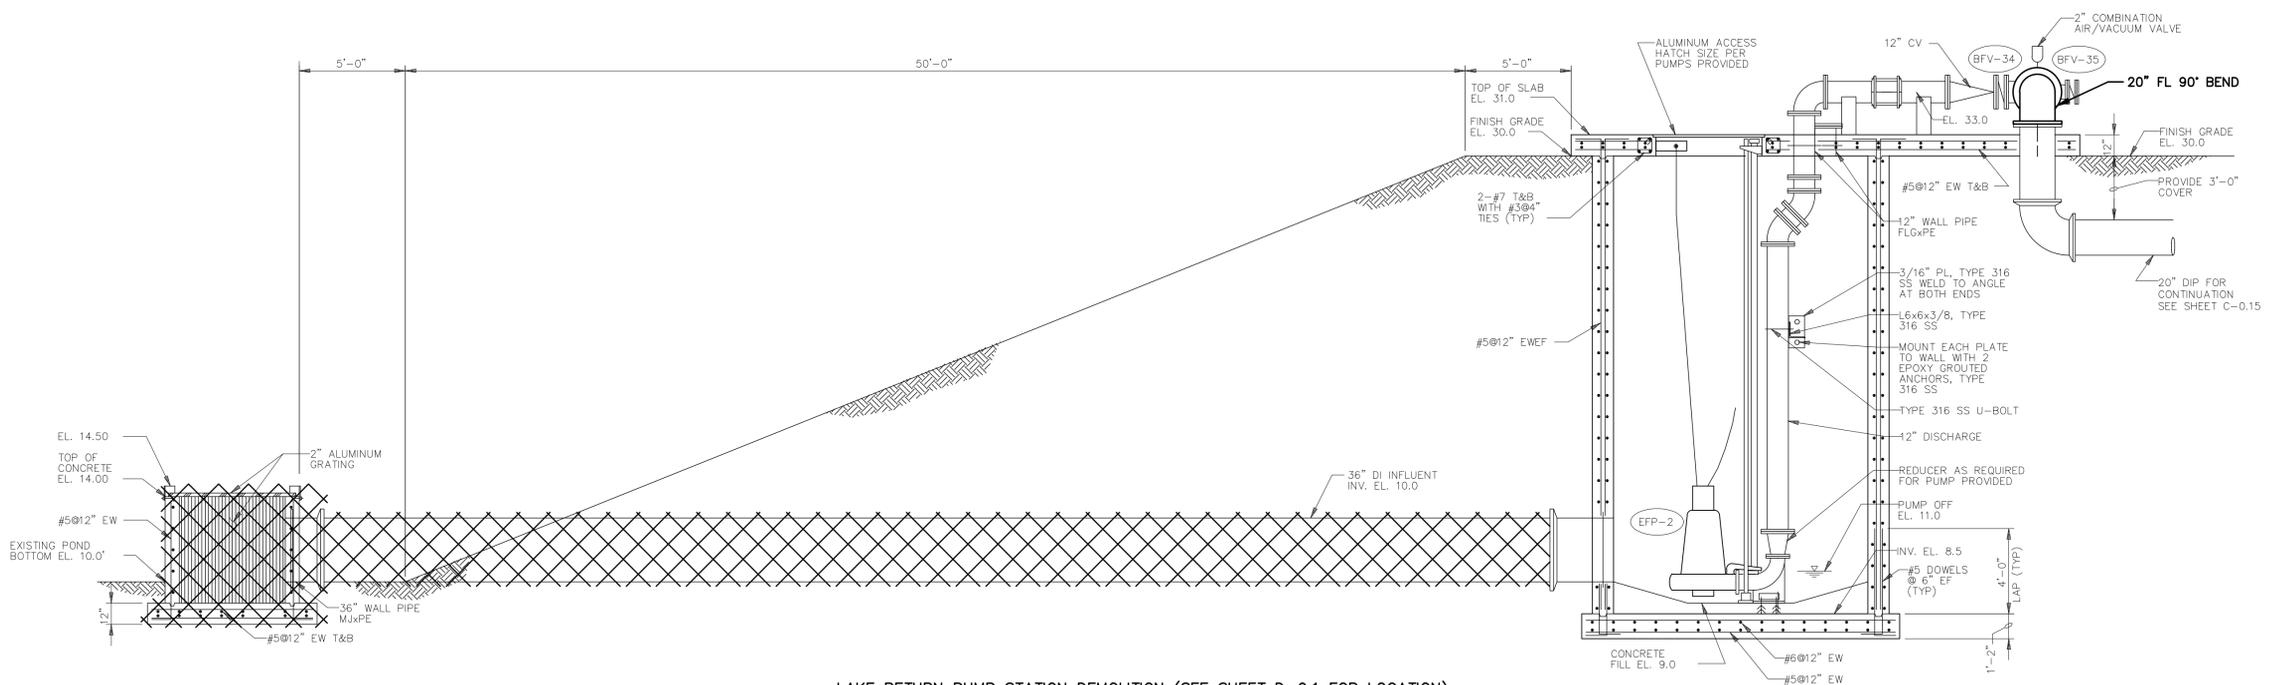

LAKE RETURN PUMP STATION DEMOLITION (SEE SHEET D-0.1 FOR LOCATION)

REV. NO.	DESCRIPTIONS	DATE

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No. 41338

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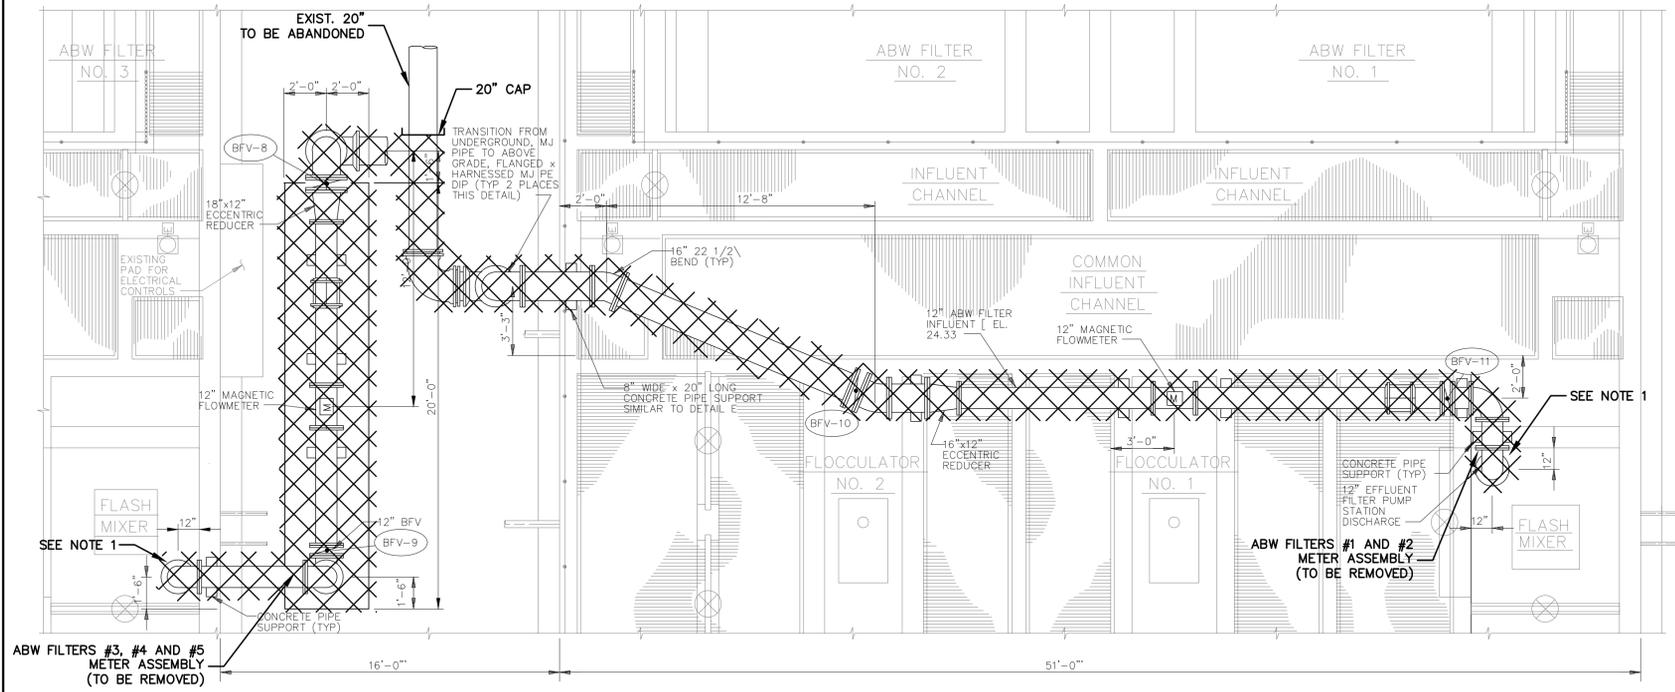
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SWRF LAKE FILTRATION AND NORTH POND IMPROVEMENTS


DEMOLITION DETAILS No. 1

DATE: FEBRUARY 2012	SCALE: HORIZONTAL: NA	DRAWING NUMBER: D-0.3
MCE PROJ. # 1024-0147	VERTICAL: NA	
DRAWN: BFN	CHECKED: JSL	REVISION: NA
DESIGNED: MSL	PROJ. MGR: MSL	
STATUS: ISSUE FOR BID		

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LAKE RETURN PIPING TO ABW FILTERS #1 THROUGH #5



LAKE RETURN PIPING TO ABW FILTERS #6 & #7

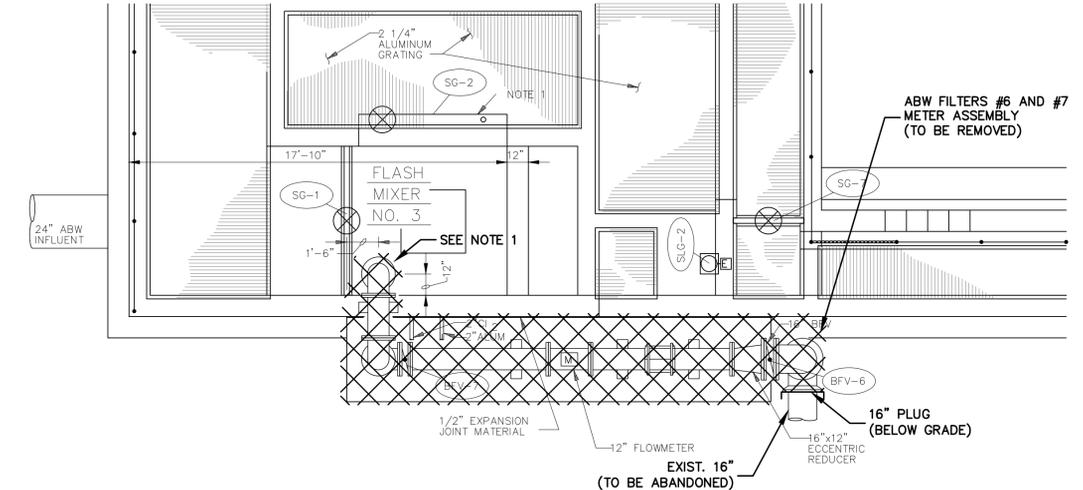- NOTES:
- CONTRACTOR SHALL PLUG HOLE, AFTER PIPE IS REMOVED, WITH ALUMINUM CHECKER PLATING OR GRATING.
 - BACKGROUND IMAGE FROM RECORD DRAWINGS DATED MAY 1996 FOR "AUTOMATIC BACKWASH FILTERS ADDITION".



ABW FILTERS #1 & #2 METER ASSEMBLY



ABW FILTERS #3, #4 & #5 METER ASSEMBLY



ABW FILTERS #6 & #7 METER ASSEMBLY

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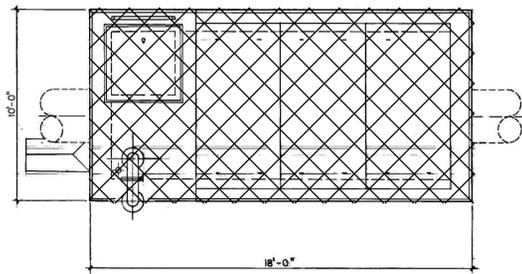
SWWRF LAKE FILTRATION AND NORTH POND IMPROVEMENTS

DEMOLITION DETAILS No. 2


DATE: FEBRUARY 2012	SCALE: HORIZONTAL: NA	DRAWING NUMBER: D-0.4
MCE PROJ. # 1024-0147	VERTICAL: NA	
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CHECKED: JSL		
PROJ. MGR: MSL		
STATUS: ISSUE FOR BID		

LEGEND


ITEMS TO BE REMOVED




NORTH MARS METER PLAN

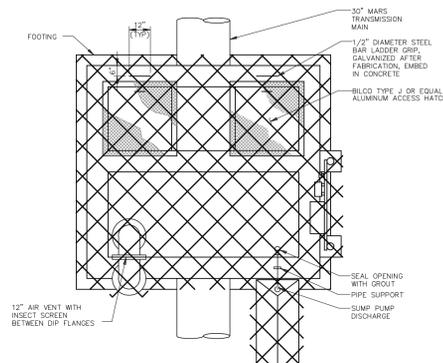

SOUTH MARS METER PLAN

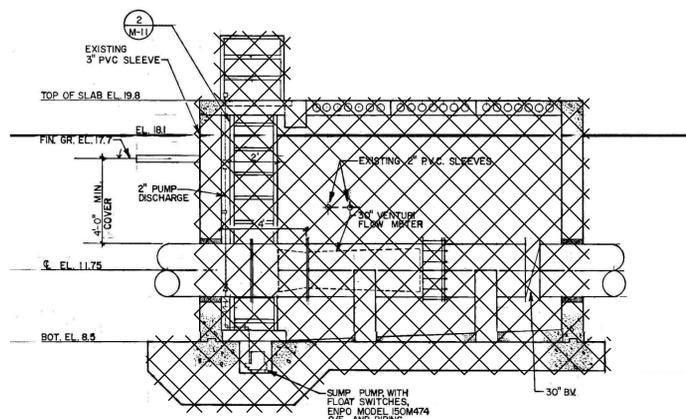

NORTH MARS METER SECTION

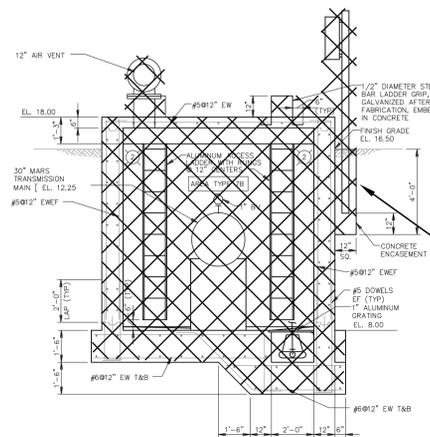

SOUTH MARS METER SECTION

DEMO EXIST. METER VAULT TO 3 FEET BELOW GRADE AND FILL WITH SAND. PUNCH 3 - 12" DIAMETER IN BOTTOM OF STRUCTURE. 30" PIPE TO REMAIN IN PLACE AND IN SERVICE.

LEGEND

ITEMS TO BE REMOVED



NORTH MARS METER
(SEE SHEET D-0.1 FOR LOCATION)



SOUTH MARS METER
(SEE SHEET D-0.1 FOR LOCATION)

REV. NO.	DESCRIPTIONS	DATE

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No. 41338


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SWWRF LAKE FILTRATION AND NORTH POND IMPROVEMENTS
DEMOLITION DETAILS No. 3

DATE: FEBRUARY 2012	SCALE: NA	DRAWING NUMBER: D-0.5
MCE PROJ. # 1024-0147	HORIZONTAL: NA	REVISION
DRAWN: BFN	VERTICAL: NA	
DESIGNED: MSL		
CHECKED: JSL		
PROJ. MGR: MSL		
STATUS: ISSUE FOR BID		



CONNECT PROP. 12" DIP AT EXIST. BLIND FLG. FACING UP.

EFFLUENT WET WELL/PUMPS

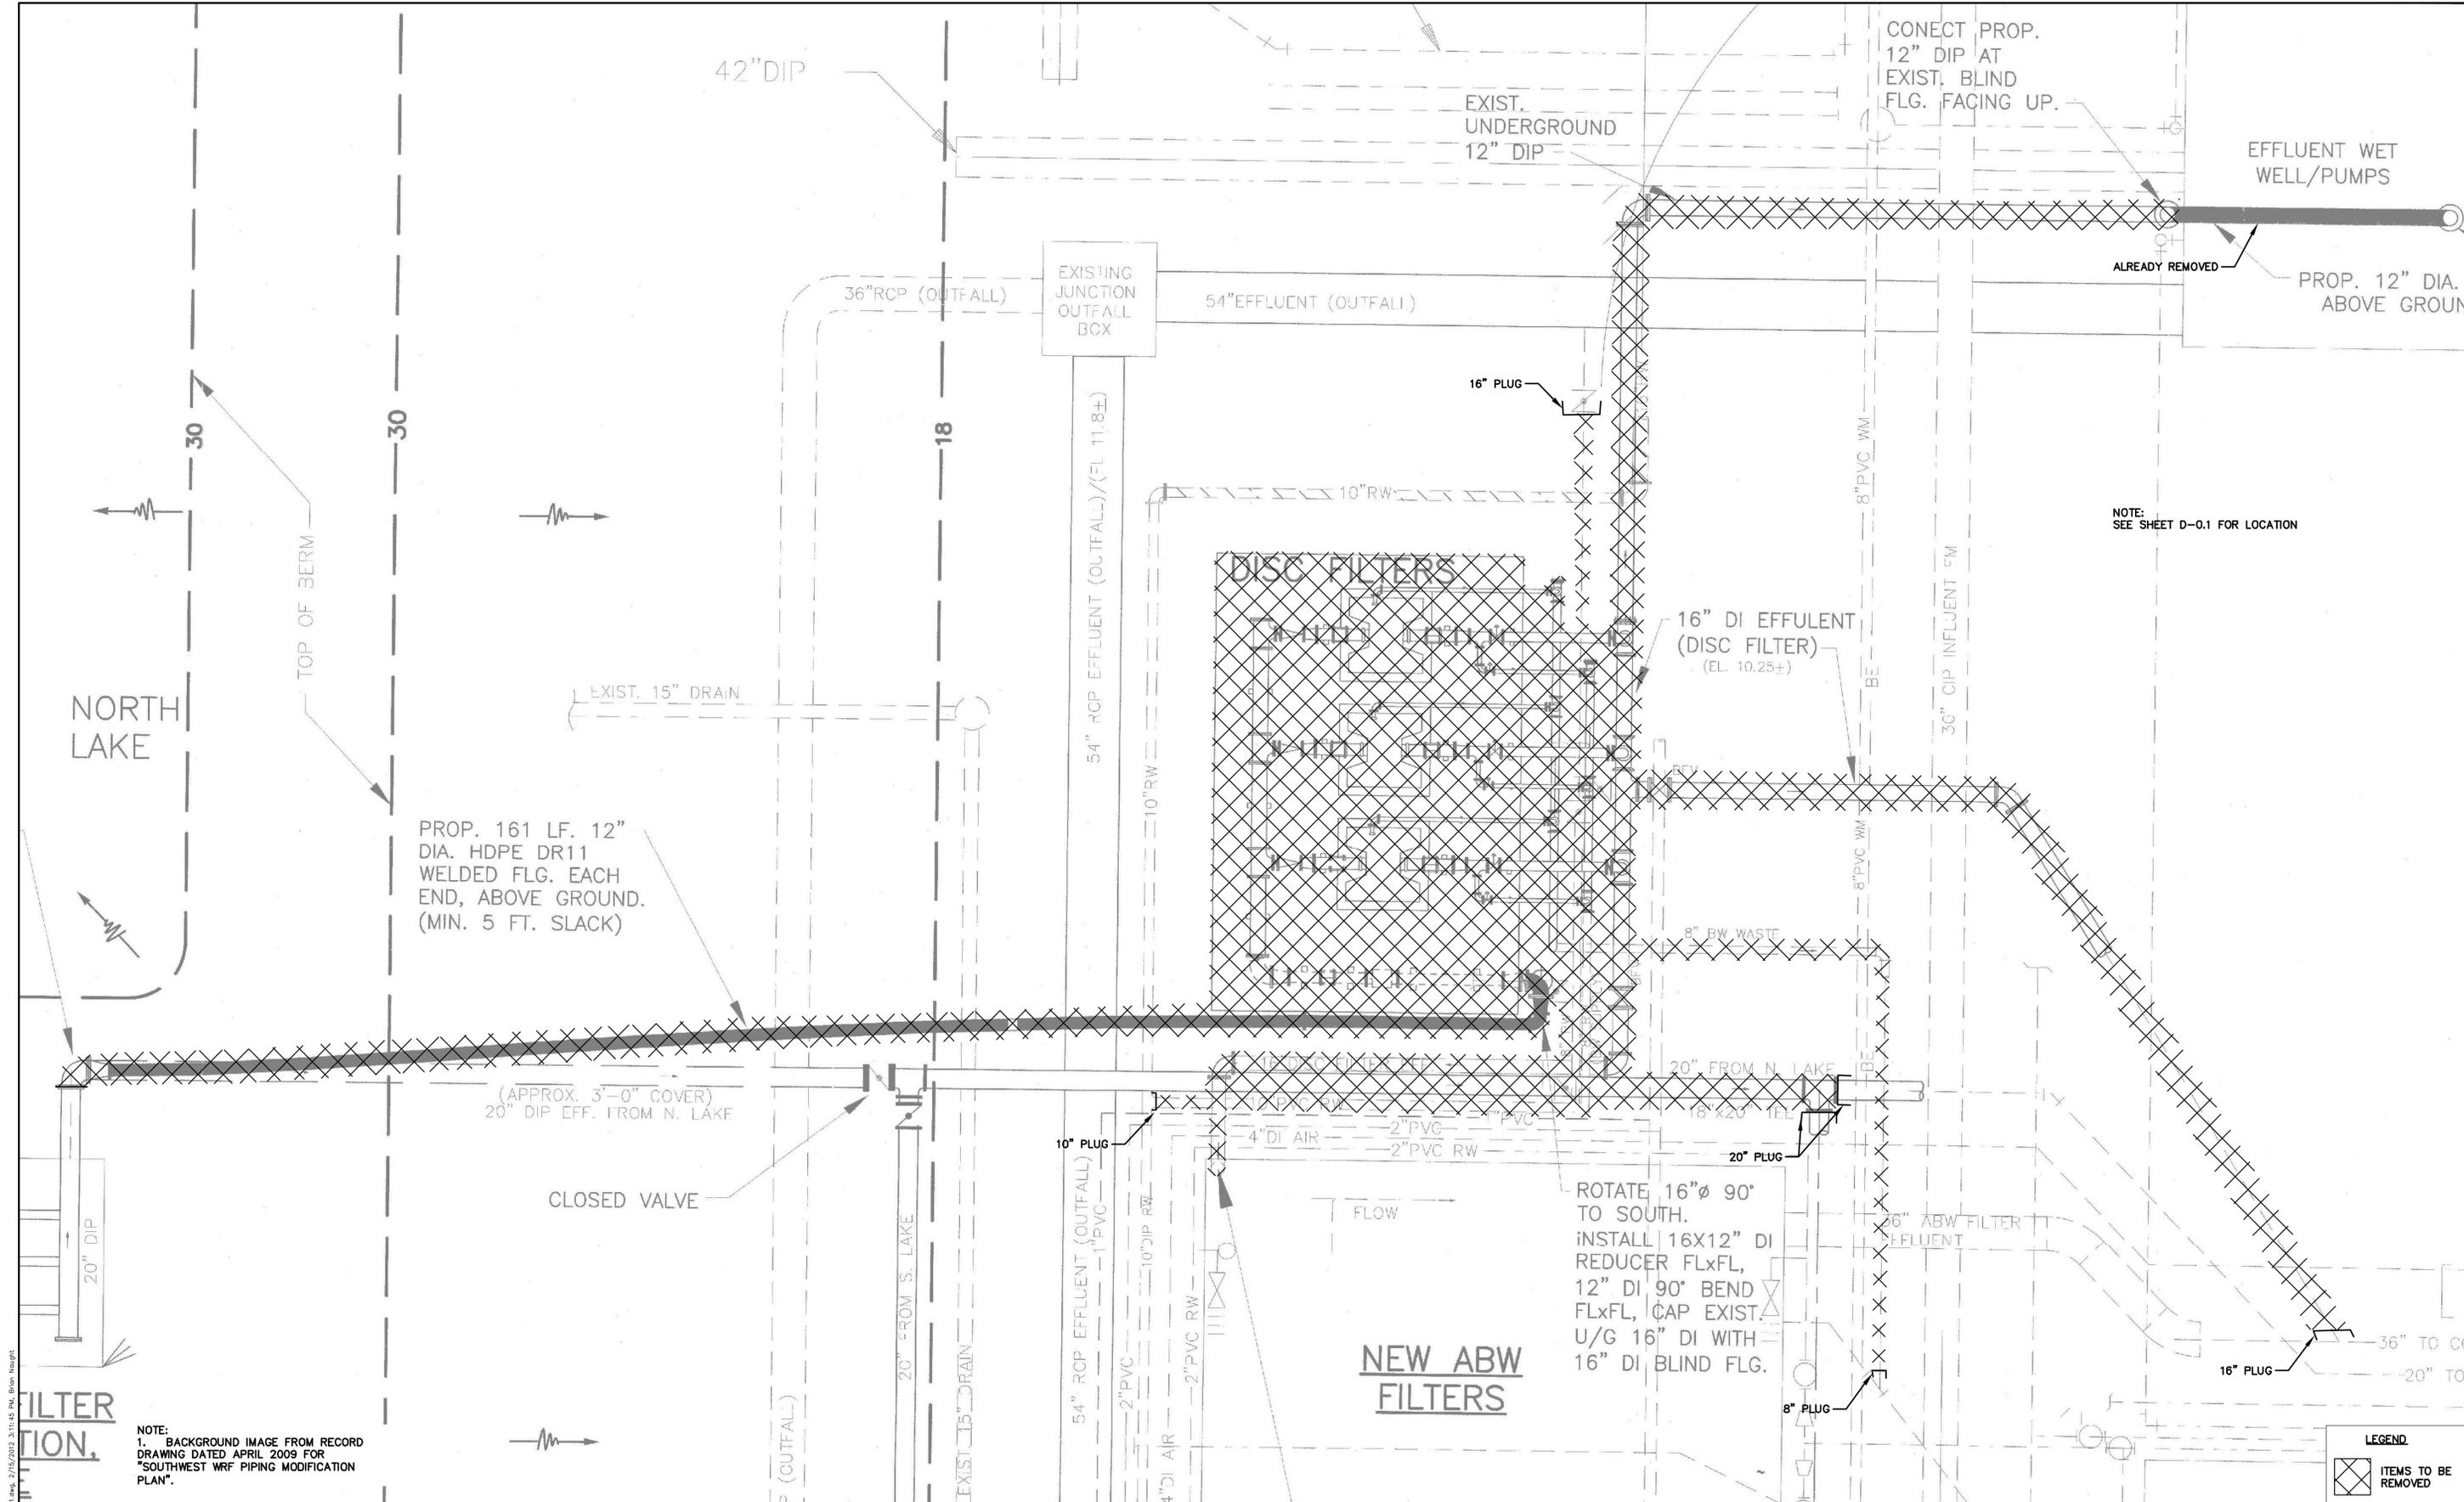PROP. 12" DIA. ABOVE GROUND

NOTE: SEE SHEET D-0.1 FOR LOCATION

PROP. 161 LF. 12" DIA. HDPE DR11 WELDED FLG. EACH END, ABOVE GROUND. (MIN. 5 FT. SLACK)

ROTATE 16"Ø 90° TO SOUTH. INSTALL 16X12" DI REDUCER FLxFL, 12" DI 90° BEND FLxFL, CAP EXIST. U/G 16" DI WITH 16" DI BLIND FLG.

NEW ABW FILTERS

LEGEND
 ITEMS TO BE REMOVED

NOTE: 1. BACKGROUND IMAGE FROM RECORD DRAWING DATED APRIL 2009 FOR "SOUTHWEST WRF PIPING MODIFICATION PLAN".

REV. NO.	DESCRIPTIONS	DATE

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 No. 41338

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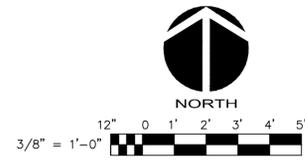
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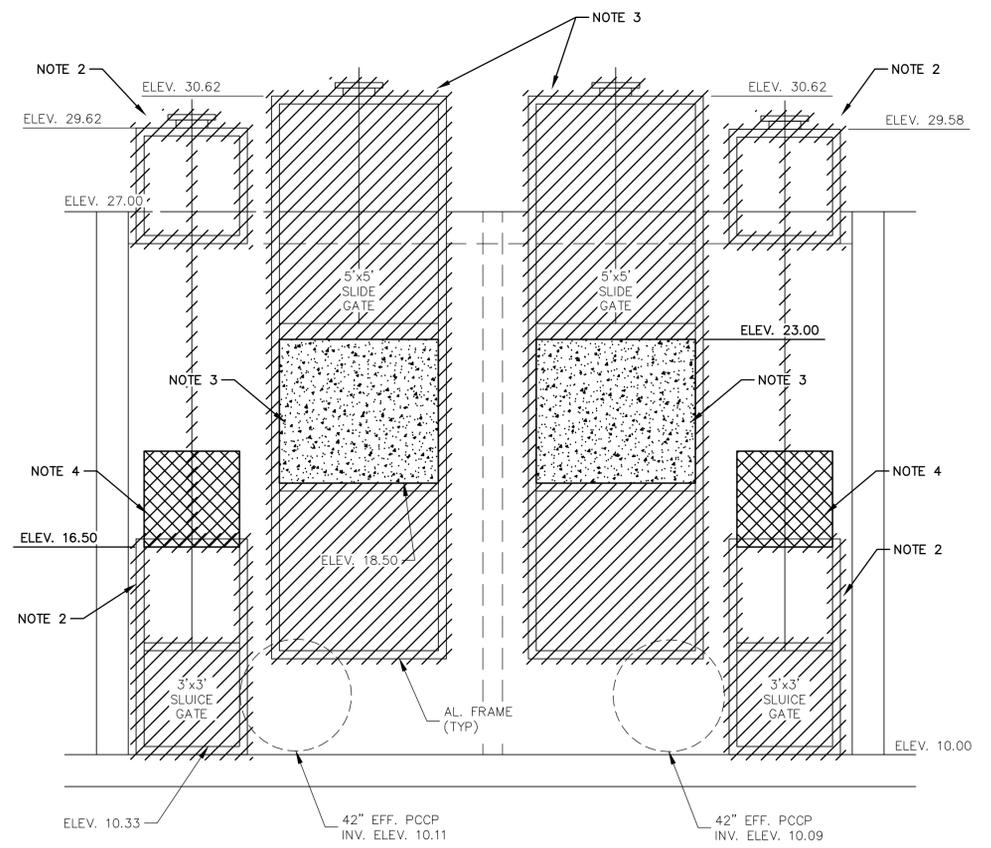
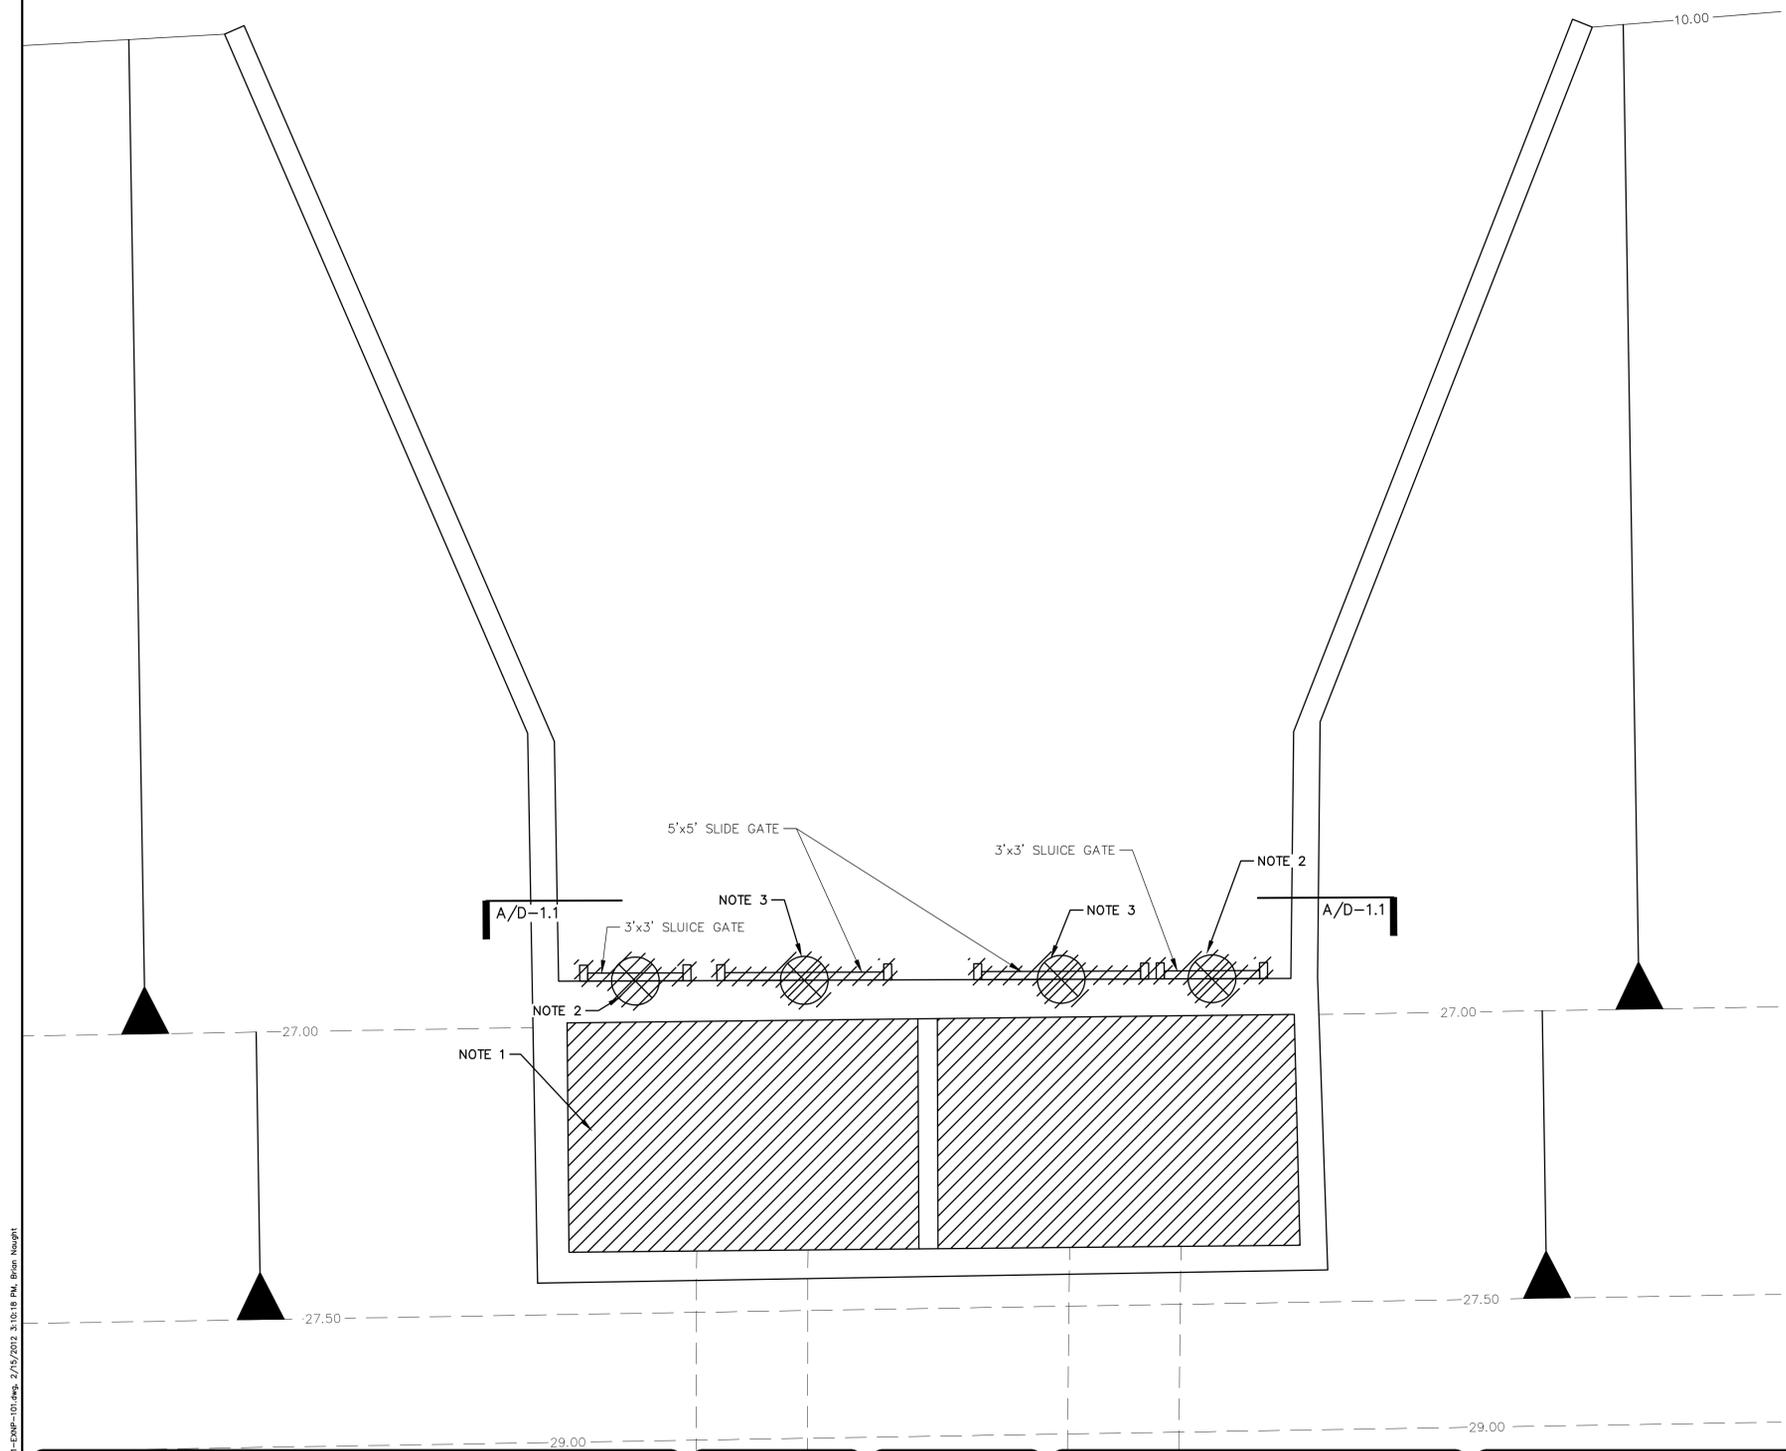
SWWRF LAKE FILTRATION AND NORTH POND IMPROVEMENTS
DEMOLITION DETAILS No. 4

DATE: FEBRUARY 2012	SCALE: HORIZONTAL: NA	DRAWING NUMBER: D-0.6
MCE PROJ. # 1024-0147	VERTICAL: NA	
DRAWN: BFN		
DESIGNED: MSL		
CHECKED: JSL		
PROJ. MGR: MSL		
STATUS: ISSUE FOR BID		

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- DEMOLITION NOTES:**
1. REMOVE GRATING FROM THE TOP OF THE STRUCTURE.
 2. REMOVE ENTIRE SLUICE GATE, INCLUDING TOP AND BOTTOM FRAMES, HANDWHEEL, OPERATING STEM AND DISK. FILL HOLE IN EXISTING CONCRETE WALL WITH CONCRETE AND STEEL REINFORCING PER STRUCTURAL DRAWINGS.
 3. REMOVE ENTIRE SLIDE GATE ASSEMBLY, INCLUDING ALUMINUM FRAME, GATE, OPERATING STEM AND HAND WHEEL. FILL HOLE IN EXISTING CONCRETE WALL WITH CONCRETE AND STEEL REINFORCING TO ELEV. 23.00 PER STRUCTURAL DRAWINGS. SEE STRUCTURAL DRAWINGS FOR DETAILS.
 4. CUT A 3'x3' HOLE INTO THE EXISTING CONCRETE WALL.
 5. SEE SHEETS Nos. S-1.1 AND S-1.2 FOR FURTHER DETAILS.



SECTION A/D-1.1
SCALE: 3/8" = 1'-0"

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SWRF LAKE FILTRATION AND
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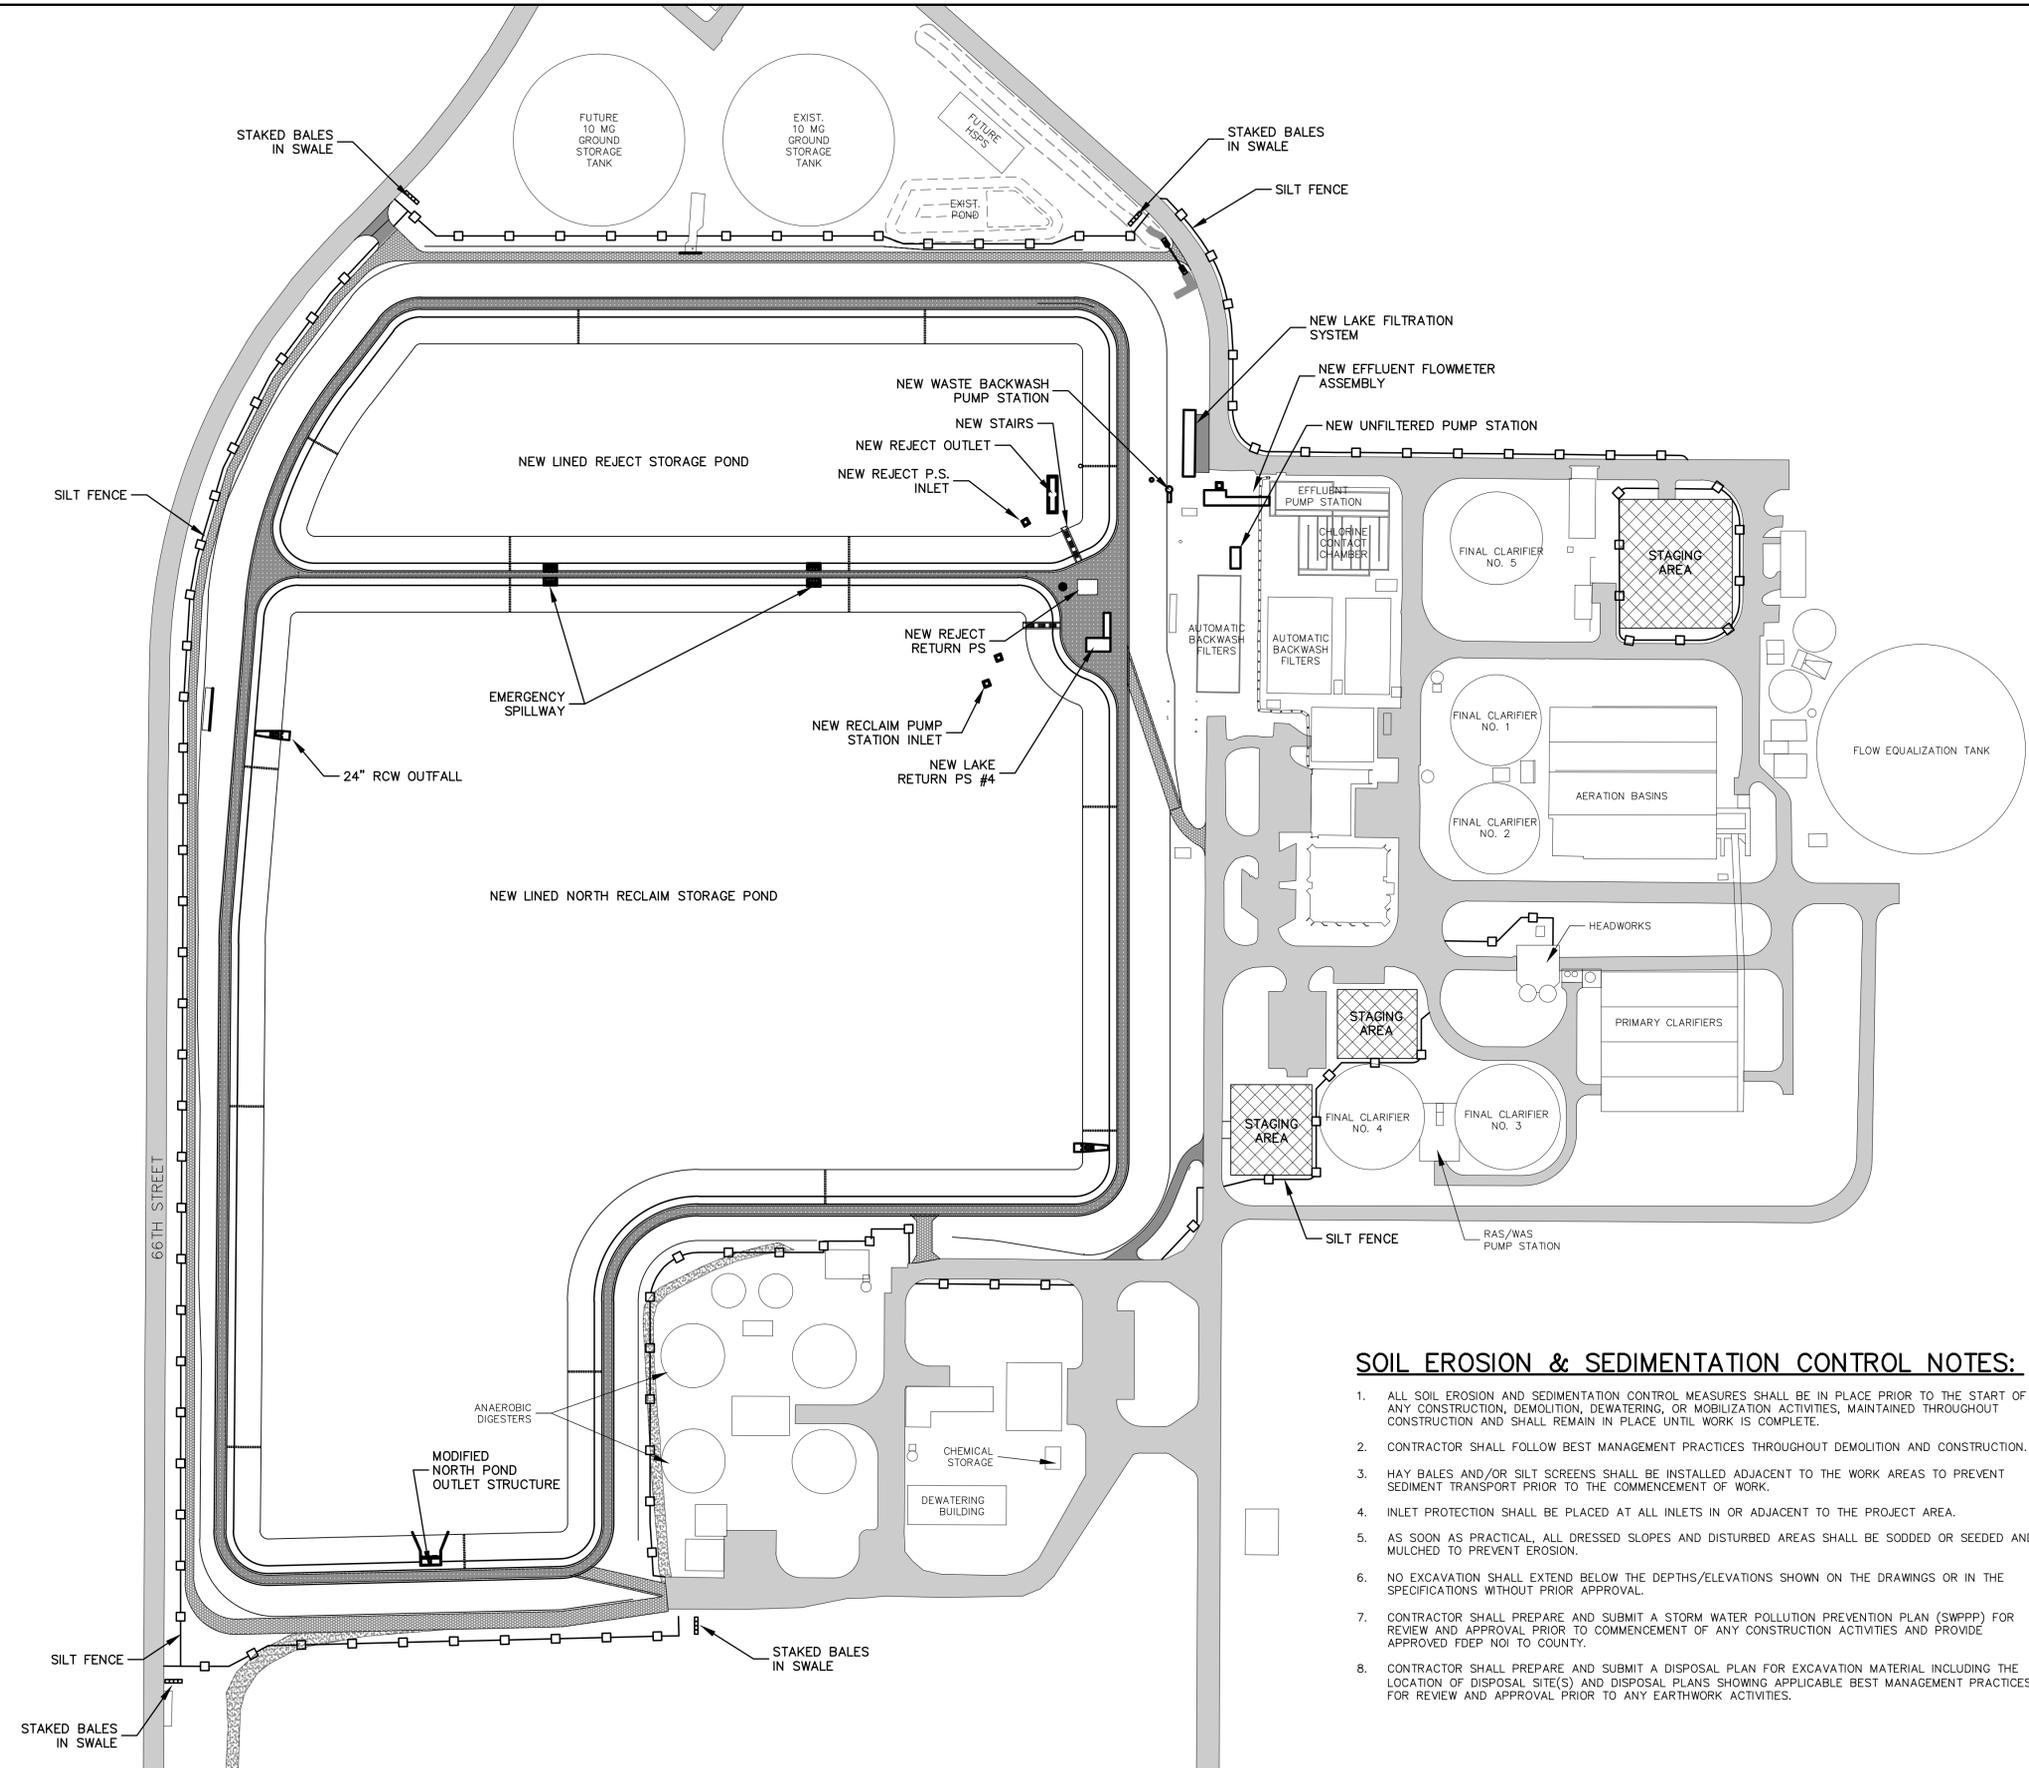
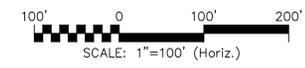
**NORTH POND OUTLET STRUCTURE
DEMOLITION PLAN AND SECTION**

DATE: FEBRUARY 2012	SCALE: HORIZONTAL: 3/8" = 1'-0"	DRAWING NUMBER: D-1.1
MCE PROJ. # 1024-0147	VERTICAL: N/A	
DRAWN: BFN		
DESIGNED: NJS		
CHECKED: MSL		
PROJ. MGR. MSL		
STATUS: ISSUE FOR BID		REVISION:

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NORTH



- DURING DEWATERING ACTIVITIES:**
1. DEWATERING DISCHARGE FLOW RATES SHALL BE RESTRICTED SO AS TO AVOID EROSION OF SOILS OR EROSION CONTROL MEASURES.
 2. THE CONTRACTOR SHALL PERFORM DAILY INSPECTIONS OF THE DEWATERING EQUIPMENT, DISCHARGE, SEDIMENT TRAP(S), SETTLEMENT TANK(S), AND/OR POND FOR SIGNS OF EROSION, SILTATION, OR OTHER DAMAGE. SHOULD ANY EROSION, SILTATION, OR OTHER DAMAGE BE OBSERVED, THE CONTRACTOR SHALL IMMEDIATELY MAKE ADJUSTMENTS TO DEWATERING ACTIVITIES AS NEEDED TO PREVENT FURTHER DAMAGE AND SHALL REPAIR ANY DAMAGE WITHIN 24 HOURS OF OBSERVATION.

- DEWATERING SEQUENCE:**
1. ALL SOIL EROSION AND SEDIMENTATION CONTROL MEASURES SHALL BE IN PLACE PRIOR TO THE START OF ANY CONSTRUCTION AND/OR DEWATERING ACTIVITIES AND SHALL REMAIN IN PLACE UNTIL WORK IS COMPLETE.
 2. PRIOR TO DEWATERING OF THE RECLAIM POND, THE CONTRACTOR SHALL COORDINATE WITH THE OWNER TO UTILIZE THE EXISTING RECLAIM POND PUMPS AND INFRASTRUCTURE TO DRAIN THE RECLAIM POND WATER. ONCE THE RECLAIM POND HAS BEEN FULLY DRAINED, THE CONTRACTOR SHALL PROVIDE, INSTALL, AND MAINTAIN DEWATERING EQUIPMENT.
 3. FOLLOWING THE COMPLETION OF DEWATERING, THE CONTRACTOR SHALL REMOVE ALL WELL POINTS, PIPES, PUMPS, AND ANY ADDITIONAL DEWATERING EQUIPMENT FROM THE PROJECT SITE.
 4. FOLLOWING THE REMOVAL OF DEWATERING EQUIPMENT, THE CONTRACTOR SHALL EXCAVATE ANY SEDIMENT OR MUCK ACCUMULATED WITHIN THE TEMPORARY SEDIMENT TRAP(S) SETTLEMENT TANK(S), AND/OR POND(S) AND DISPOSE OF SEDIMENT TO A QUALIFIED LAND FILL.
 5. FOLLOWING REMOVAL OF SEDIMENT, THE CONTRACTOR SHALL REMOVE THE SETTLEMENT TANK(S) AND/OR FILL THE SEDIMENT TRAP(S) WITH CLEAN SANDY SOIL TO RESTORE THE NATURAL GRADE AND SOD OVER AS SOON AS PRACTICALLY POSSIBLE.

- NOTES:**
1. THE CONTRACTOR IS RESPONSIBLE FOR ANY AND ALL DEWATERING ACTIVITIES.
 2. THE CONTRACTOR IS RESPONSIBLE FOR OBTAINING A GENERIC PERMIT FOR THE DISCHARGE OF PRODUCED GROUND WATER FROM ANY NON-CONTAMINATED SITE ACTIVITY (FORM 62-621.300(2)) FROM THE FDEP INDUSTRIAL WASTEWATER DEPARTMENT. THE CONTRACTOR SHALL PROVIDE THE AUTHORIZED GENERIC PERMIT AND WATER SAMPLING DATA TO THE FDEP ERP PROGRAM PRIOR TO THE PRE-CONSTRUCTION MEETING AND PRIOR TO ANY CONSTRUCTION ACTIVITIES.
 3. THE CONTRACTOR IS RESPONSIBLE FOR OBTAINING ANY AND ALL ADDITIONAL AUTHORIZATIONS OR PERMITS ASSOCIATED WITH DEWATERING ACTIVITIES INCLUDING OBTAINING ANY APPLICABLE WATER TESTING.
 4. CONTRACTOR SHALL PREPARE AND SUBMIT A DEWATERING PLAN SHOWING APPLICABLE BEST MANAGEMENT PRACTICES TO FDEP ERP PROGRAM FOR REVIEW AND APPROVAL PRIOR TO ANY DEWATERING ACTIVITIES. THE PROPOSED DEWATERING PLAN SHALL ALSO INCLUDE THE PROPOSED POINT(S) OF DISCHARGE.
 5. APPLICABLE SOIL EROSION AND SEDIMENTATION CONTROL (SESC) MEASURES INCLUDING, BUT NOT LIMITED TO TEMPORARY SEDIMENT TRAP(S), SETTLEMENT TANK(S), STAKED BALES, RIP RAP, SILT FENCE, AND/OR ROCK CHECK DAMS, SHALL BE INSTALLED PRIOR TO ANY DEWATERING ACTIVITIES. THE CONTRACTOR SHALL MAINTAIN AND INSPECT DAILY.
 6. THE CONTRACTOR IS RESPONSIBLE FOR STABILIZING AND MAINTAINING ALL DEWATERING EQUIPMENT AND S.E.S.C. MEASURES.
 7. THE CONTRACTOR SHALL BE RESPONSIBLE FOR COLLECTING AND HAULING OFF SITE IN A TIMELY MANNER ANY AQUATIC LIFE IMPACTED BY DEWATERING AND CONSTRUCTION ACTIVITIES TO AN APPROVED LANDFILL FACILITY.

SOIL EROSION & SEDIMENTATION CONTROL NOTES:

1. ALL SOIL EROSION AND SEDIMENTATION CONTROL MEASURES SHALL BE IN PLACE PRIOR TO THE START OF ANY CONSTRUCTION, DEMOLITION, DEWATERING, OR MOBILIZATION ACTIVITIES, MAINTAINED THROUGHOUT CONSTRUCTION AND SHALL REMAIN IN PLACE UNTIL WORK IS COMPLETE.
2. CONTRACTOR SHALL FOLLOW BEST MANAGEMENT PRACTICES THROUGHOUT DEMOLITION AND CONSTRUCTION.
3. HAY BALES AND/OR SILT SCREENS SHALL BE INSTALLED ADJACENT TO THE WORK AREAS TO PREVENT SEDIMENT TRANSPORT PRIOR TO THE COMMENCEMENT OF WORK.
4. INLET PROTECTION SHALL BE PLACED AT ALL INLETS IN OR ADJACENT TO THE PROJECT AREA.
5. AS SOON AS PRACTICAL, ALL DRESSED SLOPES AND DISTURBED AREAS SHALL BE SODDED OR SEEDED AND MULCHED TO PREVENT EROSION.
6. NO EXCAVATION SHALL EXTEND BELOW THE DEPTHS/ELEVATIONS SHOWN ON THE DRAWINGS OR IN THE SPECIFICATIONS WITHOUT PRIOR APPROVAL.
7. CONTRACTOR SHALL PREPARE AND SUBMIT A STORM WATER POLLUTION PREVENTION PLAN (SWPPP) FOR REVIEW AND APPROVAL PRIOR TO COMMENCEMENT OF ANY CONSTRUCTION ACTIVITIES AND PROVIDE APPROVED FDEP NOI TO COUNTY.
8. CONTRACTOR SHALL PREPARE AND SUBMIT A DISPOSAL PLAN FOR EXCAVATION MATERIAL INCLUDING THE LOCATION OF DISPOSAL SITE(S) AND DISPOSAL PLANS SHOWING APPLICABLE BEST MANAGEMENT PRACTICES FOR REVIEW AND APPROVAL PRIOR TO ANY EARTHWORK ACTIVITIES.

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REV. NO.	DESCRIPTIONS	DATE

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TRAVIS N. TERPSTRA, P.E.
No. 71412

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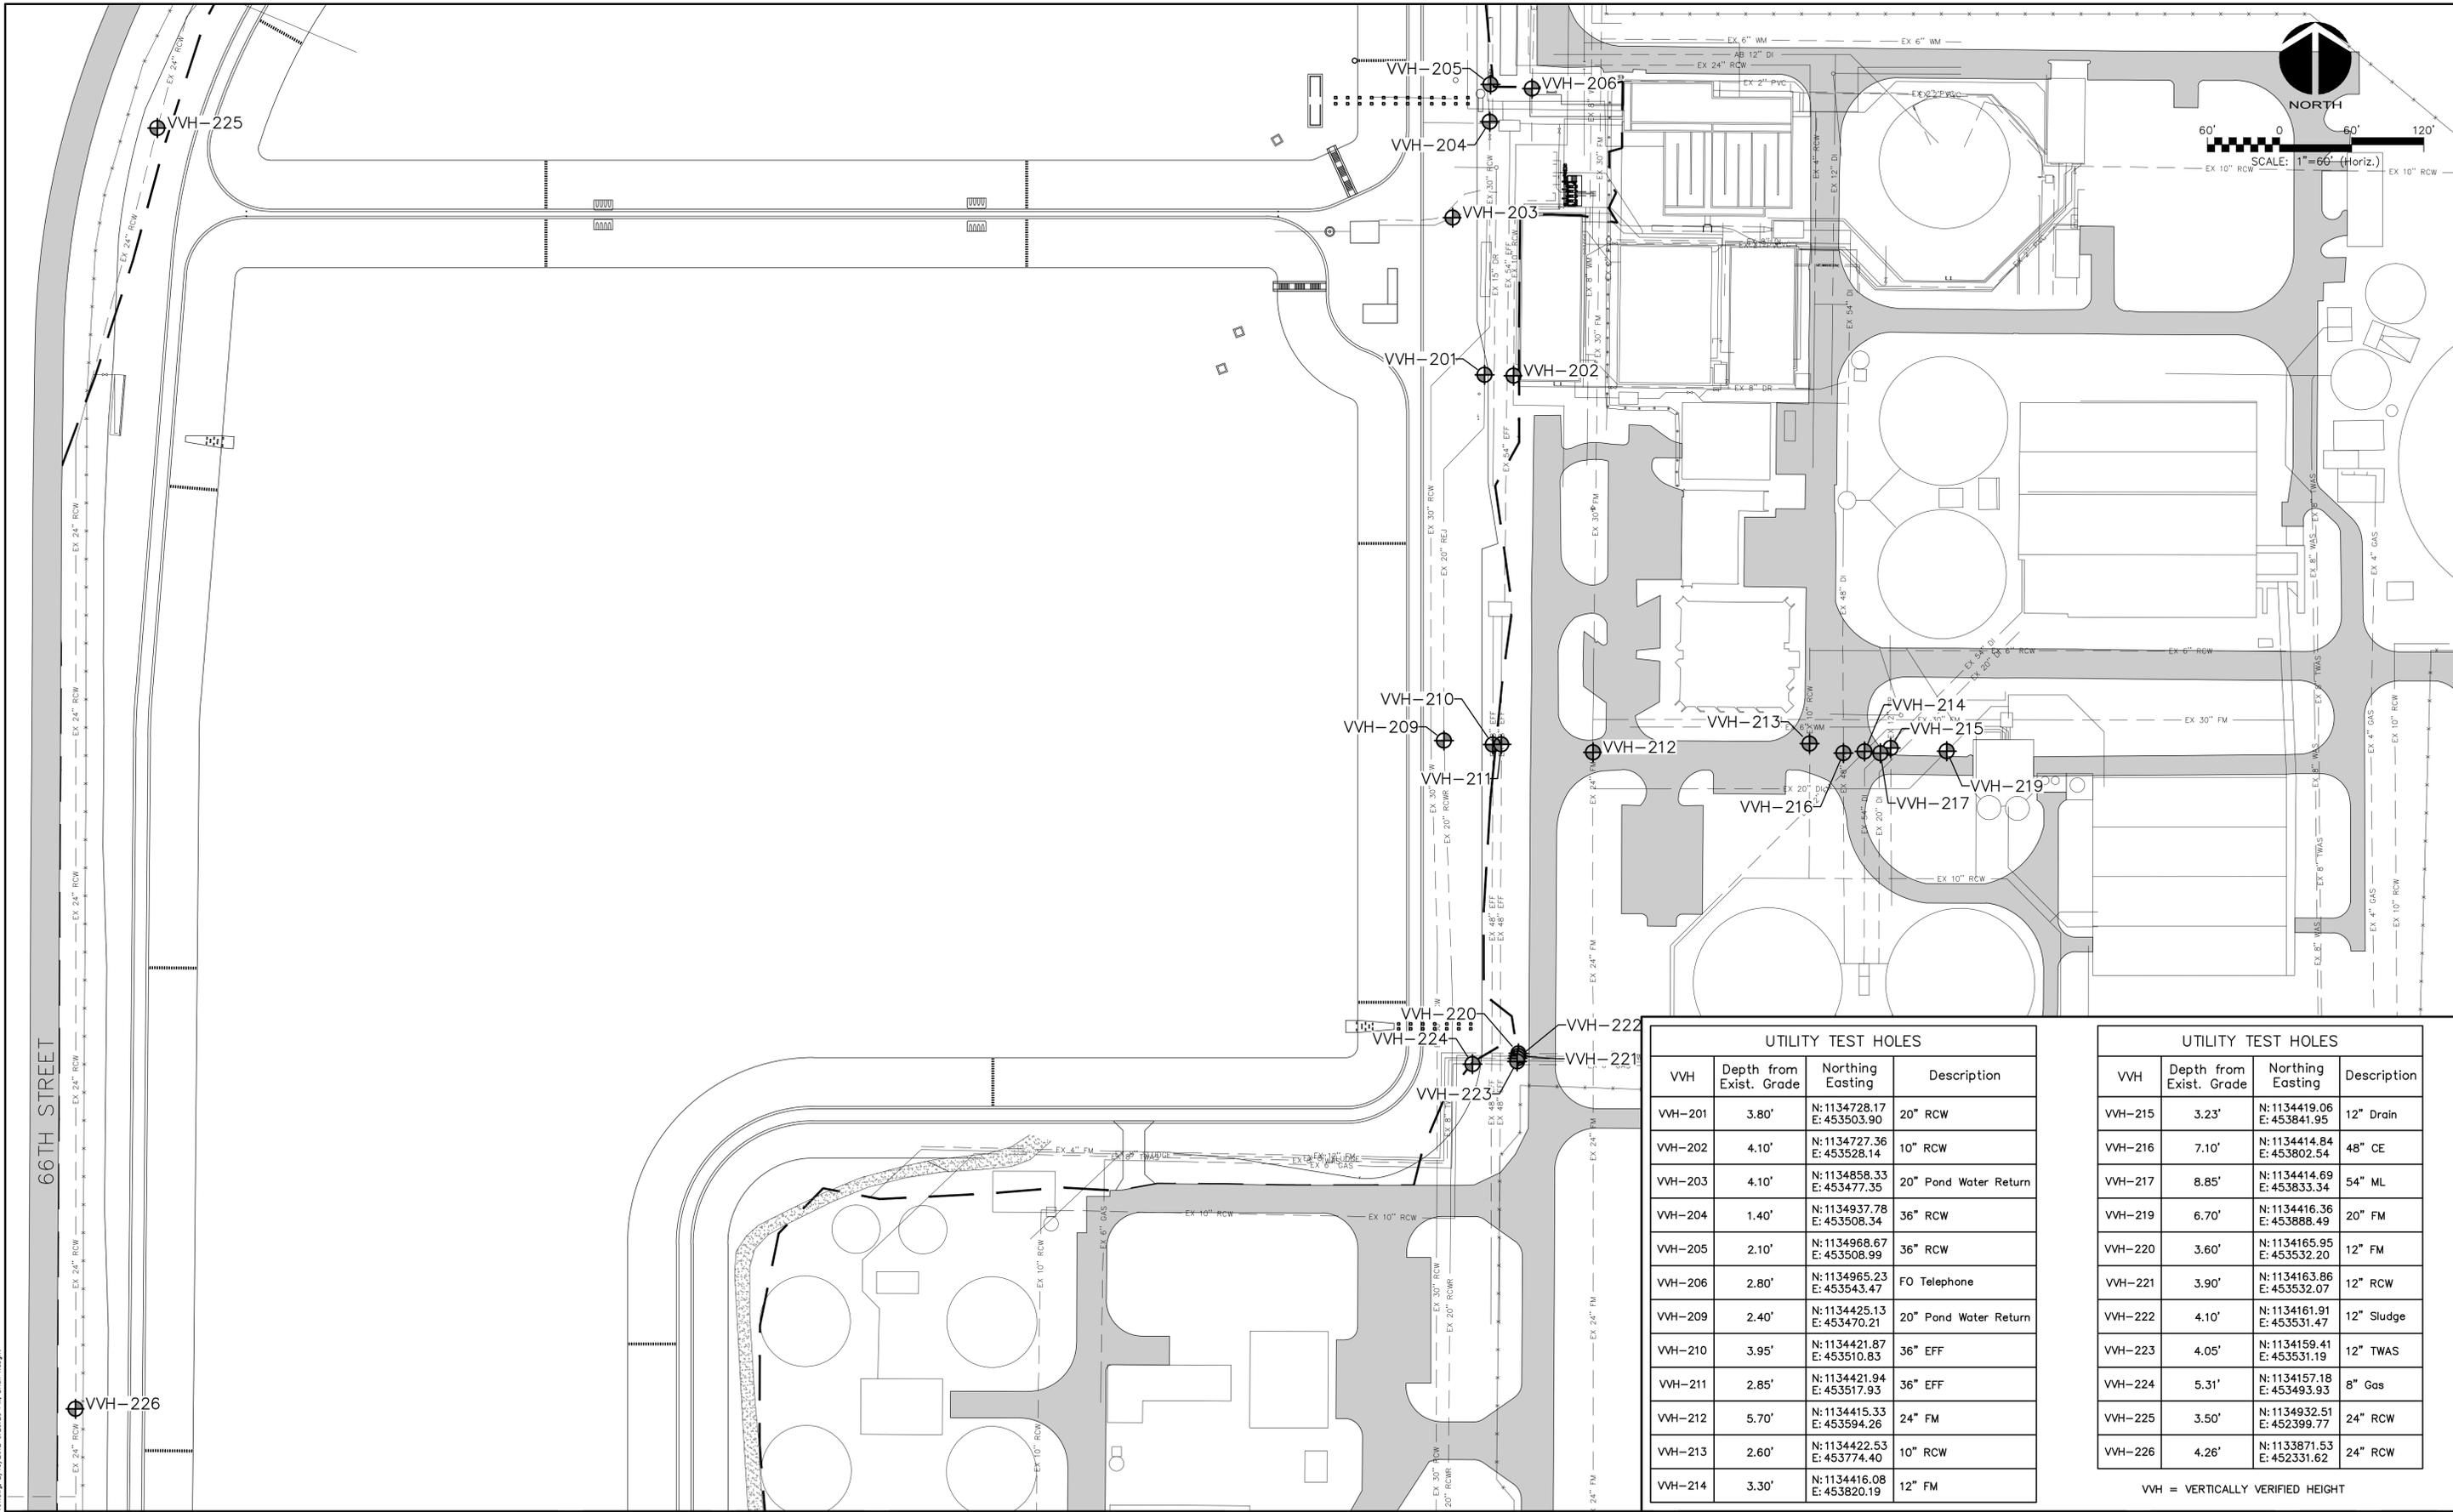
SWWRF LAKE FILTRATION AND NORTH POND IMPROVEMENTS

PROPOSED SITE PLAN AND SOIL EROSION AND SEDIMENTATION CONTROL

DATE: FEBRUARY 2012	SCALE: HORIZONTAL: 1" = 100'	DRAWING NUMBER: C-0.2
MCE PROJ. # 1024-0147	VERTICAL: NA	REVISION
DRAWN: BFN		
DESIGNED: MSL		
CHECKED: JSL		
PROJ. MGR: MSL		
STATUS: ISSUE FOR BID		



SCALE: 1" = 60' (Horiz.)



UTILITY TEST HOLES			
VH	Depth from Exist. Grade	Northing Easting	Description
VH-201	3.80'	N:1134728.17 E:453503.90	20" RCW
VH-202	4.10'	N:1134727.36 E:453528.14	10" RCW
VH-203	4.10'	N:1134858.33 E:453477.35	20" Pond Water Return
VH-204	1.40'	N:1134937.78 E:453508.34	36" RCW
VH-205	2.10'	N:1134968.67 E:453508.99	36" RCW
VH-206	2.80'	N:1134965.23 E:453543.47	FO Telephone
VH-209	2.40'	N:1134425.13 E:453470.21	20" Pond Water Return
VH-210	3.95'	N:1134421.87 E:453510.83	36" EFF
VH-211	2.85'	N:1134421.94 E:453517.93	36" EFF
VH-212	5.70'	N:1134415.33 E:453594.26	24" FM
VH-213	2.60'	N:1134422.53 E:453774.40	10" RCW
VH-214	3.30'	N:1134416.08 E:453820.19	12" FM

UTILITY TEST HOLES			
VH	Depth from Exist. Grade	Northing Easting	Description
VH-215	3.23'	N:1134419.06 E:453841.95	12" Drain
VH-216	7.10'	N:1134414.84 E:453802.54	48" CE
VH-217	8.85'	N:1134414.69 E:453833.34	54" ML
VH-219	6.70'	N:1134416.36 E:453888.49	20" FM
VH-220	3.60'	N:1134165.95 E:453532.20	12" FM
VH-221	3.90'	N:1134163.86 E:453532.07	12" RCW
VH-222	4.10'	N:1134161.91 E:453531.47	12" Sludge
VH-223	4.05'	N:1134159.41 E:453531.19	12" TWAS
VH-224	5.31'	N:1134157.18 E:453493.93	8" Gas
VH-225	3.50'	N:1134932.51 E:452399.77	24" RCW
VH-226	4.26'	N:1133871.53 E:452331.62	24" RCW

VH = VERTICALLY VERIFIED HEIGHT

REV. NO.	DESCRIPTIONS	DATE

SEAL

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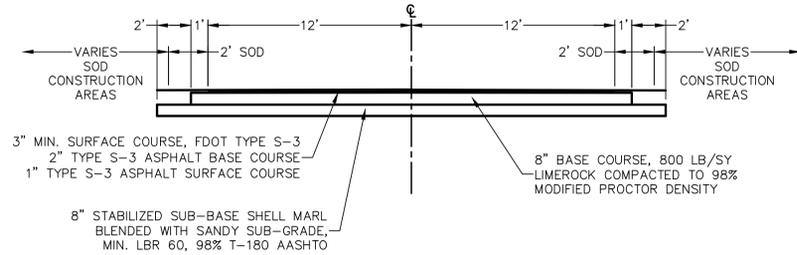
MANATEE COUNTY, FLORIDA

SWWRF LAKE FILTRATION AND NORTH POND IMPROVEMENTS


SUE LOCATIONS

DATE: FEBRUARY 2012	SCALE: HORIZONTAL: 1" = 60'	DRAWING NUMBER: C-0.5
MCE PROJ. # 1024-0147	VERTICAL: NA	
DRAWN: BFN		
DESIGNED: MSL		
CHECKED: JSL		
PROJ. MGR: MSL		
STATUS: ISSUE FOR BID		

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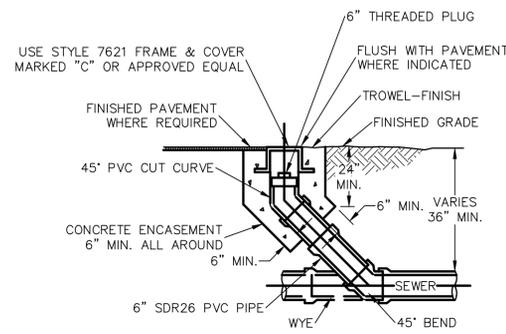
**INTERIOR PLANT ROADWAY
TYPICAL SECTION**
NOT TO SCALE




TYPICAL SIDEWALK DETAIL
NOT TO SCALE

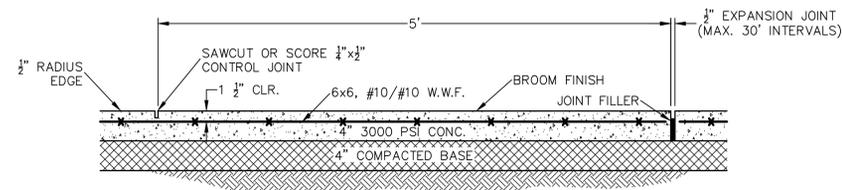- NOTES:**
- CONTRACTOR SHALL REMOVE EXISTING SLIDE AND SLUICE GATES IN THEIR ENTIRETY.
 - CONTRACTOR SHALL REPLACE EXISTING GATES AND ELECTRIC OPERATORS.
 - CONTRACTOR SHALL FIELD VERIFY CONDUIT AND WIRING FOR POWER AND CONTROLS AND REPLACE AS NECESSARY TO PROVIDE PROPERLY FUNCTIONING SYSTEM.
 - SEE SLUICE GATE DETAIL.
 - BACKGROUND IMAGE FROM RECORD DRAWINGS DATED JUNE 1998 FOR "STORAGE POND IMPROVEMENTS".


GATE SCHEDULE			
IDENTIFICATION NUMBER	SG-1	SG-2	SG-3
MOUNTING LOCATION	MIDDLE POND OUTLET	MIDDLE POND OUTLET	MIDDLE POND OUTLET
OPERATOR TYPE	FRAME MOUNTED ELECTRIC	FRAME MOUNTED ELECTRIC	FRAME MOUNTED ELECTRIC
OPENING WIDTH	5'-0"	5'-0"	4'-0"
FRAME HEIGHT	14'-0"	14'-0"	6'-0"
GATE HEIGHT "C"	5'-0"	5'-0"	4'-0"




CLEANOUT DETAIL
NOT TO SCALE

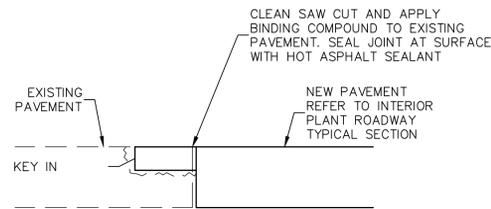


ASPHALT CONNECTION
NOT TO SCALE

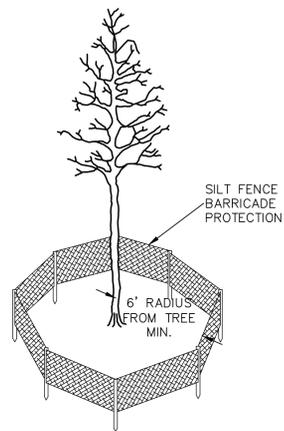

TREE PROTECTION DETAIL
NOT TO SCALE

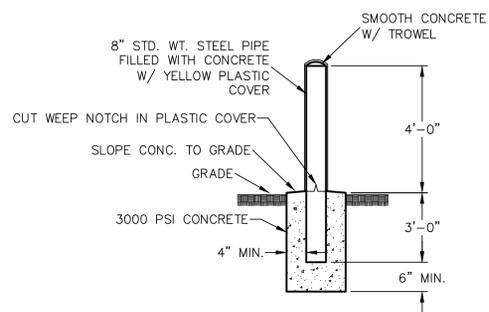

BOLLARD DETAIL
NOT TO SCALE

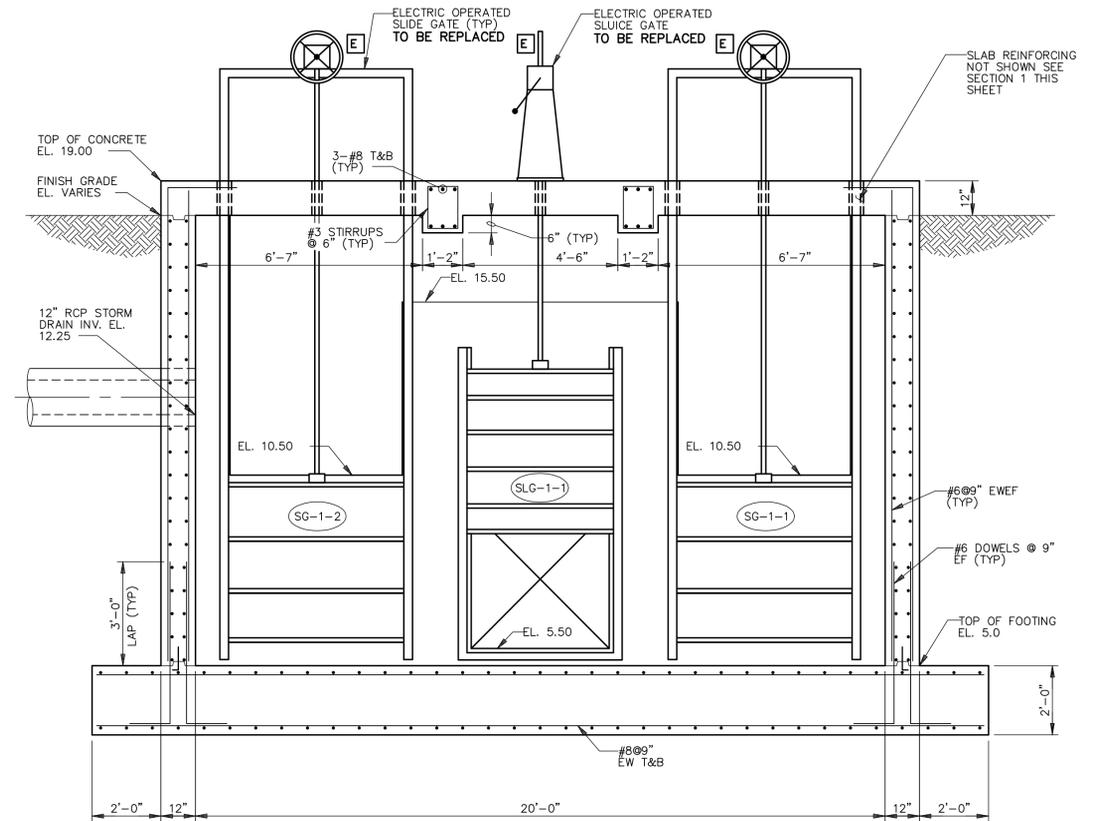

MIDDLE POND GATE SCHEDULE
NOT TO SCALE

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SWWRF LAKE FILTRATION AND
NORTH POND IMPROVEMENTS

CIVIL DETAILS No. 2


DATE: FEBRUARY 2012
MCE PROJ. # 1024-0147
DRAWN: BFN
DESIGNED: SJB
CHECKED: JSL
PROJ. MGR: MSL

SCALE: HORIZONTAL: NA
VERTICAL: NA


DRAWING NUMBER: C-0.7

STATUS: ISSUE FOR BID


REVISION

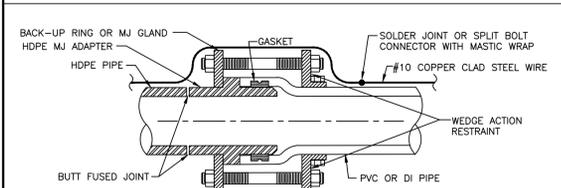

HDPE PIPE TO PVC PIPE / SPIGOT TO BELL CONNECTION

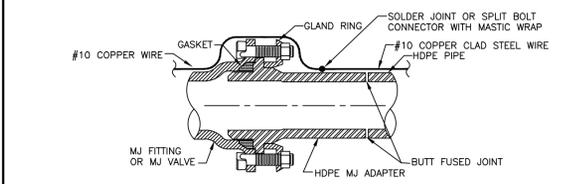


HDPE PIPE TO MJ FITTING TRANSITION

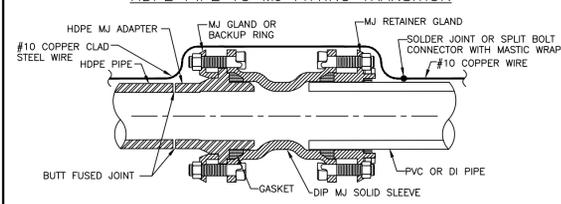


HDPE PIPE TO PVC PIPE SPIGOT TO SPIGOT CONNECTION

1. ONE # 10 GAUGE EXTRA HIGH STRENGTH COPPER CLAD STEEL TRACER WIRE SHALL BE PULLED AND SECURED TO THE PIPE FOR PIPELINES THAT ARE INSTALLED BY TRENCHLESS HORIZONTAL DIRECTIONAL DRILLING METHOD. IN NON-DIRECTIONAL BORE (TRENCHES AND JACK) APPLICATIONS, A # 10 GAUGE SOLID INSULATED COPPER WIRE SHALL BE ATTACHED TO THE PIPE. TRACER WIRES SHALL HAVE A MINIMUM 30-MILS OF POLYETHYLENE INSULATION.

PIPE SIZE (IN.)	THRUST BLOCK DIMENSIONS B ft. x d inches					
	90° BEND	45° BEND	22.5° BEND	11.25° BEND	DEAD END	45° WYE
4	1.5 3 1/2	1.1 3 1/2	0.8 3 1/2	0.6 3 1/2	1.3 3 1/2	1.1 3 1/2
6	2.2 5 1/2	1.6 3 3/4	1.2 3 3/4	0.8 3 3/4	1.9 4 1/2	1.6 3 3/4
8	2.9 7	2.1 5	1.5 3 3/4	1.1 3 3/4	2.4 5 1/2	2.0 4 3/4
10	3.5 8 1/2	2.6 6 1/2	1.9 4 1/2	1.3 3 3/4	3.0 7 1/2	2.5 6
12	4.2 10	3.1 7 1/2	2.2 5 1/2	1.6 3 3/4	3.5 8 1/2	3.0 7 1/2
14	4.9 11 3/4	3.6 8 3/4	2.6 6 1/2	1.8 4 1/2	4.1 9 3/4	3.4 8 1/2
16	5.5 13 1/4	4.1 9 3/4	2.9 7	2.1 5	4.7 11 1/2	3.9 9 1/2
18	6.2 15	4.6 11	3.3 8	2.3 5 1/2	5.2 12 1/2	4.4 10 1/2
20	6.9 16 1/2	5.0 12	3.6 8 3/4	2.6 6 1/2	5.8 14	4.9 11 3/4
24	8.2 19 3/4	6.0 14 1/2	4.3 10 1/2	3.1 7 1/2	6.9 16 1/2	5.8 14
30	10.1 24 1/4	7.5 18	5.3 12 3/4	3.8 9	8.5 20 1/2	7.2 17 1/4
36	12.1 29	8.9 21 1/4	6.4 15 1/4	4.5 10 3/4	10.2 24 1/2	8.6 20 3/4

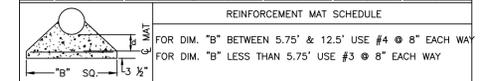

REINFORCEMENT MAT SCHEDULE
 FOR DIM. "B" BETWEEN 5.75' & 12.5' USE #4 @ 8" EACH WAY
 FOR DIM. "B" LESS THAN 5.75' USE #3 @ 8" EACH WAY

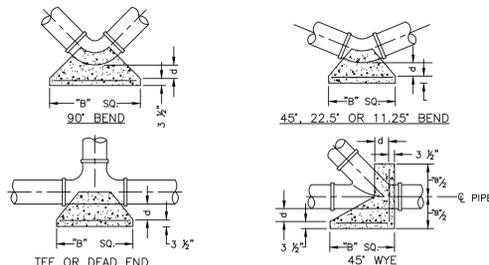

NOTES:
 1. ALL THRUST BLOCKS SHALL BE CAST IN PLACE. FITTINGS ADJACENT TO THRUST BLOCKS SHALL BE WRAPPED IN POLYETHYLENE.
 2. THIS TABLE IS BASED ON WATER PRESSURE=180 PSI WITH AN ALLOWABLE SOIL BEARING PRESSURE=2000 PSF. CONCRETE STRENGTH f_c =3000 PSI. REINFORCEMENT f_y =80.0 KSI. THRUST BLOCK SHALL BE CAST AGAINST FIRM UNDISTURBED SOIL.
 3. FOR LARGER "B" DIMENSIONS IT IS NECESSARY TO CHECK THAT PIPE IS SUFFICIENTLY DEEP TO ALLOW 15" MIN. SOIL COVER OVER TOP EDGE OF THRUST BLOCK.
 4. RESTRAINED JOINTS MAY BE USED IN LIEU OF THRUST BLOCKS TO SAVE SPACE. THRUST BLOCKS SHALL BE USED IN SITUATIONS WHERE THRUST BLOCKS AND RESTRAINED JOINTS ARE BOTH REQUIRED.

MANATEE COUNTY PUBLIC WORKS DEPARTMENT
 HDPE TO PVC OR DI PIPE ADAPTER
 UG-6
 MAY 10, 2011
 DATE OF APPROVAL
 PAGE 106

MANATEE COUNTY PUBLIC WORKS DEPARTMENT
 CONCRETE THRUST BLOCKS
 UG-7
 MAY 10, 2011
 DATE OF APPROVAL
 PAGE 107

REQUIRED LENGTH OF RESTRAINED JOINT PIPE FOR DR-18 PVC PIPE

MAIN PIPE SIZE	HORIZ. BENDS			TEES		REDUCERS		PLUGS & VALVES
	90°	45°	22.5°	SIZE	LENGTH	SIZE	LENGTH	
24	90	38	18	X24	169	X20	117	214
20	78	32	16	X20	141	X16	119	184
16	66	27	13	X16	111	X12	107	151
12	52	22	10	X12	80	X8	81	118
10	44	18	9	X10	63	X8	61	100
8	37	15	7	X8	49	X4	41	83
6	29	12	6	X6	29	X4	33	63
4	21	8	4	X4	12			45

REQUIRED LENGTH OF RESTRAINED JOINT PIPE FOR DIP (POLY-WRAPPED)


MAIN PIPE SIZE	HORIZ. BENDS			TEES		REDUCERS		PLUGS & VALVES
	90°	45°	22.5°	SIZE	LENGTH	SIZE	LENGTH	
36	142	59	28	X36	393	X24	230	453
30	124	51	25	X30	333	X24	199	391
24	106	44	21	X24	270	X18	143	327
20	92	38	18	X20	228	X16	110	280
16	77	32	15	X16	177	X12	95	231
12	61	25	12	X12	127	X8	80	181
10	52	22	10	X10	101	X8	84	153
8	44	18	9	X8	78	X4	30	128
6	34	14	7	X6	46	X4	31	98
4	24	10	5	X4	19			69

NOTES:
 1. RESTRAIN 11.25° BENDS 50% OF LENGTH FOR 22.5° BENDS.
 2. ALL VALVES AND FITTINGS SHALL BE RESTRAINED TO THE CONNECTION SECTIONS OF PIPE.
 3. ALL ISOLATION VALVES MUST BE PROPERLY ANCHORED OR RESTRAINED TO RESIST A 180 PSI TEST PRESSURE IN EITHER DIRECTION.
 4. PIPE SIZES ARE GIVEN IN INCHES.
 5. RESTRAINED PIPE LENGTHS ARE GIVEN IN FEET.
 6. LENGTHS SHOWN ARE FOR A TEST PRESSURE OF 180 PSI.
 7. THE RESTRAINED LENGTHS SHOWN IN THESE TABLES ARE BASED ON SOIL CLASSIFICATION SP WITH AWWA TYPE 3 TRENCH CONDITIONS, 180 PSI TEST PRESSURE, 3 FEET OF COVER AND 1.5 FACTOR OF SAFETY. ACTUAL BURY CONDITIONS MUST BE DETERMINED BY THE ENGINEER OF RECORD AND THE RESTRAINED LENGTHS MODIFIED ACCORDINGLY.
 8. RESTRAINED LENGTHS TO BE APPLIED TO PIPELINES PER DETAIL RESTRAINED LENGTHS FOR PIPE.

MANATEE COUNTY PUBLIC WORKS DEPARTMENT
 RESTRAINED LENGTHS FOR PVC PIPE
 UG-8
 MAY 10, 2011
 DATE OF APPROVAL
 PAGE 108


REQUIRED LENGTH OF RESTRAINED JOINT PIPE FOR DIP (NON-WRAPPED)

MAIN PIPE SIZE	HORIZ. BENDS			TEES		REDUCERS		PLUGS & VALVES
	90°	45°	22.5°	SIZE	LENGTH	SIZE	LENGTH	
36	100	42	20	X36	163	X24	96	188
30	88	37	18	X30	138	X24	104	162
24	75	31	15	X24	112	X18	87	135
20	65	27	13	X20	95	X16	85	116
16	54	22	11	X16	73	X12	77	96
12	43	18	8	X12	53	X10	57	75
10	37	15	7	X10	42	X8	46	63
8	30	13	6	X8	32	X6	35	53
6	24	10	5	X6	22	X4	21	41
4	17	7	3	X4	8			29

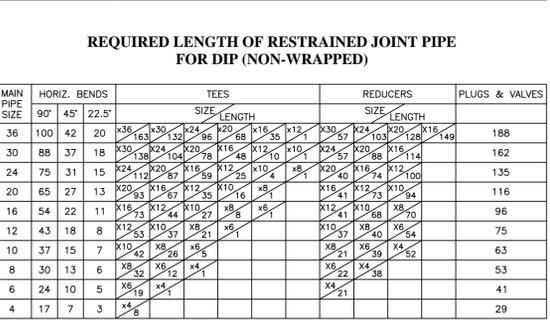


NOTE:
 SEE RESTRAINED LENGTHS FOR PVC PIPE DETAIL FOR NOTES 1 THROUGH 8 THAT ARE ALSO APPLICABLE TO RESTRAINED LENGTHS FOR DIP.


MANATEE COUNTY PUBLIC WORKS DEPARTMENT
 RESTRAINED LENGTHS FOR DIP
 UG-9
 MAY 10, 2011
 DATE OF APPROVAL
 PAGE 109

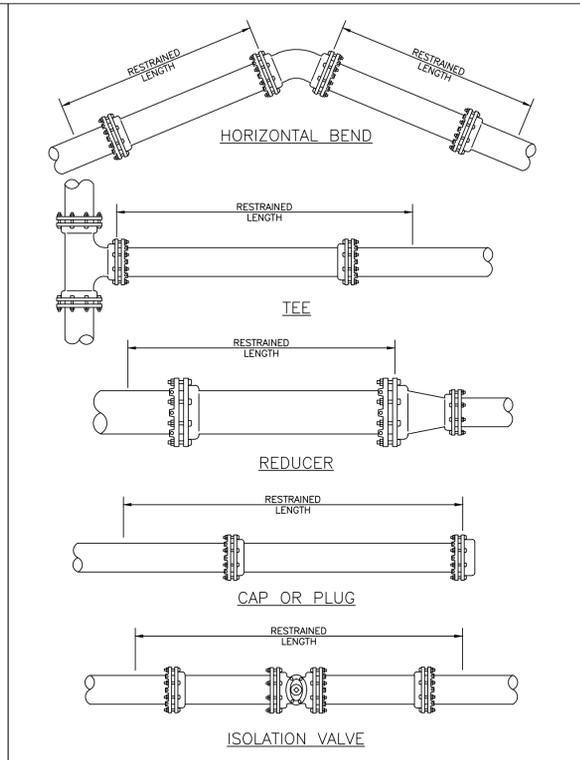


MANATEE COUNTY PUBLIC WORKS DEPARTMENT
 RESTRAINED LENGTHS FOR PIPE
 UG-10
 MAY 10, 2011
 DATE OF APPROVAL
 PAGE 110

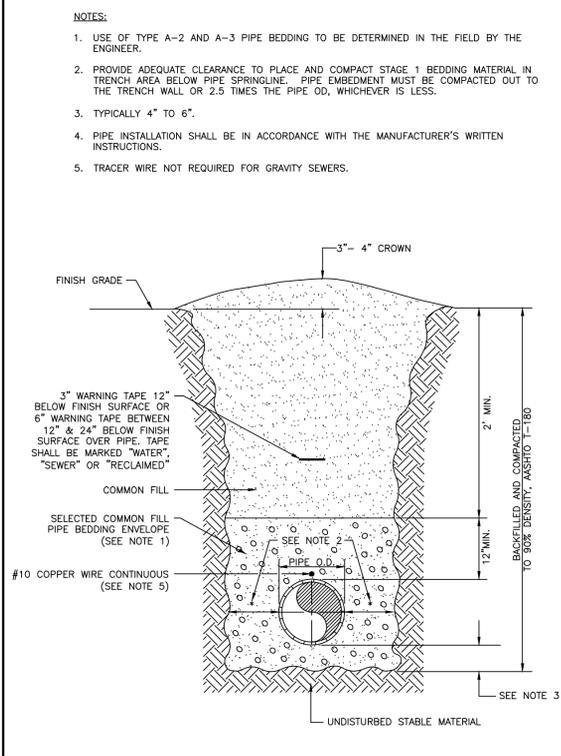


MANATEE COUNTY PUBLIC WORKS DEPARTMENT
 TRENCH WITH UNIMPROVED SURFACE TYPE A-1 PIPE BEDDING
 UG-11
 MAY 10, 2011
 DATE OF APPROVAL
 PAGE 111

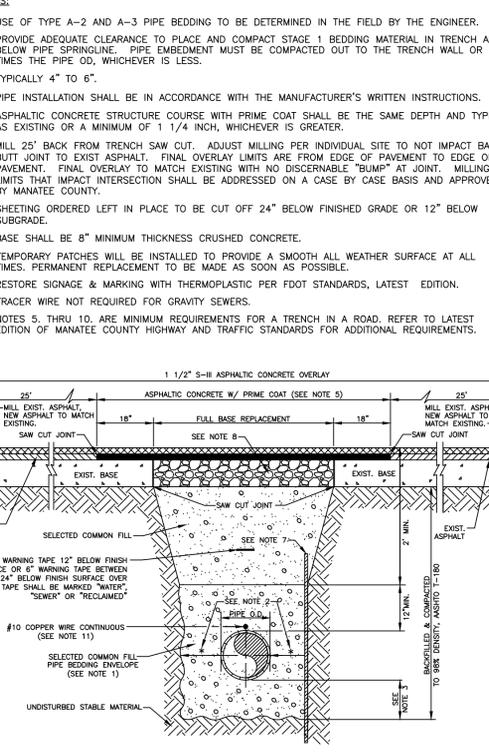


MANATEE COUNTY PUBLIC WORKS DEPARTMENT
 TRENCH WITH ASPHALT PAVEMENT SURFACE TYPE A-1 PIPE BEDDING
 UG-12
 MAY 10, 2011
 DATE OF APPROVAL
 PAGE 112

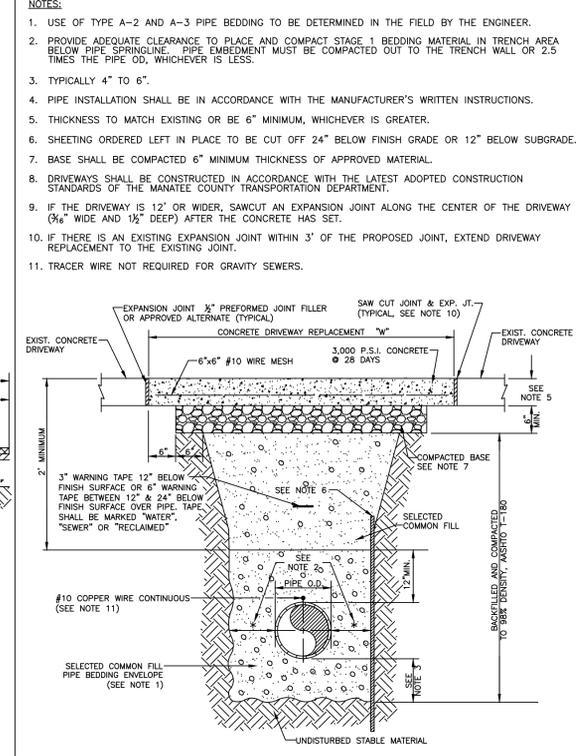

MANATEE COUNTY PUBLIC WORKS DEPARTMENT
 TRENCH WITH CONCRETE DRIVEWAY SURFACE TYPE A-1 PIPE BEDDING
 UG-14
 MAY 10, 2011
 DATE OF APPROVAL
 PAGE 114

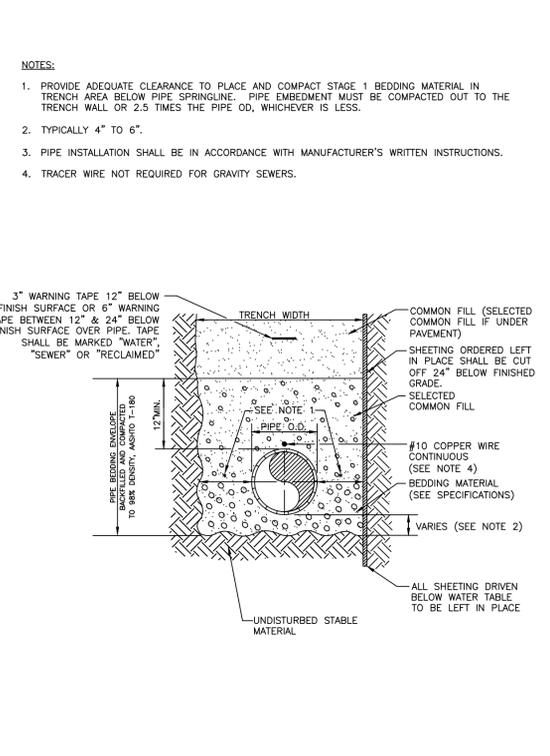

MANATEE COUNTY PUBLIC WORKS DEPARTMENT
 TRENCH WITH TYPE A-2 PIPE BEDDING
 UG-15
 MAY 10, 2011
 DATE OF APPROVAL
 PAGE 115

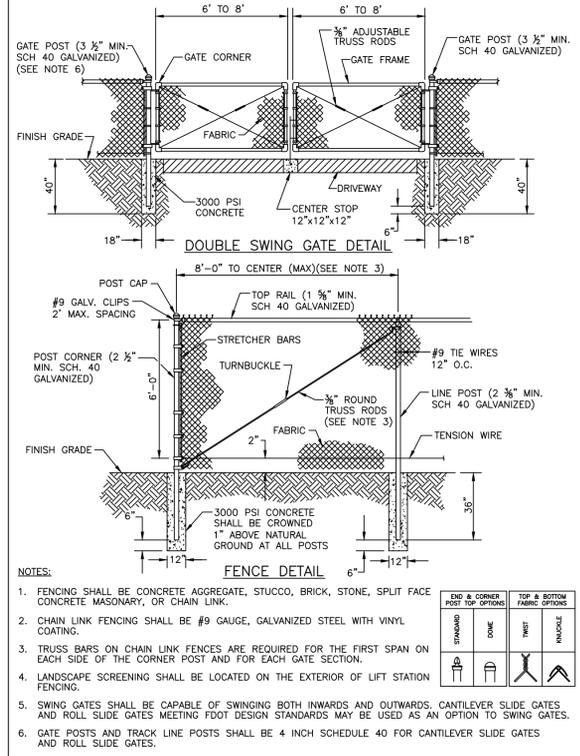

MANATEE COUNTY PUBLIC WORKS DEPARTMENT
 SECURITY FENCING
 UG-18
 MAY 10, 2011
 DATE OF APPROVAL
 PAGE 118

REV. NO.	DATE	DESCRIPTIONS

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MANATEE COUNTY, FLORIDA

SWRF LAKE FILTRATION AND NORTH POND IMPROVEMENTS
 CIVIL DETAILS No. 5


DATE: FEBRUARY 2012
 MCE PROJ. # 1024-0147
 DRAWN: BFN
 DESIGNED: SJB
 CHECKED: JSL
 PROJ. MGR: MSL

SCALE: HORIZONTAL: NA, VERTICAL: NA

DRAWING NUMBER: C-0.10


STATUS: ISSUE FOR BID

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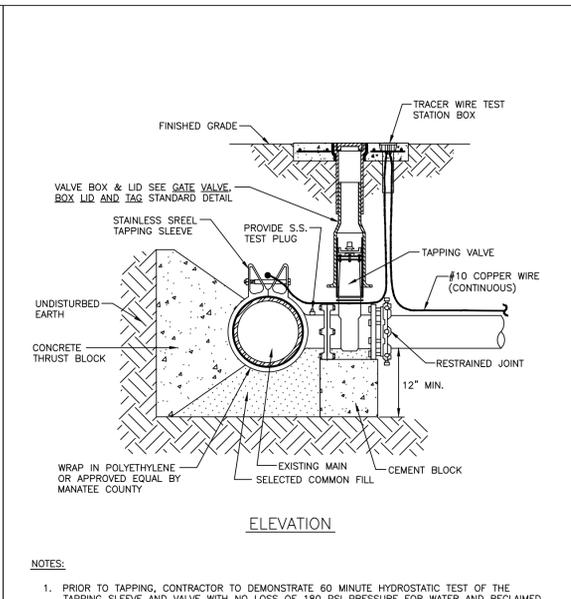
- NOTES:**
- "W" or "RW" to be impressed into the newly-poured concrete curb, along with distance in feet to the valve. If no curb, install a blue disc with "W" or purple disc with "RW" and a 1/8"x1" galvanized steel screw in the edge of pavement with the footage from the disc to the valve.
 - All existing and proposed valve boxes shall be adjusted to finished grades as determined in the field.
 - Water valves shall not be placed in handicapped ramps.
 - Pre-cast concrete pads & thrust blocks shall not be used.
 - All exposed edges of concrete shall be chamfered 1/2".
 - For valves 16" and larger, use butterfly valves.
 - Pipeline direction to be impressed into newly poured concrete pad.
 - Tracer wire test station box is not required in valve box pad if the gate valve is located within 200 feet of a water service, blow-off, backflow preventer or fire hydrant that has a tracer wire box.
 - Where thrust block not used, restrained joints must then extend from tee full length specified for "tees".
 - Bingham & Taylor P200NFG or equal for normal yard service where valve will be in street or parking under vehicle traffic. Use P525RD centered in separate concrete pad similar to standard valve box pad.

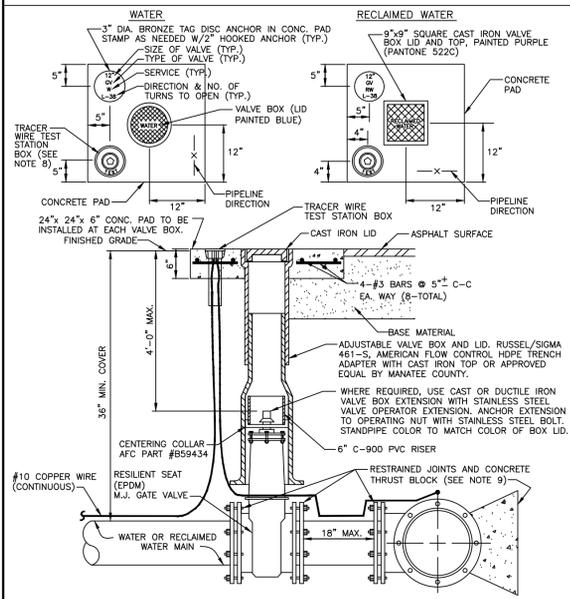MANATEE COUNTY PUBLIC WORKS DEPARTMENT		GATE VALVE, BOX, LID AND TAG		UW-2	
REV. BY	DATE	DATE OF APPROVAL	MAY 10, 2011		
CLB/KE	11/10	PAGE 120			




- NOTES:**
- "W" or "RW" to be impressed into the newly-poured concrete curb, along with if no curb, install a blue disc with "W" or purple disc with "RW" and a 1/8"x1" galvanized steel screw in the edge of pavement with the footage from the disc to the valve.
 - All existing and proposed valve boxes shall be adjusted to finished grades as determined in the field.
 - Water valves shall not be placed in handicapped ramps.
 - Pre-cast concrete pads & thrust blocks shall not be used.
 - All exposed edges of concrete shall be chamfered 1/2".
 - For valves 16" and larger, use butterfly valves.
 - Pipeline direction to be impressed into newly poured concrete pad.
 - Where thrust block not used, restrained joints must then extend from tee full length specified for "tees".
 - Bingham & Taylor P200NFG or equal for normal yard service where valve will be in street or parking under vehicle traffic. Use P525RD centered in separate concrete pad similar to standard valve box pad.

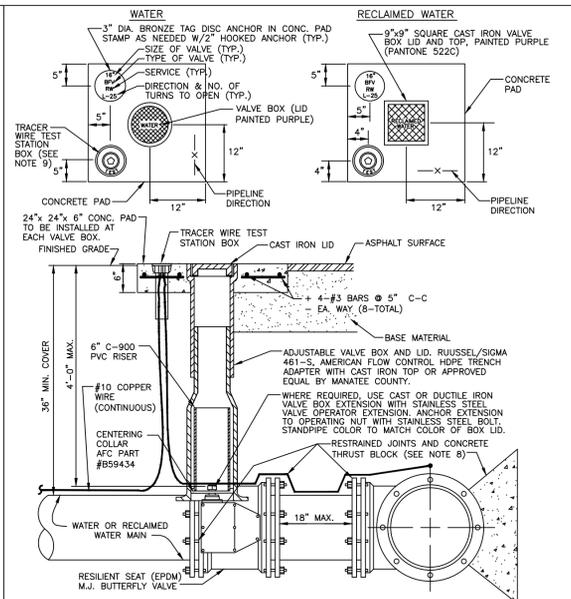MANATEE COUNTY PUBLIC WORKS DEPARTMENT		BUTTERFLY VALVE, BOX, LID AND TAG		UW-3	
REV. BY	DATE	DATE OF APPROVAL	MAY 10, 2011		
CLB/KE	11/10	PAGE 121			




- NOTES:**
- Prior to tapping, contractor to demonstrate 60 minute hydrostatic test of the tapping sleeve and valve with no loss of 180 PSI pressure for water and reclaimed water or 150 PSI for force main.
 - All fittings to be wrapped with 20 mil visqueen at thrust block.
 - All taps on concrete water mains and larger than 12" are to be made by a Manatee County approved tapping company. All materials to be supplied by the contractor.
 - All taps must be of a smaller size than the main being tapped & placed no closer than 30" or a distance equal to (1) main pipe diameter plus (2) tap pipe diameters (whichever is greater) from a joint or fitting.
 - Contractor to supply a dry hole for tapping crew to work in and a back-hoe to lower tapping machine into the hole.
 - Where thrust block not used, restrained joints must then extend from tee full length specified for "tees".
 - Tracer wire test station box is required at connections to existing mains.

MANATEE COUNTY PUBLIC WORKS DEPARTMENT		TAPPING SLEEVE AND VALVE		UW-4	
REV. BY	DATE	DATE OF APPROVAL	MAY 10, 2011		
CLB/KE	11/10	PAGE 122			

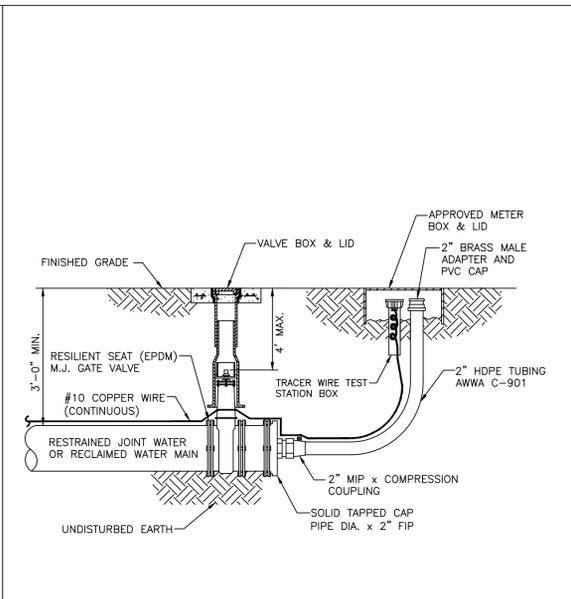


- NOTE:**
- SEE STANDARD DETAIL GATE VALVE, BOX, LID AND TAG.

MANATEE COUNTY PUBLIC WORKS DEPARTMENT		2" BLOW-OFF ASSEMBLY FOR 10" MAINS AND SMALLER		UW-7	
REV. BY	DATE	DATE OF APPROVAL	MAY 10, 2011		
CLB/KE	11/10	PAGE 125			

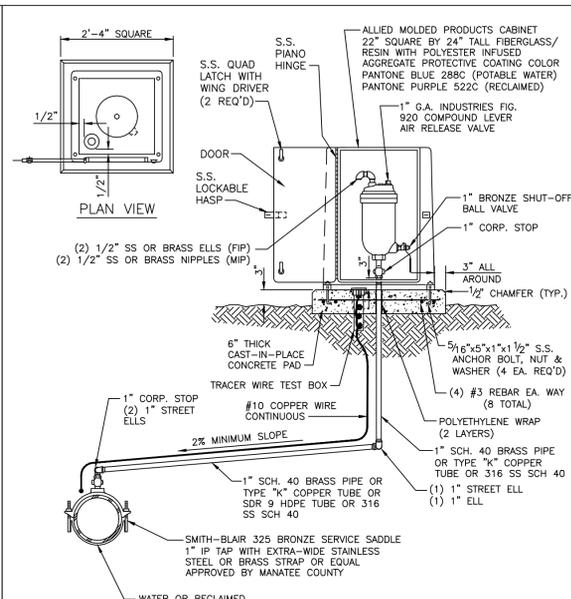


- NOTES:**
- Air release valves to be installed at high points along water mains where specifically indicated on the plan.
 - ARY vent orifice to be sized in accordance with manufacturer's recommendation for water main size.
 - All incidental fittings and hardware to be stainless steel, brass or copper.
 - All pipe threads to be sealed air tight.
 - Vent pipe to be laid accurately on slope, without high or low points.

MANATEE COUNTY PUBLIC WORKS DEPARTMENT		ABOVE-GROUND AIR RELEASE VALVE ASSY. FOR 12-INCH AND SMALLER WATER MAINS		UW-9	
REV. BY	DATE	DATE OF APPROVAL	MAY 10, 2011		
CLB/KE	11/10	PAGE 127			

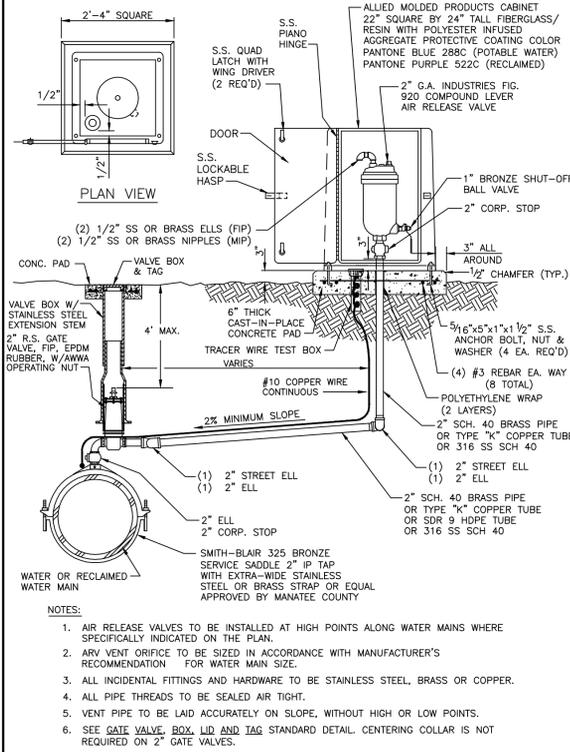


- NOTES:**
- Air release valves to be installed at high points along water mains where specifically indicated on the plan.
 - ARY vent orifice to be sized in accordance with manufacturer's recommendation for water main size.
 - All incidental fittings and hardware to be stainless steel, brass or copper.
 - All pipe threads to be sealed air tight.
 - Vent pipe to be laid accurately on slope, without high or low points.
 - SEE GATE VALVE, BOX, LID AND TAG STANDARD DETAIL. CENTERING COLLAR IS NOT REQUIRED ON 2" GATE VALVES.

MANATEE COUNTY PUBLIC WORKS DEPARTMENT		AIR RELEASE ASSEMBLY FOR 16-INCH AND LARGER MAINS		UW-10	
REV. BY	DATE	DATE OF APPROVAL	MAY 10, 2011		
CLB/KE	11/10	PAGE 128			

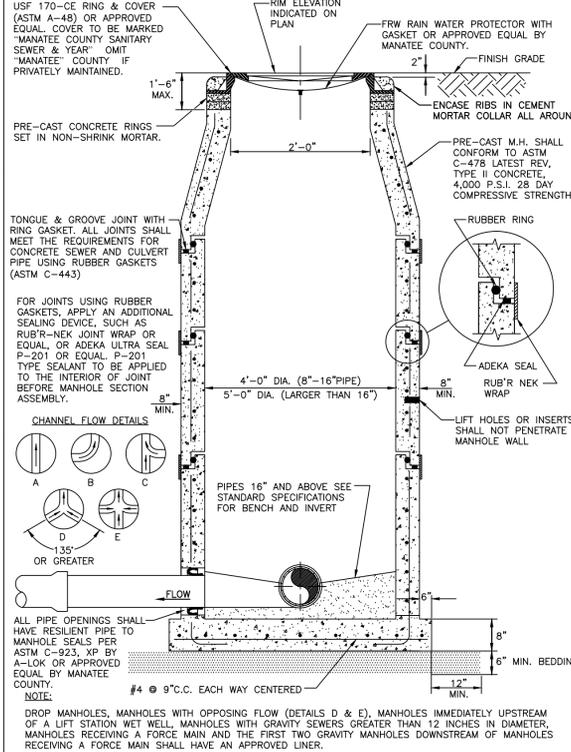


- NOTES:**
- Drop manholes, manholes with opposing flow (details D & E), manholes immediately upstream of a lift station wet well, manholes with gravity sewers greater than 12 inches in diameter, manholes receiving a force main and the first two gravity manholes downstream of manholes receiving a force main shall have an approved liner.

MANATEE COUNTY PUBLIC WORKS DEPARTMENT		STANDARD PRE-CAST SANITARY SEWER MANHOLE FOR UNDISTURBED FLOW		US-2	
REV. BY	DATE	DATE OF APPROVAL	MAY 10, 2011		
WRT/KE	04/11	PAGE 142			

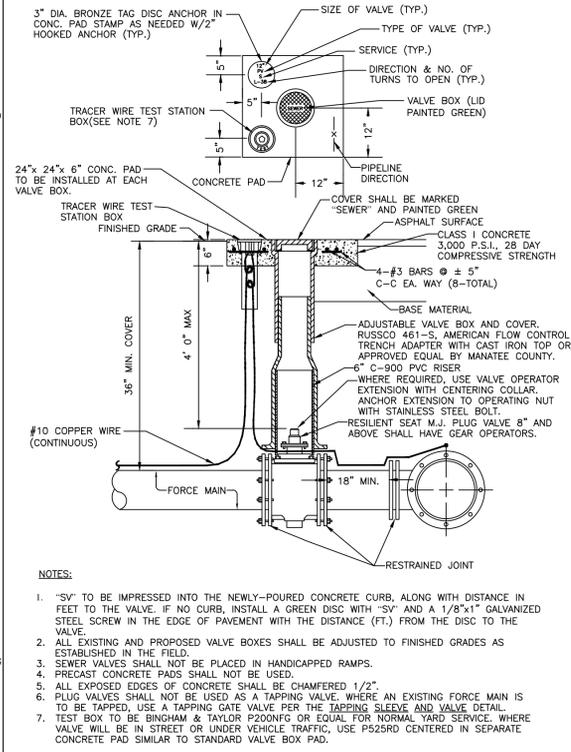

- NOTES:**
- "SV" to be impressed into the newly-poured concrete curb, along with distance in feet to the valve. If no curb, install a green disc with "SV" and a 1/8"x1" galvanized steel screw in the edge of pavement with the distance (FT) from the disc to the valve.
 - All existing and proposed valve boxes shall be adjusted to finished grades as established in the field.
 - Sever valves shall not be placed in handicapped ramps.
 - Pre-cast concrete pads shall not be used.
 - All exposed edges of concrete shall be chamfered 1/2".
 - Plug valves shall not be used as a tapping valve. Where an existing force main is to be tapped, use a tapping gate valve per the tapping sleeve and valve detail.
 - Test box to be Bingham & Taylor P200NFG or equal for normal yard service where valve will be in street or parking under vehicle traffic. Use P525RD centered in separate concrete pad similar to standard valve box pad.

MANATEE COUNTY PUBLIC WORKS DEPARTMENT		PLUG VALVE, BOX, COVER AND TAG		US-12	
REV. BY	DATE	DATE OF APPROVAL	MAY 10, 2011		
CLB/DOH	11/10	PAGE 152			

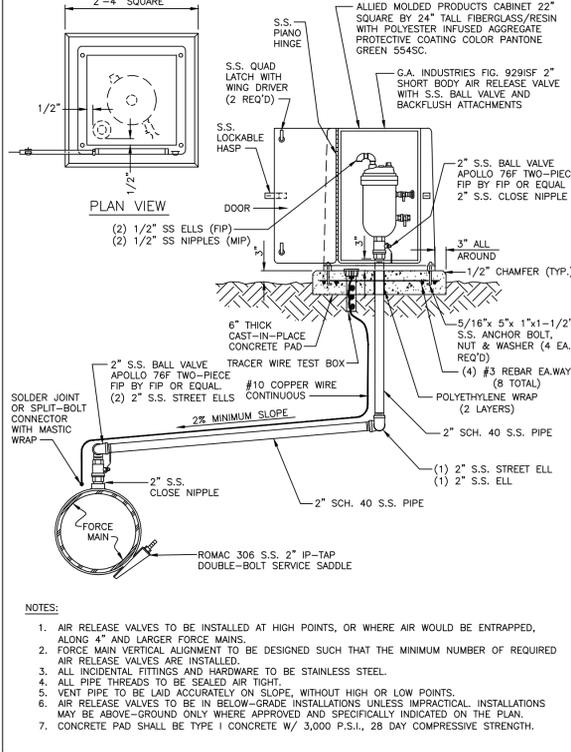

- NOTES:**
- Air release valves to be installed at high points, or where air would be entrapped, along 4" and larger force mains.
 - Force main vertical alignment to be designed such that the minimum number of required air release valves are installed.
 - All incidental fittings and hardware to be stainless steel.
 - All pipe threads to be sealed air tight.
 - Vent pipe to be laid accurately on slope, without high or low points.
 - Air release valves to be in below-grade installations unless impractical. Installations may be above-ground only where approved and specifically indicated on the plan.
 - Concrete pad shall be type 1 concrete w/ 3,000 P.S.I., 28 day compressive strength.

MANATEE COUNTY PUBLIC WORKS DEPARTMENT		ABOVE-GROUND AIR RELEASE VALVE ASSY. FOR FORCE MAINS		US-25	
REV. BY	DATE	DATE OF APPROVAL	MAY 10, 2011		
CLB/KE	11/10	PAGE 165			

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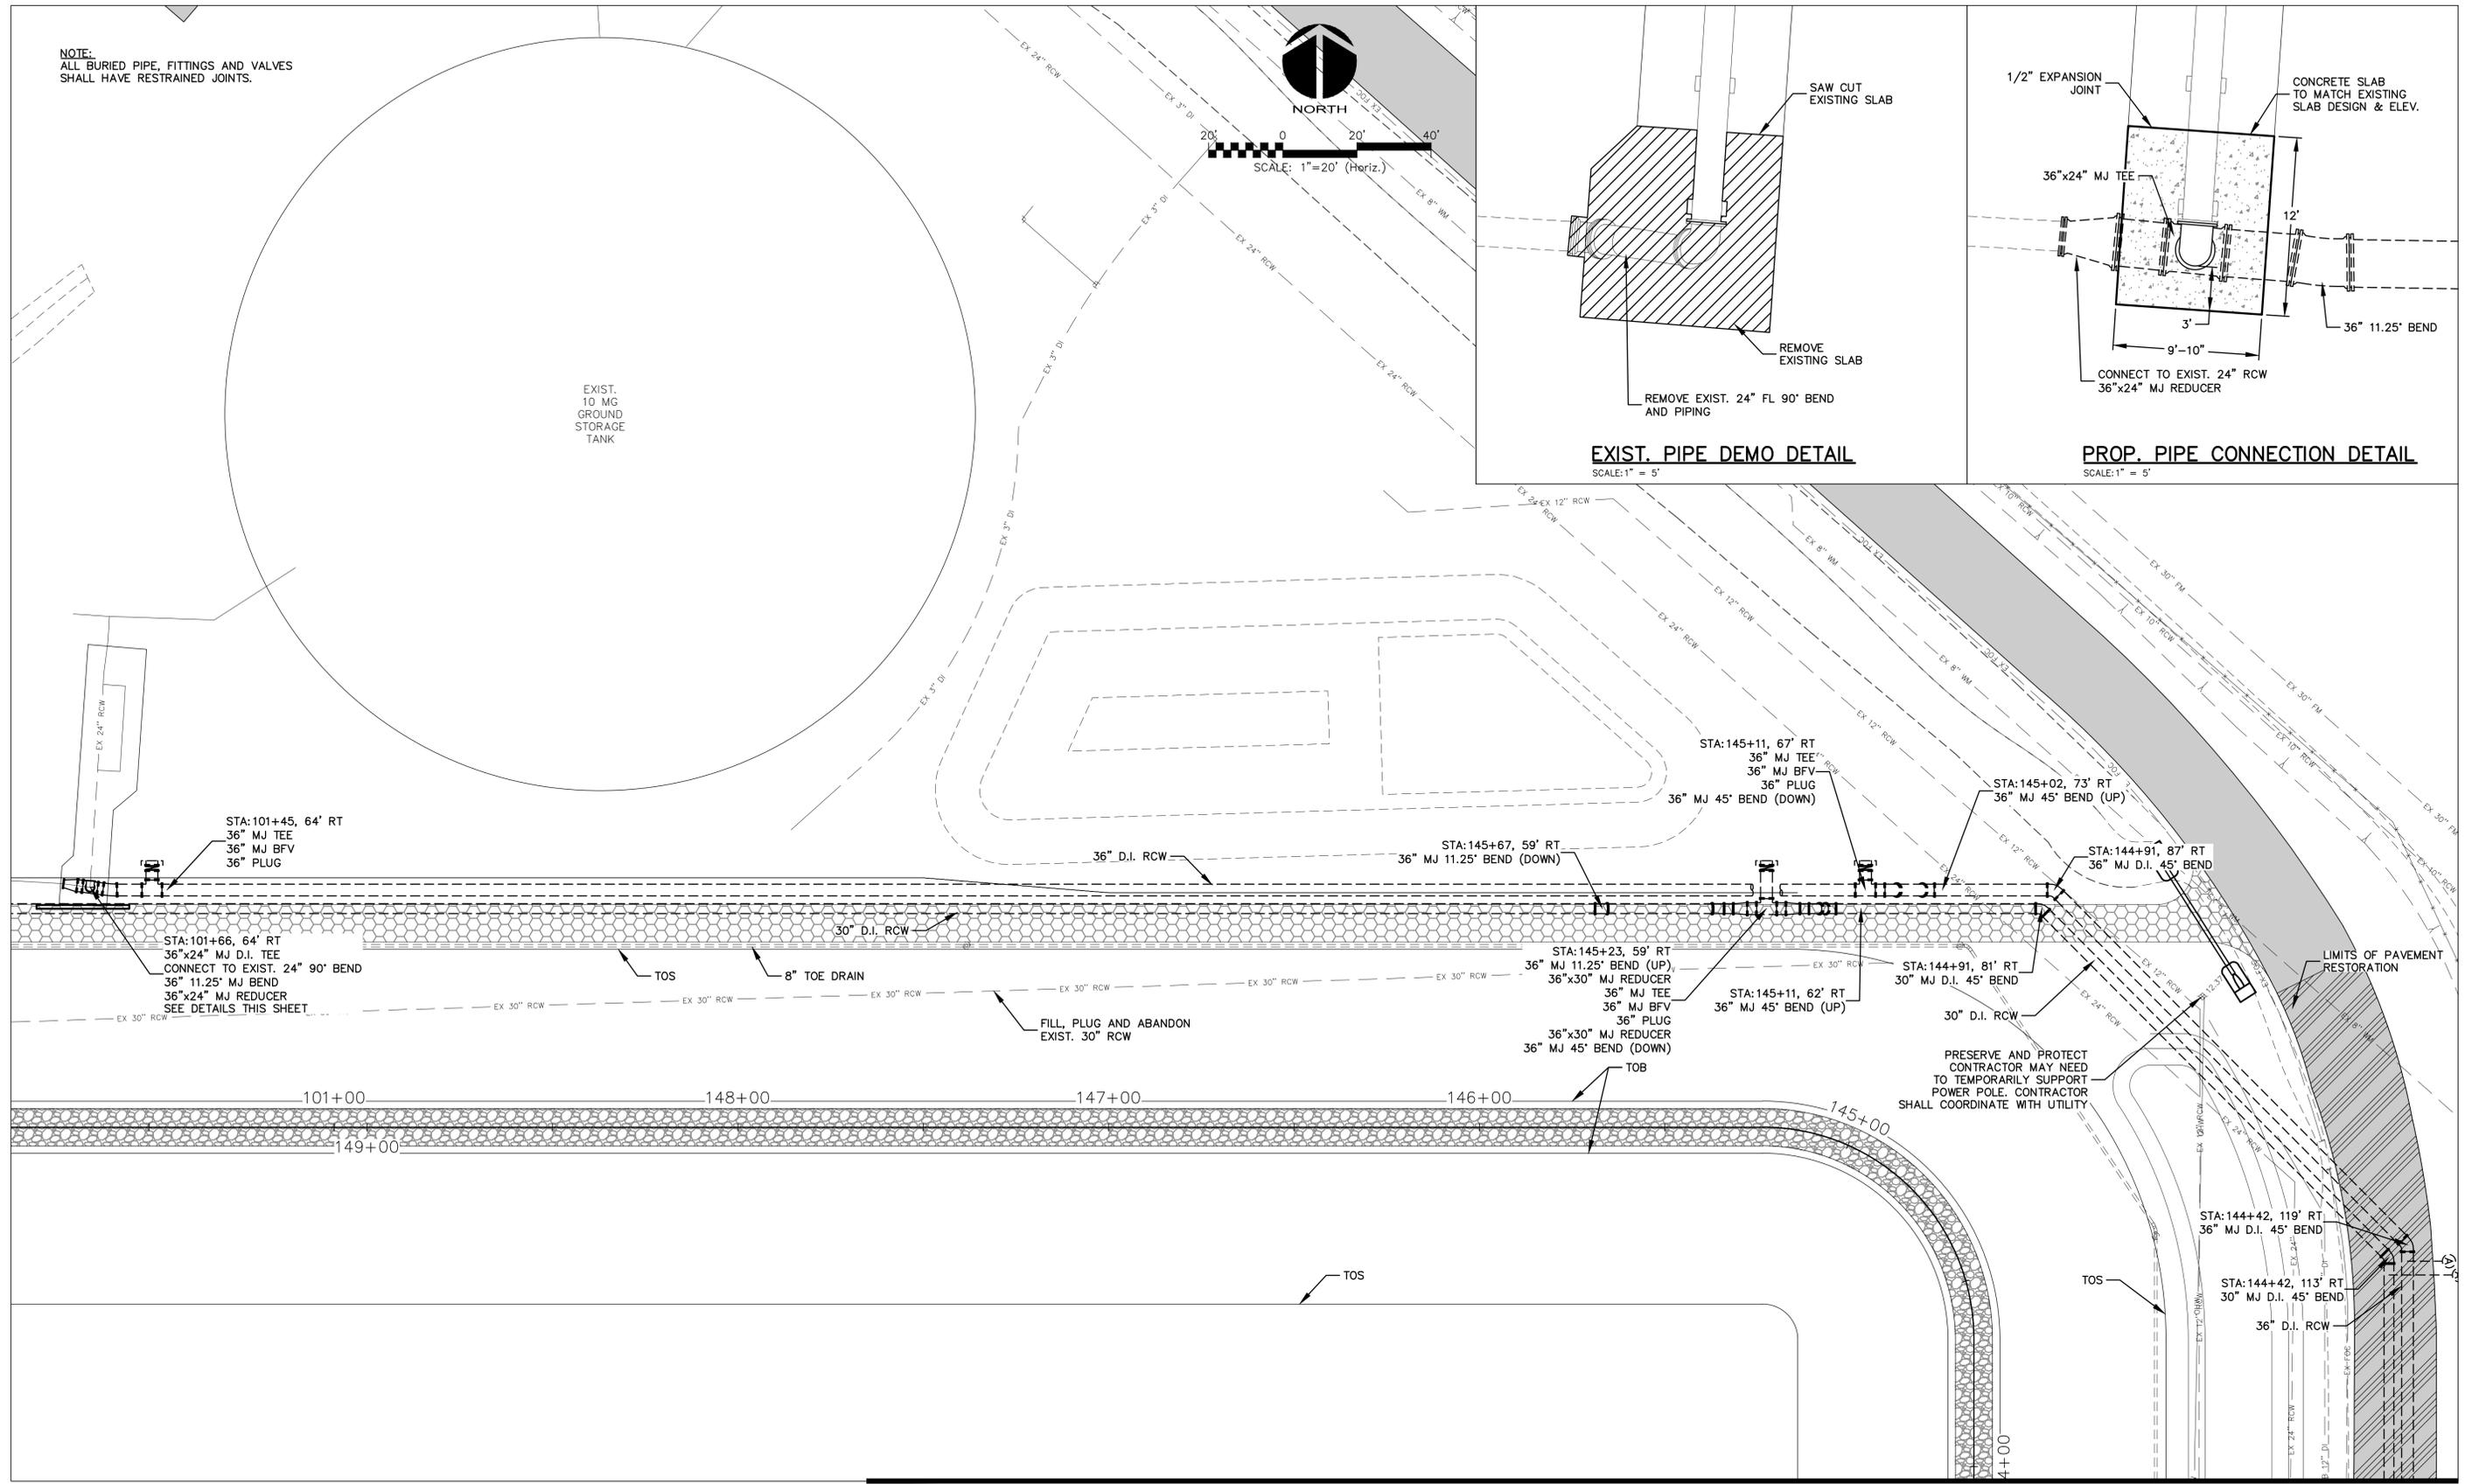
SWRF LAKE FILTRATION AND
NORTH POND IMPROVEMENTS

CIVIL DETAILS No. 6



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DRAWN: BFN	CHECKED: JSL	STATUS: ISSUE FOR BID
DESIGNED: SJB	PROJ. MGR: MSL	REVISION:

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NOTE:
ALL BURIED PIPE, FITTINGS AND VALVES
SHALL HAVE RESTRAINED JOINTS.



SCALE: 1" = 20' (Horiz.)

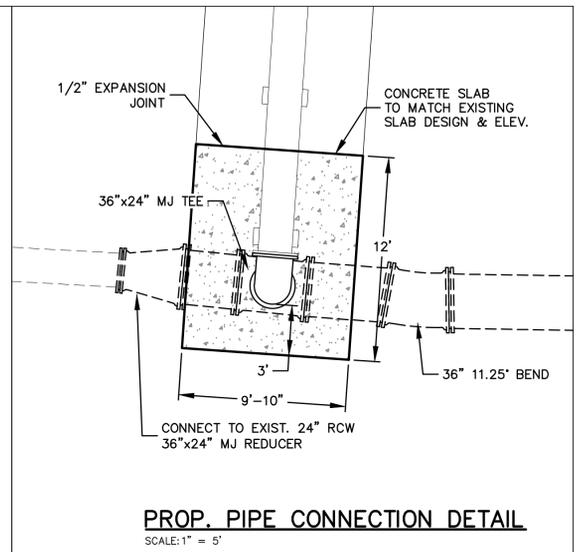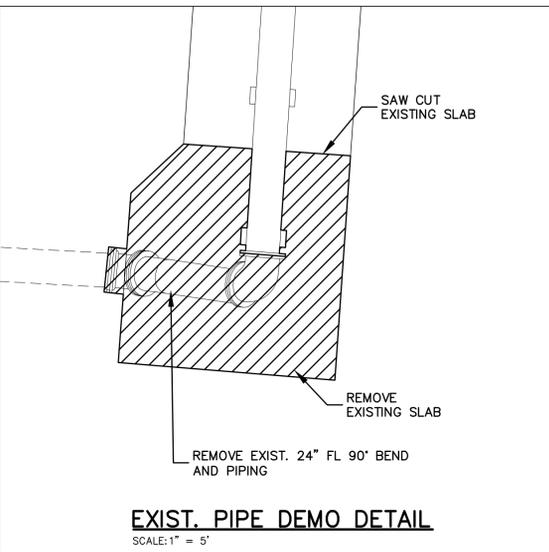

MATCHLINE SEE SHEET C-0.15

MATCHLINE SEE SHEET C-0.21

REV. NO.	DESCRIPTIONS	DATE

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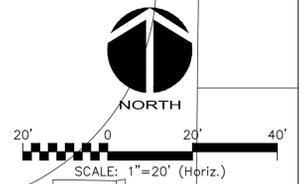
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YARD PIPING No. 1


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CHECKED: JSL		
PROJ. MGR: MSL		
STATUS: ISSUE FOR BID		REVISION

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MATCHLINE SEE SHEET C-0.15



NOTE:
ALL BURIED PIPE, FITTINGS AND VALVES SHALL HAVE RESTRAINED JOINTS.

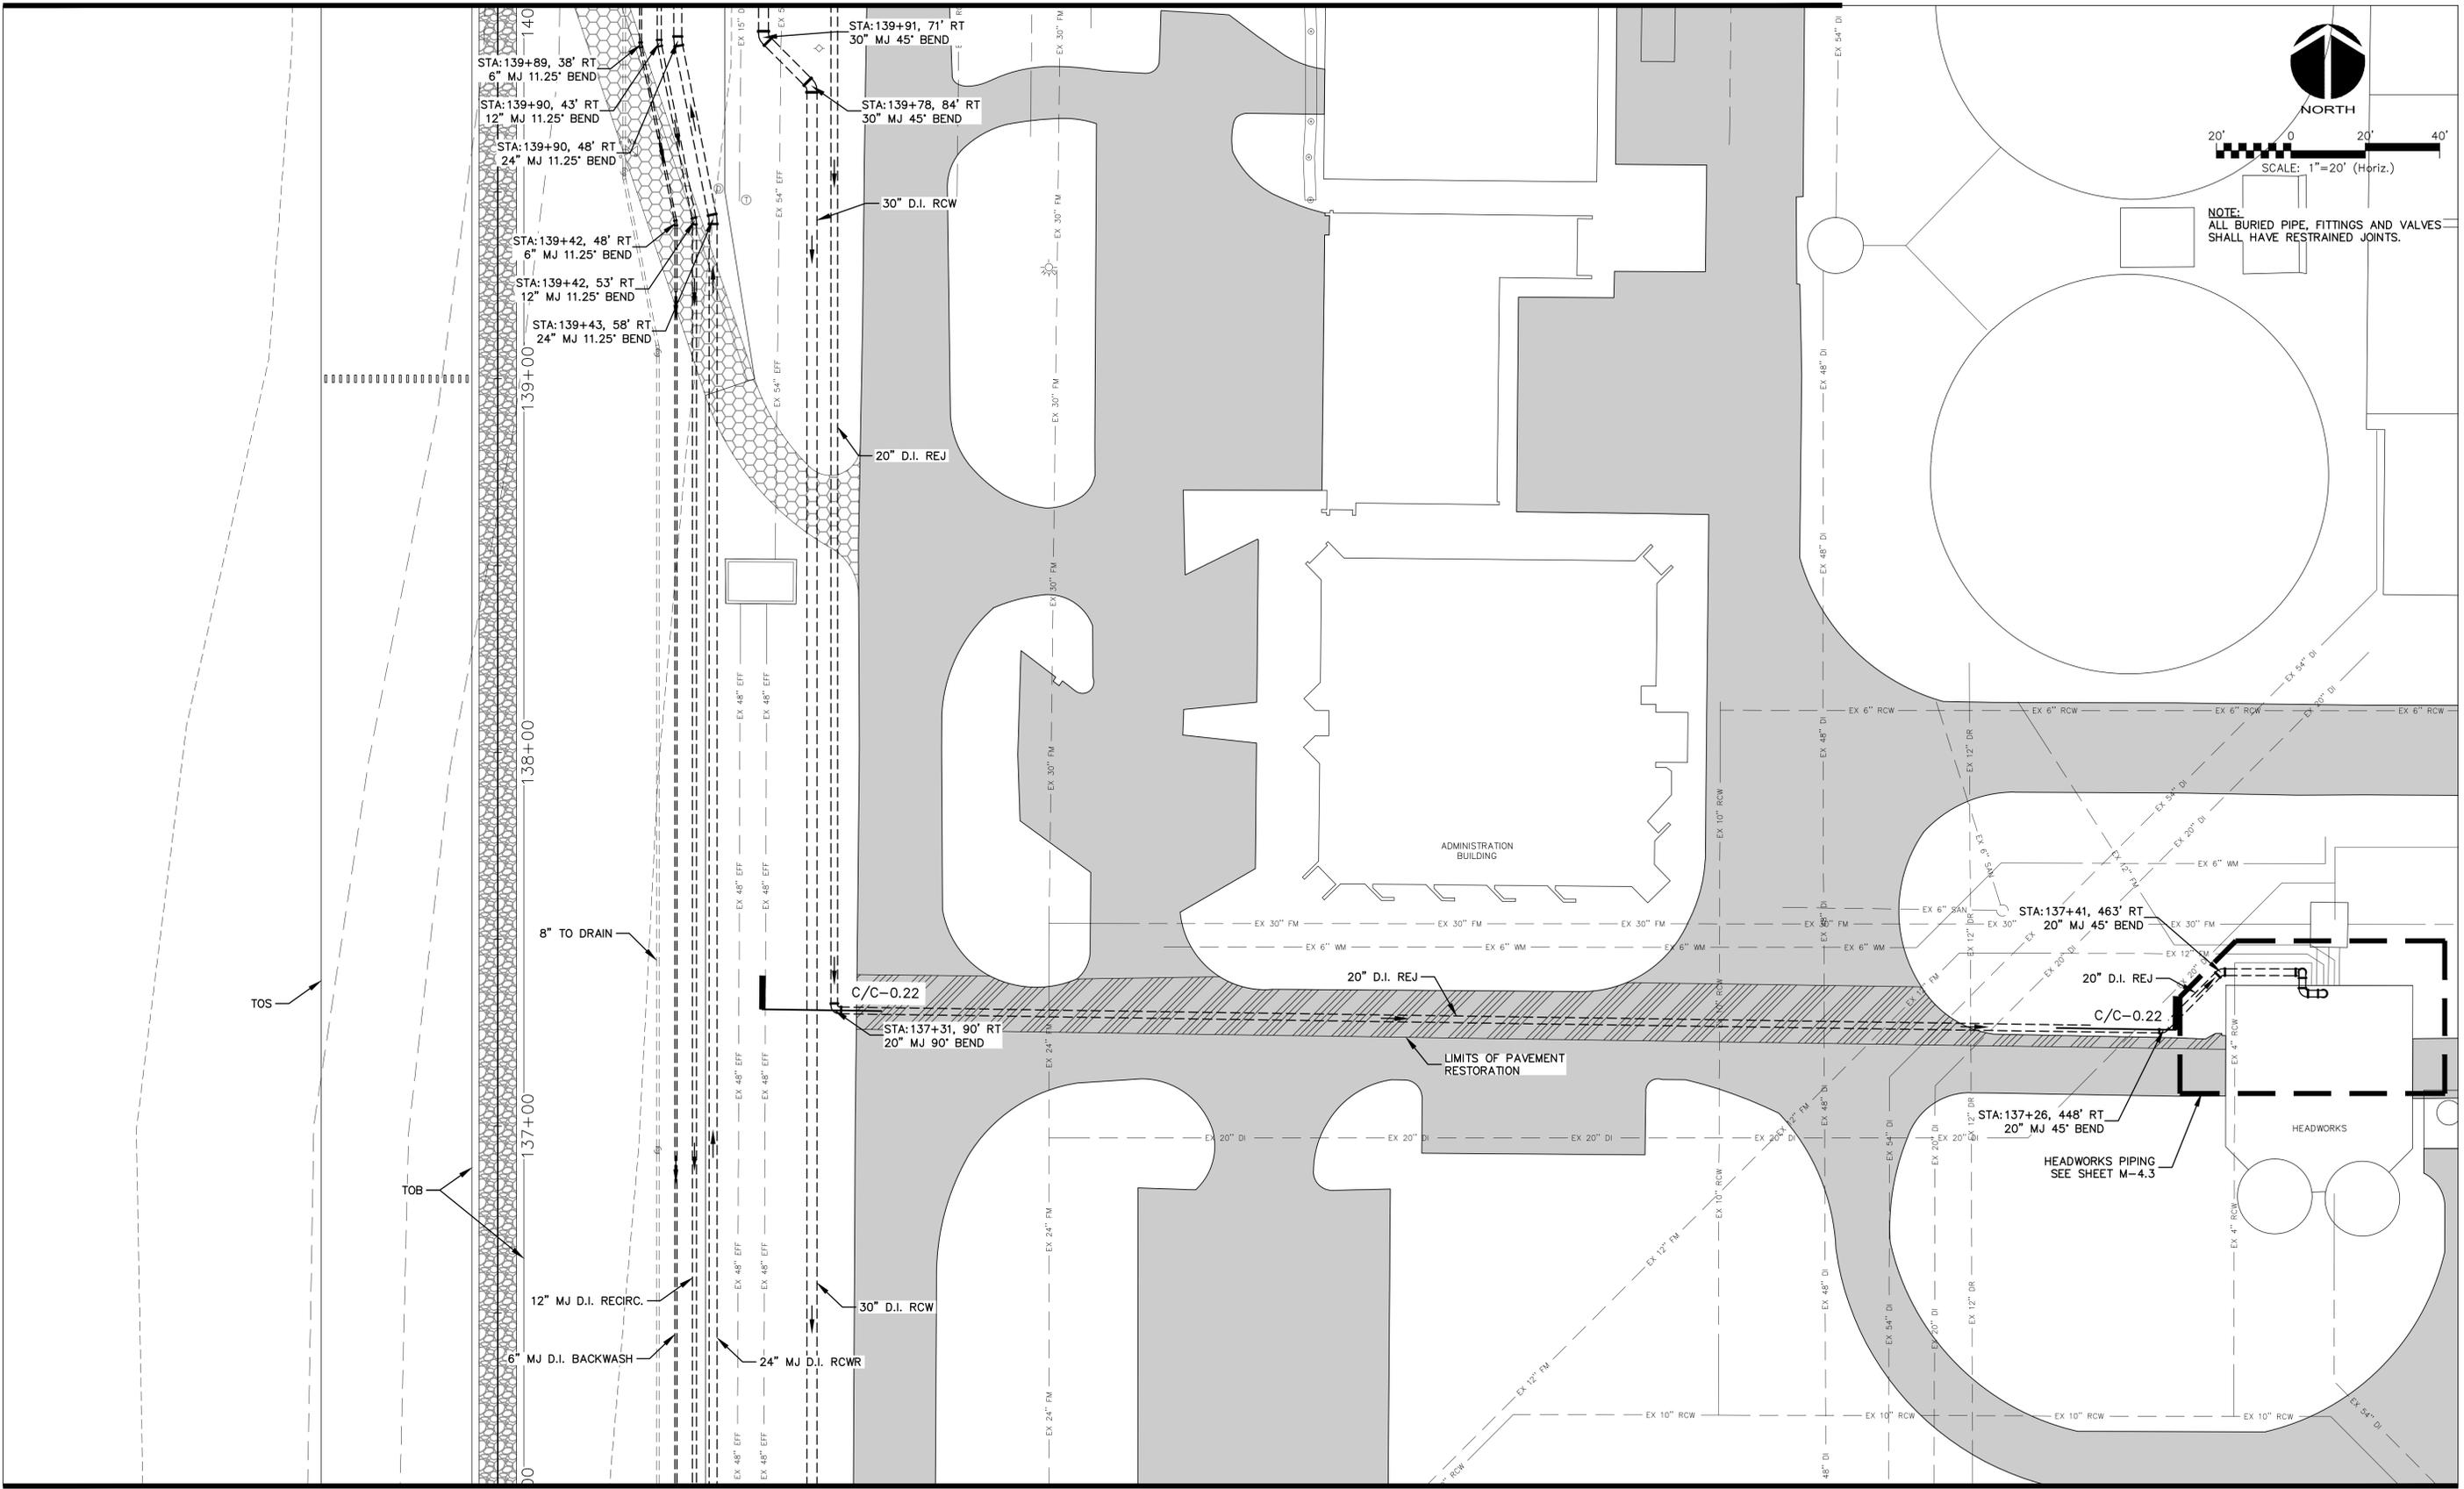

MATCHLINE SEE SHEET C-0.17

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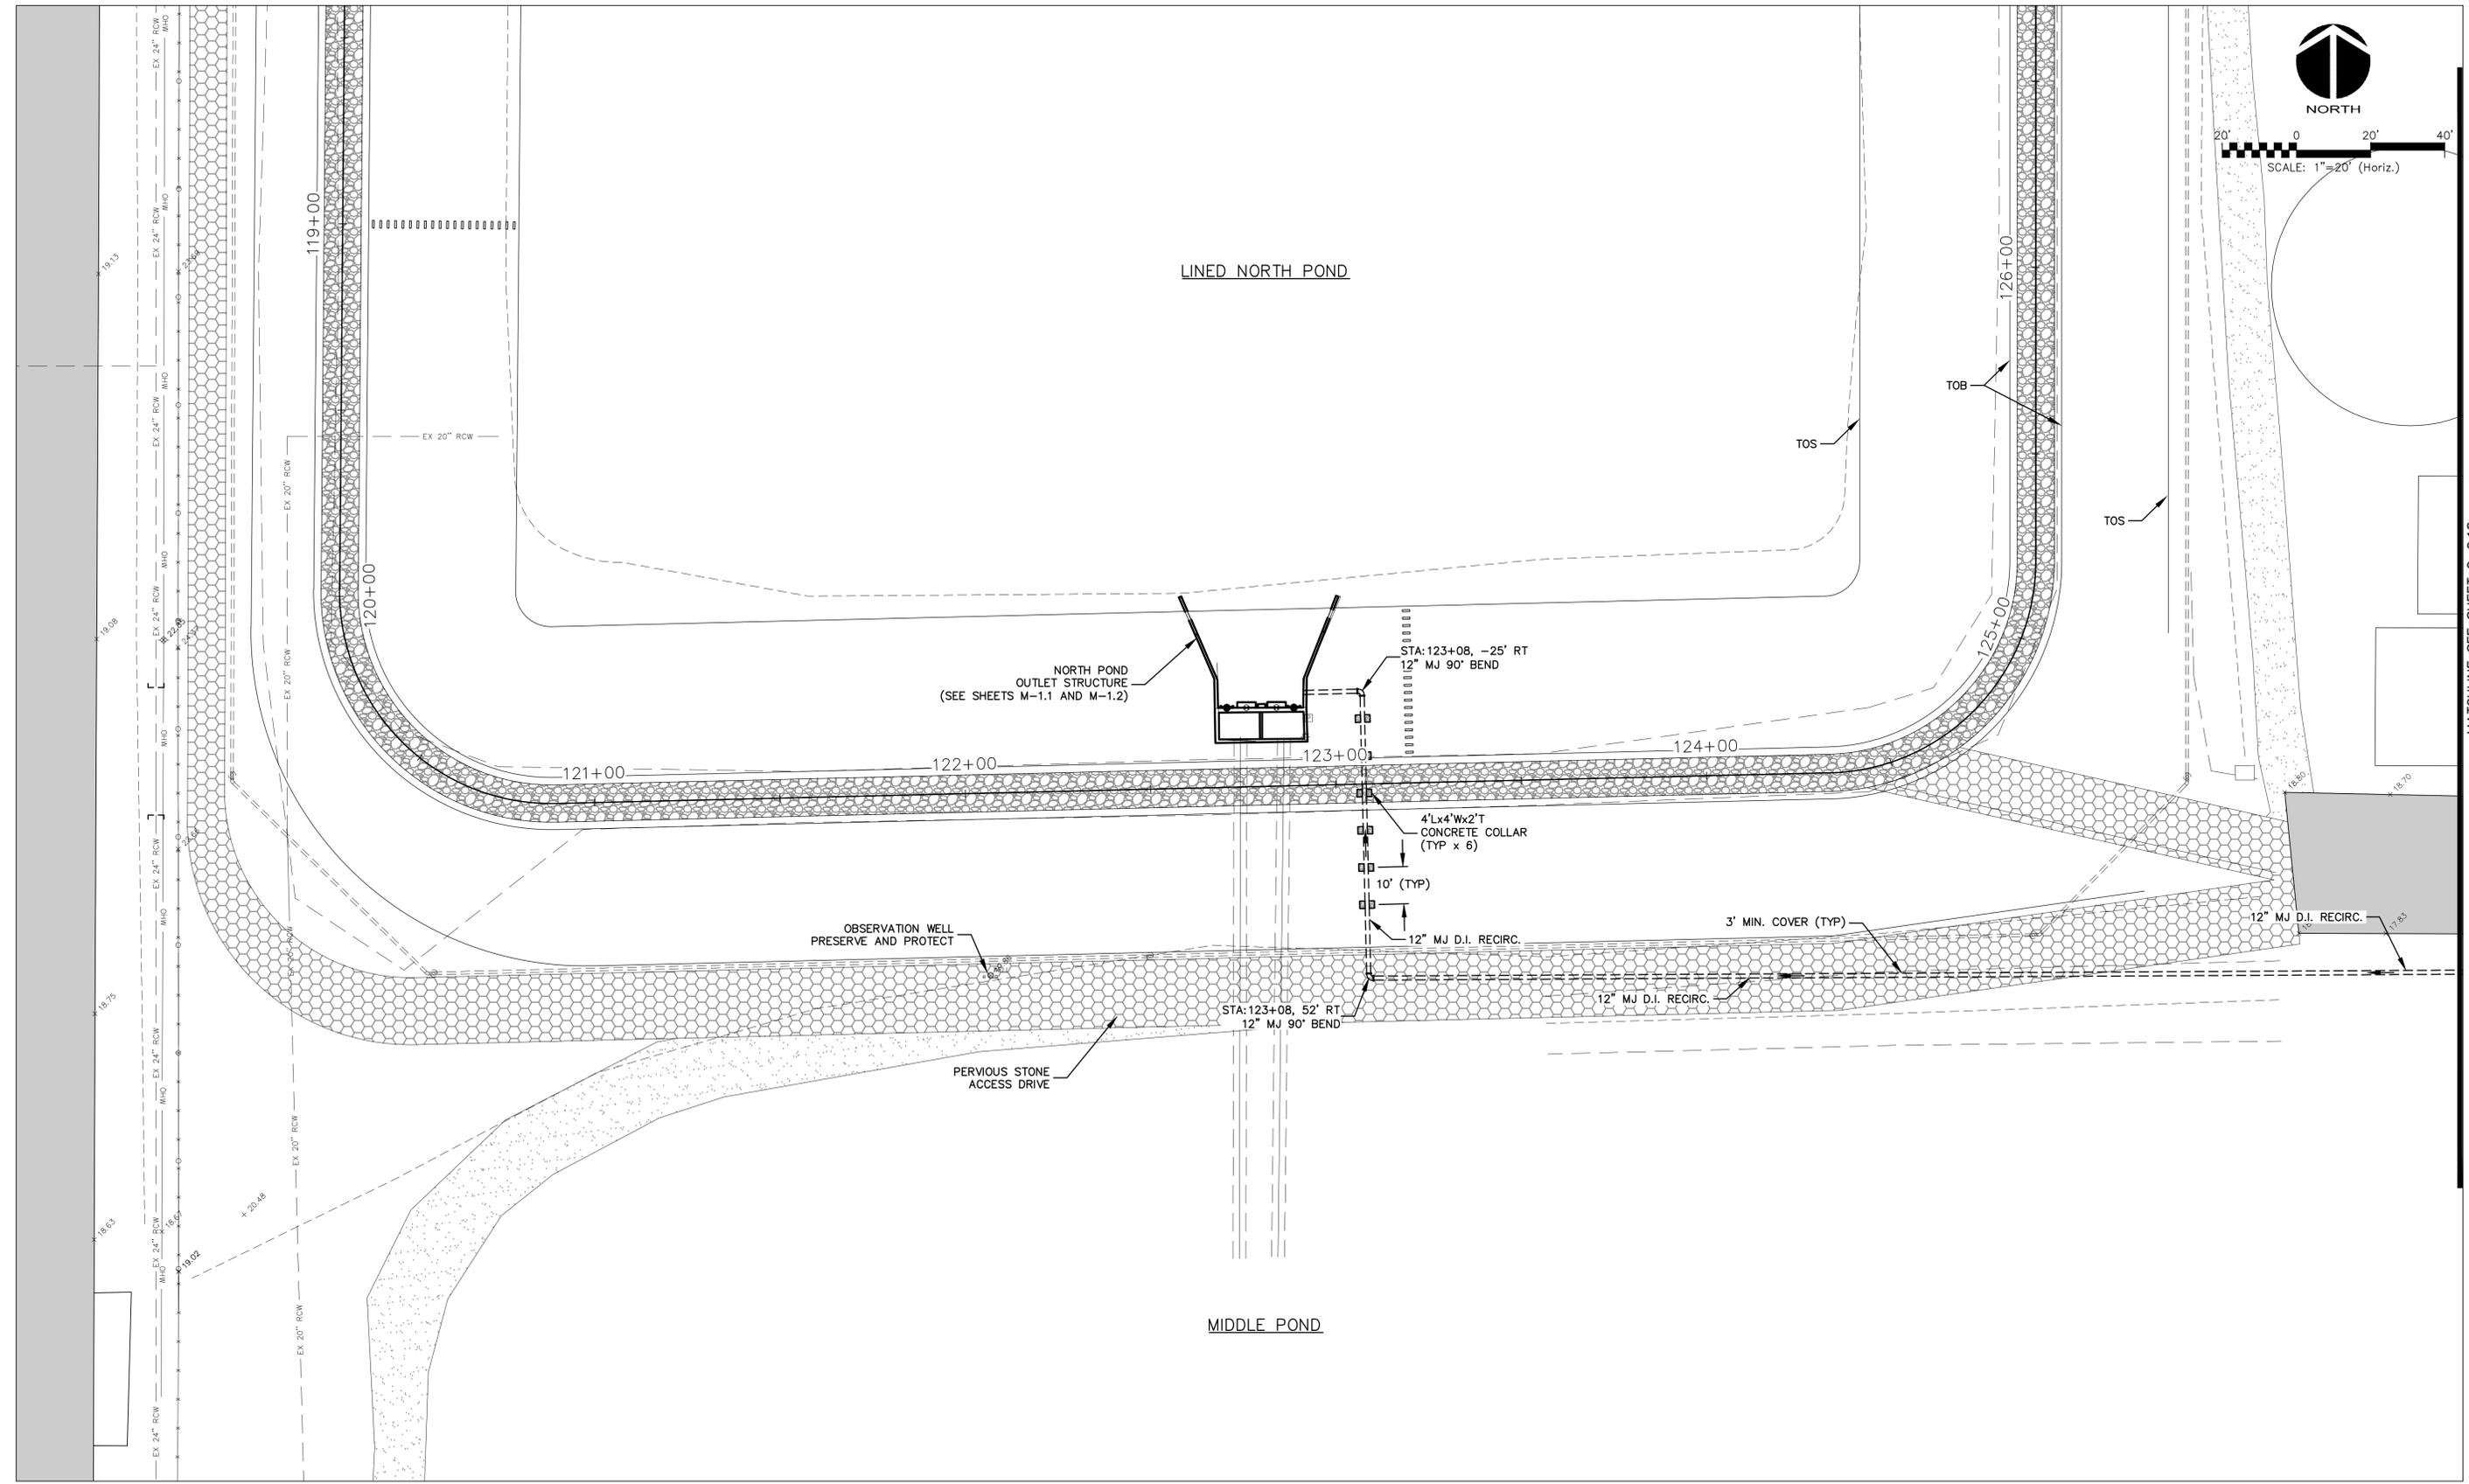
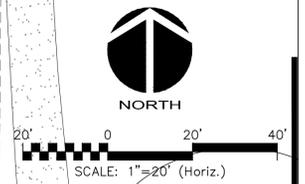


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YARD PIPING No. 3

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MCE PROJ. # 1024-0147	DESIGNED: MSL	CHECKED: JSL
PROJ. MGR. MSL	VERTICAL: NA	REVISION: ISSUE FOR BID



MATCHLINE SEE SHEET C-0.18

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YARD PIPING No. 6


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DRAWN	BNF
DESIGNED	MSL
CHECKED	JSL
PROJ. MGR.	MSL
STATUS:	

SCALE
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VERTICAL: NA


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C-0.19

REVISION

ISSUE FOR BID

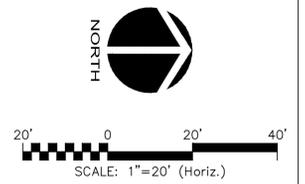

NOTE:
ALL BURIED PIPE, FITTINGS AND VALVES SHALL HAVE RESTRAINED JOINTS.

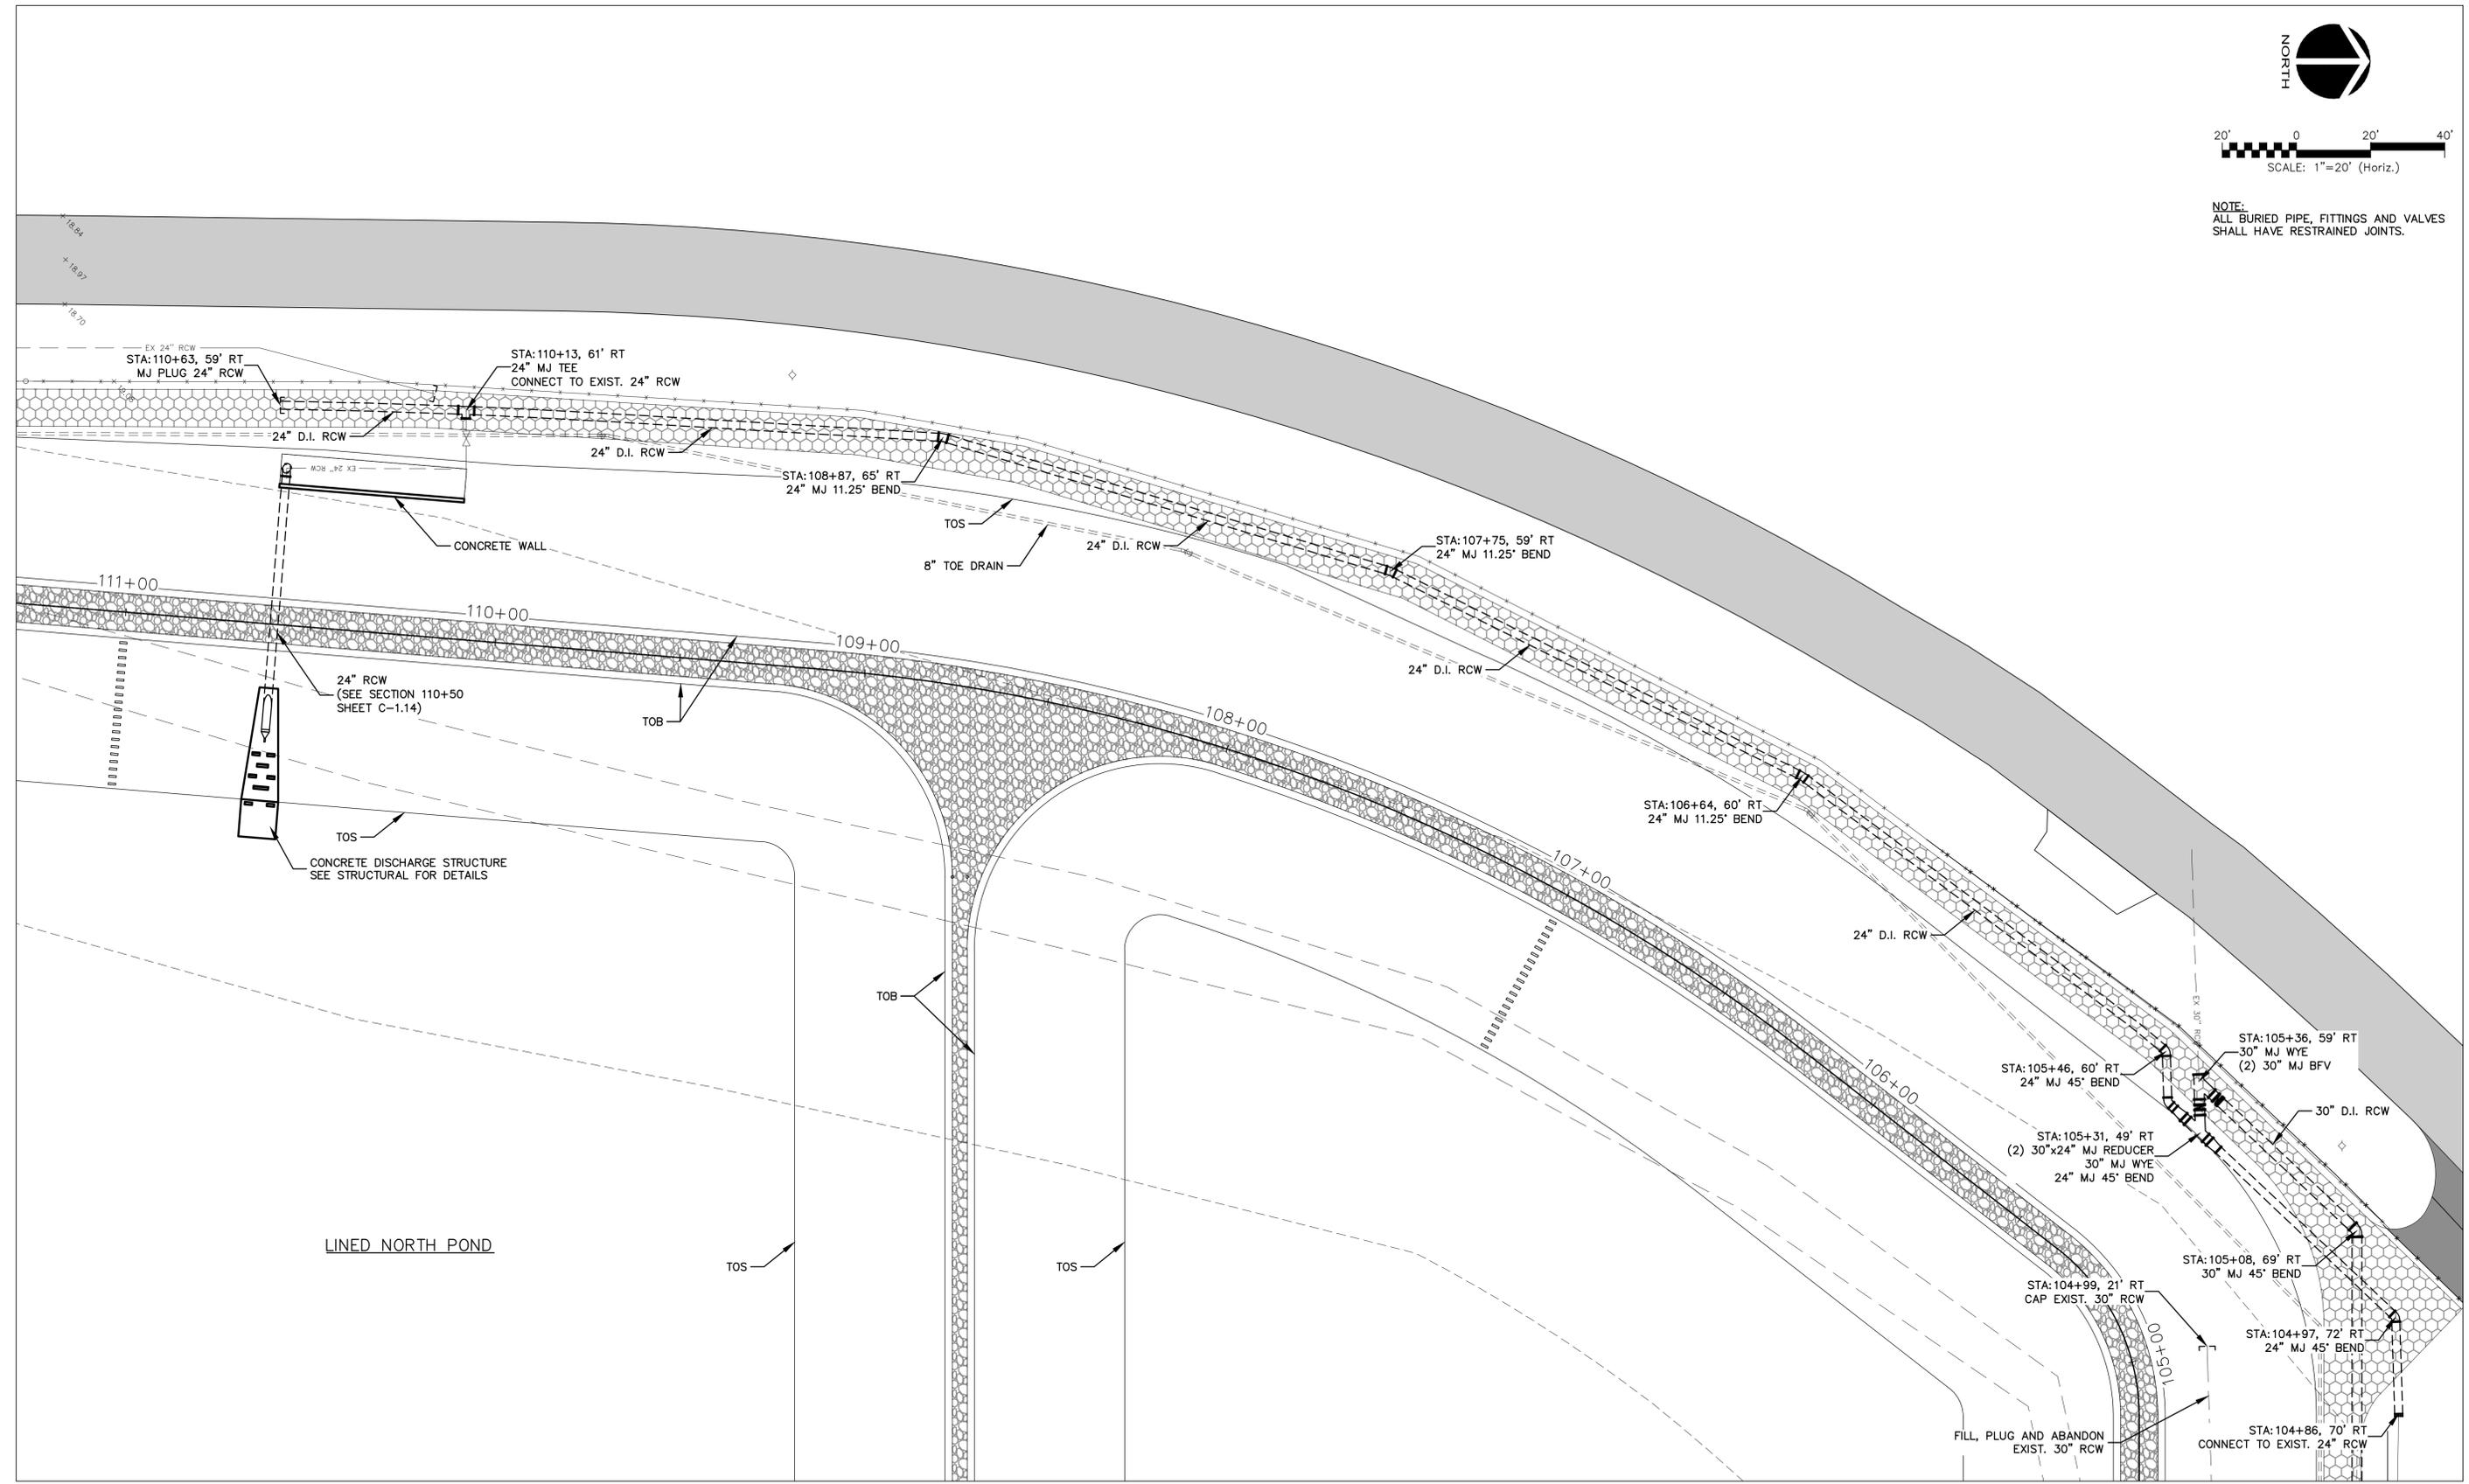

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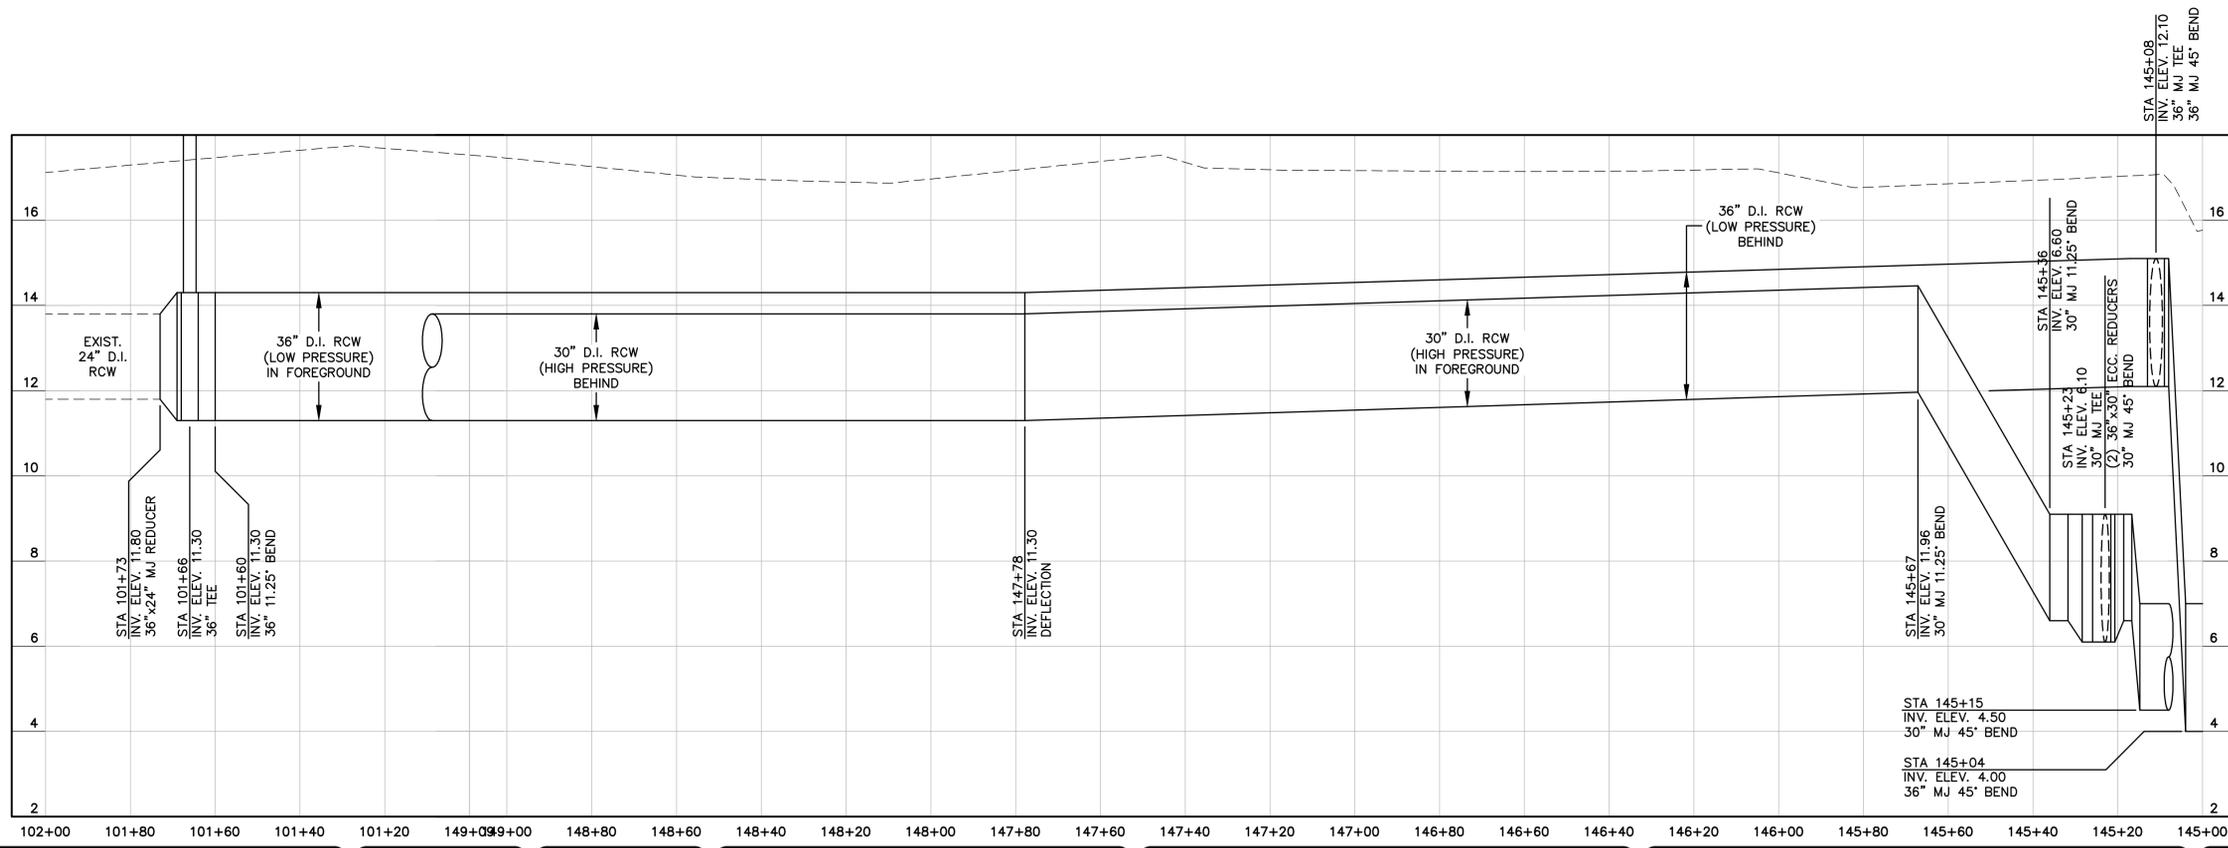
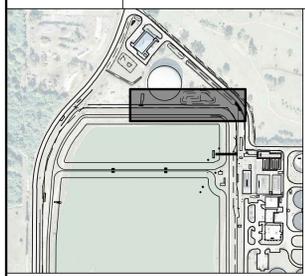
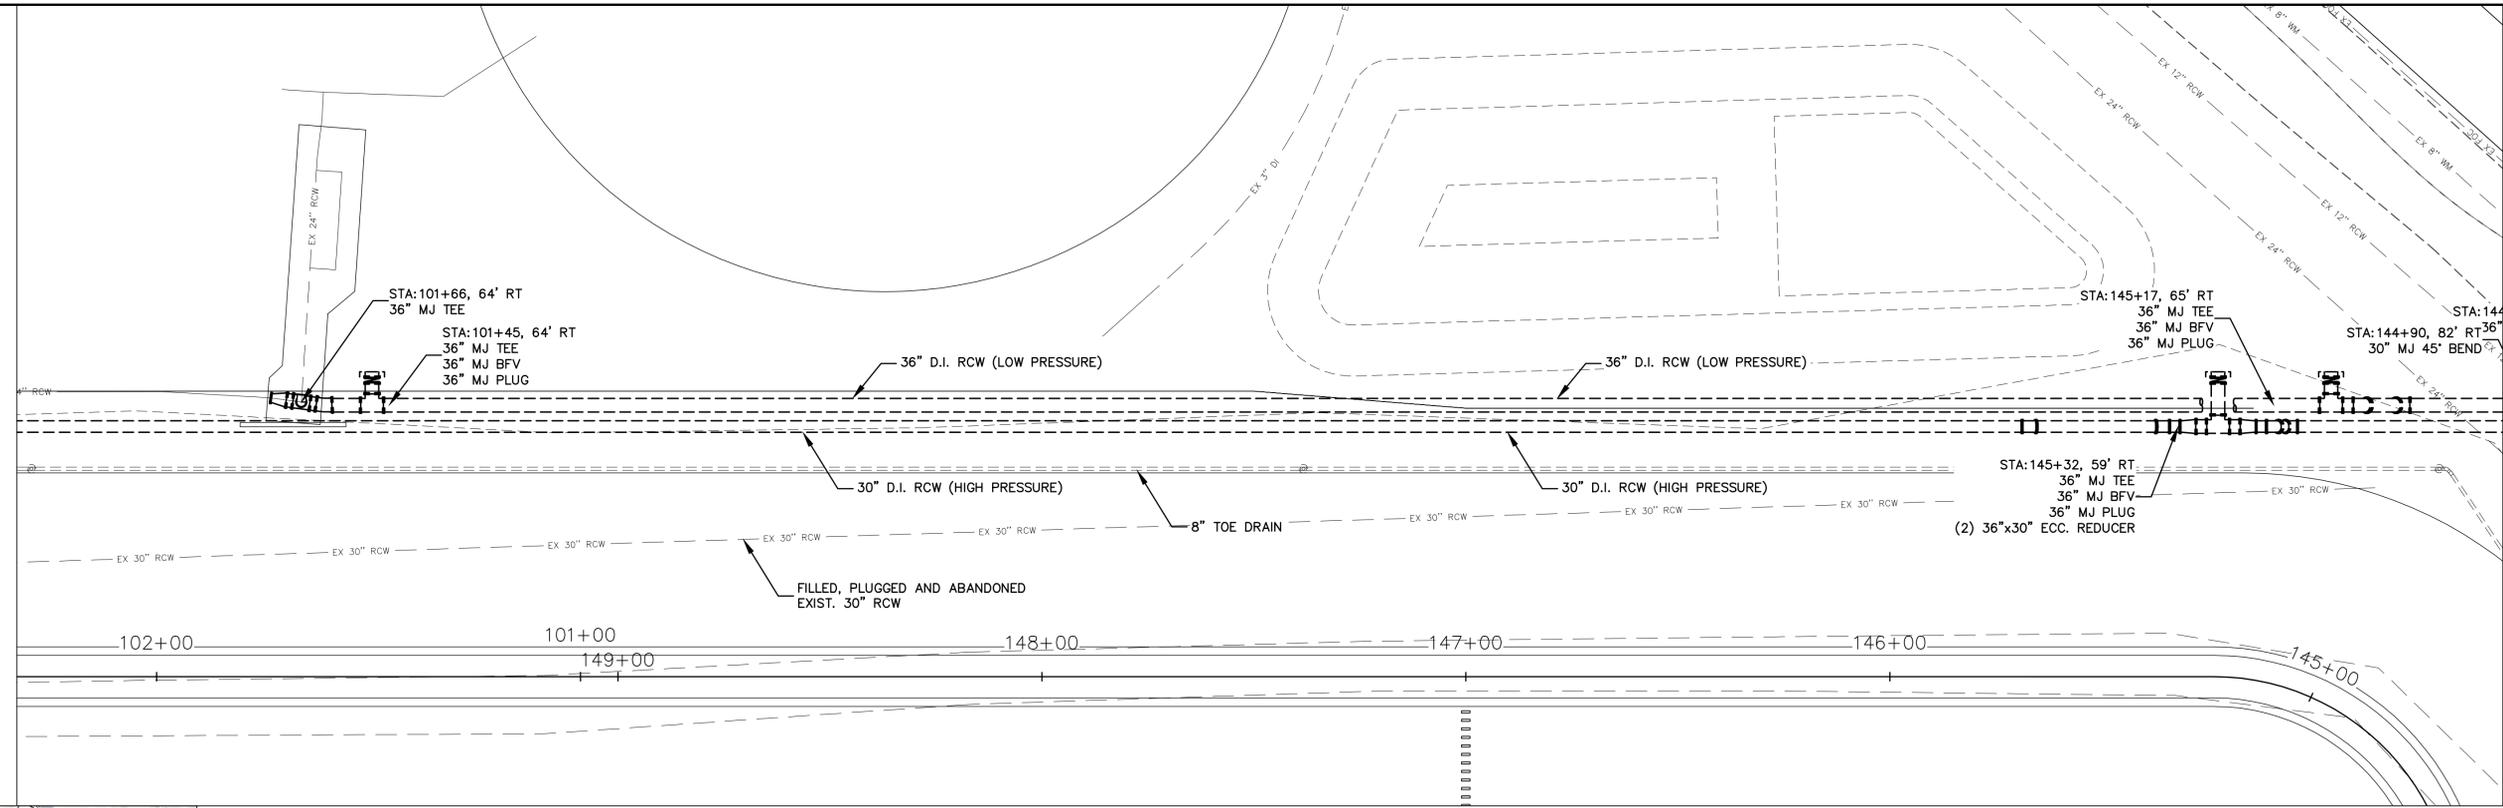
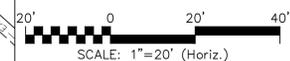
DATE:	FEBRUARY 2012
MCE PROJ. #	1024-0147
DRAWN	BN
DESIGNED	MSL
CHECKED	JSL
PROJ. MGR.	MSL

SCALE	DRAWING NUMBER
HORIZONTAL: 1" = 20'	C-0.20
VERTICAL: NA	REVISION

STATUS: **ISSUE FOR BID**



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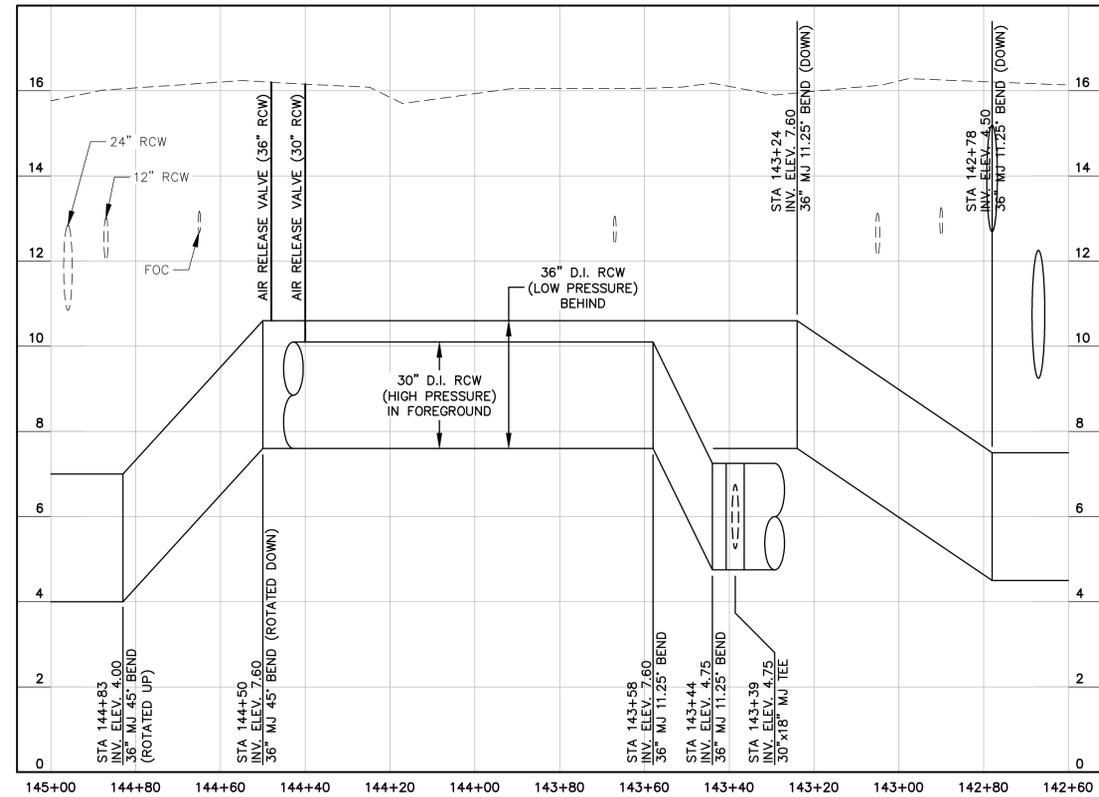
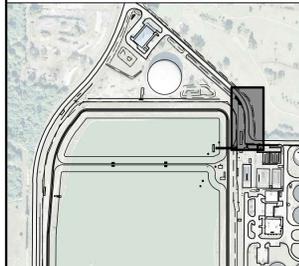
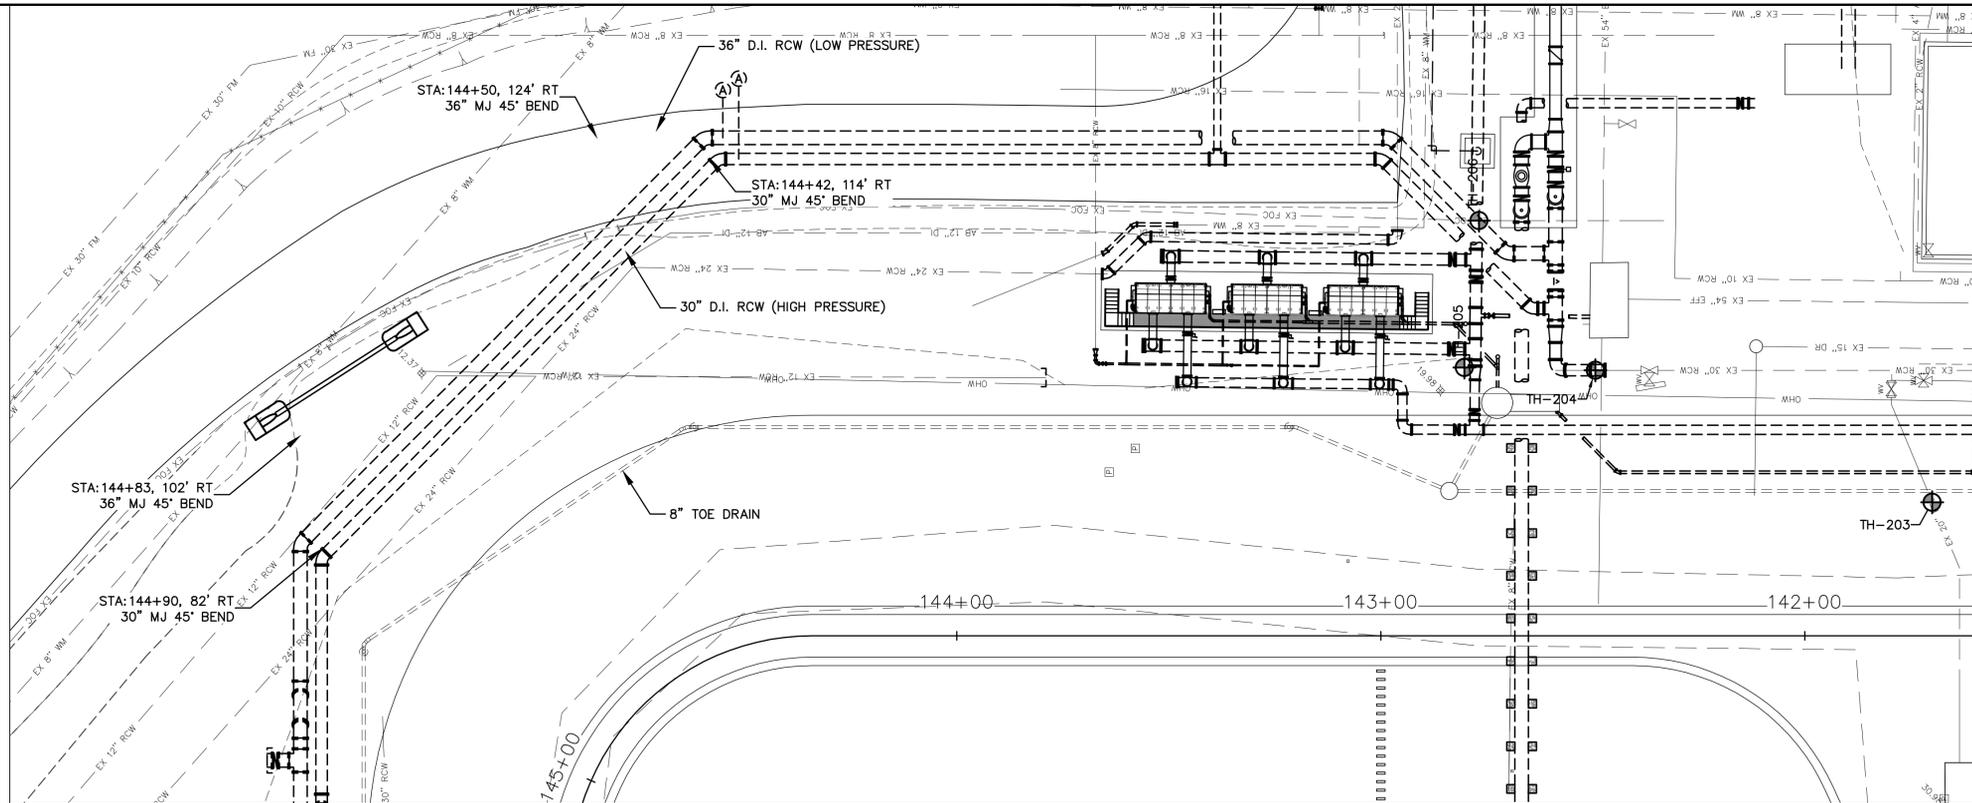
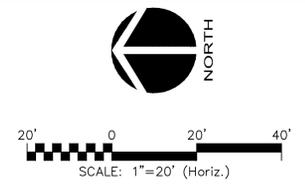
MANATEE COUNTY, FLORIDA

SWRF LAKE FILTRATION AND NORTH POND IMPROVEMENTS

UTILITY PLAN AND PROFILE No. 1

DATE: FEBRUARY 2012	SCALE: HORIZONTAL: 1" = 20'	DRAWING NUMBER: C-0.23
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DESIGNED: MSL		
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STATUS: ISSUE FOR BID		

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UTILITY PLAN AND PROFILE No. 2

DATE: FEBRUARY 2012
MCE PROJ. # 1024-0147
DRAWN: BFN
DESIGNED: MSL
CHECKED: JSL
PROJ. MGR: MSL





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VERTICAL:
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DRAWING NUMBER
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STATUS: ISSUE FOR BID

REVISION

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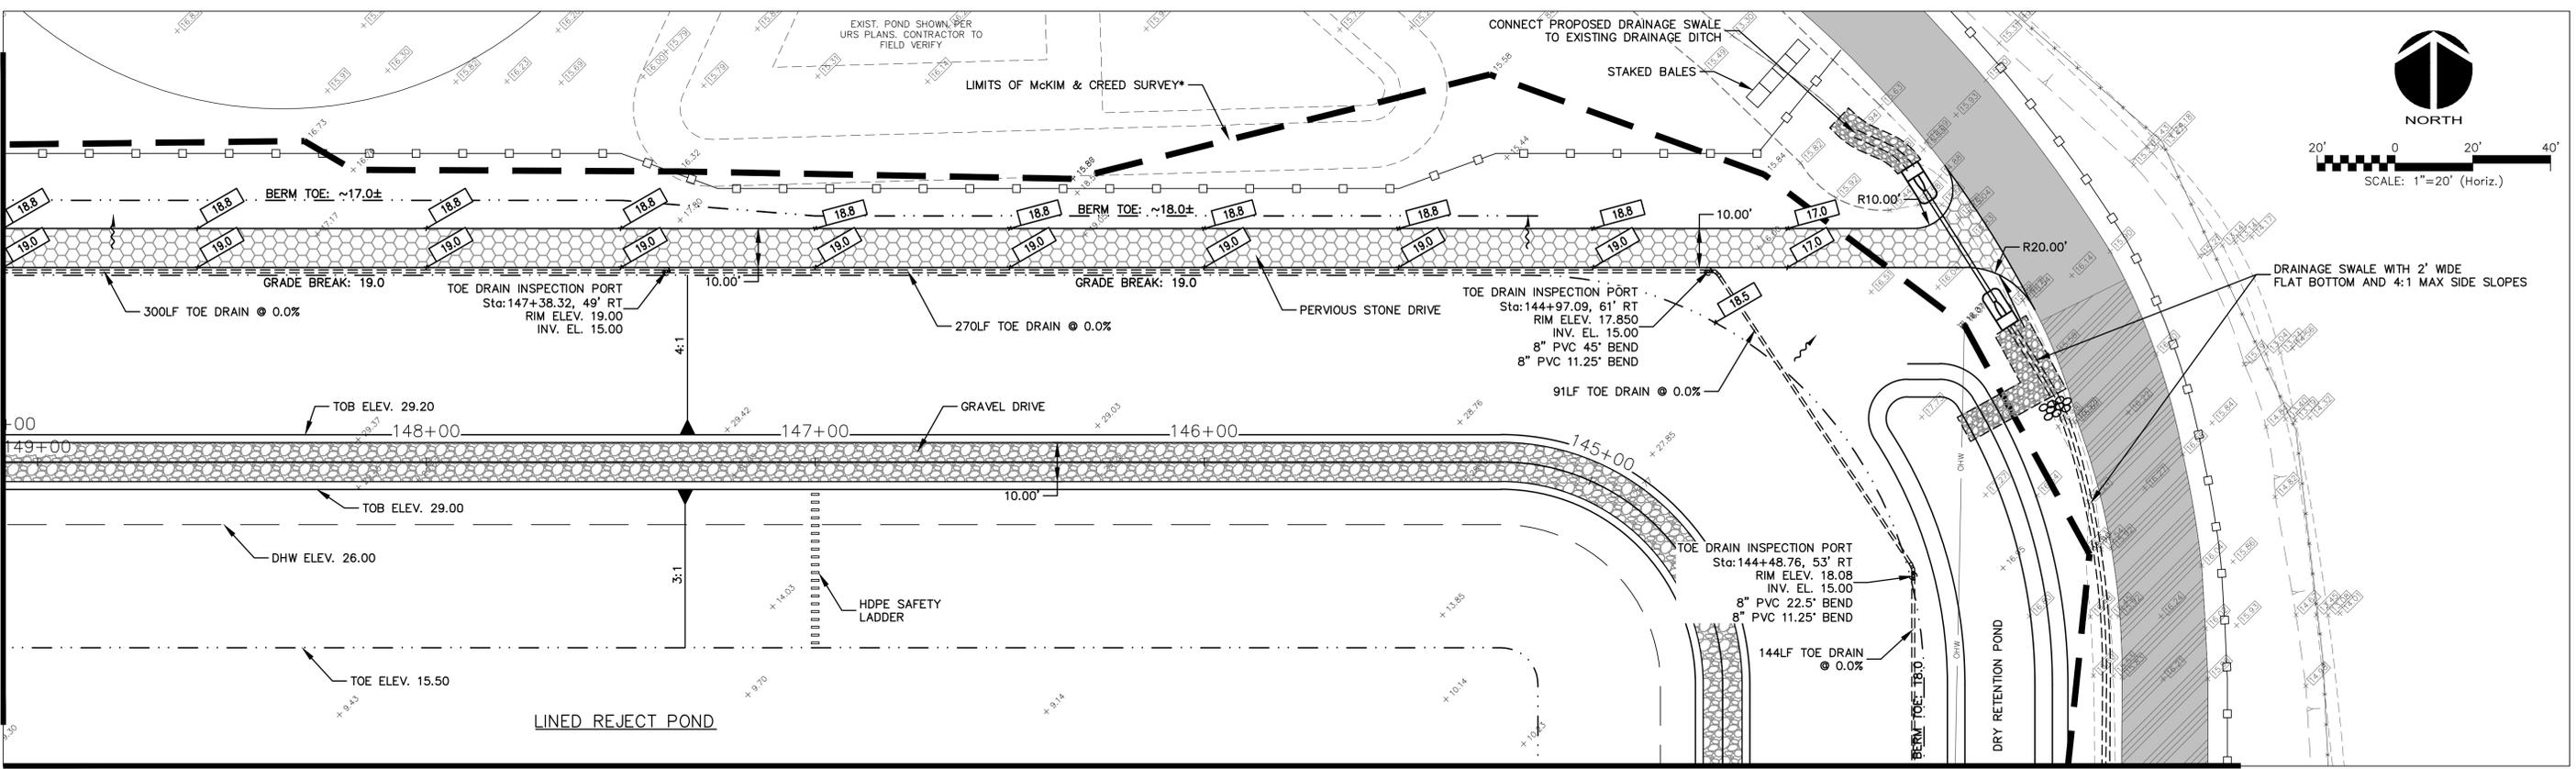
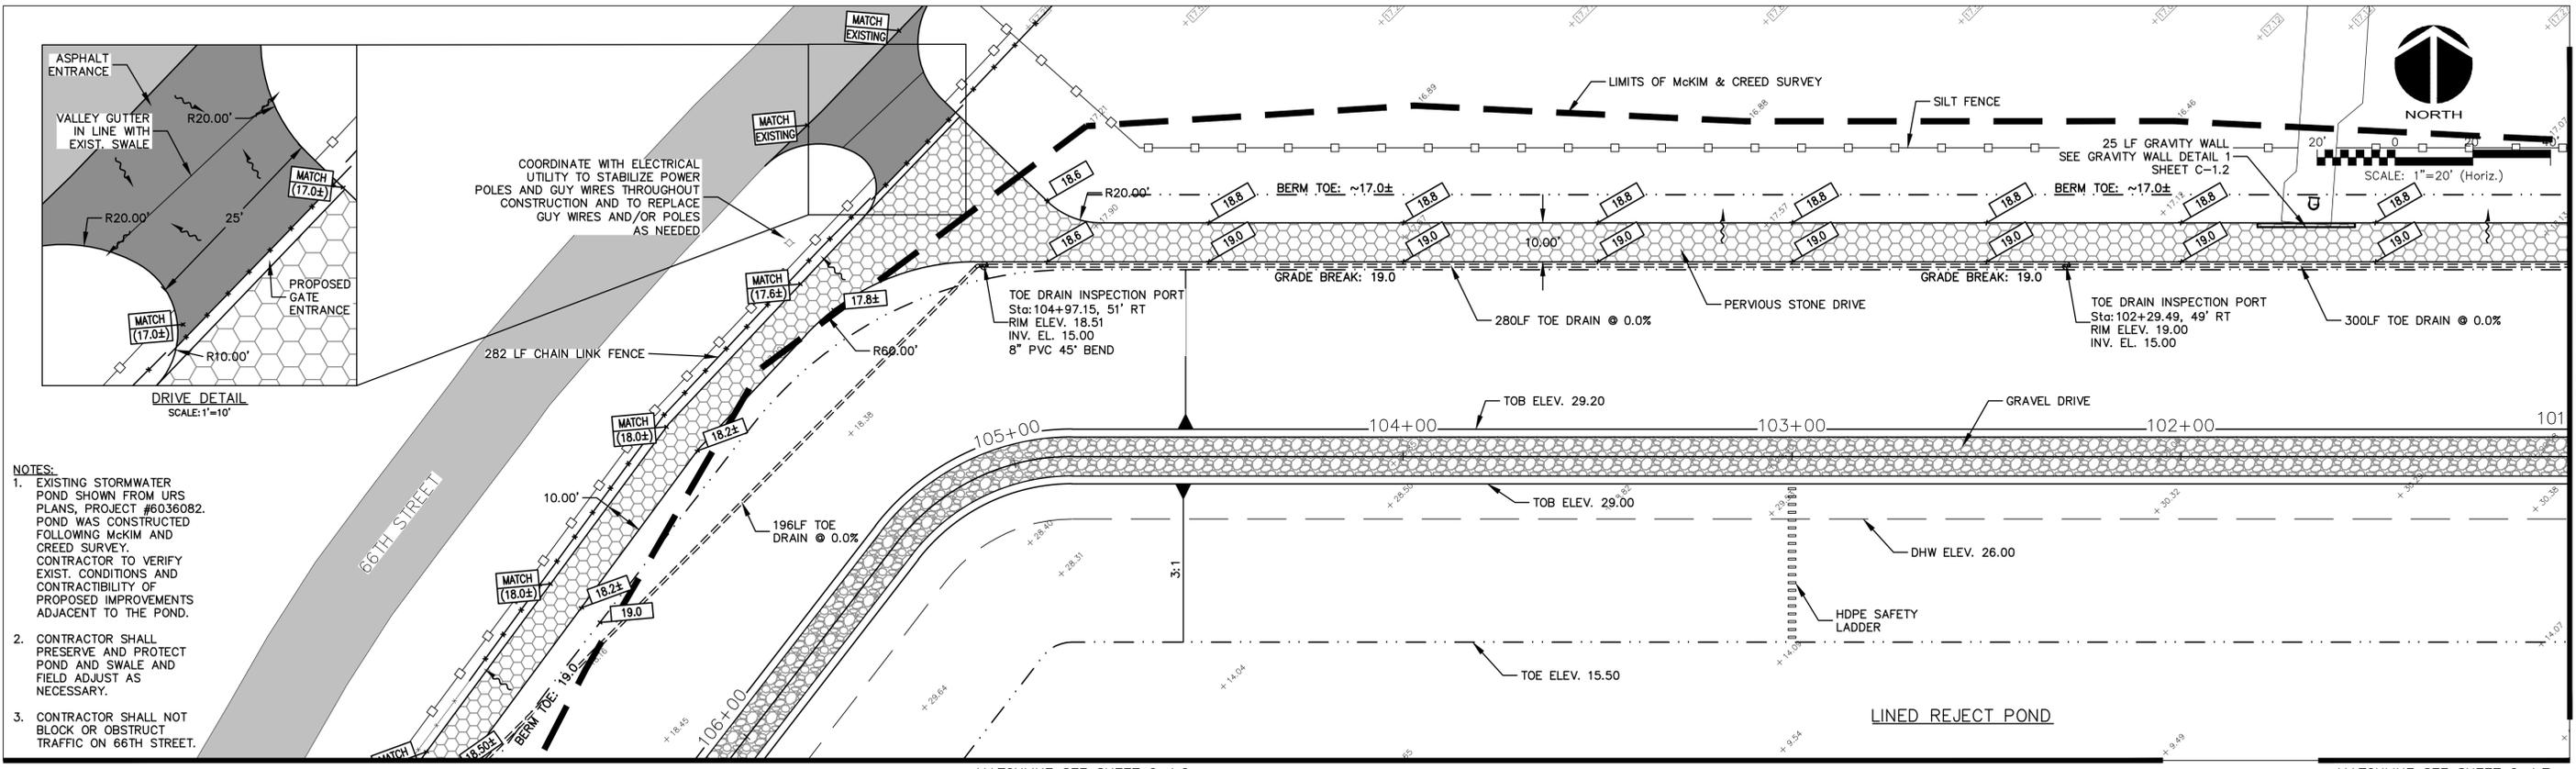
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DATE: FEBRUARY 2012
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CHECKED: JSL
PROJ. MGR. MSL

SCALE
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VERTICAL: 1" = 2'

DRAWING NUMBER
C-0.25

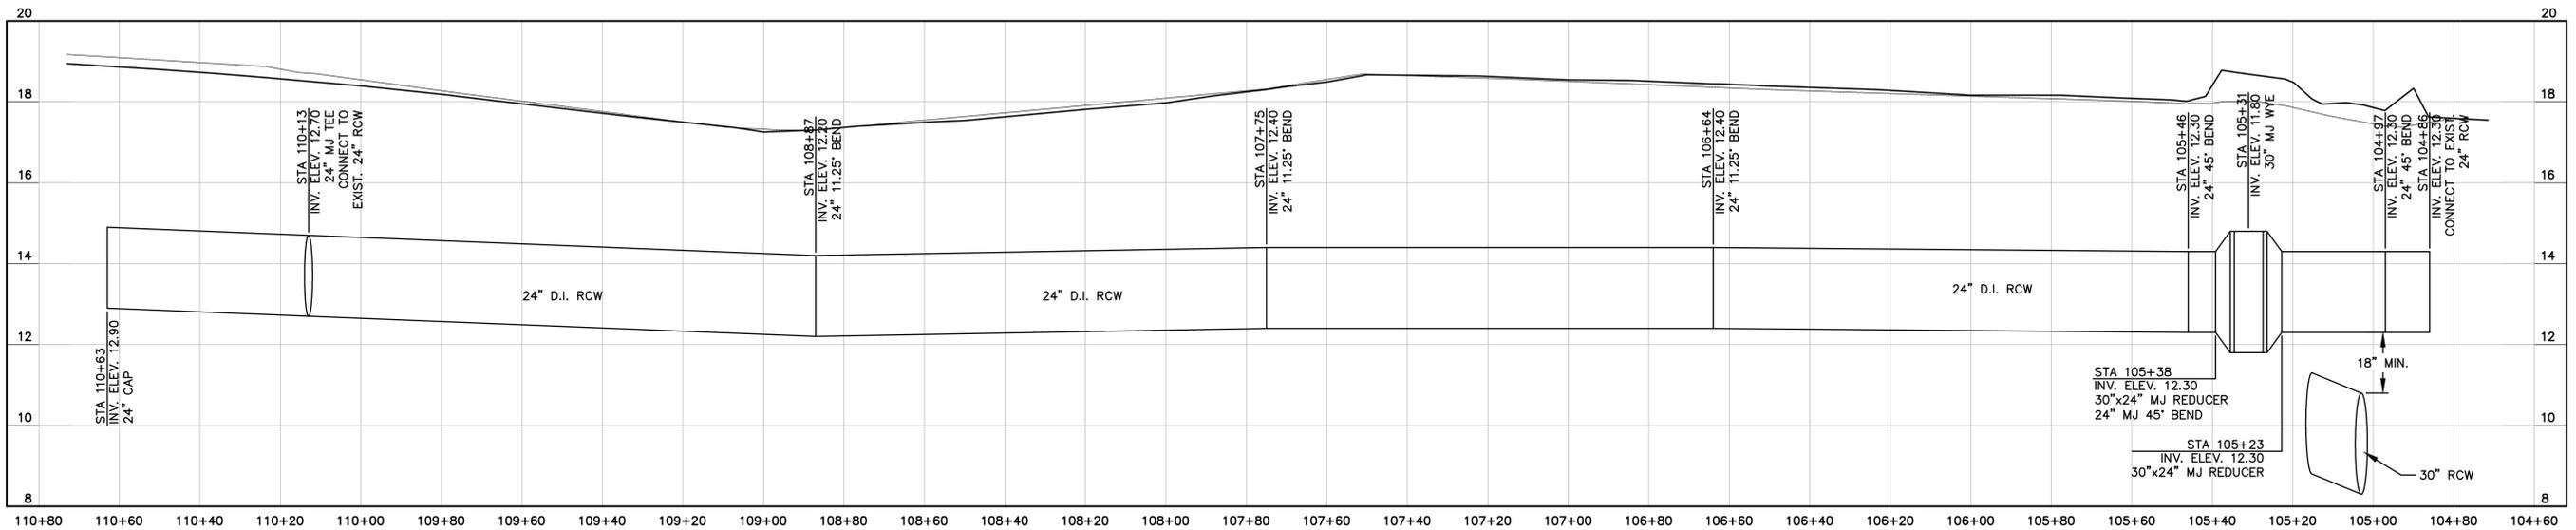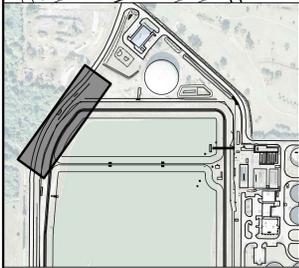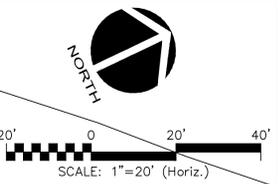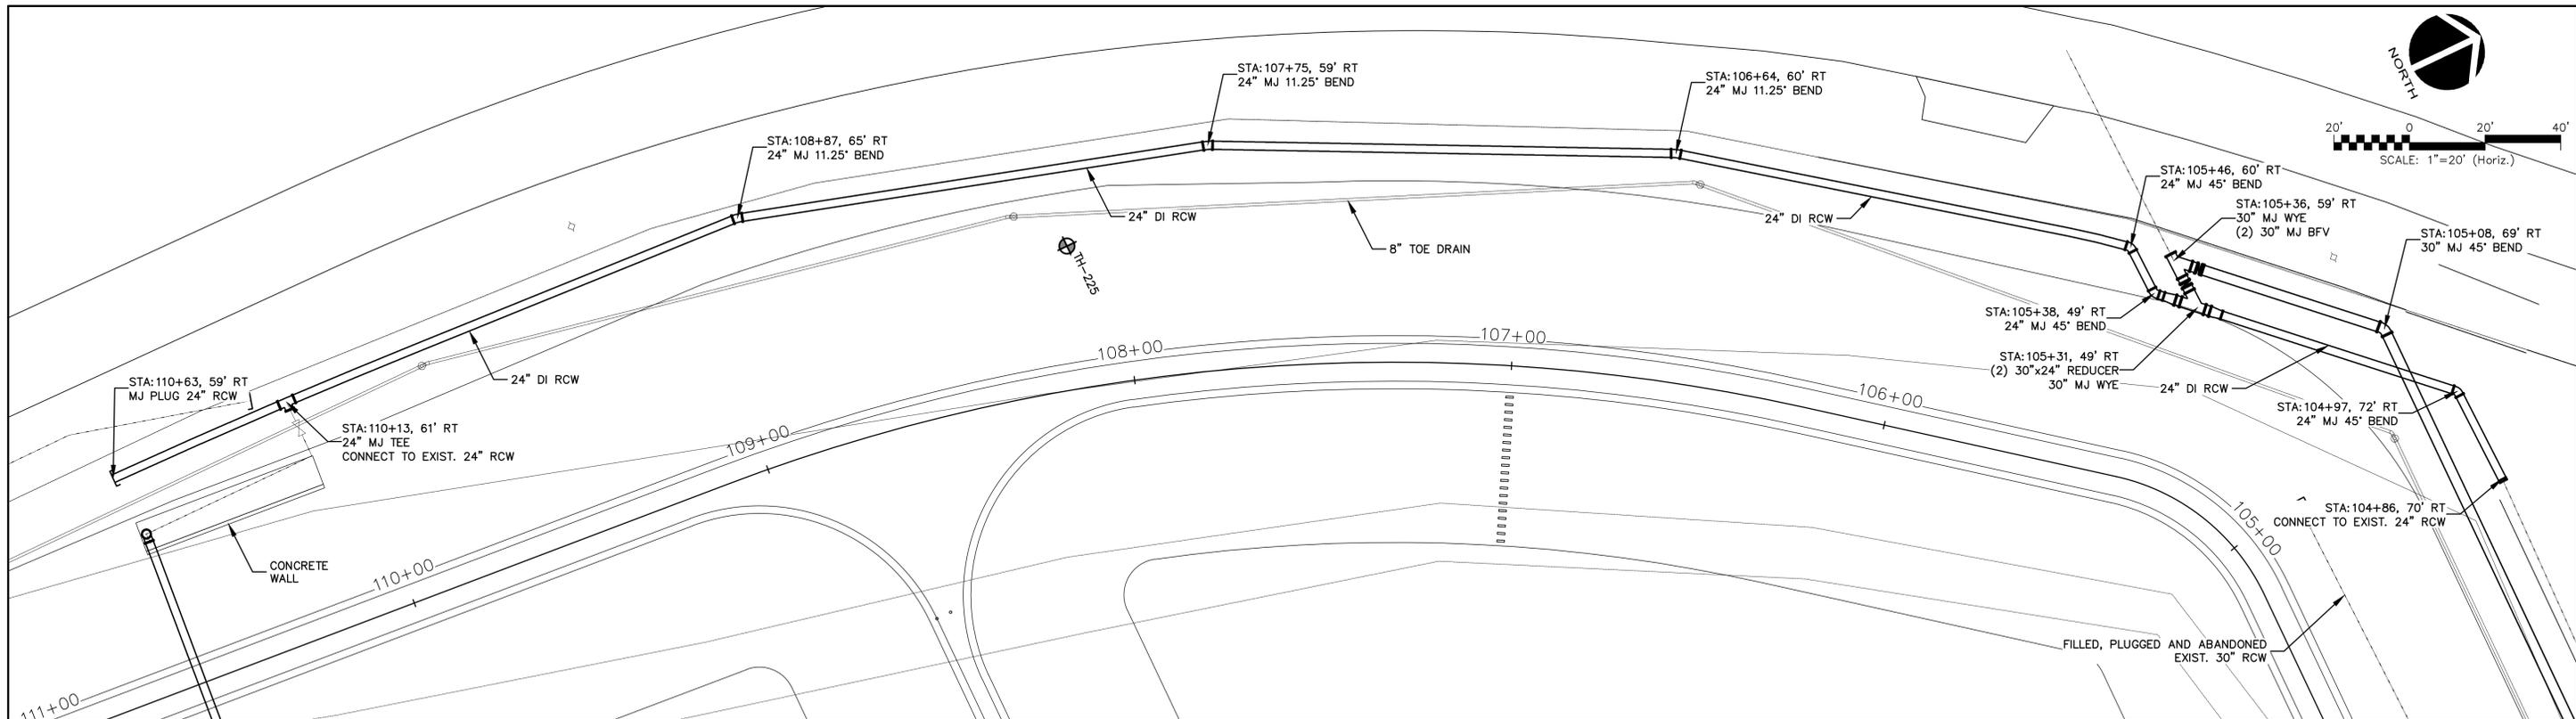STATUS: **ISSUE FOR BID**



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REVNO.	DESCRIPTIONS	DATE

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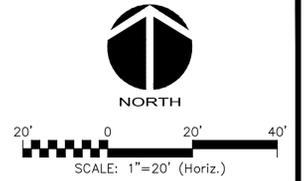
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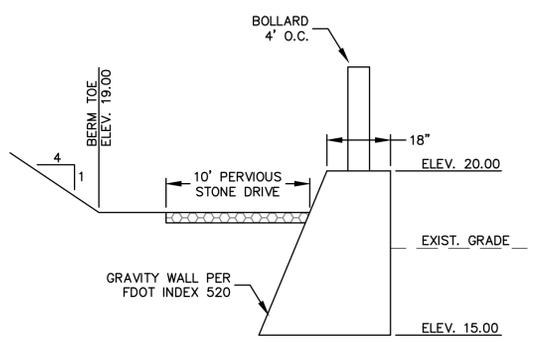
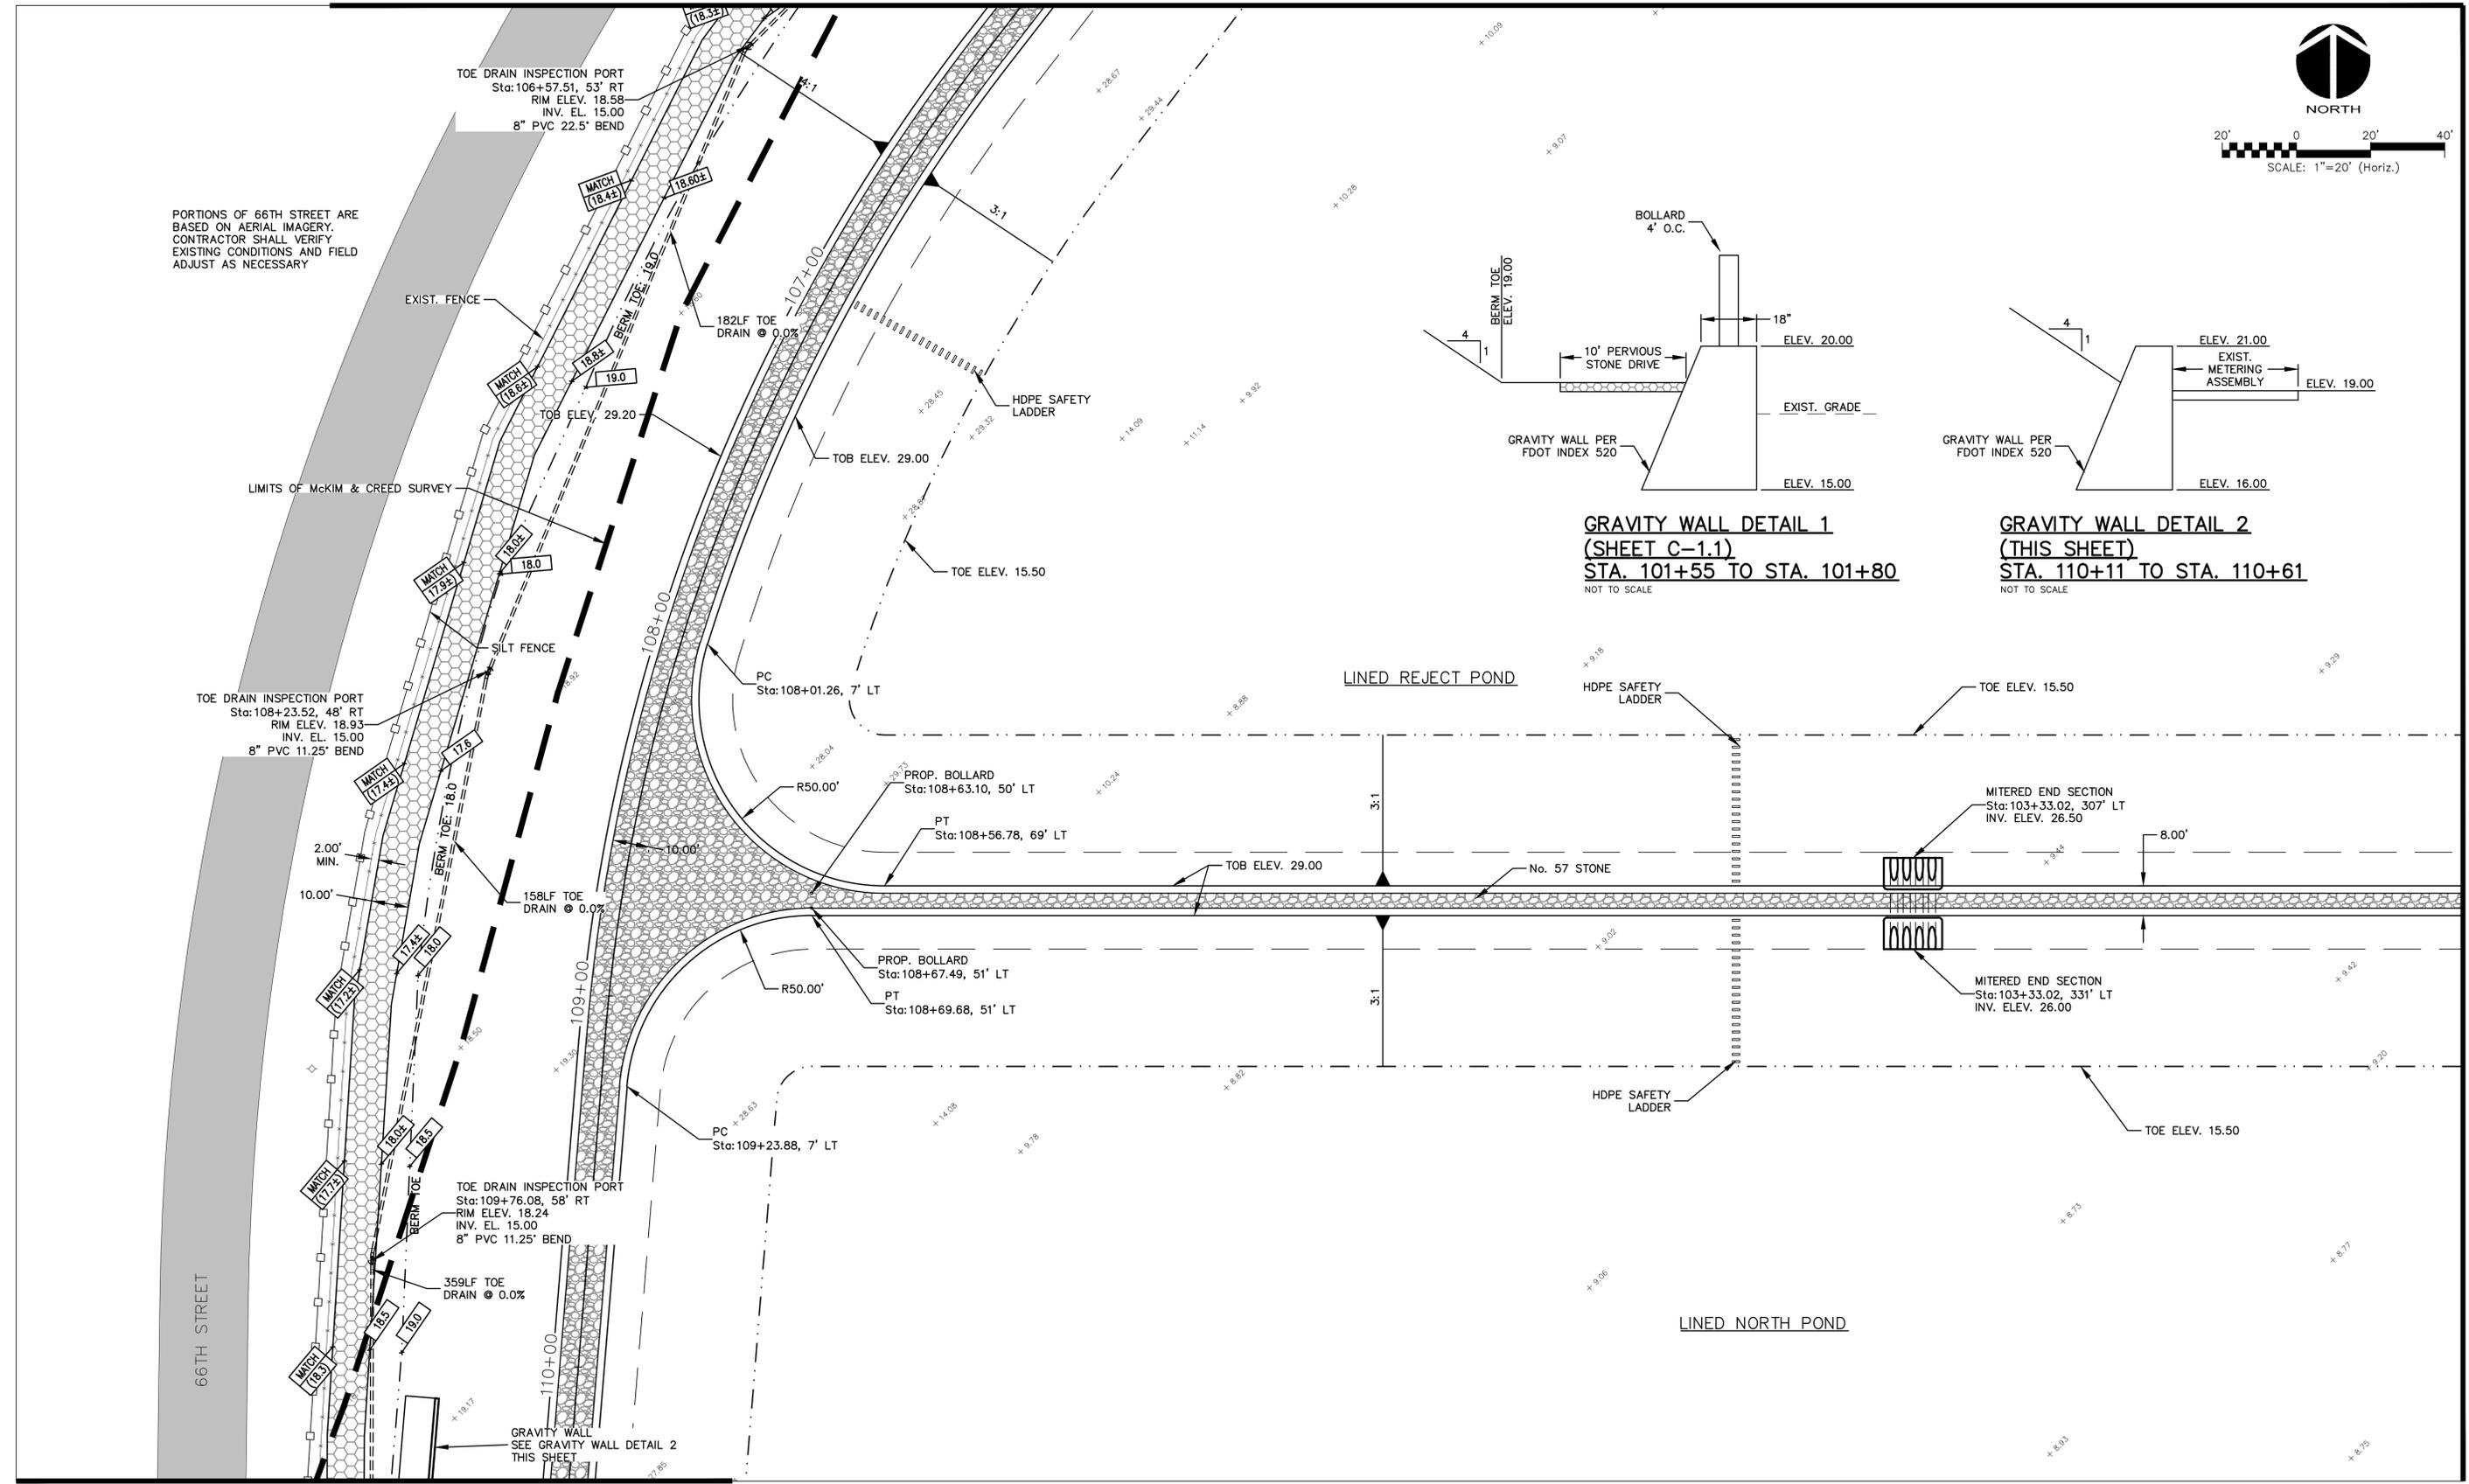
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DATE: FEBRUARY 2012	SCALE: HORIZONTAL: 1" = 20'	DRAWING NUMBER: C-1.1
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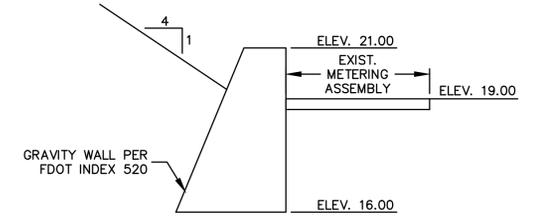
STATUS: **ISSUE FOR BID**



PORTIONS OF 66TH STREET ARE BASED ON AERIAL IMAGERY. CONTRACTOR SHALL VERIFY EXISTING CONDITIONS AND FIELD ADJUST AS NECESSARY



GRAVITY WALL DETAIL 1
(SHEET C-1.1)
STA. 101+55 TO STA. 101+80
NOT TO SCALE



GRAVITY WALL DETAIL 2
(THIS SHEET)
STA. 110+11 TO STA. 110+61
NOT TO SCALE

MATCHLINE SEE SHEET C-1.3

MATCHLINE SEE SHEET C-1.7

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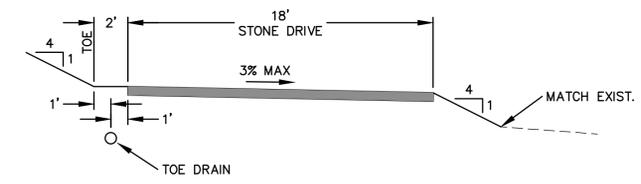
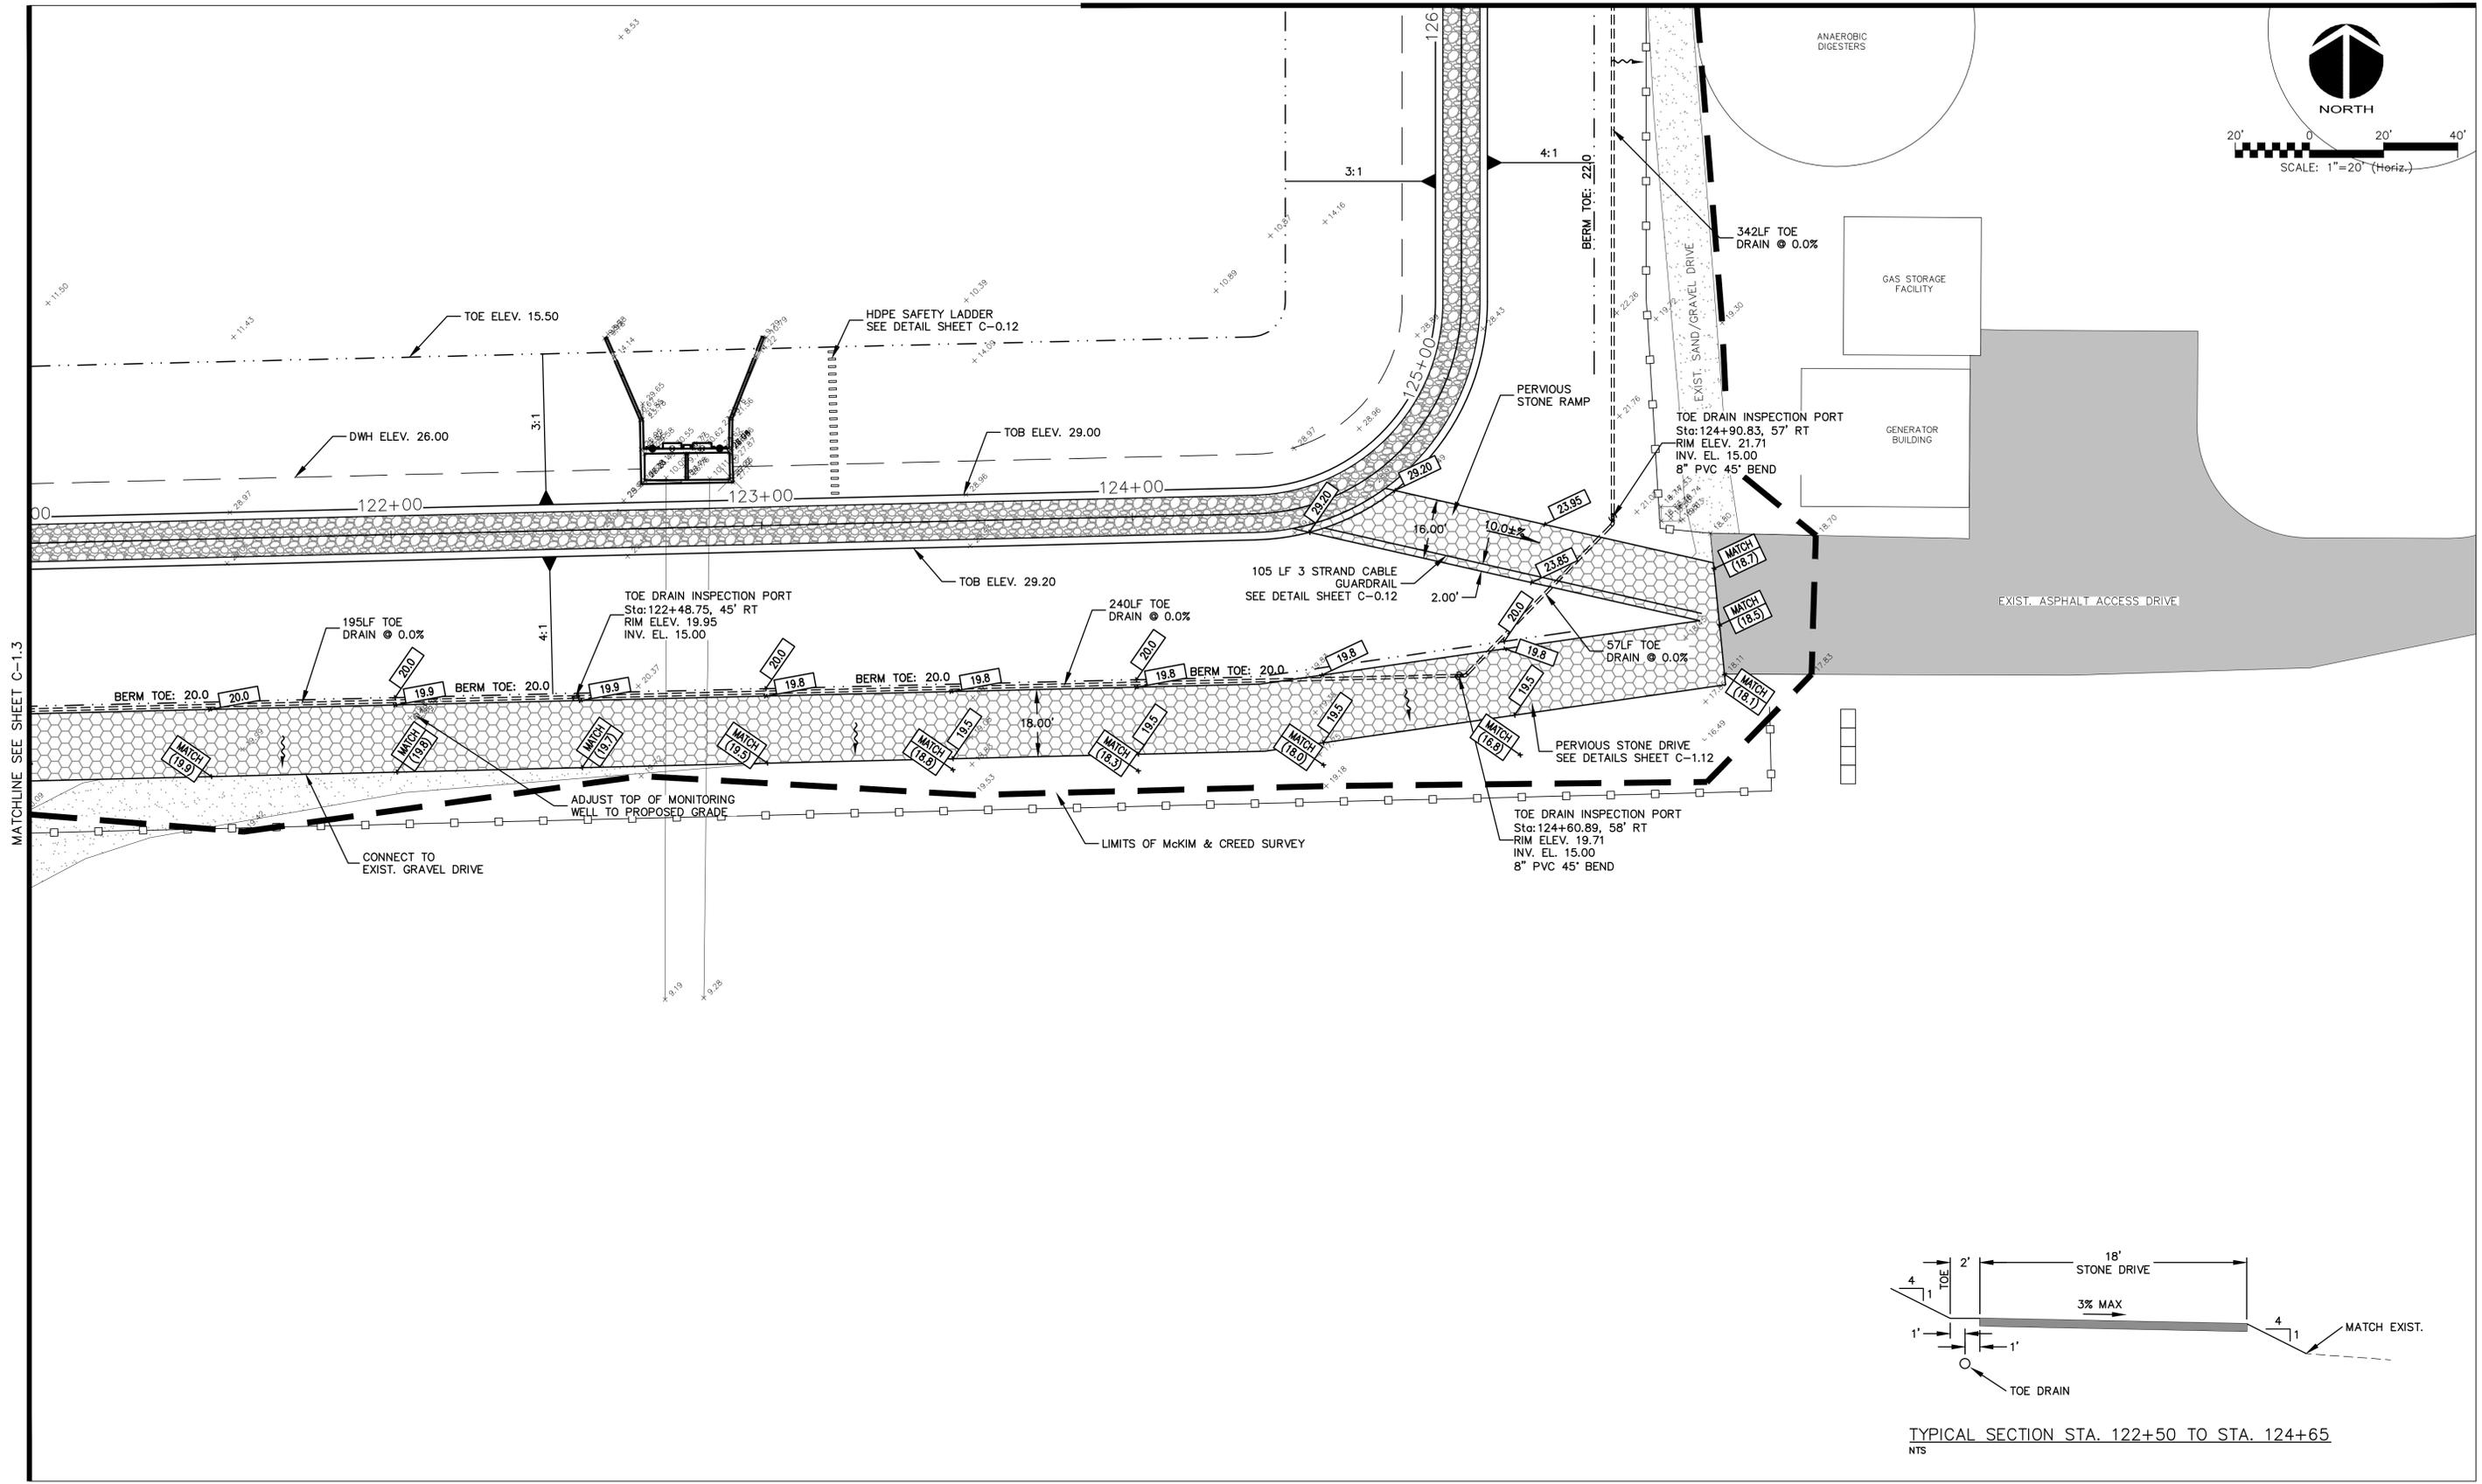
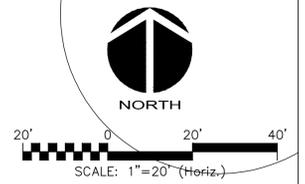
MANATEE COUNTY, FLORIDA

SWRF LAKE FILTRATION AND NORTH POND IMPROVEMENTS

GRADING PLAN No. 2

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DESIGNED: MSL		
CHECKED: JSL		
PROJ. MGR: MSL		
STATUS: ISSUE FOR BID		

MATCHLINE SEE SHEET C-1.5



TYPICAL SECTION STA. 122+50 TO STA. 124+65
NTS

MATCHLINE SEE SHEET C-1.3

REV. NO.	DESCRIPTIONS	DATE

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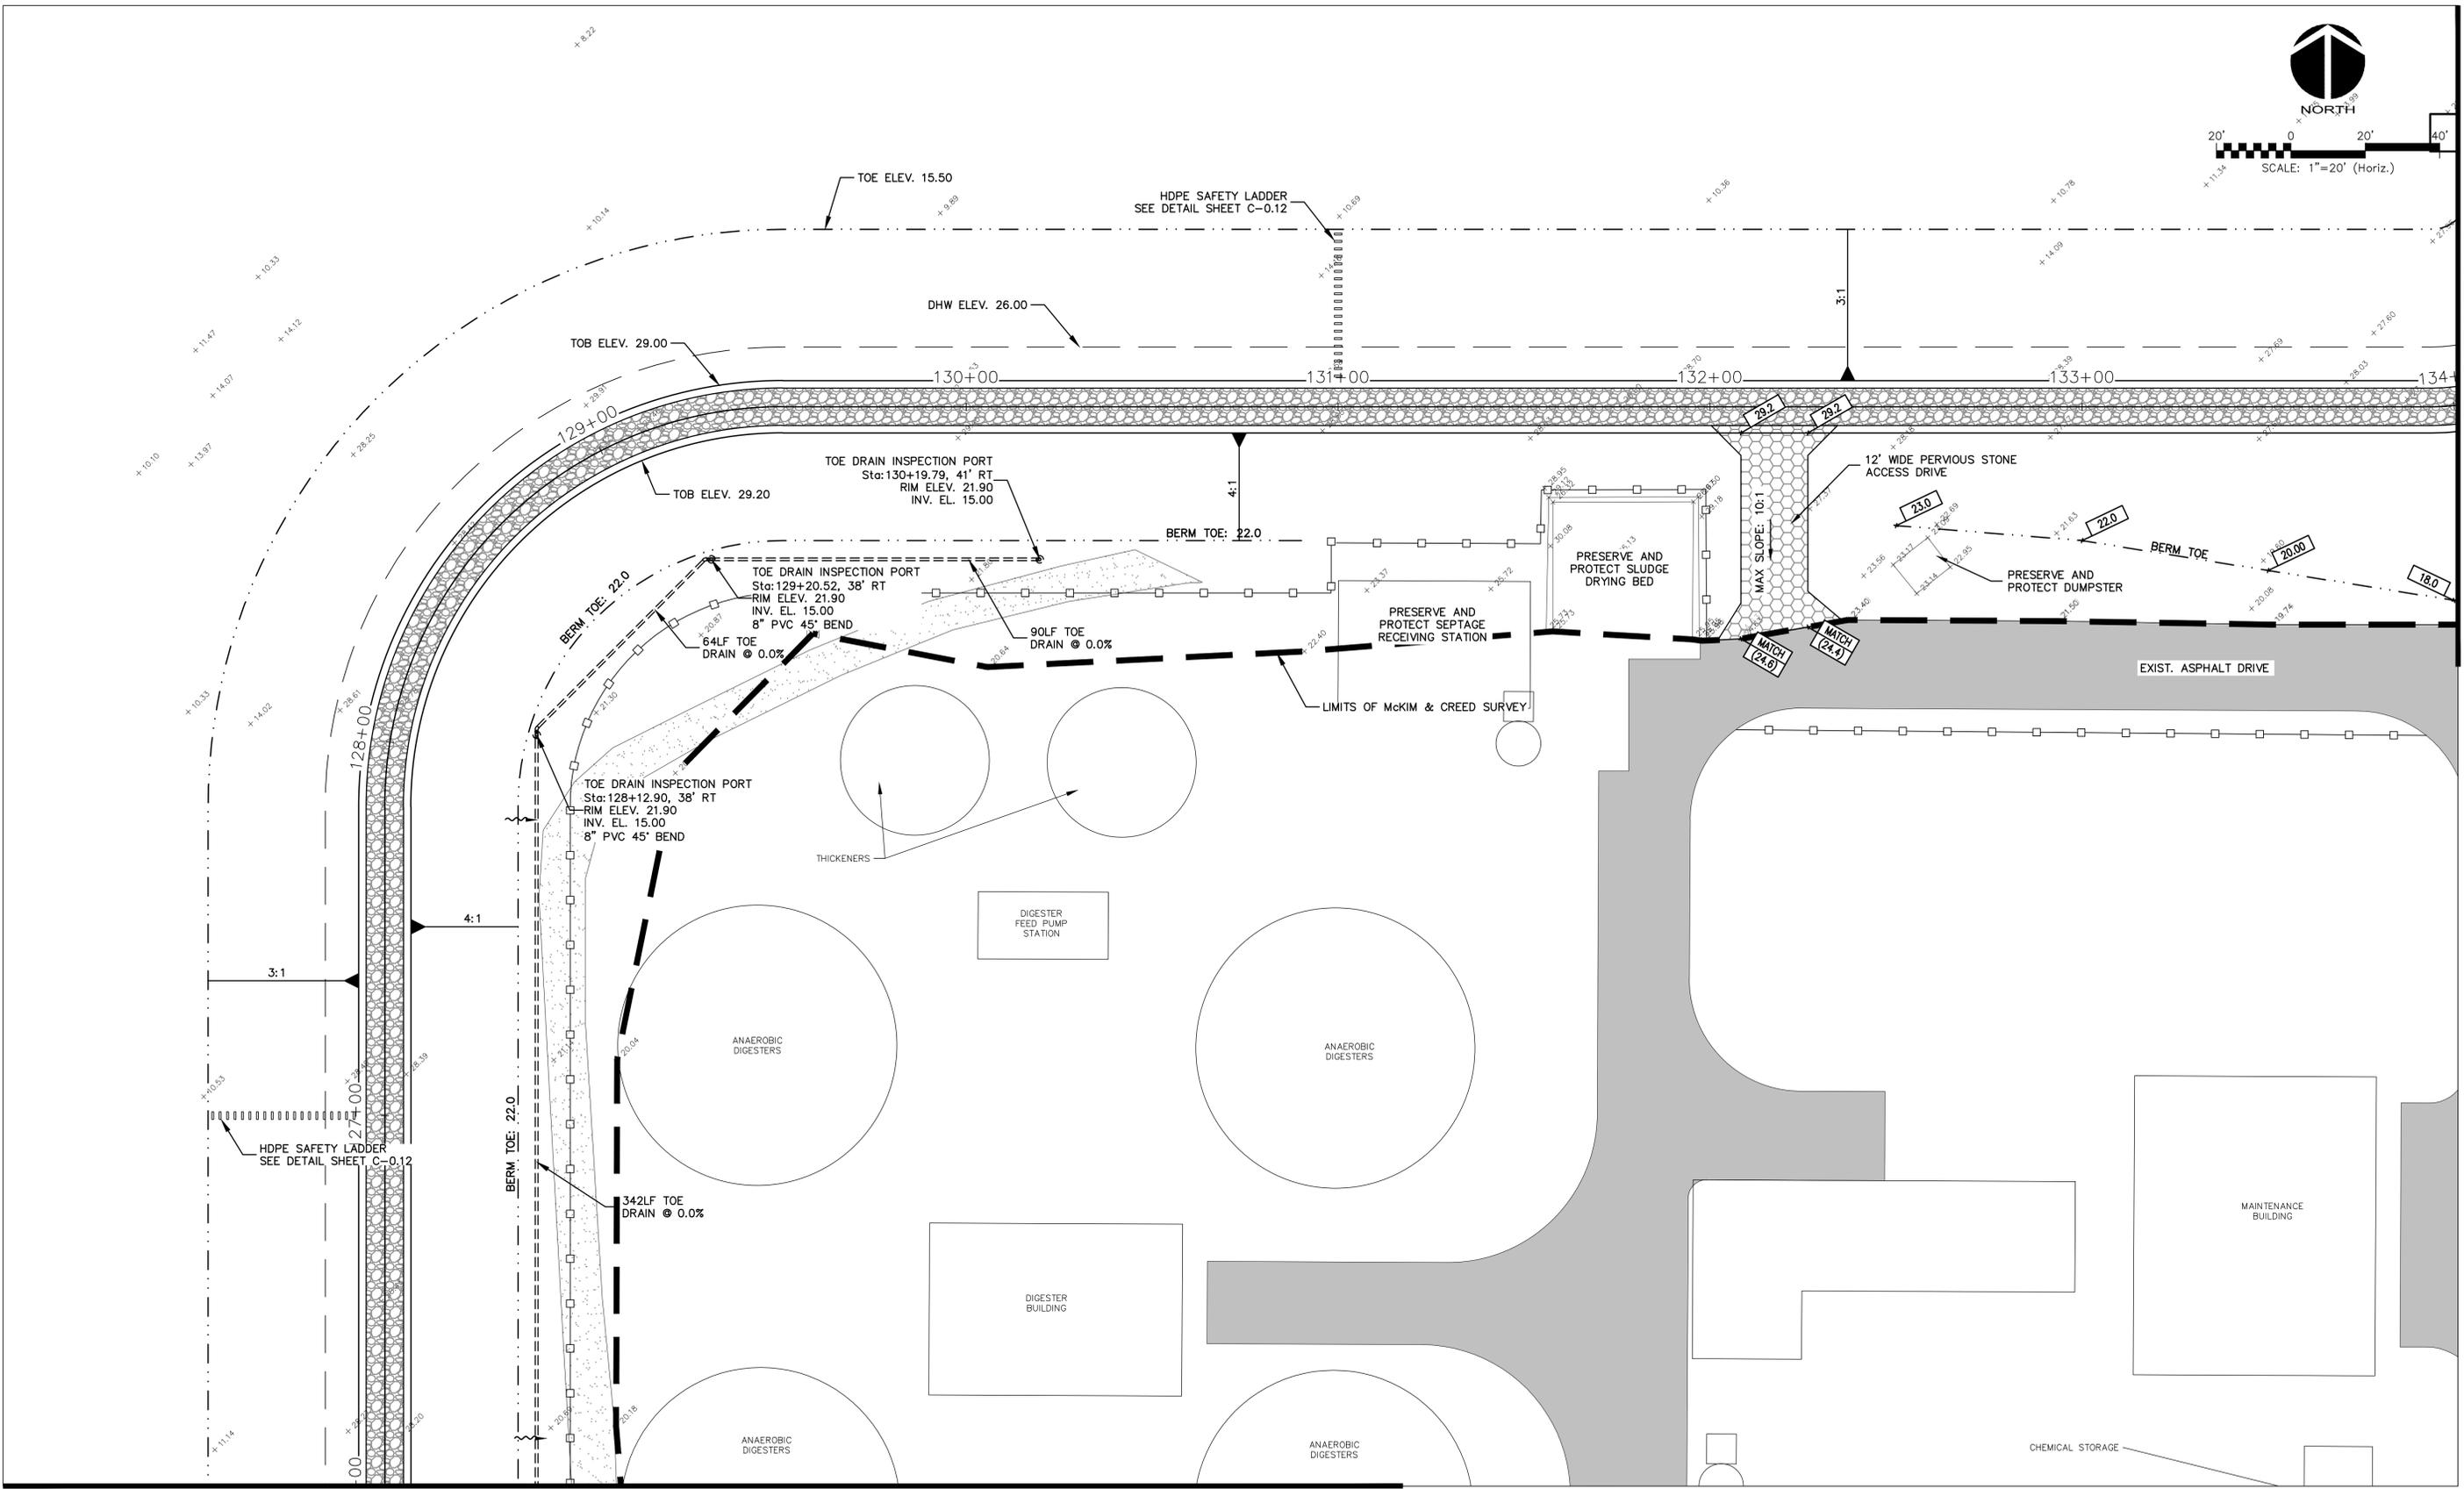
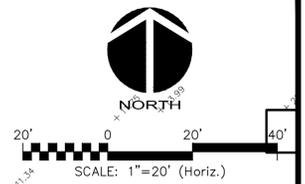
MANATEE COUNTY, FLORIDA

SWWRF LAKE FILTRATION AND
NORTH POND IMPROVEMENTS

GRADING PLAN No. 4

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DRAWN: BFN		
DESIGNED: MSL		
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PROJ. MGR. MSL		
STATUS: ISSUE FOR BID		

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MATCHLINE SEE SHEET C-1.6

MATCHLINE SEE SHEET C-1.4

REV. NO.	DESCRIPTIONS	DATE

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SWRF LAKE FILTRATION AND
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GRADING PLAN No. 5



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PROJ. MGR: MSL

SCALE: HORIZONTAL: 1" = 20' VERTICAL: NA

DRAWING NUMBER: C-1.5

STATUS: ISSUE FOR BID

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MANATEE COUNTY, FLORIDA

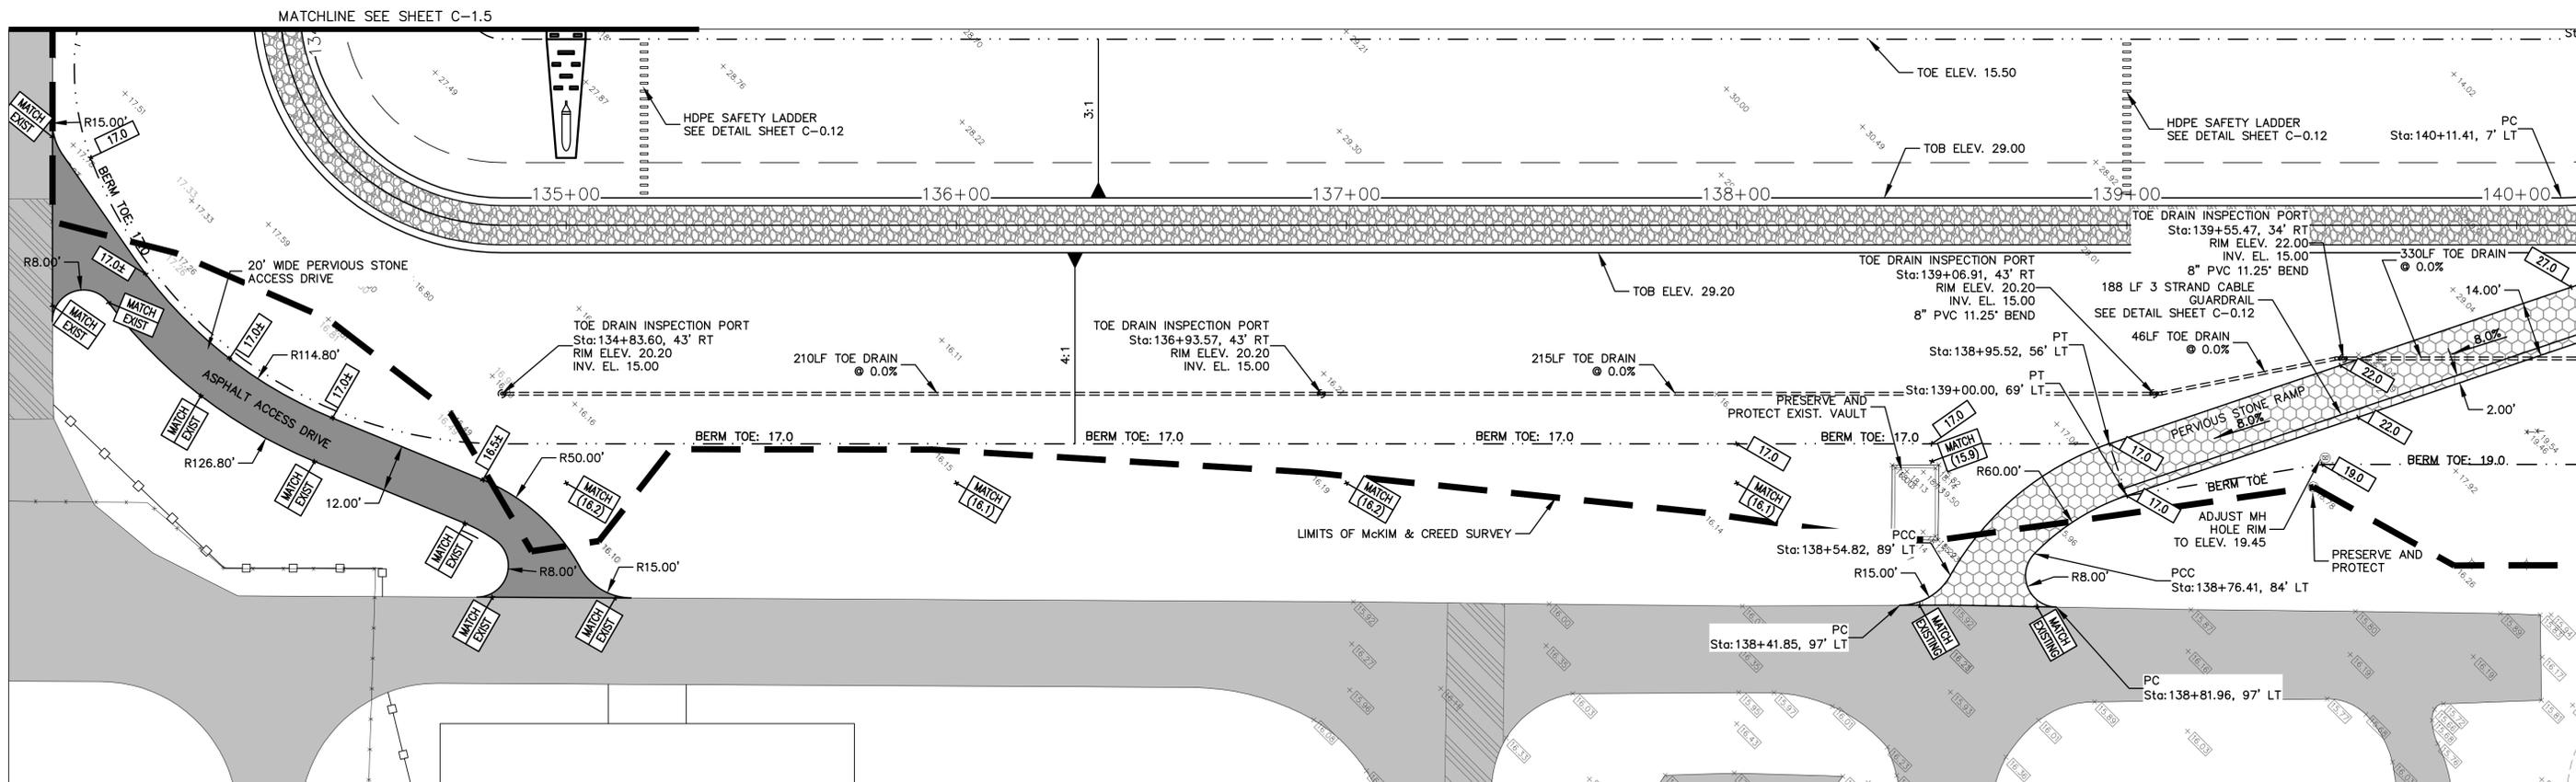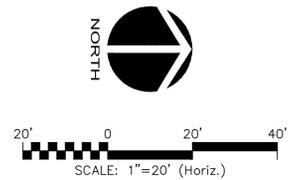
SWWRF LAKE FILTRATION AND
NORTH POND IMPROVEMENTS

GRADING PLAN No. 6

DATE: FEBRUARY 2012	SCALE: HORIZONTAL: 1" = 20'	DRAWING NUMBER: C-1.6
MCE PROJ. # 1024-0147	VERTICAL: NA	
DRAWN: BFN		
DESIGNED: MSL		
CHECKED: JSL		
PROJ. MGR: MSL		

STATUS: **ISSUE FOR BID**


S:\1024\10147\10147-01-01-01.dwg, 2/12/2012 3:31:45 PM, Brian Knight

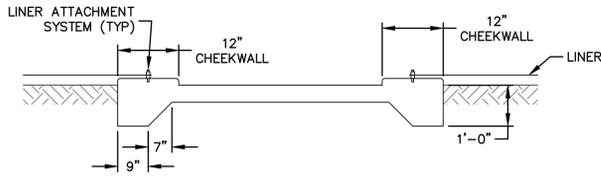


MODIFIED "CHEEKWALL" STAIR SECTION
NTS

NOTES:

1. ALL ABOVE GROUND EXISTING VALVES, STRUCTURES, ASSEMBLIES AND APPURTENANCES TO REMAIN ARE TO BE ADJUSTED AS NEEDED TO THE PROPOSED GRADES OR REPLACED IN-KIND.
2. ALL BELOW GRADE INFRASTRUCTURE OR UTILITY LINES SHALL BE ADJUSTED AS NEEDED TO MAINTAIN MINIMUM COVER.
3. AREAS OF LIMITED SURVEY WERE BASED ON AERIAL IMAGERY AND SURVEYS PROVIDED BY OTHERS AND/OR AVAILABLE DATA. CONTRACTOR SHALL FIELD VERIFY EXISTING CONDITIONS AND CONTRACTIBILITY OF PROPOSED IMPROVEMENTS. CONTRACTOR SHALL NOTIFY ENGINEER OF ANY AND ALL FIELD ADJUSTMENTS.

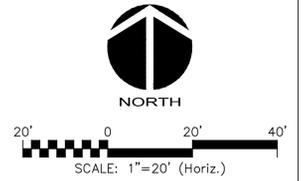

MATCHLINE SEE SHEET C-1.2

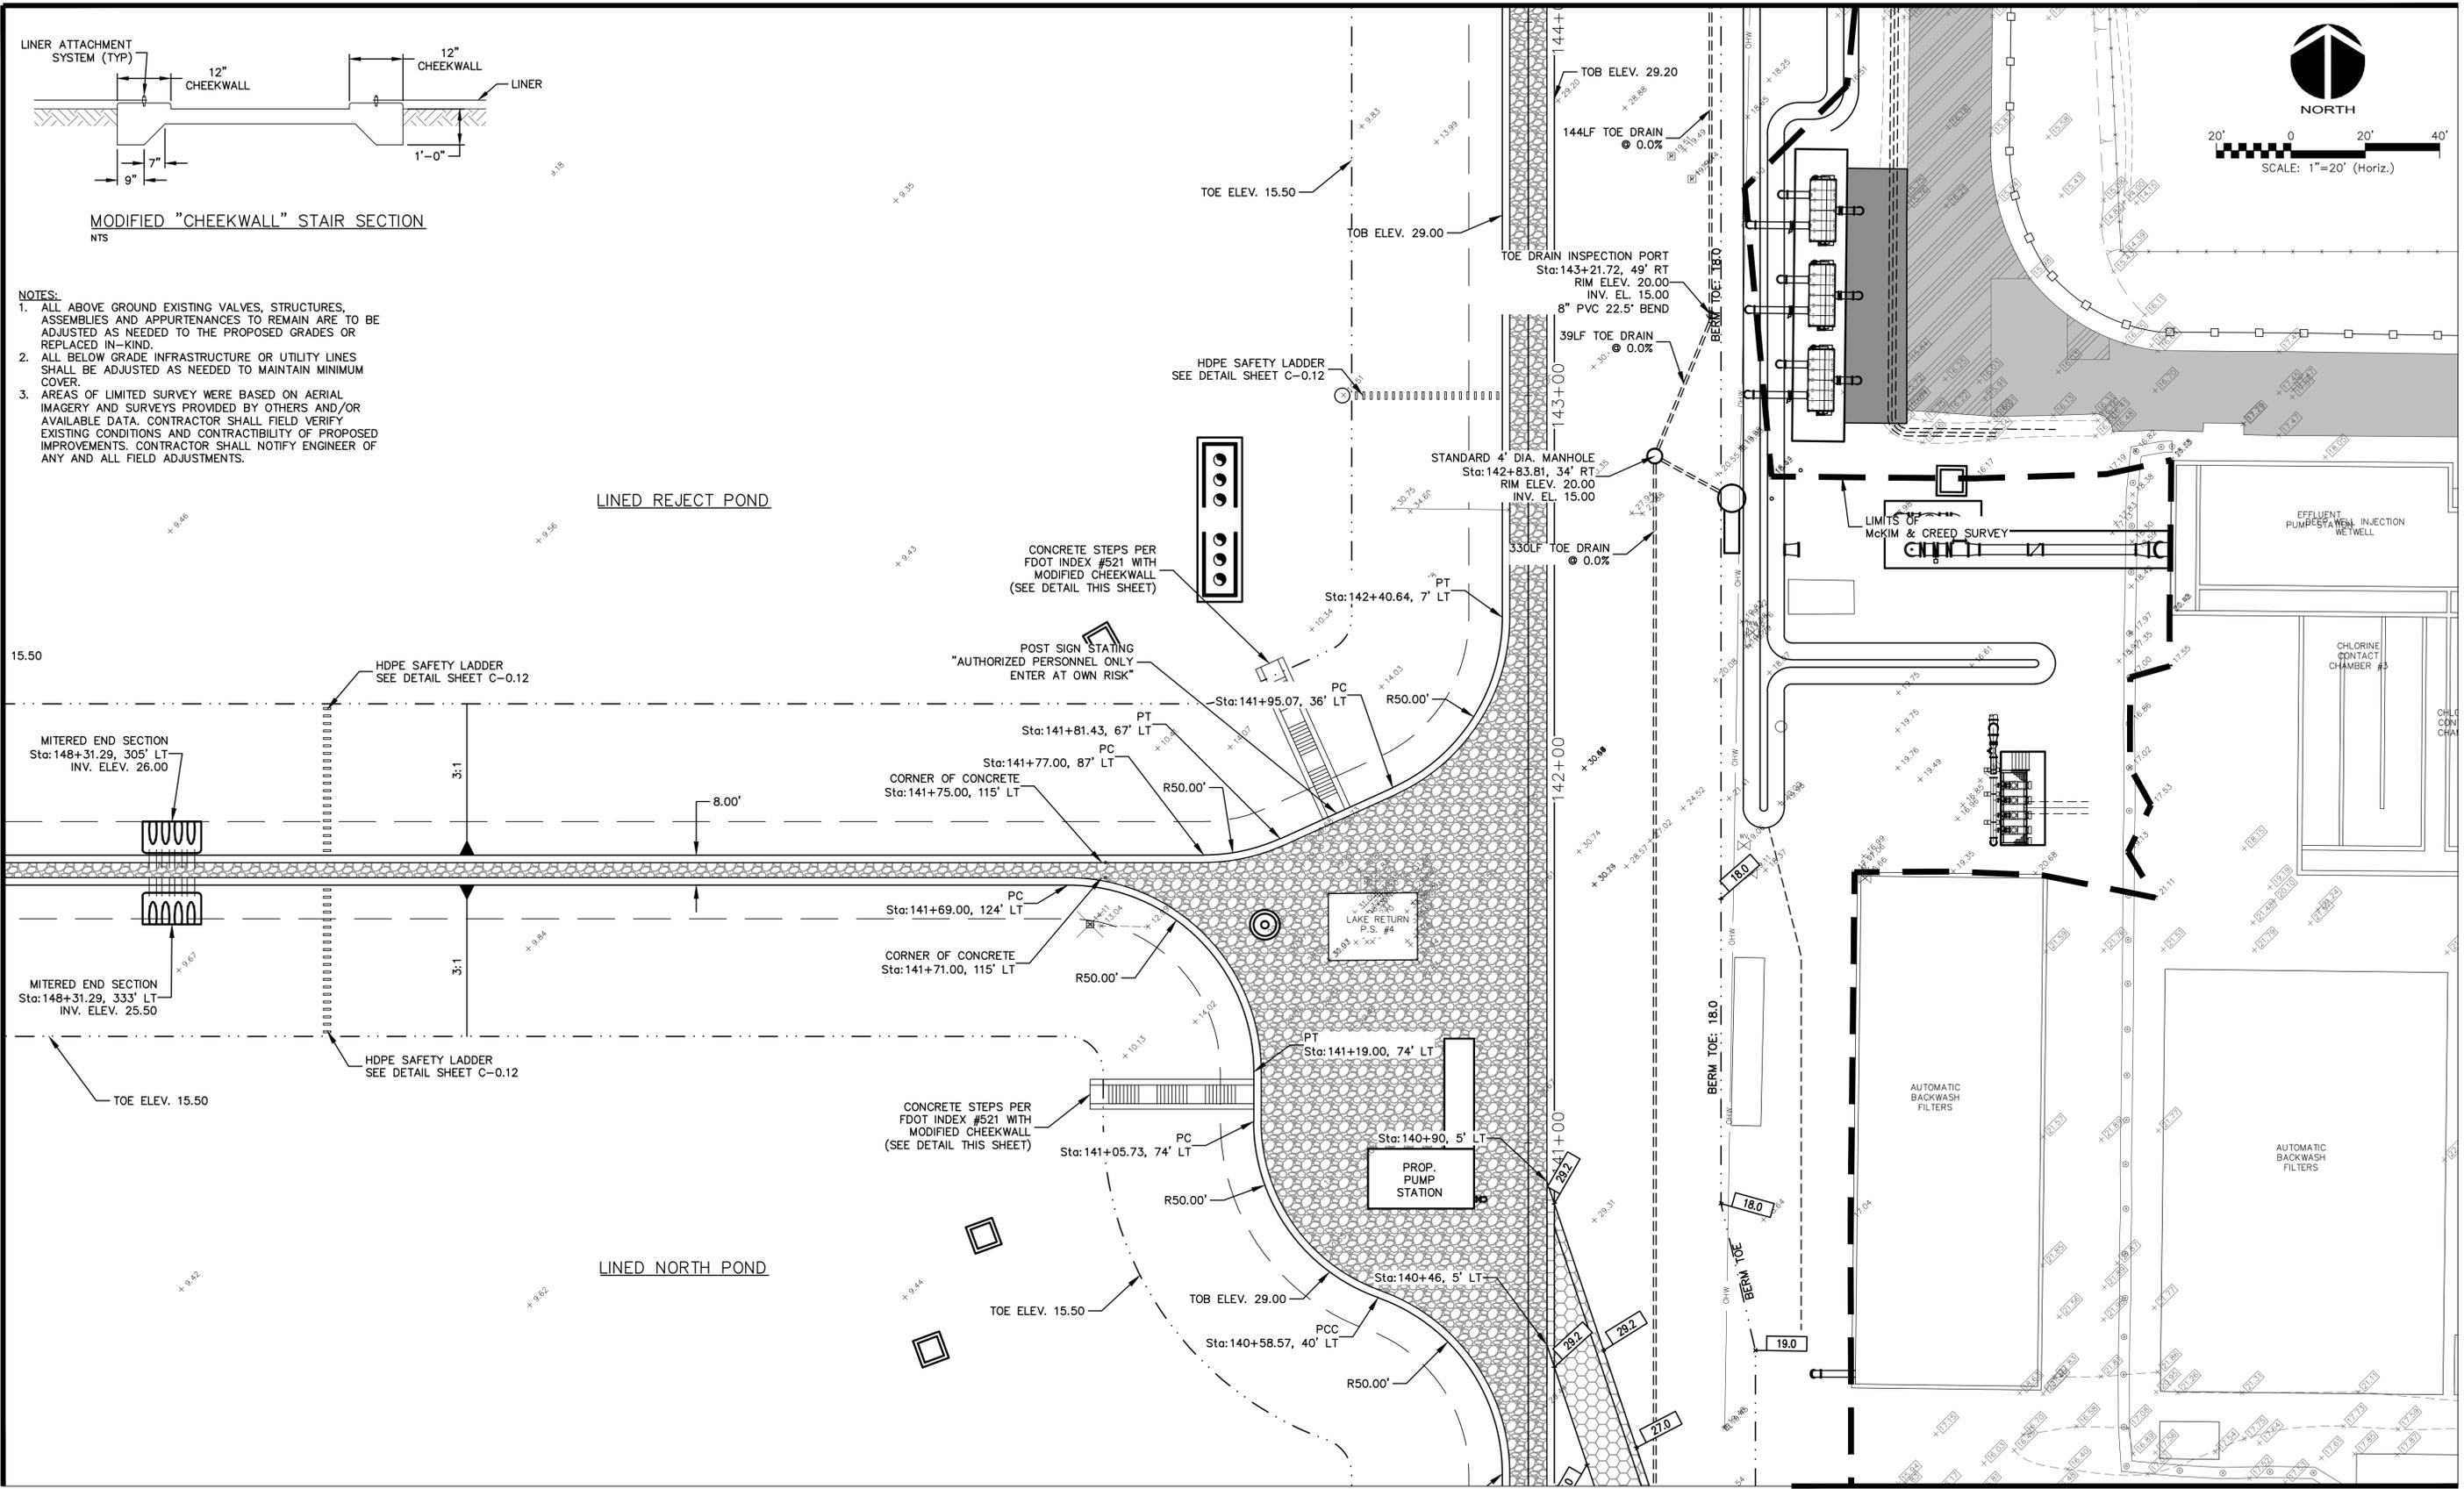

MATCHLINE SEE SHEET C-1.6

REVNO.	DESCRIPTIONS	DATE

SEAL	SEAL
TRAVIS N. TERPSTRA, P.E. No. 71412	

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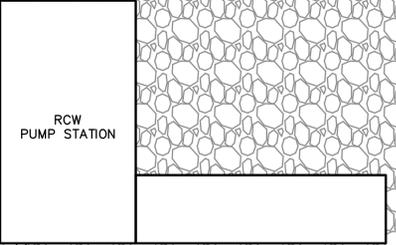
GRADING PLAN No. 7

DATE: FEBRUARY 2012	SCALE: HORIZONTAL: 1" = 20'	DRAWING NUMBER: C-1.7
MCE PROJ. # 1024-0147	VERTICAL: NA	
DRAWN: BFN		
DESIGNED: MSL		
CHECKED: JSL		
PROJ. MGR: MSL		
STATUS: ISSUE FOR BID		



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SCALE: 1"=10' (Horiz.)



LAKE RETURN PUMP STATION



COORDINATE WITH ELECTRICAL UTILITY TO STABILIZE POWER POLES AND GUY WIRES THROUGHOUT CONSTRUCTION AND TO REPLACE GUY WIRES AND/OR POLES AS NEEDED

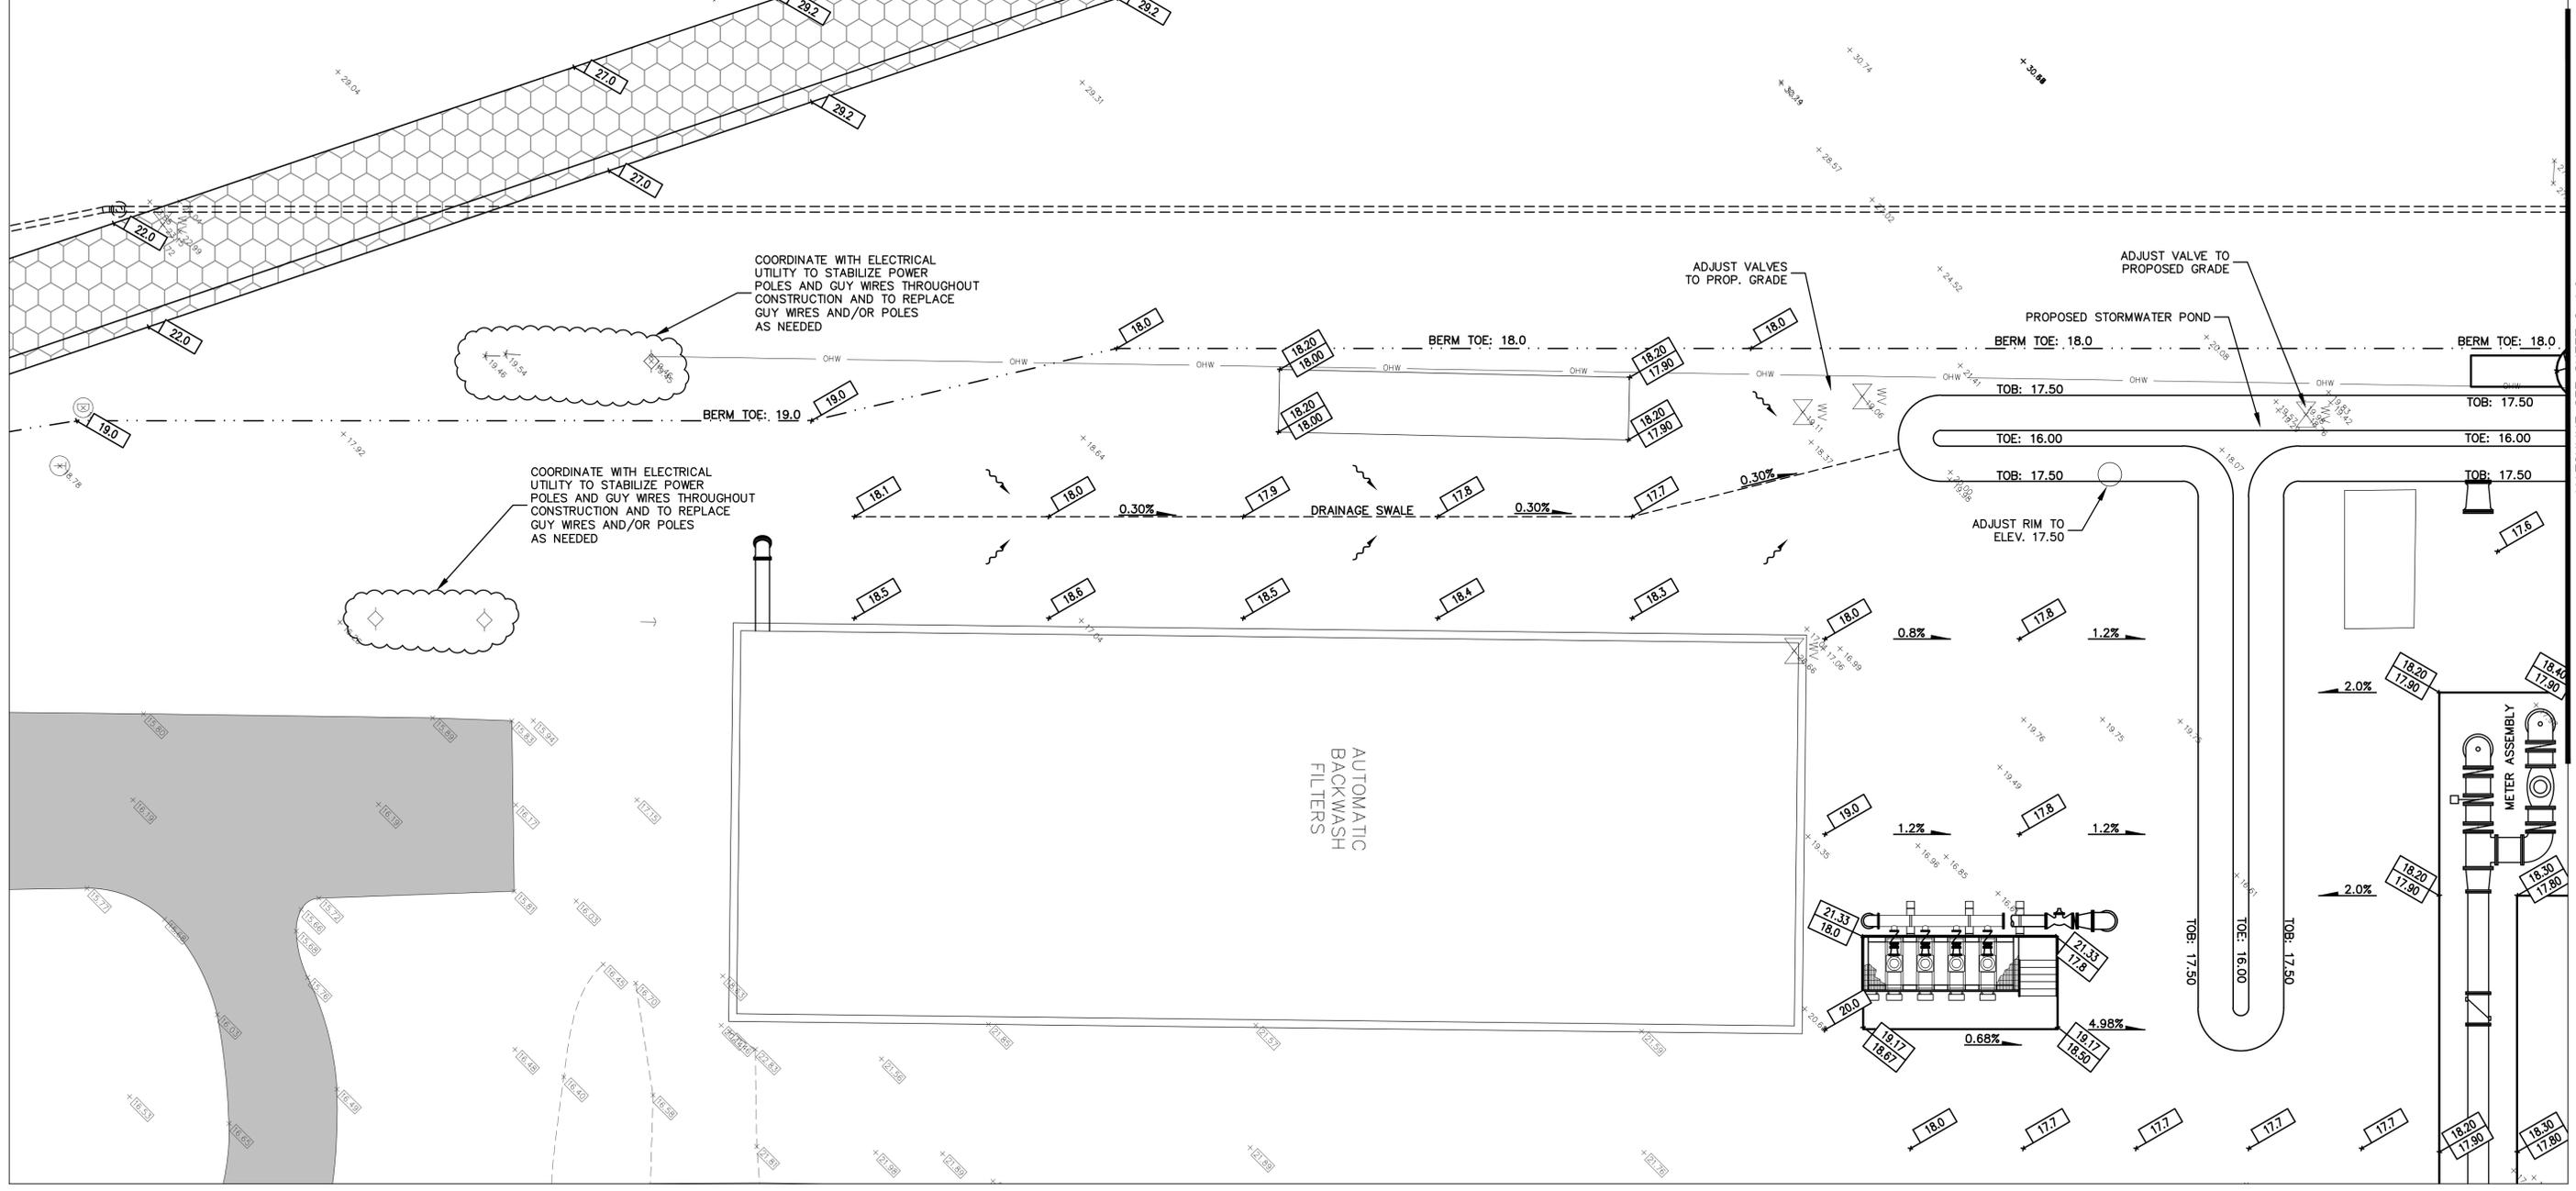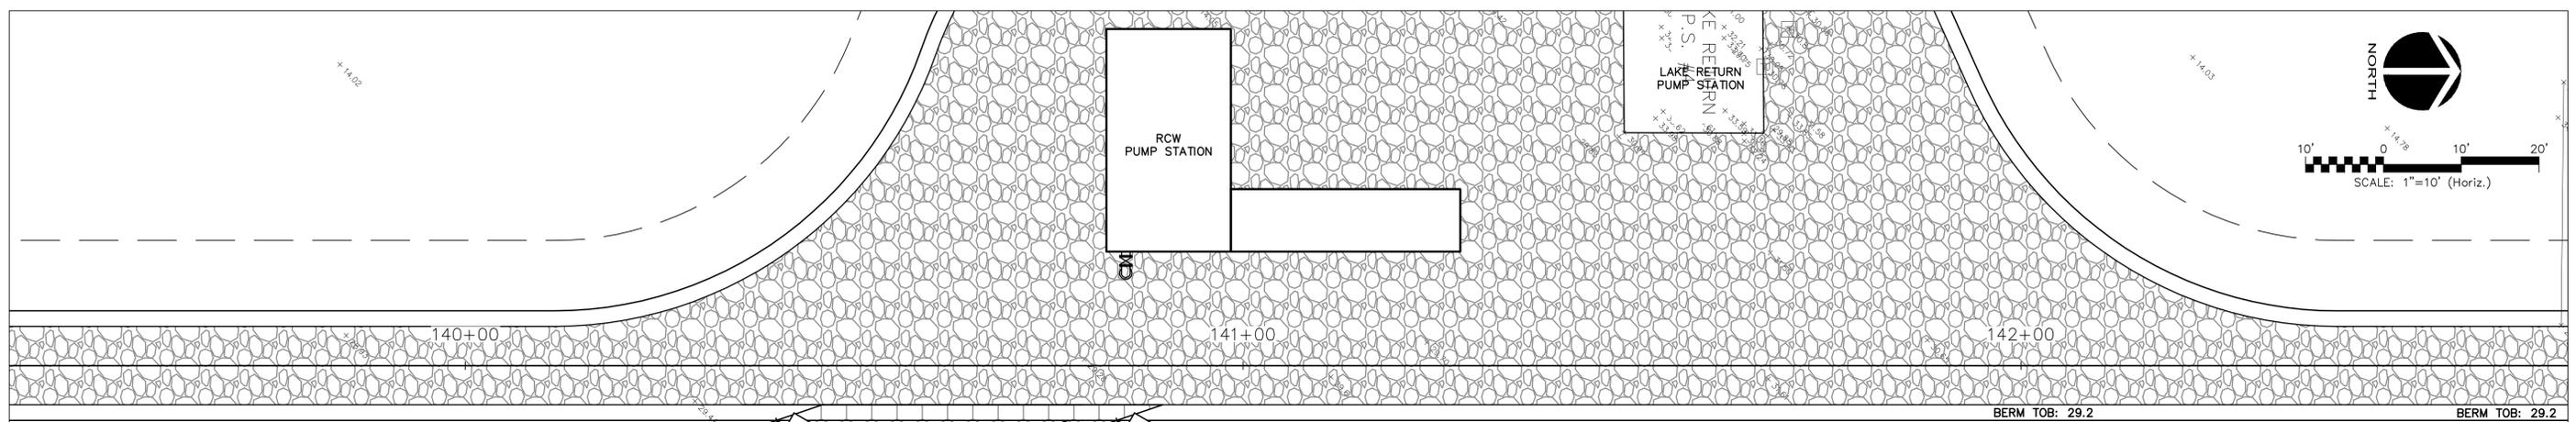COORDINATE WITH ELECTRICAL UTILITY TO STABILIZE POWER POLES AND GUY WIRES THROUGHOUT CONSTRUCTION AND TO REPLACE GUY WIRES AND/OR POLES AS NEEDED

MATCHLINE SEE SHEET C-1.9

REV. NO.	DESCRIPTIONS	DATE

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SWWRF LAKE FILTRATION AND NORTH POND IMPROVEMENTS

GRADING PLAN No. 8




DATE: FEBRUARY 2012
MCE PROJ. # 1024-0147
DRAWN: BFN
DESIGNED: MSL
CHECKED: JSL
PROJ. MGR: MSL

SCALE: HORIZONTAL: 1" = 10' VERTICAL: NA

DRAWING NUMBER: C-1.8

STATUS: ISSUE FOR BID

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- NOTES:
- "RIP-RAP" IS PER FDOT SPECIFICATION SECTION 530.2.2.2
 - GEOTEXTILE FABRIC IS PER D-3 IN FDOT INDEX #199

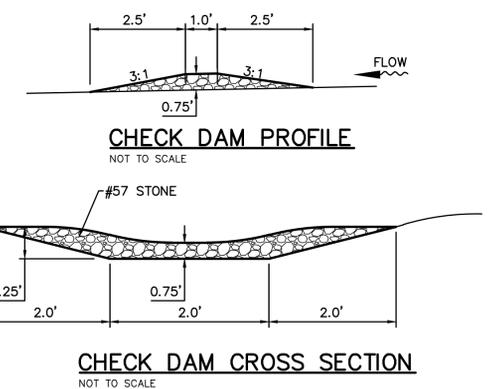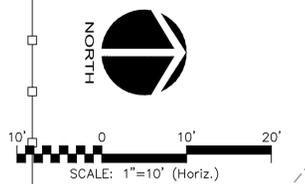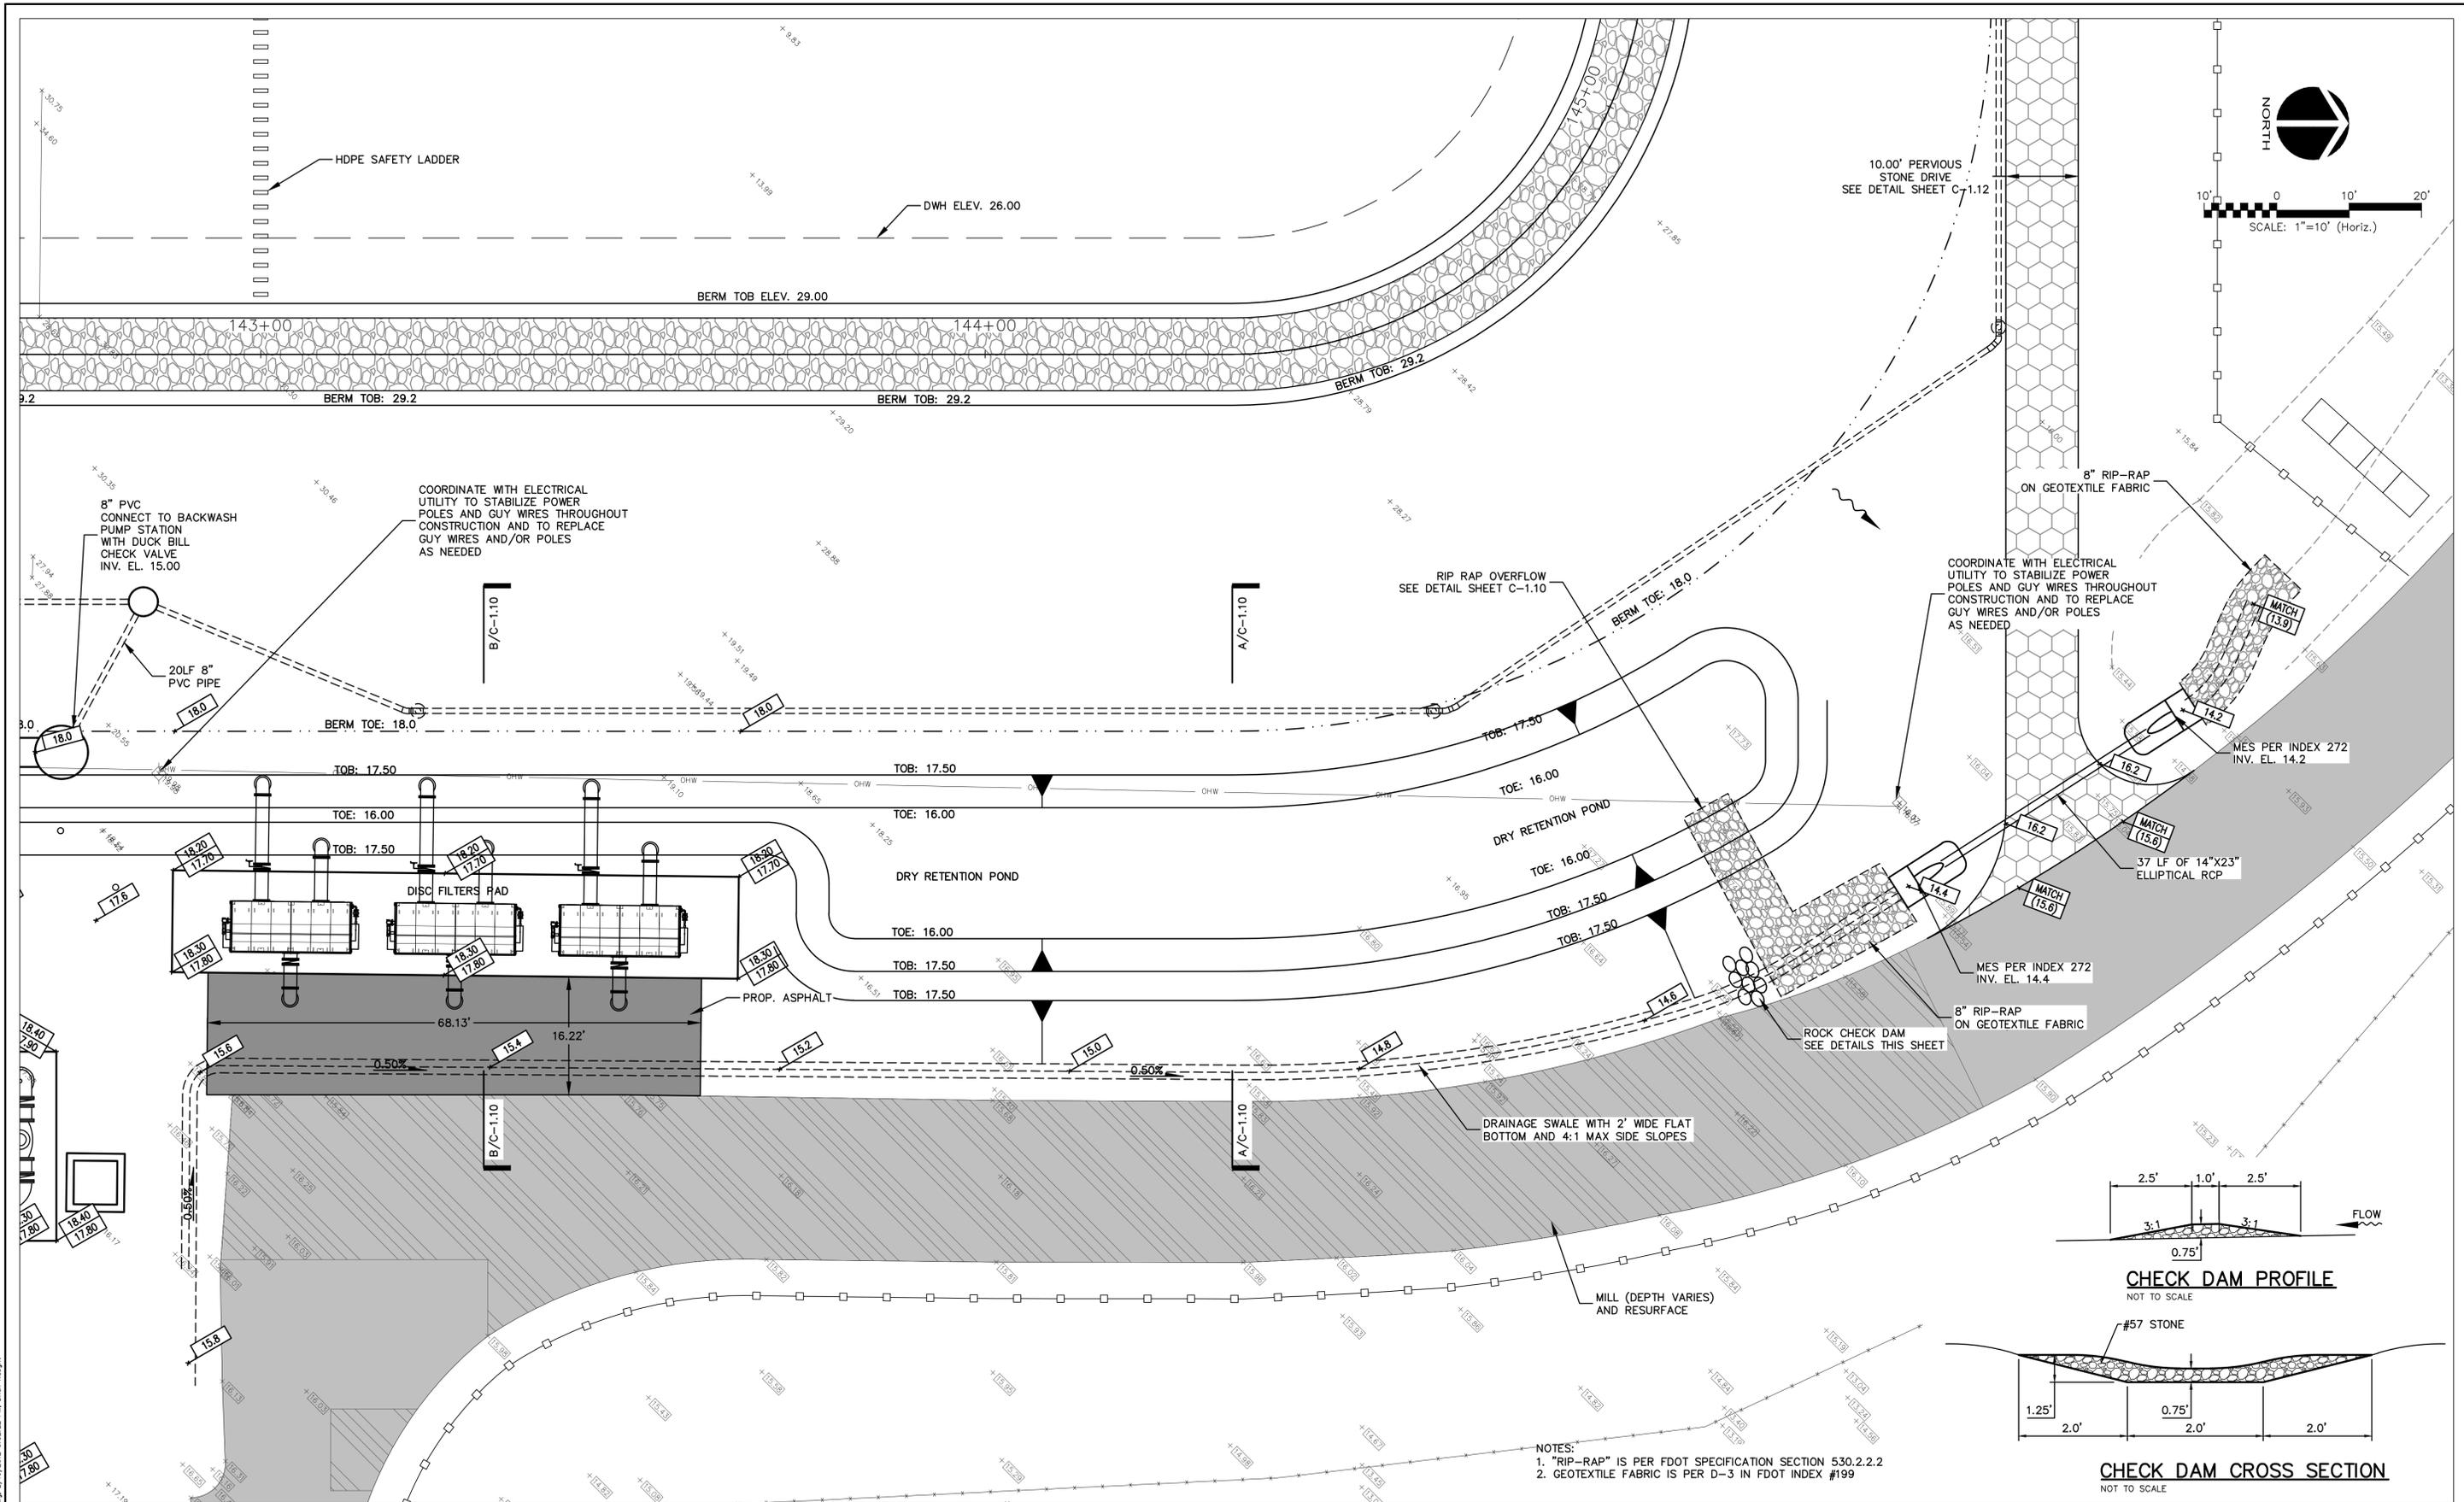REV. NO.	DESCRIPTIONS	DATE

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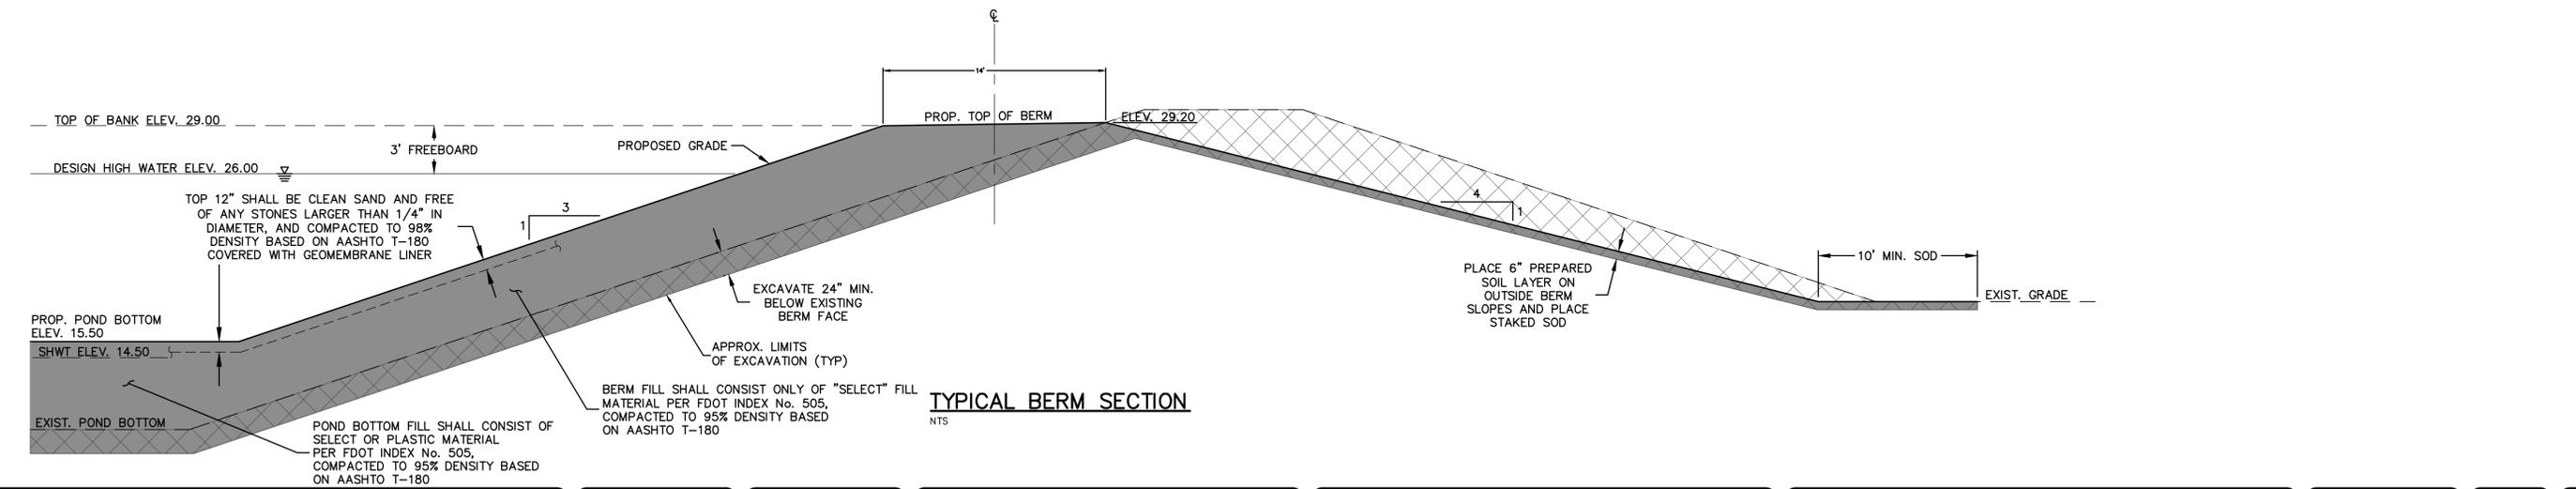
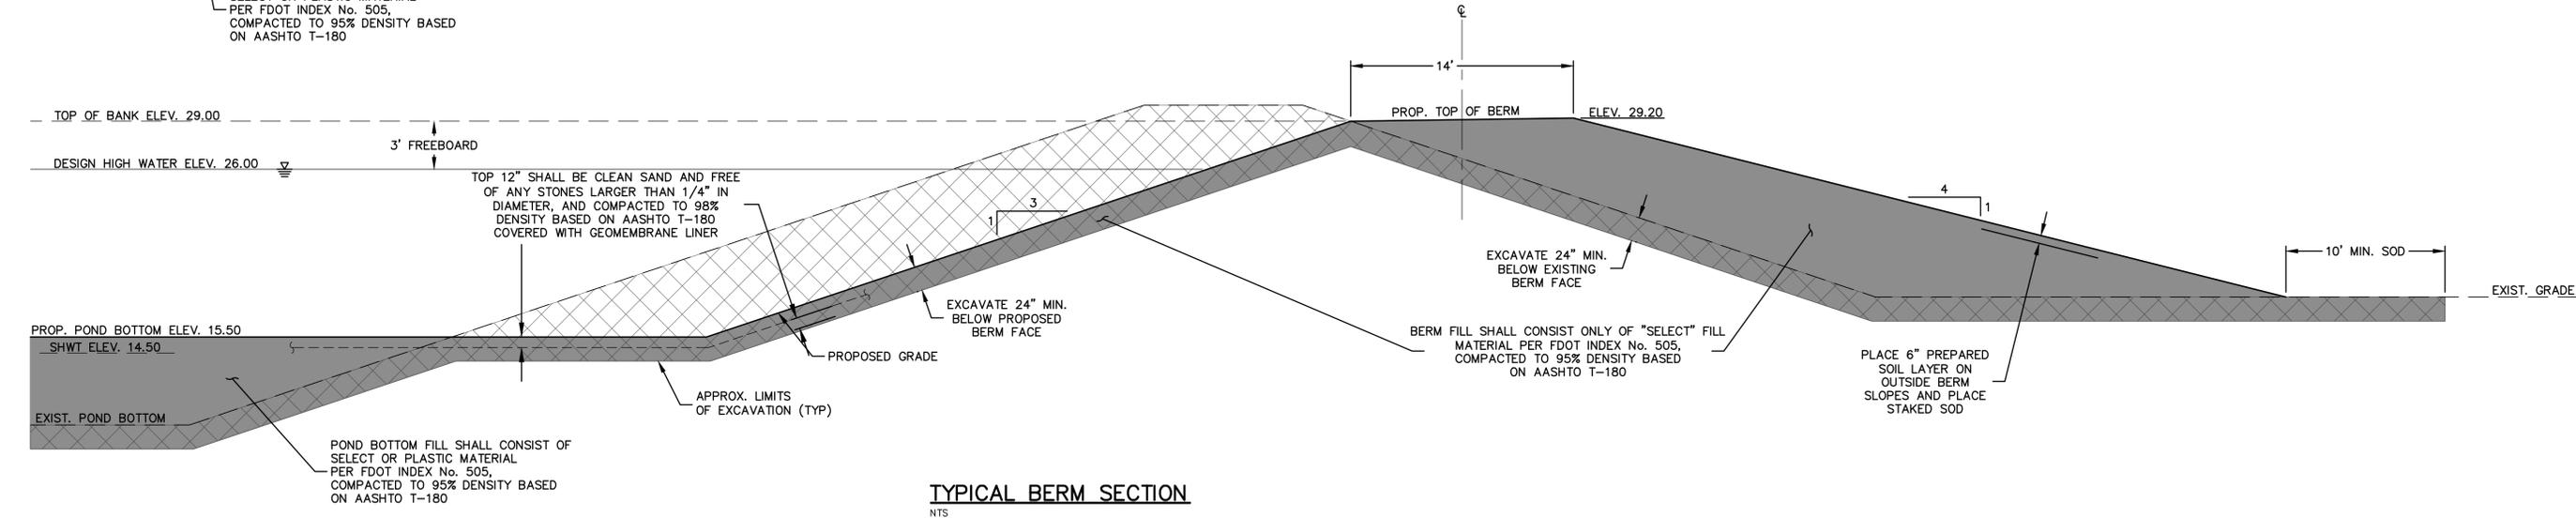
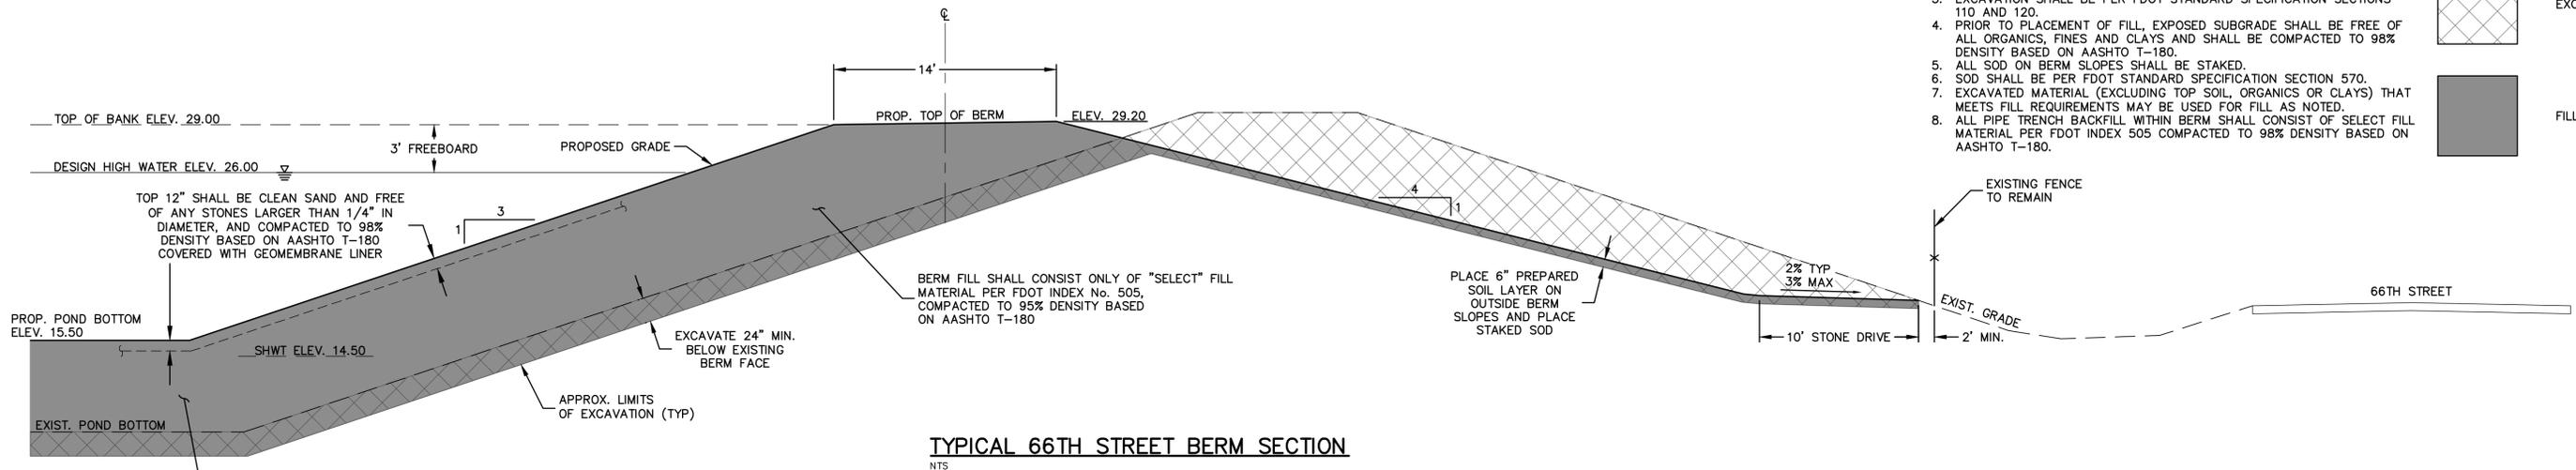
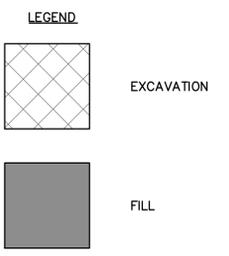
SWRF LAKE FILTRATION AND NORTH POND IMPROVEMENTS

GRADING PLAN No. 9

DATE: FEBRUARY 2012	SCALE: HORIZONTAL: 1" = 10'	DRAWING NUMBER: C-1.9
MCE PROJ. # 1024-0147	VERTICAL: NA	
DRAWN: BFN		
DESIGNED: MSL		
CHECKED: JSL		
PROJ. MGR: MSL		
STATUS: ISSUE FOR BID		

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- NOTES:**
1. PREPARED SOIL LAYER PER FDOT STANDARD SPECIFICATIONS 162 AND 987.
 2. SOD PER FDOT STANDARD SPECIFICATION SECTION 981.
 3. EXCAVATION SHALL BE PER FDOT STANDARD SPECIFICATION SECTIONS 110 AND 120.
 4. PRIOR TO PLACEMENT OF FILL, EXPOSED SUBGRADE SHALL BE FREE OF ALL ORGANICS, FINES AND CLAYS AND SHALL BE COMPACTED TO 98% DENSITY BASED ON AASHTO T-180.
 5. ALL SOD ON BERM SLOPES SHALL BE STAKED.
 6. SOD SHALL BE PER FDOT STANDARD SPECIFICATION SECTION 570.
 7. EXCAVATED MATERIAL (EXCLUDING TOP SOIL, ORGANICS OR CLAYS) THAT MEETS FILL REQUIREMENTS MAY BE USED FOR FILL AS NOTED.
 8. ALL PIPE TRENCH BACKFILL WITHIN BERM SHALL CONSIST OF SELECT FILL MATERIAL PER FDOT INDEX 505 COMPACTED TO 98% DENSITY BASED ON AASHTO T-180.



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SWRF LAKE FILTRATION AND NORTH POND IMPROVEMENTS


TYPICAL POND SECTIONS No. 1

DATE: FEBRUARY 2012
MCE PROJ. # 1024-0147
DRAWN: BFN
DESIGNED: MSL
CHECKED: JSL
PROJ. MGR: MSL


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VERTICAL: 1" = 10'

DRAWING NUMBER
C-1.11


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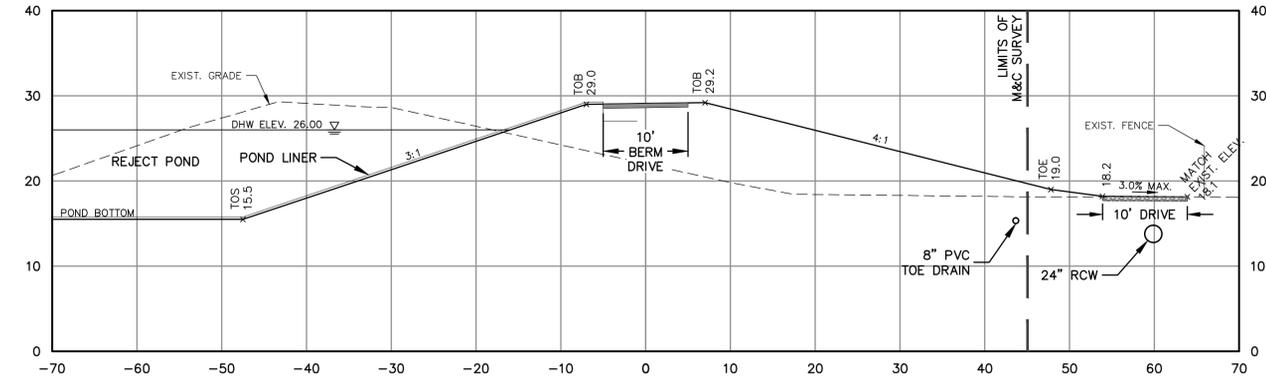
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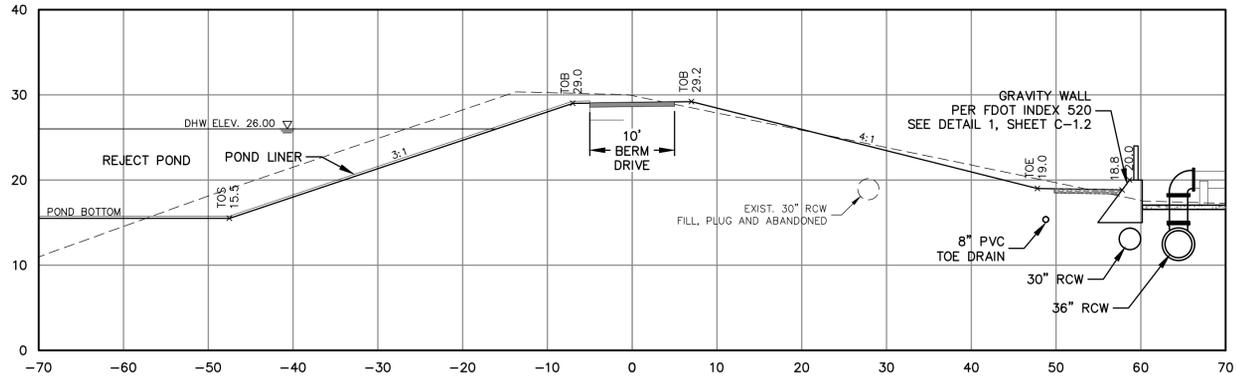
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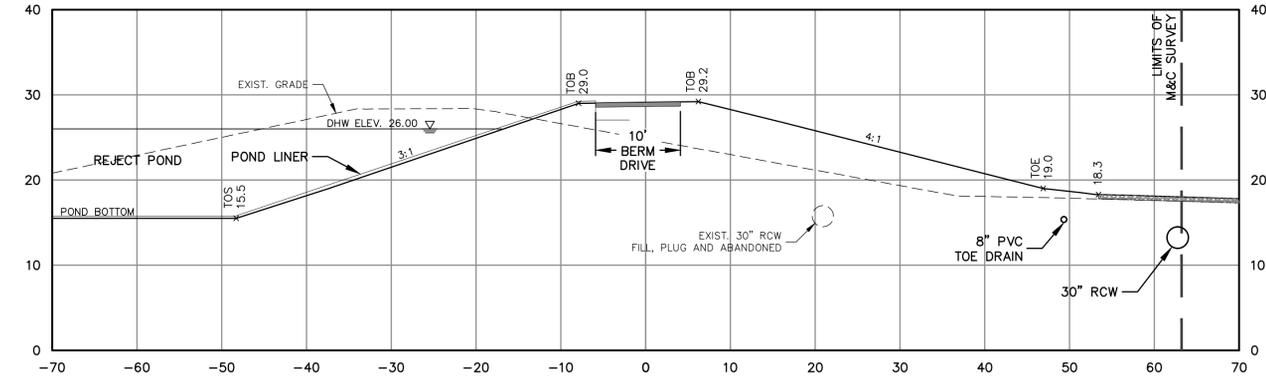
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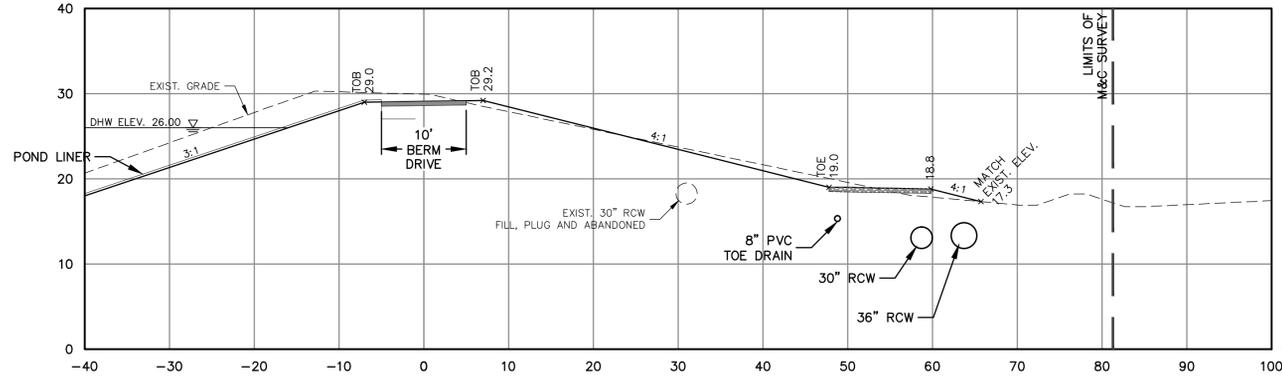
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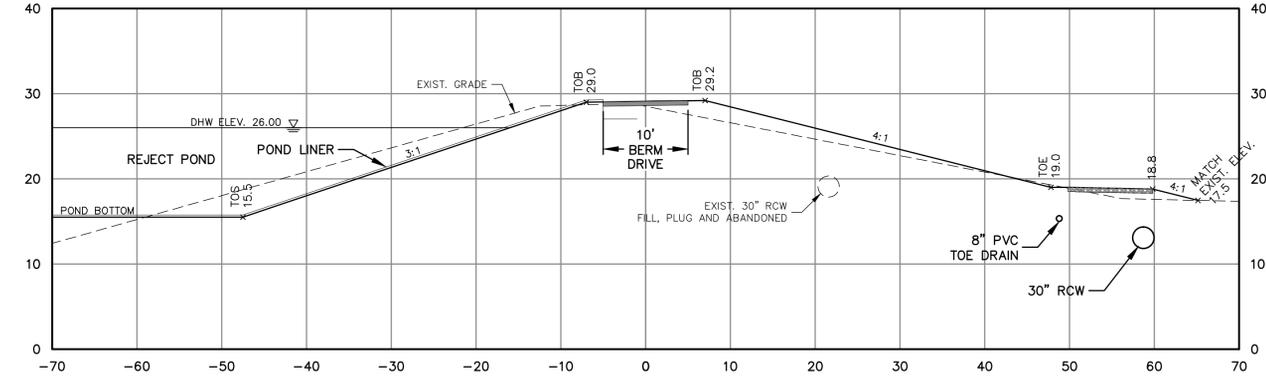
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105+00

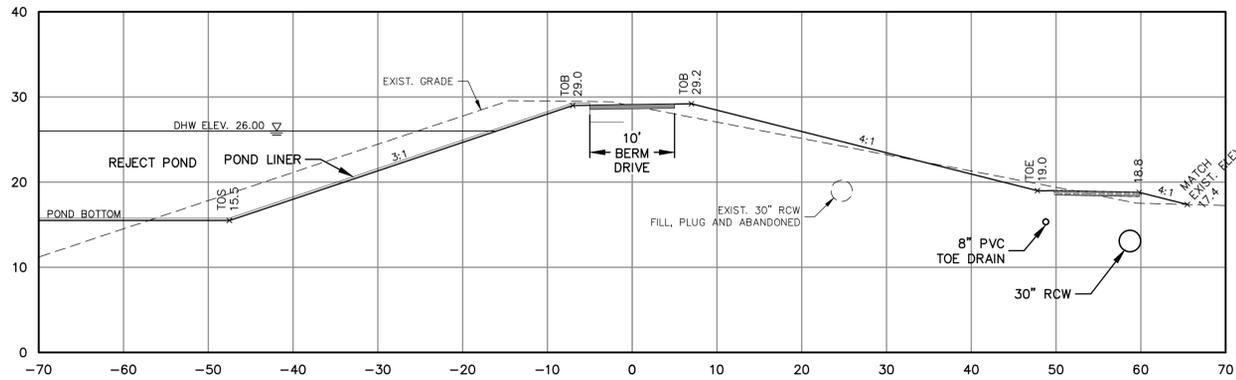

101+00

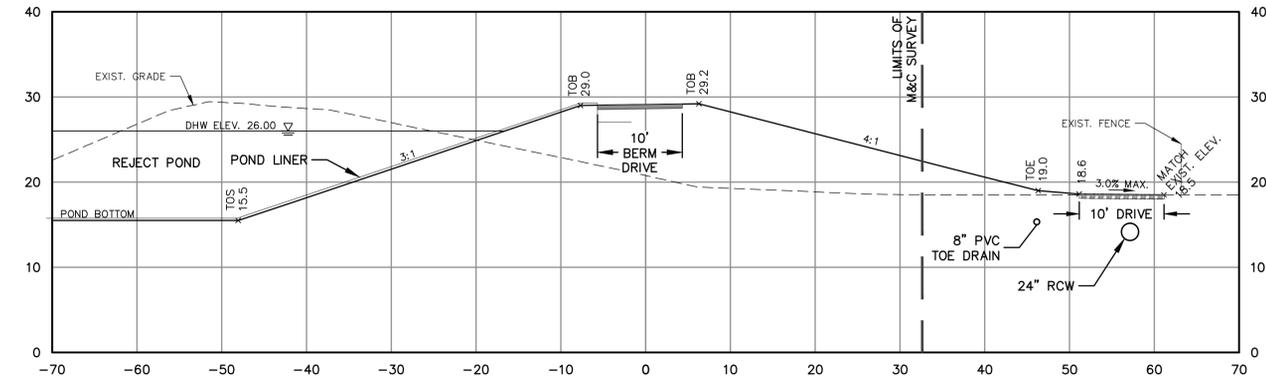

104+00
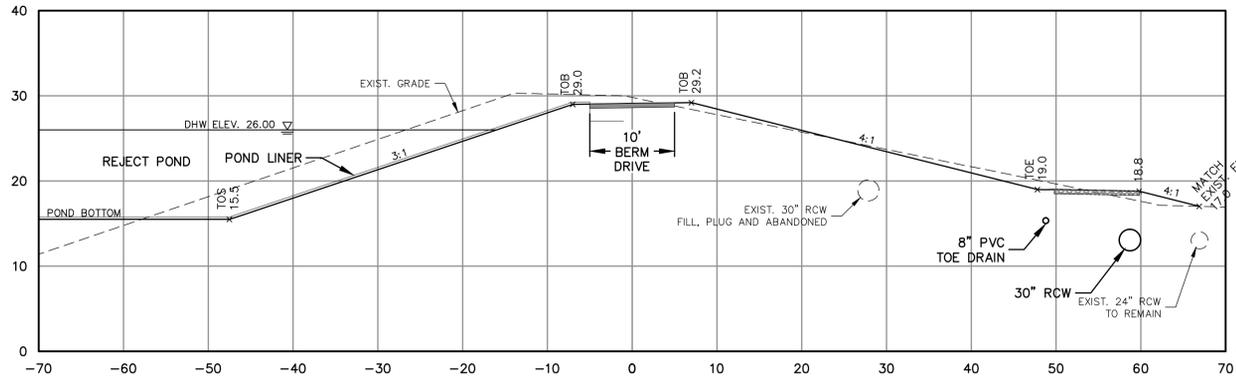
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REV. NO.	DESCRIPTIONS	DATE

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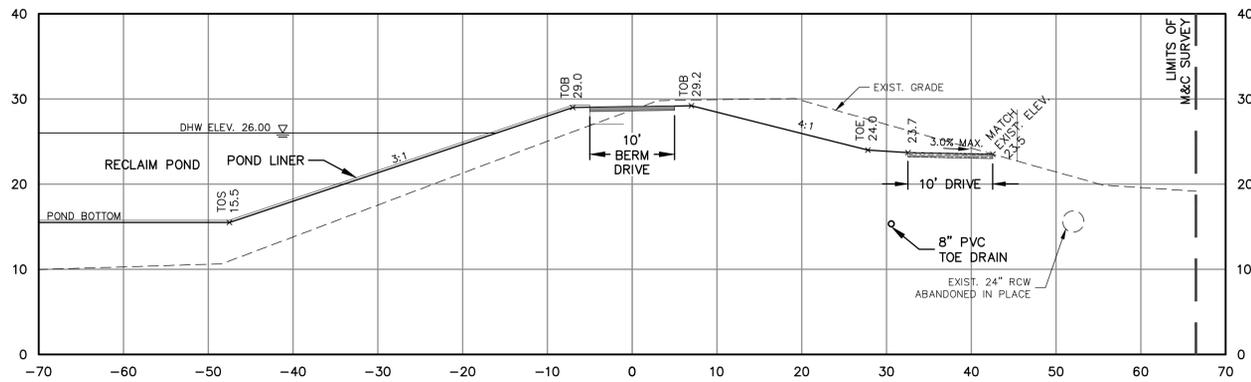
MANATEE COUNTY, FLORIDA

SWRF LAKE FILTRATION AND NORTH POND IMPROVEMENTS


POND SECTIONS No. 1

DATE:	FEBRUARY 2012
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DRAWN	BNF
DESIGNED	MSL
CHECKED	JSL
PROJ. MGR.	MSL
STATUS:	


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VERTICAL: 1" = 10'	
REVISION	
ISSUE FOR BID	




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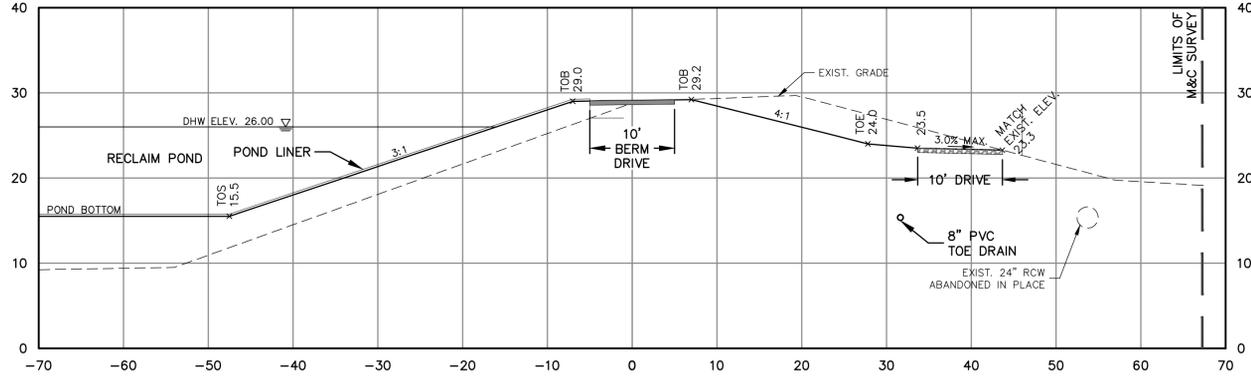
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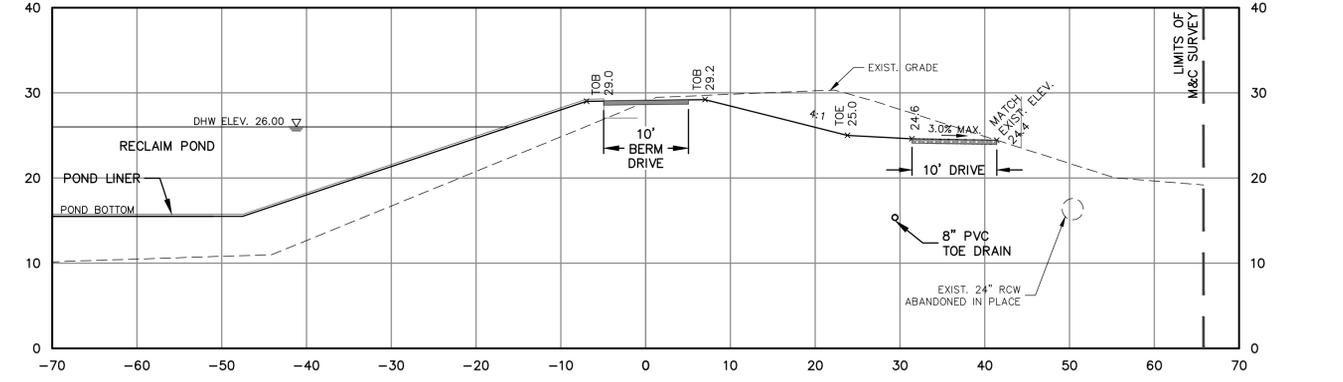
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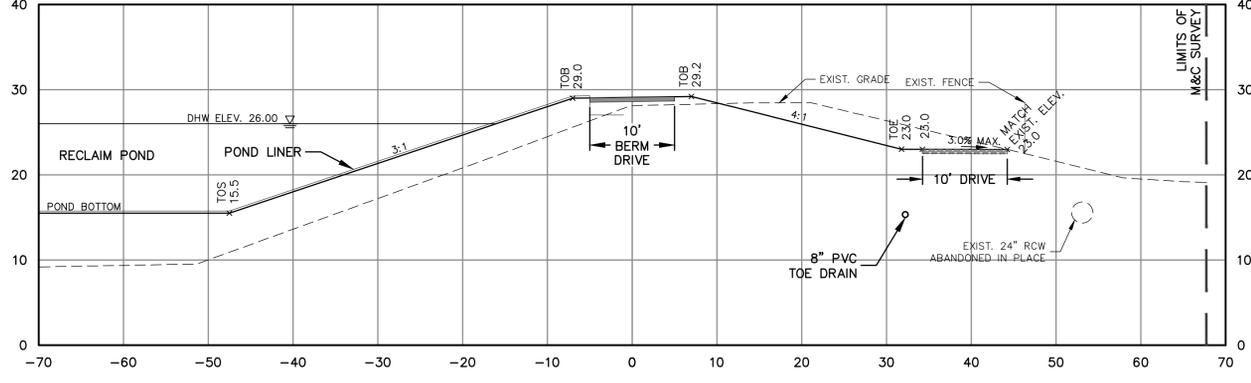
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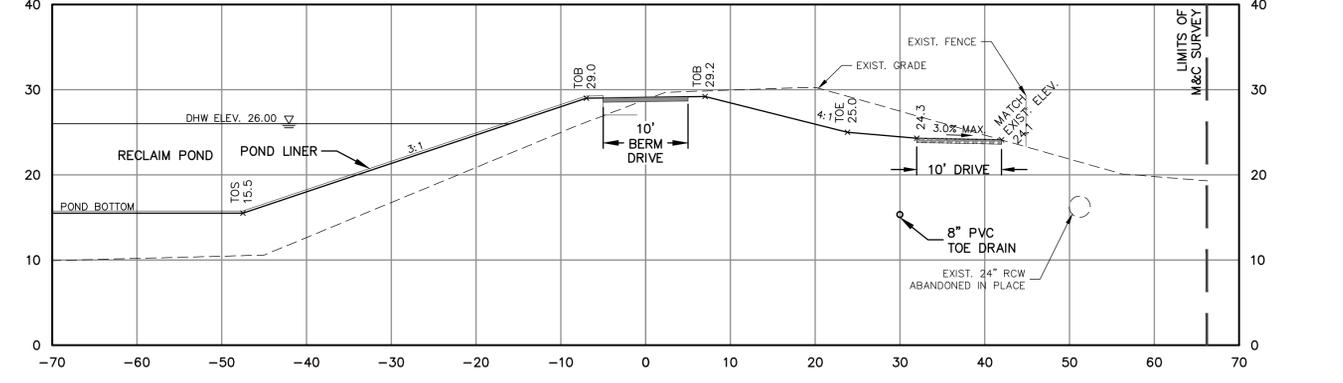
115+00

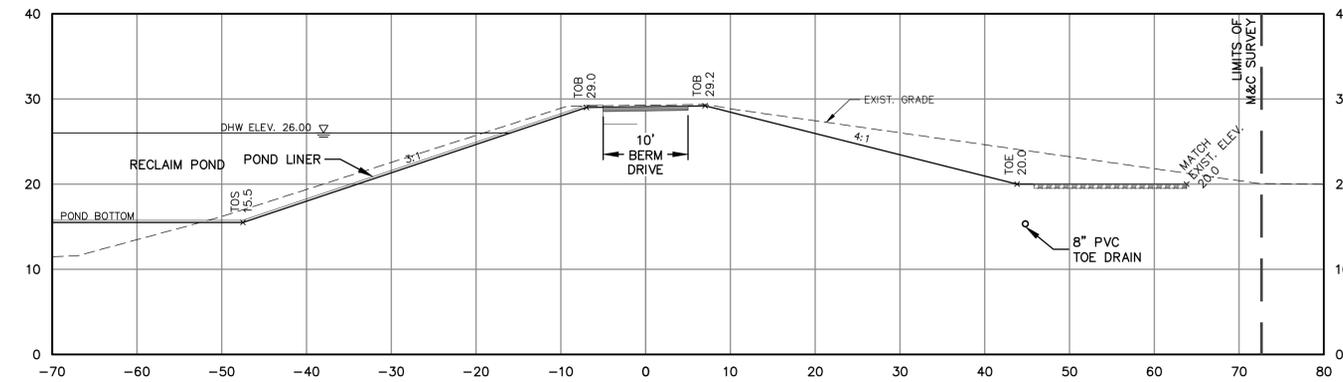

119+00

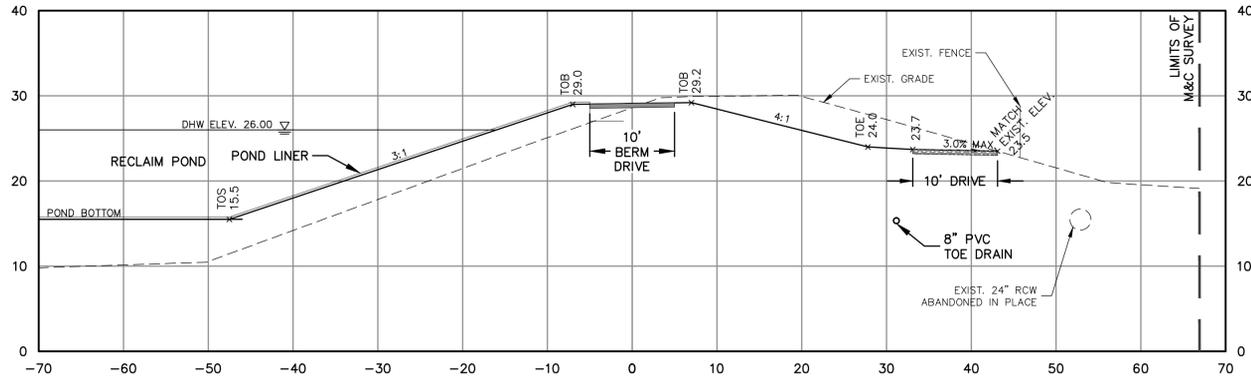

114+00

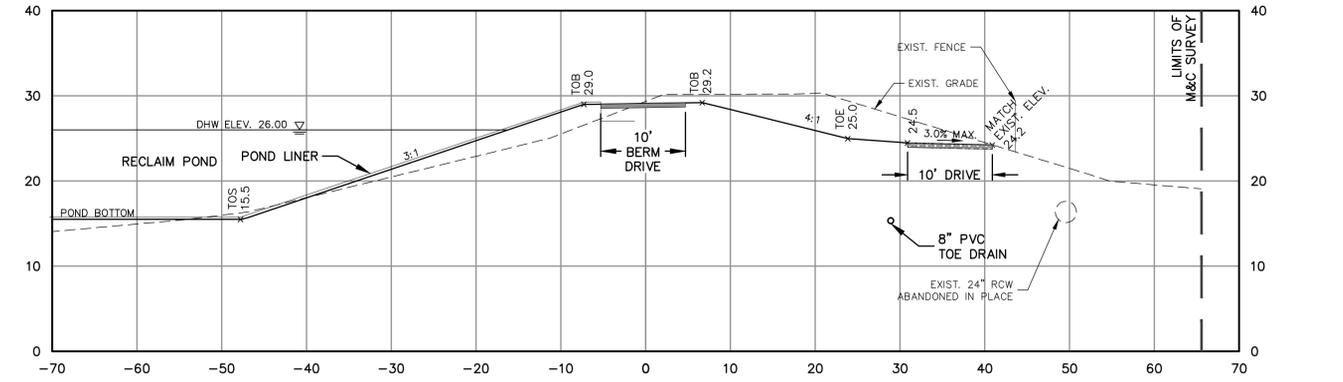

118+00

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 TRAVIS N. TERPSTRA, P.E.
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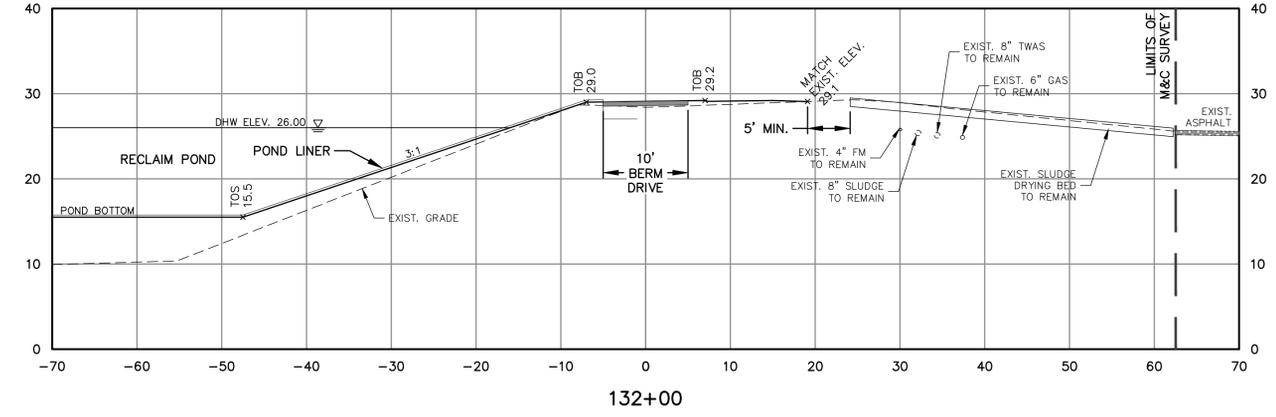
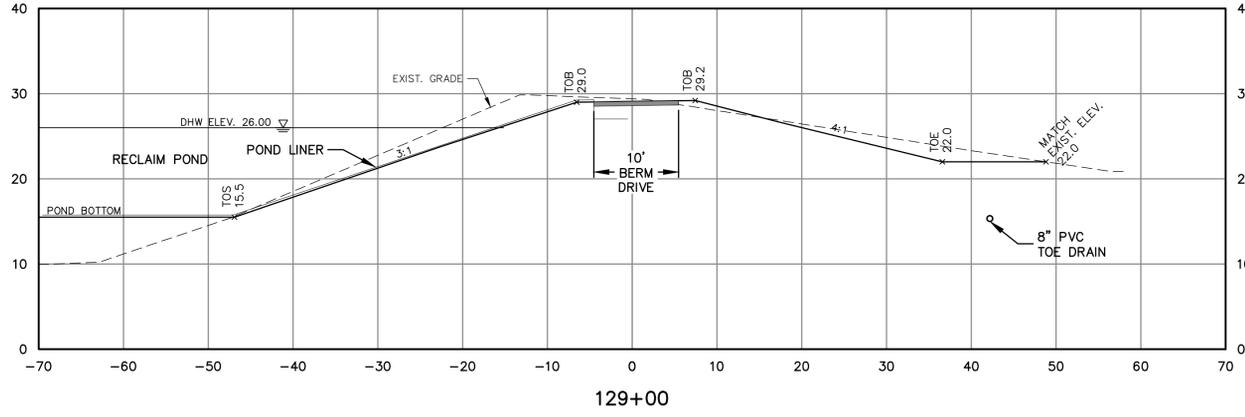
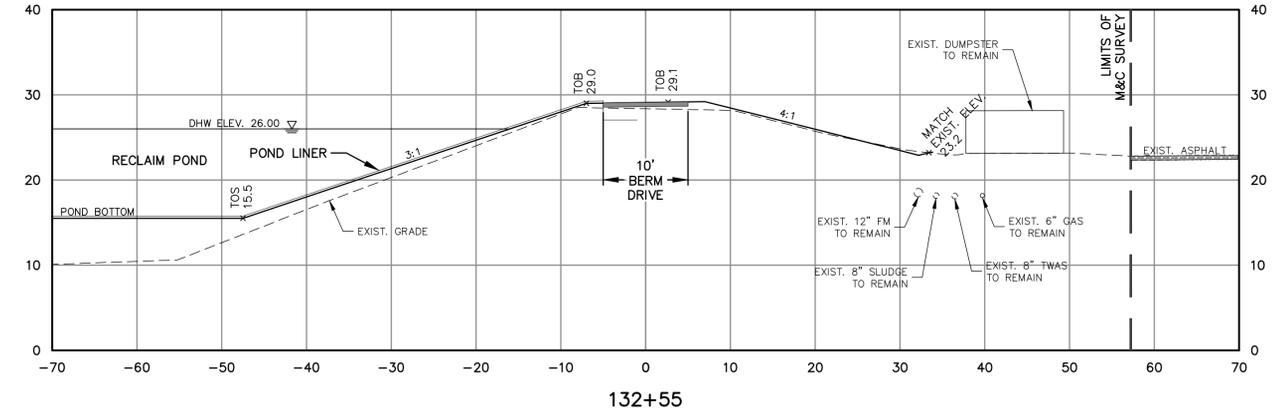
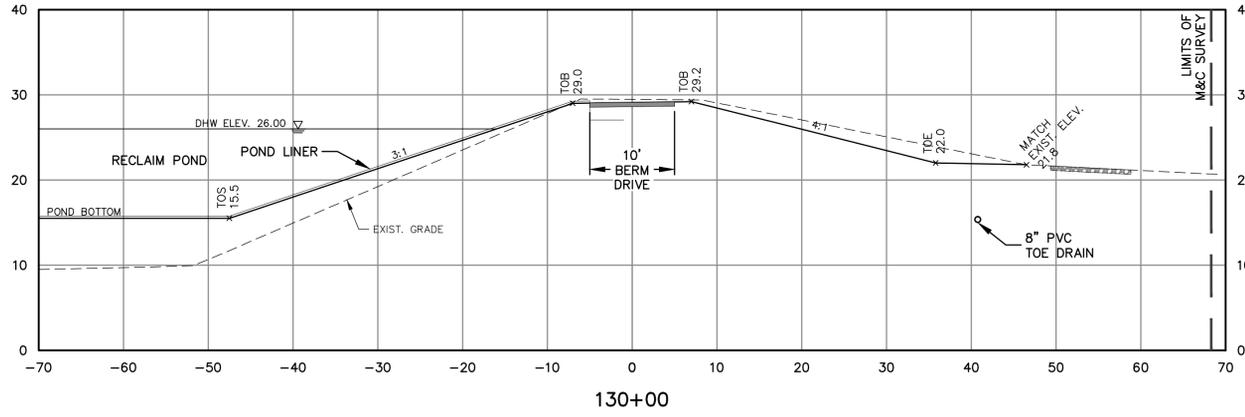
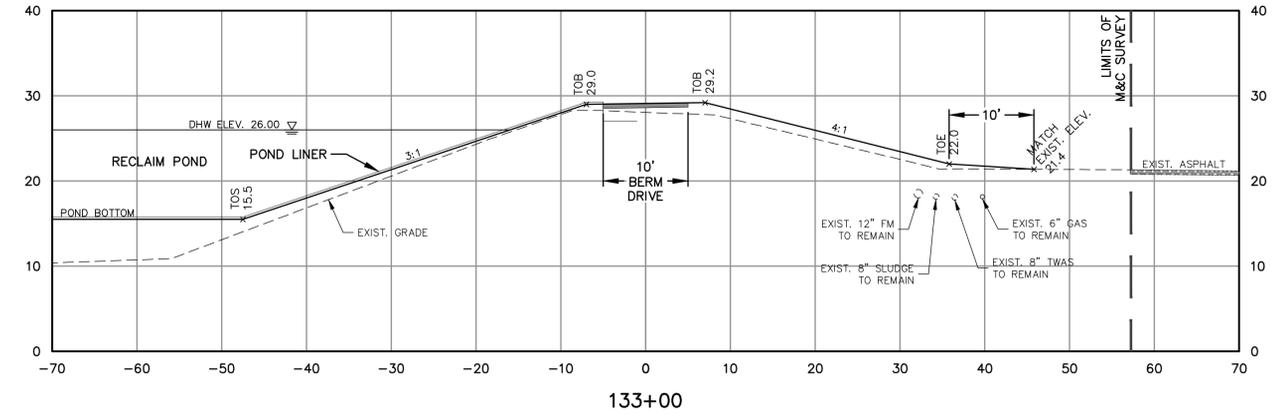
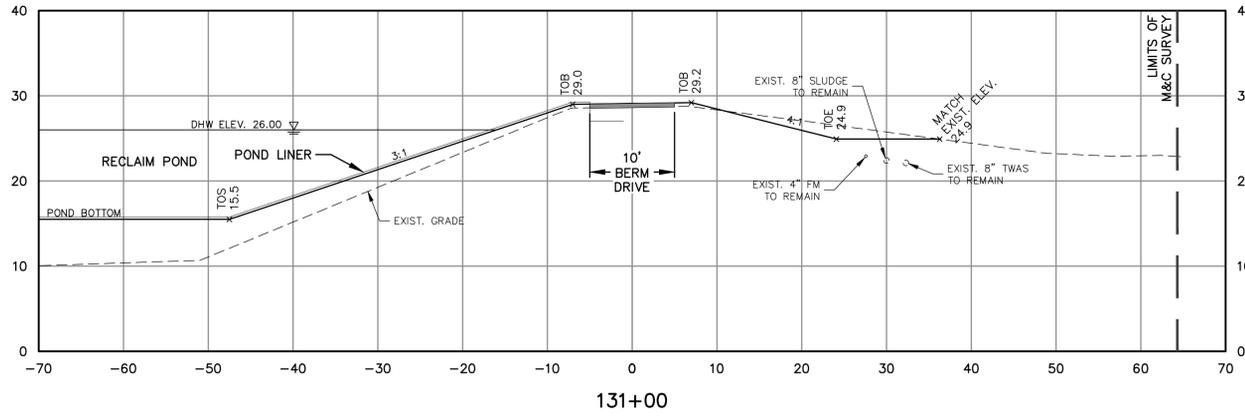
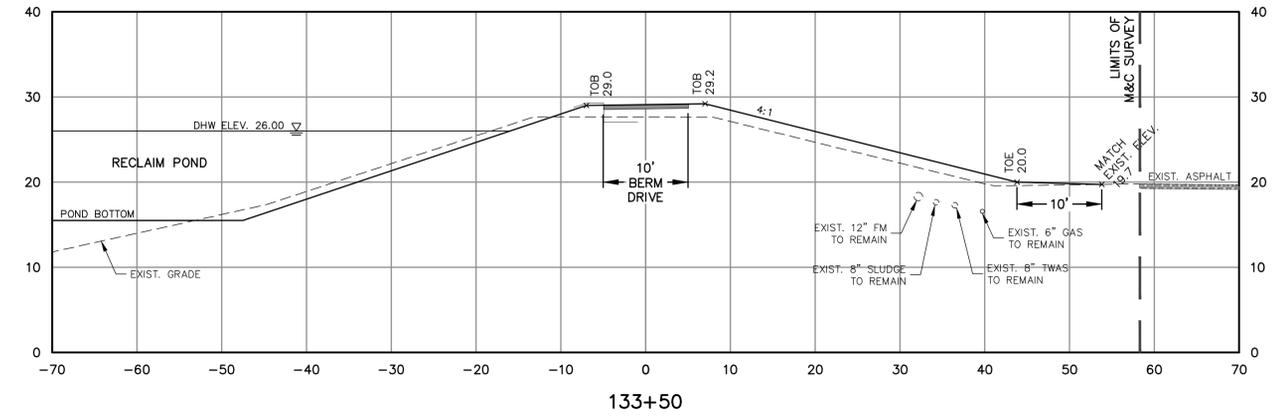
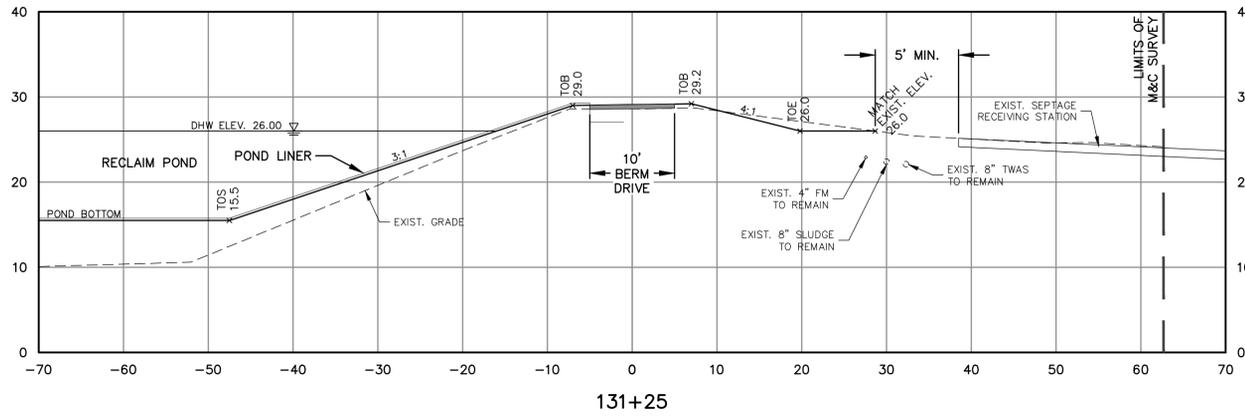
SWRF LAKE FILTRATION AND NORTH POND IMPROVEMENTS
POND SECTIONS No. 3

DATE: FEBRUARY 2012
 MCE PROJ. # 1024-0147
 DRAWN: BFN
 DESIGNED: MSL
 CHECKED: JSL
 PROJ. MGR. MSL

SCALE
 HORIZONTAL: 1" = 10'
 VERTICAL: 1" = 10'

DRAWING NUMBER
C-1.15

STATUS: **ISSUE FOR BID**



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SWWRF LAKE FILTRATION AND NORTH POND IMPROVEMENTS
POND SECTIONS No. 5

DATE: FEBRUARY 2012
 MCE PROJ. # 1024-0147
 DRAWN: BFN
 DESIGNED: MSL
 CHECKED: JSL
 PROJ. MGR. MSL





SCALE
 HORIZONTAL: 1" = 10'
 VERTICAL: 1" = 10'

DRAWING NUMBER
C-1.17

STATUS: **ISSUE FOR BID**



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SCALE: 1"=20' (Horiz.)

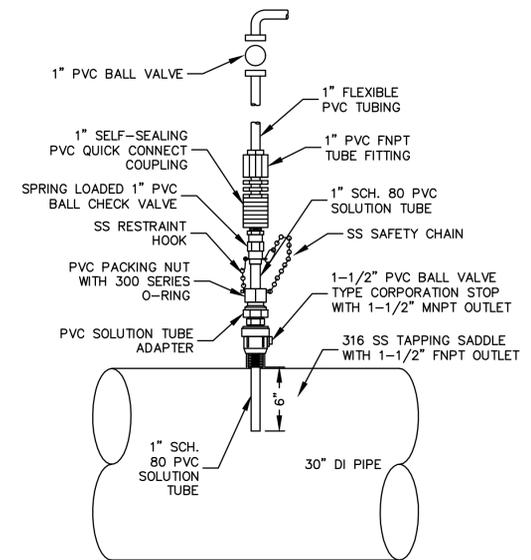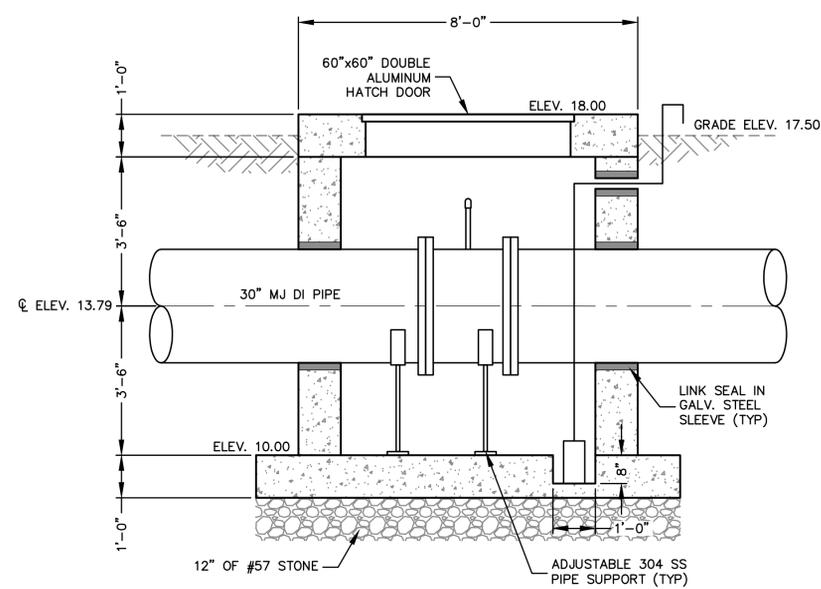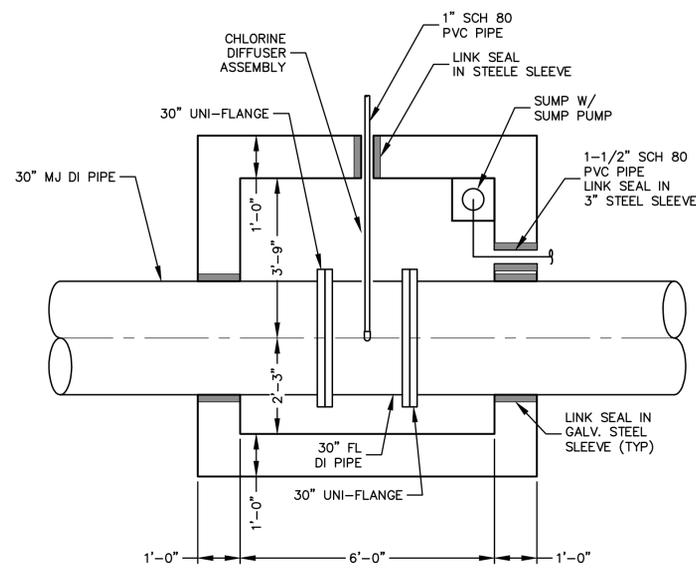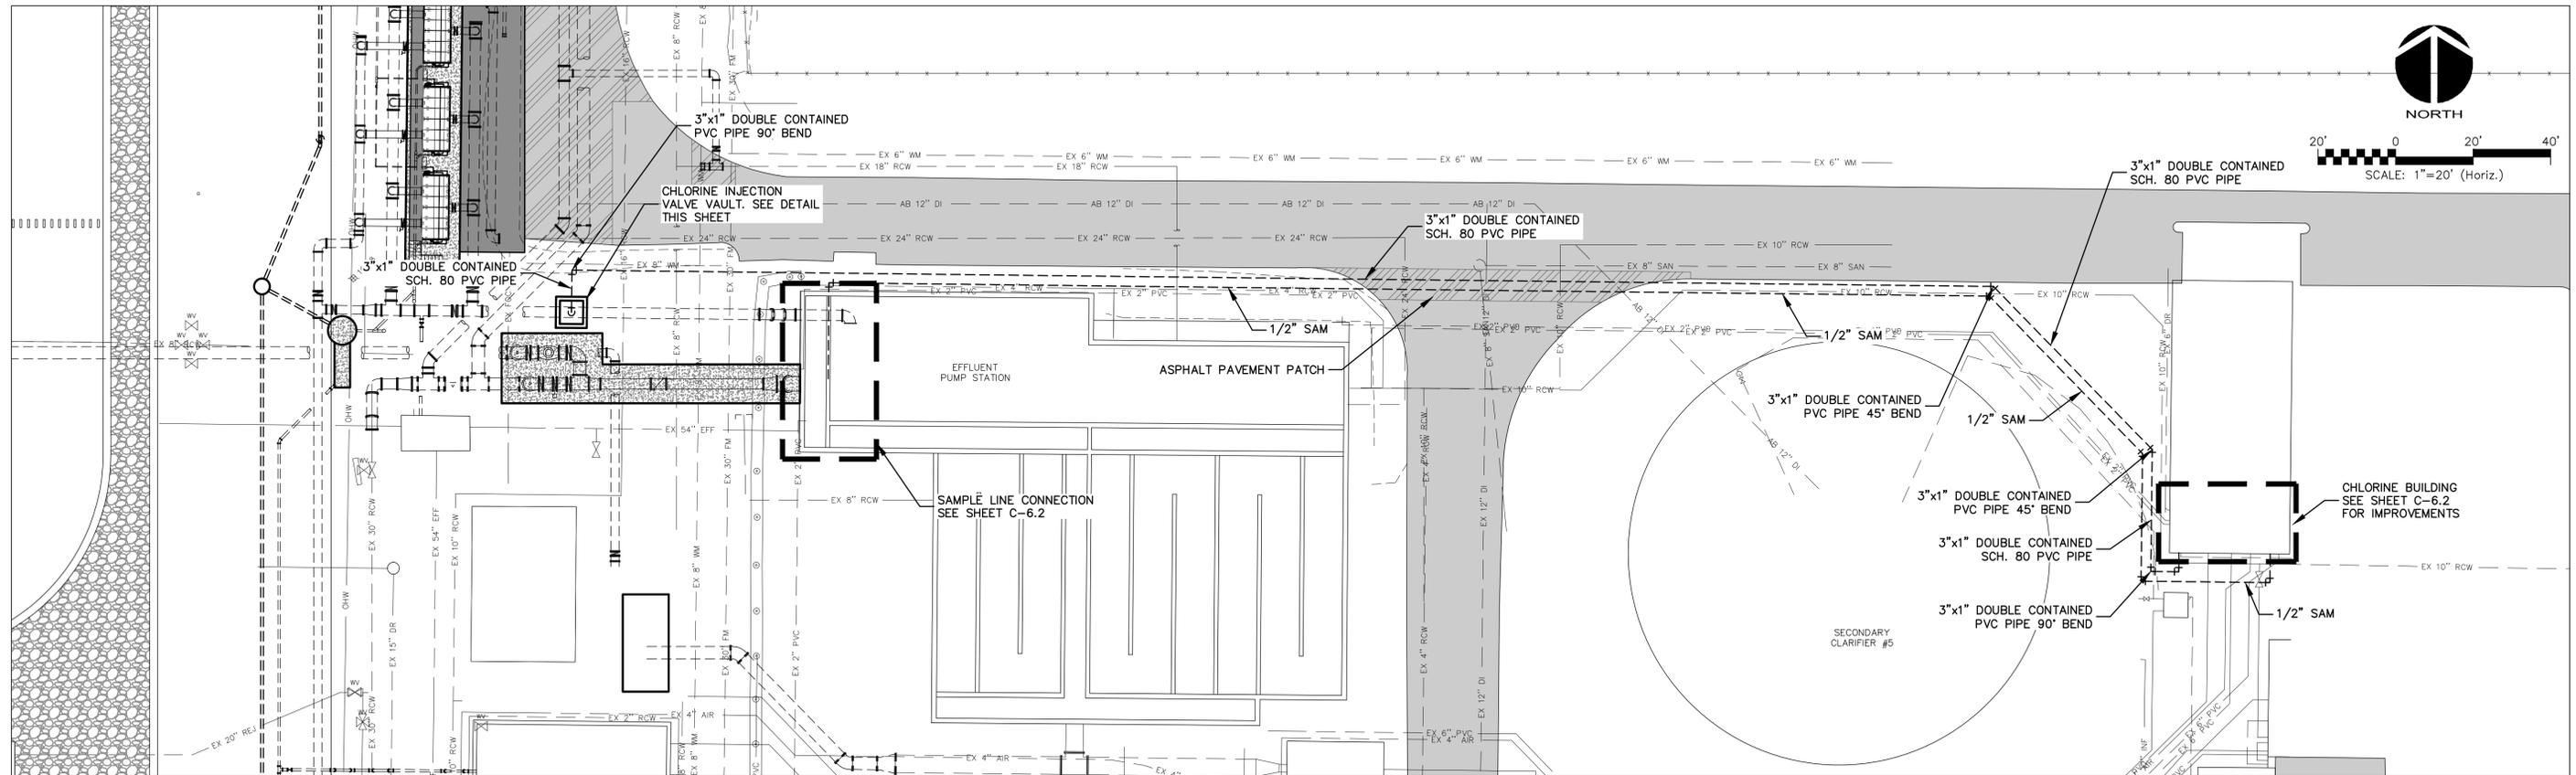

SODIUM HYPOCHLORITE INJECTOR DETAIL

SCALE: NTS

SECTION A/C-6.1

SCALE: 1" = 2'-0"

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REV. NO.	DESCRIPTIONS	DATE

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NORMAN J. SCALLY, P.E.
No. 41338

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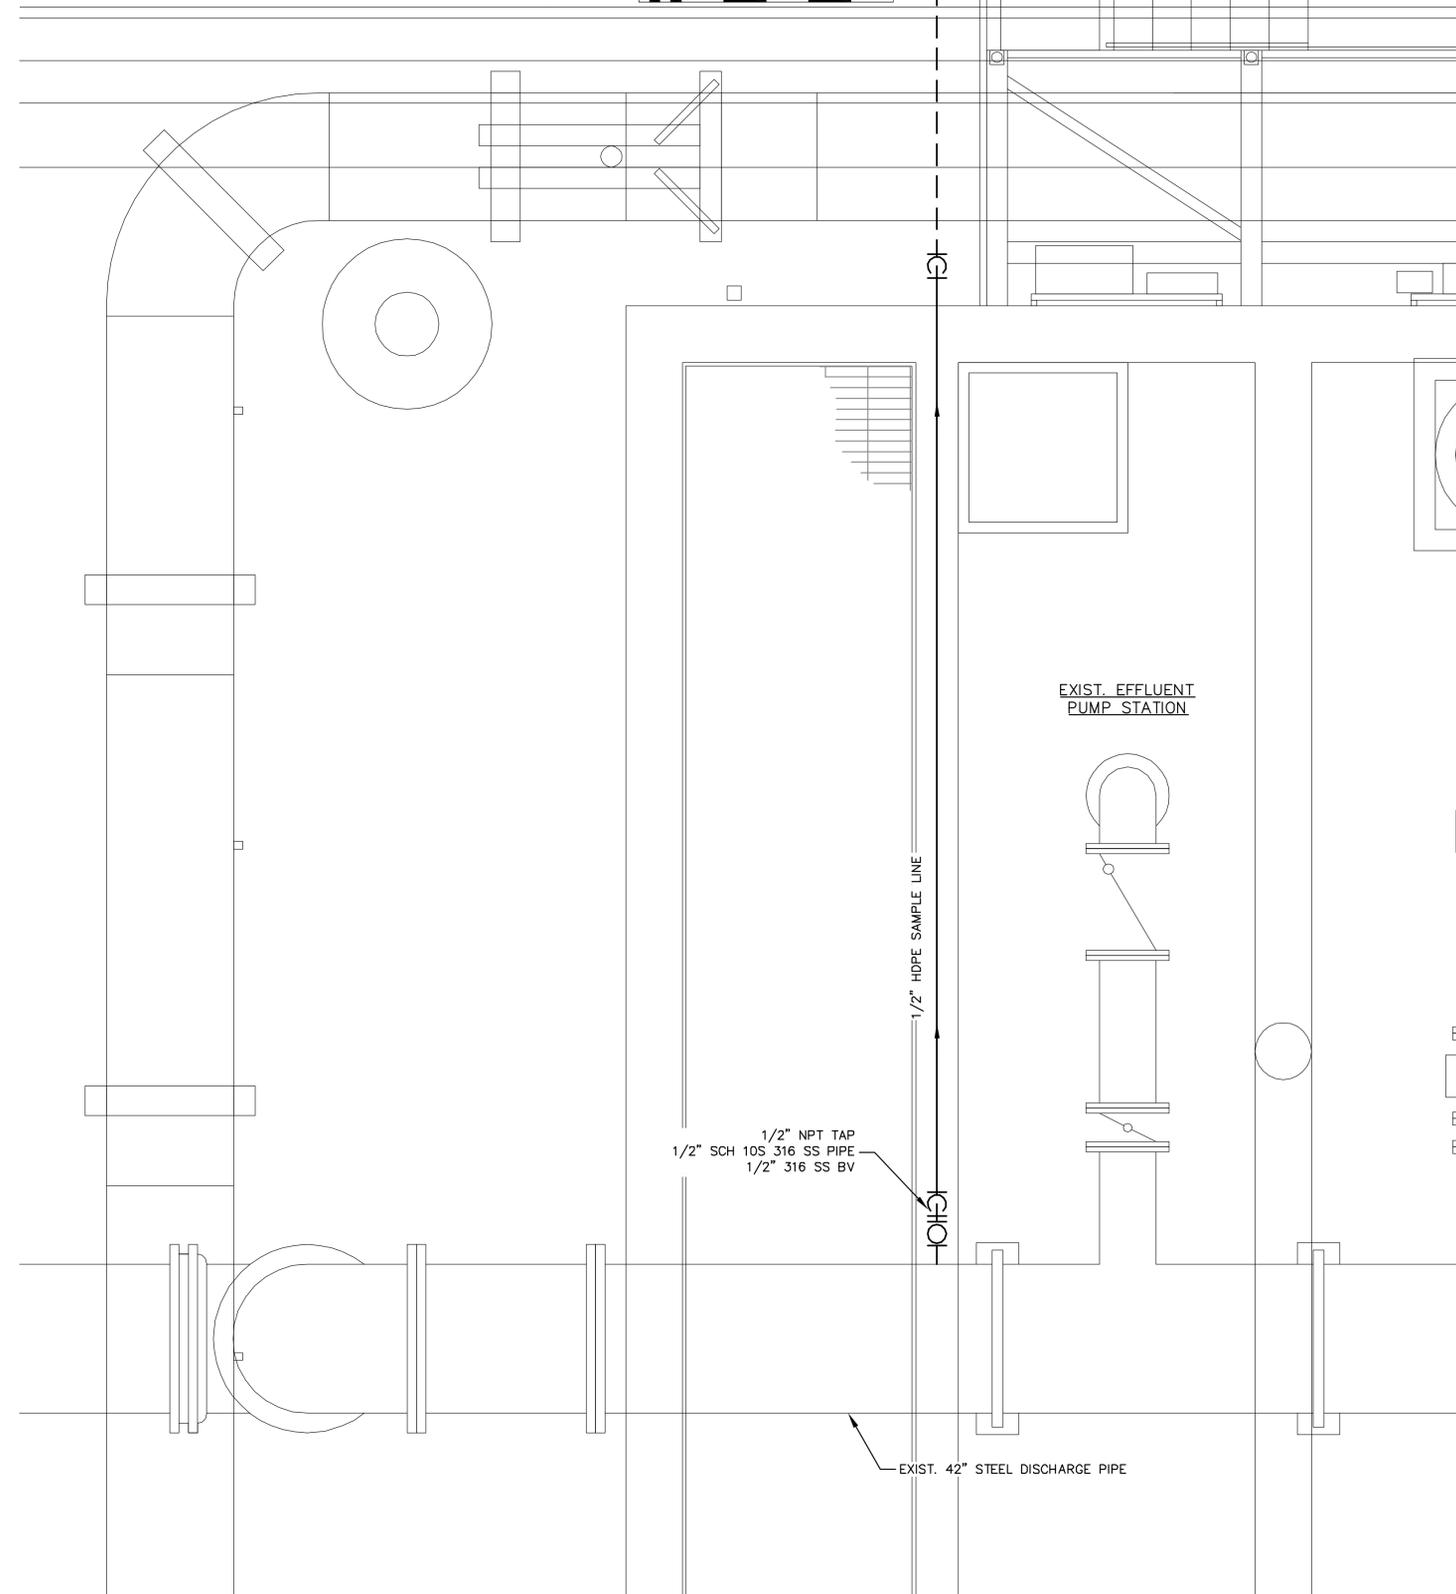
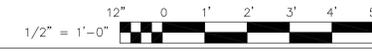
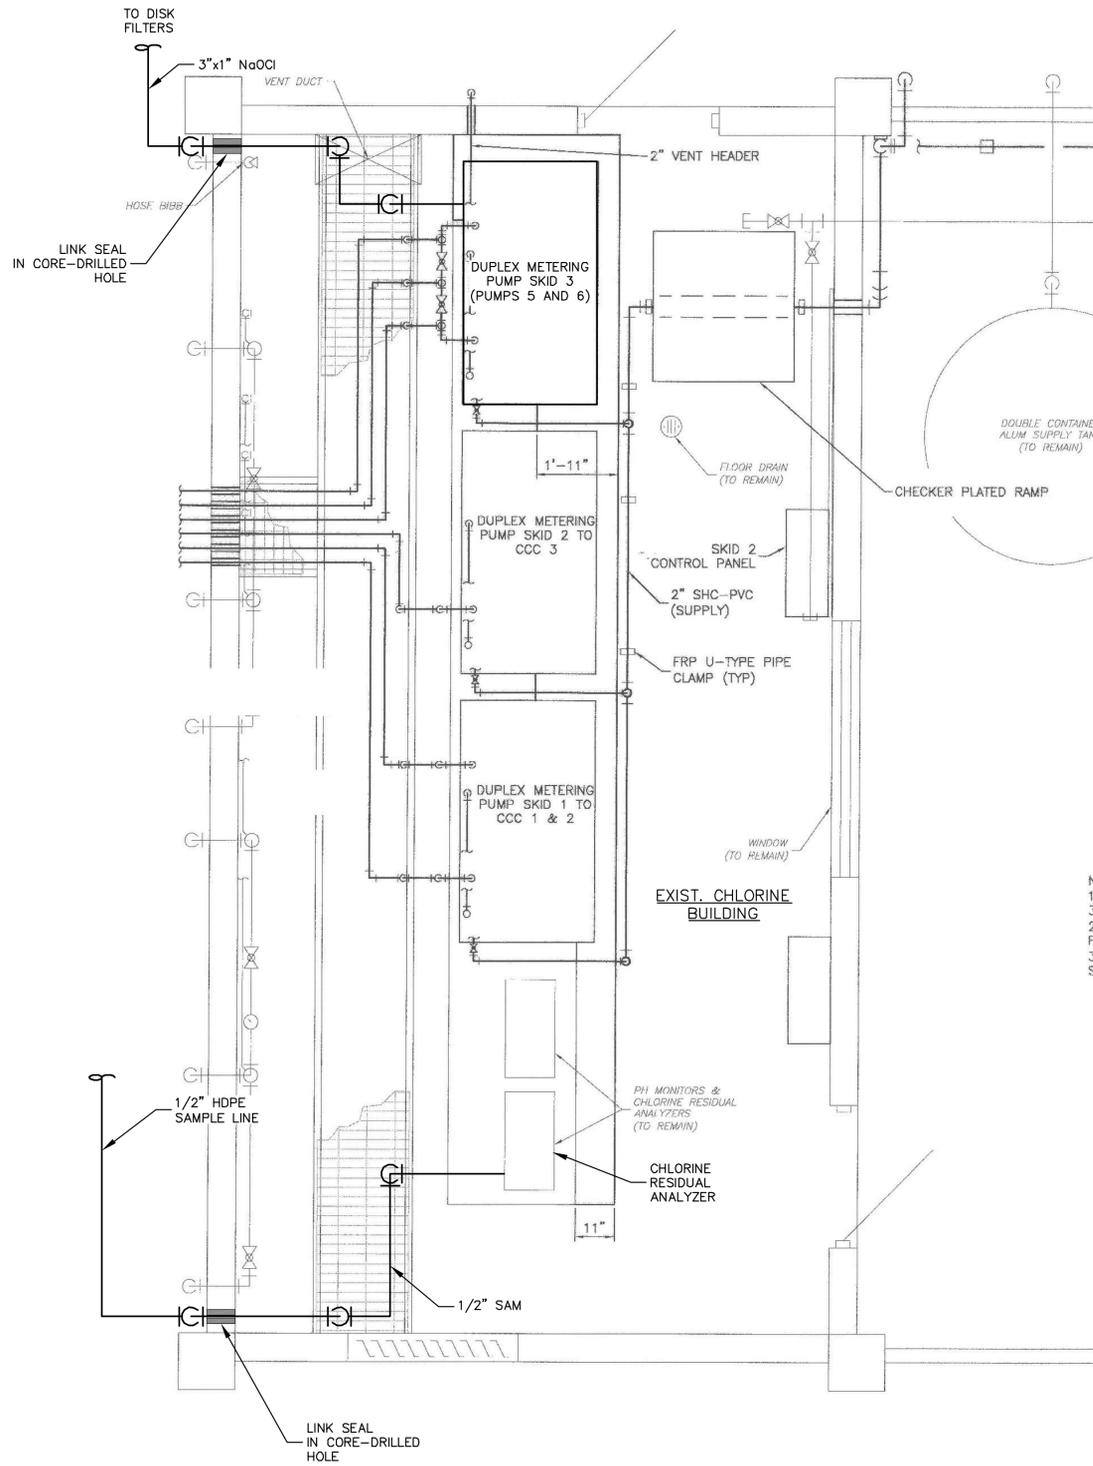
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MANATEE COUNTY, FLORIDA

SWWRF LAKE FILTRATION AND NORTH POND IMPROVEMENTS

CHLORINE INJECTION PIPING

DATE: FEBRUARY 2012	SCALE: HORIZONTAL: 1" = 20'	DRAWING NUMBER: C-6.1
MCE PROJ. # 1024-0147	VERTICAL: NA	
DRAWN: BFN		
DESIGNED: NJS		
CHECKED: JSL		
PROJ. MGR: MSL		
STATUS: ISSUE FOR BID		



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REV. NO.	DESCRIPTIONS	DATE

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SWWRF LAKE FILTRATION AND NORTH POND IMPROVEMENTS

CHLORINE INJECTION DETAILS

DATE: FEBRUARY 2012	SCALE: NA	DRAWING NUMBER: C-6.2
MCE PROJ. # 1024-0147	HORIZONTAL: 1/2" = 1'-0"	REVISION:
DRAWN: BFN	VERTICAL: NA	
DESIGNED: NJS		
CHECKED: JSL		
PROJ. MGR. MSL		
STATUS: ISSUE FOR BID		

STRUCTURAL NOTES:

1.0 GENERAL

1.1 ALL WORK IS TO BE PERFORMED IN A GOOD, WORKMANLIKE AND PROFESSIONAL MANNER.

1.2 ALL CONSTRUCTION SHALL BE IN STRICT COMPLIANCE WITH THE REQUIREMENTS OF THE FLORIDA STATE BUILDING CODE, LATEST EDITION, OR LOCAL BUILDING CODE REQUIREMENTS IF MORE STRINGENT.

1.3 THESE DRAWINGS DO NOT SHOW PROVISIONS FOR SAFETY DURING CONSTRUCTION. IT IS THE RESPONSIBILITY OF THE GENERAL CONTRACTOR TO PROVIDE THE REQUIRED BRACING, SHORING, AND SAFETY DEVICES THROUGHOUT THE CONSTRUCTION OF THIS PROJECT.

2.0 COORDINATION

2.1 STRUCTURAL DRAWINGS SHALL BE USED IN CONJUNCTION WITH AND COORDINATED WITH GENERAL, ARCHITECTURAL, CIVIL, ELECTRICAL AND MECHANICAL DRAWINGS AND OTHER CONTRACT DOCUMENTS.

2.2 COORDINATE THE EXACT SIZE AND LOCATION OF ALL SLEEVES AND OPENINGS THROUGH SLABS AND WALLS w/ GENERAL, ARCHITECTURAL, CIVIL, ELECTRICAL AND MECHANICAL DRAWINGS AND OTHER CONTRACT DOCUMENTS.

2.3 ANY DISCREPANCIES BETWEEN ACTUAL CONDITIONS AND THOSE SHOWN ON THESE DRAWINGS ARE TO BE BROUGHT TO THE ATTENTION OF THE STRUCTURAL ENGINEER BEFORE CONSTRUCTION WORK PROCEEDS, INCLUDING ORDERING AND FABRICATING MATERIALS.

2.4 INDEPENDENT TESTING OF MATERIALS SHALL BE PROVIDED AS DEFINED IN PROJECT SPECIFICATIONS. IN GENERAL PROJECT INVOLVES THE FOLLOWING:
A. CONCRETE.

2.5 IF COORDINATION OF INFORMATION PRESENTED CONFLICTS w/ THE PROJECT SPECIFICATIONS, THE DRAWINGS WILL TAKE PRECEDENCE.

2.6 IN GENERAL CALL-OUTS ARE FOR NEW CONSTRUCTION U.N.O.. EXISTING CONSTRUCTION CALL-OUTS, ELEVATIONS AND DIMENSIONS OF EXISTING STRUCTURES ARE BASED ON EXISTING RECORD DRAWINGS PROVIDED TO MCKIM & CREED. THE (*) SYMBOL ON INDIVIDUAL FACILITY "STRUCTURAL" DRAWINGS INDICATES EXISTING CONSTRUCTION CALL-OUTS, CONDITIONS, ELEVATIONS AND DIMENSIONS TO BE FIELD VERIFIED BY THE GENERAL CONTRACTOR U.N.O. PRIOR TO CONSTRUCTION, INCLUDING ORDERING AND FABRICATING MATERIALS. RECORD DRAWINGS PROVIDED BY THE MANATEE CO. PUBLIC UTILITIES DEPARTMENT UTILIZED INCLUDES:
A. NONE UTILIZED.

3.0 FOUNDATIONS

3.1 DESIGN ALLOWABLE SOIL BEARING PRESSURE - 1,000 PSF IN ACCORDANCE WITH THE GEOTECHNICAL REPORT AS PREPARED BY PROFESSIONAL SERVICES INDUSTRIES, INC. (PROJECT NO. 775-871 DATED MARCH 31, 2011). THE CONTRACTOR IS RESPONSIBLE FOR VERIFYING THIS VALUE PRIOR TO FOUNDATION CONSTRUCTION. IN AREAS WHERE THE SOIL DOES NOT YIELD THIS BEARING STRESS VALUE, ADJUSTMENT IN THE FOOTING OR BASE SLAB DEPTHS AND FOUNDATION DIMENSION MAY BE MADE BY THE ENGINEER BEFORE WORK PROCEEDS. CONTRACTOR IS RESPONSIBLE FOR PERFORMING ANY SUCH ADJUSTMENTS.

3.2 PREPARE THE EXISTING SUBGRADE IN ACCORDANCE w/ THE GEOTECHNICAL REPORT AS PREPARED BY PROFESSIONAL SERVICES INDUSTRIES, INC. (PROJECT NO. 775-871 DATED MARCH 31, 2011). IN THE EVENT UNUSUAL SOIL CONDITIONS ARE UNCOVERED, INCLUDING CONDITIONS THAT DEVIATE FROM THOSE DESCRIBED IN THE GEOTECHNICAL REPORT, NOTIFY THE OWNER AND ENGINEER PRIOR TO FOUNDATION CONSTRUCTION FOR INSTRUCTIONS HOW TO PROCEED. ADJUSTMENT IN THE FOOTING OR BASE SLAB DEPTHS AND GENERAL FOUNDATION CONSTRUCTION MAY BE MADE BY THE ENGINEER BEFORE WORK PROCEEDS. CONTRACTOR IS RESPONSIBLE FOR PERFORMING ANY SUCH ADJUSTMENTS.

3.3 ALL FILL INSIDE THE BUILDING(S) AND BELOW FOUNDATIONS SHALL BE SELECT MATERIAL FREE FROM ROOTS, TRASH, WOOD SCRAPS, AND OTHER EXTRANEOUS MATERIALS. PLACE FILL IN LIFTS NOT EXCEEDING THE RECOMMENDATIONS OF THE GEOTECHNICAL REPORT AS PREPARED BY PROFESSIONAL SERVICES INDUSTRIES, INC. (PROJECT NO. 775-871 DATED MARCH 31, 2011).

3.4 FOOTING ELEVATIONS SHALL NOT BE RAISED OR LOWERED WITHOUT APPROVAL OF THE STRUCTURAL ENGINEER.

3.5 ALL EXCAVATIONS SHALL BE ADEQUATELY DEWATERED BEFORE PLACEMENT OF CONCRETE. NO CONCRETE OR CONCRETE FILL SHALL BE PLACED IN STANDING WATER. WATER ACCUMULATION EXCEEDING 1 INCH SHALL BE PUMPED OUT.

3.6 FOOTING EXCAVATIONS AND FORMS SHALL BE REVIEWED BY AN OWNER'S CONSTRUCTION REPRESENTATIVE PRIOR TO PLACEMENT OF CONCRETE.

3.7 ALL FOOTINGS SHALL BE CENTERED UNDER THE SUPPORTING MEMBER UNLESS NOTED OTHERWISE.

3.8 CONSTRUCTION JOINTS IN SLABS, WALLS & FOOTINGS SHALL BE MADE AT LOCATIONS SHOWN ON DRAWINGS.

3.9 ANCHOR BOLTS SHALL BE SET BY MEANS OF TEMPLATE. "FLOATING" ANCHOR BOLTS INTO PLACE IS PROHIBITED.

3.10 CONTRACTOR IS TO VERIFY THE ELEVATION AND LOCATION OF ALL EXISTING AND PROPOSED UTILITIES PRIOR TO CONSTRUCTION. ANY "KNOWN" UTILITY LINES DAMAGED WILL BE REPLACED AT THE CONTRACTOR'S EXPENSE. IF ANY "UNKNOWN" UTILITY LINES ARE ENCOUNTERED WHEN EXCAVATING THE CONTRACTOR IS TO CEASE ALL EXCAVATION ACTIVITY UNTIL THE ENGINEER AND OWNER ARE NOTIFIED AND INSTRUCTIONS ARE PROVIDED ABOUT HOW TO PROCEED.

3.11 THE CONTRACTOR SHALL OBTAIN THE OWNER'S PERMISSION BEFORE ENCASED OR BACK FILLING AROUND ANY EXISTING UNDERGROUND STRUCTURE, PIPING, ELECTRICAL, OR OTHER UNDERGROUND WORK.

4.0 REINFORCING STEEL

4.1 BARS SHALL BE ROLLED FROM NEW BILLET-STEEL OF DOMESTIC MANUFACTURE CONFORMING TO "STANDARD SPECIFICATION FOR DEFORMED AND PLAIN BILLET STEEL BARS FOR CONCRETE REINFORCEMENT," ASTM A 615, GRADE 60 AND SUPPLEMENTARY REQUIREMENT S-1.

4.2 DETAIL AND FABRICATE REINFORCING STEEL IN ACCORDANCE WITH THE AMERICAN CONCRETE INSTITUTE "ACI DETAILING MANUAL," LATEST PUBLICATION.

4.3 REINFORCING STEEL IN PLACE SHALL BE REVIEWED BY THE OWNER'S CONSTRUCTION REPRESENTATIVE PRIOR TO PLACEMENT OF CONCRETE. IN GENERAL "CLR" DISTANCES FOR CONCRETE COVER ARE PROVIDED ON THE DRAWINGS IN THE SECTIONS & DETAILS. FOR SECTIONS & DETAILS w/OUT CONCRETE COVER FOR REINFORCING BARS REFERENCE THE PROJECTS SPECIFICATIONS.

4.4 WELDED WIRE FABRIC SHALL CONFORM TO "STANDARD SPECIFICATION FOR WELDED STEEL WIRE FABRIC FOR CONCRETE REINFORCEMENT," ASTM A-185.

4.5 PLACE WELDED WIRE FABRIC AT CENTER OF SLABS-ON-GRADE UNLESS NOTED OTHERWISE.

4.6 PROVIDE BARS AT CORNERS AND INTERSECTIONS OF SLAB THK'D T/D EDGES, WALLS & FOOTINGS OF THE SAME NUMBER AND SIZE AS LONGITUDINAL BARS, U.N.O. ON THE DRAWINGS.

4.7 FABRICATE CONTINUOUS BARS IN SLABS, WALLS & FOOTINGS TO THE LONGEST PRACTICABLE LENGTHS.

4.8 REINFORCING STEEL SHALL NOT BE BENT AFTER BEING PARTIALLY EMBEDDED IN HARDENED CONCRETE.

4.9 BARS SHALL BE COLD BENT AND SHALL NOT BE HEATED FOR ANY REASON.

4.10 REINFORCING BARS SHALL NOT BE WELDED UNLESS NOTED OTHERWISE ON THE DRAWINGS.

4.11 REFERENCE DRAWINGS FOR REQUIREMENTS FOR LAP REINFORCING STEEL IN CONCRETE. ALL "LCS" SHALL CONFORM TO CLASS B SPLICE CRITERIA. IT IS ACCEPTABLE TO LAP REINFORCING IN NON "LCS" STRUCTURES A MINIMUM 50 BAR DIAMETERS, UNLESS NOTED OTHERWISE.

4.12 LAP SPLICED BARS IN CONCRETE ARE TO BE WIRE TIED.

5.0 CONCRETE

5.1 IN GENERAL CONCRETE SHALL DEVELOP 3,000 TO 4,500 PSI MINIMUM COMPRESSIVE STRENGTH AT 28 DAYS. REFERENCE "DESIGN CRITERIA" THIS DWG. & PROJECT SPECIFICATIONS, FOR APPLICATION & SPECIFIC CONCRETE MIX DESIGN REQUIREMENTS.

5.2 CONCRETE WORK SHALL CONFORM TO "BUILDING CODE REQUIREMENTS FOR REINFORCED CONCRETE", ACI 318 & TO "CODE REQUIREMENTS FOR ENVIRONMENTAL ENGINEERING CONCRETE STRUCTURES", ACI 350 (LATEST EDITIONS).

5.3 PLACE 1/2 INCH EXPANSION JOINT MATERIAL BETWEEN EDGES OF SLABS AND VERTICAL SURFACES UNLESS NOTED OTHERWISE.

5.4 PROVIDE CONSTRUCTION OR CONTROL JOINTS IN SLABS & WALLS AT LOCATIONS SHOWN ON DRAWINGS, AT OFFSETS AND CHANGES IN DIRECTION AND AT THIRTY (30) FEET MAXIMUM U.N.O.. GENERAL CONTRACTOR TO PROVIDE CONSTRUCTION JOINT LAYOUT PLAN PER THE PROJECT SPECIFICATIONS PRIOR TO CONSTRUCTION, INCLUDING ORDERING & FABRICATING MATERIALS.

5.5 CHAMFER EXPOSED EDGES OF CONCRETE 3/4 INCH, UNLESS NOTED OTHERWISE.

5.6 CONTRACTOR SHALL BE RESPONSIBLE FOR PROPER CURING OF ALL CONCRETE. CURING METHODS SHALL CONFORM TO "BUILDING CODE REQUIREMENTS FOR REINFORCED CONCRETE", ACI 318, "CODE REQUIREMENTS FOR ENVIRONMENTAL ENGINEERING CONCRETE STRUCTURES" ACI 350 AND "STANDARD PRACTICE FOR CURING CONCRETE," ACI 308, LATEST EDITIONS.

5.7 UNLESS NOTED OTHERWISE DOWELS SHALL BE THE SAME NUMBER AND SIZE AS THE LARGEST VERTICAL BAR TO WHICH THEY ARE SPLICED.

5.8 REFERENCE PROJECT SPECIFICATIONS FOR REQUIRED FINISHES.

5.9 BONDING AGENT TO BE STRUCTURAL EPOXY ADHESIVE CONFORMING TO ASTM C-881 TYPE I AND II, GRADE 2, CLASS B AND C WITH A MINIMUM BOND STRENGTH OF 1900 PSI.

5.10 CONTRACTOR SHALL SUBMIT REBAR SHOP DRAWINGS FOR APPROVAL TO OWNER PRIOR TO FABRICATION. DO NOT FABRICATE REINFORCING PRIOR TO RECEIPT OF APPROVED SHOP DRAWINGS.

5.11 ROUGHEN THE "BASE" CONCRETE POUR SURFACE TO A FULL AMPLITUDE OF 1/4" MINIMUM, WHERE NOTED ON THE CONSTRUCTION DRAWINGS.

5.12 CONCRETE MIXES TO BE REVIEWED BY THE OWNER'S CONSTRUCTION REPRESENTATIVE PRIOR TO PLACEMENT OF CONCRETE. COMPRESSIVE STRENGTH TEST CYLINDERS TO BE REVIEWED BY THE OWNER'S CONSTRUCTION REPRESENTATIVE THROUGHOUT CONCRETE CONSTRUCTION OF THE PROJECT.

5.13 CONCRETE ACCESSORIES AS FOLLOWS:
a.) PREFORMED WATERSTOPS SHALL BE PVC IN ACCORDANCE w/ THE PROJECT SPECIFICATIONS.
b.) EXPANSIVE WATERSTOPS SHALL BE ADEKA ULTRA SEAL TYPE MC-2010M. THE WATERSTOP CAN BE EITHER ADHERED TO THE CONCRETE WITH 3M-2141 BONDING ADHESIVE OR NAILED IN PLACE USING 1.5 INCH CONCRETE NAILS 3 TO 6 INCHES APART.
c.) CAULK/SEALANT - SONOLASTIC (2) PART POLYSULFIDE.
d.) BONDING AGENT - SHALL BE STRUCTURAL EPOXY ADHESIVE CONFORMING TO ASTM C-881 TYPE I STRENGTH AND II, GRADE 2, CLASS B AND C WITH A MINIMUM BOND STRENGTH OF 1900 PSI.
1.) SIKA ARMATECT 110 EpoCem.

6.0 GROUT

6.1 PROVIDE NON-SHRINK GROUT UNDER ALL COLUMN BASE PLATES AND BEAM BEARING PLATES AND ELSEWHERE AS INDICATED ON DRAWINGS. NON-SHRINK GROUT SHALL CONFORM TO ASTM C 1107.

6.2 GROUT SHALL BE NON-METALLIC AND NON-STAINING AND HAVE A MINIMUM COMPRESSIVE STRENGTH OF 7000 PSI.

7.0 MASONRY (NOT APPLICABLE)

8.0 STRUCTURAL STEEL

8.1 STEEL SHALL CONFORM TO "STANDARD SPECIFICATION FOR STRUCTURAL STEEL," ASTM A-36 (Fy=36 ksi) FOR ANGLES, PLATES AND CHANNEL SECTIONS, WIDE FLANGE SECTIONS SHALL CONFORM TO ASTM A-572 (Fy=50ksi). HOLLOW STEEL SECTIONS (HSS) SHALL CONFORM TO ASTM A500, GRADE B (Fy=46 ksi). STEEL PIPE SHALL CONFORM TO ASTM A-53, GRADE B, (Fy=35 ksi).

8.2 STEEL WORK SHALL CONFORM TO "SPECIFICATION FOR THE DESIGN, FABRICATION AND ERECTION OF STRUCTURAL STEEL BUILDINGS", OF THE AMERICAN INSTITUTE OF STEEL CONSTRUCTION, INC., (LATEST EDITION), INCLUDING ALL SUPPLEMENTS AND THE "CODE OF STANDARD PRACTICE FOR STEEL BUILDINGS AND BRIDGES", (LATEST EDITION).

8.3 CONNECTION BOLTS SHALL BE 3/4 INCH DIAMETER CONFORMING TO "STANDARD SPECIFICATION FOR HIGH-STRENGTH BOLTS FOR STRUCTURAL STEEL JOINTS", ASTM A-325, UNLESS NOTED OTHERWISE CONNECTIONS ARE BEARING TYPE WITH THREADS EXCLUDED FROM SHEAR PLANES-(A-325x).

8.4 WELDING SHALL BE IN ACCORDANCE WITH THE LATEST EDITION OF THE AMERICAN WELDING SOCIETY AWS D1.1 "STRUCTURAL WELDING CODE", WELDING SHALL BE PERFORMED BY CERTIFIED PERSONNEL WHO HAVE BEEN PREVIOUSLY QUALIFIED BY TEST PRESCRIBED IN THE AWS "STRUCTURAL WELDING CODE". ELECTRODES SHALL CONFORM TO AWS 5.5, E70XX.

8.5 LINTELS SHALL BEAR EIGHT (8) INCHES MINIMUM ON MASONRY UNLESS NOTED OTHERWISE.

8.6 THE CONTRACTOR SHALL PROVIDE ADEQUATE TEMPORARY BRACING, SHORING, AND QUINING OF STEEL FRAMING AGAINST WIND, CONSTRUCTION LOADS, AND OTHER TEMPORARY FORCES UNTIL SUCH PROTECTION IS NO LONGER REQUIRED FOR THE SAFE SUPPORT OF THE FRAMING.

8.7 ALL COPES, BLOCKS, CUTS, CUT-OFFS AND OTHER CUTTING OF STRUCTURAL MEMBERS SHALL HAVE ALL RE-ENTRANT CORNERS SHAPED, AND NOTCH-FREE TO A RADIUS OF AT LEAST 1/2 INCH. THE FILLET AND ITS CONTIGUOUS CUTS SHALL MEET WITHOUT OFFSET OR CUTTING PAST THE POINT OF TANGENCY.

8.8 ANCHOR BOLTS SHALL BE ASTM F-1554 OR A-36 (NON-HEADED) AND SHALL HAVE HOOKS AS REQUIRED BY THE DRAWINGS. PROVIDE TWO (2) NUTS AND WASHERS WITH EACH ANCHOR BOLT AT COLUMNS UNLESS NOTED OTHERWISE.

8.9 OVERSIZED AND SLOTTED HOLES SHALL NOT BE USED FOR BOLTED CONNECTIONS ON THIS PROJECT EXCEPT AT LOCATIONS NOTED ON DRAWINGS.

8.10 SPLICING OF STRUCTURAL STEEL MEMBERS IS PROHIBITED WITHOUT THE APPROVAL OF THE STRUCTURAL ENGINEER, AS TO LOCATION AND TYPE OF SPLICE. ANY MEMBER HAVING A SPLICE NOT SHOWN AND DETAILED ON THE SHOP DRAWINGS WILL BE REPLACED.

8.11 PRE-GROUTING BASE PLATES IS NOT PERMITTED.

8.12 ALL HOLES IN STRUCTURAL STEEL ARE TO BE PUNCHED OR DRILLED. FLAME CUTTING OF STEEL IS STRICTLY PROHIBITED.

8.13 ALL DESIGN, DETAILING, FABRICATION AND ERECTION SHALL BE IN ACCORDANCE WITH THE LATEST EDITION OF THE AMERICAN INSTITUTE OF STEEL CONSTRUCTION (AISC) MANUAL OF STEEL CONSTRUCTION.

8.14 STRUCTURAL STEEL ERECTION SHALL BE REVIEWED BY THE OWNER'S CONSTRUCTION REPRESENTATIVE.

8.15 IN GENERAL SHOP CONNECTIONS SHALL BE EITHER WELDED OR BOLTED AND FIELD CONNECTIONS SHALL BE BOLTED UNLESS NOTED OTHERWISE.

8.16 FABRICATOR/CONTRACTOR SHALL SUBMIT SHOP DRAWINGS FOR OWNER/ENGINEER APPROVAL PRIOR TO FABRICATION. ALL SHOP DRAWINGS MAY BE EXPEDITED IF THE FABRICATOR ADHERES CLOSELY TO THE DETAILS, NOTES, AND INSTRUCTIONS, SHOWN ON THE DRAWINGS.

8.17 ALL GALVANIZED MATERIALS THAT ARE FIELD CUT, FIELD WELDED OR DAMAGED IN SURFACE FINISH SHALL BE CLEANED AND RE-COATED AS CALLED OUT IN THE PROJECT SPECIFICATIONS.

9.0 ALUMINUM

9.1 ALUMINUM FABRICATION SHALL BE IN CONFORMANCE WITH THE ALUMINUM ASSOCIATION, INC. "SPECIFICATIONS FOR ALUMINUM STRUCTURES".

9.2 UNLESS NOTED OTHERWISE, MATERIALS SHALL BE:
a. PLATE & SHEET - ASTM B209; 6061-T6, 6061-T651 ALLOY.
b. EXTRUDED SHAPES - ASTM B221; 6061-T6, 6061-T651 ALLOY. PIPE SECTIONS ARE SCHEDULE 40 U.N.O..
c. CASTINGS - ASTM B108; 214 ALLOY.
d. BOLTS - ASTM A193; GRADE B8 OR, ASTM 276; TYPE 316 STAINLESS STEEL.
e. NUTS - ASTM A194; GRADE M, OR ASTM 276; TYPE 316 STAINLESS STEEL.

9.3 ALUMINUM SHALL BE SEPARATED FROM DIRECT CONTACT WITH OTHER MATERIALS (STEEL, CONCRETE, ETC.) BY PRESSURE SENSITIVE TAPE, BITUMASTIC COATING, OR OTHER PROTECTIVE METHOD SUBMITTED BY THE CONTRACTOR AND APPROVED BY THE OWNER'S CONSTRUCTION REPRESENTATIVE.

9.4 CONNECTIONS SHALL HAVE A MINIMUM OF TWO 3/4" DIAMETER STAINLESS STEEL BOLTS.

9.5 WELDING ALUMINUM SHALL CONFORM TO AWS A5.10 & THE REQUIREMENTS OF THE ALUMINUM ASSOCIATIONS "ALUMINUM DESIGN MANUAL" (LATEST EDITION) TABLE 7.1-1 FOR WELD FILLERS FOR WROUGHT ALLOYS.

9.6 REFERENCE PROJECT SPECIFICATIONS FOR HANDRAIL REQUIREMENTS.

10.0 ABBREVIATIONS

10.1 THE FOLLOWING LIST OF ABBREVIATIONS IS NOT INTENDED TO REPRESENT ALL THOSE USED ON THE DRAWINGS, BUT TO SUPPLEMENT THE MORE COMMON ABBREVIATIONS USED.

ADD'L = ADDITIONAL	LLH = LONG LEG HORIZONTAL
AL = ALUMINUM	LLV = LONG LEG VERTICAL
BM. = BEAM	L.P. = LOW POINT
B.O. = BOTTOM OF	LSL = LONG SLOTTED
BRG. = BEARING	MAT'L. = MATERIAL
BTM. = BOTTOM	MECH. = MECHANICAL
C.I.P. = CAST-IN-PLACE	MFG. = MANUFACTURER
C.J. = CONSTRUCTION JT.	MIN. = MINIMUM
CLR. = CLEAR	MTL. = METAL
COL. = COLUMN	NO. = NUMBER
CONC. = CONCRETE	N.S. = NEAR SIDE
CONN. = CONNECTION	N.T.S. = NOT TO SCALE
CONT. = CONTINUOUS	O.C. = ON CENTER
COORD. = COORDINATE	O/F = OUTSIDE FACE
CTR. = CENTER	O/O = OUT TO OUT
CTR'D. = CENTERED	O/P = OPENING
DIR. = DIRECTION	OPP. = OPPOSITE
DIST. = DISTANCE	ORIENT. = ORIENTED
DWG. = DRAWING	PLCS. = PLACES
DWG'S. = DRAWINGS	PROJ. = PROJECT
DWL. = DOWEL	P.S. = PUMP STATION
DWL'S. = DOWELS	RAD. = RADIUS
EA. = EACH	RECT. = RECTANGULAR
EFFL. = EFFLUENT	REF. = REFERENCE
E.O. = EDGE OF	REINF. = REINFORCING
EQUIP. = EQUIPMENT	REINF. = REINFORCED
EXIST. = EXISTING	REQ'D. = REQUIRED
EXP. = EXPANSION	SIM. = SIMILAR
EXTR. = EXTERIOR	SL. = SLOPED
FDN. = FOUNDATION	SPA. = SPACED
FLG. = FLANGE	SPECS. = SPECIFICATIONS
F.S. = FAR SIDE	SQ. = SQUARE
FT. = FEET	S.S. = STAINLESS STEEL
FTG. = FOOTING	SSL = SHORT SLOTTED
GA. = GAGE	STD. = STANDARD
GALV. = GALVANIZED	STL. = STEEL
GALV'D. = GALVANIZED	SUPPT. = SUPPORT
G'RAIL = GUARD RAIL	T&B = TOP & BOTTOM
HORIZ. = HORIZONTAL	T/D = TURN DOWN
H.P. = HIGH POINT	THK. = THICK
H'RAIL = HAND RAIL	THK'D = THICKENED
I/F. = INSIDE FACE	T.O. = TOP OF
INFO. = INFORMATION	U.N.O. = UNLESS NOTED OTHERWISE
INTR. = INTERIOR	VERT. = VERTICAL
JT. = JOINT	W.W.F. = WELDED WIRE FABRIC

DESIGN LOADS:

LIVE LOAD: 300 PSF SLAB-ON-GRADE, 100 PSF STAIRS & PLATFORMS
 ROOF: NA
 SNOW: NA, IMPORTANCE FACTOR (Is): NA
 SEISMIC: NA, IMPORTANCE FACTOR (Ie): NA
 WIND: ZONE: 130 mi/hr, EXPOSURE C, CATEGORY III, IMPORTANCE FACTOR (Iw): 1.15

FLORIDA BUILDING CODE (FBC) 2007 & ASCE 7-05 WIND DESIGN:

CALCULATED WIND BASE SHEARS: Vx = 1.7 k Vy = 4.3 k (FILTER UNIT CURBS) [EA. PAIR]

DESIGN CRITERIA:

CONCRETE 28 DAY COMPRESSIVE STRENGTH:	f _c = 4,000 psi
SLAB-ON-GRADE:	f _c = 3,000 psi
EQUIPMENT PADS:	f _c = 4,500 psi
WALLS OF LIQUID CONTAINMENT STRUCTURES (LCS):	f _c = 4,500 psi
SLABS OF LCS:	f _c = 4,000 psi
FOOTINGS:	f _c = 4,000 psi
BELOW GRADE & RETAINING WALLS:	f _c = 3,000 psi
STAIRWALK:	ASTM A615, GRADE 60
REINFORCING STEEL:	ASTM A185
WELDED WIRE FABRIC:	REF. STRUCTURAL NOTE 8.1
STRUCTURAL STEEL:	REF. STRUCTURAL NOTE 9.2
ALUMINUM:	REF. STRUCTURAL NOTES 8.3 & 9.2.d
BOLTS SHALL BE 3/4"Ø ASTM A325 OR TYPE 316 S.S.:	REF. STRUCTURAL NOTE 8.8
ANCHOR BOLTS SHALL BE 3/4"Ø ASTM F-1554 OR ASTM A-36 (STEEL); TYPE 316 S.S. (ALUMINUM):	AWS 5.5 E70XX
STEEL ELECTRODES SHALL CONFORM TO:	AWS A5.10 (REF. STRUCTURAL NOTE 9.5)
ALUMINUM WELD FILLERS ALLOYS SHALL CONFORM TO:	REF. STRUCTURAL NOTE 3.1
SOL BEARING CAPACITY:	

LEGEND:

ENLARGED PLAN AREA, DETAIL	=	
CONC. WALL, PAD, ETC.	=	
GROUT	=	
GRATING	=	
DETAIL OR SECTION NUMBER/SHOWN ON SHEET	=	
PROJECT NORTH	=	
ELEVATION DATUM	=	
ELEVATION NUMBER/SHOWN ON SHEET	=	
ELEVATIONS X'-X" (Y.Y'')	=	X'-X" = DISTANCE TO/FROM FACILITY REFERENCE EL 0'-0" Y.Y'' = EQUIVALENT SITE EL VERTICAL DATUM

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REV. NO.	DESCRIPTIONS / REVISIONS	DATE

SEAL
 WILLIAM F. BAND, P.E.
 No. 67838

SEAL


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MANATEE COUNTY, FLORIDA

SWRF LAKE FILTRATION AND NORTH POND IMPROVEMENTS

STRUCTURAL GENERAL NOTES, DESIGN LOADS, CRITERIA AND LEGEND

DATE: FEBRUARY 2012	SCALE:	DRAWING NUMBER:
MCE PROJ. # 1024-0147	HORIZONTAL: NA	S-0.1
DRAWN: WFB	VERTICAL: NA	
DESIGNED: WFB		
CHECKED: JSL		
PROJ. MGR: MSL		
STATUS: ISSUE FOR BID		

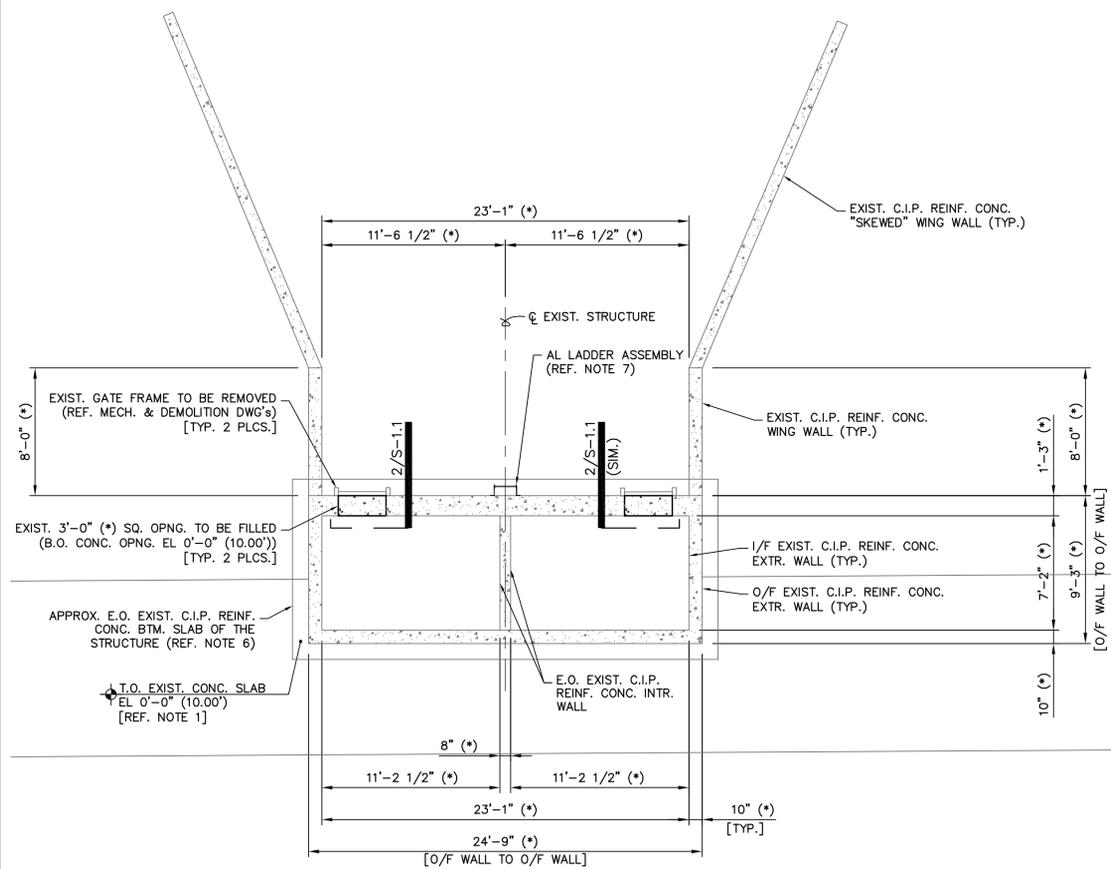


1 - PLAN - NORTH POND OUTLET STRUCTURE BOTTOM LAYOUT
SCALE: 3/16"=1'-0"



BOTTOM PLAN NOTES:

1. REFERENCE ELEVATION FOR THE EXISTING NORTH POND OUTLET STRUCTURE FACILITY IS THE BOTTOM SLAB T.O. CONC. EL 0'-0" = EL 10'-0" (10.00') N.G.V.D.-29. REFERENCE CIVIL DWGS. FOR ADDITIONAL INFORMATION.
2. REFERENCE DWG. S-01 FOR ADDITIONAL GENERAL NOTES & DESIGN CRITERIA.
3. GRADE ELEVATION AROUND THIS STRUCTURE VARIES FROM EL 16.00 (±) L.P. TO EL 29.00' (±) H.P.. REFERENCE CIVIL DRAWINGS FOR ADDITIONAL INFORMATION.
4. PIPE & EQUIPMENT LAYOUTS ARE SHOWN FOR GENERAL INFORMATION ONLY. REFERENCE CIVIL, ELECTRICAL, MECHANICAL & EQUIPMENT VENDOR DRAWINGS FOR LOCATIONS & INFO REGARDING SLAB & WALL PENETRATIONS, PIPING & MISCELLANEOUS EQUIPMENT EITHER SHOWN OR NOT SHOWN.
5. REFERENCE EQUIPMENT VENDOR DRAWINGS FOR COORDINATION & INSTALLATION OF ANCHORING EQUIPMENT TO T.O. CONC. SLAB.
6. RECORD DRAWINGS FOR THE EXISTING FACILITY WERE NOT PROVIDED BY THE OWNER FOR REVIEW & USE IN DESIGN. IN ADDITION SURVEY DATA FOR THE FACILITY DID NOT PROVIDE DATA DUE TO EXISTING BELOW GRADE CONDITIONS. THE BOTTOM SLAB EDGE OF CONCRETE SHOWN IS AN APPROXIMATE LOCATION BASED UPON EXPECTED CONSTRUCTION OF SIMILAR FACILITIES. EXISTING REINFORCING BAR SIZES AND SPACING IN WALLS & SLABS IS NOT KNOWN & REQUIRES COORDINATION DURING CONSTRUCTION OF THE MODIFICATION.
7. ANCHOR AL LADDER ASSEMBLY TO THE EXIST. STRUCTURE WALL. REFERENCE SECTIONS & DETAILS FOR ADDITIONAL INFORMATION.

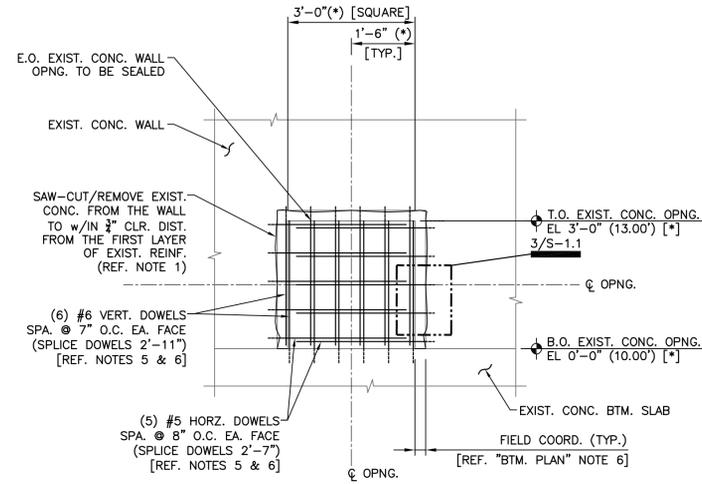


SEQUENCE OF REPAIR MOD NOTES:

1. REMOVE EXIST. CONCRETE FROM THE E.O. SAW-CUT TO A ROUGHENED EDGE 3/4" BEYOND THE FIRST LAYER OF REINFORCEMENT PARALLEL TO THE E.O. THE SAW-CUT. USE EXTREME CAUTION NOT TO DAMAGE THE EXISTING REINFORCING. EXISTING REINFORCING DAMAGED BY THE GC OR THEIR SUBS SHALL BE REPAIRED & REPLACED BY THE GC, PER THE DIRECTION OF THE ENGINEER & AT NO EXPENSE TO THE OWNER OR THE ENGINEER.

REGARDING CONCRETE REMOVAL:


- a.) IMPACT TOOLS CAN CAUSE MICRO-CRACKS IN THE CONCRETE TO REMAIN. IF IMPACT TOOLS ARE USED ADD'L CONCRETE TO BE REMOVED BY WATER JETTING OR OTHER APPROVED NON-IMPACT MEANS.

2. CUT EXISTING REINFORCING BARS PERPENDICULAR TO THE E.O. THE SAW-CUT TO 2" CLEAR OF THE E.O. THE SAW-CUT.
3. CLEAN EXPOSED REINFORCING OF ALL LOOSE CONC., AGGREGATE, DIRT, DUST & DEBRIS.
4. COAT REINFORCING BARS W/ SIKA FERROGARD 903.
5. INSTALL VERT. & HORZ. DWL.'s AT 1/2' & O/F WALL W/ 4" CLR. DISTANCE FROM THE E.O. CONCRETE. DOWEL SIZE & SPA. AS NOTED.
6. ANCHOR DWL.'s W/ HILTI HY150 INJECTION ADHESIVE. EMBED THE VERT. DWL.'s 4" (MIN.) IN TO THE EXIST. CONCRETE WALL & THE HORZ. DWL.'s 2" (MIN.) IN TO THE EXIST. CONCRETE WALL.
7. APPLY BONDING AGENT & W/STOP TO ROUGHENED SURFACES & INSTALL REPAIR CONCRETE AS FOLLOWS:
 - a.) 4500 PSI PEA-GRAVEL MIX W/ SIKADUR 32 HI-MOD LPL, HIGH STRENGTH EPOXY BONDING/GROUTING ADHESIVE. (MIX IS SIM. TO PROJ. SPEC. EXCEPT FOR AGGREGATE SIZE.)

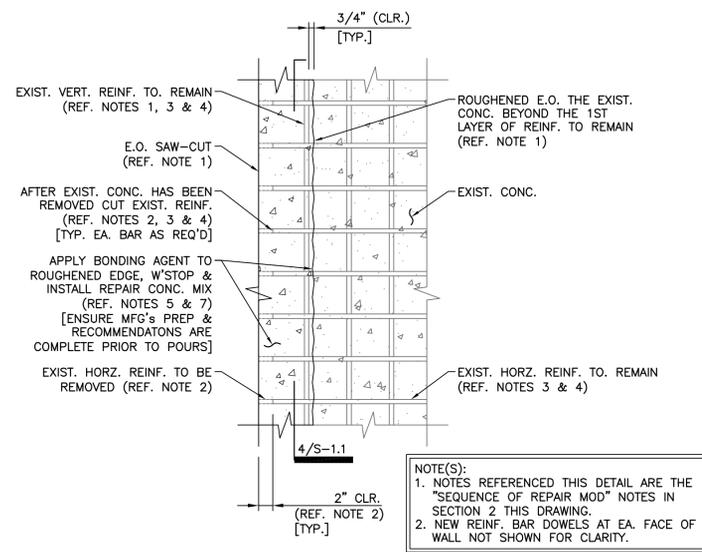

NOTE(S):

1. NOTES REFERENCED THIS DETAIL ARE THE "SEQUENCE OF REPAIR MOD" NOTES IN SECTION 2 THIS DRAWING.
2. NEW REINF. BAR DOWELS AT EA. FACE OF WALL NOT SHOWN FOR CLARITY.

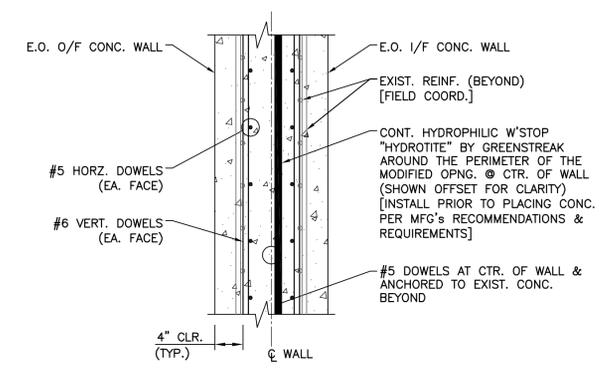

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MANATEE COUNTY, FLORIDA

SWRF LAKE FILTRATION AND NORTH POND IMPROVEMENTS

NORTH POND OUTLET STRUCTURE MODIFICATION BOTTOM PLAN, SECTIONS AND DETAILS


DATE: FEBRUARY 2012	SCALE:	DRAWING NUMBER:
MCE PROJ. # 1024-0147	HORIZONTAL: AS NOTED	S-1.1
DRAWN: WFB	VERTICAL: NA	
DESIGNED: WFB	REVISION:	
CHECKED: JSL		
PROJ. MGR: MSL		
STATUS: ISSUE FOR BID		

TOP PLAN NOTES:

1. REFERENCE ELEVATION FOR THE EXISTING NORTH POND OUTLET STRUCTURE FACILITY IS THE BOTTOM SLAB T.O. CONC. EL 0'-0" = EL 10'-0" (10.00') N.G.V.D.-29.
2. REFERENCE CIVIL DWGS. FOR ADDITIONAL INFORMATION.
3. REFERENCE DWG. S-01 FOR ADDITIONAL GENERAL NOTES & DESIGN CRITERIA.
4. EQUIPMENT LAYOUTS ARE SHOWN FOR GENERAL INFORMATION ONLY. REFERENCE CIVIL, ELECTRICAL, MECHANICAL & EQUIPMENT VENDOR DRAWINGS FOR LOCATIONS & INFO REGARDING SLAB & WALL PENETRATIONS, PIPING & MISCELLANEOUS EQUIPMENT EITHER SHOWN OR NOT SHOWN.
5. REFERENCE EQUIPMENT VENDOR DRAWINGS FOR COORDINATION & INSTALLATION OF ANCHORING EQUIPMENT TO CONC. WALLS.
6. WEIR PLATE ASSEMBLY TO BE ANCHORED TO THE CONCRETE WALL BELOW. REFERENCE MECH. DWG'S FOR ADDITIONAL INFORMATION.
7. AL GRATING TO BE REPLACED AT THE TOP OF THE FACILITY NOT SHOWN FOR CLARITY. REFERENCE MECH. DWG'S FOR INFORMATION.





SEQUENCE OF REPAIR MOD NOTES:

1. REMOVE EXIST. CONCRETE FROM THE EXISTING WALL. REMOVE CONCRETE SO THAT SAW-CUT IS 10" BEYOND THE LIMITS OF THE 3'-0" SQ. GATE OPNG.
- REGARDING CONCRETE REMOVAL:**
 - a.) IMPACT TOOLS CAN CAUSE MICRO-CRACKS IN THE CONCRETE TO REMAIN. IF IMPACT TOOLS ARE USED ADD'L CONCRETE TO BE REMOVED BY WATER JETTING OR OTHER APPROVED NON-IMPACT MEANS.
2. CLEAN EXPOSED REINFORCING OF ALL LOOSE CONC., AGGREGATE, DIRT, DUST & DEBRIS.
3. COAT EXPOSED EXIST. REINFORCING BARS w/ SIKA FERROGARD 903.
4. INSTALL VERT. & HORZ. DWL'S AT 1/F & O/F WALL w/ 4" CLR. DISTANCE FROM THE E.O. CONCRETE. DOWEL SIZE & SPA. AS NOTED. INSTALL #4 TIES w/ 2" CLR. DISTANCE FROM THE E.O. THE GATE OPNG.
5. ANCHOR DWL'S w/ HILTI HY150 INJECTION ADHESIVE. EMBED THE VERT. DWL'S 4 1/2" (MIN.) IN TO THE EXIST. CONCRETE WALL & THE HORZ. DWL'S 5" (MIN.) IN TO THE EXIST. CONCRETE WALL.
6. APPLY BONDING AGENT & W/STOP TO ROUGHENED SURFACES & INSTALL REPAIR CONCRETE AS FOLLOWS:
 - a.) 4500 PSI PEA-GRAVEL MIX w/ SIKADUR 32 HI-MOD LPL, HIGH STRENGTH EPOXY BONDING/GROUTING ADHESIVE. (MIX IS SIM. TO PROJ. SPEC. EXCEPT FOR AGGREGATE SIZE.)

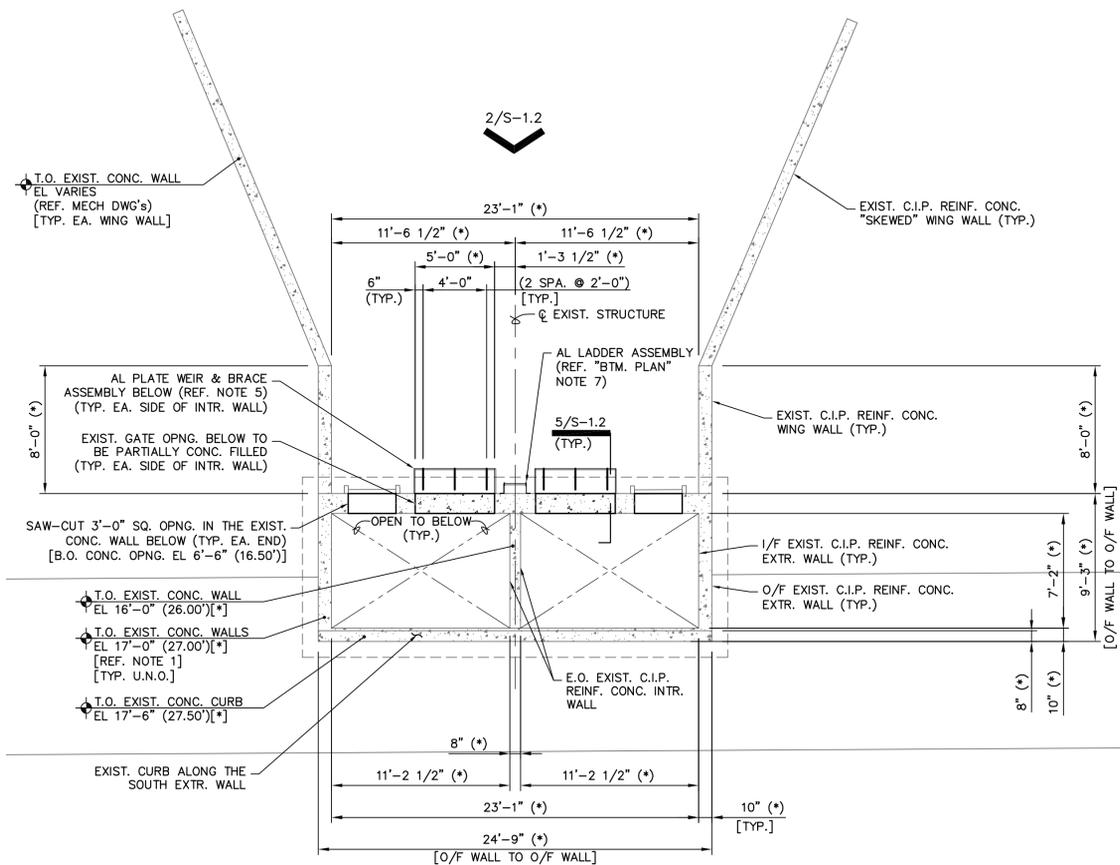

1- PLAN - NORTH POND OUTLET STRUCTURE TOP LAYOUT

SCALE: 3/16"=1'-0"

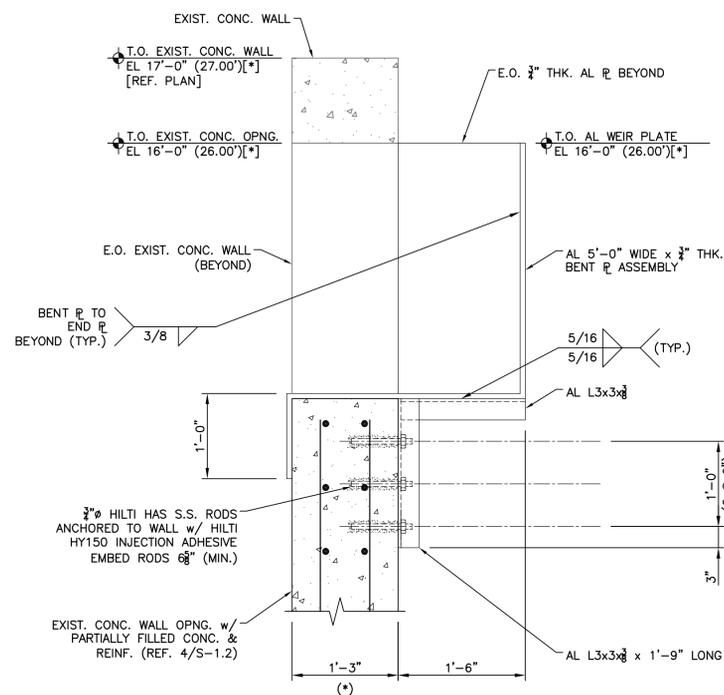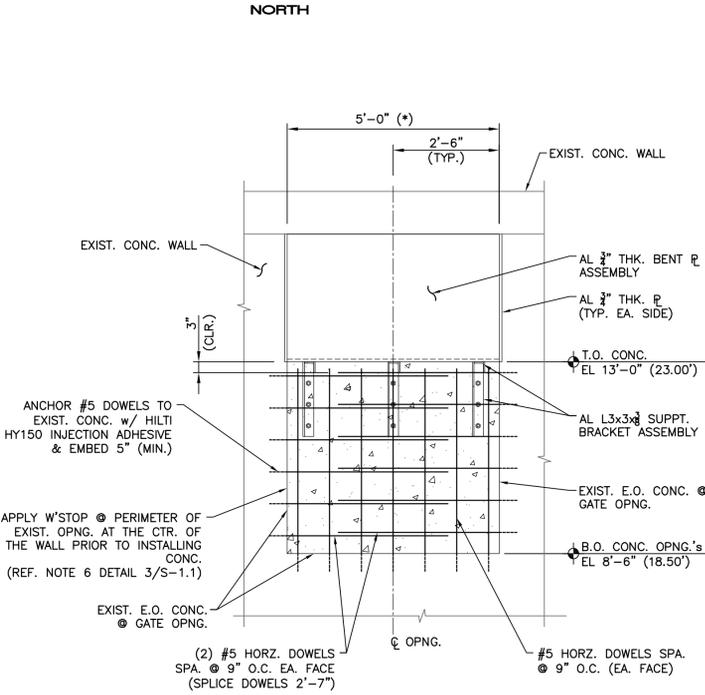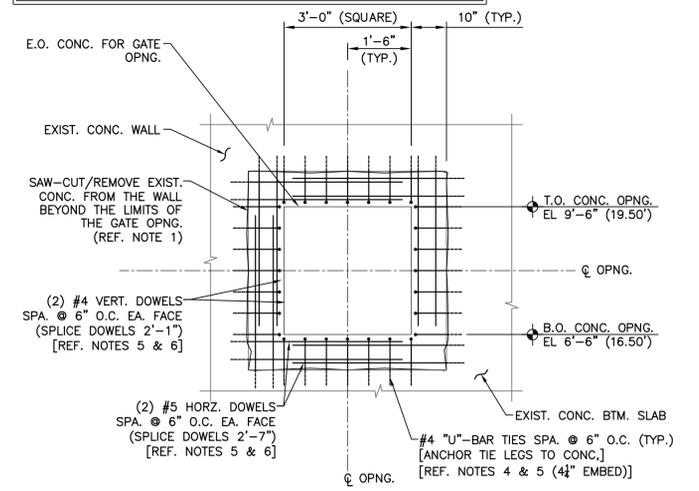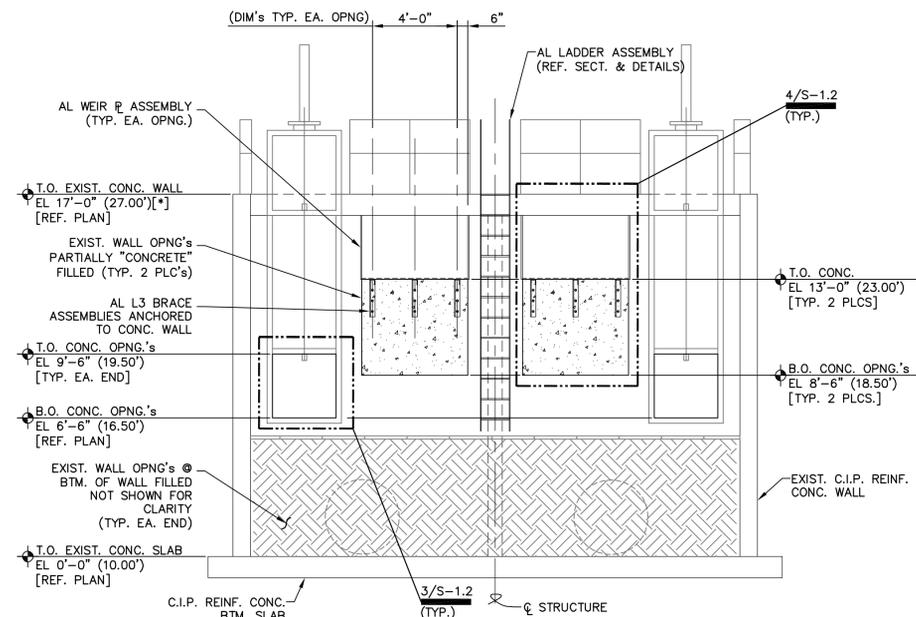

REV. NO.	DESCRIPTION	DATE

WILLIAM F. BAND, P.E.
No. 67838

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MANATEE COUNTY, FLORIDA

SWRF LAKE FILTRATION AND NORTH POND IMPROVEMENTS


NORTH POND OUTLET STRUCTURE MODIFICATION TOP PLAN, SECTIONS AND DETAILS

DATE: FEBRUARY 2012
MCE PROJ. # 1024-0147
DRAWN: WFB
DESIGNED: WFB
CHECKED: JSL
PROJ. MGR: MSL

SCALE: AS NOTED
HORIZONTAL: AS NOTED
VERTICAL: NA

DRAWING NUMBER: S-1.2

STATUS: ISSUE FOR BID

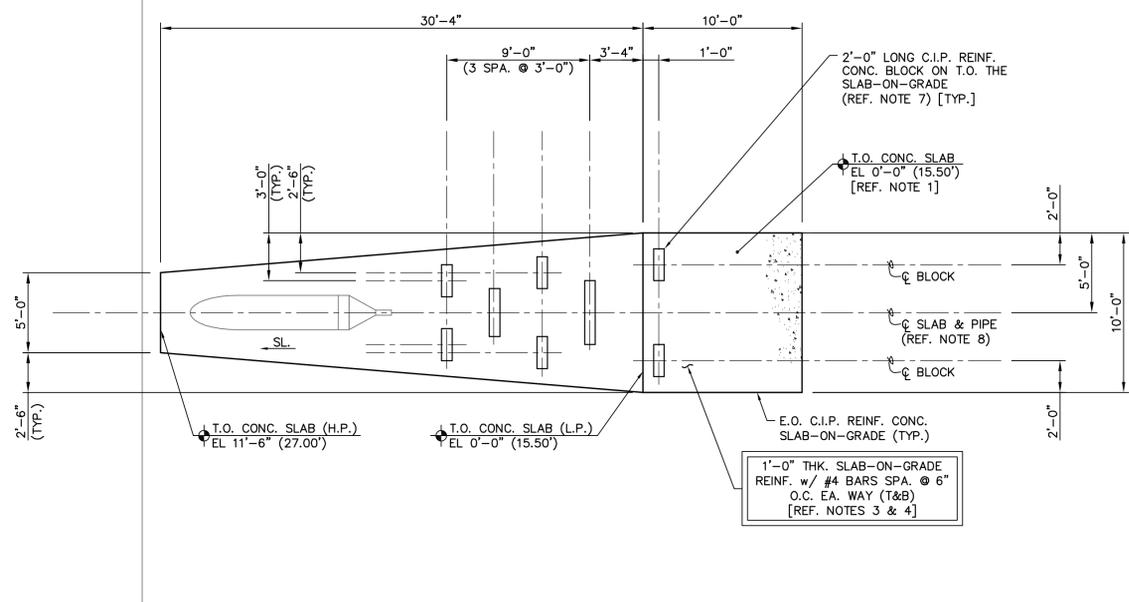

1 - PLAN - REJECT POND DISCHARGE STRUCTURE LAYOUT

SCALE: 3/16"=1'-0"

LAYOUT PLAN NOTES:

1. REFERENCE ELEVATION FOR THE RECLAIM STORAGE POND DISCHARGE STRUCTURE FACILITY IS THE SLAB-ON-GRADE T.O. CONC. EL 0'-0" = EL 15'-6" (15.50') N.G.V.D.-29. REFERENCE CIVIL DWGS. FOR ADDITIONAL INFORMATION.
2. REFERENCE DWG. S-0.1 FOR ADDITIONAL GENERAL NOTES & DESIGN CRITERIA.
3. GRADE ELEVATION AROUND THIS STRUCTURE VARIES FROM 15.50' (±) L.P. TO 27.00' (±) H.P.. REFERENCE CIVIL DRAWINGS FOR ADDITIONAL INFORMATION.
4. PREPARE THE SUBGRADE MATERIAL BELOW THE FACILITY SLAB-ON-GRADE PER THE RECOMMENDATIONS OF THE PROJECT GEOTECHNICAL REPORT. REFERENCE DRAWING S-0.1 & PROJECT SPECIFICATIONS FOR ADDITIONAL INFORMATION.
5. PIPE & EQUIPMENT LAYOUTS ARE SHOWN FOR GENERAL INFORMATION ONLY. REFERENCE CIVIL & MECHANICAL DRAWINGS FOR LOCATIONS & INFO REGARDING SLAB PENETRATIONS, PIPING & MISCELLANEOUS EQUIPMENT EITHER SHOWN OR NOT SHOWN.
6. REFERENCE EQUIPMENT VENDOR DRAWINGS FOR COORDINATION & INSTALLATION OF ANCHORING EQUIPMENT TO T.O. CONC. SLAB.
7. C.I.P. REINFORCED CONCRETE ENERGY DISSIPATION BLOCKS ON TOP OF THE SLAB-ON-GRADE ARE 8" WIDE x 5" HIGH U.N.O..
8. CENTERLINE OF THE ENERGY DISSIPATION BLOCKS IS EQUAL TO THE CENTERLINE OF THE SLAB-ON-GRADE U.N.O..

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REV. NO.	DESCRIPTIONS REVISIONS	DATE

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SEAL






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MANATEE COUNTY, FLORIDA

**SWRF LAKE FILTRATION AND
NORTH POND IMPROVEMENTS**








**DISCHARGE STRUCTURE
PLAN, SECTIONS AND DETAILS**

DATE: FEBRUARY 2012	SCALE	DRAWING NUMBER
MCE PROJ. # 1024-0147	HORIZONTAL: AS NOTED	S-1.4
DRAWN: WFB	VERTICAL: NA	
DESIGNED: WFB	REVISION	
CHECKED: JSL		
PROJ. MGR: MSL		
STATUS: ISSUE FOR BID		

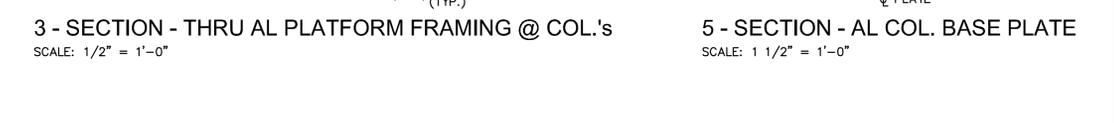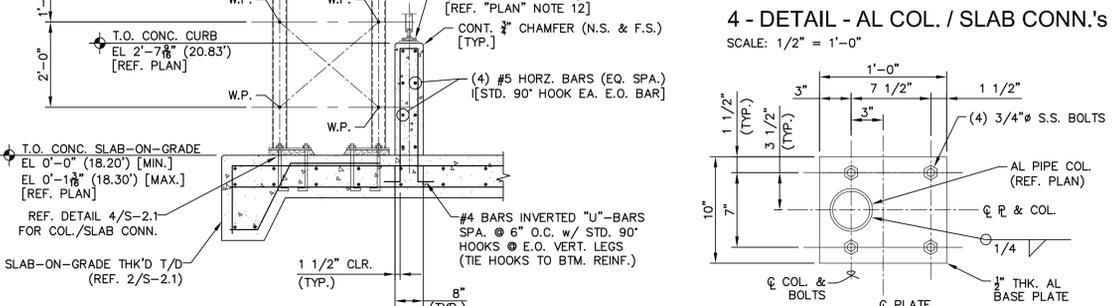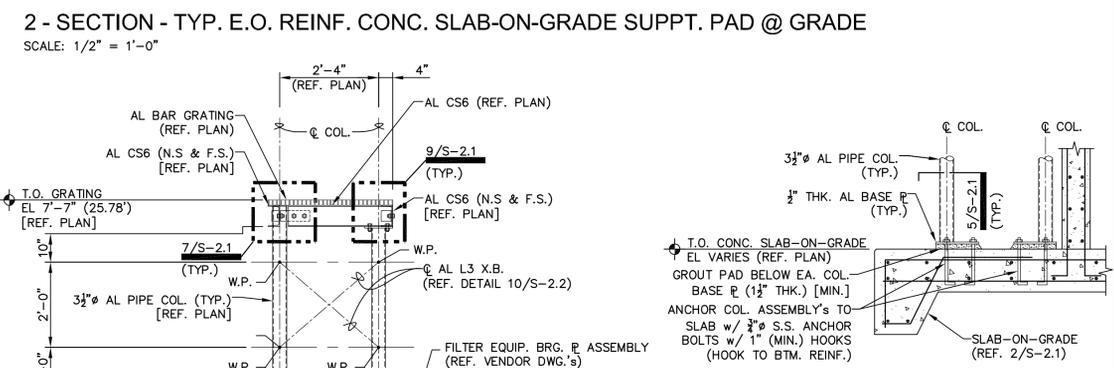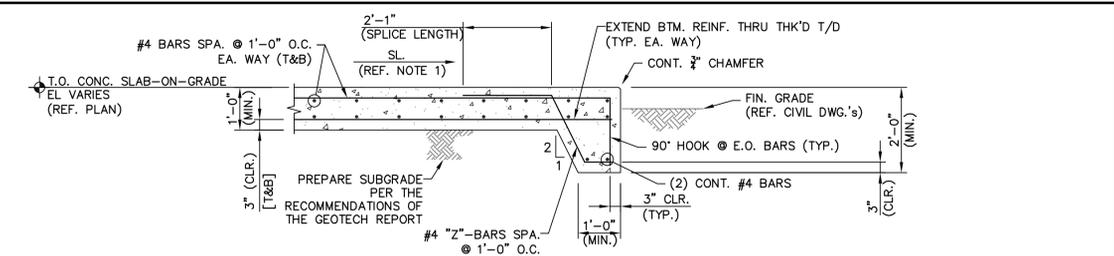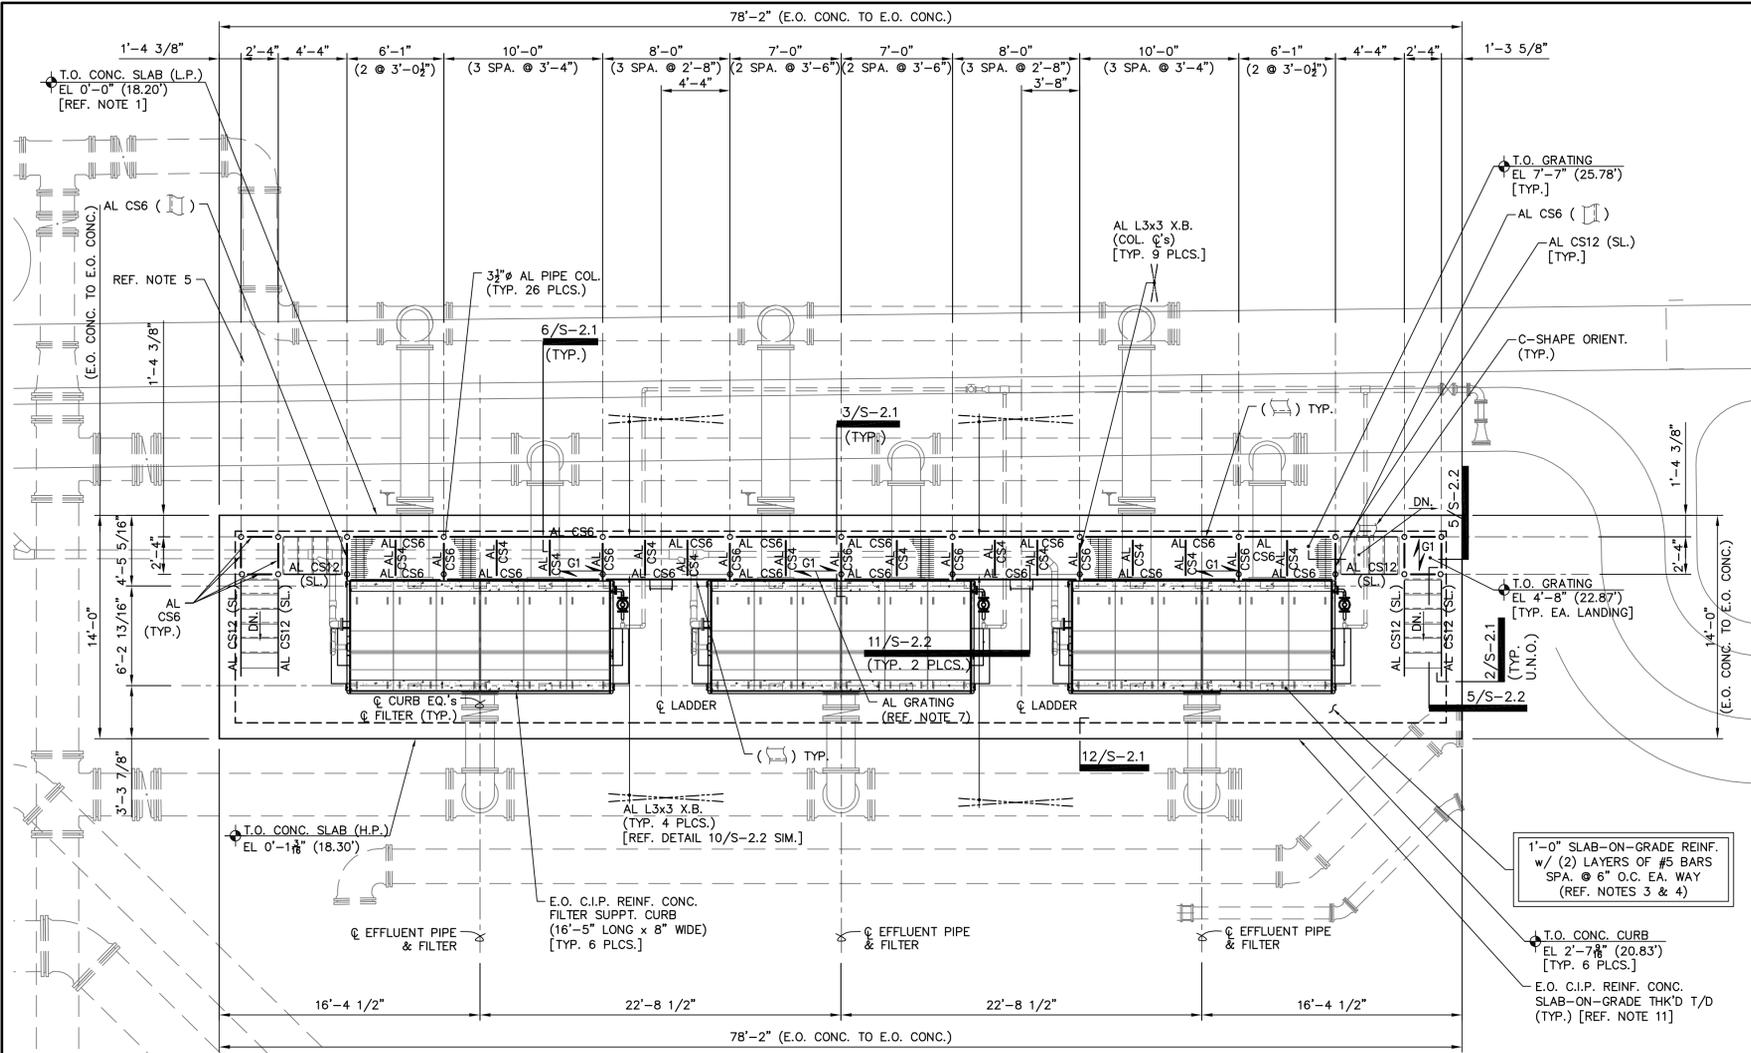

1 - PLAN - GRAVITY DISK FILTER SLAB
SCALE: 3/16" = 1'-0"
NORTH

- FOUNDATION PLAN NOTES:**
- REFERENCE ELEVATION FOR THE GRAVITY DISK FILTER FACILITY IS THE SLAB-ON-GRADE T.O. CONC. L.P. EL 0'-0" = EL 18'-2 3/8" (18.20') N.G.V.D.-29. REFERENCE CIVIL DWGS. FOR ADDITIONAL INFORMATION.
 - REFERENCE DWG. S-0.1 FOR ADDITIONAL GENERAL NOTES & DESIGN CRITERIA.
 - GRADE ELEVATION AROUND THIS STRUCTURE IS 17.70' (±). REFERENCE CIVIL DRAWINGS FOR ADDITIONAL INFORMATION.
 - PREPARE THE SUBGRADE MATERIAL BELOW THE FACILITY SLAB-ON-GRADE PER THE RECOMMENDATIONS OF THE PROJECT GEOTECHNICAL REPORT. REFERENCE DRAWING S-0.1 & PROJECT SPECIFICATIONS FOR ADDITIONAL INFORMATION.
 - PIPE & EQUIPMENT LAYOUTS ARE SHOWN FOR GENERAL INFORMATION ONLY. REFERENCE CIVIL, ELECTRICAL, MECHANICAL & EQUIPMENT VENDOR DRAWINGS FOR LOCATIONS & INFO REGARDING SLAB PENETRATIONS, PIPING & MISCELLANEOUS EQUIPMENT EITHER SHOWN OR NOT SHOWN.
 - REFERENCE EQUIPMENT VENDOR DRAWINGS FOR COORDINATION & INSTALLATION OF ANCHORING EQUIPMENT TO T.O. CONC. SLAB & CURB.
 - SYMBOL ON PLANS INDICATES SPAN DIRECTION OF GRATING MAIN BEARING BARS. GRATING IS ALUMINUM (AL) RECTANGULAR BAR U.N.O. G1 = 1 1/2" x 3/8" AL RECTANGULAR BAR GRATING (MFG'S 19 "SG" SERIES SPACE PROFILE OR GREATER).
 - ATTACH GRATING TO AL SUPPORT FRAMING W/ S.S. CLIPS PER GRATE MFG'S. RECOMMENDATIONS.
 - ALUMINUM FRAMING SECTIONS:
AL CS4 = CS4x2.33 ALUMINUM ASSOCIATION STD. CHANNEL SECTION.
AL CS6 = CS6x4.03 ALUMINUM ASSOCIATION STD. CHANNEL SECTION.
AL CS12 = CS12x8.27 ALUMINUM ASSOCIATION STD. CHANNEL SECTION.
X.B. = ALUMINUM L3x3x1/4 L-SHAPE SECTION "X"-CROSS BRACING.
 - IN GENERAL FOR PLATFORM CONNECTIONS NOT SHOWN IT IS THE FABRICATOR'S RESPONSIBILITY TO PROVIDE IN THE PROJECT SHOP DRAWINGS.
 - WHERE SLAB WILL BE CONSTRUCTED TO ADJACENT CONCRETE SIDEWALK SECTIONS INSTALL EXTR. GRADE EXP. JT. MATERIAL. CAULK & SEAL THE TOP OF JOINT W/ SONOLASTIC "SL-2" POLYURETHANE OR AN APPROVED EQUAL.
 - PROVIDE GROUT PAD IF REQ'D BY THE FILTER EQUIPMENT MFG. TO ENSURE EQUIPMENT IS INSTALLED LEVEL & W/IN MFG.'S ALLOWED TOLERANCES. GC TO FIELD COORDINATE T.O. CONC. CURB EL AS REQUIRED.

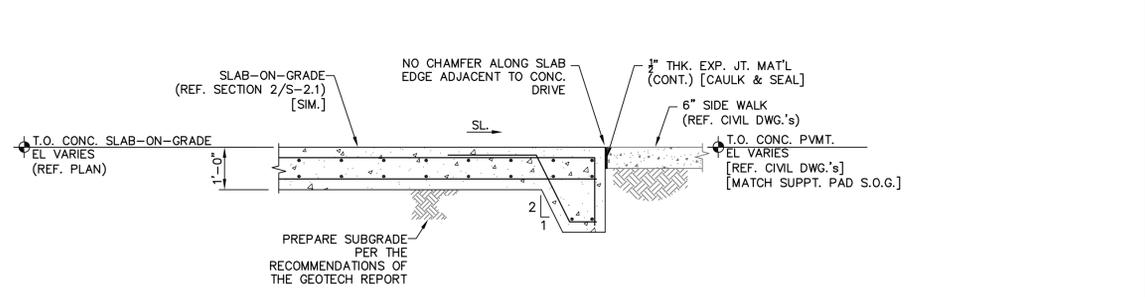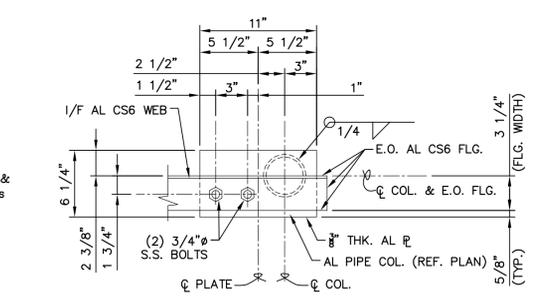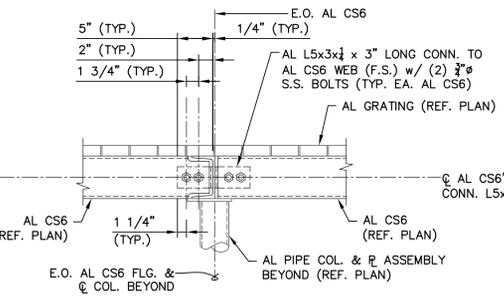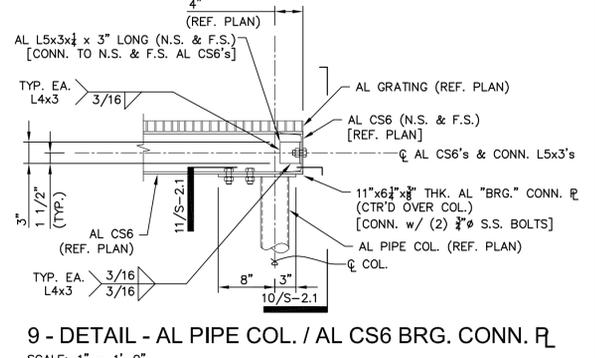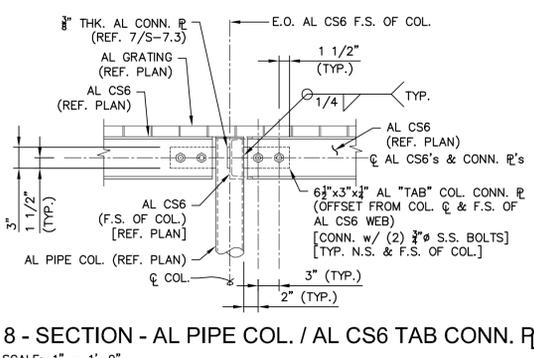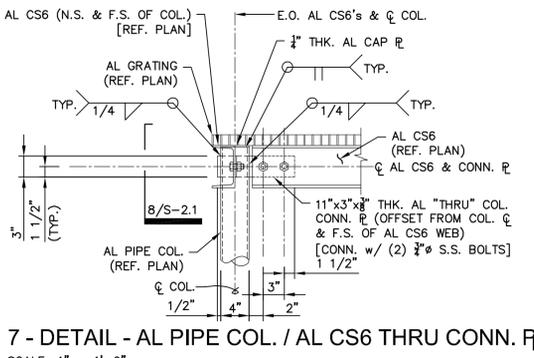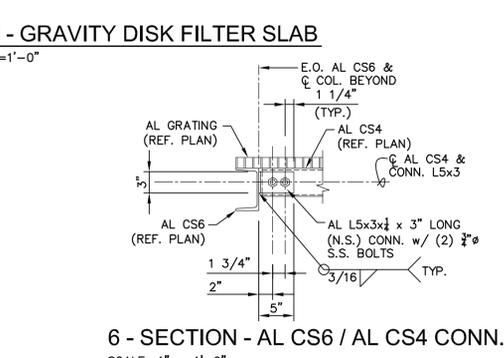

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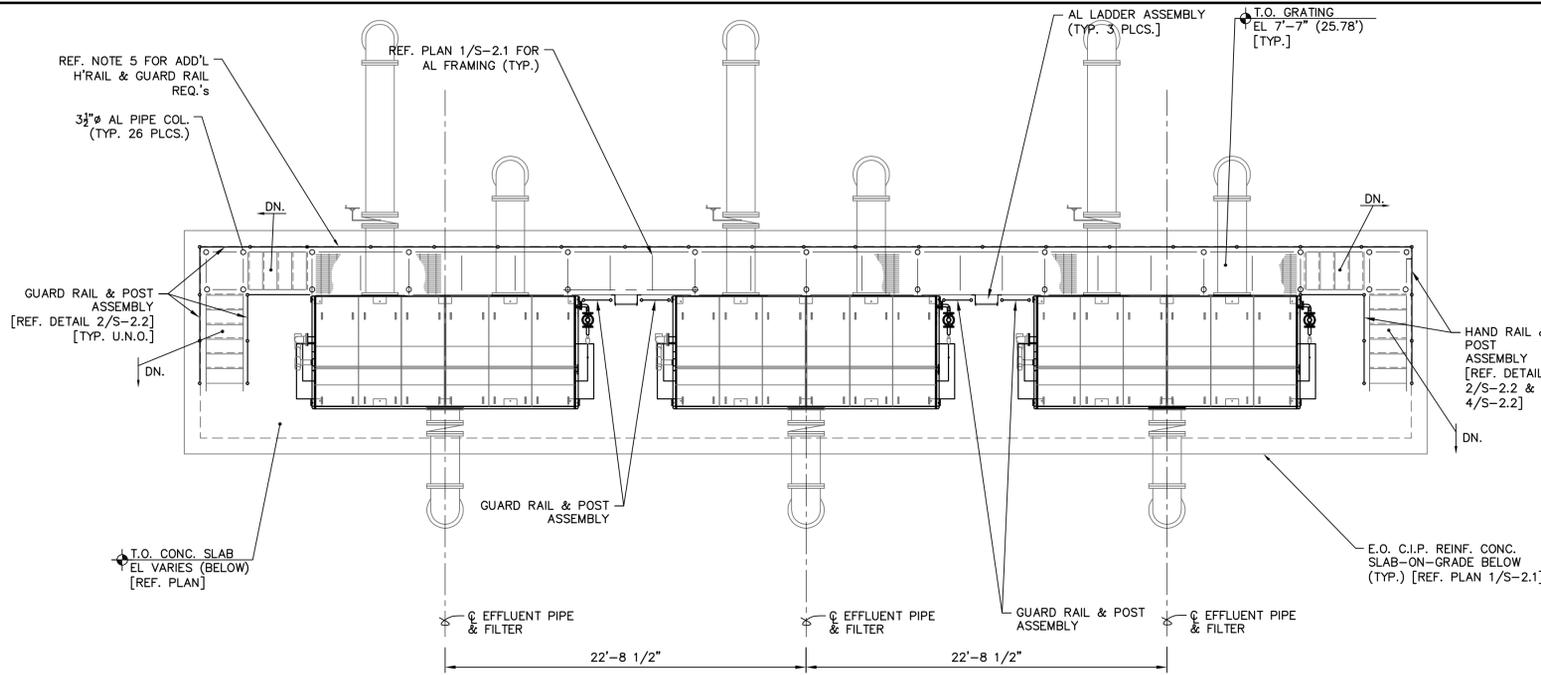
SWRF LAKE FILTRATION AND NORTH POND IMPROVEMENTS

DATE: FEBRUARY 2012
MCE PROJ. # 1024-0147
DRAWN: WFB
DESIGNED: WFB
CHECKED: JSL
PROJ. MGR: MSL


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VERTICAL: NA

DRAWING NUMBER: **S-2.1**


STATUS: **ISSUE FOR BID**




1 - PLAN - AL HAND & GUARD RAIL LAYOUT
SCALE: 3/16"=1'-0"

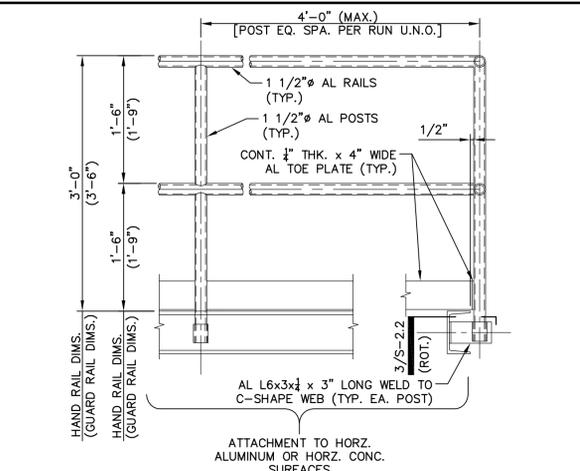

2 - DETAIL - AL HAND & GUARD RAIL / POST CONN.'s
SCALE: 1" = 1'-0"

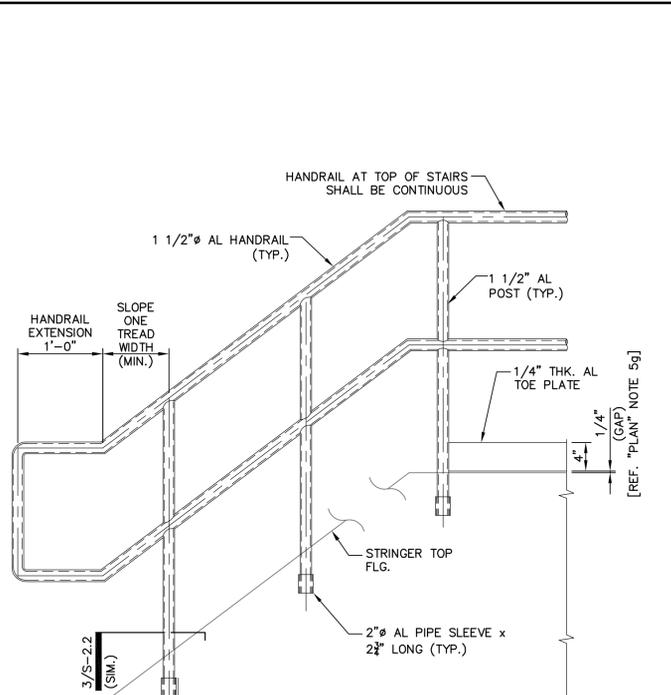


4 - DETAIL - AL RAIL STAIR STRINGER INFO
SCALE: 1" = 1'-0"

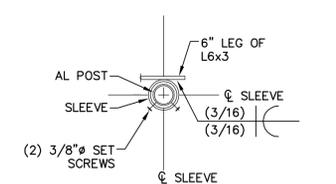


3 - SECTION - AL POST C-SHAPE CONN.
SCALE: 1 1/2" = 1'-0"

AL HAND & GUARD RAIL LAYOUT PLAN NOTES:


- REFERENCE DWG. S-0.1 FOR ADDITIONAL GENERAL NOTES & DESIGN CRITERIA.
- REFERENCE DWG. S-2.1 FOR ADDITIONAL AL PLATFORM FRAMING & SLAB-ON-GRADE REQUIREMENTS.
- T.O. AL GRATING EL EQUALS THE T.O. TOP RUNG EL FOR THE AL LADDER SECTIONS.
- IN GENERAL FOR PLATFORM CONNECTIONS NOT SHOWN IT IS THE FABRICATOR'S RESPONSIBILITY TO PROVIDE IN THE PROJECT SHOP DRAWINGS.
- HAND RAIL & GUARD RAIL ASSEMBLY INFORMATION AS FOLLOWS:
 - PROVIDE HAND RAIL ALONG STAIR RUNS & GUARD RAIL AT PLATFORMS.
 - HANDRAILS DETAILS SHOWN DEPICT INTENT OF HANDRAIL INSTALLATION. HANDRAIL FABRICATOR/INSTALLER SHALL BE RESPONSIBLE FOR ADHERING TO FLORIDA BUILDING, OSHA & ADDITIONAL JURISDICTION CODES THAT MAY BE APPLICABLE. IT IS THE GENERAL CONTRACTOR'S (GC) RESPONSIBILITY TO VERIFY APPLICABLE CODES w/ THE INSPECTOR FOR THE LOCAL JURISDICTION.
 - HANDRAIL DETAILS SHOWN ARE 1 1/2" ALUMINUM POSTS AND RAILS. REFERENCE DWG. S-0.1 GENERAL NOTES & DESIGN CRITERIA, IN ADDITION TO THE PROJECT SPECS. FOR MATERIAL REQUIREMENTS.
 - COORDINATE w/ MECH. DWG.s THE REQUIRED LOCATIONS OF HANDRAIL/GUARDRAIL ASSEMBLIES. GC TO VERIFY LOCATIONS w/ THE INSPECTOR FOR THE LOCAL JURISDICTION, IF APPLICABLE.
 - WHERE ALUMINUM MEETS CONCRETE OR DISSIMILAR METALS, BITUMASTIC OR AN APPROVED EQUAL SHALL BE APPLIED TO THE MATING SURFACE.
 - HANDRAIL CENTERLINE TO EDGE OF CONCRETE DIMENSION SHALL BE 6" (MIN.) U.N.O. WHERE APPLICABLE.
 - GAP FOR TOE PLATE ABOVE WALKING SURFACE U.N.O..
 - POST & HANDRAIL FABRICATOR TO PROVIDE HARDWARE AND/OR JOINTS FOR THERMAL EXPANSION / CONTRACTION AS REQ'D.

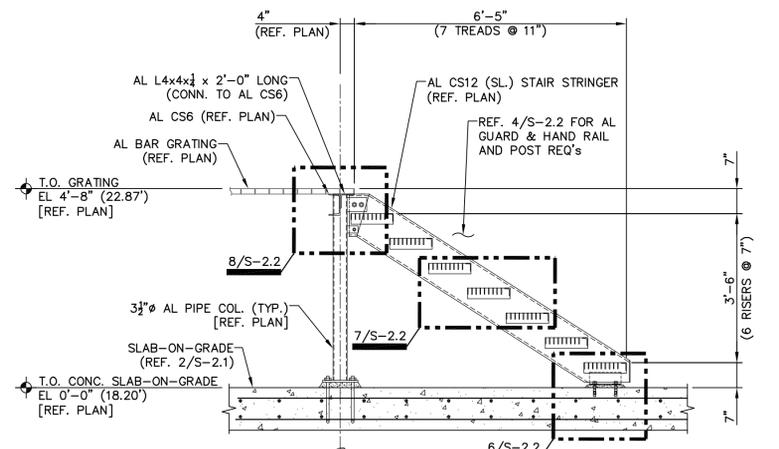


5 - SECTION - THRU AL PLATFORM ACCESS STAIR
SCALE: 1/2" = 1'-0"

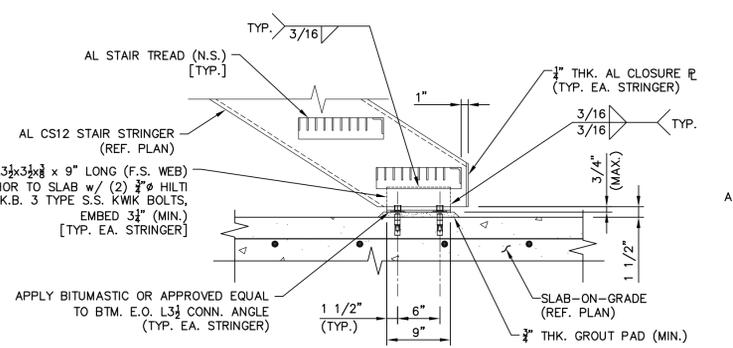


6 - DETAIL - TYP. AL STAIR / SLAB-ON-GRADE CONN.
SCALE: 1" = 1'-0"

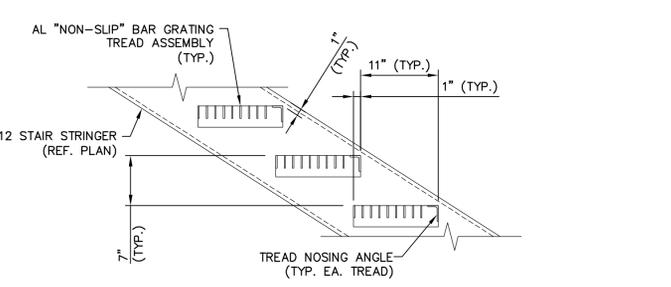


7 - DETAIL - TYP. AL STAIR INFO
SCALE: 1" = 1'-0"

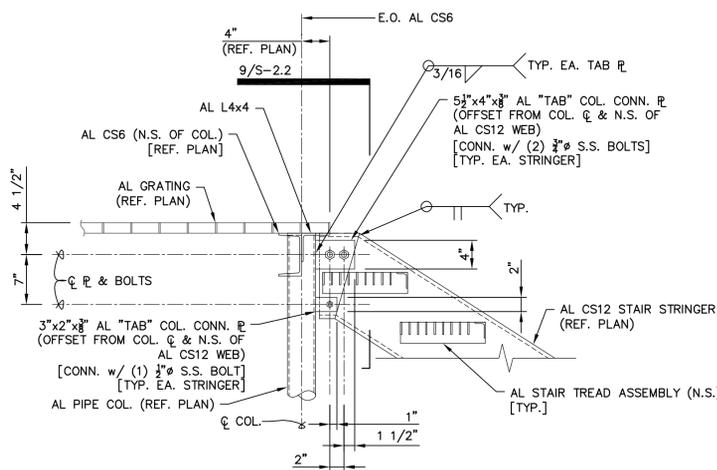


8 - DETAIL - TYP. AL PIPE COL. / STAIR AL CS12 CONN.
SCALE: 1" = 1'-0"

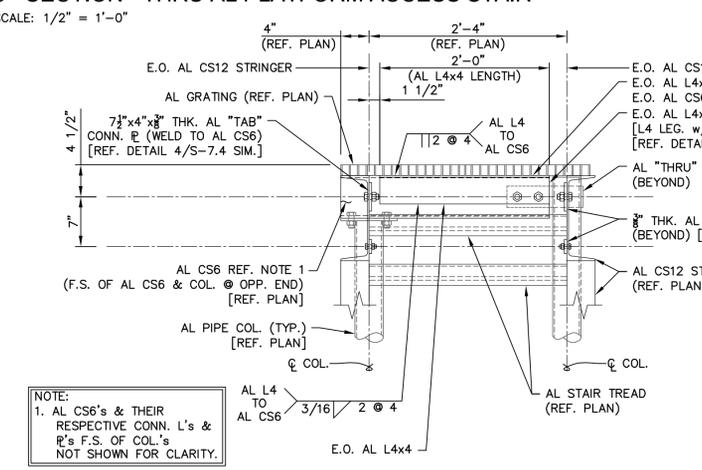

9 - SECTION - AL STAIR FRMG. & GRATING SUPPORT
SCALE: 1" = 1'-0"

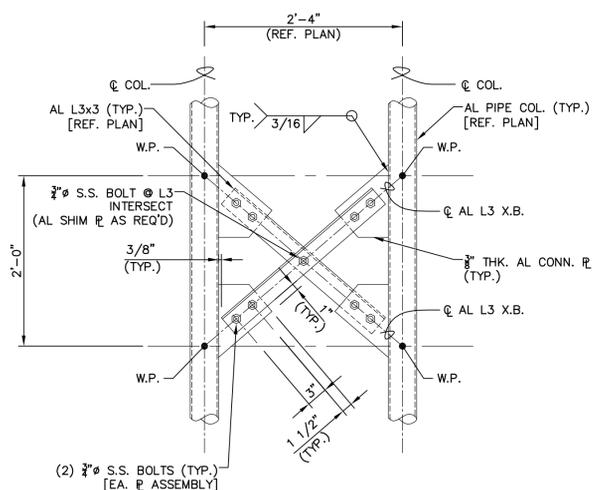

10 - DETAIL - AL PLATFORM EW DIR. "X"-BRACING
SCALE: 1" = 1'-0"

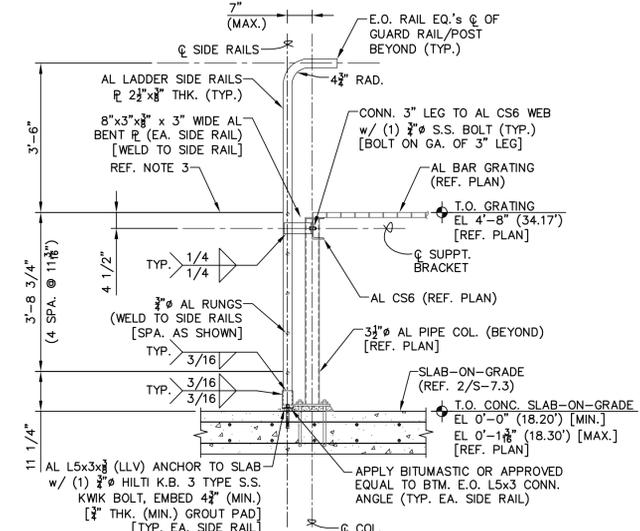

11 - SECTION - TYP. AL ACCESS LADDER FRMG.
SCALE: 1/2" = 1'-0"

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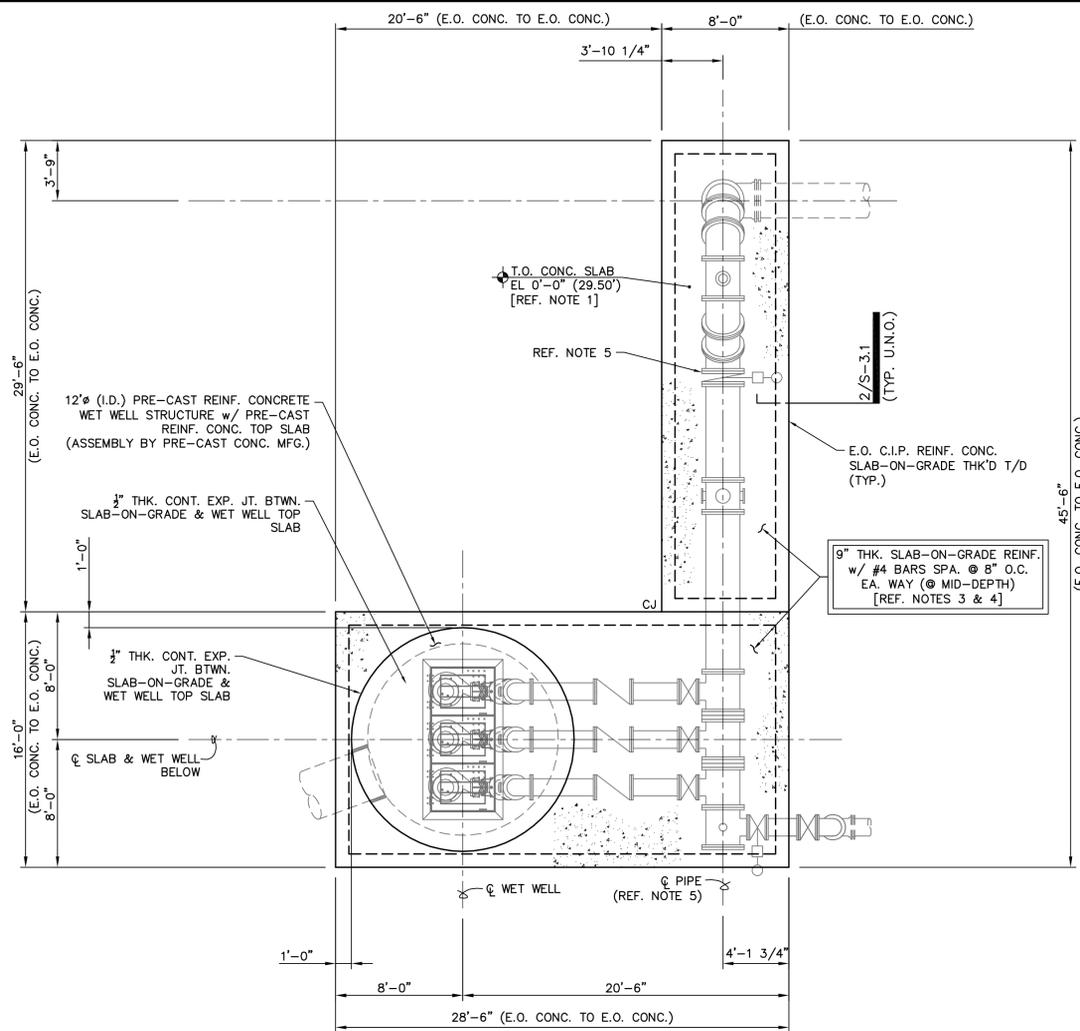
MANATEE COUNTY, FLORIDA

SWRF LAKE FILTRATION AND NORTH POND IMPROVEMENTS

GRAVITY DISK FILTER FOUNDATION & FRAMING


ADDITIONAL SECTIONS AND DETAILS

DATE: FEBRUARY 2012	SCALE: HORIZONTAL: AS NOTED	DRAWING NUMBER: S-2.2
MCE PROJ. # 1024-0147	VERTICAL: NA	REVISION:
DRAWN: WFB		
DESIGNED: WFB		
CHECKED: JSL		
PROJ. MGR: MSL		
STATUS: ISSUE FOR BID		



1 - PLAN - RECLAIM WATER PUMP STATION TOP LAYOUT

SCALE: 3/16"=1'-0"

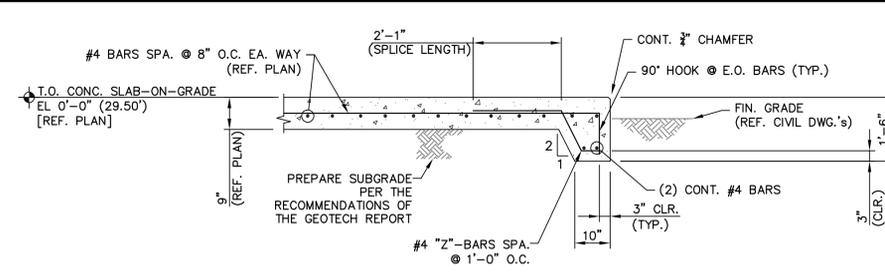

2 - SECTION - TYP. SLAB-ON-GRADE THK'D T/D REINF.

SCALE: 1/2" = 1'-0"

FOUNDATION PLAN NOTES:

1. REFERENCE ELEVATION FOR THE GRAVITY DISK FILTER FACILITY IS THE SLAB-ON-GRADE T.O. CONC. EL. 0'-0" = EL. 29'-6" (29.50') N.G.V.D.-29. REFERENCE CIVIL DWGS. FOR ADDITIONAL INFORMATION.
2. REFERENCE DWG. S-0.1 FOR ADDITIONAL GENERAL NOTES & DESIGN CRITERIA.
3. GRADE ELEVATION AROUND THIS STRUCTURE IS 29.00' (±). REFERENCE CIVIL DRAWINGS FOR ADDITIONAL INFORMATION.
4. PREPARE THE SUBGRADE MATERIAL BELOW THE FACILITY SLAB-ON-GRADE PER THE RECOMMENDATIONS OF THE PROJECT GEOTECHNICAL REPORT. REFERENCE DRAWING S-0.1 & PROJECT SPECIFICATIONS FOR ADDITIONAL INFORMATION.
5. PIPE & EQUIPMENT LAYOUTS ARE SHOWN FOR GENERAL INFORMATION ONLY. REFERENCE CIVIL, ELECTRICAL, MECHANICAL & EQUIPMENT VENDOR DRAWINGS FOR LOCATIONS & INFO REGARDING SLAB PENETRATIONS, PIPING & MISCELLANEOUS EQUIPMENT EITHER SHOWN OR NOT SHOWN.
6. REFERENCE EQUIPMENT VENDOR DRAWINGS FOR COORDINATION & INSTALLATION OF ANCHORING EQUIPMENT TO T.O. CONC. SLAB.
7. INSTALL EXTR. GRADE EXP. JT. MATERIAL. CAULK & SEAL THE TOP OF JOINT w/ SONOLASTIC "SL-2" POLYURETHANE OR AN APPROVED EQUAL.
8. PROVIDE 1" (MIN.) GROUT PAD BELOW PIPE & EQUIPMENT SUPPT.'s & ENSURE PIPING & EQUIPMENT IS INSTALLED LEVEL & w/IN MFG.'s ALLOWED TOLERANCES.

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REV. NO.	DESCRIPTIONS / REVISIONS	DATE

SEAL
WILLIAM F. BAND, P.E.
No. 67838

SEAL


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MANATEE COUNTY, FLORIDA

SWRF LAKE FILTRATION AND
NORTH POND IMPROVEMENTS

RECLAIM WATER PUMP STATION
TOP PLAN, SECTIONS AND DETAILS

DATE: FEBRUARY 2012	SCALE	DRAWING NUMBER
MCE PROJ. # 1024-0147	HORIZONTAL: AS NOTED	S-3.1
DRAWN: WFB	VERTICAL: NA	
DESIGNED: WFB		
CHECKED: JSL		
PROJ. MGR: MSL		
STATUS: ISSUE FOR BID		REVISION

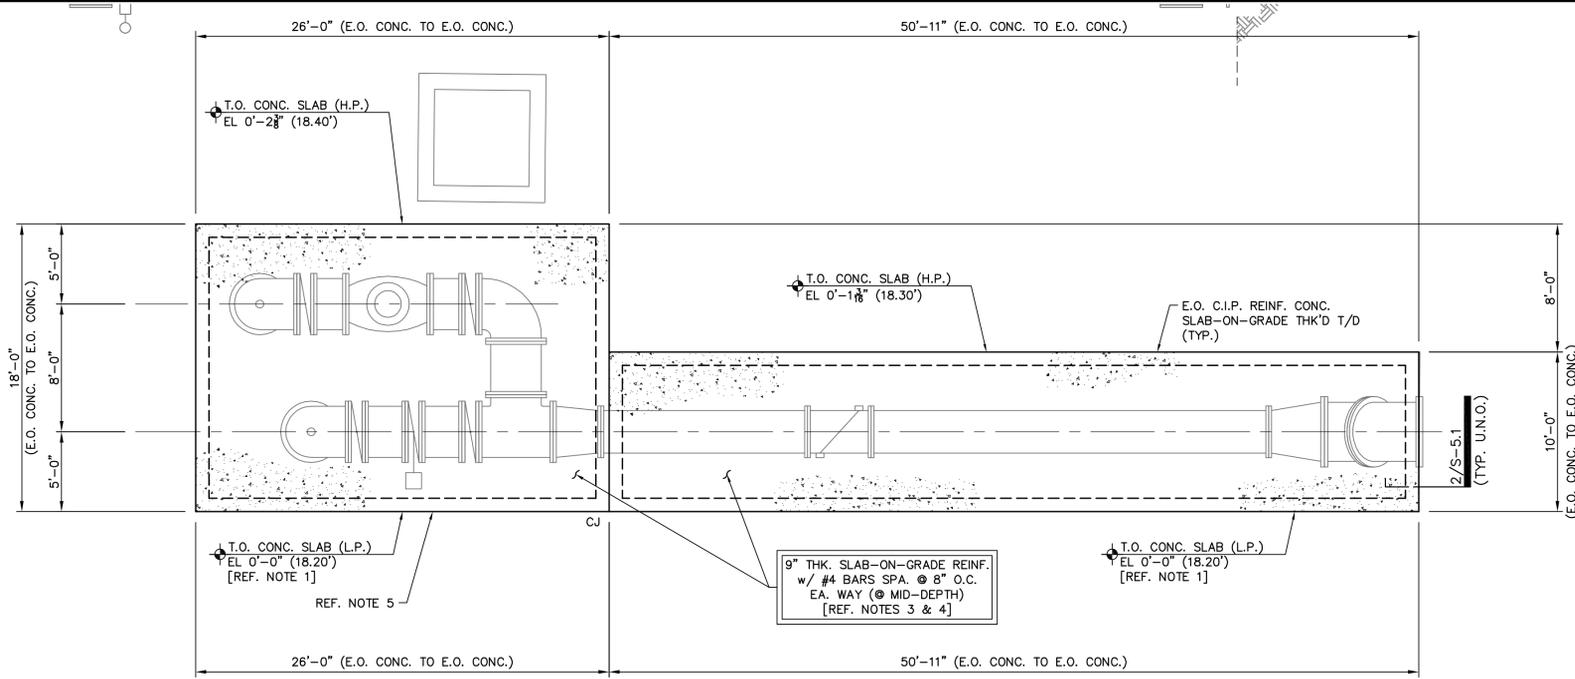


1 - PLAN - EFFLUENT PUMP STATION LAYOUT

SCALE: 3/16"=1'-0"

FOUNDATION PLAN NOTES:

- REFERENCE ELEVATION FOR THE EFFLUENT PUMP STATION FACILITY IS THE SLAB-ON-GRADE L.P., EL. T.O. CONC. EL 0'-0" = EL 18'-2 3/4" (18.20') N.G.V.D. -29. REFERENCE CIVIL DWG'S FOR ADDITIONAL INFORMATION.
- REFERENCE DWG. S-0.1 FOR ADDITIONAL GENERAL NOTES & DESIGN CRITERIA.
- GRADE ELEVATION AROUND THIS STRUCTURE IS 17.90' (±). REFERENCE CIVIL DRAWINGS FOR ADDITIONAL INFORMATION.
- PREPARE THE SUBGRADE MATERIAL BELOW THE FACILITY SLAB-ON-GRADE PER THE RECOMMENDATIONS OF THE PROJECT GEOTECHNICAL REPORT. REFERENCE DRAWING S-0.1 & PROJECT SPECIFICATIONS FOR ADDITIONAL INFORMATION.
- PIPE & EQUIPMENT LAYOUTS ARE SHOWN FOR GENERAL INFORMATION ONLY. REFERENCE CIVIL, ELECTRICAL, MECHANICAL & EQUIPMENT VENDOR DRAWINGS FOR LOCATIONS & INFO REGARDING SLAB PENETRATIONS, PIPING & MISCELLANEOUS EQUIPMENT EITHER SHOWN OR NOT SHOWN.
- REFERENCE EQUIPMENT VENDOR DRAWINGS FOR COORDINATION & INSTALLATION OF ANCHORING EQUIPMENT TO T.O. CONC. SLAB.
- INSTALL EXTR. GRADE EXP. JT. MATERIAL, CAULK & SEAL THE TOP OF JOINT w/ SONOLASTIC "SL-2" POLYURETHANE OR AN APPROVED EQUAL.

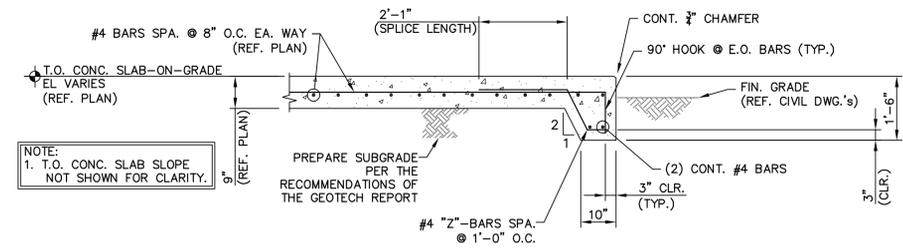

2 - SECTION - TYP. SLAB-ON-GRADE THK'D T/D REINF.

SCALE: 1/2" = 1'-0"

S:\1024\0147\DWG-DRAWINGS\Structure\5-1-SC105-10240147.dwg, 2/15/2012, 4:23:25 PM, Bill Bond

REV. NO.	DESCRIPTIONS / REVISIONS	DATE

SEAL

WILLIAM F. BAND, P.E.
No. 67838

SEAL

McKIM & CREED


1365 Hamlet Avenue
Clearwater, Florida 33756
Phone: (727)442-7196, Fax: (727)461-3827
EB0006691
www.mckimcreed.com

MANATEE COUNTY, FLORIDA


SWRF LAKE FILTRATION AND NORTH POND IMPROVEMENTS

EFFLUENT PUMP STATION PLAN, SECTIONS AND DETAILS


DATE: FEBRUARY 2012	SCALE:	DRAWING NUMBER:
MCE PROJ. # 1024-0147	HORIZONTAL: AS NOTED	S-5.1
DRAWN: WFB	VERTICAL: NA	
DESIGNED: WFB	STATUS: ISSUE FOR BID	REVISION:
CHECKED: JSL		
PROJ. MGR: MSL		

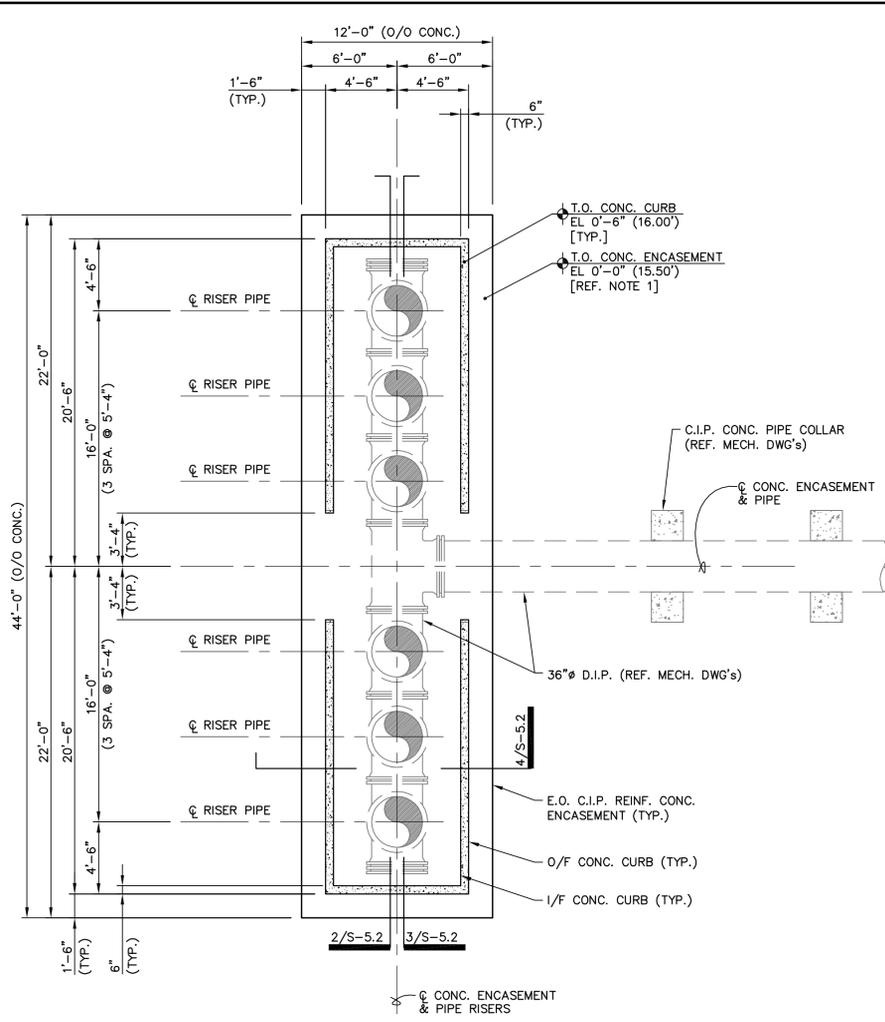

1 - PLAN - REJECT POND OUTLET ASSEMBLY PIPE LAYOUT
SCALE: 3/16"=1'-0"

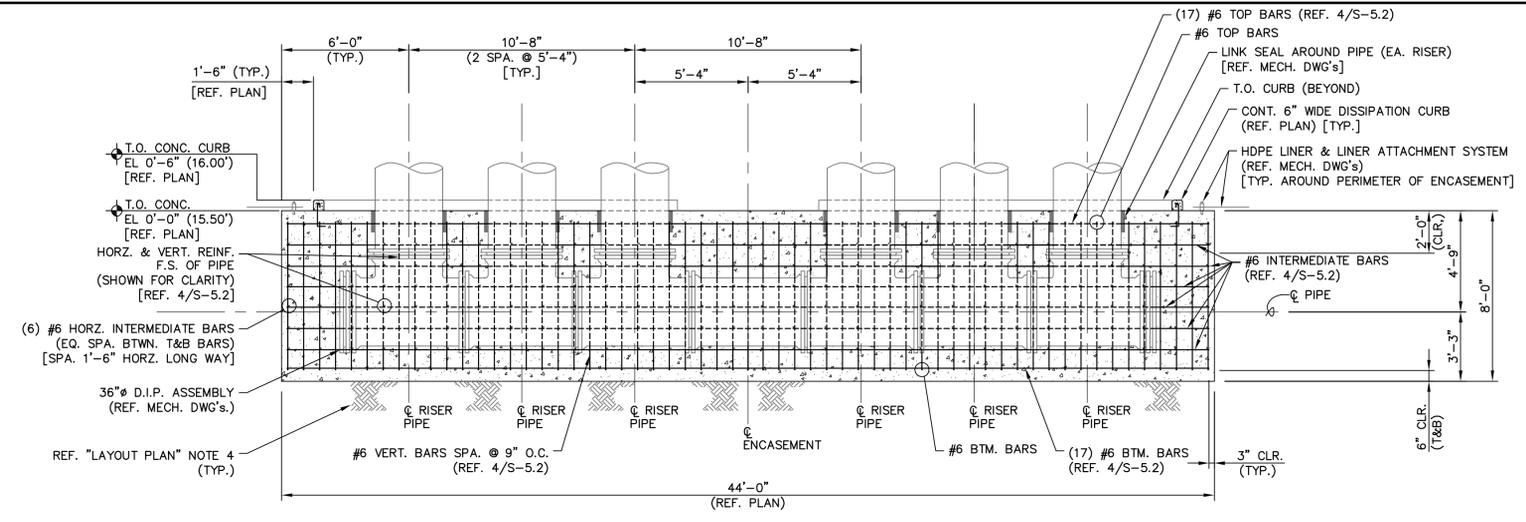


2 - SECTION - THRU REJECT POND OUTLET PIPE
SCALE: 1/4"=1'-0"

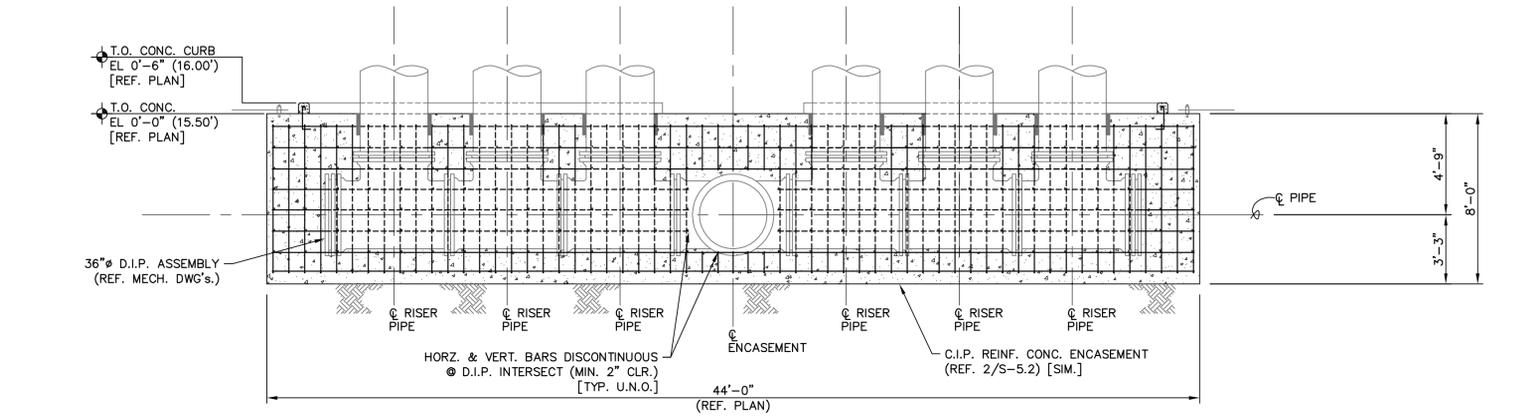


3 - SECTION - THRU REJECT POND OUTLET PIPE
SCALE: 3/8"=1'-0"

LAYOUT PLAN NOTES:

- REFERENCE ELEVATION FOR THE REJECT POND INLET PIPE FACILITY IS THE T.O. CONC. EL. 0'-0" = EL. 15'-6" (15.50') N.G.V.D.-29. REFERENCE CIVIL DWG'S FOR ADDITIONAL INFORMATION.
- REFERENCE DWG. S-0.1 FOR ADDITIONAL GENERAL NOTES & DESIGN CRITERIA.
- GRADE ELEVATION AROUND THIS STRUCTURE IS 15.50' (±). REFERENCE CIVIL DRAWINGS FOR ADDITIONAL INFORMATION.
- PREPARE THE SUBGRADE MATERIAL BELOW & ON THE SIDES OF THE FACILITY CONCRETE ENCASUREMENT PER THE RECOMMENDATIONS OF THE PROJECT GEOTECHNICAL REPORT. REFERENCE DRAWING S-0.1 & PROJECT SPECIFICATIONS FOR ADDITIONAL INFORMATION.
- PIPE & EQUIPMENT LAYOUTS ARE SHOWN FOR GENERAL INFORMATION ONLY. REFERENCE CIVIL & MECHANICAL DWG'S FOR ADDITIONAL ENCASUREMENT PENETRATION, PIPING & MISCELLANEOUS EQUIPMENT EITHER SHOWN OR NOT SHOWN.
- REFERENCE EQUIPMENT VENDOR DRAWINGS FOR COORDINATION & INSTALLATION OF ANCHORING EQUIPMENT TO T.O. CONC. ENCASUREMENT.

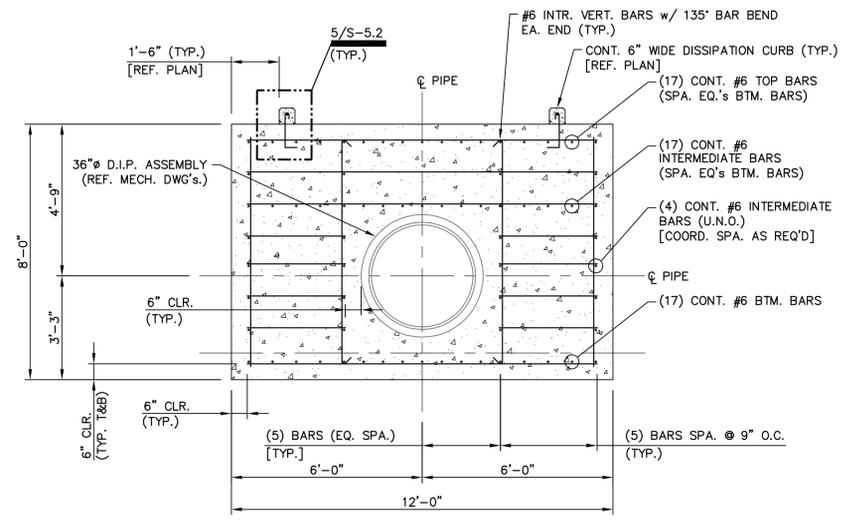

4 - SECTION - THRU REJECT POND OUTLET PIPE
SCALE: 3/8"=1'-0"

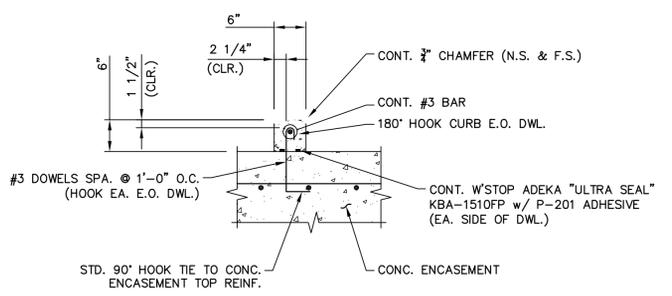

5 - DETAIL - TYP. DISSIPATION CURB REINF.
SCALE: 3/4"=1'-0"



REV. NO.	DESCRIPTION	DATE

WILLIAM F. BAND, P.E.
No. 67838

SEAL

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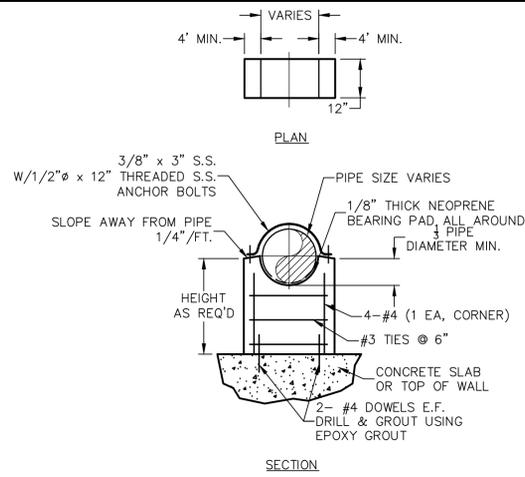
MANATEE COUNTY, FLORIDA

SWRF LAKE FILTRATION AND NORTH POND IMPROVEMENTS


REJECT POND OUTLET ASSEMBLY PLAN, SECTIONS AND DETAILS

DATE: FEBRUARY 2012	SCALE:	DRAWING NUMBER:
MCE PROJ. # 1024-0147	HORIZONTAL: AS NOTED	S-5.2
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DESIGNED: WFB		
CHECKED: JSL		
PROJ. MGR: MSL		
STATUS: ISSUE FOR BID		


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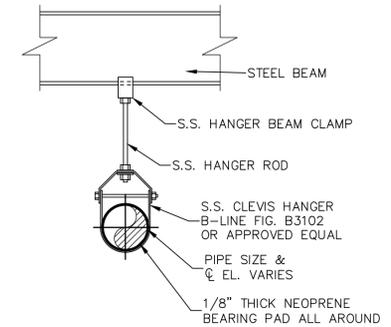
PIPE SUPPORT TYPE 1
NOT TO SCALE




PIPE SUPPORT TYPE 2
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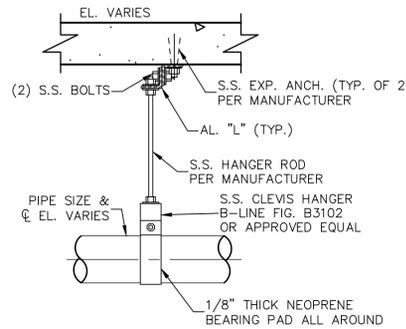
PIPE SUPPORT TYPE 3
NOT TO SCALE

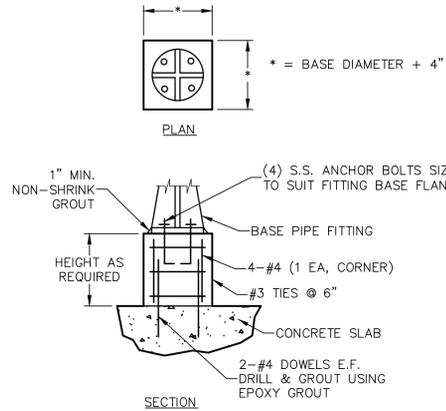


PIPE SUPPORT TYPE 4
NOT TO SCALE

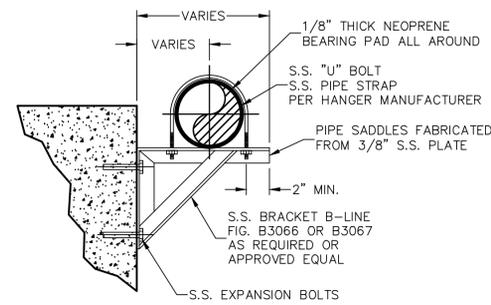


PIPE SUPPORT TYPE 5
NOT TO SCALE

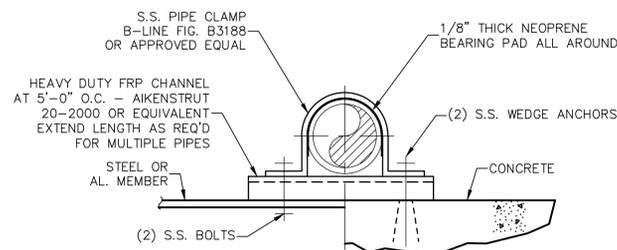


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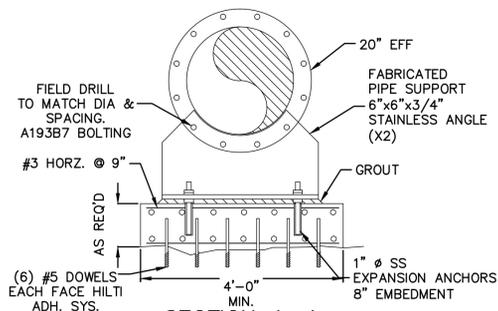
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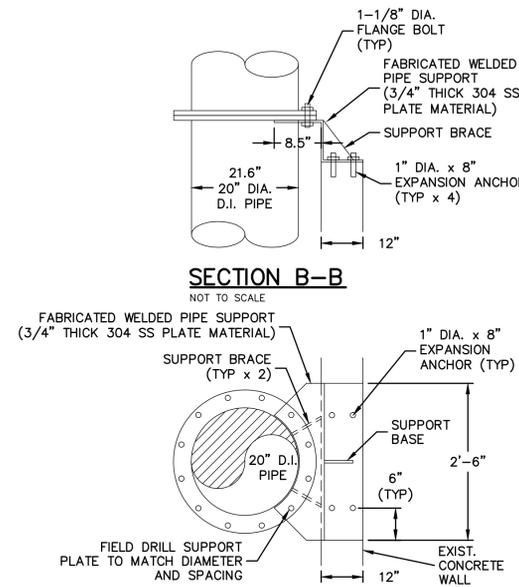
PIPE STAND-OFF BRACKET TYPE 8
NOT TO SCALE

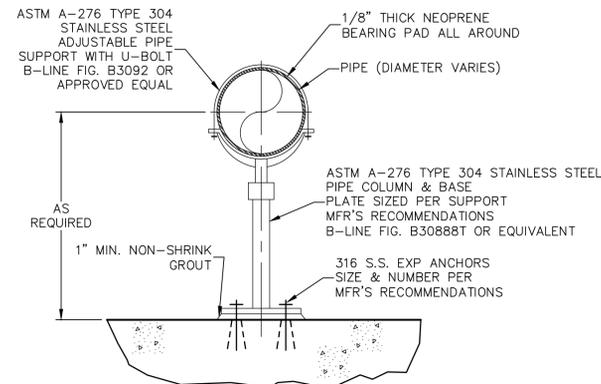


PIPE SUPPORT TYPE 9
NOT TO SCALE

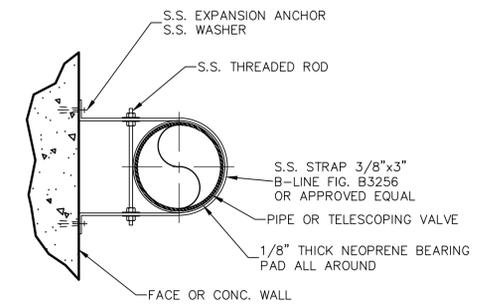

PIPE SUPPORT TYPE 10
NOT TO SCALE

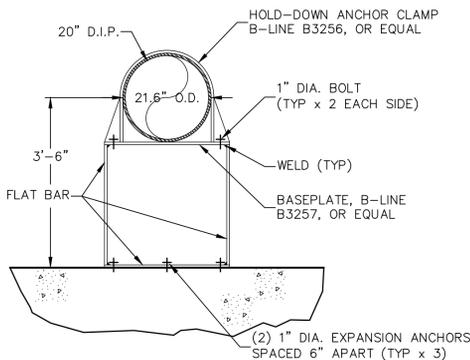

PIPE SUPPORT TYPE 11
NOT TO SCALE

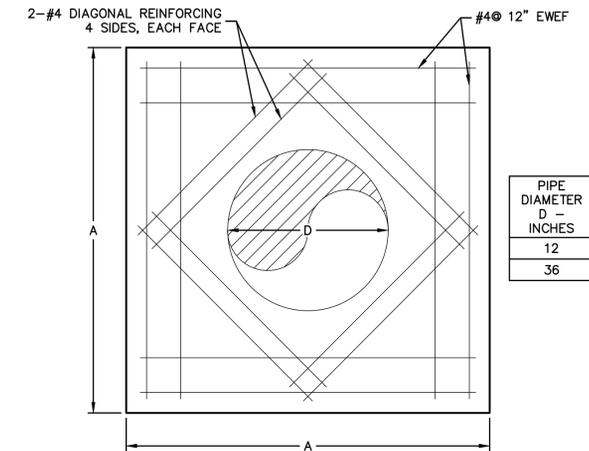

CONCRETE COLLAR DETAIL
NOT TO SCALE

PIPE DIAMETER D - INCHES	SIDE LENGTH A - FEET	CONCRETE COLLAR THICKNESS INCHES
12	4	24
36	7	24

S:\1024\0147\1024-0147-Miscellaneous\Mechanical\M-0.1-Miscellaneous.dwg, 2/15/2012, 3:48:30 PM, Brian Naught

REV. NO.	DESCRIPTIONS	DATE

SEAL
NORMAN J. SCALLY, P.E.
No. 41338

SEAL

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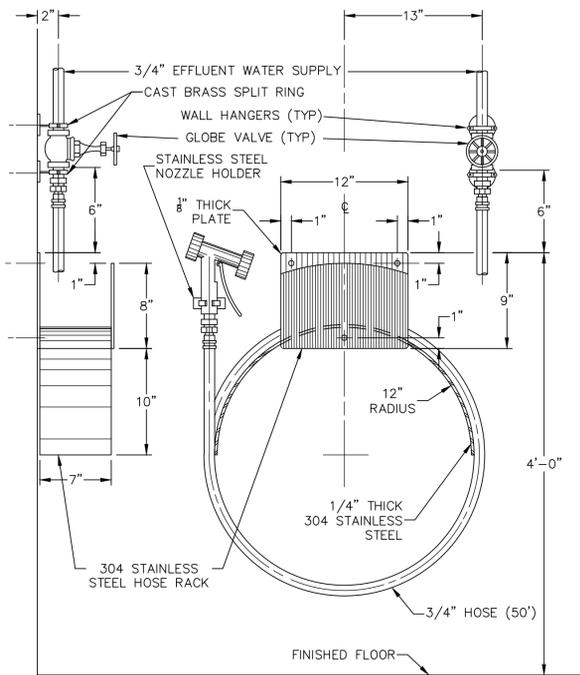
SWRF LAKE FILTRATION AND
NORTH POND IMPROVEMENTS
**MECHANICAL
MISCELLANEOUS DETAILS No. 1**

DATE: FEBRUARY 2012
MCE PROJ. # 1024-0147
DRAWN: BFN
DESIGNED: NJS
CHECKED: DCW
PROJ. MGR: MSL


SCALE: HORIZONTAL: NONE
VERTICAL: NA

DRAWING NUMBER: **M-0.1**

STATUS: **ISSUE FOR BID**





HOSE BIB AND RACK
NOT TO SCALE

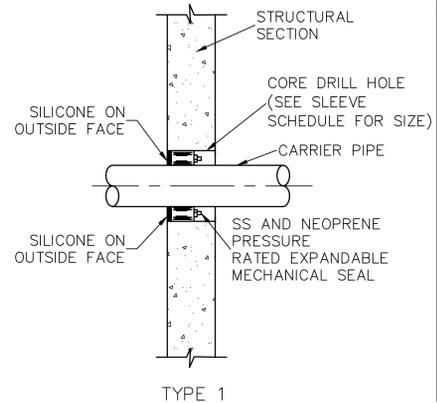

SLEEVE SCHEDULE				
NOMINAL DIAMETER INCHES	CARRIER PIPE		STEEL SLEEVE INSIDE DIAMETER (INCHES)	CORE DRILLED INSIDE DIAMETER (INCHES)
	MATERIAL	OUTSIDE DIAMETER INCHES		
1/2	SCH. 80 PVC	0.84	2.067	2
3/4	SCH. 80 PVC	1.05	2.067	3.0
1	SCH. 80 PVC	1.315	2.469	2.5
1 1/2	SCH. 80 PVC	1.90	4.026	4
2	SCH. 80 PVC	2.38	4.026	4
3	SCH. 80 PVC	3.50	5.047	5
4	SCH. 80 PVC	4.5	6.065	6
6	D.I.	9.60	10.02	10
8	D.I.	9.05	12.0	12
10	D.I.	11.10	13.25	14
12	D.I.	13.20	15.25	16
16	D.I.	17.40	19.25	20
18	D.I.	19.50	23.25	24
24	D.I.	25.80	29.25	30
36	D.I.	38.30	43.25	43
42	D.I.	44.50	47.25	48

NOTE:
INSTALL SEALS FROM DRY SIDE OF PENETRATION. WET SIDE FILLED WITH WATERPROOF NON-SHRINK GROUT.

LINK SEAL WALL PENETRATION
NOT TO SCALE

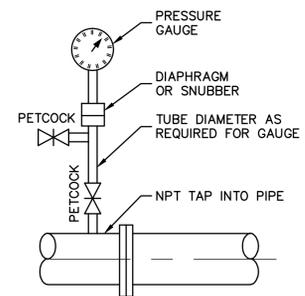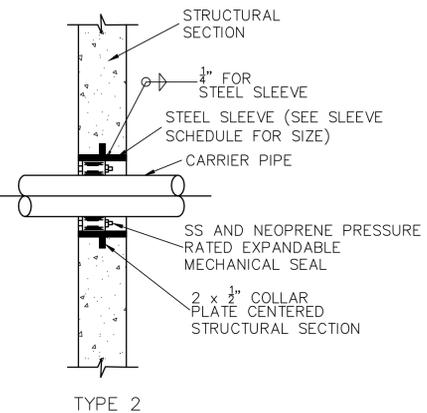

TYPICAL PRESSURE GAUGE INSTALLATION
NTS

S:\1024\0147\1024-Miscellaneous\Mechanical\M-0.2-M-502.dwg, 2/15/2012 2:48:32 PM, Brian Naught

REV. NO.	DESCRIPTIONS	DATE

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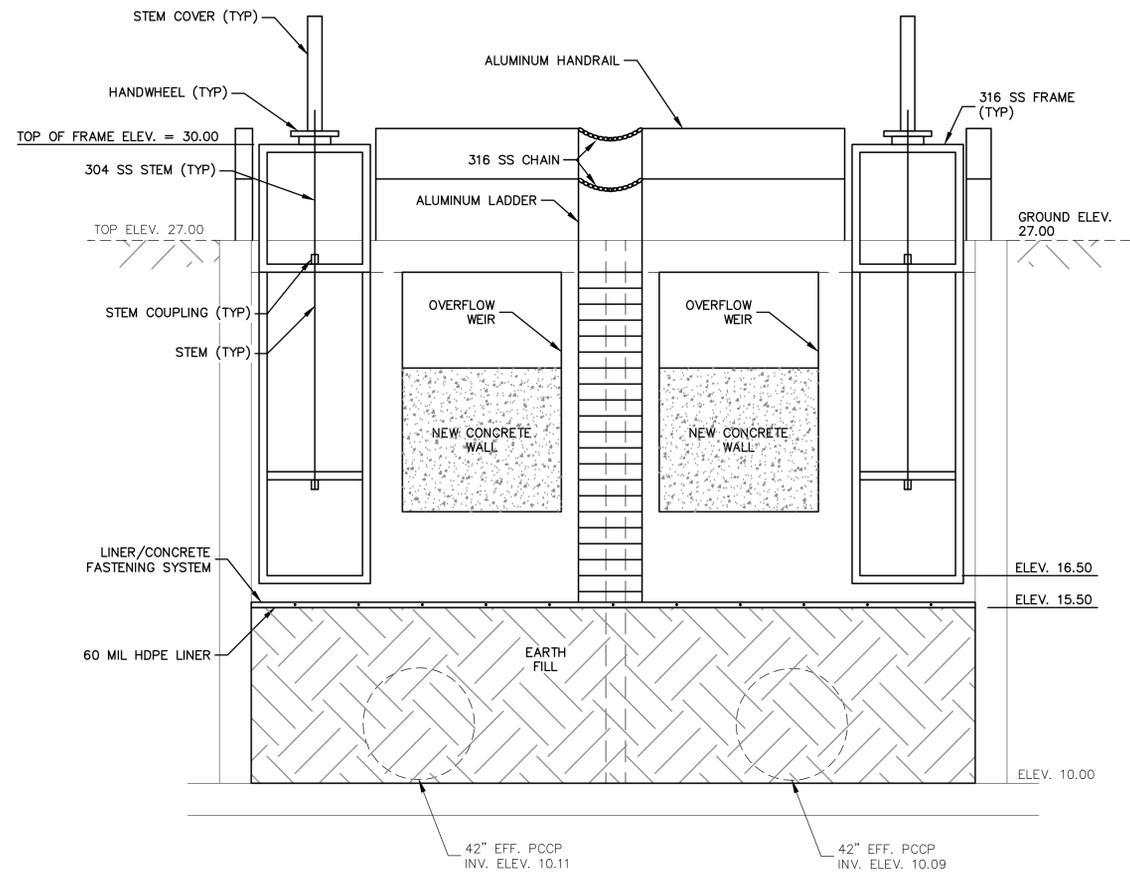
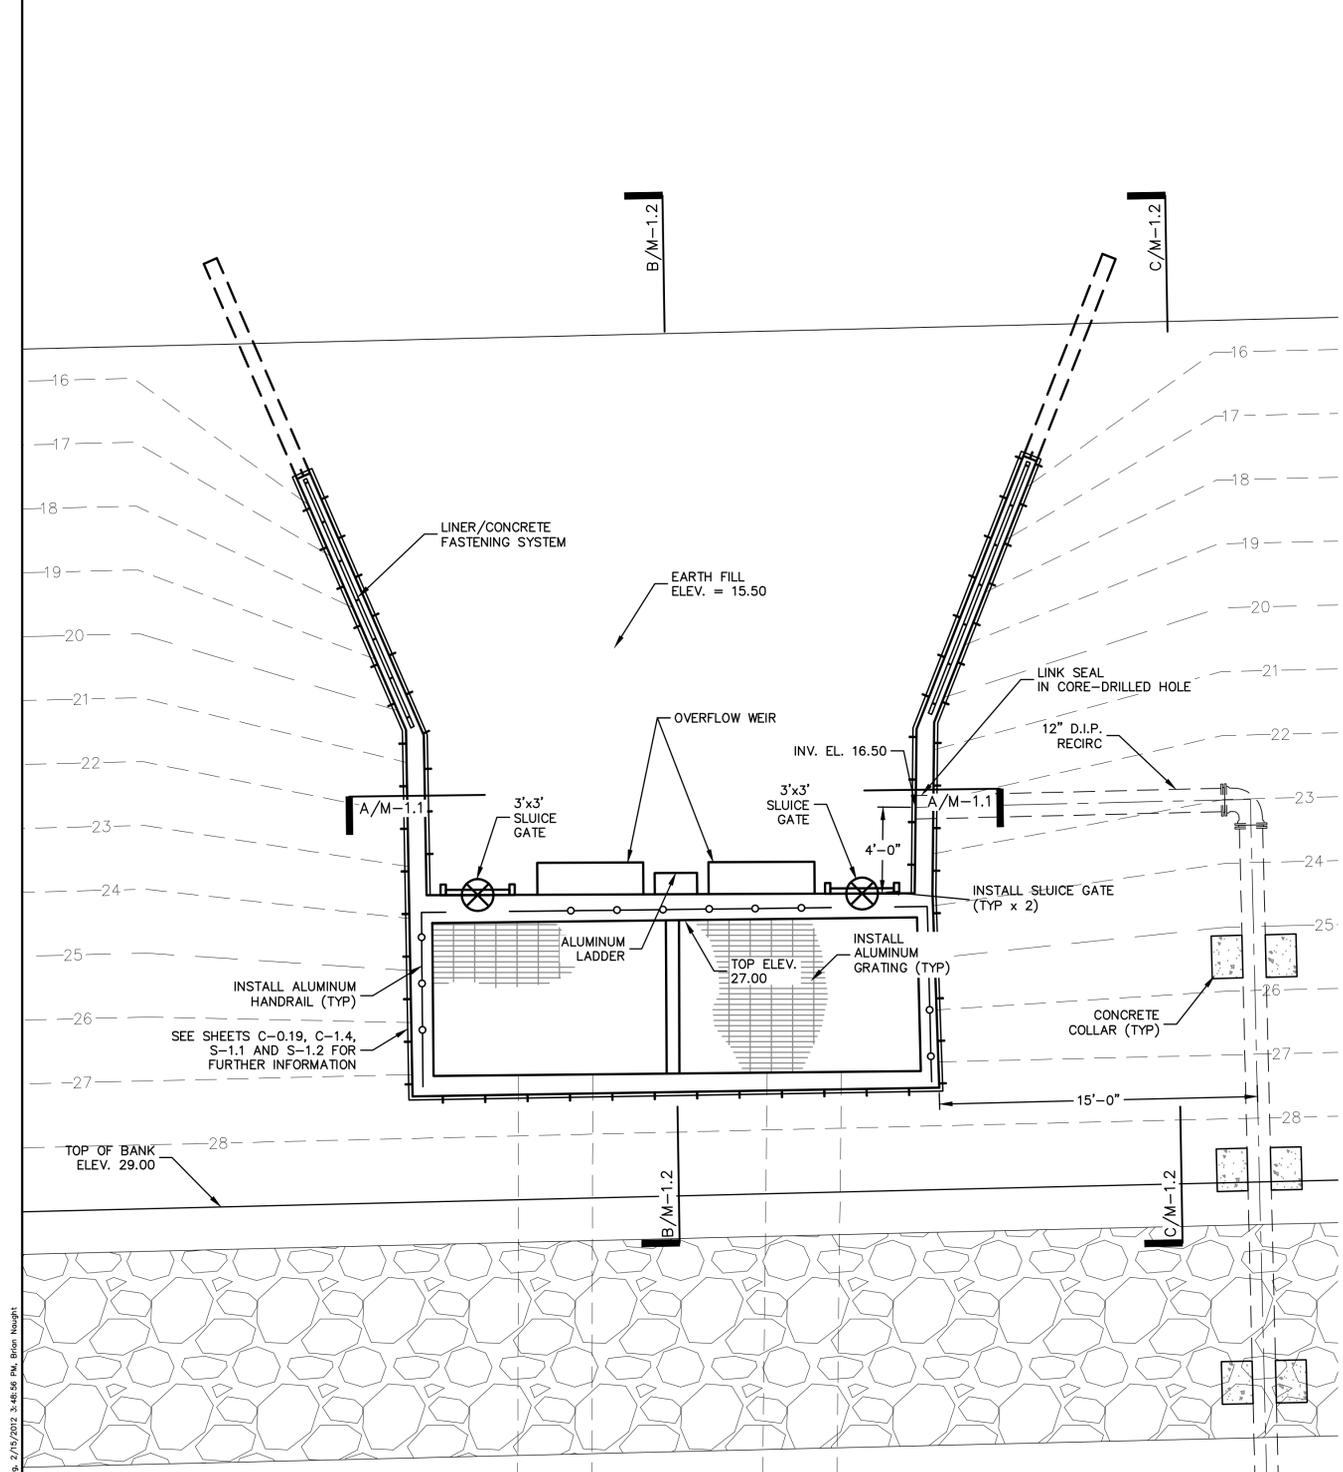
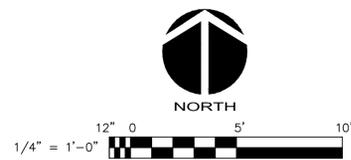
SWRF LAKE FILTRATION AND NORTH POND IMPROVEMENTS
MECHANICAL MISCELLANEOUS DETAILS No. 2

DATE: FEBRUARY 2012
MCE PROJ. # 1024-0147
DRAWN: BFN
DESIGNED: NJS
CHECKED: DCW
PROJ. MGR: MSL


SCALE
HORIZONTAL: NONE
VERTICAL: NA

DRAWING NUMBER
M-0.2

STATUS: **ISSUE FOR BID**



SECTION A/M-1.1
SCALE: 3/8" = 1'-0"

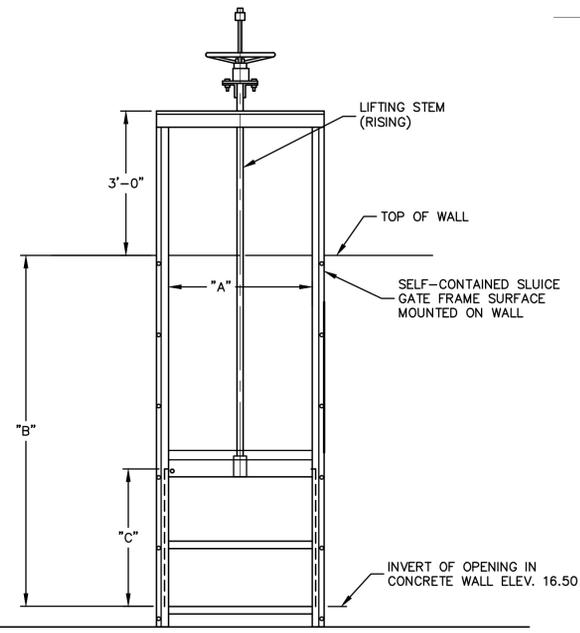

SELF-CONTAINED SLUICE GATE DETAIL
SCALE: NTS

SLUICE GATE SCHEDULE		
IDENTIFICATION NUMBER	SLC-1	SLC-2
MOUNTING LOCATION	NORTH POND OUTLET STRUCTURE	NORTH POND OUTLET STRUCTURE
OPERATOR TYPE	FRAME MOUNTED HANDWHEEL	FRAME MOUNTED HANDWHEEL
OPENING WIDTH "A"	3'-0"	3'-0"
FRAME HEIGHT "B"	10'-6"	10'-6"
GATE HEIGHT "C"	3'-0"	3'-0"
MAX. WATER DEPTH AT GATE	10'-6"	10'-6"

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REV. NO.	DESCRIPTIONS	DATE

SEAL

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MANATEE COUNTY, FLORIDA

SWRF LAKE FILTRATION AND NORTH POND IMPROVEMENTS


NORTH POND OUTLET STRUCTURE MODIFICATION PLAN

DATE: FEBRUARY 2012
MCE PROJ. # 1024-0147
DRAWN: BFN
DESIGNED: NJS
CHECKED: MSL
PROJ. MGR. MSL

SCALE: HORIZONTAL: AS SHOWN
VERTICAL: N/A

DRAWING NUMBER: **M-1.1**

STATUS: **ISSUE FOR BID**

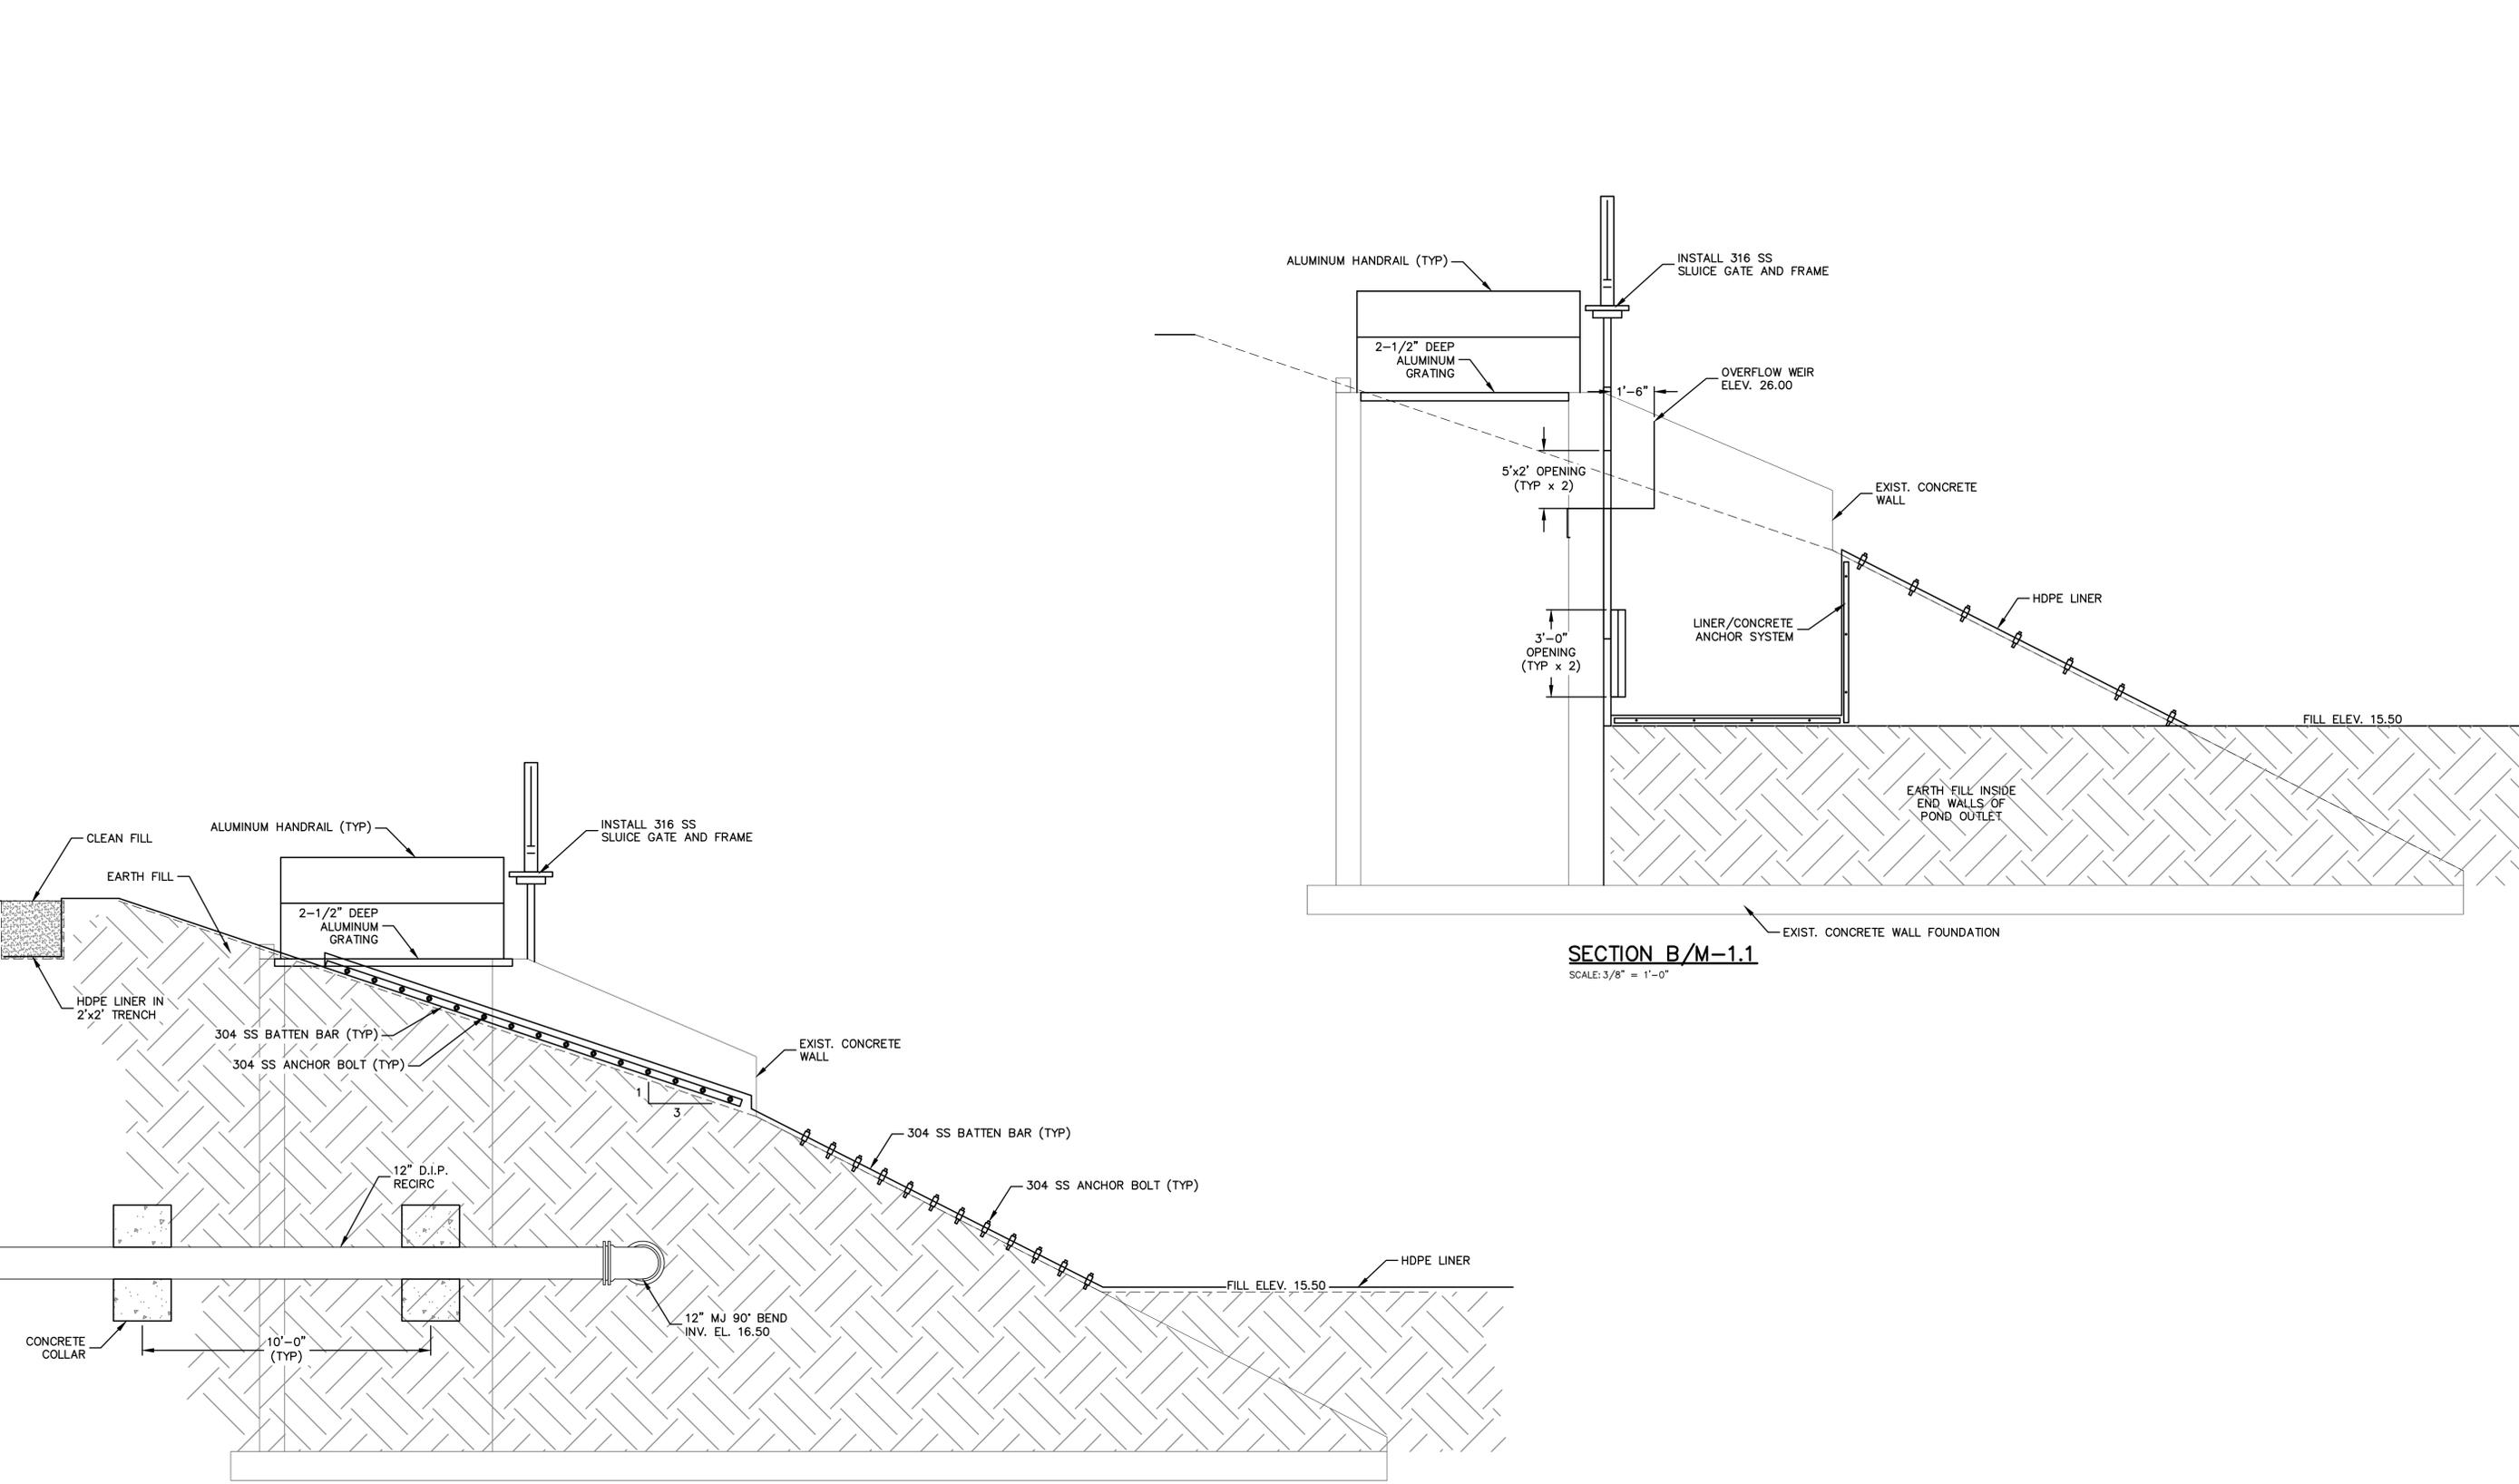

SECTION B/M-1.1
SCALE: 3/8" = 1'-0"

SECTION C/M-1.1
SCALE: 3/8" = 1'-0"

REV. NO.	DESCRIPTIONS	DATE

SEAL

NORMAN J. SCALLY, P.E.
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MANATEE COUNTY, FLORIDA

SWWRF LAKE FILTRATION AND NORTH POND IMPROVEMENTS


NORTH POND OUTLET STRUCTURE MODIFICATION SECTIONS

DATE: FEBRUARY 2012	SCALE: 3/8" = 1'-0"	DRAWING NUMBER: M-1.2
MCE PROJ. # 1024-0147	HORIZONTAL: 3/8" = 1'-0"	
DRAWN: BFN	VERTICAL: N/A	
DESIGNED: NJS		
CHECKED: MSL		
PROJ. MGR.:		
STATUS: ISSUE FOR BID		

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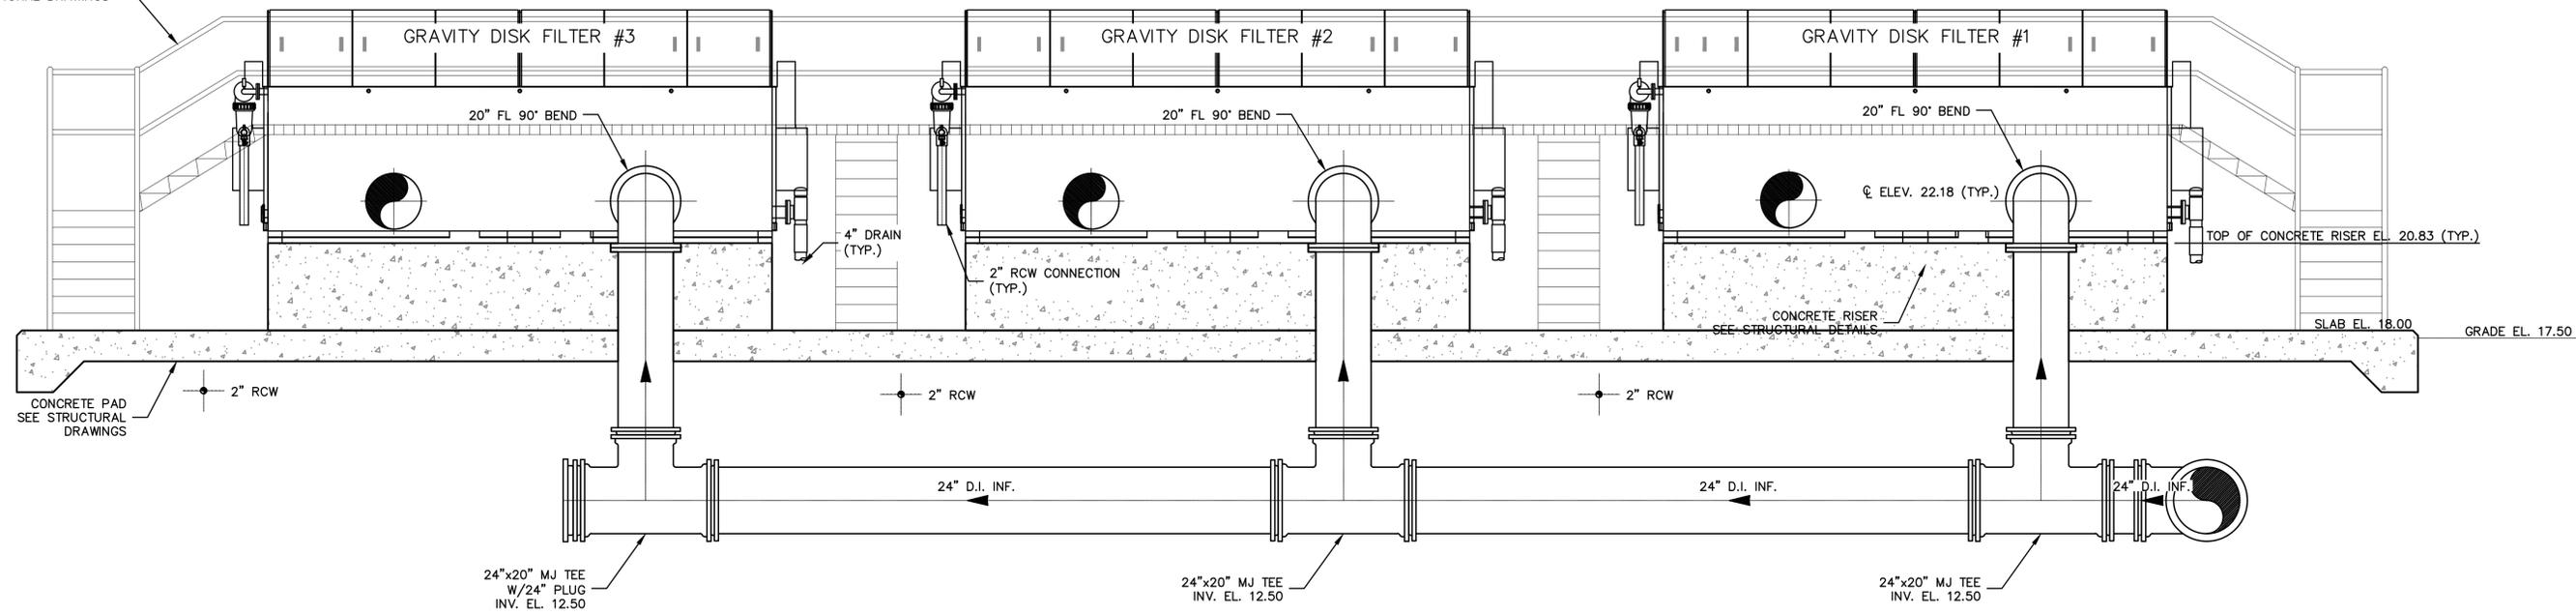
NOTE:
ALL BURIED PIPE, FITTINGS AND VALVES
SHALL HAVE RESTRAINED JOINTS.

AL HANDRAIL, STAIRS AND WALKWAY
SEE STRUCTURAL DRAWINGS

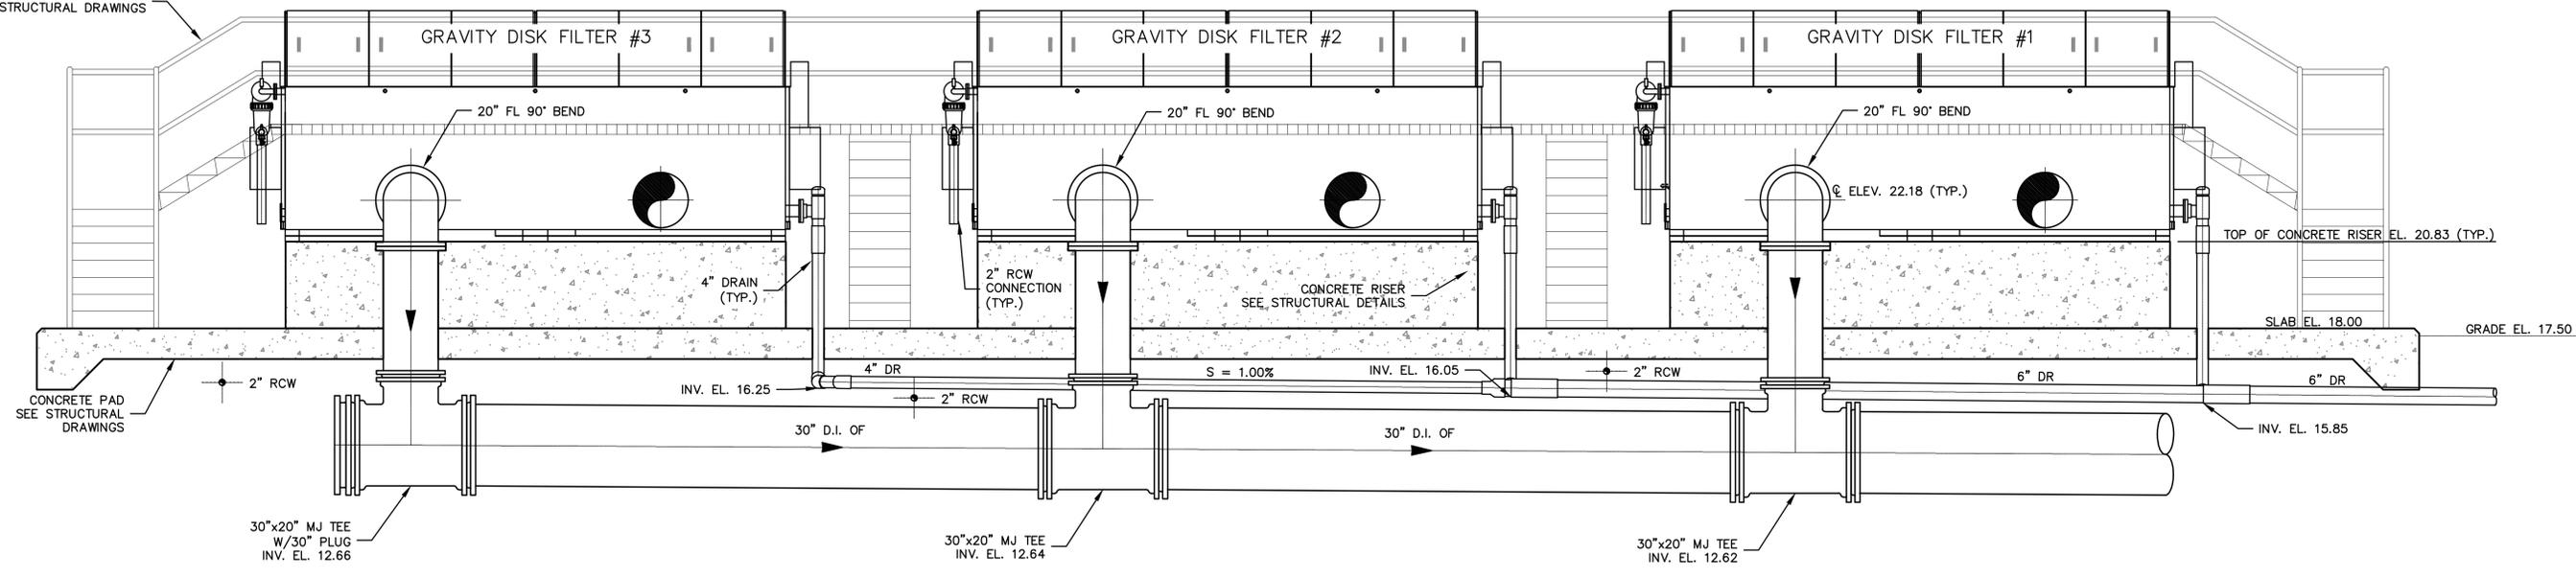

SECTION A/M-2.1
SCALE: 3/8" = 1'-0"

AL HANDRAIL, STAIRS AND WALKWAY
SEE STRUCTURAL DRAWINGS



SECTION B/M-2.1
SCALE: 3/8" = 1'-0"

REV. NO.	DESCRIPTIONS	DATE

SEAL
NORMAN J. SCALLY, P.E.
No. 41338

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MANATEE COUNTY, FLORIDA


**SWWRF LAKE FILTRATION AND
NORTH POND IMPROVEMENTS**

GRAVITY DISK FILTER SECTIONS No. 1


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MCE PROJ. # 1024-0147	VERTICAL: NA	
DRAWN: BFN		
DESIGNED: NJS		
CHECKED: JSL		
PROJ. MGR: MSL		
STATUS: ISSUE FOR BID		

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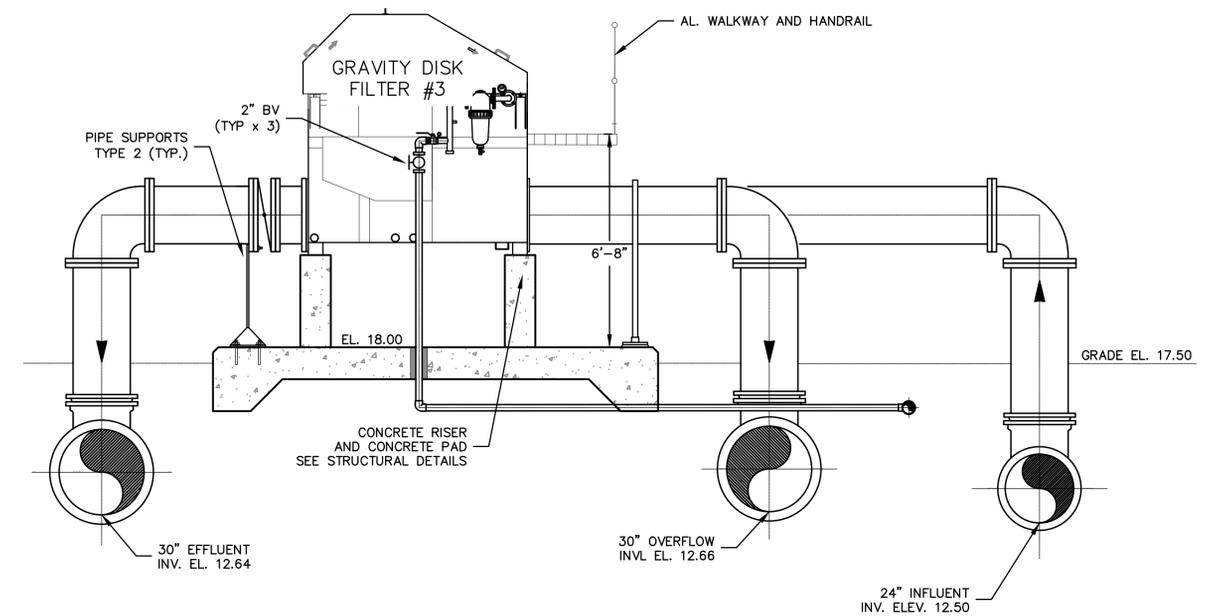
NOTE:
ALL BURIED PIPE, FITTINGS AND VALVES
SHALL HAVE RESTRAINED JOINTS.

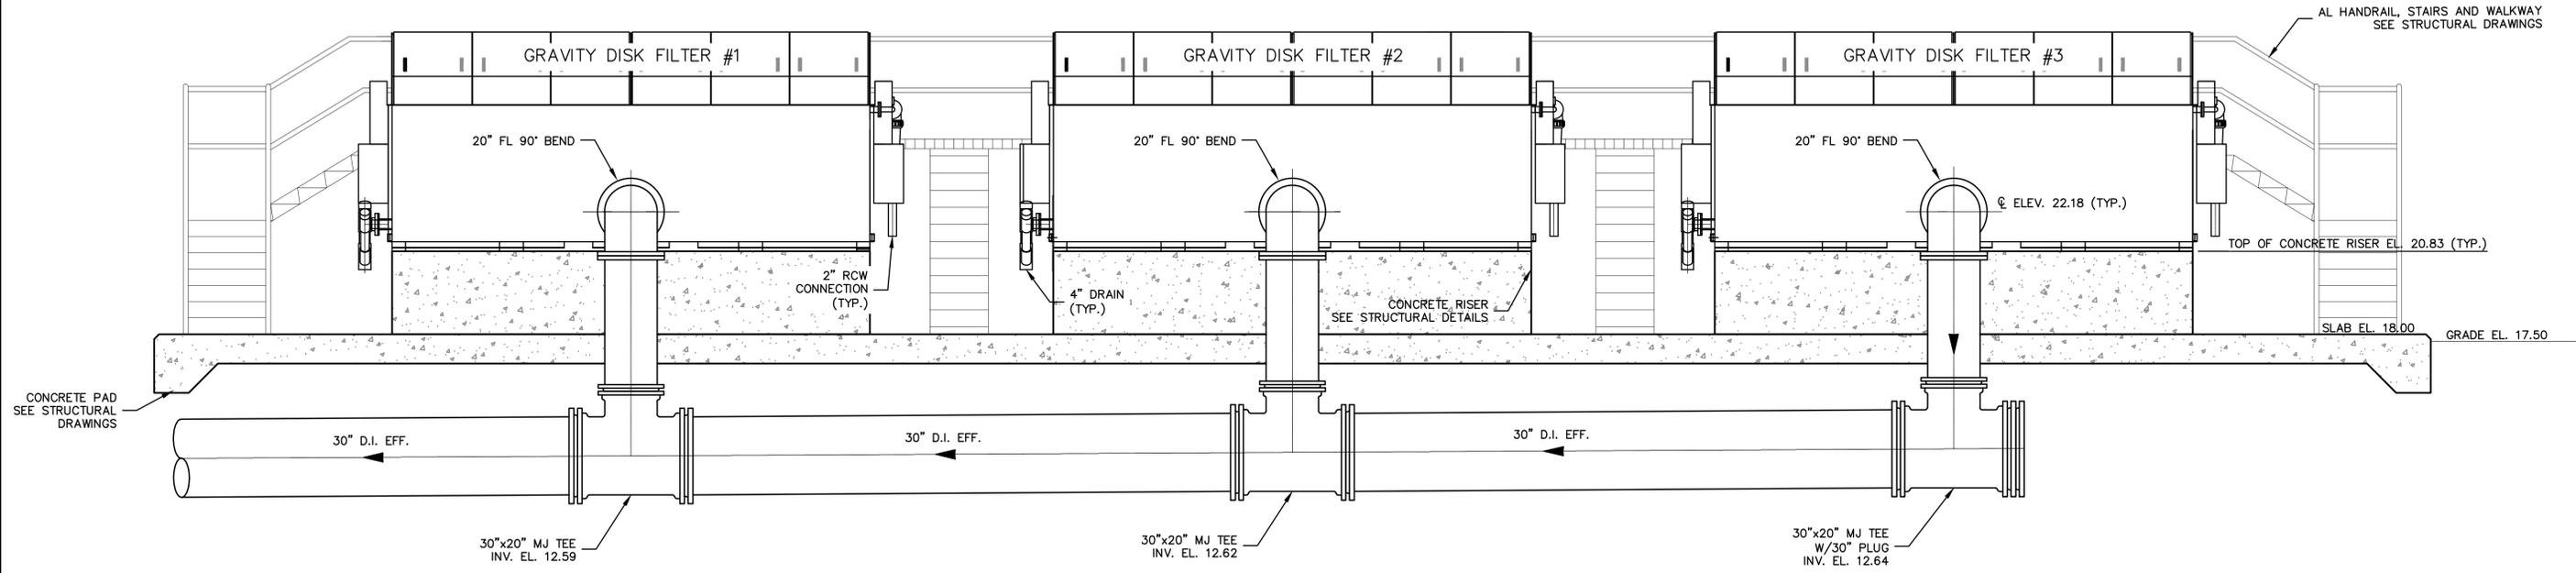

SECTION C/M-2.1
SCALE: 3/8" = 1'-0"

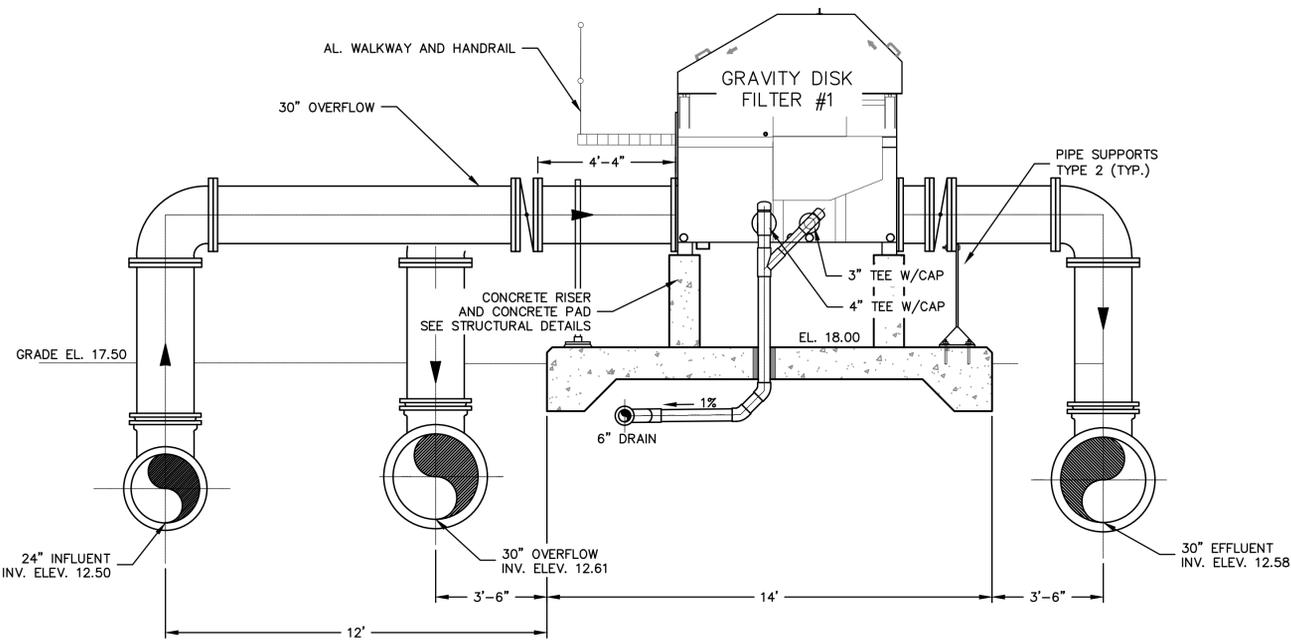

SECTION D/M-2.1
SCALE: 3/8" = 1'-0"



SECTION E/M-2.1
SCALE: 3/8" = 1'-0"

REV. NO.	DESCRIPTIONS	DATE

SEAL

NORMAN J. SCALLY, P.E.
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MANATEE COUNTY, FLORIDA


MANATEE COUNTY, FLORIDA

**SWWRF LAKE FILTRATION AND
NORTH POND IMPROVEMENTS**





GRAVITY DISK FILTER SECTIONS No. 2

DATE: FEBRUARY 2012	SCALE: 3/8" = 1'-0"	DRAWING NUMBER: M-2.3
MCE PROJ. # 1024-0147	HORIZONTAL: 3/8" = 1'-0"	REVISION
DRAWN: BFN	VERTICAL: NA	
DESIGNED: NJS		
CHECKED: JSL		
PROJ. MGR. MSL		
STATUS: ISSUE FOR BID		

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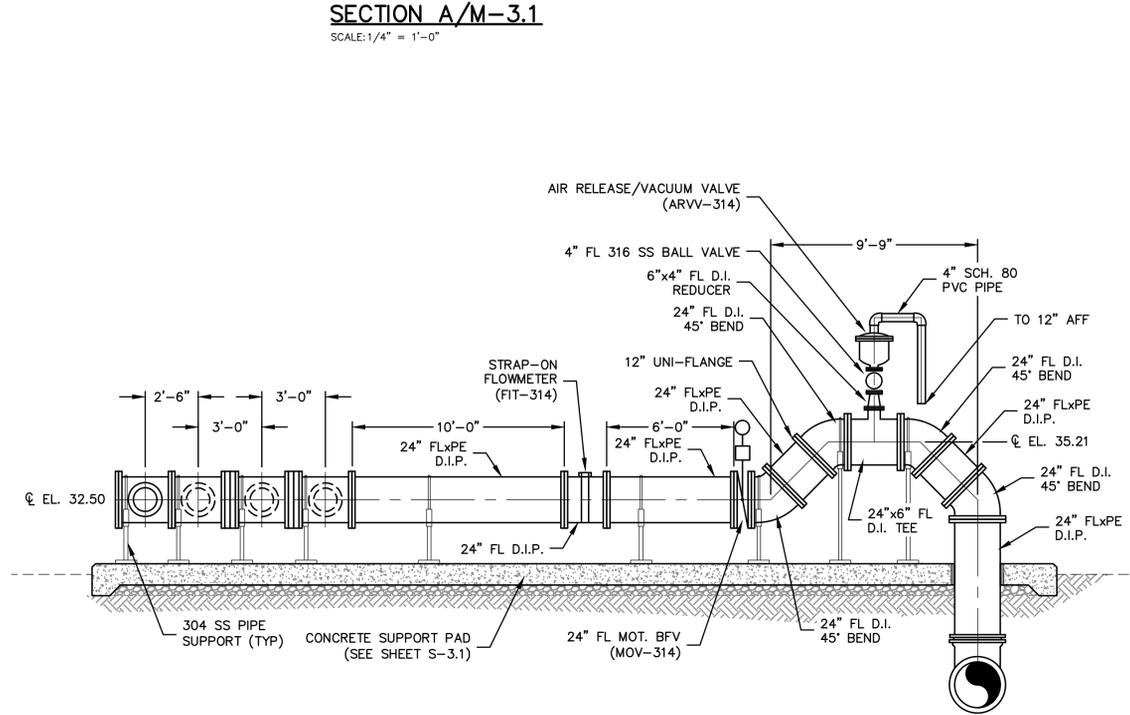


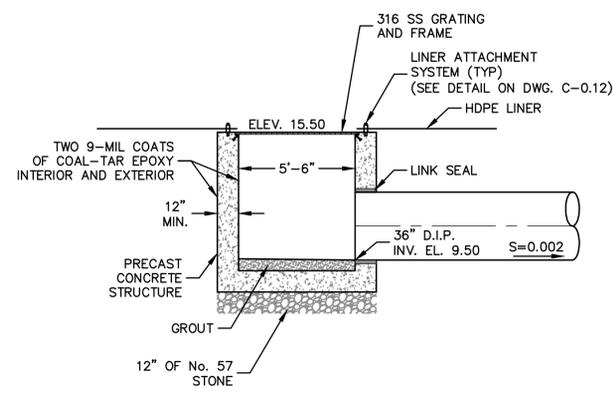SECTION C/M-3.1
SCALE: 1/4" = 1'-0"

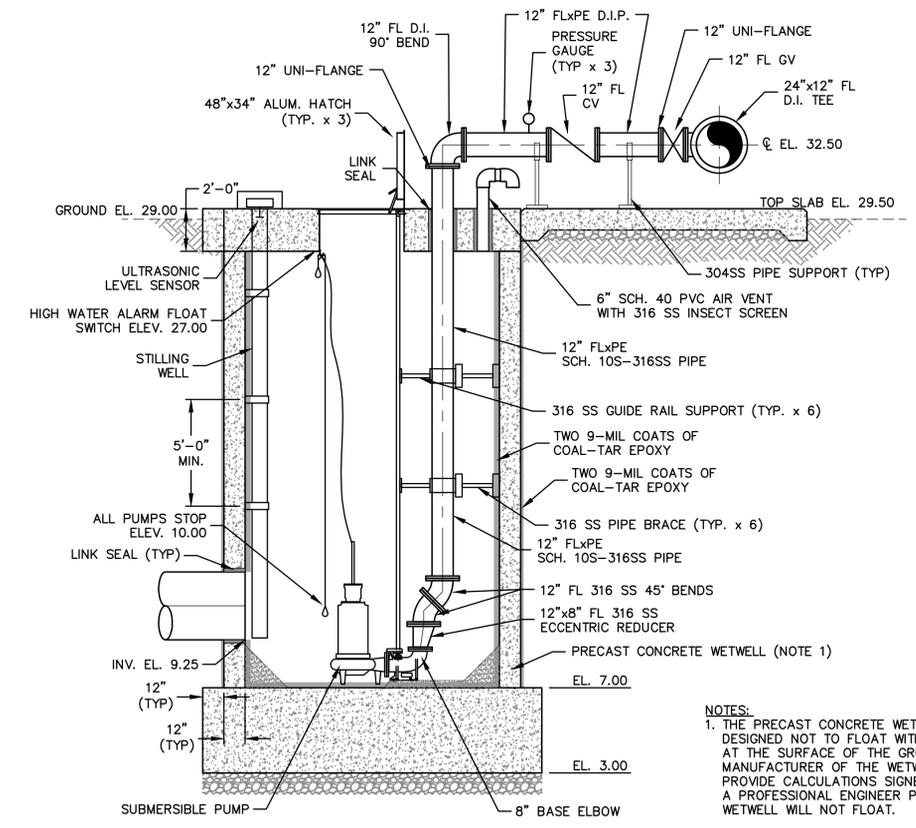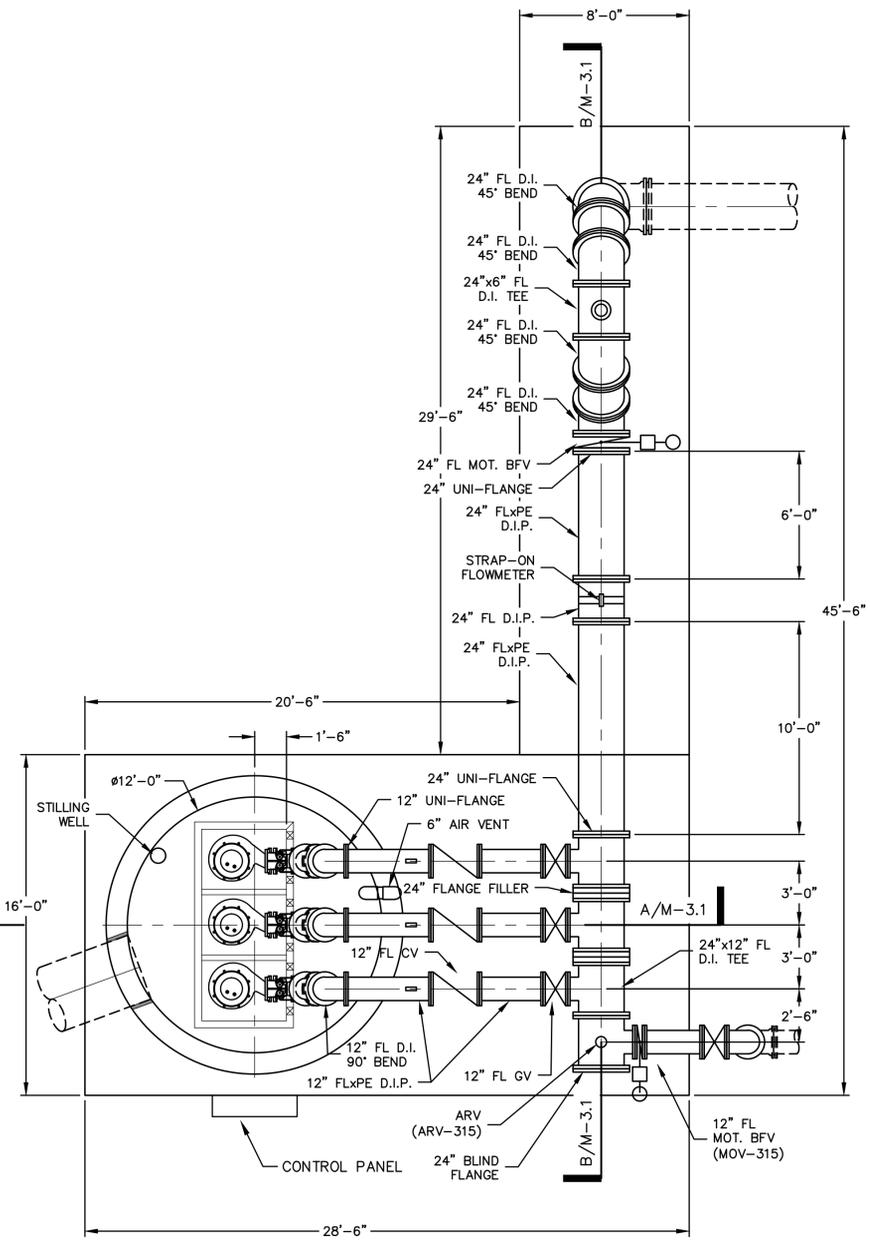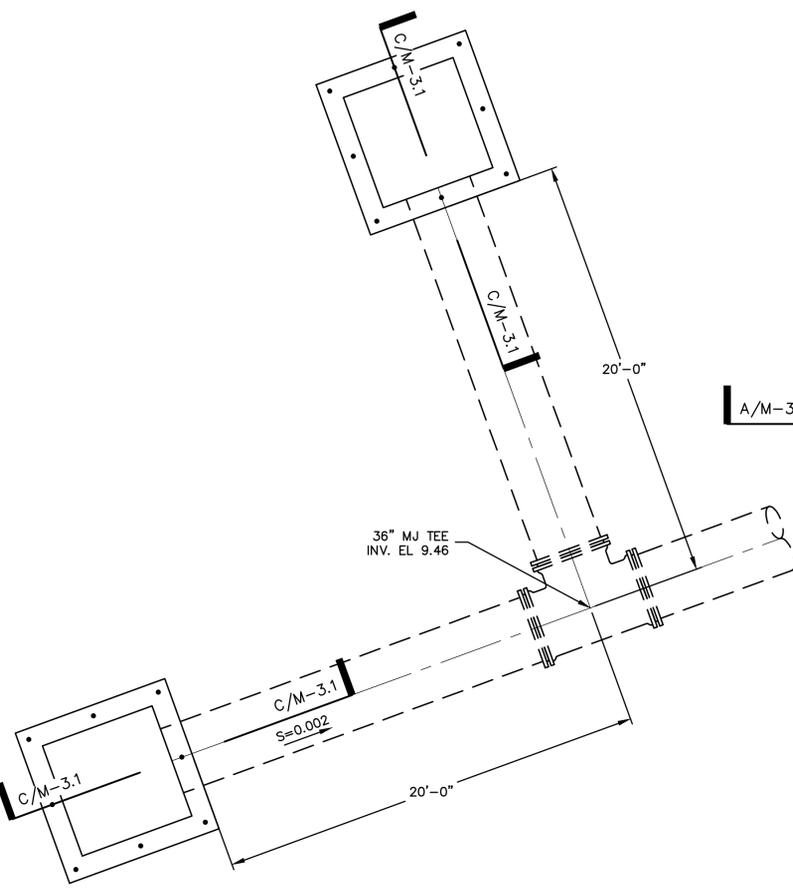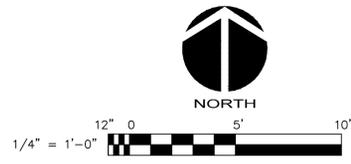

NOTES:
1. THE PRECAST CONCRETE WETWELL SHALL BE DESIGNED NOT TO FLOAT WITH GROUND WATER AT THE SURFACE OF THE GROUND. THE MANUFACTURER OF THE WETWELL SHALL PROVIDE CALCULATIONS SIGNED AND SEALED BY A PROFESSIONAL ENGINEER PROVING THAT THE WETWELL WILL NOT FLOAT.

SECTION A/M-3.1
SCALE: 1/4" = 1'-0"



SECTION B/M-3.1
SCALE: 1/4" = 1'-0"

REV. NO.	DESCRIPTIONS	DATE

SEAL
MATTHEW S. LOVE, P.E.
No. 66118

SEAL

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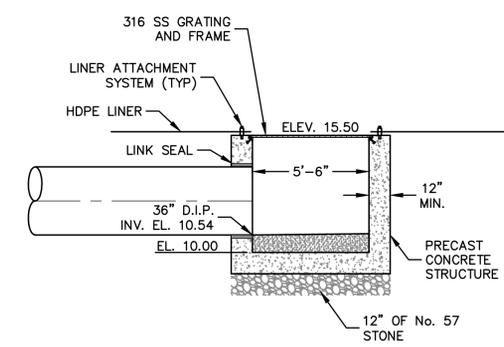
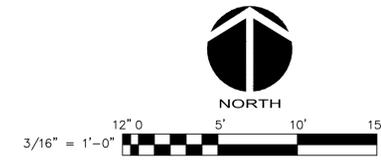
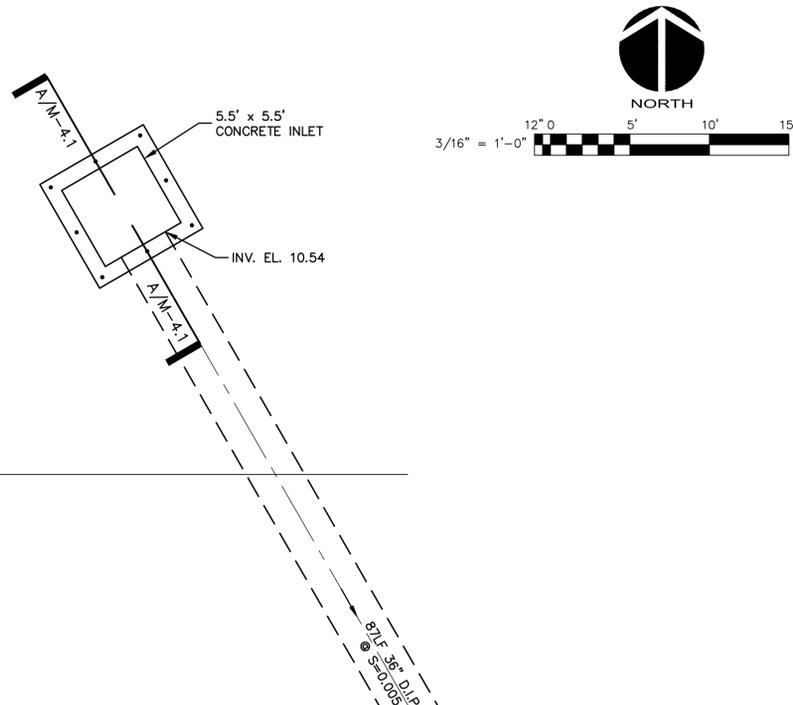
MANATEE COUNTY, FLORIDA

SWWRF LAKE FILTRATION AND NORTH POND IMPROVEMENTS


RECLAIM PUMP STATION PLAN AND SECTIONS

DATE: FEBRUARY 2012	SCALE: HORIZONTAL: 1/4" = 1'-0"	DRAWING NUMBER: M-3.1
MCE PROJ. # 1024-0147	DESIGNED: NJS	CHECKED: MSL
PROJ. MGR. MSL	VERTICAL: N/A	REVISION
ISSUE FOR BID		



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SECTION A/M-4.1
SCALE: 1/4" = 1'-0"



SECTION B/M-4.1
SCALE: 1/4" = 1'-0"

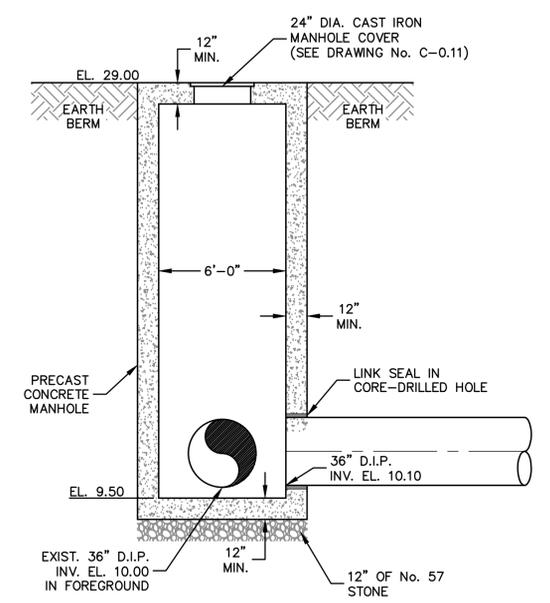

NOTE:
1. REMOVE EXIST. 36" PIPE AND REPLACE WITH 36" D.I.P. INSTALL 36" D.I.P. IN EXIST. P.S. CONCRETE WALL USING LINK SEAL.

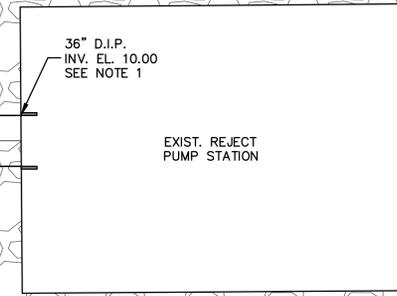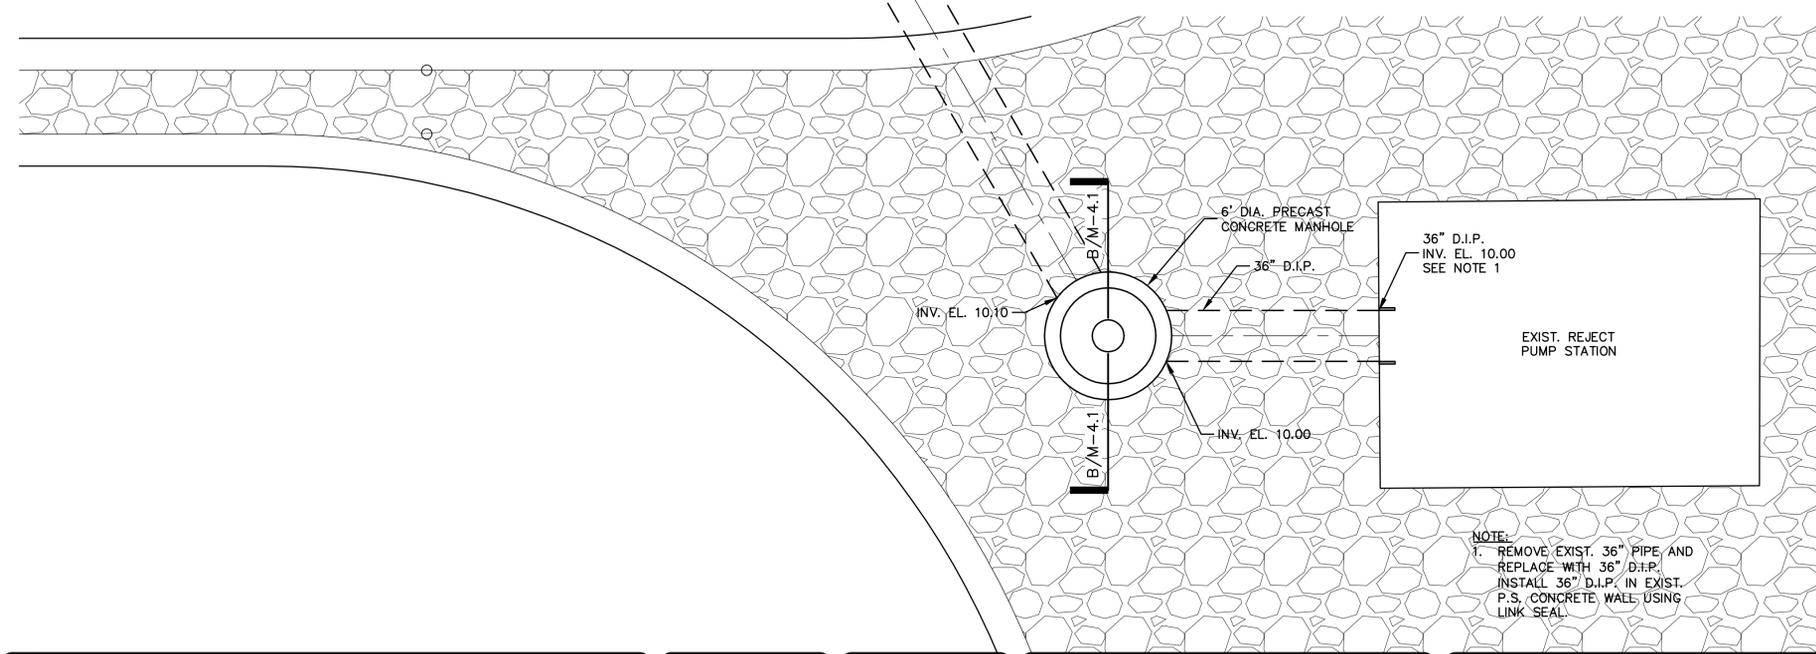

REV. NO.	DESCRIPTIONS	DATE

SEAL
MATTHEW S. LOVE, P.E.
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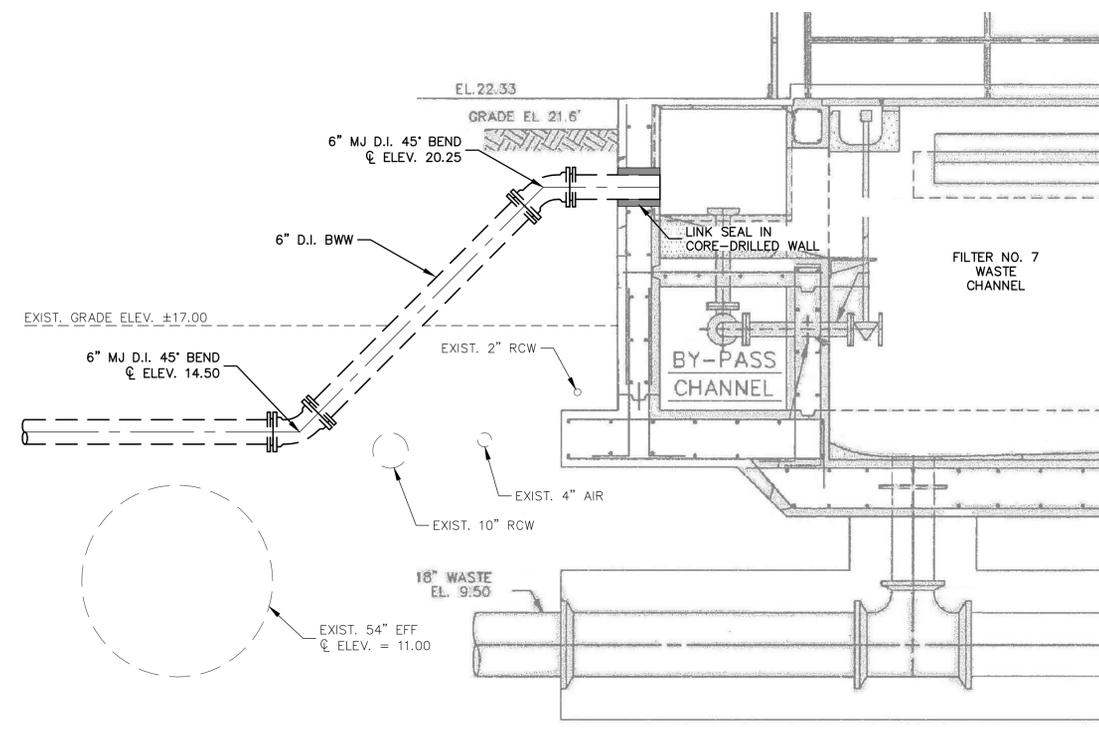
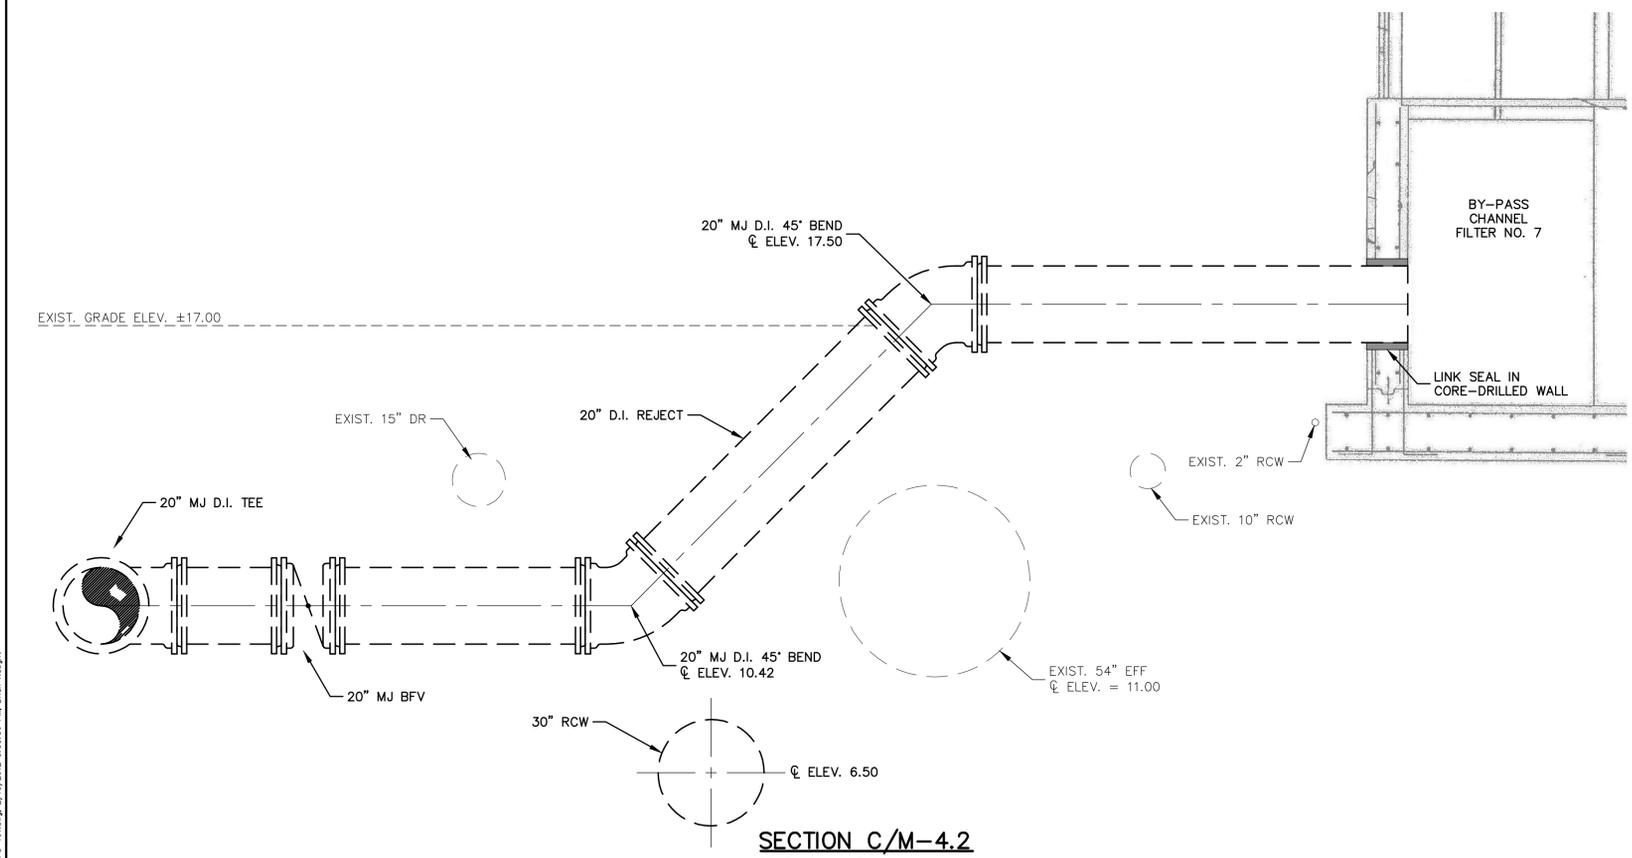
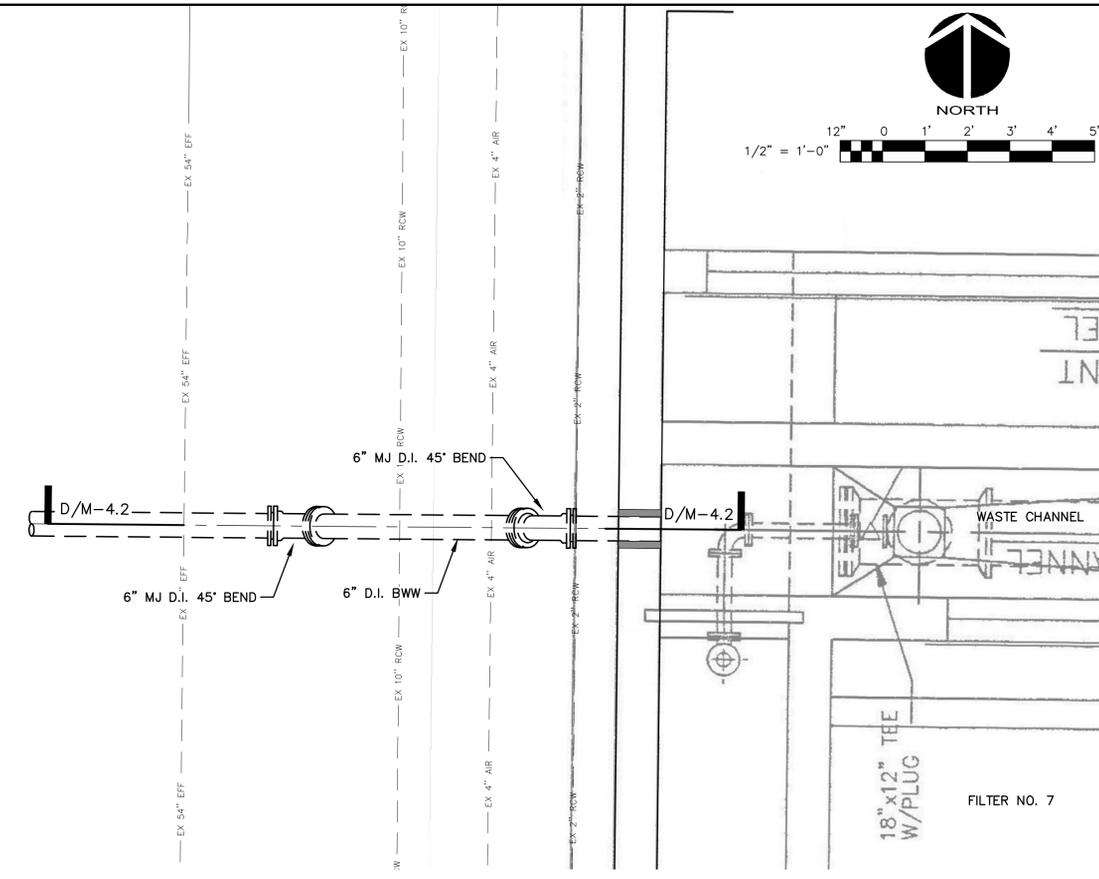
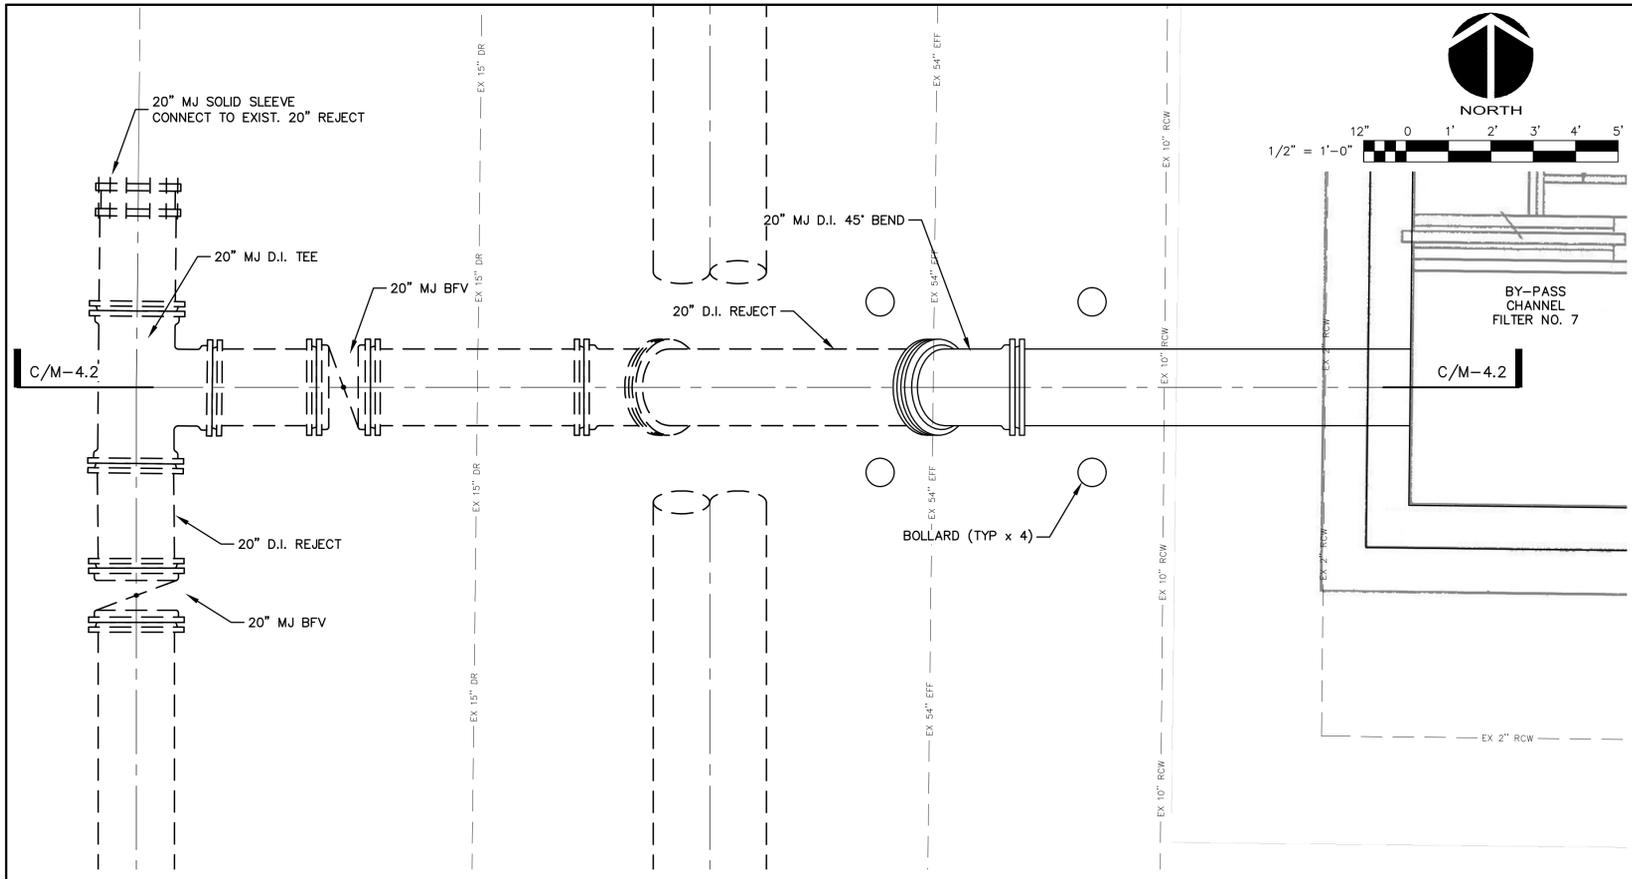
MANATEE COUNTY, FLORIDA

SWWRF LAKE FILTRATION AND NORTH POND IMPROVEMENTS

REJECT PUMP STATION INLET PLAN AND DETAIL

DATE: FEBRUARY 2012	SCALE:	DRAWING NUMBER:
MCE PROJ. # 1024-0147	HORIZONTAL: VARIES	M-4.1
DRAWN: BFN	VERTICAL: N/A	
DESIGNED: NJS	PROJECT MGR. MSL	REVISION:
CHECKED:		ISSUE FOR BID

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SECTION C/M-4.2
SCALE: 1/2" = 1'-0"

NOTE:
ALL BURIED PIPE, FITTINGS AND VALVES
SHALL HAVE RESTRAINED JOINTS.

REV. NO.	DESCRIPTIONS	DATE

SEAL
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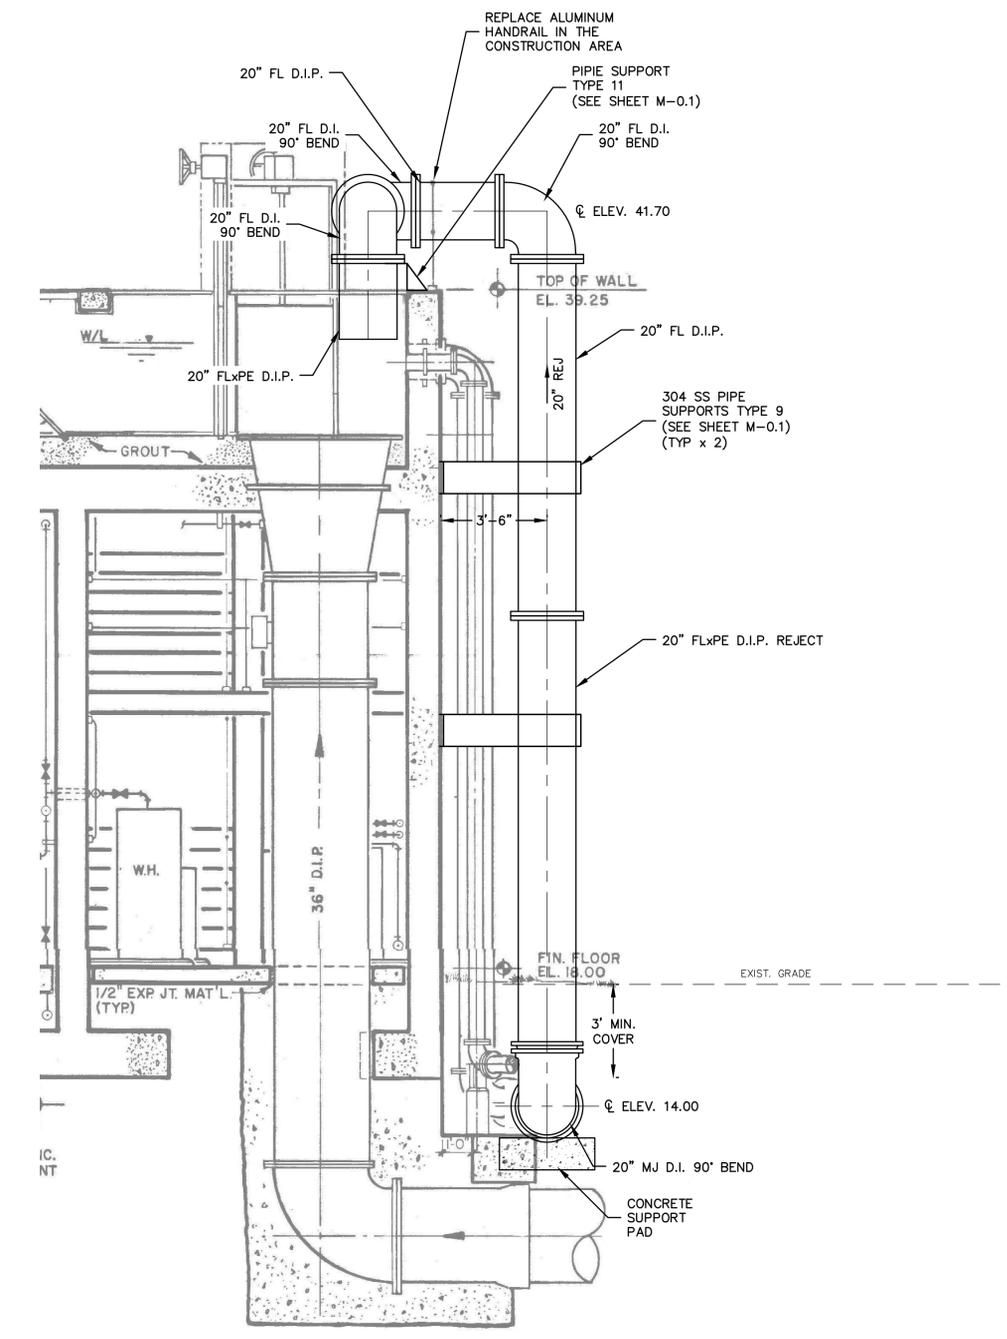
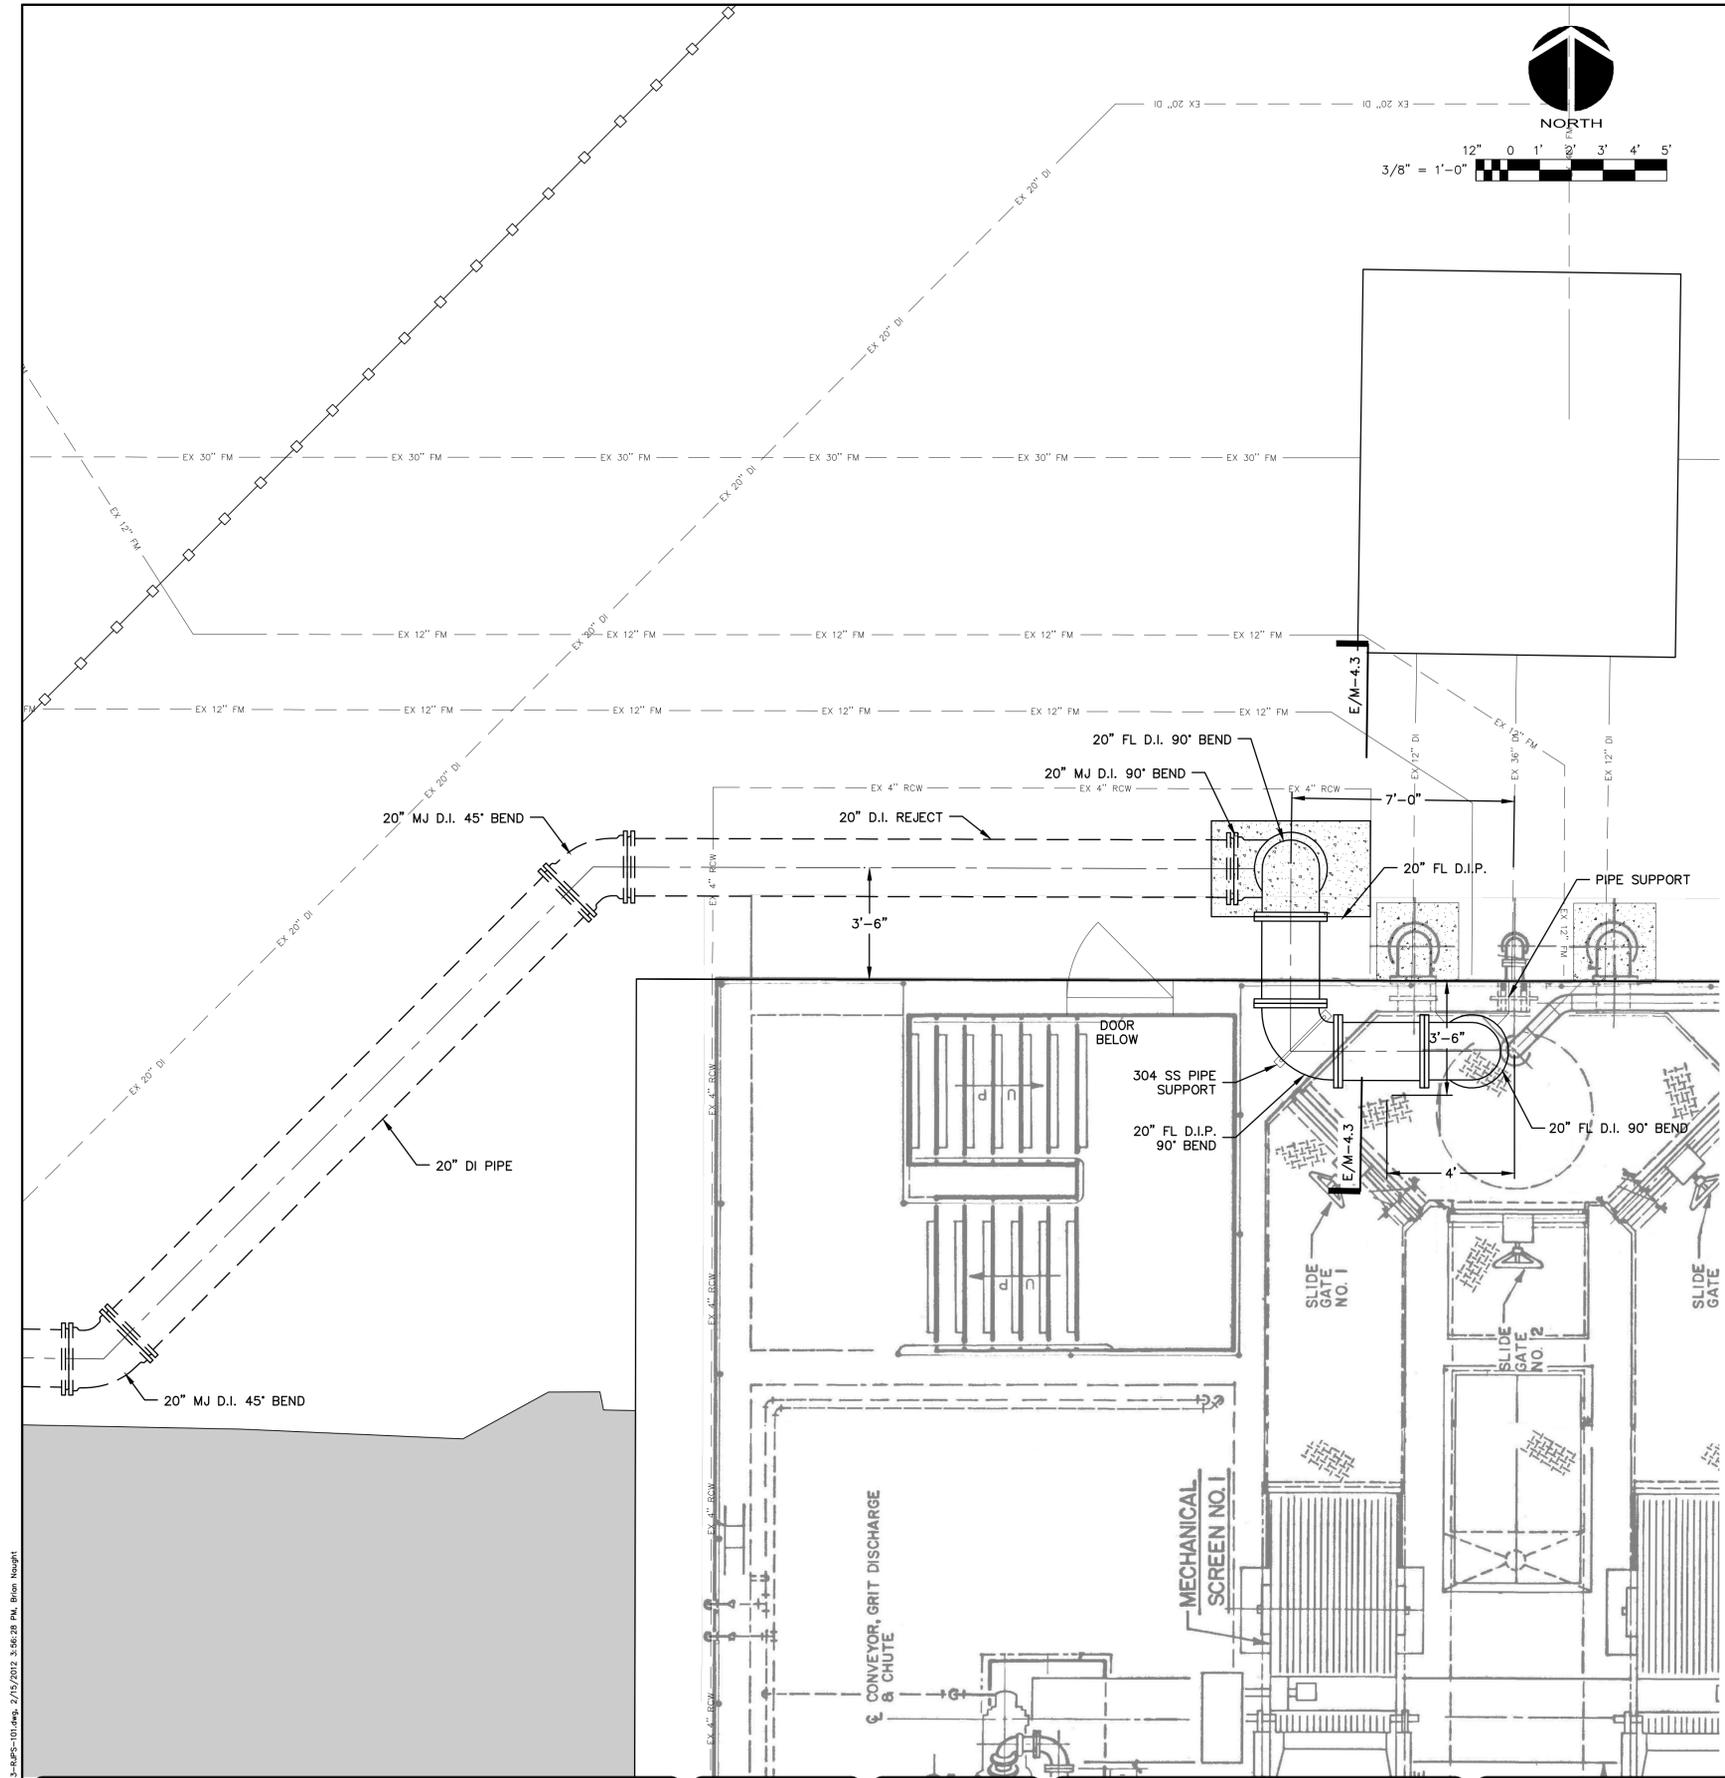
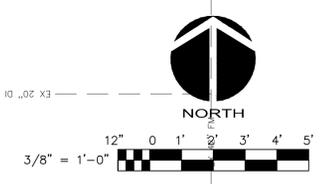
MANATEE COUNTY, FLORIDA

**SWWRF LAKE FILTRATION AND
NORTH POND IMPROVEMENTS**

**WASTE REJECT PLAN AND SECTION
AT ABW FILTERS No. 6 AND No. 7**

DATE: FEBRUARY 2012	SCALE: HORIZONTAL: 1/2" = 1'-0"	DRAWING NUMBER: M-4.2
MCE PROJ. # 1024-0147	VERTICAL: N/A	
DRAWN: BFN	DESIGNED: NJS	REVISION
CHECKED: MSL	PROJ. MGR. MSL	ISSUE FOR BID

S:\1024\1017\10-Drawings\Mechanical\M-4.1-8.dwg, 2/15/2012, 3:55:58 PM, Brian Naught



SECTION E/M-4.3
SCALE: 3/8" = 1'-0"

BACKGROUND IMAGE FROM RECORD DRAWINGS DATED 12/06/88 FOR 'SOUTHWEST REGIONAL WASTEWATER TREATMENT PLANT EXPANSION' MANATEE COUNTY

REV. NO.	DESCRIPTIONS	DATE

SEAL
NORMAN J. SCALLY, P.E.
No. 41338

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1365 Hamlet Avenue
Clearwater, Florida 33756
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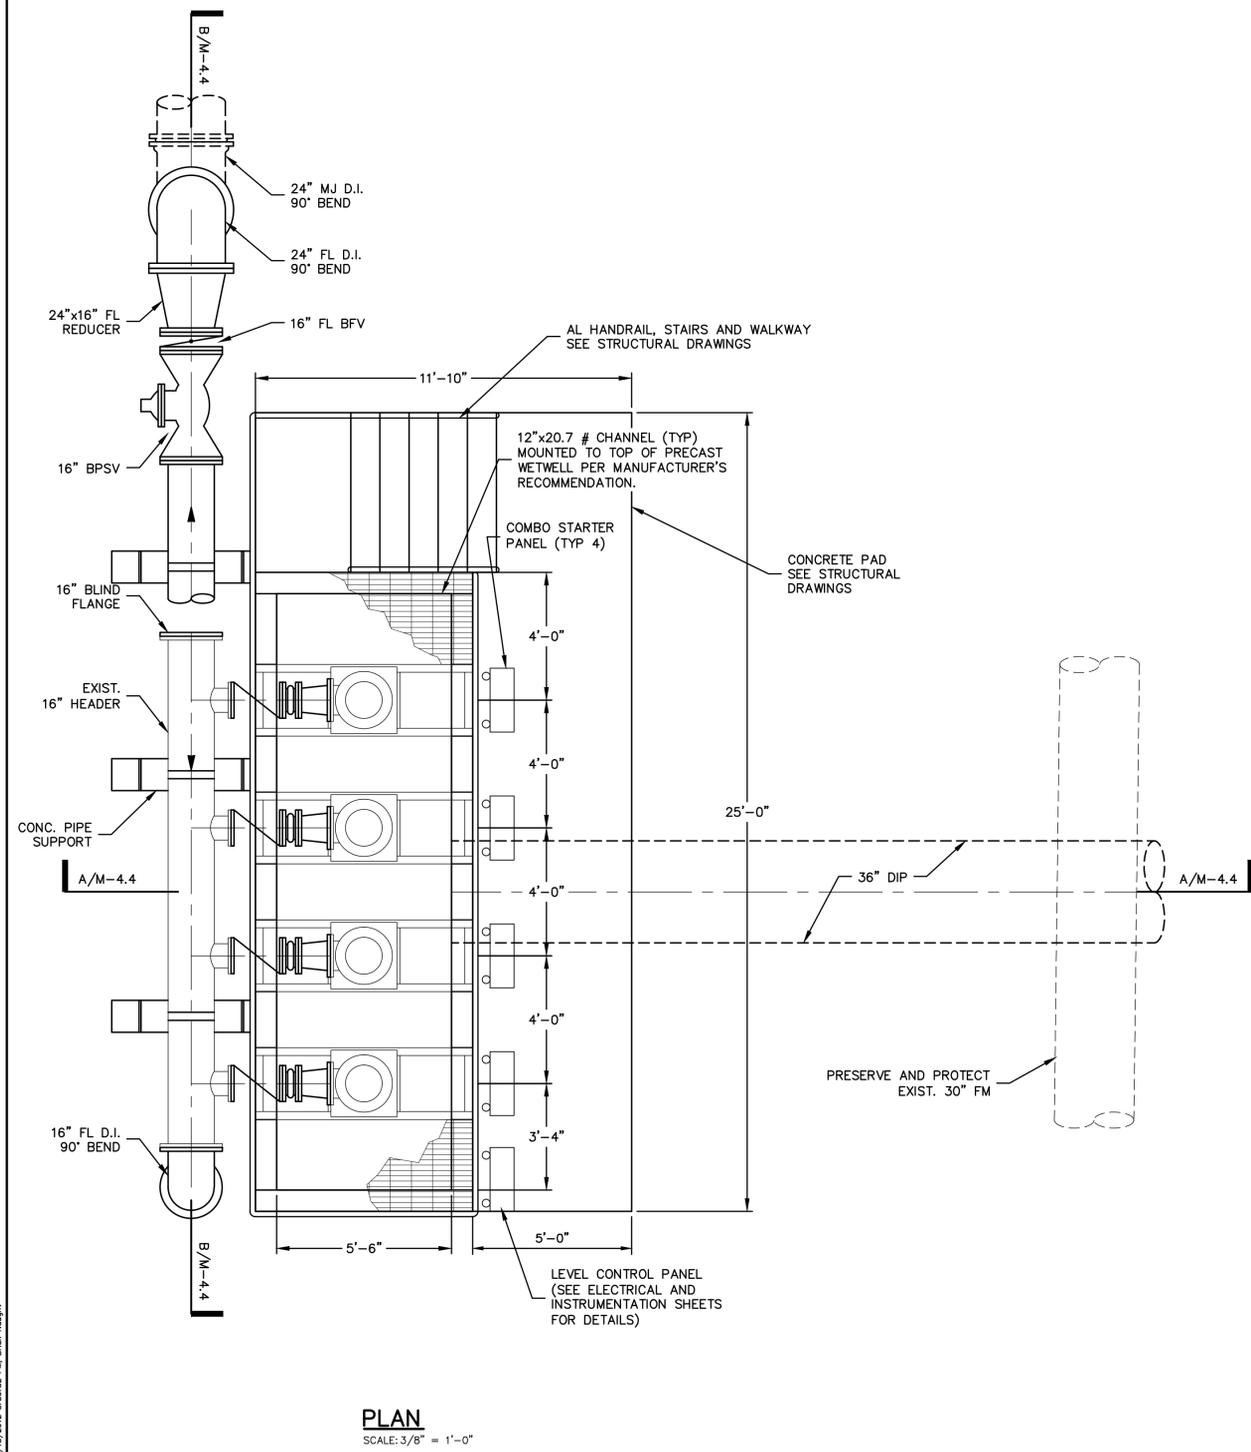
MANATEE COUNTY, FLORIDA

SWWRF LAKE FILTRATION AND NORTH POND IMPROVEMENTS


REJECT PLAN AND SECTION AT HEADWORKS

DATE: FEBRUARY 2012	SCALE: HORIZONTAL: 3/8" = 1'-0" VERTICAL: N/A	DRAWING NUMBER: M-4.3
MCE PROJ. # 1024-0147	DESIGNED: NJS	REVISION
CHECKED: MSL	PROJECT MANAGER: MSL	STATUS: ISSUE FOR BID

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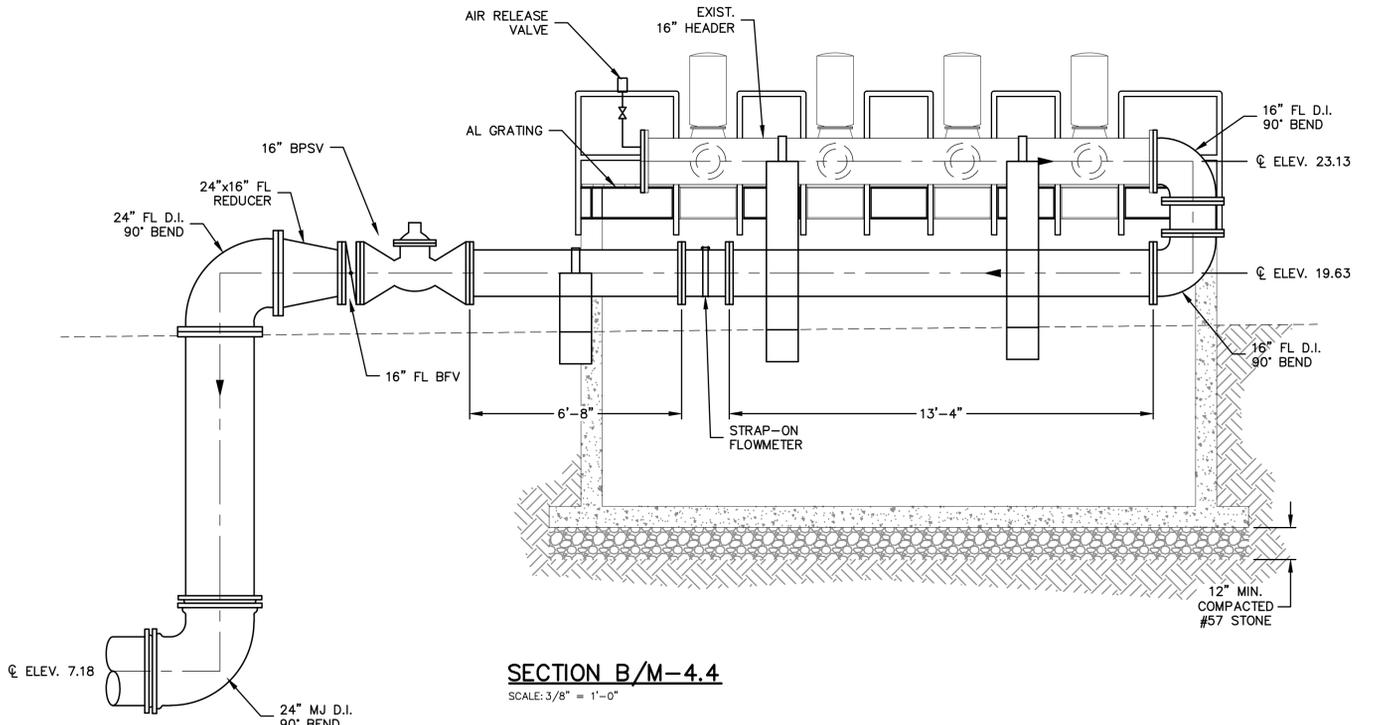


PLAN
SCALE: 3/8" = 1'-0"

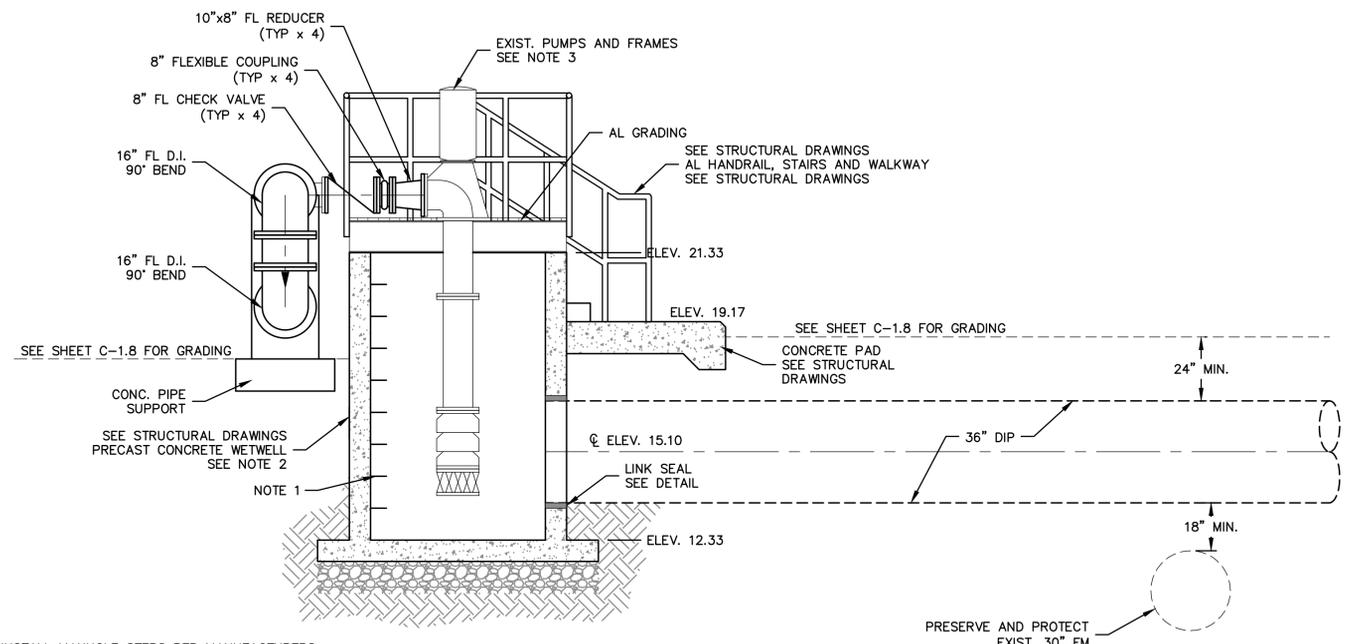

SECTION A/M-4.4
SCALE: 3/8" = 1'-0"

- NOTES:**
1. CONTRACTOR SHALL INSTALL MANHOLE STEPS PER MANUFACTURERS REQUIREMENTS AND IN ACCORDANCE WITH OSHA AND ASTM C478 STANDARDS. MANHOLE STEPS SHALL BE MODEL ML-10-NCR AS MANUFACTURED BY AMERICAN STEP CO. INC. OR APPROVED EQUAL.
 2. PRECAST WETWELL SHALL MEET ASTM C478. THE CONTRACTOR SHALL SUBMIT SHOP DRAWINGS FOR APPROVAL PRIOR TO INSTALLATION. SEE SPECIFICATION SECTION 03456.
 3. THE COUNTY SHALL PROVIDE PUMPS, PUMP SUPPORT FRAMES AND 16" HEADER. THE CONTRACTOR SHALL HAVE MODIFIED TWO VERTICAL TURBINE PUMPS FROM A COLUMN LENGTH OF 150.25" TO 90.25". CONTRACTOR SHALL COORDINATE MODIFICATION WITH BARNEY'S PUMP, INC.
 4. PUMPS SHALL BE NATIONAL PUMP MODEL J12XHC1-1 STAGE.



SECTION B/M-4.4
SCALE: 3/8" = 1'-0"

REV. NO.	DESCRIPTIONS	DATE

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SEAL

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MANATEE COUNTY, FLORIDA

SWRF LAKE FILTRATION AND NORTH POND IMPROVEMENTS

UNFILTERED PUMP STATION


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DESIGNED: MSL		
CHECKED: MSL		
PROJ. MGR: MSL		
STATUS: ISSUE FOR BID		

S:\1024\0147\1024-0147-Mechanics\M-4.4-UNFS-101.dwg, 2/15/2012, 3:56:32 PM, Brian Naught



12" 0 5' 10'
1/4" = 1'-0"

- NOTES:**
1. ALL UNDERGROUND PIPING, FITTINGS AND VALVES SHALL HAVE RESTRAINED JOINTS.
 2. PROVIDE ADDITIONAL BRACING FOR ALL THE ALUMINUM CABLE TRAY SUPPORTS NEAR CONSTRUCTION ACTIVITIES.
 3. CONTRACTOR SHALL SUBMIT CABLE TRAY SUPPORT DESIGN FOR REVIEW AND APPROVAL. SUBMITTAL SHALL BE SIGNED AND SEALED BY A PROFESSIONAL ENGINEER LICENSED IN THE STATE OF FLORIDA.
 4. CONTRACTOR SHALL REMOVE SLIDE GATE NO. 8 IN ITS ENTIRETY. CONTRACTOR SHALL INSTALL A CHAMFERED OVERFLOW WALL WITH A TOP FL. OF 16.83. THE CONTRACTOR SHALL SUBMIT A DESIGN FOR THE WALL PRIOR TO INSTALLATION, SIGNED AND SEALED BY A PROFESSIONAL ENGINEER LICENSED IN THE STATE OF FLORIDA, FOR REVIEW AND APPROVAL.

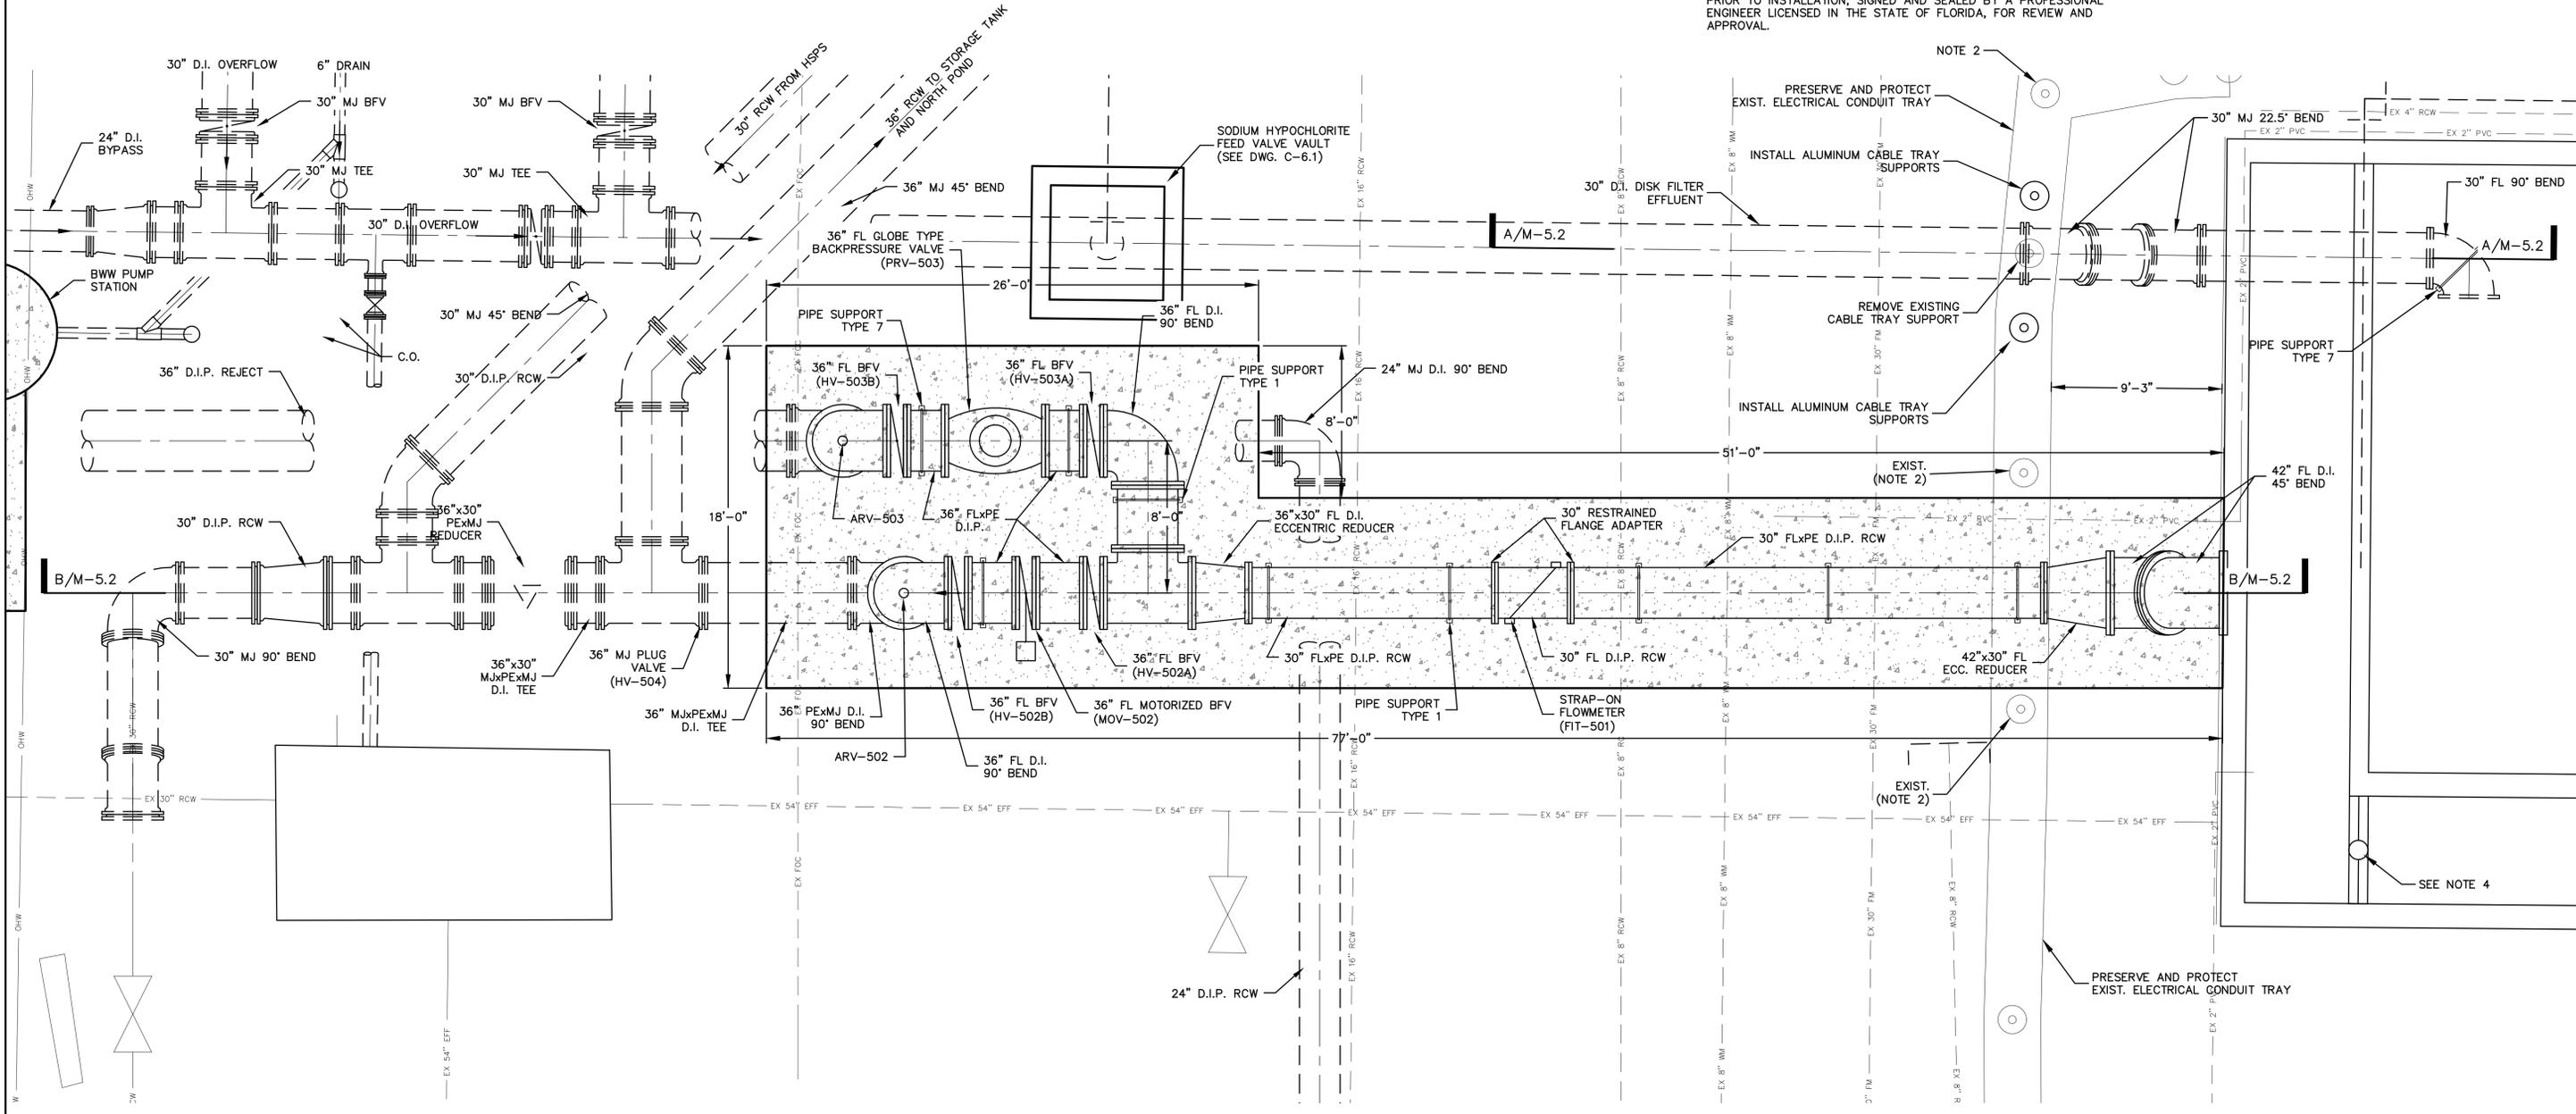

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REV. NO.	DESCRIPTIONS	DATE

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No. 66118

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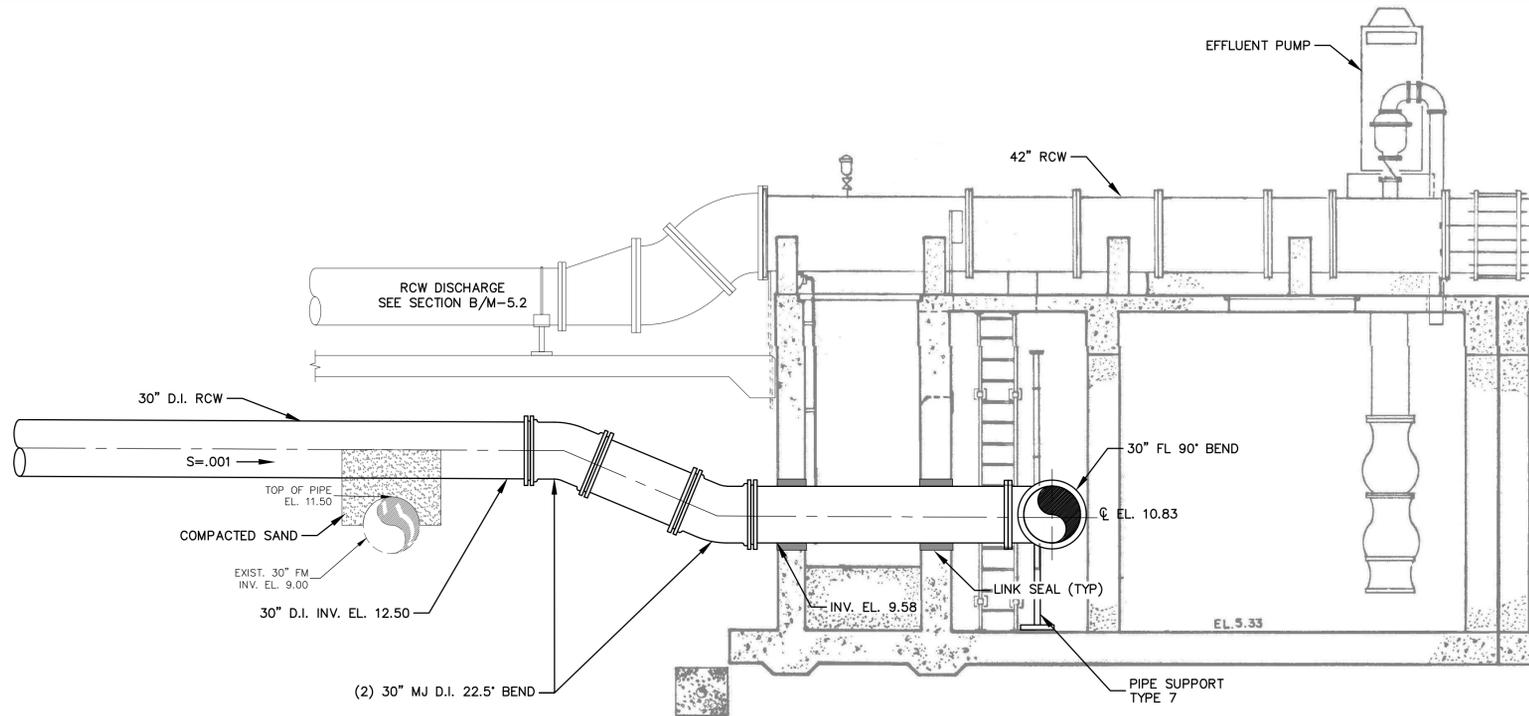
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MANATEE COUNTY, FLORIDA


SWWRF LAKE FILTRATION AND NORTH POND IMPROVEMENTS

EFFLUENT PUMP STATION FLOWMETER ASSEMBLY PLAN

DATE: FEBRUARY 2012	SCALE: HORIZONTAL: 1/4" = 1'-0"	DRAWING NUMBER: M-5.1
MCE PROJ. # 1024-0147	DESIGNED: NJS	CHECKED: MSL
PROJ. MGR. MSL	STATUS: ISSUE FOR BID	REVISION:



SECTION A/M-5.1
SCALE: 1/4" = 1'-0"

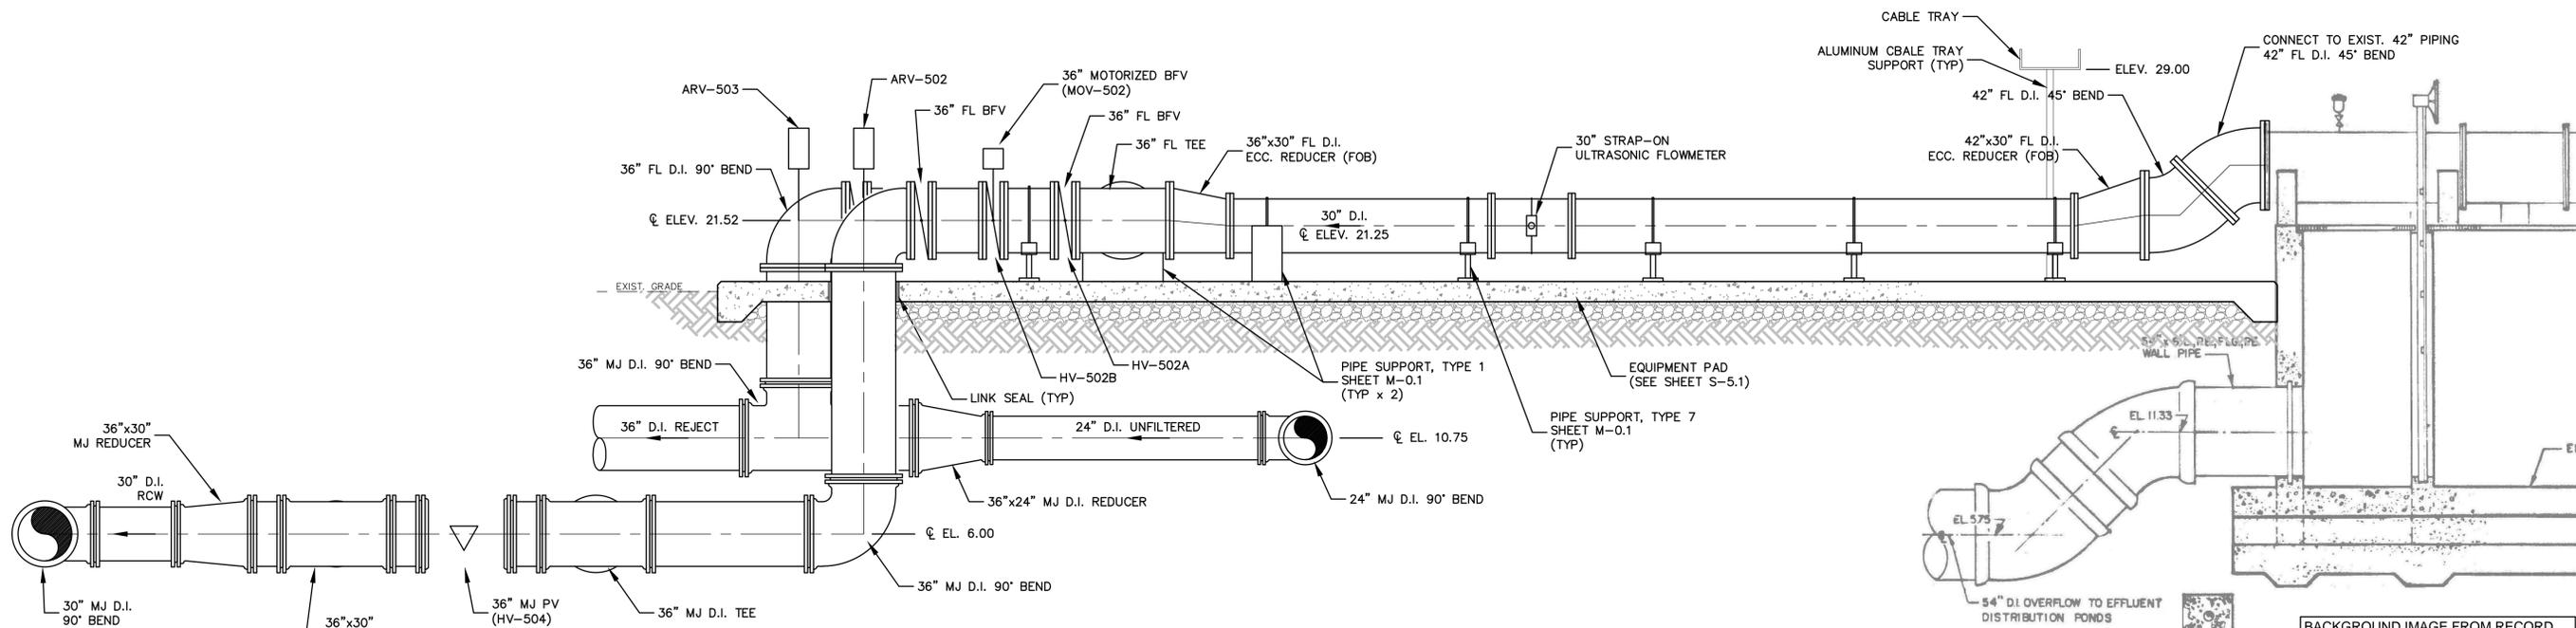

SECTION B/M-5.1
SCALE: 1/4" = 1'-0"

BACKGROUND IMAGE FROM RECORD DRAWINGS DATED 12/06/88 FOR 'SOUTHWEST REGIONAL WASTEWATER TREATMENT PLANT EXPANSION' MANATEE COUNTY

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REV. NO.	DESCRIPTIONS	DATE

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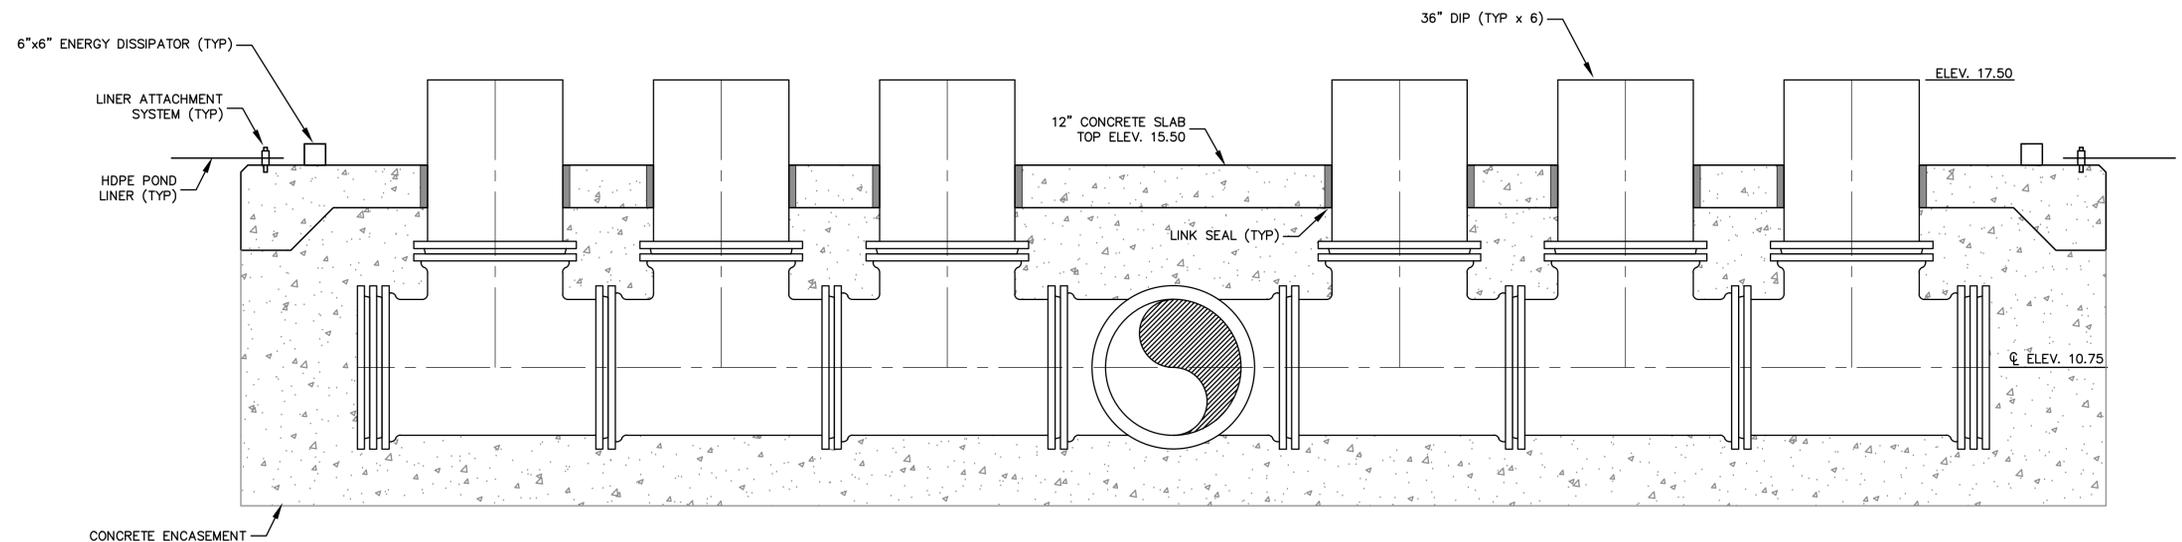
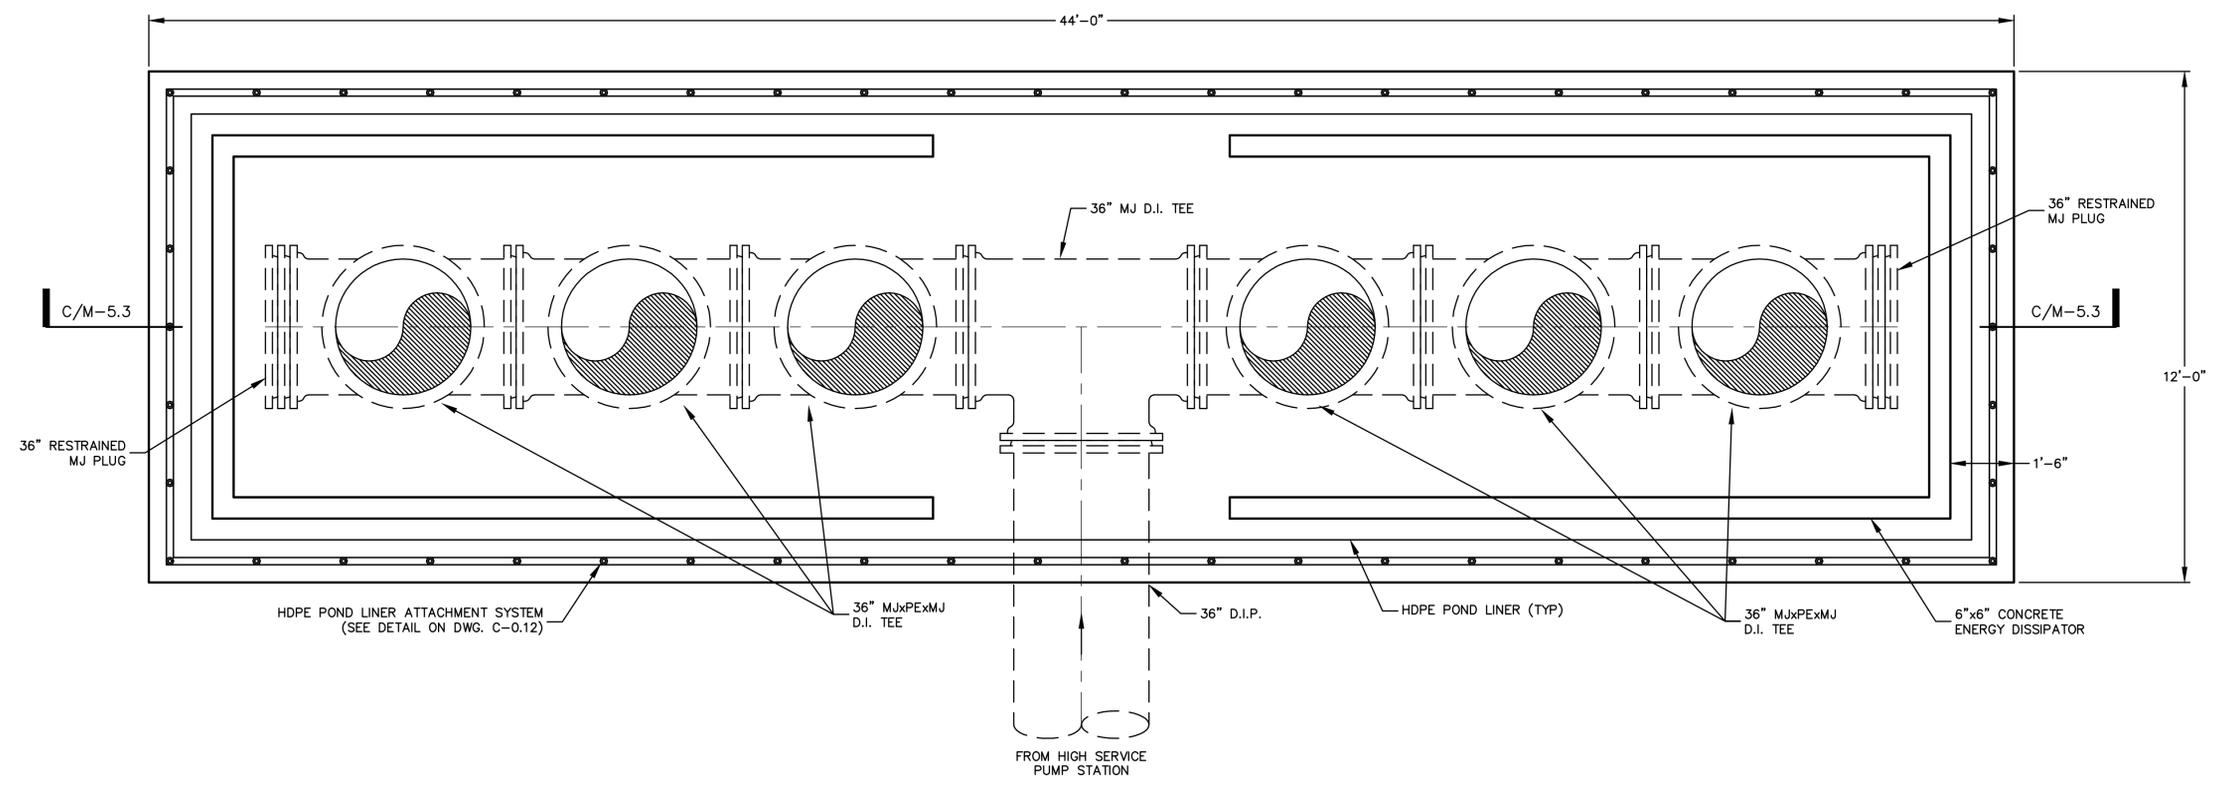
MANATEE COUNTY
FLORIDA
MANATEE COUNTY, FLORIDA

SWRF LAKE FILTRATION AND NORTH POND IMPROVEMENTS
EFFLUENT PUMP STATION FLOWMETER ASSEMBLY SECTIONS

DATE: FEBRUARY 2012	SCALE: 1/4" = 1'-0"	DRAWING NUMBER: M-5.2
MCE PROJ. # 1024-0147	HORIZONTAL: 1/4" = 1'-0"	REVISION
DRAWN: BFN	VERTICAL: N/A	
DESIGNED: NJS		
CHECKED: MSL		
PROJ. MGR. MSL		

STATUS: **ISSUE FOR BID**

1/2" = 1'-0"



SECTION C/M-5.3
SCALE: 1/2" = 1'-0"

REV. NO.	DESCRIPTIONS	DATE

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MANATEE COUNTY, FLORIDA

SWWRF LAKE FILTRATION AND NORTH POND IMPROVEMENTS
REJECT POND OUTLET ASSEMBLY PLAN AND SECTION

DATE: FEBRUARY 2012
MCE PROJ. # 1024-0147
DRAWN: BFN
DESIGNED: NJS
CHECKED: MSL
PROJ. MGR.:

SCALE:
HORIZONTAL: 1/2" = 1'-0"
VERTICAL: N/A

DRAWING NUMBER
M-5.3


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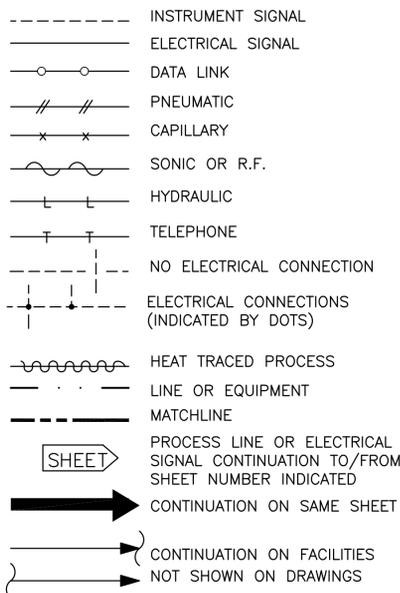
FUNCTION SYMBOL SCHEDULE

FIRST LETTER		SUCCEEDING-LETTERS		
MEASURED OR INITIATING VARIABLE	MODIFIER	READOUT OR PASSIVE FUNCTION	OUTPUT FUNCTION	MODIFIER
A	Analysis	Alarm		
B	Burner, Combustion	Programmer		
C	Conductivity (Electrical)		Control	Closed
D	Density or Specific Gravity	Differential		
E	Voltage	Sensor (Primary Element)	Education	
F	Flow Rate	Ratio (Fraction)		
G	Gaging	Glass, Viewing Device		
H	Hand			High
I	Current (Electrical)	Indicate		
J	Power	Scan		
K	Time, Time Schedule		Control Station	
L	Level	Light (Pilot)		Low
M	Motor			Middle, Intermediate
N	Vibration			
O	Operation	Offset	Orifice, Restriction	Open
P	Pressure, Vacuum		Point (Test) Connection	
Q	Quantity, Event	Integrate, Totalize	Integrate	
R	Radiation		Record, Print	Regulate
S	Speed, Frequency	Safety		Switch
T	Temperature			Transmit
U	Multivariable	Trend	Multifunction	Multifunction
V	Viscosity	Vacuum		Valve, Damper, Louver, Gate
W	Weight, Force, Torque		Well	
X	Unclassified		Unclassified	Unclassified
Y			Relay, Compute, Convert	
Z	Position		Final Control Element	Drive, Actuator, Unclassified Final Control Element

BASIC SYMBOLS




LINE CODES

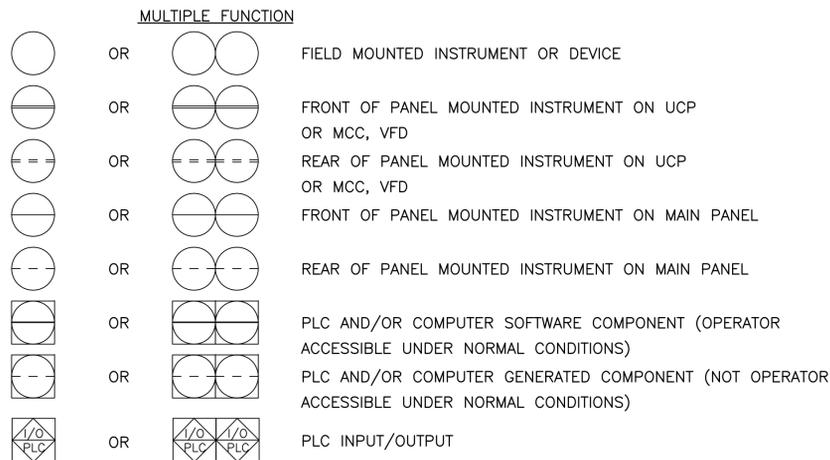


VALVES, PUMPS & METERS




VALVES, PUMPS & METERS (CONT'D)

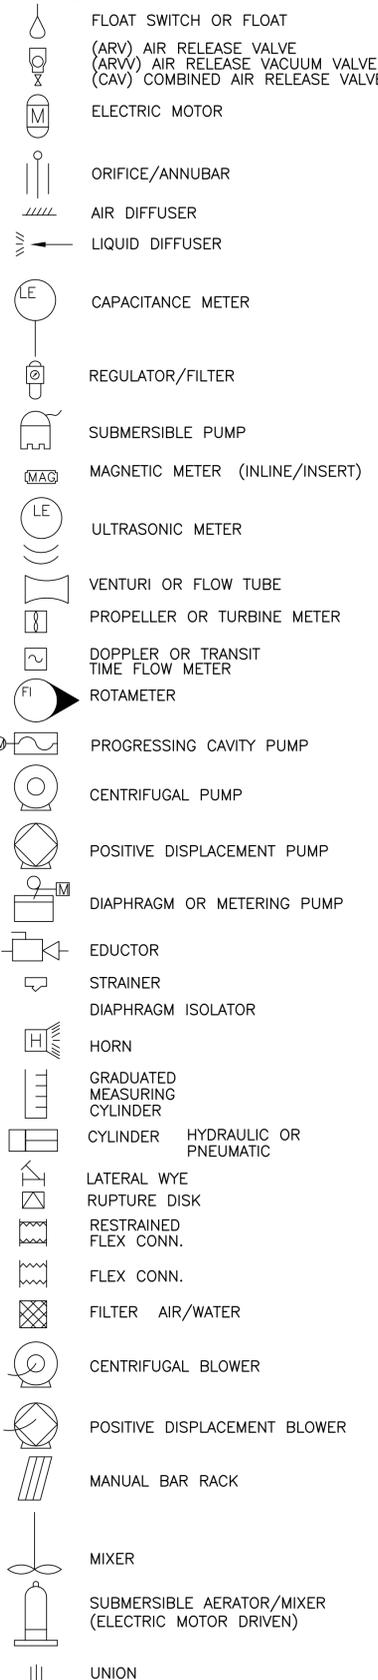


MISCELLANEOUS SYMBOLS

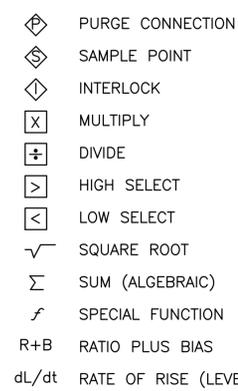



EQUIPMENT NOTATION

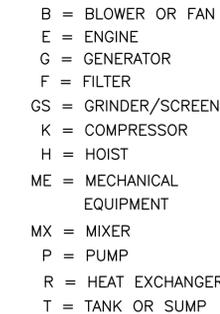

VALVE DESIGNATIONS

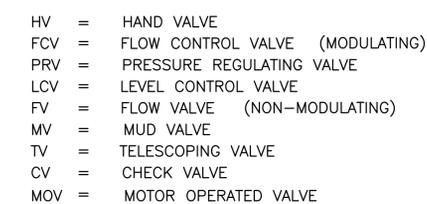

INSTRUMENT TAG NOTATION

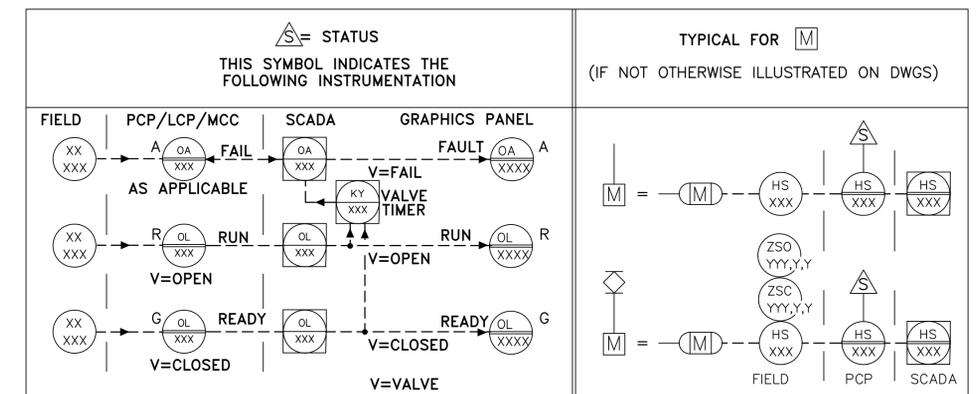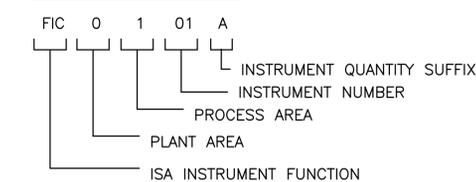

S:\1024\1017\1017-Drawings\Instrumentation\1017-0142.dwg, 2/15/2012, 9:05:53 AM, Michael Tweedel

REVNO.	DESCRIPTIONS	DATE

SEAL

MICHAEL TWEDEL, P.E.
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MANATEE COUNTY, FLORIDA

SWRF LAKE FILTRATION AND NORTH POND IMPROVEMENTS


PROCESS AND INSTRUMENTATION GENERAL NOTES, LEGEND AND ABBREVIATIONS

DATE: FEBRUARY 2012
MCE PROJ. # 1024-0142
DRAWN: MDT
DESIGNED: MDT
CHECKED: TER
PROJ. MGR: MSL

SCALE: HORIZONTAL: NA, VERTICAL: NA

DRAWING NUMBER: I-0.1

STATUS: ISSUE FOR BID

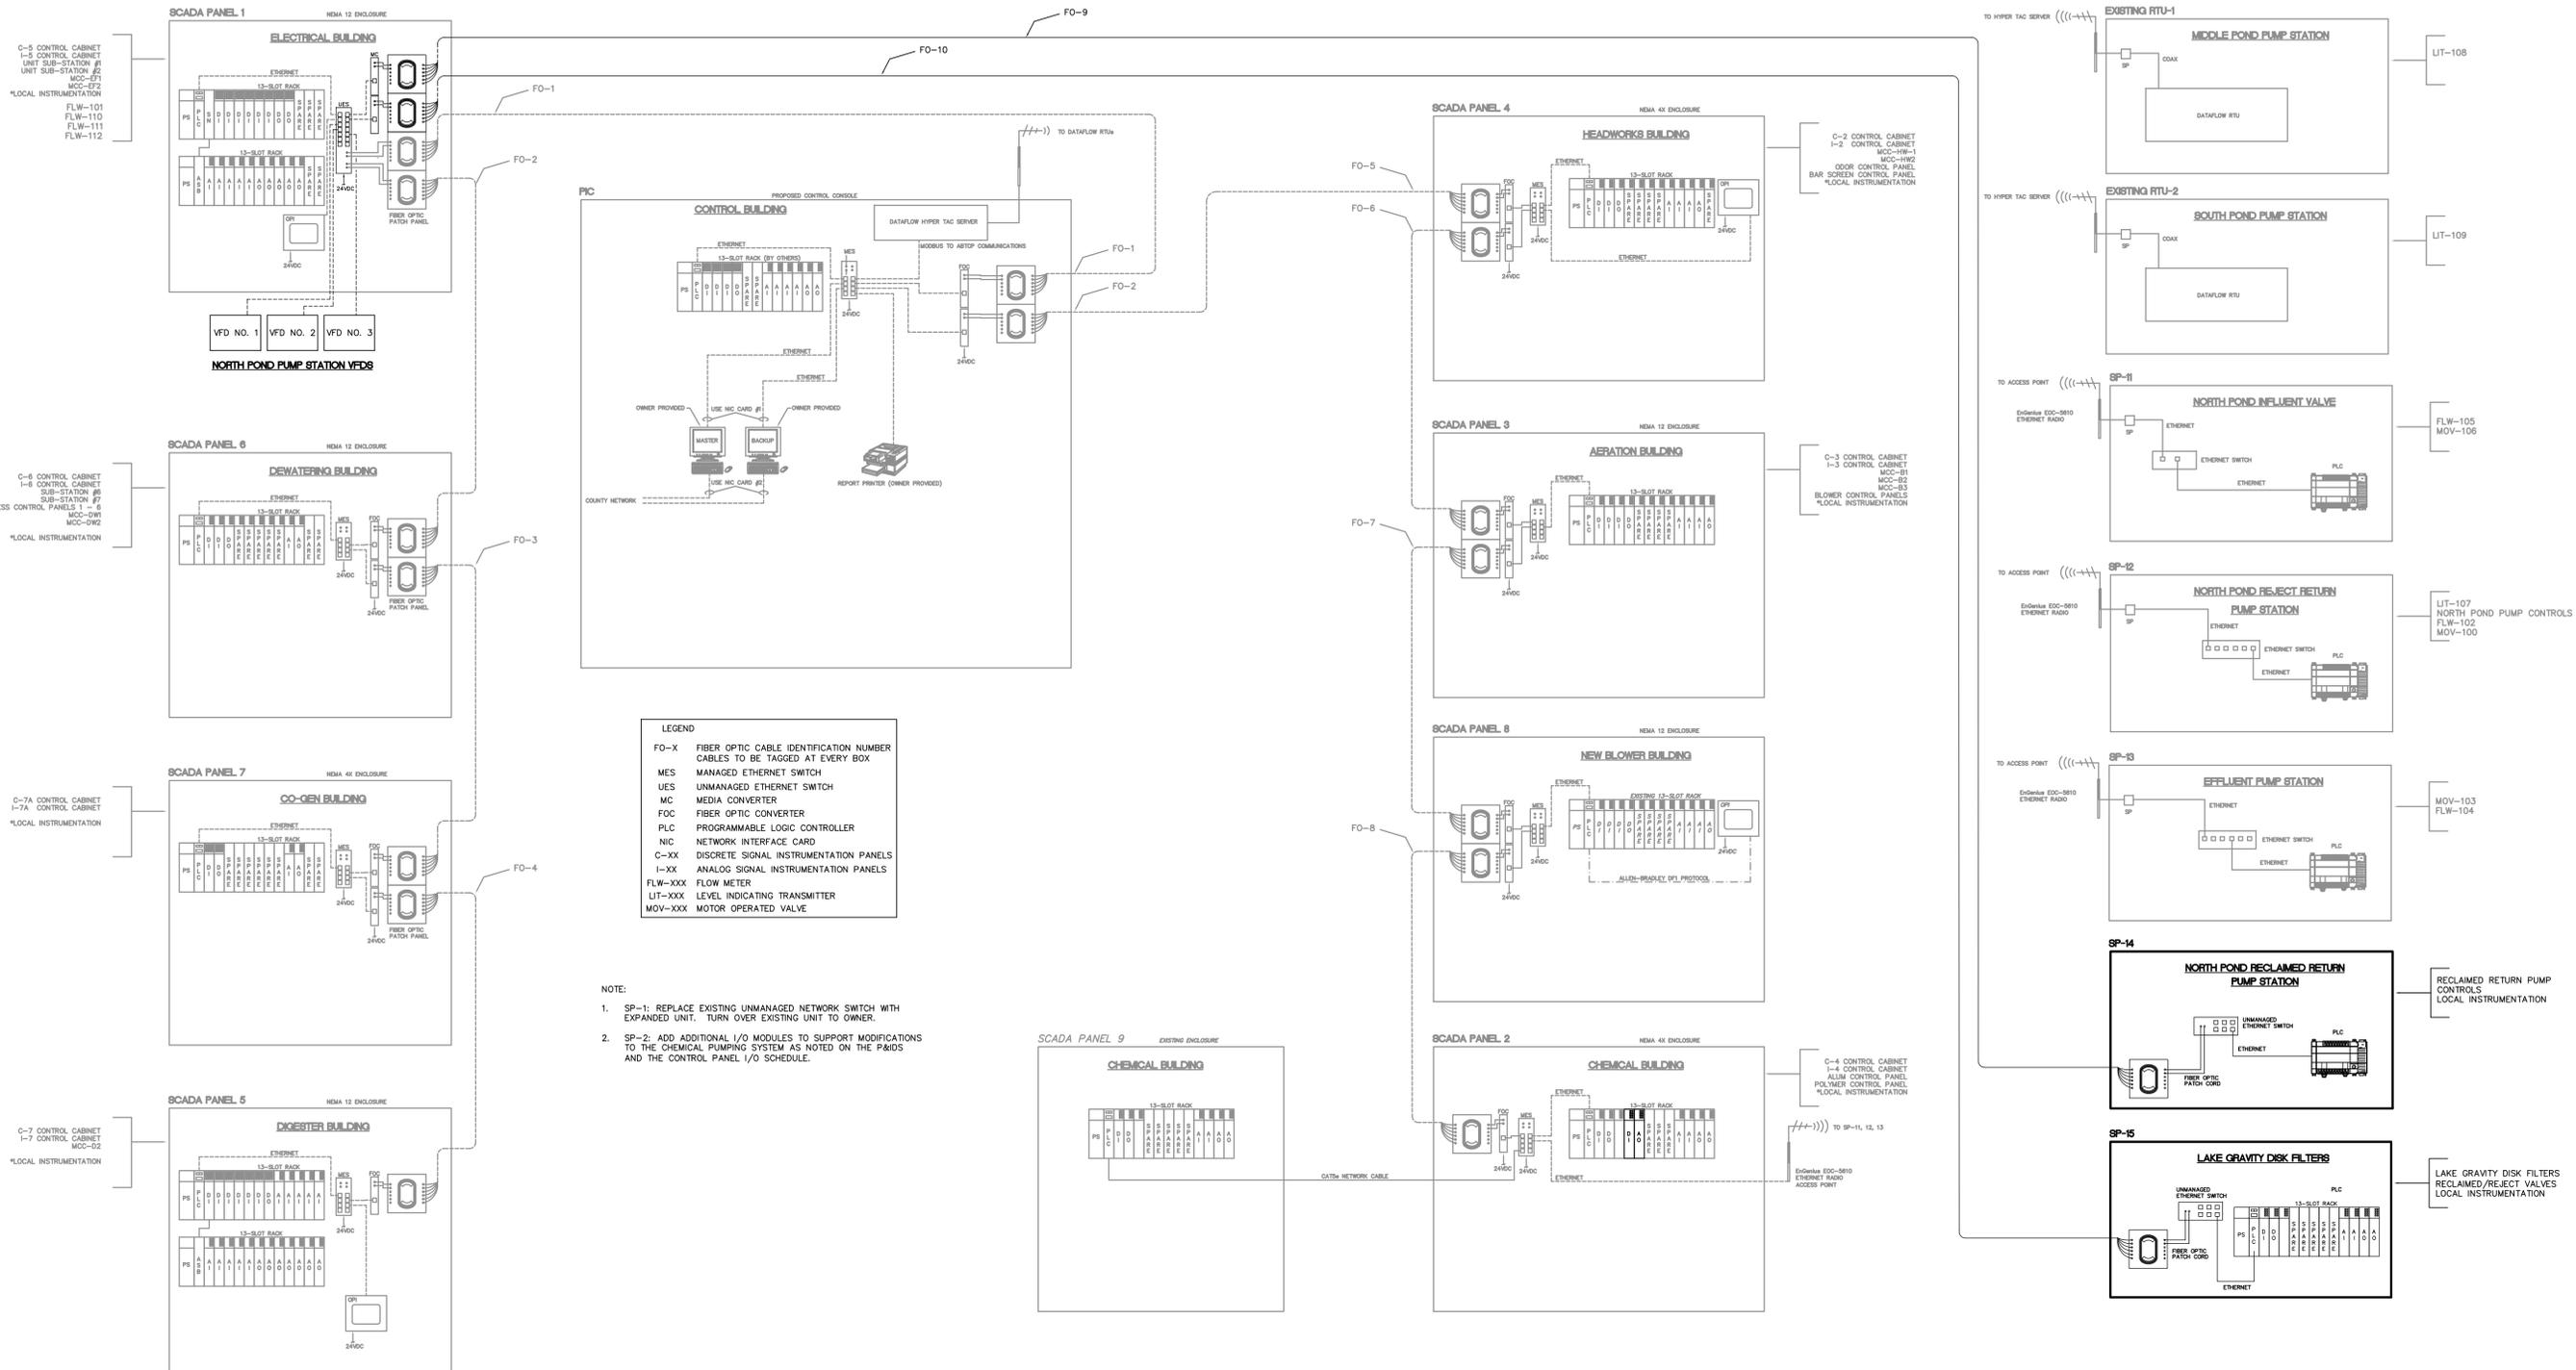

LEGEND

- FO-X FIBER OPTIC CABLE IDENTIFICATION NUMBER CABLES TO BE TAGGED AT EVERY BOX
- MES MANAGED ETHERNET SWITCH
- UES UNMANAGED ETHERNET SWITCH
- MC MEDIA CONVERTER
- FOC FIBER OPTIC CONVERTER
- PLC PROGRAMMABLE LOGIC CONTROLLER
- NIC NETWORK INTERFACE CARD
- C-XX DISCRETE SIGNAL INSTRUMENTATION PANELS
- I-XX ANALOG SIGNAL INSTRUMENTATION PANELS
- FLW-XXX FLOW METER
- LIT-XXX LEVEL INDICATING TRANSMITTER
- MOV-XXX MOTOR OPERATED VALVE

NOTE:

1. SP-1: REPLACE EXISTING UNMANAGED NETWORK SWITCH WITH EXPANDED UNIT. TURN OVER EXISTING UNIT TO OWNER.
2. SP-2: ADD ADDITIONAL I/O MODULES TO SUPPORT MODIFICATIONS TO THE CHEMICAL PUMPING SYSTEM AS NOTED ON THE PAIDS AND THE CONTROL PANEL I/O SCHEDULE.

REVNO.	DESCRIPTIONS	DATE

SEAL

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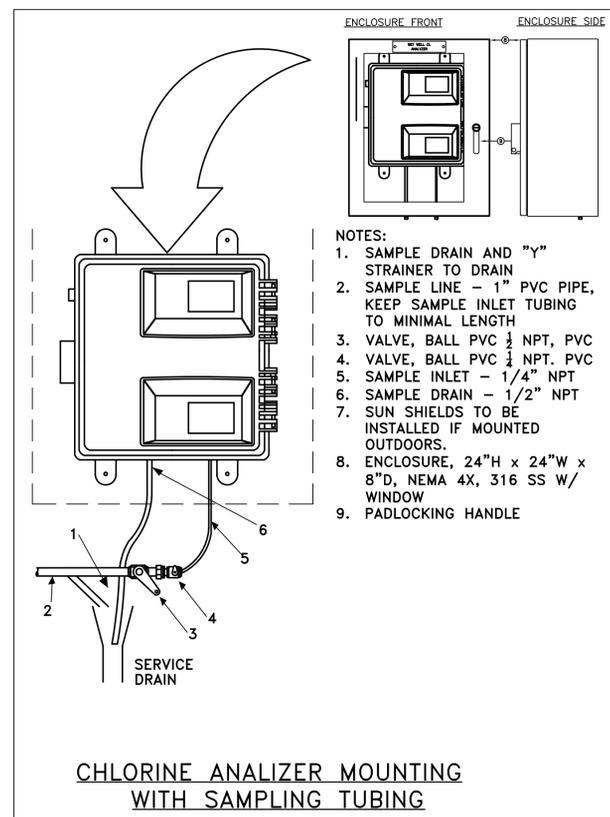
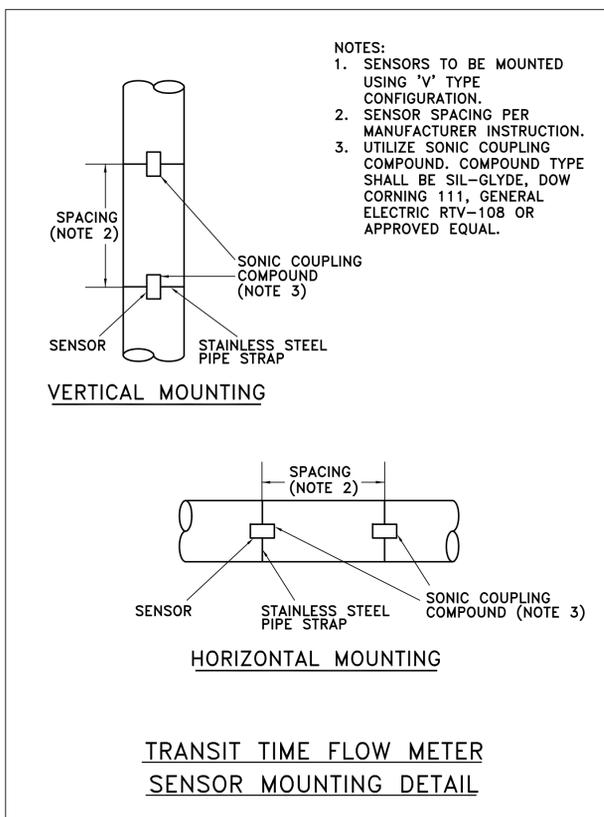
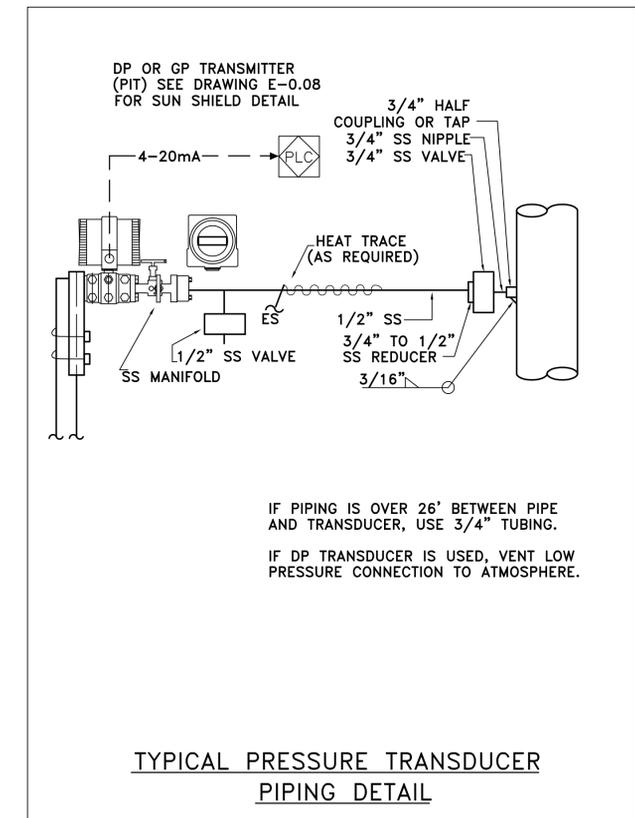
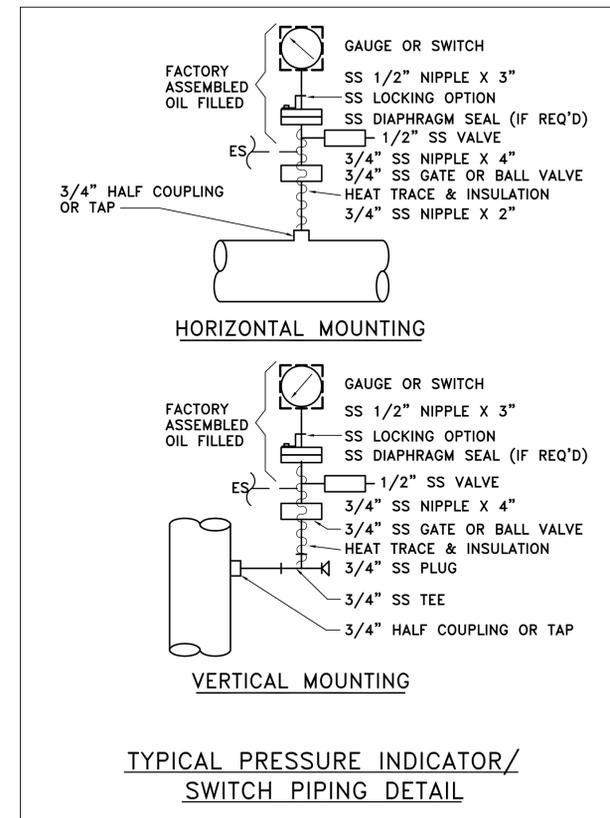
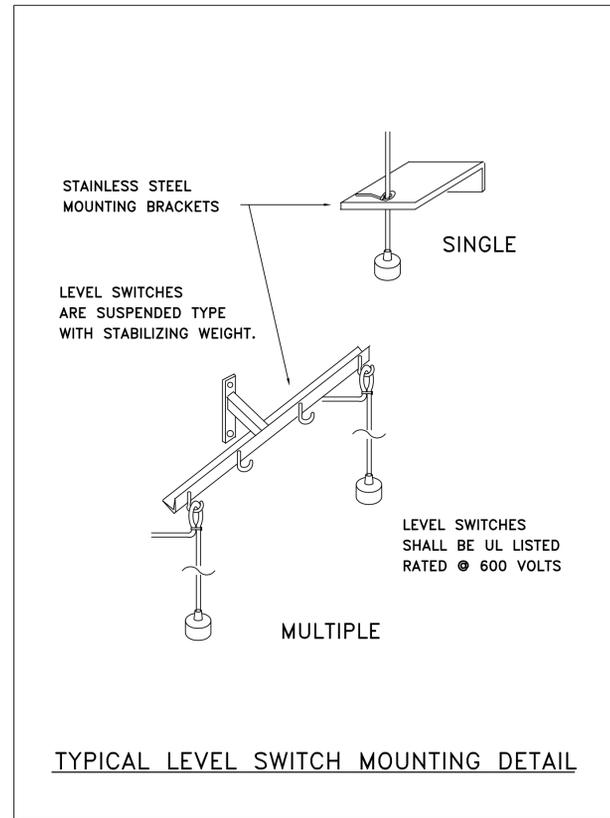
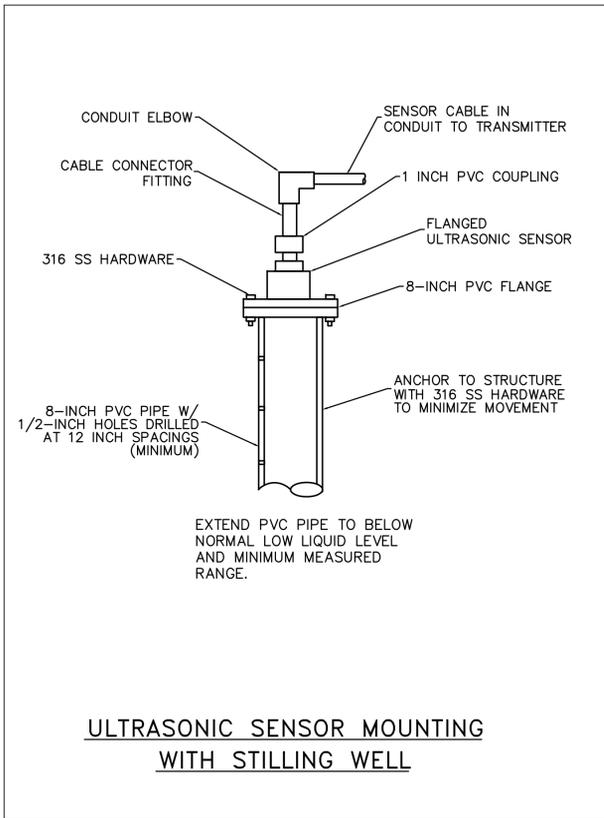
MANATEE COUNTY, FLORIDA

SWRF LAKE FILTRATION AND NORTH POND IMPROVEMENTS

COMMUNICATIONS SYSTEM MODIFICATIONS OVERVIEW

DATE: FEBRUARY 2012	SCALE	DRAWING NUMBER
MCE PROJ. # 1024-014Z	HORIZONTAL: NA	I-0.2
DRAWN: EEB	VERTICAL: NA	
DESIGNED: EEB		
CHECKED: TER		
PROJ. MGR. MSL		
STATUS: ISSUE FOR BID	REVISION	MDT

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REV. NO.	DESCRIPTIONS	DATE

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MICHAEL TWEDEDEL, P.E.
No. 60940


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MANATEE COUNTY, FLORIDA

SWRF LAKE FILTRATION AND NORTH POND IMPROVEMENTS
PROCESS AND INSTRUMENTATION DETAILS

DATE: FEBRUARY 2012	SCALE: NA	DRAWING NUMBER: I-0.3
MCE PROJ. # 1024-0142	HORIZONTAL: NA	
DRAWN: MDT	VERTICAL: NA	
DESIGNED: MDT		
CHECKED: TER		
PROJ. MGR: MSL		
STATUS: ISSUE FOR BID		



* BY FILTER EQUIPMENT SUPPLIER

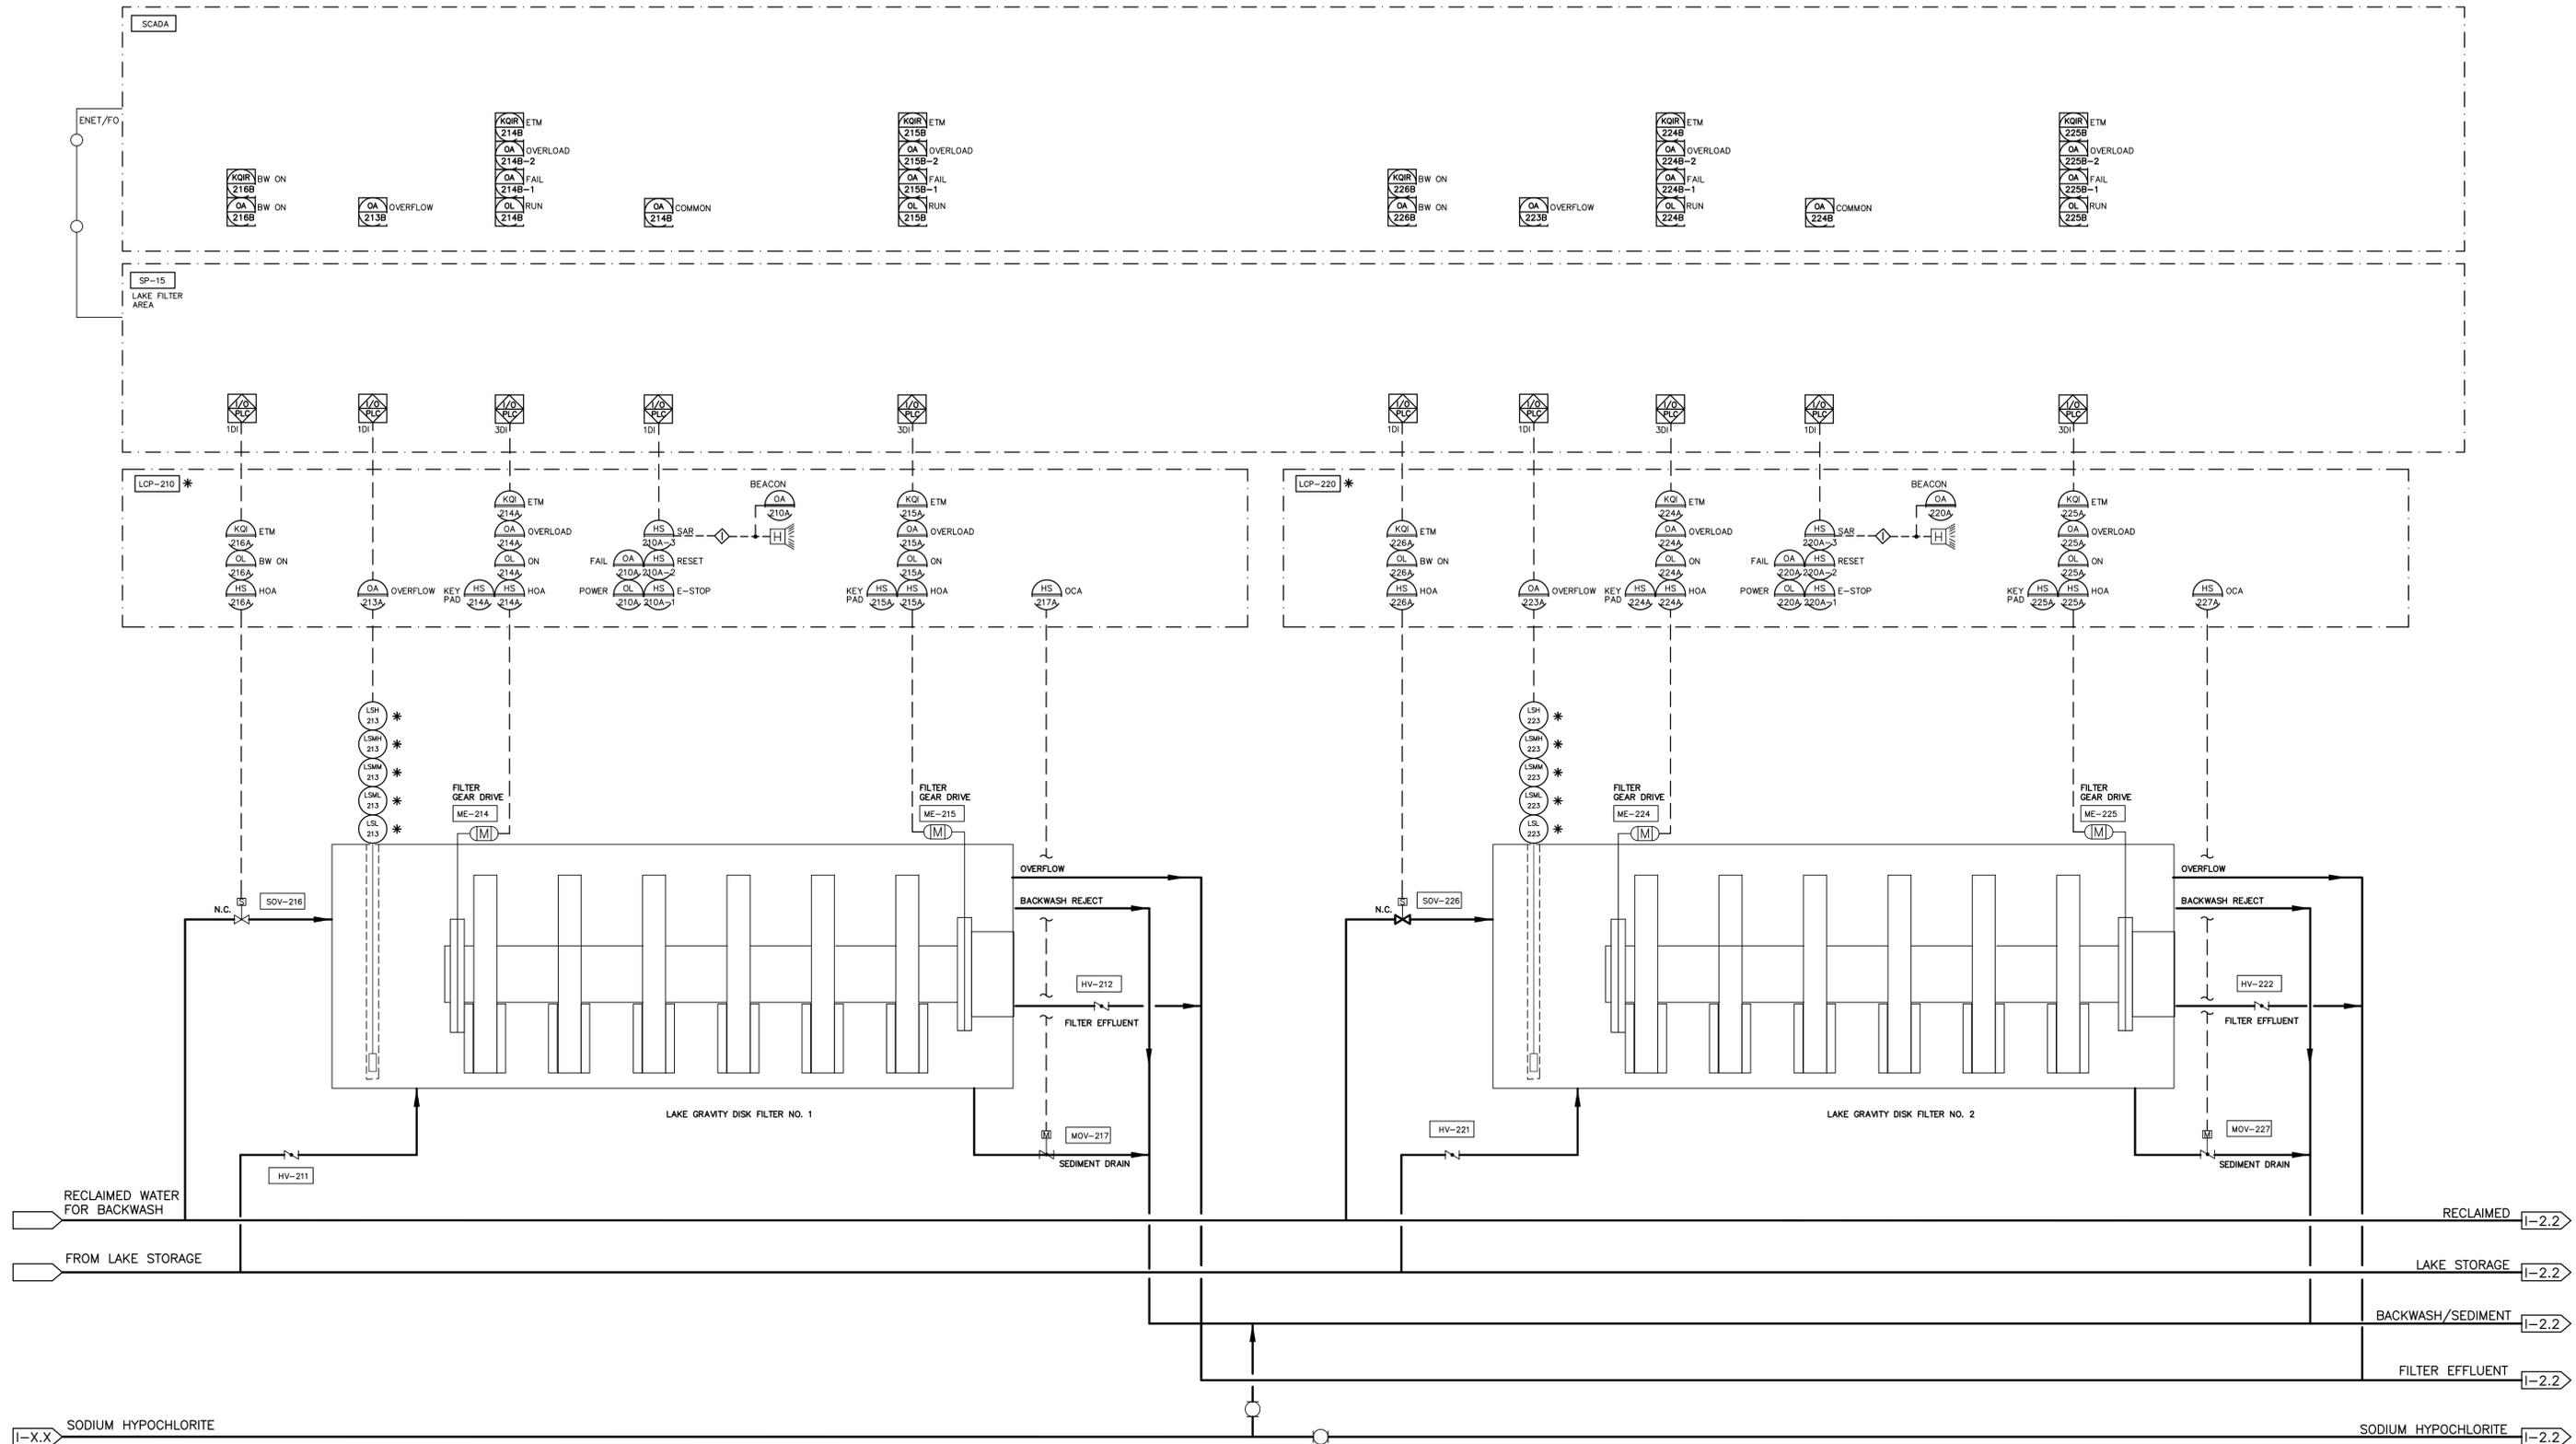REV. NO.	DESCRIPTIONS	DATE

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MICHAEL TWEDEDEL, P.E.
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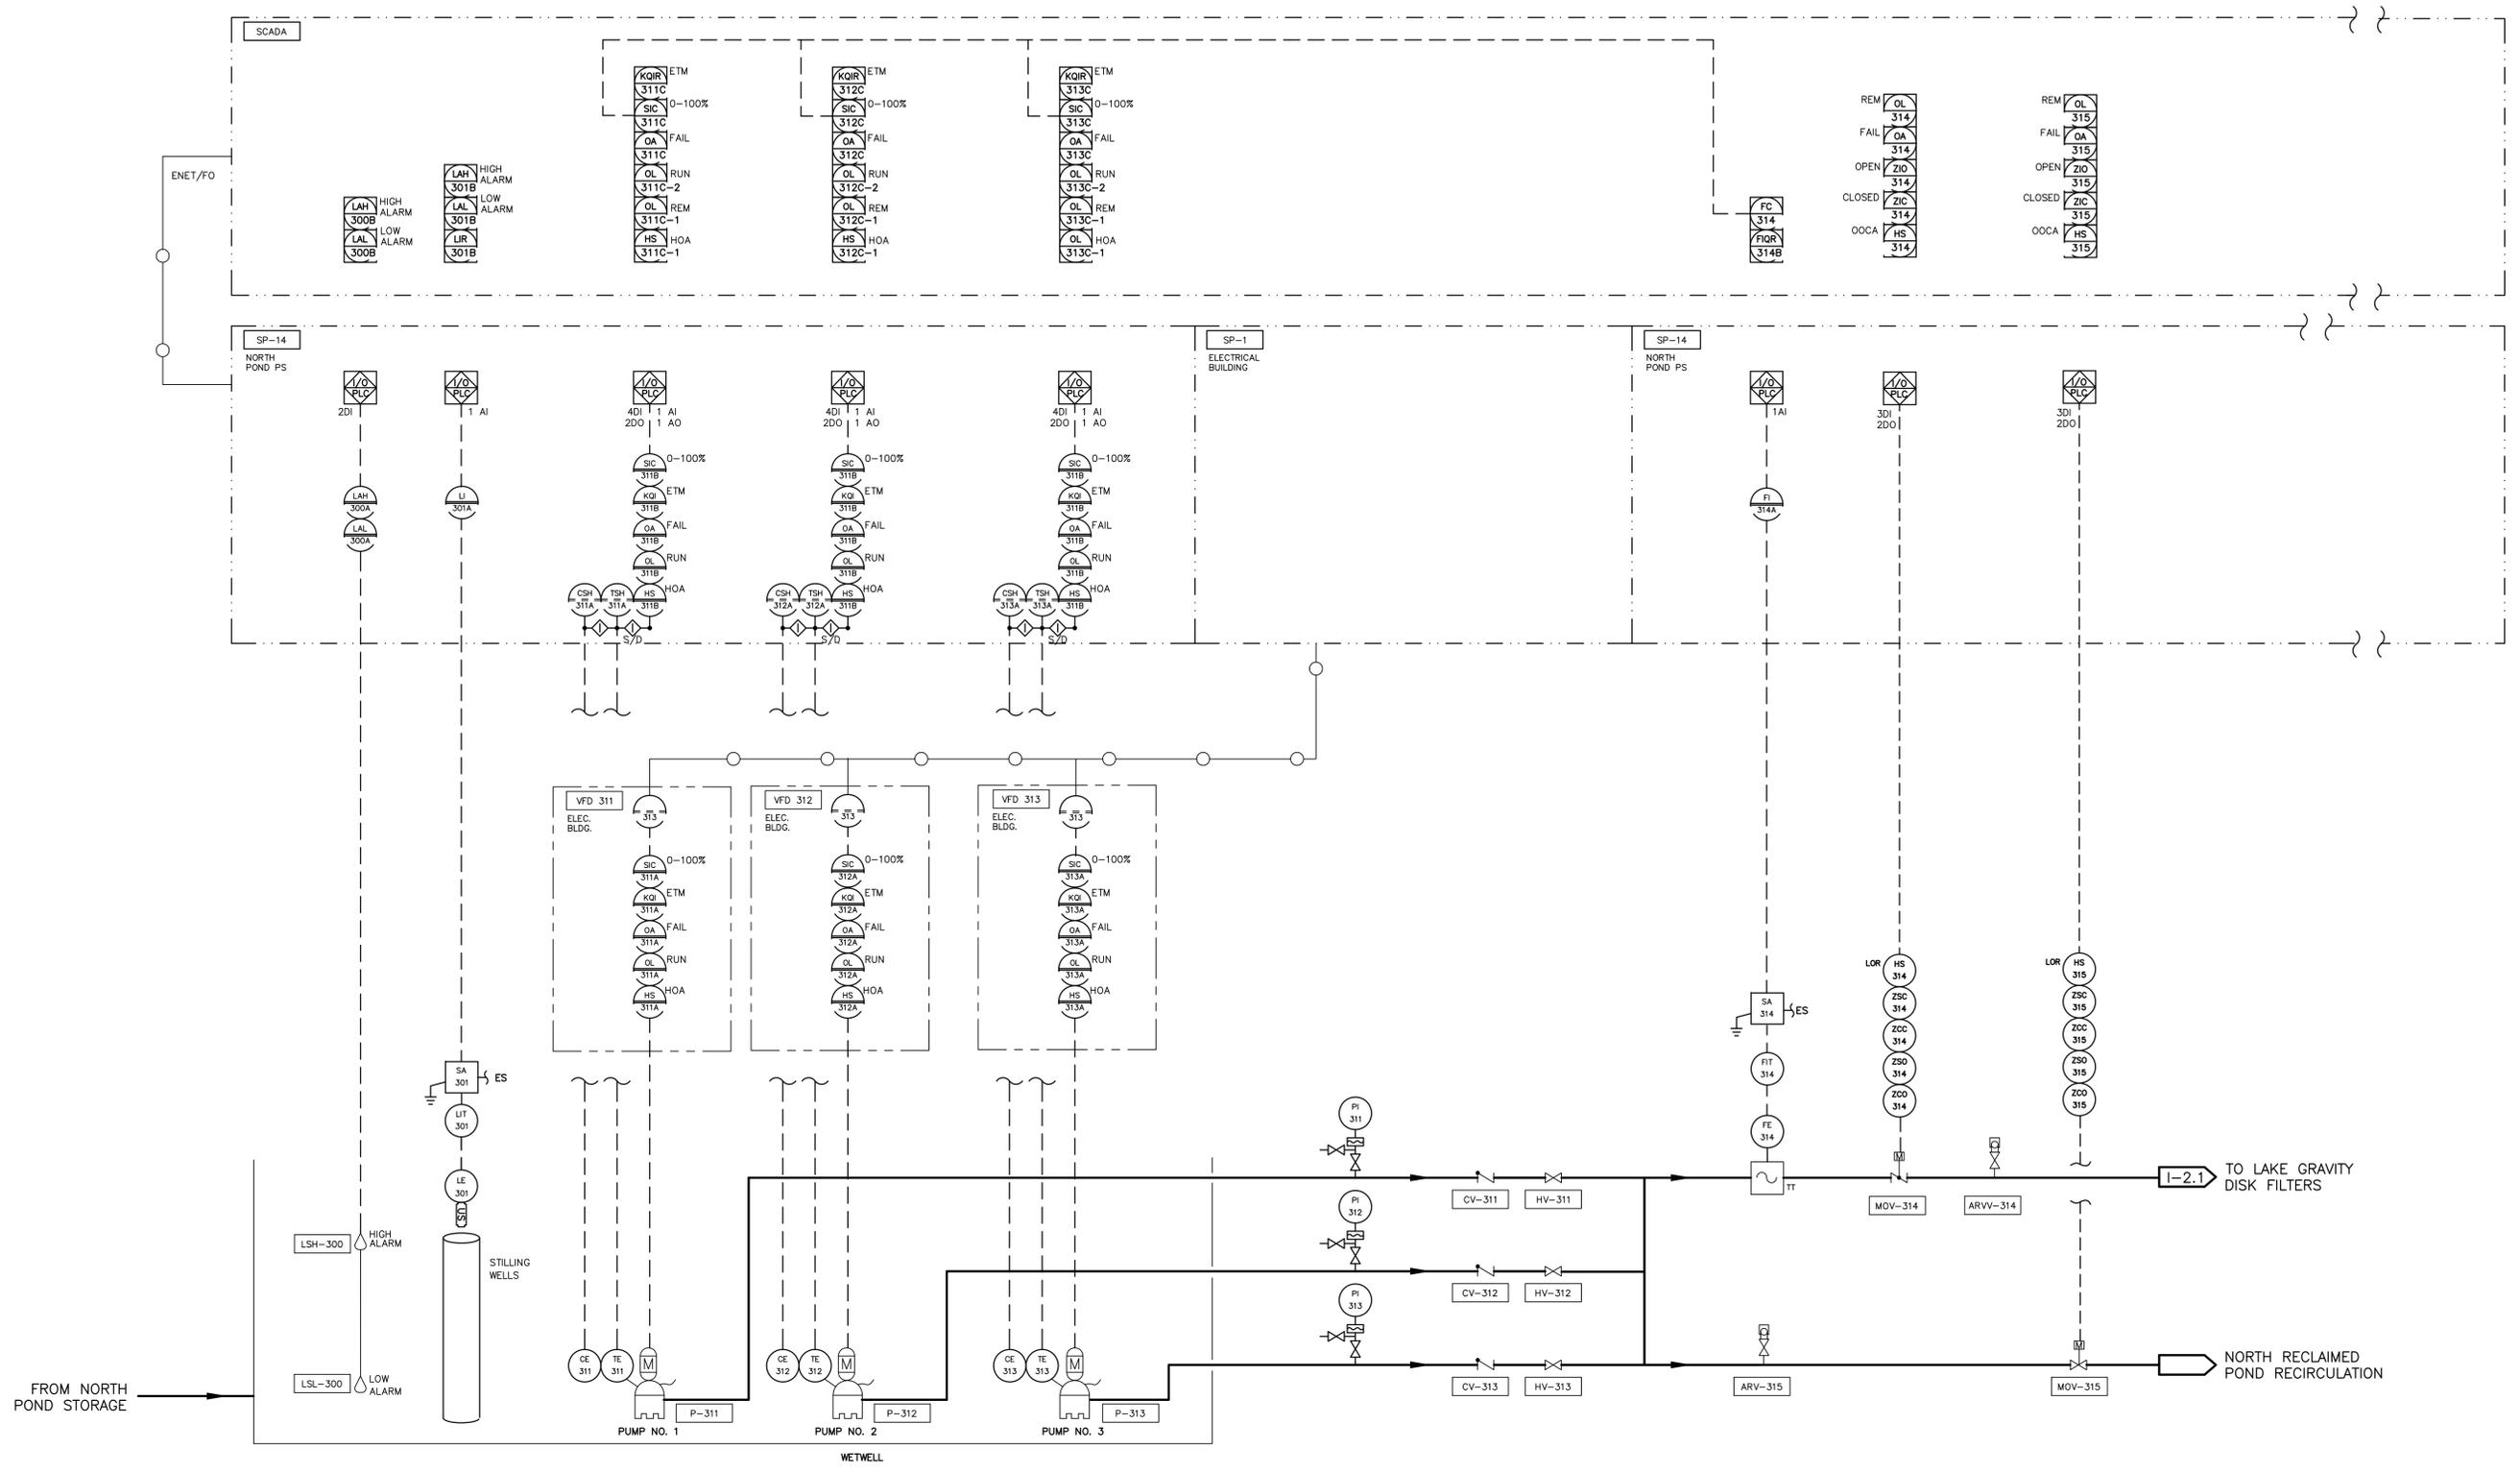
MANATEE COUNTY, FLORIDA

SWRF LAKE FILTRATION AND
NORTH POND IMPROVEMENTS

PROCESS AND INSTRUMENTATION DIAGRAM
LAKE GRAVITY DISK FILTERS
NO. 1 AND 2

DATE: FEBRUARY 2012	SCALE: NA	DRAWING NUMBER: I-2.1
MCE PROJ. # 1024-0142	HORIZONTAL: NA	
DRAWN: MDT	VERTICAL: NA	
DESIGNED: MDT		
CHECKED: TER		
PROJ. MGR: MSL		
STATUS: ISSUE FOR BID		

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NORTH RECLAIMED POND PUMP STATION

SEE DRAWING I-0.2 FOR NETWORK CONNECTIVITY DETAILS.
 1. CONTROL OF THE PUMP STATION VFDs FROM THE LOCAL SCADA PANEL (SP-14) OCCURS THROUGH AN ETHERNET COMMUNICATIONS LINK THROUGH THE ELECTRICAL BUILDING CONTROL PANEL (SP-1)

C:\Users\michael.tweedel\OneDrive\Documents\Projects\SWRF Lake Filtration\Drawings\1024-0142\1024-0142.dwg, 2/15/2012 9:15:18 AM, Michael Tweedel

REV. NO.	DESCRIPTIONS	DATE

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MICHAEL TWEEDEL, P.E.
 No. 60940

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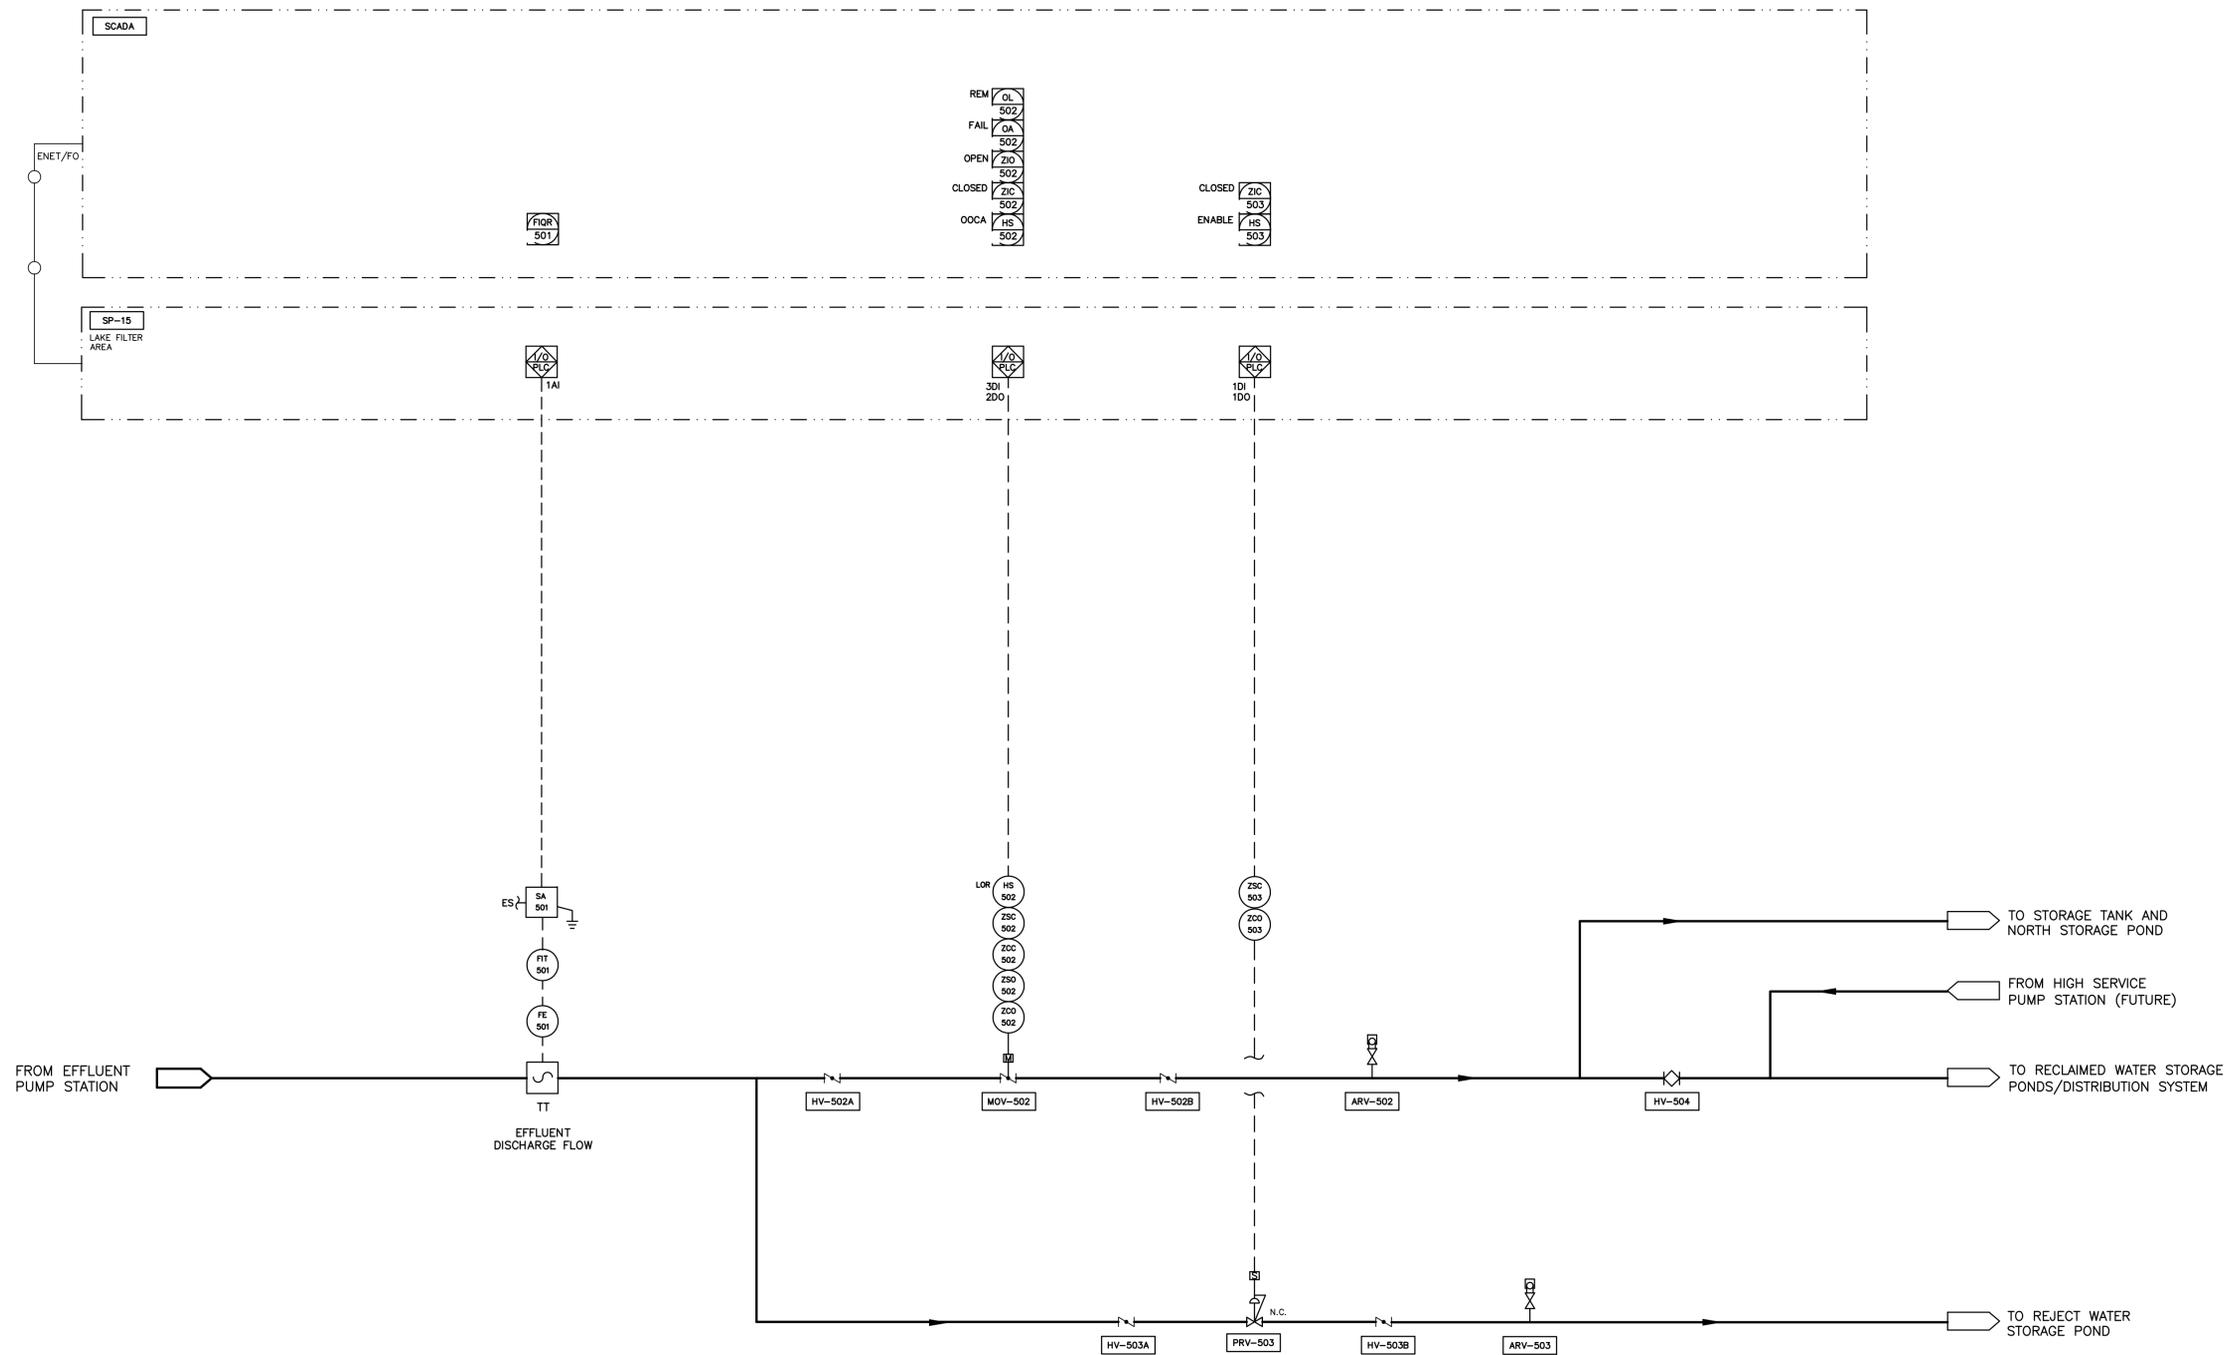
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MANATEE COUNTY, FLORIDA

SWRF LAKE FILTRATION AND NORTH POND IMPROVEMENTS

PROCESS AND INSTRUMENTATION DIAGRAM
NORTH RECLAIMED POND PUMP STATION

DATE: FEBRUARY 2012	SCALE: NA	DRAWING NUMBER: I-3.1
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- NOTES:
1. RECLAIMED WATER VALVE OPERATED TO CLOSE IN AUTO ON LOW CHLORINE RESIDUAL OR HIGH TURBIDITY LEVEL.
 2. REJECT WATER VALVE OPERATED TO OPEN IN AUTO ON LOW CHLORINE RESIDUAL OR HIGH TURBIDITY LEVEL.
 3. VALVE RETURN TO SERVICE MANUALLY INITIATED ONLY AFTER MAINTAINED SAFE CHLORINE RESIDUAL AND TURBIDITY LEVELS.
 4. DISCHARGE FLOW TO BE SEPARATELY TOTALIZED ON RECLAIMED AND REJECT OPERATIONS.

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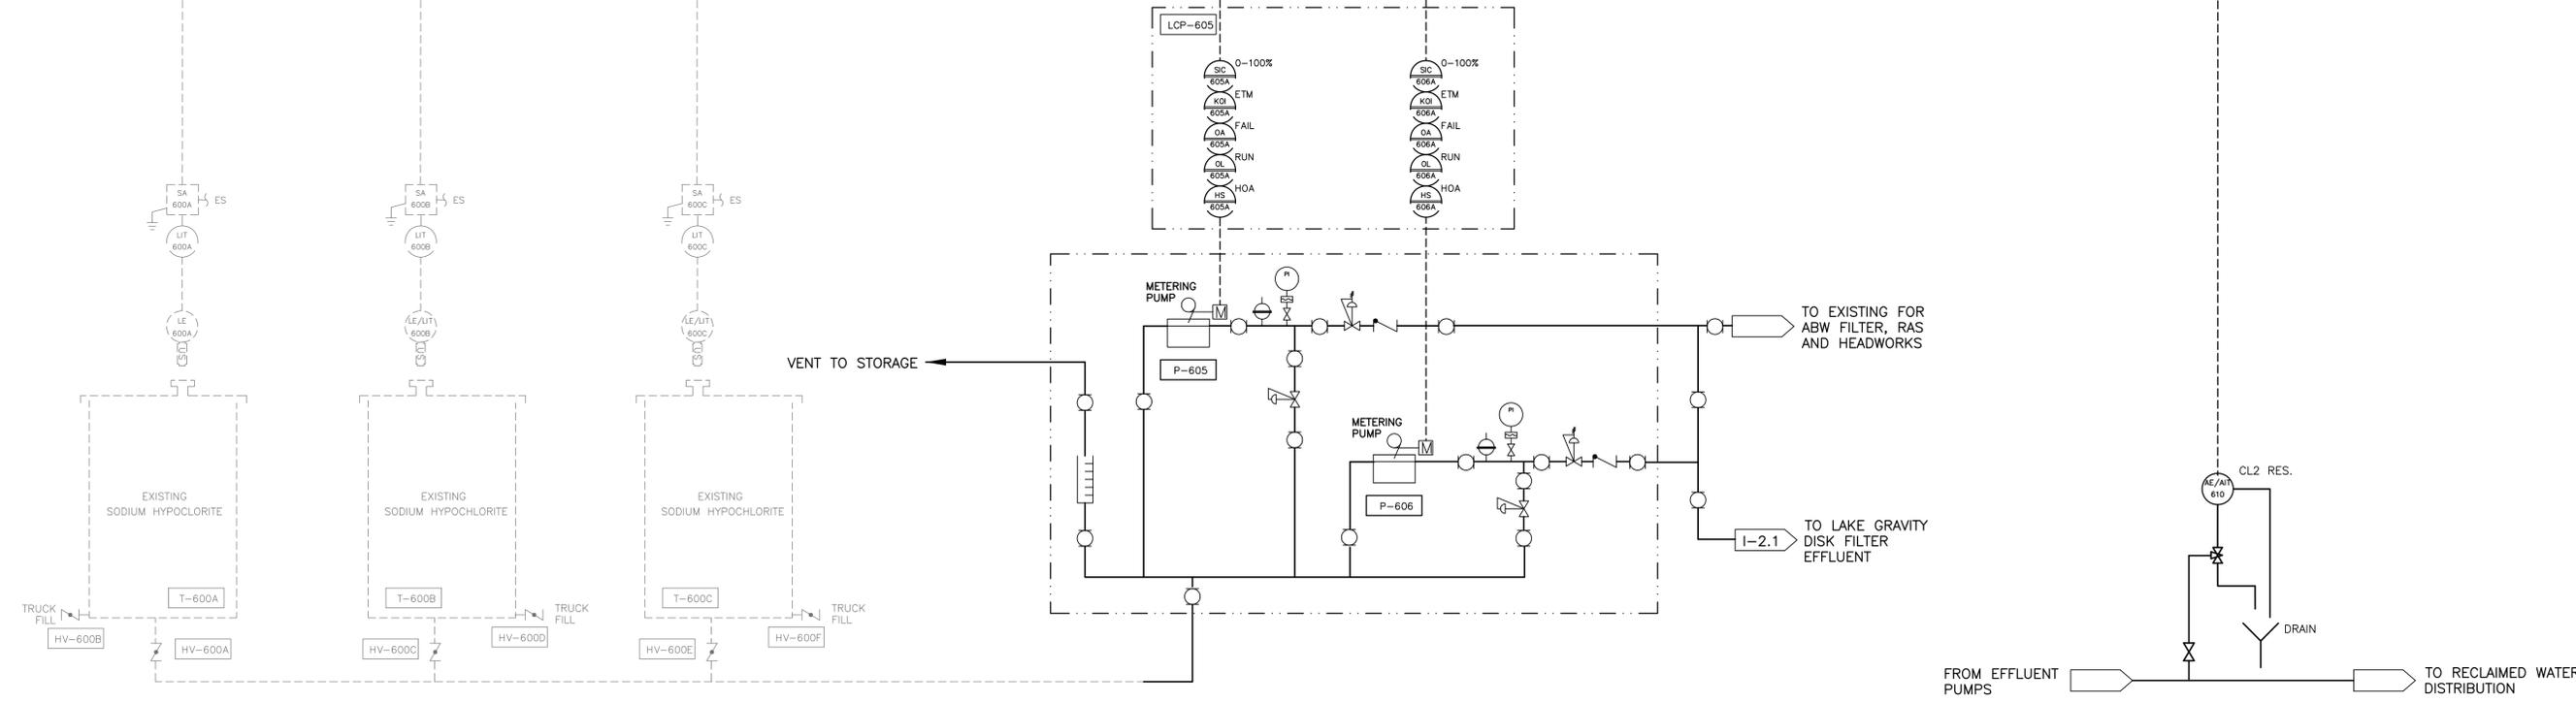
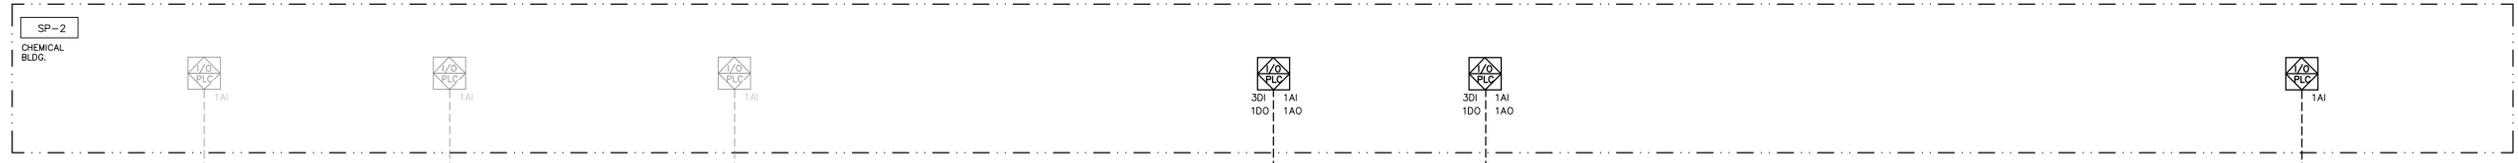
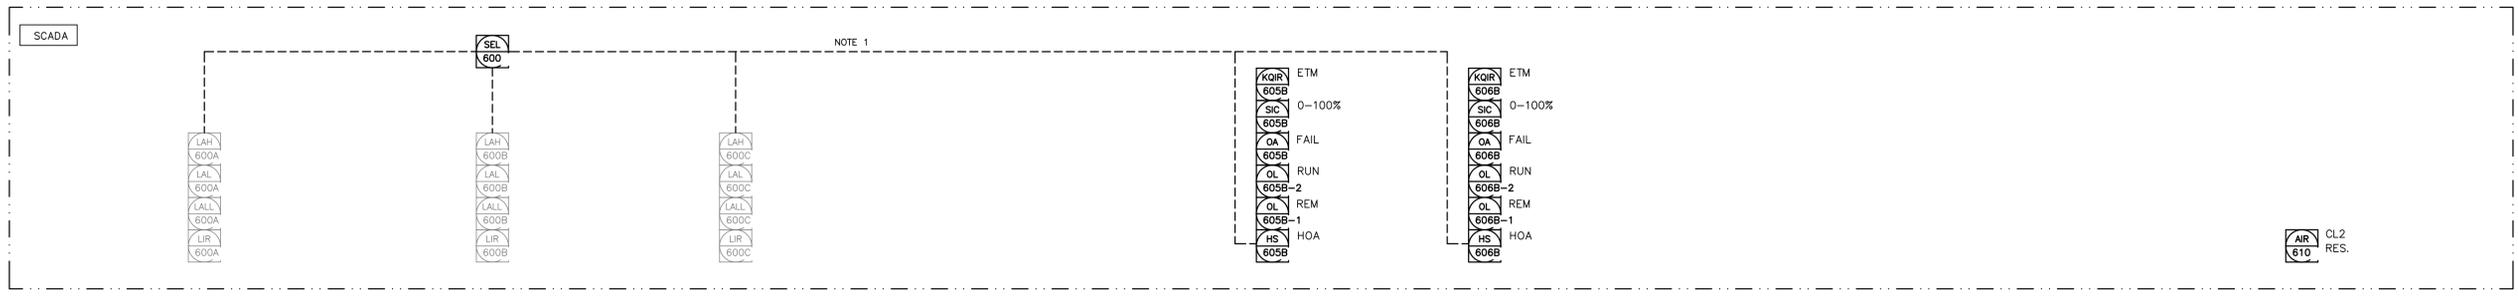
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MANATEE COUNTY, FLORIDA

SWWRF LAKE FILTRATION AND NORTH POND IMPROVEMENTS

PROCESS AND INSTRUMENTATION DIAGRAM
EFFLUENT PUMP STATION DISCHARGE

DATE: FEBRUARY 2012	SCALE:	DRAWING NUMBER:
MCE PROJ. # 1024-0142	HORIZONTAL: NA	I-5.1
DRAWN: MDT	VERTICAL: NA	
DESIGNED: MDT		
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PROJ. MGR. MSL		
STATUS: ISSUE FOR BID		



NOTES:
 1. METERING PUMPS ARE DISABLED FROM OPERATION IN AUTO MODE WHEN SELECTED STORAGE TANK IS AT LOW LEVEL.

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REV. NO.	DESCRIPTIONS	DATE

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MANATEE COUNTY, FLORIDA

SWRF LAKE FILTRATION AND NORTH POND IMPROVEMENTS
PROCESS AND INSTRUMENTATION DIAGRAM
SODIUM HYPOCHLORITE STORAGE AND PUMPING

DATE: FEBRUARY 2012	SCALE: NA	DRAWING NUMBER: I-6.1
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STATUS: ISSUE FOR BID		

LIGHTING FIXTURE SCHEDULE

TYPE	DESCRIPTION	LAMP DATA		BALLAST		VOLTAGE	WATTAGE	MOUNTING	MANUFACTURER	CATALOGUE/SERIES NUMBER	REMARKS
		No.	TYPE	No.	TYPE						
P1	HIGH-PRESSURE SODIUM SITE LIGHTING POLE-MOUNTED	1	150W HPS	1	ELCTRNC	120	187	POLE	NITE-BRITES COOPER/LUMARK LITHONIA	SBX-150S-5T-SC2-PSC HPHR-R2-150-120V-LL KSF1-150S-R2-120-SP04-LPI-CR	FIXTURE SHALL INCLUDE ENHANCED CORROSION RESISTANCE
	12' AL STRAIGHT SQUARE POLE	-	-	-	-	-	-	-	NITE-BRITES COOPER/LUMARK LITHONIA	SSA4-STB-12-D1-BRA SSA-4T12-WCM1-XG SSA-12-4C-DM19-DOB	POLE SHALL INCLUDE VIBRATION DAMPER
P2	HIGH-PRESSURE SODIUM SITE LIGHTING POLE-MOUNTED	1	150W HPS	1	ELCTRNC	120	187	POLE	NITE-BRITES COOPER/LUMARK LITHONIA	HPHR-R2-150-120V-LL KSF1-150S-R2-120-SP04-LPI-CR	FIXTURE SHALL INCLUDE ENHANCED CORROSION RESISTANCE
	17' AL STRAIGHT SQUARE POLE	-	-	-	-	-	-	-	NITE-BRITES COOPER/LUMARK LITHONIA	SSA4-STB-17-D1-BRA SSA-4T17-WCM1-XG SSA-17-4C-DM19-DOB	POLE SHALL INCLUDE VIBRATION DAMPER

LIGHTING FIXTURE SCHEDULE NOTES:

- REFER TO INDIVIDUAL LIGHTING PLANS FOR FIXTURE MOUNTING HEIGHTS NOT INDICATED ON THE SCHEDULE.

DEVICE SYMBOLS

- ⊕ FLOAT/FLOW SWITCH
- ⊖ LIMIT SWITCH
- ⊕ PRESSURE SWITCH
- ⊖ THERMOSTAT
- PULL BOX, SIZE PER NEC
- ⊕ JUNCTION BOX, SIZE PER NEC
- ⊖ ELECTRICAL EQUIPMENT CONNECTION
- ⊕ GROUND ROD
- ⊖ CONTROL STATION
- ⊕ STOP-START STATION
- ⊖ LOCK-OUT-STOP SWITCH
- ⊕ RED STOPPED LIGHT
- ⊖ FUSE
- ⊕ MOTOR OL RELAY
- ⊖ HEATER
- ⊕ CLASS 1/DIVISION 1/II CONDUIT SEAL-OFF FITTING
- LOCATED AT FIELD DEVICE
- △ LOCATED AT MAIN CONTROL PANEL
- LOCATED AT LOCAL CONTROL PANEL
- MOUNTED ON DOOR
- ⊕ CIRCUIT BREAKER
- ⊖ AMMETER
- ⊕ AMMETER SWITCH
- ⊖ VOLTMETER
- ⊕ VOLTMETER SWITCH
- ⊖ MOTOR (HP=RATED HORSEPOWER)
- ⊕ VACUUM STARTER
- ⊖ ANSII/IEEE TYPE-52 AC POWER CIRCUIT BREAKER
- ⊕ INDUSTRIAL BATTERY SET W/MOUNTING RACK
- ⊖ POWER MONITOR
- ⊕ UNDER VOLTAGE
- ⊖ PHASE UNBALANCE
- ⊕ INCOMPLETE SEQUENCE
- ⊖ OVER TEMPERATURE
- ⊕ TIMED OVERCURRENT
- ⊖ TIMED GROUND FAULT
- ⊕ ALARM RELAY
- ⊖ FREQUENCY
- ⊕ LOCK OUT
- ⊖ DIFFERENTIAL
- ⊕ DUCTBANK CALLOUT
- ⊖ CONDUIT OR CABLE NUMBER

GENERAL ELECTRICAL SYMBOLS

- LP-3 CONDUIT HOMERUN TO EQUIPMENT SHOWN. LINE TYPE DESIGNATES CONCEALED, EXPOSED, ETC. NUMBERS/TEXT CIRCUIT NUMBER.
- GENERAL CONDUIT RUN EXPOSED
- CONCEALED CONDUIT IN FLOOR SLAB, UNDERGROUND, ETC.
- EXISTING CABLE OR CONDUIT
- CONDUIT TURNED DOWN
- CONDUIT TURNED UP
- SITE ELECTRICAL
- EXISTING SITE ELECTRICAL
- SITE TELEPHONE
- EXISTING SITE TELEPHONE
- OVERHEAD ELECTRICAL UTILITY
- OVERHEAD TELEPHONE UTILITY
- UNDERGROUND ELECTRICAL UTILITY
- UNDERGROUND TELEPHONE UTILITY
- SITE GROUND
- EXISTING SITE GROUND
- ELECTRICAL INTERLOCK
- ELECTRICAL BUSS
- ELECTRICAL BUSS DUCT
- ⊕ DISCONNECT SWITCH. TOP NUMBER DENOTES FUSE SIZE (NF=NON-FUSED). BOTTOM NUMBER DENOTES FRAME SIZE. RIGHT NUMBER DENOTES NEMA ENCLOSURE RATING.
- ⊕ CIRCUIT BREAKER. TOP NUMBER DENOTES TRIP. BOTTOM NUMBER DENOTES FRAME SIZE. RIGHT NUMBER DENOTES NEMA ENCLOSURE RATING.
- ⊕ COMBINATION MAGNETIC MOTOR STARTER AND DISCONNECT SWITCH OR MOTOR CIRCUIT PROTECTOR. LEFT NUMBER DENOTES NEMA STARTER SIZE. TOP NUMBER DENOTES FUSE SIZE OR MCP. BOTTOM NUMBER DENOTES FRAME SIZE. RIGHT NUMBER DENOTES NEMA ENCLOSURE.
- ⊕ FULL VOLTAGE NON-REVERSING MOTOR STARTER. LEFT NUMBER DENOTES NEMA STARTER SIZE.
- ⊕ REDUCED VOLTAGE SOLID-STATE MOTOR STARTER.
- ⊕ VARIABLE FREQUENCY MOTOR CONTROLLER.
- ⊕ LIGHTING CONTROL SWITCH: {LOWERCASE LETTER} - CONTROL SWITCHING
- M - MOTOR RATED SWITCH 3 - THREE-WAY SWITCHING
- D - DIMMER CONTROL 4 - FOUR-WAY SWITCHING
- OS - OCCUPANCY SENSOR
- ⊕ OUTLETS: NUMBER DENOTES PANEL BOARD CIRCUIT FOR POWER OUTLETS. IF SHOWN, LOWERCASE LETTER DENOTES CONTROL SWITCHING FOR POWER OUTLETS.
- ⊕ SIMPLEX RECEPTACLE. ▼ VOICE (PHONE) OUTLET.
- ⊕ DUPLEX RECEPTACLE. ▼ DATA OUTLET.
- ⊕ QUADRUPLEX RECEPTACLE. ▼ VOICE/DATA COMBINATION OUTLET.
- PP-C/1 LIGHT FIXTURES (VARIOUS TYPES) - UPPERCASE LETTER DENOTES FIXTURE TYPE, REFER TO LIGHTING SCHEDULE OR NOTES. NUMBER DENOTES LIGHTING PANEL CIRCUIT. LOWERCASE LETTER DENOTES CONTROL SWITCH.
- B1:0
- PP-C/3 EMERGENCY LIGHT - BATTERY EQUIPPED, CIRCUIT AHEAD OF CONTROL SWITCHES. ADDITIONAL FIXTURE HEADS MAY BE SHOWN CONNECTED TO UNIT.
- E2
- PP-C/1 EMERGENCY EXIT LIGHT - BATTERY EQUIPPED.
- E3
- ⊕ PHOTOELECTRIC CONTROL DEVICE
- ⊕ LIGHTING CONTACTOR

TYPICAL ABBREVIATIONS

- A, AMP AMPERE
- AFD ADJUSTABLE FREQUENCY DRIVE
- AFG ABOVE FINISHED GRADE
- AIT ANALYTICAL INDICATION TRANSMITTER
- AHU AIR HANDLING UNIT
- AIC AMPLIFY INTERRUPTING CAPACITY
- AL ALUMINUM
- ATS AUTOMATIC TRANSFER SWITCH
- BKR BREAKER
- C CONDUIT
- CAB CABINET
- CAT CATALOG
- CL CHLORINE
- CB CIRCUIT BREAKER
- CCTV CLOSED CIRCUIT TELEVISION
- CKT CIRCUIT
- CLG CEILING
- CP CONTROL PANEL
- CR CONTROL RELAY, CORROSION RESISTANT
- CS CONTROL SWITCH
- CV CONTROL VALVE
- CT CURRENT TRANSFORMER
- CU COPPER
- EF EXHAUST FAN
- EMER EMERGENCY
- EMT ELECTRICAL METALLIC TUBING
- ENCL ENCLOSURE
- EQUIP EQUIPMENT
- EWC ELECTRIC WATER COOLER
- EWH ELECTRIC WATER HEATER
- EPRF EXPLOSION PROOF
- FA FIRE ALARM
- FAAP FIRE ALARM ANNUNCIATOR PANEL
- FACP FIRE ALARM CONTROL PANEL
- FBO FURNISHED BY OTHERS
- FLA FULL LOAD AMPS
- FVNR FULL VOLTAGE NON-REVERSING STARTER
- FLR FLOOR
- FLR FLOOR
- FMC FLEXIBLE METAL CONDUIT
- FWE FURNISHED WITH EQUIPMENT
- GEN GENERATOR
- G, GND GROUND
- GFIC GROUND FAULT CIRCUIT INTERRUPTER
- HH HANDHOLE
- HID HIGH INTENSITY DISCHARGE
- HOA HAND-OFF-AUTO
- HP HORSE POWER
- HPF HIGH POWER FACTOR
- HPS HIGH PRESSURE SODIUM
- HTR HEATER
- HV HIGH VOLTAGE
- Hz HERTZ
- IMC INTERMEDIATE METALLIC CONDUIT (GALVANIZED)
- INCAND INCANDESCENT
- JB JUNCTION BOX
- k THOUSAND
- kCMIL THOUSAND CIRCULAR MILLS
- KA KILOVOLT AMPERE
- KW KILOWATTS
- KWH KILOWATT-HOURS
- LFCM LIQUIDTIGHT FLEXIBLE METAL CONDUIT
- LFNC LIQUIDTIGHT FLEXIBLE NONMETALLIC CONDUIT
- LIT LEVEL INDICATION TRANSMITTER
- LP LIGHTING PANEL, LIGHT POLE
- LTG LIGHTING
- MCB MAIN CIRCUIT BREAKER
- MCC MOTOR CONTROL CENTER
- MCP MOTOR CIRCUIT PROTECTOR
- MDP MAIN DISTRIBUTION PANEL
- MFR MANUFACTURER
- MH MANHOLE
- MLO MAIN LUGS ONLY
- MSB MAIN SWITCHBOARD
- MTD MOUNTED/MOUNTING
- MTS MANUAL TRANSFER SWITCH
- MV MEDIUM VOLTAGE
- NEC NATIONAL ELECTRIC CODE
- NEU NEUTRAL
- NOT APPLICABLE
- NC NORMALLY CLOSE
- NO NORMALLY OPEN
- NIC NOT IN CONTRACT
- NTS NOT TO SCALE
- PA PUBLIC ADDRESS
- PB PUMP CONTROL PANEL
- PCP PUMP CONTROL PANEL
- PF POWER FACTOR
- PH PHASE
- PH PRESSURE INDICATION TRANSMITTER
- PIT PROGRAMMABLE LOGIC CONTROLLER
- PLC PANEL
- PNL PANEL
- PP POWER PANEL, POWER POLE
- PT POTENTIAL TRANSFORMER
- PWR POWER
- RECEP RECEPTACLE
- REQ REDUCED VOLTAGE SOFT STARTER
- RM ROOM
- RMC RIGID METAL CONDUIT (GALVANIZED)
- RTU REMOTE TELEMETRY UNIT
- SCR DC MOTOR DRIVE
- SH SHEET
- SPEC SPECIFICATION
- SS SELECTOR SWITCH
- SST STAINLESS STEEL
- STP SHIELDED TWISTED PAIR
- SW SWITCH
- SWBD SWITCHBOARD
- SWGR SWITCH GEAR
- TEL TELEPHONE
- TVSS TRANSIENT VOLTAGE SURGE SUPPRESSOR
- TYP TYPICAL
- UG UNDERGROUND
- UH UNIT HEATER
- UNON UNLESS OTHERWISE NOTED
- UTIL UTILITY
- UTP UNSHIELDED TWISTED PAIR
- V VOLTS
- VFD VARIABLE FREQUENCY DRIVE
- W WATT
- WH WATT-HOUR
- WP WEATHERPROOF
- XFMR TRANSFORMER

GENERAL NOTES

- REFERENCE ALL SPECIFICATIONS AND CONTRACT DRAWINGS FOR ADDITIONAL REQUIREMENTS AND CONTRACT RESPONSIBILITIES PRIOR TO COMMENCING WORK.
- THE GENERAL NOTES STATED ON THIS DRAWING ARE APPLICABLE TO ALL ELECTRICAL WORK UNLESS NOTED OTHERWISE.
- ALL ELECTRICAL WORK SHALL COMPLY WITH THE CURRENT NEC, NESC AND LOCAL CODES INCLUDING OWNERS STANDARDS AND REQUIREMENTS.
- THE ELECTRICAL INSTALLATION SHALL COMPLY THE REQUIREMENTS OF NECA-1 2006: (STANDARD PRACTICES FOR GOOD WORKMANSHIP IN ELECTRICAL CONSTRUCTION).
- THE SCHEDULING AND DURATION OF ANY SHUTDOWN OF ANY PLANT PROCESS FOR THE REMOVAL OF EXISTING EQUIPMENT OR INSTALLATION OF NEW EQUIPMENT SHALL BE COORDINATED IN ADVANCE WITH THE OWNER.
- ALL SYMBOLS AND ABBREVIATION MAY NOT BE UTILIZED FOR THIS PROJECT.
- ADDITIONAL SYMBOLS NOT SHOWN ON THIS DRAWING MAY BE SHOWN ELSEWHERE ON THE ELECTRICAL DRAWINGS.
- ELECTRICAL DRAWINGS SHOW MAJOR CABLE AND CONDUIT REQUIREMENTS. REFERENCE EQUIPMENT SPECIFICATIONS FOR ADDITIONAL REQUIREMENTS.
- ALL 480V ELECTRICAL EQUIPMENT SHALL HAVE A MINIMUM RATING OF 22K AIC.
- ALL ELECTRICAL EQUIPMENT SHALL BE INSTALLED SO THAT ALL CODE-REQUIRED AND MANUFACTURER-RECOMMENDED SERVICING CLEARANCES ARE MAINTAINED. INSTALLATIONS SHALL COMPLY WITH NEC 110-26 FOR CLEARANCE REQUIREMENTS.
- ALL POWER AND CONTROL WIRING OR CABLES SHALL BE 600V RATED XHHW-2 STRANDED COPPER, UNLESS OTHERWISE NOTED ON DRAWINGS.
- ALL AMPACITIES ARE BASED ON 75°C RATING. THE CONTRACTOR IS RESPONSIBLE FOR THE INCREASING OF CONDUCTOR SIZES AS NECESSARY TO MEET THE REQUIREMENTS OF NEC 110-14(C) WHERE TERMINATIONS ARE NOT LISTED AND LABELED FOR USE AT 75°C. THIS REQUIREMENT APPLIES TO TERMINATIONS IN BOTH NEW EQUIPMENT AND IN EXISTING EQUIPMENT TO WHICH TERMINATIONS ARE MADE AS PART OF THIS PROJECT.
- NO SPLICES OR JUNCTIONS TO FEEDER CABLES SHALL BE MADE WITHOUT ENGINEERS APPROVAL.
- ALL EXPOSED CONDUIT SHALL BE RIGID ALUMINUM.
- ALL CONDUIT INSTALLED BELOW GRADE SHALL BE NON-REINFORCED CONCRETE DUCTBANK; REFERENCE DETAIL SHEETS.
- ALL DUCTBANKS CROSSING ROADWAYS SHALL BE REINFORCED CONCRETE AND EXTEND 5- FEET FROM EDGE OF PAVEMENT. DUCTBANKS SHALL CROSS PROCESS PIPING AT 90° ANGLE WHERE POSSIBLE. REFERENCE DETAIL SHEETS.
- ALL CONDUIT TRANSITIONS THROUGH FINISHED GRADE OR CONCRETE SHALL BE ALUMINUM WITH HEAVY WALL HEAT-SHRINKABLE TUBING 6" MIN. ABOVE AND BELOW TRANSITION.
- ROUGH-IN CONDUIT AS REQUIRED FOR DIRECT CONNECTION TO EQUIPMENT AS SHOWN. PROVIDE FLEXIBLE CONNECTIONS TO ALL EQUIPMENT AND MAKE ALL CONNECTIONS COMPLETE AND IN ACCORDANCE WITH THE SPECIFICATIONS.
- ALL CONDUIT SHALL RUN CONCEALED UNLESS OTHERWISE NOTED OR SHOWN. THE CONDUITS SHALL RUN PARALLEL TO LANDSCAPE AND STRUCTURAL FEATURES, AND THE BENDS AND TURNS SHALL BE MADE BY MEANS OF CONDUIT FITTINGS. MOST CONDUIT LAYOUTS ARE NOT AS SHOWN ON THE PLANS. THE CONTRACTOR SHALL PROPOSE LOGICAL GROUPINGS, MARSHALLING AND ROUTING OF CONDUITS AND WIRING FOR APPROVAL BY ENGINEER PRIOR TO INSTALLATION.
- THE CONTRACTOR SHALL PROVIDE ALL REQUIRED PULL BOXES, TERMINAL BOXES AND JUNCTION BOXES FOR INSTALLATION OF THE WIRING IN ACCORDANCE WITH THE CONTRACT SPECIFICATIONS THOUGH THE BOXES MAY NOT BE INDICATED ON THE DRAWINGS.
- CONDUIT AND WIRING FOR LIGHTING, RECEPTACLES AND OTHER SINGLE PHASE POWERED DEVICES ARE GENERALLY NOT SHOWN BUT SHALL BE PROVIDED AS REQUIRED FOR PROPER SERVICE. MULTI-PHASE CIRCUITS SHALL BE PROVIDED WITH DEDICATED NEUTRAL CONDUCTORS.
- ALL SPARE CONDUITS SHALL BE CAPPED OR PLUGGED AND SHALL INCLUDE 200# TEST POLYPROPYLENE PULL STRING.
- STRUT-CHANNEL SHALL NOT BE BENT, DRILLED, CUT OR OTHERWISE MODIFIED TO PRODUCE FITTINGS, BRACES OR BRACKETS FOR CONDUIT AND EQUIPMENT SUPPORTS.
- MANUFACTURED STRUT-CHANNEL BRACES, BRACKETS, FITTINGS OR POST BASES SHALL BE PROVIDED AND INSTALLED WITH ASSOCIATED HARDWARE AND FASTENERS FOR CONDUIT AND EQUIPMENT SUPPORTS.
- CONTRACTOR SHALL PROVIDE AUXILIARY SUPPORTS FOR SWITCHBOARDS, PANELBOARDS, TRANSFORMERS, CONTROL PANELS, ETC., AS REQUIRED.
- CONTRACTOR SHALL PROVIDE AND INSTALL CONCRETE EMBEDDED LEVELING CHANNEL SUPPORTS FOR FLOOR MOUNTED EQUIPMENT.
- STRUCTURAL MEMBERS SHALL NOT BE DRILLED, CUT, WELDED OR OTHERWISE MODIFIED WITHOUT PRIOR APPROVAL OF THE ENGINEER OF RECORD.
- ALL NEW EQUIPMENT SHALL FIT INTO EXISTING AVAILABLE SPACE. IT IS THE RESPONSIBILITY OF THE CONTRACTOR TO PROVIDE EQUIPMENT WHICH MEETS THE SPACE REQUIREMENTS.
- THE WIRING DIAGRAMS, QUANTITY AND SIZE OF WIRES AND CONDUITS ARE BASED UPON SELECTED STANDARD COMPONENTS OF ELECTRICAL EQUIPMENT. MODIFICATIONS APPROVED BY THE ENGINEER MAY BE MADE BY THE CONTRACTOR AT HIS EXPENSE TO ACCOMMODATE EQUIPMENT ACTUALLY PURCHASED.
- THE CONTRACTOR SHALL PROVIDE ALL NECESSARY COMPONENTS REQUIRED FOR MAKING FINAL CONNECTION OF ALL EQUIPMENT INSTALLED OR MODIFIED AS PART OF THIS CONTRACT.
- NOT ALL MOISTURE AND HAZARDOUS AREA CONDUIT SEALS ARE SHOWN ON THE DRAWINGS. IT IS THE CONTRACTOR'S RESPONSIBILITY TO CONFIRM WITH THE CODE, SPECIFICATION, AND DRAWING REQUIREMENTS FOR THEIR LOCATION.
- CONTRACTOR SHALL PROVIDE BLACK TEXT ON WHITE HEAT-SHRINKABLE CABLE/WIRE IDENTIFICATION LABEL AT BOTH ENDS OF POWER, CONTROL AND DATA WIRING.
- GROUND FAULT CURRENT INTERRUPTING (GFCI) RECEPTACLES:
 - SHALL BE RATED FOR 20A AT 120V WITH LED POWER INDICATOR
 - INSTALLED IN INTERIOR SPACES WHERE EXPOSED TO WATER SOURCES SUCH AS TOILET ROOMS, SHOWER AREAS, KITCHENS, ETC., INDIVIDUAL GFCI RECEPTACLES SHALL BE PROVIDED.
 - INSTALLED OUTDOORS OR IN PROCESS AREAS, ALL RECEPTACLES SHALL BE WEATHER PROOF, CORROSION RESISTANT, AND SHALL BE INDIVIDUAL GFCI DEVICES.

TYPICAL DEVICE MOUNTING HEIGHTS

RECEPTACLES (INTERIOR PROCESS AREAS)	16" AFF
RECEPTACLES (EXTERIOR PROCESS AREAS)	48" AFF
LIGHT SWITCHES	48" AFF
PHONE OUTLETS	16" AFF
PHONE OUTLETS (WALL MOUNT)	64" AFF
DATA OUTLETS	16" AFF
FIRE ALARM PULL STATION	48" AFF
FIRE ALARM AUDIO/VISUAL ALARM	80" AFF
FIRE ALARM VISUAL ALARM ONLY	80" AFF
EXIT LIGHTS (WALL MOUNT)	16" ABOVE DOOR
EMERGENCY LIGHTS (WALL MOUNT)	96" AFF

NOTE: DIMENSIONS ARE TO DEVICE TOP UNLESS NOTED OTHERWISE.

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REVNO.	DESCRIPTIONS REVISIONS	DATE

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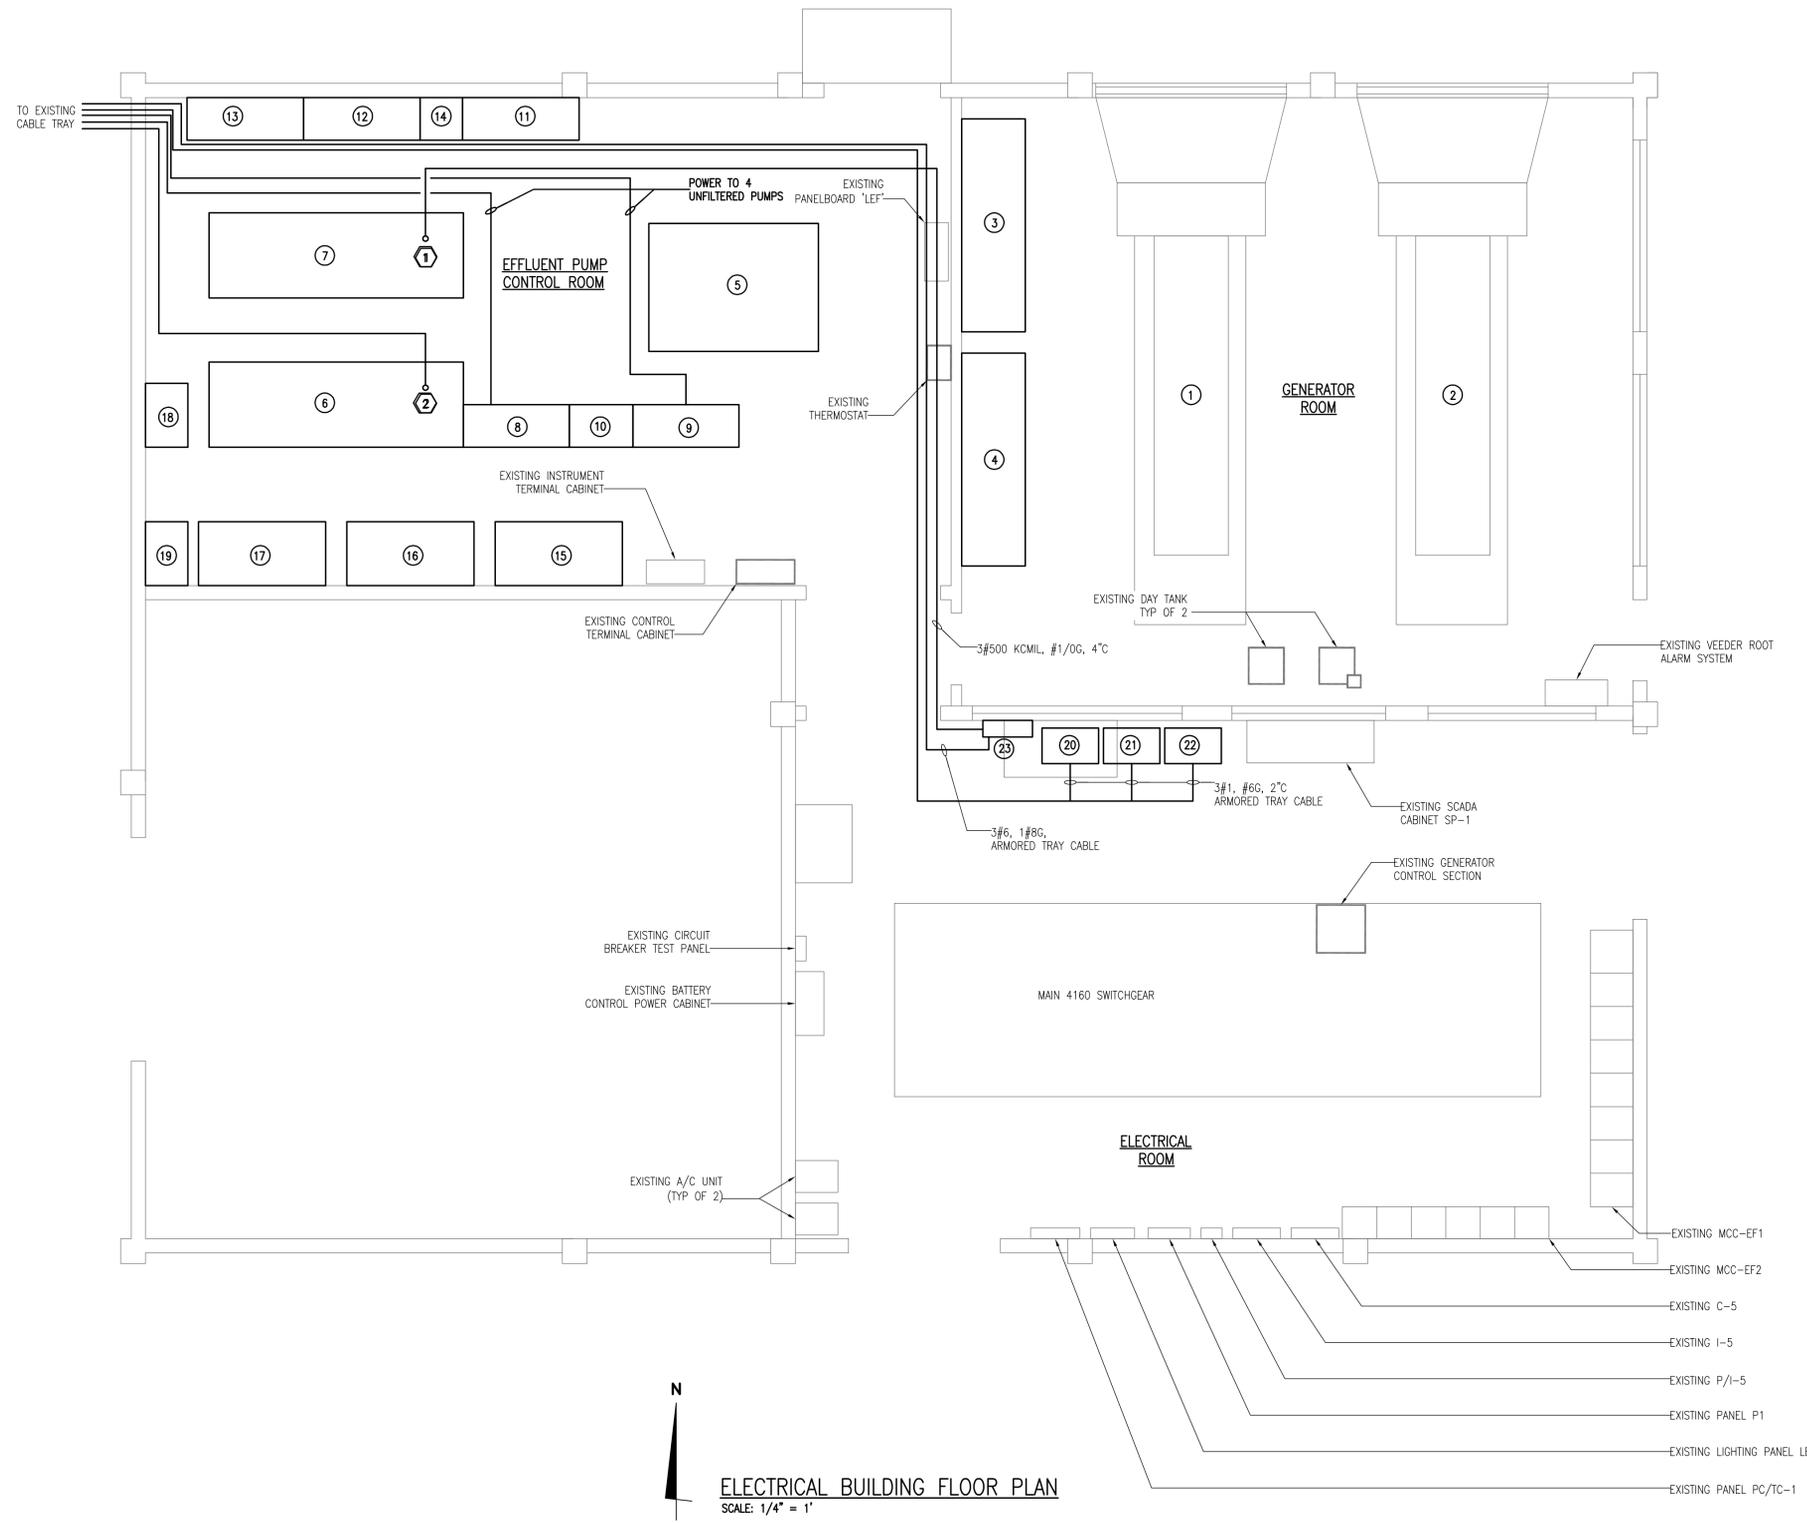


MANATEE COUNTY, FLORIDA

SWRF LAKE FILTRATION AND NORTH POND IMPROVEMENTS

ELECTRICAL GENERAL NOTES, LEGENDS AND ABBREVIATIONS

DATE: FEBRUARY 2012	SCALE:	DRAWING NUMBER:
MCE PROJ. # 1024-0147	HORIZONTAL: NA	E-0.1
DRAWN: CJR	VERTICAL: NA	
DESIGNED: ALA		
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PROJ. MGR. MSL		
STATUS: ISSUE FOR BID		



NOTES:
 1. REFER TO SHEET E001 FOR GENERAL ELECTRICAL NOTES, ABBREVIATIONS AND SYMBOLS.

KEYNOTES:
 ① INSTALL 400 AMP TRIP BREAKER IN EXISTING 750 KVA GE POWERBREAK UNIT SUBSTATION NO. 10.
 ② INSTALL 175 AMP TRIP BREAKER IN EXISTING 750 KVA GE POWERBREAK UNIT SUBSTATION NO. 9.
 ③ SUBSTATION NO. 9 AND NO. 10 ARE GENERAL ELECTRIC POWERBREAK SERIES WITH 1600 AMP BUSSING. ORIGINAL GE JOB NUMBER: 962044, ITEM: 01, SEC.: 102 PLANT: BN.

- EQUIPMENT LEGEND:**
- ① EXISTING 2000KW, 4160 GENERATOR No.1
 - ② EXISTING 2000KW, 4160 GENERATOR No.2
 - ③ 500/667 KVA, 4160-480V UNIT SUBSTATION USB-1
 - ④ 500/667 KVA, 4160-480V UNIT SUBSTATION USB-2
 - ⑤ 4160V GENERATOR SWITCHGEAR
 - ⑥ 750 KVA, 4160-480V UNIT SUBSTATION USB-9
 - ⑦ 750 KVA, 4160-480V UNIT SUBSTATION USB-10
 - ⑧ SUBSTATION 11 480V SWITCHBOARD
 - ⑨ SUBSTATION 12 480V SWITCHBOARD
 - ⑩ EFFLUENT PUMP No. 5 ATS
 - ⑪ EFFLUENT PUMP No. 1 VFD
 - ⑫ EFFLUENT PUMP No. 2 VFD
 - ⑬ EFFLUENT PUMP No. 3 VFD
 - ⑭ EFFLUENT PUMP No. 2 ATS
 - ⑮ EFFLUENT PUMP No. 4 VFD
 - ⑯ EFFLUENT PUMP No. 5 VFD
 - ⑰ EFFLUENT PUMP No. 6 VFD
 - ⑱ INSTRUMENTATION/CONTROL CONDUCTOR JUNCTION BOX
 - ⑲ POWER CONDUCTOR JUNCTION BOX
 - ⑳ PROPOSED NORTH RECLAIMED PUMP STATION PUMP 1 VFD
 - ㉑ PROPOSED NORTH RECLAIMED PUMP STATION PUMP 2 VFD
 - ㉒ PROPOSED NORTH RECLAIMED PUMP STATION PUMP 3 VFD
 - ㉓ PROPOSED NEW 480V PANELBOARD PP-301

ELECTRICAL BUILDING FLOOR PLAN
 SCALE: 1/4" = 1'

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REVNO.	DATE	DESCRIPTIONS	REVISIONS

SEAL
 ARTHUR L. ANCHORS, P.E.
 No. 39804

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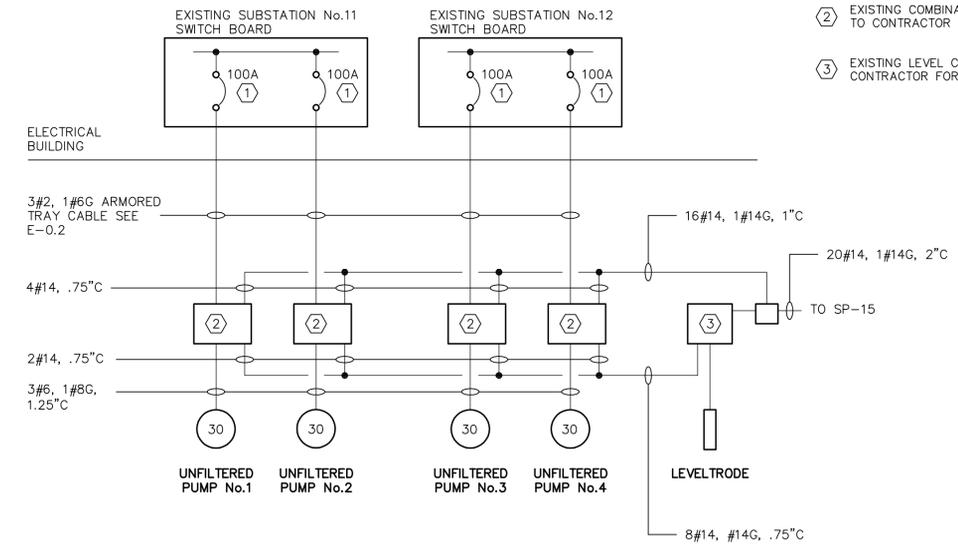
MANATEE COUNTY, FLORIDA

SWRF LAKE FILTRATION AND NORTH POND IMPROVEMENTS
ELECTRICAL BUILDING FLOOR PLAN

DATE: FEBRUARY 2012	SCALE: 1/4" = 1'	DRAWING NUMBER: E-0.3
MCE PROJ. # 1024-0147	HORIZONTAL: 1/4" = 1'	
DRAWN: CJR	VERTICAL: NA	
DESIGNED: ALA		
CHECKED: ALA		
PROJ. MGR.: MSL		
STATUS: ISSUE FOR BID		REVISION:

GENERAL NOTES:

- ① EXISTING 100A, 3P, BREAKER
- ② EXISTING COMBINATION MOTOR STARTER TO BE SUPPLIED BY OWNER TO CONTRACTOR FOR INSTALLATION
- ③ EXISTING LEVEL CONTROL PANEL TO BE SUPPLIED BY OWNER TO CONTRACTOR FOR INSTALLATION



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REV. NO.	DESCRIPTIONS	DATE

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MANATEE COUNTY, FLORIDA
MANATEE COUNTY, FLORIDA

SWWRF LAKE FILTRATION AND NORTH POND IMPROVEMENTS
ELECTRICAL BUILDING No.1 UNFILTERED PUMP STATION SINGLE LINE DIAGRAM

DATE: FEBRUARY 2012	SCALE	DRAWING NUMBER
MCE PROJ. # 1024-0147	HORIZONTAL: 1" = 100'	E-0.5
DRAWN: CJR	VERTICAL: NA	
DESIGNED: ALA		
CHECKED: ALA		
PROJ. MGR.: MSL		
STATUS: ISSUE FOR BID		

PANEL: PP-301

ENCLOSURE: NEMA: 1 MOUNTING: SURFACE MAIN: 400A MB MLO
 VOLTS: 480V, 3 PHASE, 3 WIRE NEUTRAL: 100% 200%
 LOCATION: ELECTRICAL BUILDING BRACING: 22,000A FULLY RATED FEED:

LOAD SERVED	LOAD (KVA)			BREAKER		BRANCH CIRCUIT CONDUIT & WIRING	CKT	PH	CKT	BRANCH CIRCUIT CONDUIT & WIRING	BREAKER		LOAD (KVA)			LOAD SERVED
	A	B	C	AMP	POLE						AMP	POLE	A	B	C	
RECLAIM PUMP 1 P-311	20.50	20.50		125	3	3#1/0, 1#6G, 2°C	1	A	2	3#6, 1#8G, 2°C	60	3	3.00	3.00		PANEL PP-302
		20.50					5	C	6						3.00	
RECLAIM PUM 2 P-312	20.50	20.50		125	3	3#1/0, 1#6G, 2°C	7	A	8				0.00			SPARE
		20.50					11	C	12						0.00	
RECLAIM PUMP 3 P-313	20.50	20.50		125	3	3#1/0, 1#6G, 2°C	13	A	14				0.00			SPARE
		20.50					15	B	16				0.00			SPARE
SPACE	0.00						17	C	18				0.00			SPARE
SPACE		0.00					19	A	20				0.00			SPARE
SPACE			0.00				21	B	22				0.00			SPARE
SPACE				0.00			23	C	24				0.00			SPARE
SPACE	0.00						25	A	26				0.00			SPARE
SPACE		0.00					27	B	28				0.00			SPARE
SPACE			0.00				29	C	30				0.00			SPARE
SPACE	0.00						31	A	32				0.00			SPARE
SPACE		0.00					33	B	34				0.00			SPARE
SPACE			0.00				35	C	36				0.00			SPARE
SPACE	0.00						37	A	38				0.00			SPARE
SPACE		0.00					39	B	40				0.00			SPARE
SPACE			0.00				41	C	42				0.00			SPARE
TOTAL(S):	61.50	61.50	61.50										3.00	3.00	3.00	

TOTAL BUS A LOAD: 64.50 KVA
 TOTAL BUS B LOAD: 64.50 KVA
 TOTAL BUS C LOAD: 64.50 KVA

TOTAL CONNECTED KVA: 193.50

SCHEDULE NOTES:
 1. REFER TO SPECIFICATIONS FOR ADDITIONAL REQUIREMENTS.
 2. ALL BUSSES SHALL BE PLATED COPPER.
 3. ALL BREAKERS SHALL BE FULLY RATED.

PANEL: PP-302

ENCLOSURE: NEMA: 4X MOUNTING: SURFACE MAIN: 60A MB MLO
 VOLTS: 480V, 3 PHASE, 3 WIRE NEUTRAL: 100% 200%
 LOCATION: RECLAIM PUMP STATION BRACING: 22,000A FULLY RATED FEED:

LOAD SERVED	LOAD (KVA)			BREAKER		BRANCH CIRCUIT CONDUIT & WIRING	CKT	PH	CKT	BRANCH CIRCUIT CONDUIT & WIRING	BREAKER		LOAD (KVA)			LOAD SERVED
	A	B	C	AMP	POLE						AMP	POLE	A	B	C	
MOTORIZED VALVE	0.20			20	3		1	A	2				2.00			PANEL LP-302
		0.20					3	B	4				2.00			
			0.20				5	C	6						2.00	
MOTORIZED VALVE	0.20			20	3		7	A	8				0.00			SPARE
		0.20					9	B	10				0.00			SPARE
			0.20				11	C	12						0.00	
SPACE	0.00						13	A	14				0.00			SPACE
SPACE		0.00					15	B	16				0.00			SPACE
SPACE			0.00				17	C	18				0.00			SPACE
SPACE	0.00						19	A	20				0.00			SPACE
SPACE		0.00					21	B	22				0.00			SPACE
SPACE			0.00				23	C	24				0.00			SPACE
TOTAL(S):	0.40	0.40	0.40										2.00	2.00	2.00	

TOTAL BUS A LOAD: 2.40 KVA
 TOTAL BUS B LOAD: 2.40 KVA
 TOTAL BUS C LOAD: 2.40 KVA

TOTAL CONNECTED KVA: 7.20

SCHEDULE NOTES:
 1. REFER TO SPECIFICATIONS FOR ADDITIONAL REQUIREMENTS.
 2. ALL BUSSES SHALL BE PLATED COPPER.
 3. ALL BREAKERS SHALL BE FULLY RATED.

PANEL: LP-302

ENCLOSURE: NEMA: 4X MOUNTING: SURFACE MAIN: 50A MB MLO
 VOLTS: 120/208V, 3 PHASE, 4 WIRE NEUTRAL: 100% 200%
 LOCATION: RECLAIM PUMP STATION BRACING: 10,000A FULLY RATED FEED:

LOAD SERVED	LOAD (KVA)			BREAKER		BRANCH CIRCUIT CONDUIT & WIRING	CKT	PH	CKT	BRANCH CIRCUIT CONDUIT & WIRING	BREAKER		LOAD (KVA)			LOAD SERVED
	A	B	C	AMP	POLE						AMP	POLE	A	B	C	
SP-15	0.10			20	1	2#18, 1#18G, 1°C	1	A	2			20	1	0.00		RECEPTACLES ON EQUIPMENT
		0.00					3	B	4			20	1		0.00	LIGHTS AT PUMP STATION
FIT-314			0.10	20	1		5	C	6			20	1		0.00	
SPARE	0.00			20	1		7	A	8			20	1	0.00		SPARE
SPARE		0.00		20	1		9	B	10			20	1		0.00	SPARE
SPARE			0.00	20	1		11	C	12			20	1		0.00	SPARE
TOTAL(S):	0.100	0.000	0.100											0.000	0.000	0.000

TOTAL BUS A LOAD: 0.100 KVA
 TOTAL BUS B LOAD: 0.000 KVA
 TOTAL BUS C LOAD: 0.100 KVA

TOTAL CONNECTED KVA: 0.200

SCHEDULE NOTES:
 1. REFER TO SPECIFICATIONS FOR ADDITIONAL REQUIREMENTS.
 2. ALL BUSSES SHALL BE PLATED COPPER.
 3. ALL BREAKERS SHALL BE FULLY RATED.

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REVNO.	DATE	DESCRIPTIONS REVISIONS

SEAL

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MANATEE COUNTY, FLORIDA

SWRF LAKE FILTRATION AND
 NORTH POND IMPROVEMENTS

PANELBOARD SCHEDULES

DATE: FEBRUARY 2012	SCALE	DRAWING NUMBER
MCE PROJ. # 1024-0147	HORIZONTAL: NA	E-0.7
DRAWN: CJR	VERTICAL: NA	
DESIGNED: ALA		
CHECKED: ALA		
PROJ. MGR: MSL		REVISION
STATUS: ISSUE FOR BID		

