### CONTRACT PLANS COMPONENTS

ROADWAY PLANS SIGNING AND PAVEMENT MARKINGS PLANS LIGHTING PLANS

# CONSTRUCTION PLANS 9TH AVENUE NW

MANATEE COUNTY, FLORIDA OCTOBER 2025 MANATEE COUNTY PROJECT # 20-TA003483CD

Vlanatee

### PROJECT TEAM:

941-379-7600

<u>OWNER:</u> MANATEE COUNTY 1022 26TH AVE E BRADENTON, FL 34206 CONTACT: STEVE CLARK 941-748-4501 EXT. 7326

KIMLEY-HORN AND ASSOCIATES, INC. 1800 SECOND STREET, SUITE 900 SARASOTA, FL 34236 CONTACT: IORDAN LEEP PE

HYATT SURVEYING SERVICES INC. 2012 LENA ROAD BRADENTON, FL 34211 CONTACT:JOHN MATTHEWS 941-748-4693

ARDAMAN AND ASSOCIATES, INC. 78 SARASOTA CENTER BOULEVARD SARASOTA, FL 34240 CONTACT: VIRGINIA GOEF PE 941-225-4424

### UTILITY CONTACTS

MANATEE COUNTY PUBLIC WORKS DEPT. INFRASTRUCTURE ENGINEERING 1022 26TH AVE E BRADENTON EL 34206 (941) 748-4501 EXT. 7326

TECO/PEOPLES GAS CO. ALEX MCFARLANE 8261 VICO COURT SARASOTA, FL 34240 (813) 275-3762 AMCFARLANE@TECOENERGY.COM

SUNSHINE STATE ONE CALL OF FIORIDA 1-(800) 432-4770

FRONTIER FLORIDA LIC DENISE HUTTON 1701 RINGLING BLVD SARASOTA, FL 34236 (941) 906-6722 DENISE.HUTTON@FTR.COM

FLORIDA POWER & LIGHT DISTRIBUTION BRIAN GARVER 1253 12TH AVE E PALMETTO, FL 34221 BRIAN GARVER@EPI COM

SPECTRUM SUNSHINE STATE LLC. JOSEPH WITHAM 5413 EAST SR 64 BRADENTON, FL 34208 (941) 737-0003 JOSEPH.WITHAM@CHARTER.COM


SOUTHWEST FLORIDA WATER MANAGEMENT DISTRICT SARASOTA SERVICE OFFICE BRANDEE ALEXANDER 7601 HIGHWAY 301 NORTH TAMPA, FL 33637 (813) 445-6649

MANATEE COUNTY UTILITY OPERATIONS 1022 26TH AVE EAST BRADENTON, FL 34208 (941) 708-7450 EXT. 7650 SCOTT.MAY@MYMANATEE.ORG

MCI/VERIZON BUSINESS JAMES BARRA 7701 E TELECOM PARKWAY TEMPLE TERRACE, FL 33637 (813) 928-9881 JAMES BARRAL@VERIZONWIRELESS COM

DEPARTMENT OF ENVIRONMENTAL PROTECTION ED WATSON 13051 N. TELECOM PKWY TEMPLE TERRACE, FL 33637 PHONE: (813) 470-5875 FAX: (813) 470-5993

MANATEE COUNTY PUBLIC WORK DEPT TRAFFIC ENGINEERING MUKUNDA GOPALAKRISHNA, P.E., P.T.O.E. PUBLIC WORKS DEPARTMENT COUNTY TRAFFIC ENGINEER 2101 47TH TERRACE EAST BRADENTON, FL 34203 OFFICE: (941) 749-3500, EXT. 7813

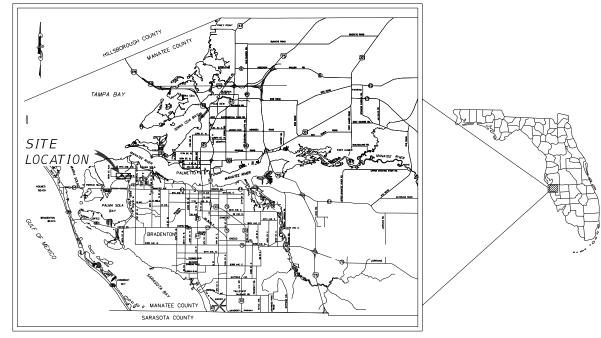

PROJECT VICINITY MAP

# COUNTY CIP PROJECT BID PLANS REVISION 1

PREPARED BY

### GOVERNING STANDARD PLANS:

Florida Department of Transportation, FY2025-26 Standard Plans for Road and Bridge Construction and applicable Interim Revions (IRs)

Standard Plans for Road Construction and associated IRs are available at the following website: http://www.fdot.gov/design/standardplans

APPLICABLE IRs: NONE

### GOVERNING STANDARD SPECIFICATIONS:

Florida Department of Transportation, FY2025-26 Standard Specifications for Road and Bridge Construction at the following website: http://www.fdot.gov/programmanagement/Implemented/SpecBooks

### INDEX OF ROADWAY PLANS


MDEN OF NO	71011711 1 271113
SHEET NO.	SHEET DESCRIPTION
£1	KEY SHEET
<u> </u>	SIGNATURE SHEET )
(3 - 5	SUMMARY OF PAY ITEMS {
Juguer 1	DRAINAGE MAPS
9 - 15	TYPICAL SECTIONS
16 - 17	SUMMARY OF DRAINAGE STRUCTURES
18 - 24	SPECIAL DETAILS
25 - 27	PROJECT LAYOUT AND CONTROL
28 - 31	GENERAL NOTES
32 - 49	PLAN SHEETS
50 - 52	INTERSECTION DETAIL SHEETS
<i>53 - 54</i>	PROFILE SHEETS
55 - 68	BOSW PROFILE SHEETS
69 - 90	CROSS SECTIONS
91 - 96	DRIVEWAY HALF SECTIONS
( °97 - 115 ° ° ° ° ° ° ° ° ° ° ° ° ° ° ° ° ° °	ŤĚMPŎŘÁŘÝ ŤŘÁFFIC ČŎŇŤŘŎĽ PLÁŇ
<u>}</u> } 116 - 131	UTILITY ADJUSTMENT SHEETS
△ } <sub>132 - 142</sub>	UTILITY CONFLICT RELOCATIONS
143 - 146	UTILITY DETAIL SHEETS
147-150	^^\$}`ORMW`ATER`POLLUTÌON`^^^
	PREVENTION PLANS
151	EROSION CONTROL DETAIL SHEET
↑ ( 152 - 162 ° ° ° ° ° ° ° ° ° ° ° ° ° ° ° ° ° ° °	ŠUE INFORMATION SHEETS
_ ~~~~~~~~~~~~~~~~~~~~~~~~~~~~~~~~~~~~~	

GR-1\* BORING LOCATION PLAN REPORT OF CORE BORINGS

\* THESE SHEETS ARE INCLUDED IN THE INDEX OF ROADWAY PLANS ONLY TO INDICATE THAT THEY ARE PART OF THE ROADWAY PLANS. THESE PLANS ARE CONTAINED IN A SEPARATE DIGITALLY SIGNED

THE SITE CONSTRUCTION STAKEOUT SHALL BE PERFORMED UNDER THE DIRECTION OF A FLORIDA REGISTERED SURVEYOR. AUTOCAD FILES WILL BE FURNISHED TO AID IN THE SITE CONSTRUCTION STAKEOUT. ANY DISCREPANCIES FOUND BETWEEN AUTOCAD FILES AND SITE CONSTRUCTION PLANS SHALL BE BROUGHT TO THE ENGINEER'S

	ATTENTION FOR CLARIFICATION PRIOR TO TH	IAT STAKFOUT	
		DATE OCTOBER 2025	
	THIS DOCUMENT IS PROTECTED BY SECTION 106 OF		
	THE "UNITED STATES COPYRIGHT ACT". REPRODUCTION OR ALTERATION OF THIS DOCUMENT OR THE INFORMATION CONTAINED HEREON BY ANY		KHA PROJECT NO. 148400070
SK	MEANS WHATSOEVER IS STRICTLY PROHIBITED WITHOUT THE PRIOR WRITTEN CONSENT OF	IODDAN E LEED DE	SHEET NUMBER
	KIMLEY-HORN AND ASSOCIATES, INC. CONSENT IS   HEREBY GRANTED SPECIFICALLY TO GOVERNMENTAL   AGENCIES TO REPRODUCE THIS DOCUMENT IN	JORDAN E. LEEP, P.E. FLORIDA LICENSE NUMBER:	1

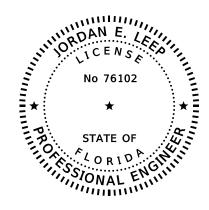

THIS ITEM HAS BEEN DIGITALLY SIGNED AND SEALED BY

ON THE DATE ADJACENT TO THE SEAL.

SIGNATURE MUST BE VERIFIED ON ANY ELECTRONIC COPIES.

KIMLEY-HORN AND ASSOCIATES, INC. 1800 SECOND STREET, SUITE 900 SARASOTA, FLORIDA 34236 JORDAN E. LEEP, P.E. NO. 76102

THE ABOVE NAMED PROFESSIONAL ENGINEER SHALL BE RESPONSIBLE FOR THE FOLLOWING SHEETS IN ACCORDANCE WITH RULE 61G15-23.004, F.A.C.

### ROADWAY PLANS

SHEET NO. SHEET DESCRIPTION

KEY SHEET SIGNATURE SHEET SUMMARY OF PAY ITEMS DRAINAGE MAPS 9 - 15 TYPICAL SECTIONS 9 - 15 16 - 17 18 - 24 25 - 27 28 - 31 32 - 49 50 - 52 53 - 54 55 - 68 69 - 90 91 - 96 97 - 115 116 \ 131 132 - 142 143 - 146 147 - 150 SUMMARY OF DRAINAGE STRUCTURES SPECIAL DETAILS PROJECT LAYOUT AND CONTROL GENERAL NOTES PLAN SHEETS INTERSECTION DETAIL SHEETS PROFILE SHEETS BOSW PROFILE SHEETS CROSS SECTIONS CROSS SECTIONS
DRIVEWAY HALF SECTIONS
TEMPORARY TRAFFIC CONTROL PLAN
UTILITY ADJUSTMENT SHEETS
UTILITY CONFLICT RELOCATIONS
UTILITY DETAIL SHEETS
STORMWATER POLLUTION PREVENTION PLANS
EROSION CONTROL DETAIL SHEET
SUE INFORMATION SHEETS 151 152 - 162

$\triangle$	UTILITY RELOCATION AND REVISION	10/14/25	5 SK	
No.	<i>REVISIONS</i>	DATE	BY	
Seth.KI.	ine			

**Kimley** » Horn

 $\ \varnothing$  2025 KIMLEY-HORN AND ASSOCIATES, INC. 1800 SECOND STREET, SUITE 900, SARASOTA, FL 34236 PHONE: 941-379-7600 WWW.KIMLEY-HORN.COM

 $\Delta$ 

KHA PROJECT		
148400070		
DATE		
10/14/2025		
SCALE AS SHOWN		
DESIGNED BY		

CHECKED BY



9TH AVENUE NW

IORDAN F LEEP, P.E. FLLICENSE NUMBER 76102

FL DATE:

LICENSED PROFESSIONAL

SIGNATURE SHEET

SHEET NUMBER

MANATEE COUNTY 10/14/2025 7:12:29 PM Default

K:\SAR\_Roadway\148400070\_9thAve\148400070\roadway\SIGNRD01.dgn

PROJECT

QUANTITY

1279

8.68

5.18

0.27

340

500.0

100.0

15

43

618

410

50

75

674

18

20

UNIT

LS

15

LF

EΑ

AC

AC

AC.

SY

FΑ

CY

CY

SY

LF

SY

SY

SY

LF

SY

EΑ

EΑ

LF

LF

ITEM NO.	ITEM DESCRIPTION	UNIT	PROJECT QUANTITY
Roadway			
101 1	MOBILIZATION	LS	1
102 2	MAINTENANCE OF TRAFFIC	LS	1
107 1	LITTER REMOVAL	AC	1.54
107 2	MOWING	AC	1.54
110 1 1	CLEARING & GRUBBING	AC	0.11
120 1	REGULAR EXCAVATION	CY	54.0
524 1 2	CONCRETE DITCH PAVEMENT, NON REINFORCED, 4"	SY	34
570 1 2	PERFORMANCE TURF, SOD	SY	520
Drainage			
430 174 248	PIPE CULVERT,OPTIONAL MATERIAL,OTHER-ELIP/ARCH, 48"SD	LF	84
430 984 641	MITERED END SECT, OPTIONAL/ELLIP/ARCH 48" SD	EA	1

### CIP 3: 87TH ST CT NW STORM SEWER REPLACEMENT

ITEM NO.	ITEM DESCRIPTION	UNIT	PROJECT	
112111111	11211 2233111 11311	0	QUANTITY	1
Roadway				
101 1	MOBILIZATION	LS	1	1
10/2	MAINMENANCE VOFA RAY FTO VVVVVVVVVVVVVVVVVVVVVVVVVVVVVVVVVVV	V LSV	$\sim\sim$	١.
104 10 3	SEDIMENT BARRIER	LF	1072	) A
10410	INSEP REDITECTION SYSTEM	NEA.		
107 1	LITTER REMOVAL	AC	11.48	
100/2	TRANTING VVVVVVVVVVVVVVVVVVVVVVVVVVVVVVVVVVVV	VASV	V 9.9A V	$\setminus$
( 110 1 1	CLEARING & GRUBBING	AC	0.32	) <sub>A</sub>
(110 4 10	REMOVAL OF EXISTING CONCRETE	SY	475	ʃ^
MAN	MANBON, ESK SNIGUE A A A A A A A A A A A A A A A A A A A	<u> </u>		ľ
120 1	REGULAR EXCAVATION	CY	125.0	
1286	ENBANKMINT	VCPV	V100.0	
160 4	TYPE B STABILIZATION	SY	1075	IL.
285 706	OPTIONAL BASE, BASE GROUP 06	SY	1075	$\left  \left\langle \right\rangle \right\rangle$
327 70 6	MILLING EXISTING ASPHALT PAVEMENT, 1 1/2" DEPTH	SY	540	1)
334 1 53	SUPERPAVE ASPHALTIC CONCRETE, TRAFFIC C, PG76-22	TN	88.7	1
33/2/83/	MORHALI CONCRETE PRICTION SOURSE, INSEPTS P. EC 12/5	NIM	\\\\\\\\\\\\\\\\\\\\\\\\\\\\\\\\\\\\\\	ĺ
5202	CONTROLET ECCURBINITY AV	VEF		١.
522 2	CONCRETE SIDEWALK AND DRIVEWAYS, 6" THICK	SY	475	]) 🕰
		<b>♦</b>		[
570 1 2	PERFORMANCE TURF, SOD	SY	458	1) 🛕
Drainage				ľ
425 2 41	MANHOLES, P-7, <10'	EΑ	7	
430 174 224	PIPE CULVERT, OPTIONAL MATERIAL, OTHER SHAPE-ELIP/ARCH, 24"SD	LF	269	1
430 175 124	PIPE CULVERT, OPTIONAL MATERIAL, ROUND, 24" S/CD	LF	698	1
430 524 112	STRAIGHT CONCRETE ENDWALLS, 24", SINGLE, 15 DEGREES, ELLIPTICAL	EA	1	1
430 830	PIPE FILLING AND PLUGGING - PLACE OUT OF SERVICE	CY	34.0	

PAY ITEM NOTES:

102-2: PAY ITEM INCLUDES THE COST OF ALL TEMPORARY STRIPING, SIGNAGE, PAVEMENT, AND SIGN RELOCATIONS.

110-1-1: PAY ITEM INCLUDES THE COST OF ALL EXISTING PIPES TO BE REMOVED OR CUT AND MODIFIED AND TREE AND STUMP REMOVAL TO 6" BELOW GRADE FOR THE ENTIRE PROJECT. TREES TO REMAIN UNLESS OTHERWISE NOTED IN THE PLANS.

120-4: PAY ITEM INCLUDES THE COST OF EXCAVATION OF IDENTIFIED ORGANIC SUBSOIL TO A DEPTH OF ONE FOOT ABOVE THE HIGHEST IDENTIFIED UTILITY WITHIN THE EXCAVATION LIMITS. THE CONTRACTOR SHALL BE RESPONSIBLE FOR IDENTIFYING THE LOCATION. DEPTH. AND ALIGNMENT OF ALL EXISTING UTILITIES WITHIN THE WORK AREA PRIOR TO THE START OF EXCAVATION. ANY DAMAGE TO EXISTING UTILITIES SHALL BE REPAIRED AT THE CONTRACTOR'S EXPENSE TO THE SATISFACTION OF THE OWNER.

430-542-300: PAY ITEM INCLUDES ALL COSTS ASSOCIATED WITH FURNISHING AND INSTALLING TYPE 45-DEGREE WINGWALLS AND U-TYPE WING STRUCTURES. REFER TO DRAINAGE DETAILS FOR CONFIGURATION AND DIMENSIONS.

Δ	UTILITY RELOCATION AND REVISION	10/14/2:	5 <i>SK</i>
_			
No.	REVISIONS	DATE	BY

## Kimley » Horn

© 2025 KIMLEY-HORN AND ASSOCIATES, INC 1800 SECOND STREET, SUITE 900, SARASOTA, FL 34236 PHONE: 941-379-7600 WWW.KIMLEY-HORN.COM

KHA PROJECT	
148400070	
DATE 10/14/2025	
SCALE AS SHOWN	
DESIGNED BY	
DRAWN BY	
CHECKED BY	MANATEE COUNTY

9TH AVENUE NW

IORDAN F IFFP. P.F. FLLICENSE NUMBER 76102 FL DATE:

LICENSED PROFESSIONAL

SUMMARY OF PAY ITEMS

SHEET NUMBER

K:\SAR Roadway\148400070 9thAve\148400070\roadway\CESSRD01.dgn

COUNTY.

REMOVED.

RECOMMENDATIONS.

ITEM NO.

MOBILIZATION

MAINTENANCE OF TRAFFIC

INLET PROTECTION SYSTEM

REMOVAL OF EXISTING CONCRETE

CONCRETE CURB & GUTTER, TYPE F

CONCRETE SIDEWALK AND DRIVEWAYS, 4" THICK

CONCRETE SIDEWALK AND DRIVEWAYS, 6" THICK

FENCING, SPECIALTYPE, 0.0-5.0', RESET EXISTING

PIPE CULVERT, OPTIONAL MATERIAL, ROUND, 18" S/CD

PAVERS, ARCHITECTURAL, REMOVE EXISTING AND REINSTALL (PAY ITEM REMOVED)

PIPE CULVERT, OPTIONAL MATERIAL, OTHER SHAPE-ELIP/ARCH, 15"SD

570-1-2: PAY ITEM INCLUDES PLACEMENT OF SOD MATCHING EXISTING TYPE AND SPECIES

700-3-501: PAY ITEM INCLUDES F&I OF SINGLE POST AND MOUNTING OF EXISTING SIGN PANEL.

590-70-1: PAY ITEM INCLUDES THE MODIFICATION AND/OR REPLACEMENT OF IRRIGATION SYSTEMS AFFECTED BY CONSTRUCTION. PROPERTIES WITH VISIBLE IRRIGATION SYSTEMS ARE NOTED ON THE PLANS. CONTRACTOR TO CHECK FOR PRESENCE OF IRRIGATION SYSTEMS WITHIN THE LIMITS OF CONSTRUCTION AT ALL PROPERTIES AND PROTECT AND RELOCATE CONFLICTING PORTIONS OF IRRIGATION SYSTEM AFFECTED UNDER THIS PAY ITEM. COST TO INCLUDE REPLACEMENT OF PARTS, LABOR, EQUIPMENT, AND MATERIALS AS REQUIRED TO REPAIR THE SYSTEM TO A COMPLETE AND FUNCTIONING STATE OF REPAIR. CONTRACTOR RESPONSIBLE FOR ANY COORDINATION WITH ADJACENT PROPERTY

715-7-11: SERVICE POINT INCLUDES ALL COSTS FOR FPL REIMBURSEMENT FOR NEW TRANSFORMER. CONTRACTOR IS

SOLDIER COURSE AND BRICK PAVERS WITHIN THE BRICK DRIVEWAY. THE CONTRACTOR SHALL CAREFULLY CLEAN ALL JOINTS TO A MINIMUM DEPTH AS SPECIFIED BY THE MANUFACTURER, ENSURING ALL DEBRIS AND VEGETATION ARE

THIS ITEM INCLUDES FURNISHING AND INSTALLING REPLACEMENT BRICK PAVERS AS SHOWN ON THE PLANS, AS WELL

AS INSTALLING THE SOLDIER COURSE IN ACCORDANCE WITH THE PROVIDED DETAILS, POLYMERIC SAND SHALL BE INCLUDED IN THE SOLDIER COURSE INSTALLATION, WITH PROPER COMPACTION FOLLOWING THE MANUFACTURER'S

WORK SHALL ALSO INCLUDE PROTECTION OF SURROUNDING SURFACES, DISPOSAL OF REMOVED MATERIALS, AND

OR ADJACENT FEATURES CAUSED DURING CONSTRUCTION SHALL BE REPAIRED AT NO ADDITIONAL COST TO THE

RESTORATION OF ANY DISTURBED AREAS TO PRE-CONSTRUCTION CONDITION. ANY DAMAGE TO SURROUNDING BRICKS

ALL QUANTITIES PROVIDED HEREIN ARE FOR ENGINEERS ESTIMATING PURPOSES ONLY, CONTRACTOR IS RESPONSIBLE

PAY ITEM INCLUDES ALL LABOR, EQUIPMENT, AND MATERIALS REQUIRED FOR THE REMOVAL OF THE EXISTING

SEDIMENT BARRIER

CLEARING & GRUBBING

MAILBOX, F&I SINGLE

REGULAR EXCAVATION

TYPE B STABILIZATION

PERFORMANCE TURF, SOD

MANHOLES, P-7, <10'

INLETS, DT BOT, TYPE C,<10

OF SOD PRESENT ADJACENT TO THE WORK AREA.

RESPONSIBLE TO COORDINATE WITH FPL TO CONFIRM COSTS.

FOR ALL QUANTITY CALCULATIONS NECESSARY FOR BIDDING.

0526 2 1 DRIVEWAY BRICK REPLACEMENT

EMBANKMENT

LITTER REMOVAL

MOWING

Roadway

101 1

102 2

104 10 3

104 18

107 1

107 2

110 1 1

110 4 10

110 7 1

120 1

120 6

160 4

522 1

522 2

520 1 10

526 1101

570 1 2

Drainage

425 1521

425 2 41

430 174 215

430 175 118

OWNERS AFFECTED.

550 10 918

CIP 5: 71ST ST NW TO 83RD ST NW

ITEM DESCRIPTION

10/14/2025 7:28:01 PM Default

### CIP UTILITIES: POTABLE, RECLAIMED, SEWER

ITEM NO.	ITEM DESCRIPTION	UNIT	PROJECT QUANTITY	
. WATER IMPRO	DVEMENTS			
1	MOBILIZATION AND MOT (WATER)	LS	1	
2	UTILITY RECORD DRAWINGS (WATER)	LS	1	
3	WATER VALVE TO BE ADJUSTED TO GRADE	EA	22	
4	8" DI CLASS 350 PIPE WATER MAIN (OPEN CUT)	LF	179	7
5	8" DI FITTING - 45 DEGREE BEND MJ (WATER)	EA	12	
6	CUT AND CONNECT TO EXISTING WATER MAIN (INCLUDES TEMP. SHUTDOWN)	EA	6	7
<b>√</b> √√	RENOVE, EXUSTANCE SYNHAPER, MANY	VEF	176	
8	WATER SERVICE ASSEMBLY	EA	1	) 🛆
	PALBARE LIKASAK LAKLIPAS SEBUBIL ANDATERA AMAMATAN	NEAN		/
10	WATER METER TO BE ADJUSTED TO GRADE	EA	2	
11	8" X 2" TAPPING SLEEVE WITH 2" VALVE (WATER)	AS	1	
12	FIRE HYDRANT ASSEMBLY (RELOCATION)	EA	2	_
13	FIRE HYDRANT ASSEMBLY TO BE ADJUSTED TO PROP. GRADE	EA	1	
VT4VV	WETER WATER V	VEAV		
15	8" GATE VALVE (WATER)	EA	2	$\int \nabla$
16	6" GATE VALVE (WATER)	EA	3	) "
	PREMOVE GATE PALVE ANATERY	TEA		/
V18VV	BACKFLOH ASSEMBLY VVVVVVVVVVVVVVVVVVVVVVVVVVVVVVVVVVVV	FA		
48	6" DI CLASS 350 PIPE WATER MAIN (OPEN CUT)	LF	215	)
49	6" C900 DR-18 PVC WATER MAIN (OPEN CUT)	LF	366	5 4
50	4" DI CLASS 350 PIPE WATER MAIN (OPEN CUT)	LF	126	₹ .
51	MOBILIZATION AND MOT (WASTEWATER)	LF	45	)
52	MOBILIZATION AND MOT (WASTEWATER)	LF	59	)
53	GROUT FILL & ABANDON EXISTING PIPELINES	CY	5.0	1
54	6" DI FITTING - 45 DEGREE BEND MJ (WATER)	EA	6	< −
55	4" PVC FITTING - 22.5 DEGREE BEND MJ (WATER)	EA	2	) ,
56	2" GATE VALVE (WATER)	EA	1	) 🕰
57	8" X 6" TEE FITTING	EA	1	$\leq$
58	6" X 6" TEE FITTING	EA	1	\
59	6" X 4" DI REDUCER	EA	1	)
60	6" DI CAPS (WATER)	EA	2	)
	4" DI CAP WITH 2" THREADED COUPLING		1	$\leq$
61 62	2" BLOW OFF ASSEMBLY (WATER)	EA EA	1	<
63	SINGLE WATER SERVICE WITH RPZ	EA	6	)
64			3	)
	DOUBLE WATER SERVICE WITH RPZ	EA		$\leq$
65 1 AN ASTEMATA	6" FIRE HYDRANT ASSEMBLY RANDAOVEMENTS	EA		/
19	MOBILIZATION AND MOT (WASTEWATER)	LS	1	
20	UTILITY RECORD DRAWINGS (WASTEWATER)	LS	1	
21	SANITARY VALVE TO BE ADJUSTED TO GRADE	EA	1	
<u> </u>	SANTARY MYTY BEVADUSTED YOURADE	VEAV		) A
23	6" C900 DR-18 PVC FORCE MAIN (OPEN CUT)	LF	53	} \land
<u> </u>	6" CROODERAS AV CROBKE MALININAZ" AV COCARNICODEN AUTIO	NEN	256	
25	6" DI FITTING - 45 DEG. BEND MJ (WASTEWATER)	EA	8	
<u> </u>	CUTVAND COMPECT OF EXISMING/FORCE MAIN (INCLODES/BYPASSING)	VEAV	4	) ^
27	6" SANITARY SEWER VERTICAL ADJUSTMENT	EA	8	JΔ
				` ^
29	REMOVE EXISTING 6" FORCE MAIN	LF	302	) 🛆
	SAMTAAN SERVICE ASSEMBLY VIII VIII VIII VIII VIII VIII VIII VI	LEAN.		
31	6" X 2" TAPPING SLEEVE WITH 2" VALVE (WASTEWATER)	AS	1	

	ITEM NO.	ITEM DESCRIPTION	UNIT	PROJECT QUANTITY
	III. RECLAIMED	II. RECLAIMED WATER IMPROVEMENTS		
	32	MOBILIZATION AND MOT (RECLAIM)	LS	1
	33	UTILTITY RECORD DRAWINGS (RECLAIM)	LS	1
,	<del>34</del>	WEDVATIN VANVE VO BYE AND INSTEND TO GRADEN VVVVVVVVVVVVVVVVVVVVVVVVVVVVVVVVVVVV	VEAV	V8V
$\Psi($	35	12" DI CLASS 350 PIPE RECLAIM MAIN (OPEN CUT)	LF	238
`			<b>₩</b>	
$\Lambda$	37	12" DI FITTING - 45 DEG. BEND MJ (RECLAIM)	EA	15
	₩.V.	8^D1/F17/NHC 45-DEG.BEHD-HI/HECLA/NH/	<u>LA</u>	
7	39	12" GATE VALVE (RECLAIM)	EA	3
	40	8" GATE VALVE (RECLAIM)	EA	1
	41	REMOVE GATE VALVE (RECLAIM)	EA	4
/	<del>\</del> \ \ \ \ \ \ \ \ \ \ \ \ \ \ \ \ \ \	CUVANY COMPECT YO EXISMINOREVARY WATER MAYN YMCLYDES TYMPY SPOTDOWNY	VEAV	V8V
$\nabla$ (	43	REMOVE EXISTING 12" RECLAIM WATER MAIN	LF	205
`	<u> </u>	TREMONIENE EXASTING SY BENCLANUMITER MALIN VIOLONO	NEN	
	45	RECLAIM SERVICE ASSEMBLY	EA	1
\	46	AIR RELEASE VALVE ASSEMBLY (RECLAIM)	EA	2
_ /	47	M2V2VTAPPTING SNEEDE WITHV2" WALDVE (RECOMM) VVVVVVVVVVVVVVVVVVVVVVVVVVVVVVVVVVV	VASV	$\sim\sim$
(	66	6" C900 DR-18 PVC RECLAIM MAIN (OPEN CUT)	LF	4
	67	4" DI CLASS 350 PIPE RECLAIM MAIN (OPEN CUT)	LF	34
>	68	1" RECLAIM ADJUSTMENT	EA	2
$\Delta$	69	6" GATE VALVE (RECLAIM)	EΑ	1
(	70	4" GATE VALVE (RECLAIM)	EA	1
	71	12" X 6" TEE FITTING	EA	1
>	72	12" X 4" TEE FITTING	EA	1
7	73	6" DI CAP (RECLAIM)	EA	1
7	(	6" DI CAP (RECLAIM)	EA	

	UTILITY RELOCATION AND REVISION	10/14/23	5 S K	
No.	REVISIONS	DATE	BY	
Seth.	Kline	•		

**Kimley Morn** 

© 2025 KIMLEY-HORN AND ASSOCIATES, INC. 1800 SECOND STREET, SUITE 900, SARASOTA, FL 34236 PHONE: 941-379-7600 WWW.KIMLEY-HORN.COM

KHA PROJECT 148400070	
DATE 10/14/2025	
SCALE AS SHOWN	
DESIGNED BY	
DRAWN BY	

3	Manatee County	-
9TH	AVENUE	NN

JORDAN E. LEEP, P.E. FLLICENSE NUMBER 76102

LICENSED PROFESSIONAL

SUMMARY OF PAY ITEMS

SHEET NUMBER

5

CHECKED BY MANATEE COUNTY
10/14/2025 7:39:22 PM Default

### PHASE I

- PLACE ADVANCE WARNING TRAFFIC CONTROL SIGNS AND DEVICES AS SHOWN IN THE TTCP GENERAL NOTES/DETAILS SHEET
- PLACE WORK ZONE SIGNS AND CHANNELIZING DEVICES, UTILIZING INDICES 102-600, 102-602, 102-603, AND 102-604 AS REQUIRED. SET UP DETOUR PLAN PER PHASE IA DETOUR PLAN SHEET.
- CONSTRUCT OUTFALL CANAL ADJACENT TO THE CROSS DRAIN AT APPROXIMATE STA. 36+80. CONSTRUCT CULVERT AT HAWTHORN PARK OUTFALL
- CONSTRUCT WATER MAIN AND RECLAIM MAIN RELOCATIONS AT CULVERT IN CONJUNCTION WITH CULVERT CONSTRUCTION
- CONSTRUCT ALL CURBLINES, WIDENING AND RECONSTRUCTION, DRAINAGE, EARTHWORK, SODDING, AND SIDEWALKS FROM APPROXIMATE STA. 34+00 TO STA. 39+10.
- SEE 92ND TEMPORARY TRAFFIC CONTROL PHASING PLAN SHEETS, PHASING NOTES, AND DETOUR PLAN TO CONSTRUCT THE WORK AT 92ND STREET NW AND 9TH AVENUE NW. MAKE CONNECTION TO MULTI-USE-TRAIL ON THE NORTH SIDE AND CONNECTION TO PIPE AT STRUCTURE

### PHASE IIA

- PLACE ADVANCE WARNING TRAFFIC CONTROL SIGNS AND DEVICES AS SHOWN IN THE TTCP GENERAL NOTES / DETAILS SHEET.
- PLACE WORK ZONE SIGNS AND CHANNELIZING DEVICES, UTILIZING INDICES 102-600, 102-602, 102-603 AND 102-604 AS REQUIRED.
- EAST OF APPROXIMATE STA. 43+75, CONSTRUCT WIDENING TO THE SOUTH UP TO THE FINAL LIFT, SIDEWALKS, CURBLINES, SODDING, AND EARTHWORK UP TO APPROXIMATE STA. 53+13.
- MAINTAIN LOCAL ACCESS DOWN 88TH STREET NW SOUTH OF 9TH AVENUE NW AT ALL TIMES USING A FLAGGER AS NECESSARY CONSTRUCT OUTFALL STRUCTURE AND DRAINAGE TRUNKLINE UP TO, BUT NOT INCLUDING, STRUCTURE S-800.
- SEE 87TH TEMPORARY TRAFFIC CONTROL PHASING PLAN SHEETS, PHASING NOTES, AND DETOUR PLAN TO CONSTRUCT THE WORK AT 87TH STREET NW AND 9TH AVENUE NW. MAKE CONNECTION TO MULTI-USE-TRAIL ON THE NORTH SIDE.

### PHASE IIB

- PLACE ADVANCE WARNING TRAFFIC CONTROL SIGNS AND DEVICES AS SHOWN IN THE TTCP GENERAL NOTES / DETAILS SHEET.
- 2. PLACE WORK ZONE SIGNS AND CHANNELIZING DEVICES, UTILIZING INDICES 102-600, 102-602, 102-603, AND 102-604 AS REQUIRED.
- EAST OF APPROXIMATE STA. 57+10, CONSTRUCT WIDENING TO THE SOUTH UP TO THE FINAL LIFT, SIDEWALKS, CURBLINES, SODDING, AND EARTHWORK ENDING WORK AT APPROXIMATE STA. 71+70.

### PHASE III

- PLACE ADVANCE WARNING TRAFFIC CONTROL SIGNS AND DEVICES AS SHOWN IN THE TTCP GENERAL NOTES / DETAILS SHEET.
- PLACE WORK ZONE SIGNS AND CHANNELIZING DEVICES, UTILIZING INDICES 102-600, 102-602, 102-603, AND 102-604 AS REQUIRED. USE SINGLE LANE CLOSURES AND FLAGGER TO CARRY-OUT MILLING OPERATIONS ALONG THE ENTIRE PROJECT LIMITS.
- EAST OF APPROXIMATE STA. 75+00, CONSTRUCT SODDING AND EARTHWORK UP TO APPROXIMATE STA. 83+15. SEE 9TH AVENUE NW: 78TH STREET NW TO 75TH STREET NW PROJECT FOR MORE INFORMATION ON TIE-IN INFORMATION.
- CONSTRUCT SIDEWALK AND DRAINAGE WORK EAST OF 75TH STREET NW UP TO 71ST STREET NW. ENSURE DRIVEWAY ACCESS TO ALL RESIDENTIAL PROPERTIES AT ALL TIMES.
- CONSTRUCT MILLING OPERATIONS ALONG ENTIRE PROJECTS LIMITS USING INDEX 102-603. PLACE FINAL LIFT OF ASPHALT AND FINAL SURFACE PAVEMENT MARKINGS ALONG THE ENTIRE PROJECT LIMITS.
- PLACE FINAL LIFT OF ASPHALT AND FINAL SURFACE PAVEMENT MARKINGS ALONG THE ENTIRE PROJECT LIMITS.

### PHASING NOTES - 87TH STREET COURT NW

- PLACE ADVANCE WARNING TRAFFIC CONTROL SIGNS AND DEVICES AS SHOWN IN THE TTCP GENERAL NOTES / DETAILS SHEET.
- PLACE WORK ZONE SIGNS AND CHANNELIZING DEVICES, UTILIZING INDICES 102-600, 102-602, 102-603 AND 102-604 AS REQUIRED.
- CONSTRUCT STRUCTURES S-805, S-806, AND S-807 AND THEIR ASSOCIATED PIPES. MAKE CONNECTION FROM STRUCTURE S-804 TO S-805. CONSTRUCT STRUCTURE S-804 AND APPROXIMATELY 11 LF OF PIPE. COVER WITH STEEL PLATES OVERNIGHT AND MAINTAIN ACCESS TO ALL RESIDENTIAL PROPERTIES. COORDINATE WITH PROPERTY OWNERS PRIOR TO WORK AND MAINTAIN ACCESS
- CONSTRUCT STRUCTURES S-800, S-801, S-802, AND S-803 AND THEIR ASSOCIATED PIPES.
- RECONSTRUCT THE NORTHBOUND LANE OF 87TH STREET COURT NORTHWEST FROM APPROXIMATELY STA. 10+42 16+70 UP TO THE FINAL LIFT. COMPLETE SODDING OF RESIDENTIAL YARDS AND COORDINATE WITH PROPERTY OWNERS TO RECONSTRUCT DRIVEWAYS AS SHOWN IN THE PLANS. ENSURE DRIVEWAY ACCESS TO ALL RESIDENTIAL PROPERTIES AT ALL TIMES. CONTRACTOR TO COVER ANY DROPOFF CONDITIONS IN ACCORDANCE WITH INDEX 102-600 AND MAINTAIN TWO 10-FT LANES IN ALL DIRECTIONS AT THE END OF
- RECONSTRUCT AND MILL THE SOUTHBOUND LANE OF 87TH STREET AND CONSTRUCT 6" WATER MAIN WHERE SHOWN IN THE PLANS. COMPLETE SODDING OF RESIDENTIAL YARDS AND COORDINATE WITH PROPERTY OWNERS TO RECONSTRUCT DRIVEWAYS AS SHOWN IN THE PLANS. ENSURE DRIVEWAY ACCESS TO ALL RESIDENTIAL PROPERTIES AT ALL TIMES. CONTRACTOR TO COVER ANY DROPOFF CONDITIONS IN ACCORDANCE WITH INDEX 102-600 AND MAINTAIN TWO 10-FT LANES IN ALL DIRECTIONS AT THE END OF EACH WORK
  - PLACE FINAL LIFT OF ASPHALT PAVEMENT.

9TH AVENUE NW

IORDAN F LEEP. P.E FLLICENSE NUMBER 76102 FL DATE:

LICENSED PROFESSIONA

PROP. WATER MAIN-

TTCPPHASING NOTES

RIGHT-OF-WAY VARIES 67' TO 115

WORK ZONE FULL ROAD CLOSURI

STA. 34+00 TO 39+10

PHASE I

RIGHT-OF-WAY

VARIES 55' TO 72

STA. 43+75 TO 53+13

PHASE IIA

STA. 57+10 TO 71+70

PHASE IIB

EXIST. DRAINAGE

RIGHT-OF-WAY VARIES 67' TO 75

WORK ZONE

& UTILITY ESMI

WORK ZONE

87TH ST CT NW

STA. 10+42.00 - STA. 17+59.50

WORK ZONE

SHEET NUMBER 98

$\triangle$	UTILITY RELOCATION AND REVISION	10/14/25	5SK
No.	REVISIONS	DATE	BY

Seth.Kline

Kimley » Horn

© 2025 KIMLEY-HORN AND ASSOCIATES, INC. 1800 SECOND STREET, SUITE 900, SARASOTA, FL 34236 PHONE: 941-379-7600 WWW.KIMLEY-HORN.COM

MANATEE COUNTY 10/14/2025 8:04:01 PM Default

148400070 10/14/2025


SCALE AS SHOWI


DRAWN BY


HECKED BY


K:\SAR\_Roadway\148400070\_9thAve\148400070\roadway\TCGNRD01.dgr


- PROP. DRAINAGE

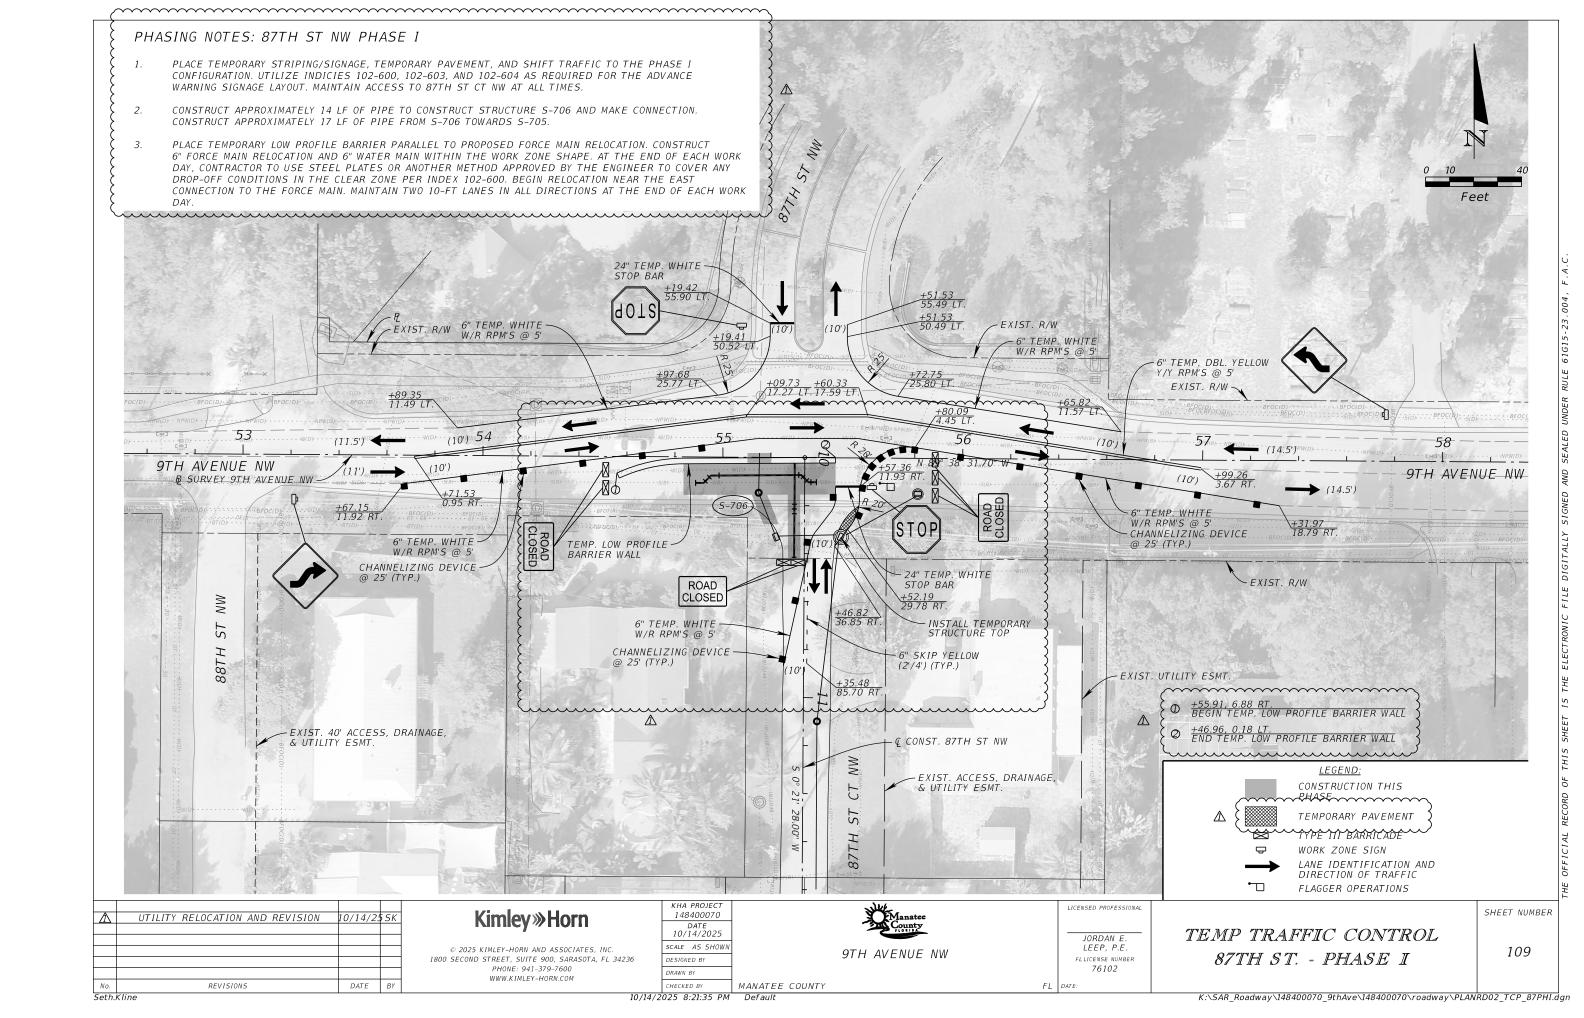


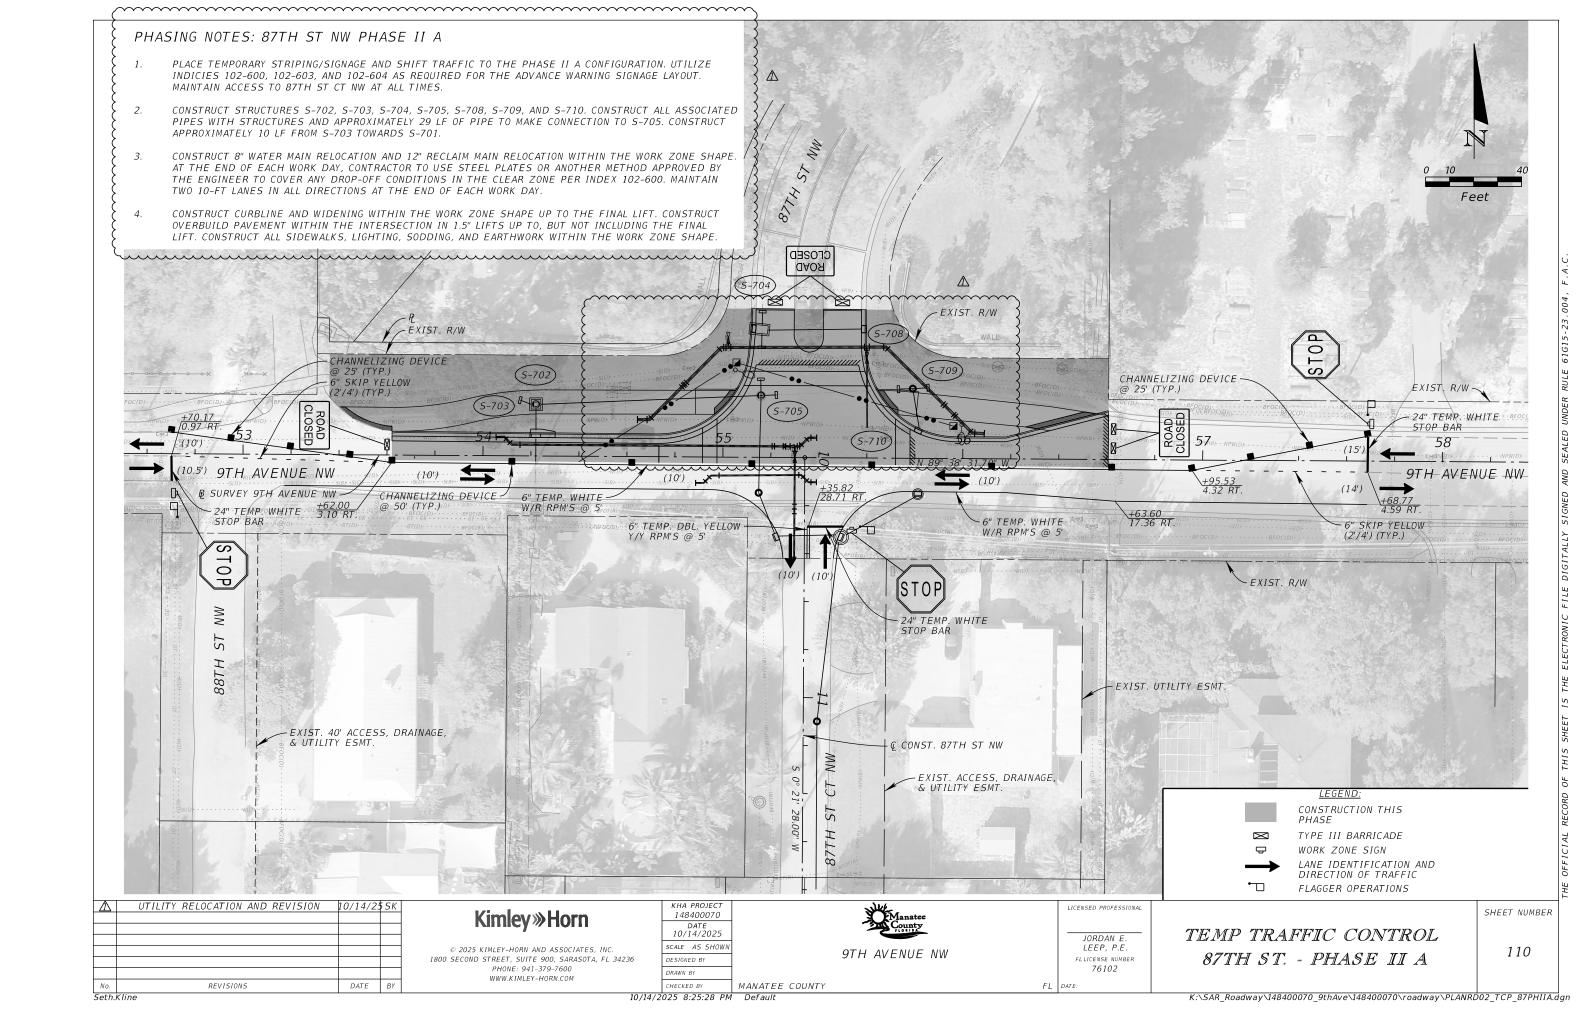


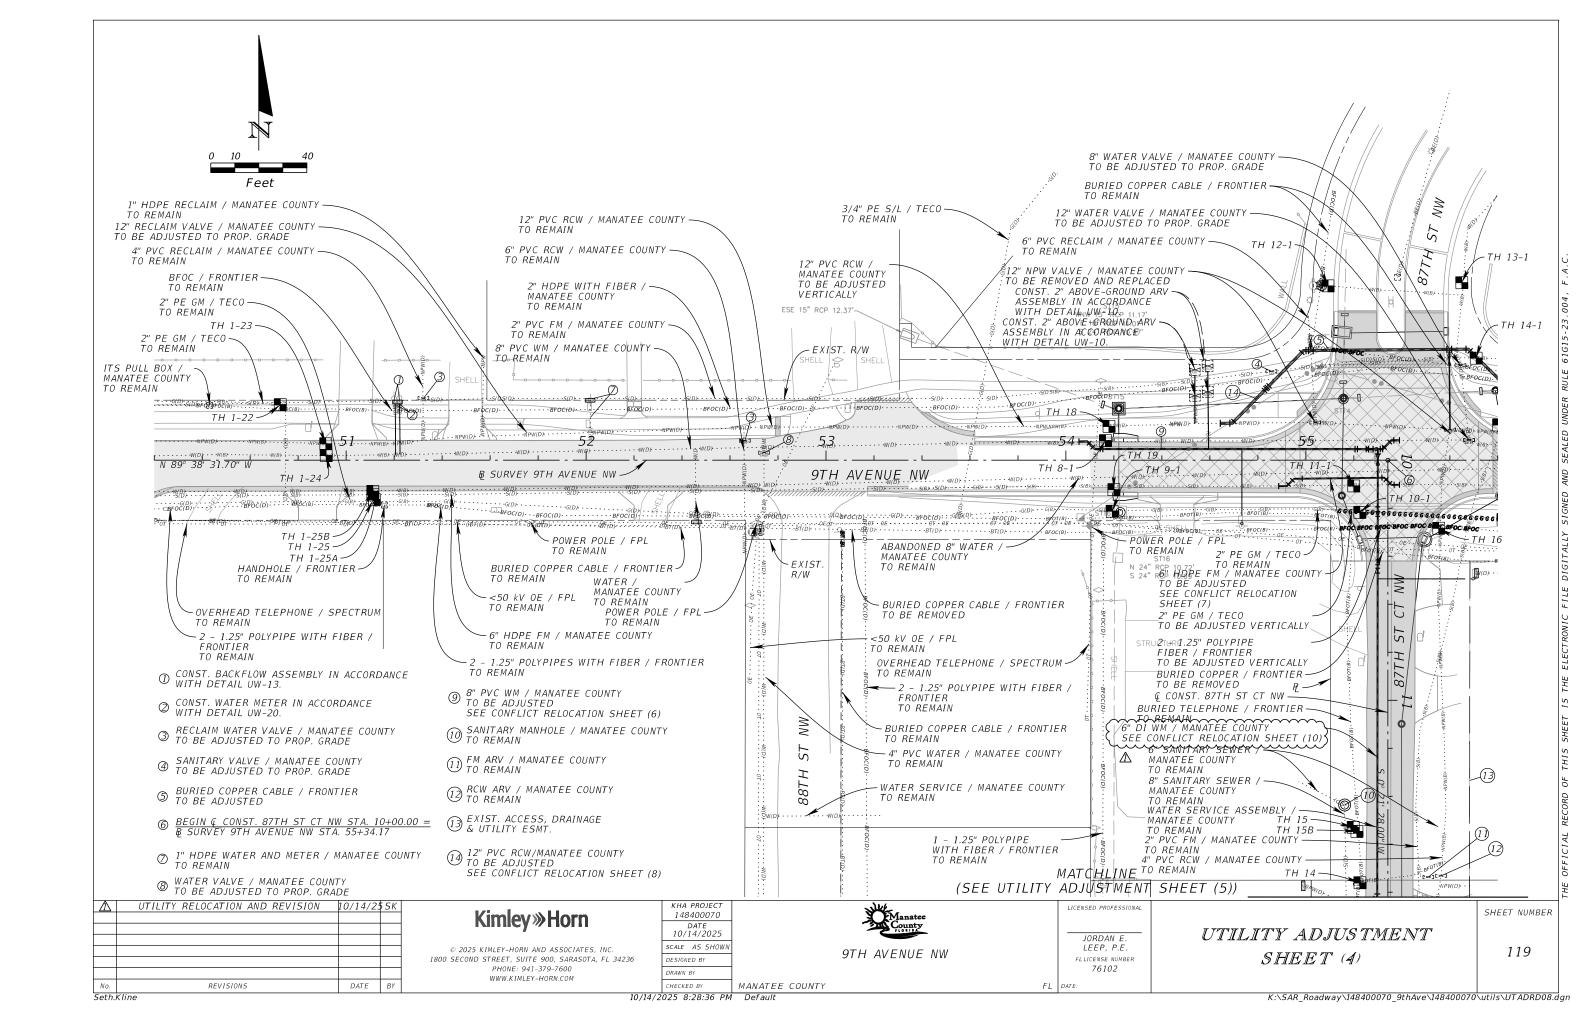


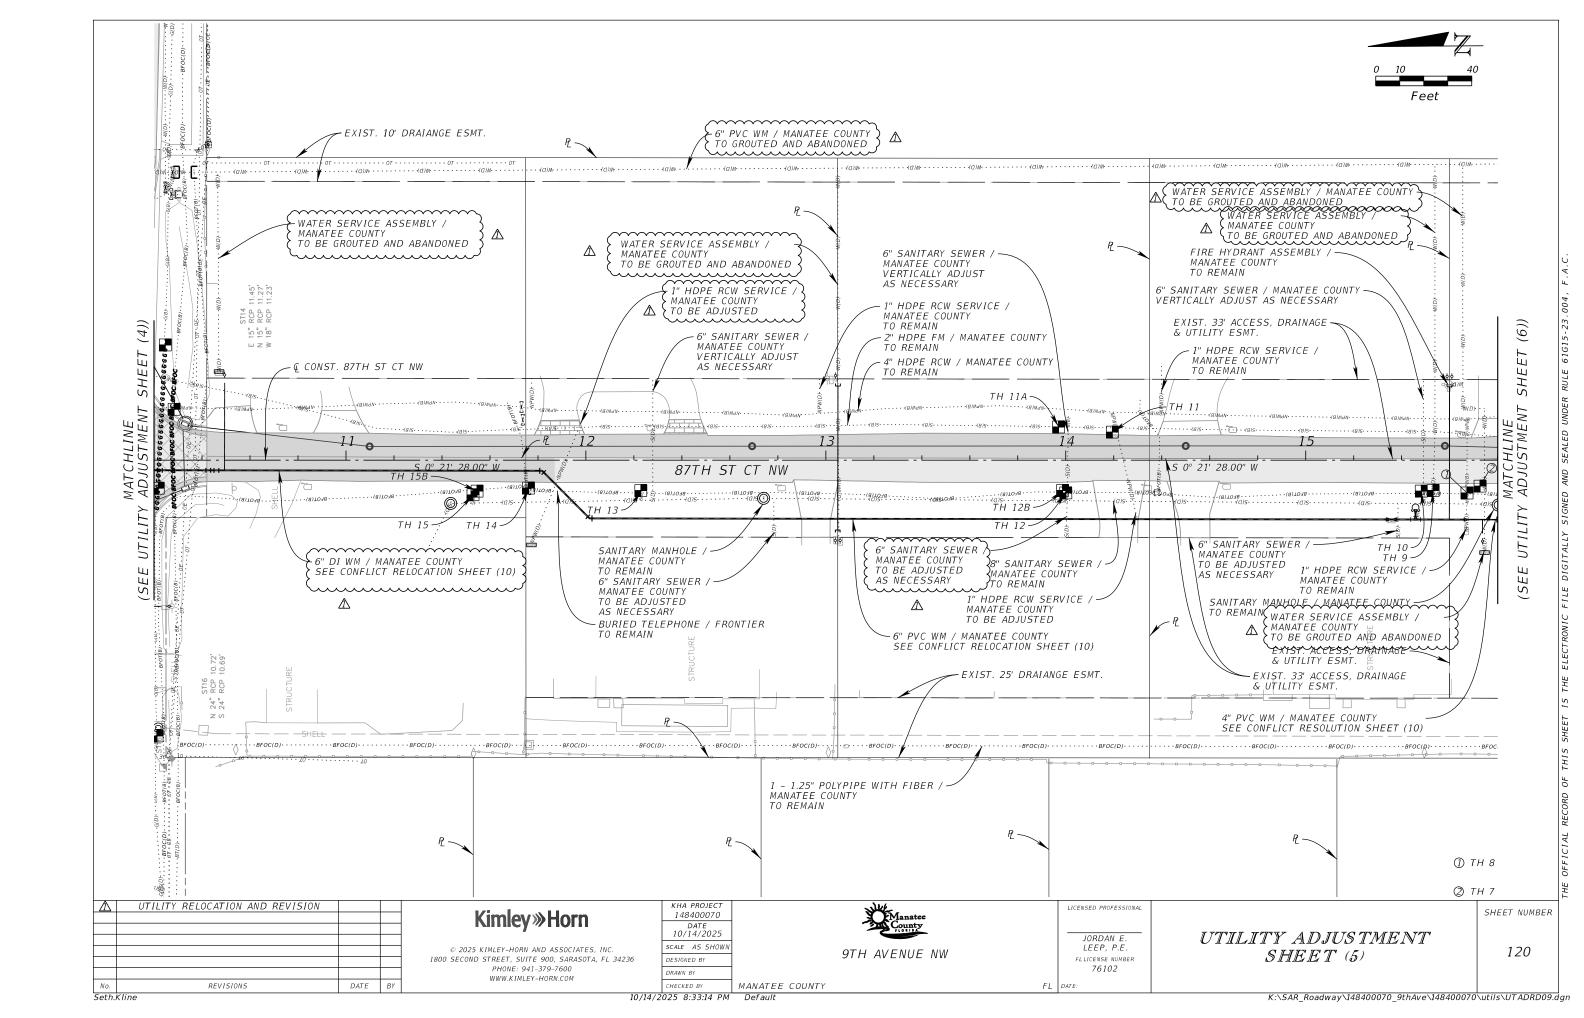

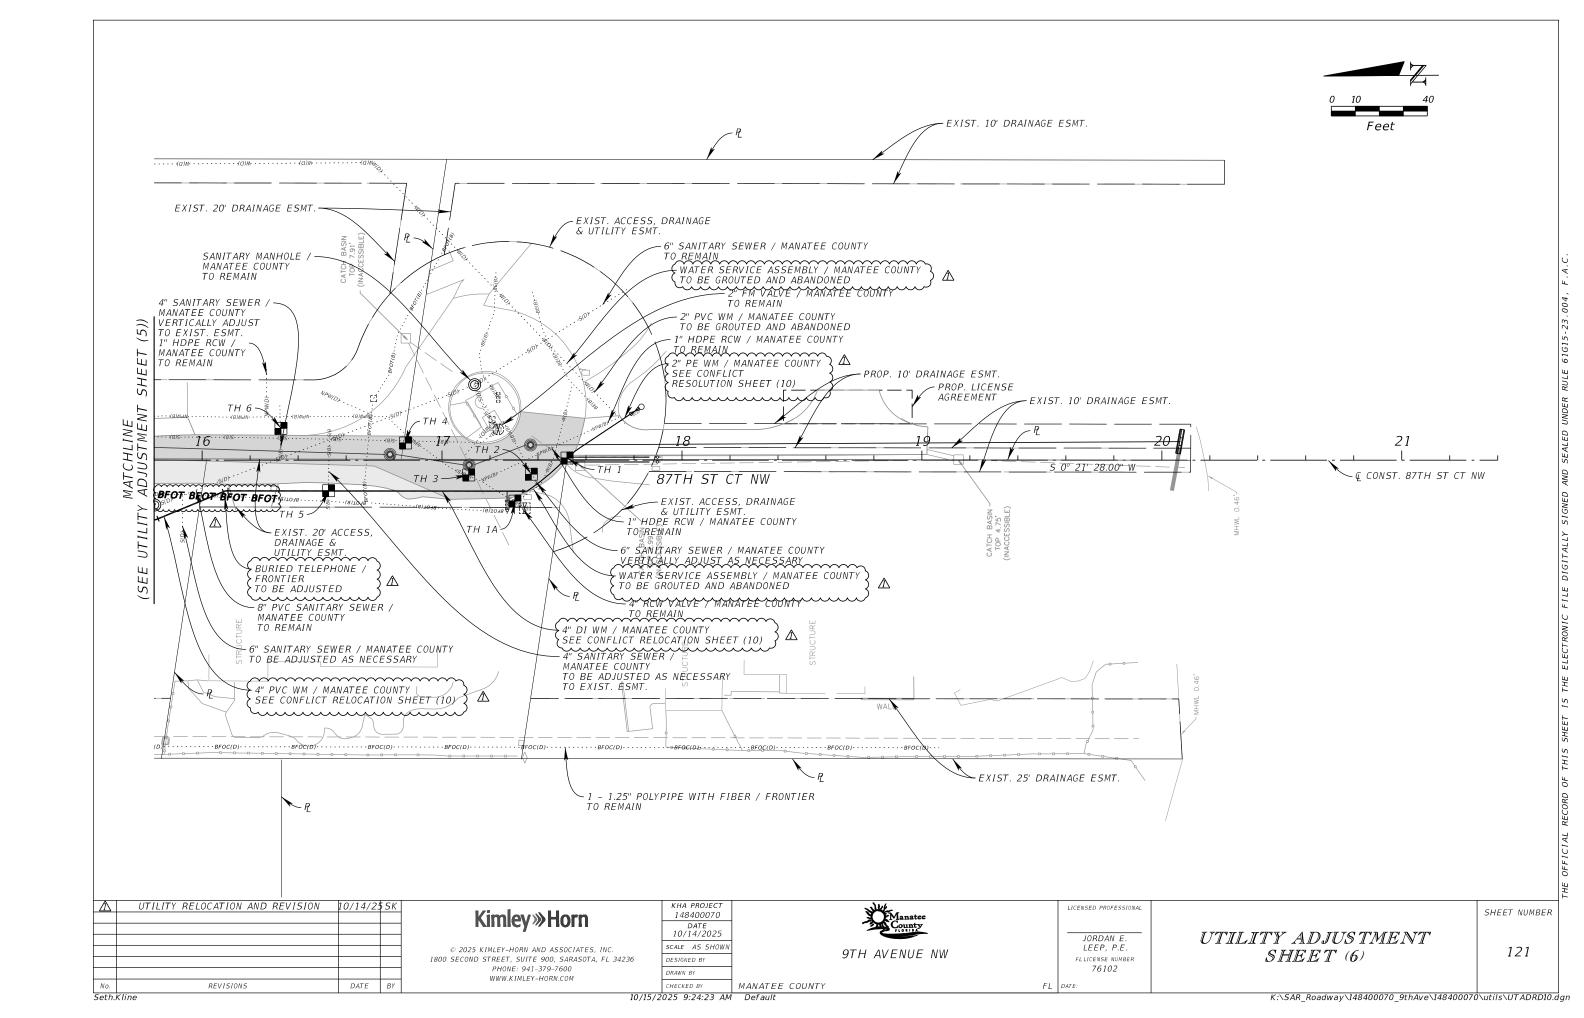


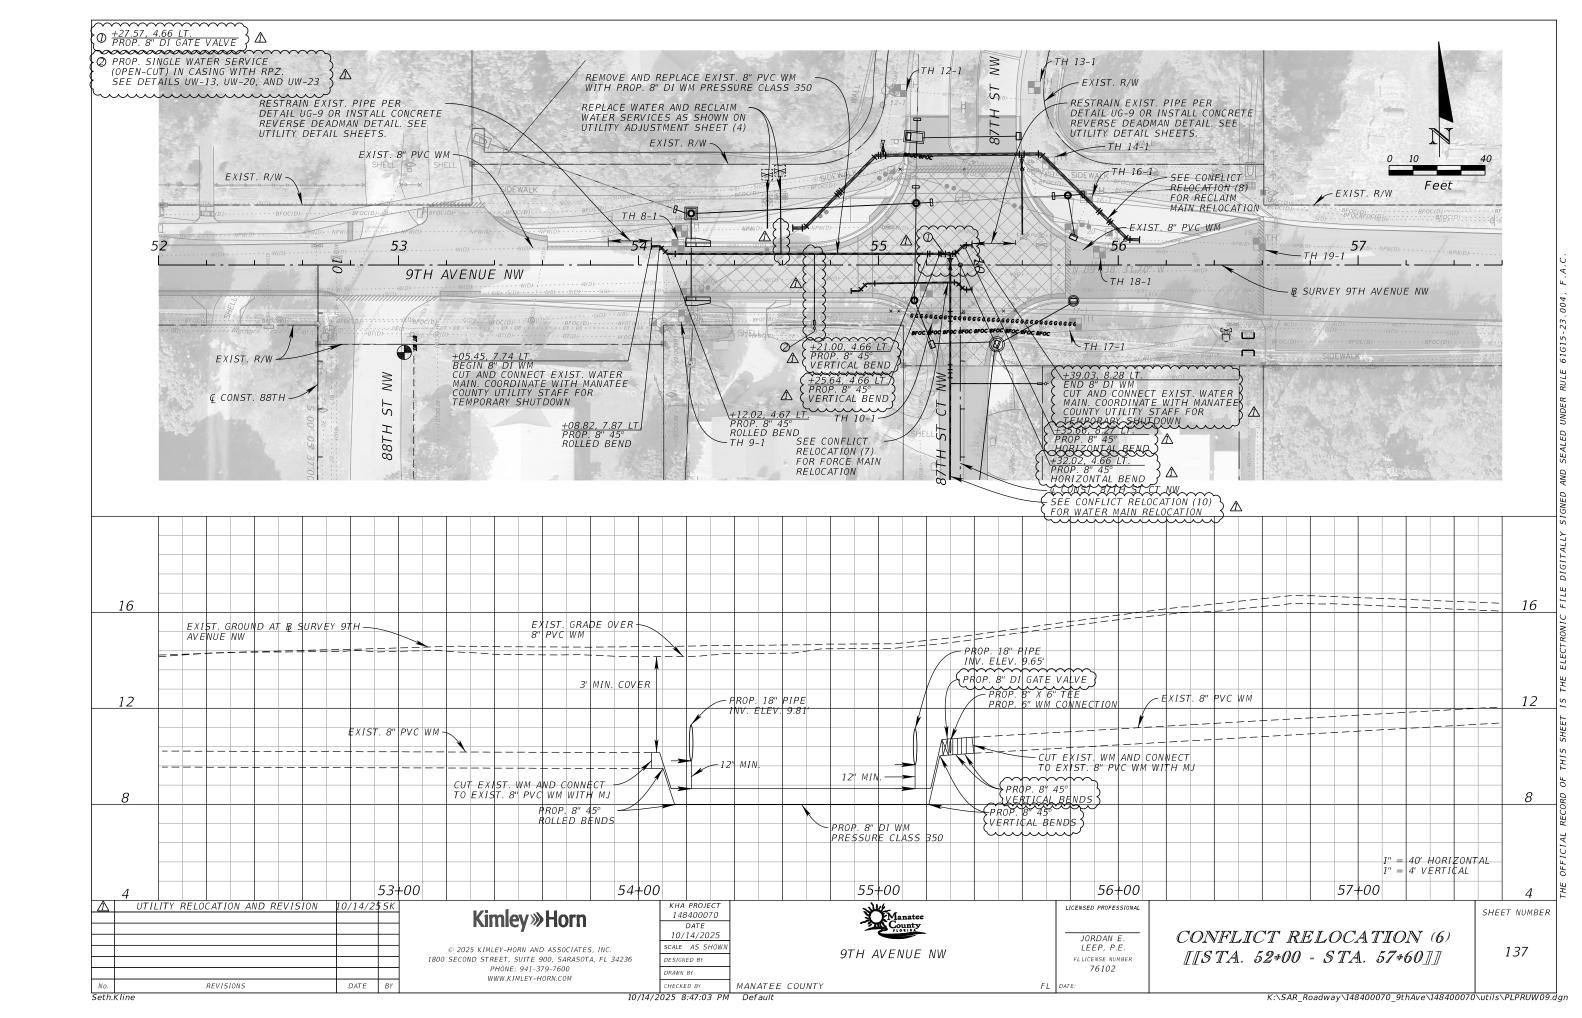


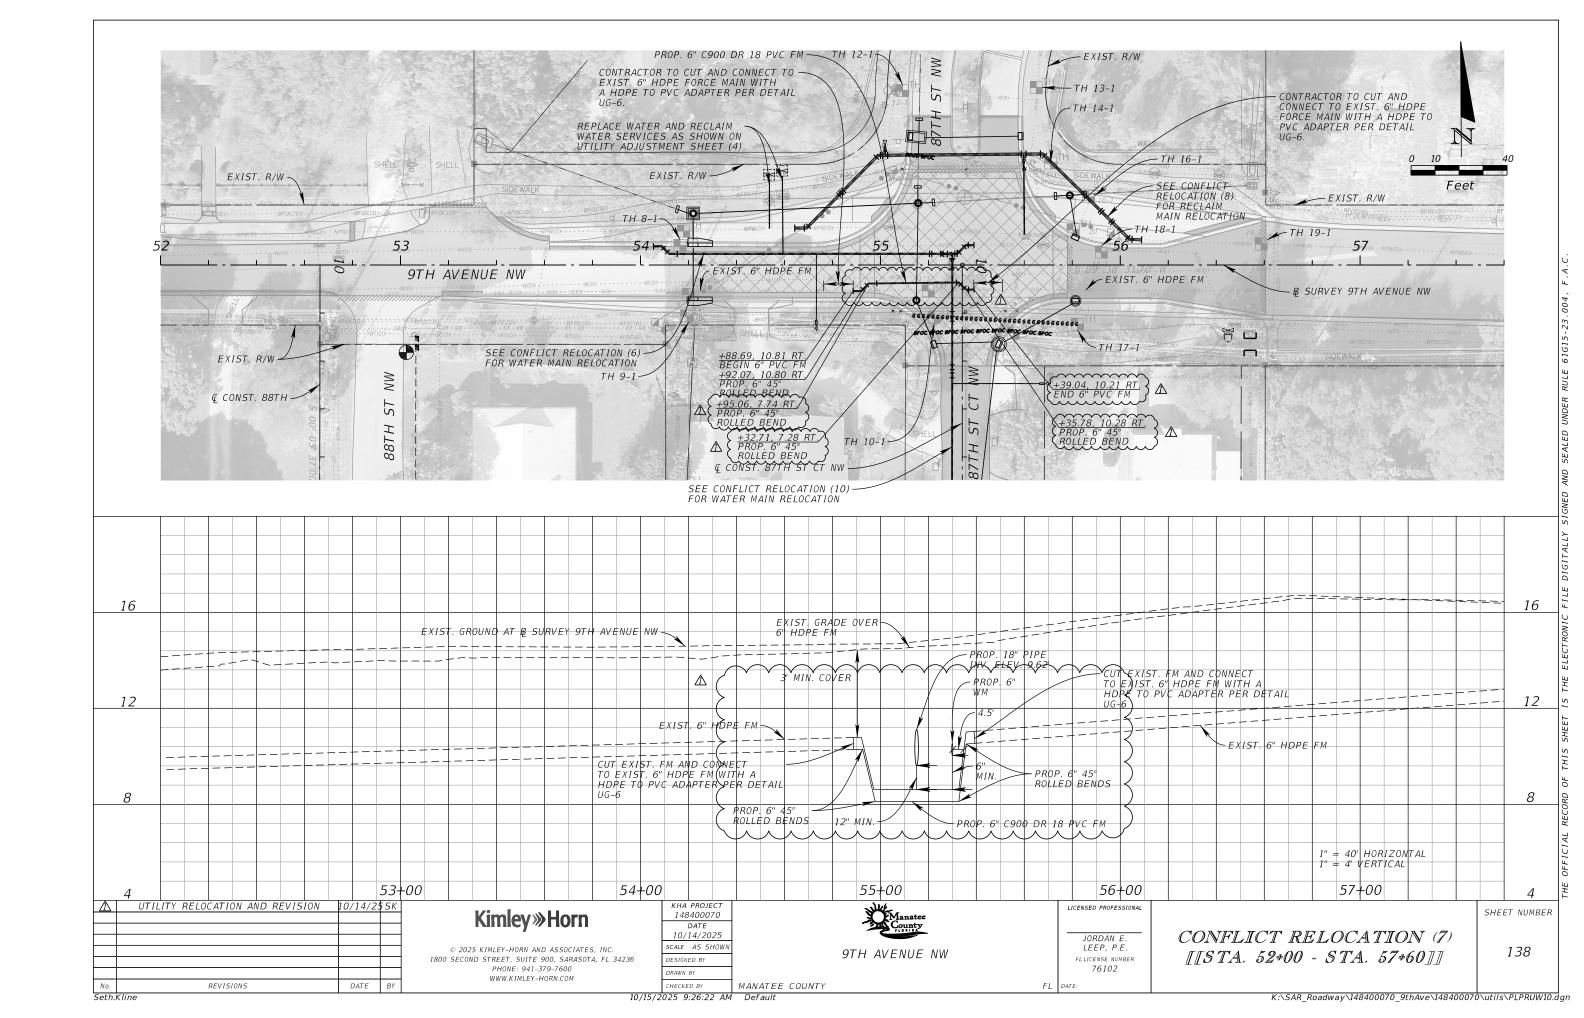


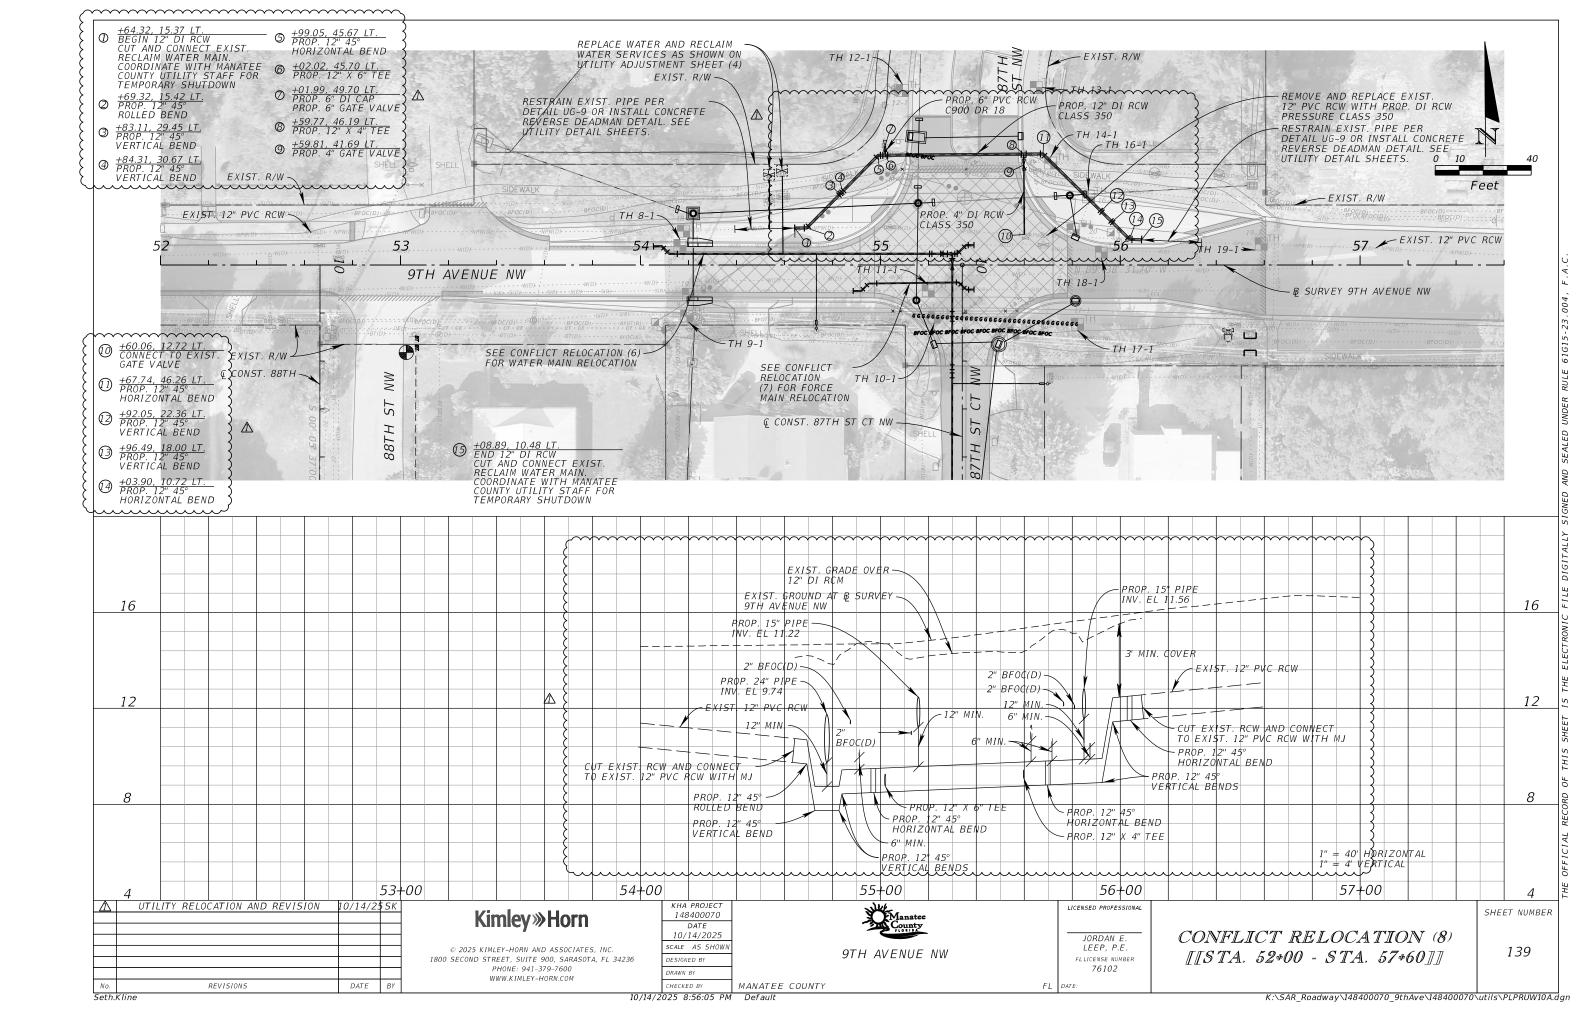



^^^^^

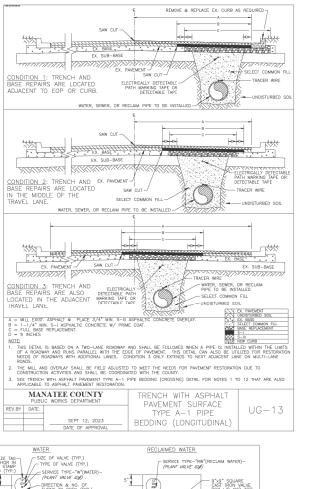


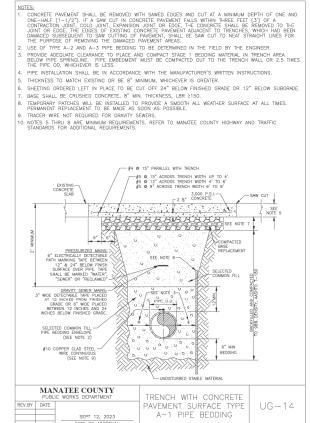


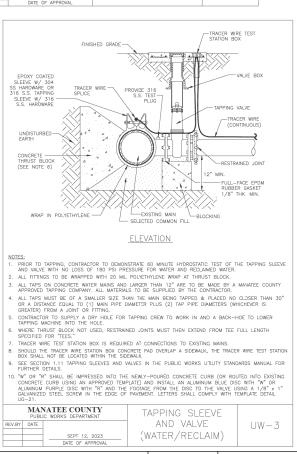


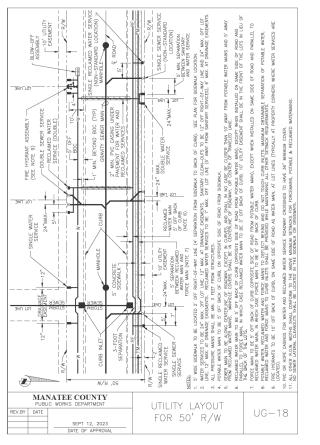

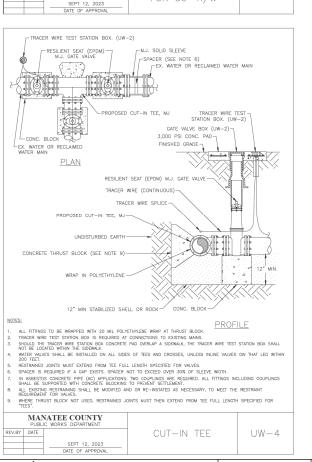

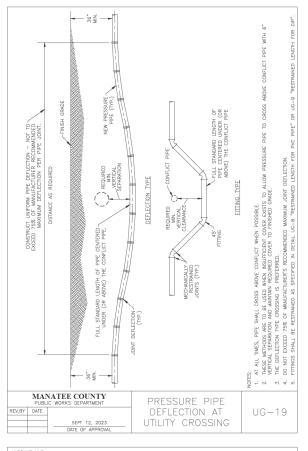

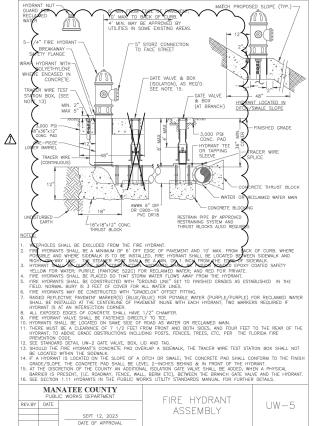

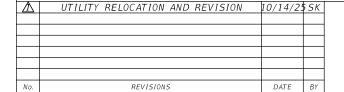

GATE VALVE, BOX,

LID AND TAG

UW-2

RESILIENT SEAT (EPDM) M.J. GATE VALVE

**Kimley** »Horn

© 2025 KIMLEY-HORN AND ASSOCIATES, INC. 1800 SECOND STREET, SUITE 900, SARASOTA, FL 34236 PHONE: 941-379-7600 WWW.KIMLEY-HORN.COM

	_
KHA PROJECT	
148400070	
DATE	
10/14/2025	
SCALE AS SHOWN	
DESIGNED BY	
DRAWN BY	

CHECKED BY

9TH AVENUE NW

IORDAN F FLLICENSE NUMBER 76102

LICENSED PROFESSIONAL


UTILITY DETAIL SHEET (2)

SHEET NUMBER

144

MANATEE COUNTY 10/14/2025 9:11:20 PM Default

K:\SAR\_Roadway\148400070\_9thAve\148400070\utils\UTDTUW02.dgn

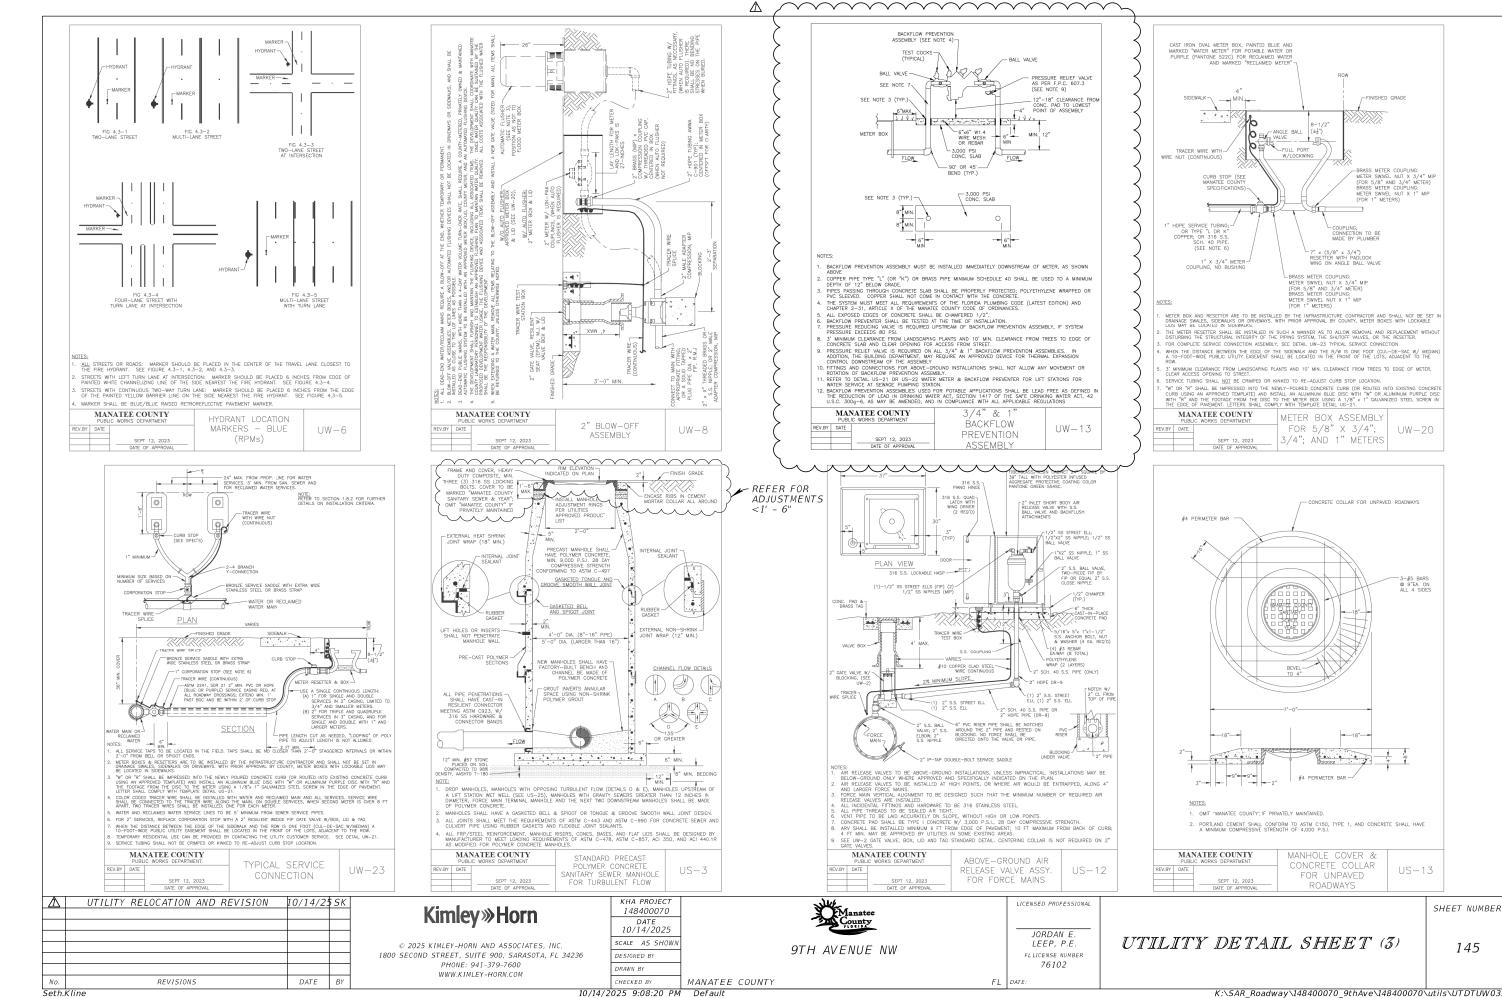

K:\SAR\_Roadway\148400070\_9thAve\148400070\utils\UTDTUW03.dgn

Α	
$\Delta$	

Date:		4/03 -4/	/15/2025				Test Hol	e Data Repo	ort			Crew Members	:		DO,BM,NM,NK
ECHO Pro	ject #:	21-	·137	48	303 George Road			- O - I	10	ECHO U	ES, Inc.	City, State:			Bradenton, FL
Financial I	-	20-TA0	03483CD		Tampa, Florida	33634	≫ŀ	CH			www.echoues.com General Location:		9th Avenue		
Truck No.			Т-1		400 SR 434, Ste	. 1024	S - S	INEERING &		888.778 - GROW, INSPIRE, MA		Coordinate Uni		ura:	US Survey Feet
TTUCK NO.					Oviedo, Florida	32/03		INEEKING &	SURVET						
ns n : 1		Utility Type			10 T '	Utilit	y Material	· 10:		Identif	ied By:	Abbreviat			
BE = Buried			aimed Water		AC = Transite		GALV = Galva	Inized Pipe Density Polyet	hadaa Dina	HUB = Survey Hub IRC = Iron Rod & Cap	"FCUO TEST HOLE"	N/A = Not Applicat		EP= Edge of Pav BC = Back of Cu	
GM = Gas M BT = Buried		TS = Traffic SL = Street			CI= Cast Iron CP = Concrete P	ino	PE = Polyeth	<del>, ,</del>	inylene Pipe	NL = Nail & Disk "ECH		Datum	ican	BL = Back of Cu	
	Optic Cable	IRR = Irrigat			DBC = Direct Bu	•	PVC = Polyvir			SLEEVE = Sleeve	10 TEST HOLE	NAVD = North Ame	erican	COORD = Surve	•
WM = Wate	•	GS = Gas Se			CMP = Corrugat		STL = Steel	Tyr emoriae		X = "X" in Concrete		Vertical Datum	2110411	CL = Centerline	y coordinates
SAN = Sanita		WS = Water			CONC = Concret		VCP = Vitrifie	d Clay Pipe		Surfac	е Туре	UNK = Unknown		HUB = Survey H	ub
STM = Storn	•	UNK = Unkr	nown Utility		CPP = Corrugate	ed Plastic Pipe		ressed Cylinde	r Concrete	ASPH = Asphalt	,,	BL = Baseline		RW = Right of W	/ay
CATV = Cabl	le Television	BED = Burie	d Electrical D	uct	DCT = Duct	·	Pipe	,		CONC = Concrete				ST = Swing Ties	
FM = Force	Main	BTD = Burie	d Telephone	Duct	DIP = Ductile Iro	on Pipe	RCP = Reinfo	rced Concrete	Pipe	NG = Natural Ground	I			X = "X" in Concr	ete
			Utility Size	Utility		Ņ			Surface		Datums:	Horizontal:	NAD83/11		
Test Hole	Utility Type	Utility Material	Outside Diameter	Manual Depth	Cross Sectional View	<b>₩</b>	Identified By	Surface Type	Thickness	Apparent Utility Owner	- Datamoi	Vertical:	NAVD88	Ground Elevation	Utility Elevation
		iviateriai	inches	Depth feet	Sectional view	Utility Direction			inches	Owner	Station	Offset	BL	Lievation	Lievation
1		EXPLORA <sup>*</sup>	TORY - NO UT	TILITIES FOU	ND - CLEARED TO	0 10'	NL	ASPH	2"	N/A	17+52.09	0.91' LT	87THST	7.44'	N/A
1A	WS	PE	1"	1.36'	o		IRC	NG	N/A	MANATEE COUNTY	17+30.37	17.00' RT	87THST	7.59'	6.23'
2	SAN	PVC	4"	3.78'	$\circ$		NL	ASPH	4"	MANATEE COUNTY	17+37.21	5.84' RT	87THST	7.80'	4.02'
3	RCW	PVC	2"	3.86'	0	1	NL	ASPH	8"	MANATEE COUNTY	17+11.11	6.15' RT	87THST	7.96'	4.10'
4	FM	HDPE	2"	3.56'	0	<b></b>	NL	ASPH	4"	MANATEE COUNTY	16+84.78	7.19' LT	87THST	8.19'	4.63'
5	SAN	PVC	4"	7.82'	$\circ$	<b>←</b> →	IRC	NG	N/A	MANATEE COUNTY	16+52.71	12.70' RT	87THST	8.27'	0.45'
6	SAN	PVC	4"	5.02'	$\circ$	<b>←</b> →	IRC	NG	N/A	MANATEE COUNTY	16+32.84	13.28' LT	87THST	8.65'	3.63'
7		EXPLORA <sup>-</sup>	TORY - NO UT	TILITIES FOU	ND - CLEARED TO	) 10'	IRC	NG	N/A	N/A	15+72.68	10.79' RT	87THST	8.71'	N/A
8	RCW	PVC	2"	2.10'	0	<b>←</b> →	IRC	NG	N/A	MANATEE COUNTY	15+67.24	13.65' RT	87THST	9.03'	6.93'
9	WS	CI	1"	6.31'	o	<b>←</b> →	IRC	NG	N/A	MANATEE COUNTY	15+53.10	12.60' RT	87THST	9.28'	2.97'
Notes:	TH# 3 - POSS	SIBLE 2" PVC;	UNABLE TO	VISUALLY VE	RIFY SIZE AND M	IATERIAL DUE TO W	ATER AND CA	VE-IN.							
	TH# 5 - POSS	SIBLE 4" PVC;	UNABLE TO	VISUALLY VE	RIFY SIZE AND M	IATERIAL DUE TO W	ATER TABLE, [	DEPTH AND CA	VE-IN.						
	TH# 6 - POSS	SIBLE 4" PVC;	UNABLE TO	VISUALLY VE	RIFY SIZE AND M	IATERIAL DUE TO W	ATER TABLE, [	DEPTH AND CA	VE-IN.						
	TH# 9 - POSS	SIBLE 1" CI; U	NABLE TO VIS	SUALLY VER	FY SIZE AND MA	TERIAL DUE TO WAT	ER TABLE, DE	PTH AND CAV	E-IN.						
												Prepared by:	EU/CM	Date: 4/15/20	25
												Checked by:	MA	Date: 4/15/20	25

Ч					
ı	X	VIII RELOCATION AND REVISION	10/14/25	SK	
Ì					Kimley»Horn
ļ					ranney w rioin
					© 2025 KIMLEY-HORN AND ASSOCIATES, I
ļ					1800 SECOND STREET, SUITE 900, SARASOTA, PHONE: 941-379-7600
ļ					WWW.KIMLEY-HORN.COM
	No	REVISIONS	DATE	RY	

© 2025 KIMLEY-HORN AND ASSOCIATES, INC. 1800 SECOND STREET, SUITE 900, SARASOTA, FL 34236 PHONE: 941-379-7600 WWW.KIMLEY-HORN.COM





9TH AVENUE NW

JORDAN E. LEEP, P.E. FLLICENSE NUMBER 76102 SUE INFORMATION SHEET (9)

160

CHECKED BY MANATEE COUNTY

10/14/2025 9:15:03 PM Default

K:\SAR\_Roadway\148400070\_9thAve\148400070\utils\UTEXRD\_ECHO01.dgn

⚠	

Date:		4/03 -4/	/15/2025				Test Hol	e Data Repo	art		Crew Members: DO,BM,NM				
ECHO Pro	iect #:	21-	-137	48								City, State:			Bradenton, FL
Financial I			03483CD		Tampa, Florida 33634			CH		www.echo	oues.com	General Location:		9th Avenue	
,				400 SR 434, Ste. 1024						888.778.ECHO					
Truck No.: VT-1			Oviedo, Florida	32.00	JTILITY ENGINEERING & SURVEY			- GROW, INSPIRE, MAKE A DIFFERENCE-		Coordinate Unit of Meas			JS Survey Feet		
Utility Type				Utility	i	y Material		Identified By:		Abbreviatio		Offset Meas			
BE = Buried			aimed Water		AC = Transite		GALV = Galva	•		HUB = Survey Hub		N/A = Not Applicable		EP= Edge of Pav	
GM = Gas M		TS = Traffic			CI= Cast Iron			Density Polyet	hylene Pipe	IRC = Iron Rod & Cap		NAD = North Americ Datum		BC = Back of Cur	
<del>'</del>		SL = Street			CP = Concrete P DBC = Direct Bu		PE = Polyethy	•		NL = Nail & Disk "ECH SLEEVE = Sleeve	10 TEST HOLE"	NAVD = North Amer		BL = Baseline of COORD = Survey	,
WM = Wate		IRR = Irrigat GS = Gas Se			CMP = Corrugat		PVC = Polyvin STL = Steel	iyi Chloride		X = "X" in Concrete		Vertical Datum	Can	CL = Centerline	Coordinates
SAN = Sanita		WS = Water			CONC = Concret	· · · · · · · · · · · · · · · · · · ·	VCP = Vitrifie	d Clay Pine		Surface	a Tyne	UNK = Unknown		HUB = Survey H	ıb
STM = Storm	,		nown Utility		CPP = Corrugate			essed Cylinde	Concrete	ASPH = Asphalt	гурс	BL = Baseline		RW = Right of W	
CATV = Cabl			ed Electrical D		DCT = Duct	tu i lastic i ipc	Pipe	esseu Cyllilae	Concrete	CONC = Concrete		Da Daseille		ST = Swing Ties	<u>.,</u>
FM = Force I			ed Telephone		DIP = Ductile Iro	on Pipe	<u> </u>	ced Concrete	Pipe	NG = Natural Ground				X = "X" in Concre	ete
			Utility Size	Utility		Ņ			Surface		5 :	Horizontal: N	IAD83/11		
Test Hole	Utility Type	Utility	Outside	Manual	Cross	<b>**</b>	Identified By	Surface Type	Thickness	Apparent Utility	Datums:	Vertical:	NAVD88	Ground	Utility
	, ,,	Material	al Diameter inches	Depth feet	Sectional View	Utility Direction	ĺ	·	inches	Owner	Station	Offset	BL	Elevation	Elevation
10		EXPLORA <sup>*</sup>	•		ND - CLEARED TO		IRC	NG	N/A	N/A	15+48.18	12.88' RT	87THST	9.45'	N/A
11		EXPLORA <sup>-</sup>	TORY - NO UT	TILITIES FOU	ES FOUND - CLEARED TO 10'		IRC	NG	N/A	N/A	14+19.39	11.72' LT	87THST	13.13'	N/A
11A	FM	HDPE	2"	2.83'	0	<b></b>	IRC	NG	N/A	MANATEE COUNTY	13+97.01	13.85' LT	87THST	13.71'	10.88'
12	SAN	PVC	6"	5.06'	0	<b>←→</b>	IRC	NG	N/A	MANATEE COUNTY	14+00.00	13.61' RT	87THST	13.55'	8.49'
12B	FOC	PE	1"	2.34'	o	<b></b>	IRC	NG	N/A	FRONTIER	13+98.68	12.59' RT	87THST	13.58'	11.24'
13	SAN	PVC	6"	4.06'	$\circ$	<b>←</b> →	IRC	NG	N/A	MANATEE COUNTY	12+22.86	12.64' RT	87THST	15.39'	11.33'
14	FOC	PE	1.5"	2.34'	0	<b></b>	IRC	NG	N/A	FRONTIER	11+76.04	11.63' RT	87THST	15.33'	12.99'
15	SAN	PVC	6"	3.94'	$\circ$	<b>←</b> →	IRC	NG	N/A	MANATEE COUNTY	11+52.94	14.40' RT	87THST	15.16'	11.22'
15B	FOC	PE	1.5	2.46'	0	$\updownarrow$	IRC	NG	N/A	FRONTIER	11+54.63	12.87' RT	87THST	15.18'	12.72'
16	RCW	HDPE	4"	3.26'	0	<b>1</b>	IRC	NG	N/A	MANATEE COUNTY	10+28.36	21.21' LT	87THST	15.23'	11.97'
Notes:															
												Prepared by: E	и/см	Date: 4/15/20	25
												Checked by: M	Α	Date: 4/15/20	25

<u> </u>	- OFFICE RELOCATION AND REVESTOR -	10/14/25	5K	$\sim$
No.	REVISIONS	DATE	BY	
Seth.	Kline			

Kimley»Horn

© 2025 KIMLEY-HORN AND ASSOCIATES, INC. 1800 SECOND STREET, SUITE 900, SARASOTA, FL 34236 PHONE: 941-379-7600 WWW.KIMLEY-HORN.COM

4	KHA PROJECT/	$\vdash$
	148400070	
	DATE 10/14/2025	
	SCALE AS SHOWN	
	DESIGNED BY	
	DRAWN BY	



ENUE NW LEE FLUCEN

JORDAN E. LEEP, P.E. FLLICENSE NUMBER 76102 SUE INFORMATION
SHEET (10)

161

CHECKED BY MANATEE COUNTY


10/14/2025 9:15:28 PM Default

Date: 4/03 -4/15/2025 Test						Test Hol	e Data Repo	ort		Crew Members	rew Members: DO,BM,NM				
ECHO Pro	ject #:	21-	-137	48	4803 George Road Ste 350 ECHO UES, Inc. City								ity, State: Braden		
Financial	ncial Project #: 20-TA003483CD		3CD Tampa, Florida 33634			≫⊩	CH		www.ech		General Location:			9th Avenue	
	Fruck No.: VT-1		400 SR 434, Ste. 1024 Oviedo, Florida 32765			JTILITY ENGINEERING & SURVEY			888.778.ECHO - GROW, INSPIRE, MAKE A DIFFERENCE-		Coordinate Unit of Meas				
Truck ito.		Utility Type			Oviedo, Florida	. 52, 55	Trees-east to har exercises	INCERNIO &	SUKVLI	Identif					sured From:
BE = Buried			aimed Water	i			y Material  GALV = Galvanized Pipe			HUB = Survey Hub	led by.	N/A = Not Applicable		EP= Edge of Pav	
GM = Gas N		TS = Traffic			CI= Cast Iron		<del>                                     </del>	Density Polyet	hylene Pine	IRC = Iron Rod & Cap	"ECHO TEST HOLE"	NAD = North Amer		BC = Back of Cui	
BT = Buried		SL = Street			CP = Concrete P	Pipe	PE = Polyethy		yiene i ipe	NL = Nail & Disk "ECH		Datum	· carr	BL = Baseline of	
	Optic Cable	IRR = Irrigat	-		DBC = Direct Bu	•	PVC = Polyvir	•		SLEEVE = Sleeve		NAVD = North Ame	rican	COORD = Survey	
WM = Wate	·	GS = Gas Se			CMP = Corrugat		STL = Steel	,		X = "X" in Concrete		Vertical Datum		CL = Centerline	,
SAN = Sanit	ary Sewer	WS = Water	r Service		CONC = Concre		VCP = Vitrifie	d Clay Pipe		Surfac	е Туре	UNK = Unknown		HUB = Survey H	ub
STM = Storr	-	UNK = Unkr	nown Utility		CPP = Corrugate	ed Plastic Pipe		ressed Cylinde	r Concrete	ASPH = Asphalt	•	BL = Baseline		RW = Right of W	/ay
CATV = Cab	le Television	BED = Burie	d Electrical D	uct	DCT = Duct	·	Pipe	<b>,</b>		CONC = Concrete				ST = Swing Ties	
FM = Force	Main	BTD = Burie	d Telephone	Duct	DIP = Ductile Iro	on Pipe	RCP = Reinfo	ced Concrete	Pipe	NG = Natural Ground	I			X = "X" in Concr	ete
		Utility	Utility Size Outside	Utility Manual	Cross	~ <del>\</del>			Surface	Apparent Utility	Datums:		NAD83/11	Ground	Utility
Test Hole	Utility Type	Material	Diameter	Depth	Sectional View	Litility Direction	Identified By	Surface Type	Thickness inches	Owner	Station	Vertical: Offset	NAVD88 BL	Elevation	Elevation
18	RCW	DIP	inches 12"	feet 3.42'		Utility Direction	NL	ASPH	4"	MANATEE COUNTY	54+17.95	14.10' LT	9THAVE	13.93'	10.51'
19	UNK	CONC	UNK	2.22'		<b>←</b> →	NL	ASPH	4"	N/A	54+19.98	12.27' RT	9THAVE	14.14'	11.92'
20	FM	HDPE	2"	7.06'	0		NL	ASPH	4"	MANATEE COUNTY	55+80.36	14.68' LT	9THAVE	15.30'	8.24'
	TIII 42	A DI E TO 255	FORM TEST :	1015 0225	DUE TO SOME	TTE DEDDIG (25) 2	CDOUNTS OF T	TRUCTION ST	FD 514						
Notes:						ETE DEBRIS/BELOW									
	TH# 20 - POS	SSIBLE 2" HD	PE; UNABLE T	O VISUALLY	VERIFY SIZE AND	) MATERIAL DUE TO	DEPTH, WATE	ER AND CAVE-I	N.						
												Prepared by:	EU/CM	Date: 4/15/20	25
												Checked by: I	MA	Date: 4/15/20	25

<u>//\</u>	P O O O PILITA RELOCATION MINDRESASSION C	10/14/25	SK	$\sim$
				ĺ
No.	REVISIONS	DATE	BY	
Seth.	Kline			

Kimley»Horn

© 2025 KIMLEY-HORN AND ASSOCIATES, INC. 1800 SECOND STREET, SUITE 900, SARASOTA, FL 34236 PHONE: 941-379-7600 WWW.KIMLEY-HORN.COM

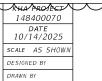



9TH AVENUE NW

JORDAN E. LEEP, P.E. FLLICENSE NUMBER 76102 SUE INFORMATION
SHEET (11)

162

CHECKED BY MANATEE COUNTY

10/14/2025 9:15:59 PM Default

K:\SAR\_Roadway\148400070\_9thAve\148400070\utils\UTEXRD\_ECHO01.dgn