

CONSTRUCTION PLANS  
FOR  
9TH AVENUE NW

MANATEE COUNTY, FLORIDA

OCTOBER 2025

MANATEE COUNTY PROJECT # 20-TA003483CD



PROJECT TEAM:

OWNER:  
MANATEE COUNTY  
1022 26TH AVE E  
BRADENTON, FL 34206  
CONTACT: STEVE CLARK  
941-748-4501 EXT. 7326

SURVEYOR:  
HYATT SURVEYING SERVICES INC.  
2012 LENA ROAD  
BRADENTON, FL 34211  
CONTACT: JOHN MATTHEWS  
941-748-4693

ENGINEER:  
KIMLEY-HORN AND ASSOCIATES, INC.  
1800 SECOND STREET, SUITE 900  
SARASOTA, FL 34236  
CONTACT: JORDAN LEEP, P.E.  
941-379-7600

GEOTECH:  
ARDAMAN AND ASSOCIATES, INC.  
78 SARASOTA CENTER BOULEVARD  
SARASOTA, FL 34240  
CONTACT: VIRGINIA GOFF, P.E.  
941-225-4424

UTILITY CONTACTS

MANATEE COUNTY  
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ED WATSON  
13051 N. TELECOM PKWY  
TEMPLE TERRACE, FL 33637  
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FAX: (813) 470-5993


SUNSHINE STATE ONE CALL OF  
FLORIDA  
1-(800) 432-4770

SOUTHWEST FLORIDA WATER  
MANAGEMENT DISTRICT  
SARASOTA SERVICE OFFICE  
BRANDEE ALEXANDER  
7601 HIGHWAY 301 NORTH  
TAMPA, FL 33637  
(813) 445-6649

MANATEE COUNTY  
PUBLIC WORK DEPT.  
TRAFFIC ENGINEERING  
MUKUNDA GOPALAKRISHNA,  
P.E., P.T.O.E.  
PUBLIC WORKS DEPARTMENT  
COUNTY TRAFFIC ENGINEER  
2101 47TH TERRACE EAST  
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PROJECT VICINITY MAP

N.T.S.

COUNTY CIP PROJECT  
BID PLANS

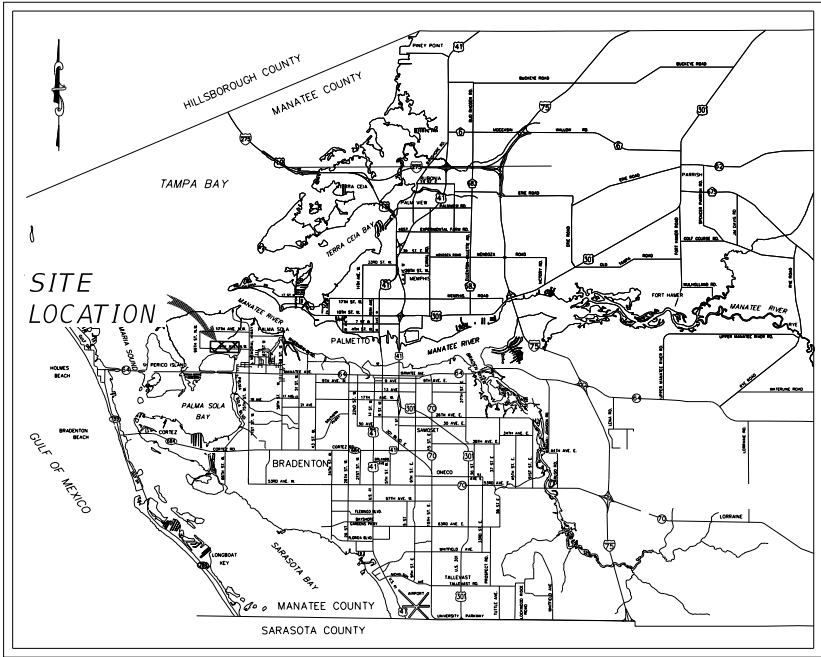PREPARED BY  
**Kimley»Horn**

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\* THESE SHEETS ARE INCLUDED IN THE INDEX OF ROADWAY PLANS ONLY TO INDICATE THAT THEY ARE PART OF THE ROADWAY PLANS. THESE PLANS ARE CONTAINED IN A SEPARATE DIGITALLY SIGNED AND SEALED DOCUMENT.

GOVERNING STANDARD PLANS:

Florida Department of Transportation, FY2025-26 Standard Plans for Road and Bridge Construction and applicable Interim Revions (IRs)

Standard Plans for Road Construction and associated IRs are available at the following website: <http://www.fdot.gov/design/standardplans>

APPLICABLE IRs: NONE

GOVERNING STANDARD SPECIFICATIONS:


Florida Department of Transportation, FY2025-26 Standard Specifications for Road and Bridge Construction at the following website: <http://www.fdot.gov/programmanagement/Implemented/SpecBooks>

THE SITE CONSTRUCTION STAKEOUT SHALL BE PERFORMED UNDER THE DIRECTION OF A FLORIDA REGISTERED SURVEYOR. AUTOCAD FILES WILL BE FURNISHED TO AID IN THE SITE CONSTRUCTION STAKEOUT. ANY DISCREPANCIES FOUND BETWEEN AUTOCAD FILES AND SITE CONSTRUCTION PLANS SHALL BE BROUGHT TO THE ENGINEER'S ATTENTION FOR CLARIFICATION PRIOR TO THAT STAKEOUT.

No.	REVISIONS	DATE	BY

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		KHA PROJECT NO. 148400070 SHEET NUMBER 1



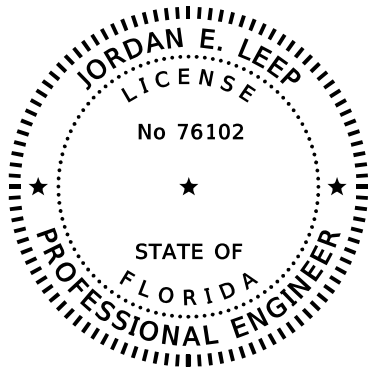

THIS ITEM HAS BEEN DIGITALLY  
SIGNED AND SEALED BY

ON THE DATE ADJACENT TO THE SEAL.

SIGNATURE MUST BE VERIFIED ON ANY  
ELECTRONIC COPIES.

KIMLEY-HORN AND ASSOCIATES, INC.  
1800 SECOND STREET, SUITE 900  
SARASOTA, FLORIDA 34236  
JORDAN E. LEEP, P.E. NO. 76102

THE ABOVE NAMED PROFESSIONAL ENGINEER SHALL BE RESPONSIBLE FOR THE  
FOLLOWING SHEETS IN ACCORDANCE WITH RULE 61G15-23.004, F.A.C.

ROADWAY PLANS

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No.	REVISIONS	DATE	BY						



CIP 2: HAWTHORNE PARK SEDIMENT BASIN

ITEM NO.	ITEM DESCRIPTION	UNIT	PROJECT QUANTITY
Roadway			
101 1	MOBILIZATION	LS	1
102 2	MAINTENANCE OF TRAFFIC	LS	1
107 1	LITTER REMOVAL	AC	1.54
107 2	MOWING	AC	1.54
110 1 1	CLEARING & GRUBBING	AC	0.11
120 1	REGULAR EXCAVATION	CY	54.0
524 1 2	CONCRETE DITCH PAVEMENT, NON REINFORCED, 4"	SY	34
570 1 2	PERFORMANCE TURF, SOD	SY	520
Drainage			
430 174 248	PIPE CULVERT,OPTIONAL MATERIAL,OTHER-ELIP/ARCH, 48"SD	LF	84
430 984 641	MITERED END SECT, OPTIONAL/ELLIP/ARCH 48" SD	EA	1

CIP 3: 87TH ST CT NW STORM SEWER REPLACEMENT

ITEM NO.	ITEM DESCRIPTION	UNIT	PROJECT QUANTITY
Roadway			
101 1	MOBILIZATION	LS	1
102 2	MAINTENANCE OF TRAFFIC	LS	1
104 10 3	SEDIMENT BARRIER	LF	927
104 18	INLET PROTECTION SYSTEM	EA	2
107 1	LITTER REMOVAL	AC	11.48
107 2	MOWING	AC	9.94
110 1 1	CLEARING & GRUBBING	AC	0.27
110 4 10	REMOVAL OF EXISTING CONCRETE	SY	330
110 7 1	MAILBOX, F&I SINGLE	EA	3
120 1	REGULAR EXCAVATION	CY	125.0
120 6	EMBANKMENT	CY	100.0
160 4	TYPE B STABILIZATION	SY	916
285 706	OPTIONAL BASE, BASE GROUP 06	SY	912
327 70 6	MILLING EXISTING ASPHALT PAVEMENT, 1 1/2" DEPTH	SY	703
334 1 53	SUPERPAVE ASPHALTIC CONCRETE, TRAFFIC C, PG76-22	TN	75.3
337 7 83	ASPHALT CONCRETE FRICTION COURSE, TRAFFIC C, FC-12.5	TN	133.3
520 2 1	CONCRETE CURB, TYPE A	LF	12
522 2	CONCRETE SIDEWALK AND DRIVEWAYS, 6" THICK	SY	330
526 2 1	DRIVEWAY BRICK REPLACEMENT	SY	24
570 1 2	PERFORMANCE TURF, SOD	SY	388
Drainage			
425 2 41	MANHOLES, P-7, <10'	EA	7
430 174 224	PIPE CULVERT, OPTIONAL MATERIAL, OTHER SHAPE-ELIP/ARCH, 24"SD	LF	269
430 175 124	PIPE CULVERT, OPTIONAL MATERIAL, ROUND, 24" S/CD	LF	698
430 524 112	STRAIGHT CONCRETE ENDWALLS, 24", SINGLE, 15 DEGREES, ELLIPTICAL	EA	1
430 830	PIPE FILLING AND PLUGGING - PLACE OUT OF SERVICE	CY	34.0

PAY ITEM NOTES:

102-2: PAY ITEM INCLUDES THE COST OF ALL TEMPORARY STRIPING, SIGNAGE, PAVEMENT, AND SIGN RELOCATIONS.

110-1-1: PAY ITEM INCLUDES THE COST OF ALL EXISTING PIPES TO BE REMOVED OR CUT AND MODIFIED AND TREE AND STUMP REMOVAL TO 6" BELOW GRADE FOR THE ENTIRE PROJECT. TREES TO REMAIN UNLESS OTHERWISE NOTED IN THE PLANS.

120-4: PAY ITEM INCLUDES THE COST OF EXCAVATION OF IDENTIFIED ORGANIC SUBSOIL TO A DEPTH OF ONE FOOT ABOVE THE HIGHEST IDENTIFIED UTILITY WITHIN THE EXCAVATION LIMITS. THE CONTRACTOR SHALL BE RESPONSIBLE FOR IDENTIFYING THE LOCATION, DEPTH, AND ALIGNMENT OF ALL EXISTING UTILITIES WITHIN THE WORK AREA PRIOR TO THE START OF EXCAVATION. ANY DAMAGE TO EXISTING UTILITIES SHALL BE REPAIRED AT THE CONTRACTOR'S EXPENSE TO THE SATISFACTION OF THE OWNER.

430-542-300: PAY ITEM INCLUDES ALL COSTS ASSOCIATED WITH FURNISHING AND INSTALLING TYPE 45-DEGREE WINGWALLS AND U-TYPE WING STRUCTURES. REFER TO DRAINAGE DETAILS FOR CONFIGURATION AND DIMENSIONS.

CIP 5: 71ST ST NW TO 83RD ST NW

ITEM NO.	ITEM DESCRIPTION	UNIT	PROJECT QUANTITY
Roadway			
101 1	MOBILIZATION	LS	1
102 2	MAINTENANCE OF TRAFFIC	LS	1
104 10 3	SEDIMENT BARRIER	LF	1279
104 18	INLET PROTECTION SYSTEM	EA	3
107 1	LITTER REMOVAL	AC	8.68
107 2	MOWING	AC	5.18
110 1 1	CLEARING & GRUBBING	AC	0.27
110 4 10	REMOVAL OF EXISTING CONCRETE	SY	340
110 7 1	MAILBOX, F&I SINGLE	EA	2
120 1	REGULAR EXCAVATION	CY	500.0
120 6	EMBANKMENT	CY	100.0
160 4	TYPE B STABILIZATION	SY	15
520 1 10	CONCRETE CURB & GUTTER, TYPE F	LF	43
522 1	CONCRETE SIDEWALK AND DRIVEWAYS, 4" THICK	SY	618
522 2	CONCRETE SIDEWALK AND DRIVEWAYS, 6" THICK	SY	410
526 1101	PAVERS, ARCHITECTURAL, REMOVE EXISTING AND REINSTALL (PAY ITEM REMOVED)	SY	50
550 10 918	FENCING, SPECIALTYPE, 0.0-5.0', RESET EXISTING	LF	75
570 1 2	PERFORMANCE TURF, SOD	SY	674
Drainage			
425 1521	INLETS, DT BOT, TYPE C,<10	EA	3
425 2 41	MANHOLES, P-7, <10'	EA	1
430 174 215	PIPE CULVERT, OPTIONAL MATERIAL, OTHER SHAPE-ELIP/ARCH, 15"SD	LF	18
430 175 118	PIPE CULVERT, OPTIONAL MATERIAL, ROUND, 18" S/CD	LF	20

570-1-2: PAY ITEM INCLUDES PLACEMENT OF SOD MATCHING EXISTING TYPE AND SPECIES OF SOD PRESENT ADJACENT TO THE WORK AREA.

590-70-1: PAY ITEM INCLUDES THE MODIFICATION AND/OR REPLACEMENT OF IRRIGATION SYSTEMS AFFECTED BY CONSTRUCTION. PROPERTIES WITH VISIBLE IRRIGATION SYSTEMS ARE NOTED ON THE PLANS. CONTRACTOR TO CHECK FOR PRESENCE OF IRRIGATION SYSTEMS WITHIN THE LIMITS OF CONSTRUCTION AT ALL PROPERTIES AND PROTECT AND RELOCATE CONFLICTING PORTIONS OF IRRIGATION SYSTEM AFFECTED UNDER THIS PAY ITEM. COST TO INCLUDE REPLACEMENT OF PARTS, LABOR, EQUIPMENT, AND MATERIALS AS REQUIRED TO REPAIR THE SYSTEM TO A COMPLETE AND FUNCTIONING STATE OF REPAIR. CONTRACTOR RESPONSIBLE FOR ANY COORDINATION WITH ADJACENT PROPERTY OWNERS AFFECTED.

700-3-501: PAY ITEM INCLUDES F&I OF SINGLE POST AND MOUNTING OF EXISTING SIGN PANEL.

715-7-11: SERVICE POINT INCLUDES ALL COSTS FOR FPL REIMBURSEMENT FOR NEW TRANSFORMER. CONTRACTOR IS RESPONSIBLE TO COORDINATE WITH FPL TO CONFIRM COSTS.

0526 2 1 DRIVEWAY BRICK REPLACEMENT

PAY ITEM INCLUDES ALL LABOR, EQUIPMENT, AND MATERIALS REQUIRED FOR THE REMOVAL OF THE EXISTING SOLDIER COURSE AND BRICK PAVERS WITHIN THE BRICK DRIVEWAY. THE CONTRACTOR SHALL CAREFULLY CLEAN ALL JOINTS TO A MINIMUM DEPTH AS SPECIFIED BY THE MANUFACTURER, ENSURING ALL DEBRIS AND VEGETATION ARE REMOVED. THIS ITEM INCLUDES FURNISHING AND INSTALLING REPLACEMENT BRICK PAVERS AS SHOWN ON THE PLANS, AS WELL AS INSTALLING THE SOLDIER COURSE IN ACCORDANCE WITH THE PROVIDED DETAILS. POLYMERIC SAND SHALL BE INCLUDED IN THE SOLDIER COURSE INSTALLATION, WITH PROPER COMPACTION FOLLOWING THE MANUFACTURER'S RECOMMENDATIONS. WORK SHALL ALSO INCLUDE PROTECTION OF SURROUNDING SURFACES, DISPOSAL OF REMOVED MATERIALS, AND RESTORATION OF ANY DISTURBED AREAS TO PRE-CONSTRUCTION CONDITION. ANY DAMAGE TO SURROUNDING BRICKS OR ADJACENT FEATURES CAUSED DURING CONSTRUCTION SHALL BE REPAIRED AT NO ADDITIONAL COST TO THE COUNTY.

ALL QUANTITIES PROVIDED HEREIN ARE FOR ENGINEERS ESTIMATING PURPOSES ONLY, CONTRACTOR IS RESPONSIBLE FOR ALL QUANTITY CALCULATIONS NECESSARY FOR BIDDING.

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No.	REVISIONS	DATE	BY						

CIP UTILITIES: POTABLE, RECLAIMED, SEWER

ITEM NO.	ITEM DESCRIPTION	UNIT	PROJECT QUANTITY
I. WATER IMPROVEMENTS			
1	MOBILIZATION AND MOT (WATER)	LS	1
2	UTILITY RECORD DRAWINGS (WATER)	LS	1
3	WATER VALVE TO BE ADJUSTED TO GRADE	EA	22
4	8" DI CLASS 350 PIPE WATER MAIN (OPEN CUT)	LF	179
5	8" DI FITTING - 45 DEGREE BEND MJ (WATER)	EA	12
6	CUT AND CONNECT TO EXISTING WATER MAIN (INCLUDES TEMP. SHUTDOWN)	EA	6
7	REMOVE EXISTING 8" WATER MAIN	LF	176
8	WATER SERVICE ASSEMBLY	EA	2
9	AIR RELEASE VALVE ASSEMBLY (WATER)	EA	1
10	WATER METER TO BE ADJUSTED TO GRADE	EA	2
11	8" X 2" TAPPIING SLEEVE WITH 2" VALVE (WATER)	AS	1
12	FIRE HYDRANT ASSEMBLY (RELOCATION)	EA	2
13	FIRE HYDRANT ASSEMBLY TO BE ADJUSTED TO PROP. GRADE	EA	1
14	METER (WATER)	EA	7
15	8" GATE VALVE (WATER)	EA	1
16	6" GATE VALVE (WATER)	EA	1
17	REMOVE GATE VALVE (WATER)	EA	1
18	BACKFLOW ASSEMBLY	EA	2
II. WASTEWATER IMPROVEMENTS			
19	MOBILIZATION AND MOT (WASTEWATER)	LS	1
20	UTILITY RECORD DRAWINGS (WASTEWATER)	LS	1
21	SANITARY VALVE TO BE ADJUSTED TO GRADE	EA	1
22	SANITARY MH TO BE ADJUSTED TO GRADE	EA	1
23	6" C900 DR-18 PVC FORCE MAIN (OPEN CUT)	LF	44
24	6" C900 DR-18 PVC FORCE MAIN IN 12" PVC CASING (OPEN CUT)	LF	256
25	6" DI FITTING - 45 DEG. BEND MJ (WASTEWATER)	EA	8
26	CUT AND CONNECT TO EXISTING FORCE MAIN (INCLUDES BYPASSING)	EA	4
27	6" SANITARY SEWER VERTICAL ADJUSTMENT	EA	7
28	4" SANITARY SEWER VERTICAL ADJUSTMENT	EA	2
29	REMOVE EXISTING 6" FORCE MAIN	LF	294
30	SANITARY SERVICE ASSEMBLY	EA	1
31	6" X 2" TAPPING SLEEVE WITH 2" VALVE (WASTEWATER)	AS	1
II. RECLAIMED WATER IMPROVEMENTS			
32	MOBILIZATION AND MOT (RECLAIM)	LS	1
33	UTILITY RECORD DRAWINGS (RECLAIM)	LS	1
34	RECLAIM VALVE TO BE ADJUSTED TO GRADE	EA	8
35	12" DI CLASS 350 PIPE RECLAIM MAIN (OPEN CUT)	LF	97
36	8" DI CLASS 350 PIPE RECLAIM MAIN (OPEN CUT)	LF	40
37	12" DI FITTING - 45 DEG. BEND MJ (RECLAIM)	EA	12
38	8" DI FITTING - 45 DEG. BEND MJ (RECLAIM)	EA	4
39	12" GATE VALVE (RECLAIM)	EA	3
40	8" GATE VALVE (RECLAIM)	EA	1
41	REMOVE GATE VALVE (RECLAIM)	EA	4
42	CUT AND CONNECT TO EXISTING RECLAIM WATER MAIN (INCLUDES TEMP. SHUTDOWN)	EA	8
43	REMOVE EXISTING 12" RECLAIM WATER MAIN	LF	87
44	REMOVE EXISTING 8" RECLAIM WATER MAIN	LF	40
45	RECLAIM SERVICE ASSEMBLY	EA	1
46	AIR RELEASE VALVE ASSEMBLY (RECLAIM)	EA	2
47	12" X 2" TAPPING SLEEVE WITH 2" VALVE (RECLAIM)	AS	1



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No.	REVISIONS	DATE	BY						
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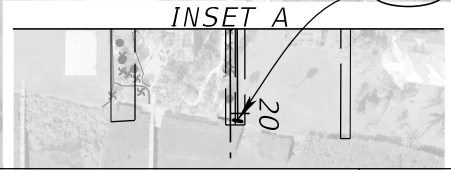
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← FLOW DIRECTION

--- BASIN DIVIDE



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No.	REVISIONS	DATE	BY

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KHA PROJECT  
148400070

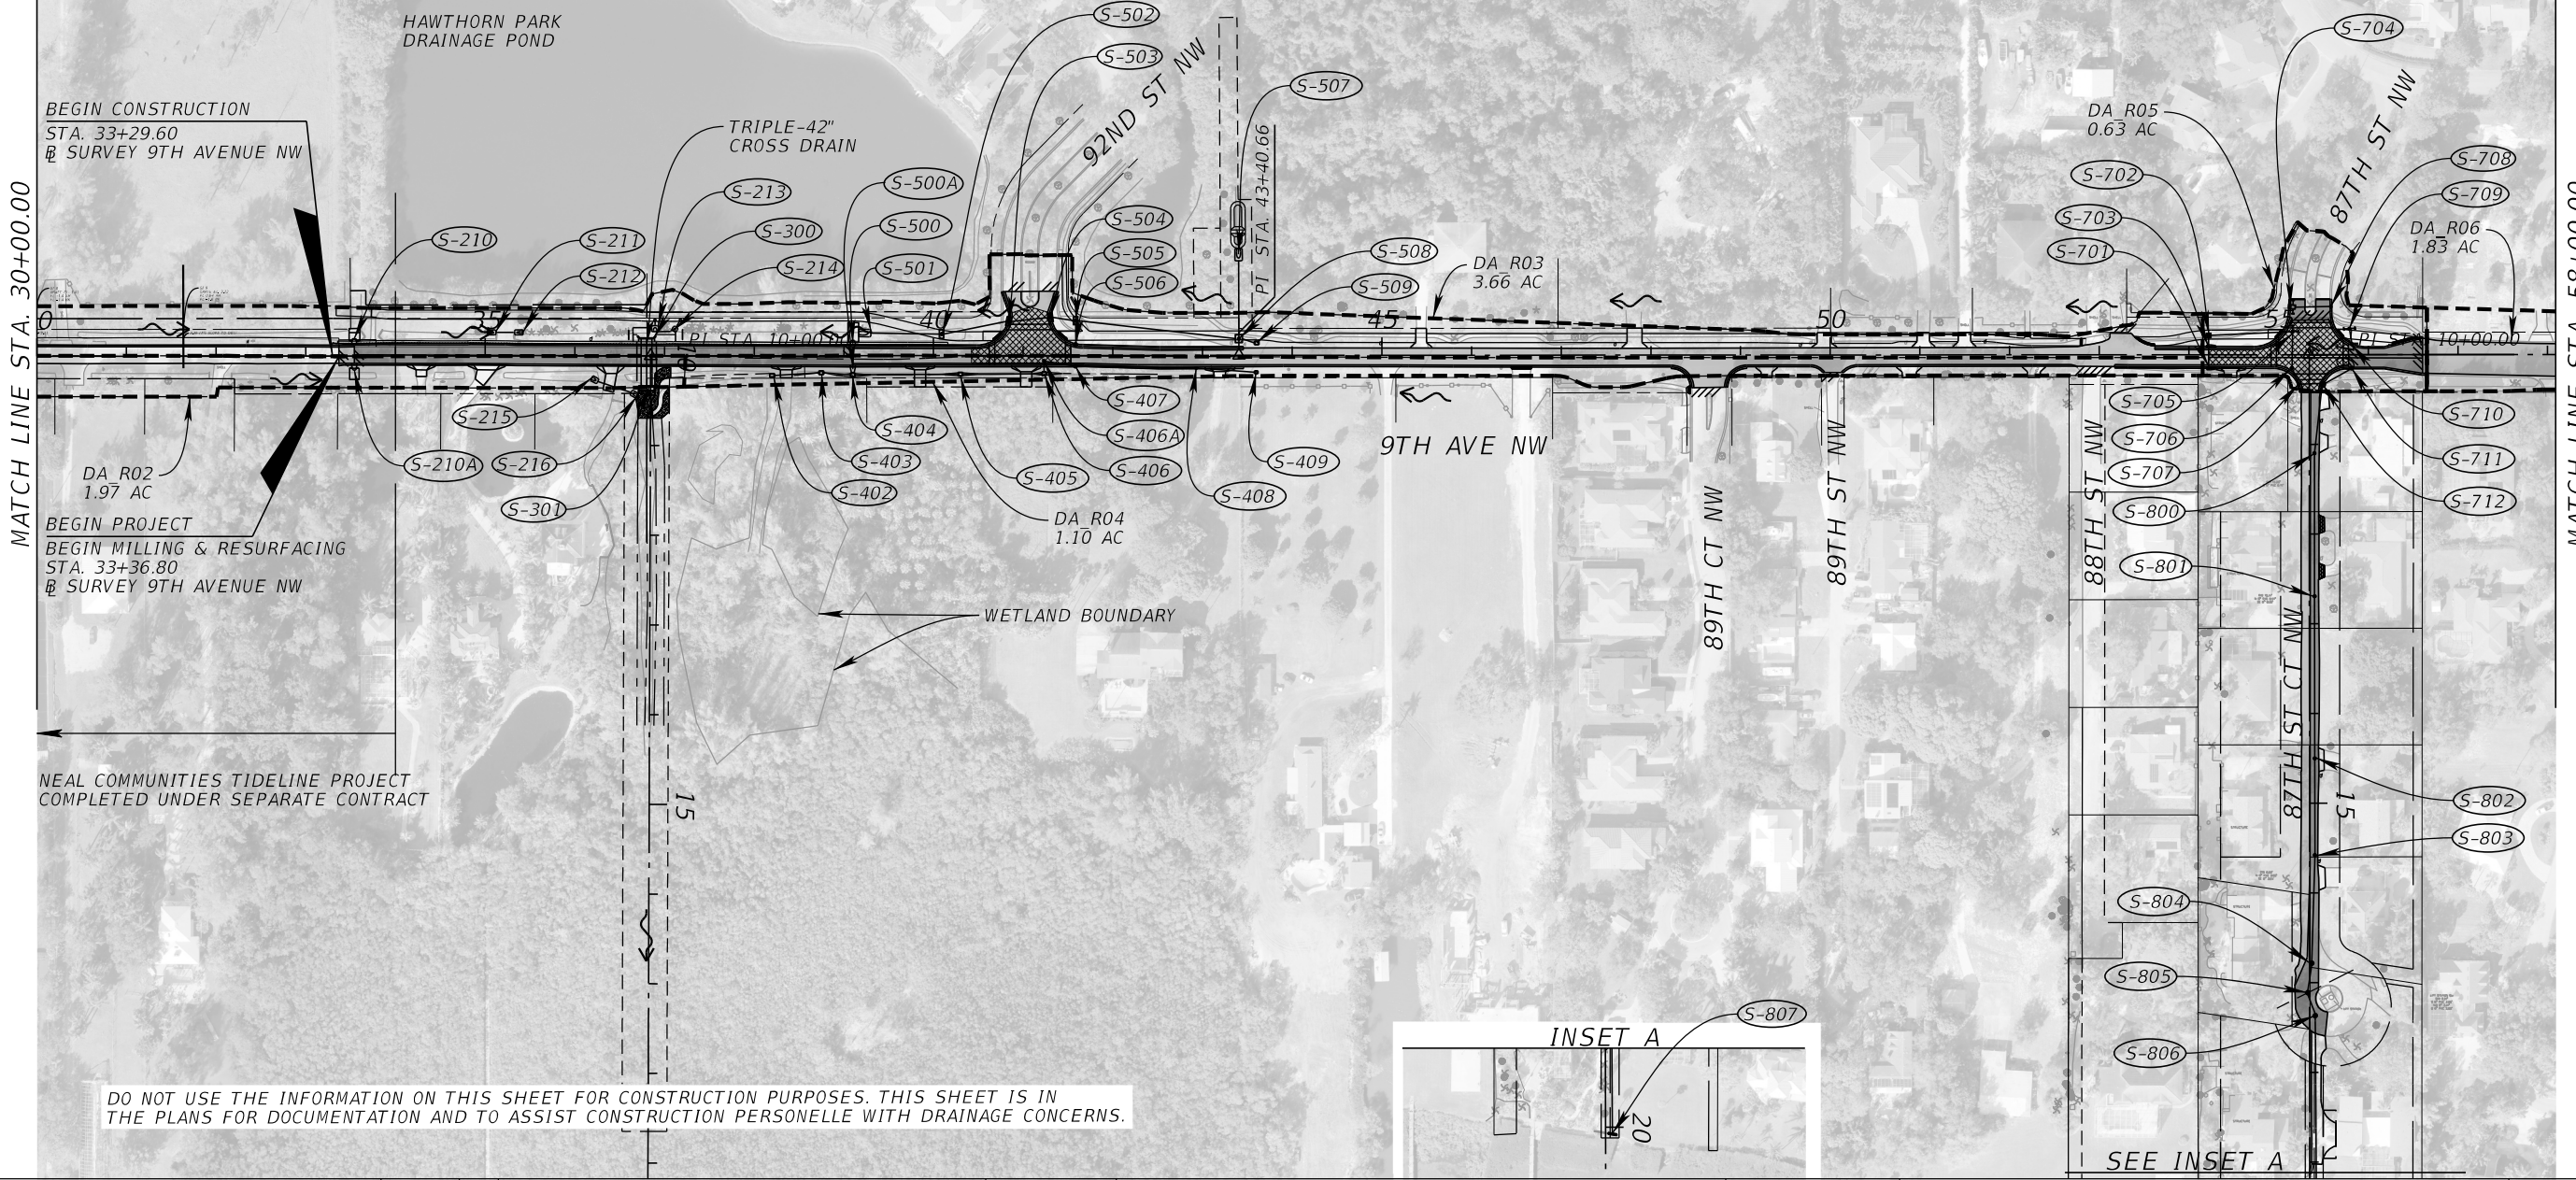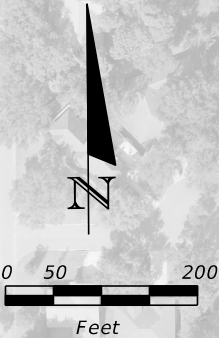DATE  
10/02/2025

SCALE AS SHOWN

DESIGNED BY

DRAWN BY

CHECKED BY

9TH AVENUE NW

MANATEE COUNTY

FL

LICENSED PROFESSIONAL

JORDAN E. LEEP, P.E.  
FL LICENSE NUMBER 76102

DATE:

DRAINAGE MAP (1)

6

SHEET NUMBER

6


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SCALE AS SHOWN
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DRAWN BY
CHECKED BY



9TH AVENUE NW

MANATEE COUNTY

FL

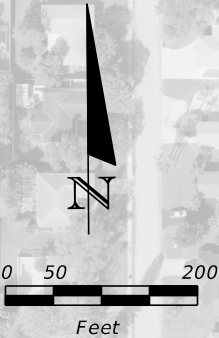LICENSED PROFESSIONAL

JORDAN E. LEEP, P.E.  
FL LICENSE NUMBER 76102

*DRAINAGE MAP (2)*

SHEET NUMBER

7


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LEGEND

↩ FLOW DIRECTION

--- BASIN DIVIDE



MATCH LINE STA. 86+00.00

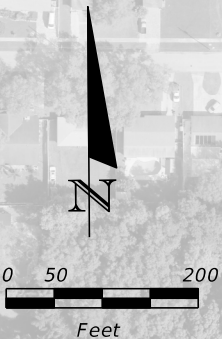

DO NOT USE THE INFORMATION ON THIS SHEET FOR CONSTRUCTION PURPOSES. THIS SHEET IS IN THE PLANS FOR DOCUMENTATION AND TO ASSIST CONSTRUCTION PERSONNELLE WITH DRAINAGE CONCERNS.

No.	REVISIONS	DATE	BY



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1800 SECOND STREET, SUITE 900, SARASOTA, FL 34236  
PHONE: 941-379-7600  
WWW.KIMLEY-HORN.COM

KHA PROJECT 148400070
DATE 10/02/2025
SCALE AS SHOWN
DESIGNED BY
DRAWN BY
CHECKED BY



9TH AVENUE NW

MANATEE COUNTY

LICENSED PROFESSIONAL

JORDAN E. LEEP, P.E.  
FL LICENSE NUMBER 76102


DRAINAGE MAP (3)

SHEET NUMBER

8

THE OFFICIAL RECORD OF THIS SHEET IS THE ELECTRONIC FILE DIGITALLY SIGNED AND SEALED UNDER RULE 61G15-23.004, F.A.C.



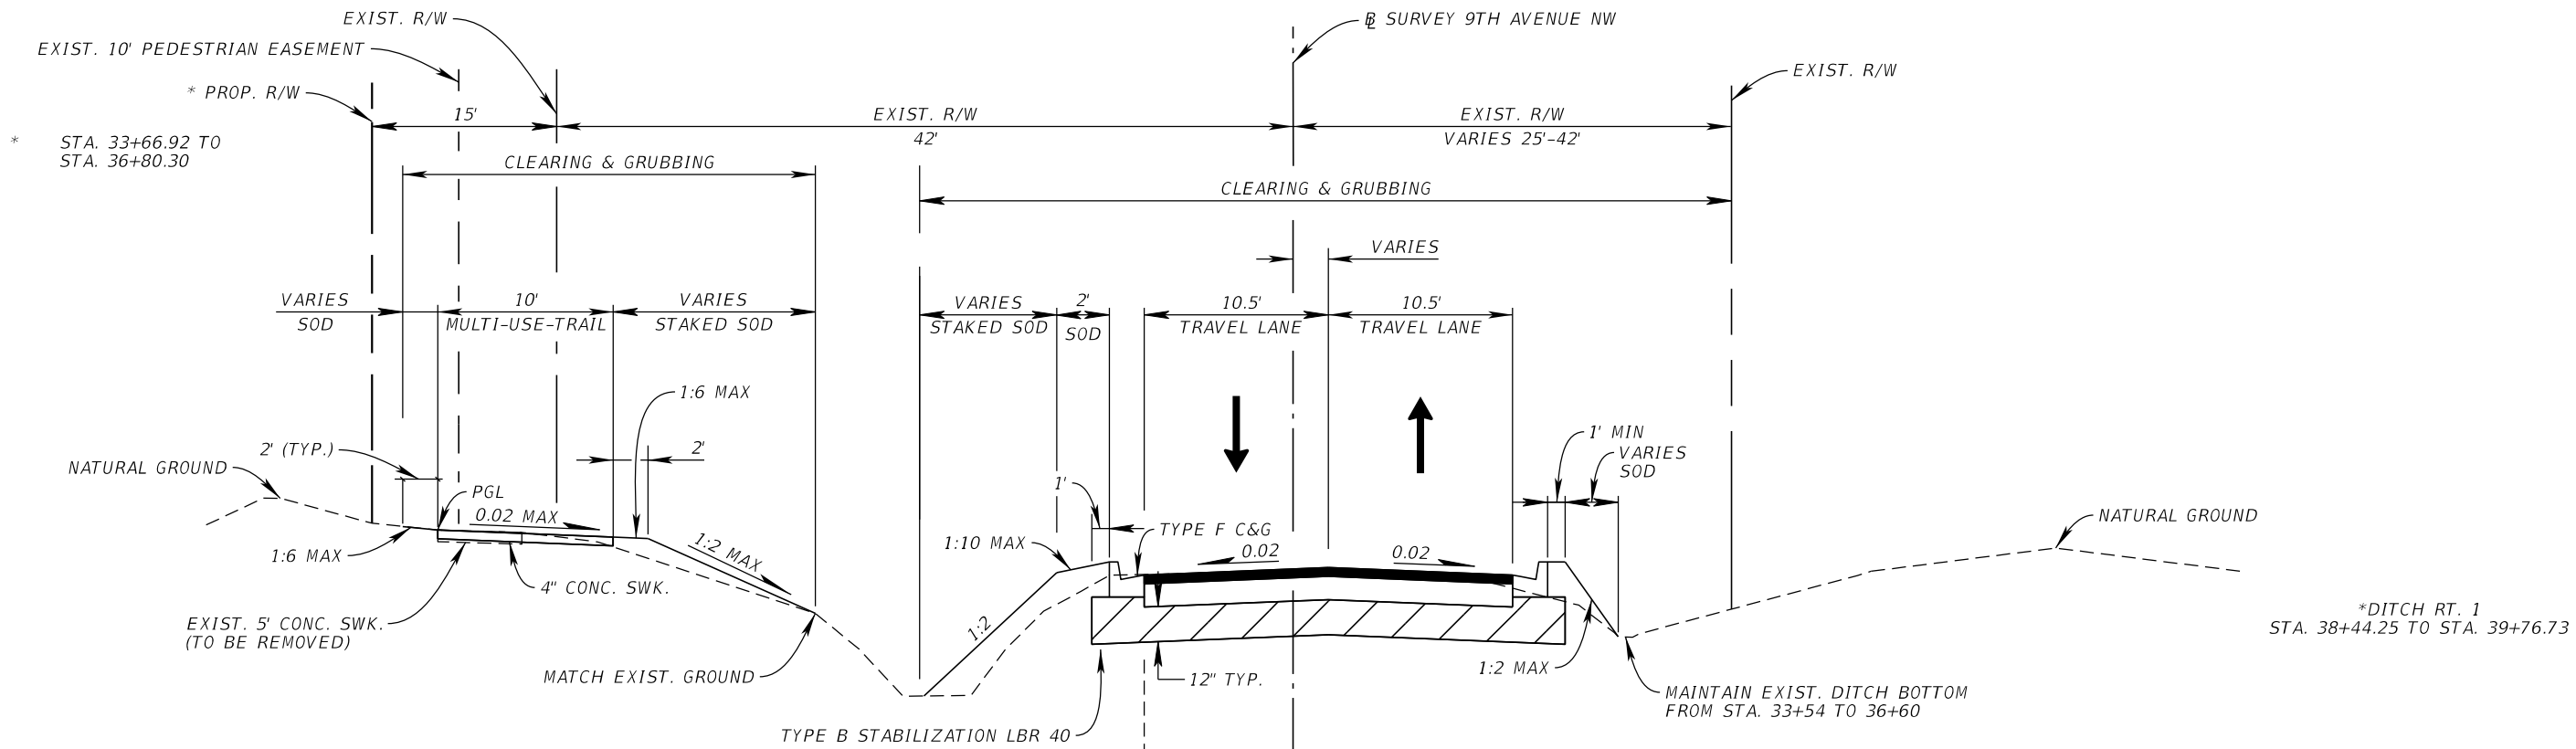


\*\* SEE PLANS FOR GUARDRAIL LOCATION.

**MULTI-USE TRAIL**

DESIGN SPEED = 18 MPH

**TRAFFIC DATA**

DESIGN SPEED = 35 MPH  
POSTED SPEED = 30 MPH

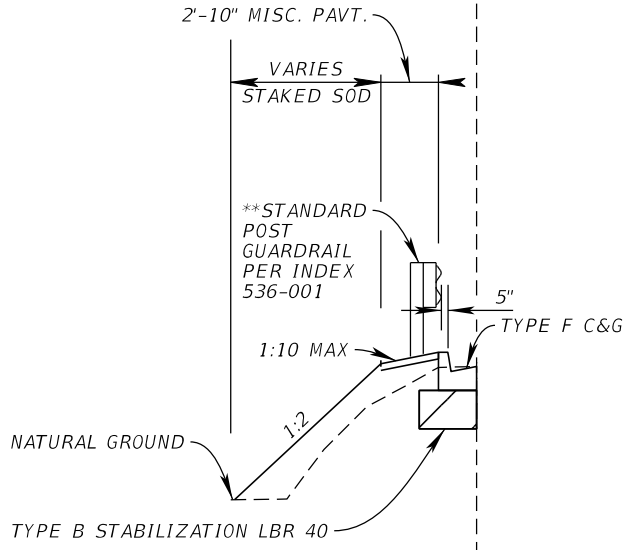

GUARDRAIL  
STA. 33+50.97 - STA. 39+52.92

**TYPICAL SECTION**  
**9TH AVENUE NW**  
**STA. 33+36.80 - STA. 39+10.00**

**RECONSTRUCTION**  
OPTIONAL BASE GROUP 6  
STRUCTURAL COURSE SP-12.5 (TRAFFIC C) (1.5")  
FRICTION COURSE FC-12.5 (TRAFFIC C) (1.5") (PG 76-22)

**MILLING**  
MILL EXISTING ASPHALT PAVEMENT (1.5")


**RESURFACING**  
FRICTION COURSE FC-12.5 (TRAFFIC C) (1.5") (PG 76-22)

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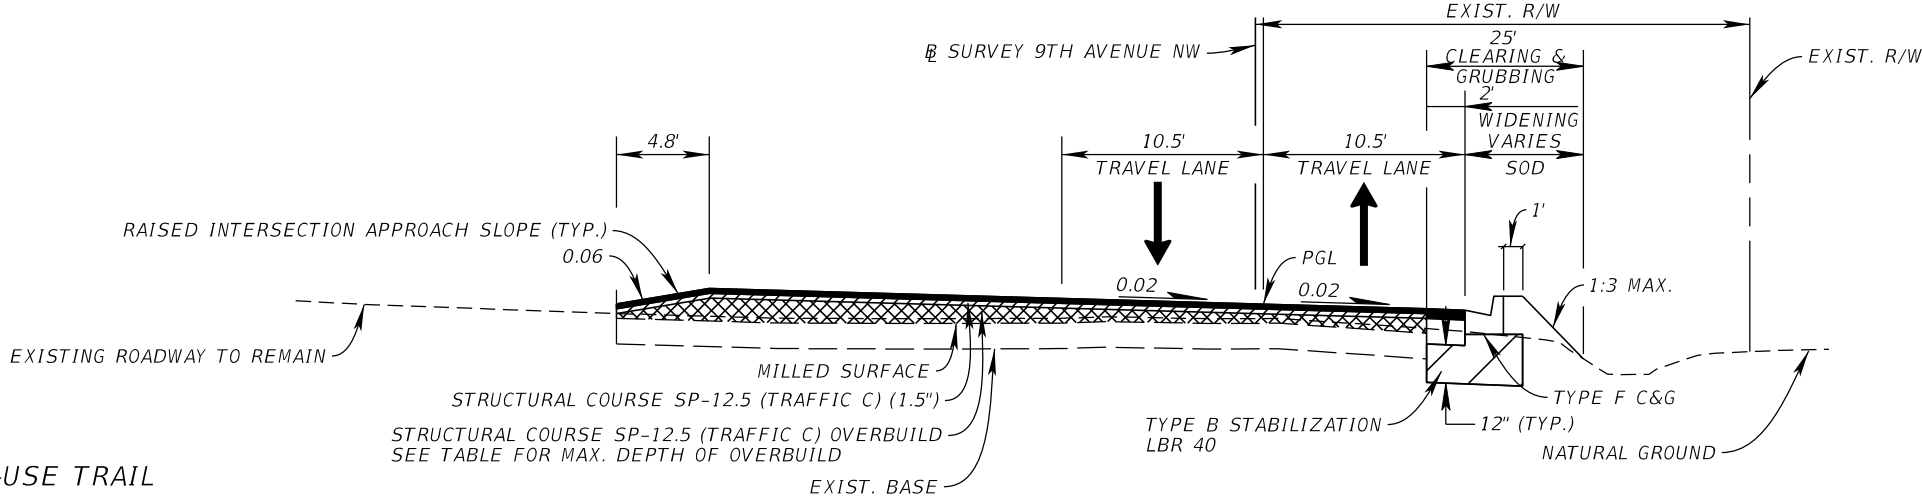
Susan.Pluta

THE OFFICIAL RECORD OF THIS SHEET IS THE ELECTRONIC FILE DIGITALLY SIGNED AND SEALED UNDER RULE 61G15-23.004, F.A.C.

OVERBUILD DETAILS					
STATION	EXIST. SLOPE (%)	PROP. SLOPE (%)	MAX. DEPTH OF OVERBUILD (IN.)	WIDTH OF OVERBUILD (FT.)	AREA OF OVERBUILD (SQ. FT.)
92ND RAISED INTERSECTION					
40+40.00	VARIES	VARIES	0.0	0.0	0.0
40+60.00	VARIES	VARIES	2.6	18.3	4.0
40+80.00	VARIES	VARIES	5.9	32.4	15.9
41+00.00	VARIES	VARIES	8.2	60.4	41.1
41+20.00	VARIES	VARIES	7.0	59.1	34.3
41+40.00	VARIES	VARIES	5.0	27.4	11.4
41+60.00	VARIES	VARIES	0.0	0.0	0.0

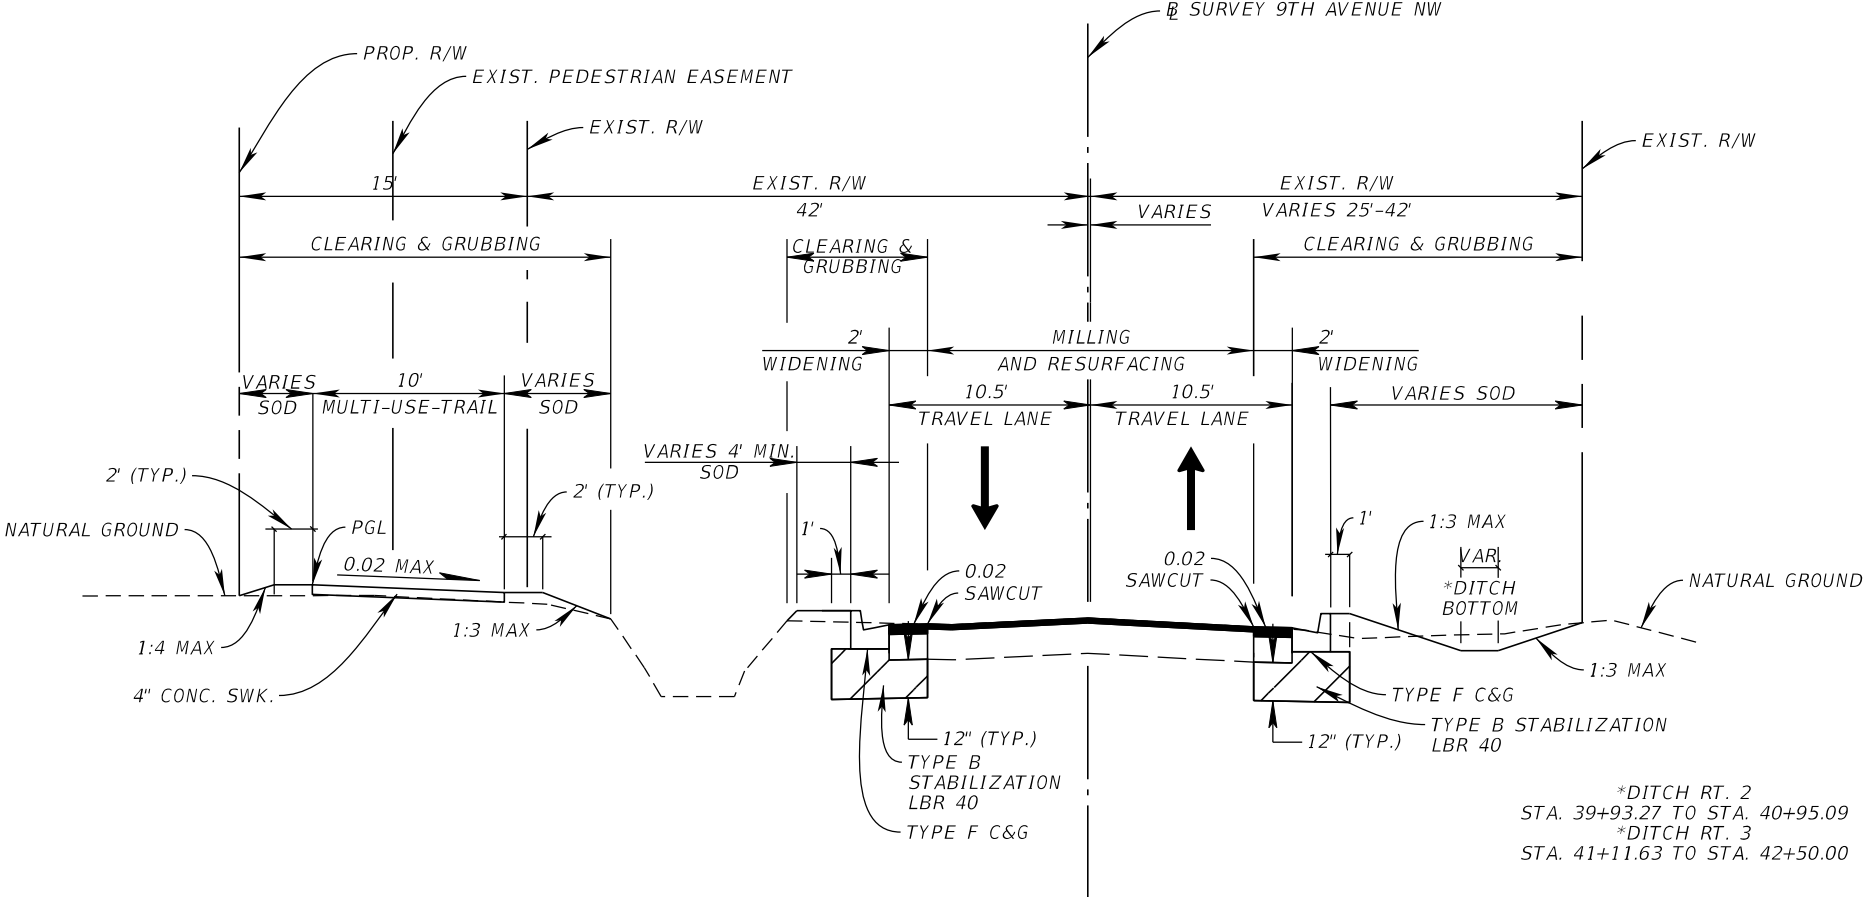

TYPICAL SECTION  
9TH AVENUE NW  
STA. 39+10.00 - STA. 43+40.66



TYPICAL SECTION  
92ND ST - RAISED INTERSECTION  
STA. 40+62.29 - STA. 41+53.17

<b>WIDENING</b>
OPTIONAL BASE GROUP 6
STRUCTURAL COURSE SP-12.5 (TRAFFIC C) (1.5")
FRICTION COURSE FC-12.5 (TRAFFIC C) (1.5") (PG 76-22)
<b>MILLING</b>
MILL EXISTING ASPHALT PAVEMENT (1.5")
<b>RESURFACING</b>
FRICTION COURSE FC-12.5 (TRAFFIC C) (1.5") (PG 76-22)
<b>OVERBUILD</b>
STRUCTURAL COURSE SP-12.5 (TRAFFIC C) (VARIES)
STRUCTURAL COURSE SP-12.5 (TRAFFIC C) (1.5")
FRICTION COURSE FC-12.5 (TRAFFIC C) (1.5") (PG 76-22)

DESIGN SPEED = 18 MPH
TRAFFIC DATA
DESIGN SPEED = 35 MPH
POSTED SPEED = 30 MPH

No.	REVISIONS	DATE	BY

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1800 SECOND STREET, SUITE 900, SARASOTA, FL 34236  
PHONE: 941-379-7600  
WWW.KIMLEY-HORN.COM

KHA PROJECT  
148400070  
DATE  
10/02/2025  
SCALE AS SHOWN  
DESIGNED BY  
DRAWN BY  
CHECKED BY

9TH AVENUE NW

MANATEE COUNTY

LICENSED PROFESSIONAL  
JORDAN E. LEEP, P.E.  
FL LICENSE NUMBER  
76102

FL DATE:

SHEET NUMBER  
10

TYPICAL SECTIONS (2)


Susan.Pluta

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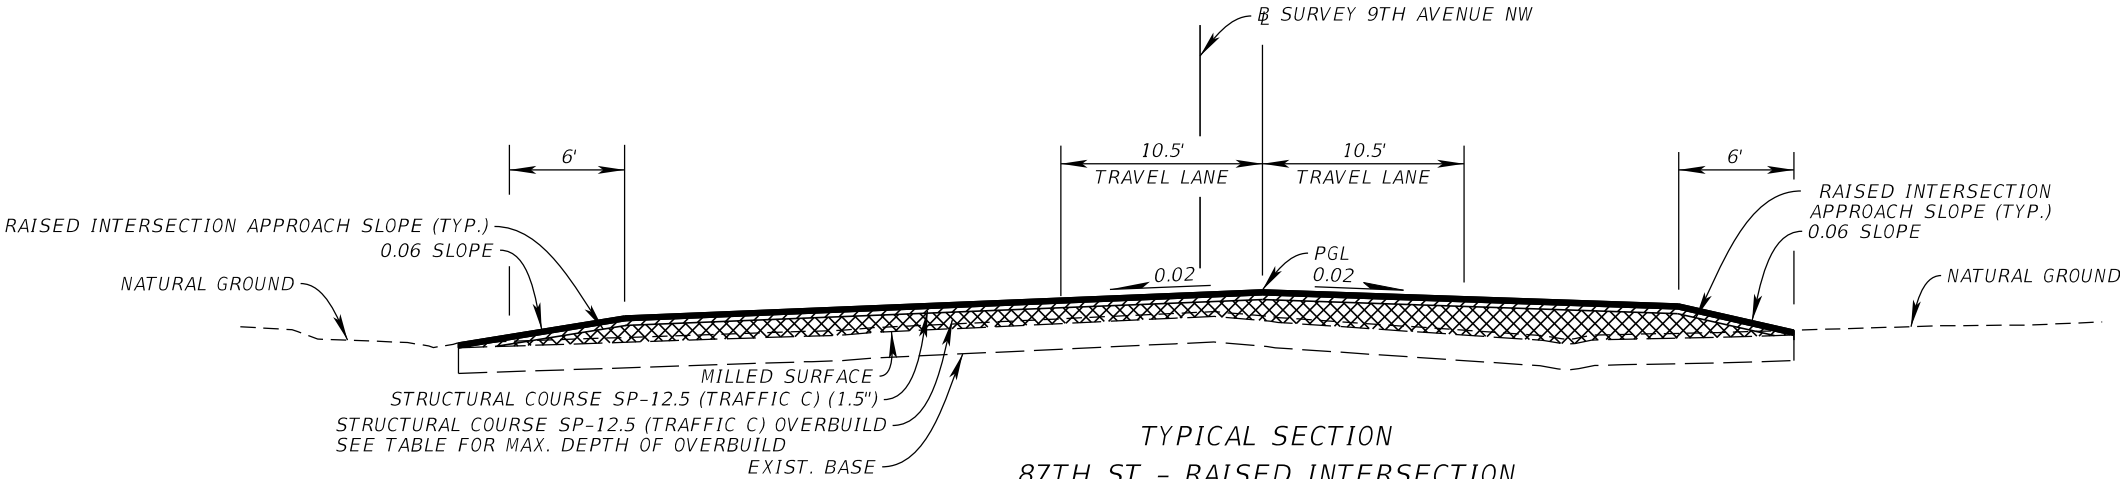
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OVERBUILD DETAILS					
STATION	EXIST. SLOPE (%)	PROP. SLOPE (%)	MAX. DEPTH OF OVERBUILD (IN.)	WIDTH OF OVERBUILD (FT.)	AREA OF OVERBUILD (SQ. FT.)
87TH RAISED INTERSECTION					
54+20.00	VARIES	VARIES	0.0	0.0	0.0
54+40.00	VARIES	VARIES	0.8	17.0	1.2
54+60.00	VARIES	VARIES	2.0	17.0	2.8
54+80.00	VARIES	VARIES	4.0	17.7	5.9
55+00.00	VARIES	VARIES	8.0	27.7	18.5
55+20.00	VARIES	VARIES	9.0	62.0	46.5
55+40.00	VARIES	VARIES	10.2	80.7	68.6
55+60.00	VARIES	VARIES	8.2	44.7	30.6
55+80.00	VARIES	VARIES	0.0	0.0	0.0



TYPICAL SECTION  
9TH AVENUE NW  
STA. 43+40.66 - STA. 54+22.00

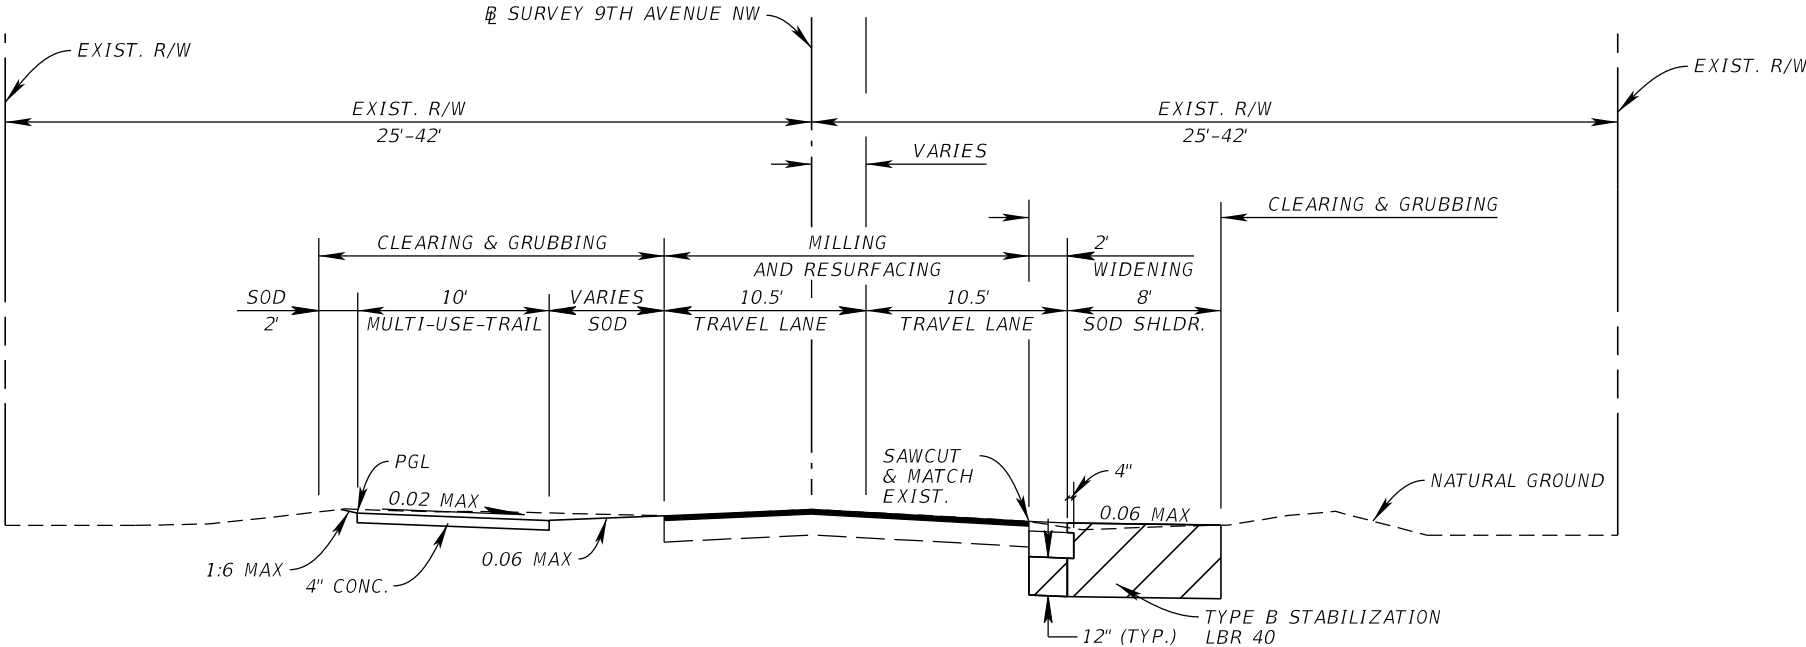


TYPICAL SECTION  
87TH ST - RAISED INTERSECTION  
STA. 54+22.00 - STA. 55+78.00

MILLING
MILL EXISTING ASPHALT PAVEMENT (1.5")
RESURFACING
FRICTION COURSE FC-12.5 (TRAFFIC C) (1.5") (PG 76-22)
WIDENING
OPTIONAL BASE GROUP 6
STRUCTURAL COURSE SP-12.5 (TRAFFIC C) (1.5")
FRICTION COURSE FC-12.5 (TRAFFIC C) (1.5") (PG 76-22)
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STRUCTURAL COURSE SP-12.5 (TRAFFIC C) (1.5")
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MULTI-USE TRAIL
DESIGN SPEED = 18 MPH
TRAFFIC DATA
DESIGN SPEED = 35 MPH
POSTED SPEED = 30 MPH

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THE OFFICIAL RECORD OF THIS SHEET IS THE ELECTRONIC FILE DIGITALLY SIGNED AND SEALED UNDER RULE 61G15-23.004, F.A.C.



TYPICAL SECTION  
9TH AVENUE NW  
STA. 55+78.00 - STA. 56+60.61

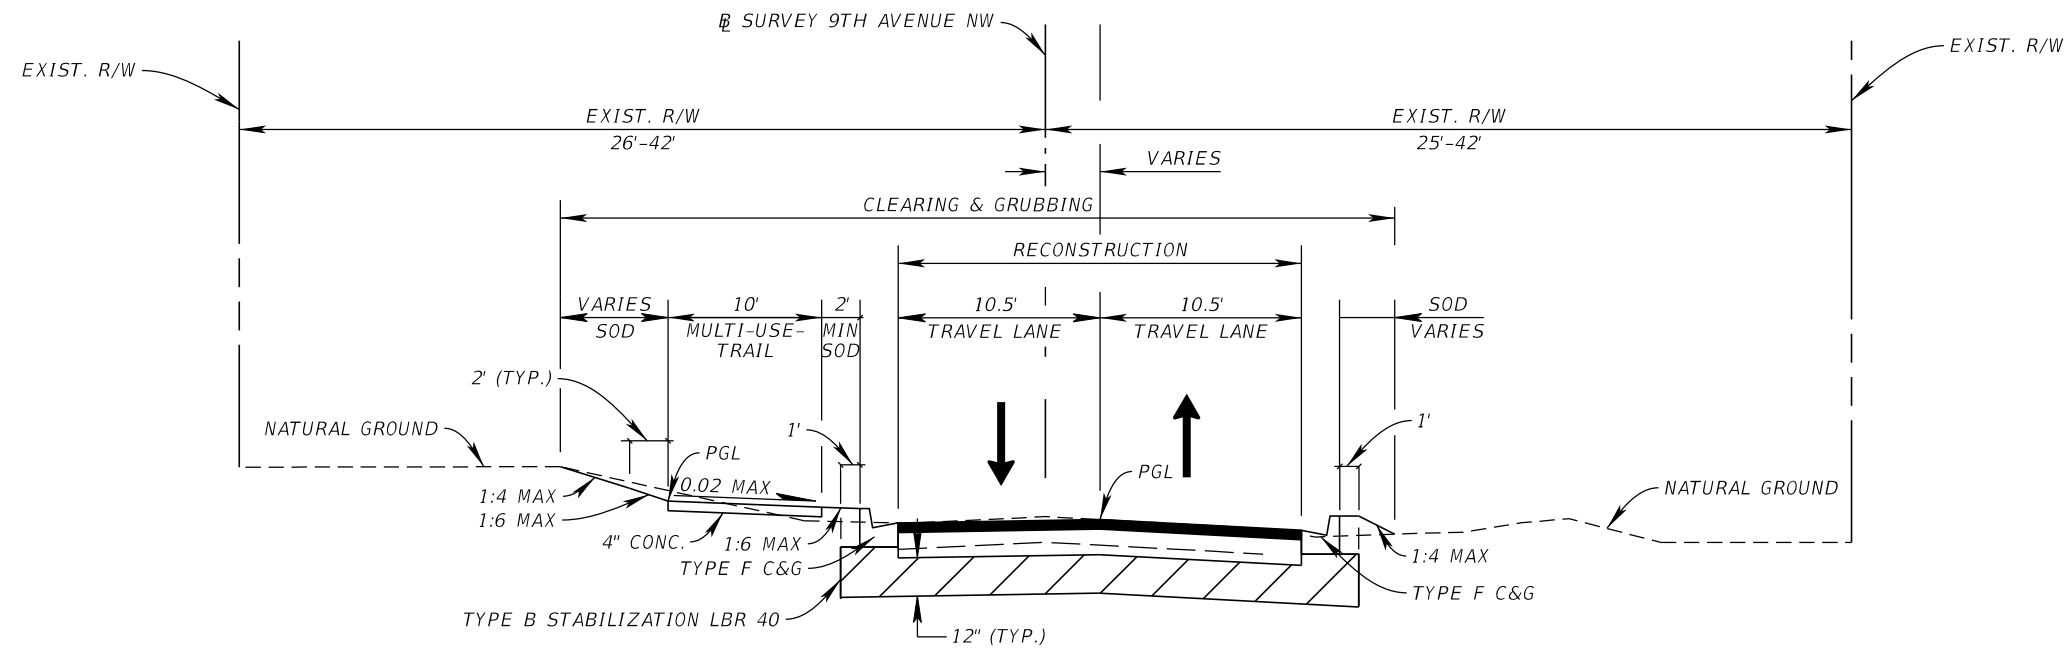MULTI-USE TRAIL

DESIGN SPEED = 18 MPH

TRAFFIC DATA

DESIGN SPEED = 35 MPH  
POSTED SPEED = 30 MPH

RECONSTRUCTION

OPTIONAL BASE GROUP 6

STRUCTURAL COURSE SP-12.5 (TRAFFIC C) (1.5")

FRICTION COURSE FC-12.5 (TRAFFIC C) (1.5") (PG 76-22)

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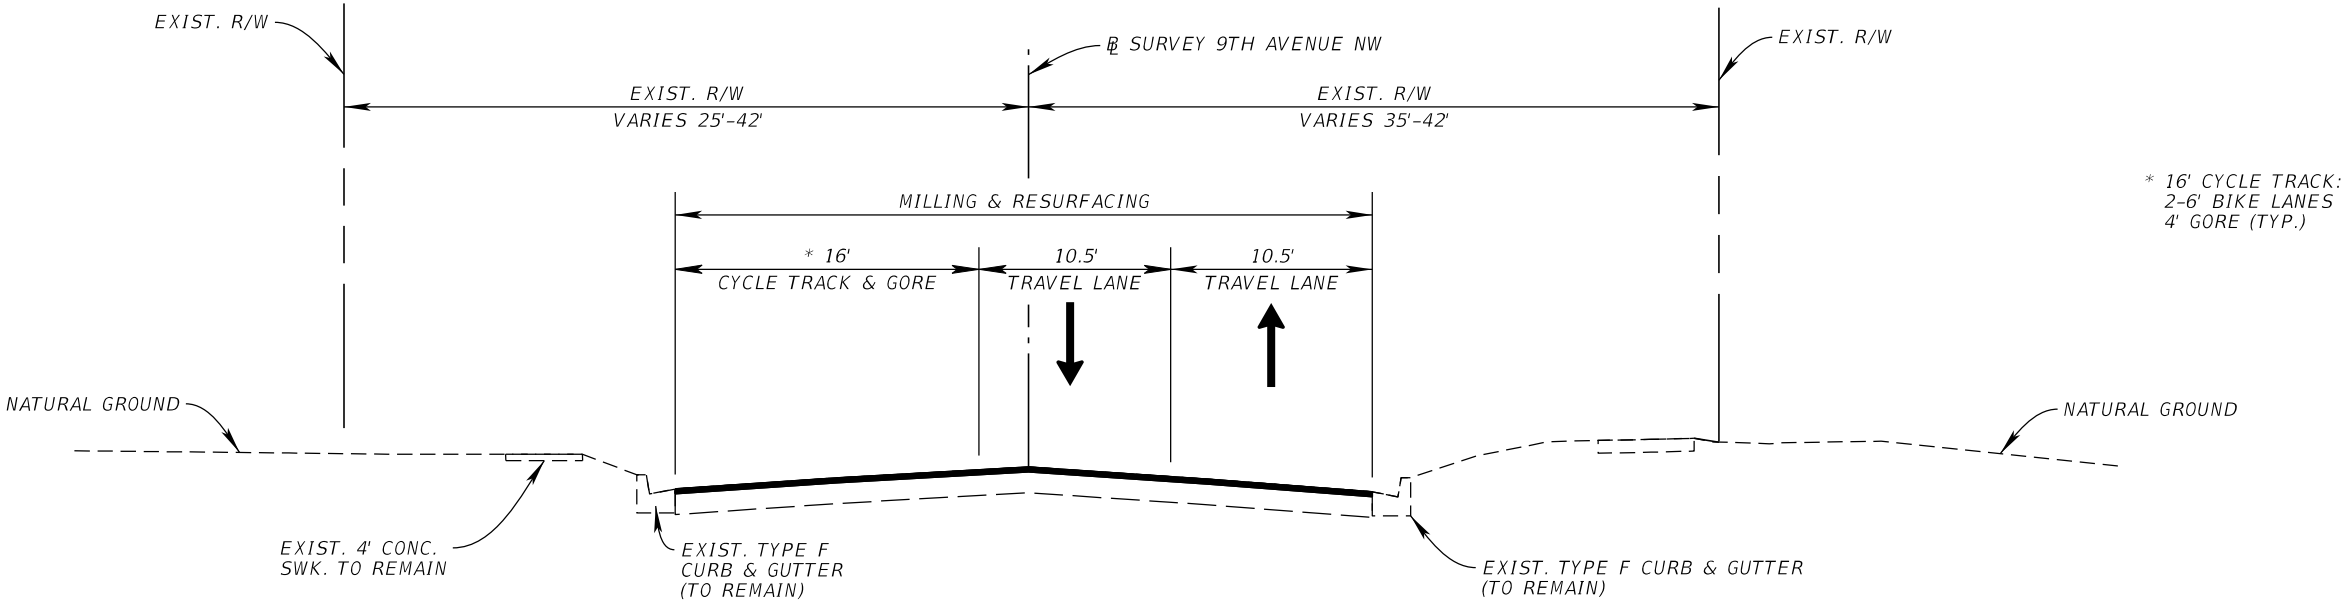
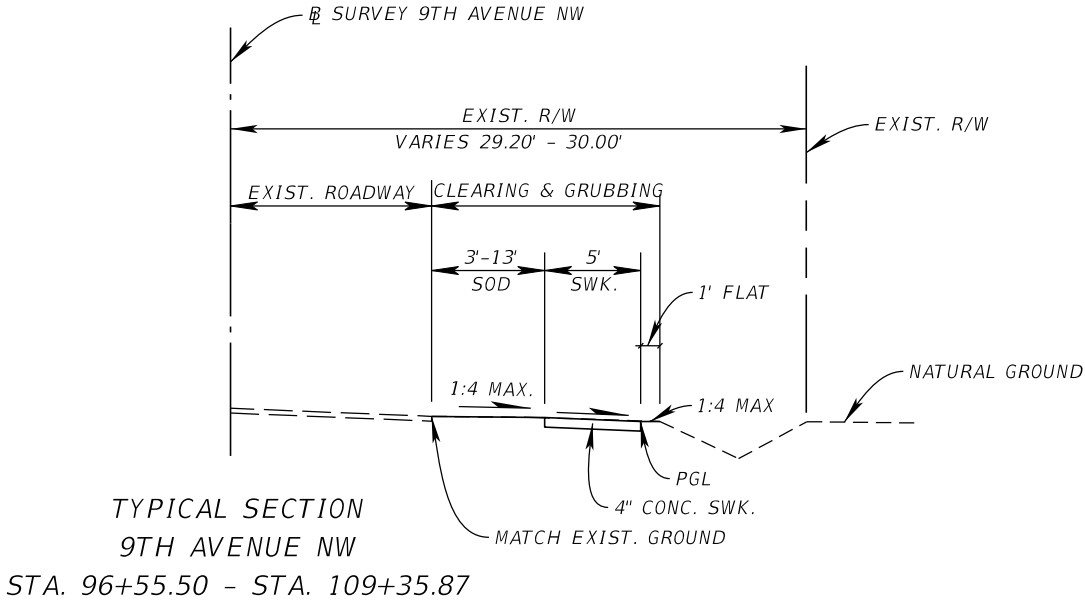
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THE OFFICIAL RECORD OF THIS SHEET IS THE ELECTRONIC FILE DIGITALLY SIGNED AND SEALED UNDER RULE 61G15-23.004, F.A.C.




TYPICAL SECTION  
9TH AVENUE NW  
STA. 56+60.61 - STA. 71+71.17  
STA. 74+98.53 - STA. 83+14.38


MILLING  
MILL EXISTING ASPHALT PAVEMENT (1.5")  
RESURFACING  
FRICTION COURSE FC-12.5 (TRAFFIC C) (1.5") (PG 76-22)

TRAFFIC DATA

DESIGN SPEED = 35 MPH  
POSTED SPEED = 30 MPH

				<div>Kimley»Horn</div> <div>© 2025 KIMLEY-HORN AND ASSOCIATES, INC. 1800 SECOND STREET, SUITE 900, SARASOTA, FL 34236 PHONE: 941-379-7600 WWW.KIMLEY-HORN.COM</div>	<div>KHA PROJECT 148400070</div> <div>DATE 10/02/2025</div> <div>SCALE AS SHOWN</div> <div>DESIGNED BY</div> <div>DRAWN BY</div> <div>CHECKED BY</div>		<div></div> <div>9TH AVENUE NW</div> <div>MANATEE COUNTY</div>	<div>LICENSED PROFESSIONAL</div> <div>JORDAN E. LEEP, P.E.</div> <div>FL LICENSE NUMBER 76102</div>	<div>TYPICAL SECTIONS (5)</div>	<div>SHEET NUMBER</div> <div>13</div>
No.	REVISIONS	DATE	BY							



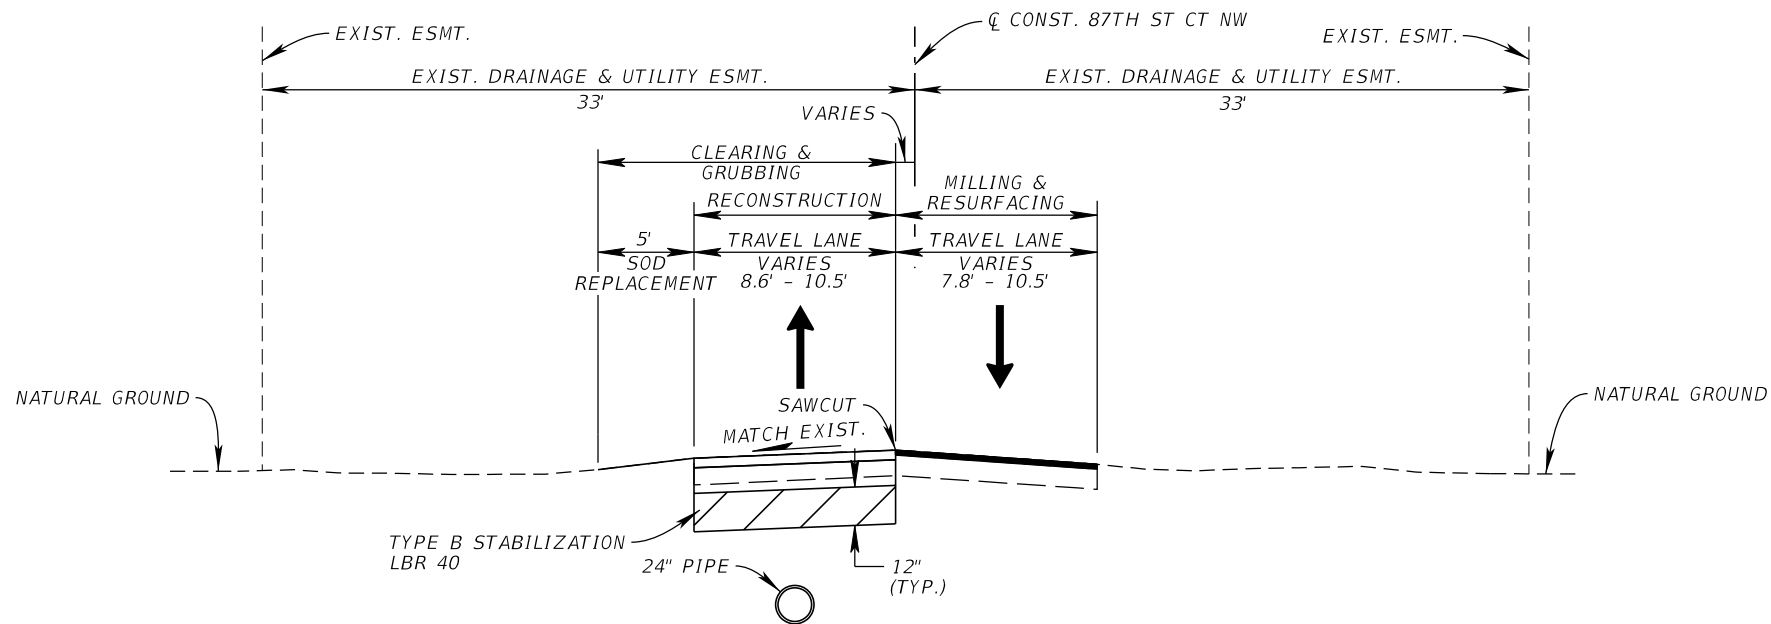

TRAFFIC DATA

DESIGN SPEED = 25 MPH  
POSTED SPEED = 25 MPH

TYPICAL SECTION  
87TH ST CT NW  
STA. 10+35.77 - STA. 17+59.50

RECONSTRUCTION

OPTIONAL BASE GROUP 6  
STRUCTURAL COURSE SP-12.5 (TRAFFIC C) (1.5")  
FRICTION COURSE FC-12.5 (TRAFFIC C) (1.5") (PG 76-22)

MILLING

MILL EXISTING ASPHALT PAVEMENT (1.5")

RESURFACING

FRICTION COURSE FC-12.5 (TRAFFIC C) (1.5") (PG 76-22)

TYPICAL SECTIONS (7)

				<div>Kimley»Horn</div> <div>© 2025 KIMLEY-HORN AND ASSOCIATES, INC. 1800 SECOND STREET, SUITE 900, SARASOTA, FL 34236 PHONE: 941-379-7600 WWW.KIMLEY-HORN.COM</div>	<div>KHA PROJECT 148400070</div> <div>DATE 10/02/2025</div> <div>SCALE AS SHOWN</div> <div>DESIGNED BY</div> <div>DRAWN BY</div> <div>CHECKED BY</div>		<div></div> <div>9TH AVENUE NW</div> <div>MANATEE COUNTY</div>	<div>LICENSED PROFESSIONAL</div> <div>JORDAN E. LEEP, P.E.</div> <div>FL LICENSE NUMBER 76102</div>		SHEET NUMBER  15
No.	REVISIONS	DATE	BY							



QUANTITY	STR. NO.	STATION	SIDE	DESCRIPTION	BARRELS	REINFORCED CONCRETE PIPE CLASS III										CURB INLETS					MANHOLE			DITCH BOTTOM INLETS			GUTTER INLET S	SIDE DRAIN MITERED END SECTION										U-TYPE CONCRETE EDNWALL	STRAIGHT CONCRETE ENDWALL		SODDING	REMARKS																																																																																																																																																																																																																																																																																																																																																																																																																																																																																																																																																																																																																																																																																																																																																																																																																																																																																																																																																																																																																																																																																																																																																																																																						
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*Susan.Pluta*

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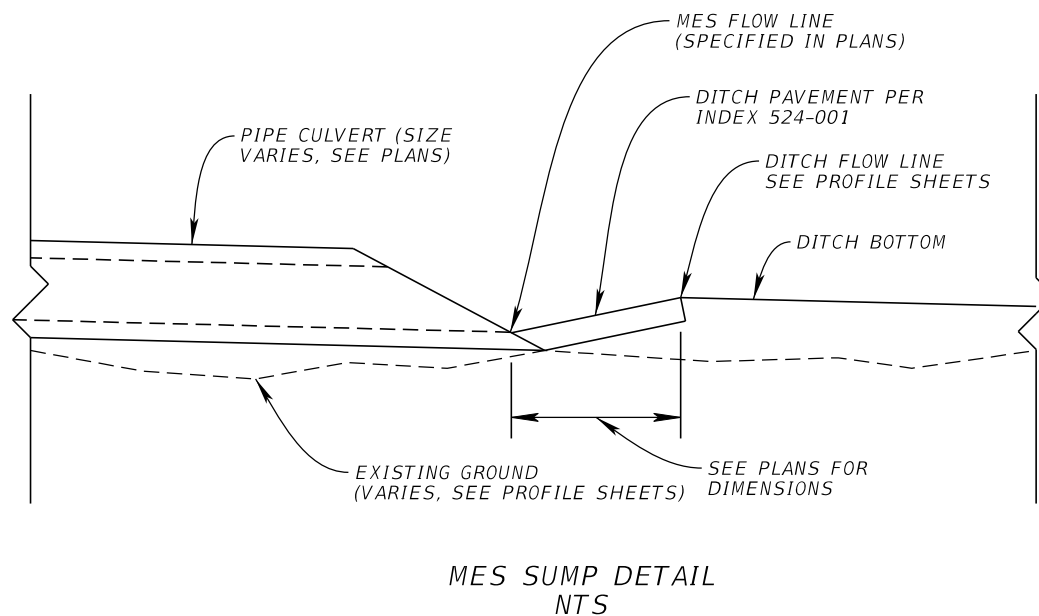
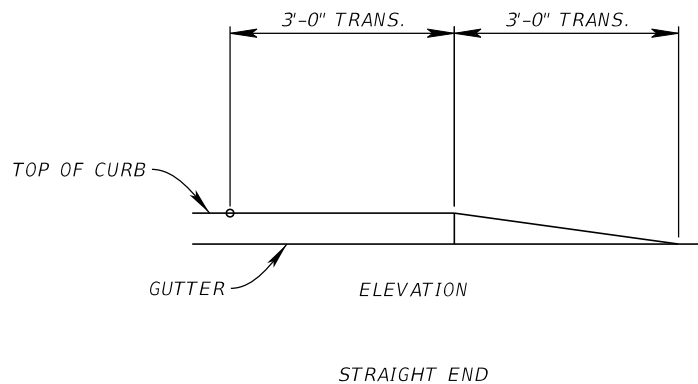
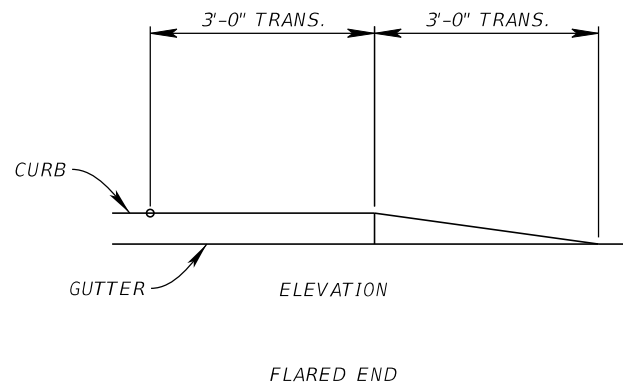
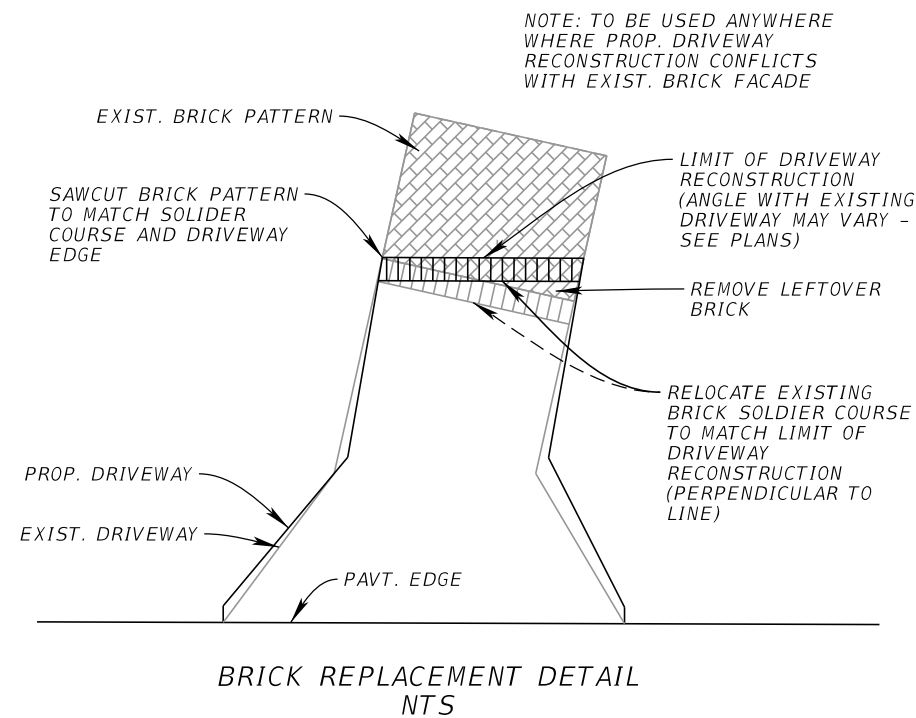
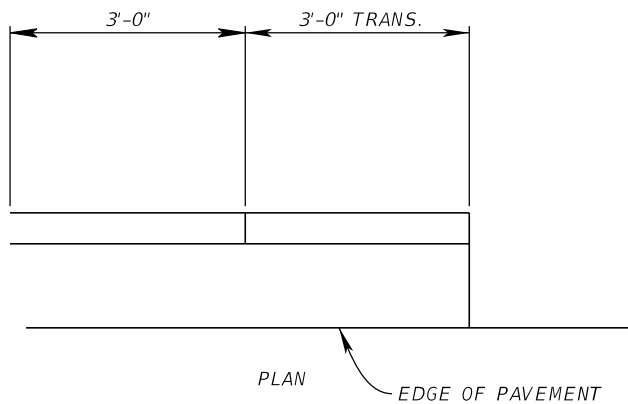
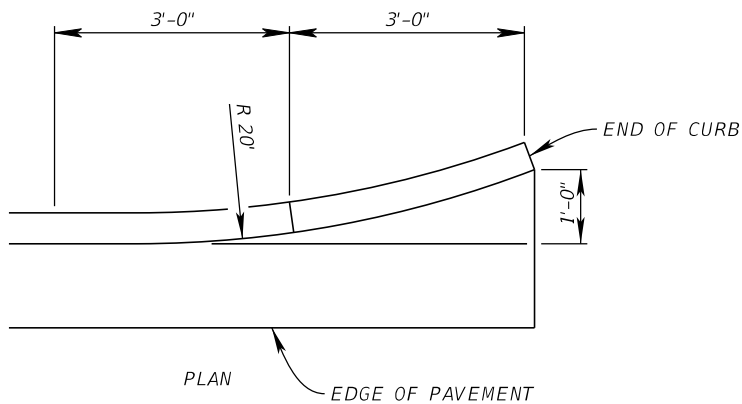
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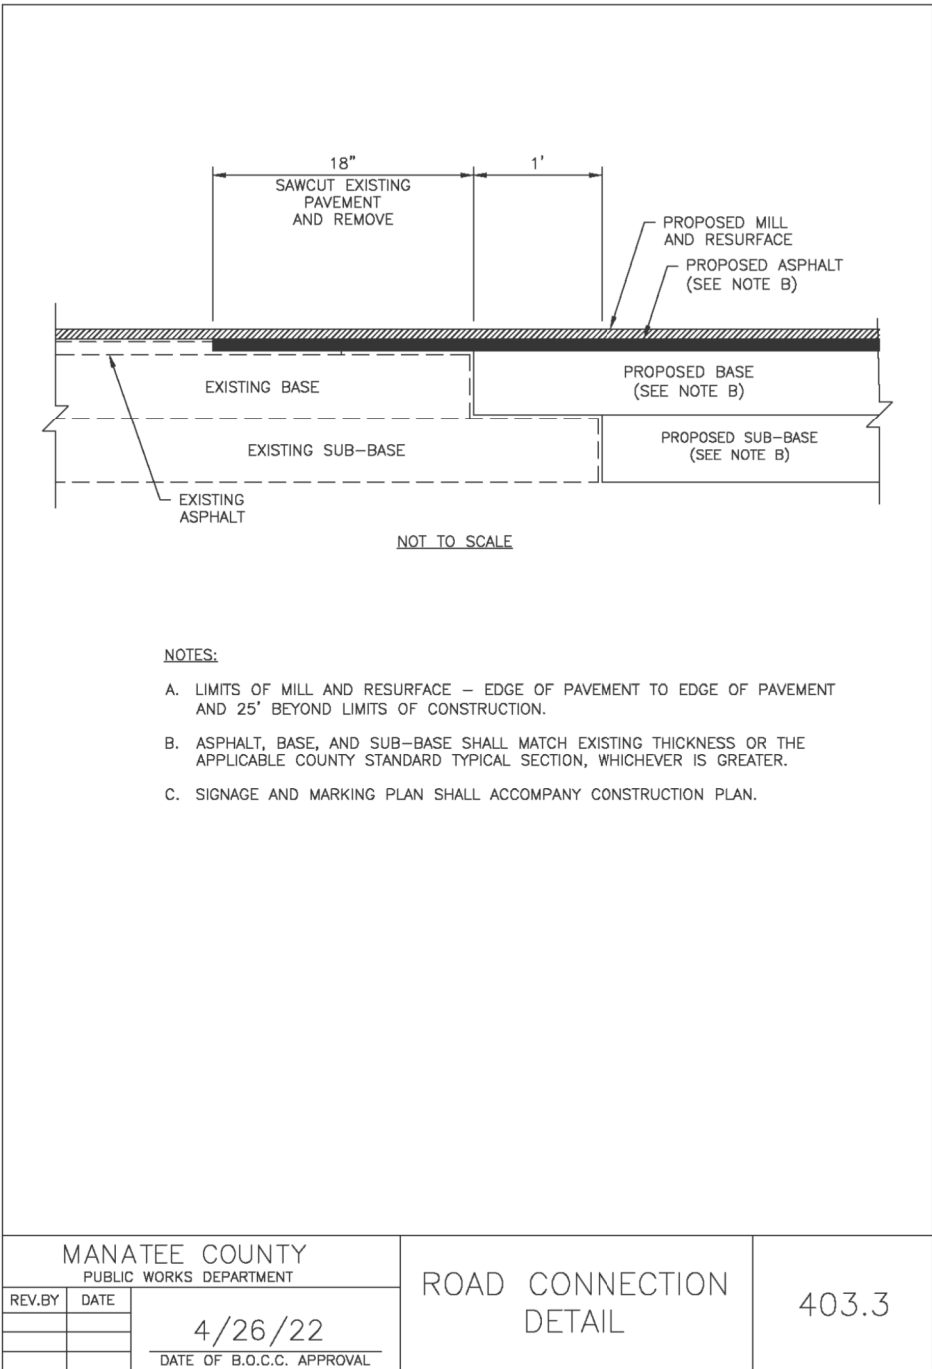
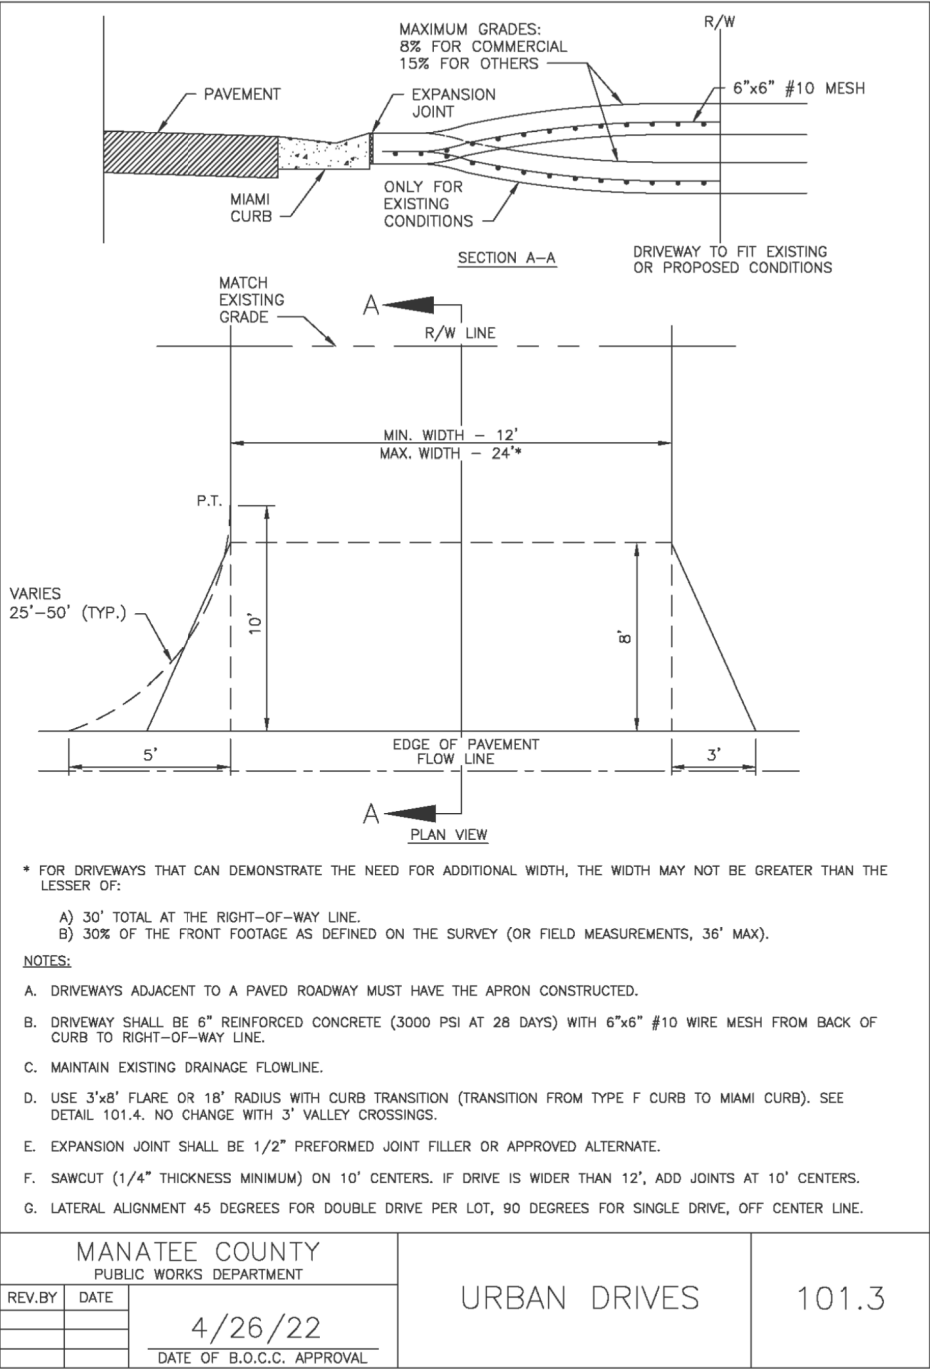
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THE OFFICIAL RECORD OF THIS SHEET IS THE ELECTRONIC FILE DIGITALLY SIGNED AND SEALED UNDER RULE 61G15-23.004, F.A.C.





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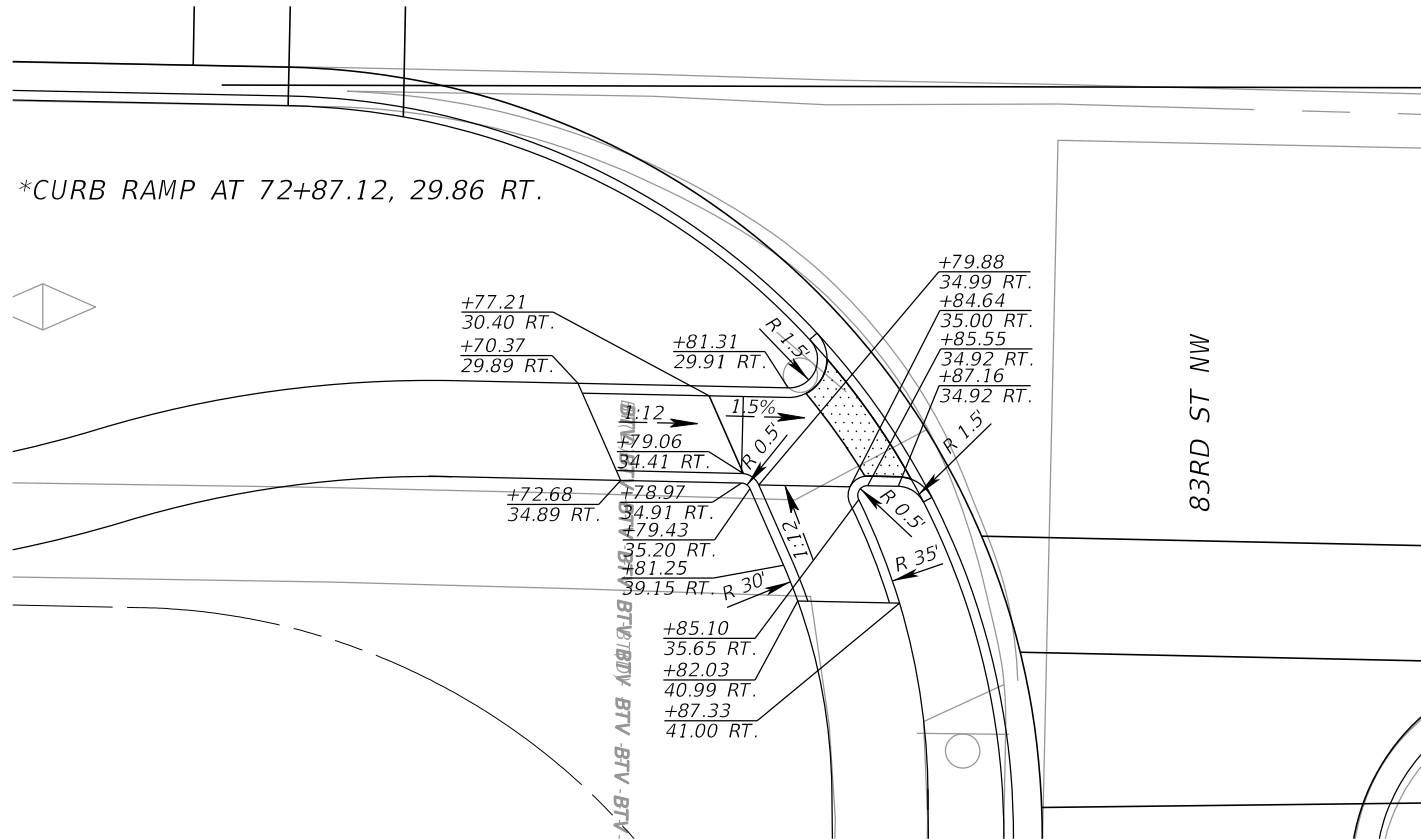


~~\*CURB RAMP AT 72+87.98, 25.64 LT.~~


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\*CURB RAMP AT 72+87.12, 29.86 RT.

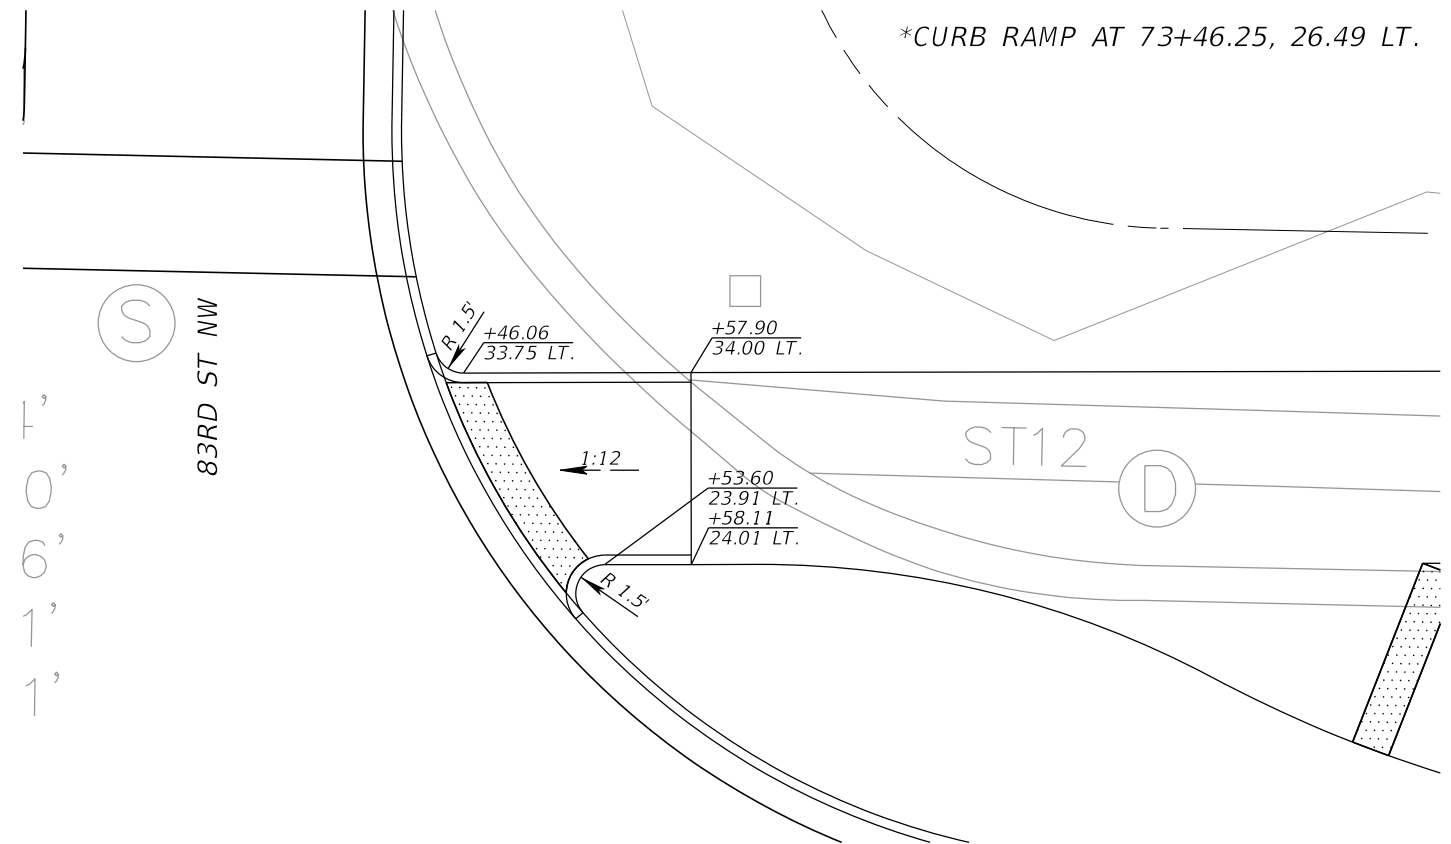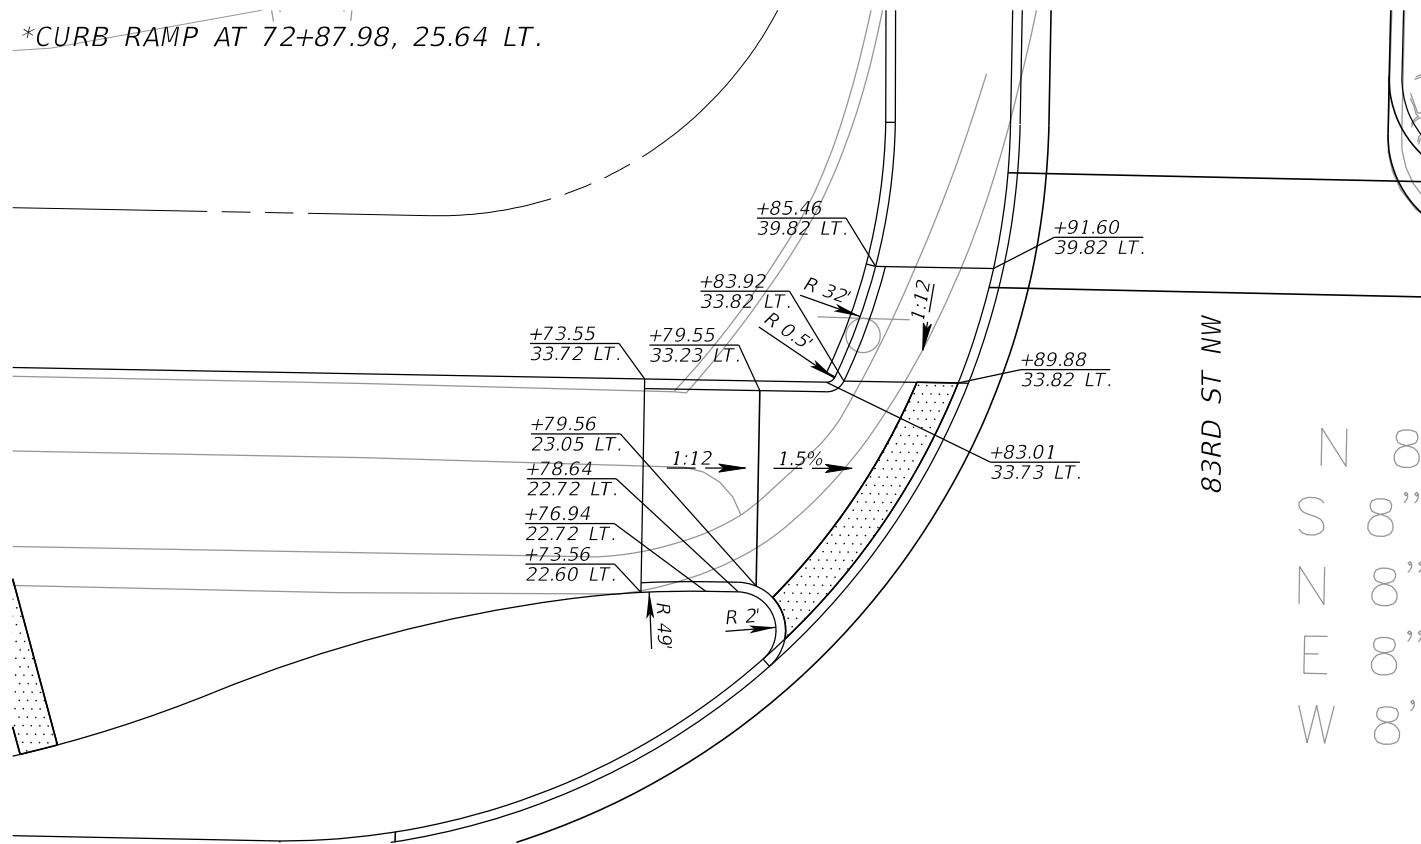

\*CURB RAMP AT 73+57.10, 30.00 RT.



No.	REVISIONS	DATE	BY

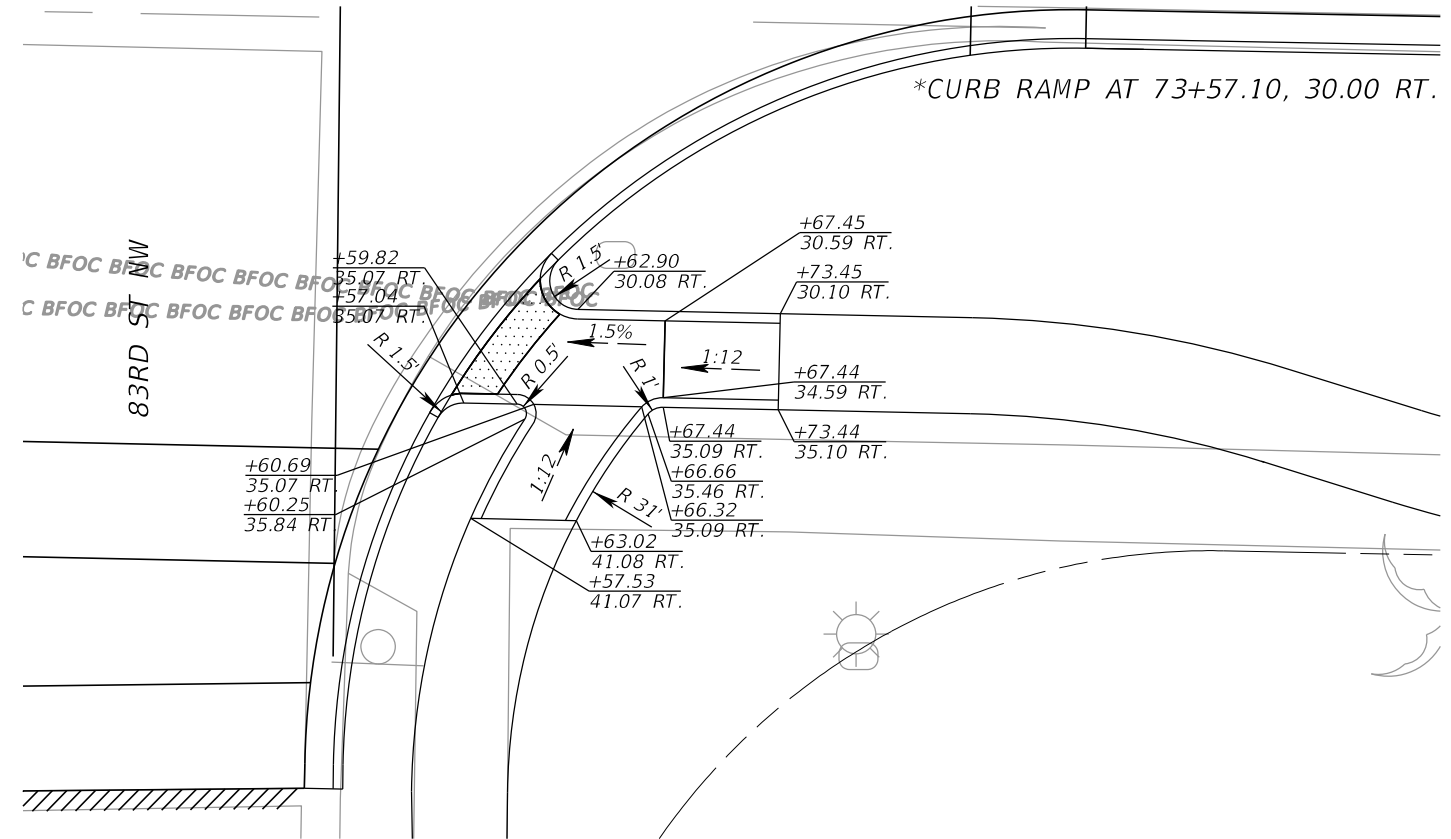**Kimley»Horn**

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1800 SECOND STREET, SUITE 900, SARASOTA, FL 34236  
PHONE: 941-379-7600  
WWW.KIMLEY-HORN.COM

KHA PROJECT 148400070
DATE 10/02/2025
SCALE AS SHOWN
DESIGNED BY
DRAWN BY
CHECKED BY



9TH AVENUE NW




LICENSED PROFESSIONAL

JORDAN E.  
LEEP, P.E.  
FL LICENSE NUMBER  
76102


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*83RD ST. NW*

SHEET NUMBER

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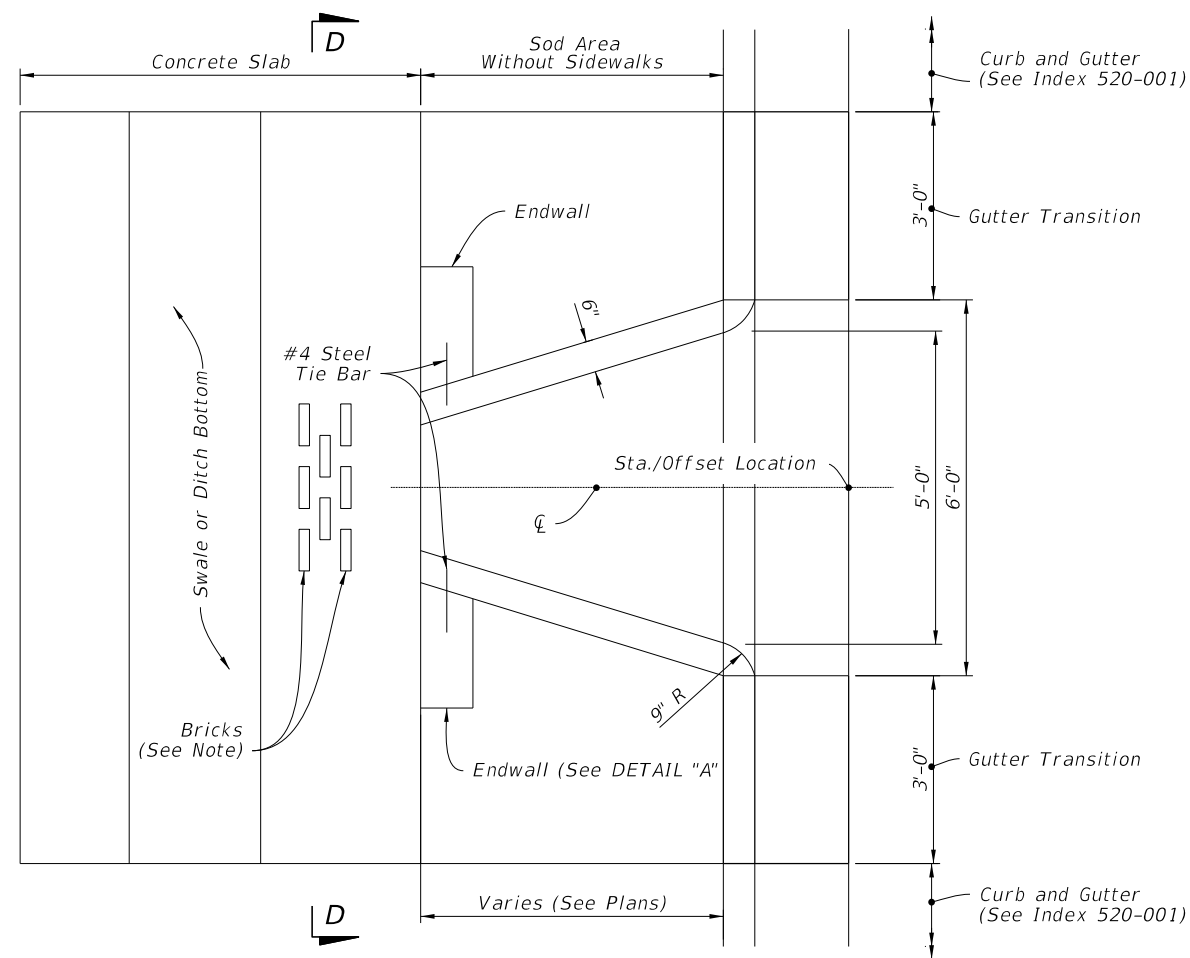

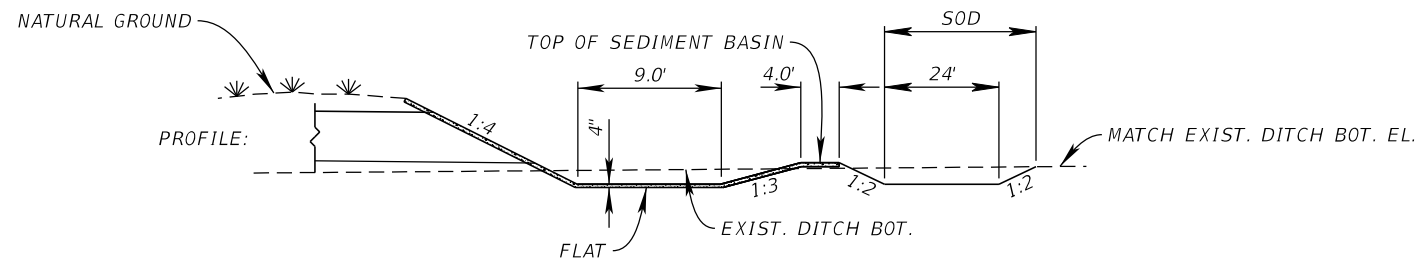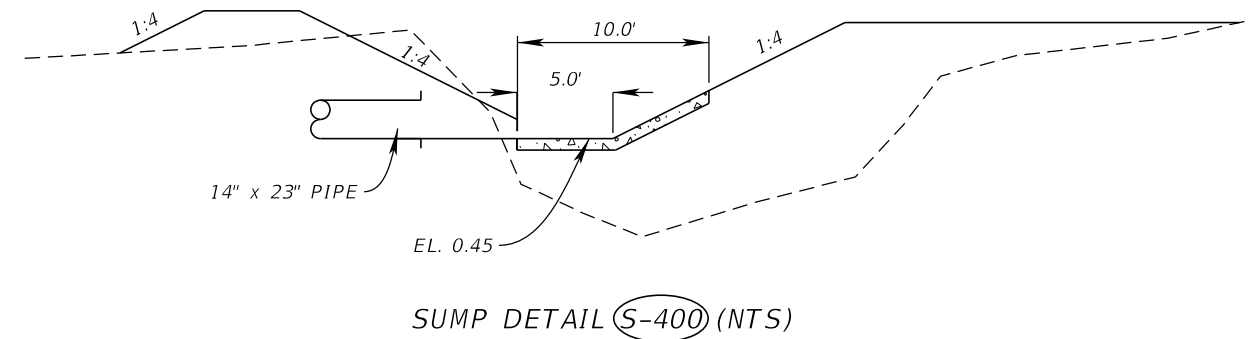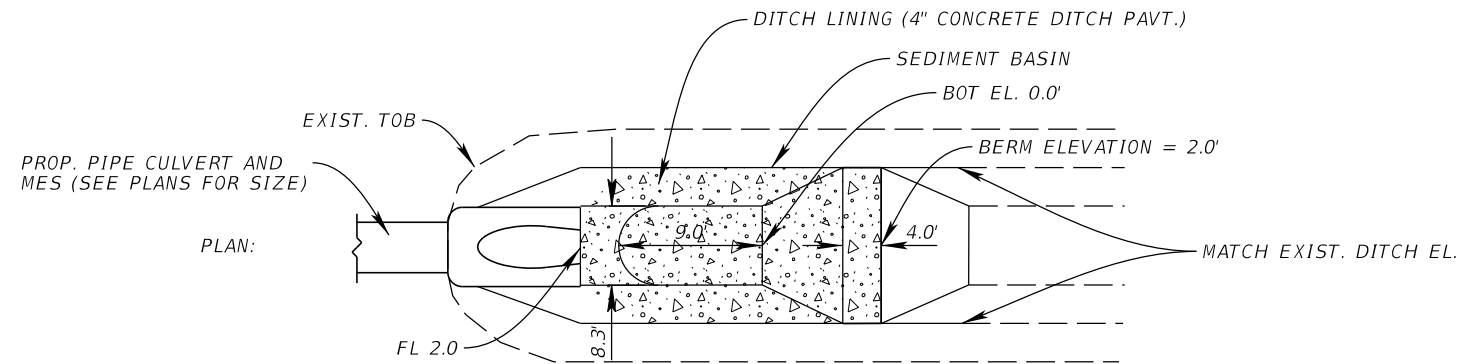
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STA. 43+40.00

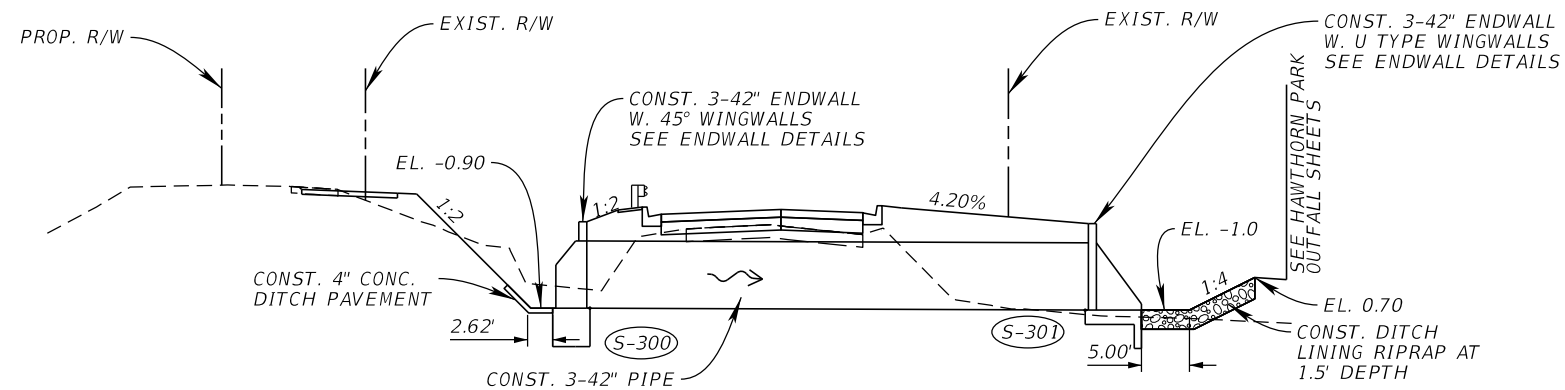


CROSS DRAIN GRADING DETAIL AT STA. 36+80.00 (NTS)


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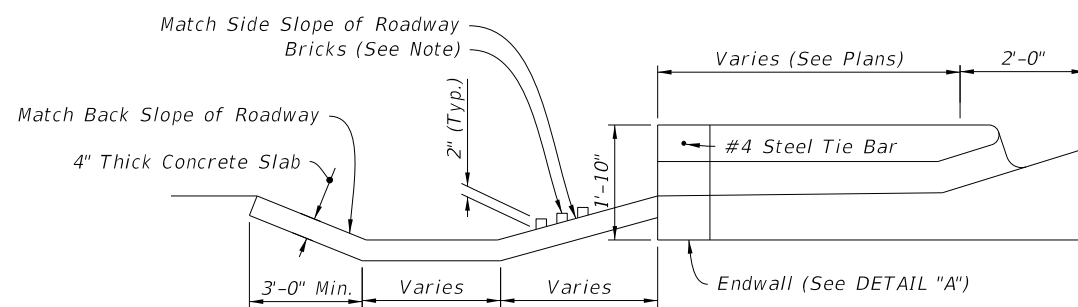
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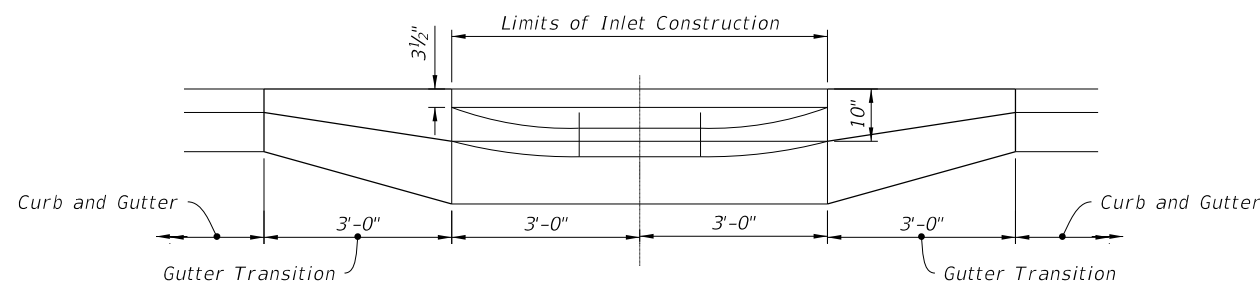
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SECTION D-D



SIDE ELEVATION



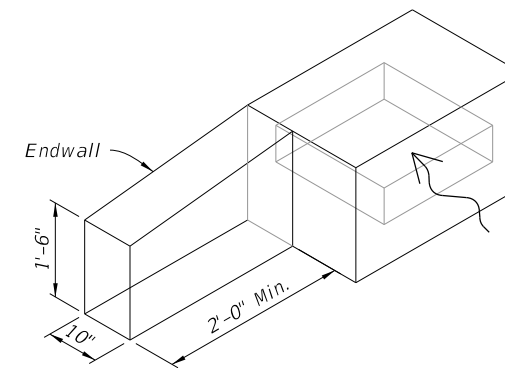


FRONT ELEVATION



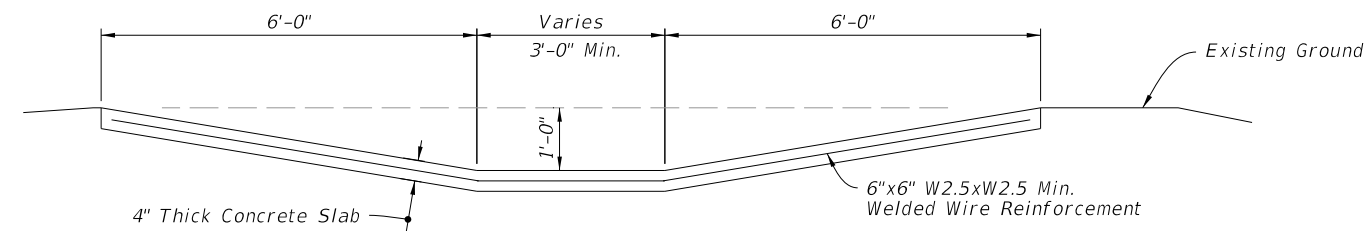
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### ENDWALL WITH 45° WINGS



### ENDWALL WITH U-TYPE WINGS

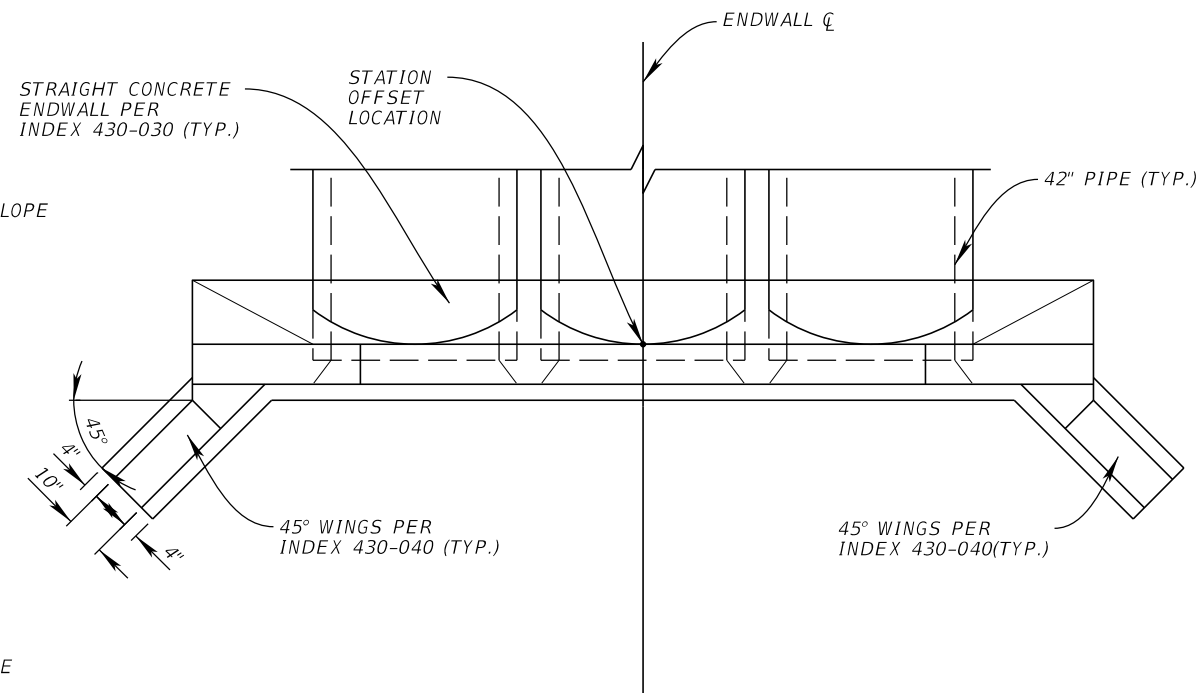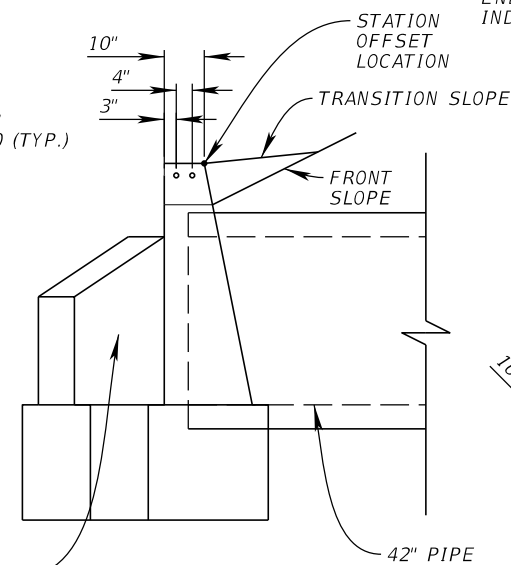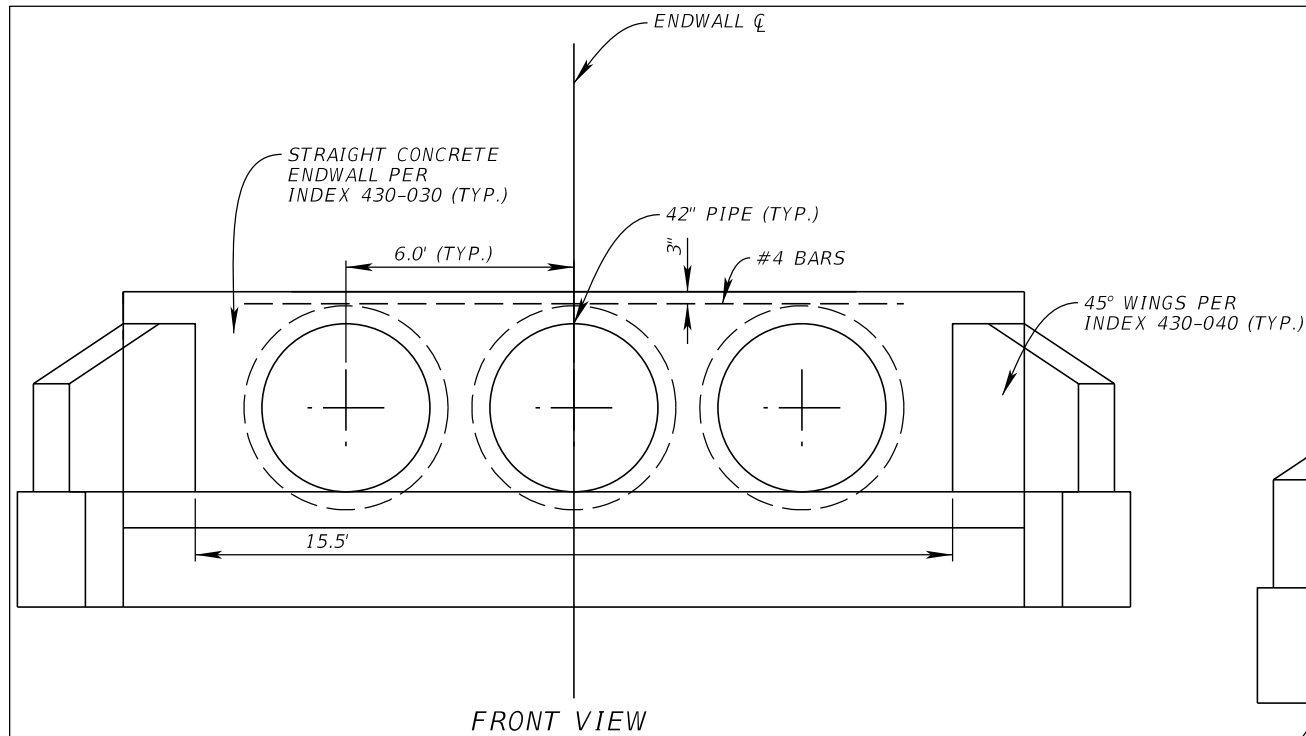No.	REVISIONS	DATE	BY

**Kimley»Horn**
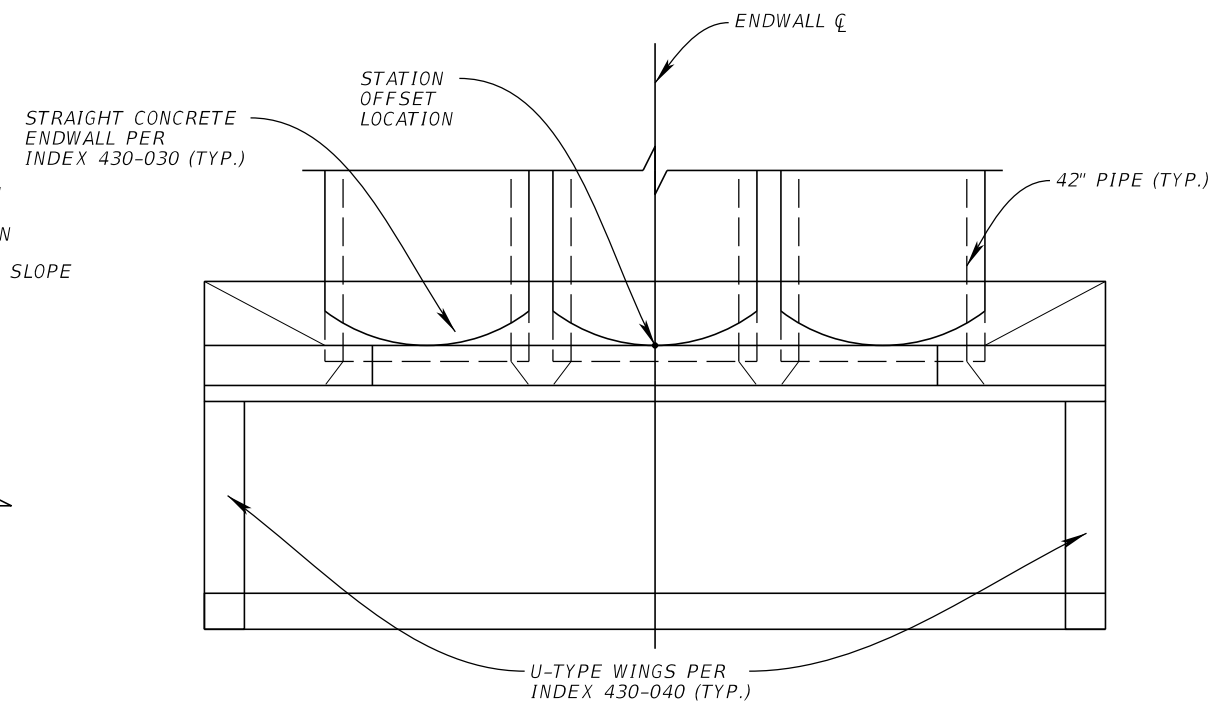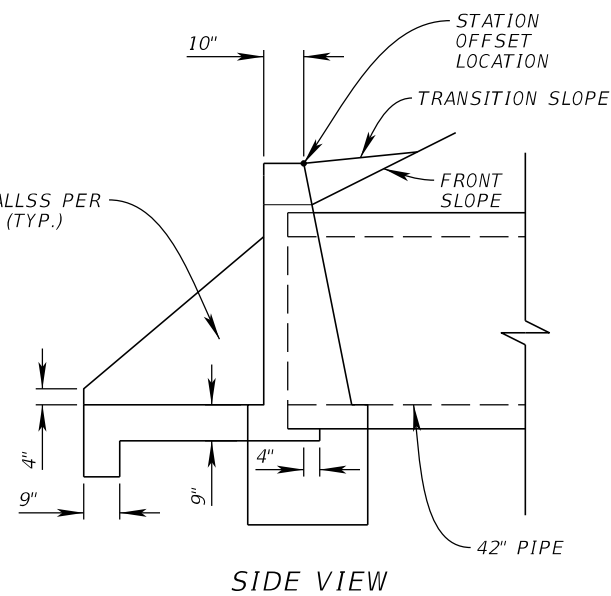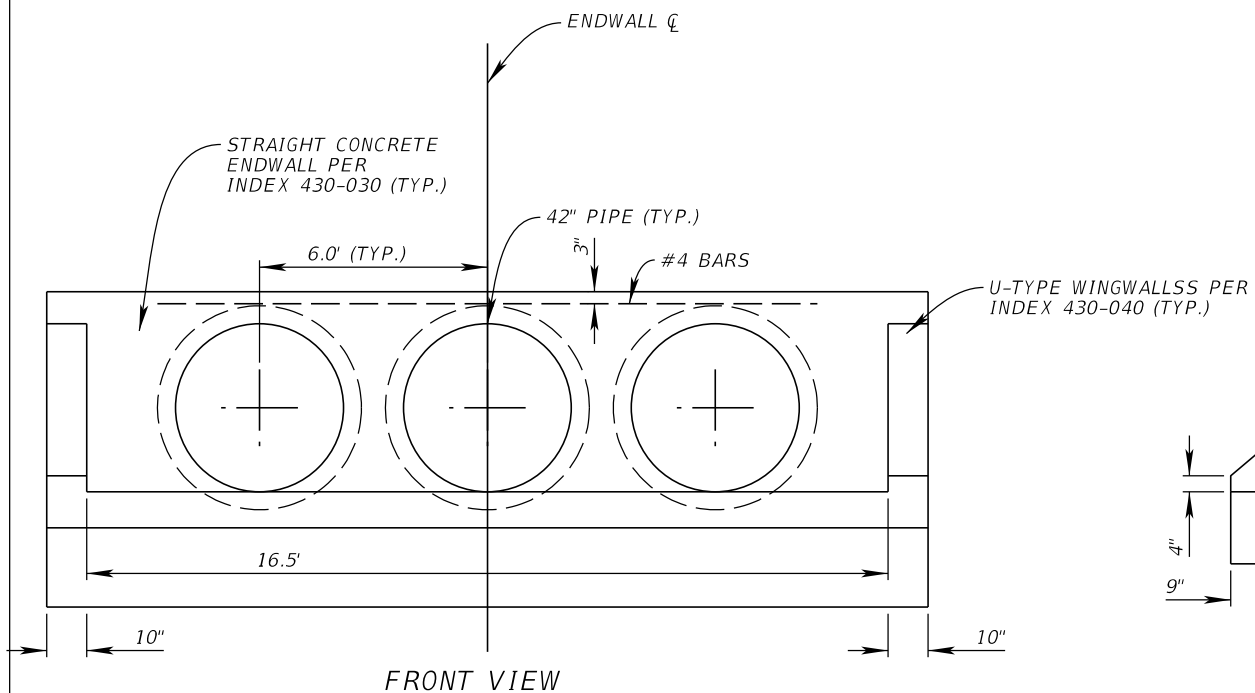
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1800 SECOND STREET, SUITE 900, SARASOTA, FL 34236  
PHONE: 941-379-7600  
WWW.KIMLEY-HORN.COM

KHA PROJECT 148400070
DATE 10/02/2025
SCALE AS SHOWN
DESIGNED BY
DRAWN BY
CHECKED BY



9TH AVENUE NW

MANATEE COUNTY

LICENSED PROFESSIONAL

JORDAN E.  
LEEP, P.E.  
FL LICENSE NUMBER  
76102

FL DATE:

## DRAINAGE DETAILS

SHEET NUMBER


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*Susan.Pluta*


10/1/2025	5:00:56 PM	Default
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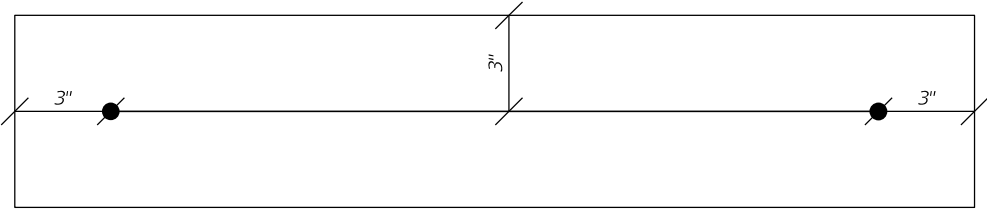
THE OFFICIAL RECORD OF THIS SHEET IS THE ELECTRONIC FILE DIGITALLY SIGNED AND SEALED UNDER RULE 61G15-23.004, F.A.C.



FRONT SECTION VIEW  
N.T.S.

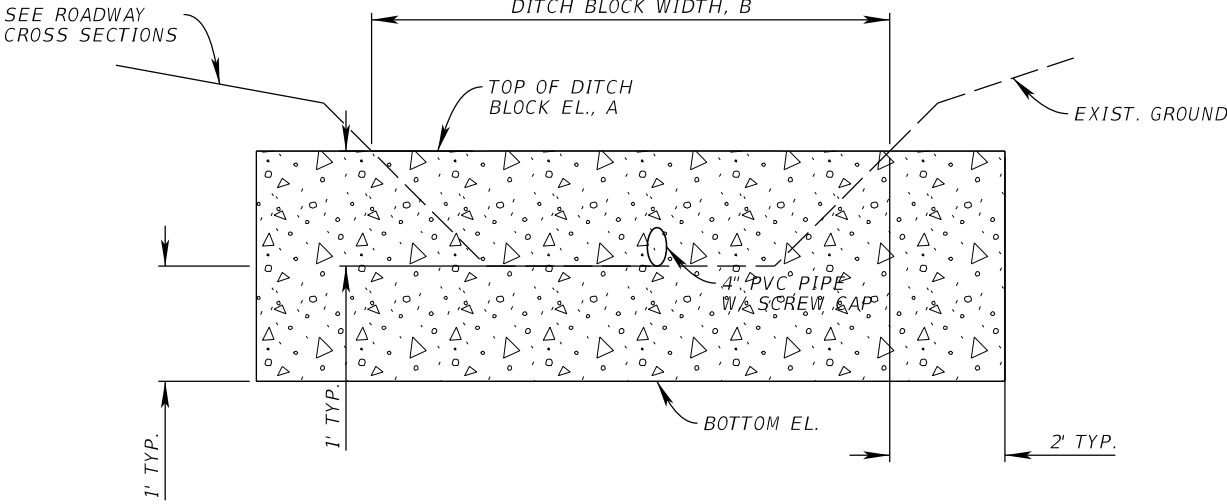

SIDE SECTION VIEW  
N.T.S.

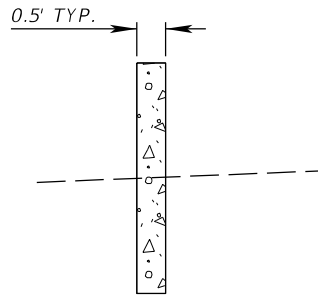

#4 @ 12" O/C EW  
CENTERED IN SLAB

DITCH BLOCK REINFORCEMENT DETAIL  
N.T.S.

STATION	SIDE	TOP OF DITCH BLOCK EL., A	DITCH BLOCK WIDTH, B	CLEANOUT INVERT EL., C	BOTTOM EL.
36+60	LT.	1.4	6.6	0.4	-0.8
37+20	LT.	1.8	7.7	0.8	-0.5

No.

REVISIONS

DATE

BY

**Kimley»Horn**

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1800 SECOND STREET, SUITE 900, SARASOTA, FL 34236  
PHONE: 941-379-7600  
WWW.KIMLEY-HORN.COM

KHA PROJECT  
148400070

DATE  
10/02/2025

SCALE AS SHOWN

DESIGNED BY

DRAWN BY

CHECKED BY

**Manatee County**  
FLORIDA

9TH AVENUE NW

MANATEE COUNTY

LICENSED PROFESSIONAL

JORDAN E. LEEP, P.E.  
FL LICENSE NUMBER 76102

FL


DATE:

SHEET NUMBER

24

**DRAINAGE DETAILS**

THE OFFICIAL RECORD OF THIS SHEET IS THE ELECTRONIC FILE DIGITALLY SIGNED AND SEALED UNDER RULE 61G15-23.004, F.A.C.

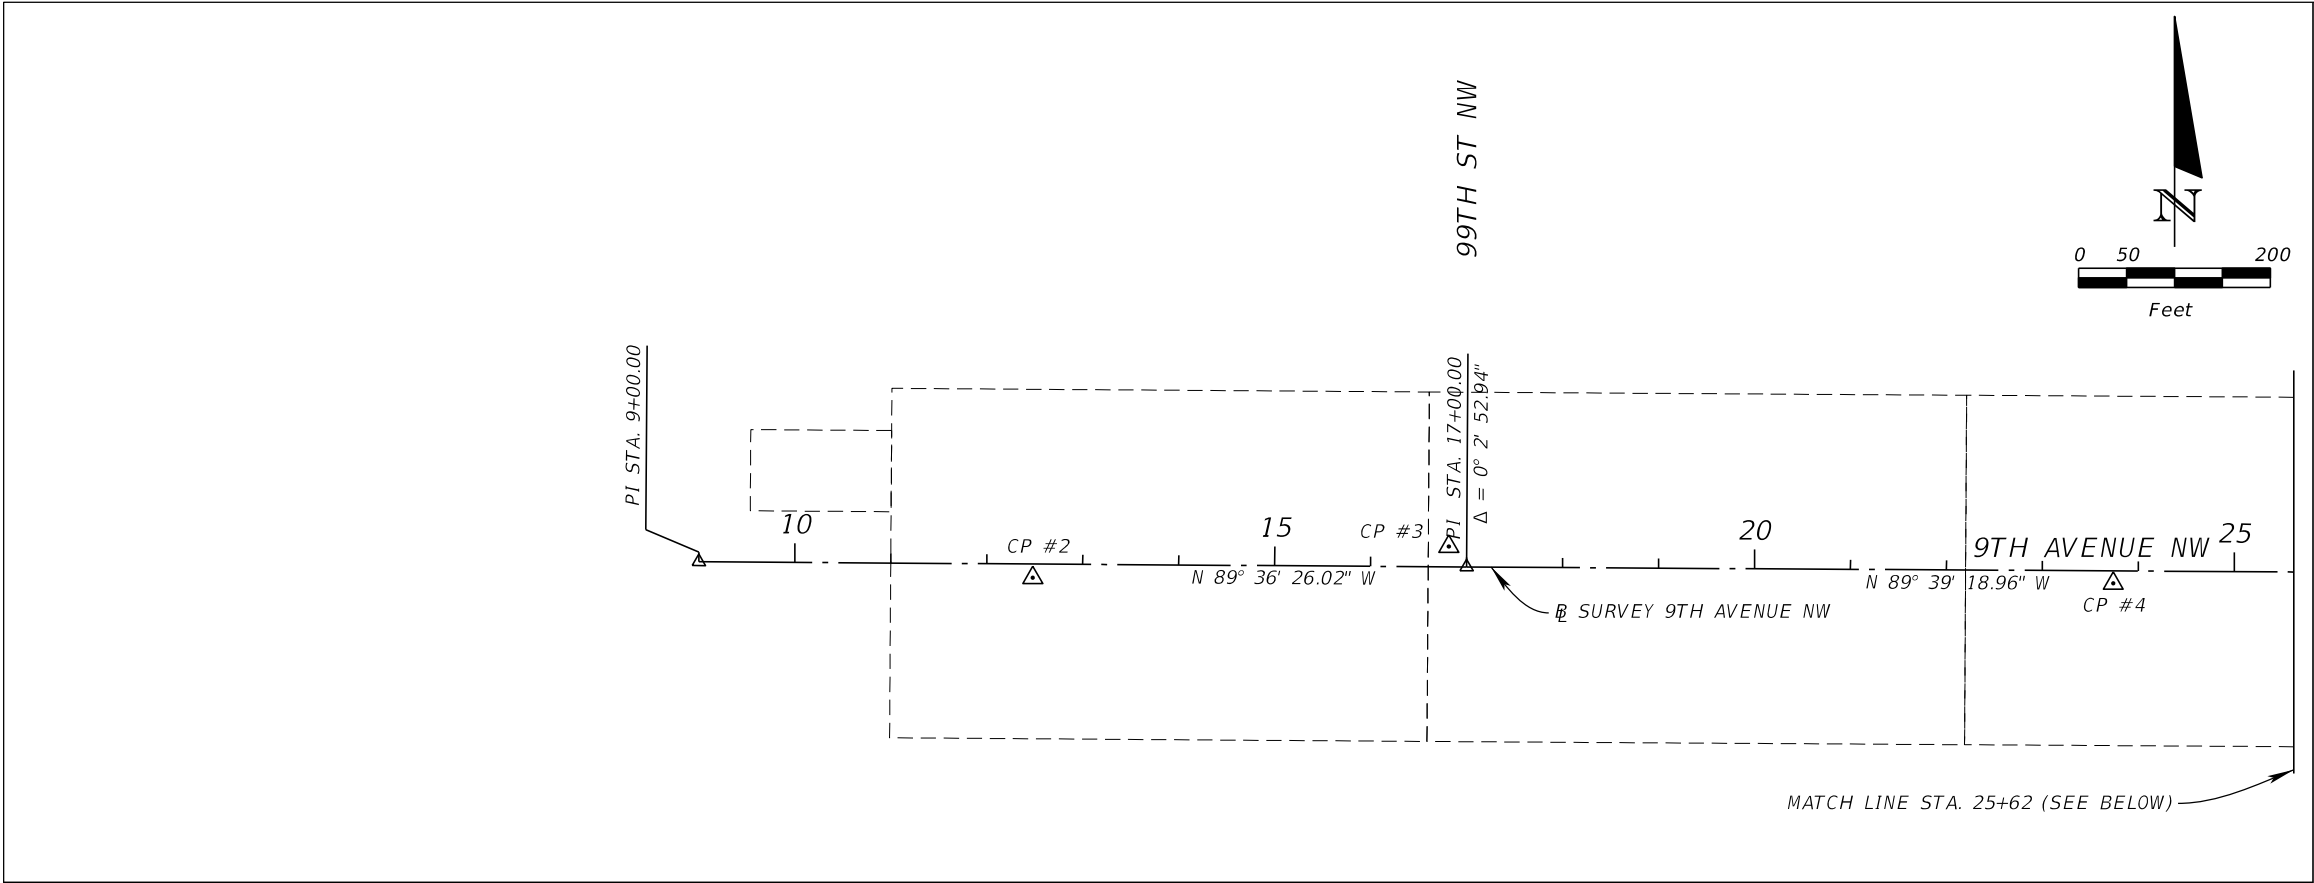

SITE CONTROL:

CP #2  
NORTHING: 1154098.073  
EASTING: 441460.871  
ELEVATION: 3.71  
STATION: 12+48.07  
OFFSET: 14.28 RT.

CP #3  
NORTHING: 1154130.618  
EASTING: 441894.432  
ELEVATION: 3.82  
STATION: 16+81.40  
OFFSET: 21.24 LT.


CP #4  
NORTHING: 1154092.276  
EASTING: 442586.723  
ELEVATION: 3.50  
STATION: 23+73.92  
OFFSET: 12.92 RT.

CP #5  
NORTHING: 1154089.135  
EASTING: 443241.817  
ELEVATION: 3.82  
STATION: 30+29.02  
OFFSET: 12.12 RT.

CP #6  
NORTHING: 1154085.929  
EASTING: 443729.500  
ELEVATION: 3.31  
STATION: 35+16.72  
OFFSET: 12.39 RT.

CP #7  
NORTHING: 1154119.978  
EASTING: 444319.451  
ELEVATION: 5.04  
STATION: 41+06.45  
OFFSET: 25.21 LT.

CP #8  
NORTHING: 1154069.687  
EASTING: 445046.167  
ELEVATION: 11.33  
STATION: 48+33.46  
OFFSET: 20.60 RT.

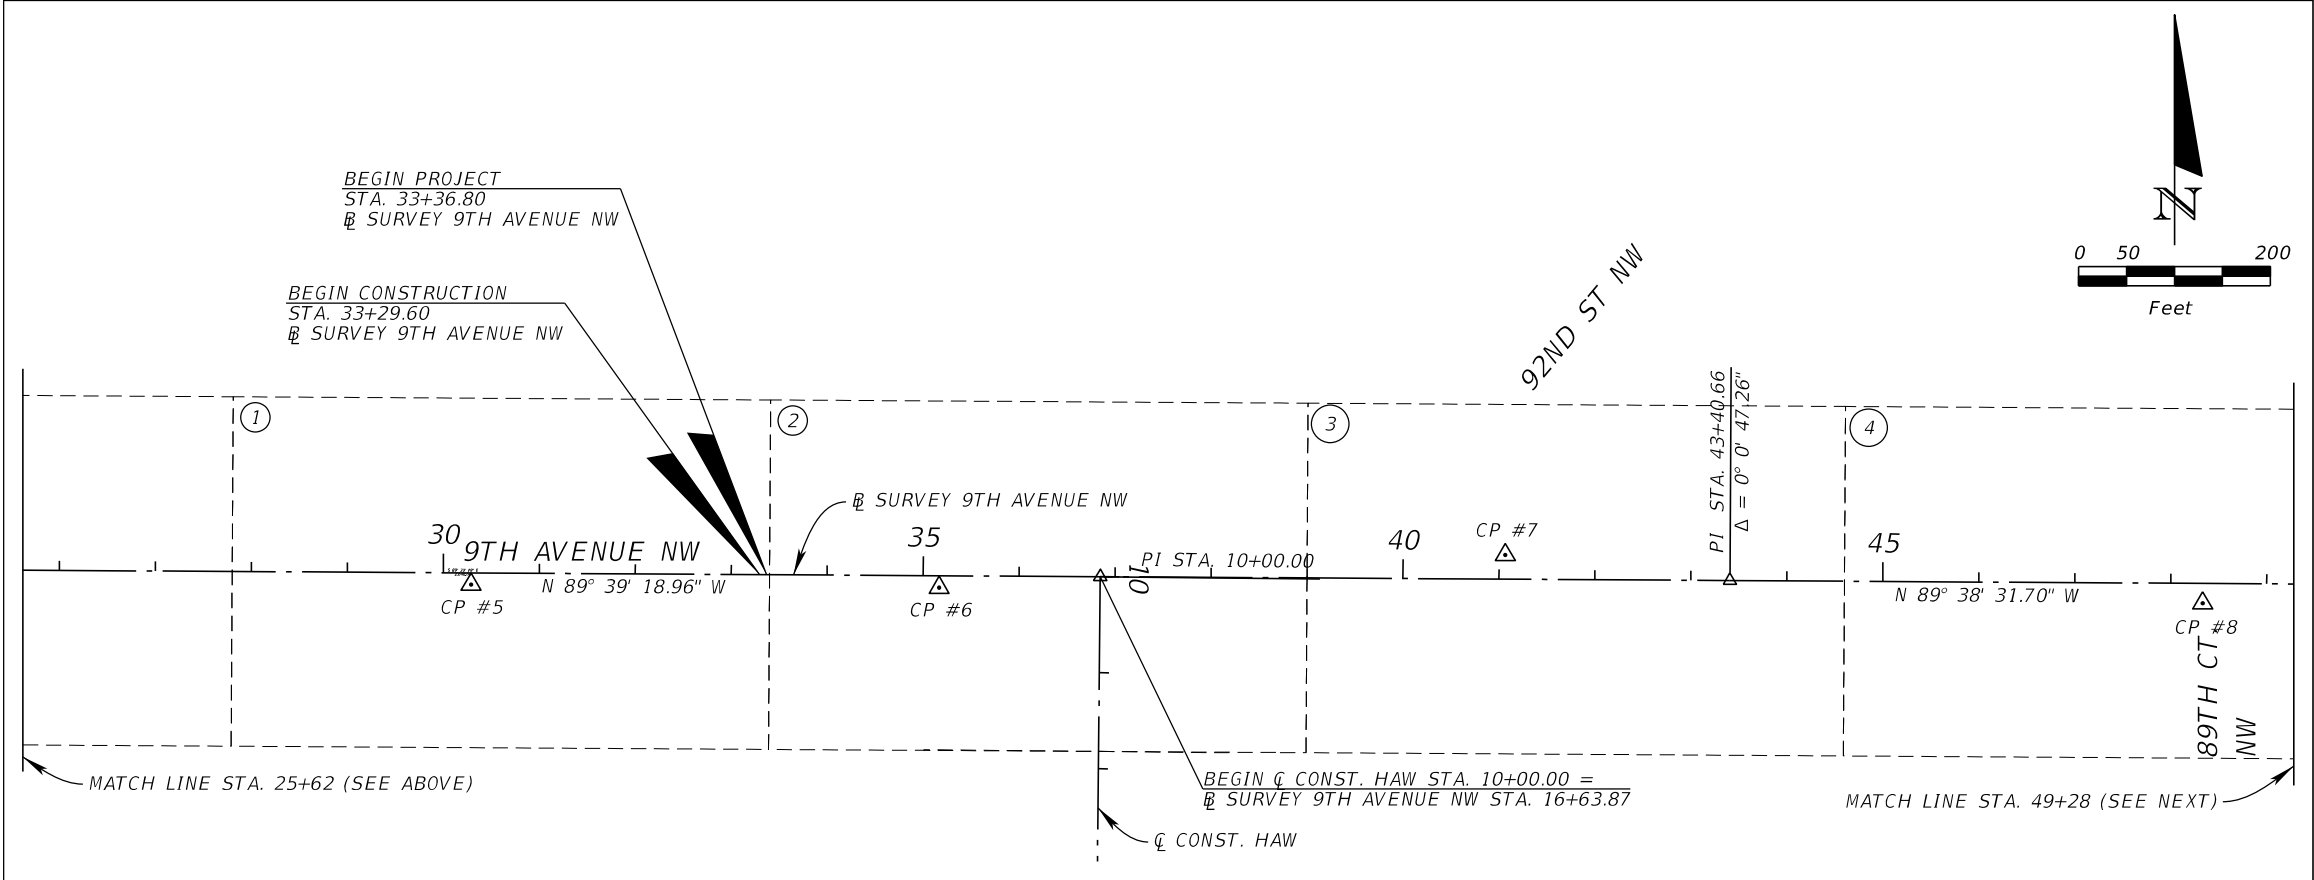

LEGEND:

- △ CONTROL POINT
- ⊗ PLAN SHEET REFERENCE NUMBER
- PLAN SHEET CLIP OUTLINE

No.	REVISIONS	DATE	BY



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1800 SECOND STREET, SUITE 900, SARASOTA, FL 34236  
PHONE: 941-379-7600  
WWW.KIMLEY-HORN.COM

KHA PROJECT 148400070
DATE 10/02/2025
SCALE AS SHOWN
DESIGNED BY
DRAWN BY
CHECKED BY



9TH AVENUE NW

MANATEE COUNTY

LICENSED PROFESSIONAL



JORDAN E. LEEP, P.E.  
FL LICENSE NUMBER 76102

PROJECT LAYOUT  
AND CONTROL (1)

SHEET NUMBER

25

THE OFFICIAL RECORD OF THIS SHEET IS THE ELECTRONIC FILE DIGITALLY SIGNED AND SEALED UNDER RULE 61G15-23.004, F.A.C.

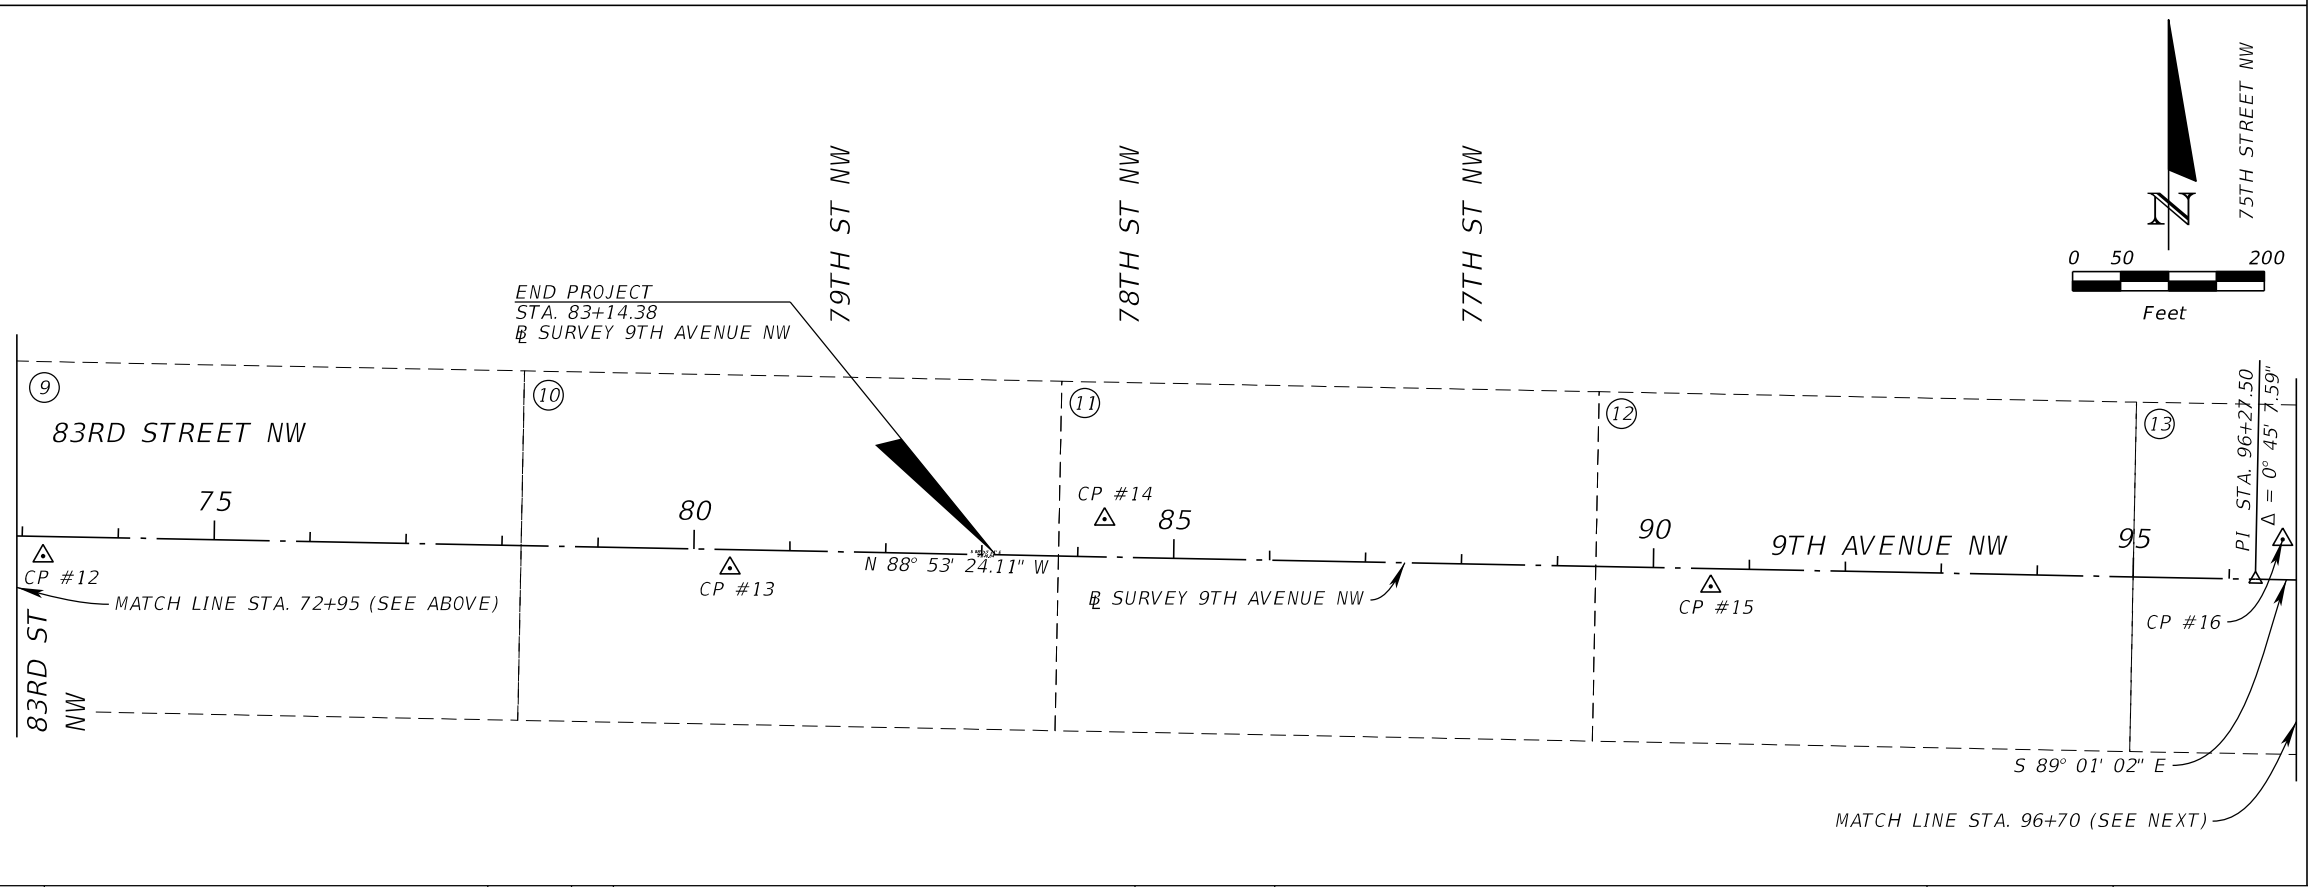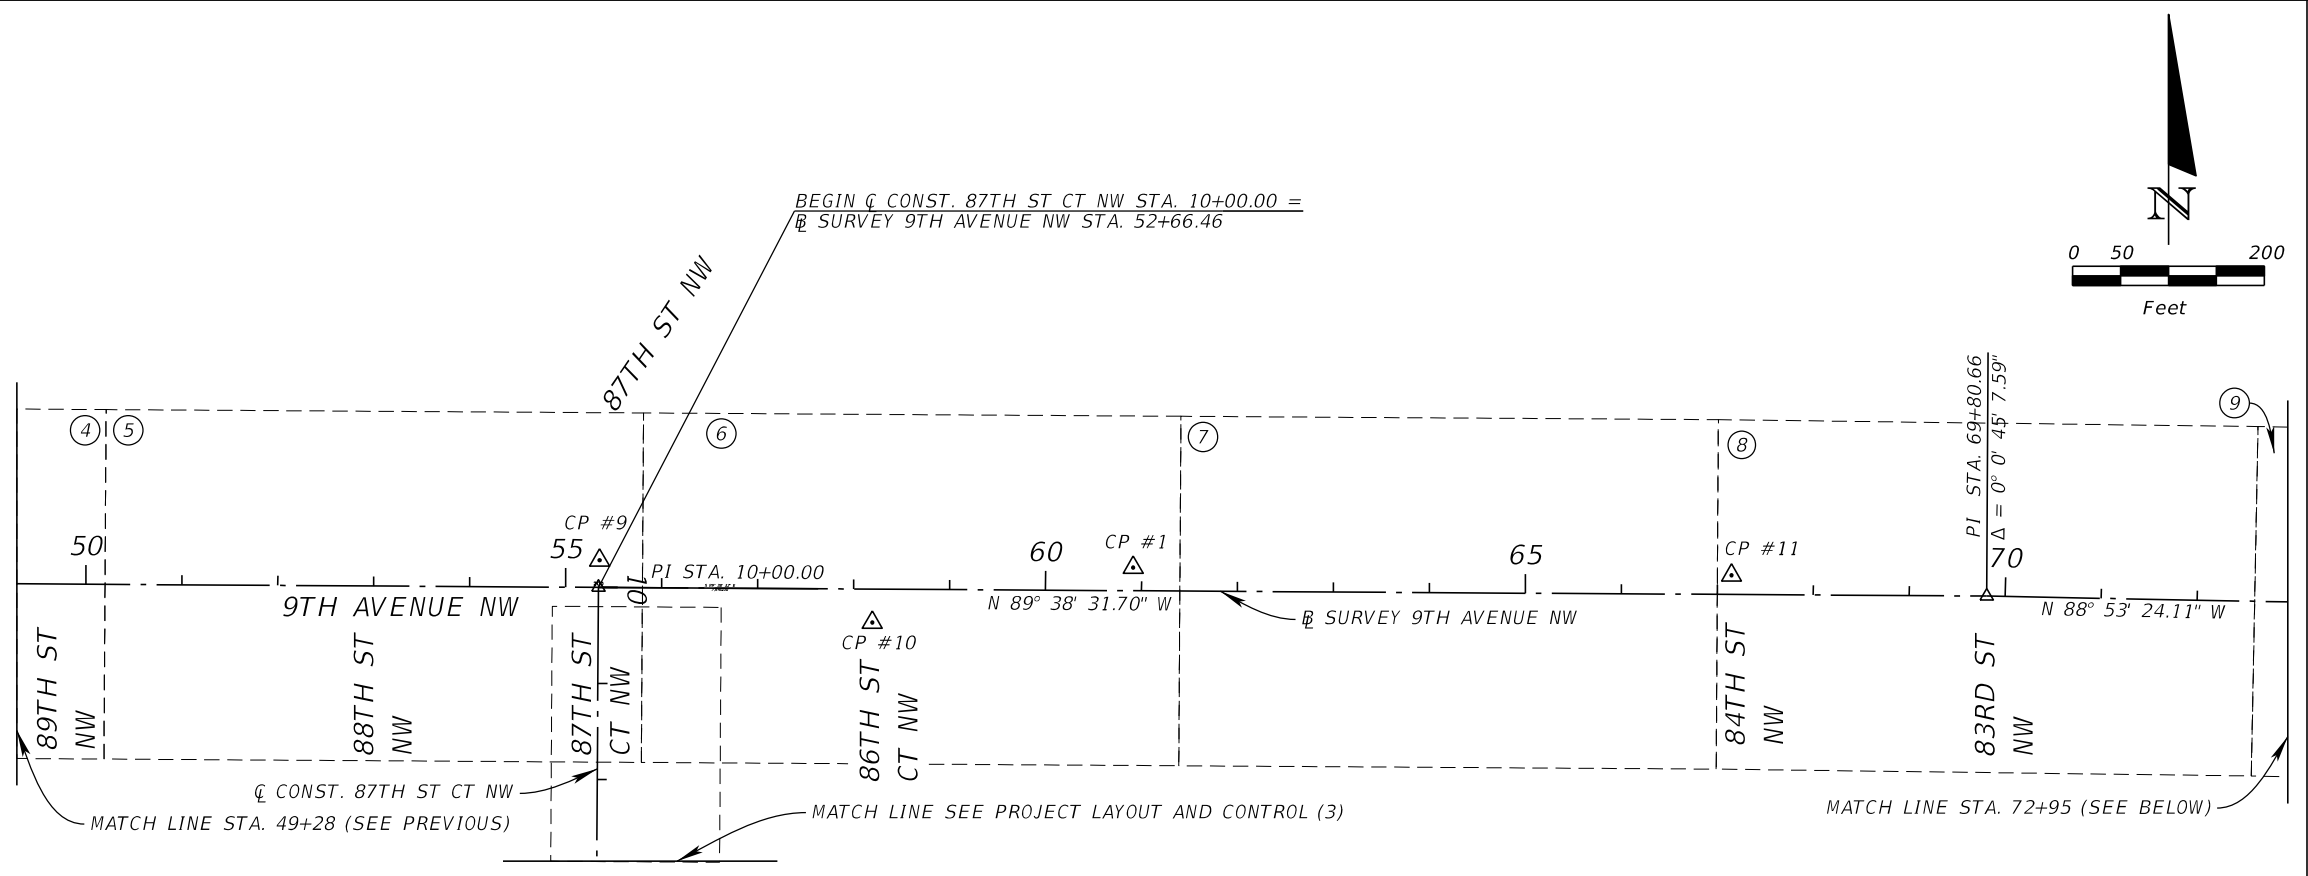

SITE CONTROL:

CP #9  
NORTHING: 1154114.156  
EASTING: 445748.197  
ELEVATION: 14.40  
STATION: 55+35.20  
OFFSET: 28.26 LT.

CP #10  
NORTHING: 1154051.703  
EASTING: 446033.167  
ELEVATION: 16.11  
STATION: 58+20.56  
OFFSET: 32.42 RT.

CP #1  
NORTHING: 1154106.565  
EASTING: 446304.175  
ELEVATION: 15.73  
STATION: 60+91.22  
OFFSET: 24.14 LT.

CP #11  
NORTHING: 1154098.519  
EASTING: 446927.657  
ELEVATION: 16.17  
STATION: 67+14.74  
OFFSET: 19.99 LT.

CP #12  
NORTHING: 1154049.650  
EASTING: 447534.511  
ELEVATION: 13.57  
STATION: 73+22.18  
OFFSET: 20.61 RT.

CP #13  
NORTHING: 1154037.062  
EASTING: 448250.233  
ELEVATION: 4.73  
STATION: 80+38.02  
OFFSET: 19.33 RT.

CP #14  
NORTHING: 1154088.182  
EASTING: 448640.617  
ELEVATION: 4.53  
STATION: 84+27.34  
OFFSET: 39.34 LT.

CP #15  
NORTHING: 1154018.208  
EASTING: 449272.158  
ELEVATION: 7.33  
STATION: 90+60.11  
OFFSET: 18.39 RT.

CP #16  
NORTHING: 1154067.052  
EASTING: 449868.214  
ELEVATION: 8.35  
STATION: 96+55.20  
OFFSET: 41.93 LT.

LEGEND:

- △ CONTROL POINT
- ⊗ PLAN SHEET REFERENCE NUMBER
- PLAN SHEET CLIP OUTLINE

No.	REVISIONS	DATE	BY



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9TH AVENUE NW

MANATEE COUNTY

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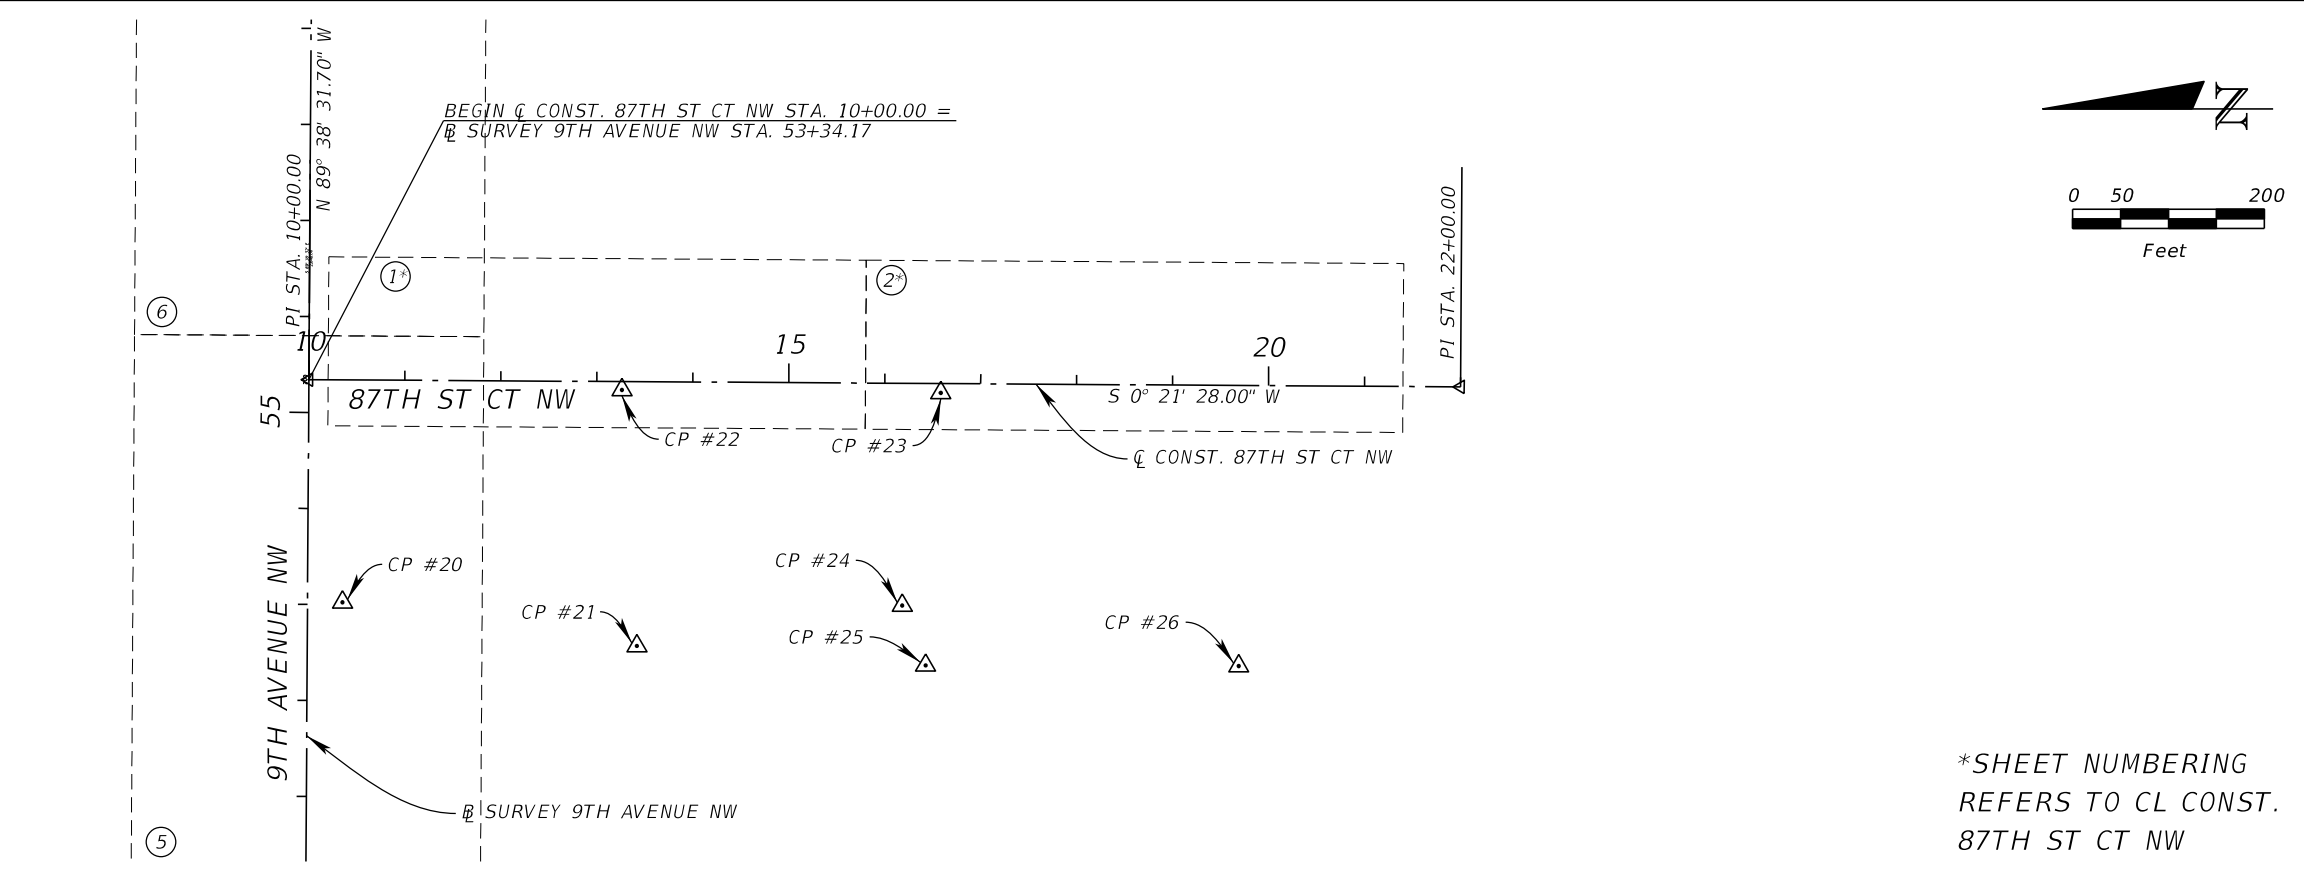
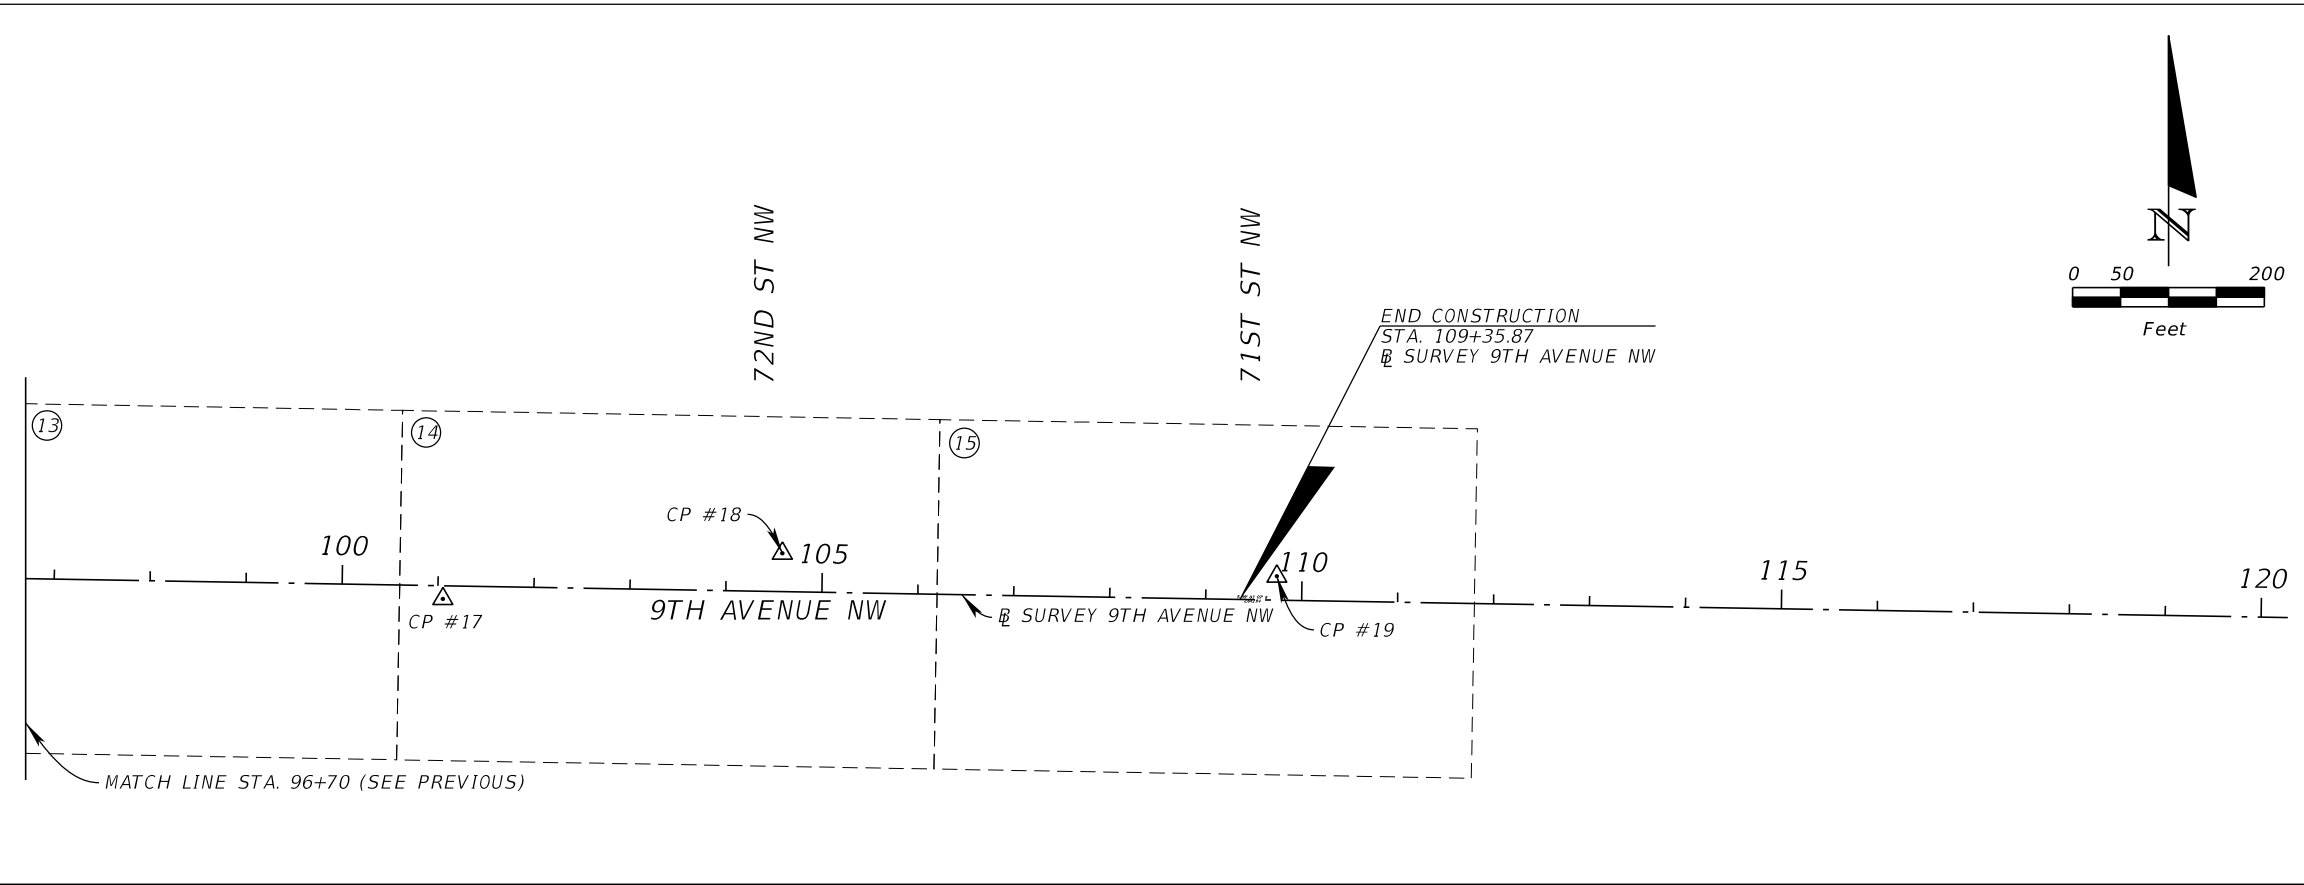
JORDAN E. LEEP, P.E.  
FL LICENSE NUMBER 76102

PROJECT LAYOUT  
AND CONTROL (2)

SHEET NUMBER

26

THE OFFICIAL RECORD OF THIS SHEET IS THE ELECTRONIC FILE DIGITALLY SIGNED AND SEALED UNDER RULE 61G15-23.004, F.A.C.



SITE CONTROL:

CP #17  
NORTHING: 1154003.861  
EASTING: 450317.276  
ELEVATION: 8.60  
STATION: 101+05.28  
OFFSET: 13.55 RT.

CP #18  
NORTHING: 1154051.330  
EASTING: 450671.032  
ELEVATION: 7.26  
STATION: 104+58.17  
OFFSET: 39.98 LT.

CP #19  
NORTHING: 1154027.392  
EASTING: 451186.318  
ELEVATION: 4.29  
STATION: 109+73.80  
OFFSET: 24.89 LT.

CP #20  
NORTHING: 1154050.924  
EASTING: 445515.019  
ELEVATION: 13.93  
STATION: 53+02.42  
OFFSET: 36.43 RT.

CP #21  
NORTHING: 1153744.159  
EASTING: 445469.558  
ELEVATION: 12.19  
STATION: 52+58.88  
OFFSET: 343.47 RT.

CP #22  
NORTHING: 1153759.694  
EASTING: 445736.213  
ELEVATION: 14.75  
STATION: 55+25.43  
OFFSET: 326.27 RT.

CP #23  
NORTHING: 1153427.529  
EASTING: 445733.178  
ELEVATION: 8.10  
STATION: 55+24.47  
OFFSET: 658.45 RT.

CP #24  
NORTHING: 1153467.654  
EASTING: 445511.652  
ELEVATION: 11.10  
STATION: 53+02.70  
OFFSET: 619.71 RT.

CP #25  
NORTHING: 1153443.352  
EASTING: 445449.352  
ELEVATION: 10.93  
STATION: 52+40.55  
OFFSET: 644.40 RT.

CP #26  
NORTHING: 1153117.066  
EASTING: 445448.662  
ELEVATION: 1.95  
STATION: 52+41.90  
OFFSET: 970.69 RT.

LEGEND:

- △ CONTROL POINT
- ⊗ PLAN SHEET REFERENCE NUMBER
- PLAN SHEET CLIP OUTLINE

\*SHEET NUMBER  
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THE OFFICIAL RECORD OF THIS SHEET IS THE ELECTRONIC FILE DIGITALLY SIGNED AND SEALED UNDER RULE 61G15-23.004, F.A.C.

GENERAL

1. ALL CONSTRUCTION ACTIVITIES SHALL BE COORDINATED WITH THE PROJECT MANAGEMENT DIVISION. THE PROJECT MANAGER IS: STEVE CLARK AND CAN BE REACHED AT (941) 748-4501; EXT. 7326.
  2. SITE VISITS ARE MANDATORY FOR ALL BIDDERS. THESE SITE VISITS CAN BE ARRANGED THROUGH THE PROJECT MANAGER.
  3. ALL CONSTRUCTION ON THIS PROJECT SHALL BE IN ACCORDANCE WITH THE LATEST EDITION OF MANATEE COUNTY UTILITY AND TRANSPORTATION STANDARDS AND/OR FDOT "STANDARD SPECIFICATIONS FOR ROAD AND BRIDGE CONSTRUCTION" UNLESS OTHERWISE INDICATED ON THE PLANS.
  4. VERTICAL CONTROL FOR THE PROJECT WAS ESTABLISHED BY A MINIMUM OF TWO REFERENCE BENCHMARKS DESCRIBED ON THE "THE NORTH AMERICAN VERTICAL DATUM OF 1988", (NAVD '88).
  5. THE CONTRACTOR SHALL BE RESPONSIBLE FOR MEETING ALL CONDITIONS AND REQUIREMENTS OF ALL PERMITS AND ALL GOVERNING FEDERAL, STATE, AND LOCAL AGENCIES. THE CONTRACTOR SHALL OBTAIN AND PAY FOR ALL REQUIRED PERMITS THAT ARE NOT PROVIDED IN THE BID DOCUMENTS, AT NO ADDITIONAL COST TO THE OWNER.
  6. THE INFORMATION PROVIDED IN THESE PLANS IS SOLELY TO ASSIST THE CONTRACTOR IN ASSESSING THE NATURE AND EXTENT OF THE CONDITIONS WHICH MAY BE ENCOUNTERED DURING THE COURSE OF WORK. ALL CONTRACTORS ARE DIRECTED, PRIOR TO BIDDING, TO CONDUCT WHATEVER INVESTIGATION THEY MAY DEEM NECESSARY TO ARRIVE AT THEIR OWN CONCLUSIONS REGARDING THE ACTUAL CONDITIONS THAT WILL BE ENCOUNTERED, AND UPON WHICH THEIR BIDS WILL BE BASED.
  7. THE CONTRACTOR SHALL REVIEW AND VERIFY ALL DIMENSIONS ON THE PLANS AND REVIEW ALL FIELD CONDITIONS THAT MAY AFFECT CONSTRUCTION. SHOULD DISCREPANCIES OCCUR, THE CONTRACTOR SHALL NOTIFY THE ENGINEER TO OBTAIN THE ENGINEER'S CLARIFICATION BEFORE COMMENCING WITH CONSTRUCTION.
  8. AT LEAST 48 HOURS PRIOR TO ANY EXCAVATION, THE CONTRACTOR SHALL CONTACT SUNSHINE STATE ONE CALL OF FLORIDA AT 1-800-432-4770 OR THE NATIONAL 811 ONE CALL NUMBER WHEN APPLICABLE FOR UTILITY LOCATIONS. THE CONTRACTOR SHALL BE RESPONSIBLE FOR COORDINATING WITH ALL UTILITIES FOR THE POSSIBLE RELOCATION OR THE TEMPORARY MOVEMENT OF ANY EXISTING UTILITIES WITHIN THE RIGHTS-OF-WAY.
  9. ALL STATIONS AND OFFSETS REFER TO BASELINE OF SURVEY, UNLESS OTHERWISE NOTED.
  10. THE CONSTRUCTION LENGTHS IN THESE PLANS ARE APPROXIMATE. ACTUAL LIMITS MAY BE SET IN THE FIELD AS DIRECTED BY THE ENGINEER.
  11. SEPARATE PAYMENT SHALL BE MADE ONLY FOR THE ITEMS OF WORK LISTED AND IDENTIFIED BY APPROPRIATE PAY ITEM ON THE BID FORM. THE COST OF ANY RELATED WORK NOT SPECIFICALLY IDENTIFIED, BUT WHICH IS REQUIRED FOR SATISFACTORY COMPLETION OF THE WORK, SHALL BE CONSIDERED TO BE INCLUDED IN THE CONTRACT PRICE FOR THE APPROPRIATE BID ITEM.
  12. THE CONTRACTOR SHALL HAVE A FOREMAN, OR RESPONSIBLE PARTY, ON SITE AT ALL TIMES WHEN WORK IS BEING PERFORMED. ALL WORKERS ON THE JOB SITE WILL BE COURTEOUS TO THE PUBLIC AT ALL TIMES, AND SHALL REFER ANY QUESTIONS OR CONCERNS TO THE CONTRACTOR'S FOREMAN OR THE COUNTY INSPECTOR. THE FOREMAN SHALL SPEAK AND UNDERSTAND ENGLISH AND SHALL BE AVAILABLE AT ALL TIMES FOR TIMELY RESOLUTION OF PROJECT-RELATED ISSUES.
  13. THE CONTRACTOR SHALL BE RESPONSIBLE FOR THE COMPLETE COORDINATION OF CONSTRUCTION SCHEDULING BETWEEN CONTRACTOR AND ALL UTILITY AGENCIES.
- NOTE:  
THIS INCLUDED MEETING WITH UTILITY AGENCIES PRIOR TO THE PRE-CONSTRUCTION CONFERENCE TO ADJUST THEIR SCHEDULES TO COINCIDE WITH THE CONTRACTOR'S CONSTRUCTION SCHEDULE. (REFERENCE CONTRACT DOCUMENTS)
14. ANY DAMAGE TO STATE, COUNTY, OR LOCAL ROADS CAUSED BY THE CONTRACTOR'S HAULING OR EXCAVATION EQUIPMENT SHALL BE REPAIRED BY THE CONTRACTOR TO THE SATISFACTION OF THE COUNTY PROJECT MANAGER. PAYMENT SHALL NOT BE MADE FOR THIS WORK.
  15. ALL CONSTRUCTION WITHIN MANATEE COUNTY RIGHT-OF-WAY IS TO BE IN ACCORDANCE WITH CURRENT FDOT STANDARD SPECIFICATIONS FOR ROADWAY CONSTRUCTION AND THE DESIGN STANDARDS.

16. ALL SIGNING AND PAVEMENT MARKINGS SHALL BE PROVIDED IN ACCORDANCE WITH THE LATEST EDITIONS OF THE MUTCD, FDOT DESIGN STANDARDS, AND THE MANATEE COUNTY PUBLIC WORKS DEPARTMENT HIGHWAY, TRAFFIC, AND STORMWATER STANDARDS.
17. ALL CONSTRUCTION WITHIN MANATEE COUNTY RIGHT-OF-WAY IS TO BE PER MANATEE COUNTY PUBLIC WORKS STANDARDS.
18. ALL EXISTING DRAINAGE STRUCTURES WITHIN THE PROJECT LIMITS SHALL BE REMOVED UNLESS OTHERWISE CALLED FOR IN THE PLANS.
19. EXISTING LARGE TREES TO REMAIN UNLESS NOTED OTHERWISE.

*SAFETY*

20. THE CONTRACTOR SHALL BE RESPONSIBLE FOR COMPLIANCE WITH THE FLORIDA TRENCH SAFETY ACT, 90-96, LAWS OF FLORIDA EFFECTIVE OCTOBER 1, 1990 AND THE OCCUPATIONAL SAFETY AND HEALTH ADMINISTRATION EXCAVATION SAFETY STANDARDS, 29 CFR 1926.650, SUBPART P, AS AMENDED. THE CONTRACTOR SHALL INCLUDE IN THE TOTAL BID PRICE ALL COSTS FOR COMPLIANCE WITH THESE REGULATIONS.
21. THE CONTRACTOR SHALL USE SHEET PILING, SHEETING, BRACING, ETC., AS REQUIRED IN ALL EXCAVATION AREAS AND CONFORM TO ALL OSHA REQUIREMENTS.
22. THE CONTRACTOR SHALL USE ALL NECESSARY SAFETY PRECAUTIONS TO AVOID CONTACT WITH OVERHEAD AND UNDERGROUND UTILITIES, POWER LINES, ETC.
23. THESE DRAWINGS DO NOT INCLUDE NECESSARY COMPONENTS FOR CONSTRUCTION SAFETY. THIS EXCLUSION DOES NOT ALLEVIATE THE CONTRACTOR FOR PROVIDING A CONTINUOUS SAFE WORKSPACE.

ENVIRONMENTAL

24. CONTRACTOR IS RESPONSIBLE FOR INSTALLING ALL SEDIMENT AND EROSION CONTROL (SEC) DEVICES (E.G., BARRIERS, SEDIMENT TRAPS/BASINS, VEGETATIVE BUFFERS, ETC.) AS SPECIFIED IN THE FINAL APPROVED PLANS FOR THE PROJECT. CONTRACTOR SHALL BE RESPONSIBLE FOR MAINTAINING ALL SEC DEVICES UTILIZED DURING THE PROJECT, AS WELL AS INSTALLATION & MAINTENANCE OF ANY ADDITIONAL MEASURES DEEMED NECESSARY DURING PROJECT IMPLEMENTATION, TO PREVENT EROSION AND OFF-SITE SEDIMENT MIGRATION. CONTRACTOR SHALL ALSO BE RESPONSIBLE FOR REMOVAL AND PROPER DISPOSAL OF ALL SEC DEVICES UPON CONCLUSION OF THE PROJECT, AND UPON ADEQUATE STABILIZATION OF DISTURBED SOILS.
25. WHEN A BENTONITE SPILL OR FRACK-OUT OCCURS OR THERE IS A LOSS OF RETURN INDICATING EXCESSIVE SEEPAGE OR LOSS OF DRILLING FLUID, DRILLING MUST BE STOPPED UNTIL THE LOCATION OF THE SPILL IS IDENTIFIED. UNDER NO CIRCUMSTANCES WILL DRILLING CONTINUE WHEN A SPILL IS APPARENT.
26. ONCE LOCATED, THE BENTONITE SPILL MUST BE ISOLATED AND SEEPAGE INTO ANY NEARBY WATER BODIES WILL BE BLOCKED DEPENDING ON THE DEGREE OF THE SPILL, THE ISOLATED BENTONITE MUST BE REMOVED MANUALLY OR MECHANICALLY AND DISPOSED OF BY APPROPRIATE MEANS OR REUSED.
27. THE CONTRACTOR SHALL PROVIDE AND INSTALL ALL NECESSARY STORM WATER, EROSION, AND SEDIMENTATION CONTROL MEASURES IN ACCORDANCE WITH THE FDEP "FLORIDA STORM WATER, EROSION AND SEDIMENTATION CONTROL INSPECTOR'S MANUAL". IT IS THE RESPONSIBILITY OF THE CONTRACTOR TO CONTROL AND PREVENT EROSION AND TRANSPORT OF SEDIMENT TO SURFACE DRAINS AND TO DITCHES DURING CONSTRUCTION.
28. STOCKPILES SHALL BE PROTECTED AT ALL TIMES BY ON-SITE DRAINAGE CONTROLS WHICH PREVENT EROSION OF THE STOCKPILED MATERIAL. CONTROL OF DUST FROM SUCH STOCKPILES IS REQUIRED, DEPENDING UPON THEIR LOCATION AND THE EXPECTED LENGTH OF TIME THE STOCKPILES WILL BE PRESENT. IN NO CASE SHALL ANY STOCKPILED MATERIAL REMAIN AFTER THIRTY (30) CALENDAR DAYS.
29. STORM WATER INLETS IN THE VICINITY OF THE PROJECT SHALL BE PROTECTED BY SEDIMENT TRAPS SUCH AS SECURED HAY BALES, SOD, STONE, ETC., WHICH SHALL BE MAINTAINED AND MODIFIED AS REQUIRED BY CONSTRUCTION PROGRESS, AND WHICH MUST BE APPROVED BY THE ENGINEER BEFORE INSTALLATION. THIS WILL BE MAINTAINED TO PREVENT DEGRADATION OF THE WATERS OF THE COUNTY AND STATE.
30. SEDIMENT BASINS AND TRAPS, PERIMETER BERMS, SEDIMENT BARRIERS, VEGETATIVE BUFFERS, AND OTHER MEASURES INTENDED TO TRAP SEDIMENT AND/OR PREVENT THE TRANSPORT OF SEDIMENT ONTO ADJACENT PROPERTIES, OR INTO EXISTING BODIES OF WATER, MUST BE INSTALLED, CONSTRUCTED, OR IN THE CASE OF VEGETATIVE BUFFERS, PROTECTED FROM DISTURBANCE, AS A FIRST STEP IN THE LAND ALTERATION PROCESS. SUCH SYSTEMS SHALL BE FULLY OPERATIVE BEFORE ANY OTHER DISTURBANCE OF THE SITE BEGINS. EARTHEN STRUCTURES INCLUDING BUT NOT LIMITED TO BERMS, EARTH FILTERS, DAMS OR DIKES SHALL BE STABILIZED AND PROTECTED FROM DRAINAGE DAMAGE OR EROSION WITHIN ONE (1) WEEK OF INSTALLATION.

[illegible]

31.	ALL SWALES, DITCHES, AND CHANNELS LEADING FROM THE SITE SHALL BE PROTECTED FROM SILTATION AND EROSION DURING CONSTRUCTION AND BE SODDED WITHIN THREE (3) DAYS OF EXCAVATION.	44.	ALL EXISTING FACILITIES IN THE PROJECT AREA SHALL REMAIN OPERATIONAL AND ACCESSIBLE BY COUNTY PERSONNEL AT ALL TIMES, I.E. VALVES, FIRE HYDRANTS, MANHOLE COVERS, SEWER CLEAN-OUTS, ETC. ALL SHALL BE ADJUSTED TO FINISHED GRADE.
32.	SOIL DISPLACED BY CONSTRUCTION WILL BE REMOVED. EROSION CONTROL SHALL BE IMPLEMENTED IN AREAS WHICH ARE CONSIDERED ENVIRONMENTALLY SENSITIVE. EROSION CONTROL SYSTEMS SHALL BE REQUIRED FOR ALL WORK WITHIN JURISDICTIONAL AREAS. THESE SYSTEMS MAY INCLUDE STAKED HAY BALES, SILT SCREENS, FILTER FABRIC, AND TURBIDITY SCREENS.	45.	THE CONTRACTOR SHALL USE APPROPRIATE TECHNIQUES, AS APPROVED, RECOMMENDED OR OFFERED BY FLORIDA POWER AND LIGHT TO PREVENT UNDERMINING OF POWER POLES DURING CONSTRUCTION. IF HOLDING OF POWER POLES IS RECOMMENDED OR REQUIRED BY THE UTILITY, THE CONTRACTOR SHALL COORDINATE THIS ACTIVITY WITH THE UTILITY AND BEAR ALL RELATED COSTS.
33.	ALL EROSION AND POLLUTION CONTROL DEVICES SHALL BE CHECKED REGULARLY, ESPECIALLY AFTER EACH RAINFALL AND SHALL BE CLEANED OUT AND/OR REPAIRED AS REQUIRED.	46.	EXCEPT WHERE THE PLANS AND SPECIFICATIONS PROVIDE THAT SUCH WORK SHALL BE PERFORMED UNDER THE CONTRACT FOR THIS PROJECT. ALL UTILITIES INTERFERING WITH CONSTRUCTION SHALL BE REMOVED, RELOCATED OR ADJUSTED BY THEIR OWNERS, AT THEIR EXPENSE. THE CONTRACTOR SHALL ARRANGE HIS SCHEDULE TO ALLOW UTILITY OWNERS TIME FOR THE NECESSARY RELOCATION AND ADJUSTMENT OF UTILITIES AND RELATED STRUCTURES.
34.	THE CONTRACTOR SHALL NOT ENTER UPON OR IN ANY WAY ALTER WETLAND AREAS THAT MAY BE ON OR NEAR THE CONSTRUCTION SITE, UNLESS OTHERWISE SHOWN ON THE PLANS. ALL WORK IN THE VICINITY OF OPEN WATER AND/OR WETLANDS IS TO BE PERFORMED IN COMPLIANCE WITH THE ENVIRONMENTAL REGULATIONS AND/OR PERMITS FOR THE SITE. THE CONTRACTOR WILL BE RESPONSIBLE FOR ANY FINES RESULTING FROM HIS VIOLATION OF ANY REGULATIONS OR PERMIT CONDITIONS.	47.	A FLORIDA POWER AND LIGHT SPECIAL PROVISION IS THAT THE TYPE OF EQUIPMENT USED IN THE INSTALLATION OF MAST ARMS/FOUNDATIONS, OVERHEAD/CANTILEVER SIGNS/ROUNDATIONS, AND THE MOVEMENT/INSTALLATION OF STRAIN POLES SHALL MEET THE FOLLOWING REQUIREMENTS: 1) OVERHEAD LINES SHALL STAY IN PLACE BOTH VERTICALLY AND HORIZONTALLY 2) CONTRACTOR SHALL MEET ALL APPLICABLE OSHA REQUIREMENTS (SEPARATION SHALL FOLLOW FPL GUIDELINES). ANY COST ASSOCIATED WITH THIS TYPE OF EQUIPMENT REQUIRED FOR THIS INSTALLATION IS INCLUDED IN THE RELATED PAY ITEMS. PLEASE REFER TO THE SPECIAL CONDITIONS IN THE UTILITY WORK SCHEDULE AND UTILITY COORDINATION.
35.	FOR MORE INFORMATION, SEE THE EROSION CONTROL DETAIL SHEET INCLUDED IN THE PLANS.	48.	CONTRACTOR SHALL BE RESPONSIBLE FOR COORDINATING WITH ALL UTILITY COMPANIES FOR THE RELOCATION AND ADJUSTMENT OF ALL UTILITIES, INCLUDING, ANY EXISTING POWER POLES AND/OR UTILITY CONDUITS WITHIN RIGHT-OF-WAY.
<u>RIGHT OF WAY</u>		49.	PRIOR TO CONSTRUCTION, THE CONTRACTOR SHALL BE RESPONSIBLE TO COORDINATE WITH THE APPROPRIATE PARTIES TO DETERMINE THE COUNTY'S FIBER COMMUNICATION NETWORK, KNOWN AS ATMS (COUNTY ISD, SCHOOL BOARD, AND TRAFFIC MANAGEMENT CENTER) IN THE AREA TO ACCOMMODATE ANY POTENTIAL CONFLICTS. AS-BUILT INFORMATION FOR EXISTING COMMUNICATION CONDUIT AND FIBER IS AVAILABLE FROM OLGA ROSIER, WITH UTILITY RECORDS (941-792-8811 EXT. 5059). CONSTRUCTION PLAN INFORMATION FOR PROJECTS UNDER CONSTRUCTION WITH THE COUNTY'S TRAFFIC MANAGEMENT CENTER ARE AVAILABLE AT WWW.MANATEEATMS.COM AND WWW.MANATEEATMS2.COM.
36.	ALL CONSTRUCTION ACTIVITIES SHALL BE LIMITED TO WITHIN THE MANATEE COUNTY/FDOT RIGHT-OF-WAY AND/OR EASEMENTS SHOWN ON THE DRAWINGS.	50.	IN THE EVENT OF A PRECAUTIONARY OR MANDATORY BOIL WATER NOTICE, THE CONTRACTOR IS RESPONSIBLE TO NOTIFY ALL AFFECTED INDIVIDUALS AND BUSINESSES.
37.	THE CONTRACTOR SHALL EMPLOY A LAND SURVEYOR REGISTERED IN THE STATE OF FLORIDA TO REFERENCE AND RESTORE PROPERTY CORNER MONUMENTS, PINS, AND LANDMARKS THAT MAY BE DISTURBED BY CONSTRUCTION AT NO ADDITIONAL COST TO THE OWNER.	51.	WORK MAY NEED TO BE SCHEDULED DURING OVERNIGHT HOURS AT THE DISCRETION OF THE COUNTY. THE COUNTY WILL NOT INCUR ANY NEW FEES OR PENALTIES FOR OVERNIGHT WORK.
38.	THE CONTRACTOR, PRIOR TO CONSTRUCTION AND RESTRICTING ANY TRAFFIC, MUST OBTAIN A RIGHTS-OF-WAY USE PERMIT AND A TRAFFIC CONTROL PLAN. THE CONTRACTOR SHALL OBTAIN ALL REQUIRED PERMITS FROM OTHER GOVERNMENTAL AGENCIES HAVING RELEVANT JURISDICTION. ALL MAINTENANCE AND PROTECTION OF TRAFFIC SHALL BE IN ACCORDANCE WITH THE APPLICABLE REQUIREMENTS OF THE CURRENT FEDERAL HIGHWAY ADMINISTRATION "MANUAL ON UNIFORM TRAFFIC CONTROL DEVICES" (MUTCD). A TRAFFIC CONTROL PLAN SHALL BE SUPPLIED BY THE CONTRACTOR AT THE PRE-CONSTRUCTION MEETING.	52.	ALL WATER/RECLAIM CONNECTIONS (TAPPING SADDLES, VALVES, PIPING CROSSING, WATER SERVICES, ETC.) SHALL DUG UP WITH A COUNTY REPRESENTATIVE TO VERIFY IT MEETS CURRENT COUNTY STANDARDS. IF THE UTILITY DOES NOT MEET CURRENT STANDARDS, IT WILL NEED TO BE REPLACED TO CURRENT STANDARDS.
39.	THE CONTRACTOR SHALL BE RESPONSIBLE FOR REPLACING ALL DAMAGED STORM WATER STRUCTURES, PIPING, ENTRANCE PIPE AND HEADWALLS, THAT ARE TO REMAIN, WHETHER SHOWN ON THE PLANS OR NOT.	53.	REPLACE ALL WATER SERVICES PER COUNTY STANDARD FROM MAIN TO METER TO THE NEW RIGHT-OF-WAY.
40.	IT IS THE RESPONSIBILITY OF THE CONTRACTOR TO ESTABLISH IN THE FIELD THE RIGHT-OF-WAY LINES, BASE LINES, BENCH MARKS (ELEV.), CENTER LINES, AND STATIONING AS REQUIRED TO CONSTRUCT THIS PROJECT. ROADWAY PLANS AND PROPOSED DESIGN ARE BASED ON TOPOGRAPHIC SURVEYS PROVIDED BY HYATT SURVEY INC. REFER TO THE ORIGINAL SIGNED AND SEALED SURVEY CONTROL SHEETS IN THE PROJECT FILE.	54.	ALL VALVES SHALL BE SET TO PROPOSED GRADE PER COUNTY STANDARD BY CONTRACTOR.
41.	THE CONTRACTOR SHALL COORDINATE THE CUTTING OF DRIVEWAYS WITH THE PROPERTY OWNER PRIOR TO CUT. ALL DRIVEWAYS WILL BE IN PASSABLE CONDITION AT THE END OF THE WORK DAY AND FULLY RESTORED PER PLAN. THE CONTRACTOR SHALL COORDINATE WITH THE AFFECTED UTILITY COMPANY FOR THE ADJUSTMENT OF ANY EXISTING UTILITIES AND STRUCTURES IN ORDER TO MATCH THE PROPOSED ELEVATIONS AND ALIGNMENTS.	55.	ANY WATER OR RECLAIM MAIN LINES OR SERVICES DAMAGED DURING CONSTRUCTION MUST BE REPLACED FROM RIGHT-OF-WAY TO RIGHT-OF-WAY AND WATER SERVICES FROM CORP ON MAIN TO METER.
<u>UTILITIES</u>		56.	CHECK ALL WATER LINES AND FIRE HYDRANT CONNECTIONS AT MAIN FOR SADDLE/SLEEVE VALVE REPLACEMENT.
42.	LOCATIONS, ELEVATIONS AND DIMENSIONS OF EXISTING UTILITIES, STRUCTURES AND OTHER FEATURES ARE SHOWN TO THE BEST INFORMATION AVAILABLE AT THE TIME OF PREPARATION OF THESE PLANS BUT DO NOT PURPORT TO BE ABSOLUTELY CORRECT. THERE MAY BE OTHER IMPROVEMENTS, UTILITIES, ETC. WHICH ARE WITHIN THE PROJECT AREA AND WHICH HAVE NOT BEEN LOCATED OR IDENTIFIED, MAY NOT BE IN THE EXACT LOCATION SHOWN OR RELOCATED SINCE THE PREPARATION OF THESE PLANS. THE CONTRACTOR SHALL VERIFY, PRIOR TO CONSTRUCTION, THE LOCATIONS, ELEVATIONS AND DIMENSIONS OF ALL EXISTING UTILITIES STRUCTURES AND OTHER FEATURES (WHETHER OR NOT SHOWN ON THE PLANS) THAT MAY AFFECT HIS WORK. ALL EXISTING UTILITIES TO BE EXTENDED, CROSSED OR CONNECTION POINTS SHALL BE EXPOSED PRIOR TO CONSTRUCTION TO VERIFY LOCATION AND ELEVATION. ANY DISCREPANCIES OR CONFLICTS FOUND SHALL BE BROUGHT TO THE ENGINEER'S ATTENTION FOR RESOLUTION. UTILITIES DESIGNATED VV, VH, AND VVH ARE BASED ON LIMITED INVESTIGATION TECHNIQUES AND SHOULD BE CONSIDERED APPROXIMATE ONLY. THE VERIFIED BEEN VERIFIED. EXTREME CAUTION SHALL BE EXERCISED WHEN WORKING NEAR UTILITIES.		
43.	THE CONTRACTOR SHALL PROTECT ALL EXISTING STRUCTURES, WATER AND SEWER LINES, STORM DRAINS, UTILITIES, DRIVEWAYS, SIDEWALKS, SIGNS, MAIL BOXES, FENCES, TREES, LANDSCAPING, AND ANY OTHER IMPROVEMENT OR FACILITY IN THE CONSTRUCTION AREA. THE CONTRACTOR SHALL REPAIR AND/OR REPLACE ANY DAMAGED ITEM DUE TO HIS CONSTRUCTION		

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No.	REVISIONS	DATE	BY					






84. ALL EXISTING SIGNS WITHIN THE PROJECT LIMITS SHALL REMAIN UNLESS OTHERWISE NOTED IN THE PLANS, OR AS DIRECTED BY THE ENGINEER.
85. ANY EXISTING SIGN TO REMAIN THAT IS DISTURBED OR RELOCATED DURING CONSTRUCTION SHALL BE RESET TO CURRENT STANDARDS FOR HEIGHT, OFFSET, AND METHOD OF INSTALLATION AT NO ADDITIONAL COST TO THE COUNTY.
86. ALL EXISTING SWALES NOT DESIGNATED FOR RECONSTRUCTION SHALL BE REGRADED TO PROMOTE POSITIVE DRAINAGE AND MATCH PROPOSED CENTERLINE SWALE ELEVATION AND ALIGNMENT.
87. ALL STORM DRAINS AND STRUCTURES TO REMAIN SHALL BE CLEANED OF DEBRIS, DIRT, VEGETATION AND OTHER MATERIAL. STORM SEWER INLETS SHALL BE MODIFIED (RAISED/LOWERED) TO MATCH PROPOSED FINISHED GRADE. ANY EXISTING PIPES DRAINING TO THE RIGHT OF WAY CALLED OUT TO BE MODIFIED BY THE PLANS SHALL BE INCLUDED IN THE COST OF CLEARING AND GRUBBING.
88. ALL EXISTING FENCES DISTURBED DURING CONSTRUCTION SHALL BE REPAIRED OR REPLACED AND REINSTALLED BY THE CONTRACTOR AT NO ADDITIONAL COST. (EXISTING FENCES WITHIN R/W TAKING LIMITS SHALL BE RECONSTRUCTED TO THE NEW R/W LINE AND ARE TO BE REIMBURSED UNDER THE MISCELLANEOUS BID ITEM).
89. ALL EXISTING TREES LOCATED WITHIN R/W LIMITS SHALL REMAIN UNLESS OTHERWISE NOTED.
90. ALL EXISTING BUILDINGS SHALL REMAIN UNLESS OTHERWISE NOTED.
91. ALL IMPACTED PROPERTY CORNERS AND MARKERS TO BE RESET.

MITIGATION NOTES

92. MAINTENANCE SHALL BE IN ACCORDANCE WITH PERMIT CONDITIONS. WETLAND BOUNDARY AND BUFFER AREAS SHALL BE CLEARLY DELINEATED ON SITE PRIOR TO INITIAL CLEARING AND GRUBBING ACTIVITIES. THE DELINEATION SHALL ENDURE THROUGHOUT THE CONSTRUCTION PERIOD, AND BE READILY DISCERNIBLE TO CONSTRUCTION PERSONNEL. THE WETLAND (JURISDICTIONAL) AND BUFFER AREAS ARE TO BE IDENTIFIED IN THE FIELD WITH STAKES AND FLAGGED STRING LINES (STRING LINE 5' ABOVE GRADE WITH FLAGGING AT 10' INTERVALS) PRIOR TO COMMENCEMENT OF CLEARING AND GRUBBING. THE STRING LINE SHALL BE MAINTAINED THROUGHOUT CONSTRUCTION. THE CONTRACTOR SHALL STAY OUT OF THE EXISTING WETLAND AND BUFFER AREAS, EXCEPT WHERE PLANS CALL OUT SPECIFIC WORK TO BE PERFORMED.

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No.	REVISIONS	DATE	BY		MANATEE COUNTY	FL	DATE:		

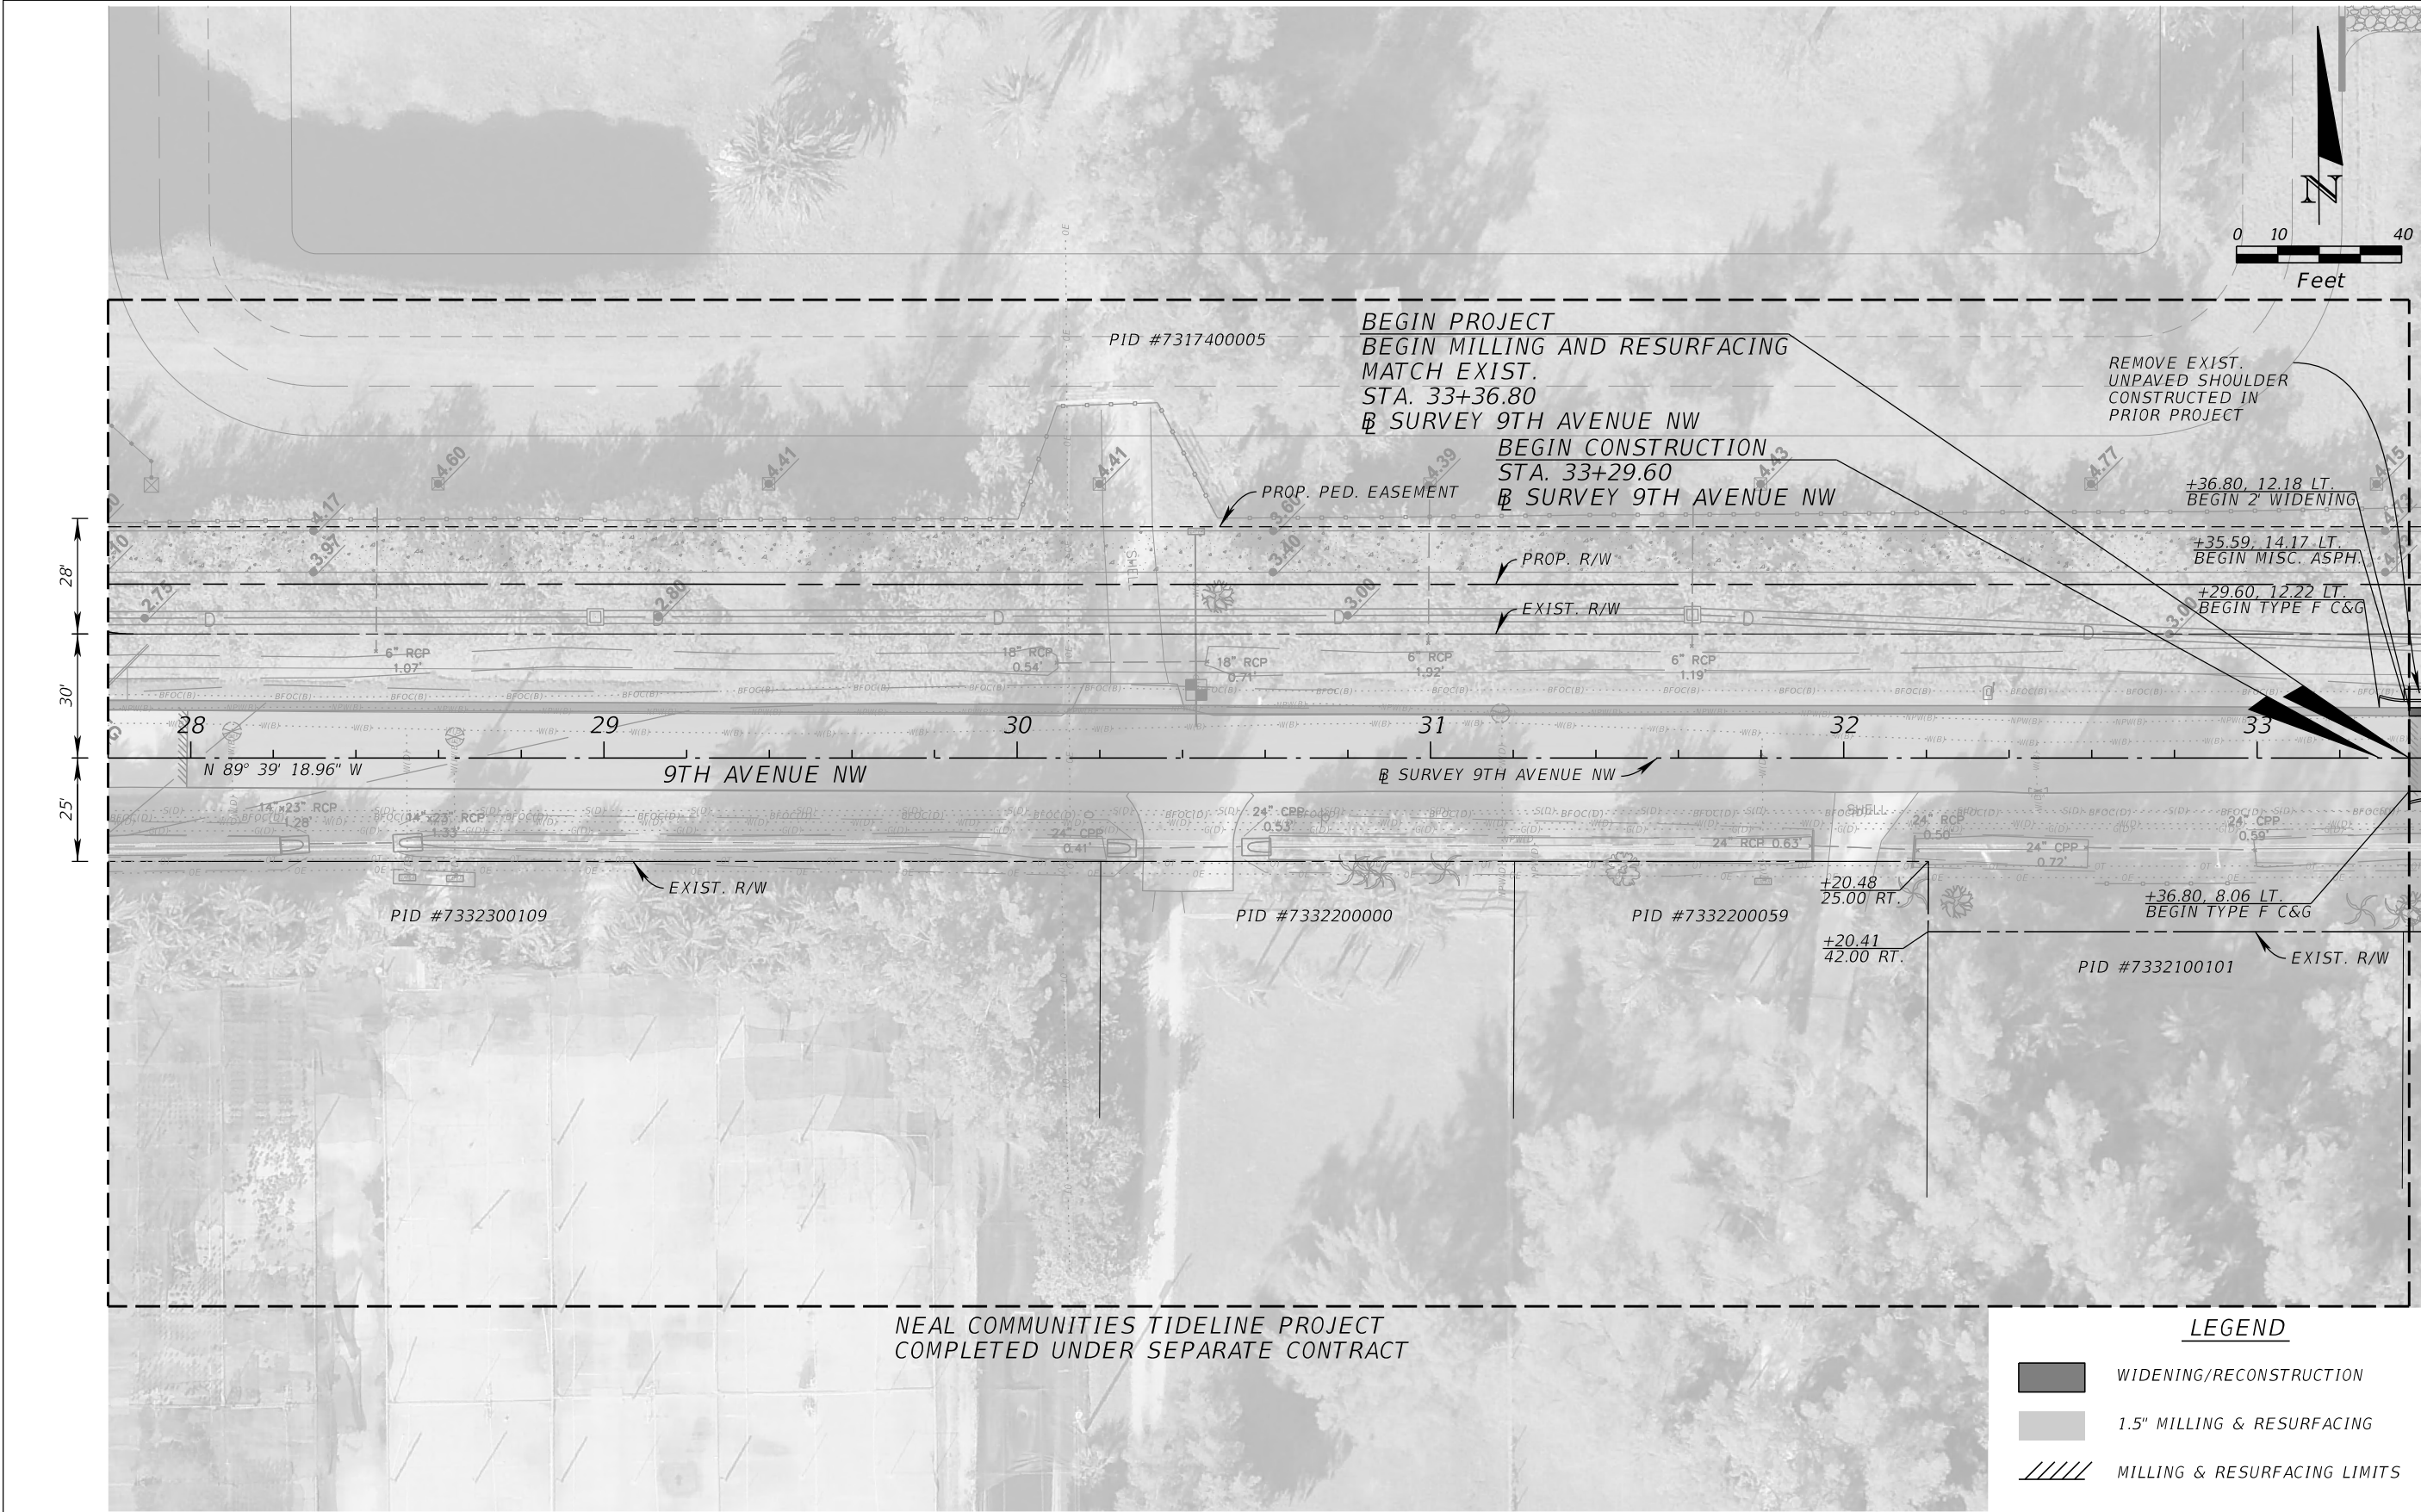

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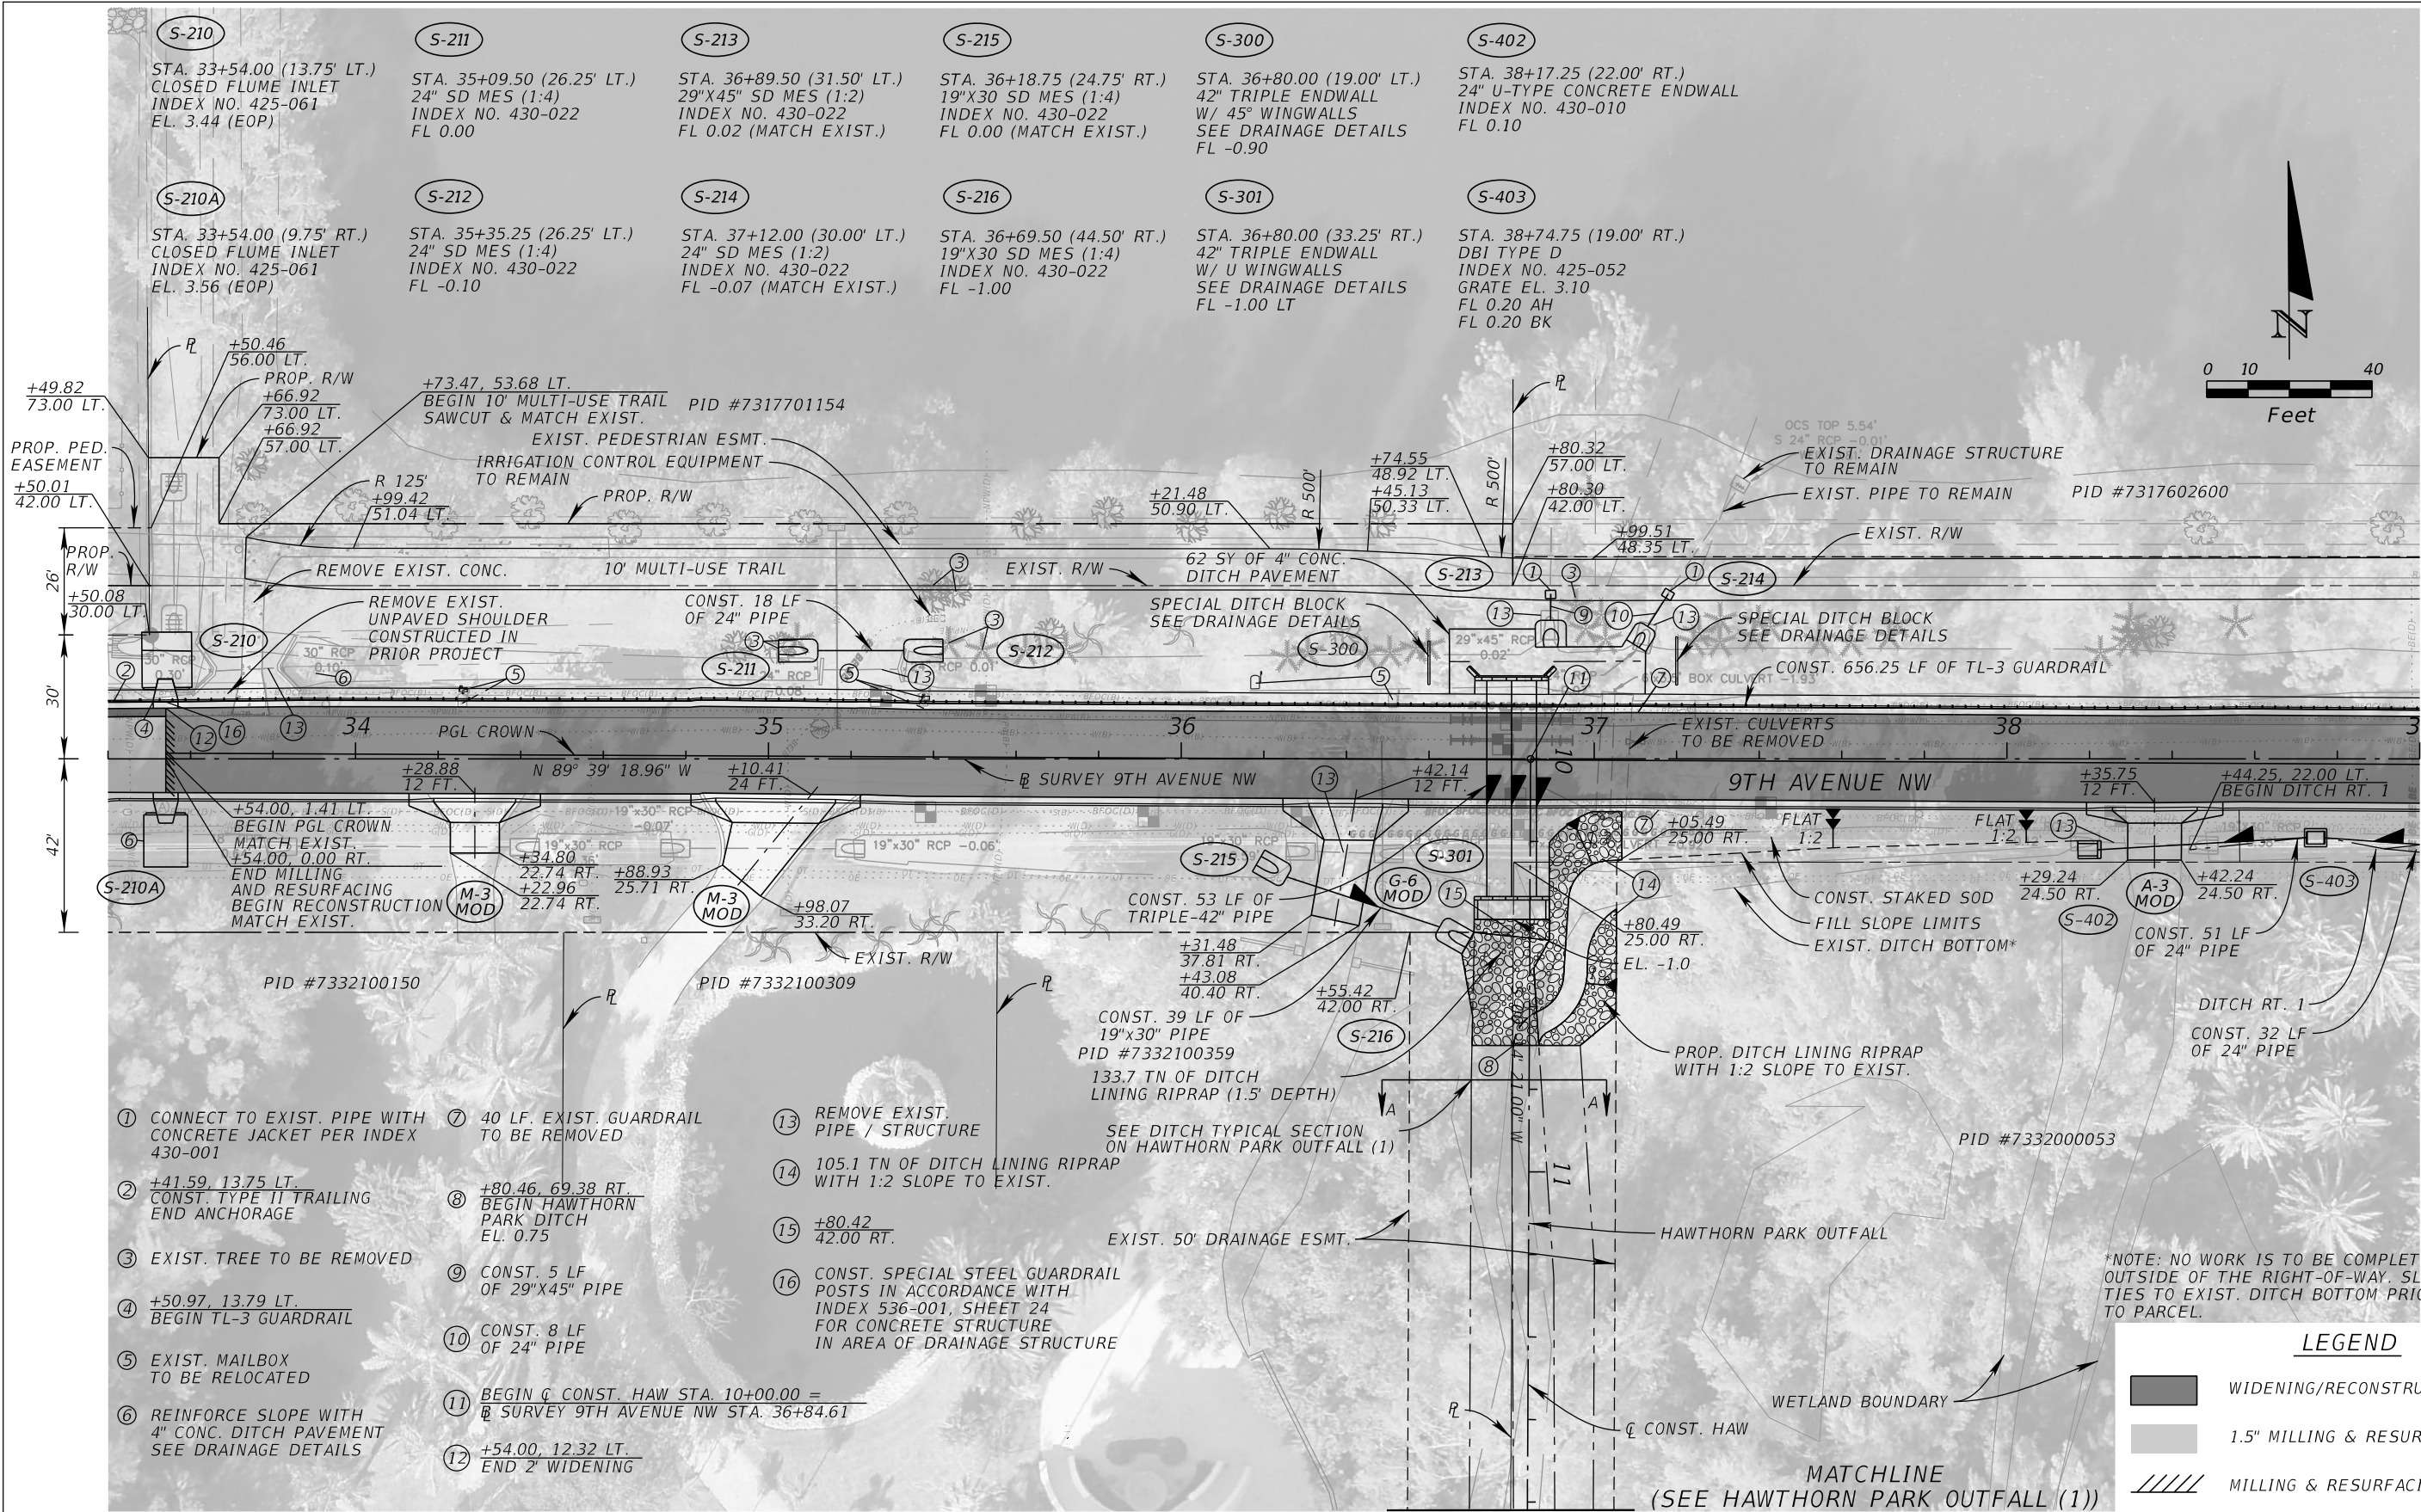
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JORDAN E. LEEP, P.E.  
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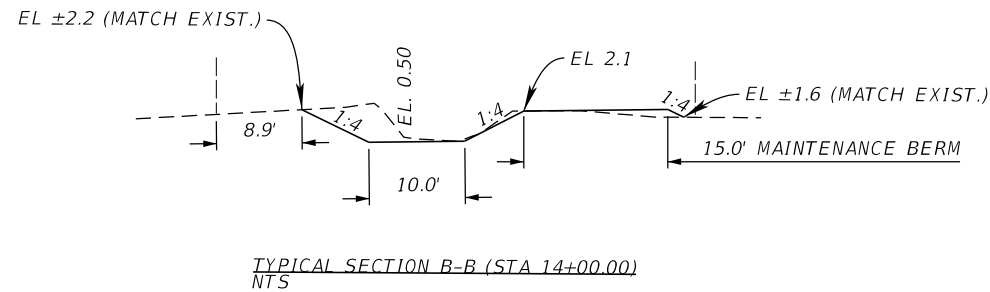
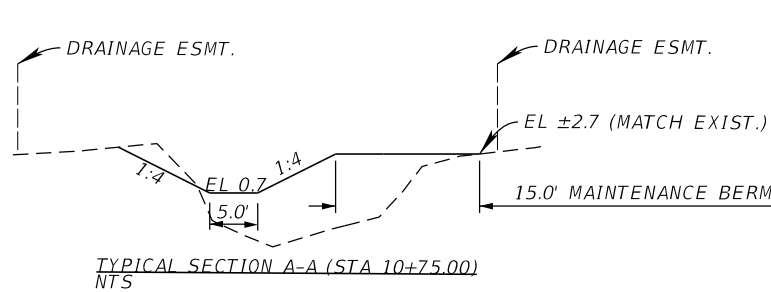
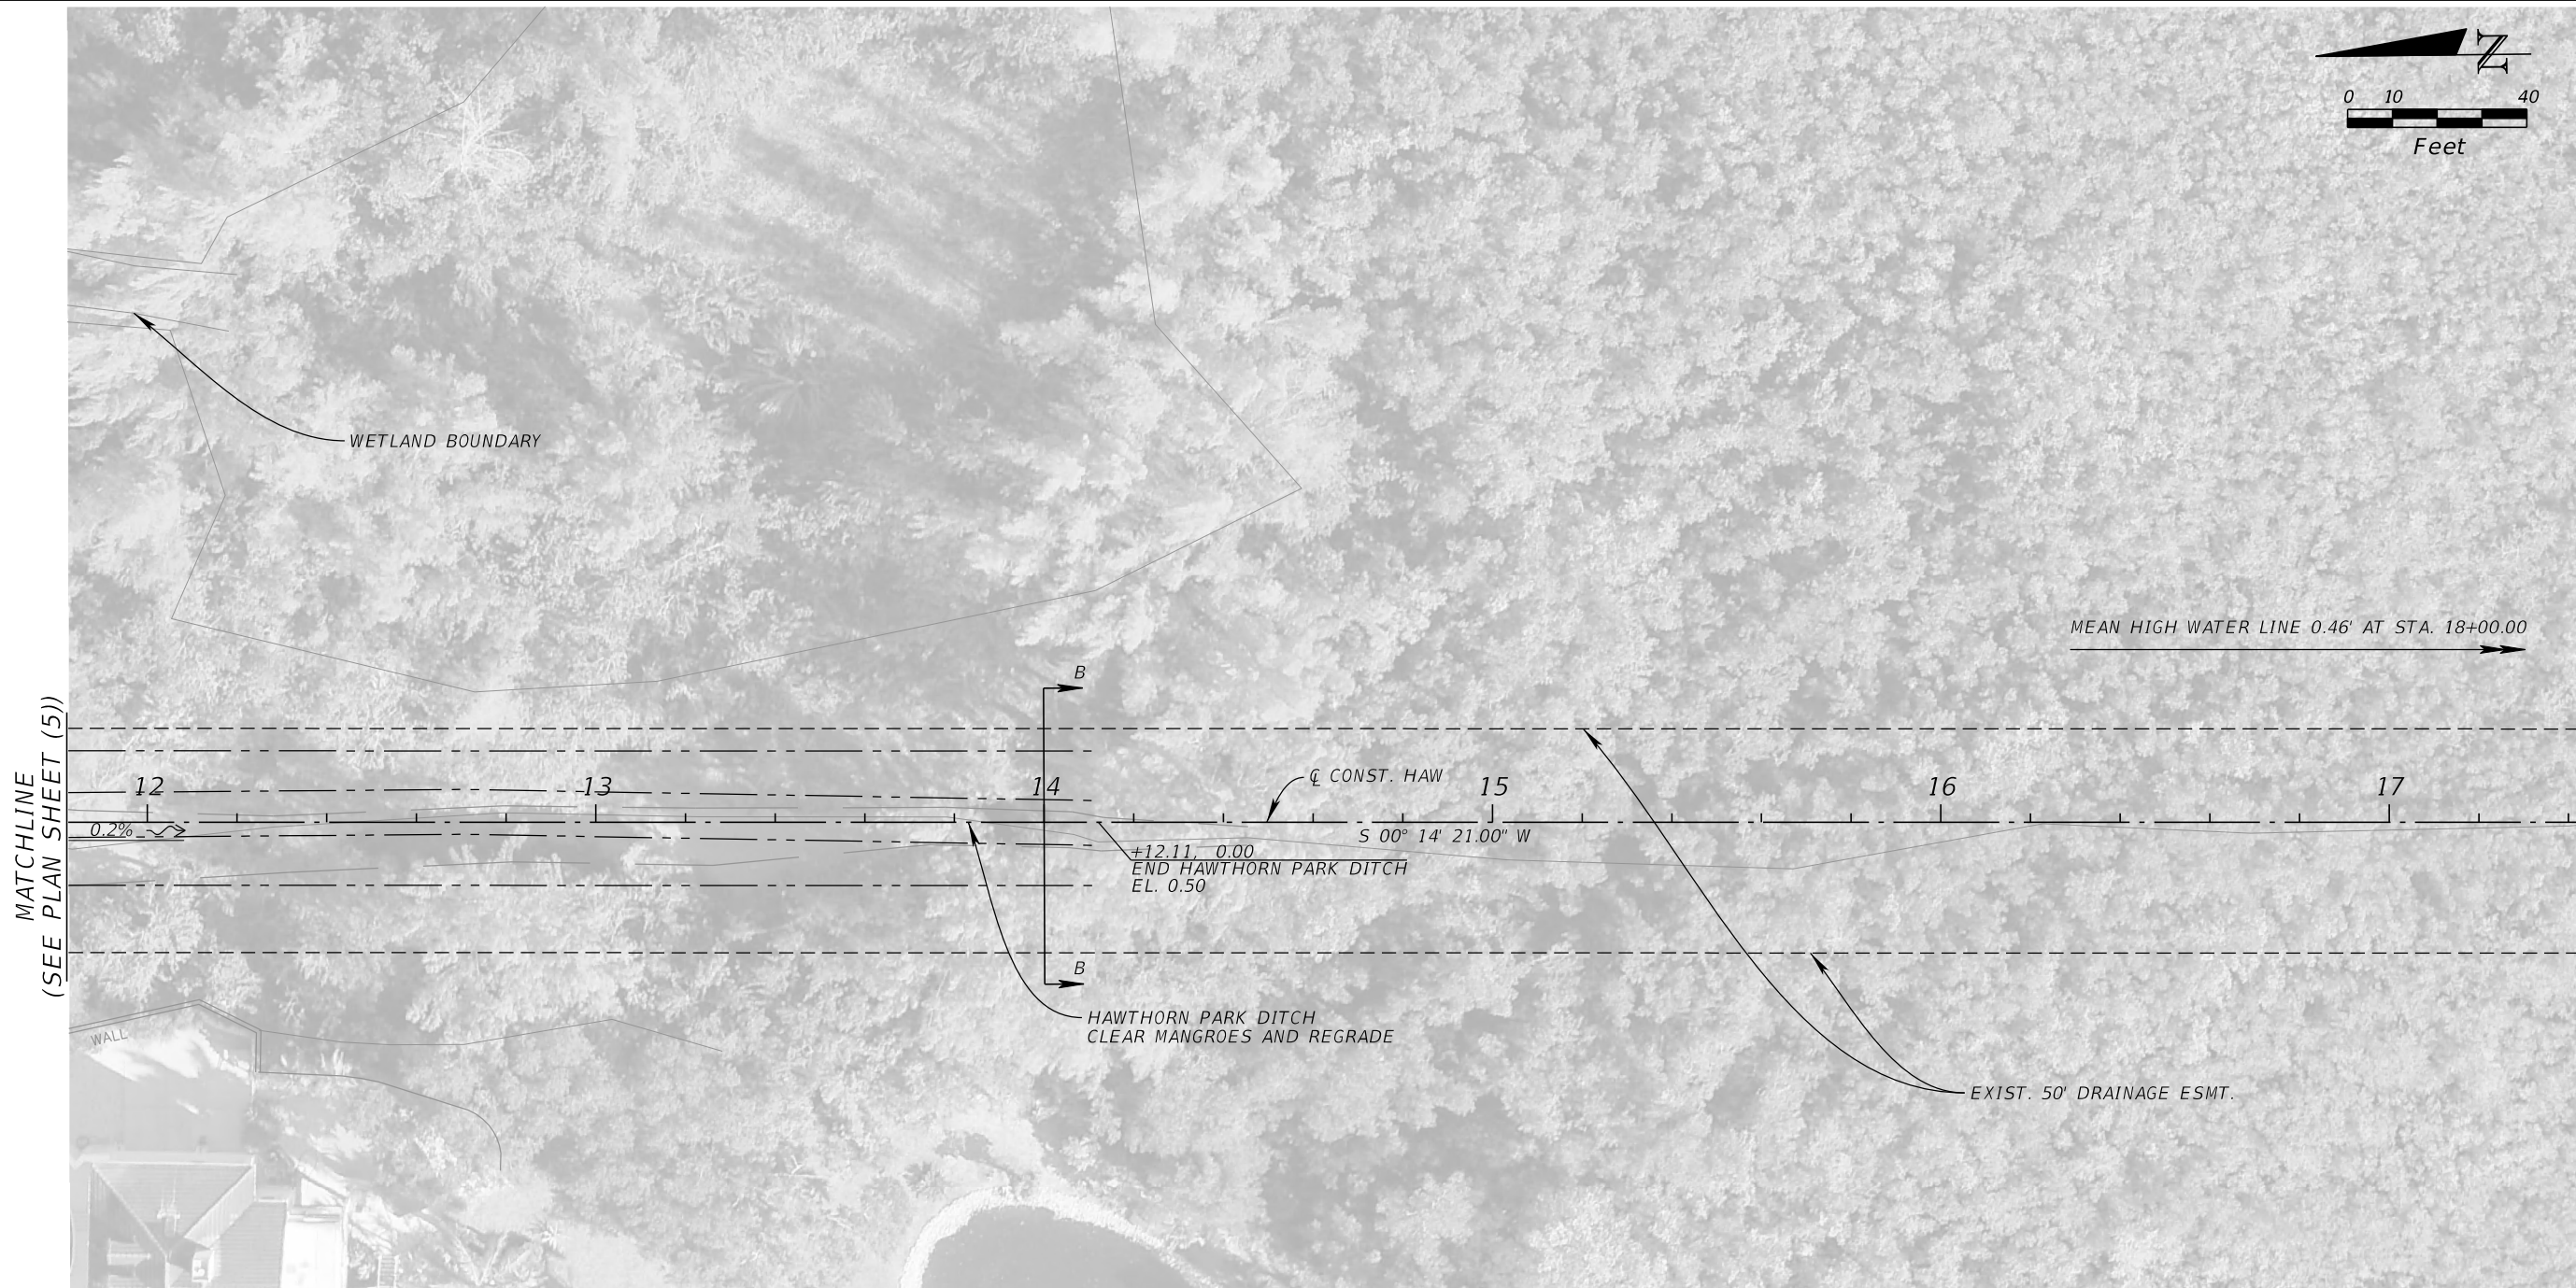
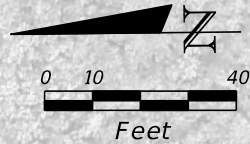
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THE OFFICIAL RECORD OF THIS SHEET IS THE ELECTRONIC FILE DIGITALLY SIGNED AND SEALED UNDER RULE 61G15-23.004, F.A.C.





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KHA PROJECT 148400070
DATE 10/02/2025
SCALE AS SHOWN
DESIGNED BY
DRAWN BY
CHECKED BY

9TH AVENUE NW  
MANATEE COUNTY  
FL


LICENSED PROFESSIONAL
JORDAN E. LEEP, P.E. FL LICENSE NUMBER 76102

**HAWTHORN PARK  
OUTFALL (1)**

SHEET NUMBER
34

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No.

REVISIONS

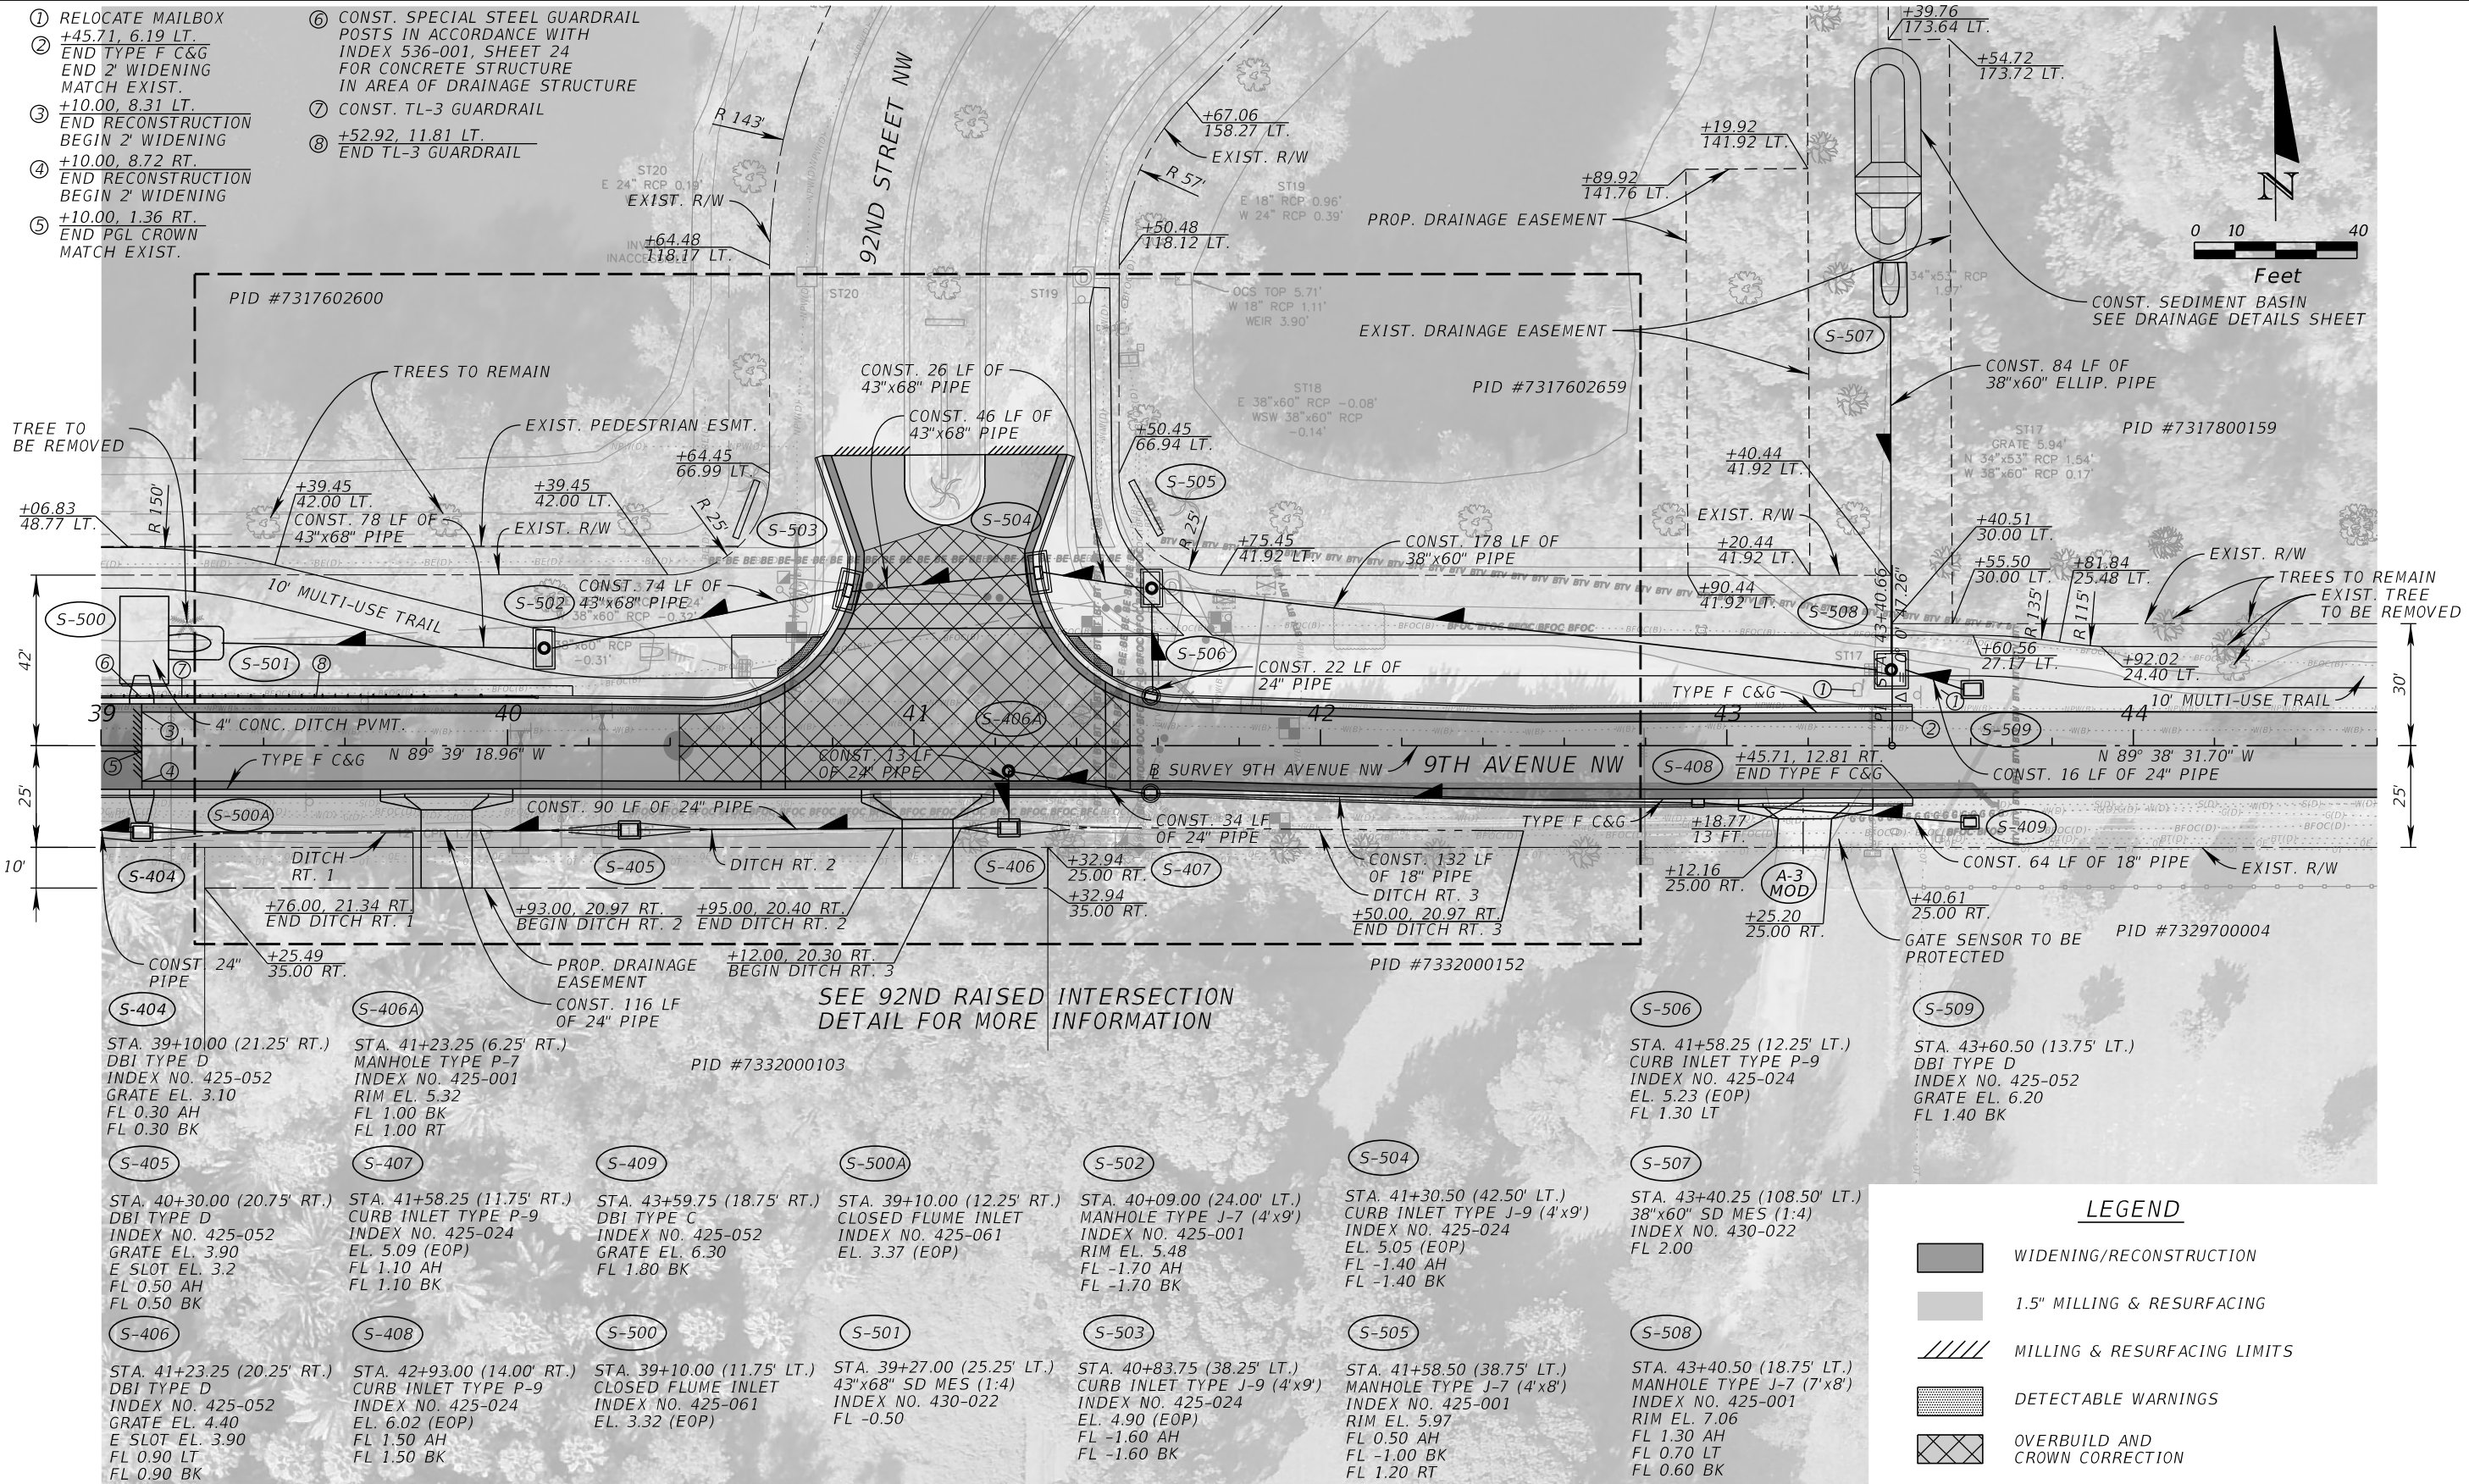DATE

BY

Joshua.Wassermann

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KHA PROJECT  
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10/02/2025

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MANATEE COUNTY

9TH AVENUE NW

LICENSED PROFESSIONAL

JORDAN E. LEEP, P.E.  
FL LICENSE NUMBER 76102

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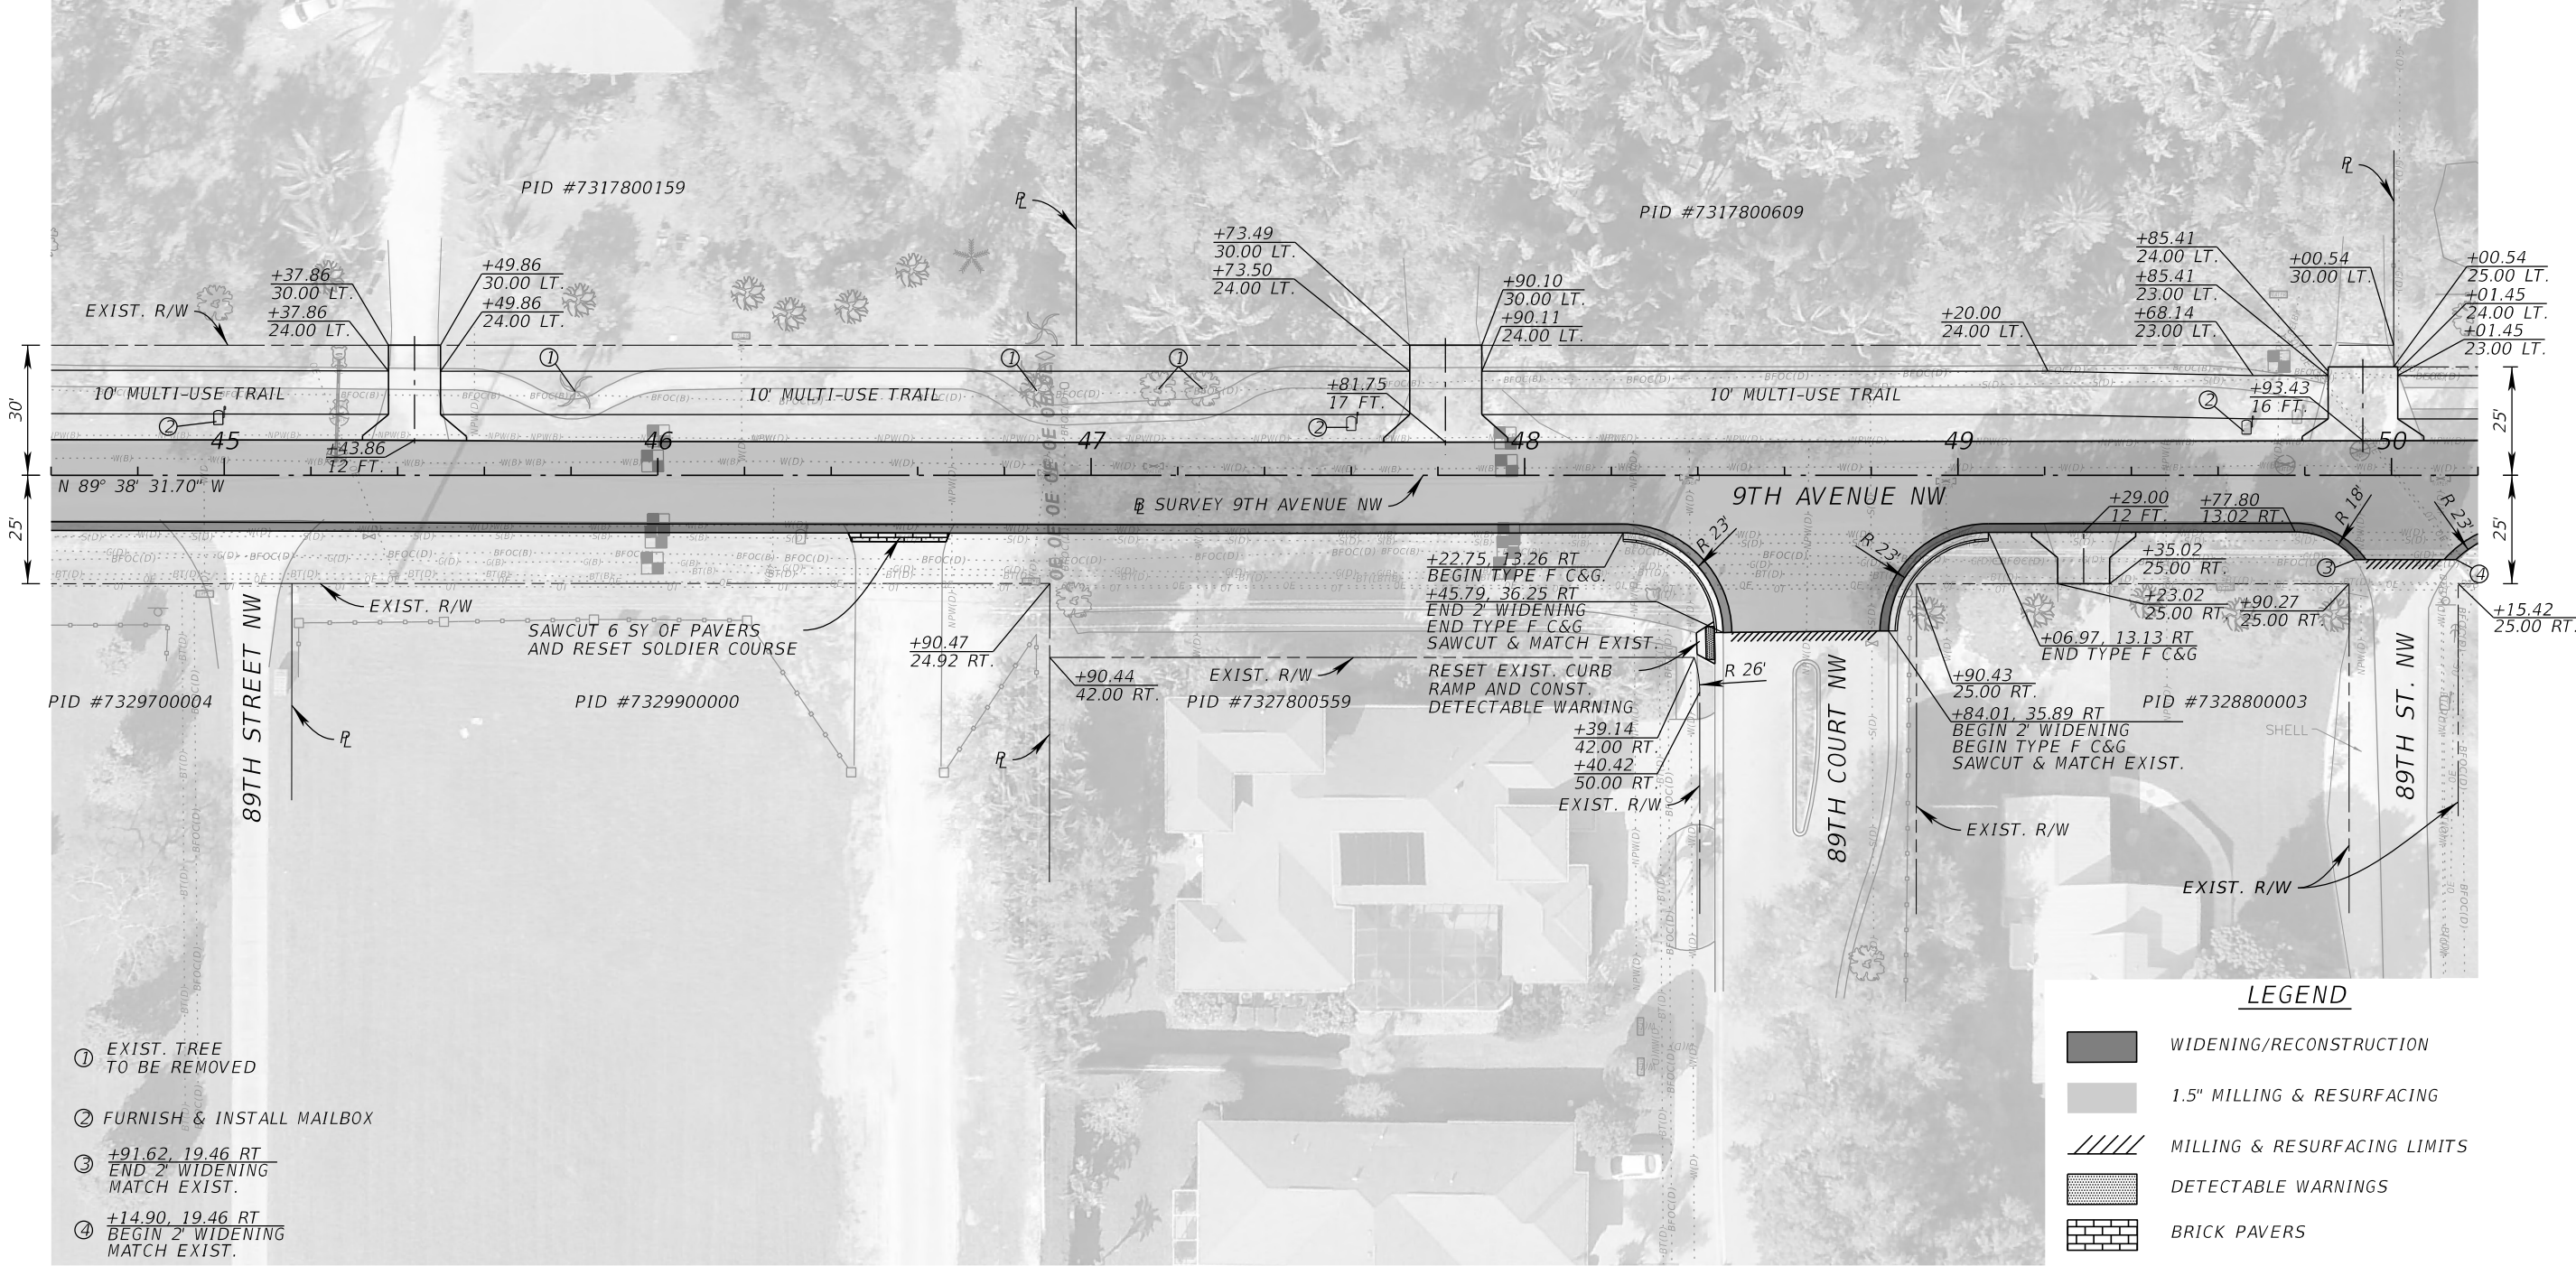
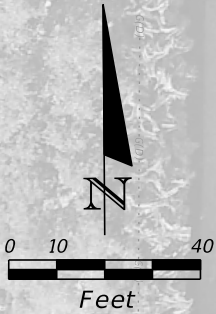
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PLAN SHEET (3)

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PLAN SHEET (4)


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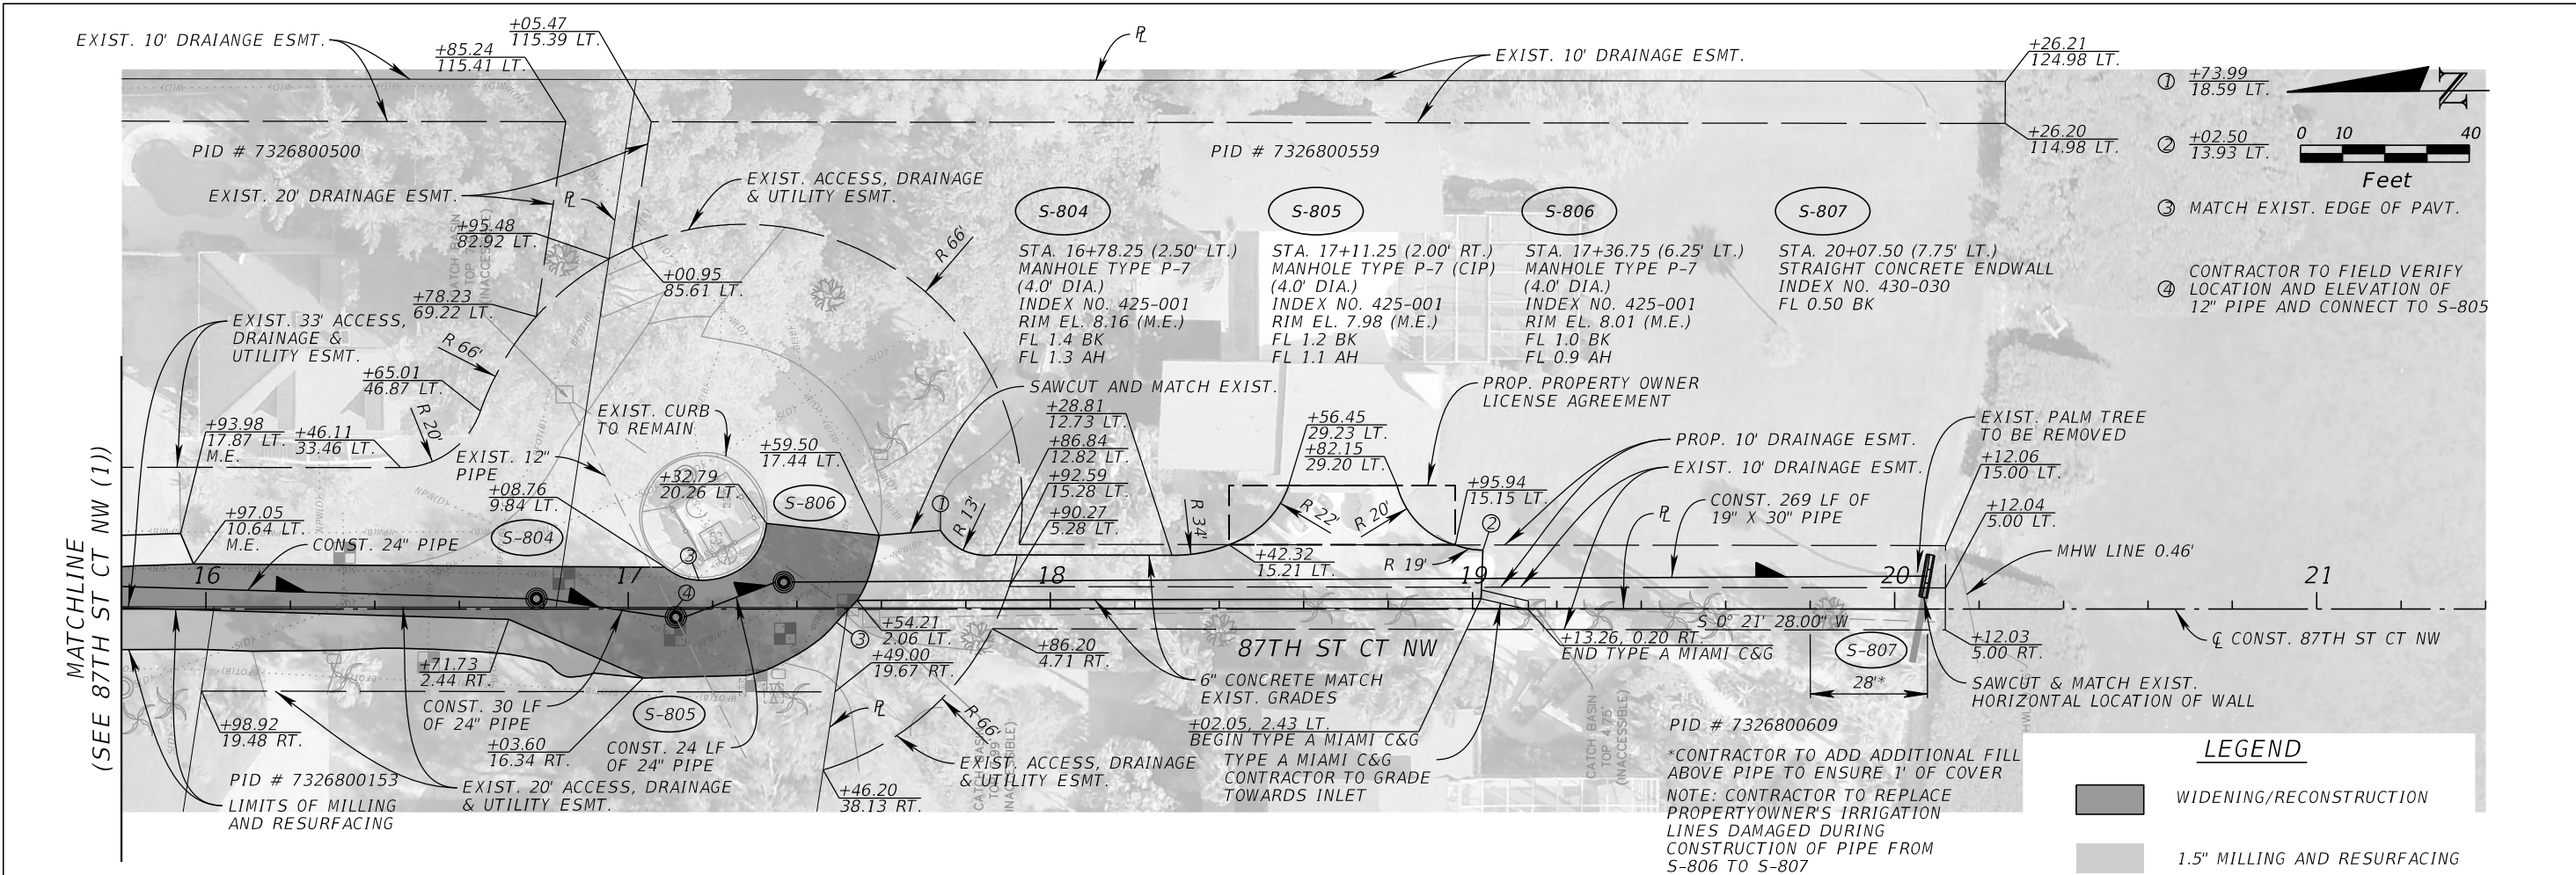
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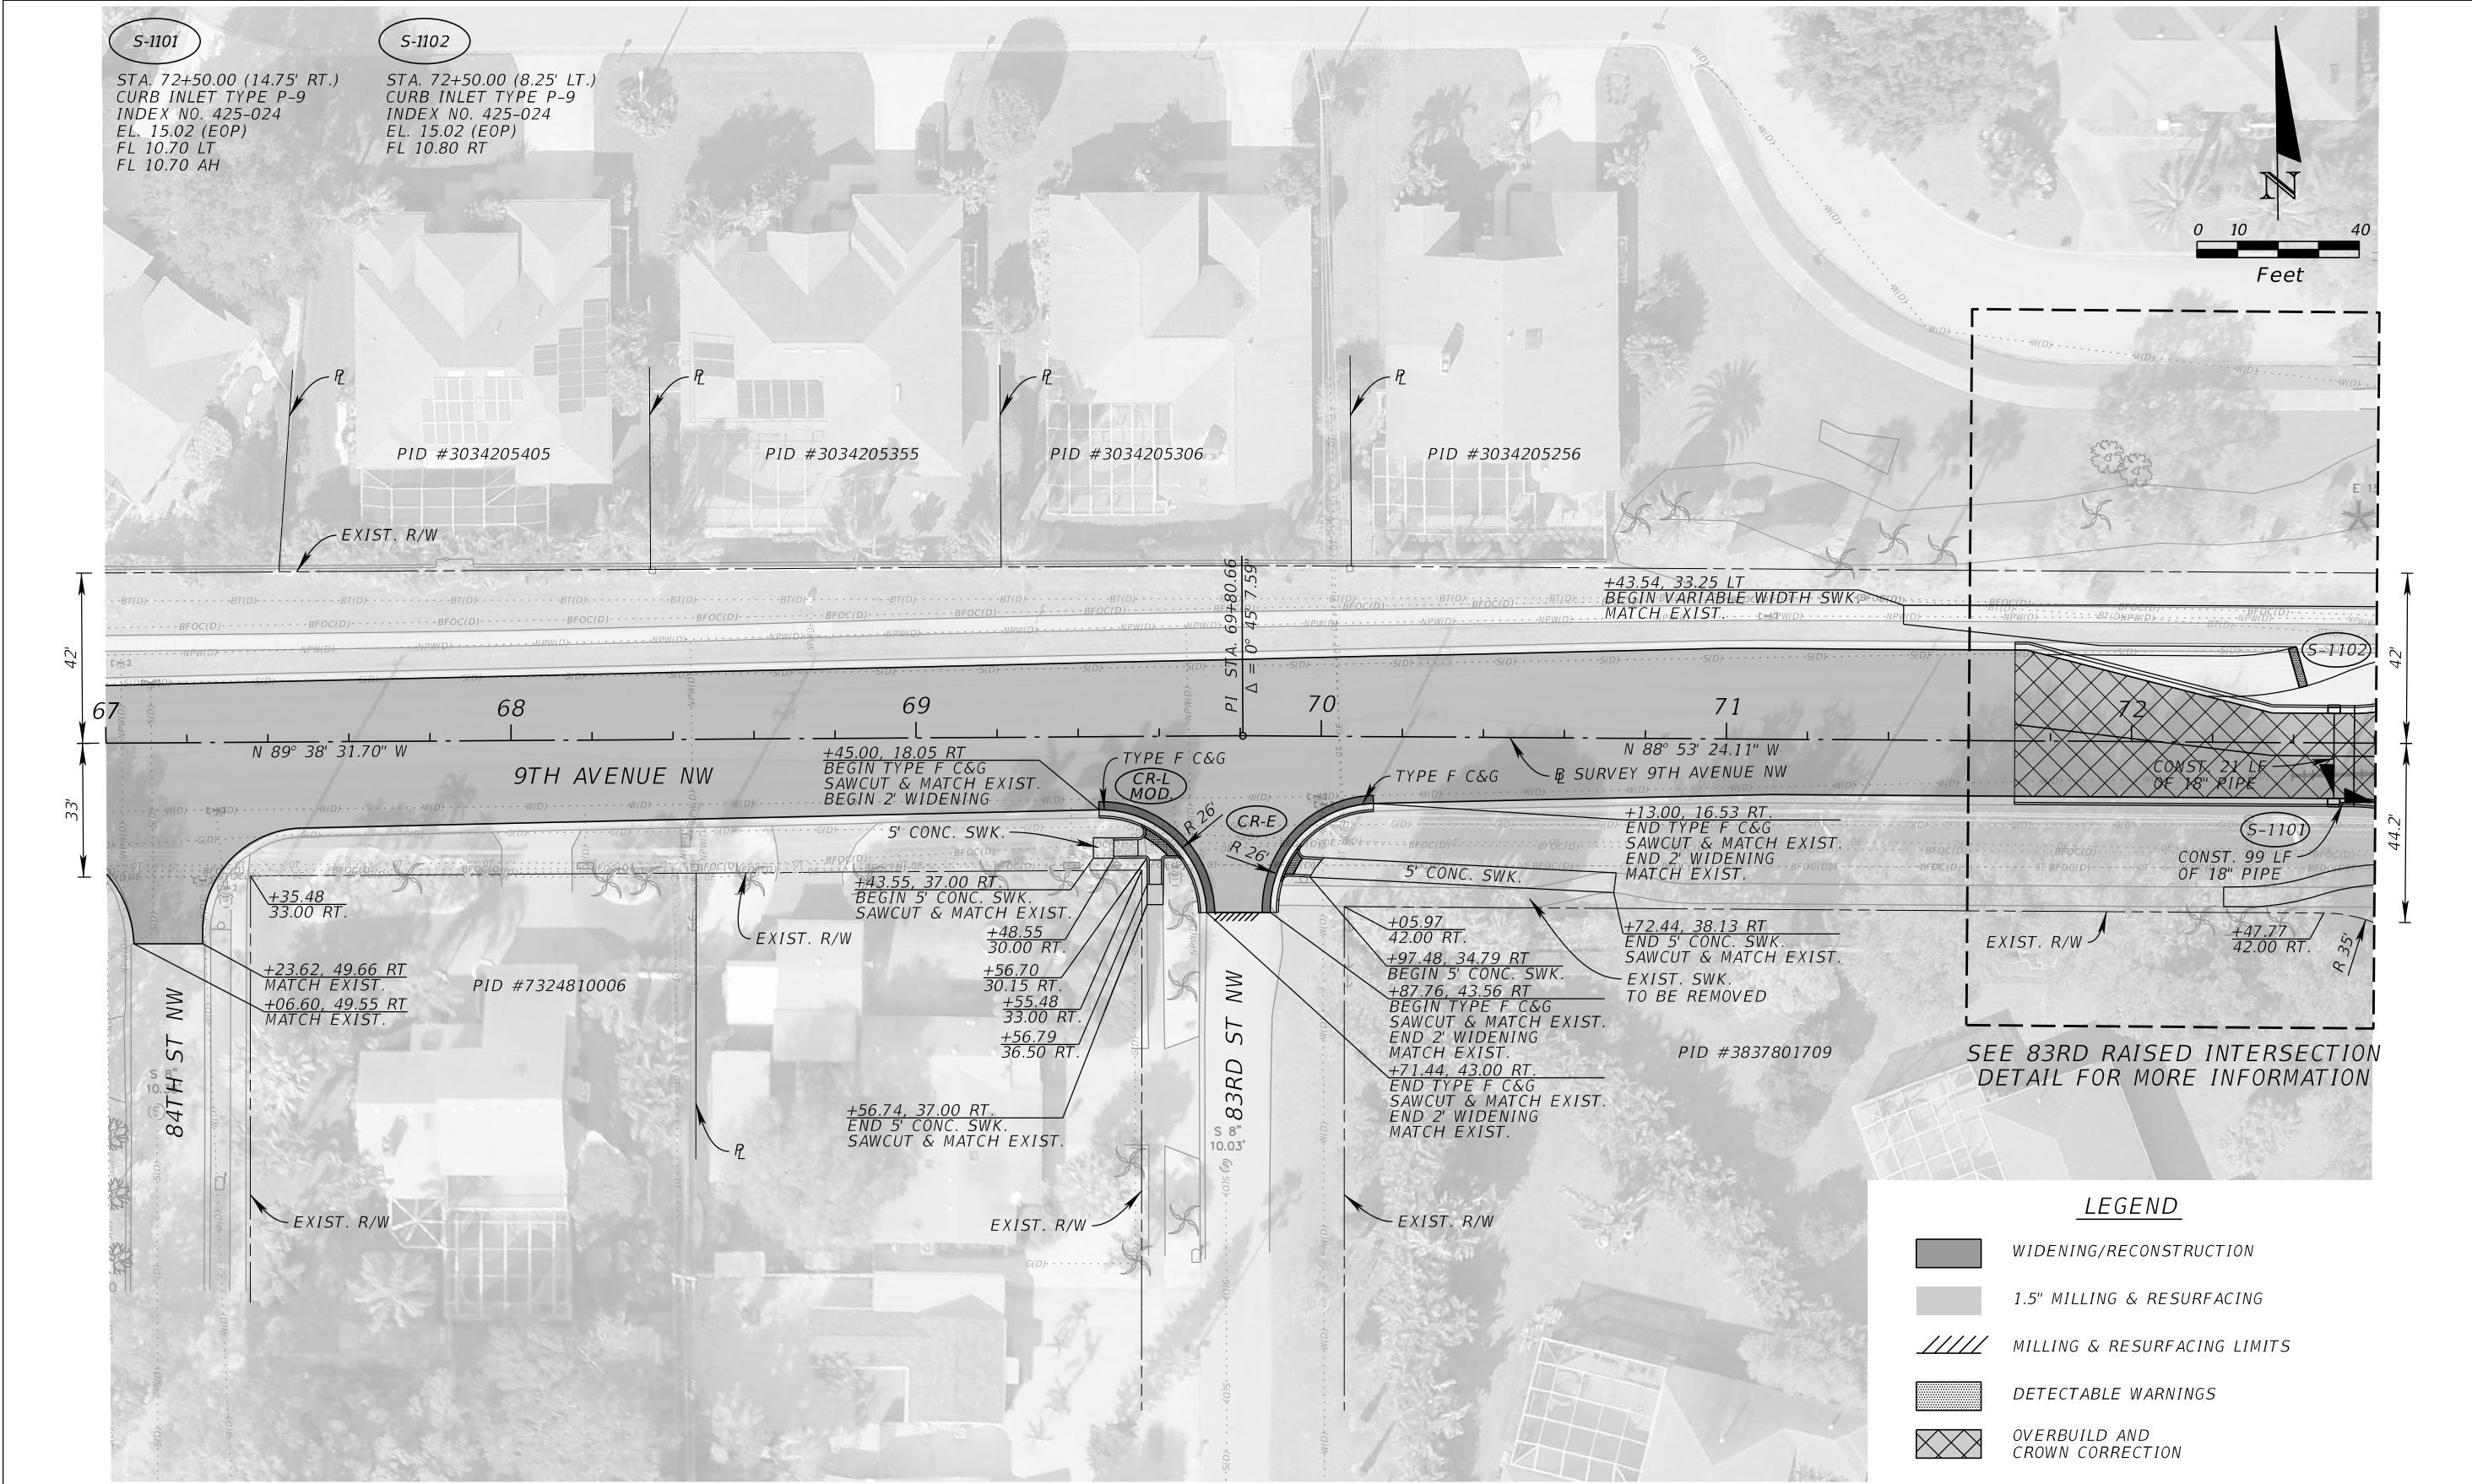










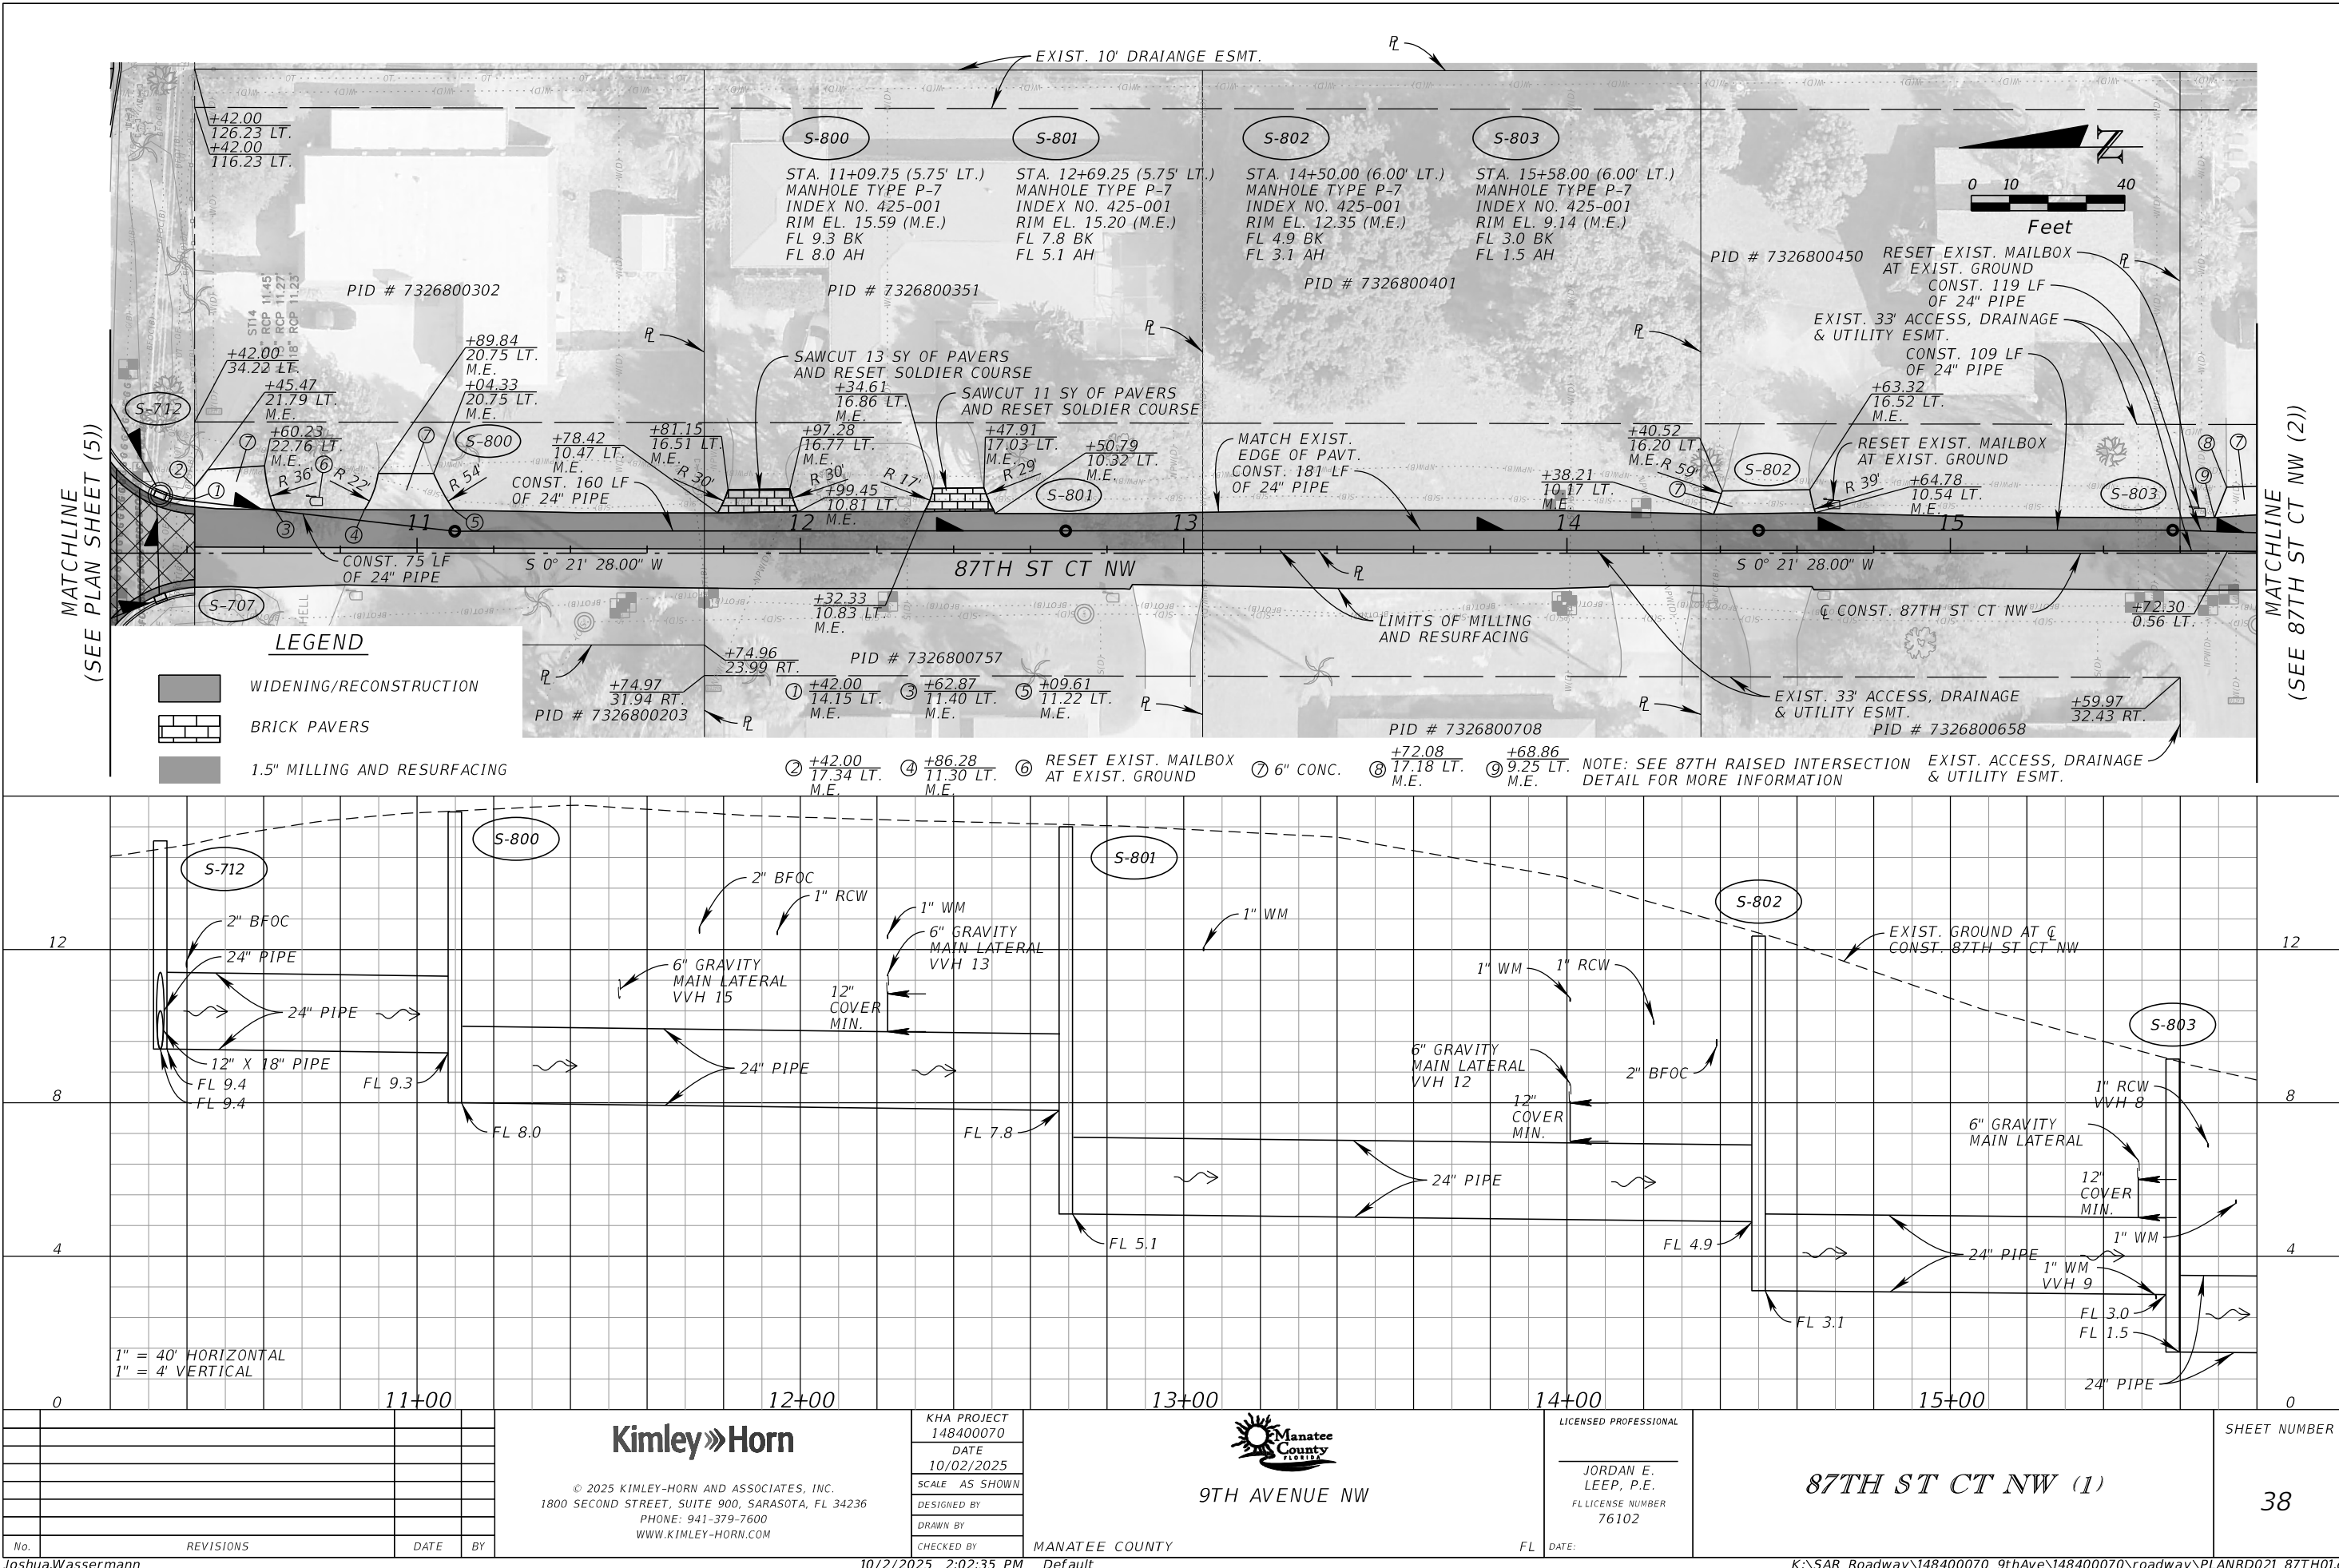

LEGEND	
	WIDENING/RECONSTRUCTION
	1.5" MILLING & RESURFACING
	MILLING & RESURFACING LIMITS
	DETECTABLE WARNINGS
	OVERBUILD AND CROWN CORRECTION

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9TH AVENUE NW

MANATEE COUNTY

LICENSED PROFESSIONAL

JORDAN E. LEEP, P.E.  
FL LICENSE NUMBER  
76102


FL DATE:

PLAN SHEET (8)

SHEET NUMBER

42

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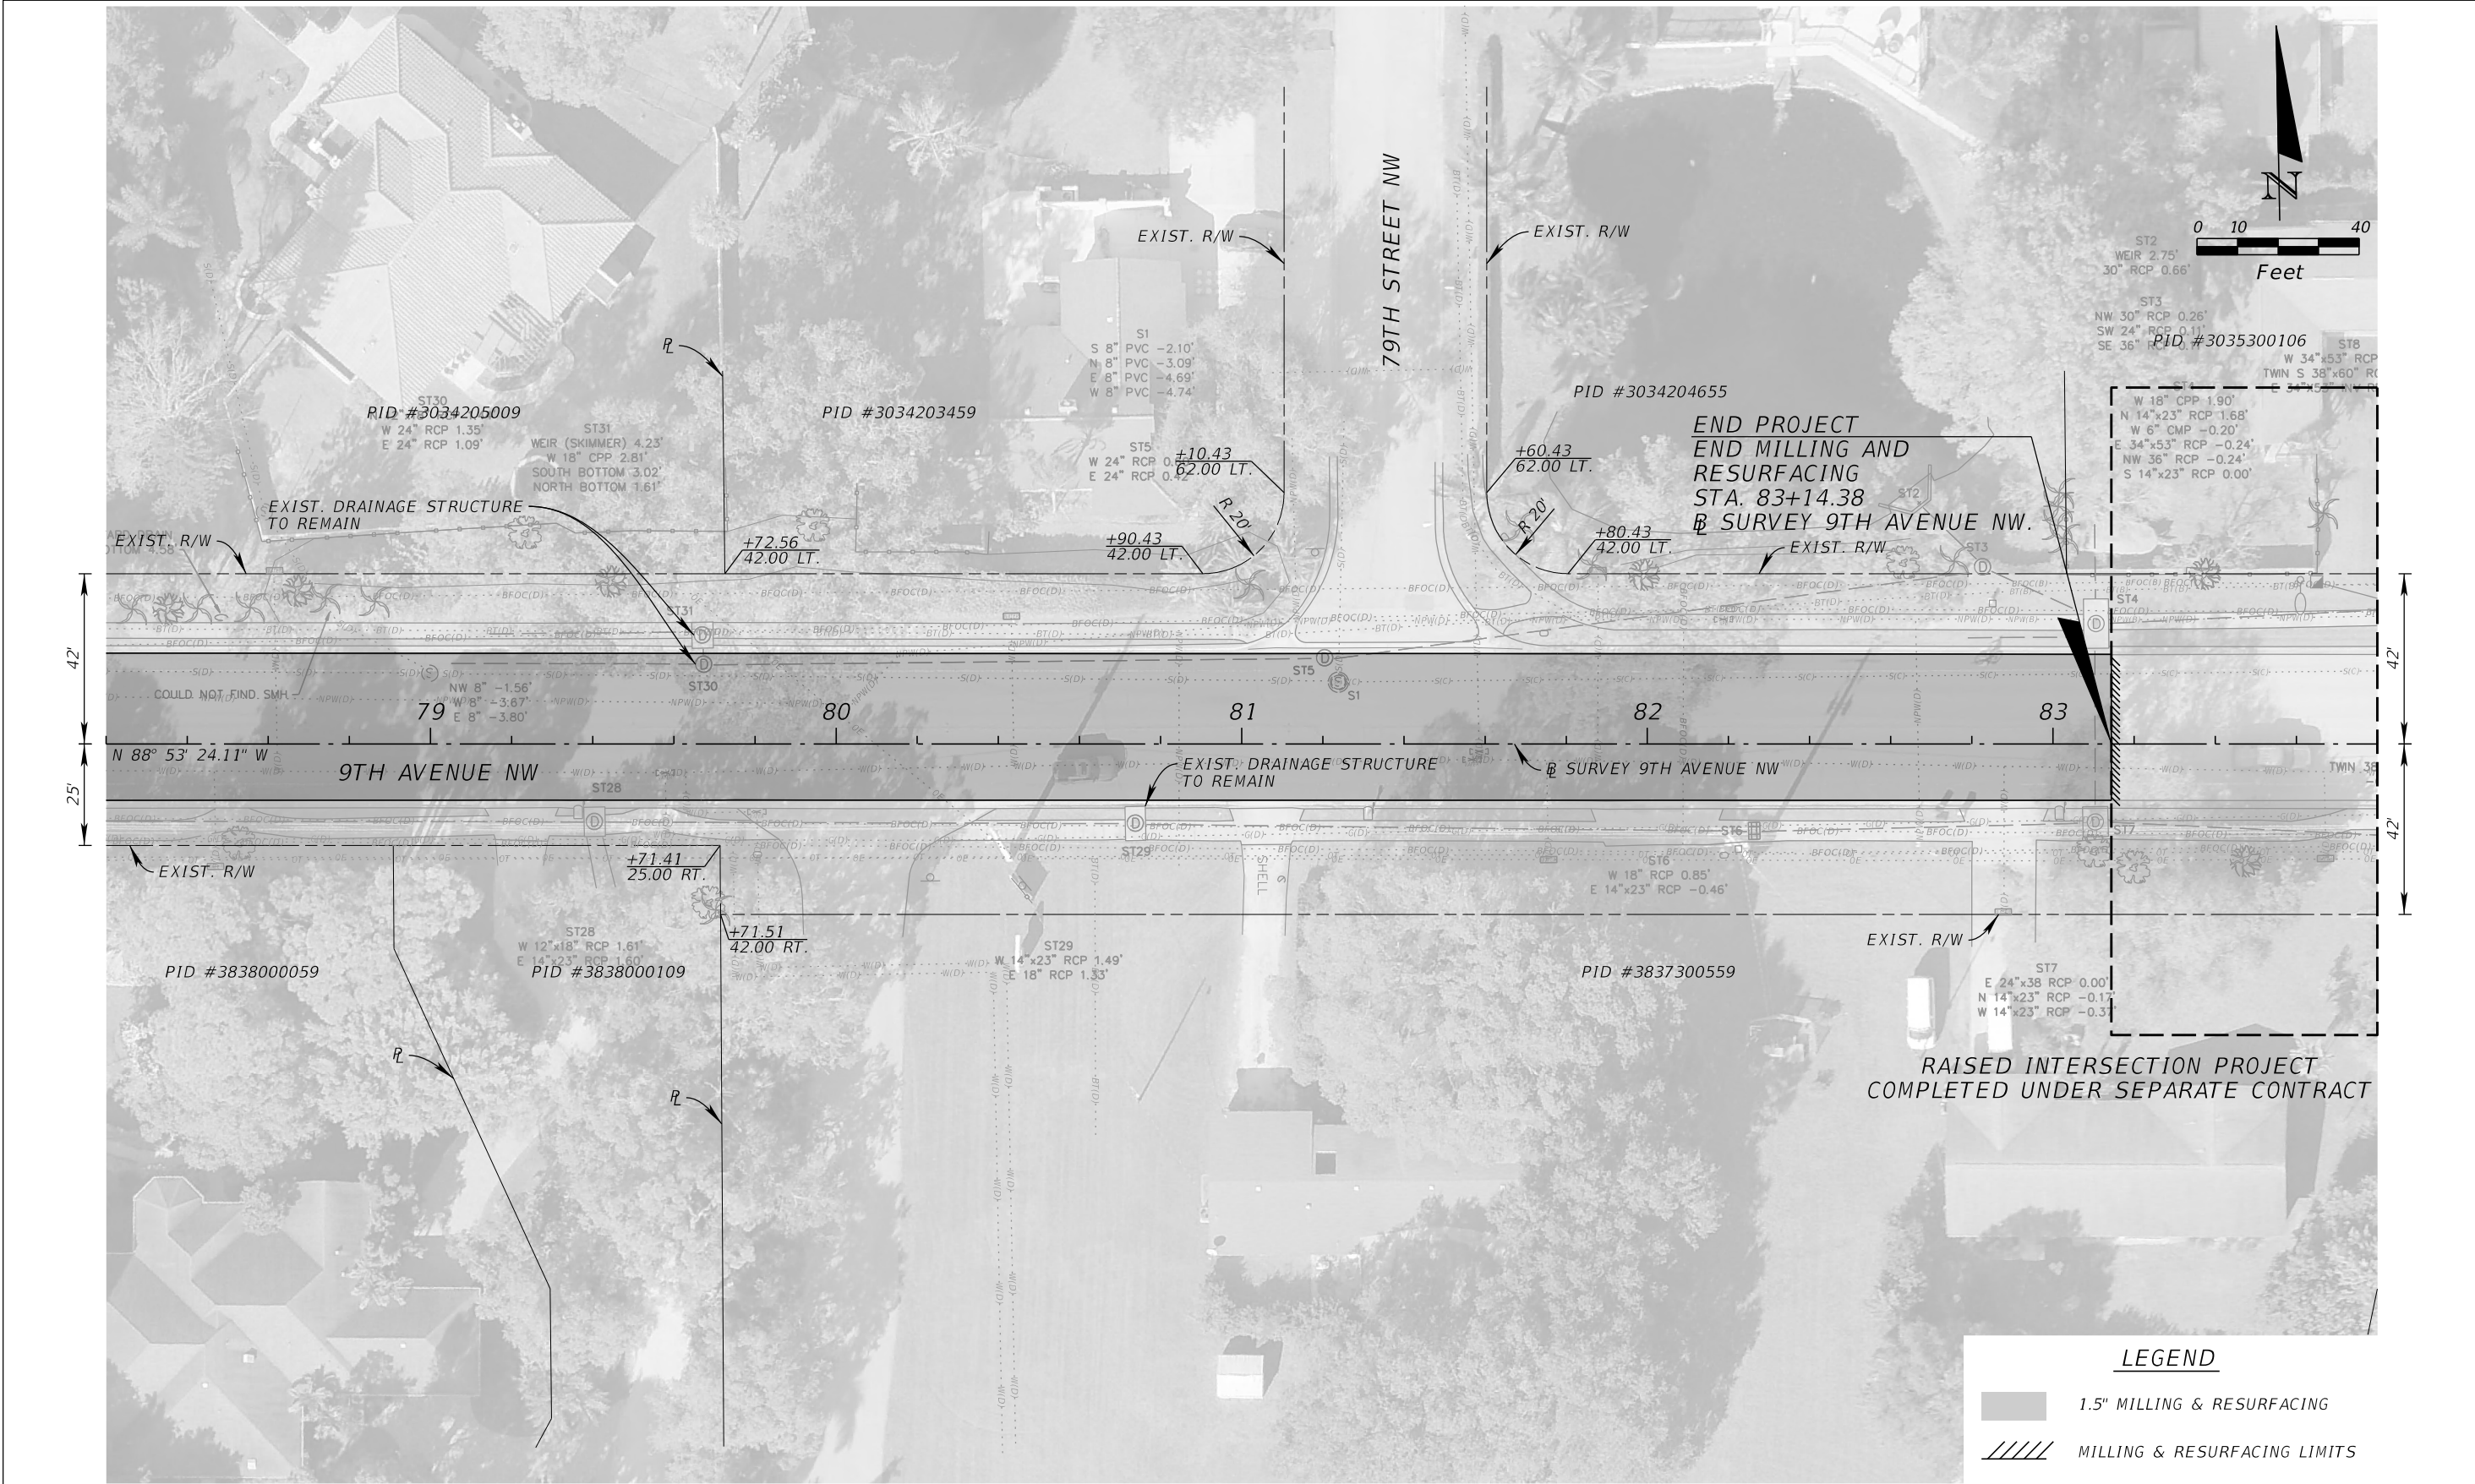
SEE 83RD RAISED INTERSECTION  
DETAIL FOR MORE INFORMATION

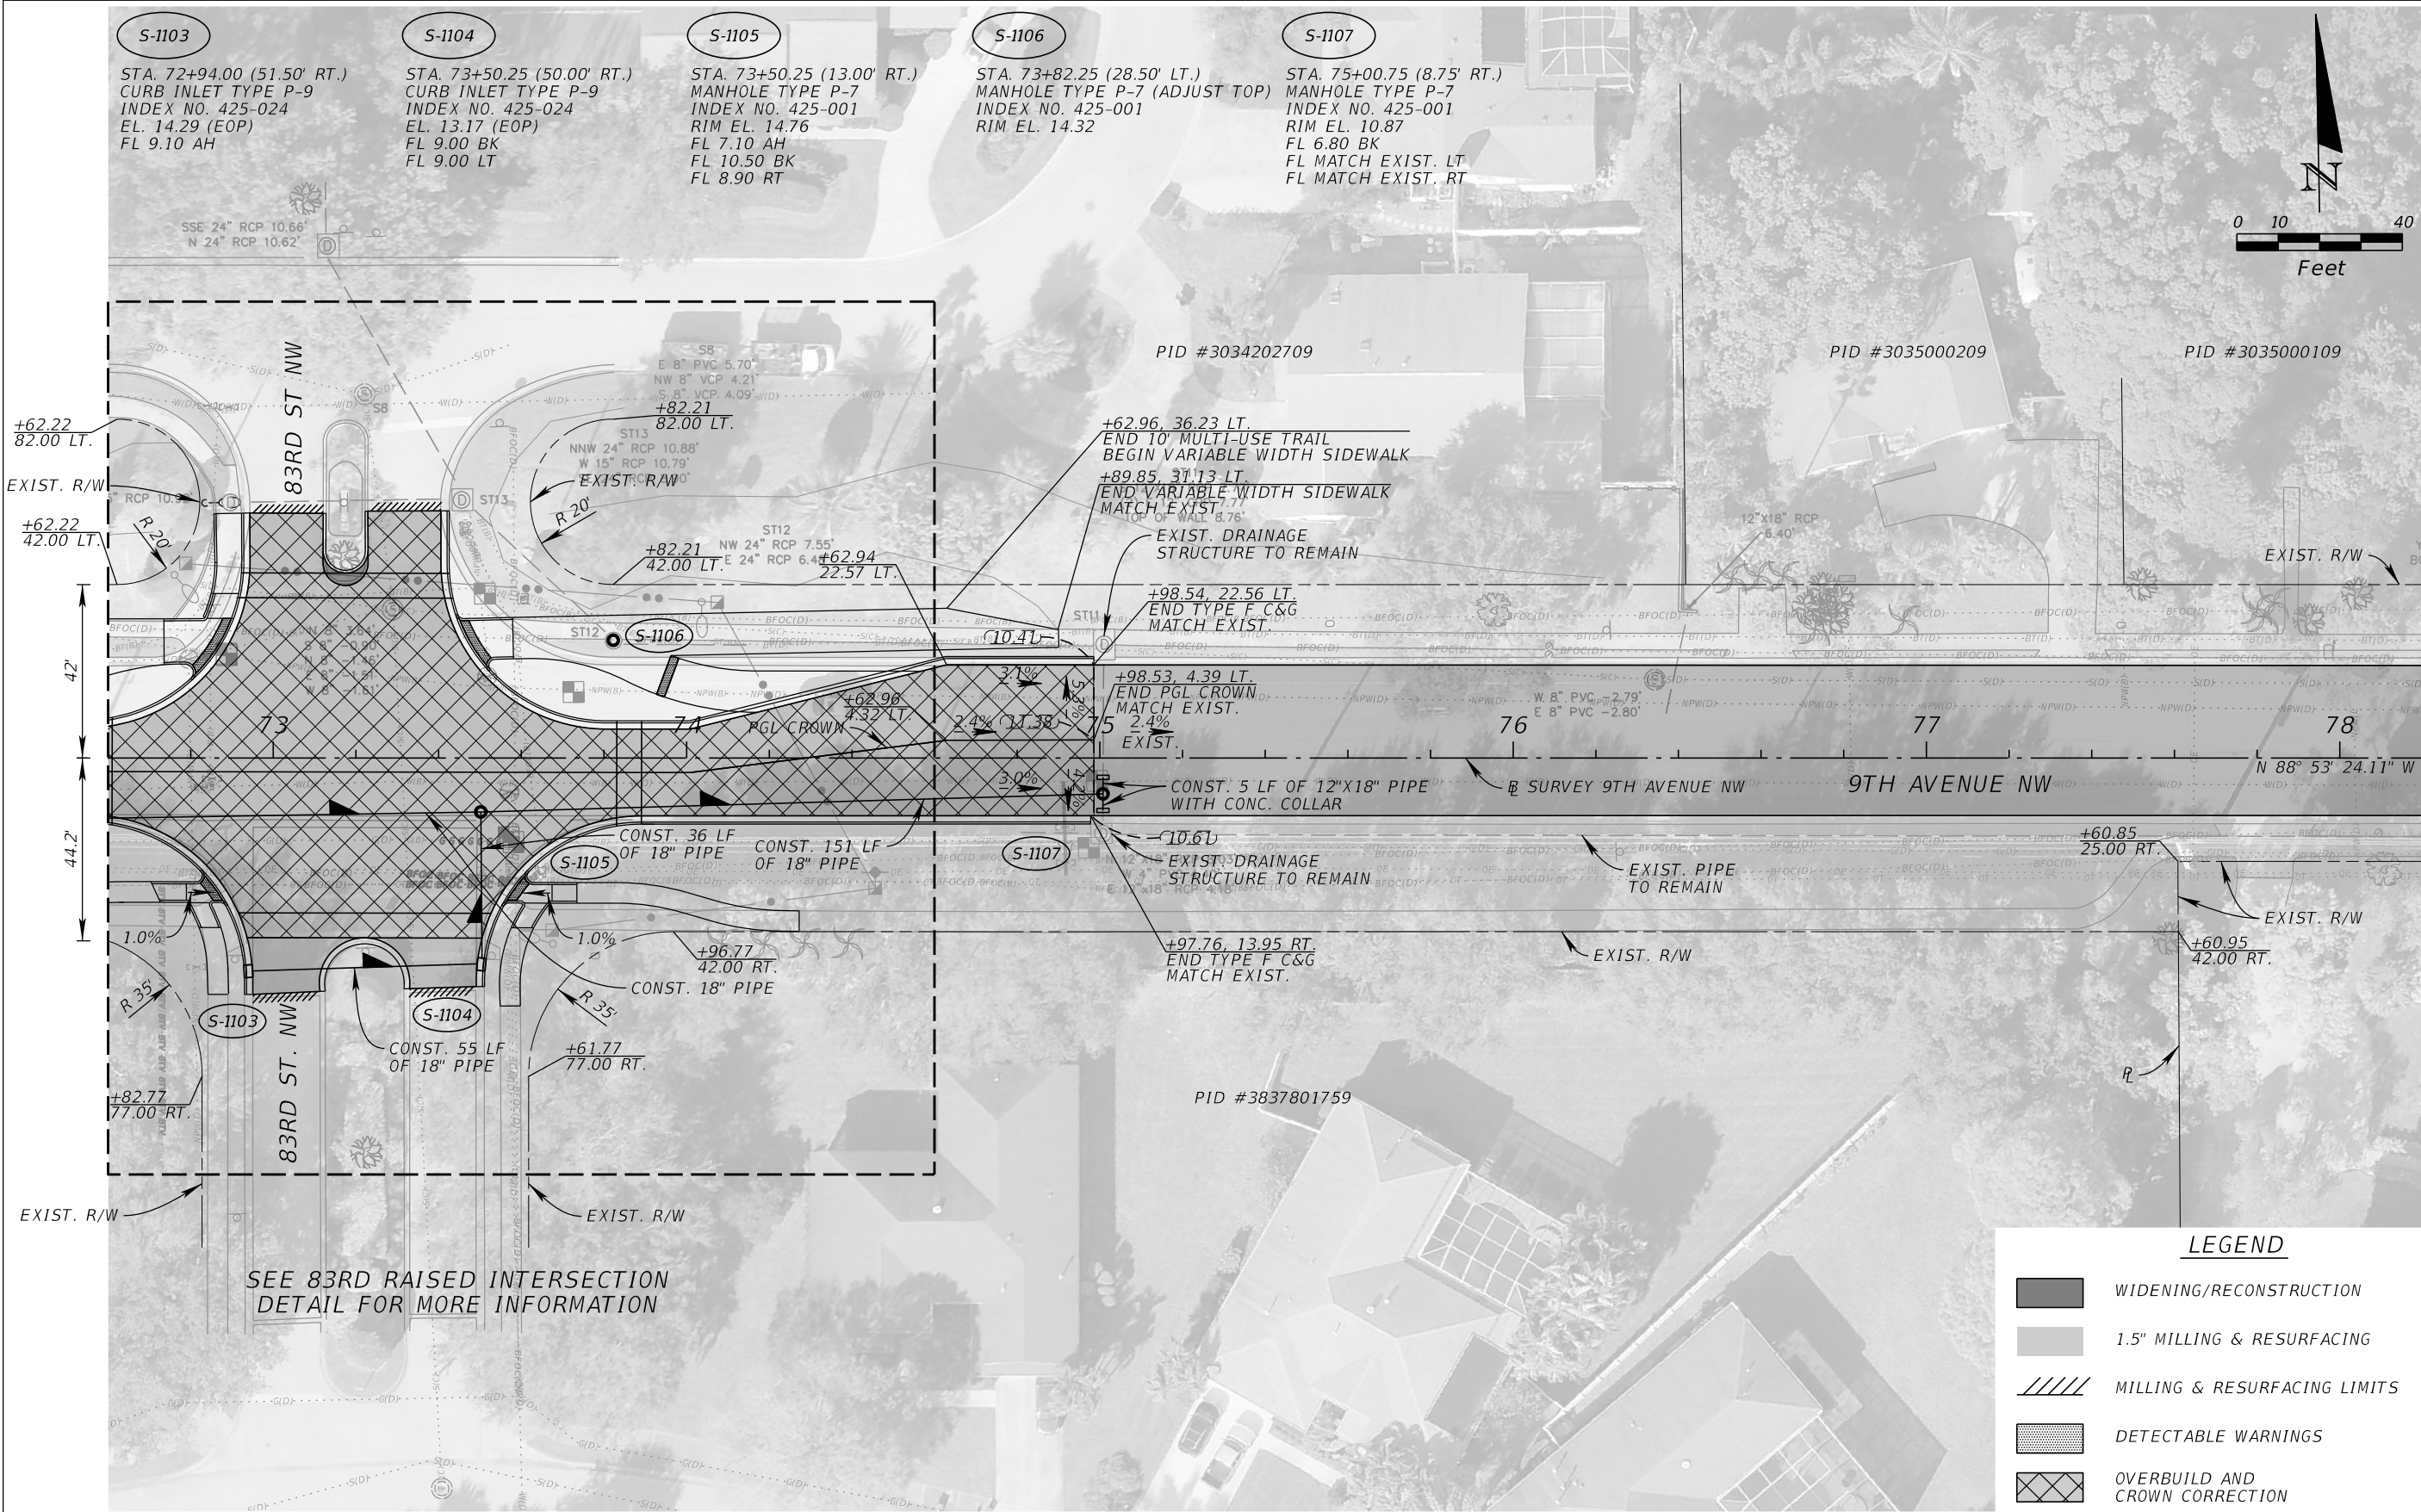LEGEND	
	WIDENING/RECONSTRUCTION
	1.5" MILLING & RESURFACING
	MILLING & RESURFACING LIMITS
	DETECTABLE WARNINGS
	OVERBUILD AND CROWN CORRECTION

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No.	REVISIONS	DATE	BY

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			<div>DATE 10/02/2025</div>							
			<div>SCALE AS SHOWN</div>							
			<div>DESIGNED BY</div>							
			<div>DRAWN BY</div>							
			<div>CHECKED BY</div>							
No.	REVISIONS	DATE	BY				FL	DATE:		

THE OFFICIAL RECORD OF THIS SHEET IS THE ELECTRONIC FILE DIGITALLY SIGNED AND SEALED UNDER RULE 61G15-23.004, F.A.C.



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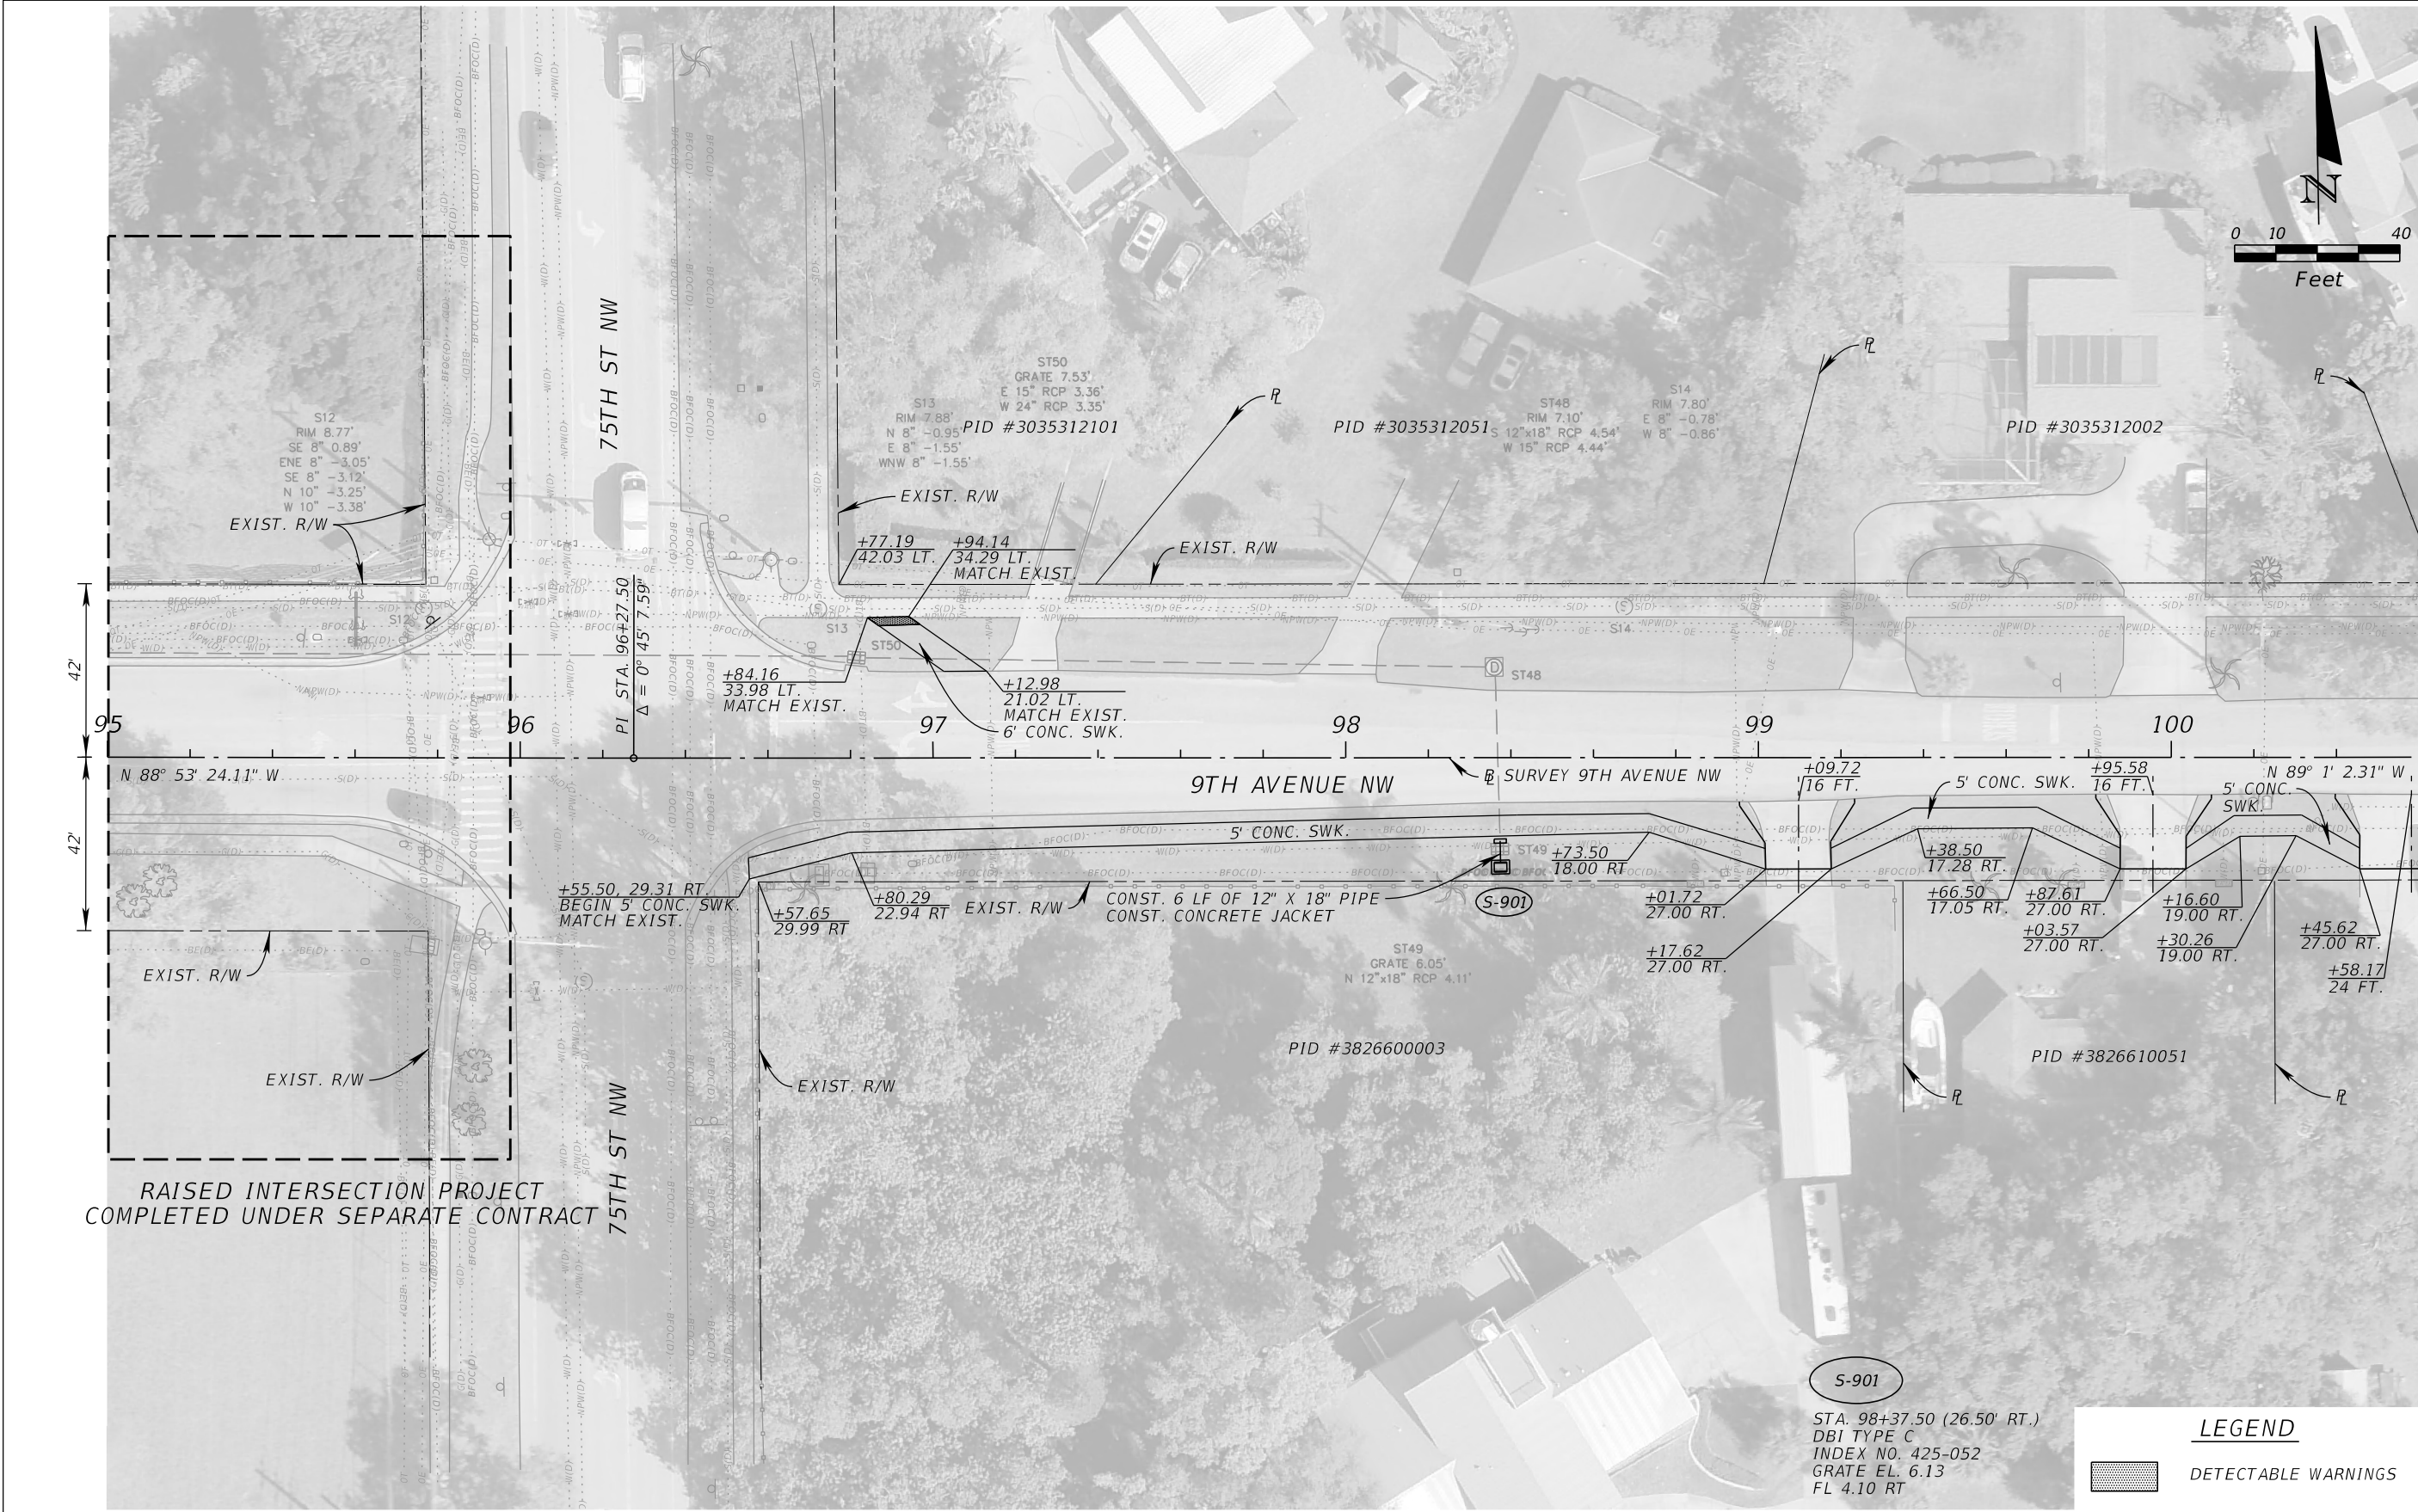
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No.	REVISIONS	DATE	BY						

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


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9TH AVENUE NW

MANATEE COUNTY

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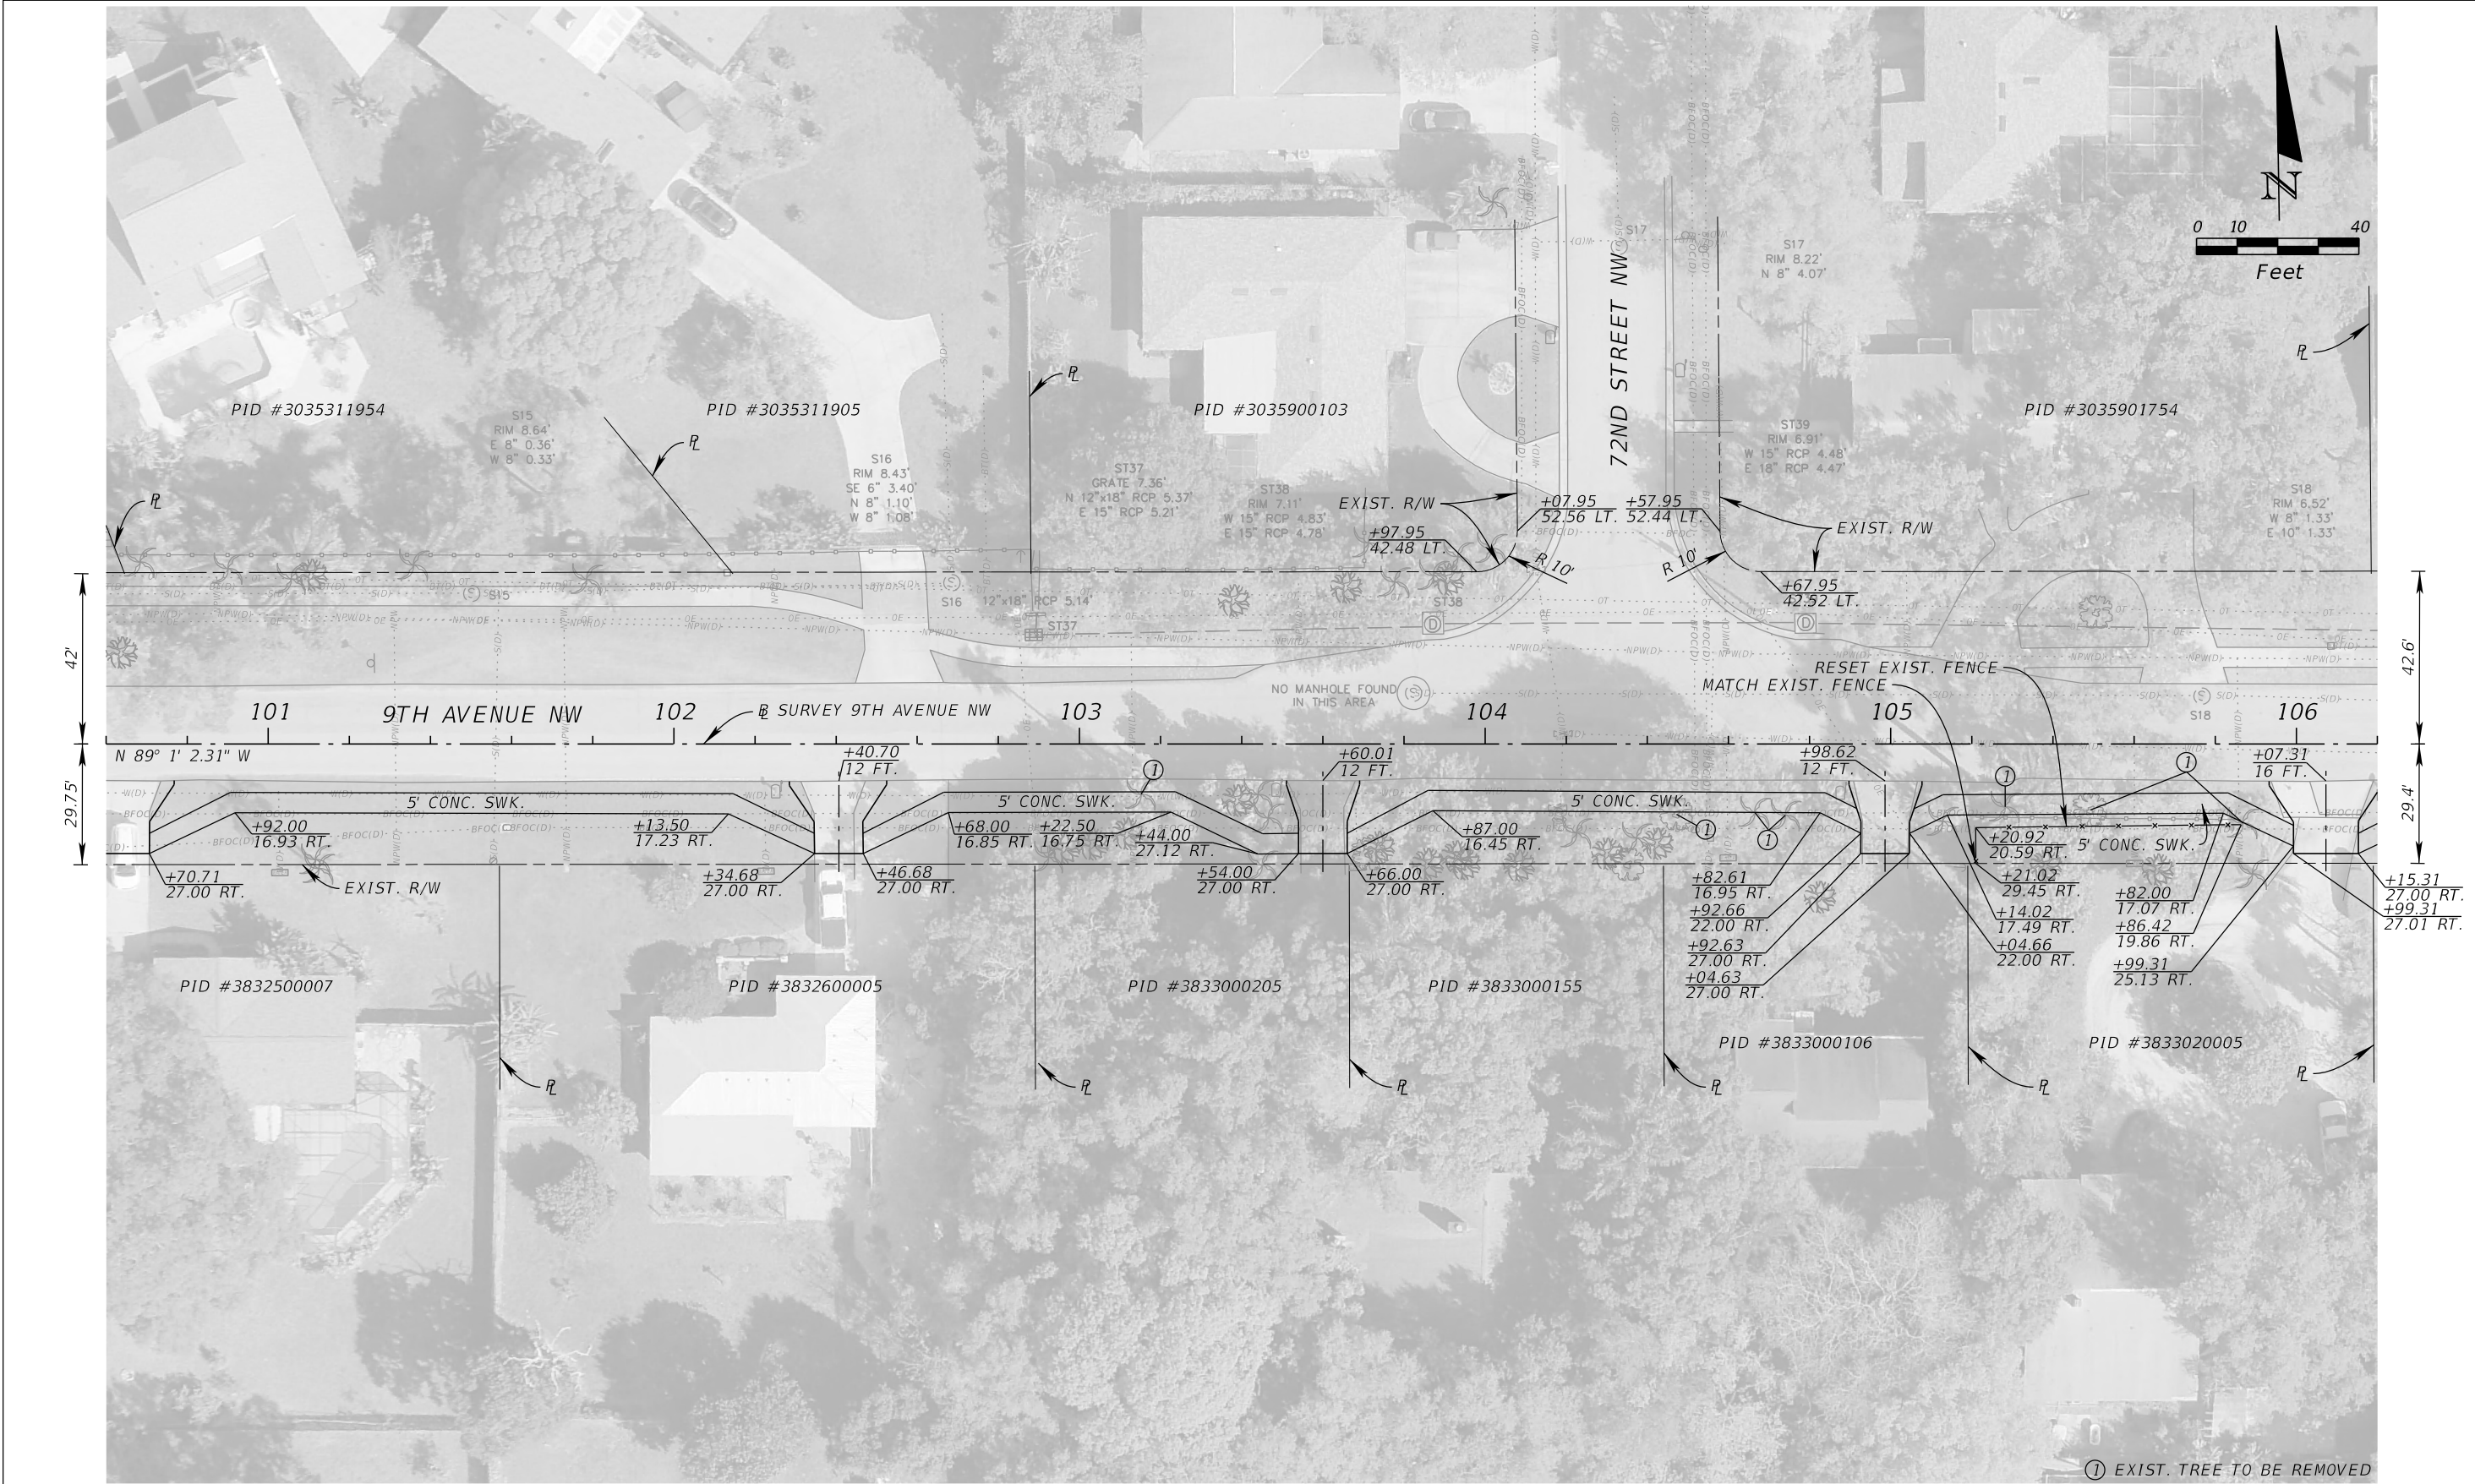
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PLAN SHEET (13)

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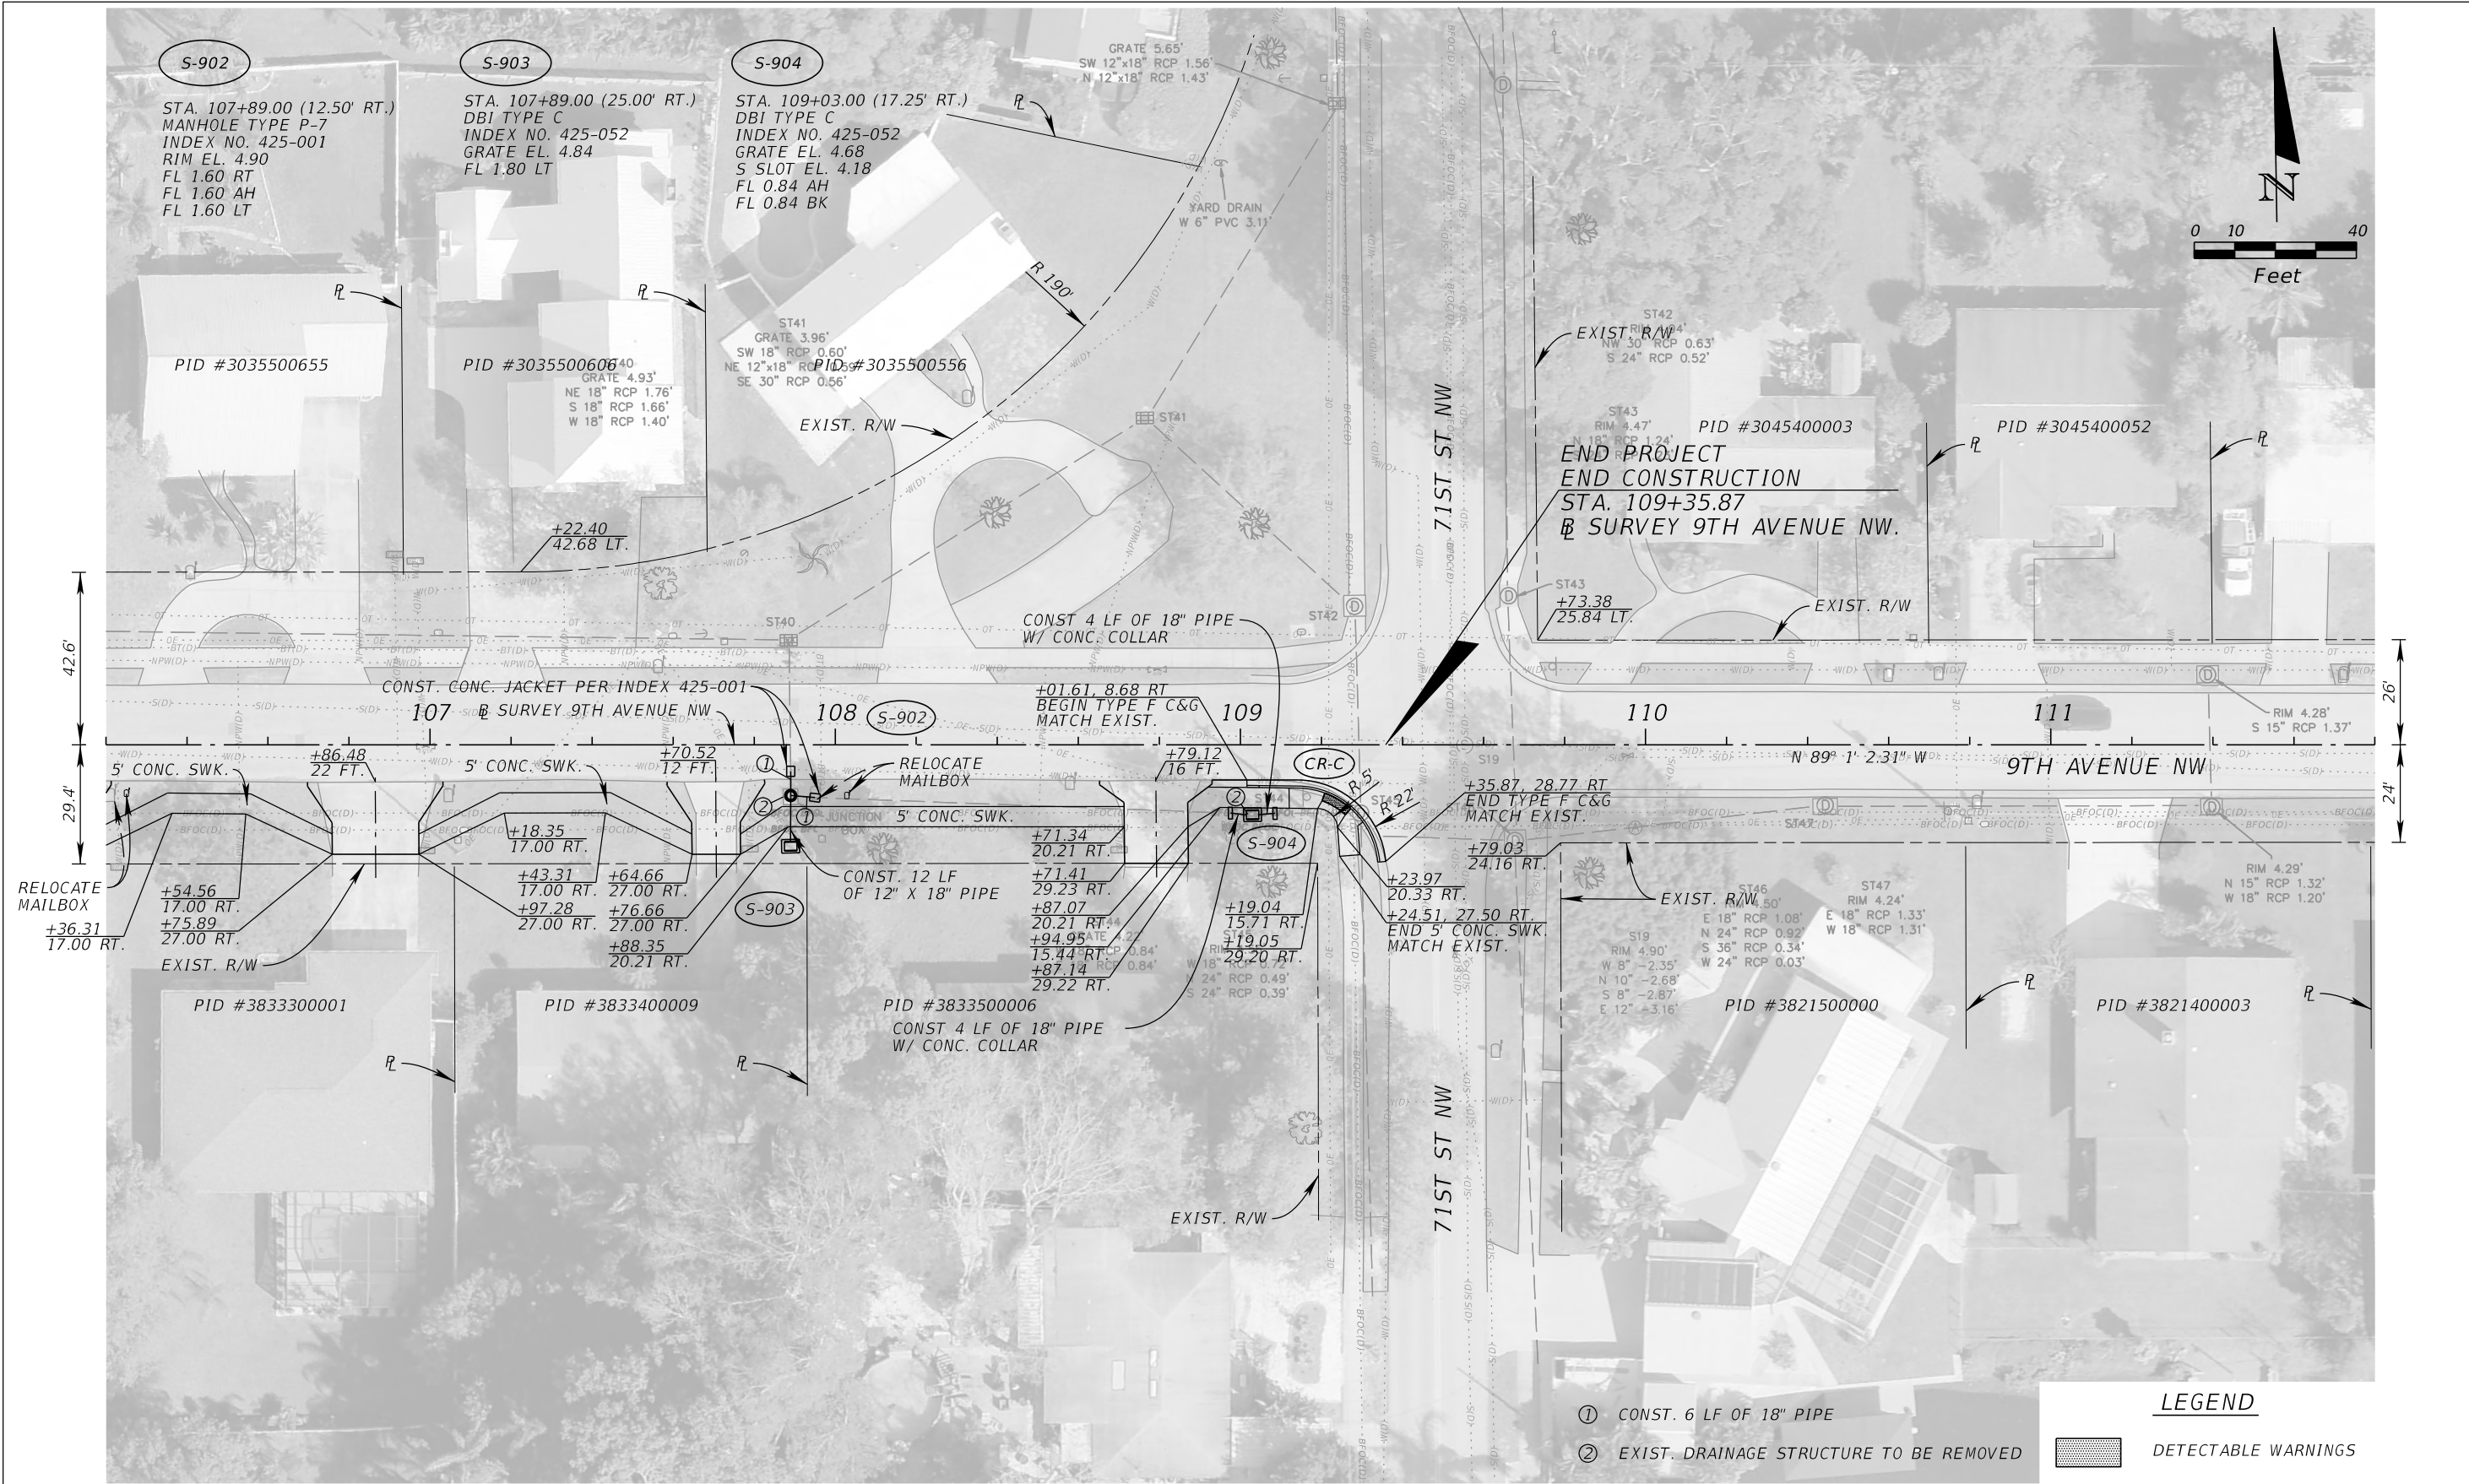
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THE OFFICIAL RECORD OF THIS SHEET IS THE ELECTRONIC FILE DIGITALLY SIGNED AND SEALED UNDER RULE 61G15-23.004, F.A.C.



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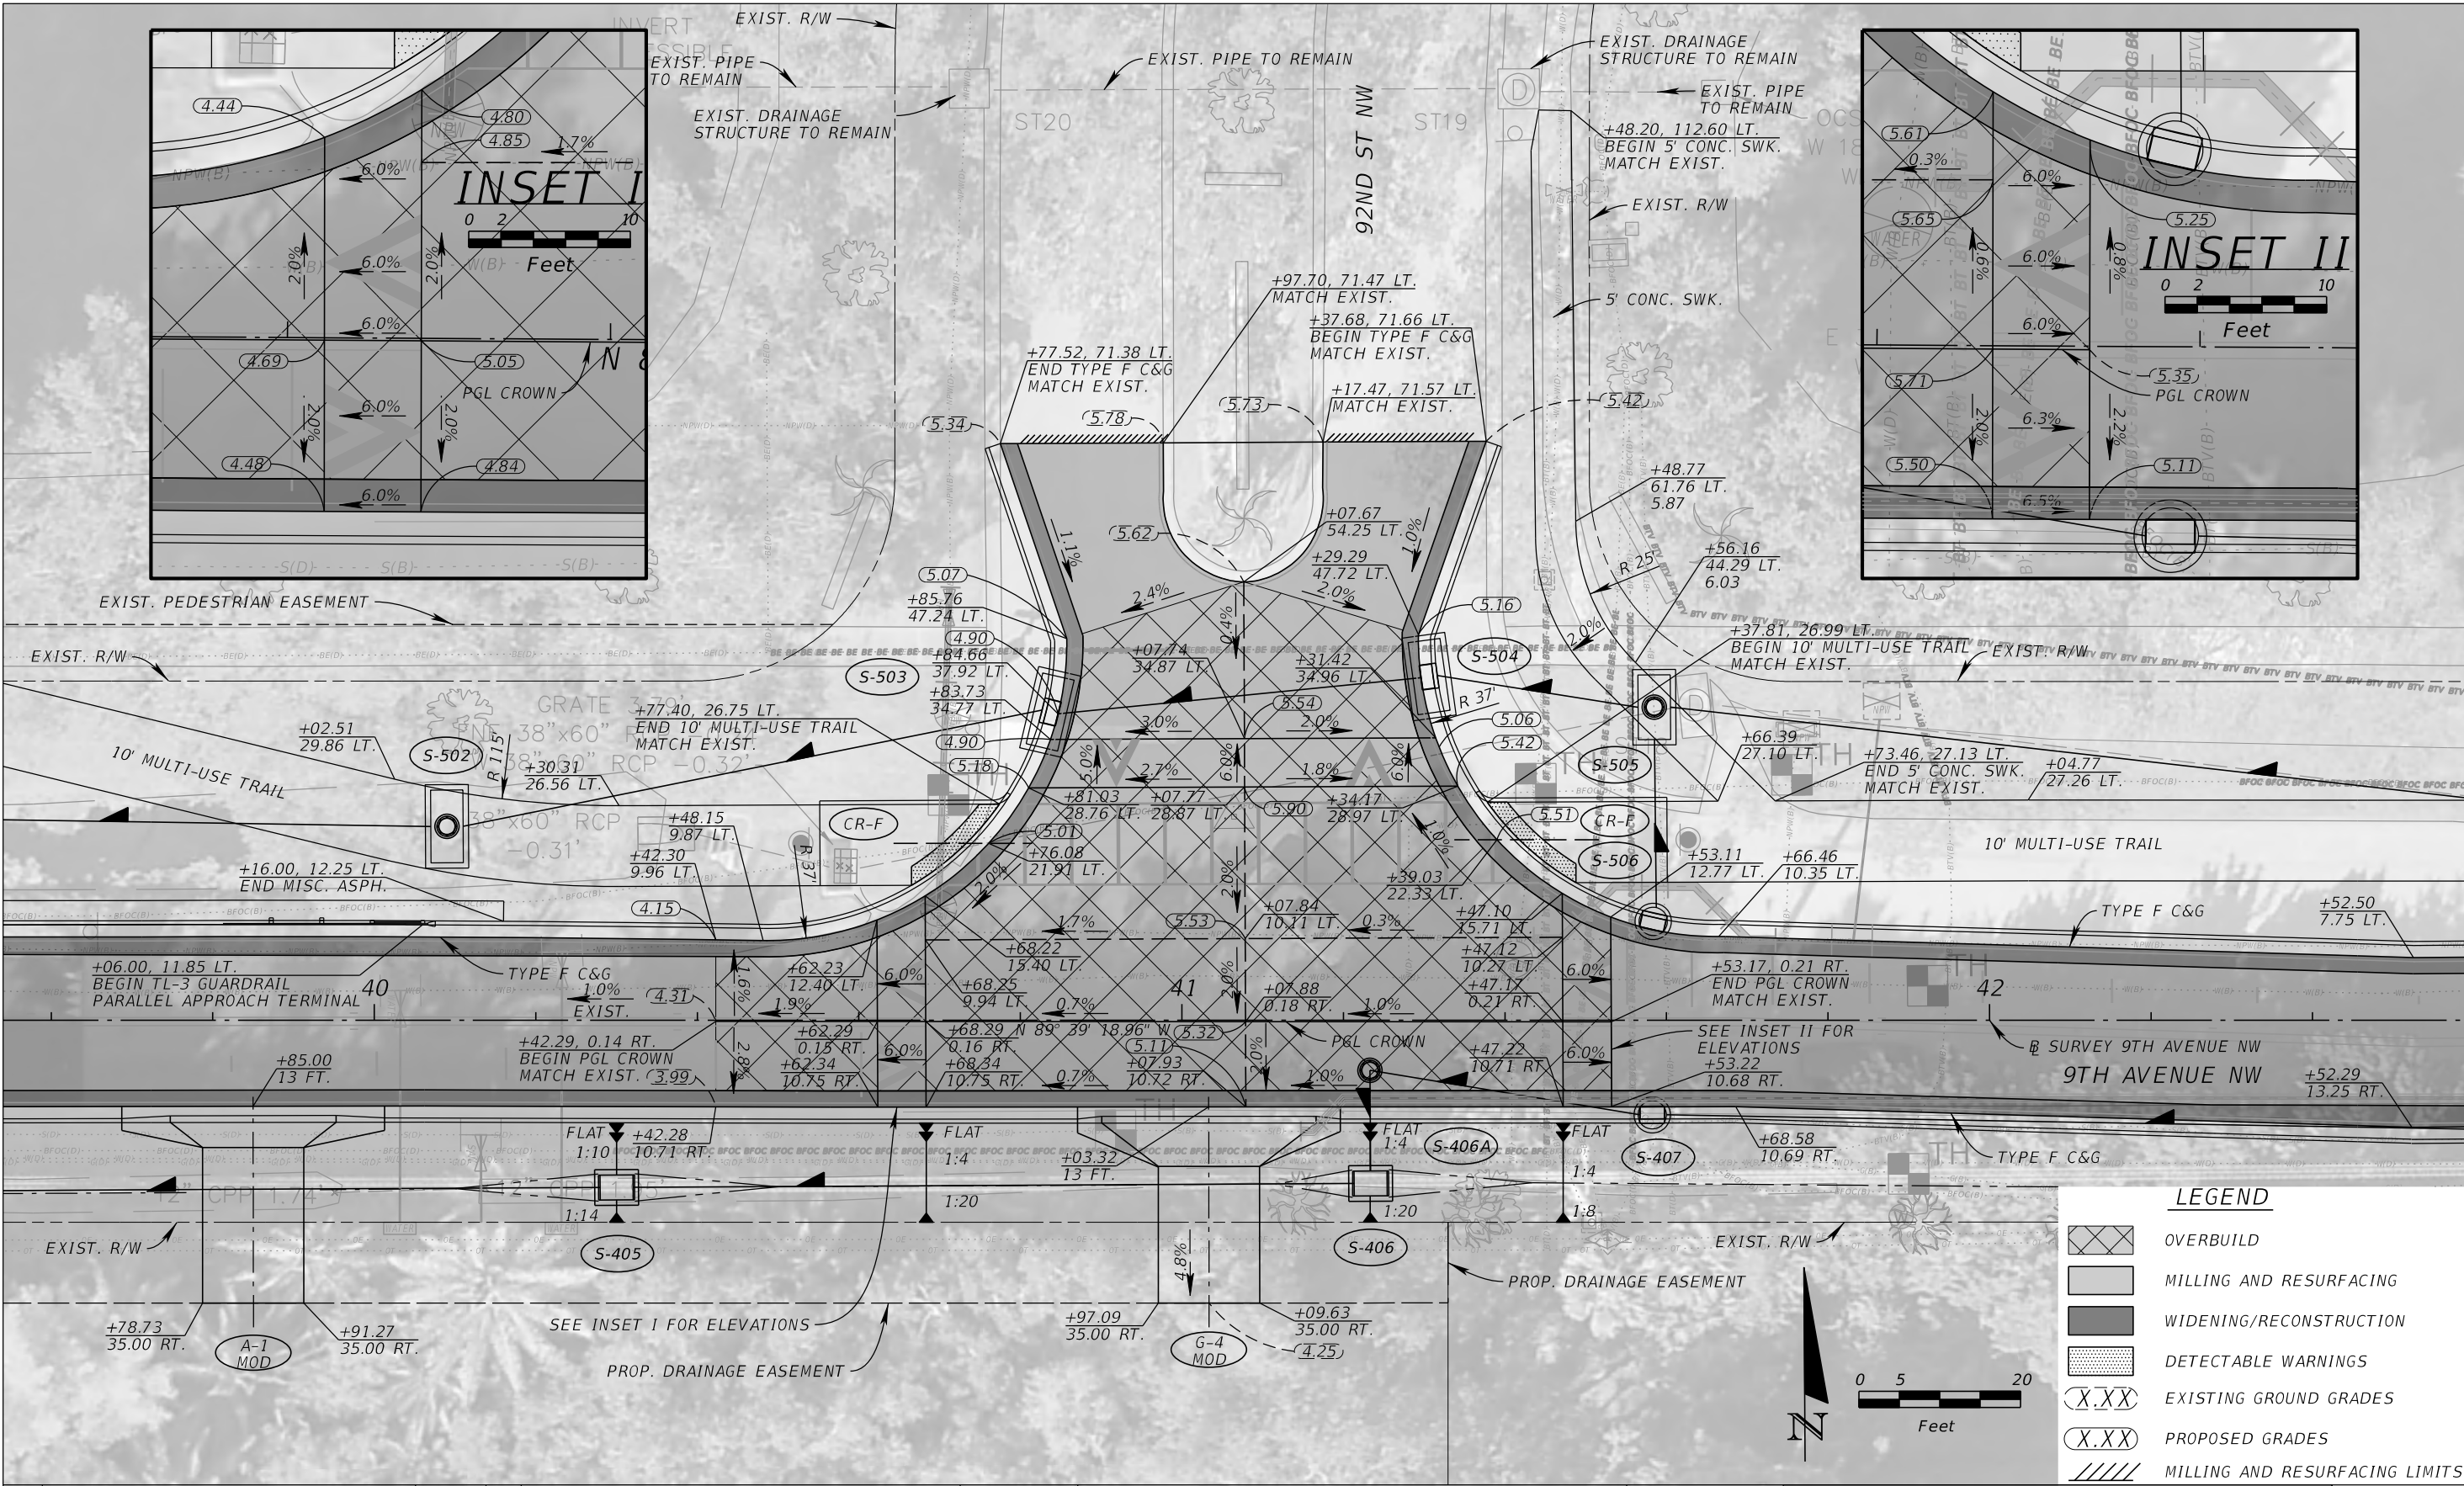
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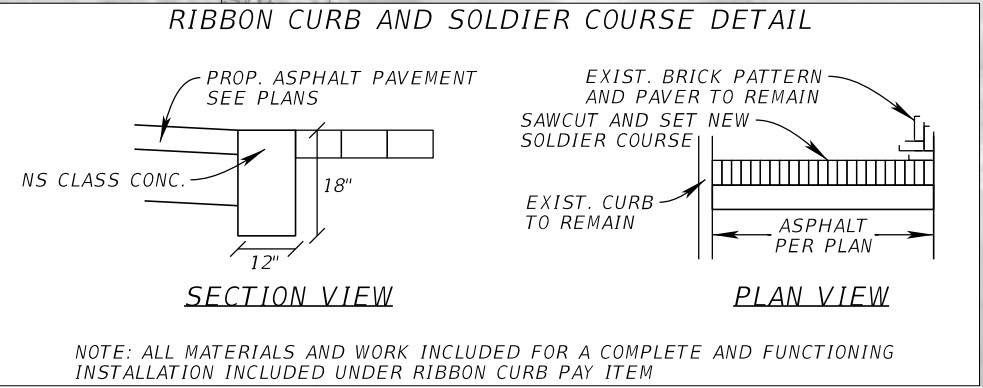
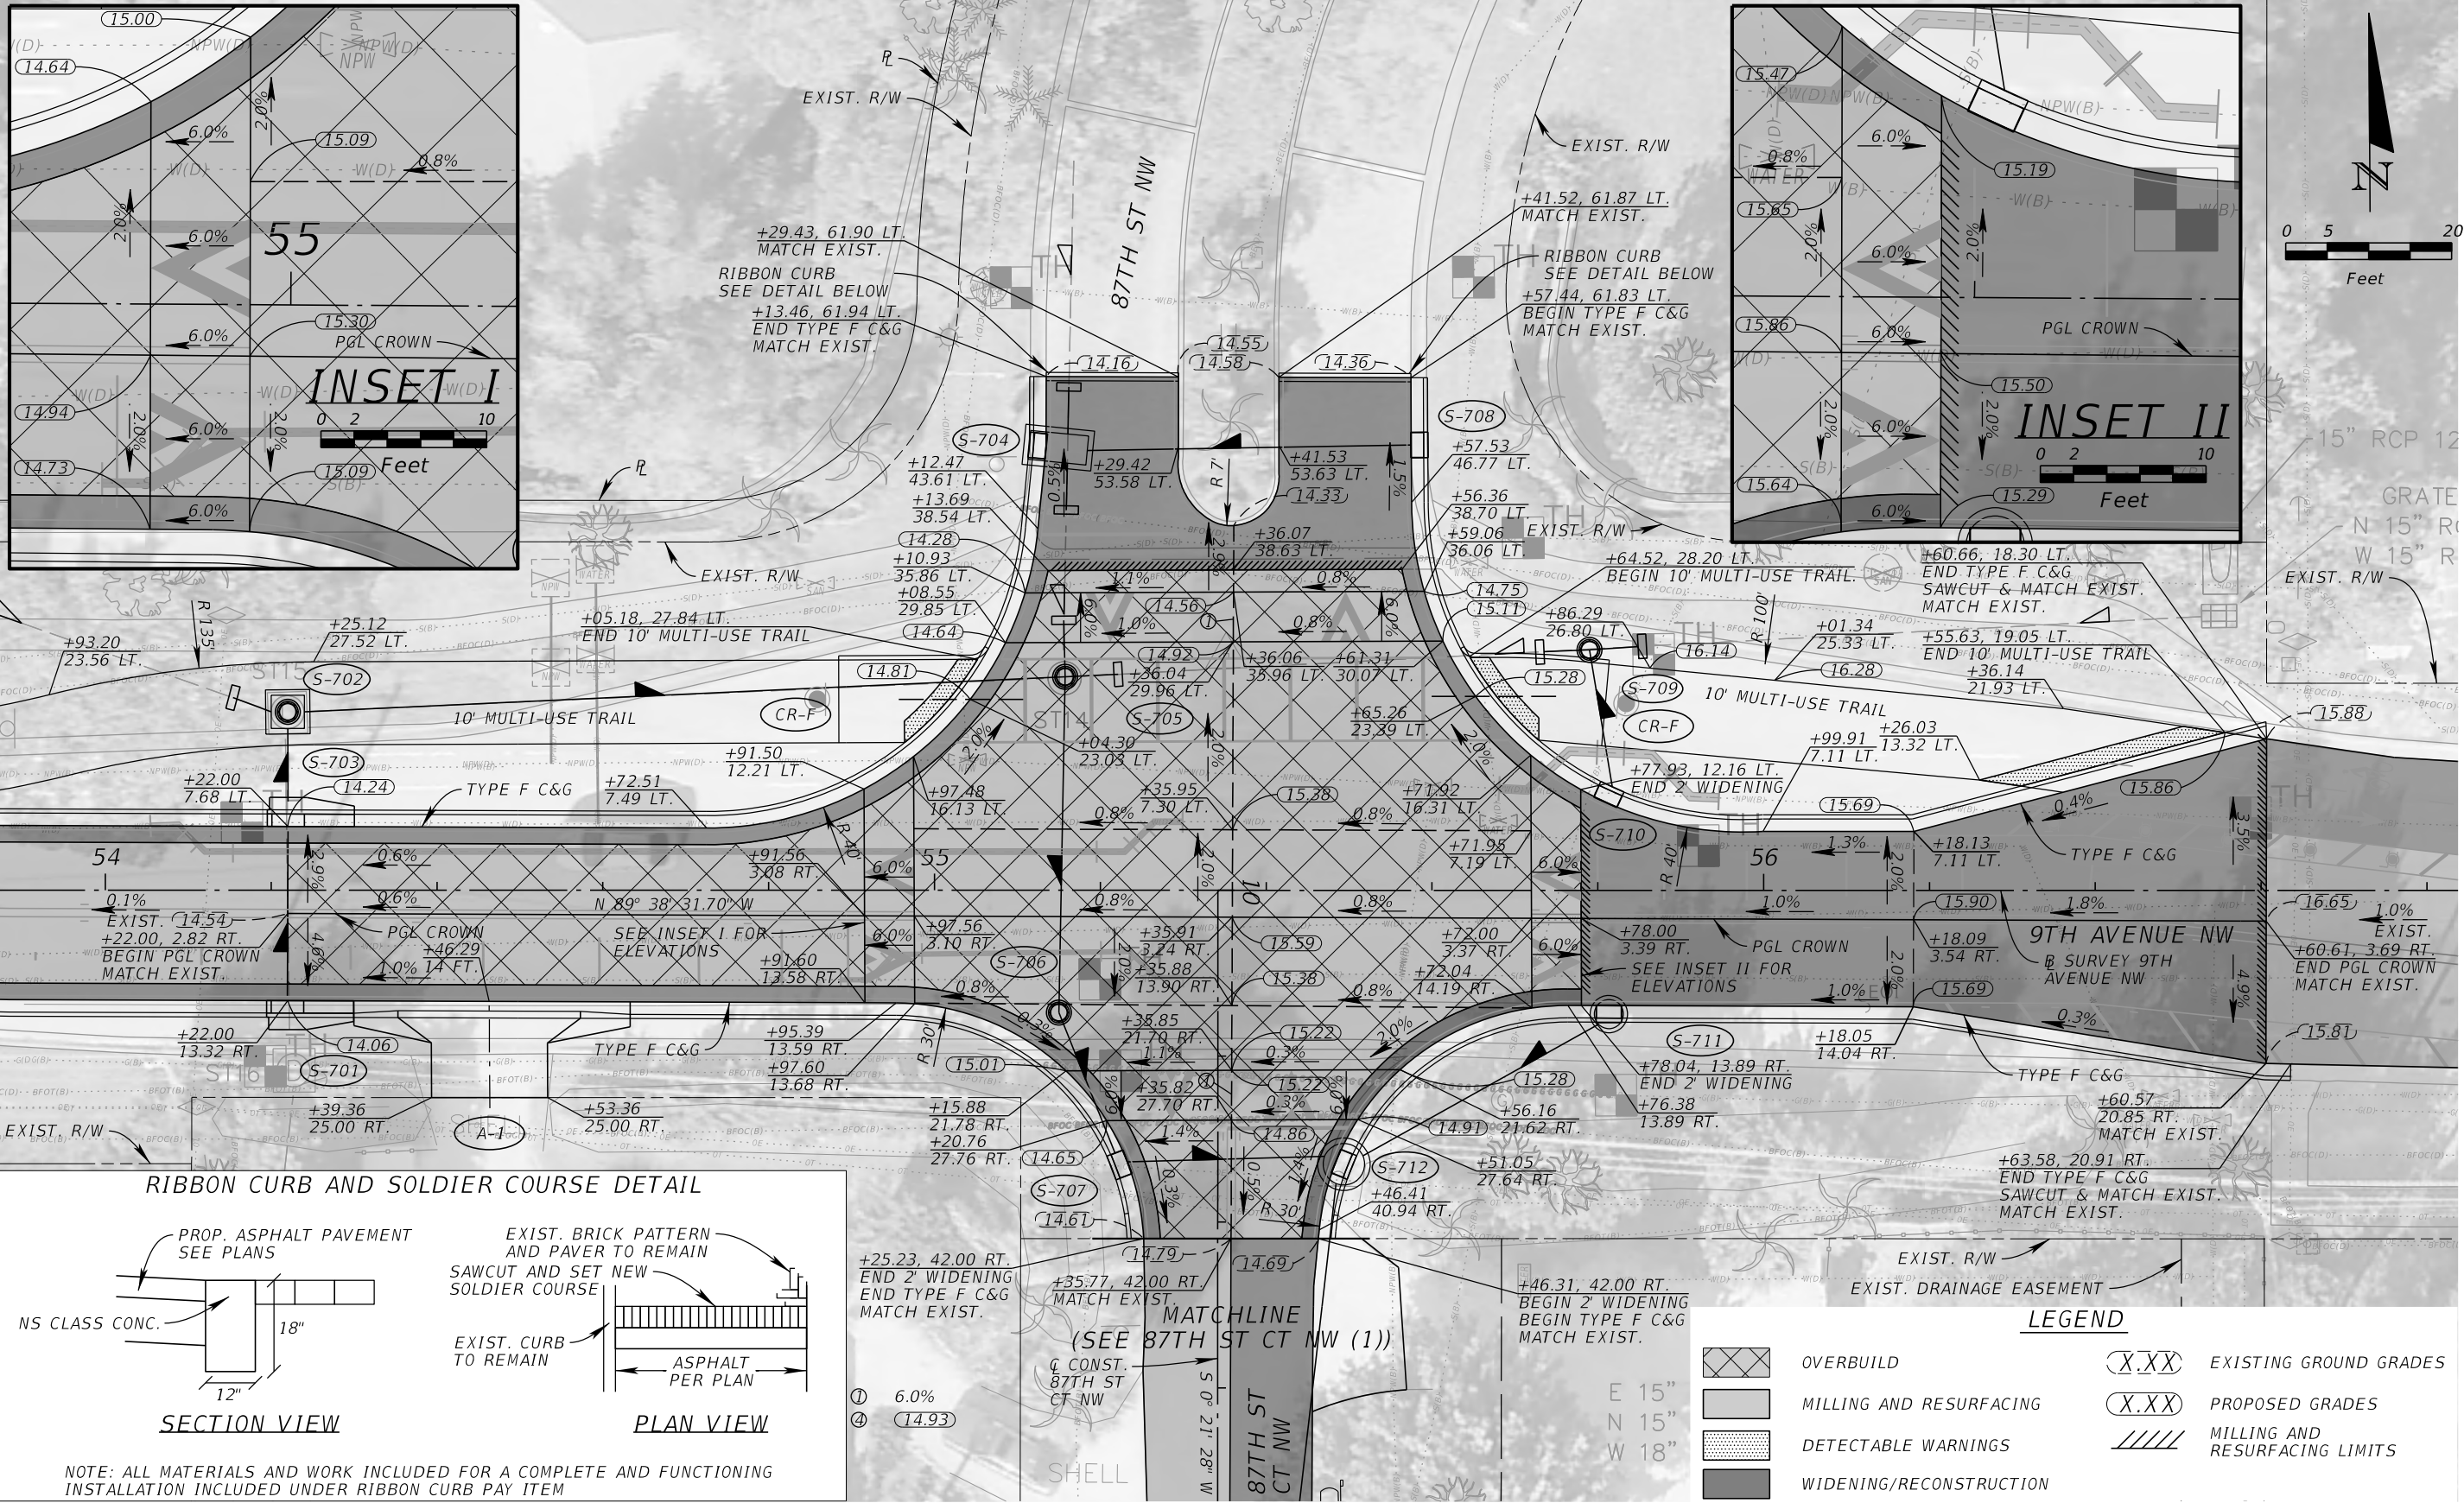
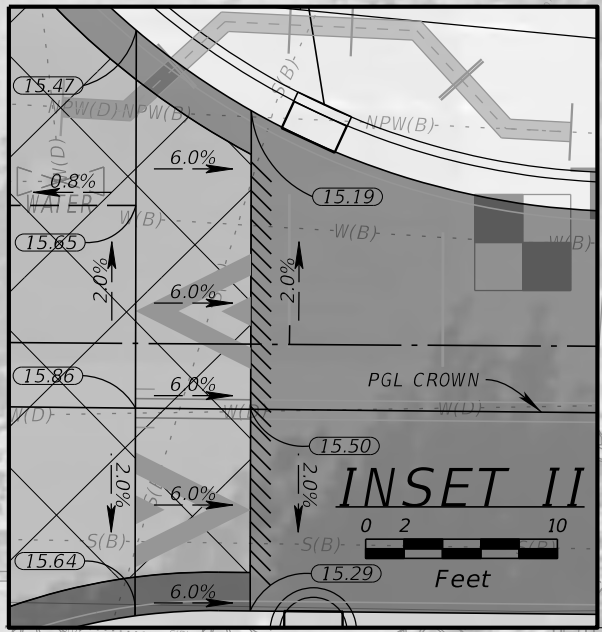
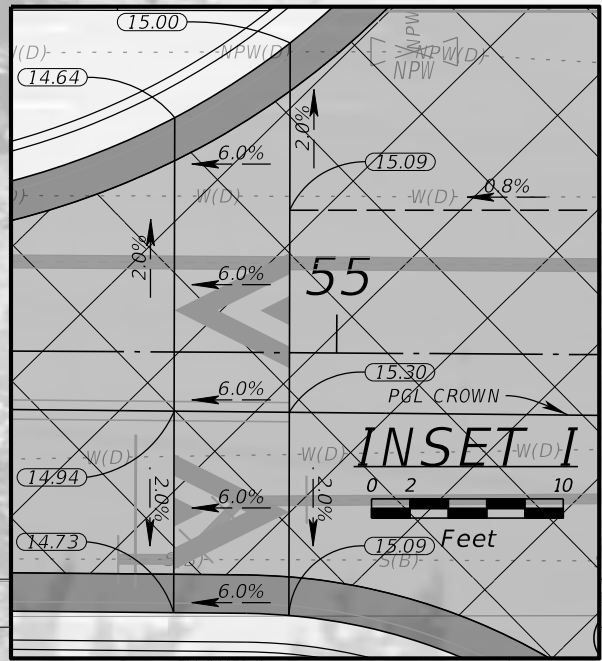
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THE OFFICIAL RECORD OF THIS SHEET IS THE ELECTRONIC FILE DIGITALLY SIGNED AND SEALED UNDER RULE 61G15-23.004, F.A.C.





<div><p>© 2025 KIMLEY-HORN AND ASSOCIATES, INC. 1800 SECOND STREET, SUITE 900, SARASOTA, FL 34236 PHONE: 941-379-7600 WWW.KIMLEY-HORN.COM</p></div>				<div><p>KHA PROJECT 148400070</p><p>DATE 10/02/2025</p><p>SCALE AS SHOWN</p><p>DESIGNED BY</p><p>DRAWN BY</p><p>CHECKED BY</p></div>		<div><p>9TH AVENUE NW</p></div>		<div><p>LICENSED PROFESSIONAL</p><p>JORDAN E. LEEP, P.E. FL LICENSE NUMBER 76102</p></div>		<div><p>SHEET NUMBER</p><p>50</p></div>																																							
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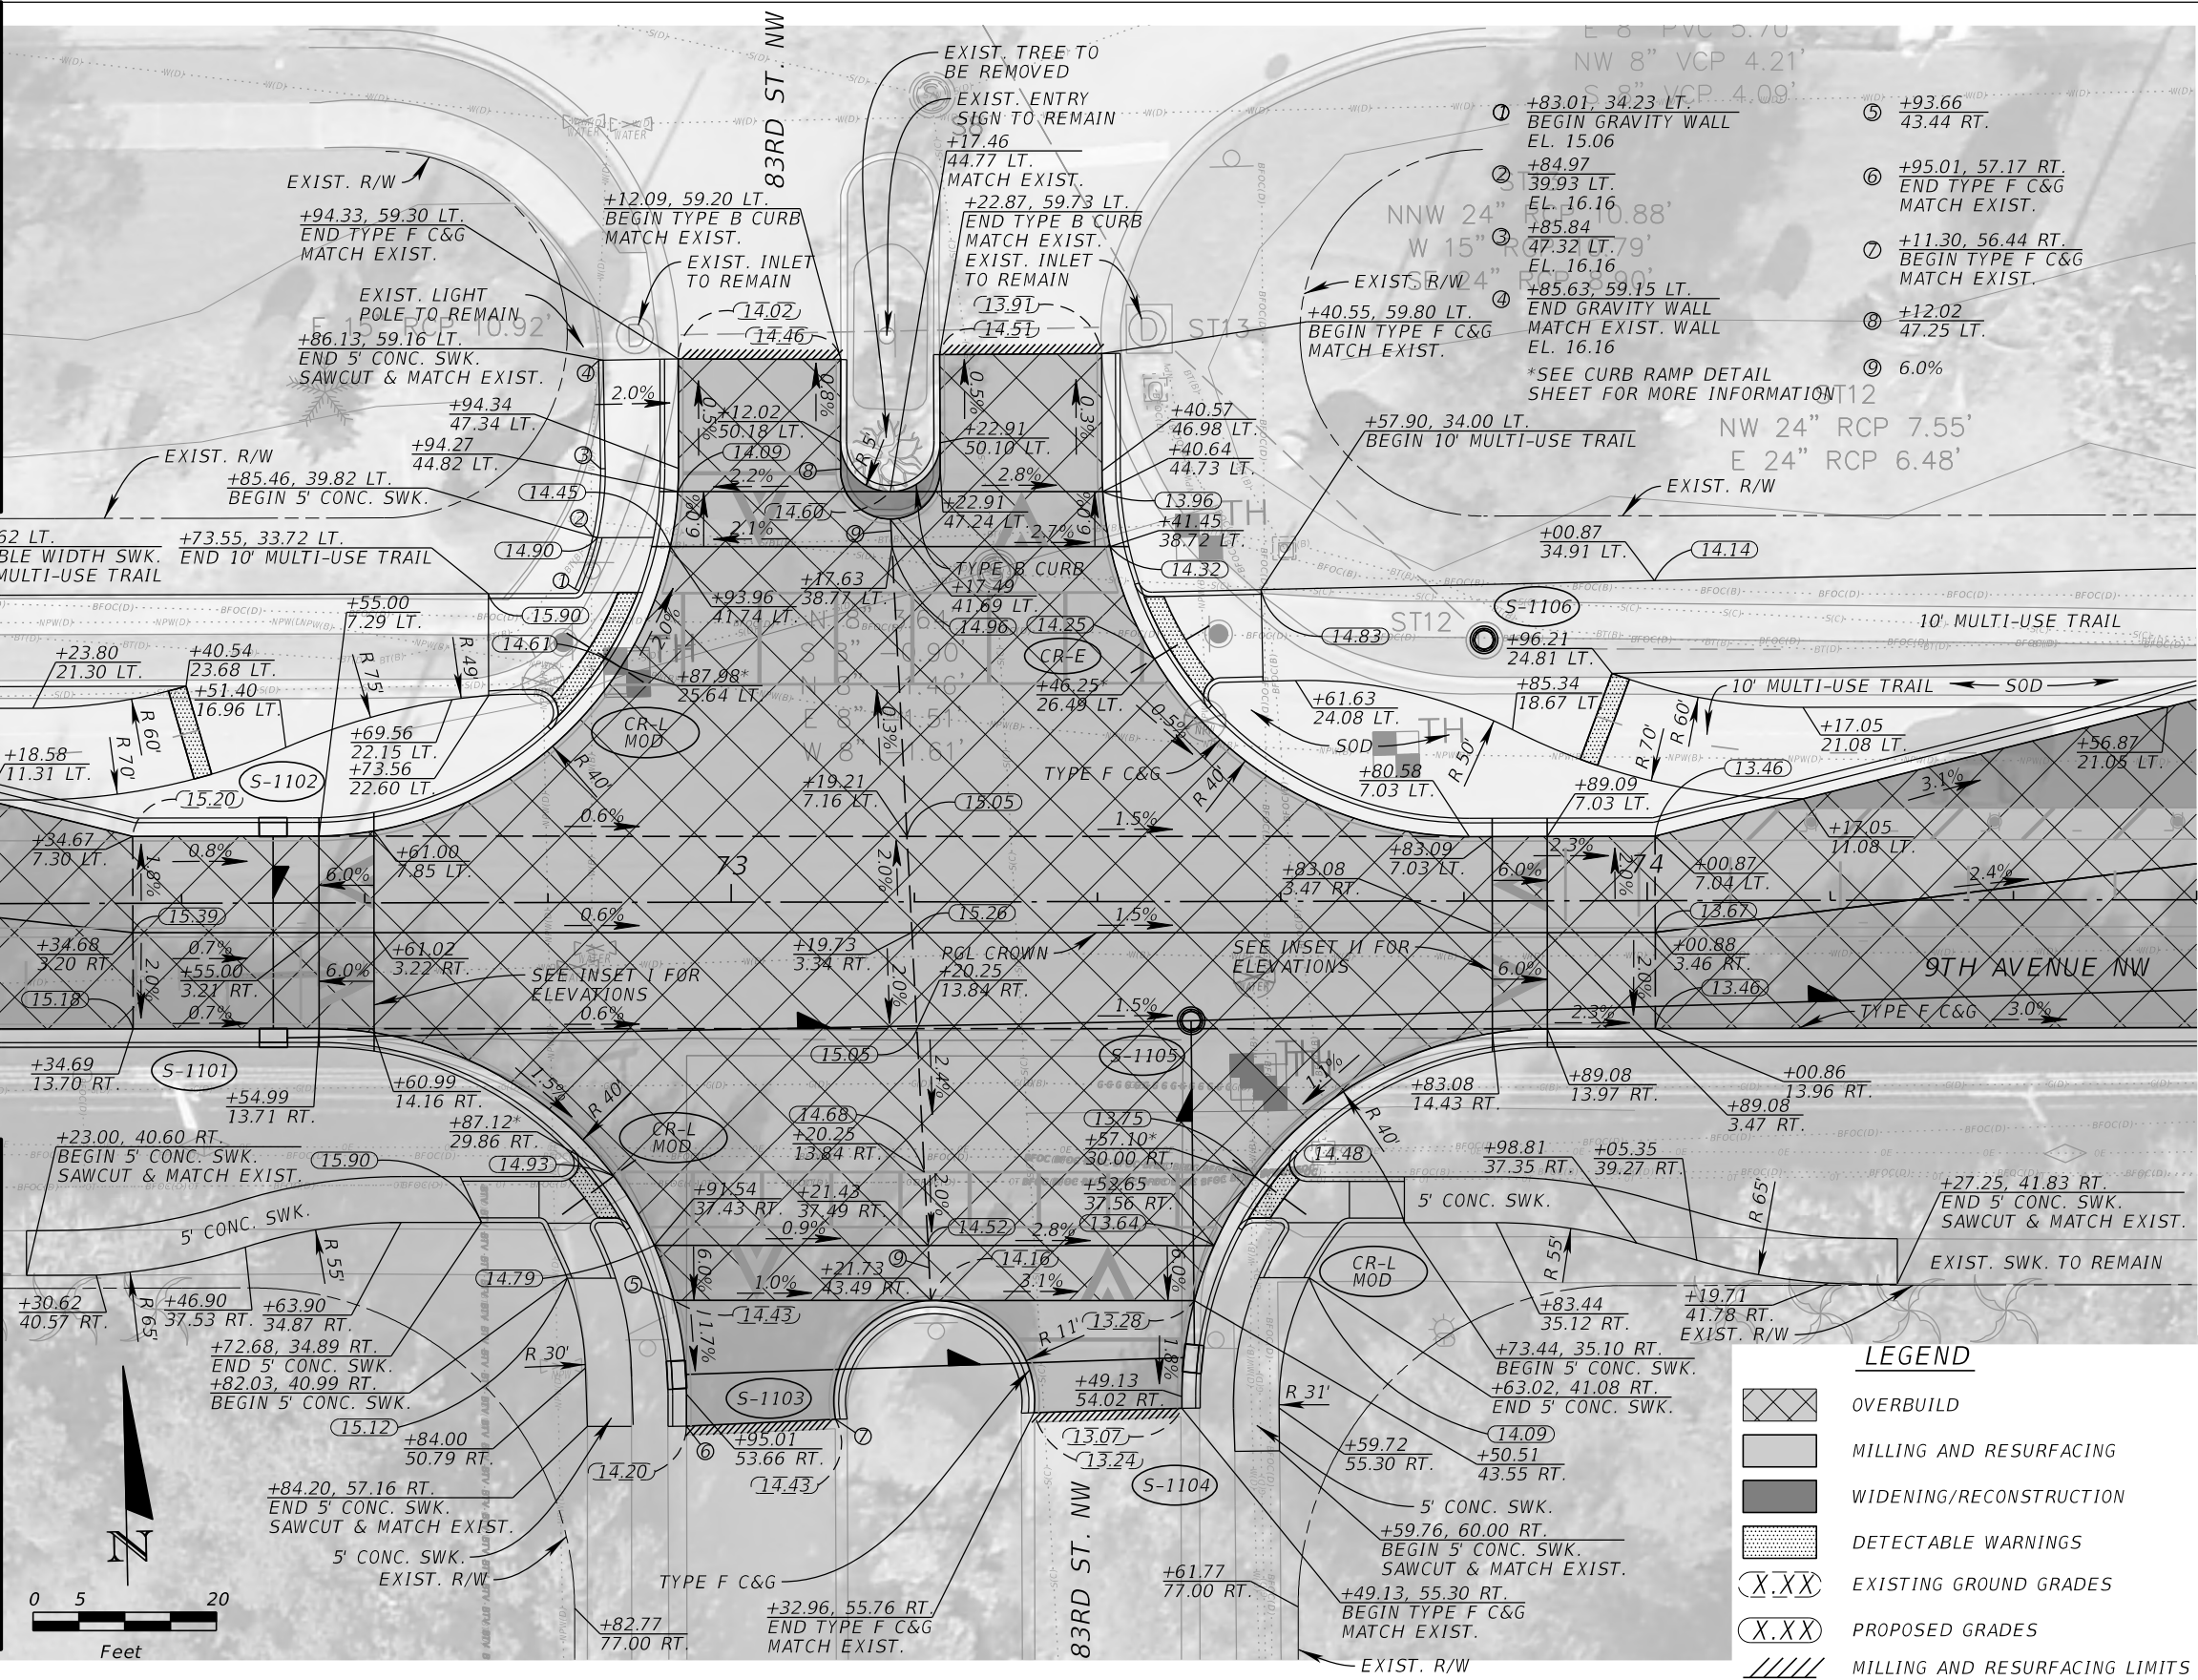
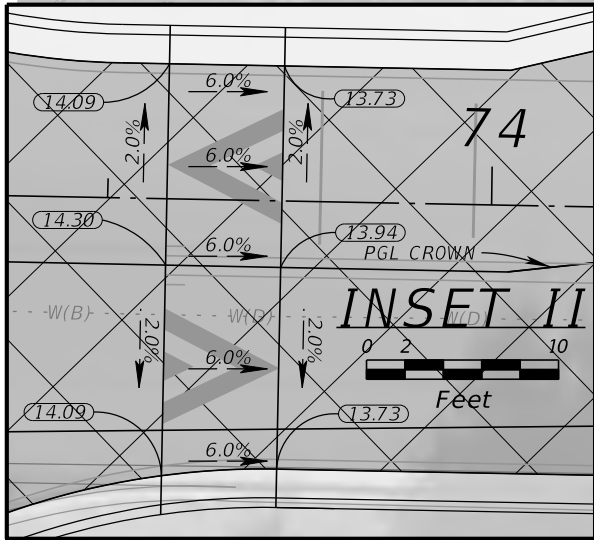
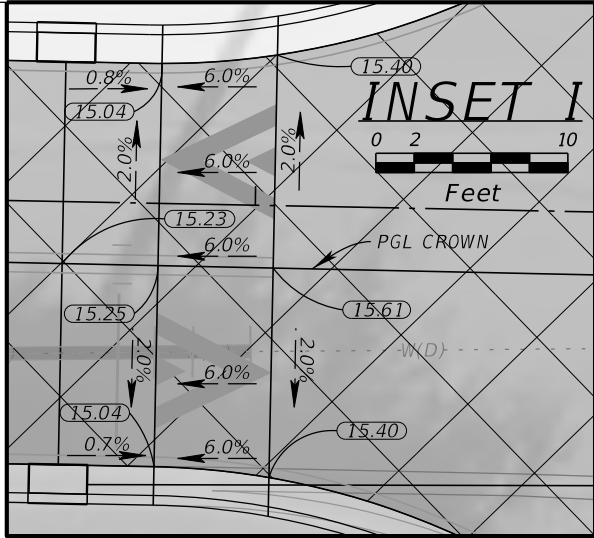
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© 2025 KIMLEY-HORN AND ASSOCIATES, INC. 1800 SECOND STREET, SUITE 900, SARASOTA, FL 34236 PHONE: 941-379-7600 WWW.KIMLEY-HORN.COM				DATE 10/02/2025		9TH AVENUE NW		FL DATE:		INTERSECTION DETAIL - 87TH	
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	MILLING AND RESURFACING LIMITS

No.	REVISIONS	DATE	BY

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1800 SECOND STREET, SUITE 900, SARASOTA, FL 34236  
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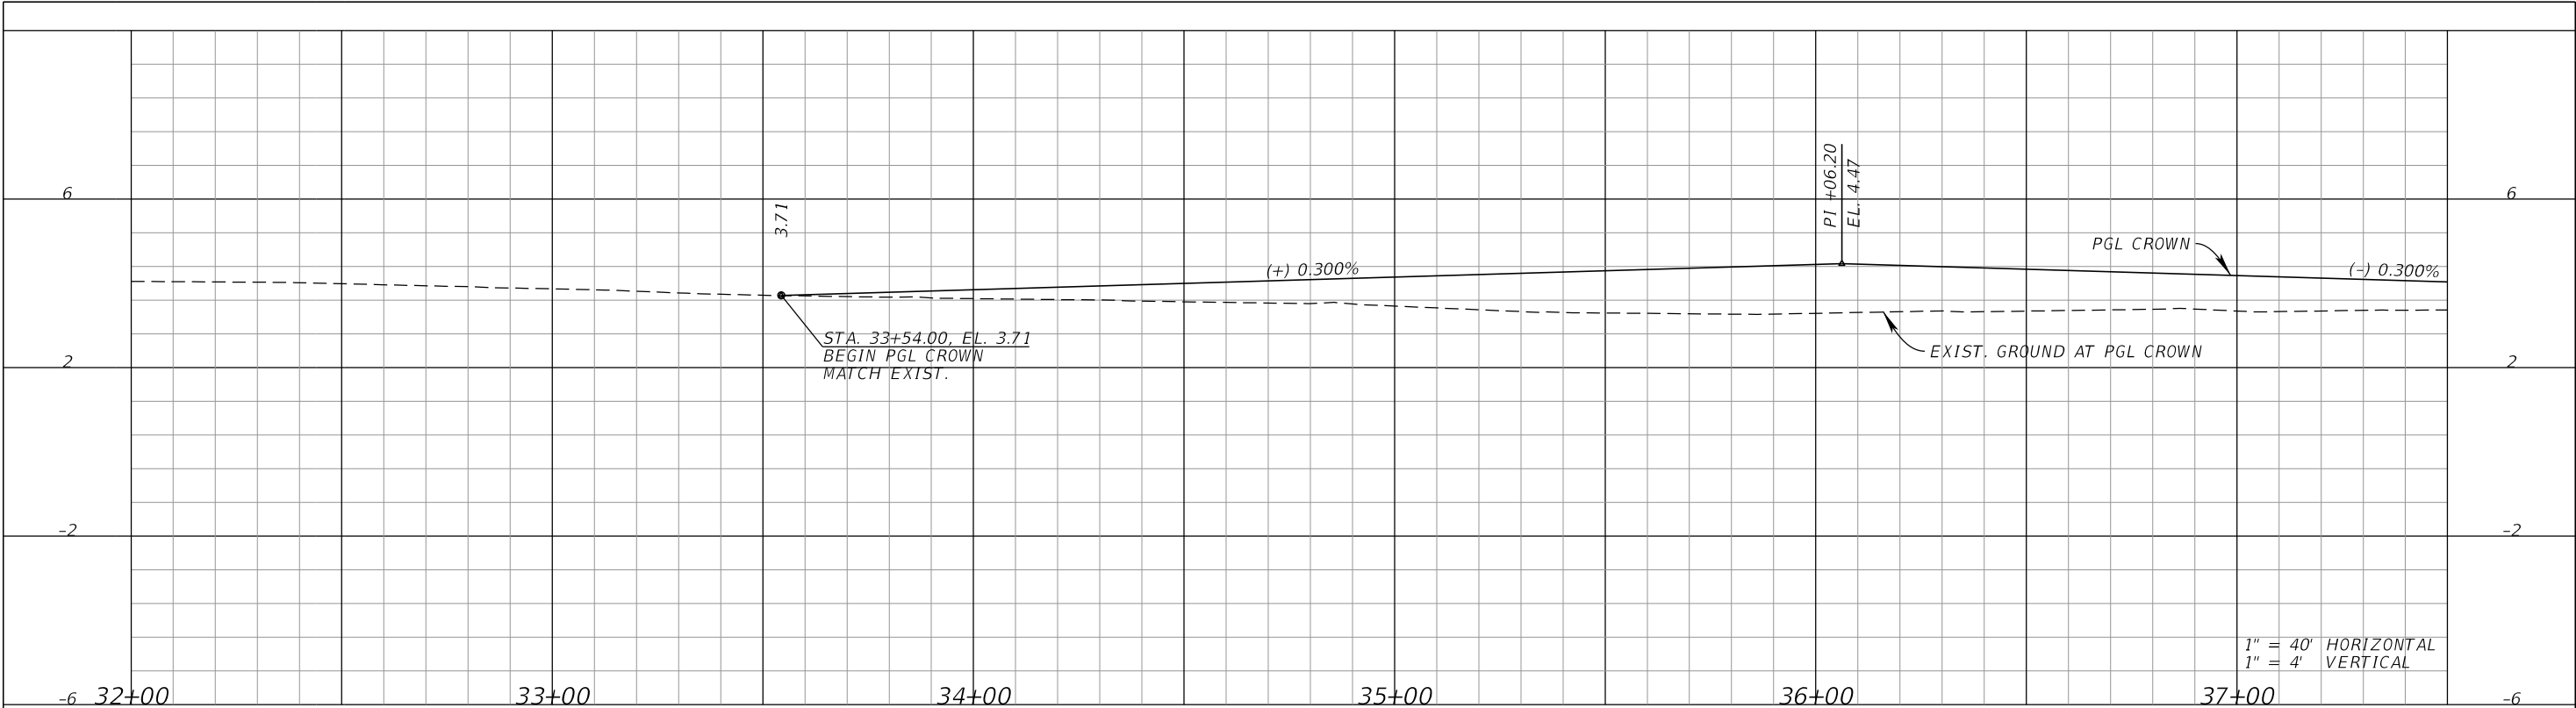
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FL LICENSE NUMBER  
76102


INTERSECTION DETAIL - 83RD

SHEET NUMBER  
52



⌘ SURVEY 9TH AVENUE NW

⌘ SURVEY 9TH AVENUE NW

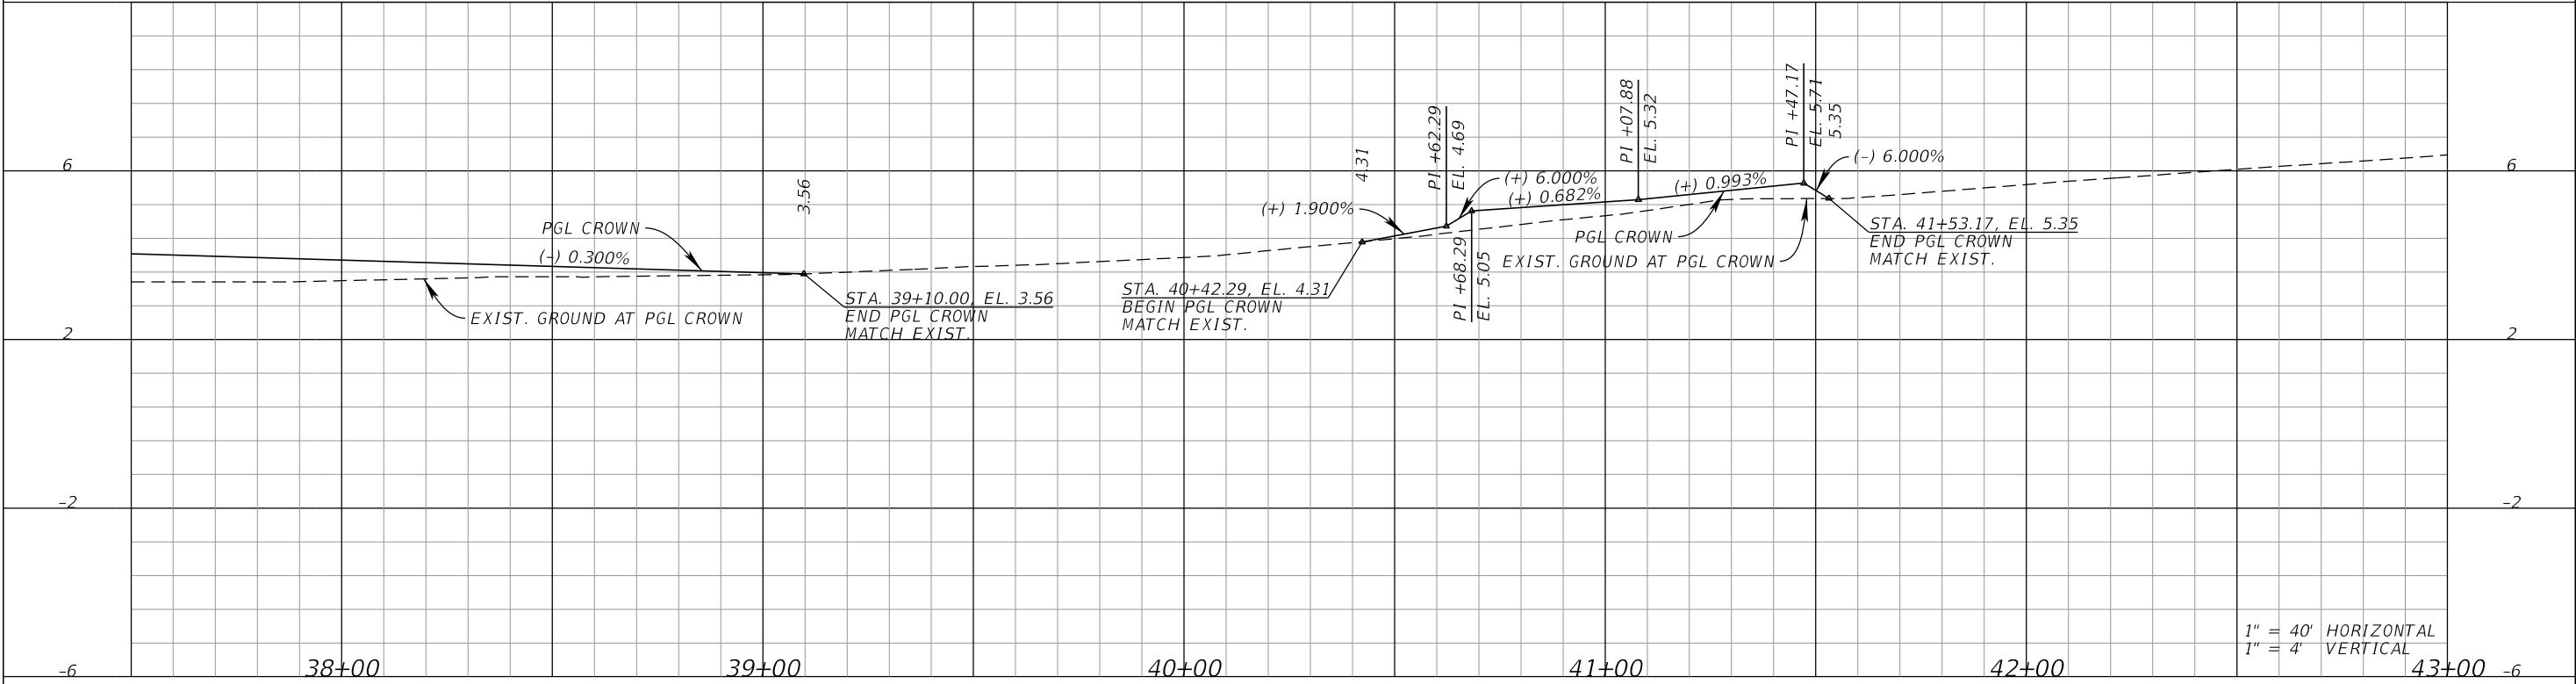

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DATE 10/02/2025
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9TH AVENUE NW

FL

DATE:

LICENSED PROFESSIONAL

JORDAN E. LEEP, P.E.  
FL LICENSE NUMBER 76102


PGL PROFILE (1)

53

SHEET NUMBER
53

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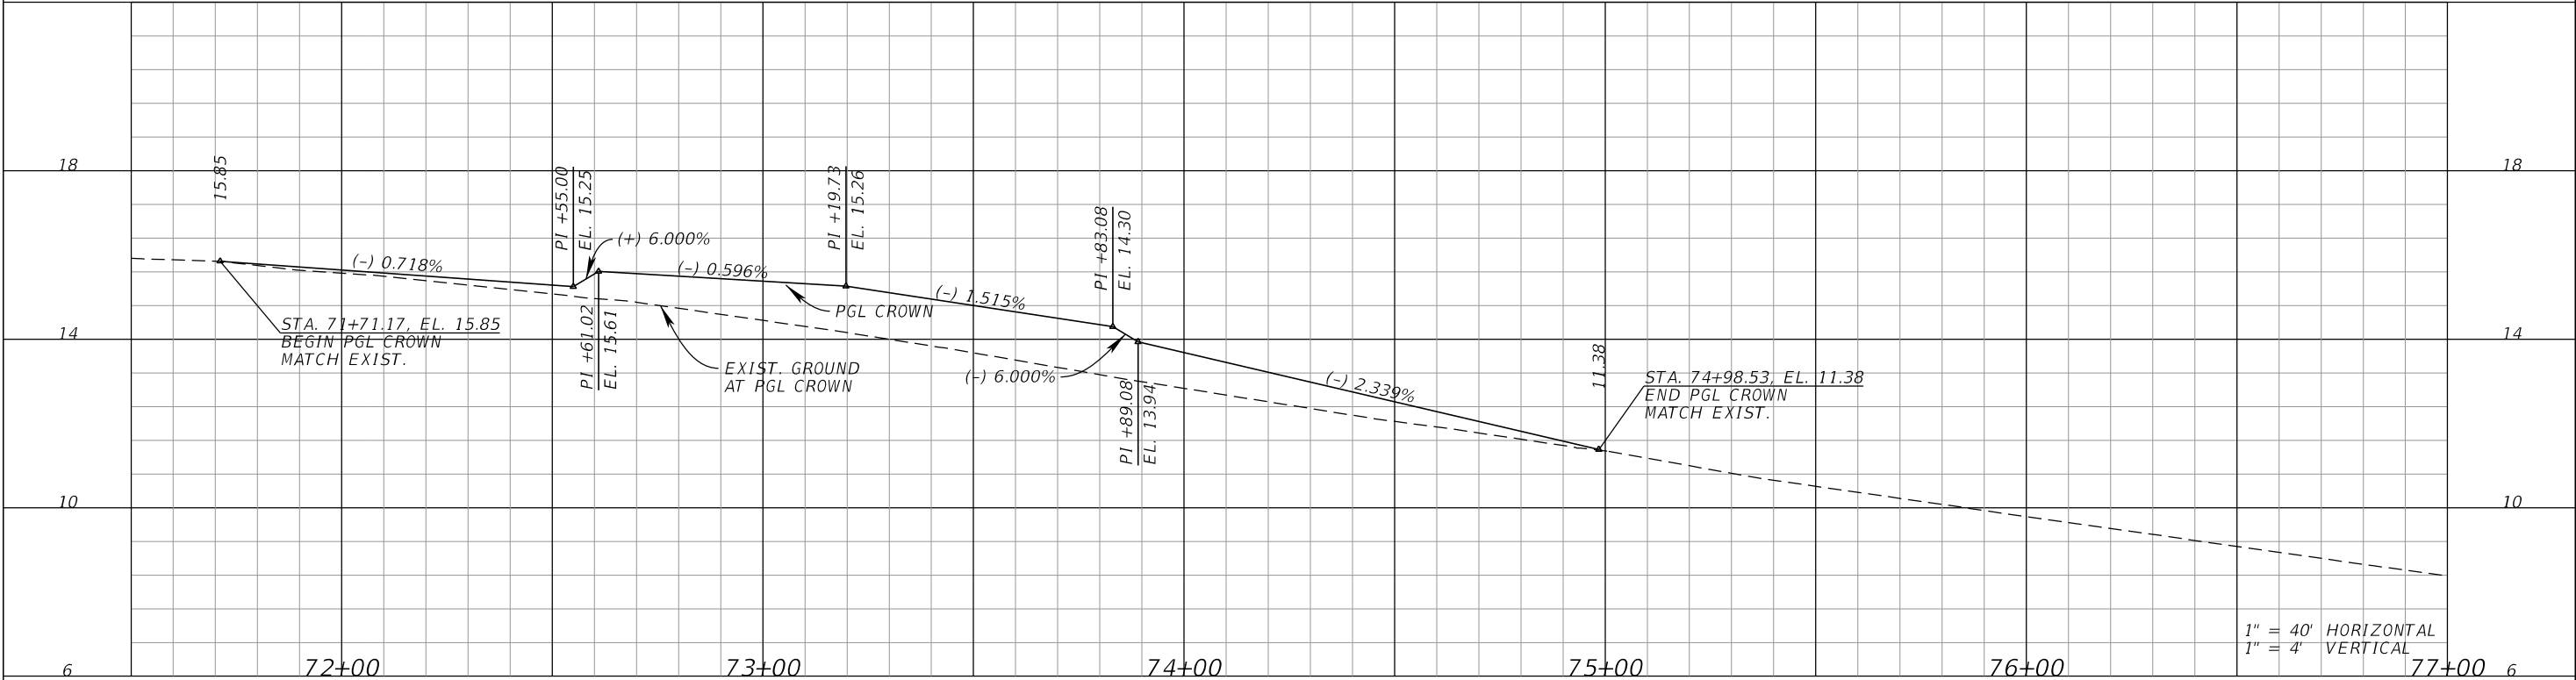


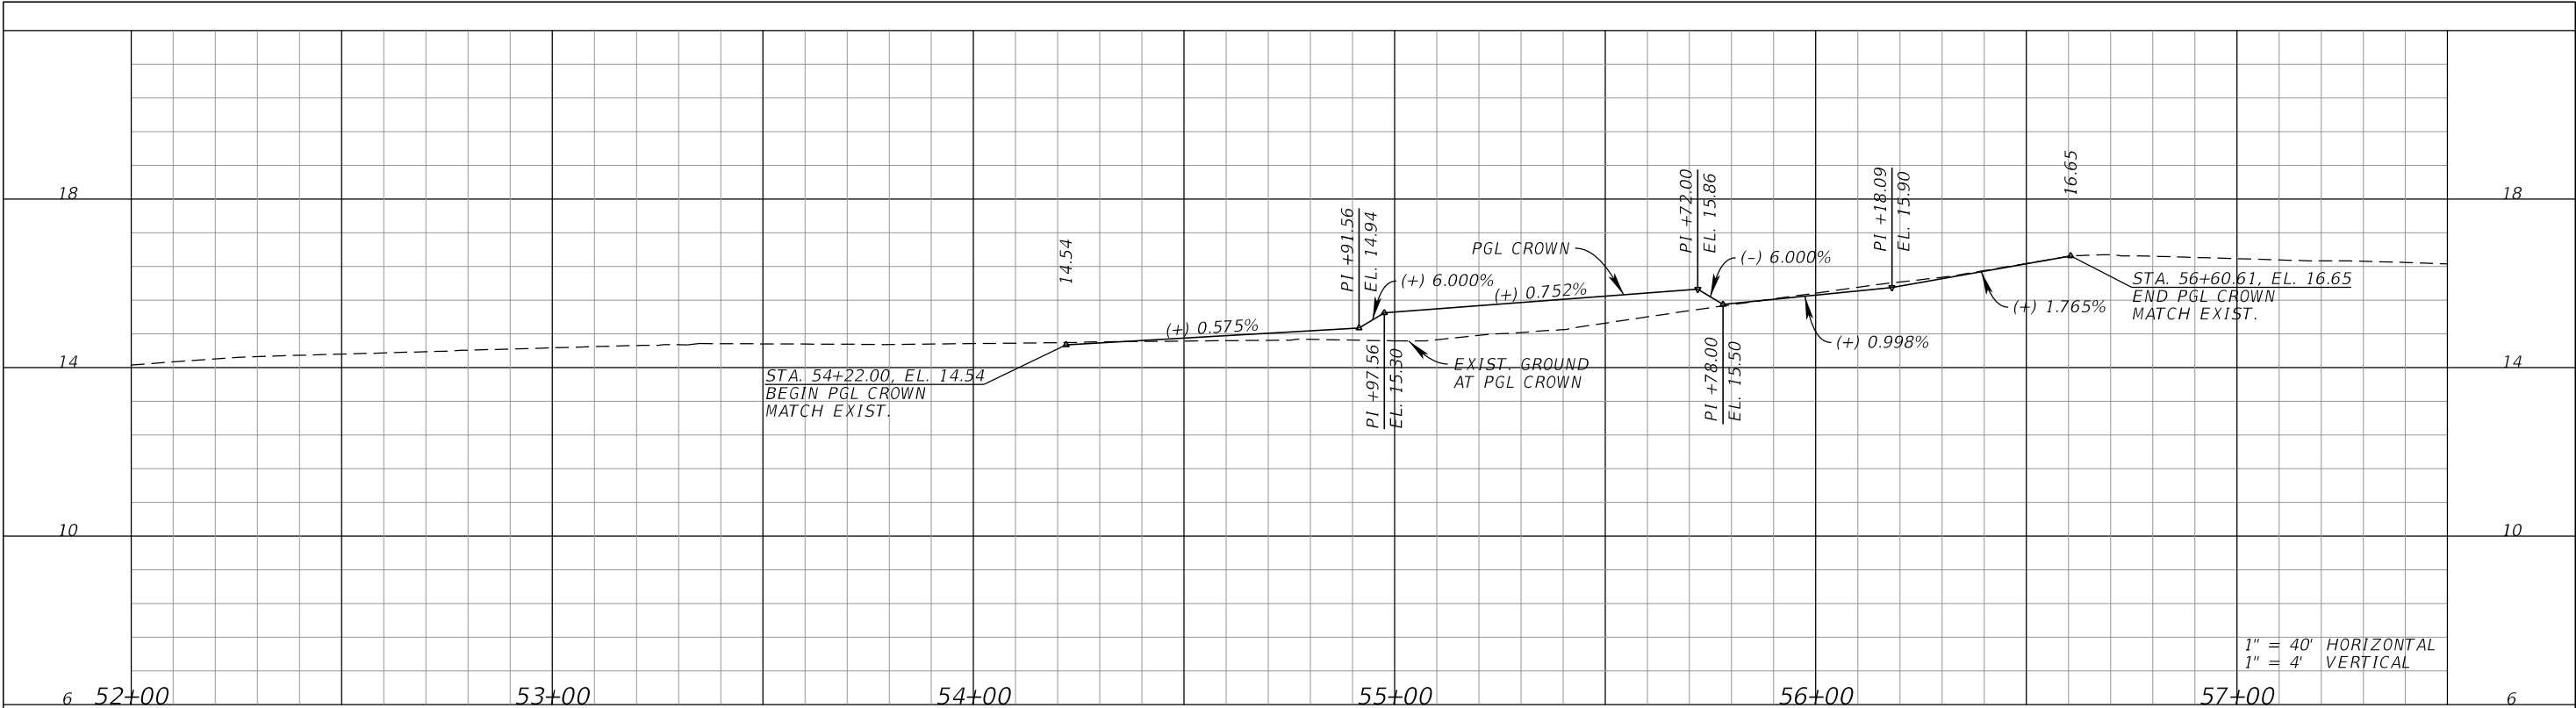

1" = 40' HORIZONTAL  
1" = 4' VERTICAL

**9 SURVEY 9TH AVENUE NW**

**9 SURVEY 9TH AVENUE NW**



1" = 40' HORIZONTAL  
1" = 4' VERTICAL

No.	REVISIONS	DATE	BY

**Kimley»Horn**

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**9TH AVENUE NW**


MANATEE COUNTY

LICENSED PROFESSIONAL
JORDAN E. LEEP, P.E.
FL LICENSE NUMBER 76102

**PGL PROFILE (2)**

SHEET NUMBER
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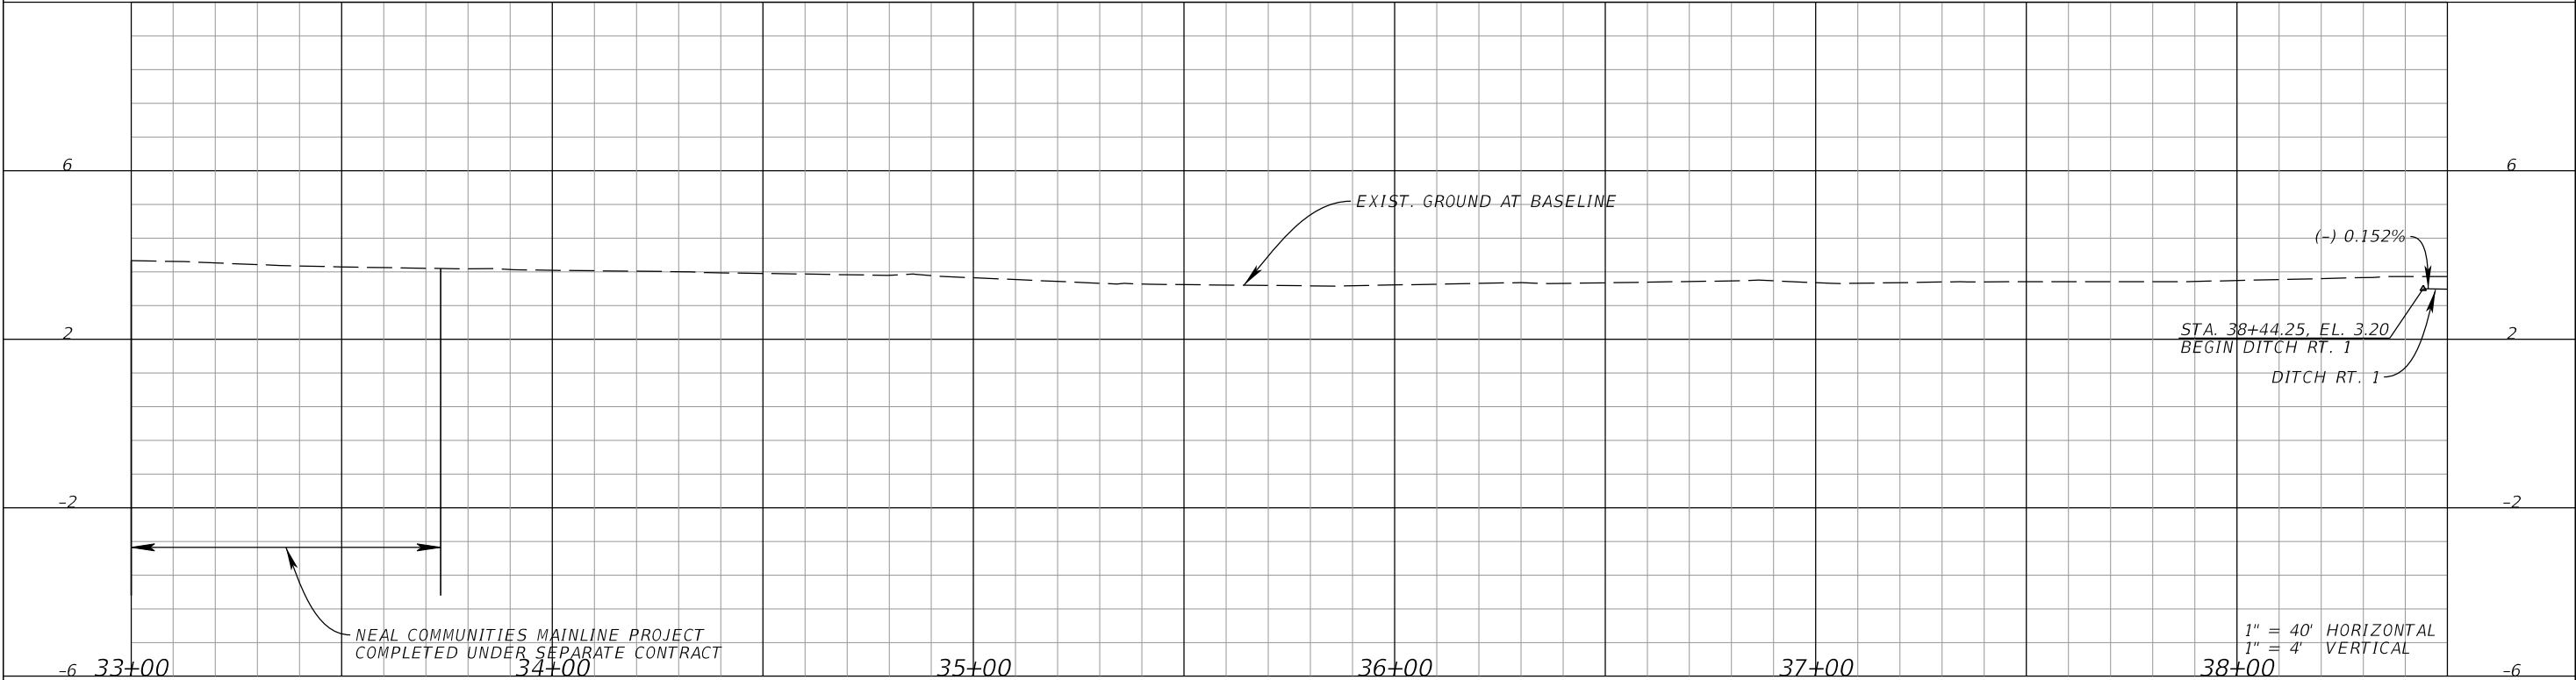


BOSW LEFT

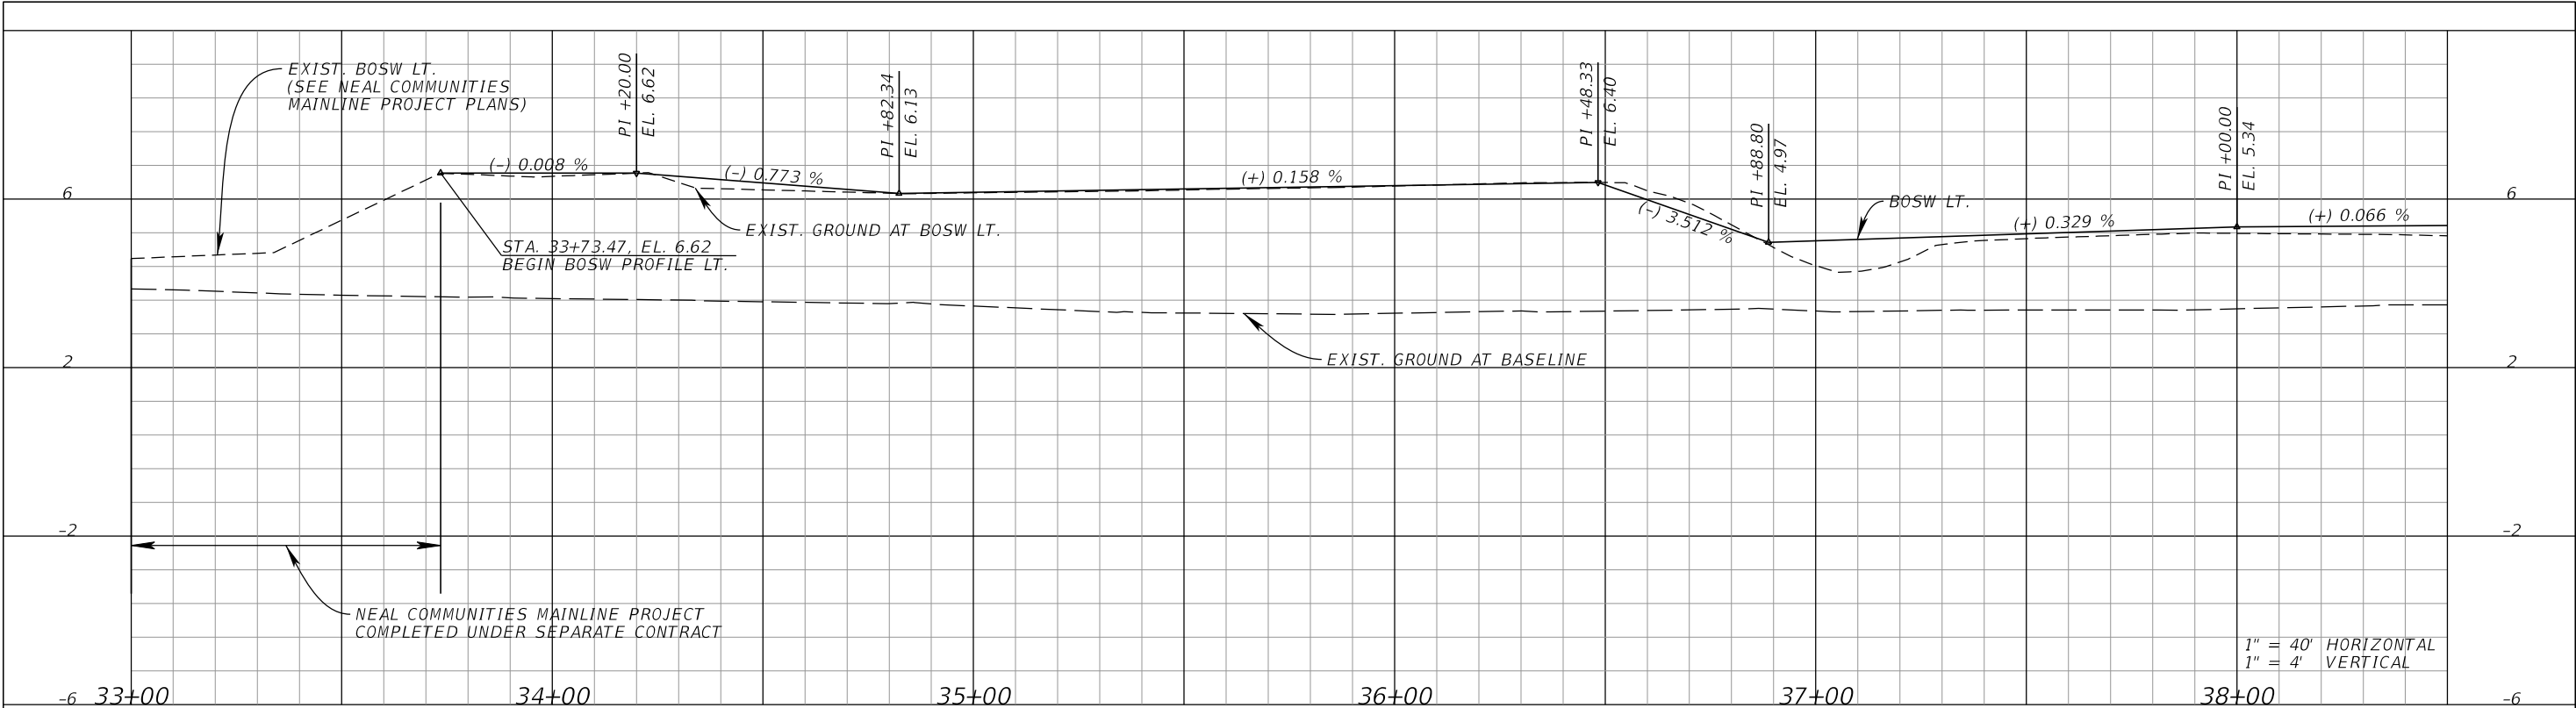⌘ SURVEY 9TH AVENUE NW

BOSW RIGHT

⌘ SURVEY 9TH AVENUE NW



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9TH AVENUE NW

MANATEE COUNTY

LICENSED PROFESSIONAL


JORDAN E. LEEP, P.E.  
FL LICENSE NUMBER 76102

BOSW PROFILES (1)

SHEET NUMBER


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⌘ SURVEY 9TH AVENUE NW

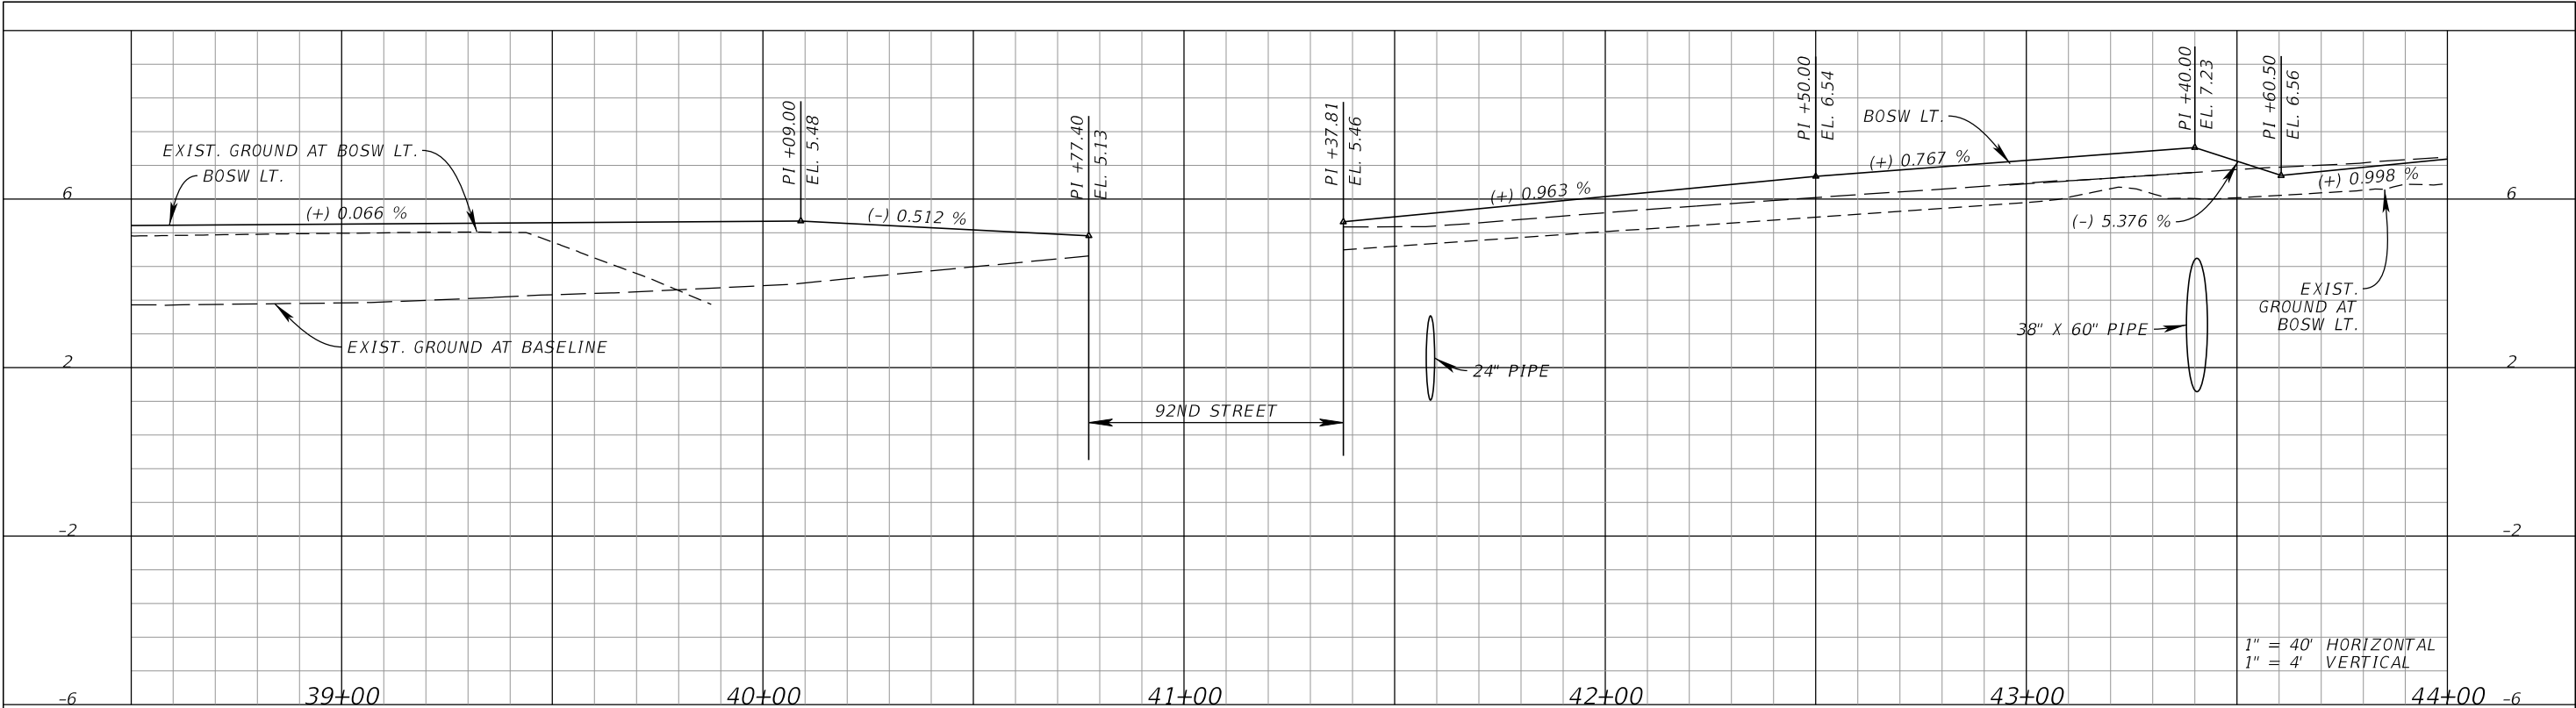

BOSW RIGHT

⌘ SURVEY 9TH AVENUE NW

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9TH AVENUE NW

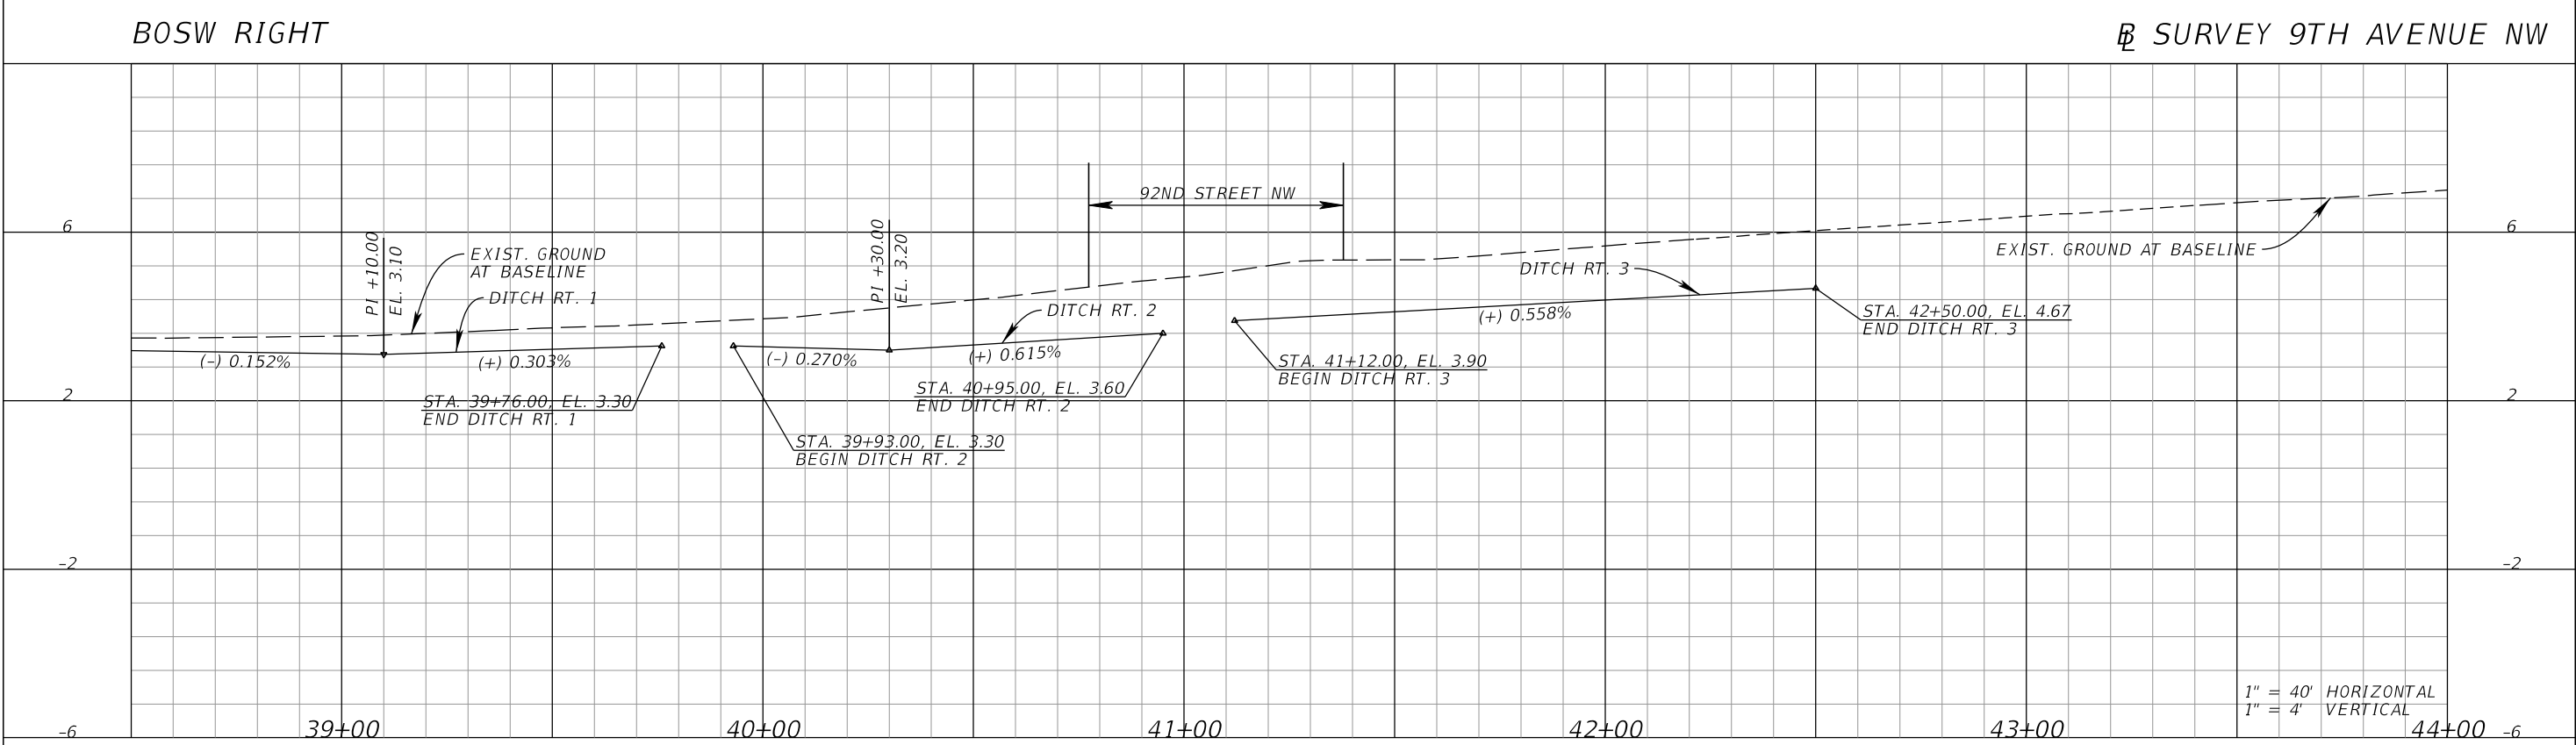MANATEE COUNTY

LICENSED PROFESSIONAL


JORDAN E. LEEP, P.E.  
FL LICENSE NUMBER 76102

BOSW PROFILES (2)

SHEET NUMBER


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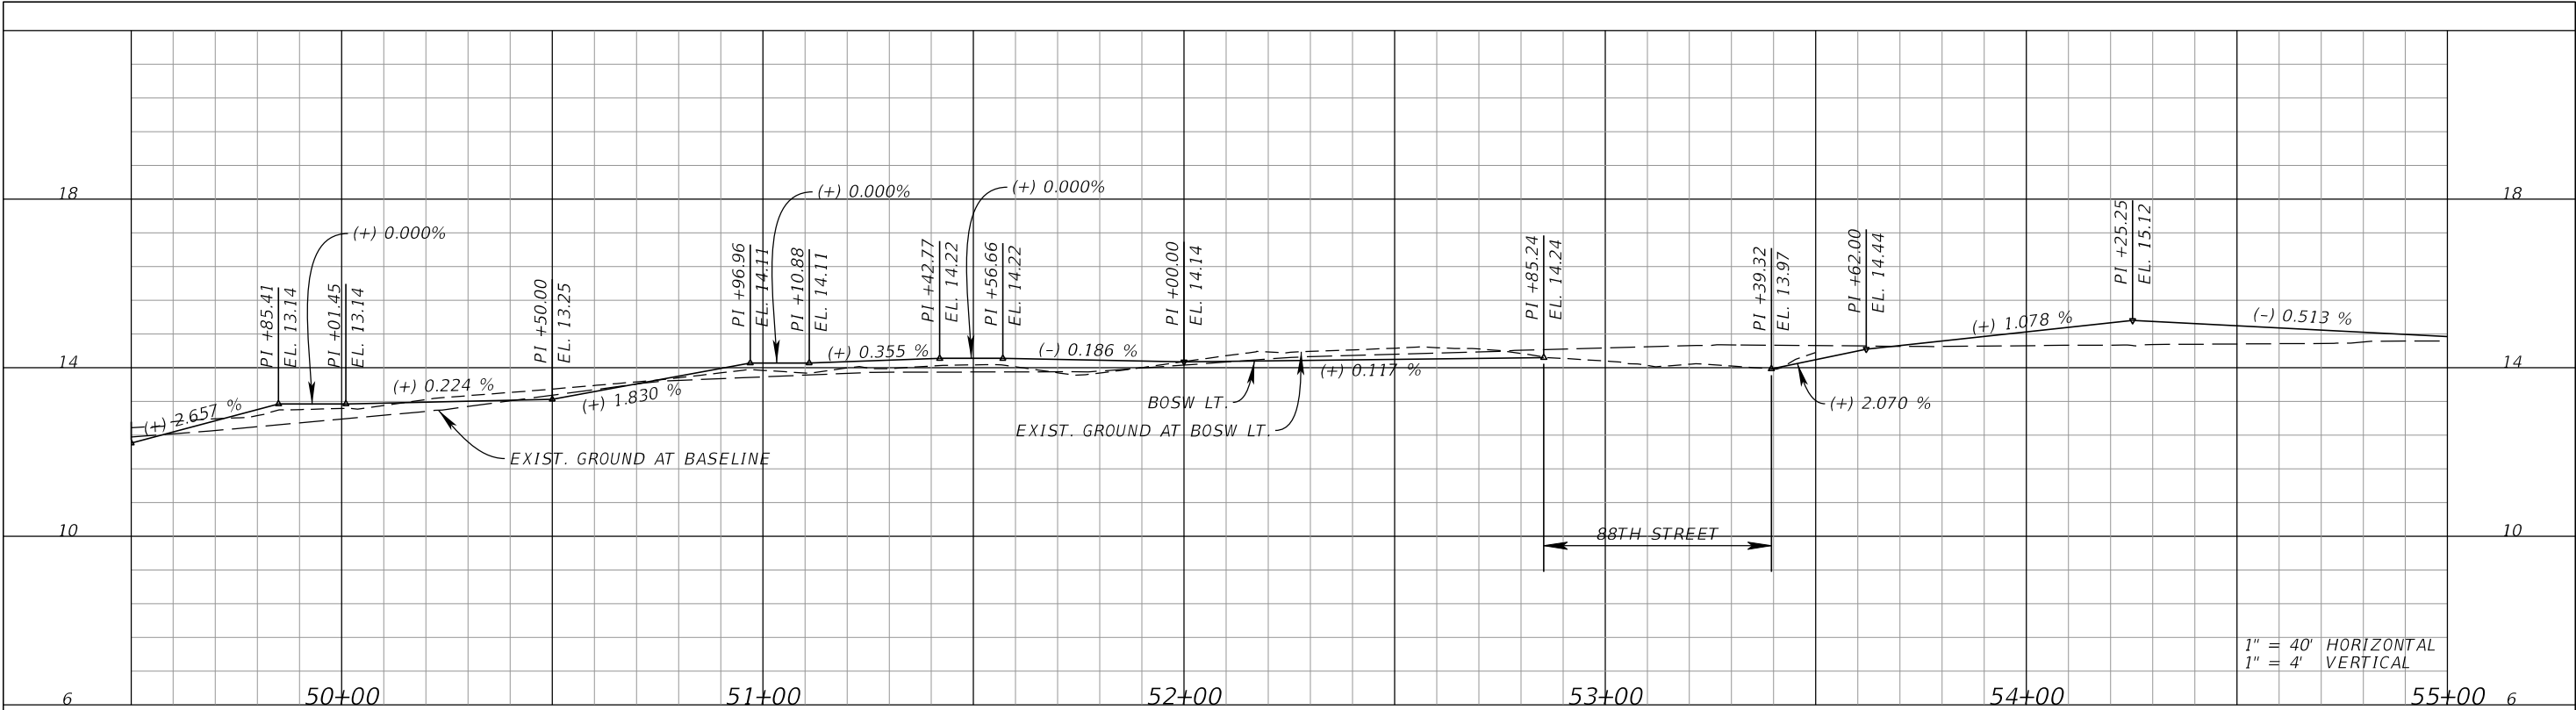


BOSW RIGHT

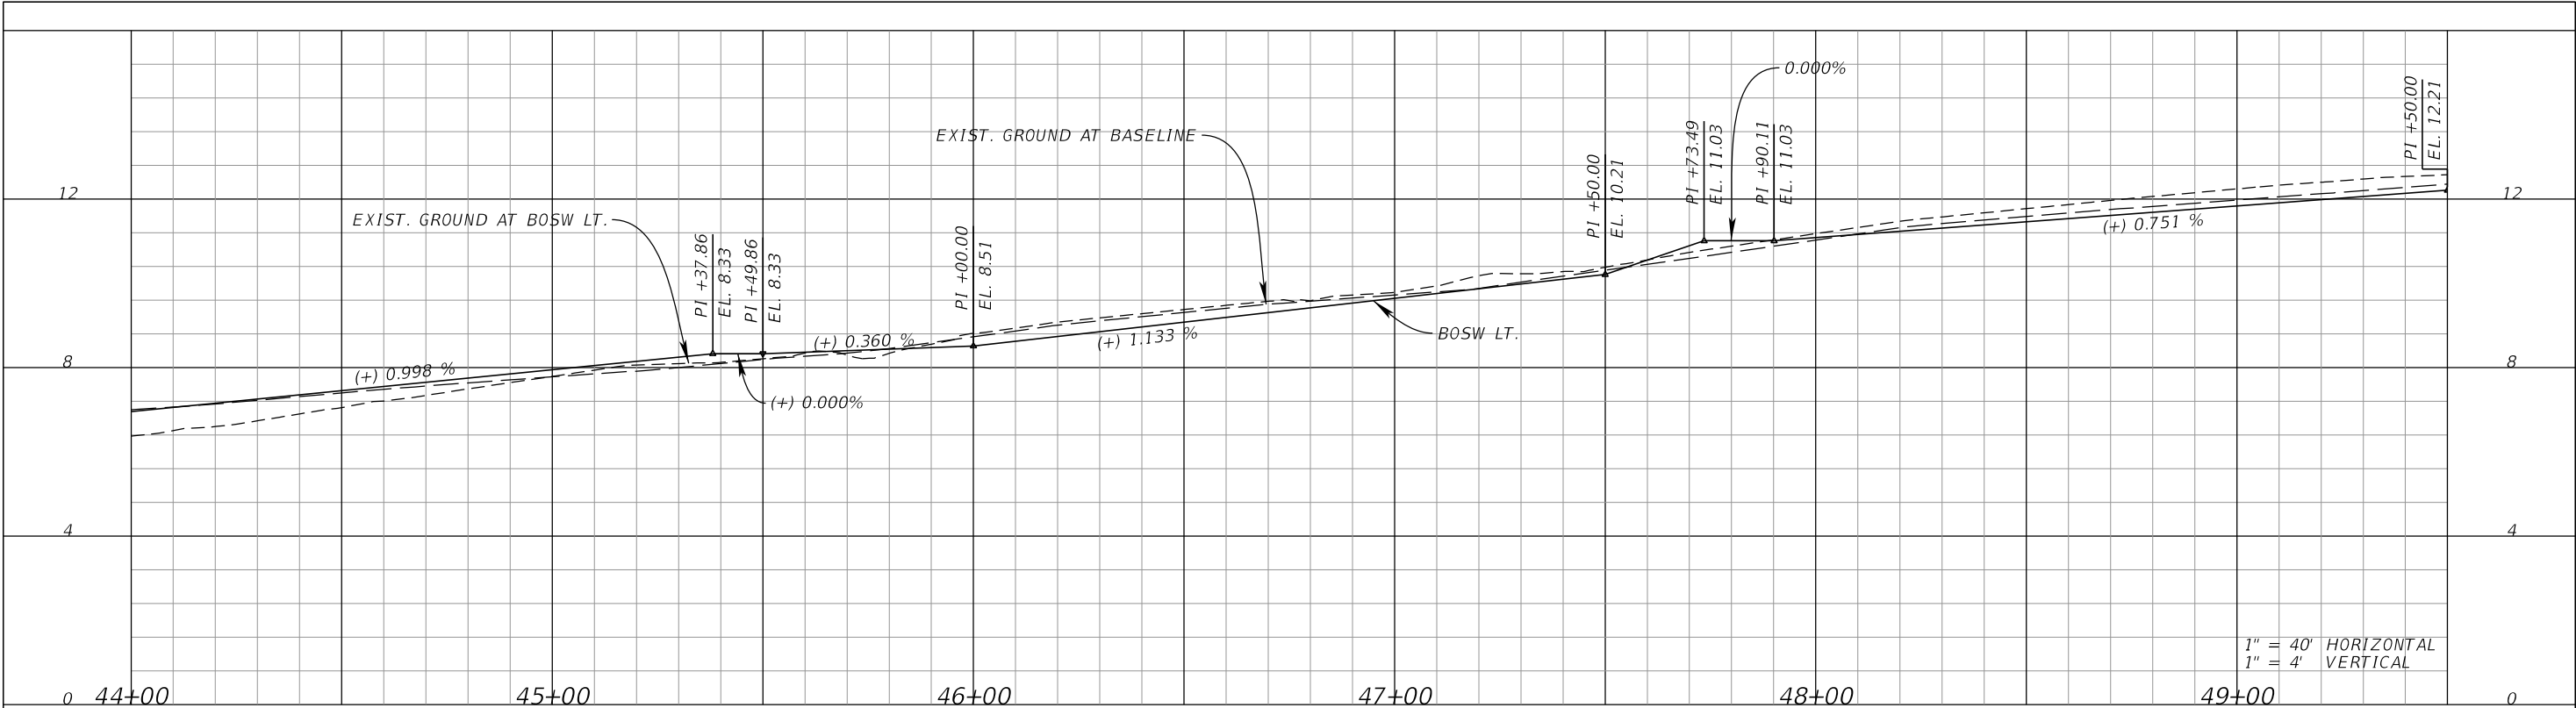⌘ SURVEY 9TH AVENUE NW


				<div>Kimley»Horn</div> <div>© 2025 KIMLEY-HORN AND ASSOCIATES, INC. 1800 SECOND STREET, SUITE 900, SARASOTA, FL 34236 PHONE: 941-379-7600 WWW.KIMLEY-HORN.COM</div>	<div>KHA PROJECT 148400070</div> <div>DATE 10/02/2025</div> <div>SCALE AS SHOWN</div> <div>DESIGNED BY</div> <div>DRAWN BY</div> <div>CHECKED BY</div>	<div></div> <div>9TH AVENUE NW</div> <div>MANATEE COUNTY</div>	<div>LICENSED PROFESSIONAL</div> <div>JORDAN E. LEEP, P.E.</div> <div>FL LICENSE NUMBER 76102</div>	<div>BOSW PROFILES (3)</div>	<div>SHEET NUMBER</div> <div>57</div>
No.	REVISIONS	DATE	BY						

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⌘ SURVEY 9TH AVENUE NW

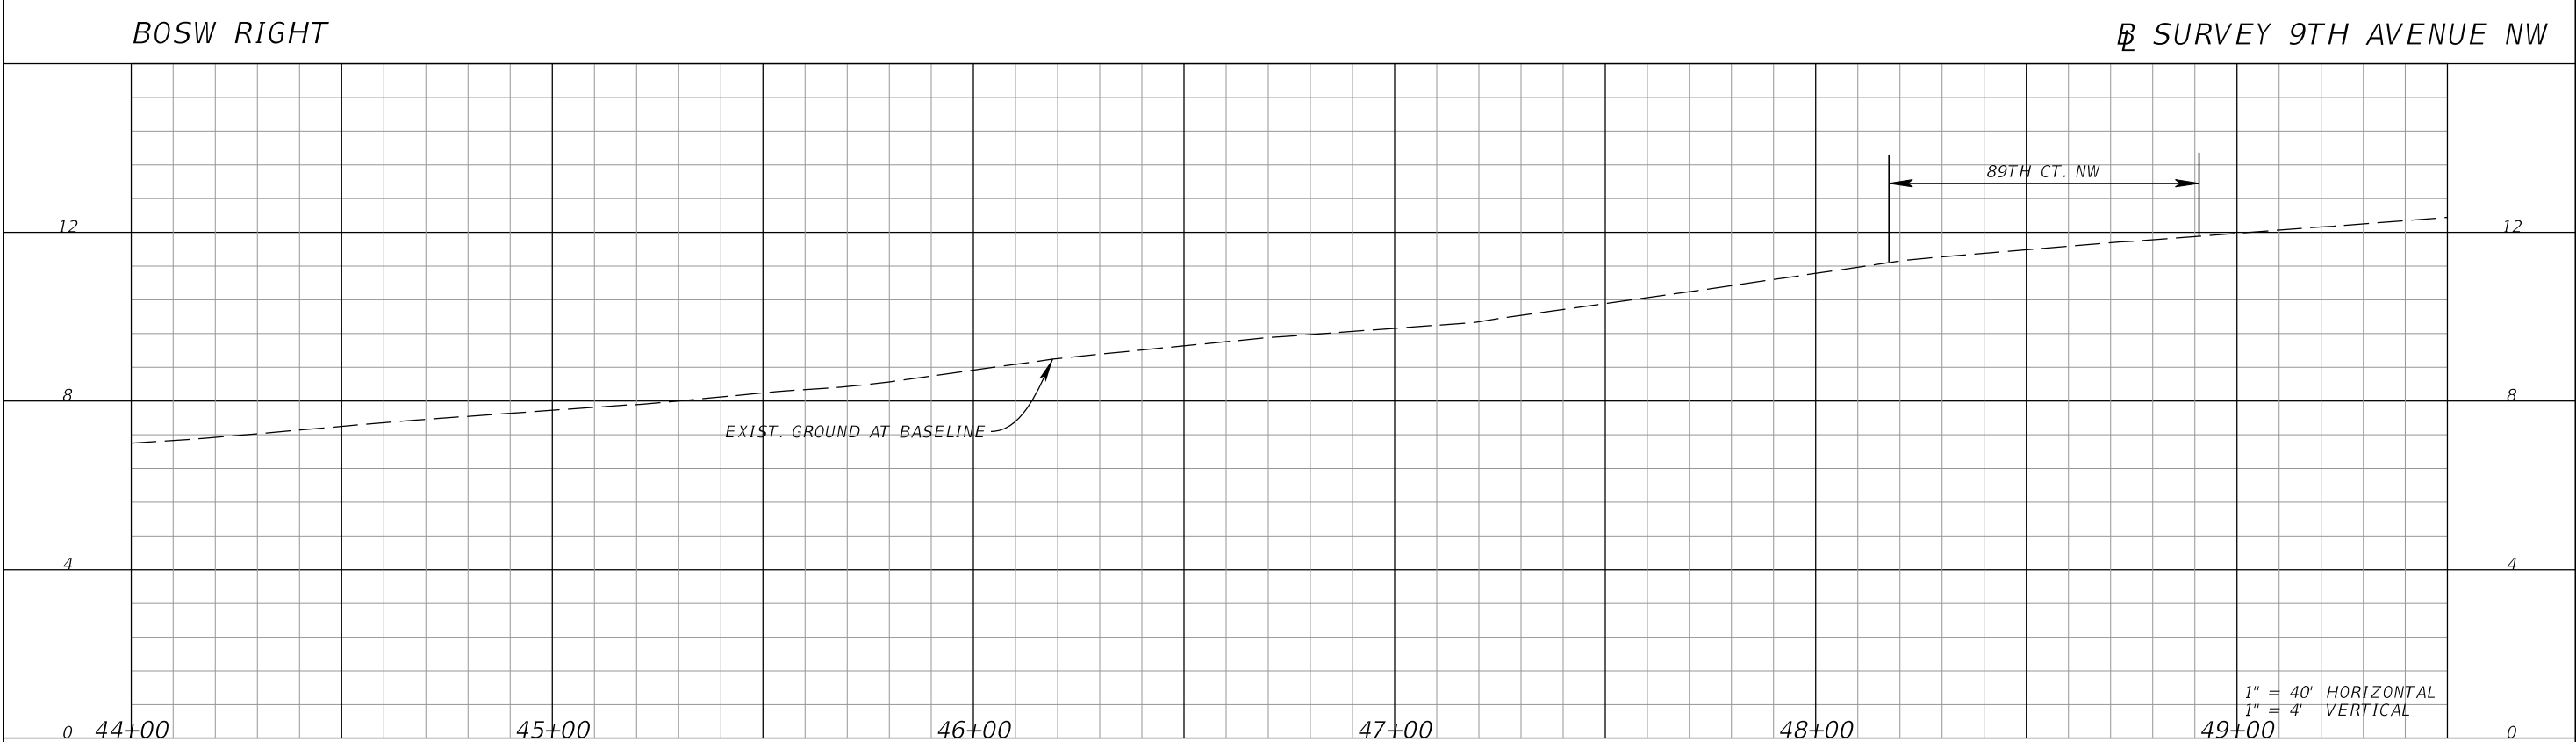


BOSW RIGHT

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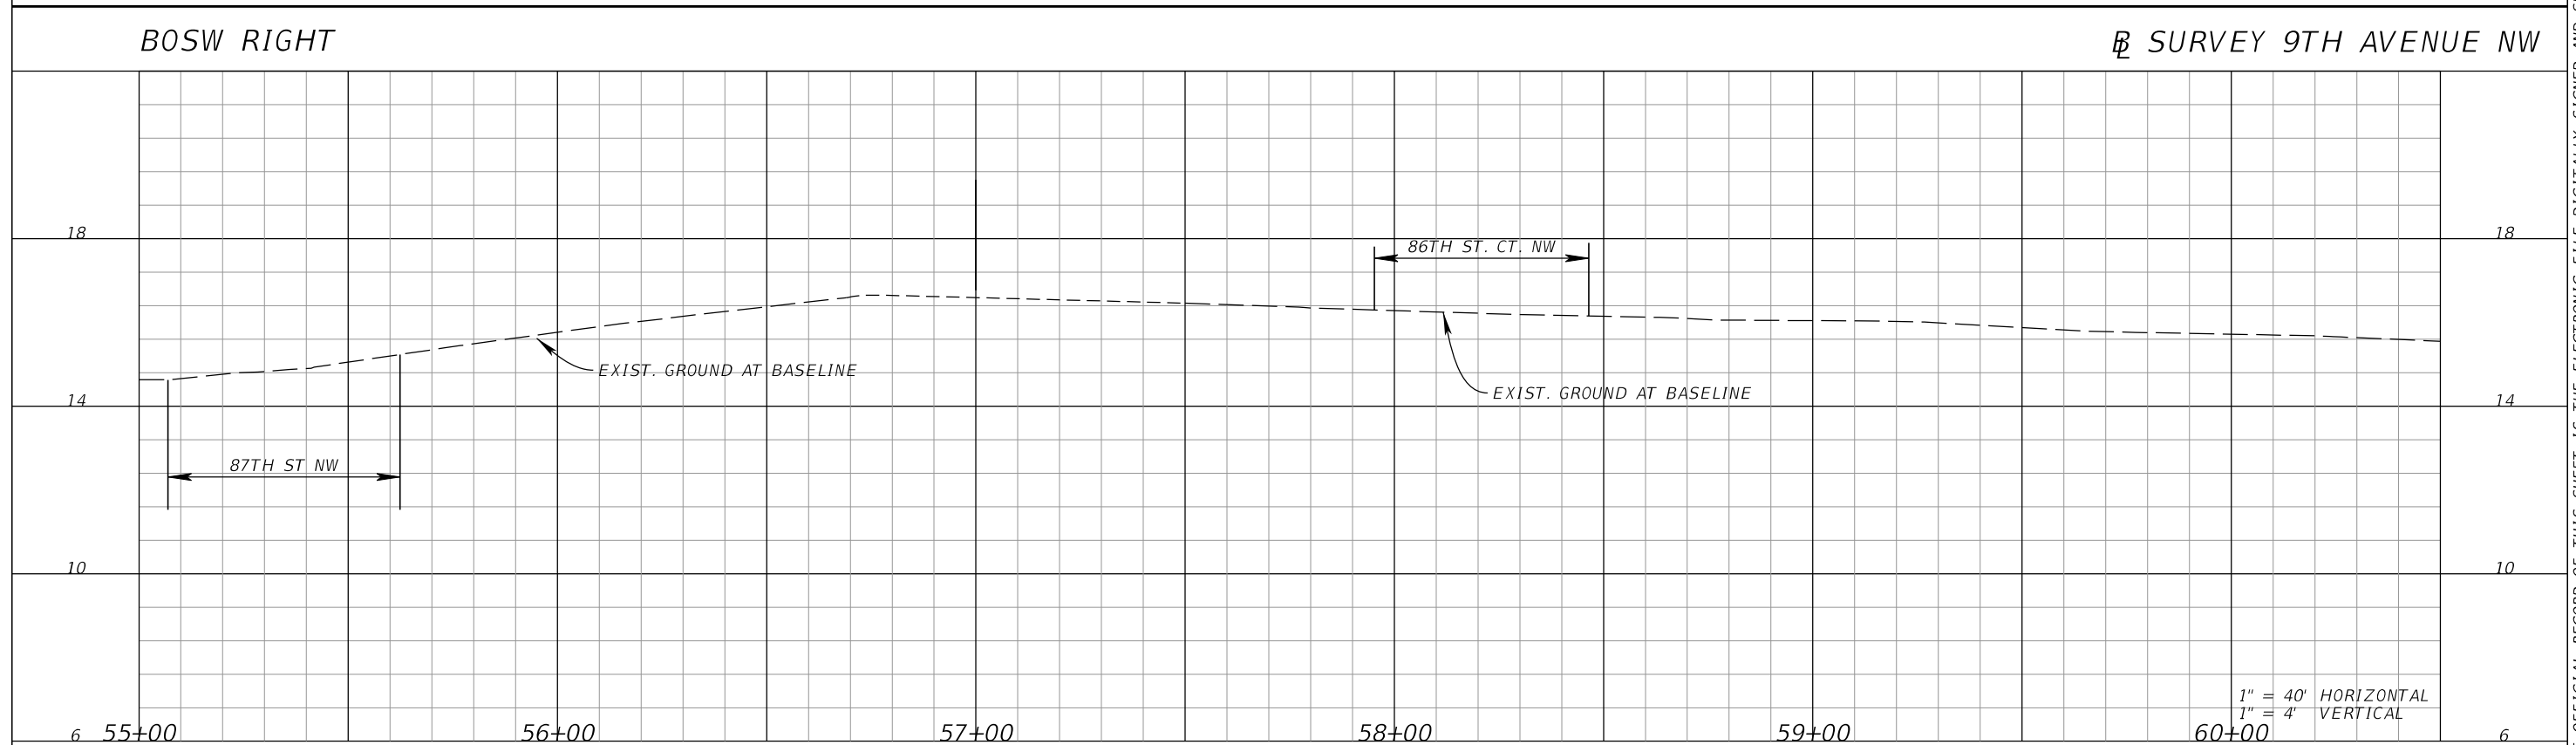
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					DATE 10/02/2025						
					SCALE AS SHOWN						
					DESIGNED BY						
					DRAWN BY						
					CHECKED BY						
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Susan.Pluta											
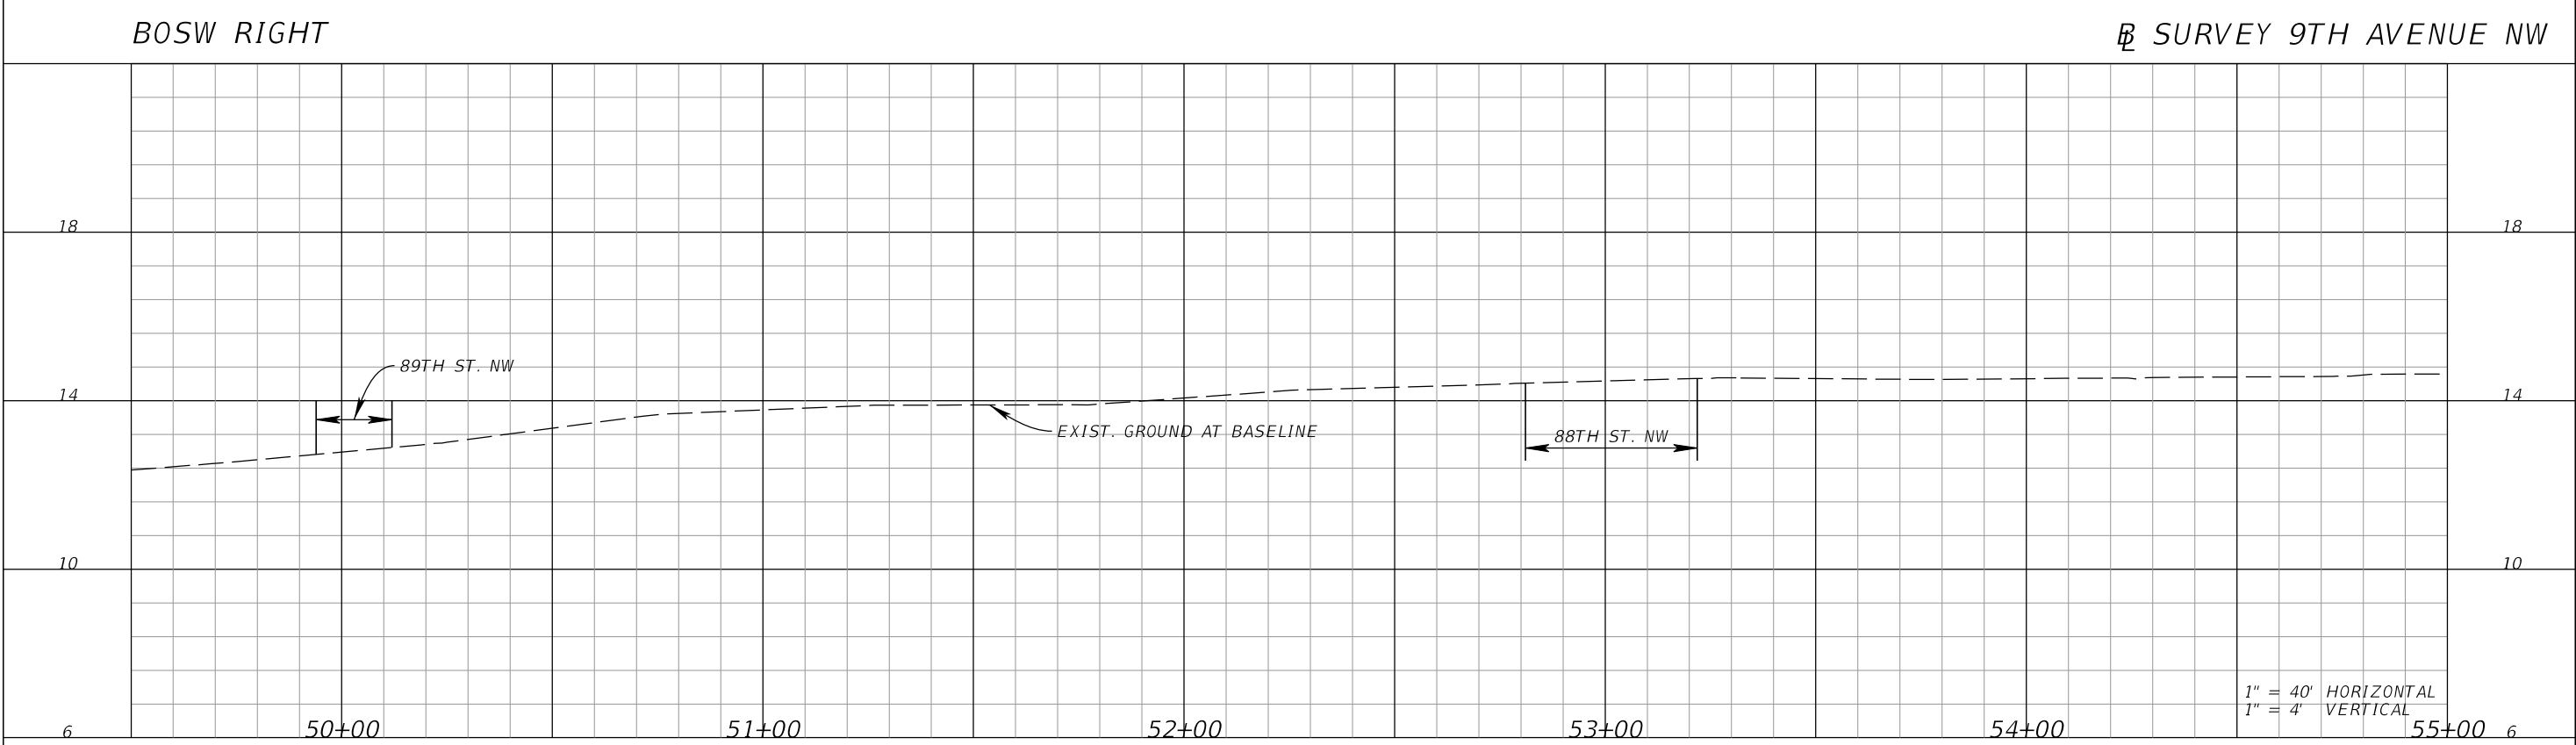
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B SURVEY 9TH AVENUE NW

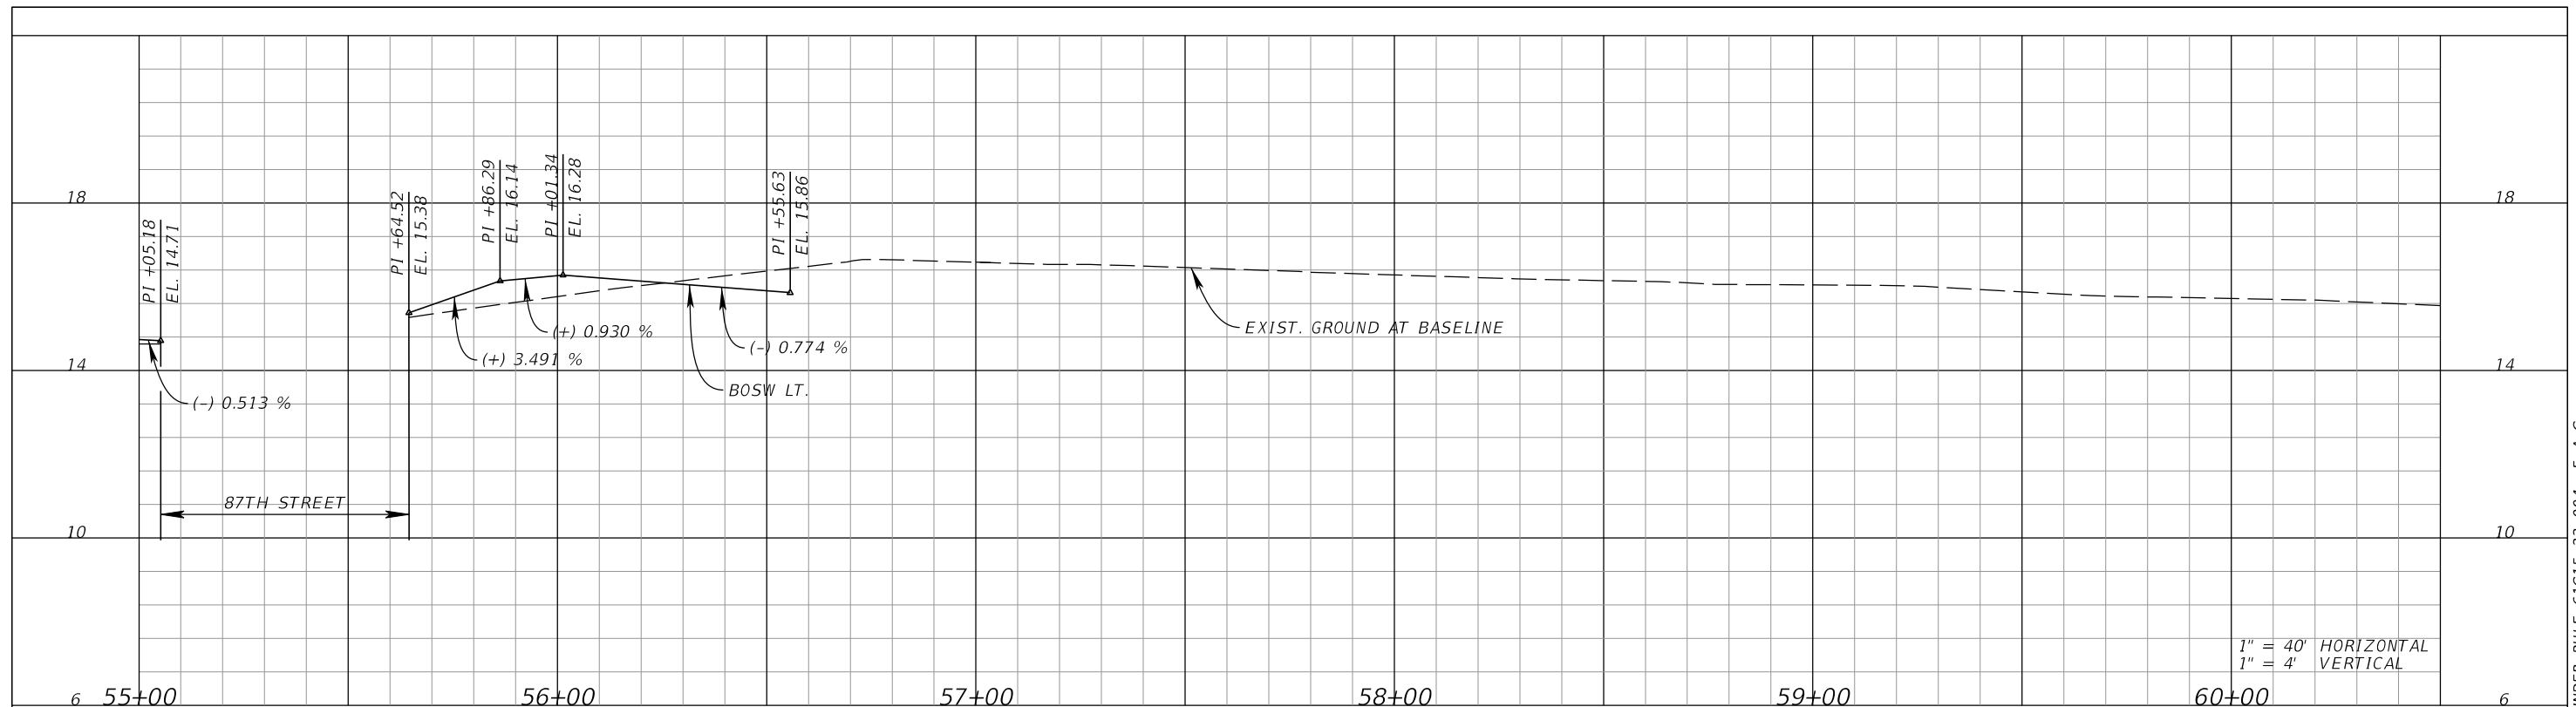

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MANATEE COUNTY



9TH AVENUE NW

LICENSED PROFESSIONAL

JORDAN E.  
LEEP, P.E.  
FL LICENSE NUMBER  
76102

FL DATE:

BOSW PROFILES (5)

SHEET NUMBER


59

*Susan.Pluta*

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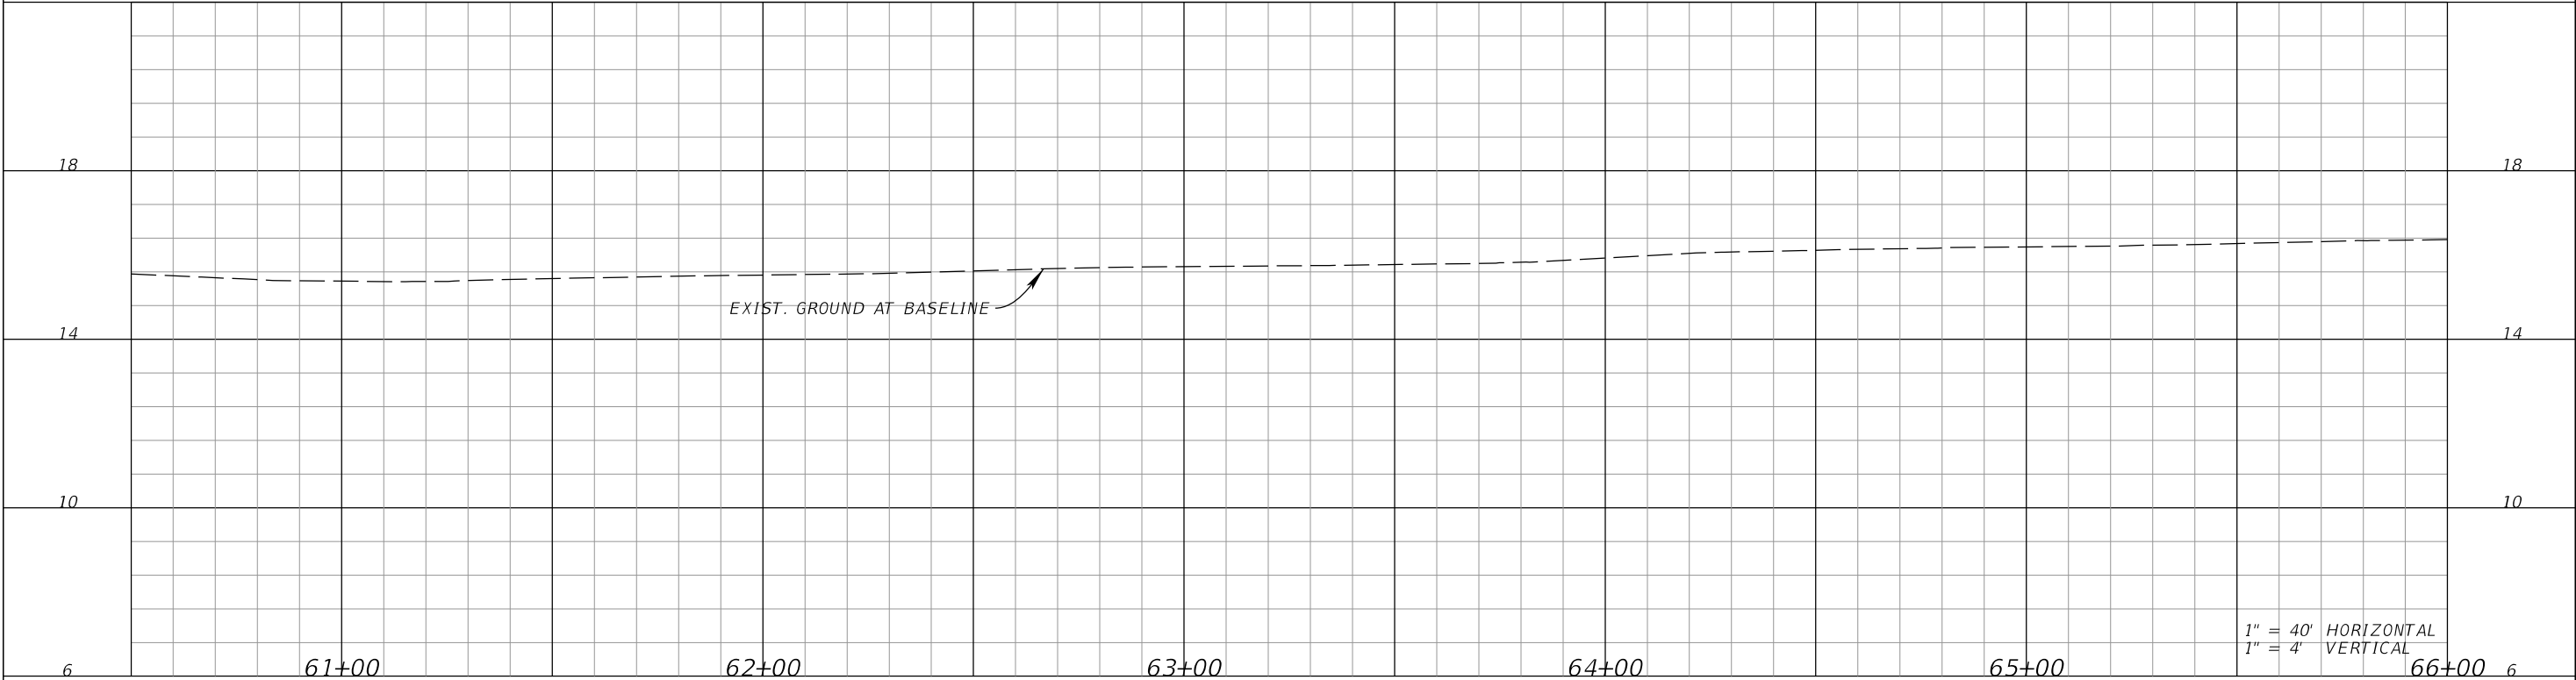


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⌚ SURVEY 9TH AVENUE NW

BOSW RIGHT

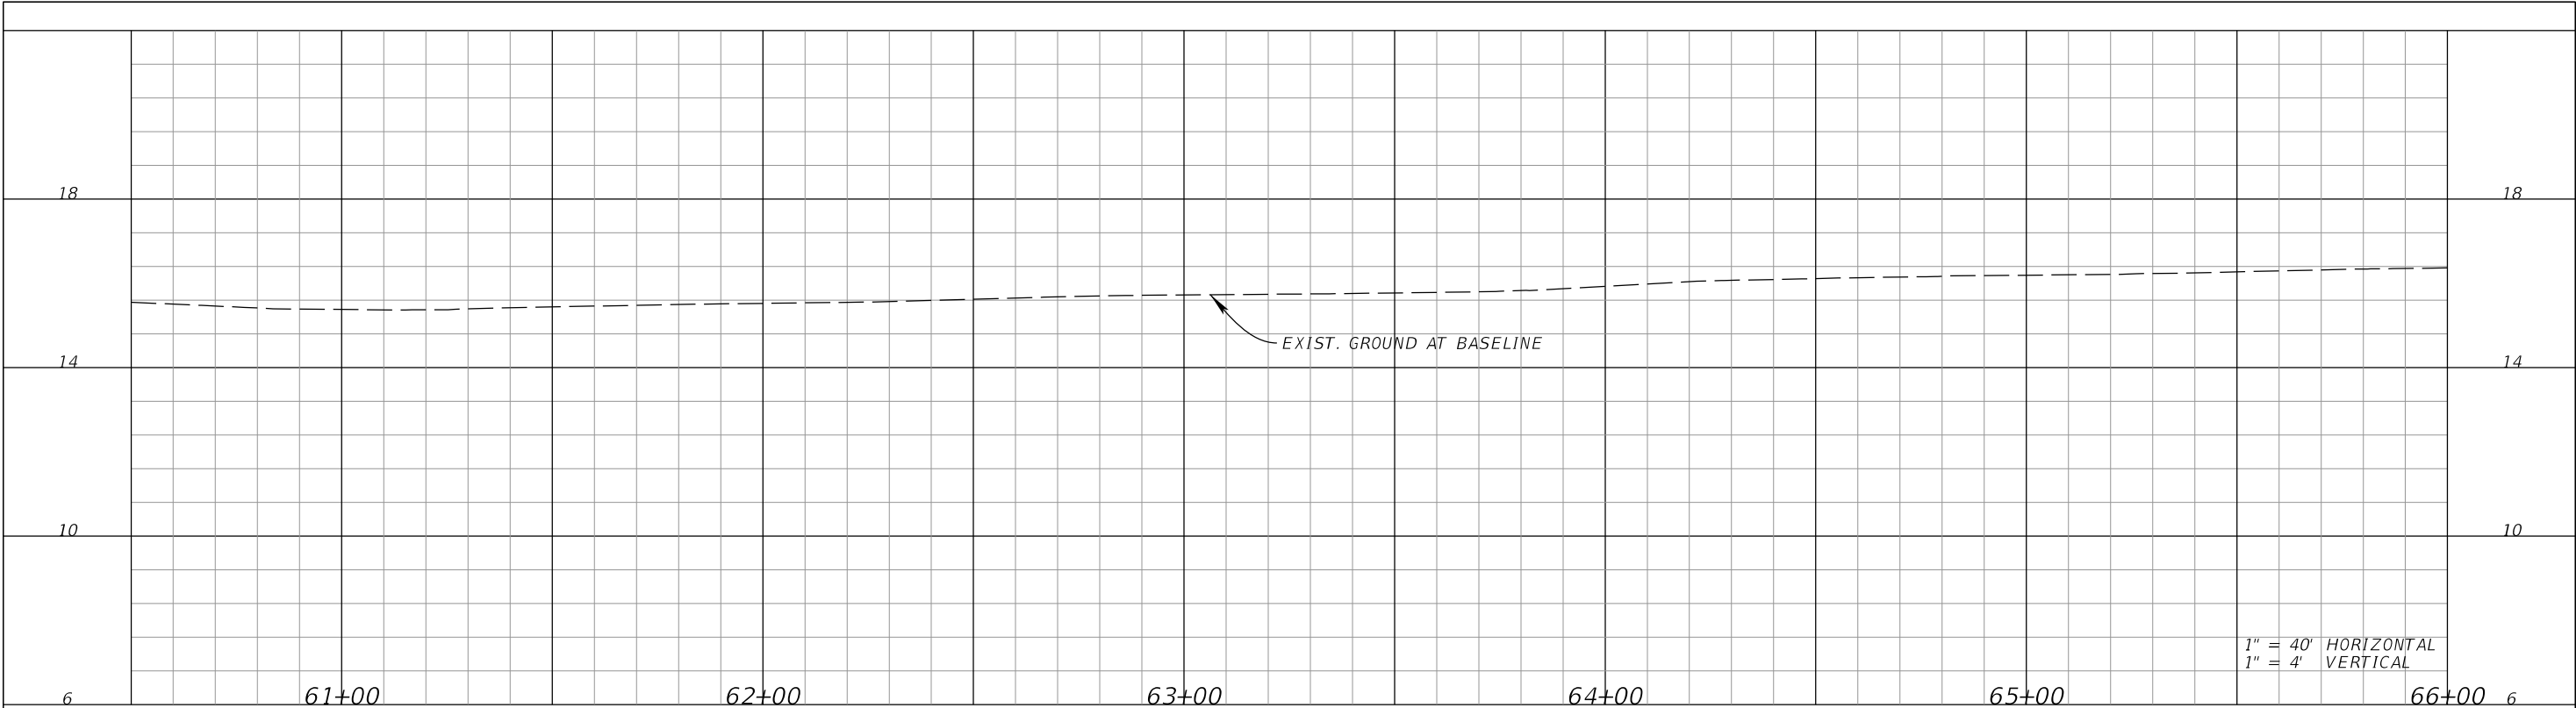
⌚ SURVEY 9TH AVENUE NW



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No.	REVISIONS	DATE	BY						

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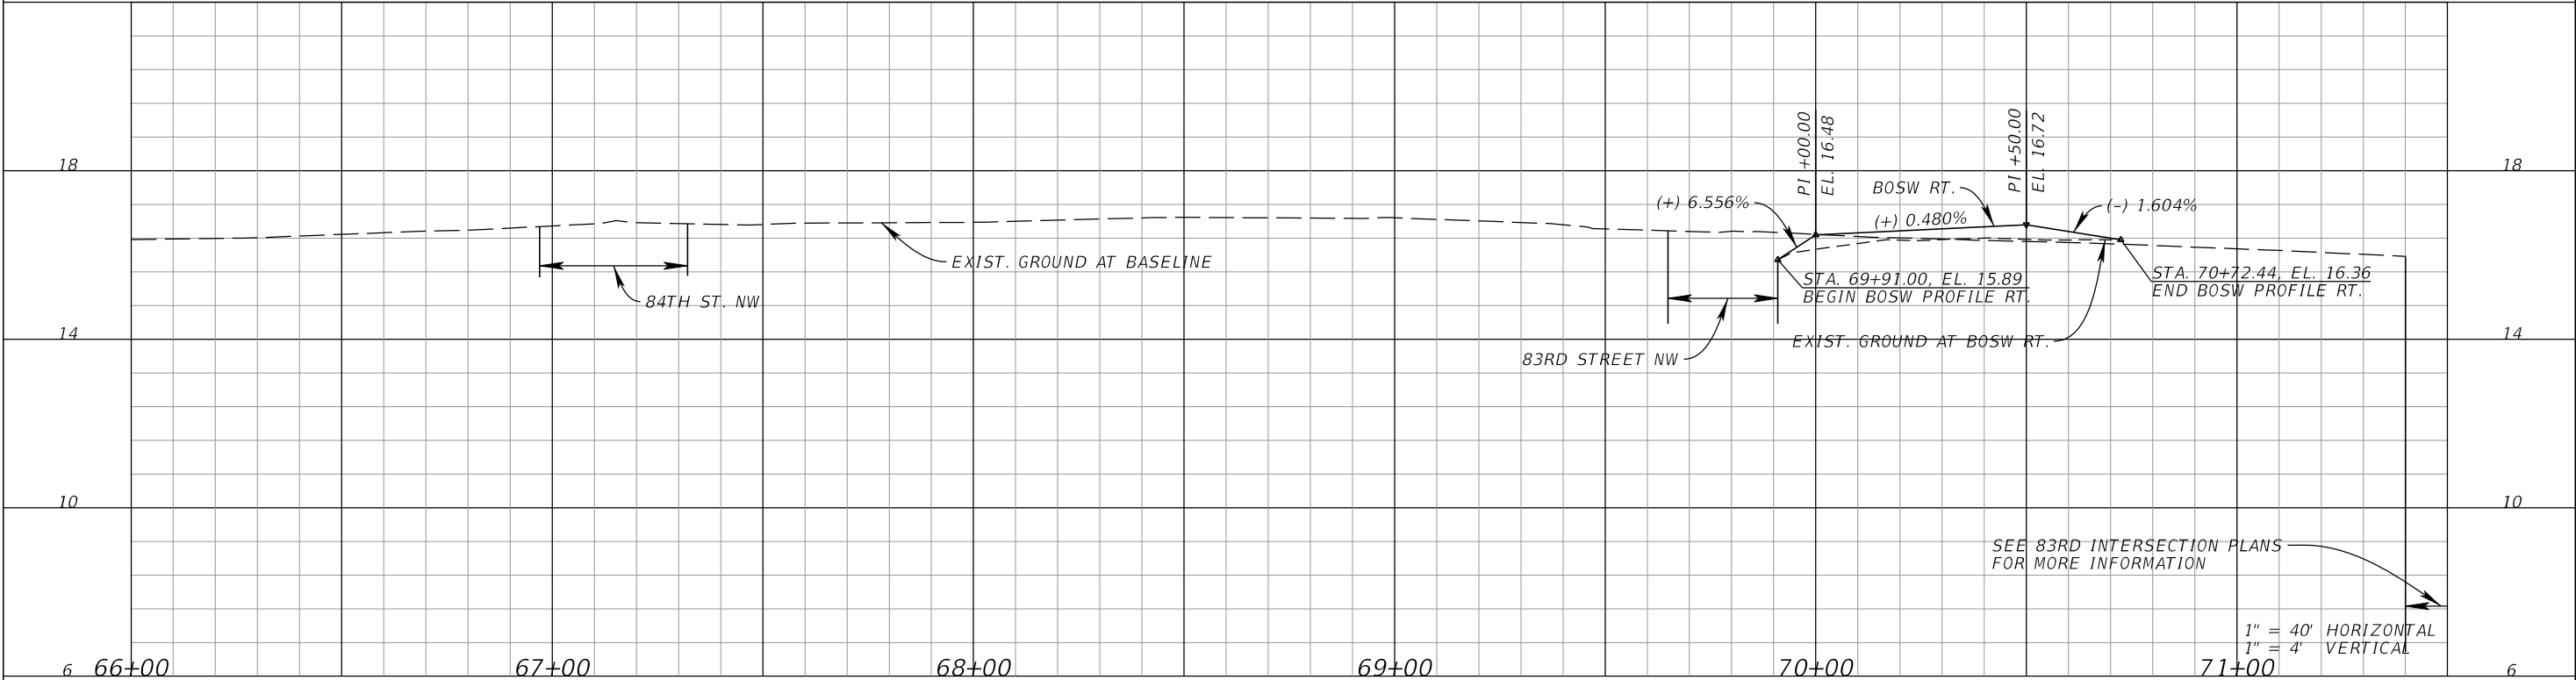


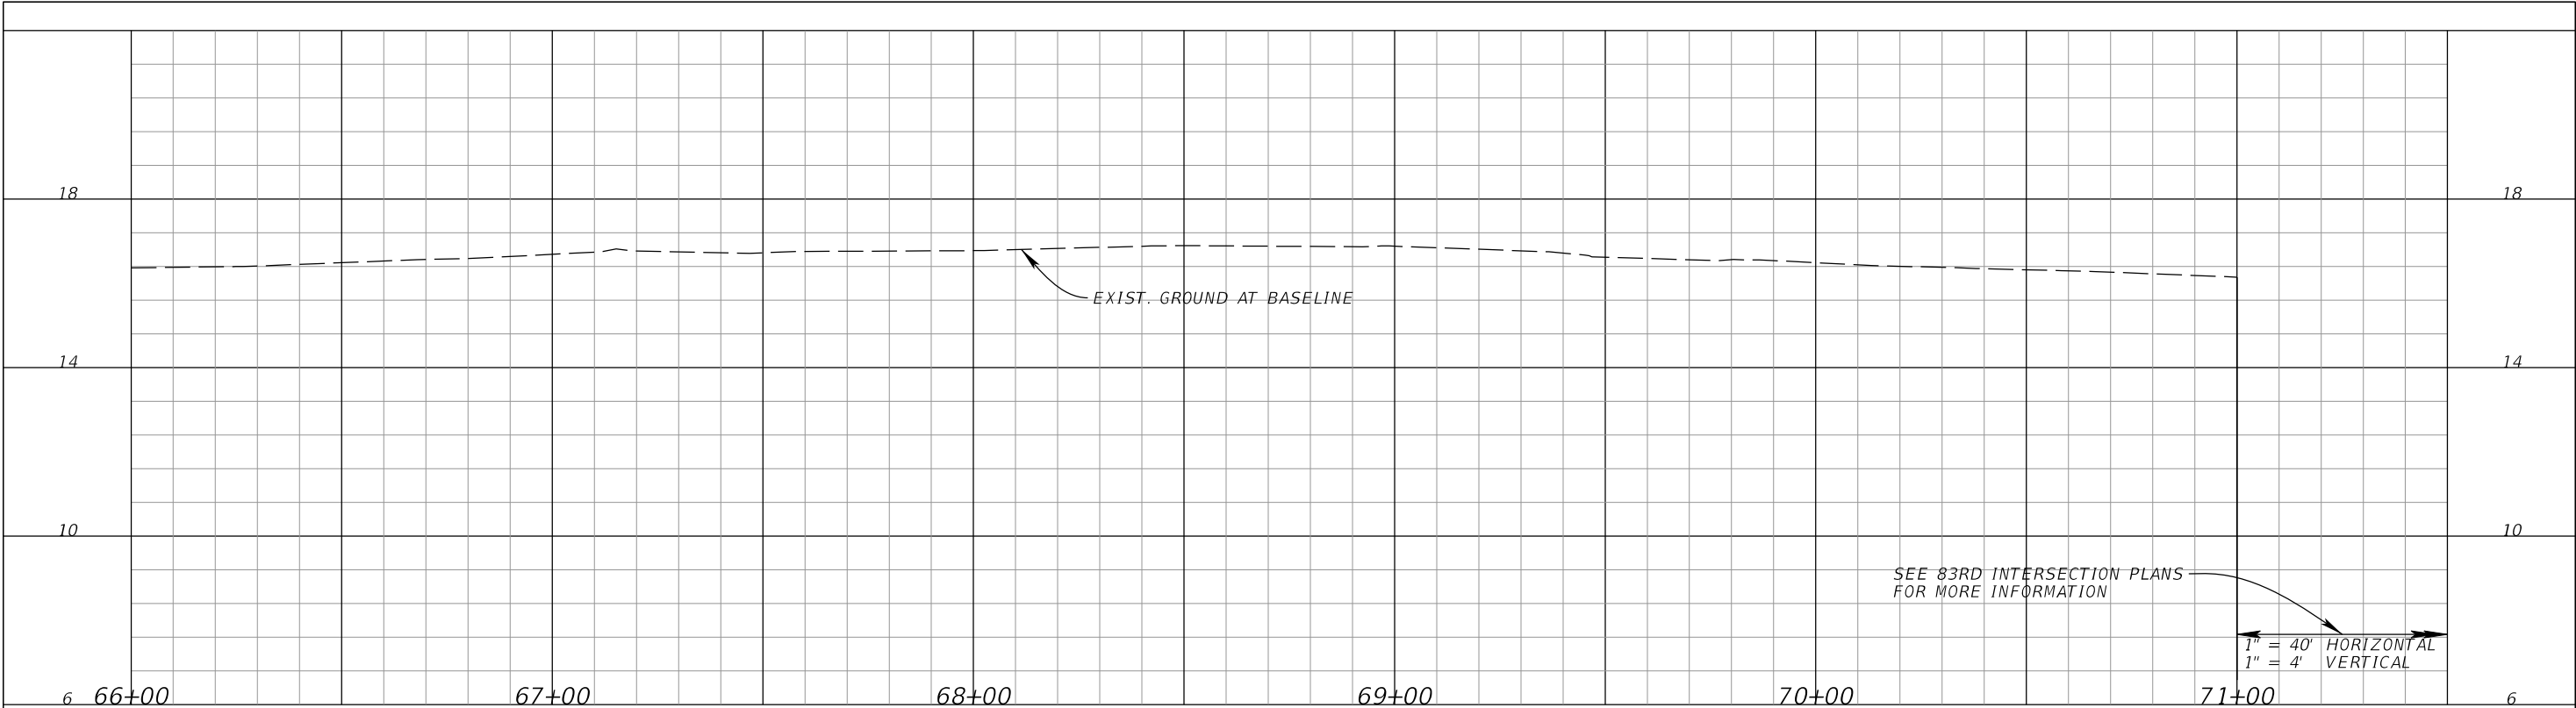

BOSW LEFT

⌘ SURVEY 9TH AVENUE NW

BOSW RIGHT ⌘ SURVEY 9TH AVENUE NW



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9TH AVENUE NW

MANATEE COUNTY

LICENSED PROFESSIONAL

JORDAN E. LEEP, P.E.  
FL LICENSE NUMBER 76102

BOSW PROFILES (7)

SHEET NUMBER

61

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⌘ SURVEY 9TH AVENUE NW

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⌘ SURVEY 9TH AVENUE NW



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9TH AVENUE NW

MANATEE COUNTY

LICENSED PROFESSIONAL


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FL LICENSE NUMBER 76102

BOSW PROFILES (8)

SHEET NUMBER

62

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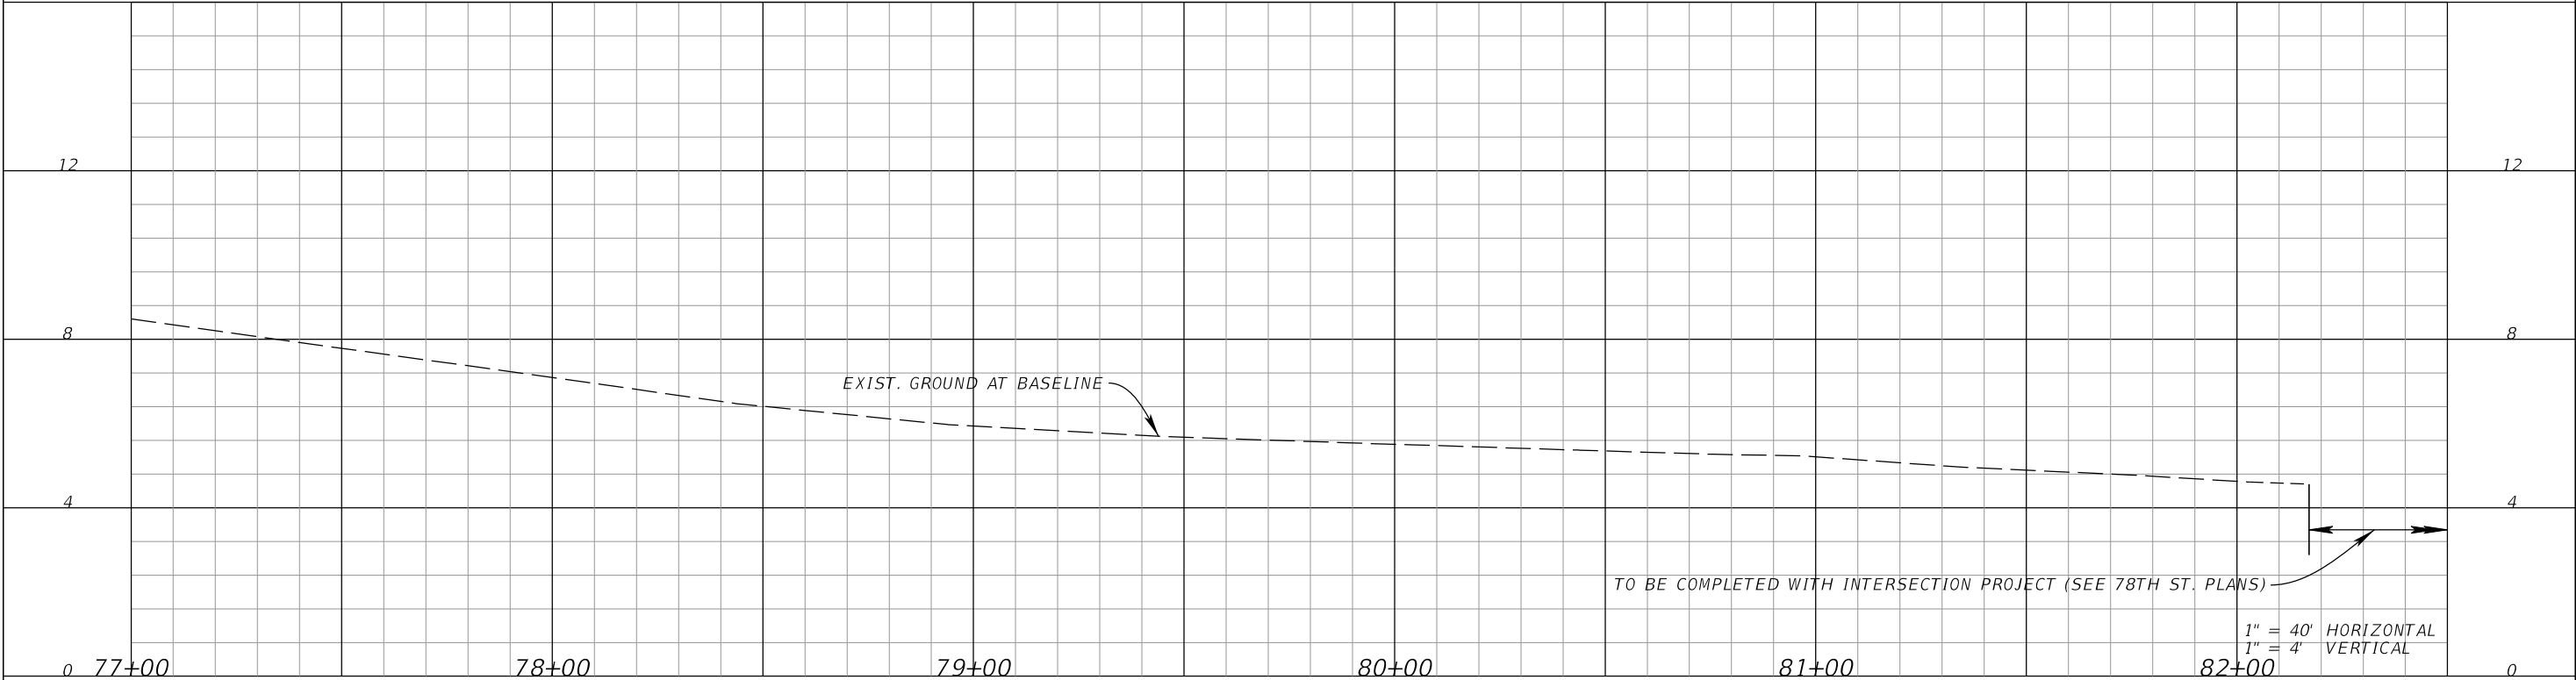


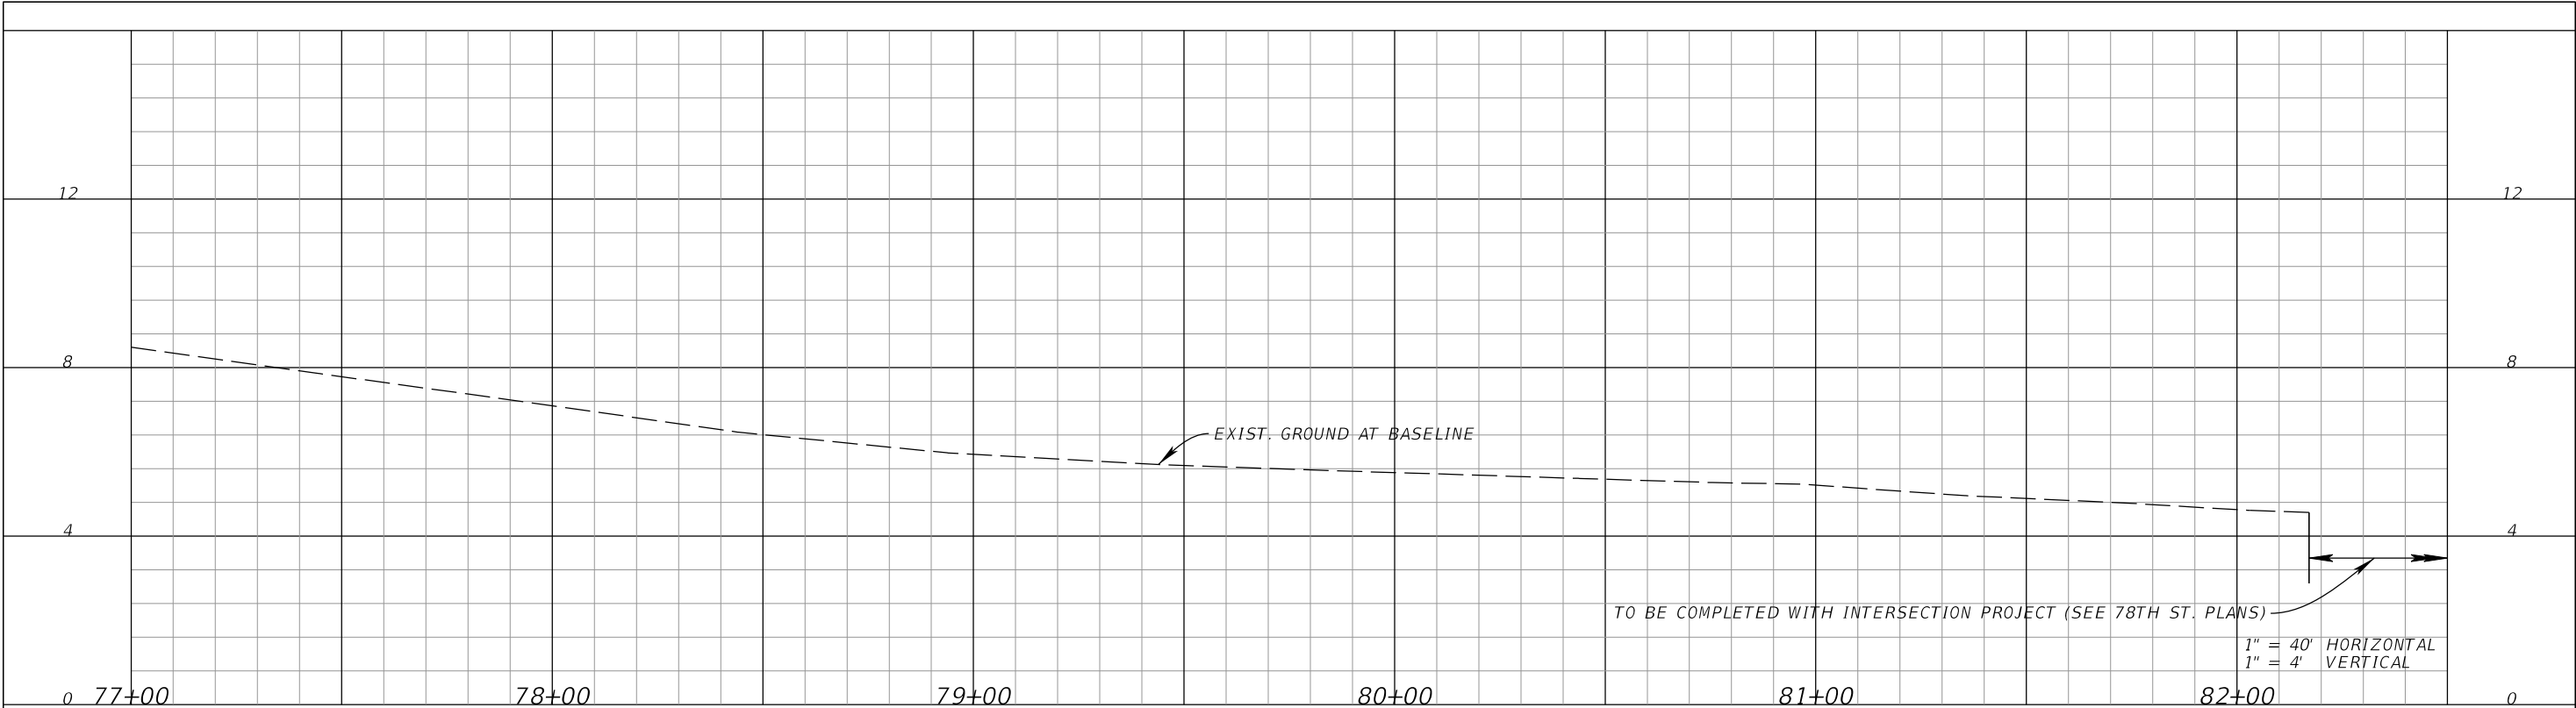BOSW LEFT

⌘ SURVEY 9TH AVENUE NW

BOSW RIGHT

⌘ SURVEY 9TH AVENUE NW



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No.	REVISIONS	DATE	BY						

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⌘ SURVEY 9TH AVENUE NW


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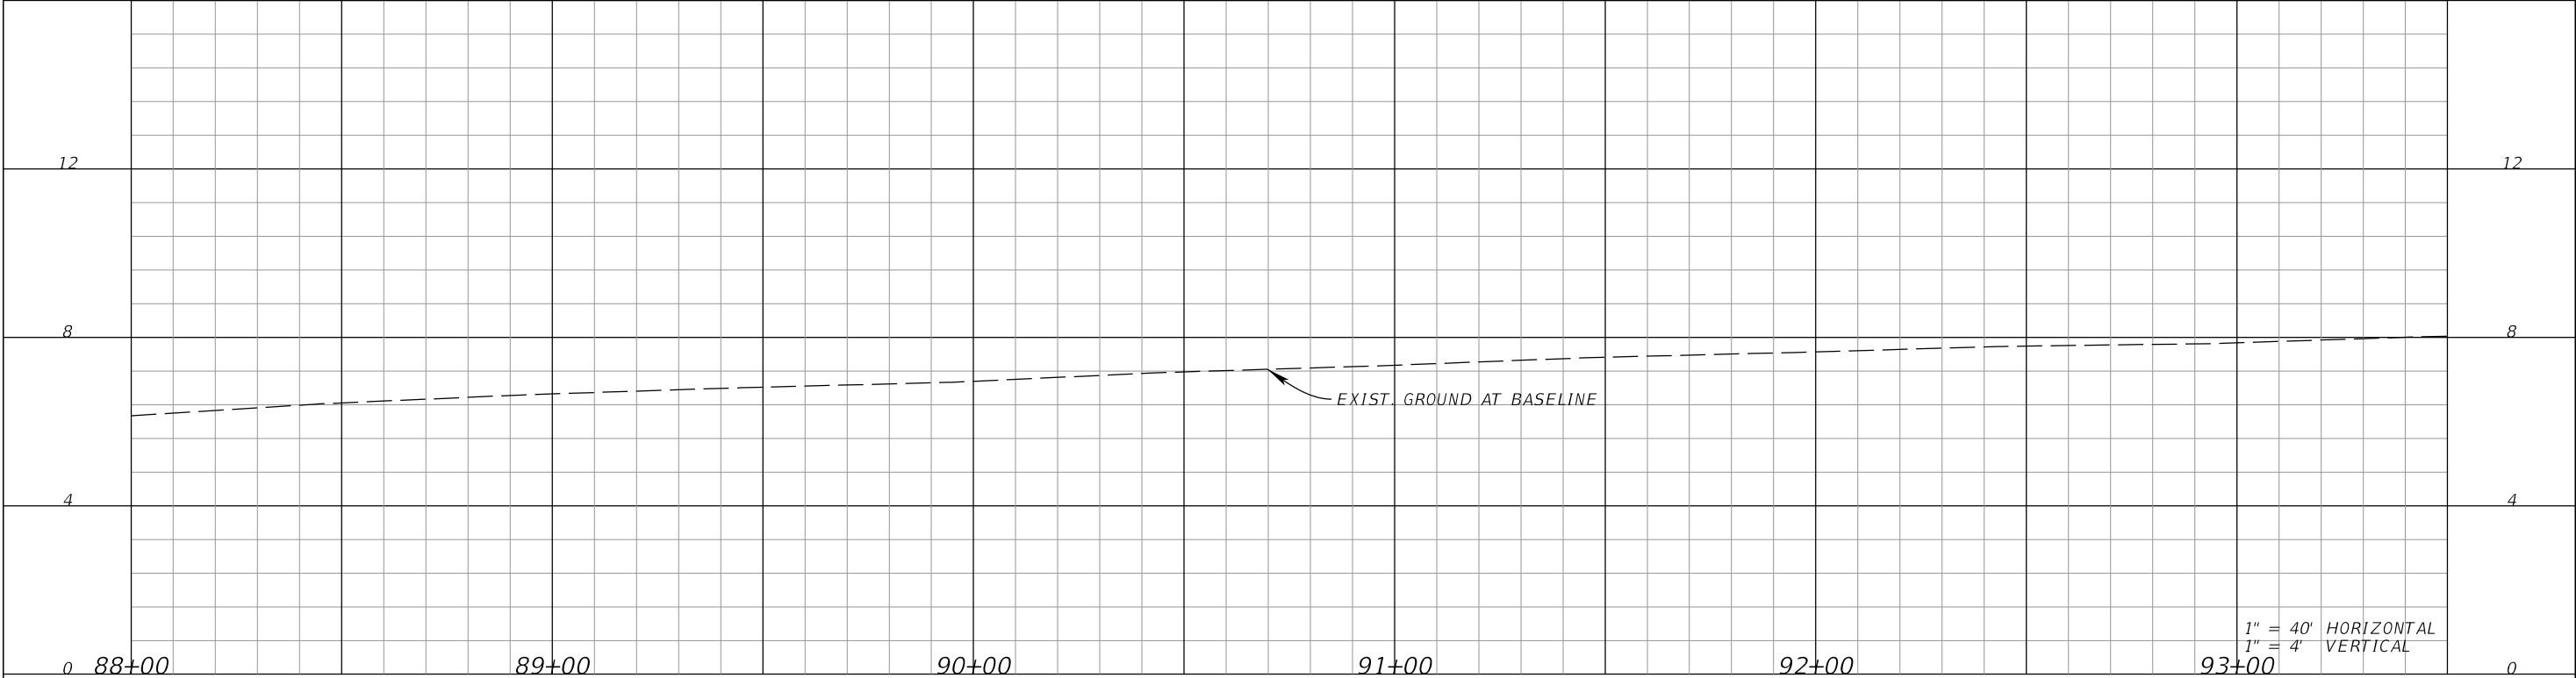
				<div><div><div>Kimley»Horn</div><div>© 2025 KIMLEY-HORN AND ASSOCIATES, INC. 1800 SECOND STREET, SUITE 900, SARASOTA, FL 34236 PHONE: 941-379-7600 WWW.KIMLEY-HORN.COM</div></div></div>	<div><div>KHA PROJECT 148400070</div><div>DATE 10/02/2025</div><div>SCALE AS SHOWN</div><div>DESIGNED BY</div><div>DRAWN BY</div><div>CHECKED BY</div></div>	<div><div><div><div></div><div>9TH AVENUE NW</div></div></div><div>MANATEE COUNTY</div></div>	<div><div>LICENSED PROFESSIONAL</div><div>JORDAN E. LEEP, P.E. FL LICENSE NUMBER 76102</div></div> <div>FL DATE:</div>	<div><div>BOSW PROFILES (10)</div></div>	<div><div>SHEET NUMBER</div><div>64</div></div>
No.	REVISIONS	DATE	BY						

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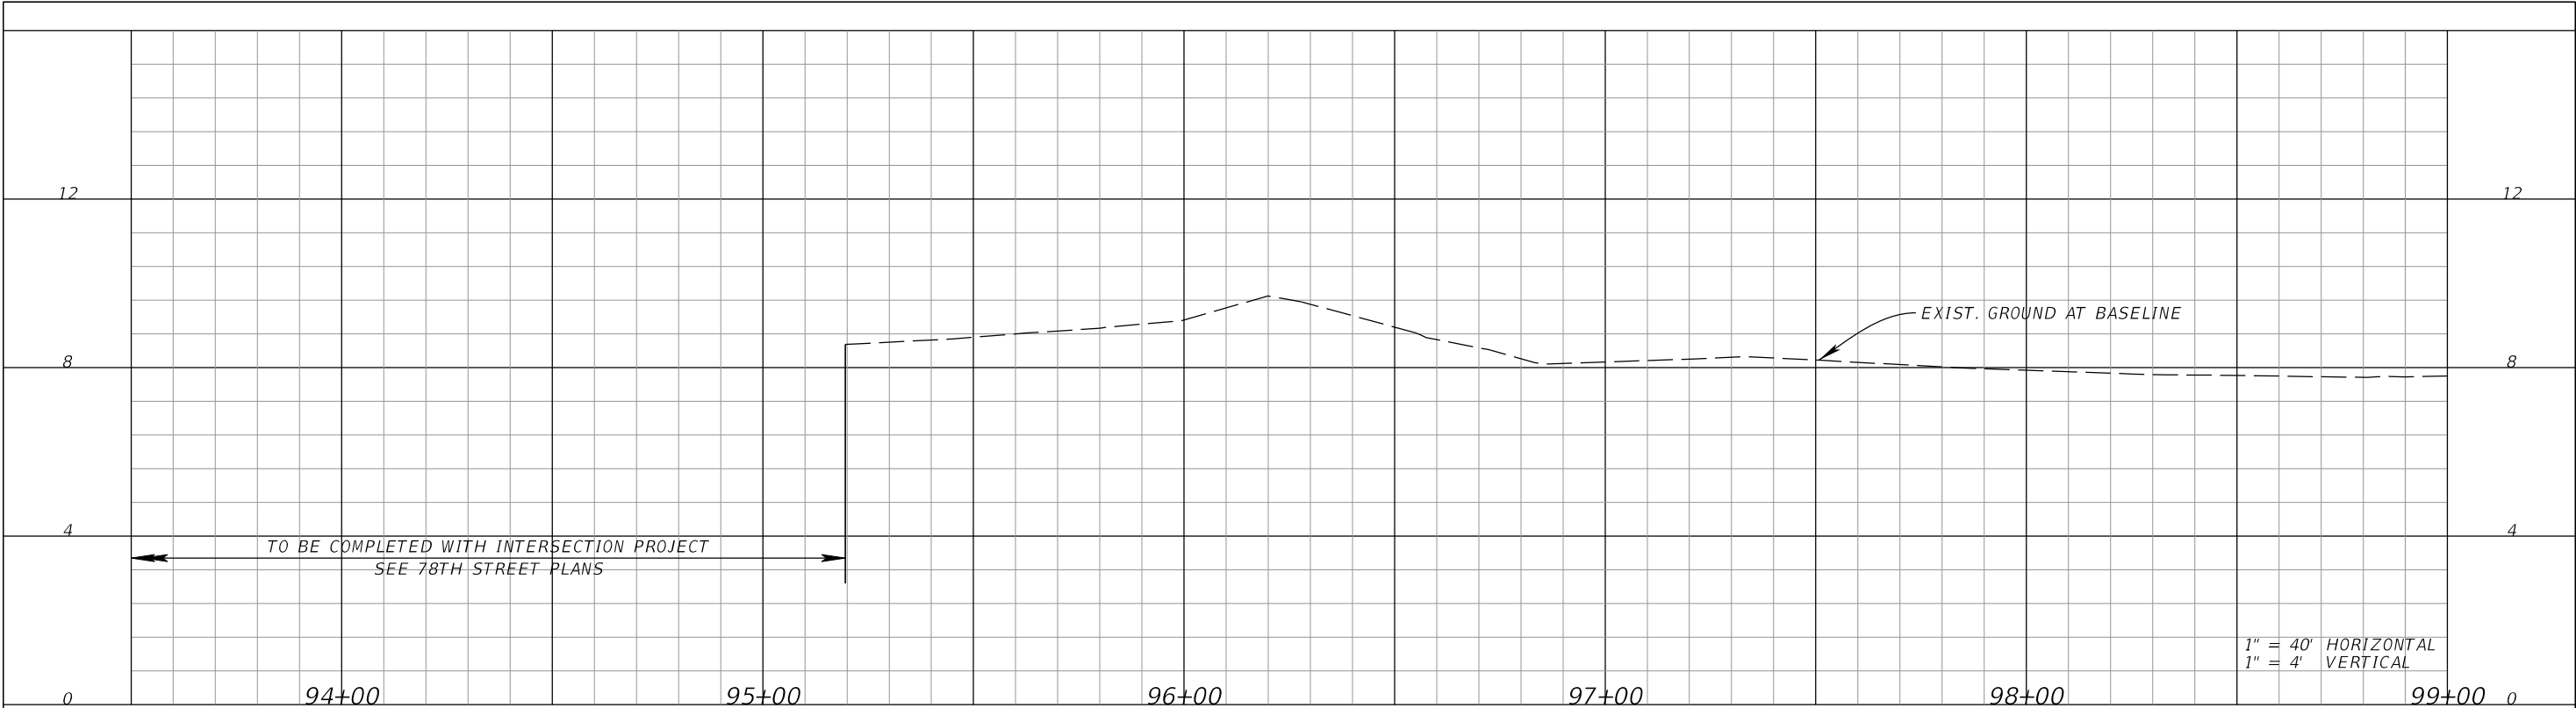
BOSW LEFT SURVEY 9TH AVENUE NW

BOSW RIGHT SURVEY 9TH AVENUE NW



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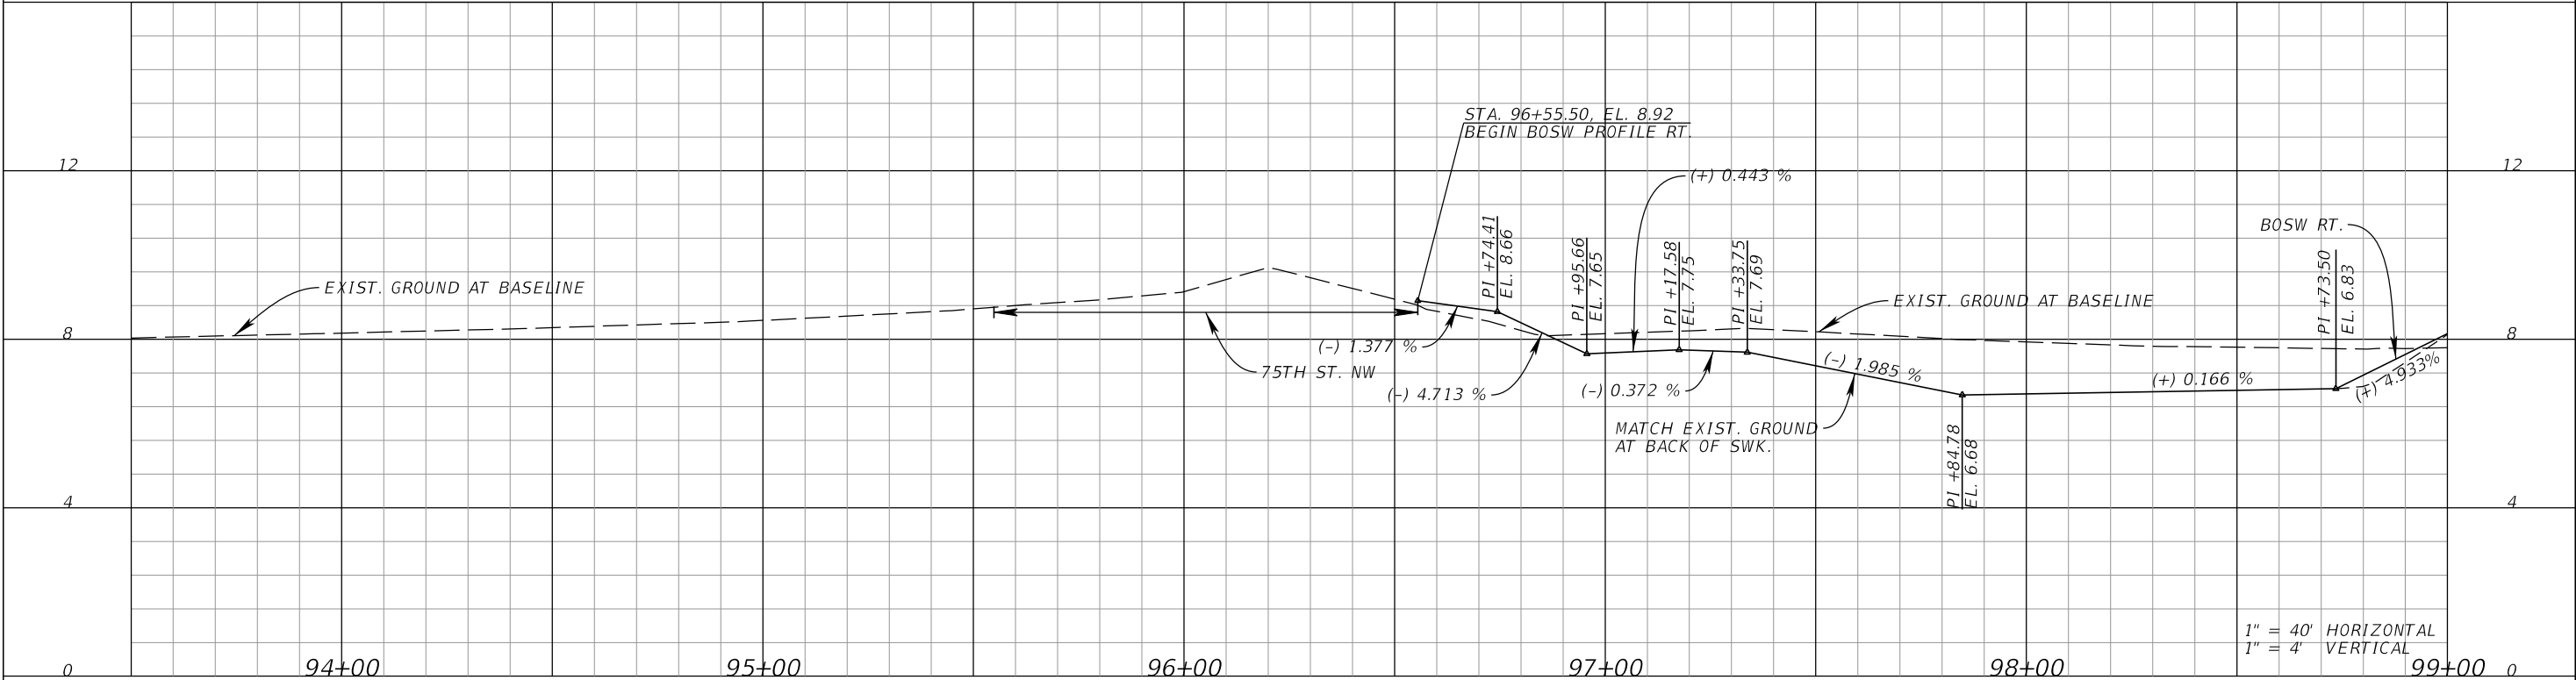


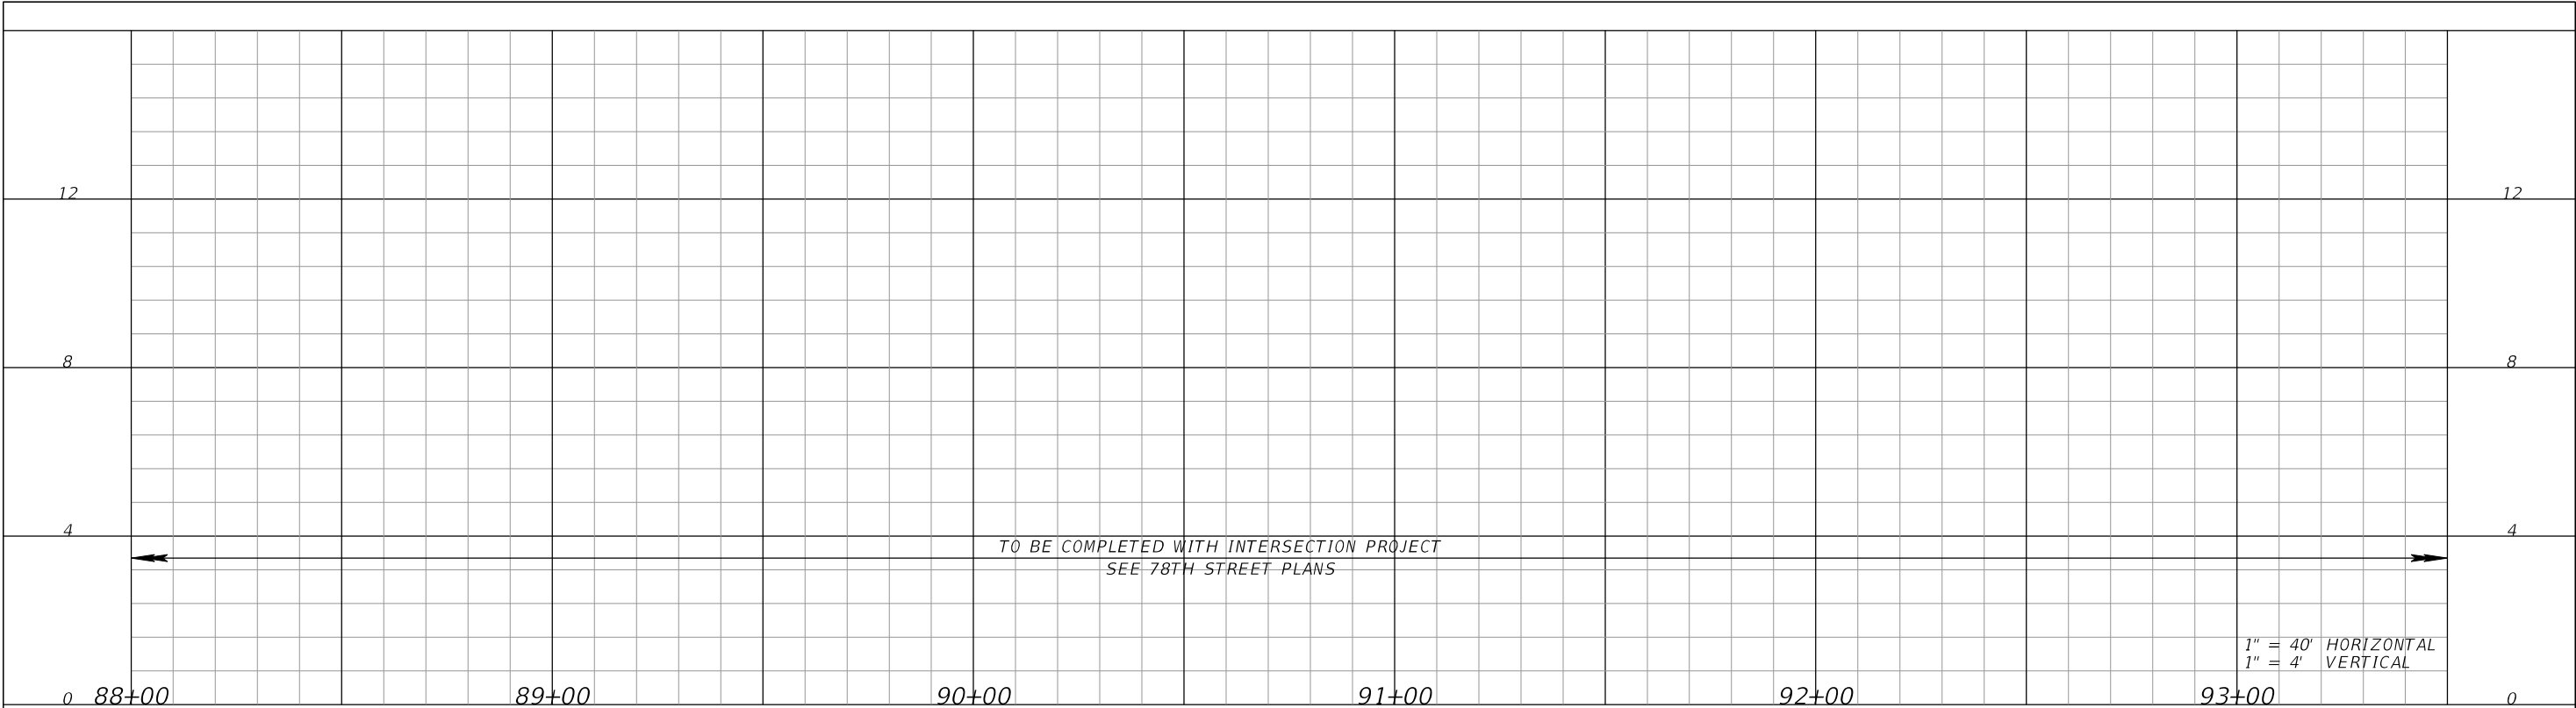BOSW LEFT

⌘ SURVEY 9TH AVENUE NW

BOSW RIGHT

⌘ SURVEY 9TH AVENUE NW



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9TH AVENUE NW

FL DATE:

LICENSED PROFESSIONAL


JORDAN E. LEEP, P.E.  
FL LICENSE NUMBER 76102

BOSW PROFILES (12)

SHEET NUMBER


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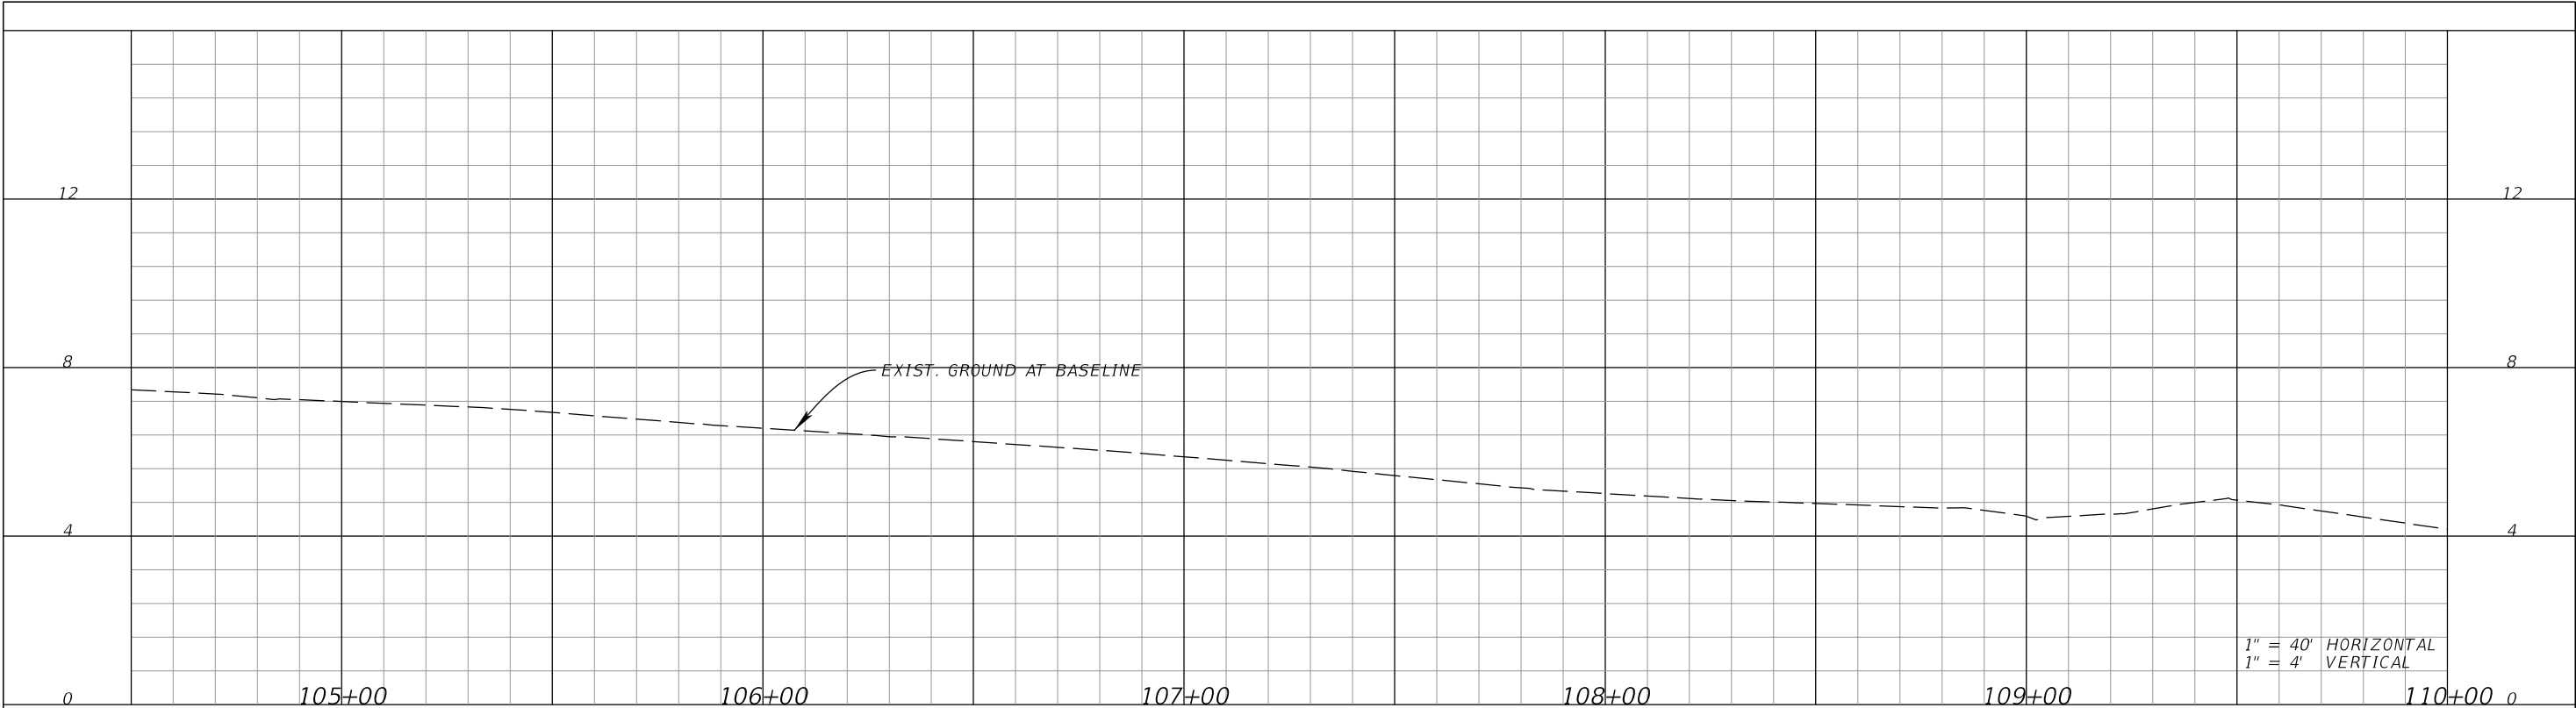
BOSW LEFT SURVEY 9TH AVENUE NW

BOSW RIGHT SURVEY 9TH AVENUE NW

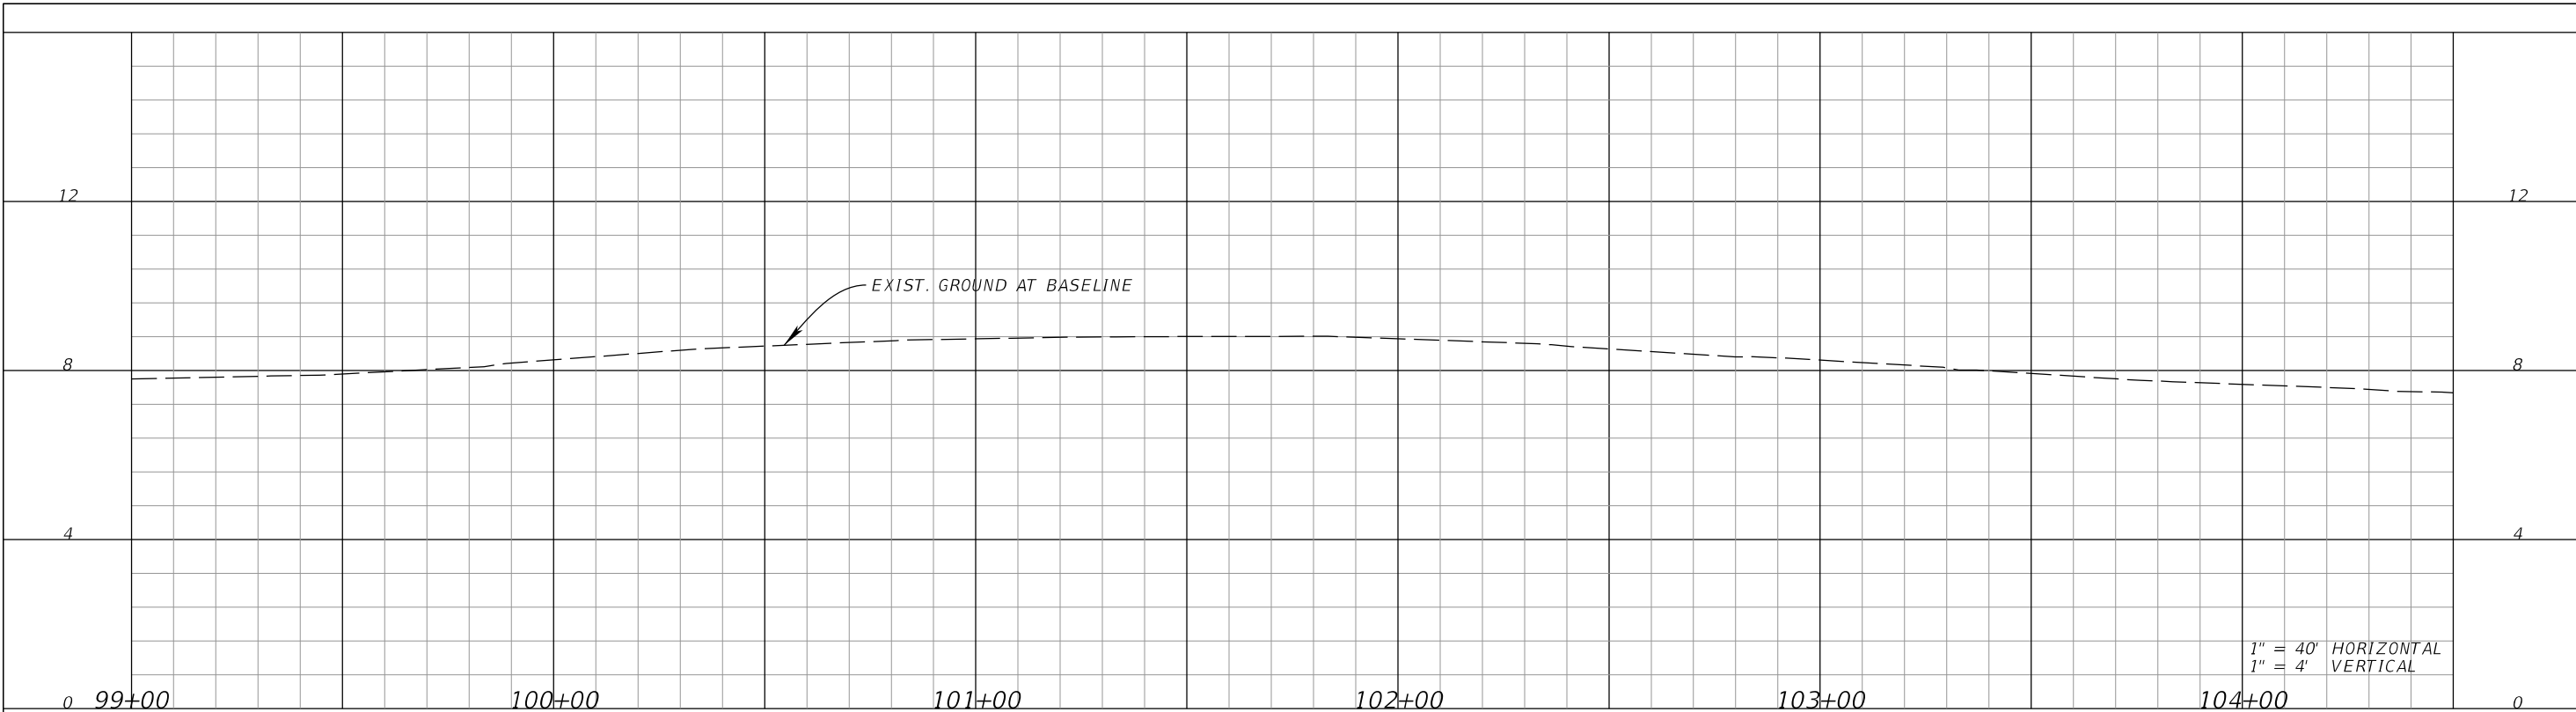

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No.	REVISIONS	DATE	BY				


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⌘ SURVEY 9TH AVENUE NW

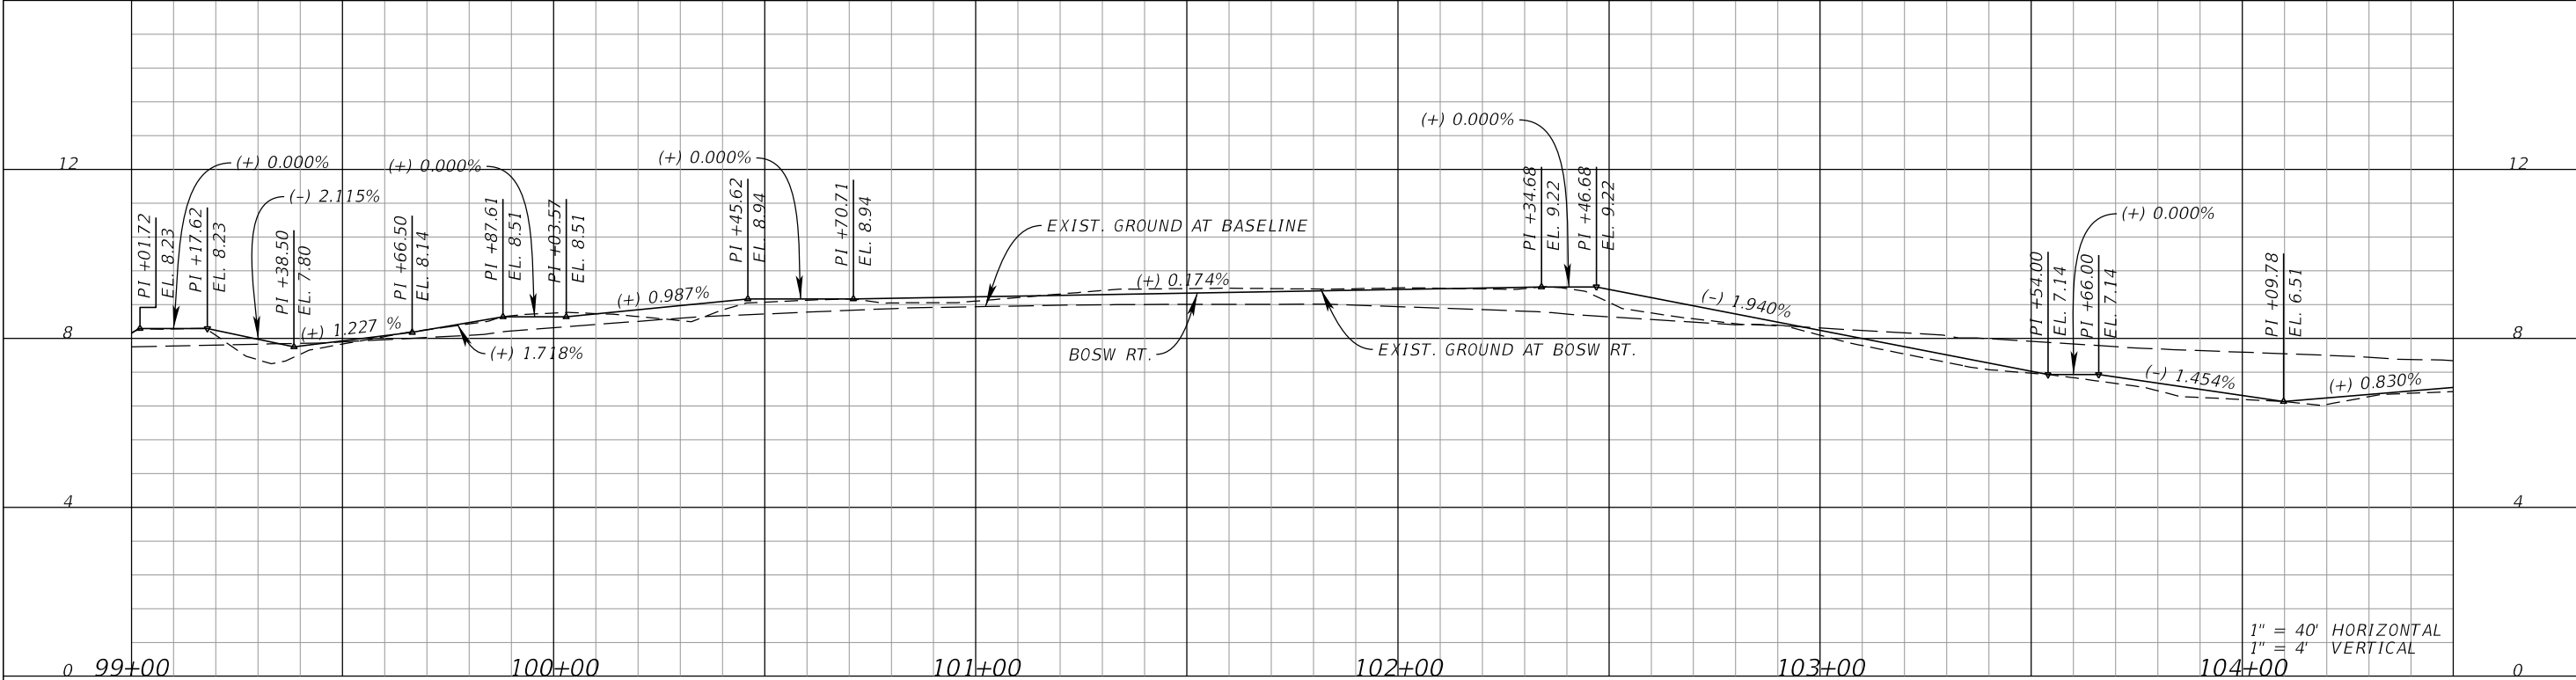BOSW RIGHT ⌘ SURVEY 9TH AVENUE NW



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9TH AVENUE NW

MANATEE COUNTY

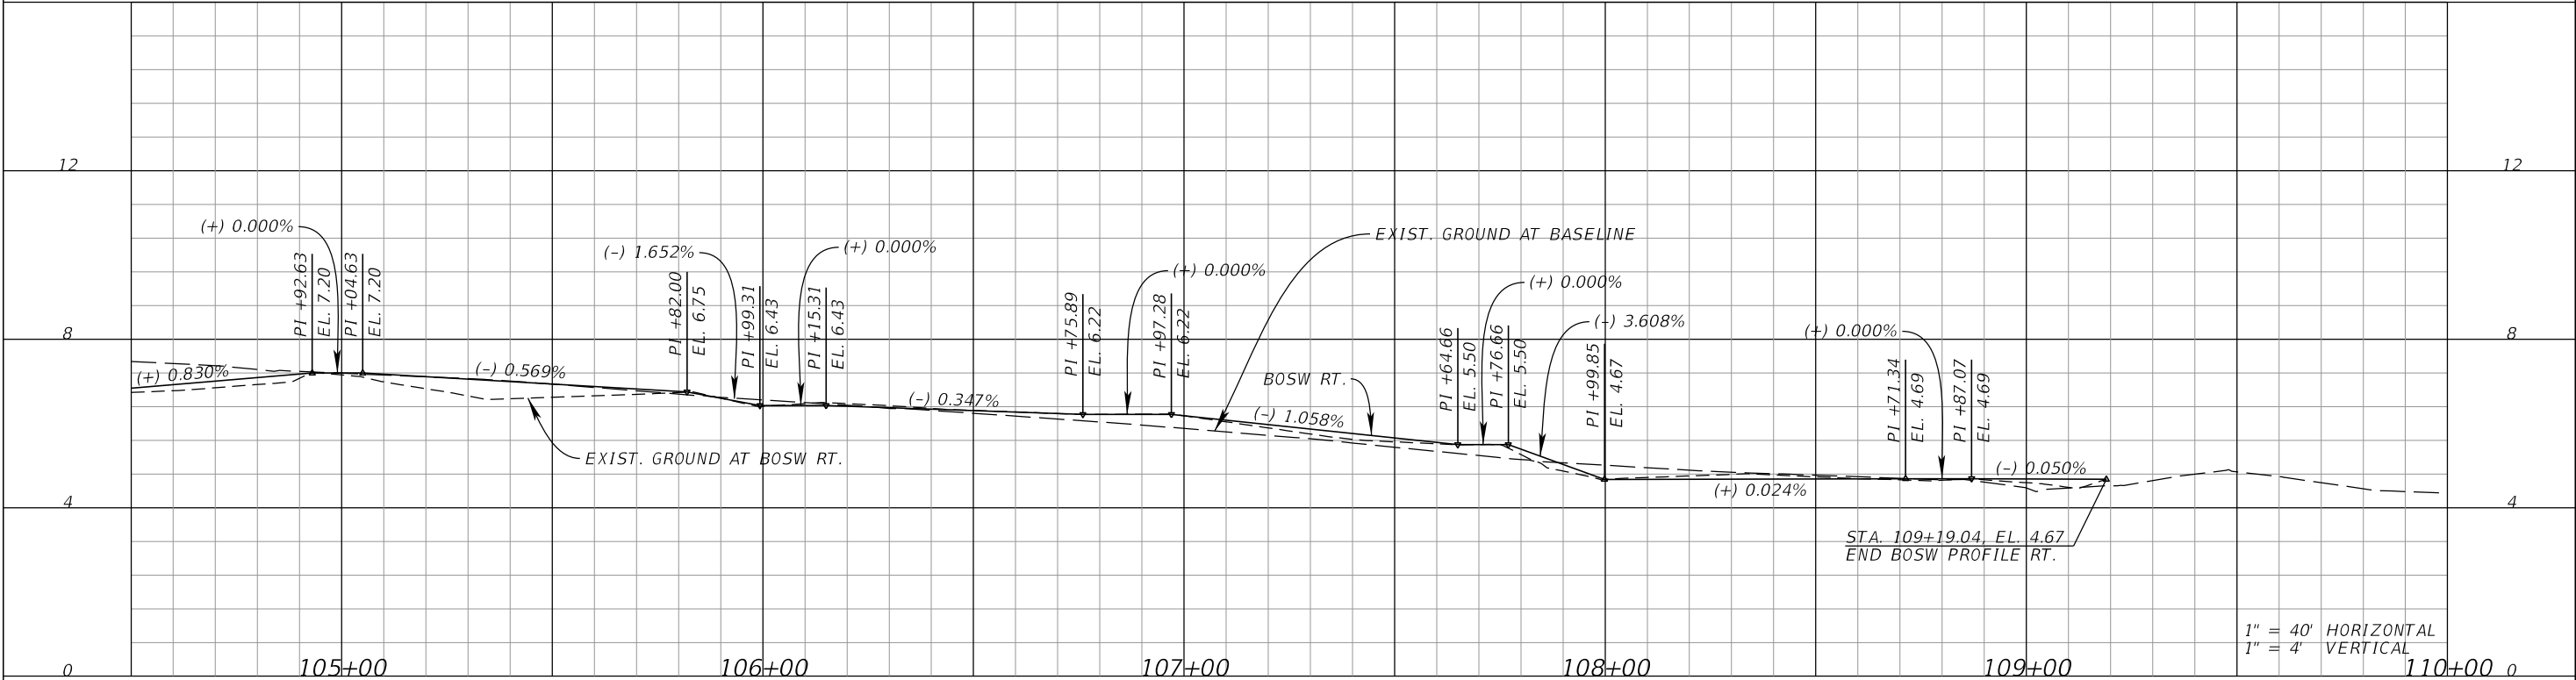FL

LICENSED PROFESSIONAL

JORDAN E. LEEP, P.E.  
FL LICENSE NUMBER 76102


BOSW PROFILES (14)

68

SHEET NUMBER

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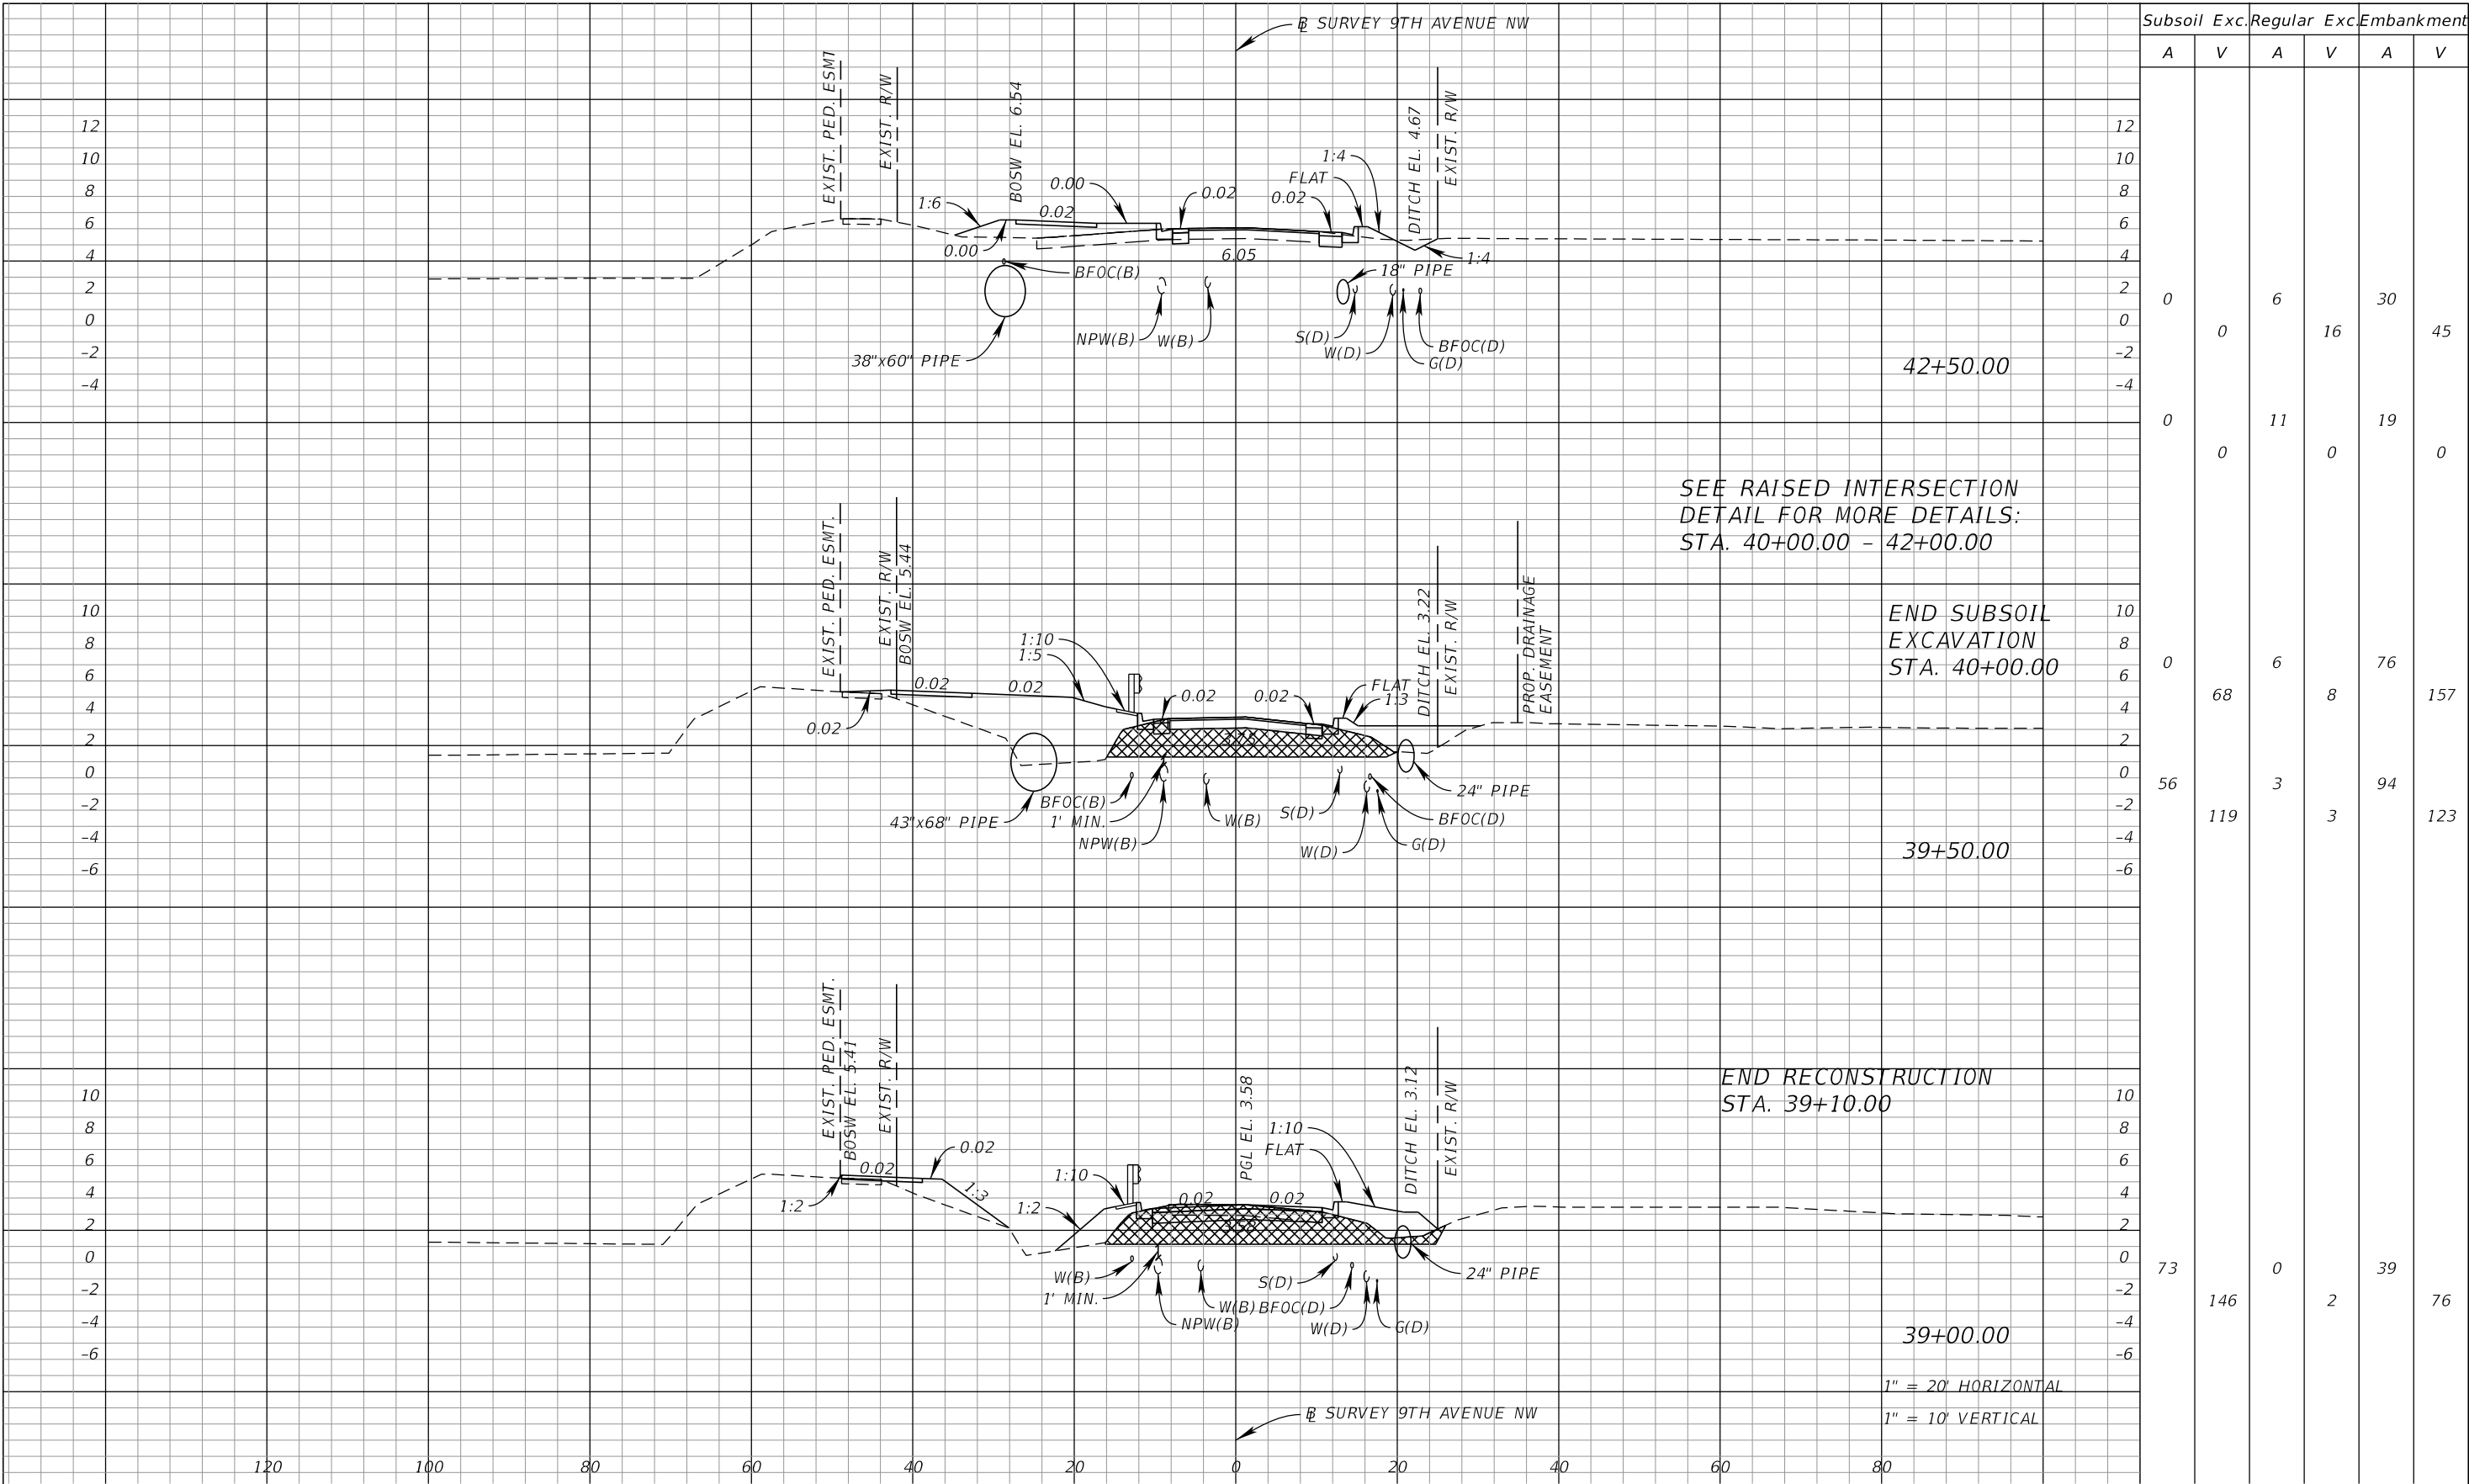
				<div><div><div>Kimley»Horn</div><div>© 2025 KIMLEY-HORN AND ASSOCIATES, INC. 1800 SECOND STREET, SUITE 900, SARASOTA, FL 34236 PHONE: 941-379-7600 WWW.KIMLEY-HORN.COM</div></div></div>	<div><div>KHA PROJECT 148400070 DATE 10/02/2025</div><div>SCALE AS SHOWN</div><div>DESIGNED BY JNR</div><div>DRAWN BY JRW</div><div>CHECKED BY JEL</div></div>	<div><div><div><div><div><div></div><div>Manatee County Florida</div></div></div><div>9TH AVENUE NW</div></div></div><div>MANATEE COUNTY</div></div>	<div>LICENSED PROFESSIONAL</div> <div><div>JORDAN E. LEEP, P.E.</div><div>FL LICENSE NUMBER 76102</div></div>	<div><div>9TH AVENUE NW CROSS SECTIONS</div></div>	SHEET NUMBER	
										69
No.	REVISIONS	DATE	BY						FL DATE:	

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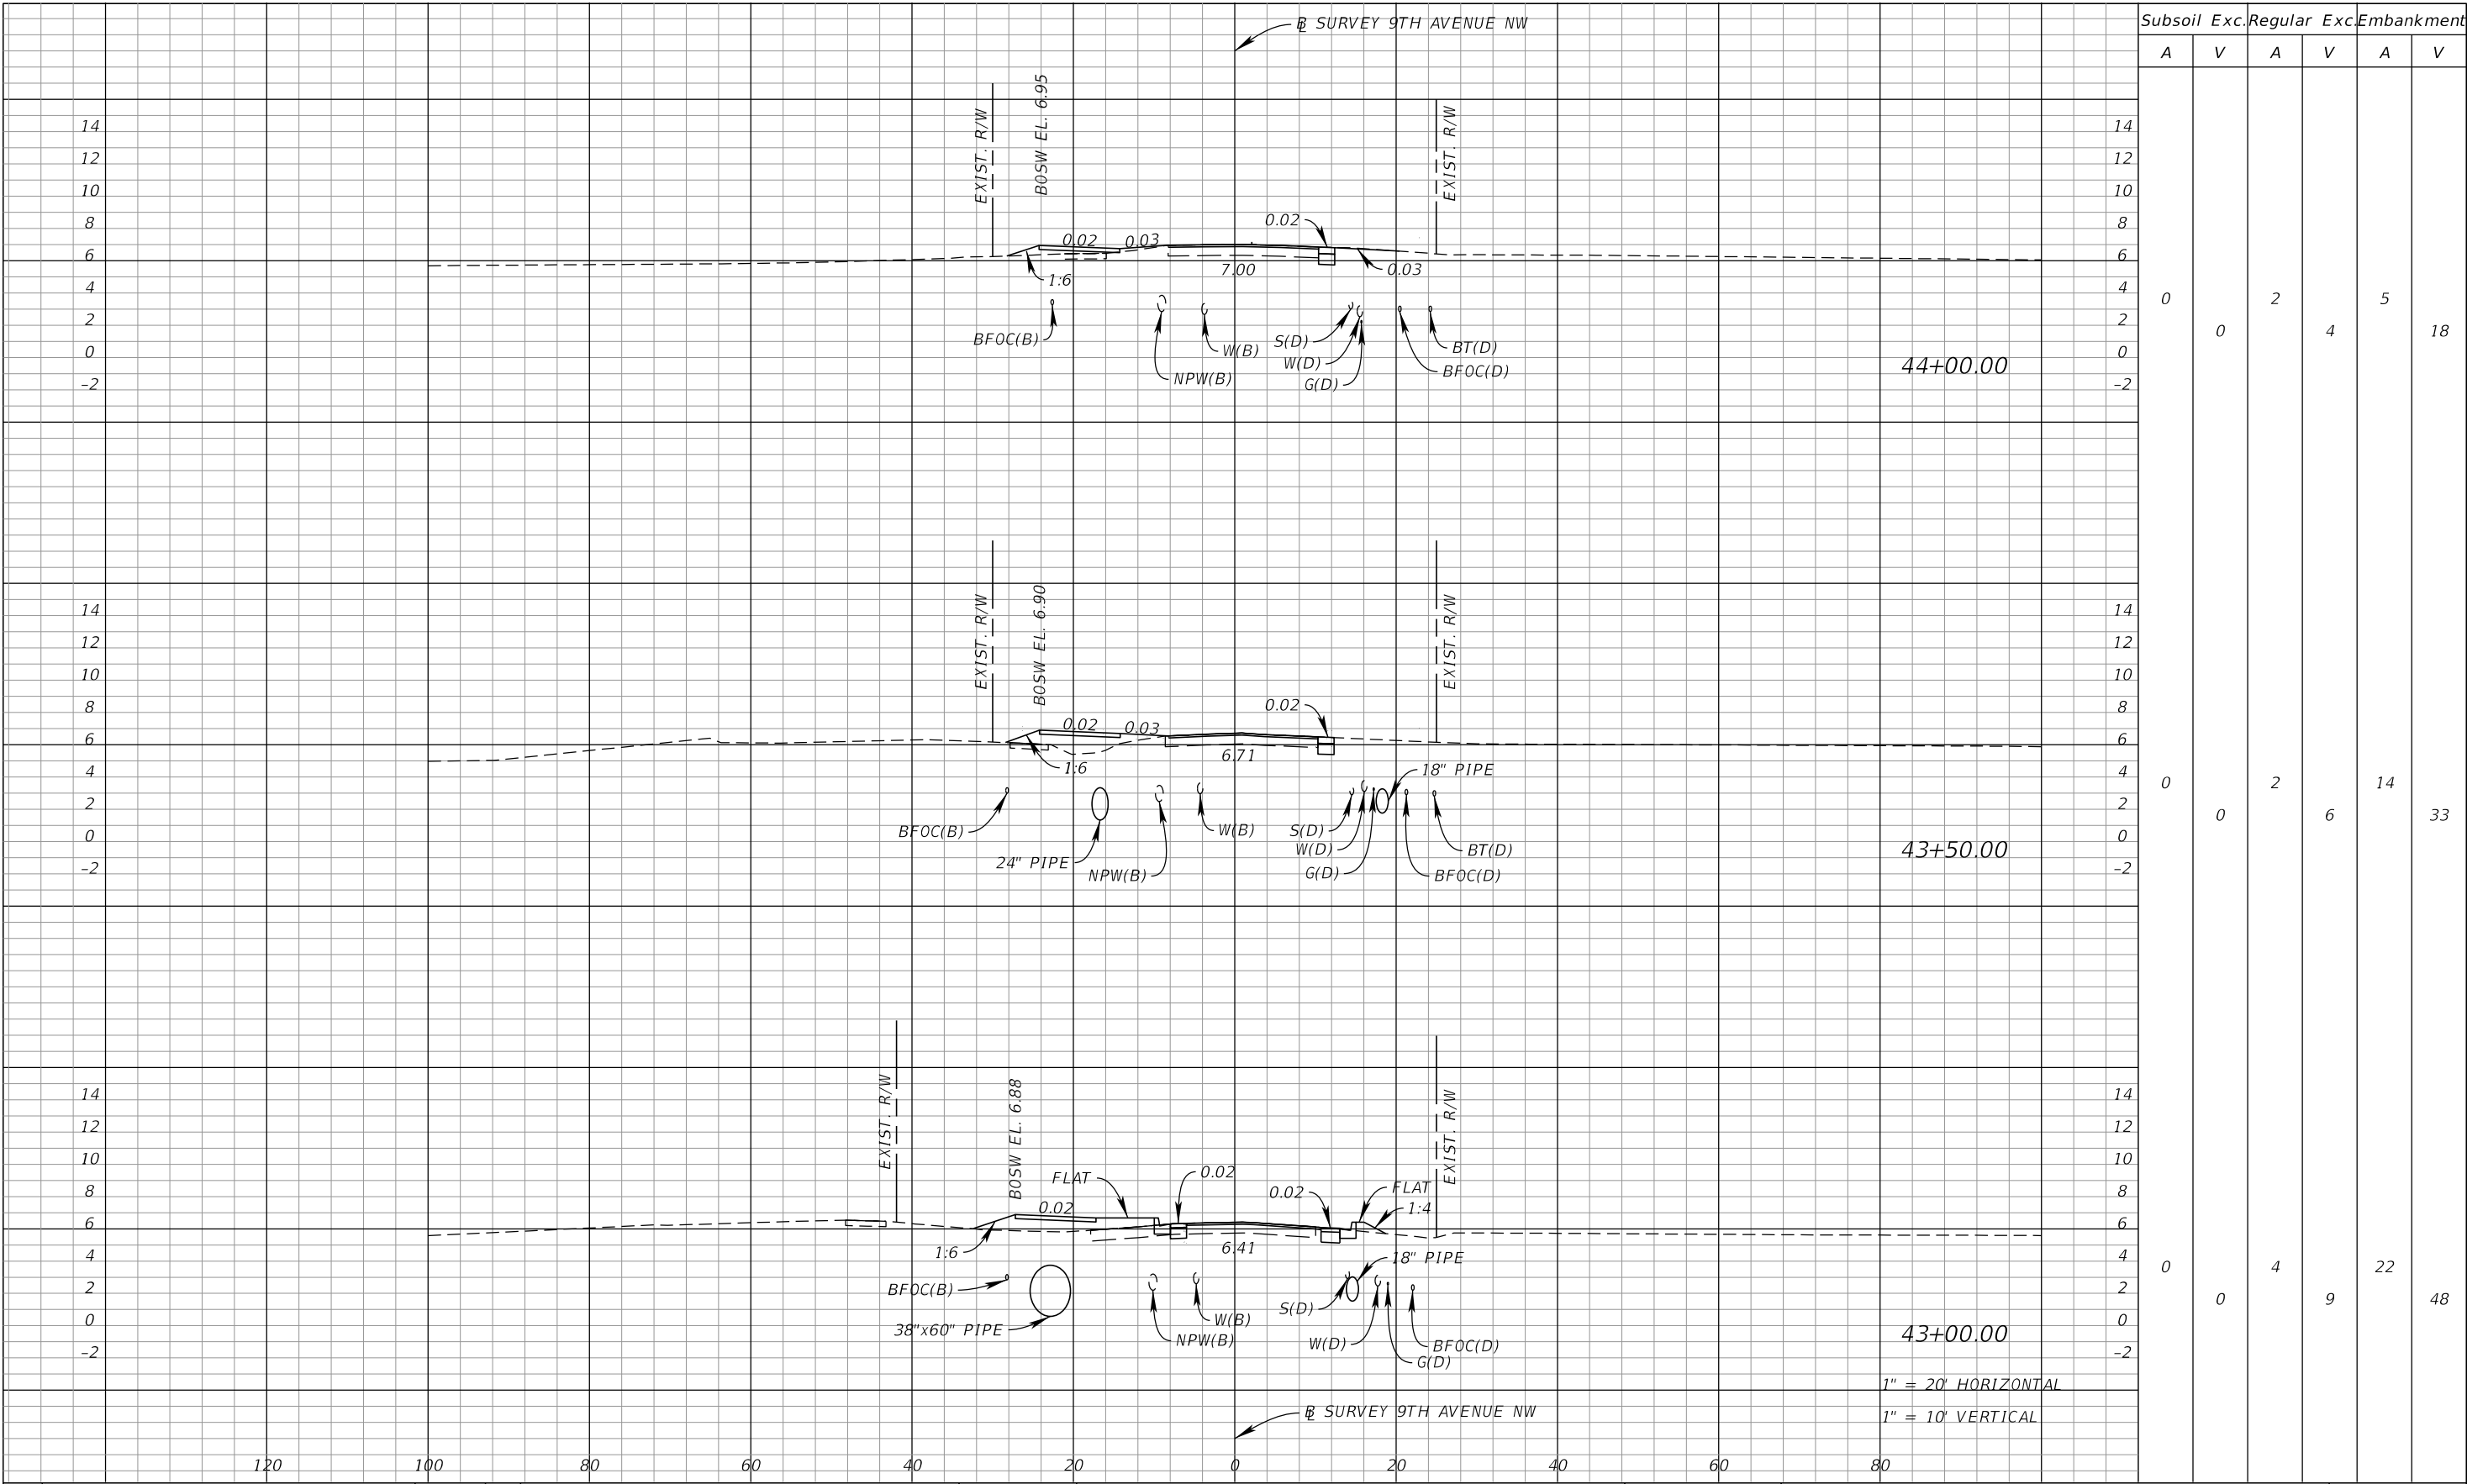


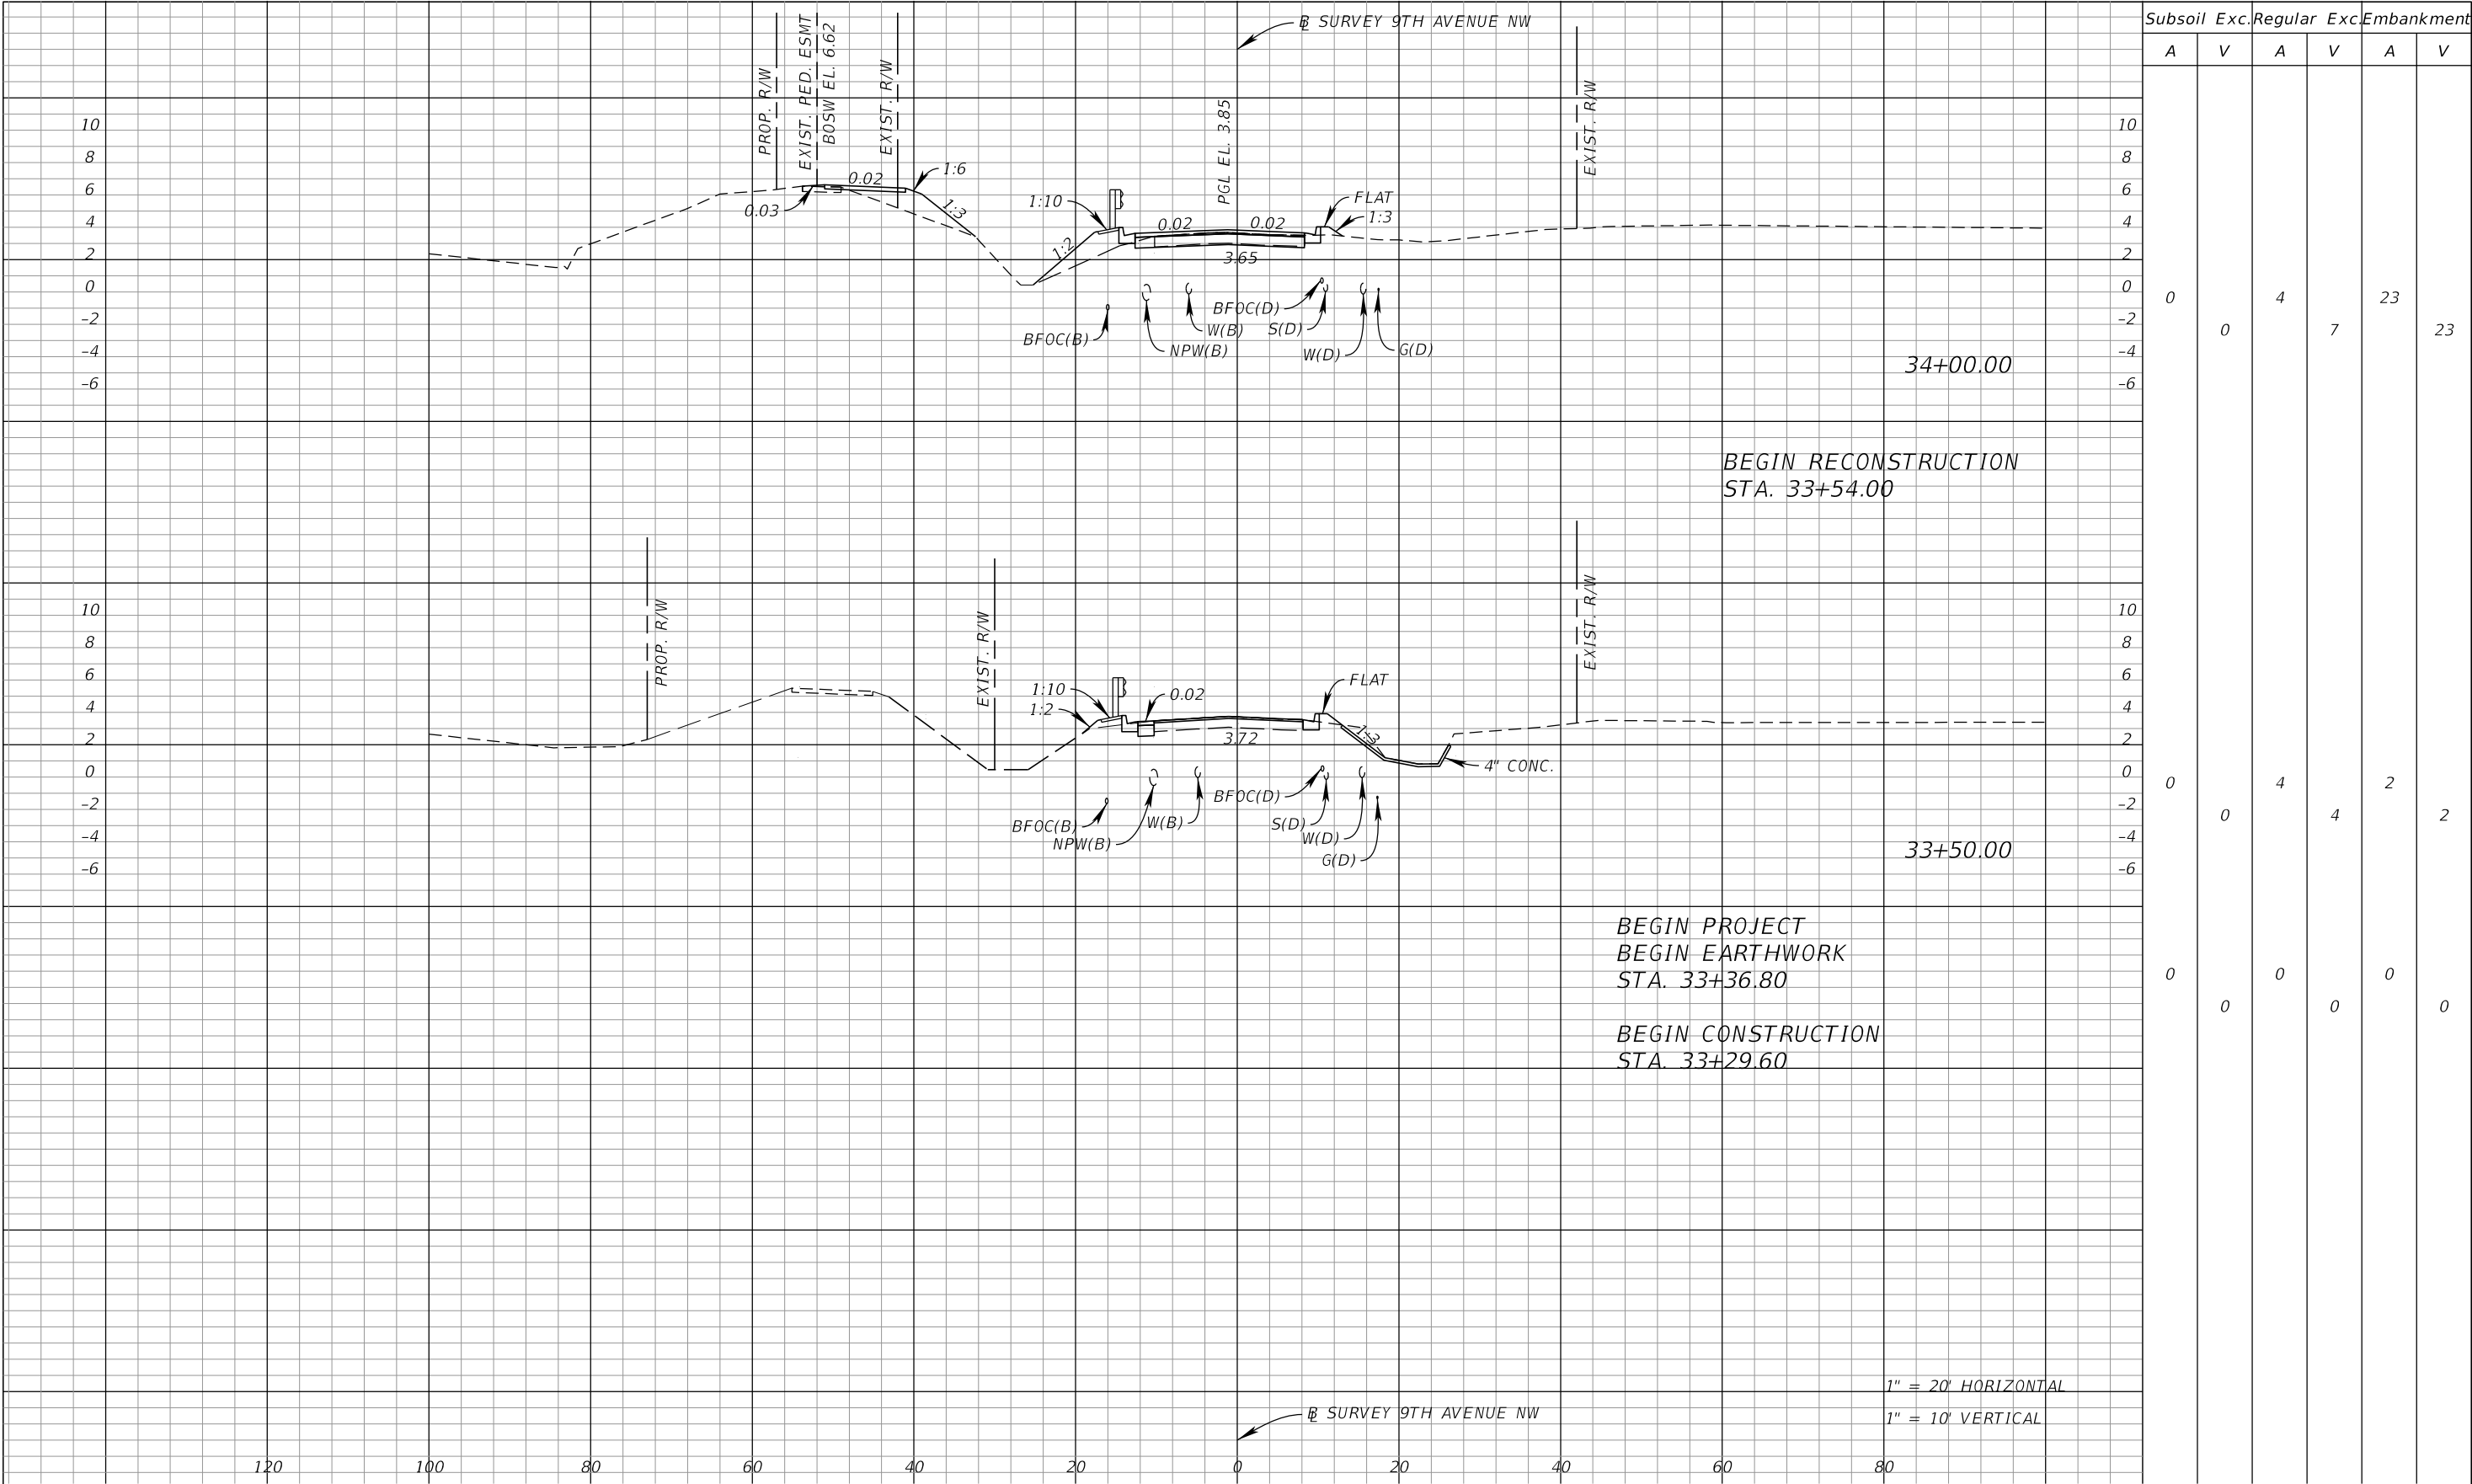





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No.	REVISIONS	DATE	BY						




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			<div>DATE 10/02/2025</div>		<div>JORDAN E. LEEP, P.E.</div>				
			<div>SCALE AS SHOWN</div>		<div>FL LICENSE NUMBER 76102</div>				
			<div>DESIGNED BY JNR</div>						
			<div>DRAWN BY JRW</div>						
			<div>CHECKED BY JEL</div>						
No.	REVISIONS	DATE	BY		MANATEE COUNTY	FL	DATE:		

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			<div>DATE 10/02/2025</div>						
			<div>SCALE AS SHOWN</div>						
			<div>DESIGNED BY JNR</div>						
			<div>DRAWN BY JRW</div>						
			<div>CHECKED BY JEL</div>						
No.	REVISIONS	DATE	BY				FL		DATE:


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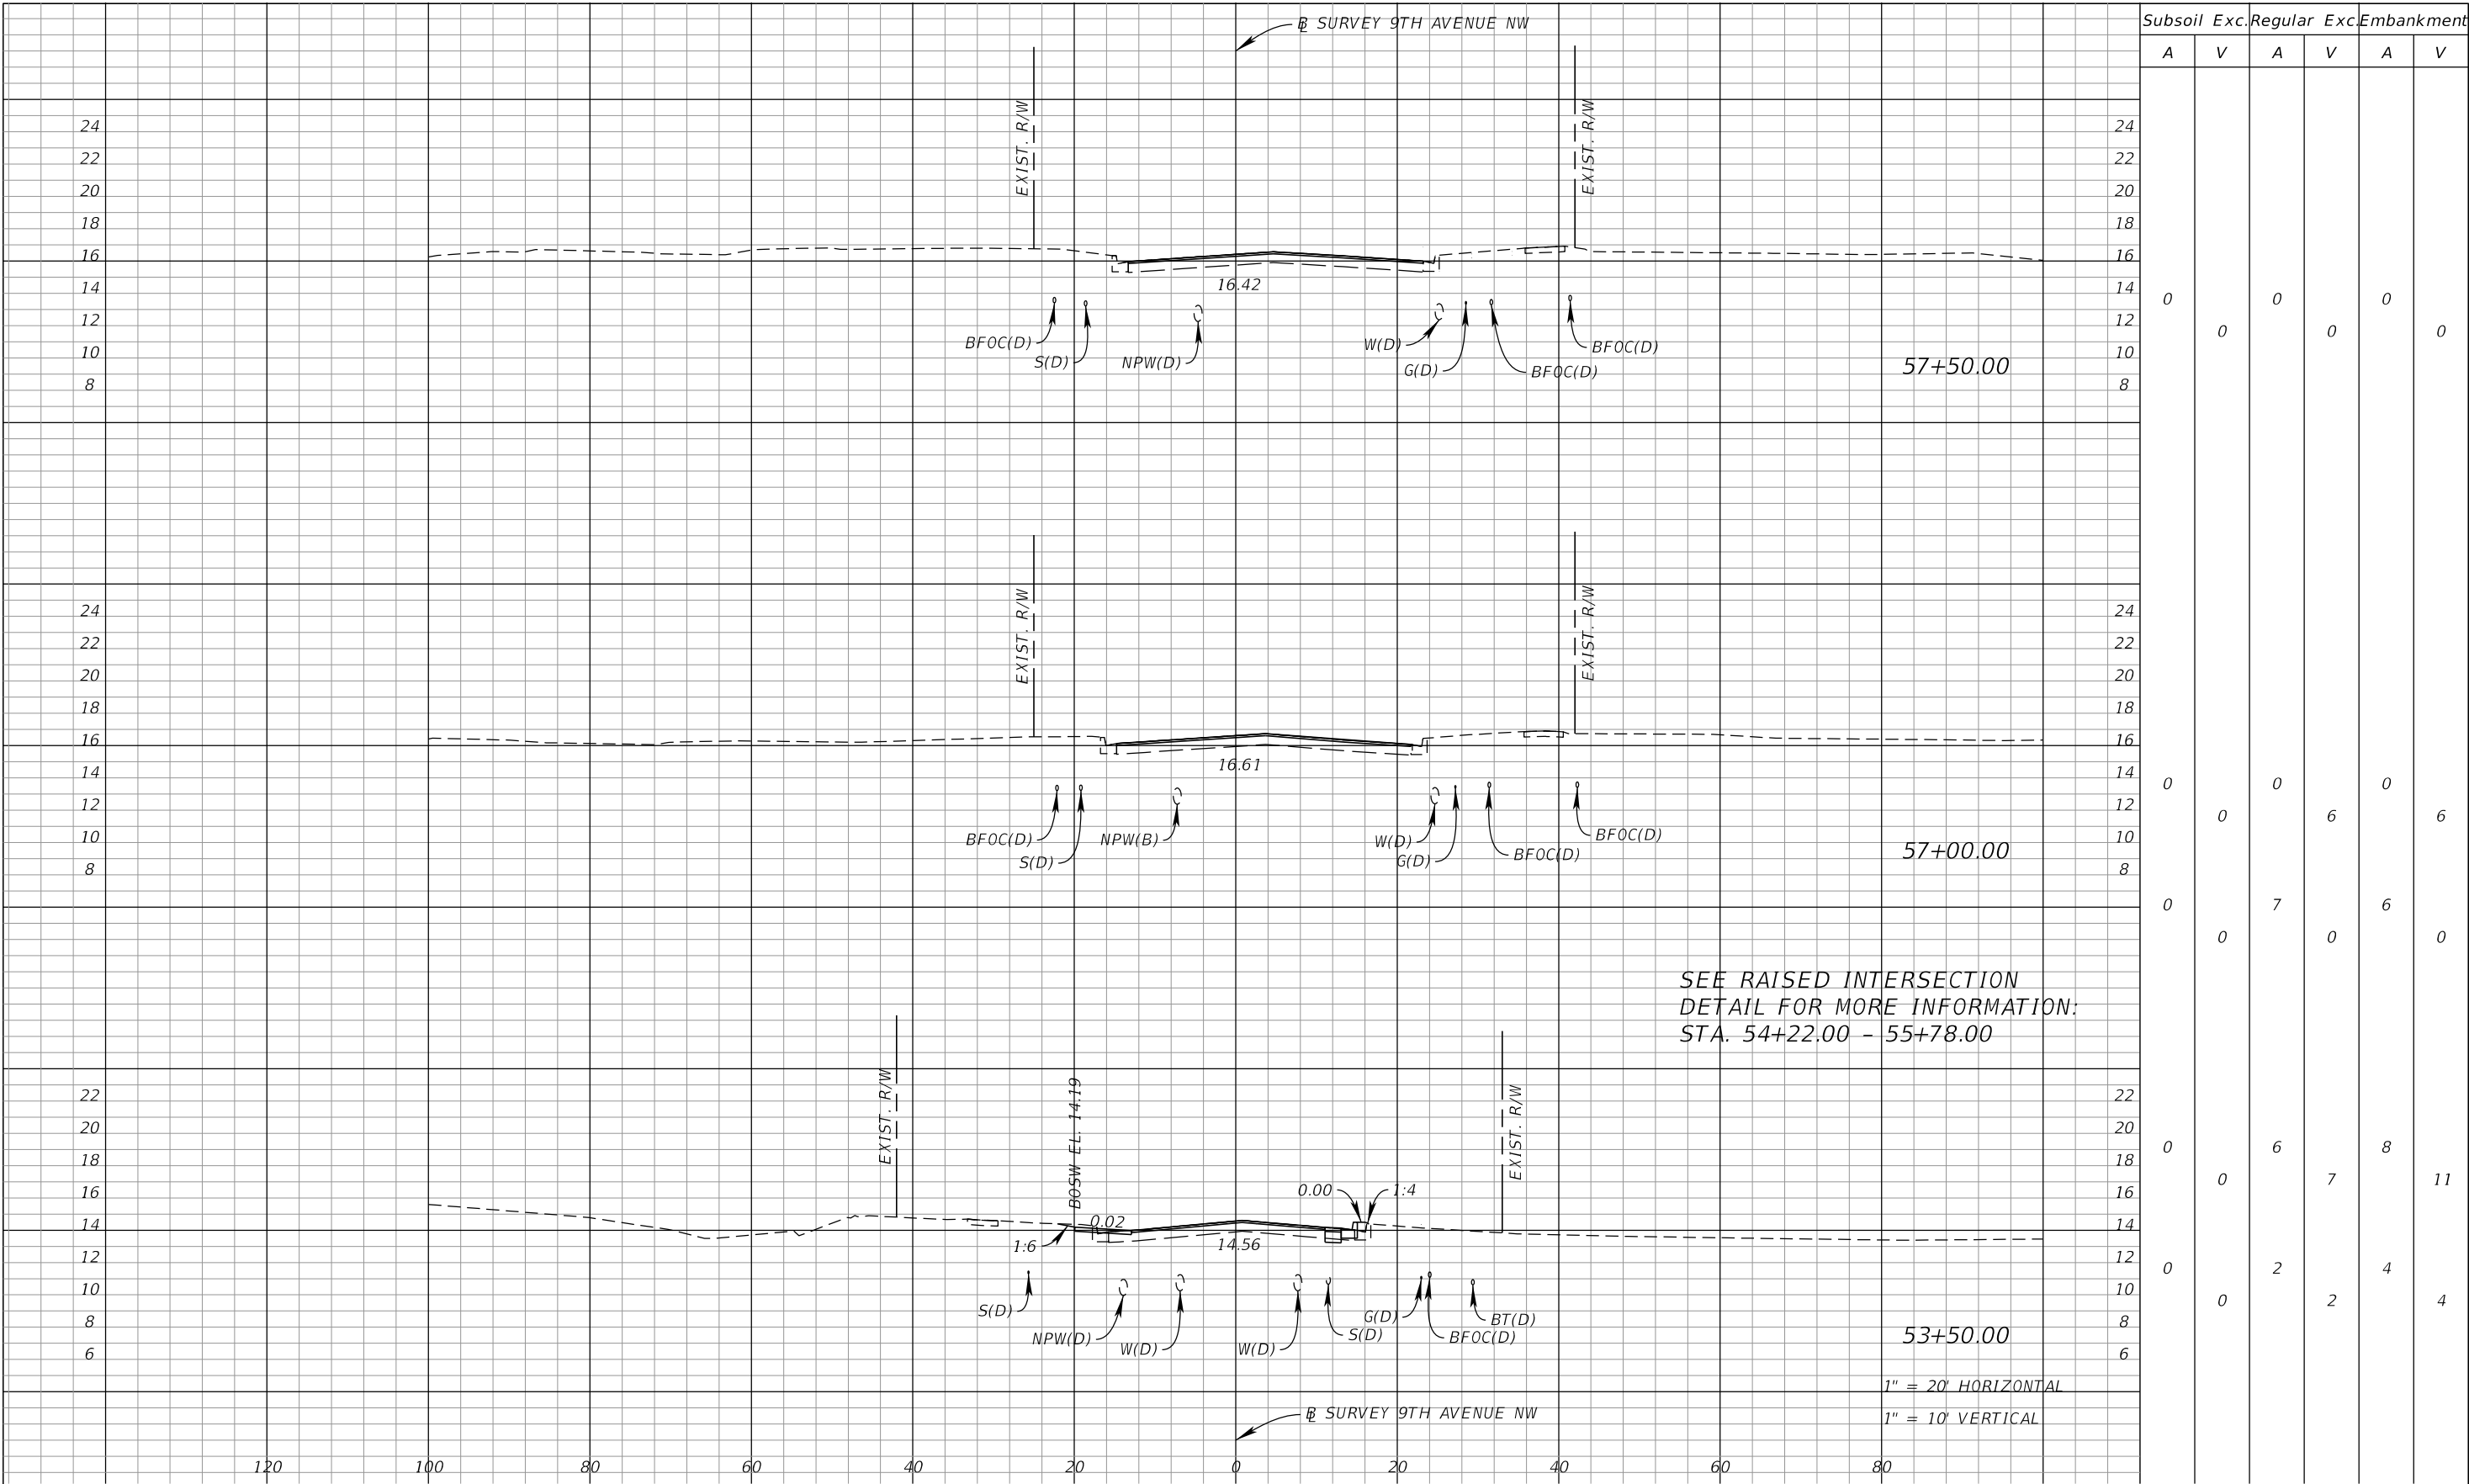




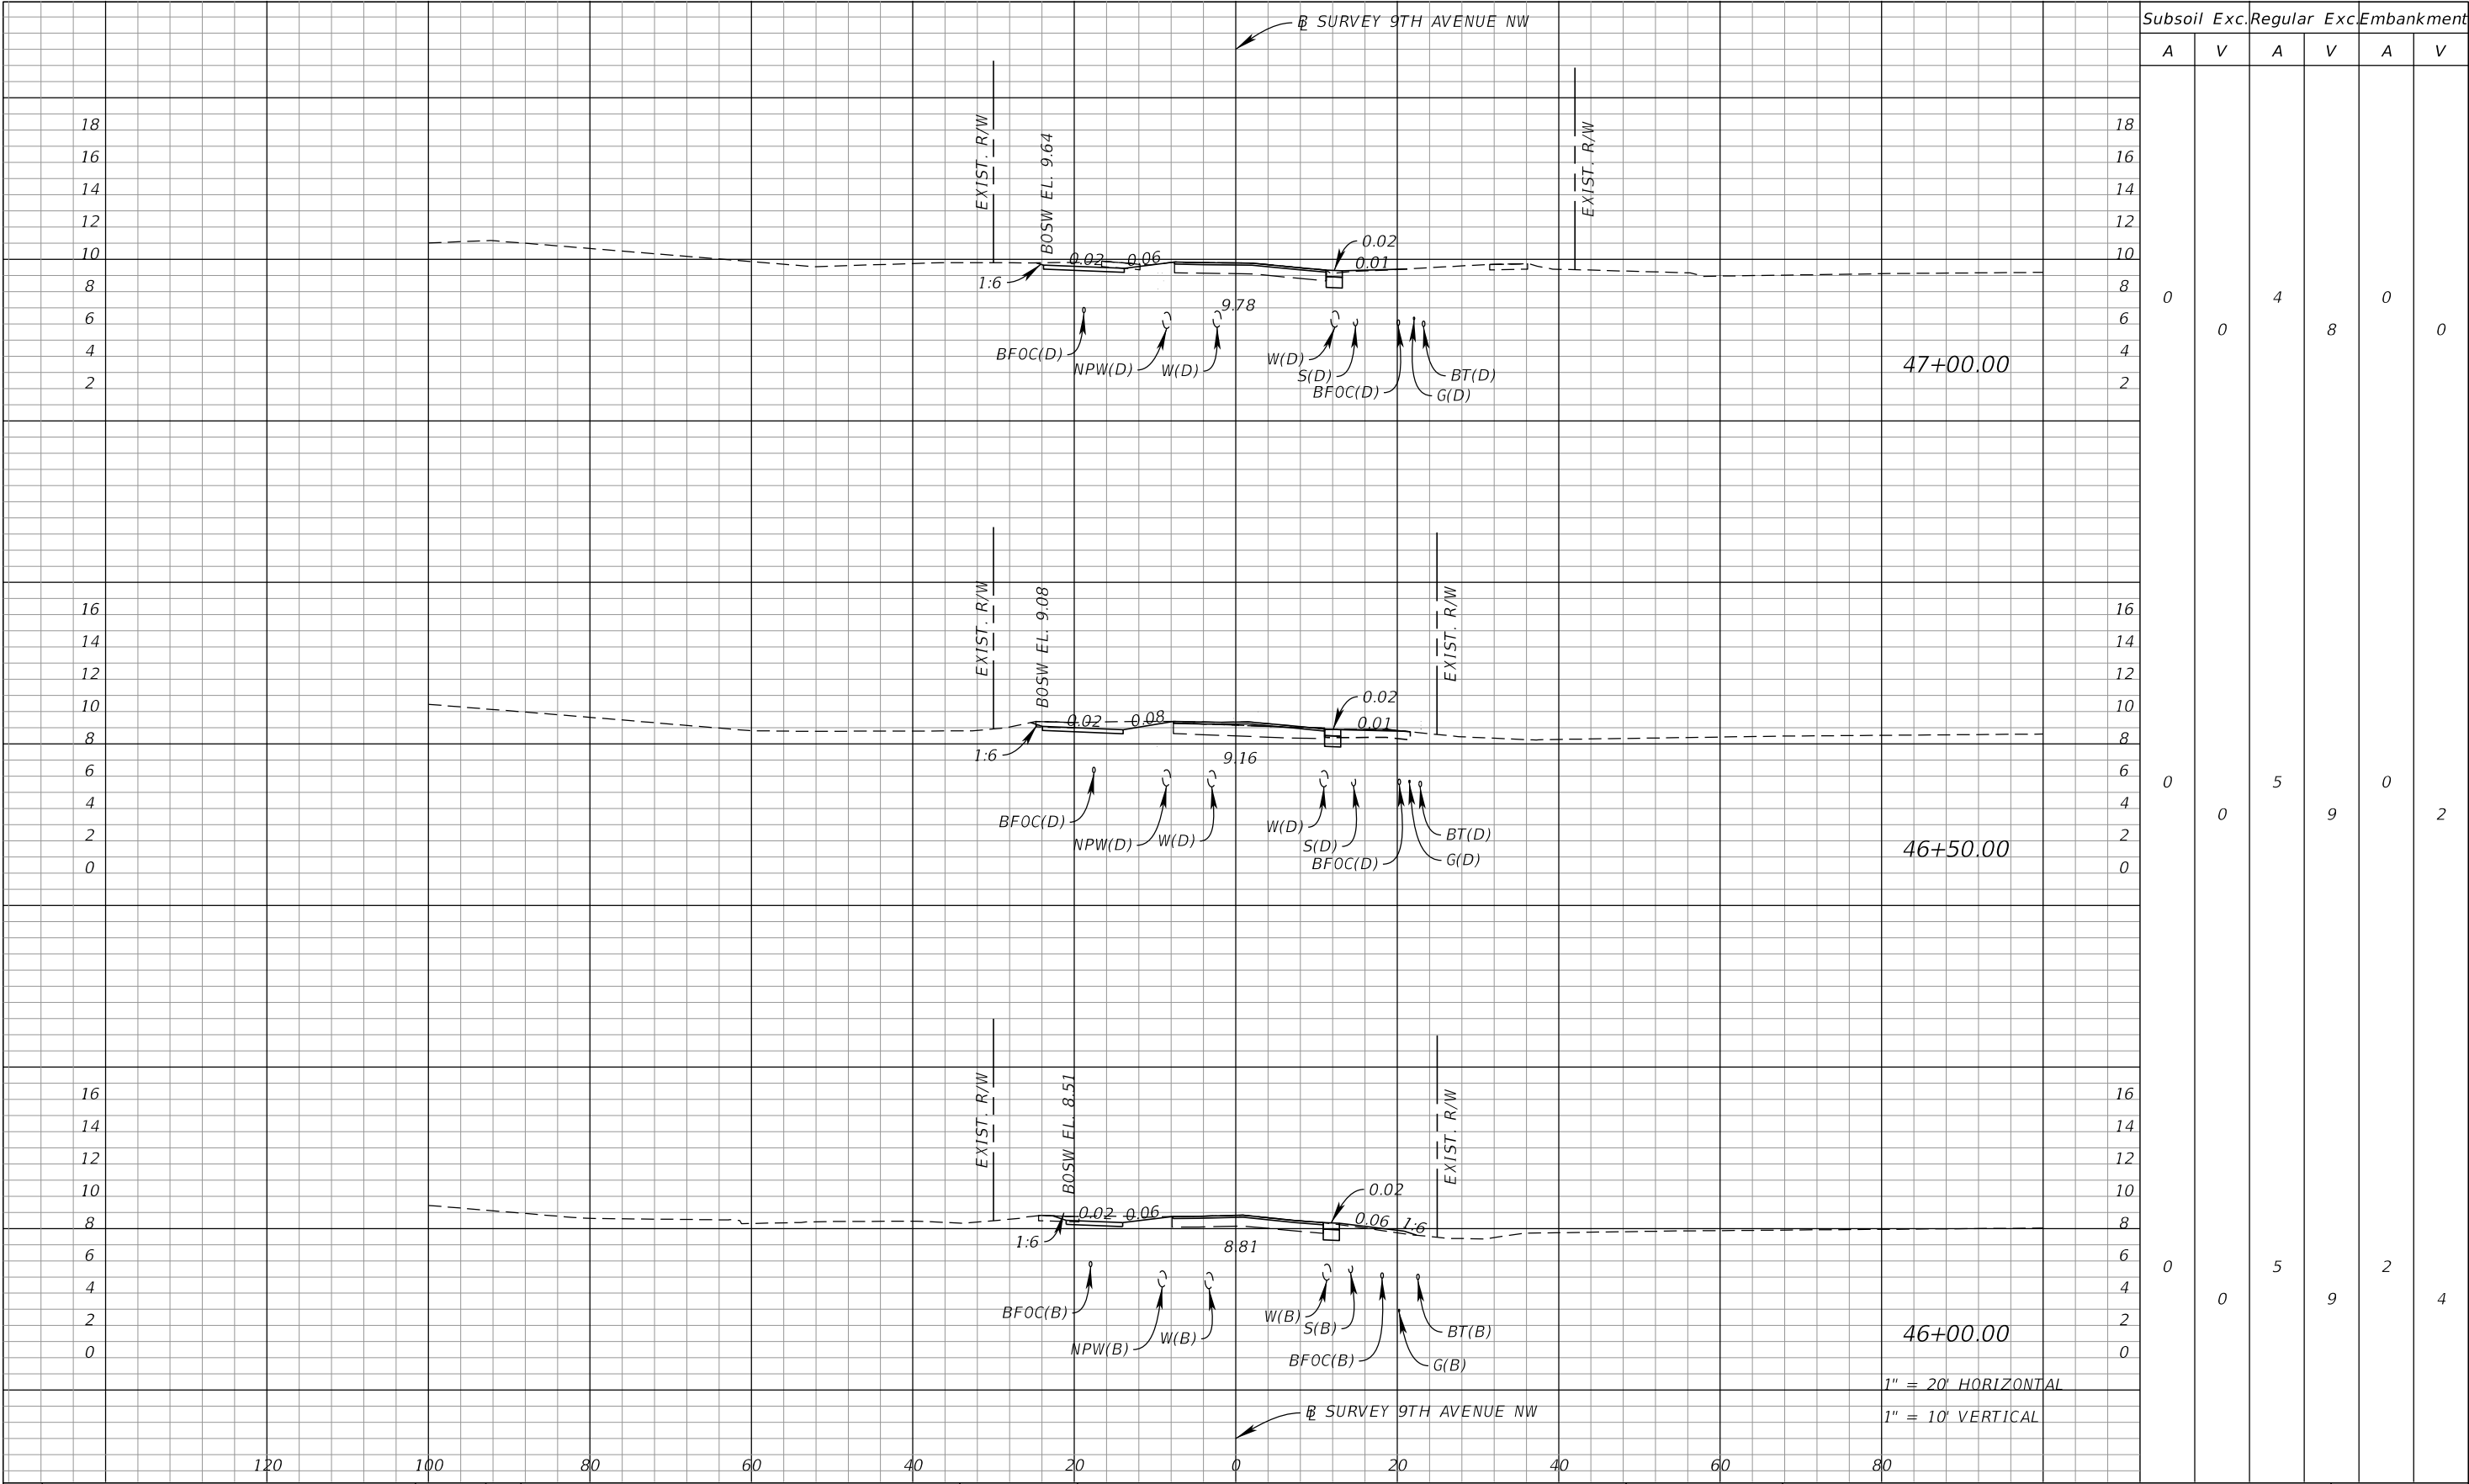




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				<div><div><div>Kimley»Horn</div><div>© 2025 KIMLEY-HORN AND ASSOCIATES, INC. 1800 SECOND STREET, SUITE 900, SARASOTA, FL 34236 PHONE: 941-379-7600 WWW.KIMLEY-HORN.COM</div></div></div>	<div><div>KHA PROJECT 148400070</div><div>DATE 10/02/2025</div><div>SCALE AS SHOWN</div><div>DESIGNED BY JNR</div><div>DRAWN BY JRW</div><div>CHECKED BY JEL</div></div>	<div><div><div><div><div><div>Manatee County</div><div>FLORIDA</div></div></div><div>9TH AVENUE NW</div></div></div></div>	<div><div>LICENSED PROFESSIONAL</div><div>JORDAN E. LEEP, P.E.</div><div>FL LICENSE NUMBER 76102</div></div>	<div><div>9TH AVENUE NW</div><div>CROSS SECTIONS</div></div>	<div><div>SHEET NUMBER</div><div>81</div></div>		
No.	REVISIONS	DATE	BY		MANATEE COUNTY					FL	DATE:
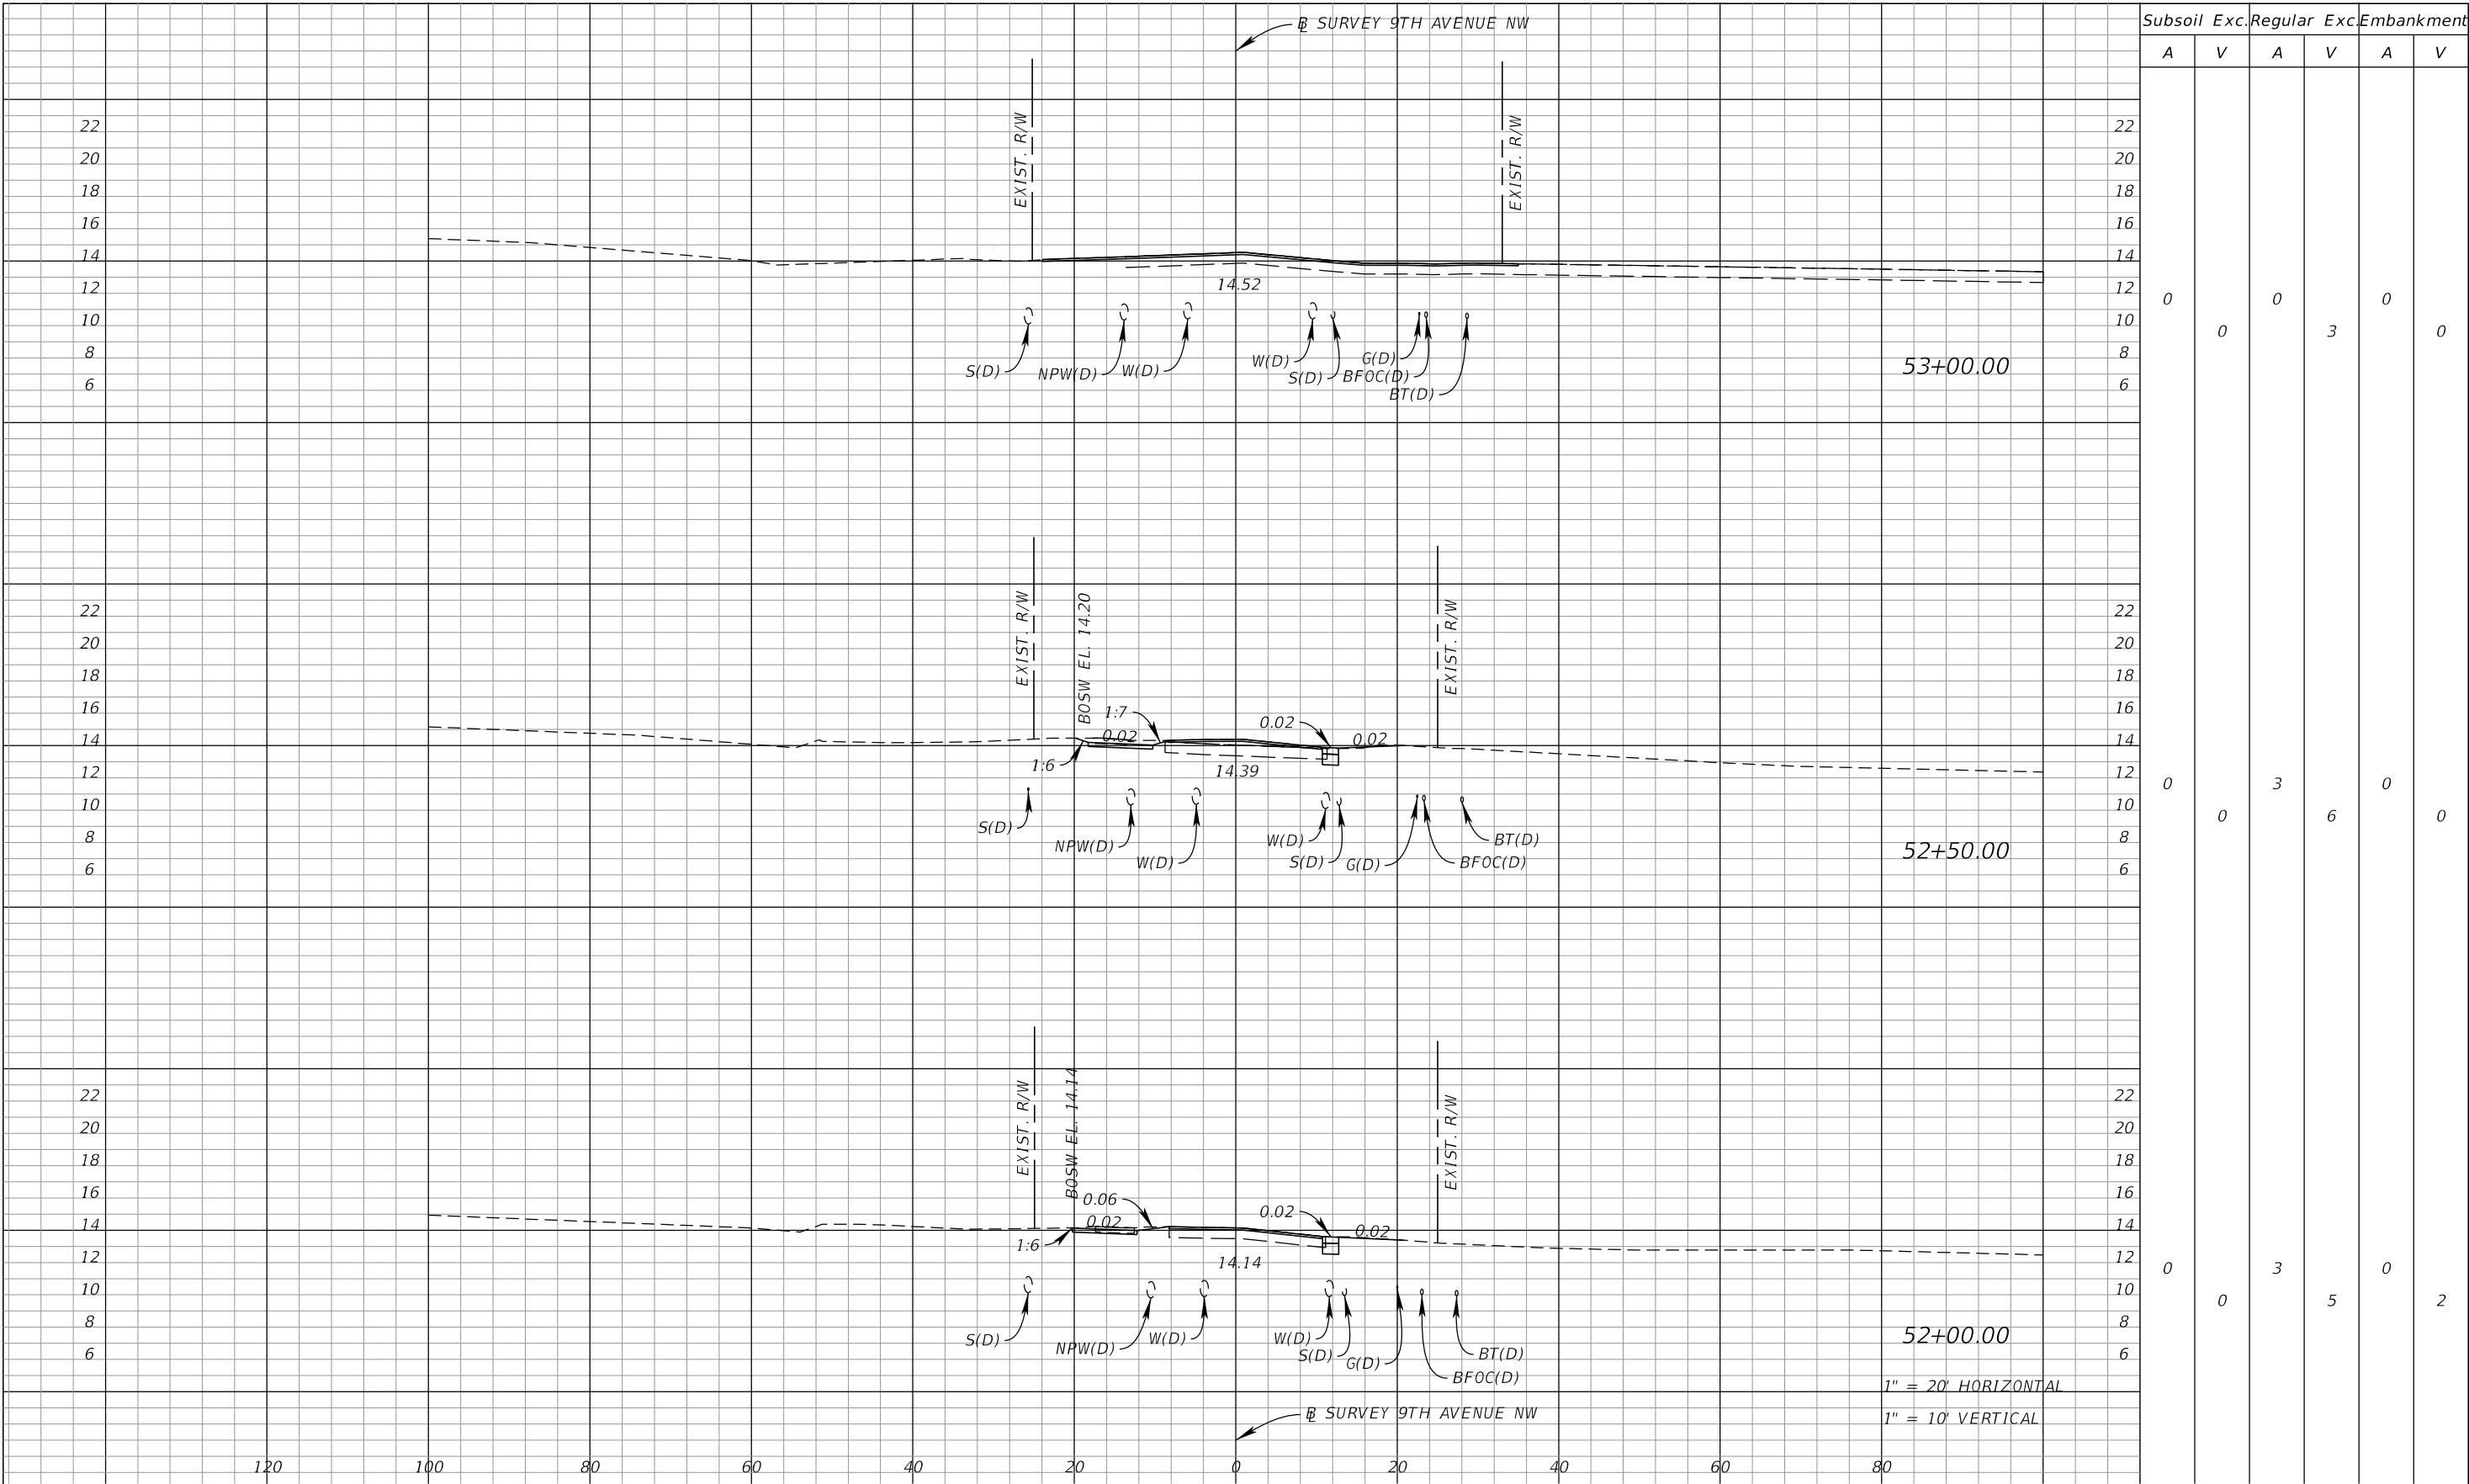
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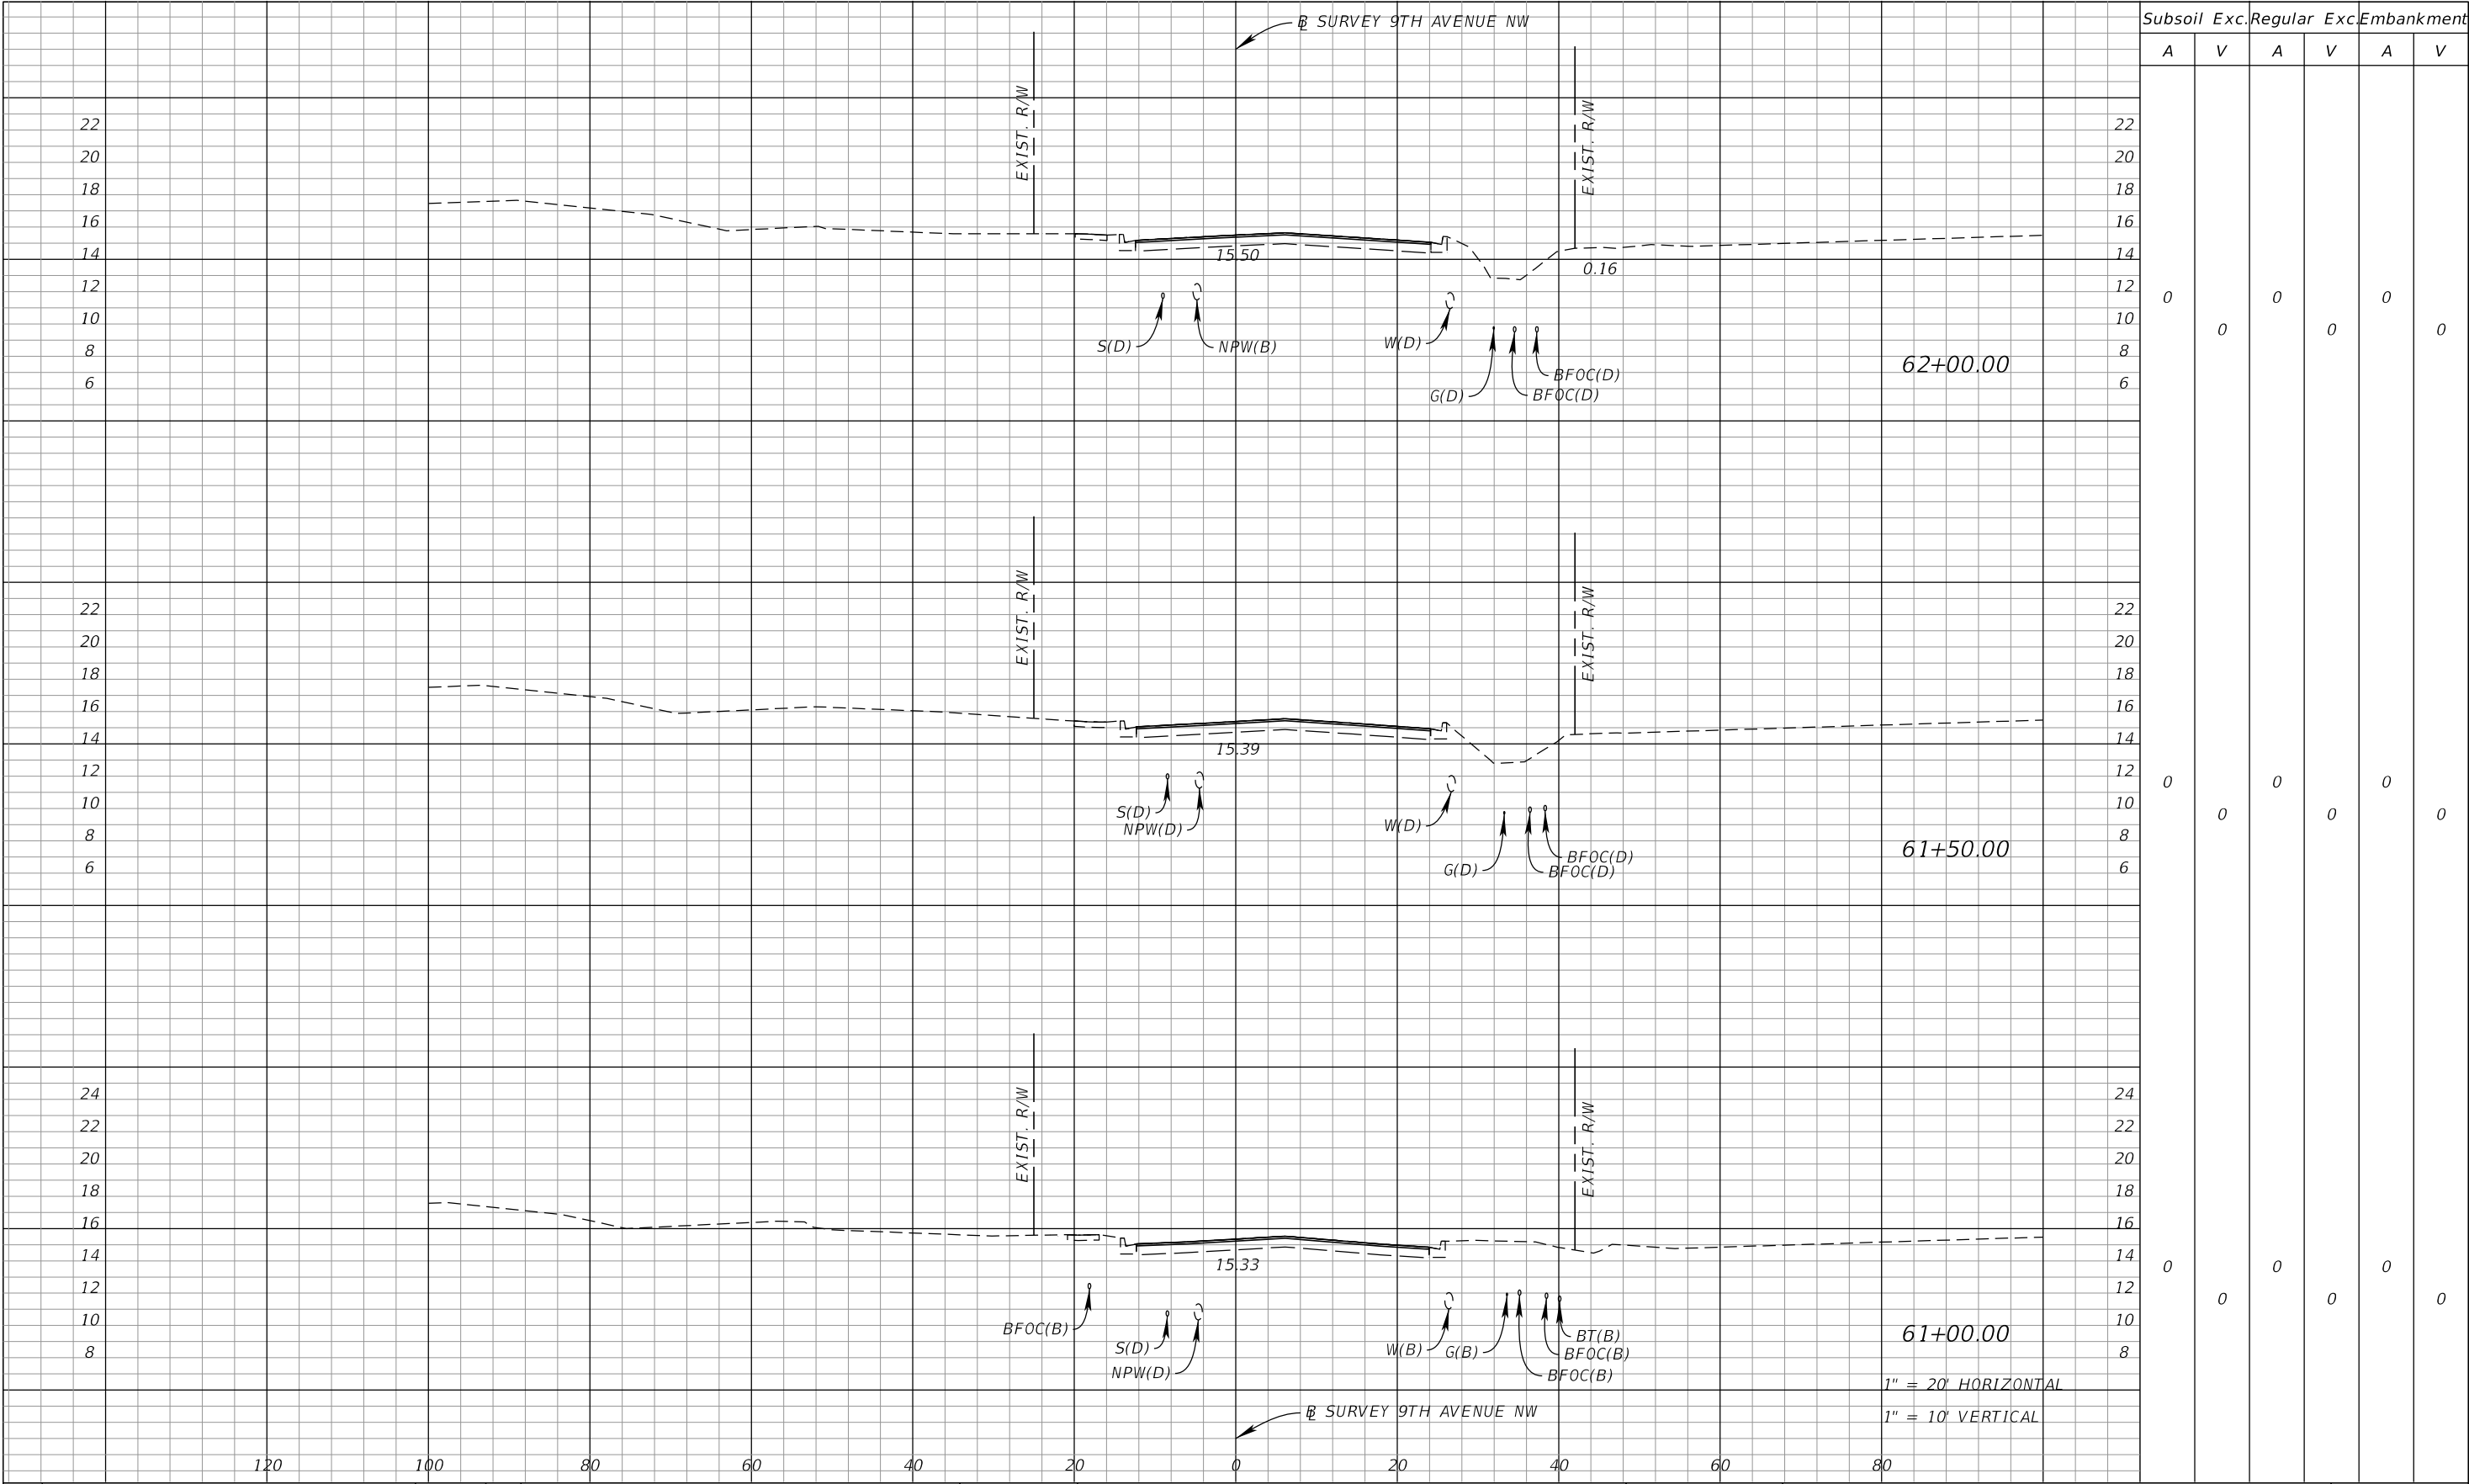


<div><div><div><div></div><div></div><div></div><div></div><div></div><div></div><div></div><div></div><div></div><div></div></div><div>No.</div><div>REVISIONS</div><div>DATE</div><div>BY</div></div><div><div><div><div></div><div></div><div></div><div></div><div></div><div></div><div></div><div></div><div></div><div></div></div><div></div><div></div><div></div><div></div><div></div><div></div><div></div><div></div><div></div><div></div></div><div><div>Kimley»Horn</div><div>© 2025 KIMLEY-HORN AND ASSOCIATES, INC. 1800 SECOND STREET, SUITE 900, SARASOTA, FL 34236 PHONE: 941-379-7600 WWW.KIMLEY-HORN.COM</div></div></div><div><div><div><div>KHA PROJECT 148400070</div><div>DATE 10/02/2025</div><div>SCALE AS SHOWN</div><div>DESIGNED BY JNR</div><div>DRAWN BY JRW</div><div>CHECKED BY JEL</div></div><div><div>Manatee County Florida</div><div>9TH AVENUE NW</div><div>MANATEE COUNTY</div></div></div><div><div>LICENSED PROFESSIONAL</div><div>JORDAN E. LEEP, P.E. FL LICENSE NUMBER 76102</div><div>FL DATE:</div></div><div><div>9TH AVENUE NW CROSS SECTIONS</div><div>SHEET NUMBER 82</div></div></div></div>			
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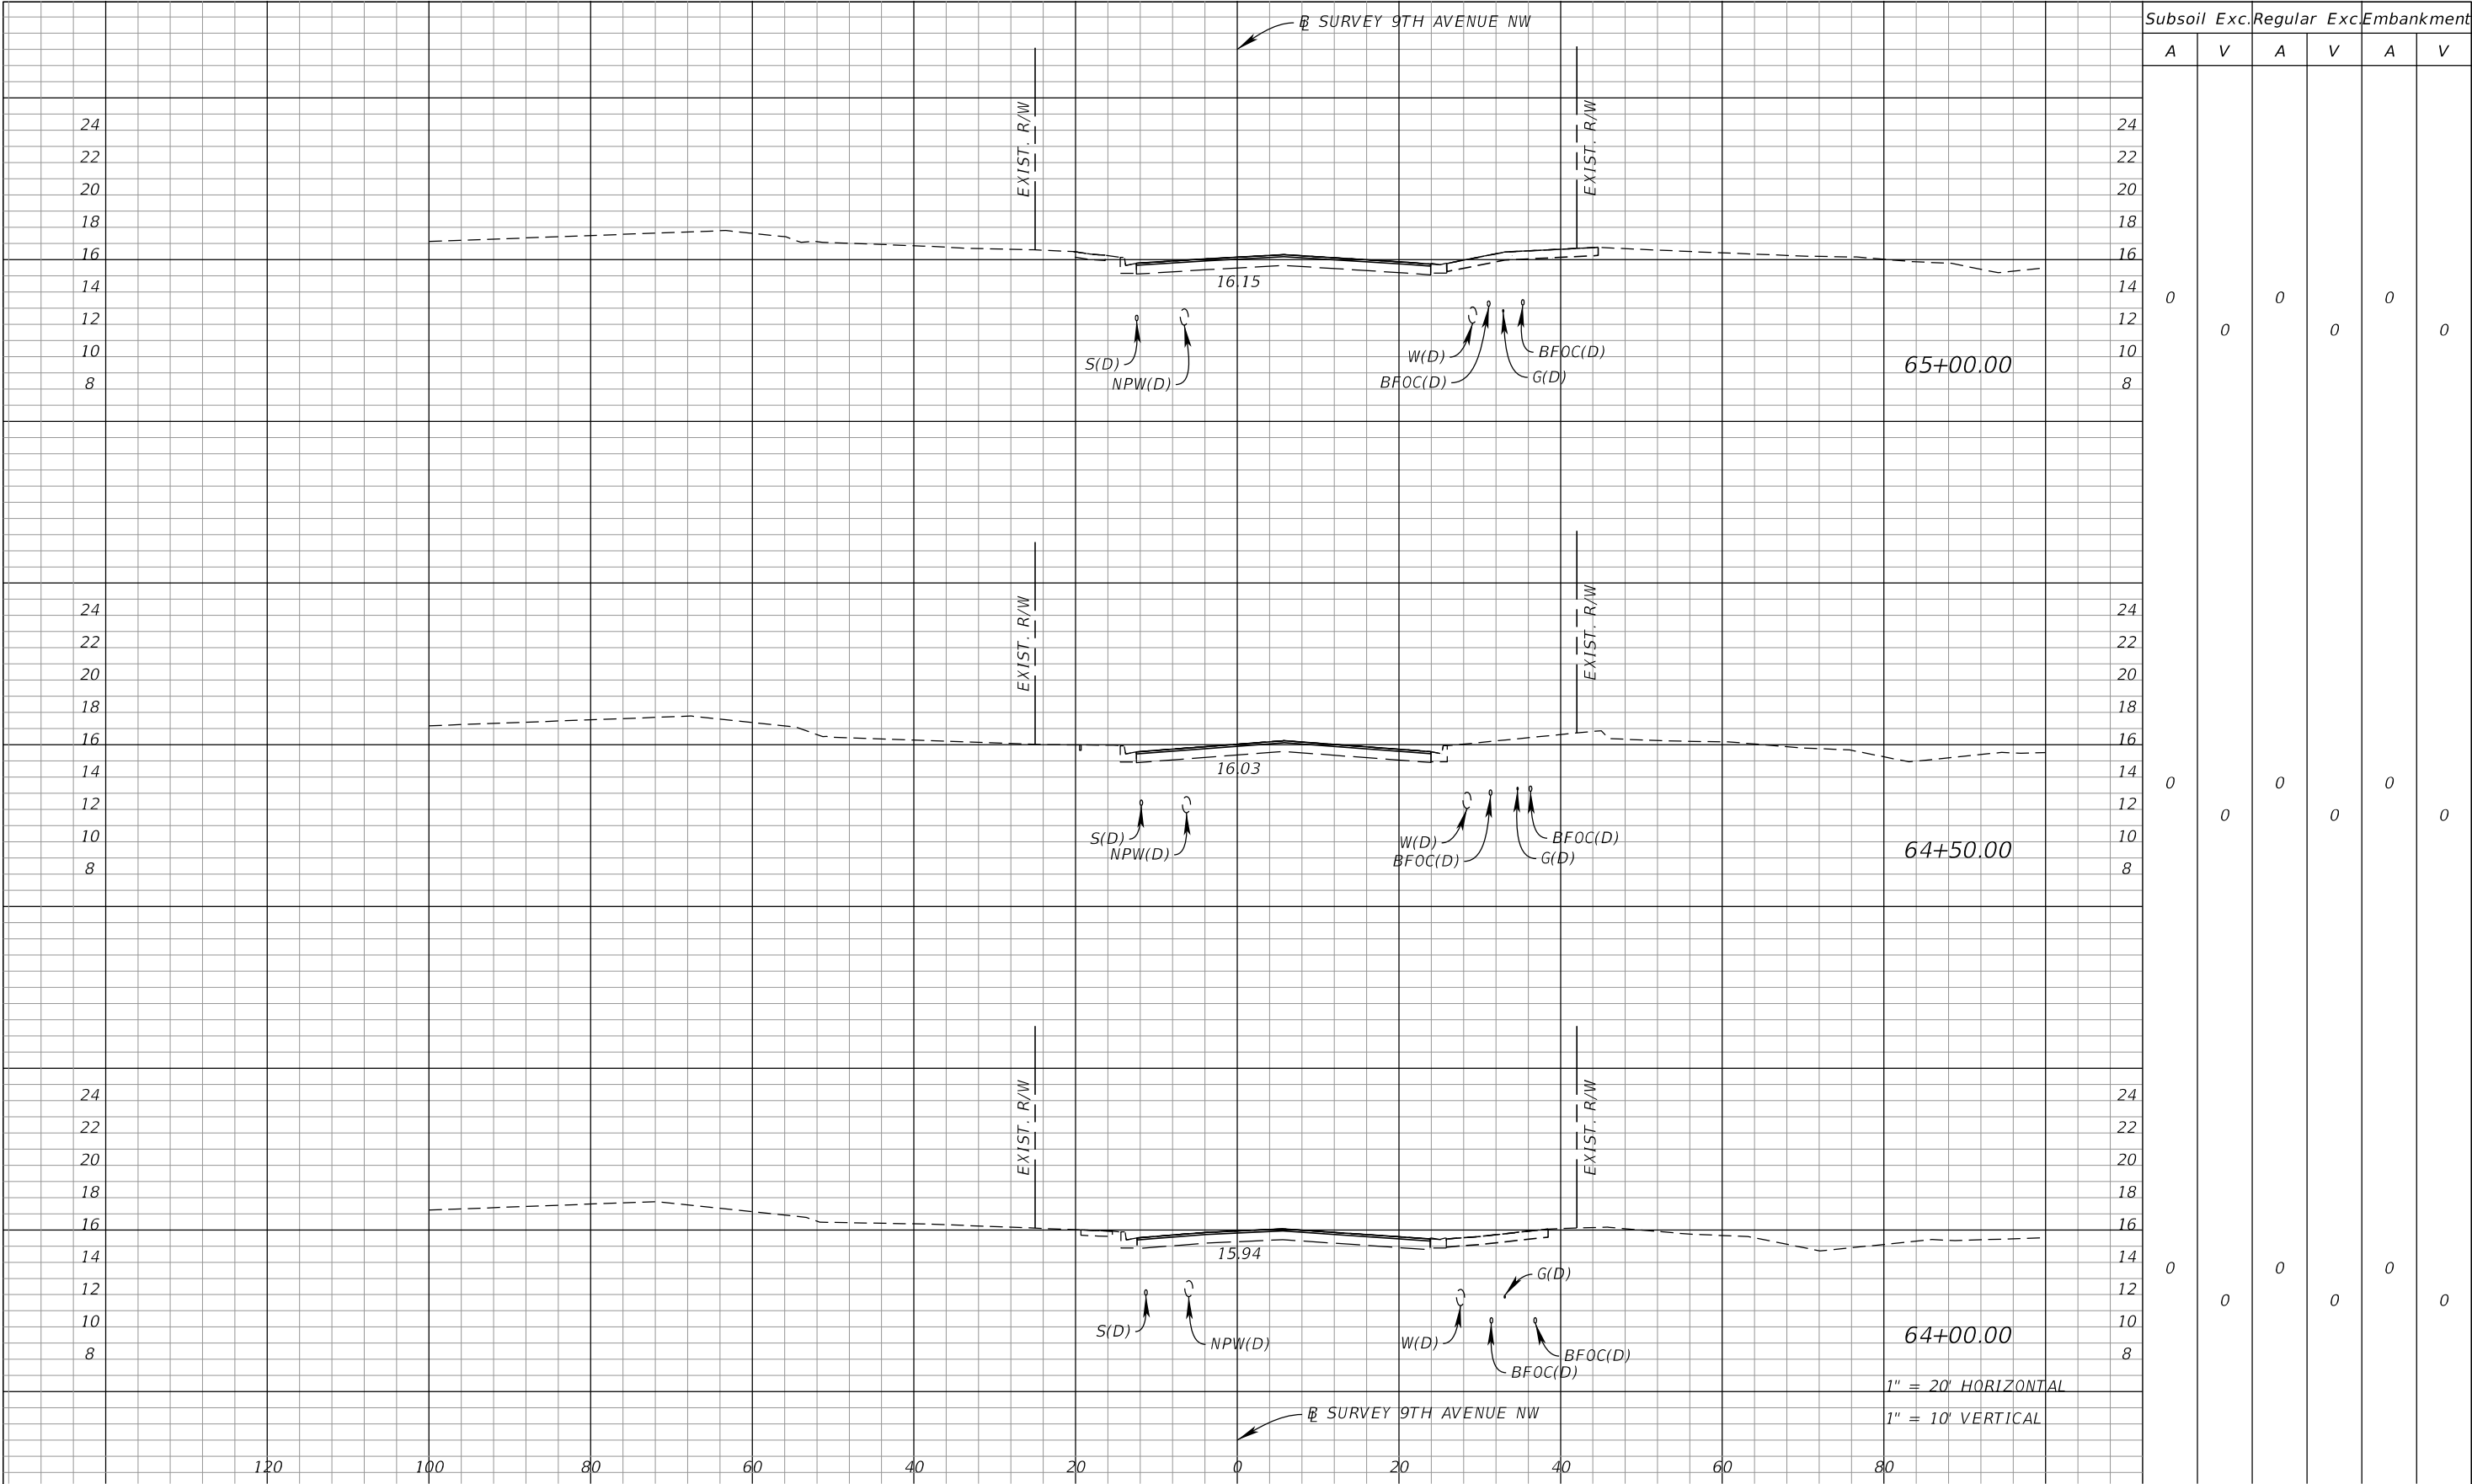


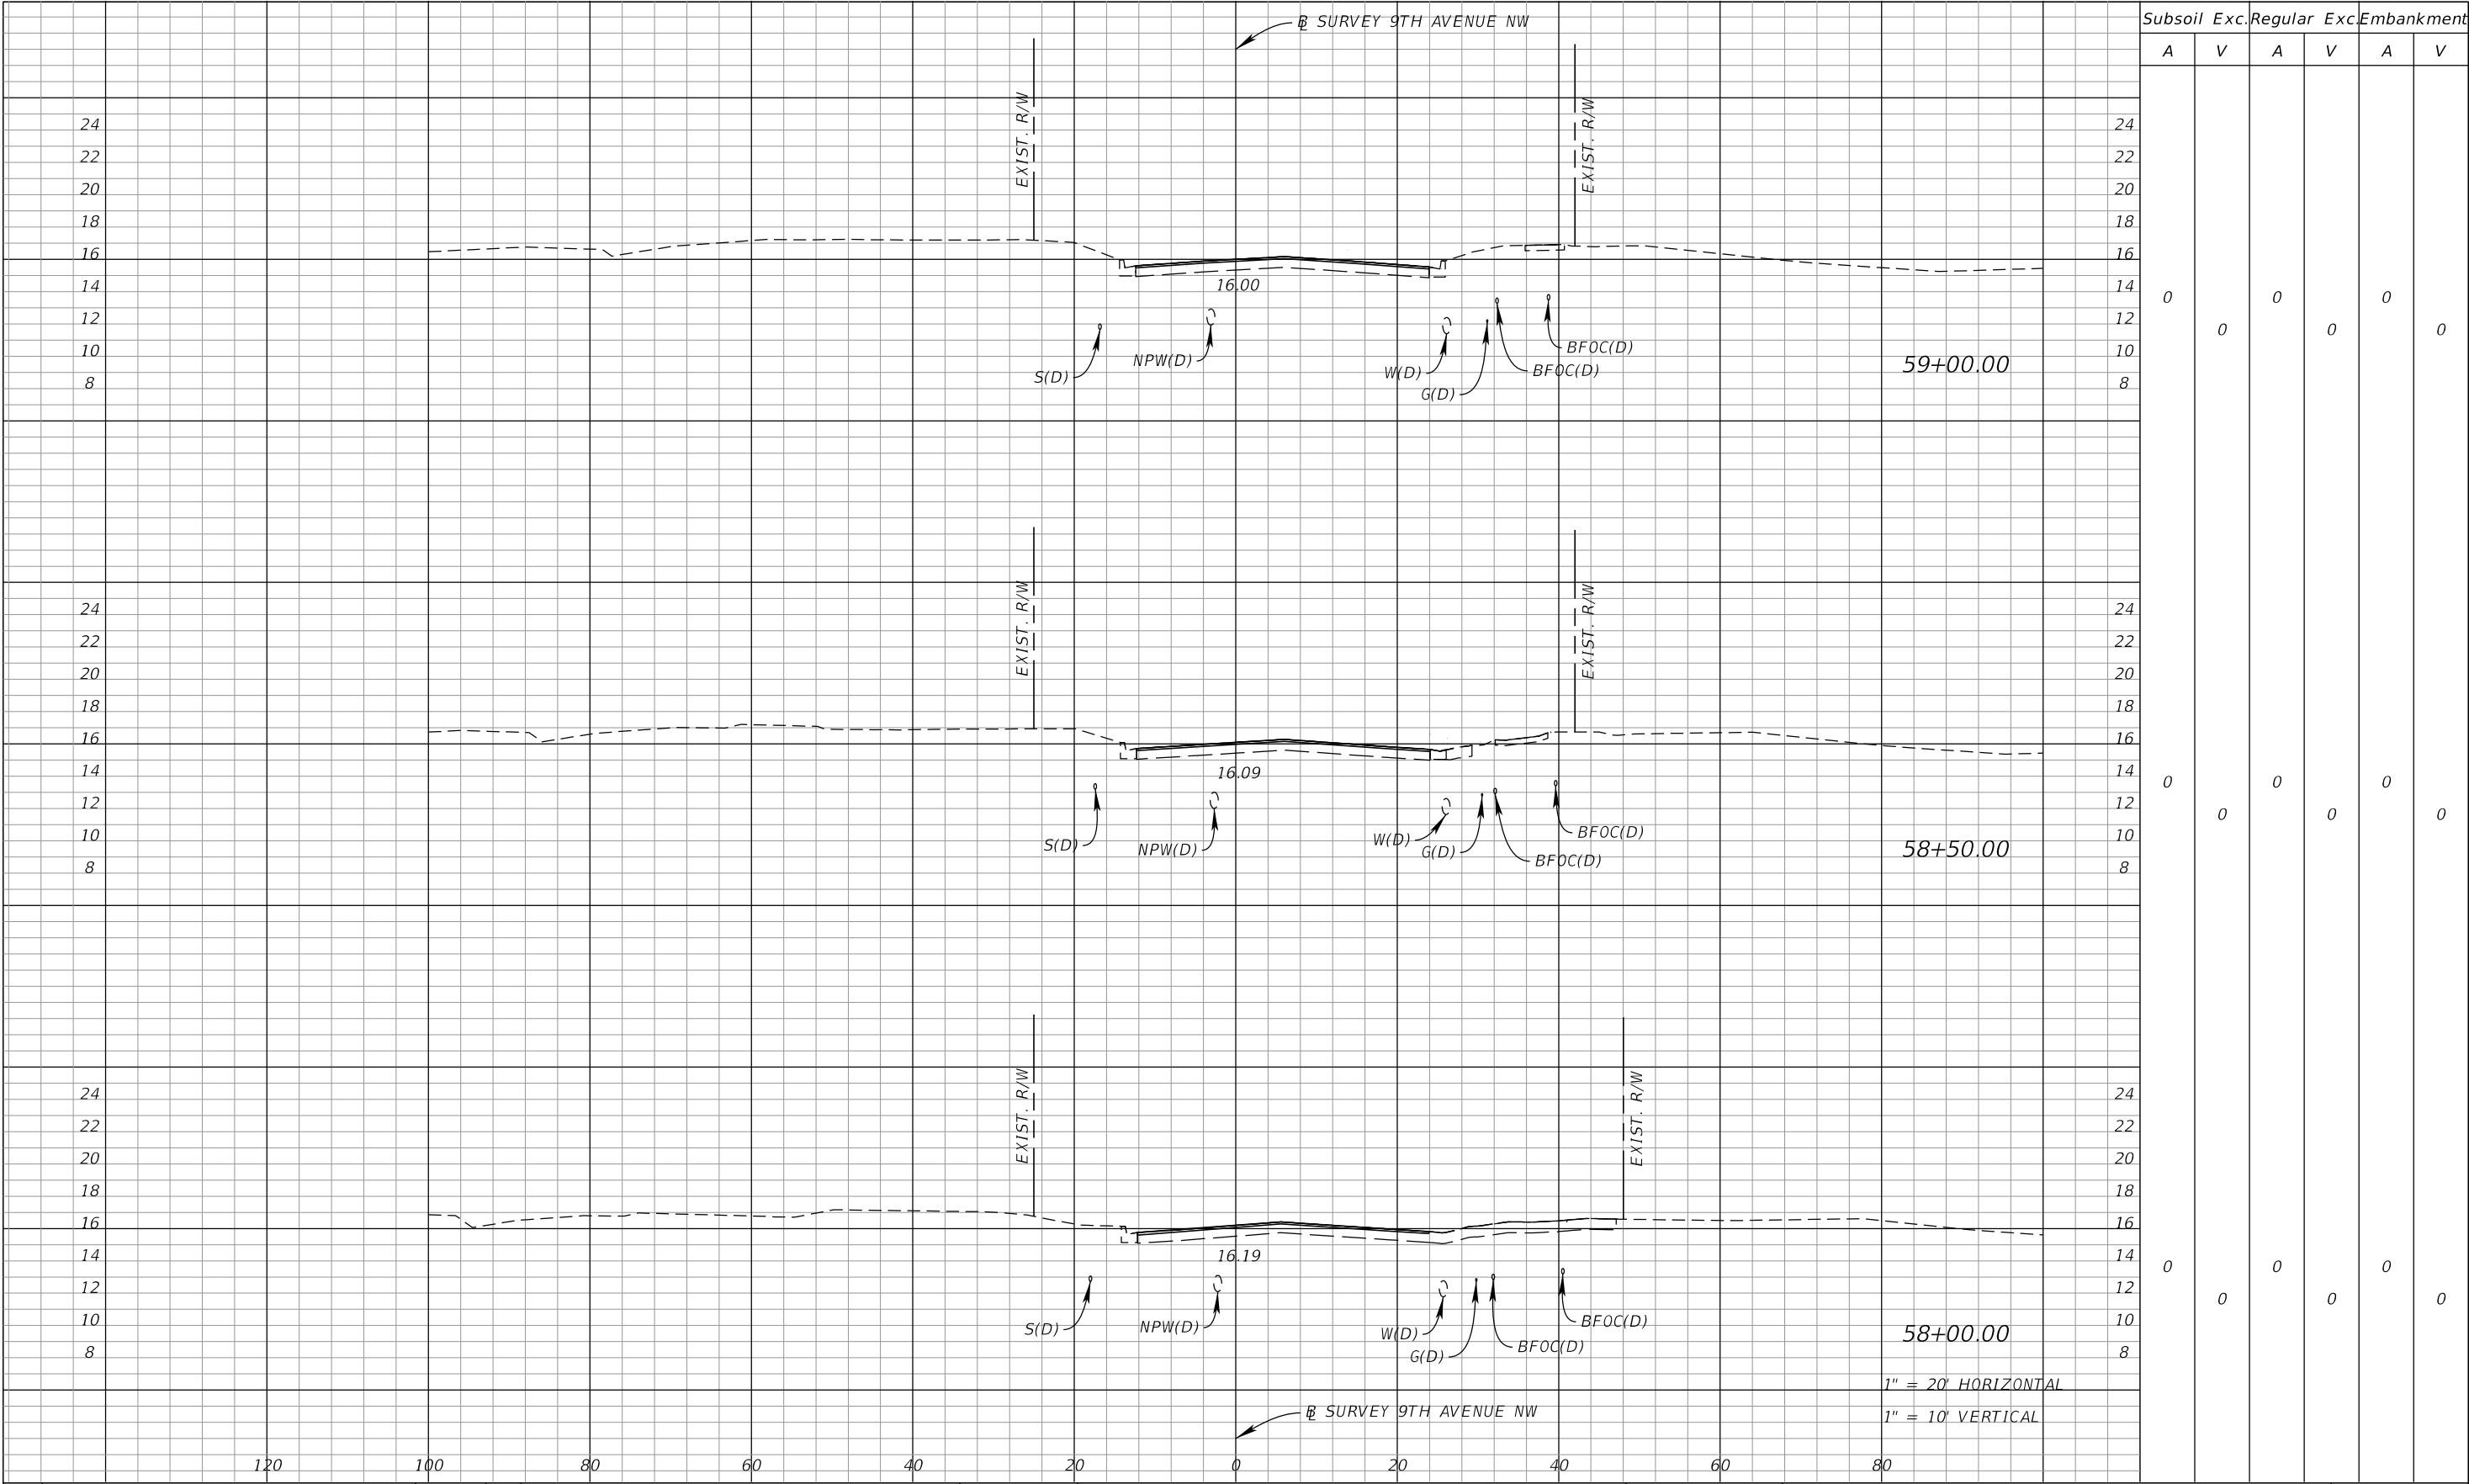

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No.	REVISIONS	DATE	BY				

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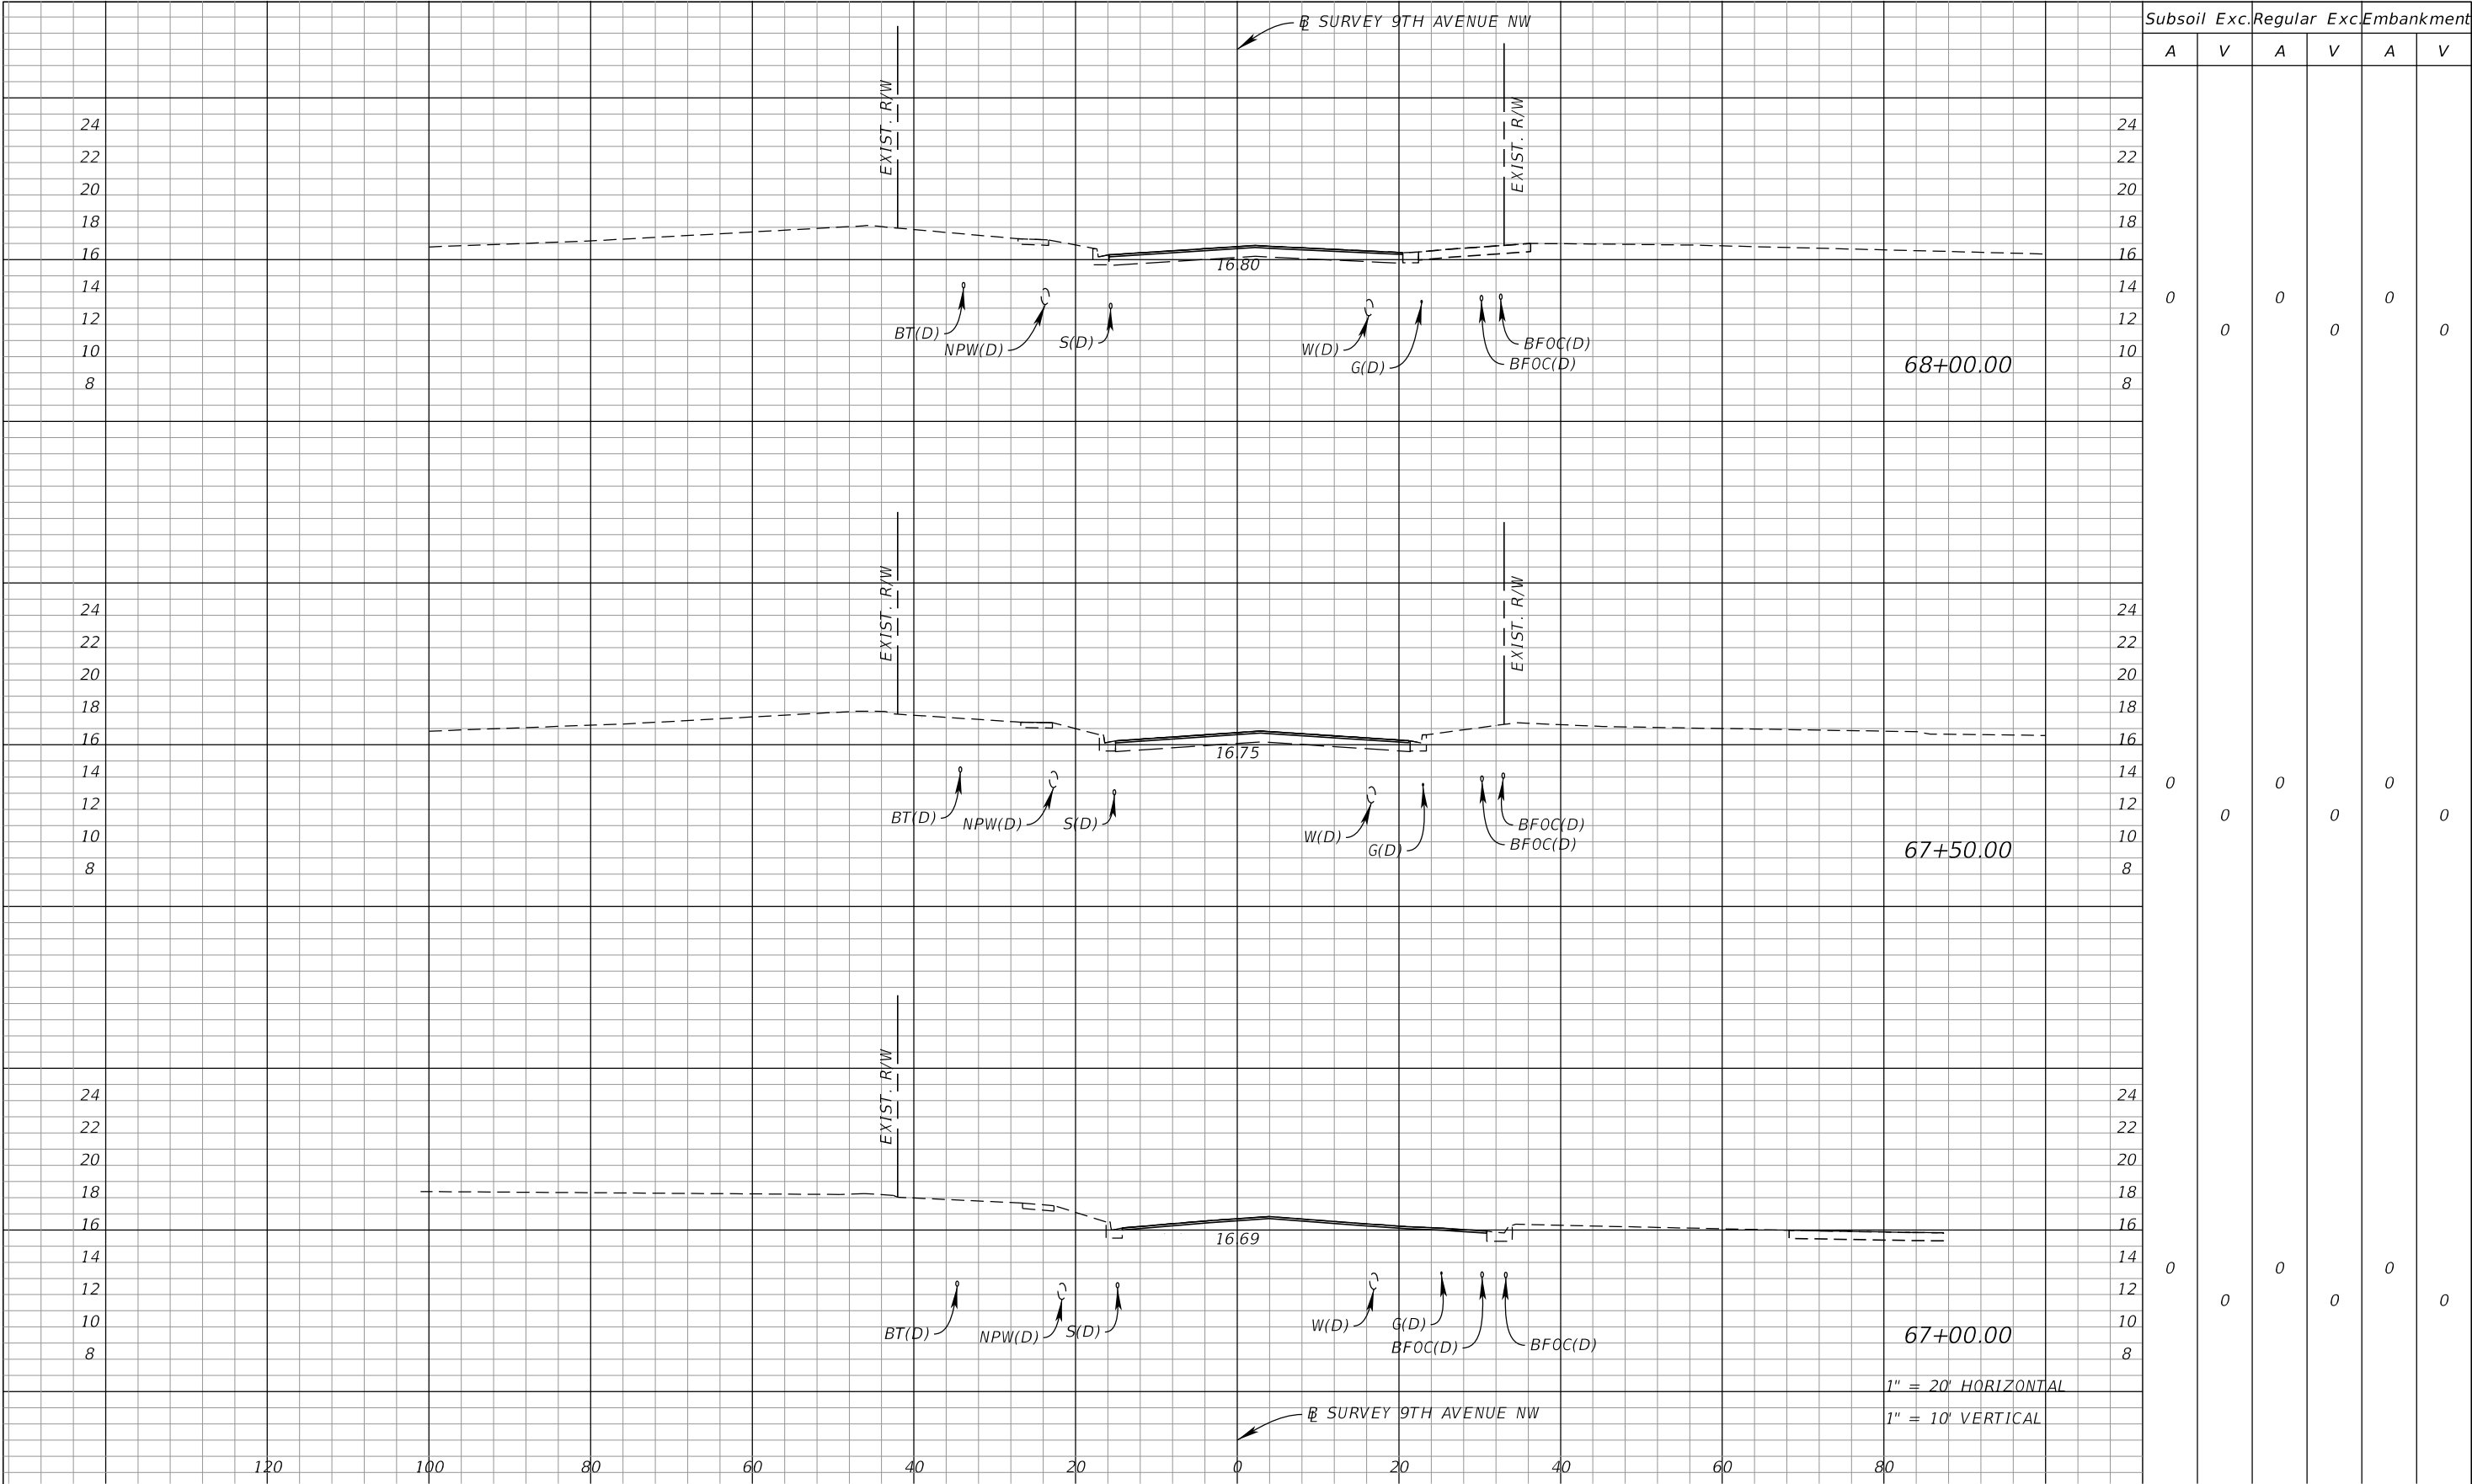




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			<div>DATE 10/02/2025</div>								
			<div>SCALE AS SHOWN</div>								
			<div>DESIGNED BY JNR</div>								
			<div>DRAWN BY JRW</div>								
			<div>CHECKED BY JEL</div>								
No.	REVISIONS	DATE	BY								


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No.	REVISIONS	DATE	BY			MANATEE COUNTY	FL	DATE:	






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No.	REVISIONS	DATE	BY					

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1" = 20' HORIZONTAL  
1" = 10' VERTICAL

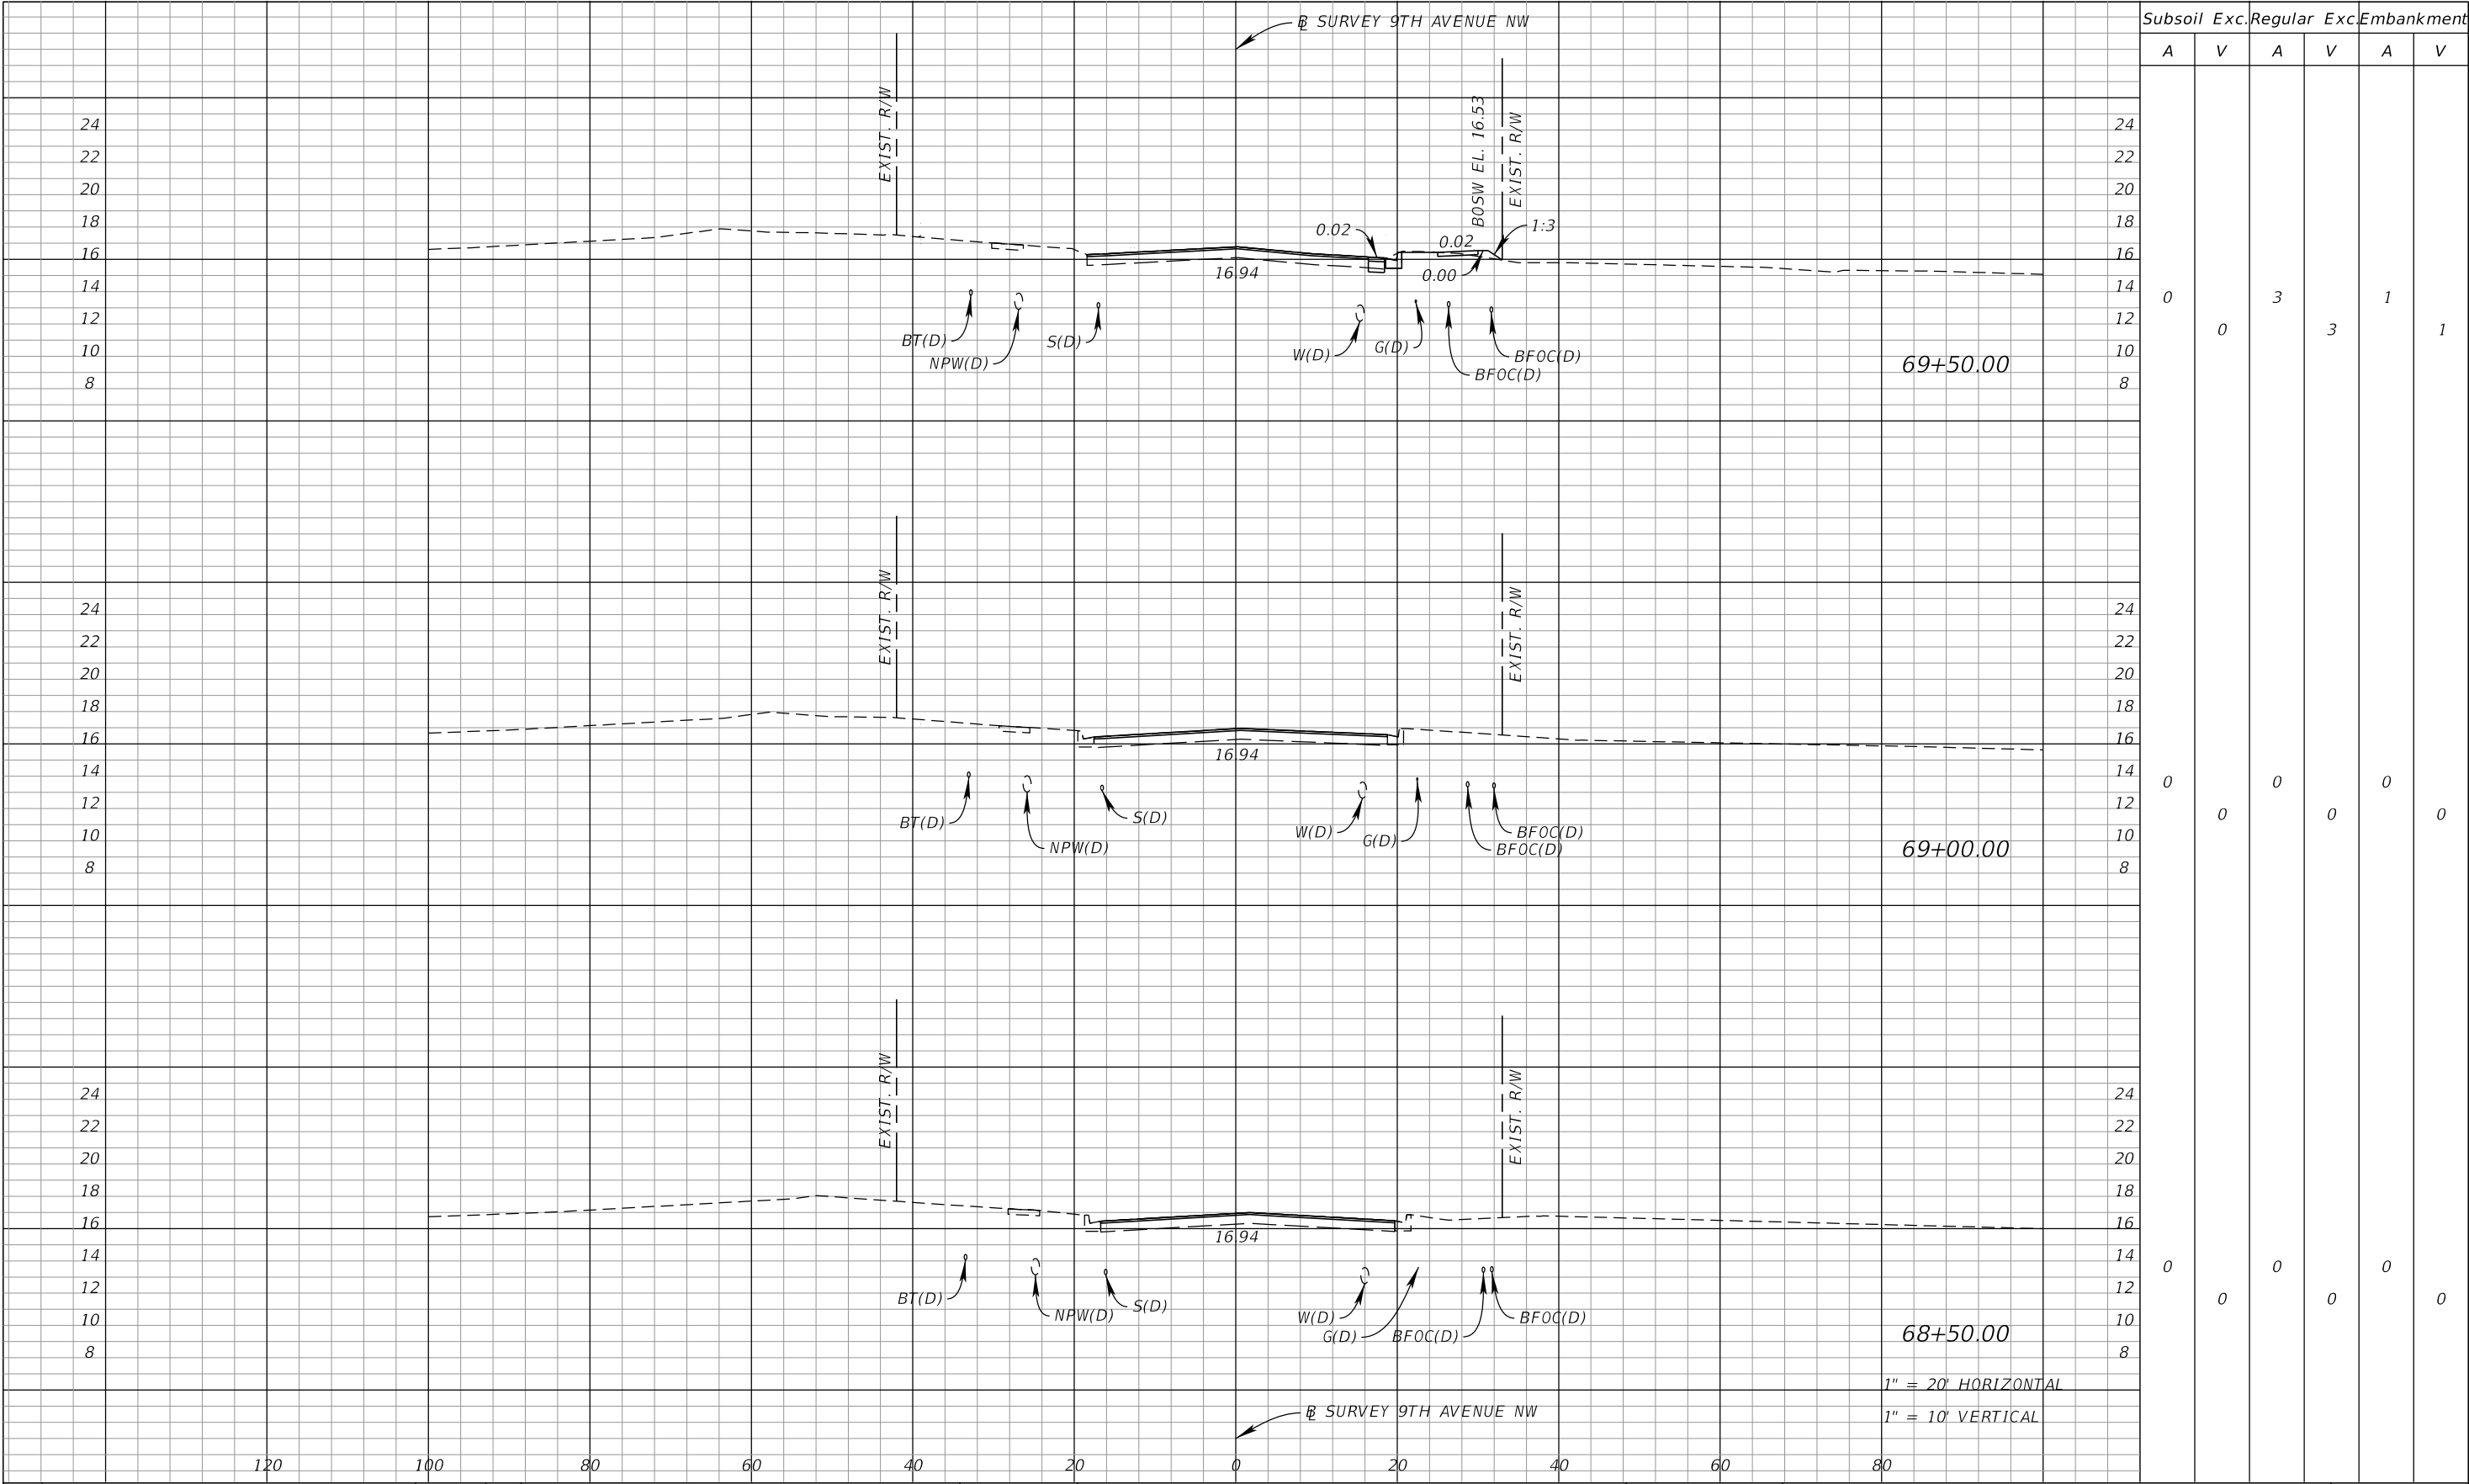No.	REVISIONS	DATE	BY

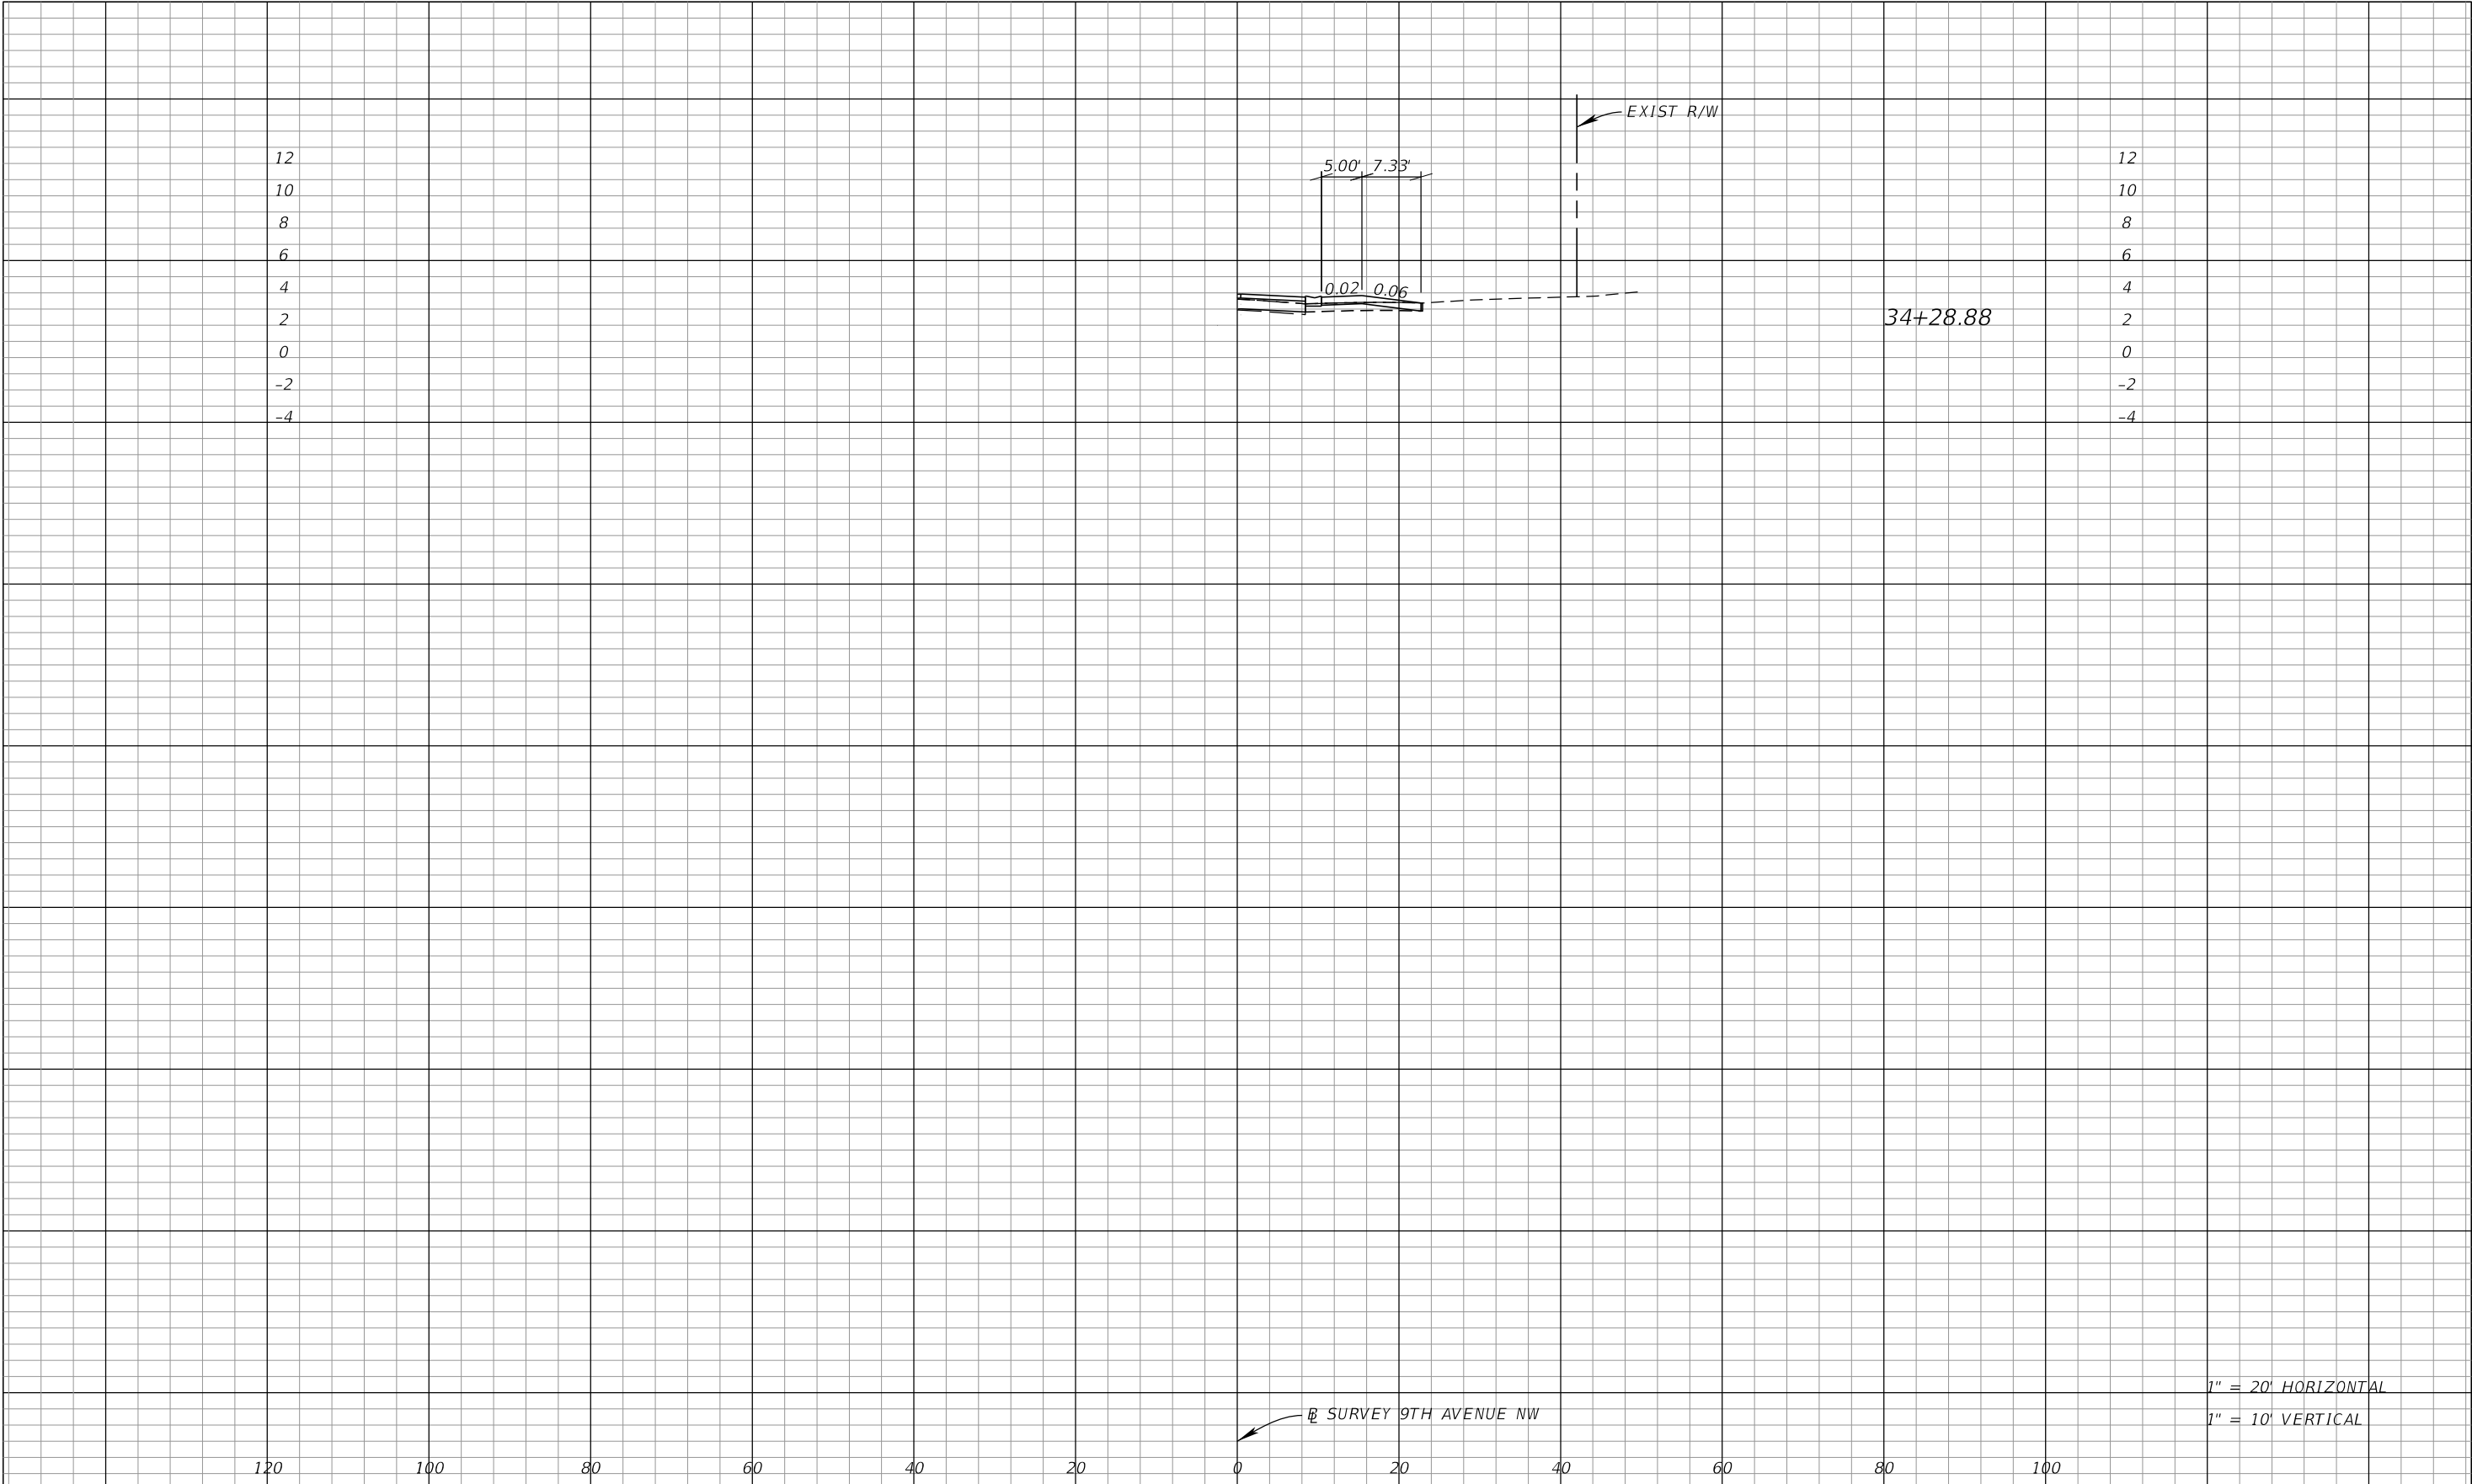

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KHA PROJECT 148400070
DATE 10/02/2025
SCALE AS SHOWN
DESIGNED BY
DRAWN BY
CHECKED BY



9TH AVENUE NW

MANATEE COUNTY

FL

LICENSED PROFESSIONAL

JORDAN E.  
LEEP, P.E.  
FL LICENSE NUMBER  
76102




DATE:

DRIVEWAY HALF SECTIONS  
9TH AVENUE NW

SHEET NUMBER

91

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 $38 + 35.75$  $36+42.14$  $35+10.41$ 

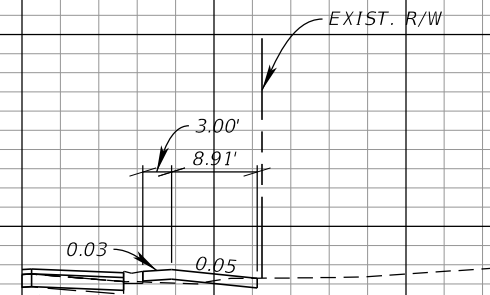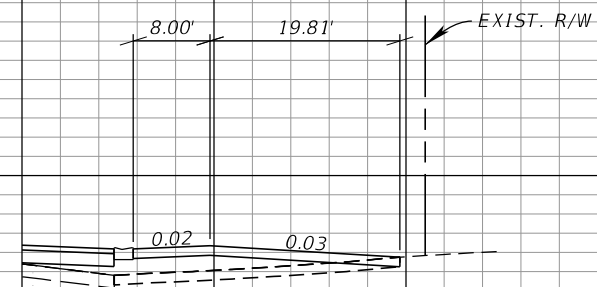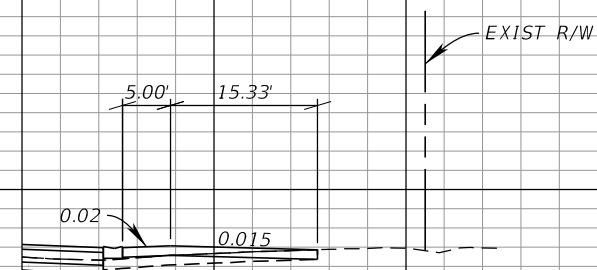1/2 SURVEY 9TH AVENUE NW

1" = 20' HORIZONTAL

 $1'' = 10' \text{ VERTICAL}$ [illegible]

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9TH AVENUE NW

MANATEE COUNTY

LICENSED PROFESSIONAL

JORDAN E.  
LEEP, P.E.  
FL LICENSE NUMBER  
76102

FL DATE:

DRIVEWAY HALF SECTIONS  
9TH AVENUE NW

SHEET NUMBER


92

*Susan.Pluta*

10/1/2025	5:22:30 PM	Rdxsrd shg
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K:\SAR Roadway\148400070 9thAve\148400070\roadway\RDXS RD04 DWY.dgn

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9TH AVENUE NW

MANATEE COUNTY

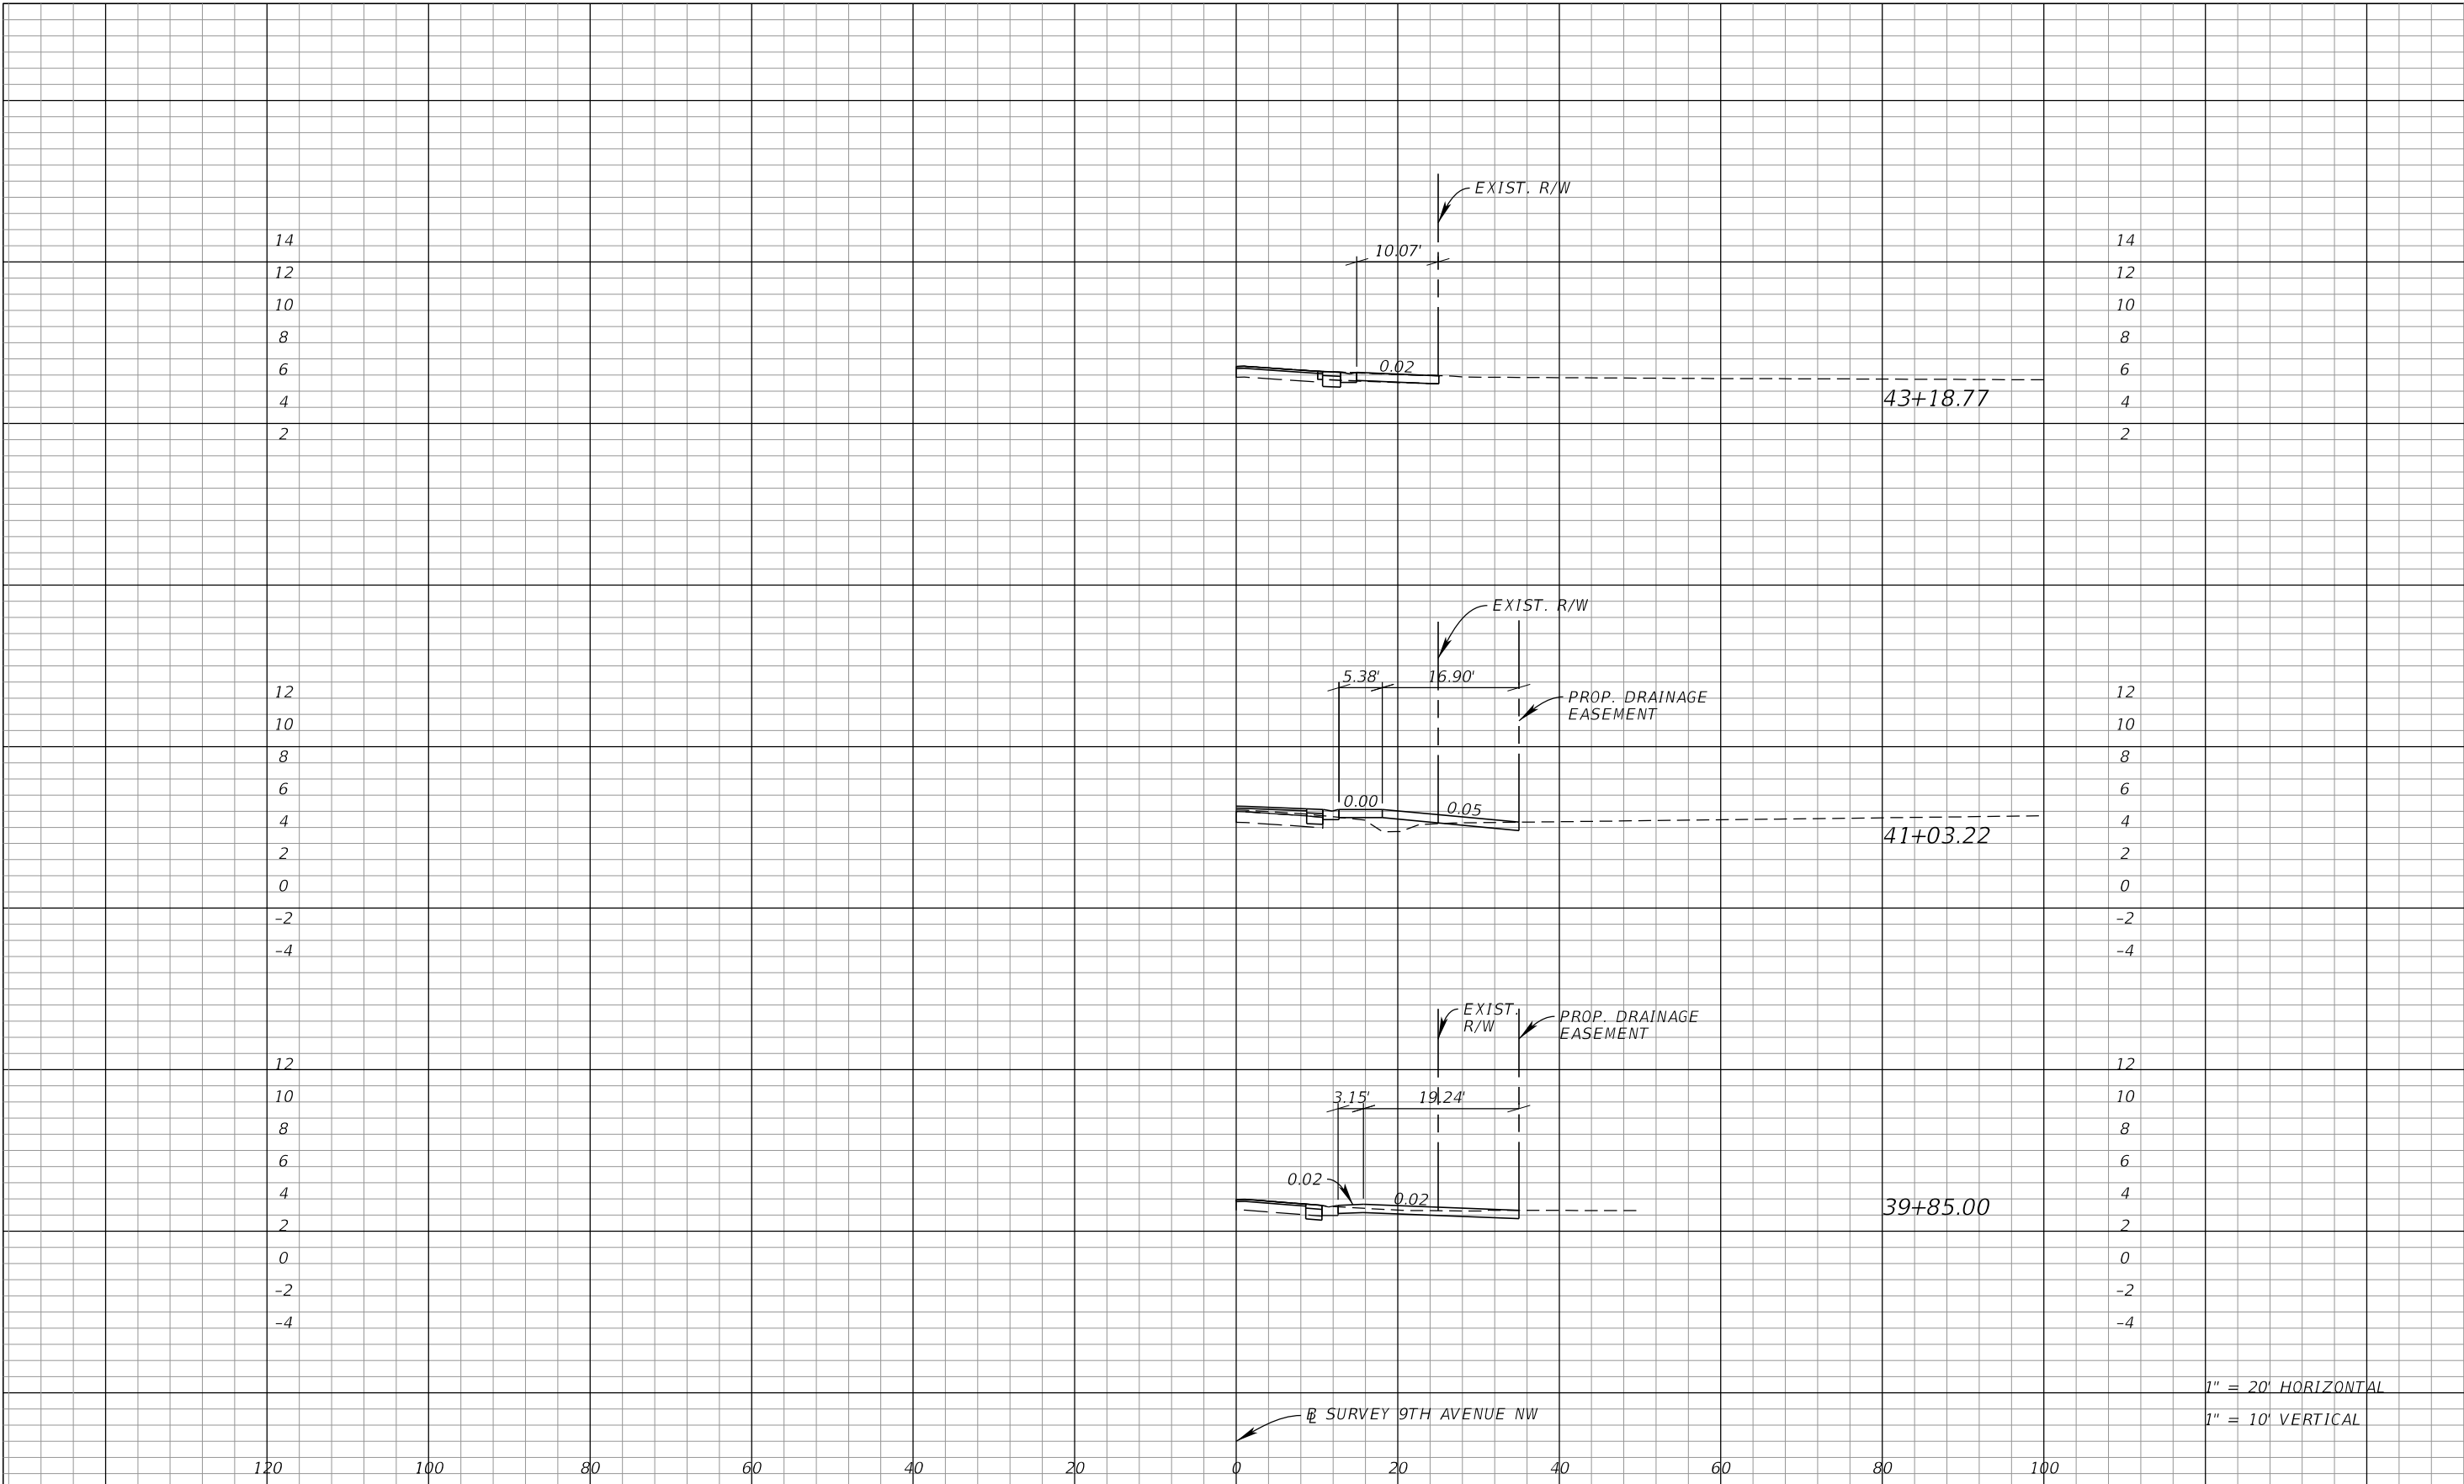LICENSED PROFESSIONAL

JORDAN E. LEEP, P.E.  
FL LICENSE NUMBER 76102


DRIVEWAY HALF SECTIONS  
9TH AVENUE NW

SHEET NUMBER

93

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9TH AVENUE NW

MANATEE COUNTY

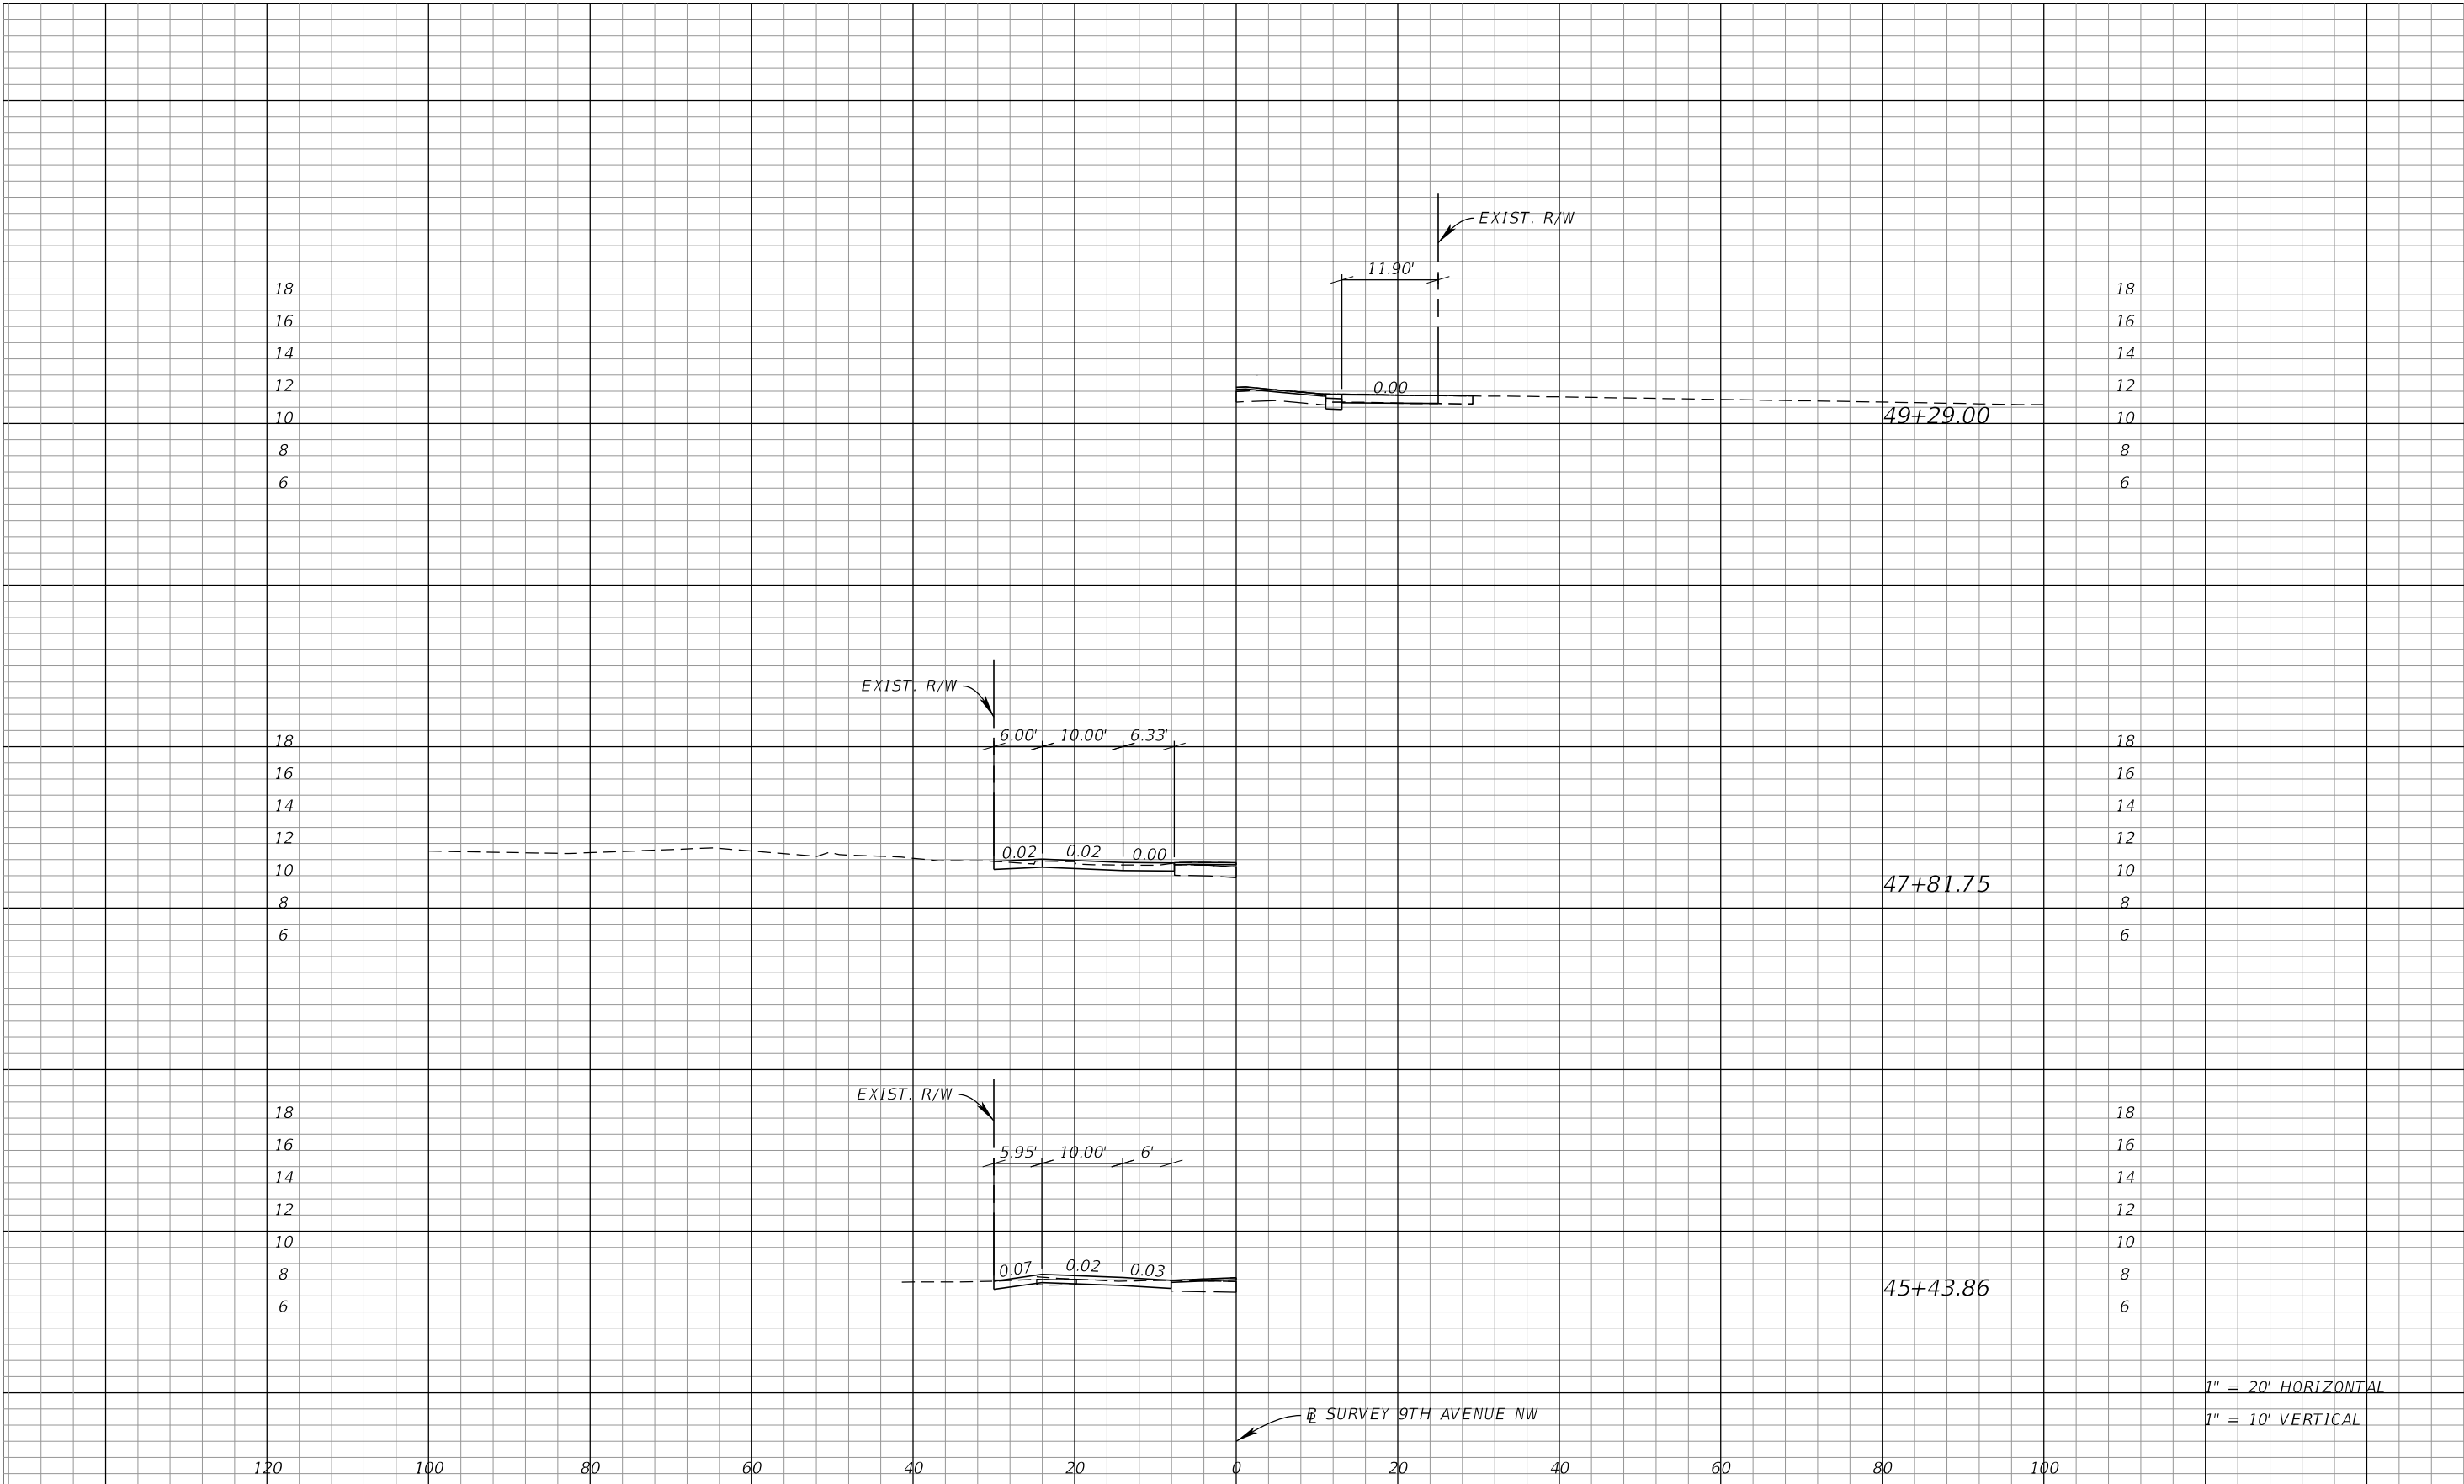LICENSED PROFESSIONAL


JORDAN E. LEEP, P.E.  
FL LICENSE NUMBER 76102

DRIVEWAY HALF SECTIONS  
9TH AVENUE NW

SHEET NUMBER
94

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No.	REVISIONS	DATE	BY

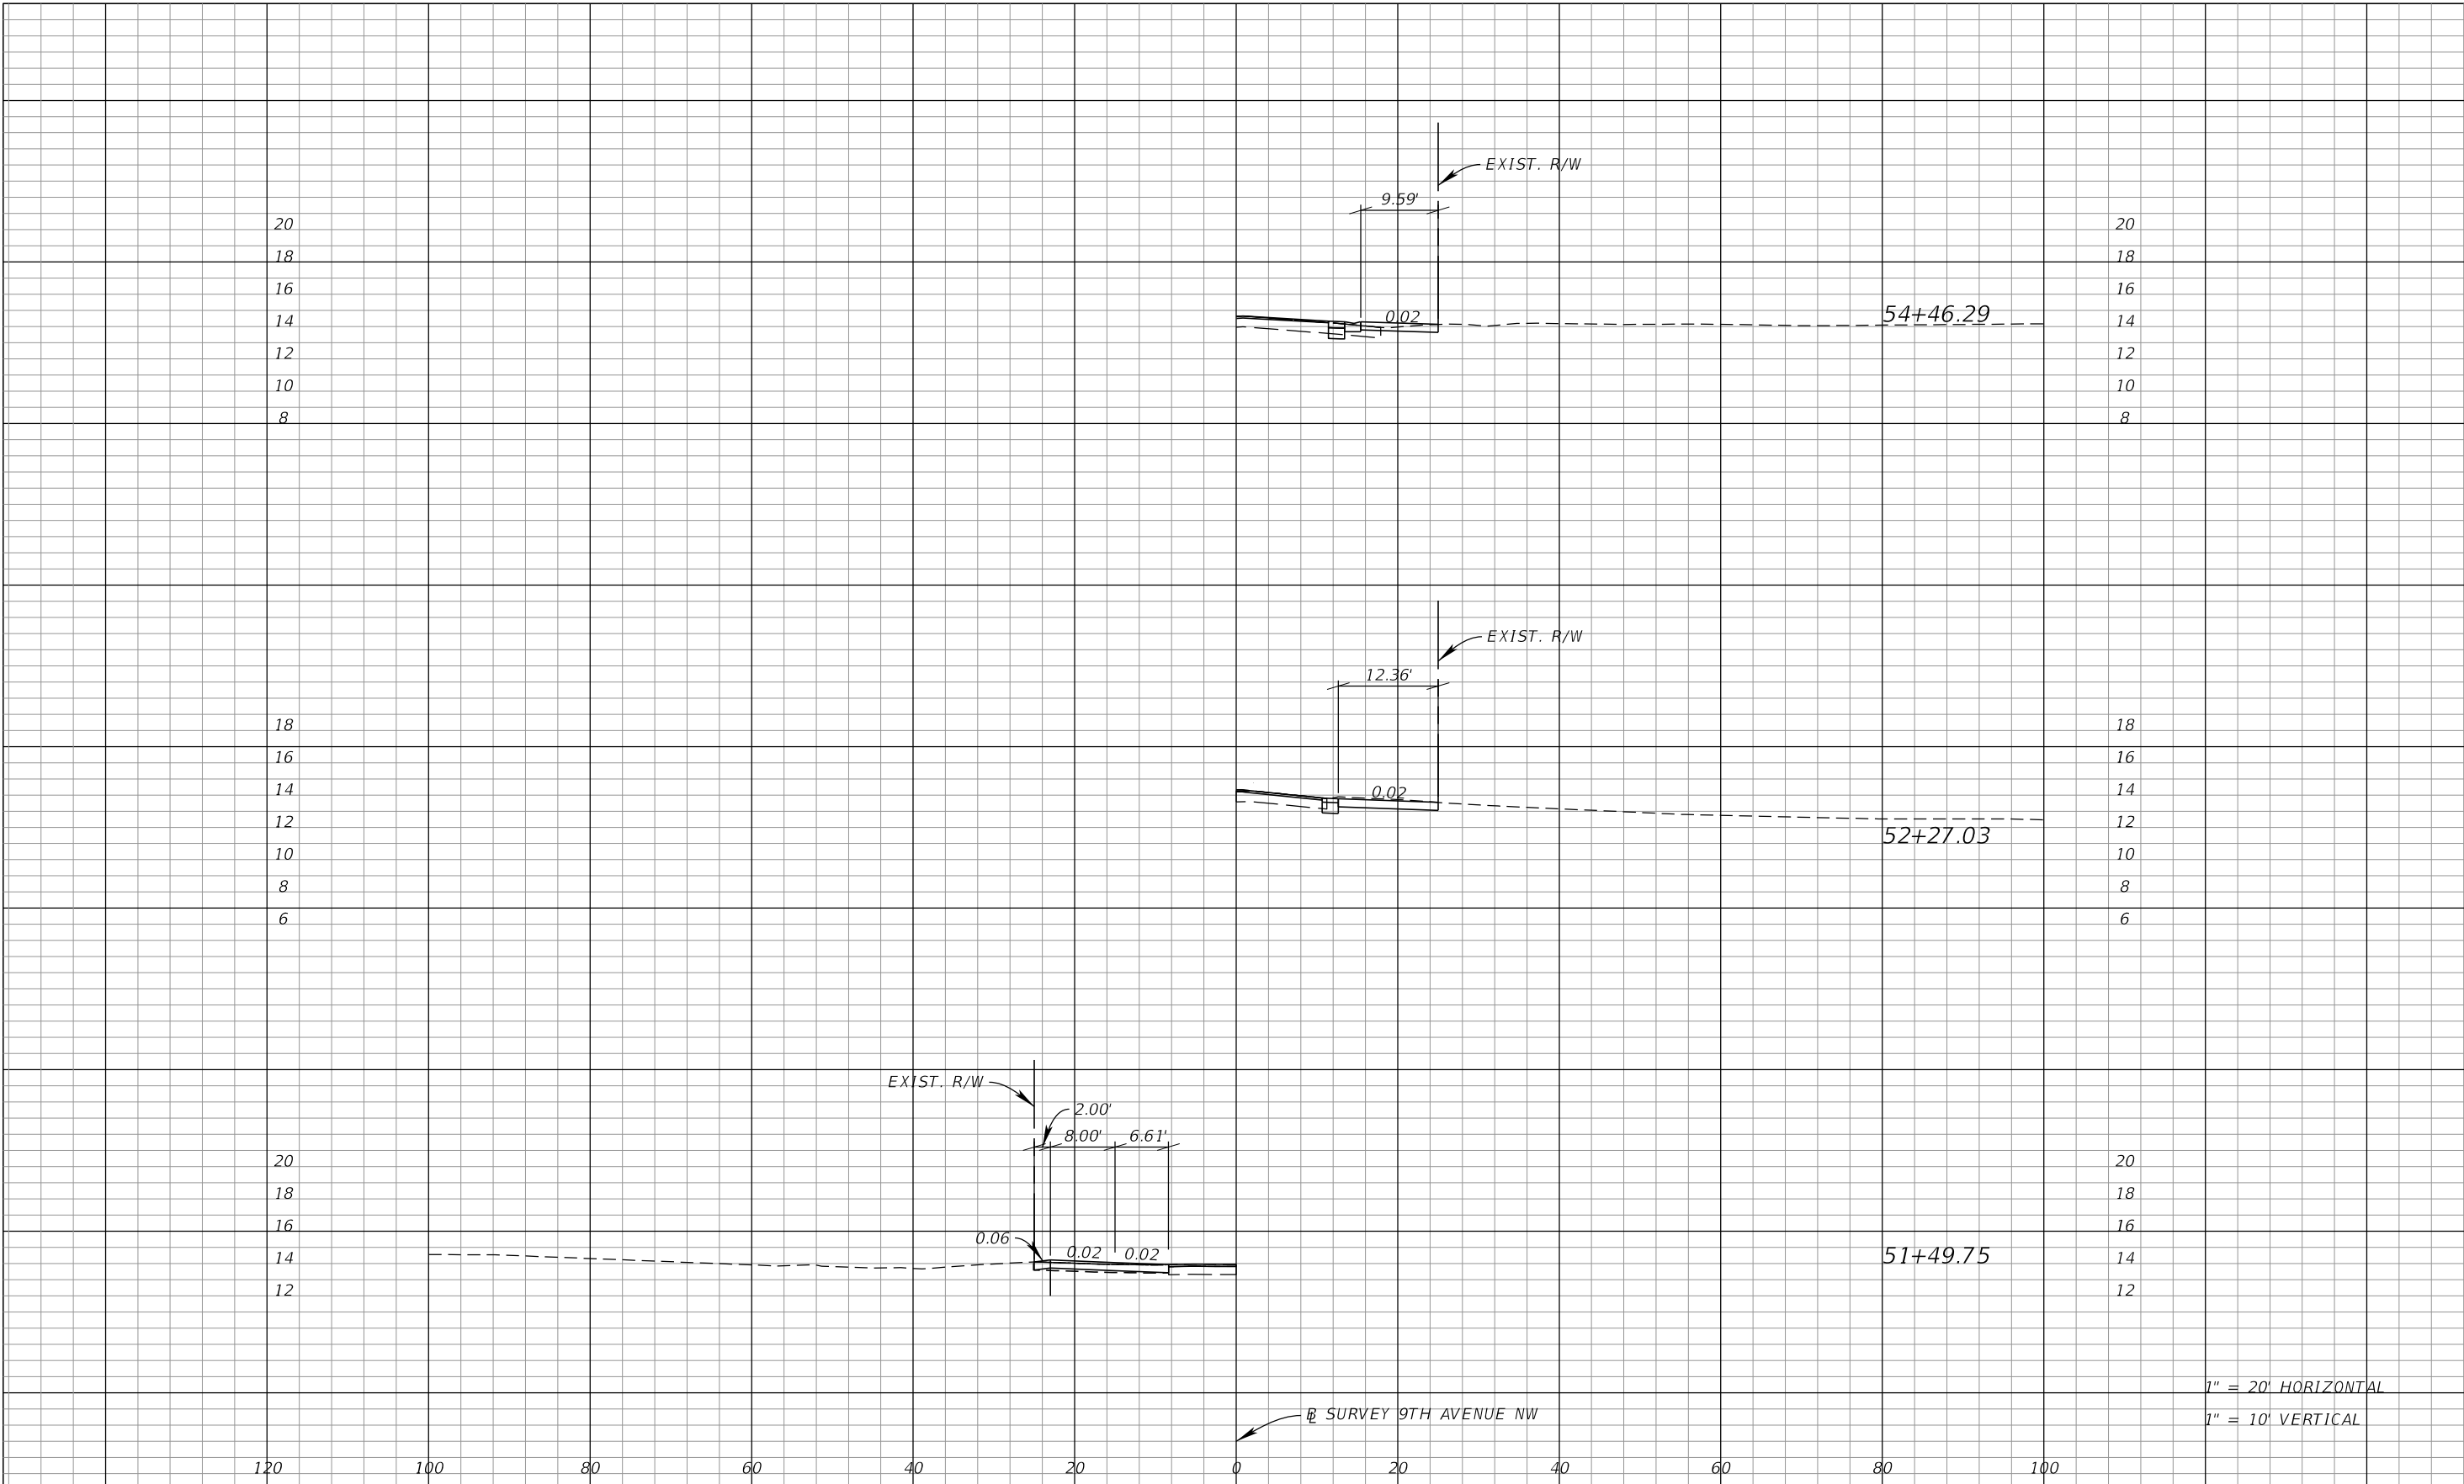

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9TH AVENUE NW

MANATEE COUNTY

FL

LICENSED PROFESSIONAL

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JORDAN E.  
LEEP, P.E.  
FL LICENSE NUMBER  
76102

DRIVEWAY HALF SECTIONS  
9TH AVENUE NW


SHEET NUMBER

96

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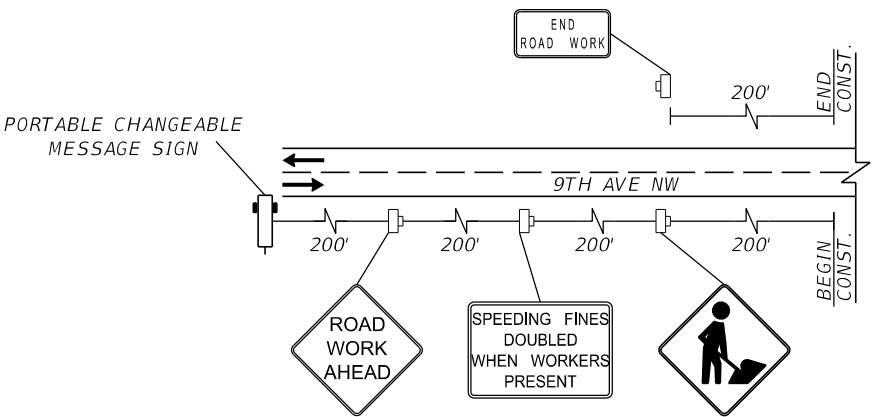
TRAFFIC CONTROL GENERAL NOTES

- 1. MAINTAIN ACCESS FOR LOCAL TRAFFIC AT ALL TIMES FOR WORK ZONE AREA.
- 2. MAINTAIN A WORK ZONE SPEED OF 35 MPH (POSTED) UNLESS OTHERWISE NOTED.
- 3. COORDINATE TEMPORARY DRIVEWAY ACCESS WITH ALL RESIDENTIAL PROPERTIES PRIOR TO CONSTRUCTION.
- 4. REMOVE, COVER OR TEMPORARILY RELOCATE ALL EXISTING SIGNS AND PAVEMENT MARKINGS WHICH CONFLICT WITH THE TRAFFIC CONTROL PLAN DURING A CONSTRUCTION PHASE.
- 5. PERFORM ALL WORK DURING DAYTIME HOURS (7:00 AM – 7:00 PM).
- 6. ADHERE TO THE REQUIREMENTS SET FORTH IN THE LATEST VERSION OF THE INDEX 102-600 SERIES OF THE FDOT STANDARD PLANS AT ALL TIMES.
- 7. MAINTAIN AN ADA COMPLIANT PEDESTRIAN PATHWAY THROUGHOUT LIMITS OF CONSTRUCTION PROJECT AT LOCATIONS WHERE SIDEWALK CURRENTLY EXISTS. PLACE NECESSARY SIDEWALK CLOSURE SIGNAGE IN ACCORDANCE WITH STANDARD FDOT INDEX 102-660.
- 8. MAINTAIN BI-DIRECTIONAL TRAFFIC FLOW IN ALL AREAS WHERE POSSIBLE.
- 9. CONTRACTOR TO COORDINATE WITH MANATEE COUNTY TO APPROVE ANY LANE CLOSURES NO LESS THAN THREE WEEKS IN ADVANCE. PORTABLE CHANGEABLE MESSAGE SIGN MUST ANNOUNCE LANE CLOSURE NO LESS THAN ONE WEEK PRIOR TO CLOSURE.

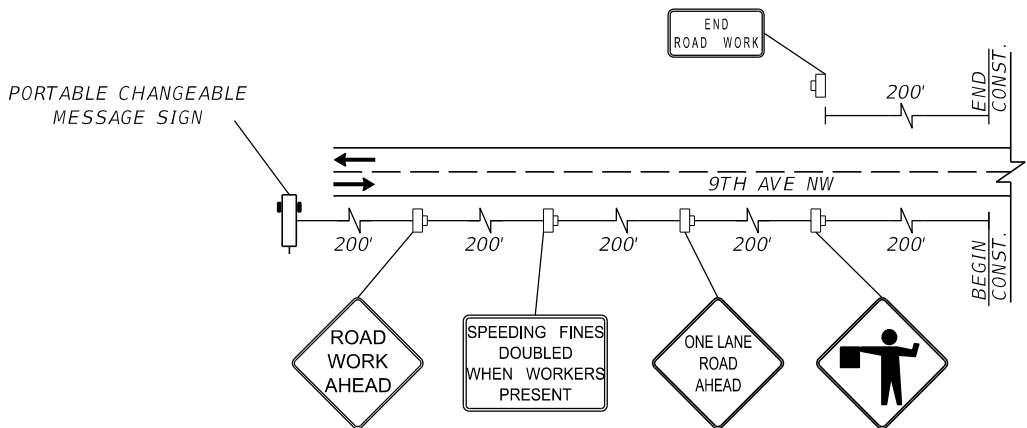

ADVANCE WARNING FLAGGING OPERATIONS

9TH AVE NW EB  
(FOR WB TRAFFIC USE INVERTED IMAGE)  
SEE INDEX 102-600 FOR SIDE STREET APPROACHES



ADVANCE WARNING BEGIN/END CONSTRUCTION


9TH AVE NW EB  
(FOR WB TRAFFIC USE INVERTED IMAGE)

PORTABLE CHANGEABLE MESSAGE SIGNS

PLACE PORTABLE CHANGEABLE MESSAGE SIGNS (PCMS) 14 DAYS PRIOR TO THE FIRST DAY OF CONSTRUCTION.



BEGIN/END PROJECT PRIOR TO CONSTRUCTION (9TH AVE NW FOR BOTH DIRECTIONS OF TRAVEL)

MESSAGES SHOULD READ:

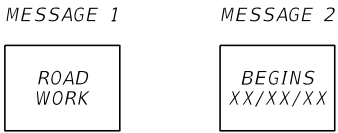

BEGIN/END PROJECT DURING CONSTRUCTION (9TH AVE NW FOR BOTH DIRECTIONS OF TRAVEL)

MESSAGES SHOULD READ:

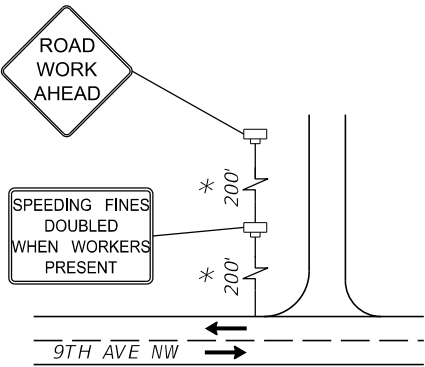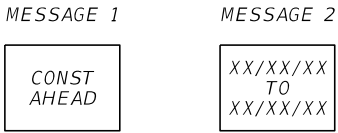

ADVANCE WARNING UNSIGNALIZED SIDE STREET DETAIL

- 79TH ST NW (LT)
- 82ND ST NW (LT)
- 83RD ST NW (LT/RT)
- 84TH ST NW (RT)
- 86TH ST CT NW (RT)
- 87TH ST NW (LT)
- 87TH ST CT NW (RT)
- 88TH ST NW (RT)
- 89TH ST NW (RT)
- 89TH CT NW (RT)
- 92ND ST NW (LT)

LEGEND

- LANE IDENTIFICATION AND DIRECTION OF TRAFFIC
- \* ADJUST DISTANCE BETWEEN SIGNS TO ACCOMMODATE SITE CONDITIONS
- WORK ZONE SIGN
- ◇ TRAFFIC CONTROL SIGN

No.	REVISIONS	DATE	BY

**Kimley»Horn**

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KHA PROJECT 148400070
DATE 10/02/2025
SCALE AS SHOWN
DESIGNED BY
DRAWN BY
CHECKED BY

**Manatee County**  
FLORIDA

9TH AVENUE NW

MANATEE COUNTY

LICENSED PROFESSIONAL
JORDAN E. LEEP, P.E.
FL LICENSE NUMBER 76102

TTCP GENERAL NOTES / DETAILS

SHEET NUMBER
97

PHASING NOTES - 9TH AVENUE NW

PHASE I

1. PLACE ADVANCE WARNING TRAFFIC CONTROL SIGNS AND DEVICES AS SHOWN IN THE TTCP GENERAL NOTES/DETAILS SHEET.
2. PLACE WORK ZONE SIGNS AND CHANNELIZING DEVICES, UTILIZING INDICES 102-600, 102-602, 102-603, AND 102-604 AS REQUIRED. SET UP DETOUR PLAN PER PHASE 1A DETOUR PLAN SHEET.
3. CONSTRUCT OUTFALL CANAL ADJACENT TO THE CROSS DRAIN AT APPROXIMATE STA. 36+80. CONSTRUCT CULVERT AT HAWTHORN PARK OUTFALL.
4. CONSTRUCT WATER MAIN AND RECLAIM MAIN RELOCATIONS AT CULVERT IN CONJUNCTION WITH CULVERT CONSTRUCTION.
5. CONSTRUCT ALL CURBLINES, WIDENING AND RECONSTRUCTION, DRAINAGE, EARTHWORK, SODDING, AND SIDEWALKS FROM APPROXIMATE STA. 34+00 TO STA. 39+10.
6. SEE 92ND TEMPORARY TRAFFIC CONTROL PHASING PLAN SHEETS, PHASING NOTES, AND DETOUR PLAN TO CONSTRUCT THE WORK AT 92ND STREET NW AND 9TH AVENUE NW. MAKE CONNECTION TO MULTI-USE-TRAIL ON THE NORTH SIDE AND CONNECTION TO PIPE AT STRUCTURE S-404.

PHASE IIA

1. PLACE ADVANCE WARNING TRAFFIC CONTROL SIGNS AND DEVICES AS SHOWN IN THE TTCP GENERAL NOTES / DETAILS SHEET.
2. PLACE WORK ZONE SIGNS AND CHANNELIZING DEVICES, UTILIZING INDICES 102-600, 102-602, 102-603 AND 102-604 AS REQUIRED.
3. EAST OF APPROXIMATE STA. 43+75, CONSTRUCT WIDENING TO THE SOUTH UP TO THE FINAL LIFT, SIDEWALKS, CURBLINES, SODDING, AND EARTHWORK UP TO APPROXIMATE STA. 53+13.
4. MAINTAIN LOCAL ACCESS DOWN 88TH STREET NW SOUTH OF 9TH AVENUE NW AT ALL TIMES USING A FLAGGER AS NECESSARY. CONSTRUCT OUTFALL STRUCTURE AND DRAINAGE TRUNKLINE UP TO, BUT NOT INCLUDING, STRUCTURE S-800.
5. SEE 87TH TEMPORARY TRAFFIC CONTROL PHASING PLAN SHEETS, PHASING NOTES, AND DETOUR PLAN TO CONSTRUCT THE WORK AT 87TH STREET NW AND 9TH AVENUE NW. MAKE CONNECTION TO MULTI-USE-TRAIL ON THE NORTH SIDE.

PHASE IIB





1. PLACE ADVANCE WARNING TRAFFIC CONTROL SIGNS AND DEVICES AS SHOWN IN THE TTCP GENERAL NOTES / DETAILS SHEET.
2. PLACE WORK ZONE SIGNS AND CHANNELIZING DEVICES, UTILIZING INDICES 102-600, 102-602, 102-603, AND 102-604 AS REQUIRED.
3. EAST OF APPROXIMATE STA. 57+10, CONSTRUCT WIDENING TO THE SOUTH UP TO THE FINAL LIFT, SIDEWALKS, CURBLINES, SODDING, AND EARTHWORK ENDING WORK AT APPROXIMATE STA. 71+70.

PHASE III

1. PLACE ADVANCE WARNING TRAFFIC CONTROL SIGNS AND DEVICES AS SHOWN IN THE TTCP GENERAL NOTES / DETAILS SHEET.
2. PLACE WORK ZONE SIGNS AND CHANNELIZING DEVICES, UTILIZING INDICES 102-600, 102-602, 102-603, AND 102-604 AS REQUIRED. USE SINGLE LANE CLOSURES AND FLAGGER TO CARRY-OUT MILLING OPERATIONS ALONG THE ENTIRE PROJECT LIMITS.
3. EAST OF APPROXIMATE STA. 75+00, CONSTRUCT SODDING AND EARTHWORK UP TO APPROXIMATE STA. 83+15. SEE 9TH AVENUE NW: 78TH STREET NW TO 75TH STREET NW PROJECT FOR MORE INFORMATION ON TIE-IN INFORMATION.
4. CONSTRUCT SIDEWALK AND DRAINAGE WORK EAST OF 75TH STREET NW UP TO 71ST STREET NW. ENSURE DRIVEWAY ACCESS TO ALL RESIDENTIAL PROPERTIES AT ALL TIMES.
5. CONSTRUCT MILLING OPERATIONS ALONG ENTIRE PROJECTS LIMITS USING INDEX 102-603. PLACE FINAL LIFT OF ASPHALT AND FINAL SURFACE PAVEMENT MARKINGS ALONG THE ENTIRE PROJECT LIMITS.
4. PLACE FINAL LIFT OF ASPHALT AND FINAL SURFACE PAVEMENT MARKINGS ALONG THE ENTIRE PROJECT LIMITS.

PHASING NOTES - 87TH STREET COURT NW

1. PLACE ADVANCE WARNING TRAFFIC CONTROL SIGNS AND DEVICES AS SHOWN IN THE TTCP GENERAL NOTES / DETAILS SHEET.
2. PLACE WORK ZONE SIGNS AND CHANNELIZING DEVICES, UTILIZING INDICES 102-600, 102-602, 102-603 AND 102-604 AS REQUIRED.
3. CONSTRUCT STRUCTURES S-800, S-801, S-802, AND S-803 AND THEIR ASSOCIATED PIPES.
3. RECONSTRUCT THE NORTHBOUND LANE OF 87TH STREET COURT NORTHWEST FROM APPROXIMATELY STA. 10+42 - 16+70 UP TO THE FINAL LIFT. MILL THE EXISTING SOUTHBOUND LANE. COMPLETE SODDING OF RESIDENTIAL YARDS AND COORDINATE WITH PROPERTY OWNERS TO RECONSTRUCT DRIVEWAYS AS SHOWN IN THE PLANS. ENSURE DRIVEWAY ACCESS TO ALL RESIDENTIAL PROPERTIES AT ALL TIMES.
4. CONSTRUCT STRUCTURE S-804 AND APPROXIMATELY 11 LF OF PIPE. COVER WITH STEEL PLATES OVERNIGHT AND MAINTAIN ACCESS TO ALL RESIDENTIAL PROPERTIES. CONSTRUCT STRUCTURES S-805, S-806, AND S-807 AND THEIR ASSOCIATED PIPES. MAKE CONNECTION FROM STRUCTURE S-804 TO S-805. COORDINATE WITH PROPERTY OWNERS PRIOR TO WORK AND MAINTAIN ACCESS AT ALL TIMES.
5. PLACE FINAL LIFT OF ASPHALT PAVEMENT.

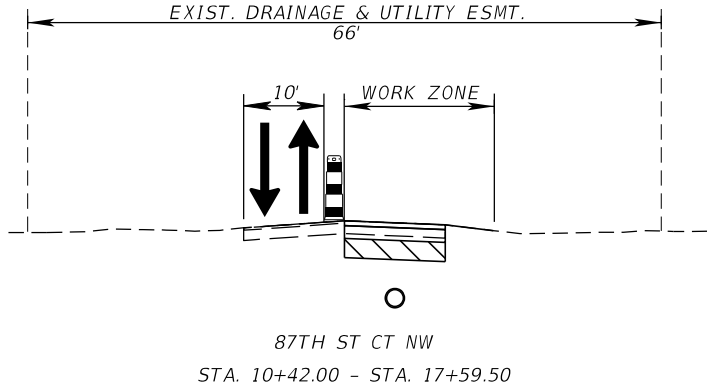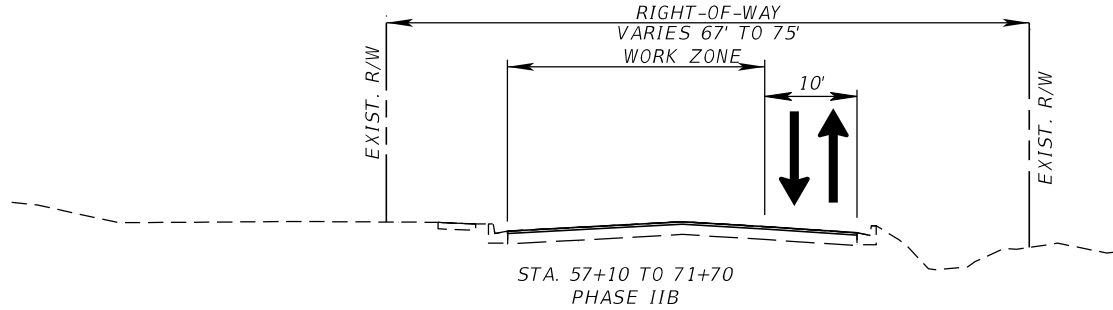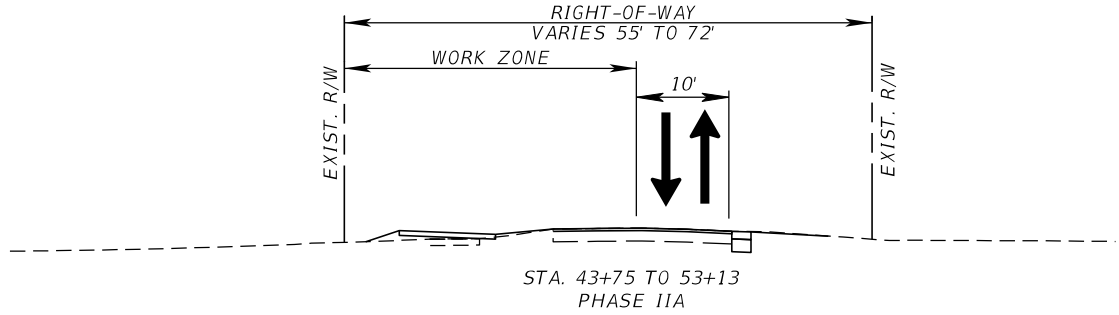
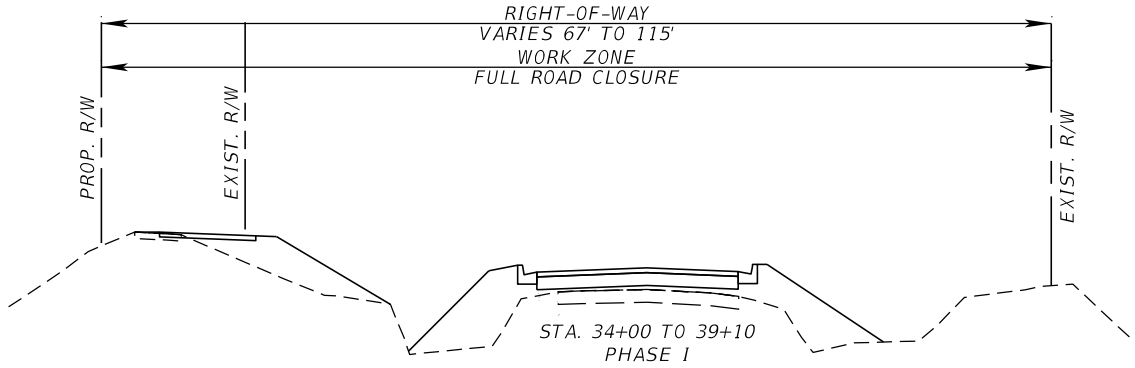


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No.	REVISIONS	DATE	BY		MANATEE COUNTY	FL	DATE:		





PHASE I

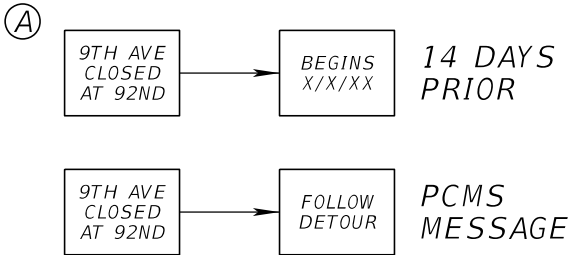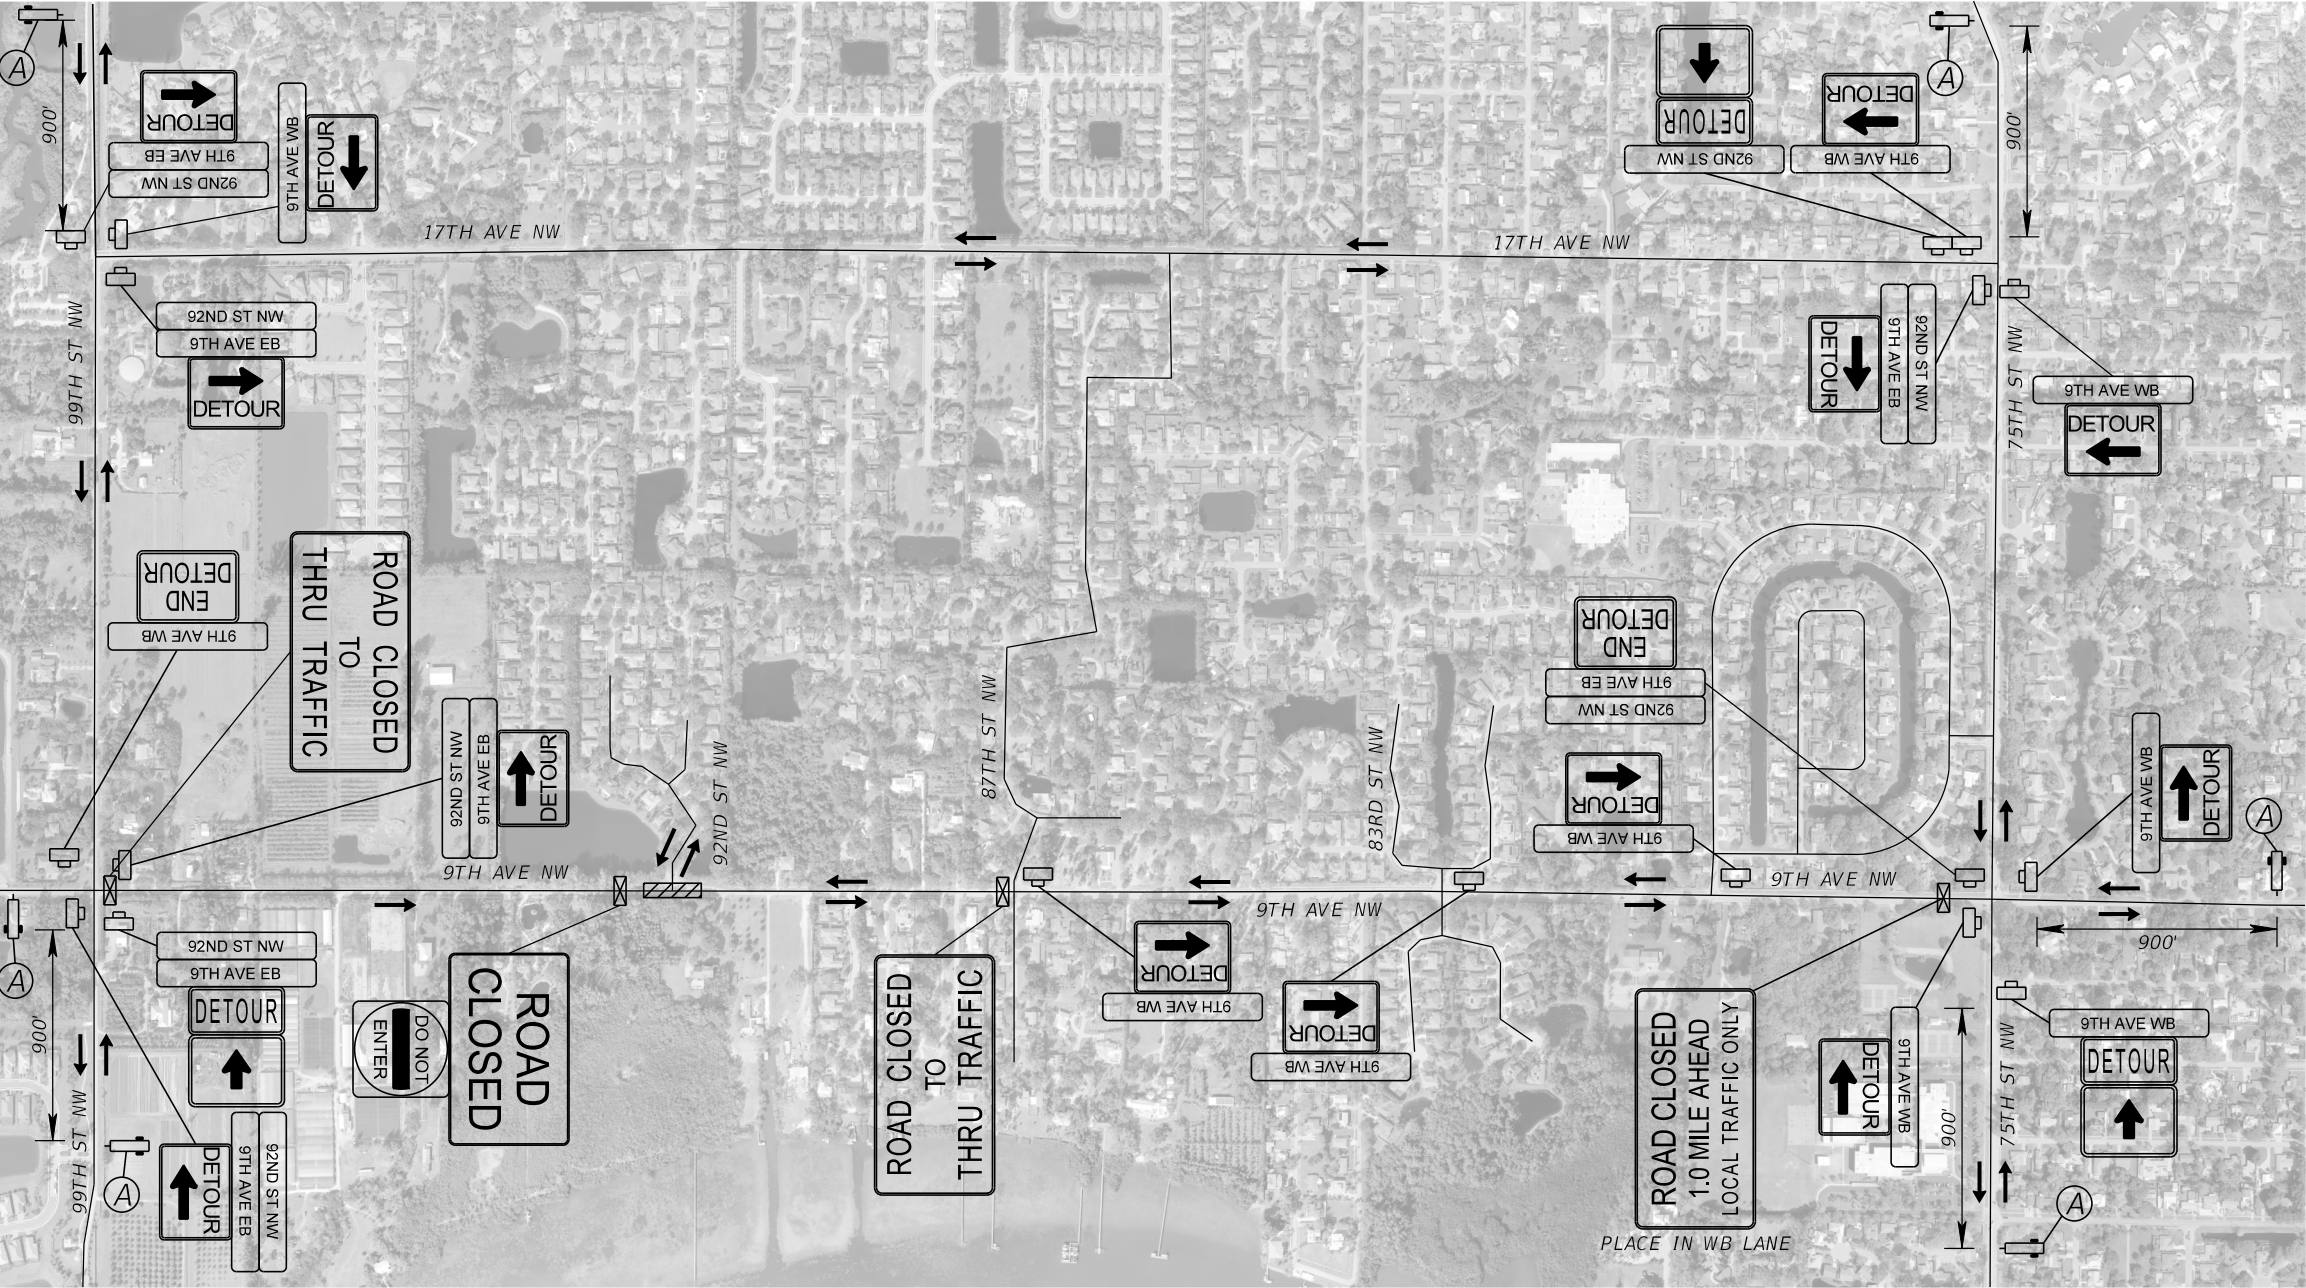

LEGEND	
	WORK ZONE AREA
	WORK ZONE SIGN
	PORTABLE CHANGEABLE (VARIABLE) MESSAGE SIGN
	LANE IDENTIFICATION AND DIRECTION OF TRAFFIC
	TYPE III BARRICADE

No.	REVISIONS	DATE	BY

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KHA PROJECT  
148400070

DATE  
10/02/2025

SCALE AS SHOWN

DESIGNED BY

DRAWN BY

CHECKED BY

9TH AVENUE NW

MANATEE COUNTY

LICENSED PROFESSIONAL

JORDAN E. LEEP, P.E.  
FL LICENSE NUMBER 76102


FL DATE:

DETOUR PLAN  
9TH AVE / 92ND ST

SHEET NUMBER  
100

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PHASE II

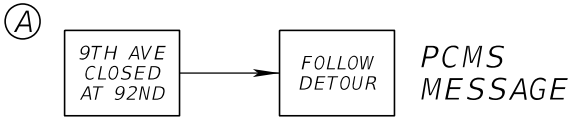

LEGEND	
	WORK ZONE AREA
	WORK ZONE SIGN
	PORTABLE CHANGEABLE (VARIABLE) MESSAGE SIGN
	LANE IDENTIFICATION AND DIRECTION OF TRAFFIC
	TYPE III BARRICADE

No.	REVISIONS	DATE	BY

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KHA PROJECT  
148400070

DATE  
10/02/2025

SCALE AS SHOWN

DESIGNED BY

DRAWN BY

CHECKED BY

9TH AVENUE NW

MANATEE COUNTY

LICENSED PROFESSIONAL

JORDAN E.  
LEEP, P.E.  
FL LICENSE NUMBER  
76102

FL DATE:


DETOUR PLAN  
9TH AVE / 92ND ST






SHEET NUMBER

101
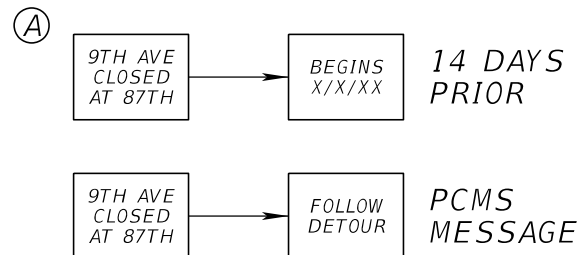
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LEGEND	
	WORK ZONE AREA
	WORK ZONE SIGN
	PORTABLE CHANGEABLE (VARIABLE) MESSAGE SIGN
	LANE IDENTIFICATION AND DIRECTION OF TRAFFIC
	TYPE III BARRICADE

[illegible]

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PHASE II A



LEGEND	
	WORK ZONE AREA
	WORK ZONE SIGN
	LANE IDENTIFICATION AND DIRECTION OF TRAFFIC
	TYPE III BARRICADE

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			<div>DATE 10/02/2025</div>						
			<div>SCALE AS SHOWN</div>						
			<div>DESIGNED BY</div>						
			<div>DRAWN BY</div>						
			<div>CHECKED BY</div>						
No.	REVISIONS	DATE	BY		MANATEE COUNTY	FL	DATE:		

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PHASE II B



NOTE: CONTRACTOR TO MAINTAIN  
LOCAL ACCESS TO 82ND ST NW

LEGEND	
	WORK ZONE AREA
	WORK ZONE SIGN
	PORTABLE CHANGEABLE (VARIABLE) MESSAGE SIGN
	LANE IDENTIFICATION AND DIRECTION OF TRAFFIC
	TYPE III BARRICADE

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No.	REVISIONS	DATE	BY	

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PHASING NOTES: 92ND ST NW PHASE I

1.

PLACE TEMPORARY STRIPING/SIGNAGE AND SHIFT TRAFFIC TO THE PHASE I CONFIGURATION. UTILIZE INDICES 102-600, 102-603, AND 102-604 AS REQUIRED FOR ADVANCE WARNING SIGNAGE SHEET.
2.

CONSTRUCT 6" RECLAIM WATER MAIN RELOCATION.
3.

CONSTRUCT STRUCTURE S-503 AND 55 LF OF 43" X 68" PIPE WEST TOWARDS S-502. CONSTRUCT STRUCTURES S-500, S-500A, AND S-404 WITH THE ASSOCIATED CONCRETE DITCH PAVEMENT BEHIND S-500. MAINTAIN EXISTING FLOWS EAST TOWARDS THE HAWTHORN PARK OUTFALL THROUGHOUT THE DITCH SYSTEM. CONSTRUCT S-404 TO THE 24" PIPE RUN CONSTRUCTED IN THE OVERALL PHASE I OF THE PROJECT. CONSTRUCT STRUCTURES S-405 AND S-406 AND ASSOCIATED PIPE.
4.



CONSTRUCT 27 LF OF 43" X 68" PIPE EAST TOWARDS S-504 FROM S-503. WITHIN THE PROPOSED CONSTRUCTION AREA CONSTRUCT CURBLINE AND WIDENING UP TO THE FINAL LIFT. CONSTRUCT OVERBUILD PAVEMENT WITHIN THE INTERSECTION IN 1.5" LIFTS UP TO THE FINAL LIFT. CONSTRUCT ALL SIDEWALKS, LIGHTING, SODDING, AND EARTHWORK.

TRANSITION CHANNELIZING DEVICES  
@ 10' (TYP.) ALONG 40' RADIUS TO EXIST.  
SOUTHERN EDGE OF PAVEMENT

ROAD  
CLOSED

ROAD  
CLOSED

ROAD  
CLOSED

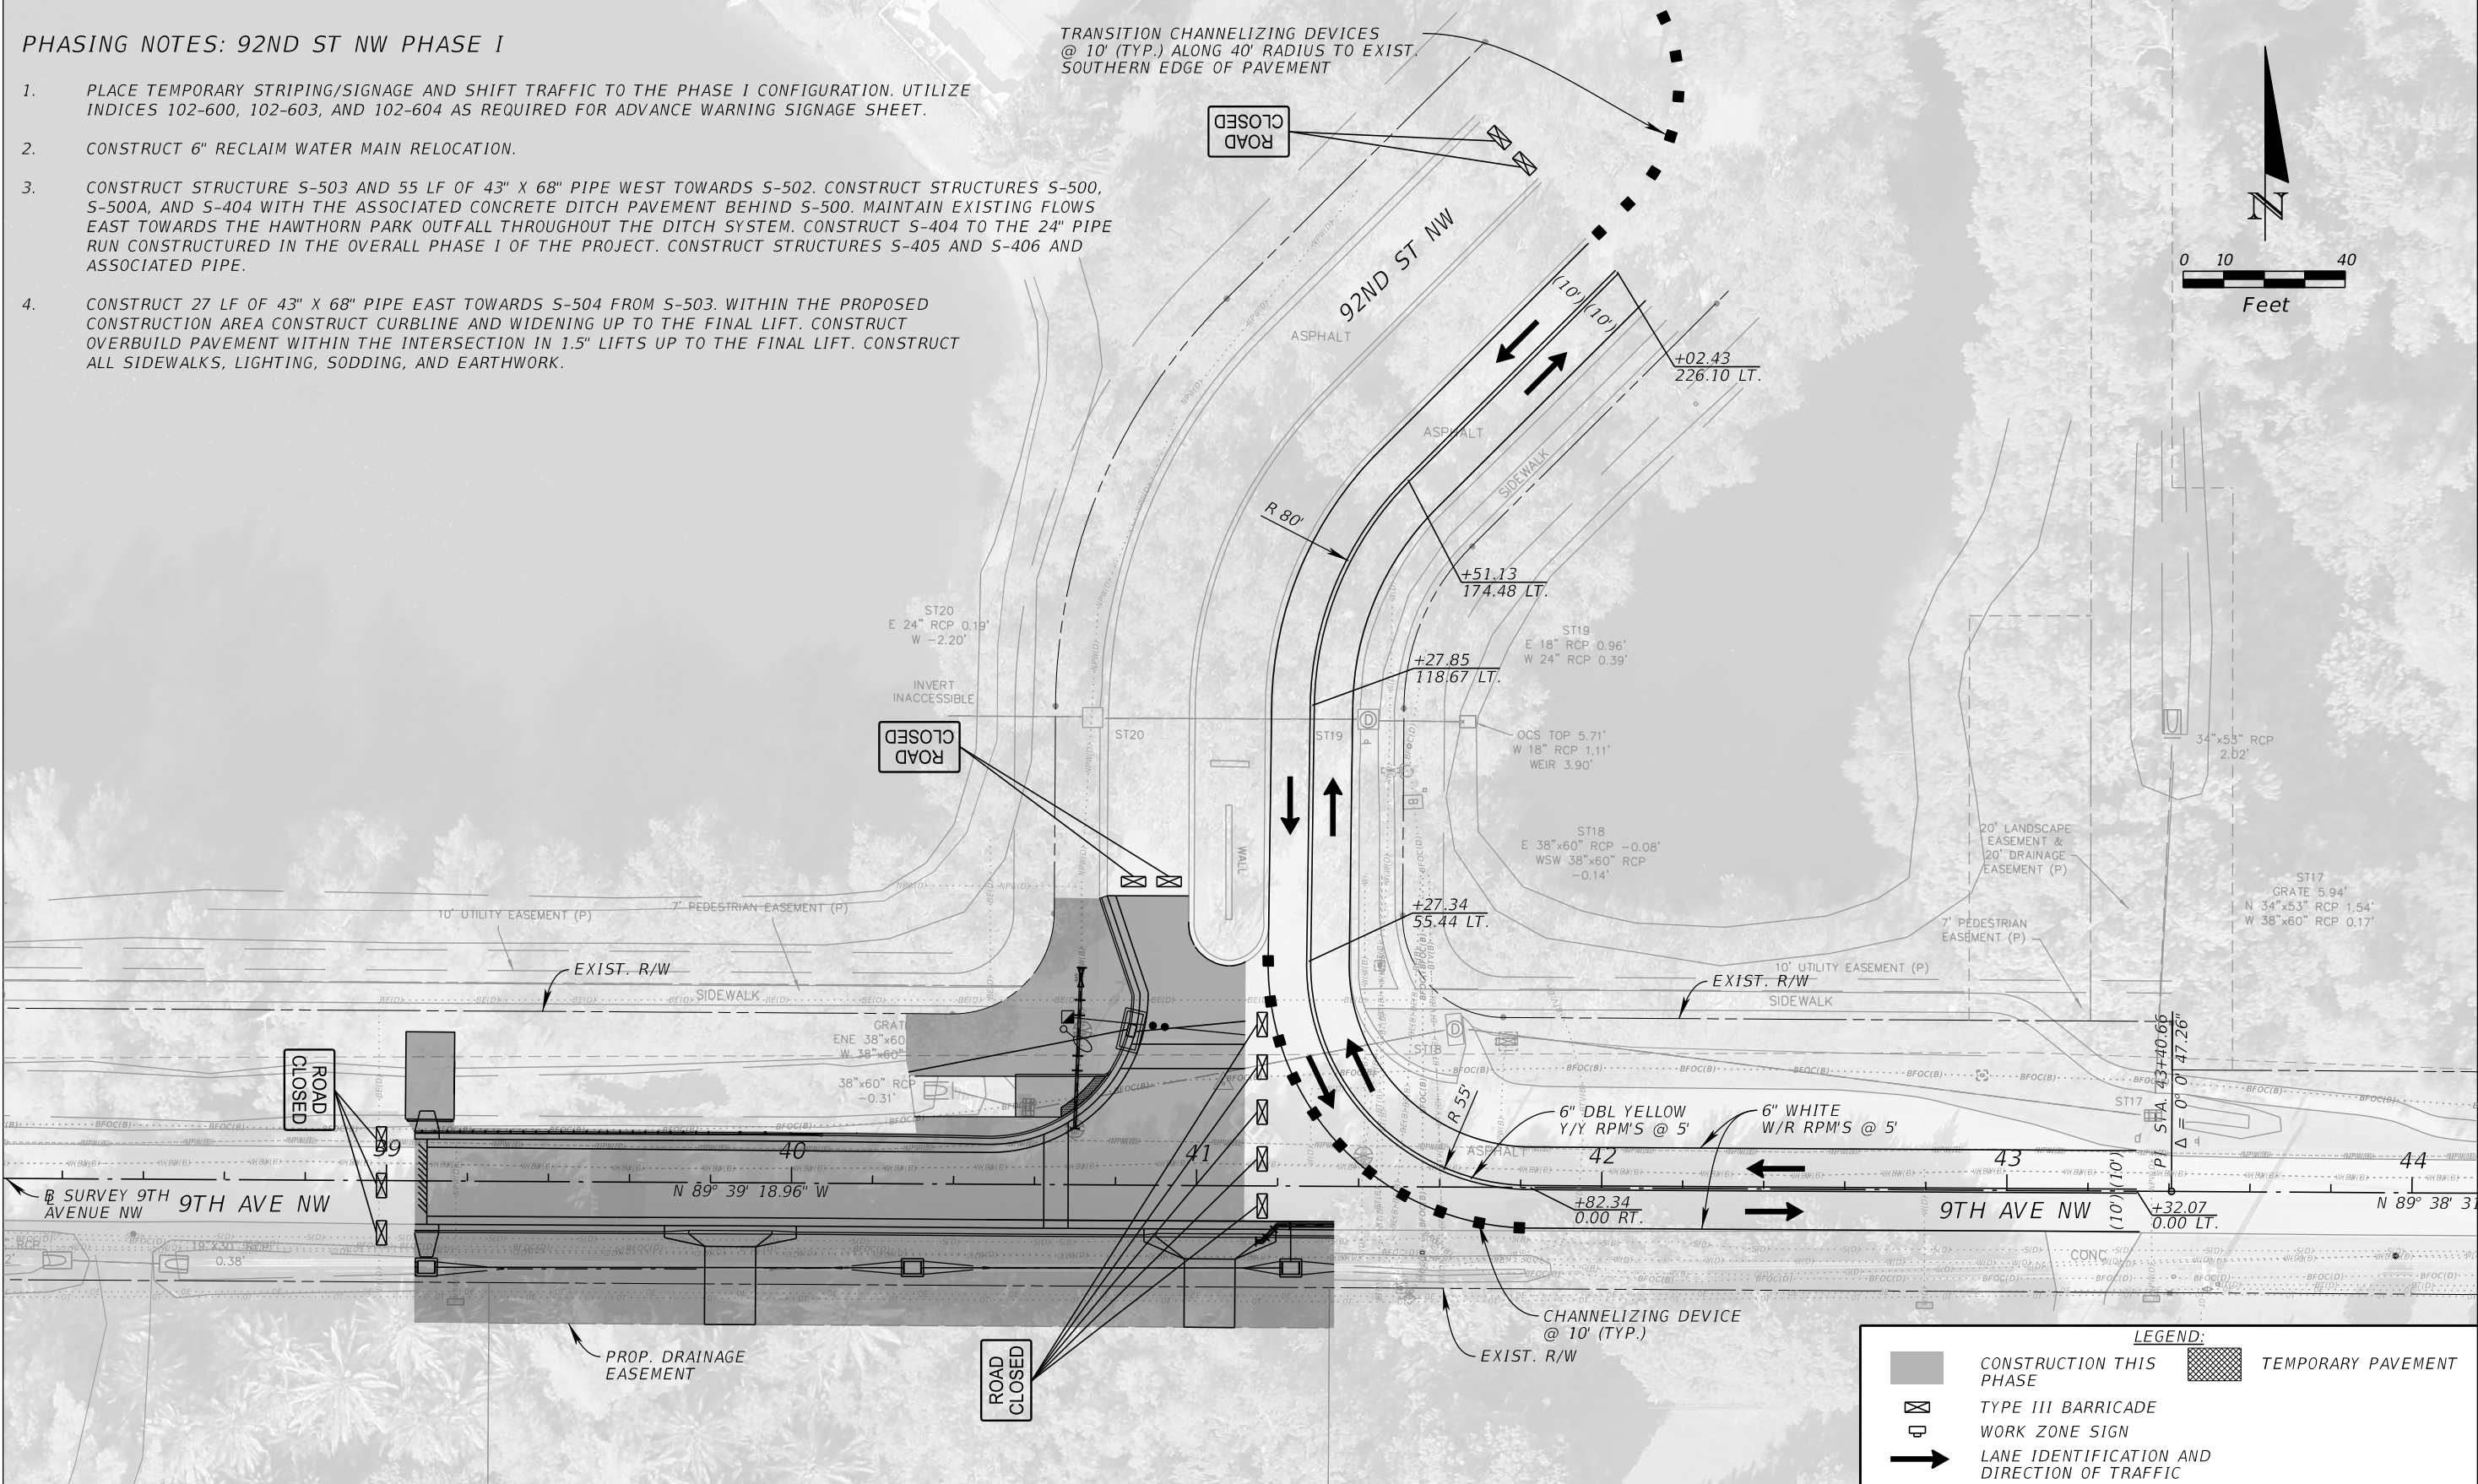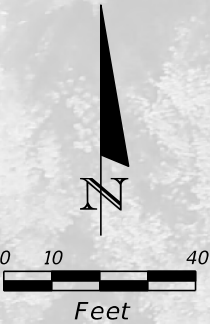

LEGEND:

CONSTRUCTION THIS PHASE

⊗

TYPE III BARRICADE

⓪

WORK ZONE SIGN

➔

LANE IDENTIFICATION AND DIRECTION OF TRAFFIC

TEMPORARY PAVEMENT


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			<div>DATE 10/02/2025</div>						
			<div>SCALE AS SHOWN</div>						
			<div>DESIGNED BY</div>						
			<div>DRAWN BY</div>						
No.	REVISIONS	DATE	BY		<div>CHECKED BY</div>		FL		

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PHASING NOTES: 92ND ST NW PHASE II

1. PLACE TEMPORARY ASPHALT AS DEPICTED IN THE PHASE I TRAFFIC CONTROL PLAN SHEET. PLACE TEMPORARY STRIPING/SIGNAGE AND SHIFT TRAFFIC TO THE PHASE II CONFIGURATION. UTILIZE INDICES 102-600, 102-603, AND 102-604 AS REQUIRED FOR ADVANCE WARNING SIGNAGE SHEET.
2. CONSTRUCT 12" RECLAIM WATER MAIN AND 6" FORCE MAIN RELOCATION.
3. CONSTRUCT REMAINING 18 LF OF 43" X 68" PIPE WEST AND CONSTRUCT/CONNECT INTO S-502. CONSTRUCT S-501 AND ASSOCIATED PIPE RUN. CONSTRUCT STRUCTURES S-504, S-505, AND S-506. WITHIN THE PROPOSED CONSTRUCTION AREA CONSTRUCT 102 LF OF 38" X 60" PIPE FROM S-505 EAST TOWARDS S-508. MAINTAIN EXISTING FLOWS AND MAKE A TEMPORARY CONNECTION INTO THE EXISTING PIPE. CONSTRUCT THE REMAINING 76 LF OF 38" X 60" PIPE AND CONSTRUCT/CONNECT INTO S-508.
4. CONSTRUCT STRUCTURES S-509, S-507, S-407, S-408, AND S-409 AND THEIR ASSOCIATED PIPE RUNS. COMPLETE THE SEDIMENT BASIN CONSTRUCTION AS DETAILED ON THE DRAINAGE DETAILS PLAN SHEET.
5. WITHIN THE PROPOSED CONSTRUCTION AREA CONSTRUCT CURBLINE AND WIDENING UP TO THE FINAL LIFT. CONSTRUCT OVERBUILD PAVEMENT WITHIN THE INTERSECTION IN 1.5" LIFTS UP TO THE FINAL LIFT. CONSTRUCT ALL REMAINING SIDEWALKS, LIGHTING, SODDING, AND EARTHWORK.
6. PLACE FINAL SIGNAGE AND PAINTED PAVEMENT MARKINGS IN FINAL CONFIGURATION PER PAVEMENT MARKING PLAN.



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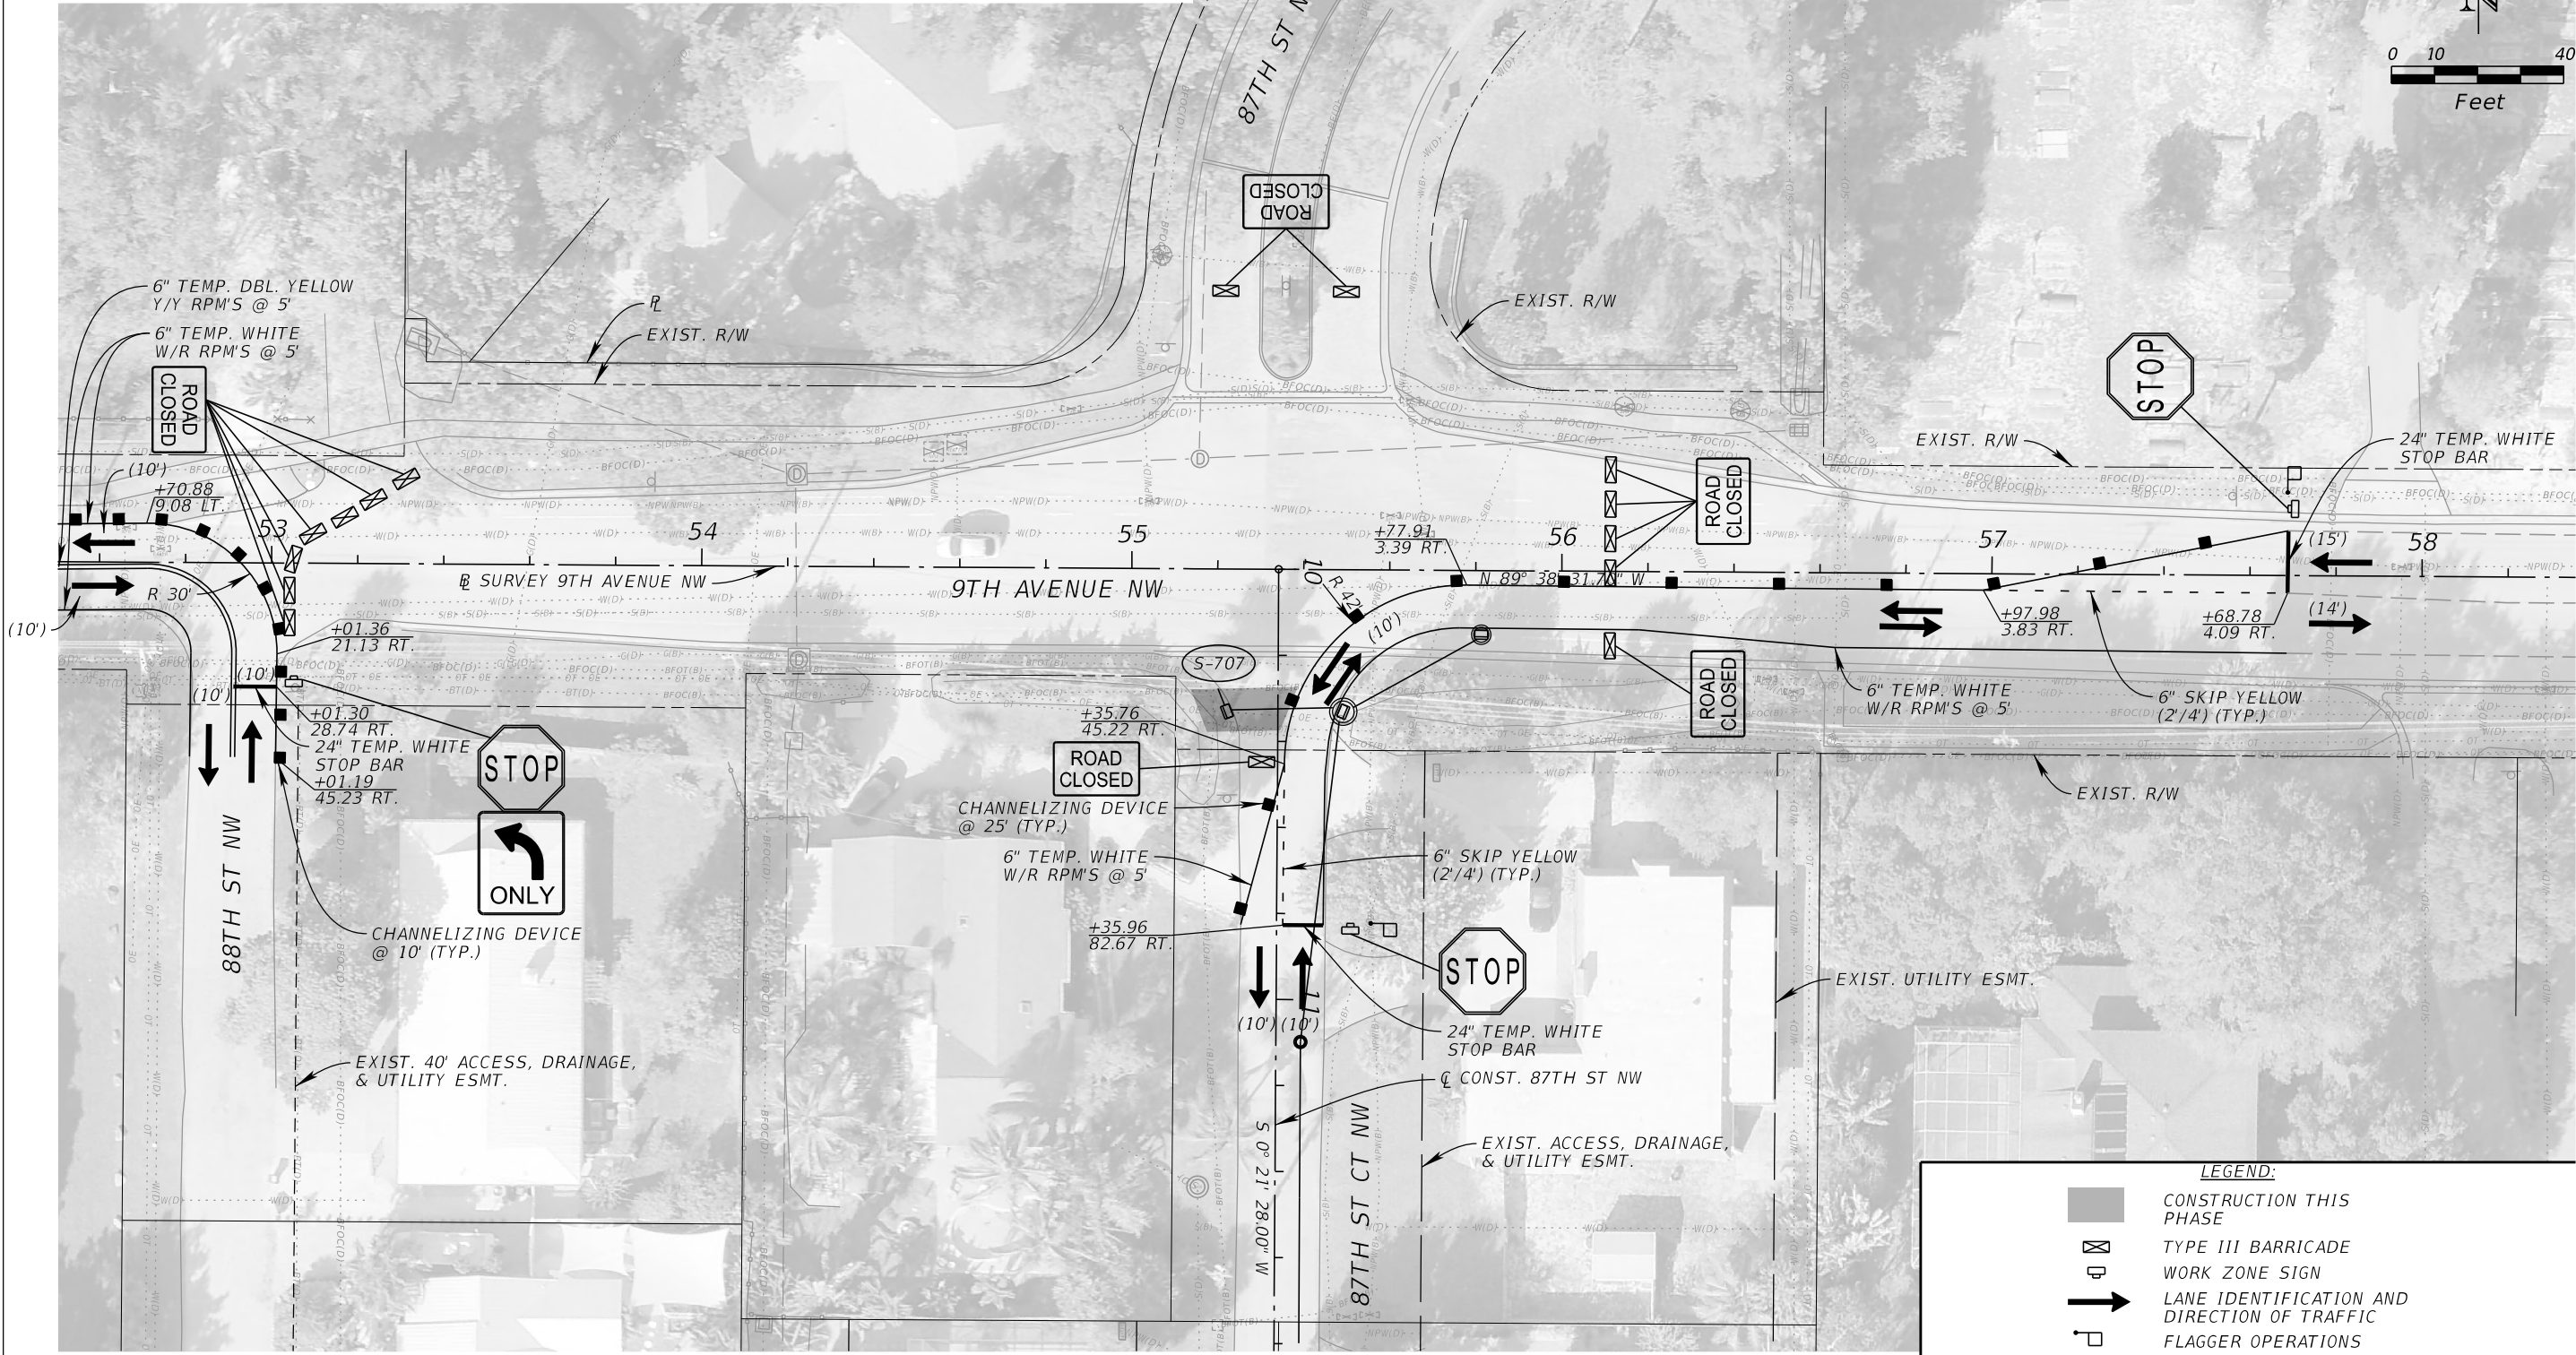
1. PLACE TEMPORARY STRIPING/SIGNAGE, TEMPORARY PAVEMENT, AND SHIFT TRAFFIC TO THE PRE-PHASE A CONFIGURATION. UTILIZE INDICIES 102-600, 102-603, AND 102-604 AS REQUIRED FOR THE ADVANCE WARNING SIGNAGE LAYOUT. MAINTAIN ACCESS TO 87TH ST CT NW AND 88TH ST NW AT ALL TIMES.
2. MAKE PIPE CONNECTION TO COVERED PIPE INSTALLED ALONG 87TH ST CT NW AND CONSTRUCT STRUCTURES S-711 AND S-712. CONSTRUCT PIPE CONNECTION BETWEEN S-712 AND S-711 AND APPROXIMATELY 14 LF OF PIPE TOWARDS S-707. AT THE END OF EACH WORK DAY, CONTRACTOR TO COVER ANY DROP-OFF CONDITIONS IN ACCORDANCE WITH INDEX 102-600 AND MAINTAIN TWO 10-FT LANES IN ALL DIRECTIONS.

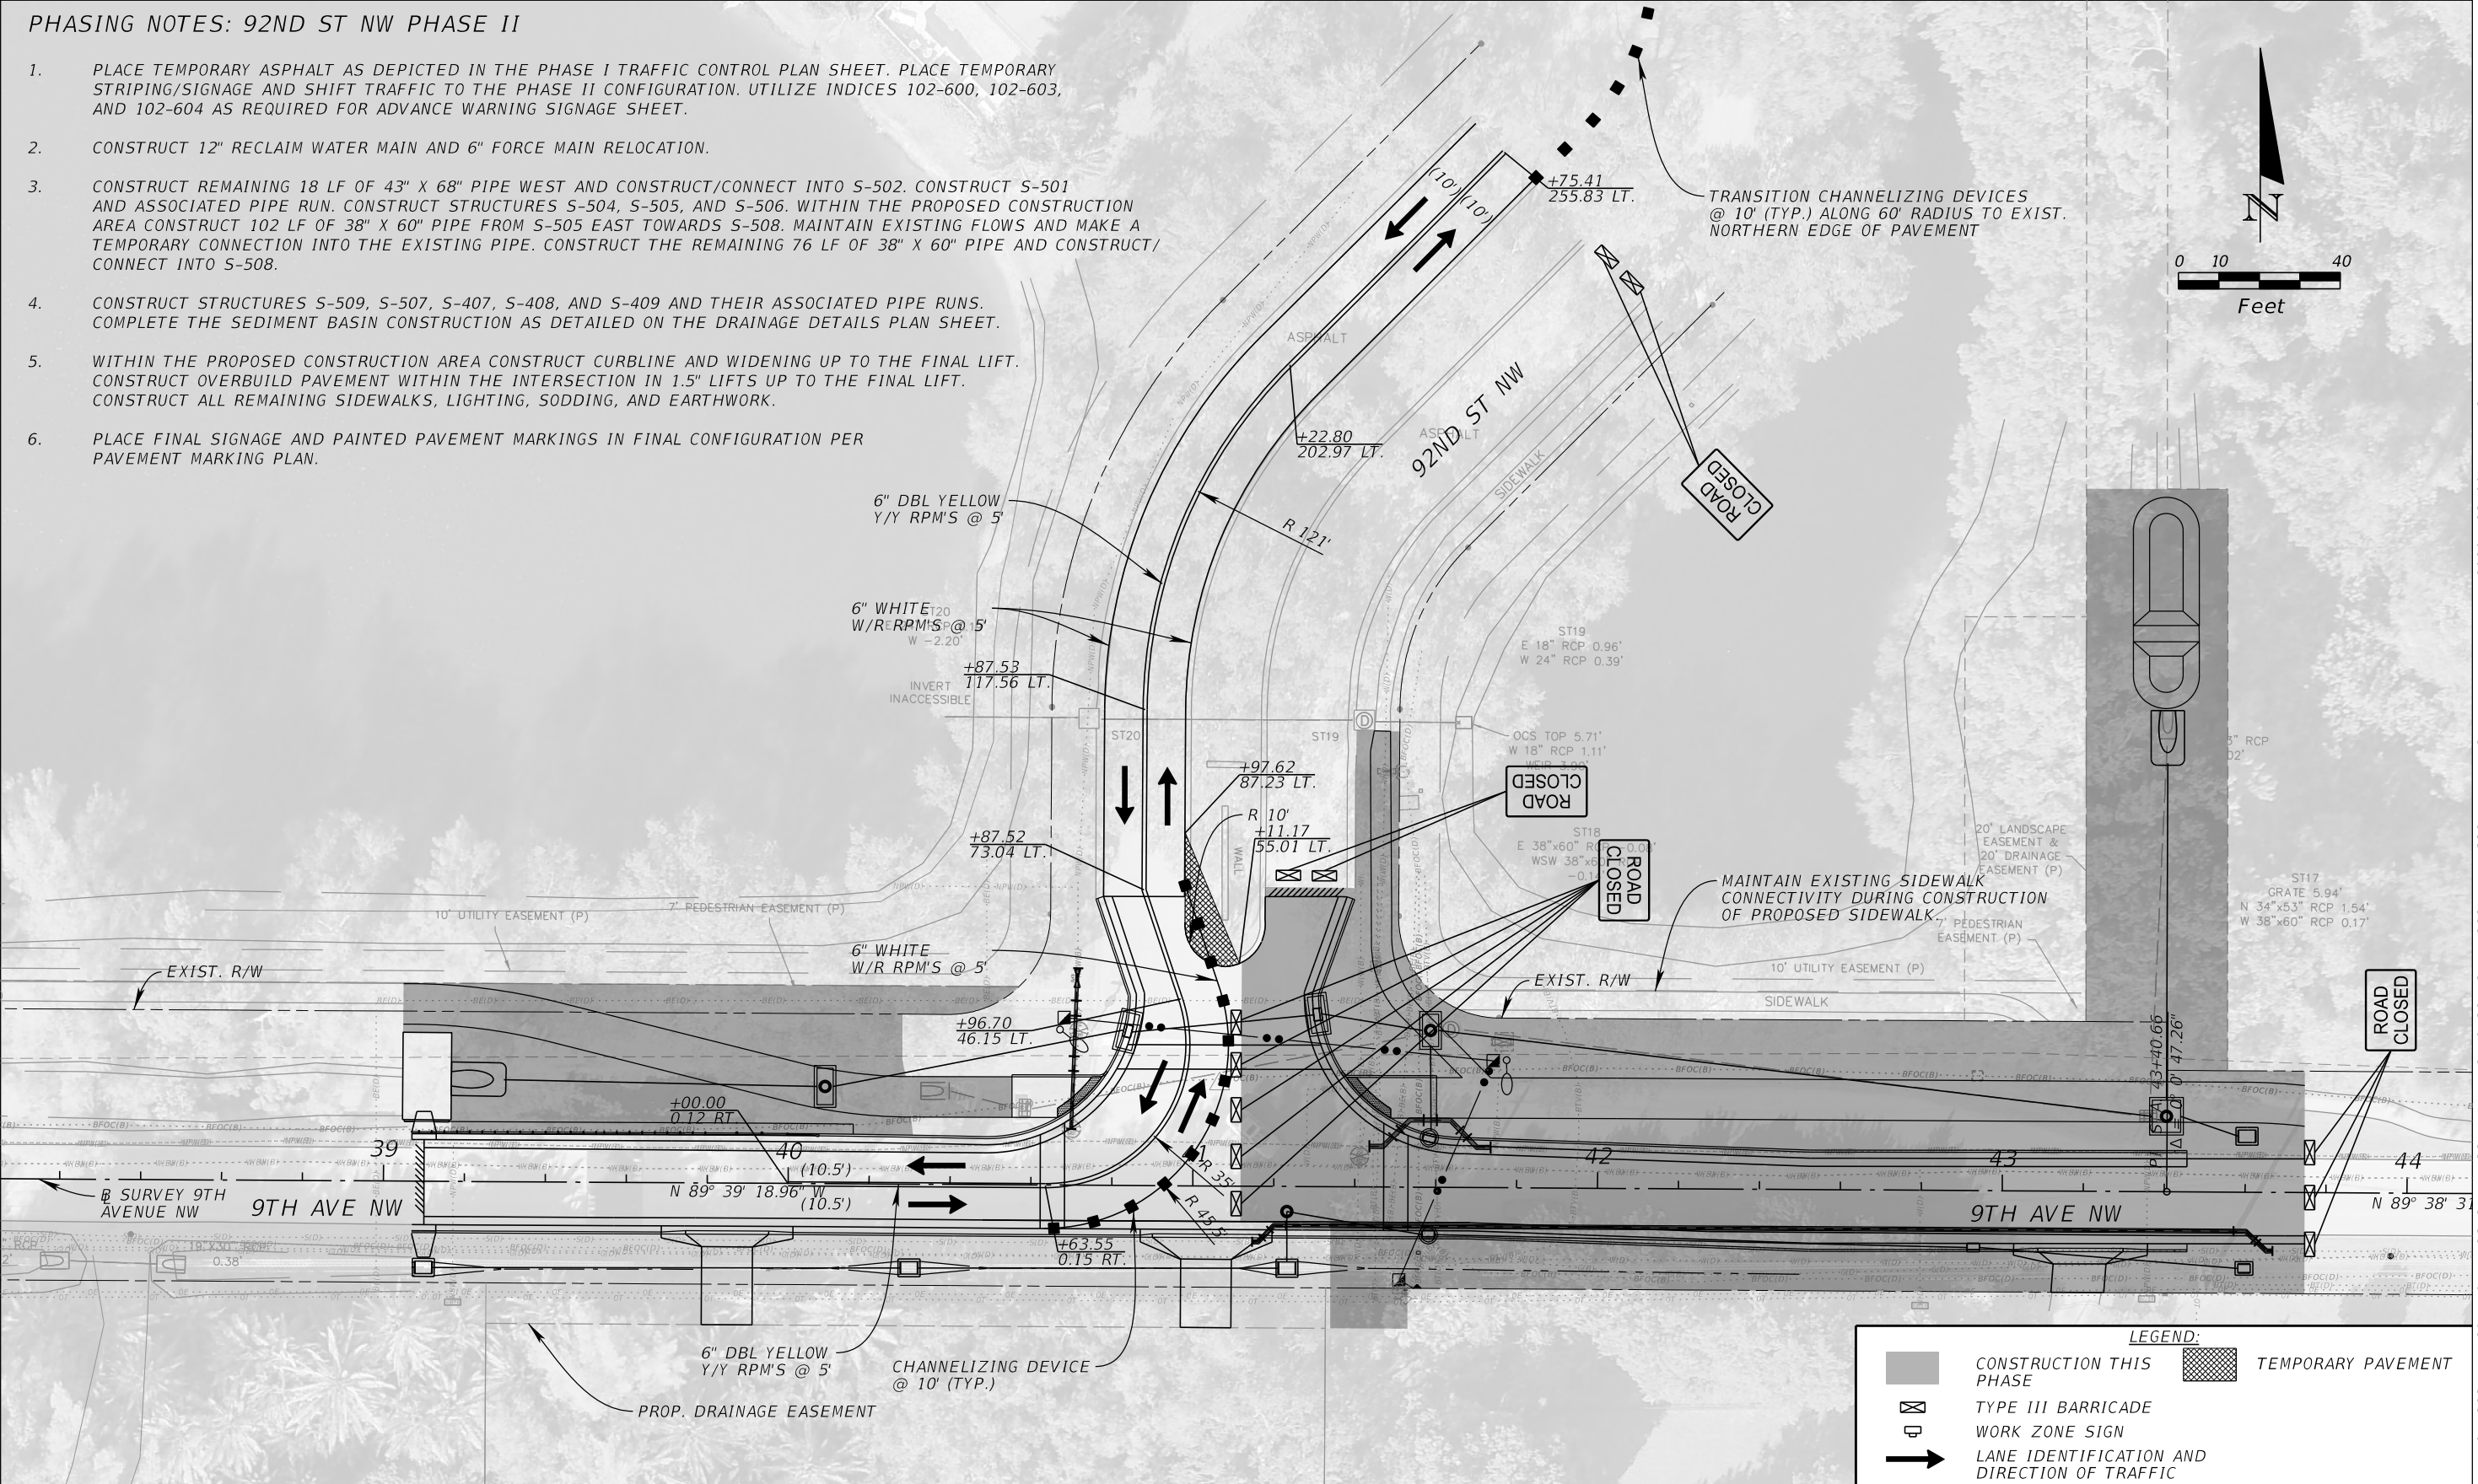



PHASING NOTES: 87TH ST NW PRE-PHASE B

1.
- PLACE TEMPORARY STRIPING/SIGNAGE AND SHIFT TRAFFIC TO THE PRE-PHASE B CONFIGURATION. UTILIZE INDICIES 102-600, 102-603, AND 102-604 AS REQUIRED FOR THE ADVANCE WARNING SIGNAGE LAYOUT. MAINTAIN ACCESS TO 87TH ST CT NW AND 88TH ST NW AT ALL TIMES.
2.
- CONSTRUCT APPROXIMATELY 14 LF OF PIPE AND CONSTRUCT STRUCTURE S-707. CONSTRUCT APPROXIMATELY 5 LF OF PIPE FROM S-707 TOWARDS S-706. AT THE END OF EACH WORK DAY, CONTRACTOR TO COVER ANY DROP-OFF CONDITIONS IN ACCORDANCE WITH INDEX 102-600 AND MAINTAIN TWO 10-FT LANES IN ALL DIRECTIONS.




PHASING NOTES: 87TH ST NW PHASE I

1.

PLACE TEMPORARY STRIPING/SIGNAGE AND SHIFT TRAFFIC TO THE PHASE I CONFIGURATION. UTILIZE INDICIES 102-600, 102-603, AND 102-604 AS REQUIRED FOR THE ADVANCE WARNING SIGNAGE LAYOUT. MAINTAIN ACCESS TO 87TH ST CT NW AT ALL TIMES.
2.

CONSTRUCT APPROXIMATELY 14 LF OF PIPE TO CONSTRUCT STRUCTURE S-706 AND MAKE CONNECTION. CONSTRUCT APPROXIMATELY 17 LF OF PIPE FROM S-706 TOWARDS S-705.
3.

PLACE TEMPORARY LOW PROFILE BARRIER PARALLEL TO PROPOSED FORCE MAIN RELOCATION. CONSTRUCT 6" FORCE MAIN RELOCATION WITHIN THE WORK ZONE SHAPE. AT THE END OF EACH WORK DAY, CONTRACTOR TO USE STEEL PLATES OR ANOTHER METHOD APPROVED BY THE ENGINEER TO COVER ANY DROP-OFF CONDITIONS IN THE CLEAR ZONE PER INDEX 102-600. BEGIN RELOCATION NEAR THE EAST CONNECTION TO THE FORCE MAIN. MAINTAIN TWO 10-FT LANES IN ALL DIRECTIONS AT THE END OF EACH WORK DAY.

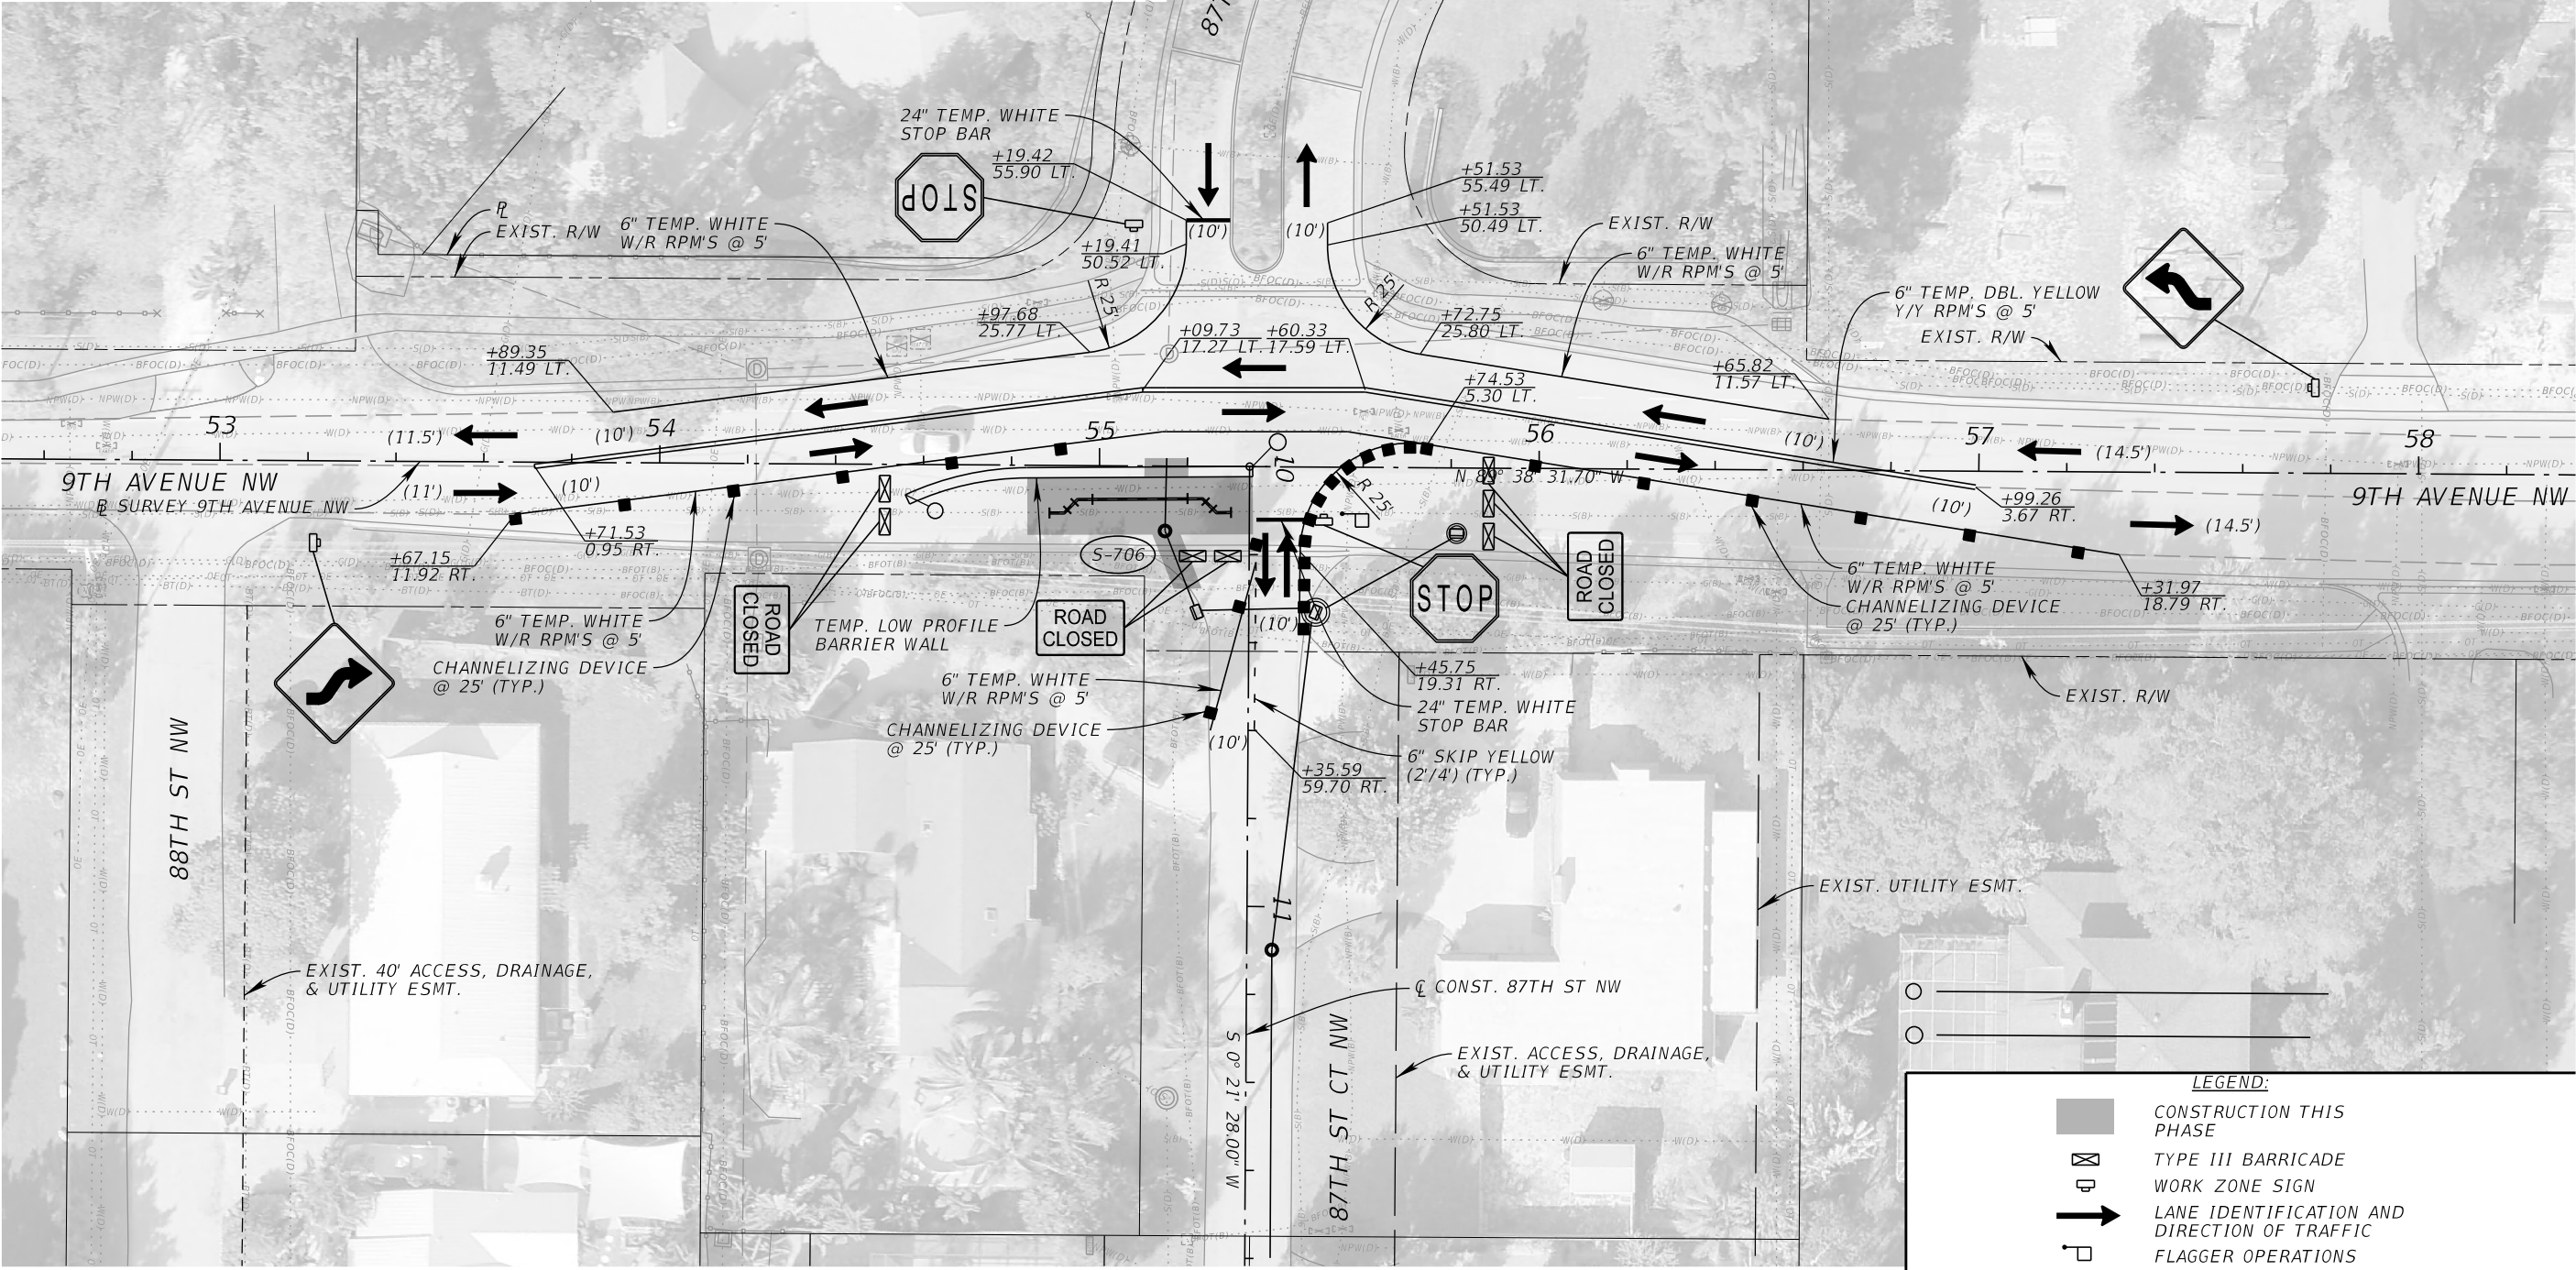

**LEGEND:**

	CONSTRUCTION THIS PHASE
	TYPE III BARRICADE
	WORK ZONE SIGN
	LANE IDENTIFICATION AND DIRECTION OF TRAFFIC
	FLAGGER OPERATIONS


				<div>Kimley»Horn</div> <div>© 2025 KIMLEY-HORN AND ASSOCIATES, INC. 1800 SECOND STREET, SUITE 900, SARASOTA, FL 34236 PHONE: 941-379-7600 WWW.KIMLEY-HORN.COM</div>	<div>KHA PROJECT 148400070</div>	<div></div> <div>9TH AVENUE NW</div> <div>MANATEE COUNTY</div>	<div>LICENSED PROFESSIONAL</div> <div>JORDAN E. LEEP, P.E.</div> <div>FL LICENSE NUMBER 76102</div>	<div>TEMP TRAFFIC CONTROL</div> <div>87TH ST. - PHASE I</div>	<div>SHEET NUMBER</div> <div>109</div>
			<div>DATE 10/02/2025</div>						
			<div>SCALE AS SHOWN</div>						
			<div>DESIGNED BY</div>						
			<div>DRAWN BY</div>						
			<div>CHECKED BY</div>						
No.	REVISIONS	DATE	BY				FL		

THE OFFICIAL RECORD OF THIS SHEET IS THE ELECTRONIC FILE DIGITALLY SIGNED AND SEALED UNDER RULE 61G15-23.004, F.A.C.



PHASING NOTES: 87TH ST NW PHASE II A

1. PLACE TEMPORARY STRIPING/SIGNAGE AND SHIFT TRAFFIC TO THE PHASE II A CONFIGURATION. UTILIZE INDICIES 102-600, 102-603, AND 102-604 AS REQUIRED FOR THE ADVANCE WARNING SIGNAGE LAYOUT. MAINTAIN ACCESS TO 87TH ST CT NW AT ALL TIMES.
2. CONSTRUCT STRUCTURES S-702, S-703, S-704, S-705, S-708, S-709, AND S-710. CONSTRUCT ALL ASSOCIATED PIPES WITH STRUCTURES AND APPROXIMATELY 29 LF OF PIPE TO MAKE CONNECTION TO S-705. CONSTRUCT APPROXIMATELY 10 LF FROM S-703 TOWARDS S-701.
3. CONSTRUCT 8" WATER MAIN RELOCATION WITHIN THE WORK ZONE SHAPE. AT THE END OF EACH WORK DAY, CONTRACTOR TO USE STEEL PLATES OR ANOTHER METHOD APPROVED BY THE ENGINEER TO COVER ANY DROP-OFF CONDITIONS IN THE CLEAR ZONE PER INDEX 102-600. MAINTAIN TWO 10-FT LANES IN ALL DIRECTIONS AT THE END OF EACH WORK DAY.
4. CONSTRUCT CURBLINE AND WIDENING WITHIN THE WORK ZONE SHAPE UP TO THE FINAL LIFT. CONSTRUCT OVERBUILD PAVEMENT WITHIN THE INTERSECTION IN 1.5" LIFTS UP TO, BUT NOT INCLUDING THE FINAL LIFT. CONSTRUCT ALL SIDEWALKS, LIGHTING, SODDING, AND EARTHWORK WITHIN THE WORK ZONE SHAPE.

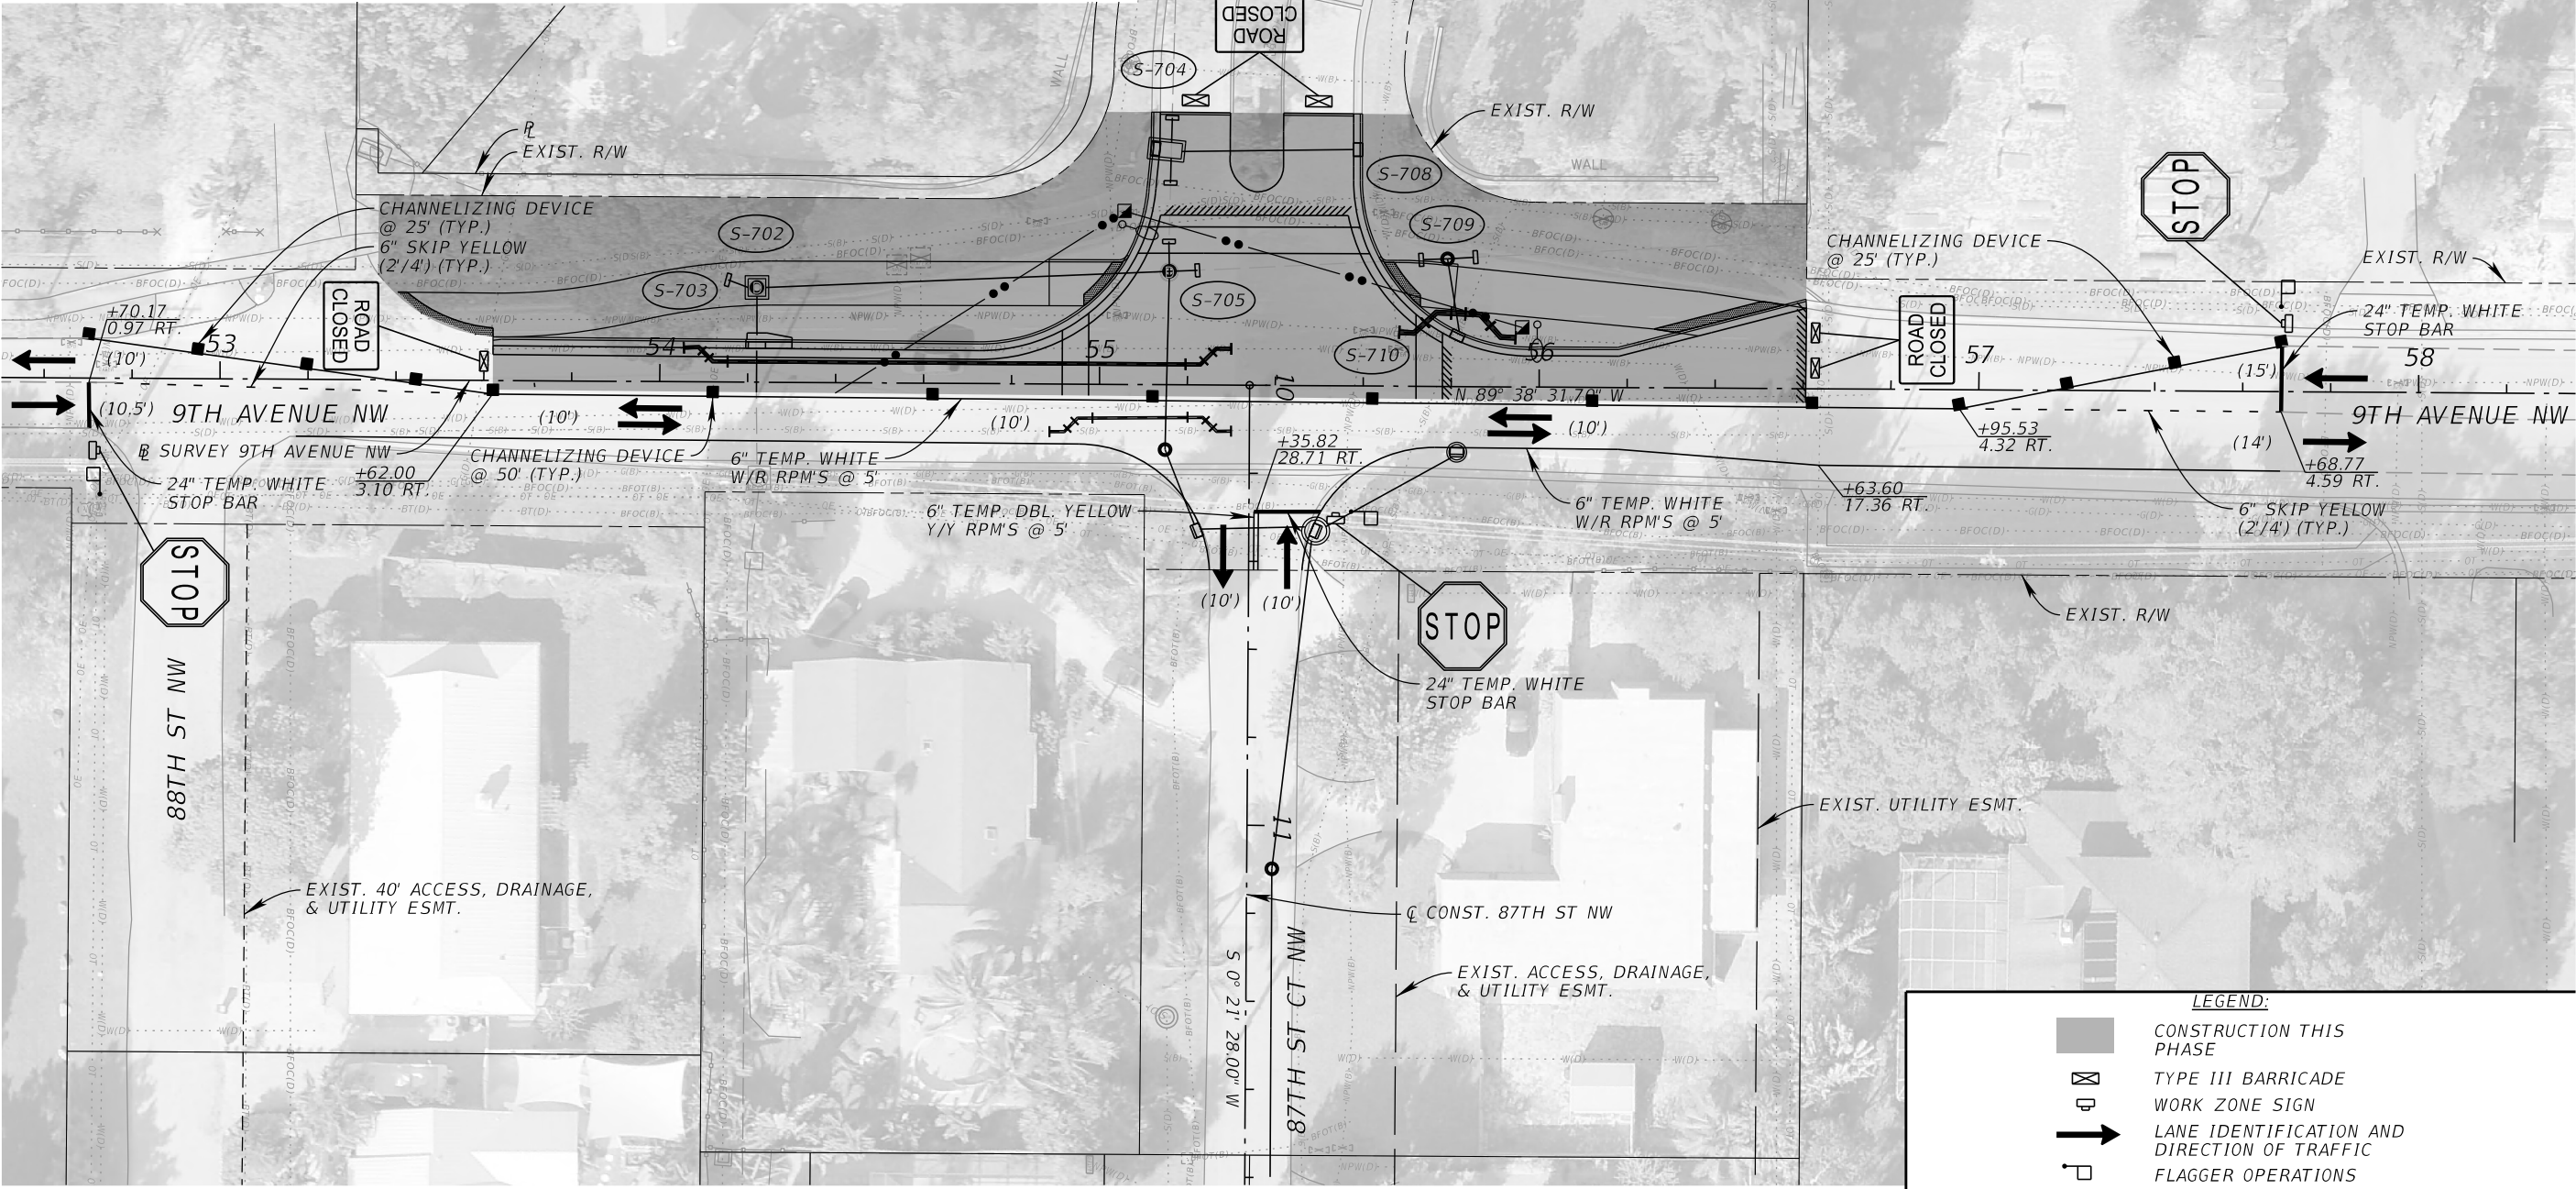

LEGEND:

CONSTRUCTION THIS PHASE

TYPE III BARRICADE

WORK ZONE SIGN

LANE IDENTIFICATION AND DIRECTION OF TRAFFIC

FLAGGER OPERATIONS

No.	REVISIONS	DATE	BY

**Kimley»Horn**

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PHONE: 941-379-7600  
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KHA PROJECT  
148400070

DATE  
10/02/2025

SCALE AS SHOWN

DESIGNED BY

DRAWN BY

CHECKED BY

Manatee County  
FLORIDA

9TH AVENUE NW

MANATEE COUNTY

LICENSED PROFESSIONAL

JORDAN E. LEEP, P.E.  
FL LICENSE NUMBER 76102

FL DATE:

TEMP TRAFFIC CONTROL

87TH ST. - PHASE II A

SHEET NUMBER

110

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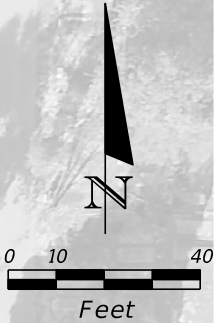
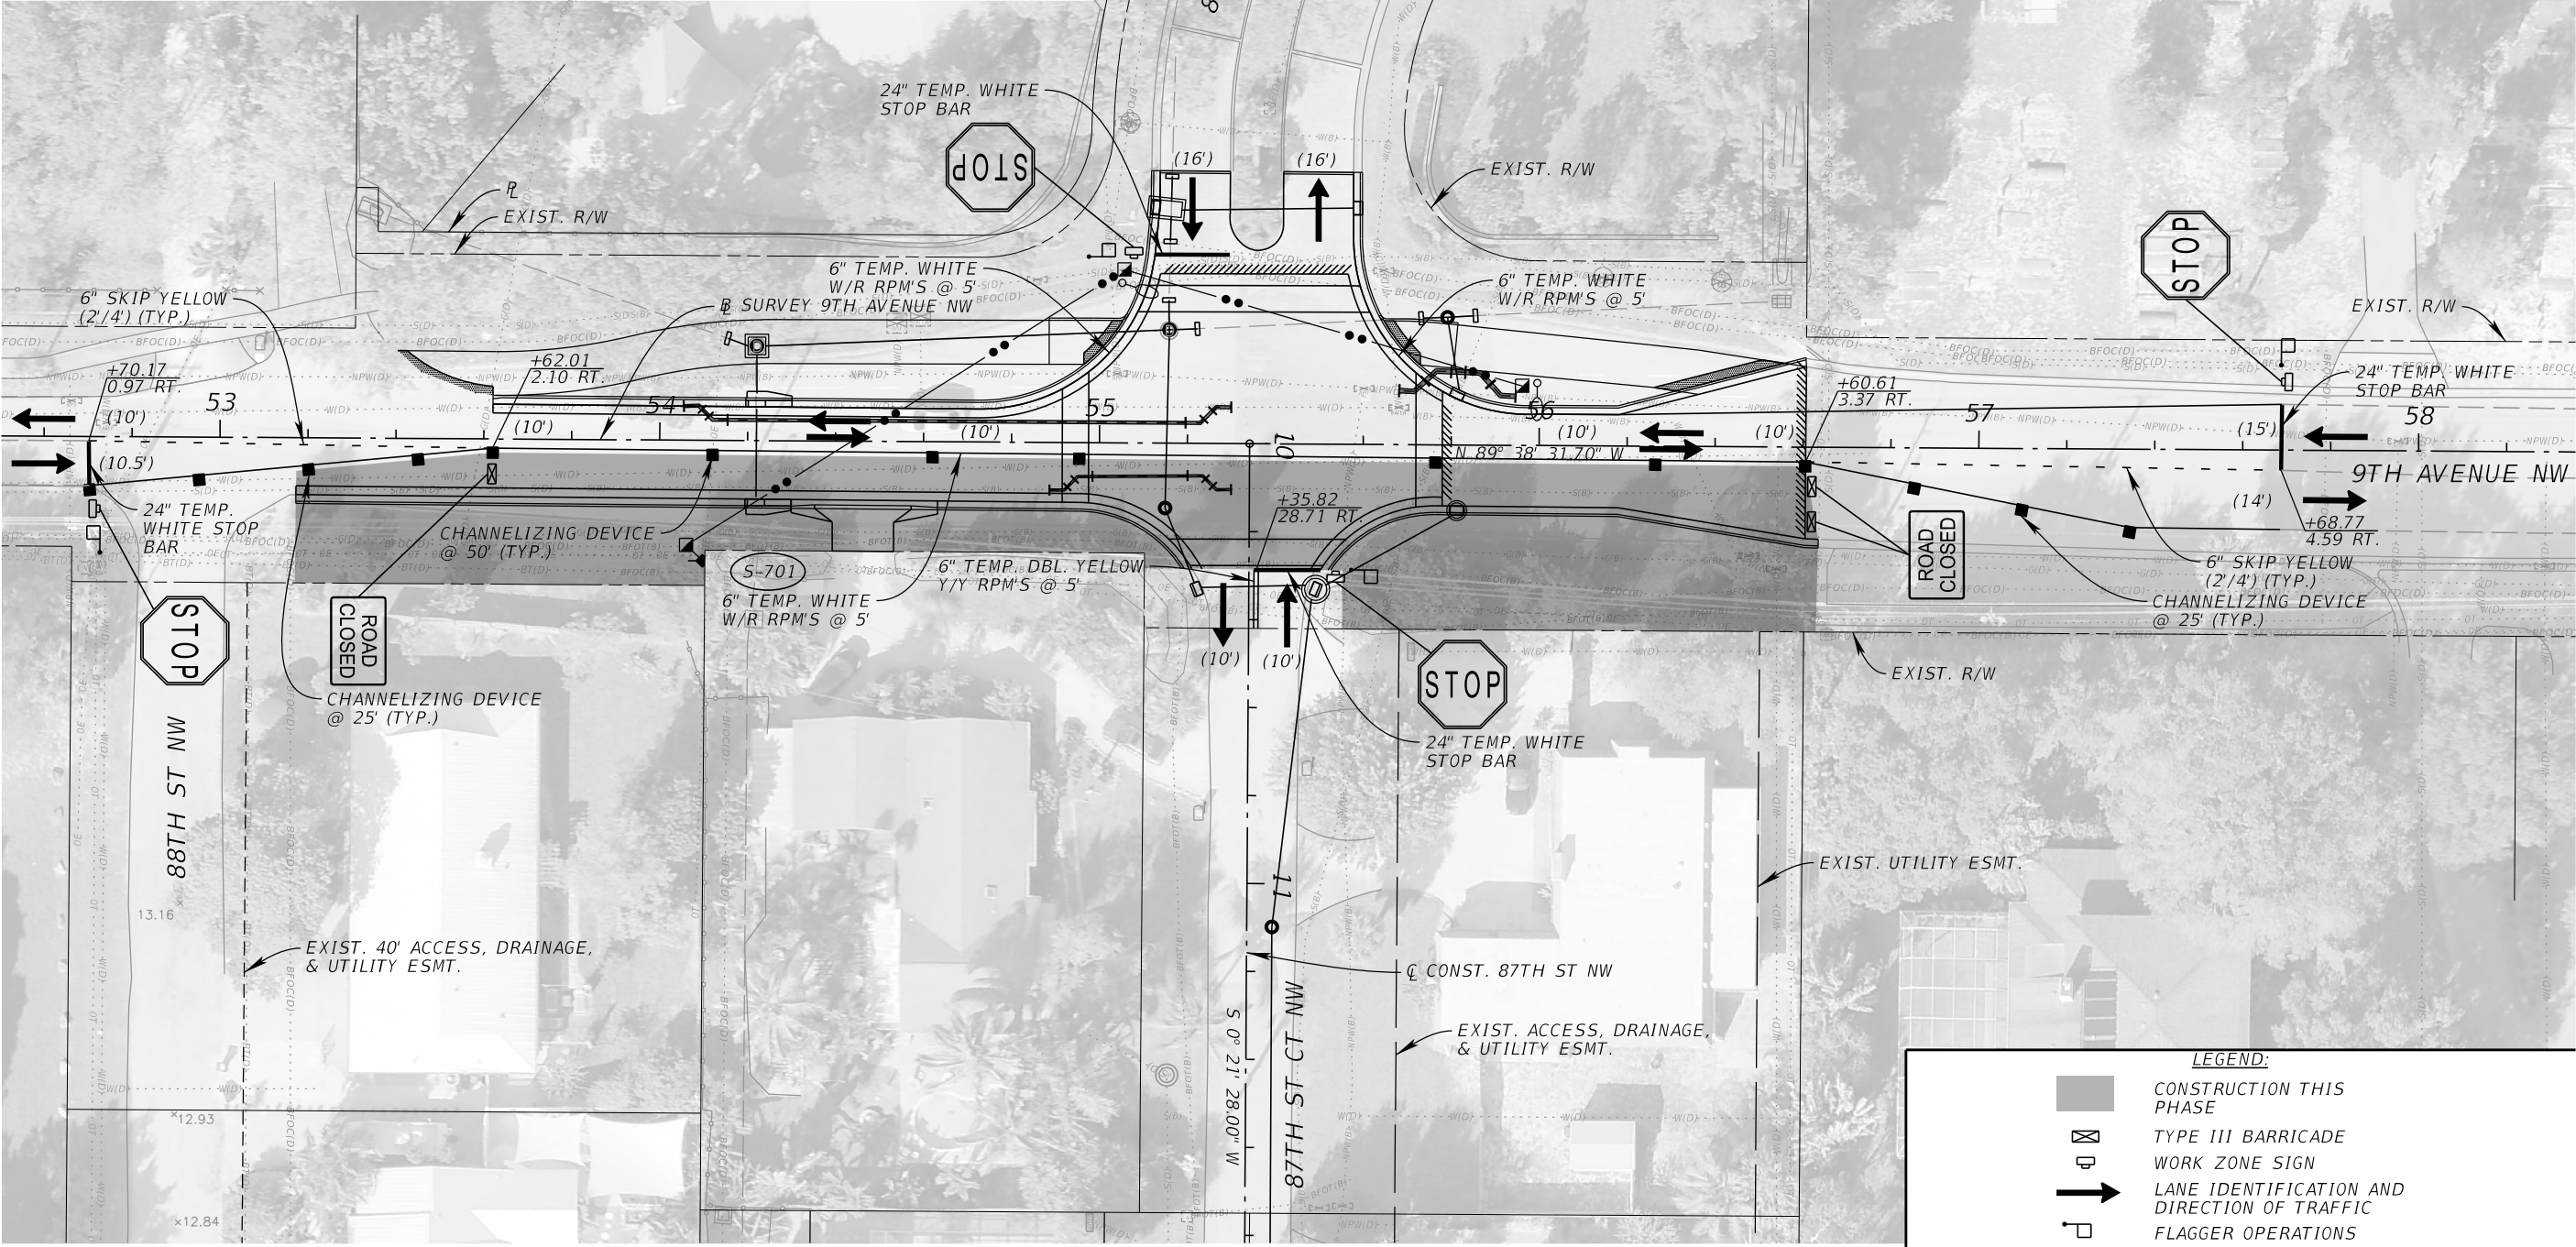
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THE OFFICIAL RECORD OF THIS SHEET IS THE ELECTRONIC FILE DIGITALLY SIGNED AND SEALED UNDER RULE 61G15-23.004, F.A.C.



PHASING NOTES: 87TH ST NW PHASE II B

1. PLACE TEMPORARY STRIPING/SIGNAGE AND SHIFT TRAFFIC TO THE PHASE II B CONFIGURATION. UTILIZE INDICIES 102-600, 102-603, AND 102-604 AS REQUIRED FOR THE ADVANCE WARNING SIGNAGE LAYOUT. MAINTAIN ACCESS TO 87TH ST CT NW AND 88TH ST NW AT ALL TIMES.
2. CONSTRUCT APPROXIMATELY 10 LF OF PIPE TO CONSTRUCT STRUCTURE S-701. CONSTRUCT CURBLINE AND WIDENING WITHIN THE WORK ZONE SHAPE UP TO THE FINAL LIFT. CONSTRUCT OVERBUILD PAVEMENT WITHIN THE INTERSECTION IN 1.5" LIFTS UP TO, BUT NOT INCLUDING THE FINAL LIFT. CONSTRUCT ALL SIDEWALKS, LIGHTING, SODDING, AND EARTHWORK WITHIN THE WORK ZONE SHAPE. AT THE END OF EACH WORK DAY, CONTRACTOR TO PROTECT ALL DROP-OFF CONDITIONS AND UTILIZE COMPLIANT SLOPES WITHIN THE CLEAR ZONE.
3. PLACE FINAL SIGNAGE AND PAINTED PAVEMENT MARKINGS IN FINAL CONFIGURATION PER PAVEMENT MARKING PLAN.



LEGEND:

CONSTRUCTION THIS PHASE

TYPE III BARRICADE

WORK ZONE SIGN

LANE IDENTIFICATION AND DIRECTION OF TRAFFIC

FLAGGER OPERATIONS

No.	REVISIONS	DATE	BY

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9TH AVENUE NW

LICENSED PROFESSIONAL

JORDAN E. LEEP, P.E.  
FL LICENSE NUMBER 76102

FL DATE:

TEMP TRAFFIC CONTROL

87TH ST. - PHASE II B

SHEET NUMBER

111

Susan.Pluta


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THE OFFICIAL RECORD OF THIS SHEET IS THE ELECTRONIC FILE DIGITALLY SIGNED AND SEALED UNDER RULE 61G15-23.004, F.A.C.

PHASING NOTES: 83RD ST NW PHASE I A

1.
- PLACE TEMPORARY STRIPING/SIGNAGE AND SHIFT TRAFFIC TO THE PHASE I A CONFIGURATION. UTILIZE INDICIES 102-600, 102-603, AND 102-604 AS REQUIRED FOR THE ADVANCED WARNING SIGNAGE LAYOUT. MAINTAIN ACCESS TO THE 83RD ST NW AND 82ND ST NW AT ALL TIMES.
2.
- CONSTRUCT STRUCTURES S-1104, S-1105, AND S-1107 AND THEIR ASSOCIATED PIPE CONNECTIONS. CONSTRUCT APPROXIMATELY 28 LF OF PIPE FROM STRUCTURE S-1105 TOWARDS STRUCTURE S-1101. CONSTRUCT APPROXIMATELY 36 LF OF PIPE FROM STRUCTURE S-1104 TOWARDS STRUCTURE S-1103. AT THE END OF THE WORK DAY, CONTRACTOR TO COVER ANY DROP-OFF CONDITIONS IN ACCORDANCE WITH INDEX 102-600 AND MAINTAIN TWO 10-FT LANES IN ALL DIRECTIONS.



- LEGEND:
- CONSTRUCTION THIS PHASE
  - TYPE III BARRICADE
  - WORK ZONE SIGN
  - LANE IDENTIFICATION AND DIRECTION OF TRAFFIC
  - FLAGGER OPERATIONS

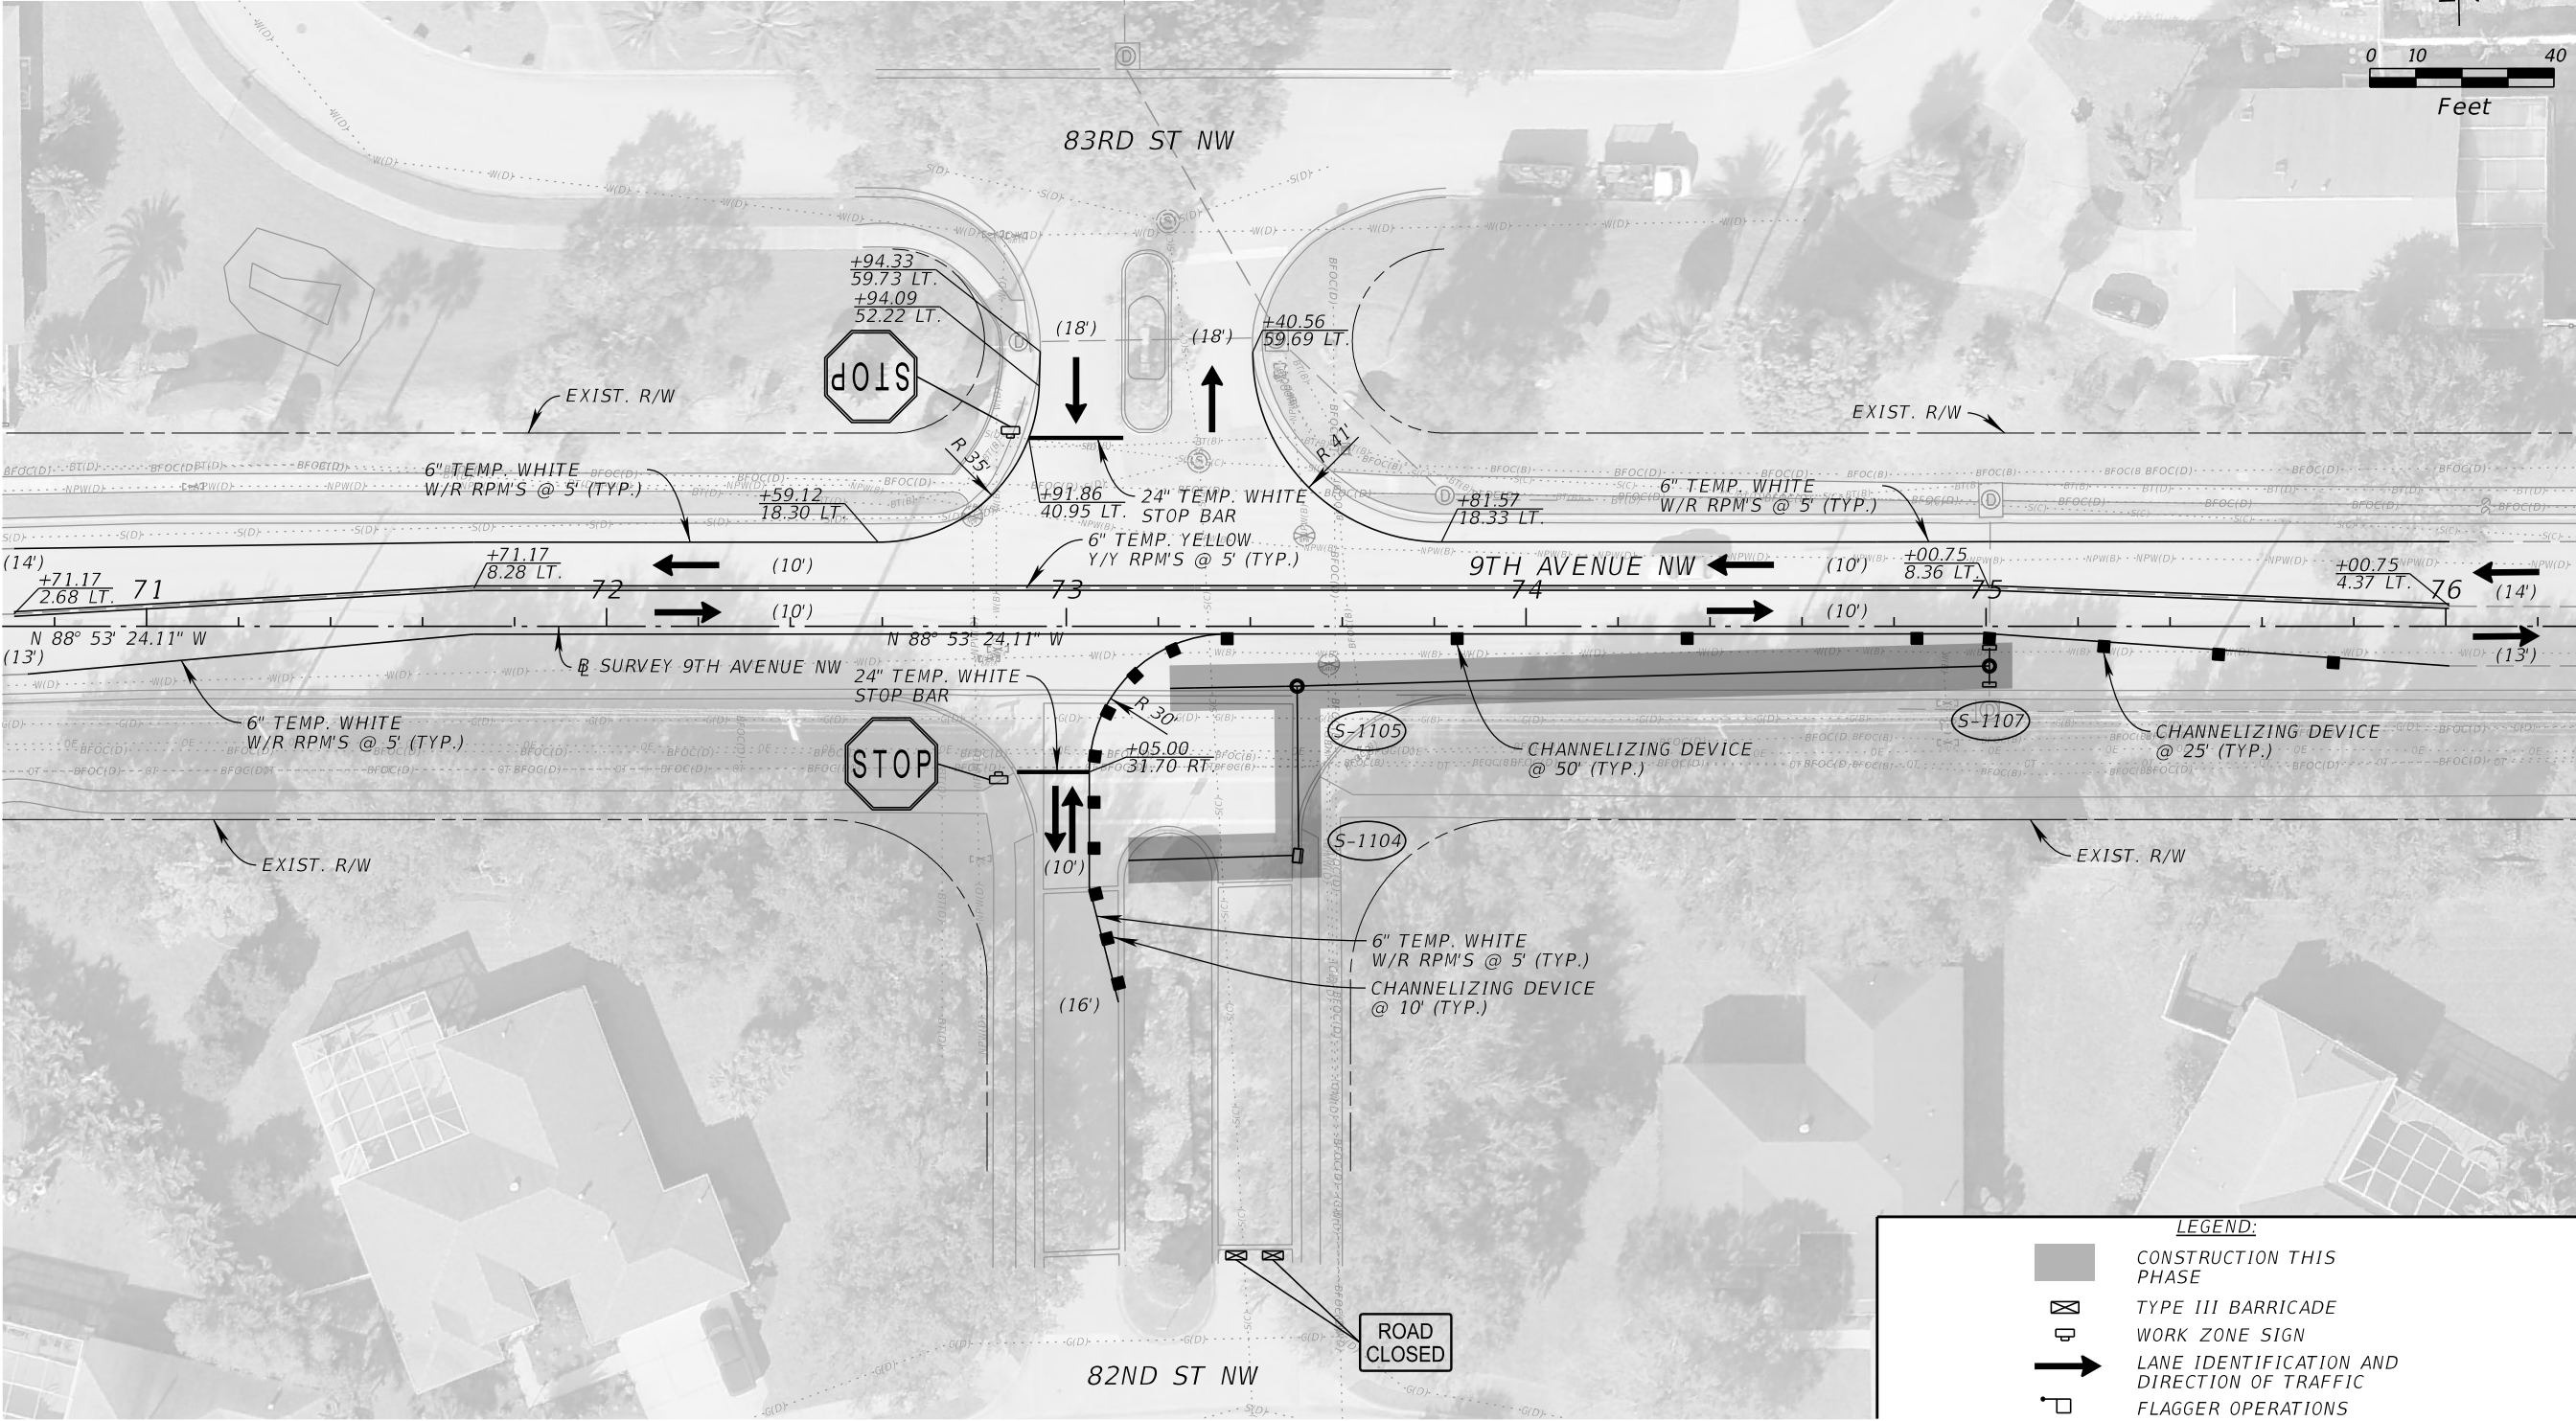No.	REVISIONS	DATE	BY

**Kimley»Horn**

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DATE 10/02/2025
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CHECKED BY

**Manatee County**  
FLORIDA

9TH AVENUE NW

MANATEE COUNTY

LICENSED PROFESSIONAL
JORDAN E. LEEP, P.E. FL LICENSE NUMBER 76102
FL DATE:


TEMP TRAFFIC CONTROL  
83RD ST. - PHASE I A

SHEET NUMBER  
112



PHASING NOTES: 83RD ST NW PHASE I B

1.
- PLACE TEMPORARY STRIPING/SIGNAGE AND SHIFT TRAFFIC TO THE PHASE I B CONFIGURATION. UTILIZE INDICIES 102-600, 102-603, AND 102-604 AS REQUIRED FOR THE ADVANCED WARNING SIGNAGE LAYOUT. MAINTAIN ACCESS TO 83RD ST NW AND 82ND ST NW AT ALL TIMES.
2.
- CONSTRUCT APPROXIMATELY 19 LF OF PIPE TO CONSTRUCT AND MAKE CONNECTION TO STRUCTURE S-1103. CONSTRUCT APPROXIMATELY 71 LF OF PIPE TO CONSTRUCT AND MAKE CONNECTION TO STRUCTURE S-1101. AT THE END OF EACH WORK DAY, CONTRACTOR TO COVER ANY DROP-OFF CONDITIONS IN ACCORDANCE WITH INDEX 102-600 AND MAINTAIN TWO 10-FT LANES IN ALL DIRECTIONS.

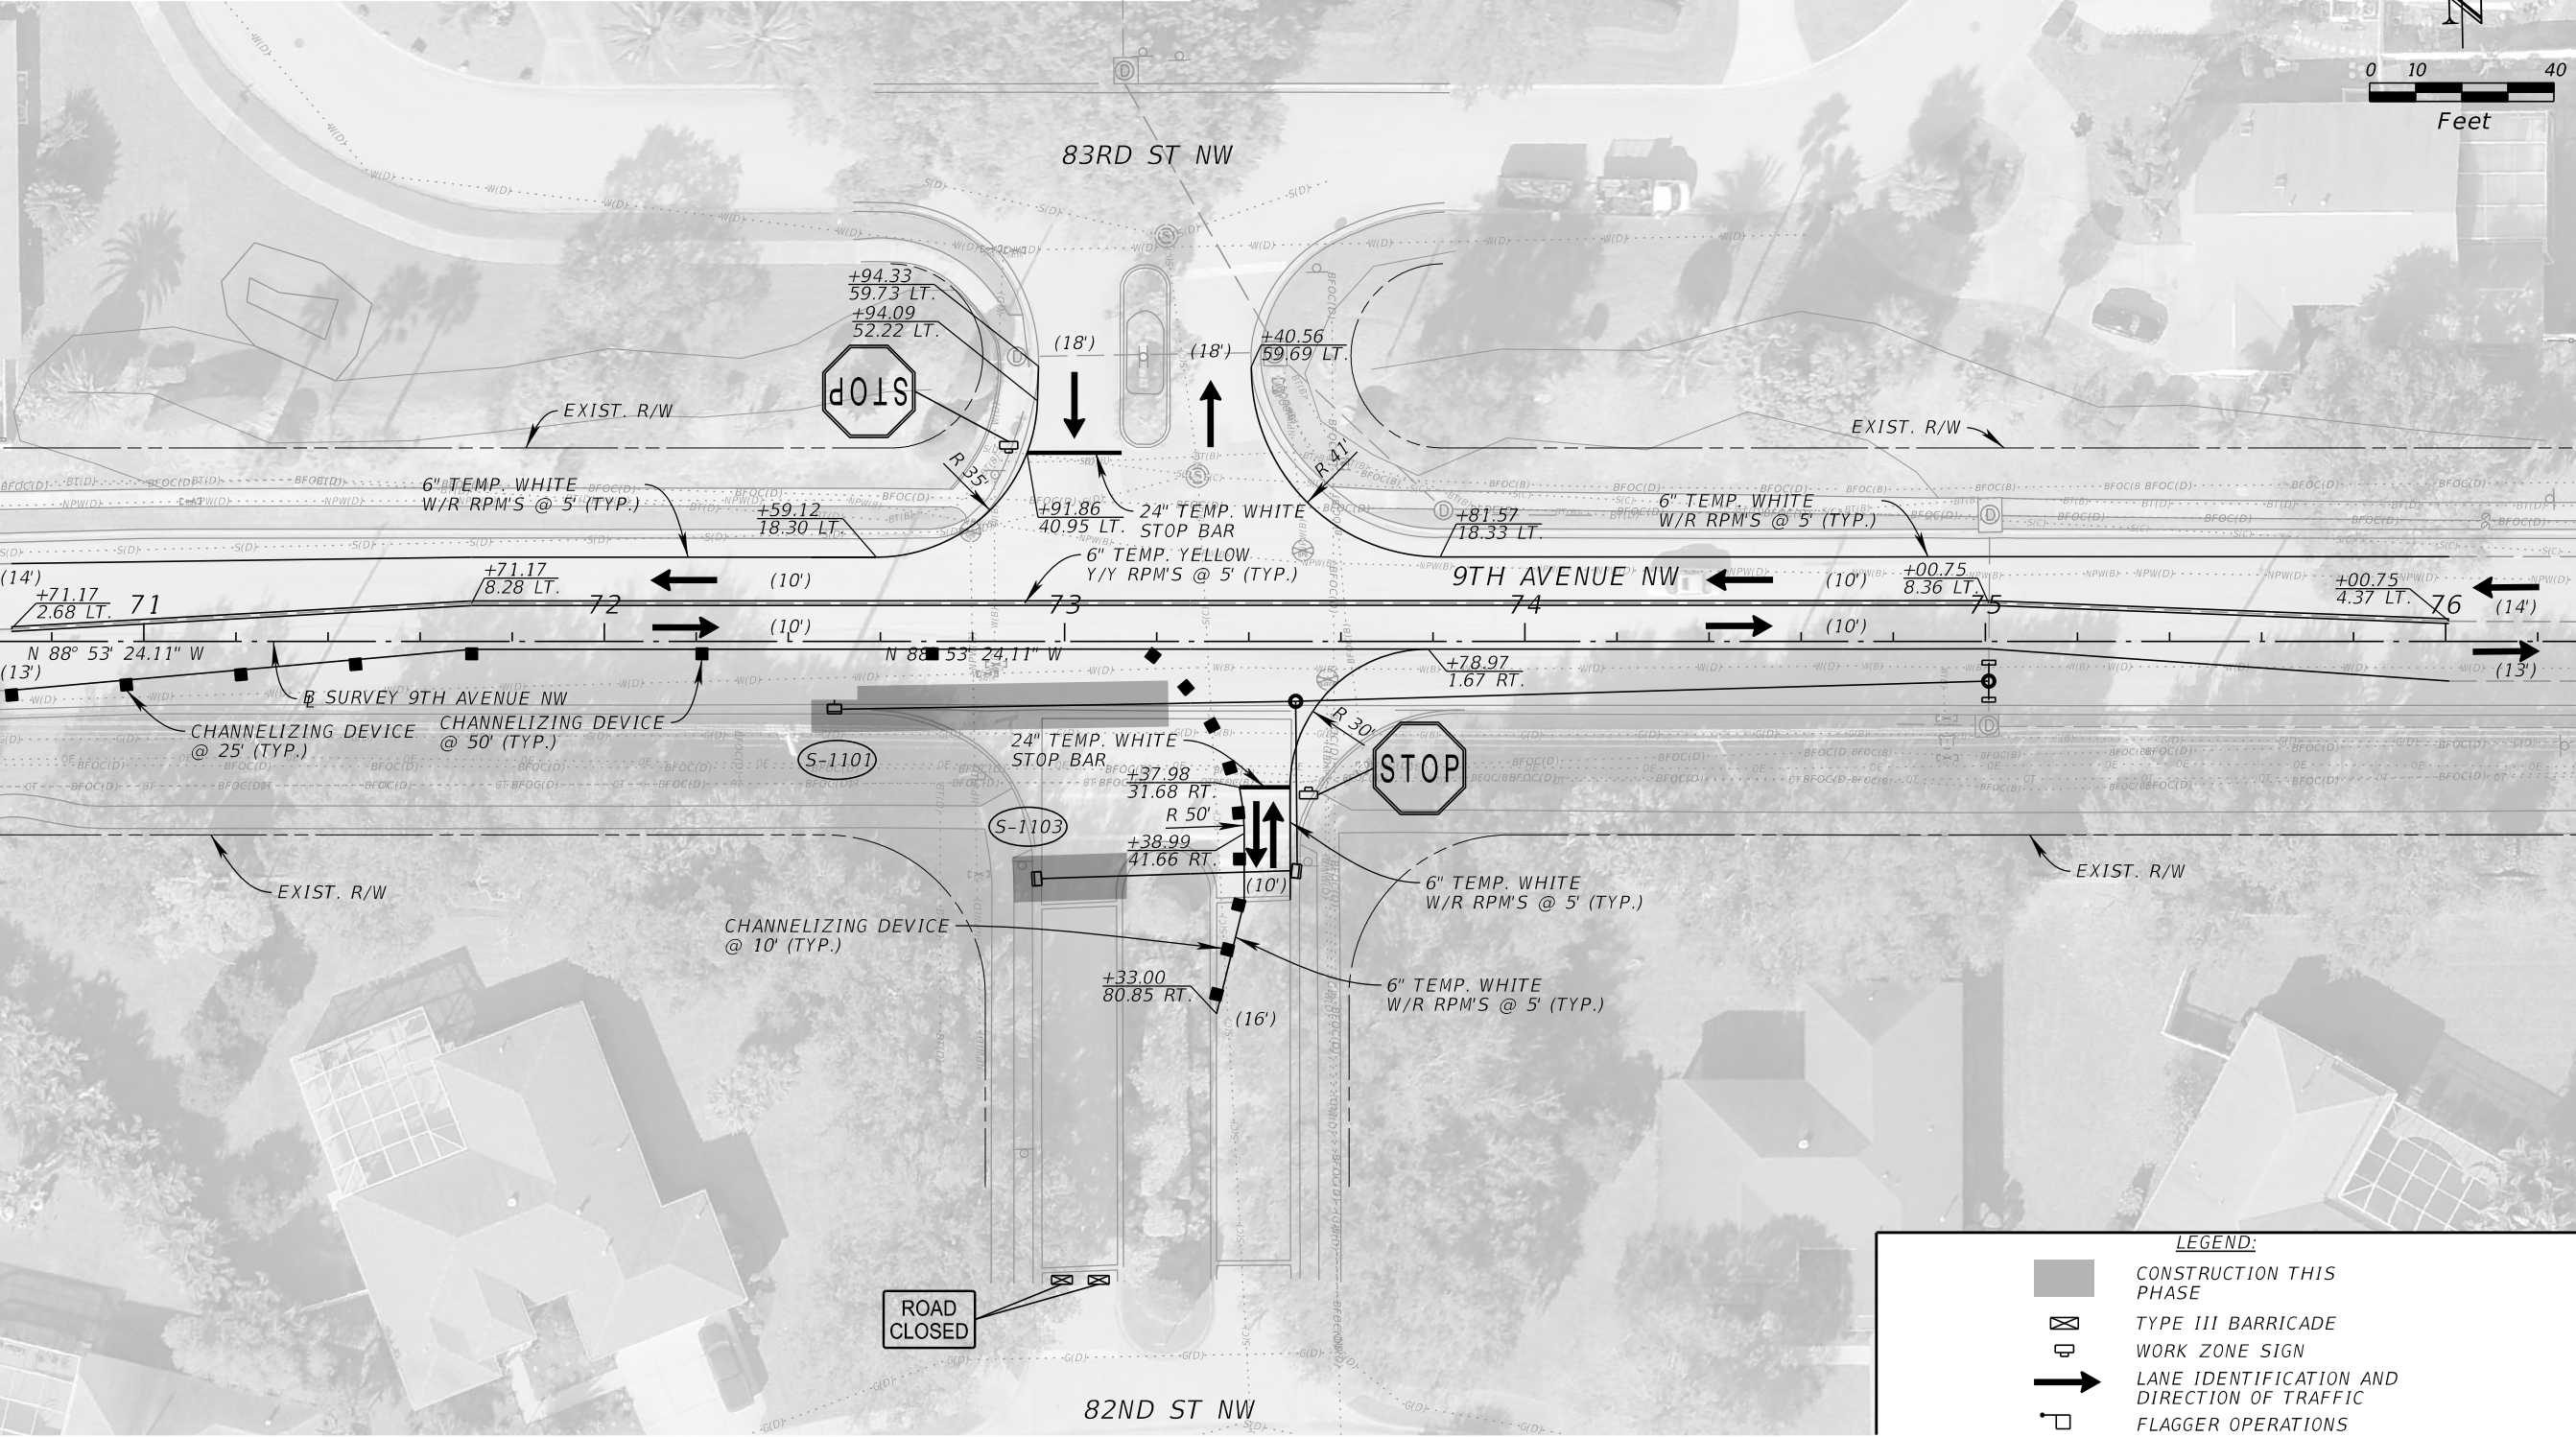

- LEGEND:
- CONSTRUCTION THIS PHASE
  - TYPE III BARRICADE
  - WORK ZONE SIGN
  - LANE IDENTIFICATION AND DIRECTION OF TRAFFIC
  - FLAGGER OPERATIONS

No.	REVISIONS	DATE	BY

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9TH AVENUE NW

MANATEE COUNTY

FL

LICENSED PROFESSIONAL
JORDAN E. LEEP, P.E.
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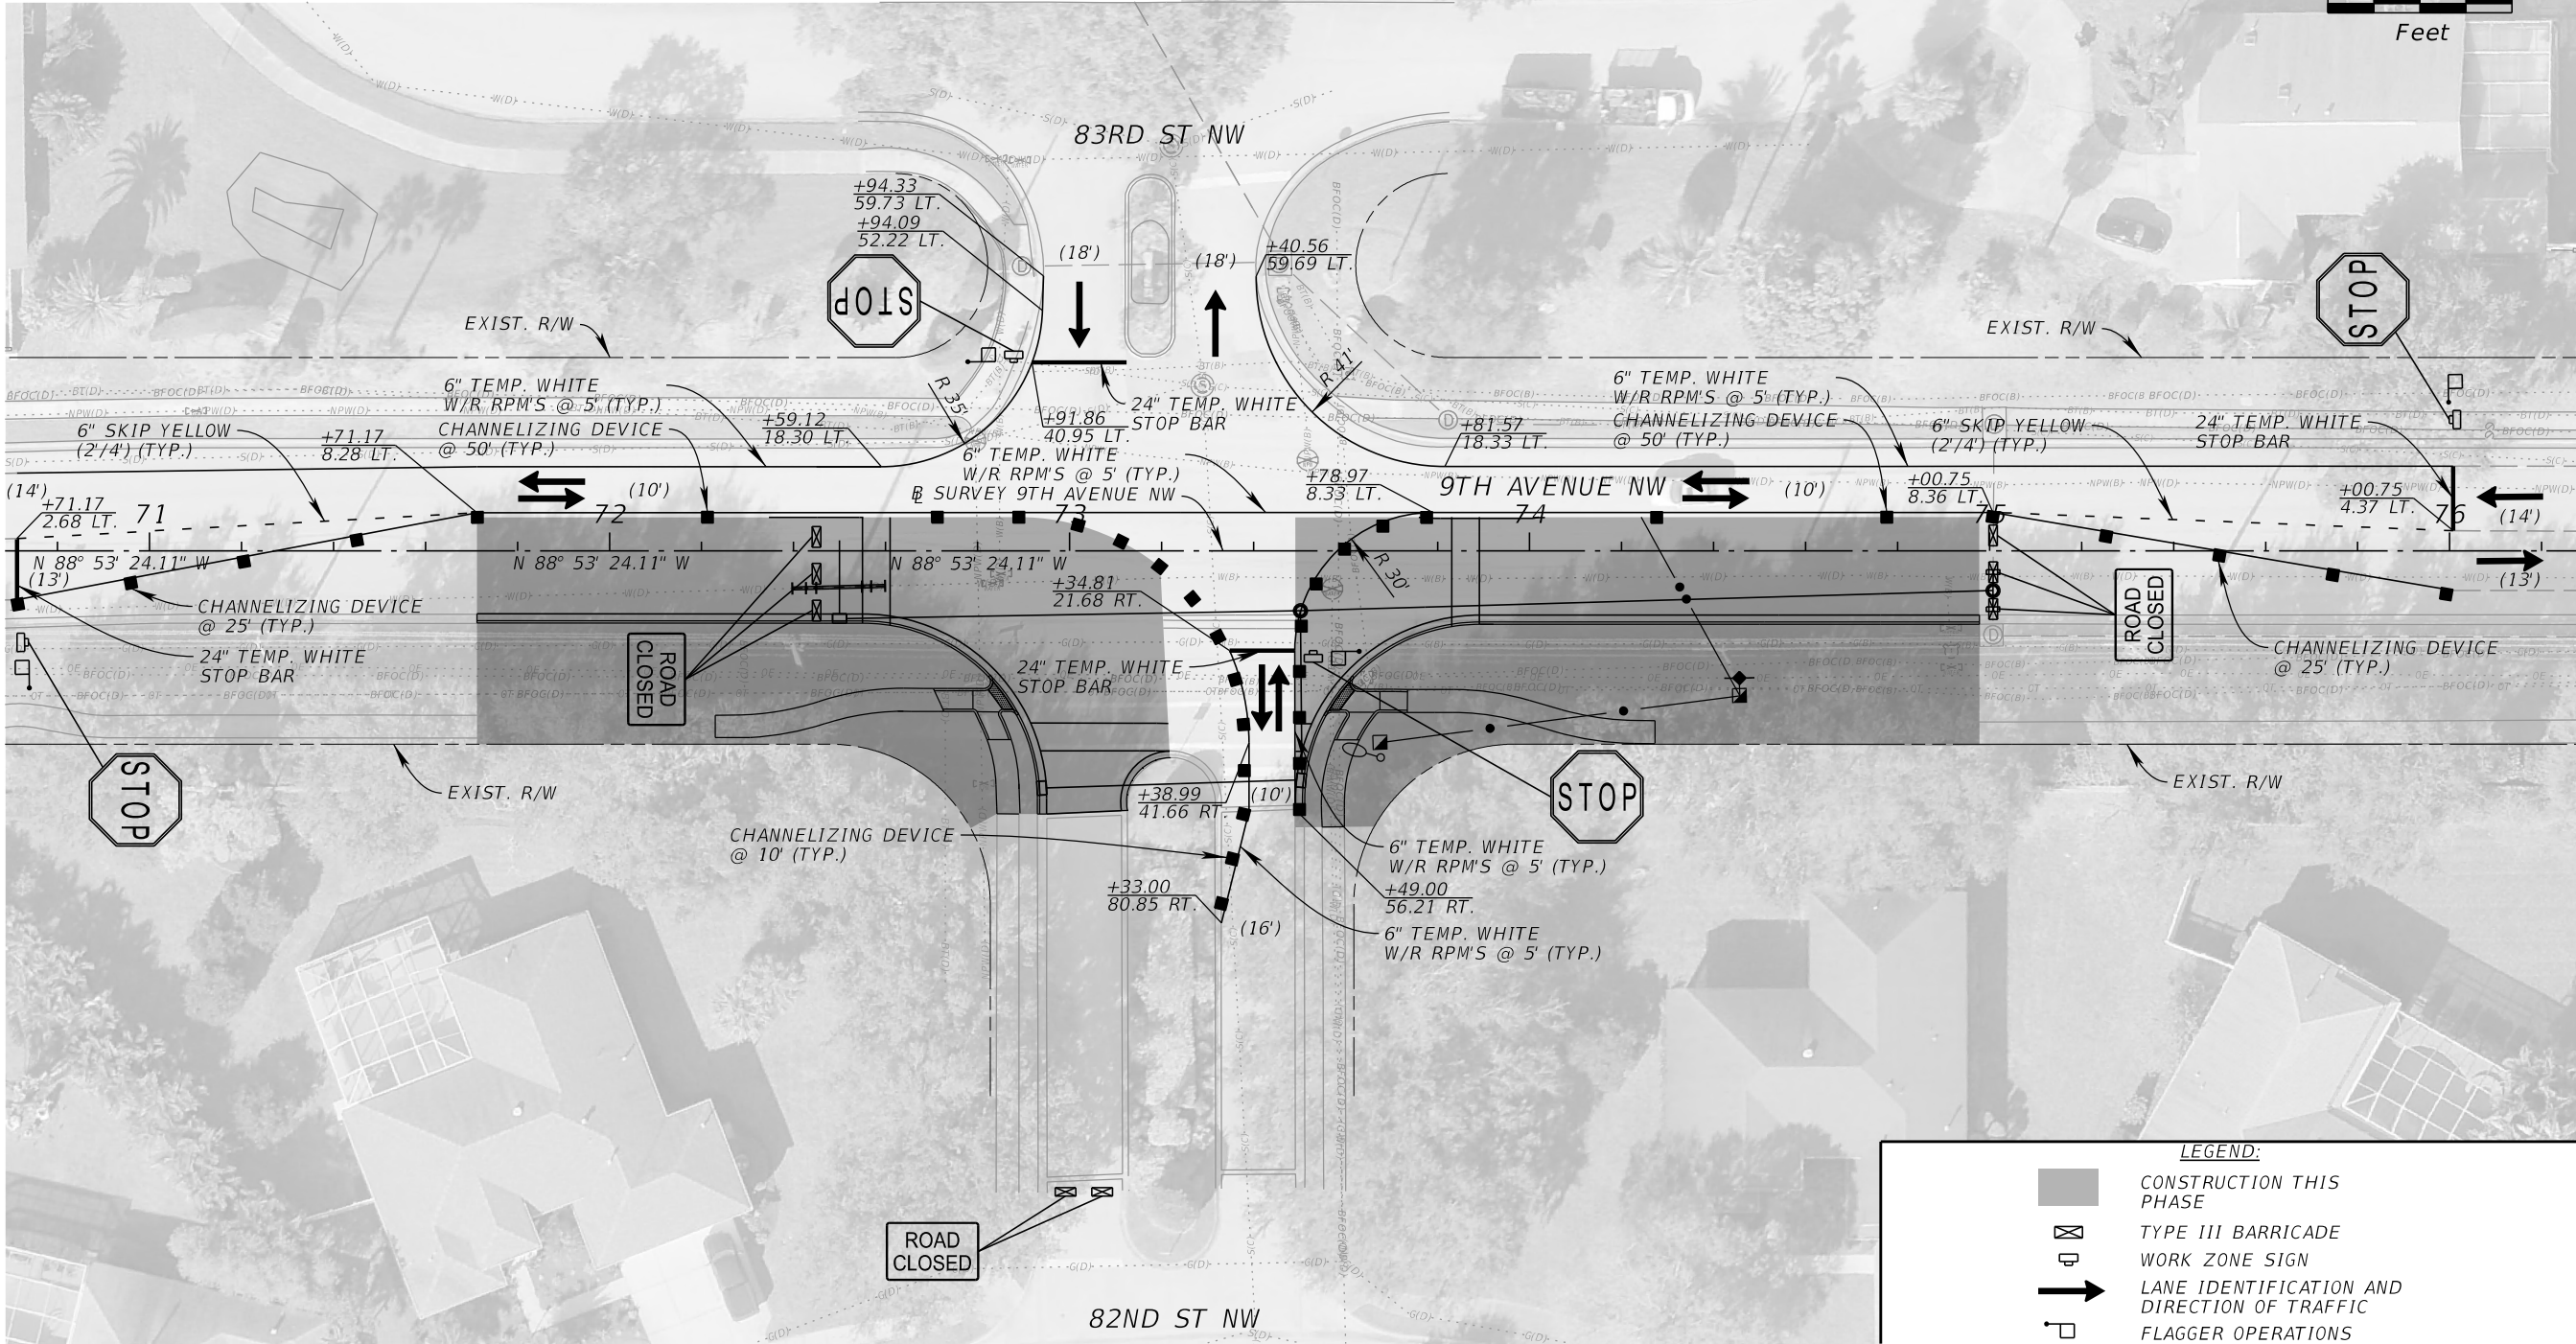
**TEMP TRAFFIC CONTROL**  
**83RD ST. - PHASE I B**

SHEET NUMBER
113

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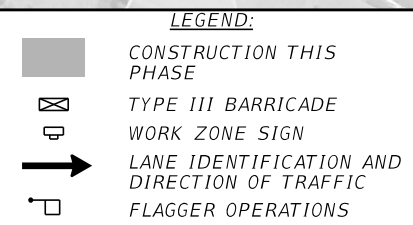
PHASING NOTES: 83RD ST NW PHASE II A

1. PLACE TEMPORARY STRIPING/SIGNAGE AND SHIFT TRAFFIC TO THE PHASE II A CONFIGURATION. UTILIZE INDICIES 102-600, 102-603, AND 102-604 AS REQUIRED FOR THE ADVANCED WARNING SIGNAGE LAYOUT. MAINTAIN ACCESS TO 83RD ST NW AND 82ND ST NW AT ALL TIMES.
2. CONSTRUCT 8" WATER MAIN RELOCATION WITHIN THE WORK ZONE SHAPE. CONSTRUCT APPROXIMATELY 16 LF OF PIPE FROM STRUCTURE S-1101 TOWARDS STRUCTURE S-1102. AT THE END OF EACH WORK DAY, CONTRACTOR TO USE STEEL PLATES OR ANOTHER METHOD APPROVED BY THE ENGINEER TO COVER ANY DROP-OFF CONDITIONS IN THE CLEAR ZONE PER INDEX 102-600. MAINTAIN TWO 10-FT LANES IN ALL DIRECTIONS AT THE END OF EACH WORK DAY.
3. CONSTRUCT CURBLINE AND WIDENING WITHIN THE WORK ZONE SHAPE UP TO THE FINAL LIFT. CONSTRUCT OVERBUILD PAVEMENT WITHIN THE INTERSECTION IN 1.5" LIFTS UP TO, BUT NOT INCLUDING THE FINAL LIFT. CONSTRUCT ALL SIDEWALKS, LIGHTING, SODDING, AND EARTHWORK WITHIN THE WORK ZONE SHAPE.







1. PLACE TEMPORARY STRIPING/SIGNAGE AND SHIFT TRAFFIC TO THE PHASE II B CONFIGURATION. UTILIZE INDICIES 102-600, 102-603, AND 102-604 AS REQUIRED FOR THE ADVANCED WARNING SIGNAGE LAYOUT. MAINTAIN ACCESS TO 82ND ST NW AT ALL TIMES.
2. CONSTRUCT APPROXIMATELY 5 LF COMPLETING THE CONNECTION TO STRUCTURE S-1102 AND CONSTRUCT STRUCTURE S-1102. AT THE END OF EACH WORK DAY, CONTRACTOR TO COVER ANY DROP-OFF CONDITIONS IN ACCORDANCE WITH INDEX 102-600 AND MAINTAIN TWO 10-FT LANES IN ALL DIRECTIONS.
3. CONSTRUCT CURBLINE AND WIDENING WITHIN THE WORK ZONE SHAPE UP TO THE FINAL LIFT. CONSTRUCT OVERBUILD PAVEMENT WITHIN THE INTERSECTION IN 1.5" LIFTS UP TO, BUT NOT INCLUDING THE FINAL LIFT. CONSTRUCT ALL SIDEWALKS, LIGHTING, SODDING, AND EARTHWORK WITHIN THE WORK ZONE SHAPE.
4. PLACE FINAL SIGNAGE AND PAINTED PAVEMENT MARKINGS IN FINAL CONFIGURATION PER PAVEMENT MARKING PLAN.

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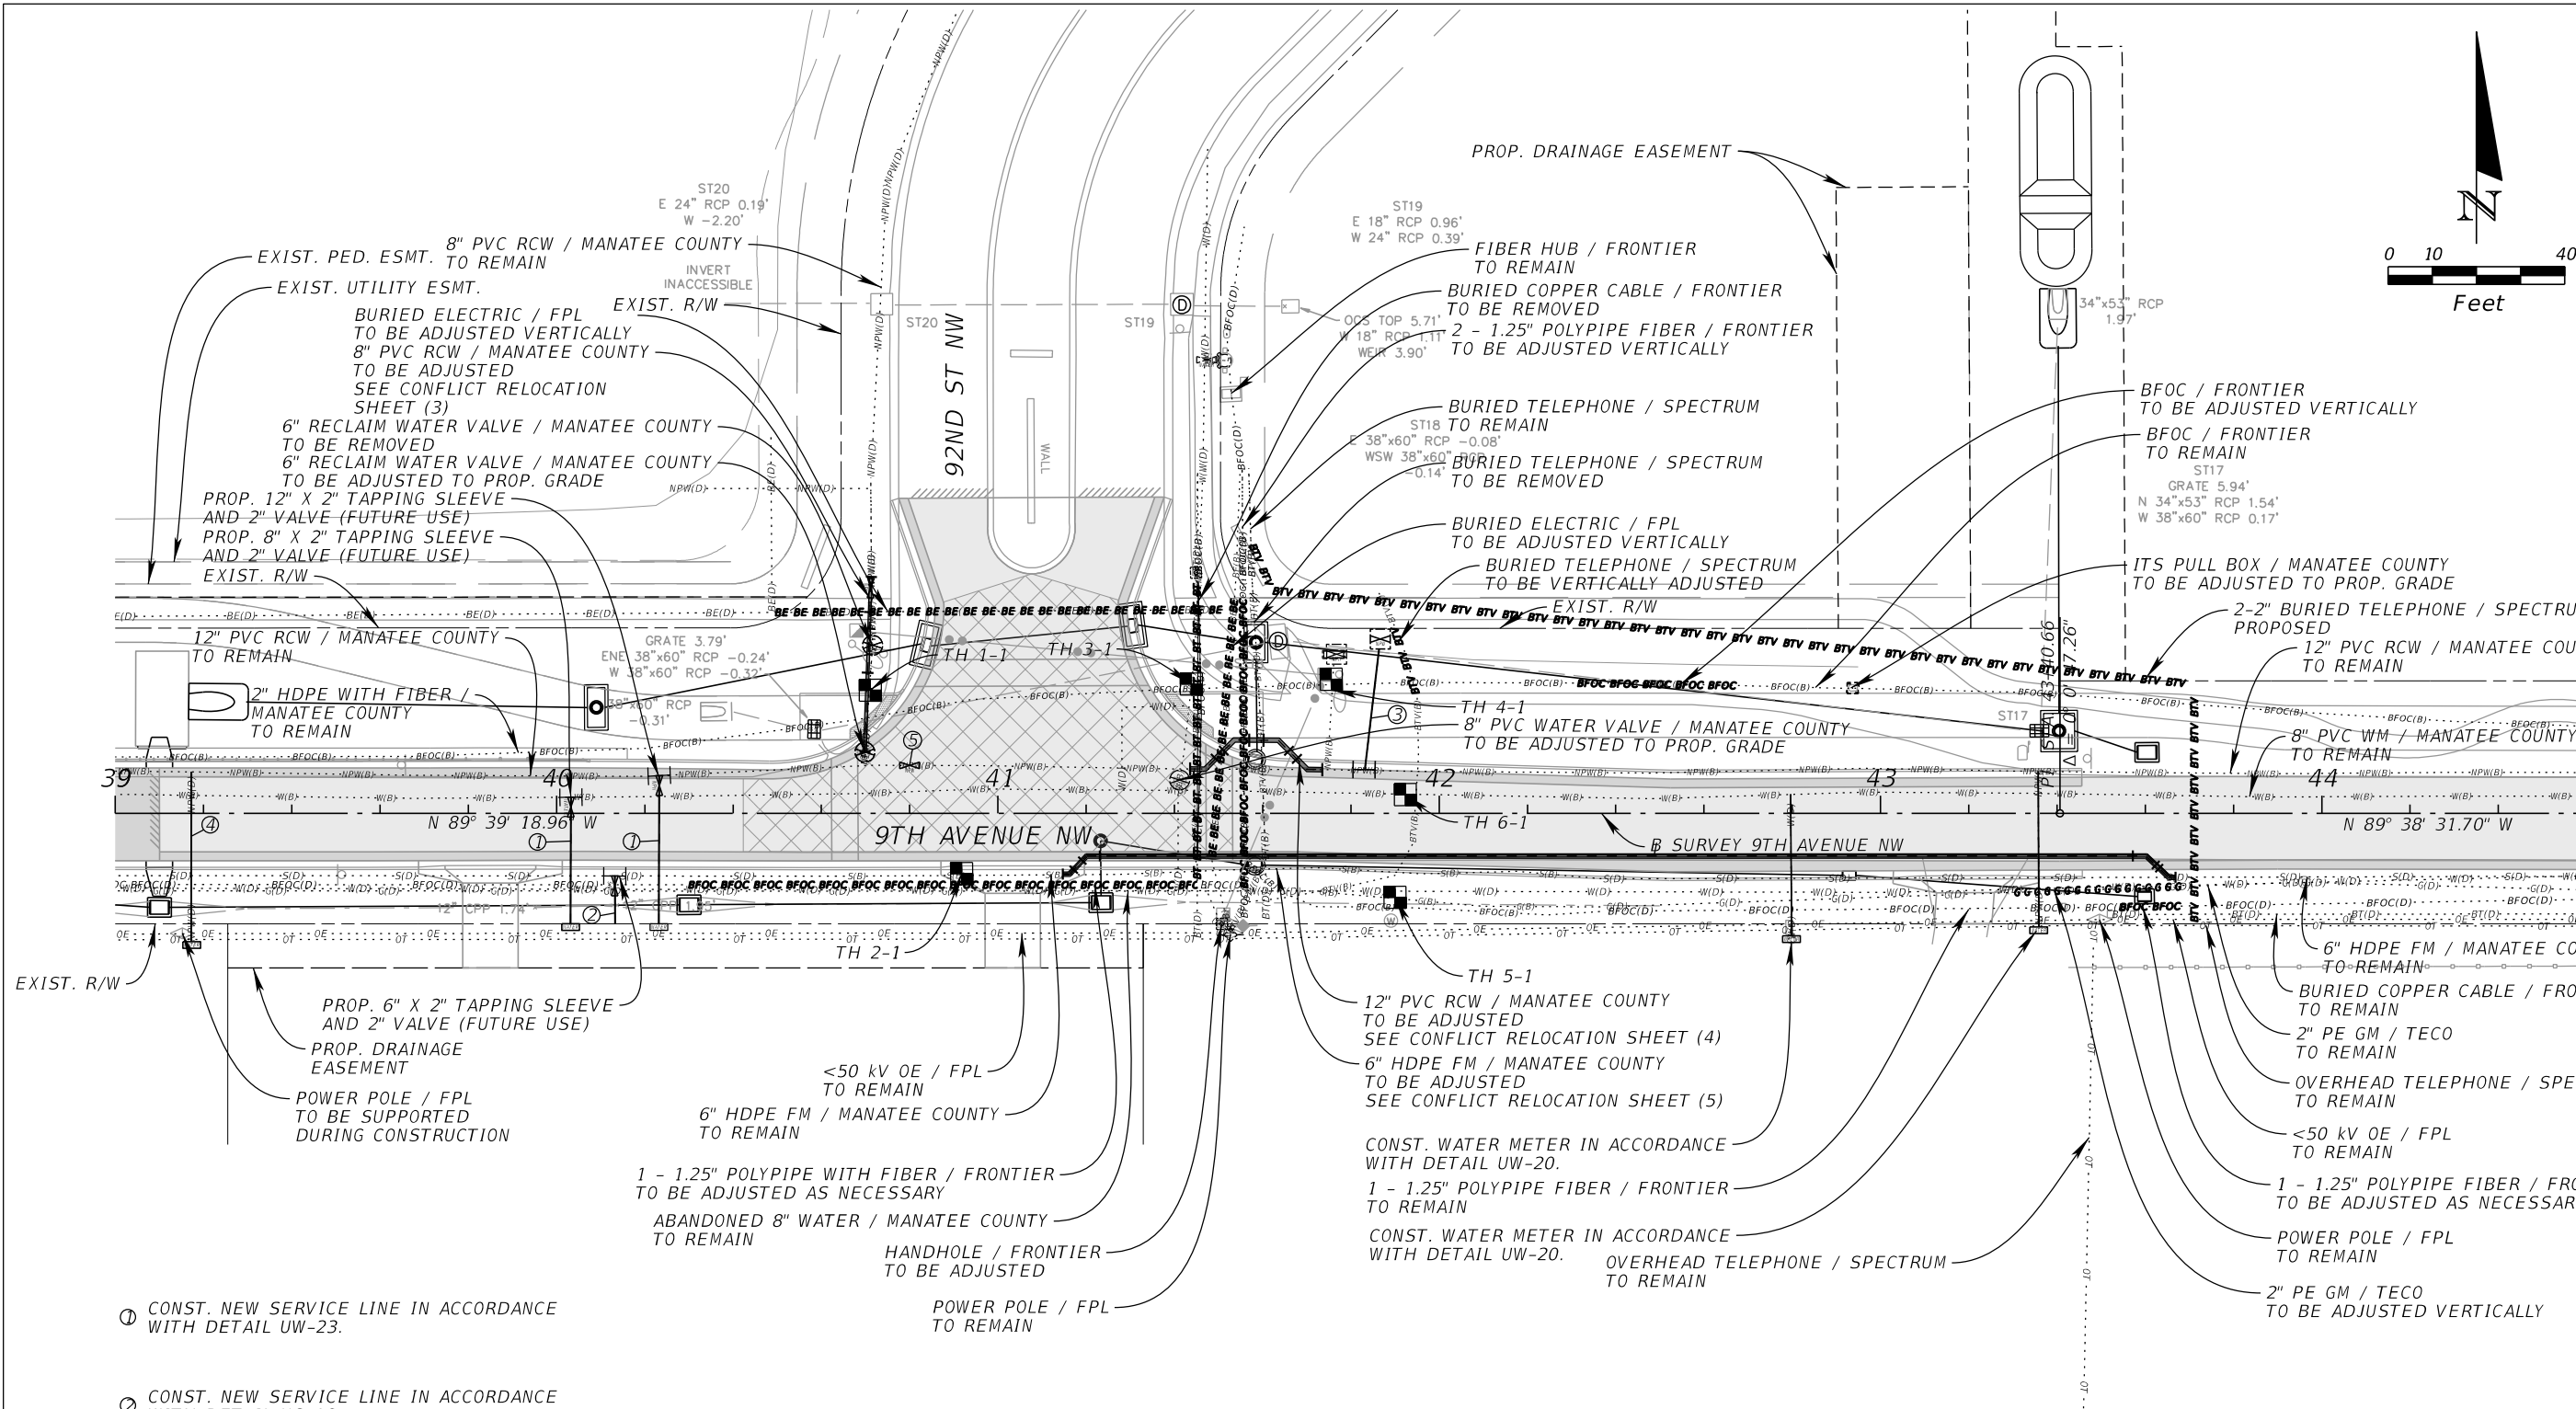


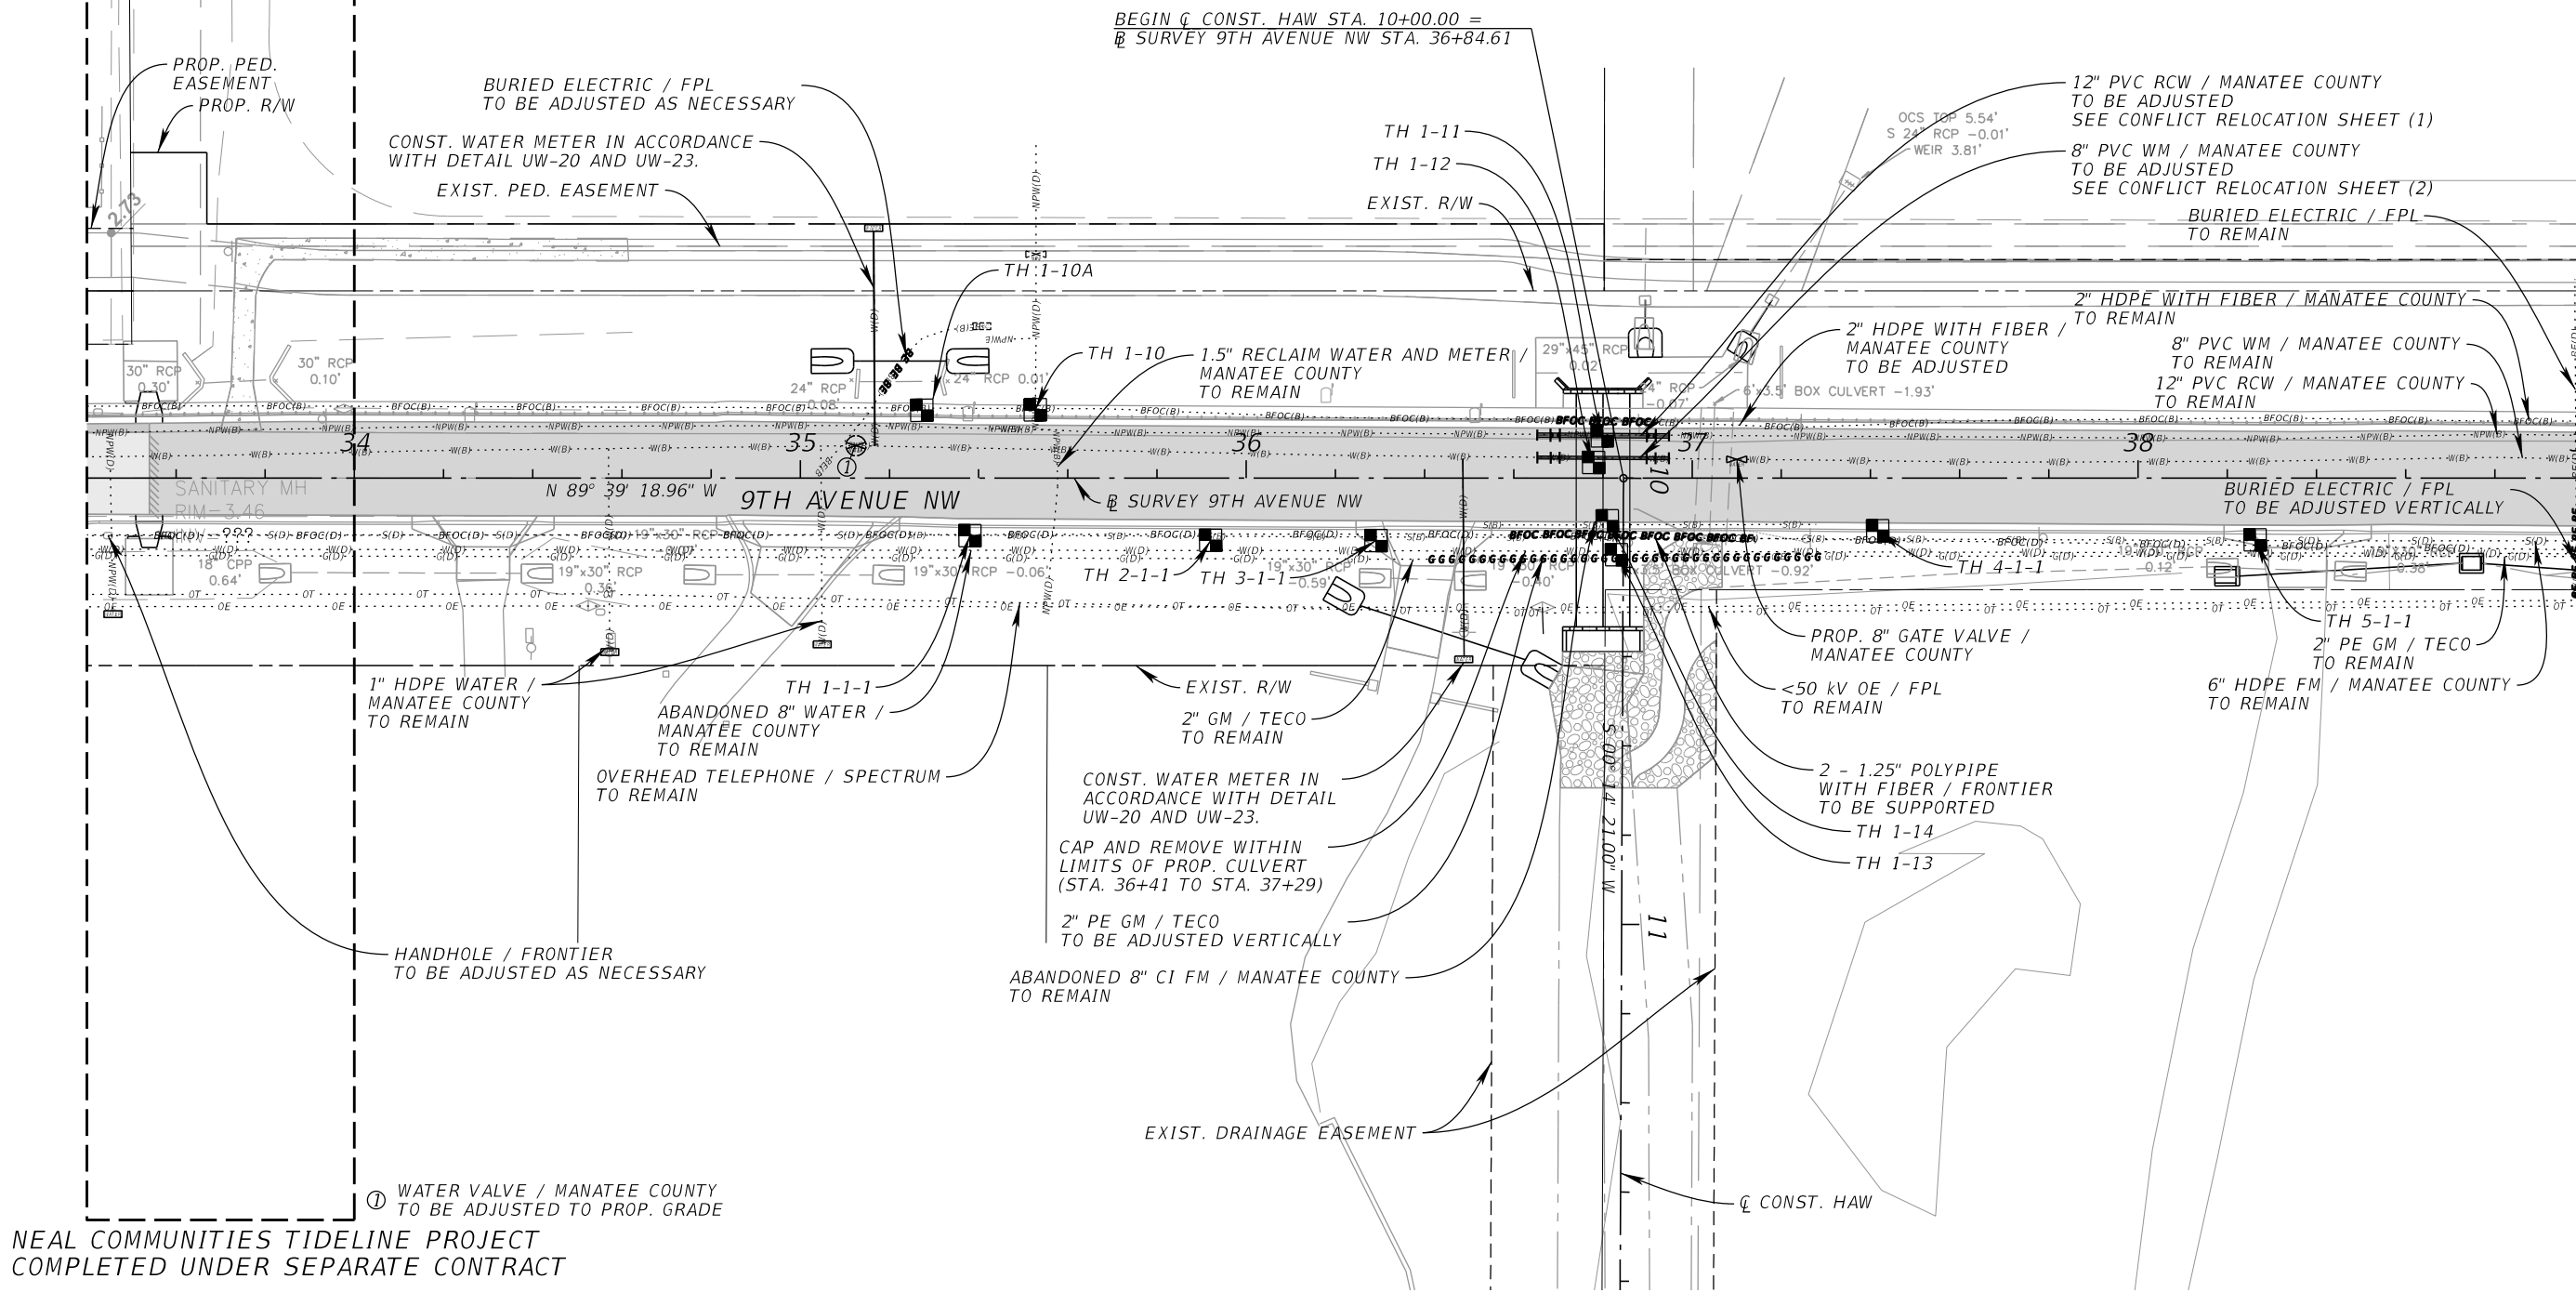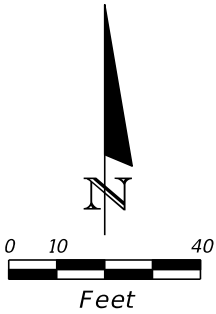

NEAL COMMUNITIES TIDELINE PROJECT  
COMPLETED UNDER SEPARATE CONTRACT

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			<div>DATE 10/02/2025</div>						
			<div>SCALE AS SHOWN</div>						
			<div>DESIGNED BY</div>						
			<div>DRAWN BY</div>						
			<div>CHECKED BY</div>						
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- ① CONST. NEW SERVICE LINE IN ACCORDANCE WITH DETAIL UW-23.
- ② CONST. NEW SERVICE LINE IN ACCORDANCE WITH DETAIL US-16.
- ③ CONST. 2" ABOVE-GROUND ARV ASSEMBLY IN ACCORDANCE WITH DETAIL UW-10.
- ④ CONST. WATER METER IN ACCORDANCE WITH DETAIL UW-20.

⑤ PROP. 12" GATE VALVE / MANATEE COUNTY INSPECT TEE AND REPLACE IF NEEDED

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148400070  
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9TH AVENUE NW

MANATEE COUNTY

LICENSED PROFESSIONAL



JORDAN E. LEEP, P.E.  
FL LICENSE NUMBER 76102

UTILITY ADJUSTMENT  
SHEET (2)

SHEET NUMBER  
117

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- ① 1" WATER / MANATEE COUNTY TO REMAIN
- ② 4" PVC WATER / MANATEE COUNTY TO REMAIN
- ③ 6" PVC WATER / MANATEE COUNTY TO REMAIN
- ④ 4" PVC RECLAIM / MANATEE COUNTY TO REMAIN
- ⑤ WATER VALVE / MANATEE COUNTY TO BE ADJUSTED TO PROP. GRADE
- ⑥ RECLAIM VALVE / MANATEE COUNTY TO BE ADJUSTED TO PROP. GRADE

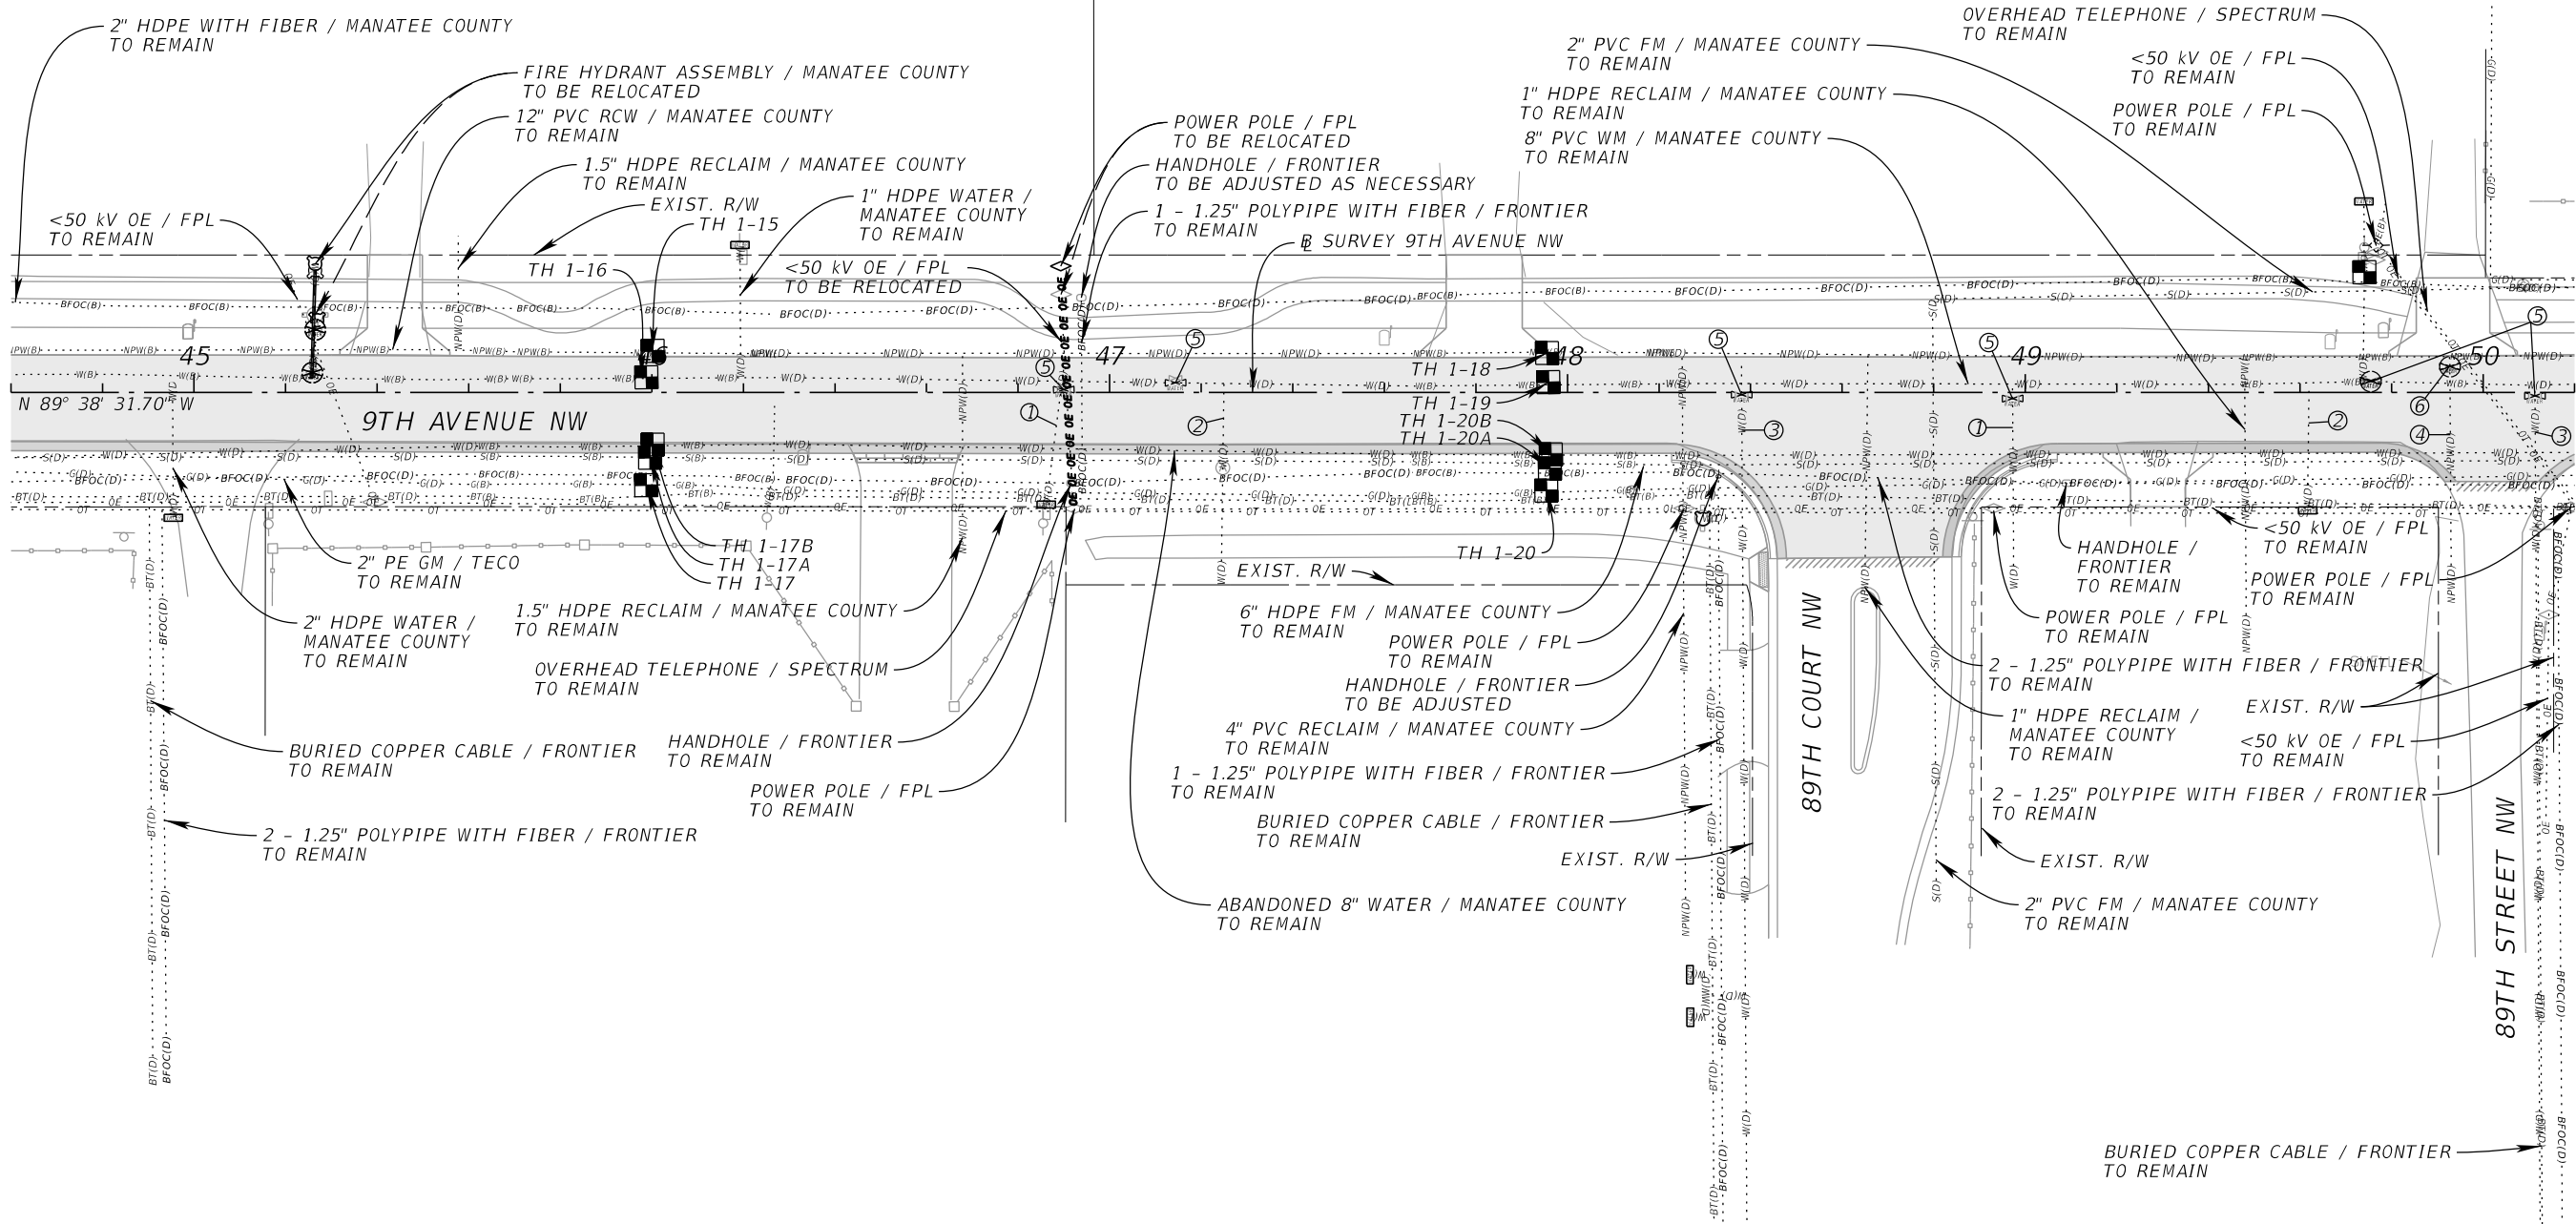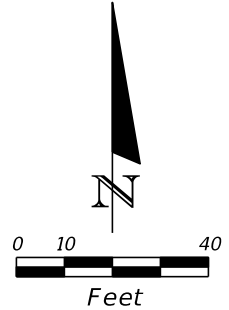

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**9TH AVENUE NW**

**MANATEE COUNTY**

LICENSED PROFESSIONAL

JORDAN E. LEEP, P.E.  
FL LICENSE NUMBER 76102

FL DATE:

**UTILITY ADJUSTMENT**  
**SHEET (3)**



SHEET NUMBER

118

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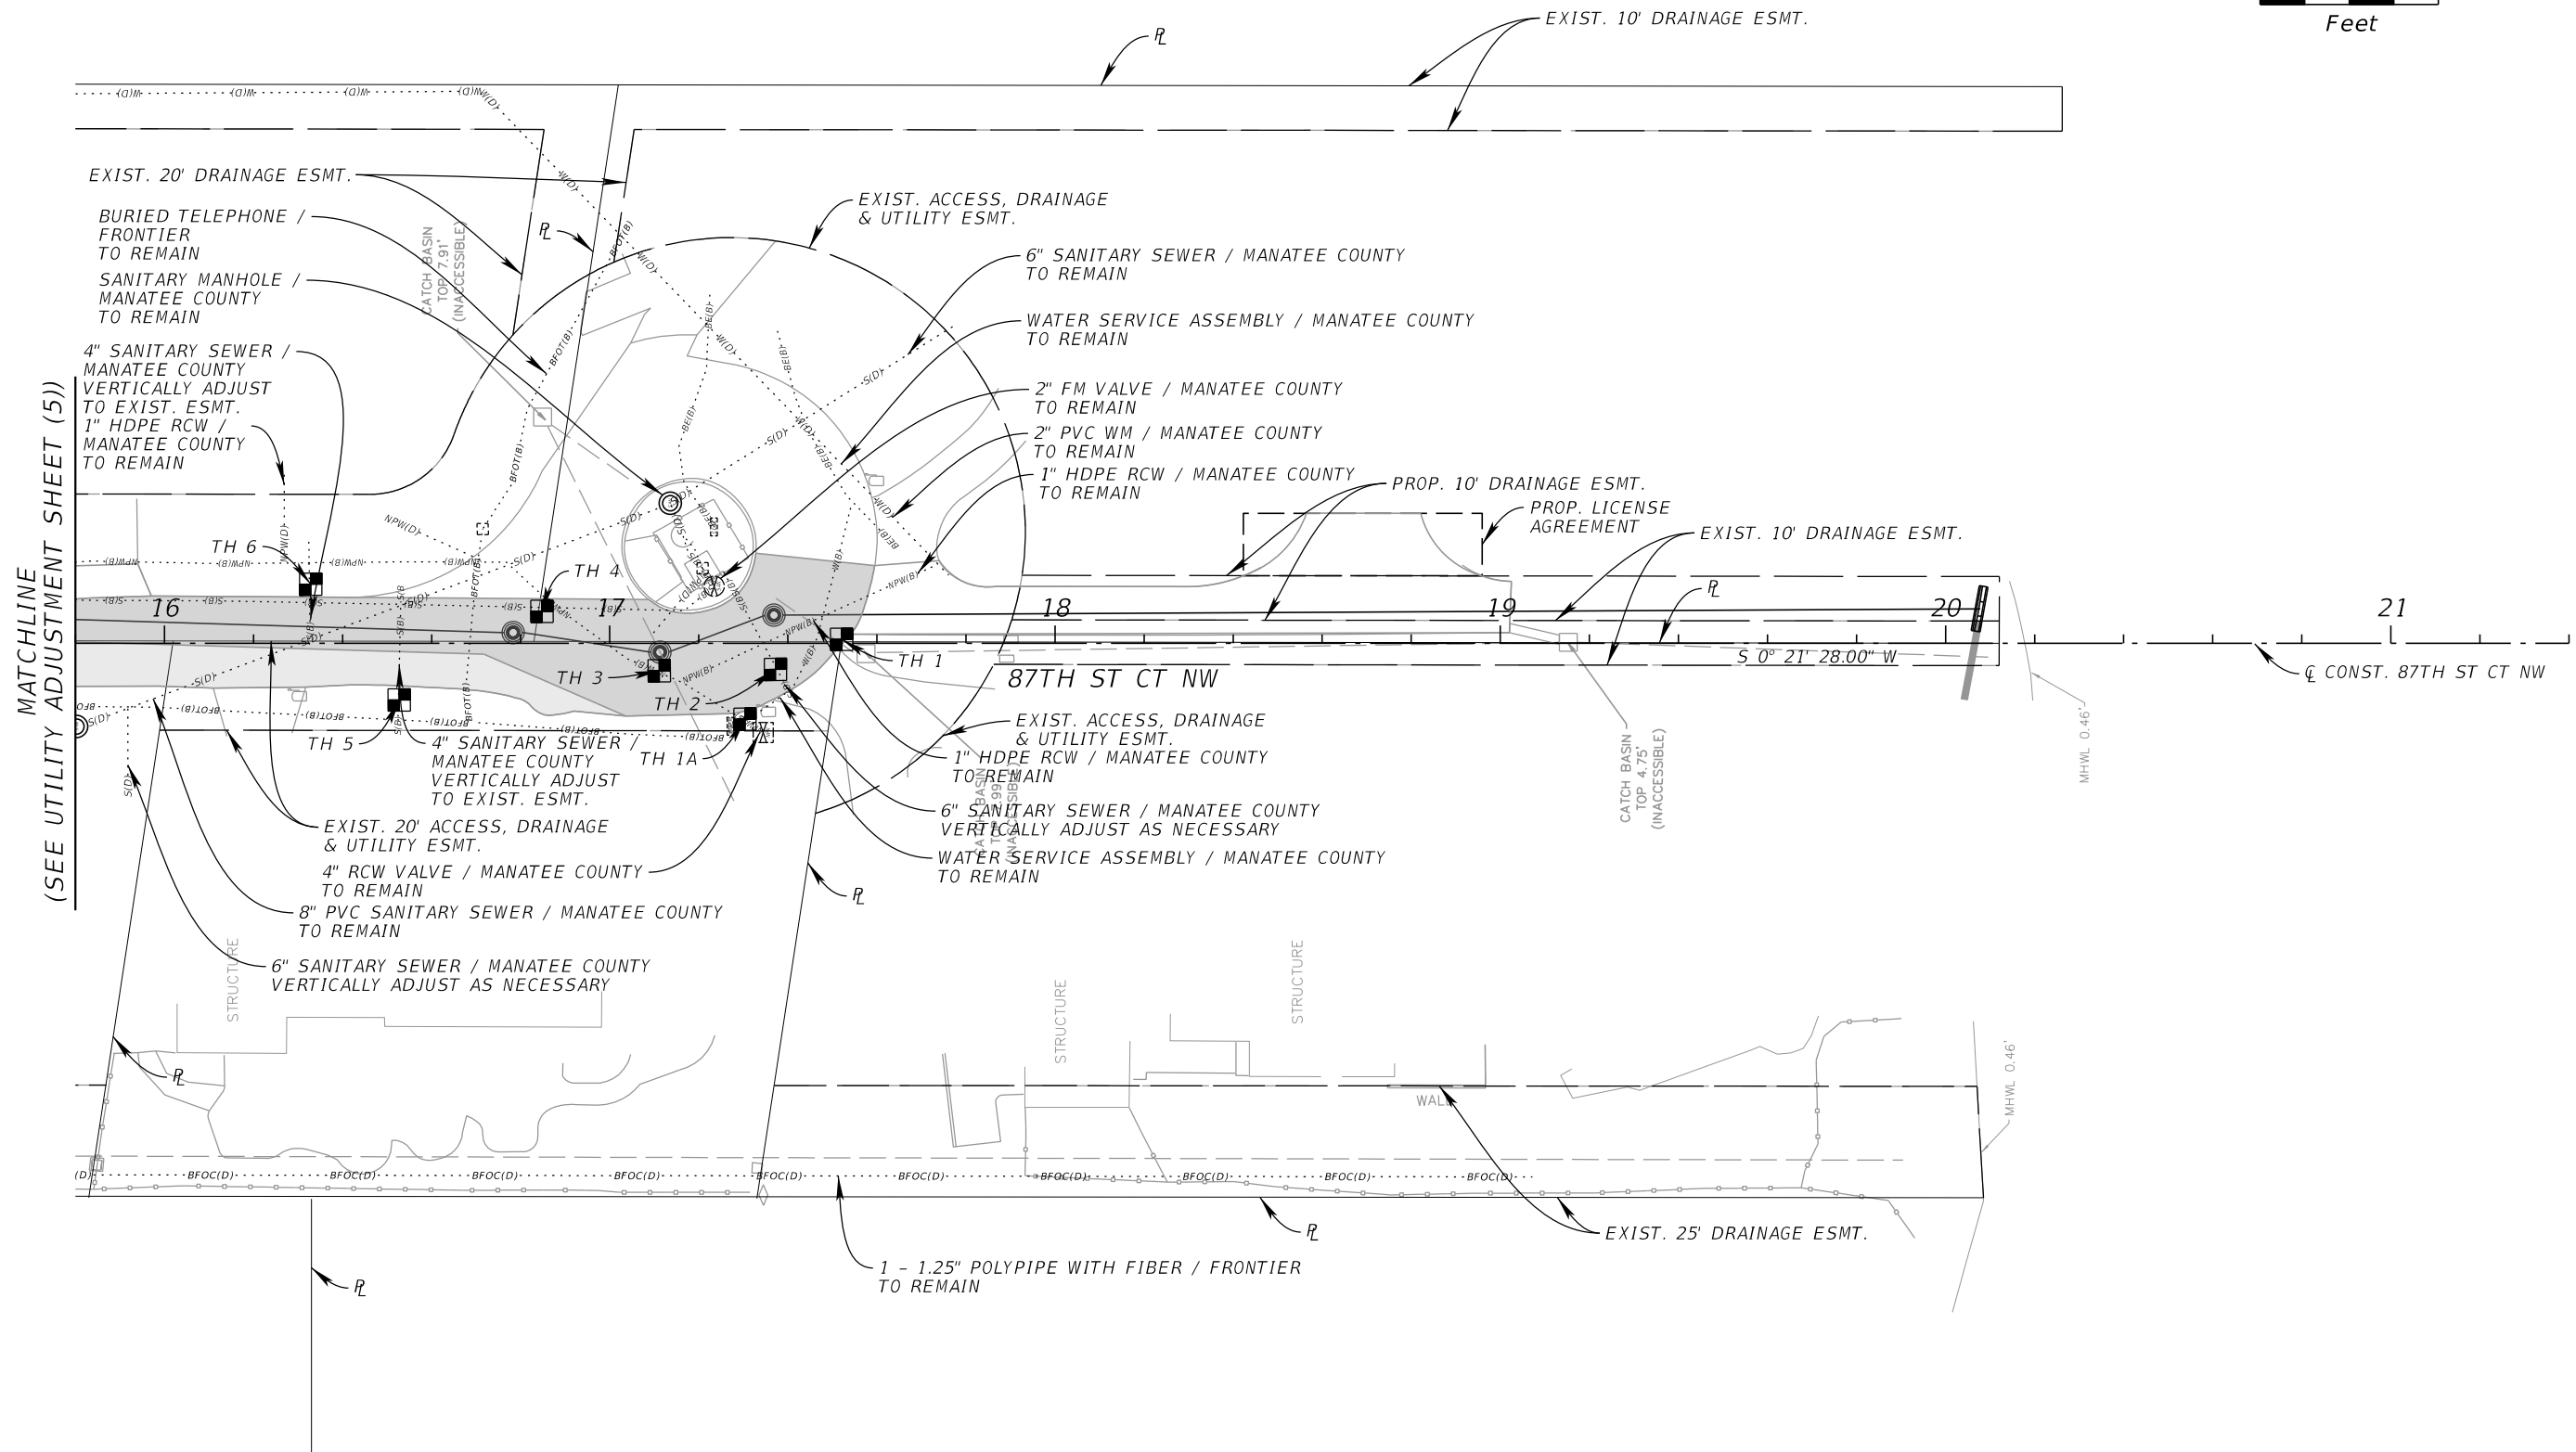
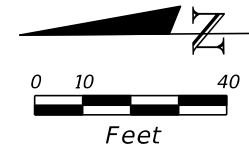
9TH AVENUE NW

MANATEE COUNTY

LICENSED PROFESSIONAL
JORDAN E. LEEP, P.E.
FL LICENSE NUMBER 76102

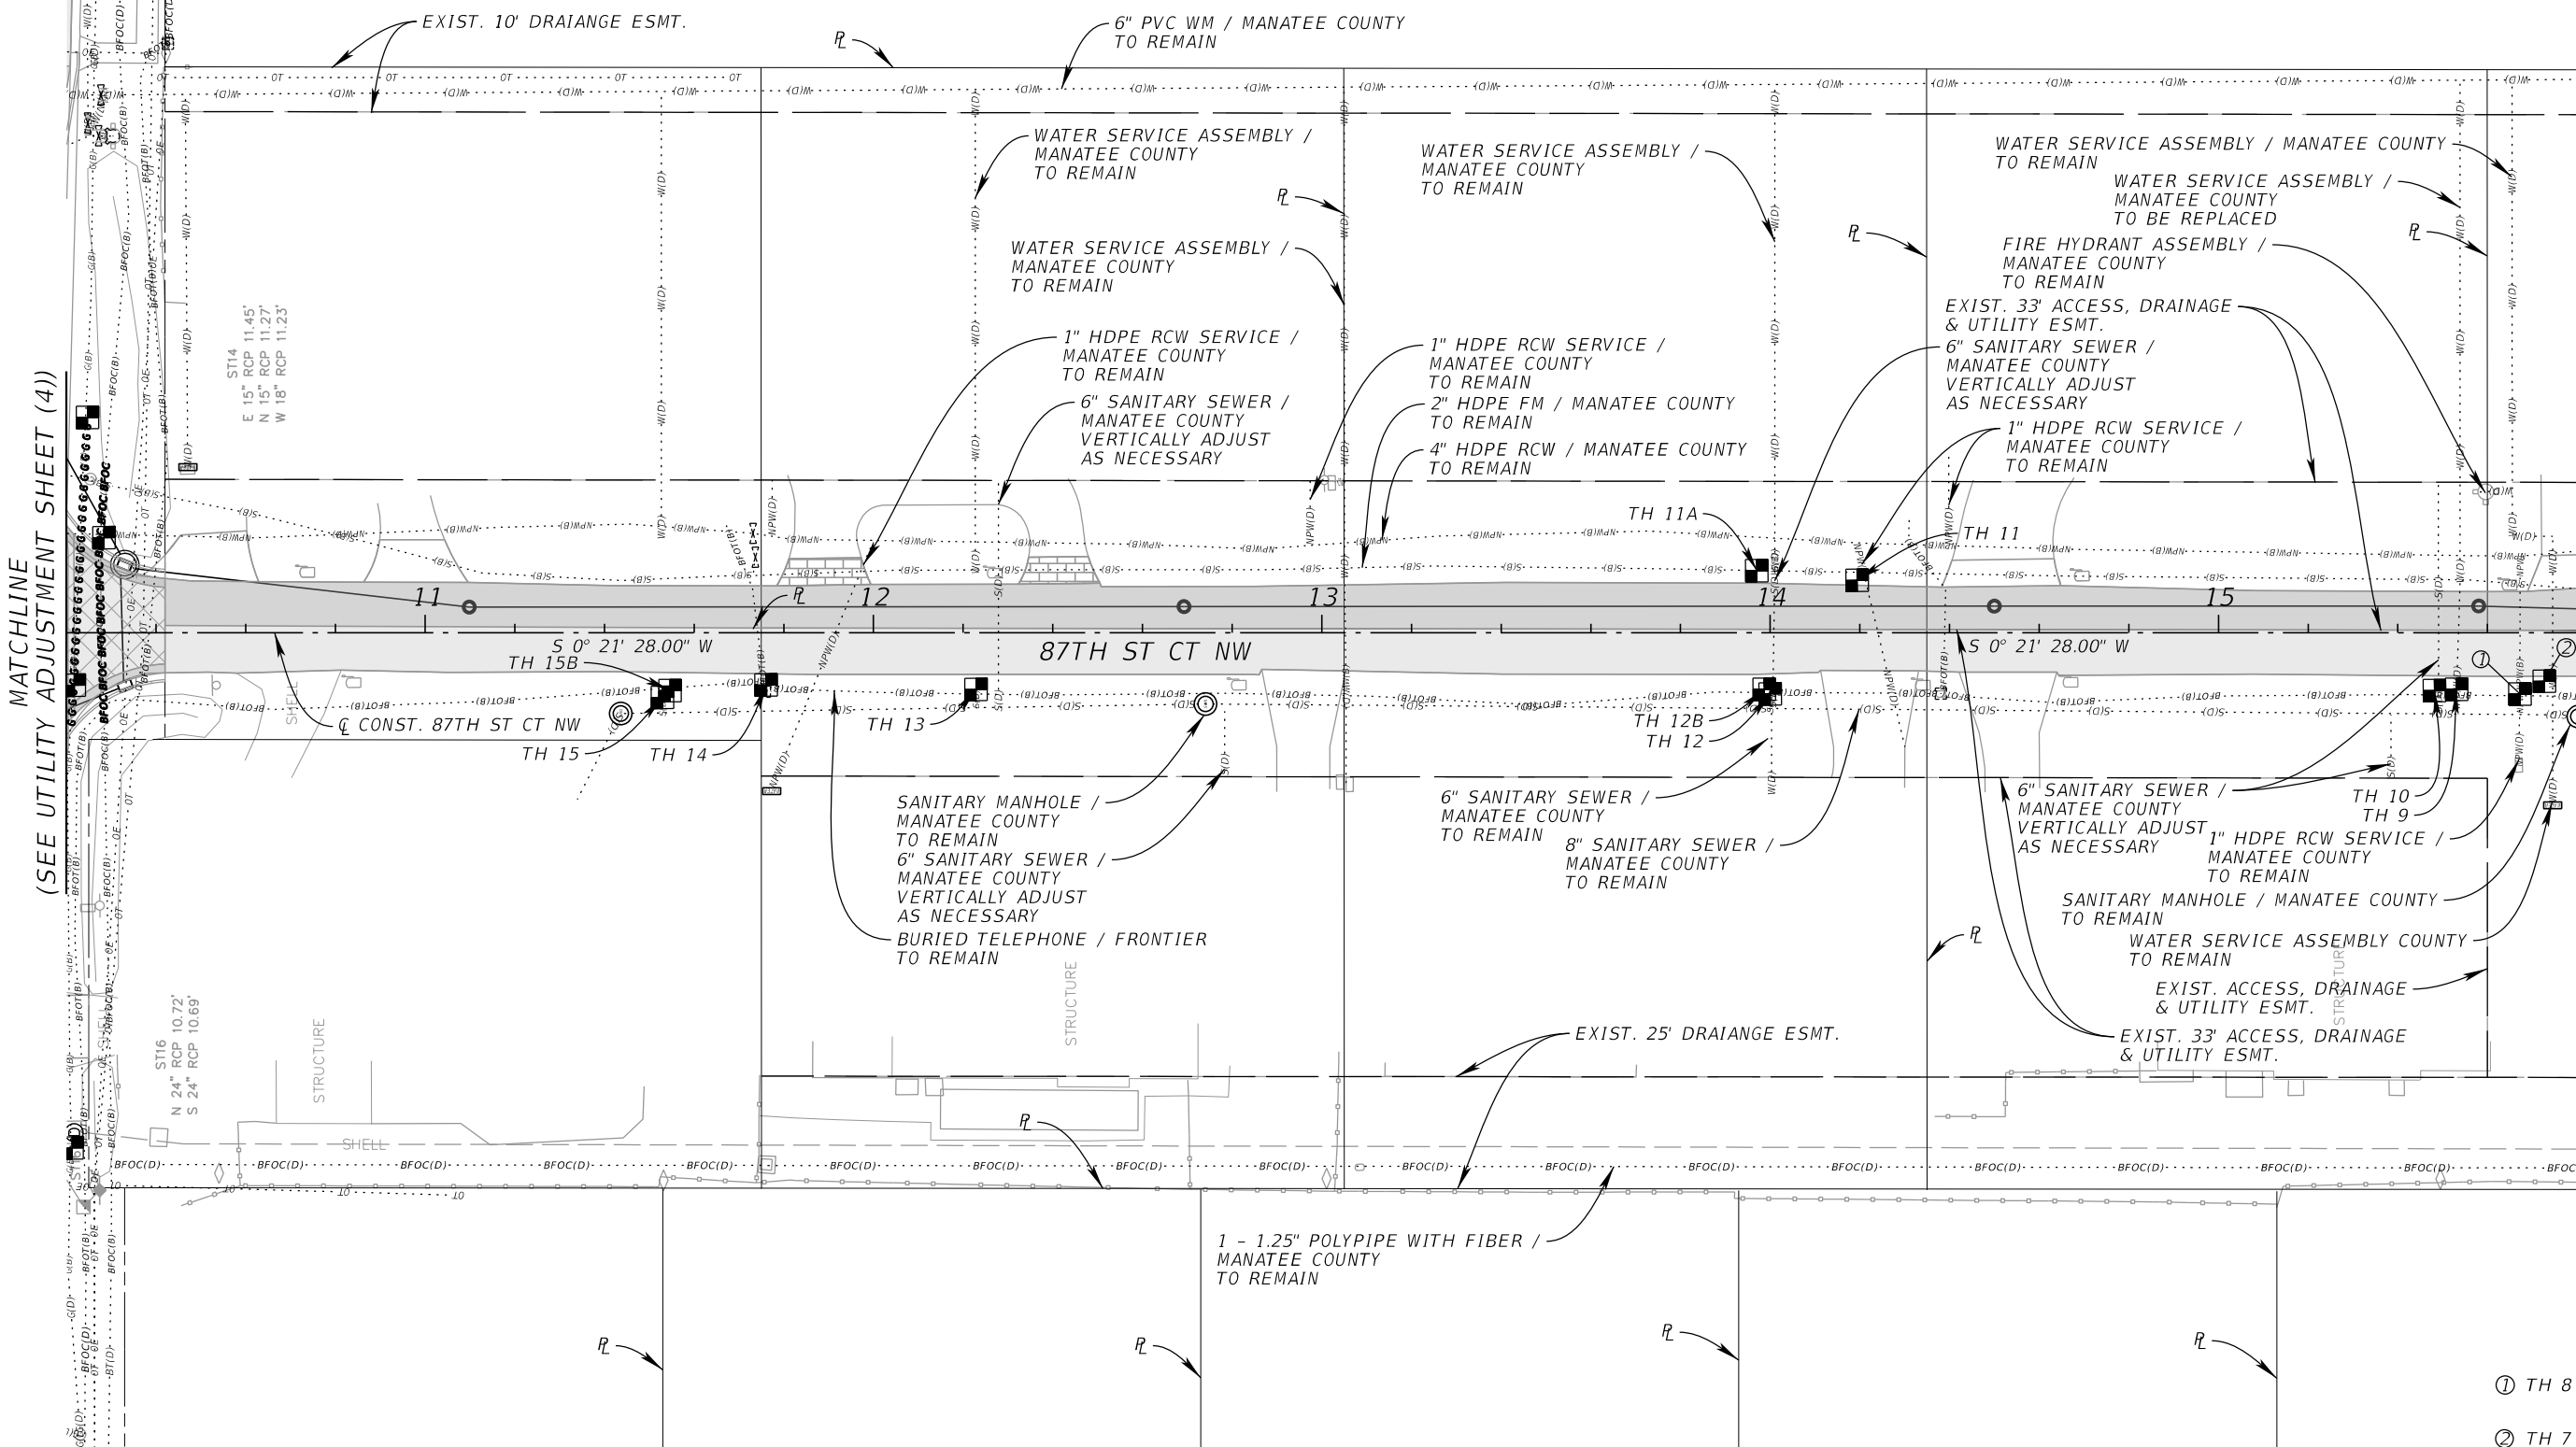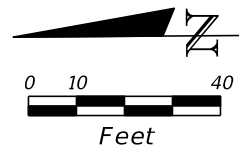UTILITY ADJUSTMENT  
SHEET (5)

SHEET NUMBER
120



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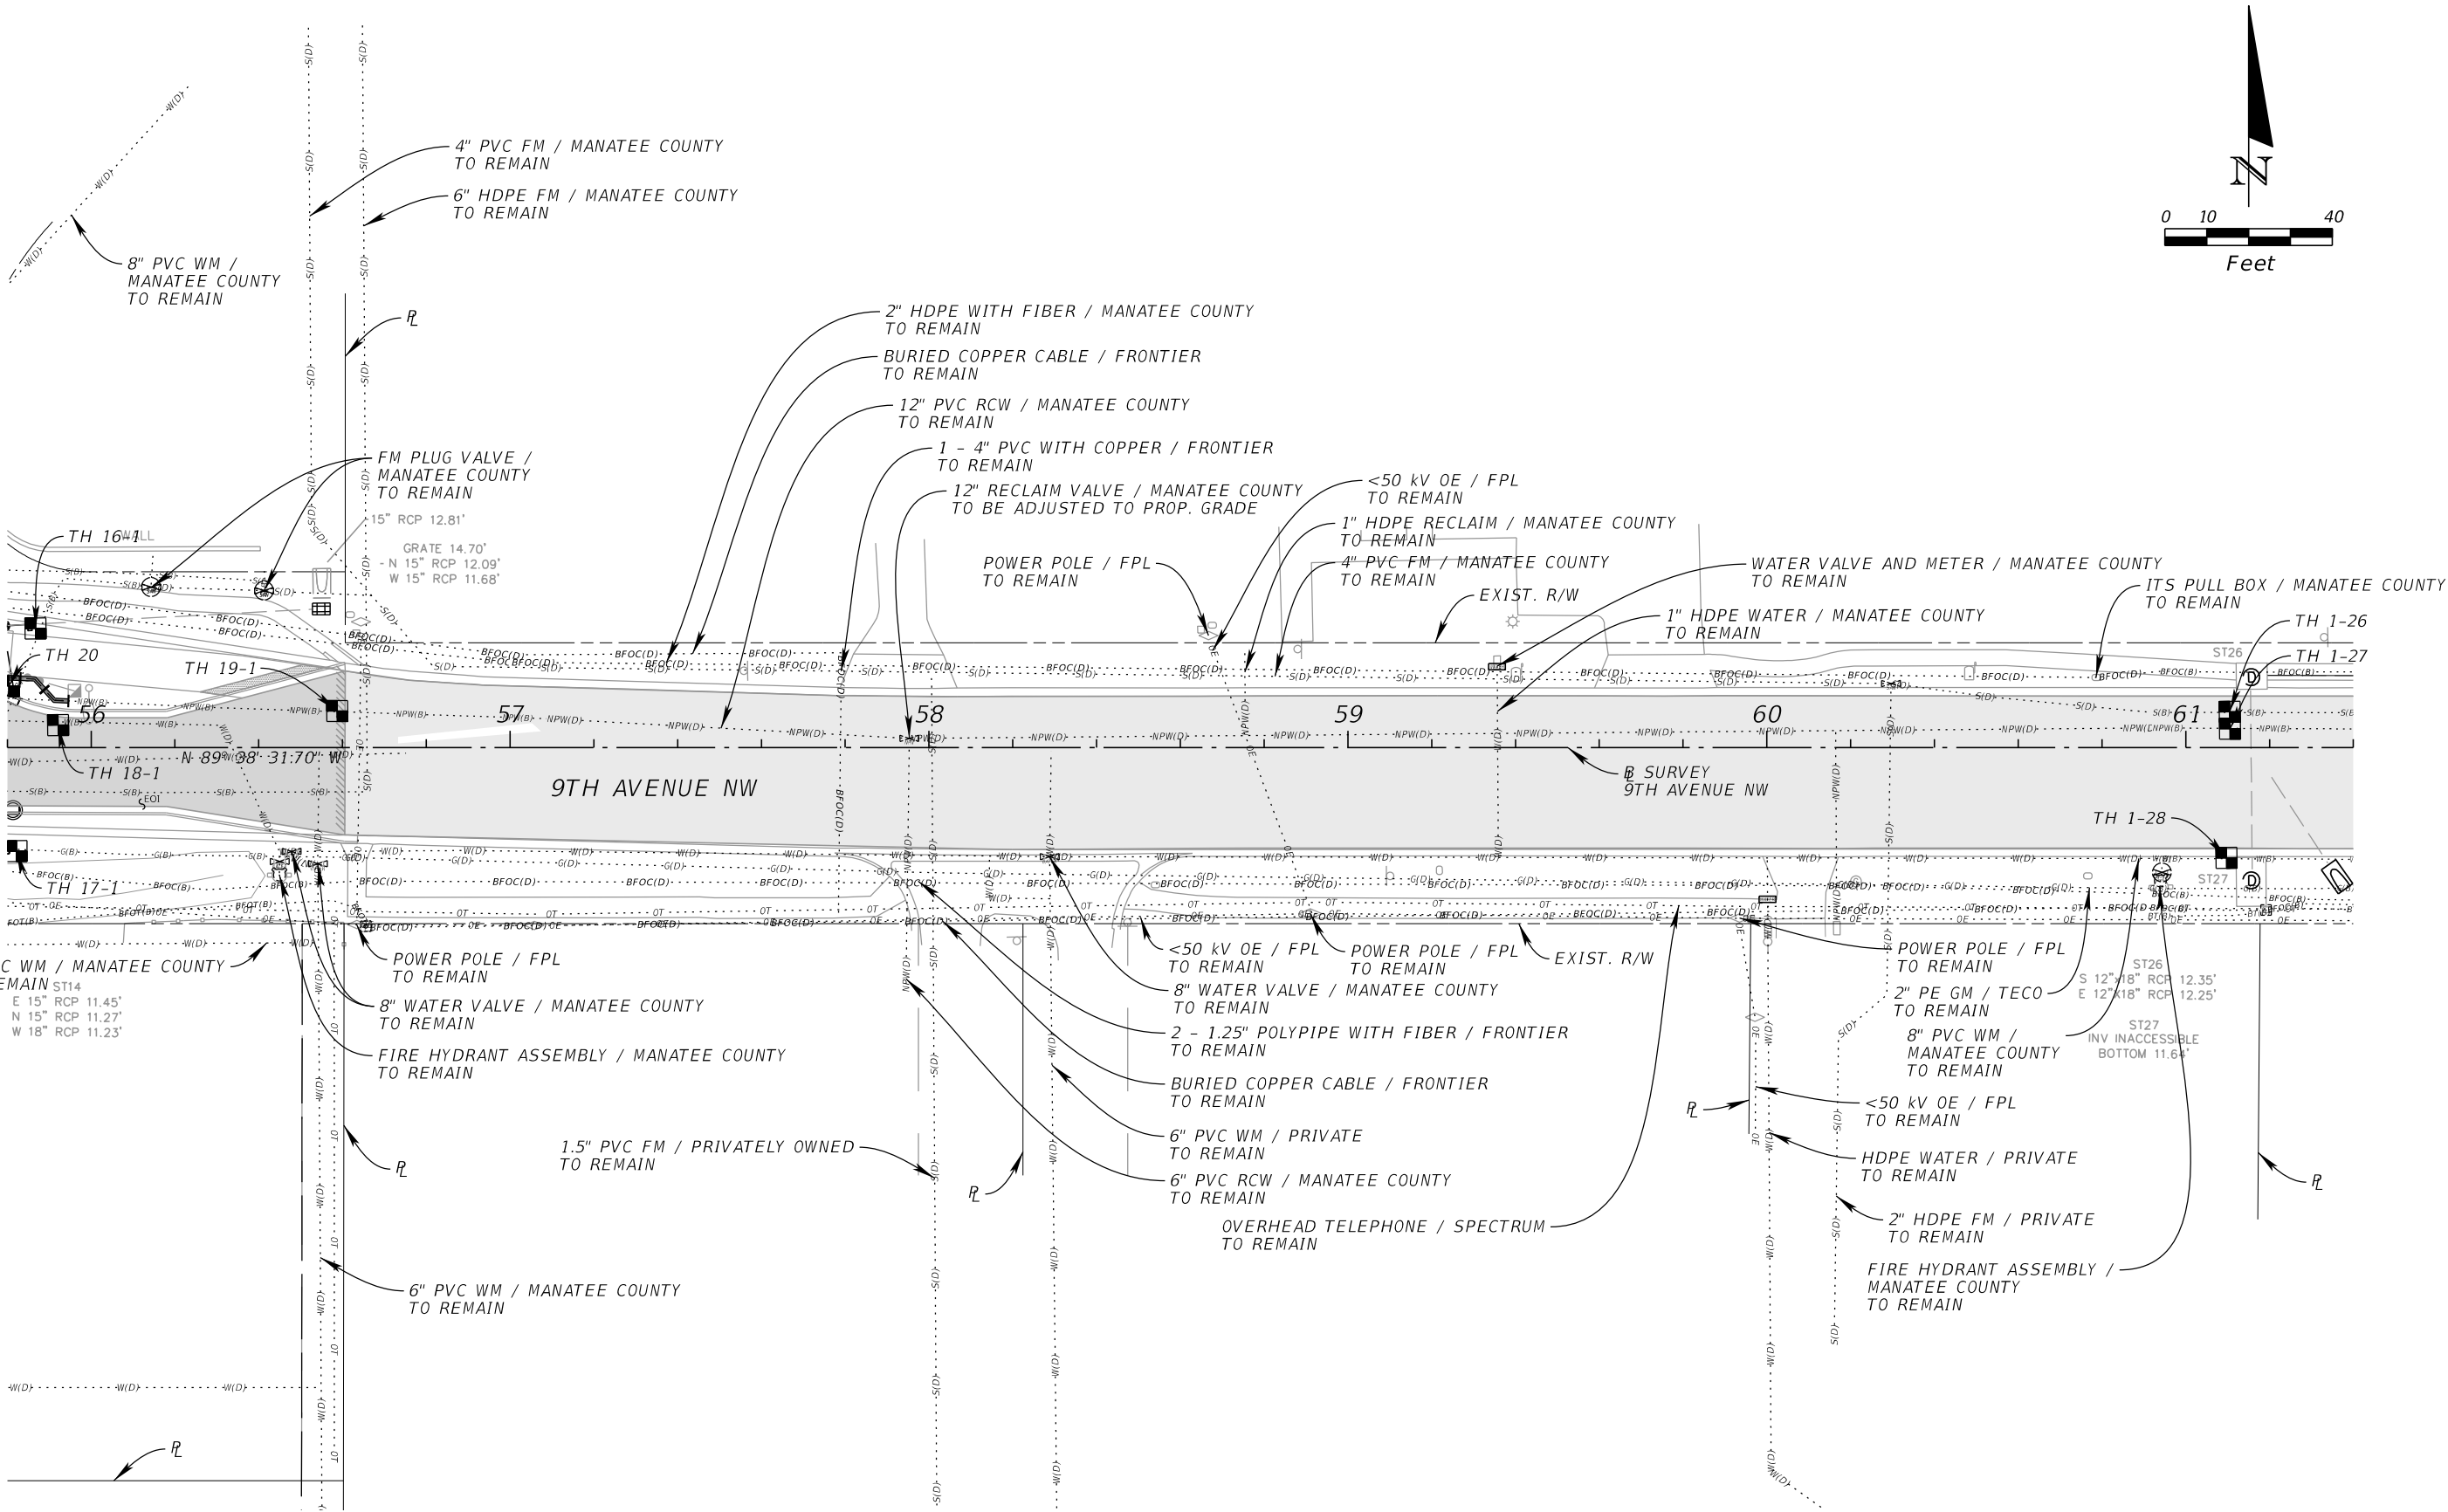
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JORDAN E. LEEP, P.E.
FL LICENSE NUMBER 76102
FL DATE:



UTILITY ADJUSTMENT  
SHEET (6)

SHEET NUMBER
121



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No.	REVISIONS	DATE	BY						

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9TH AVENUE NW

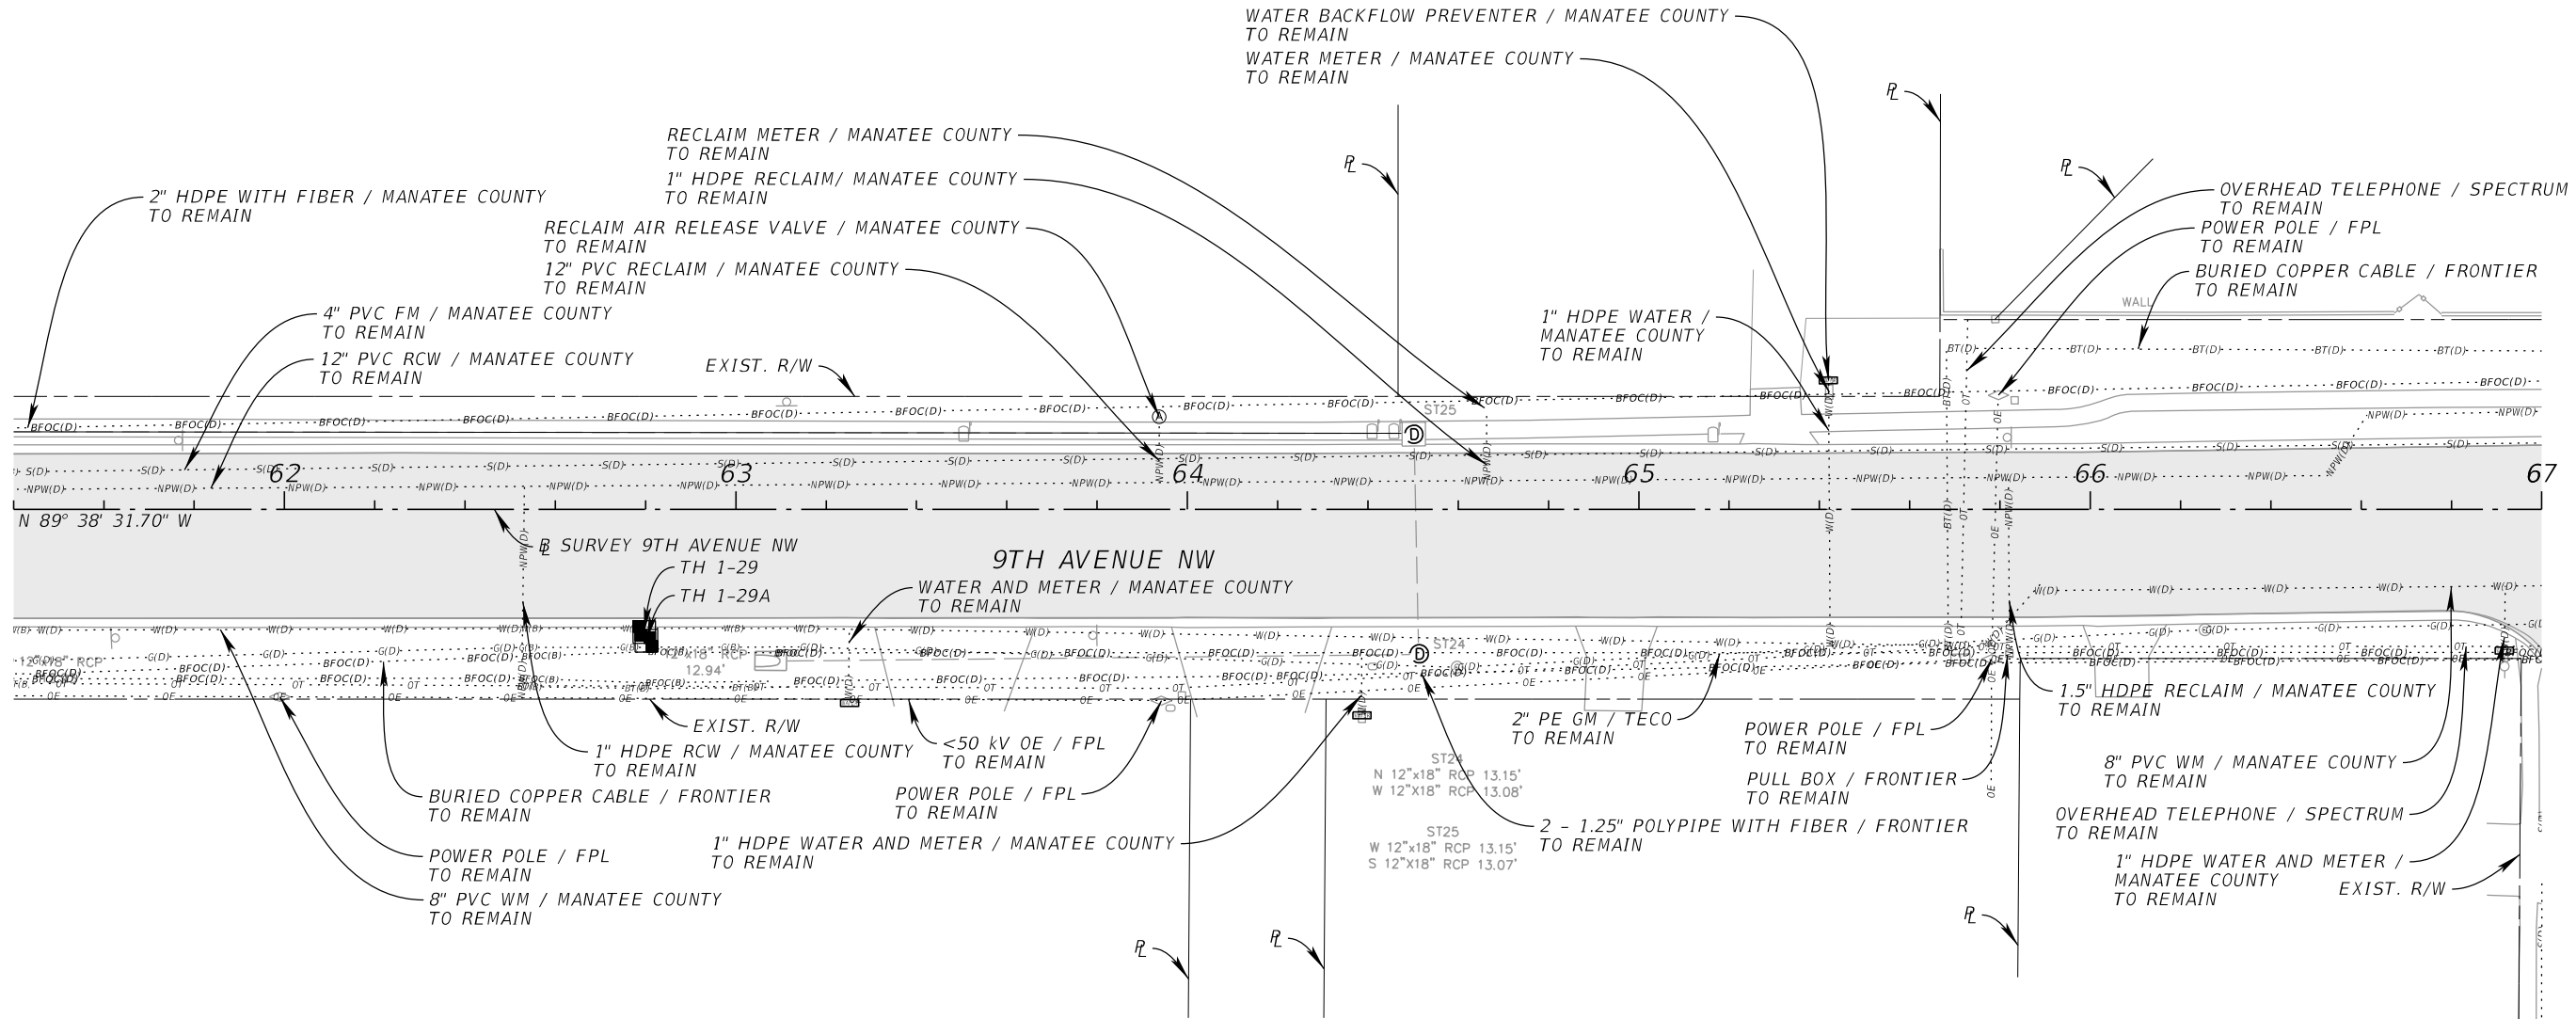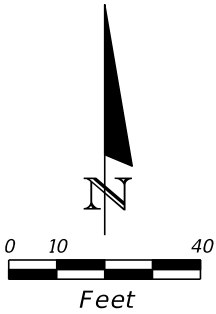MANATEE COUNTY

FL



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JORDAN E. LEEP, P.E.
FL LICENSE NUMBER 76102

UTILITY ADJUSTMENT  
SHEET (8)

SHEET NUMBER
123

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148400070


DATE  
10/02/2025

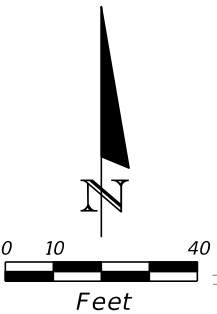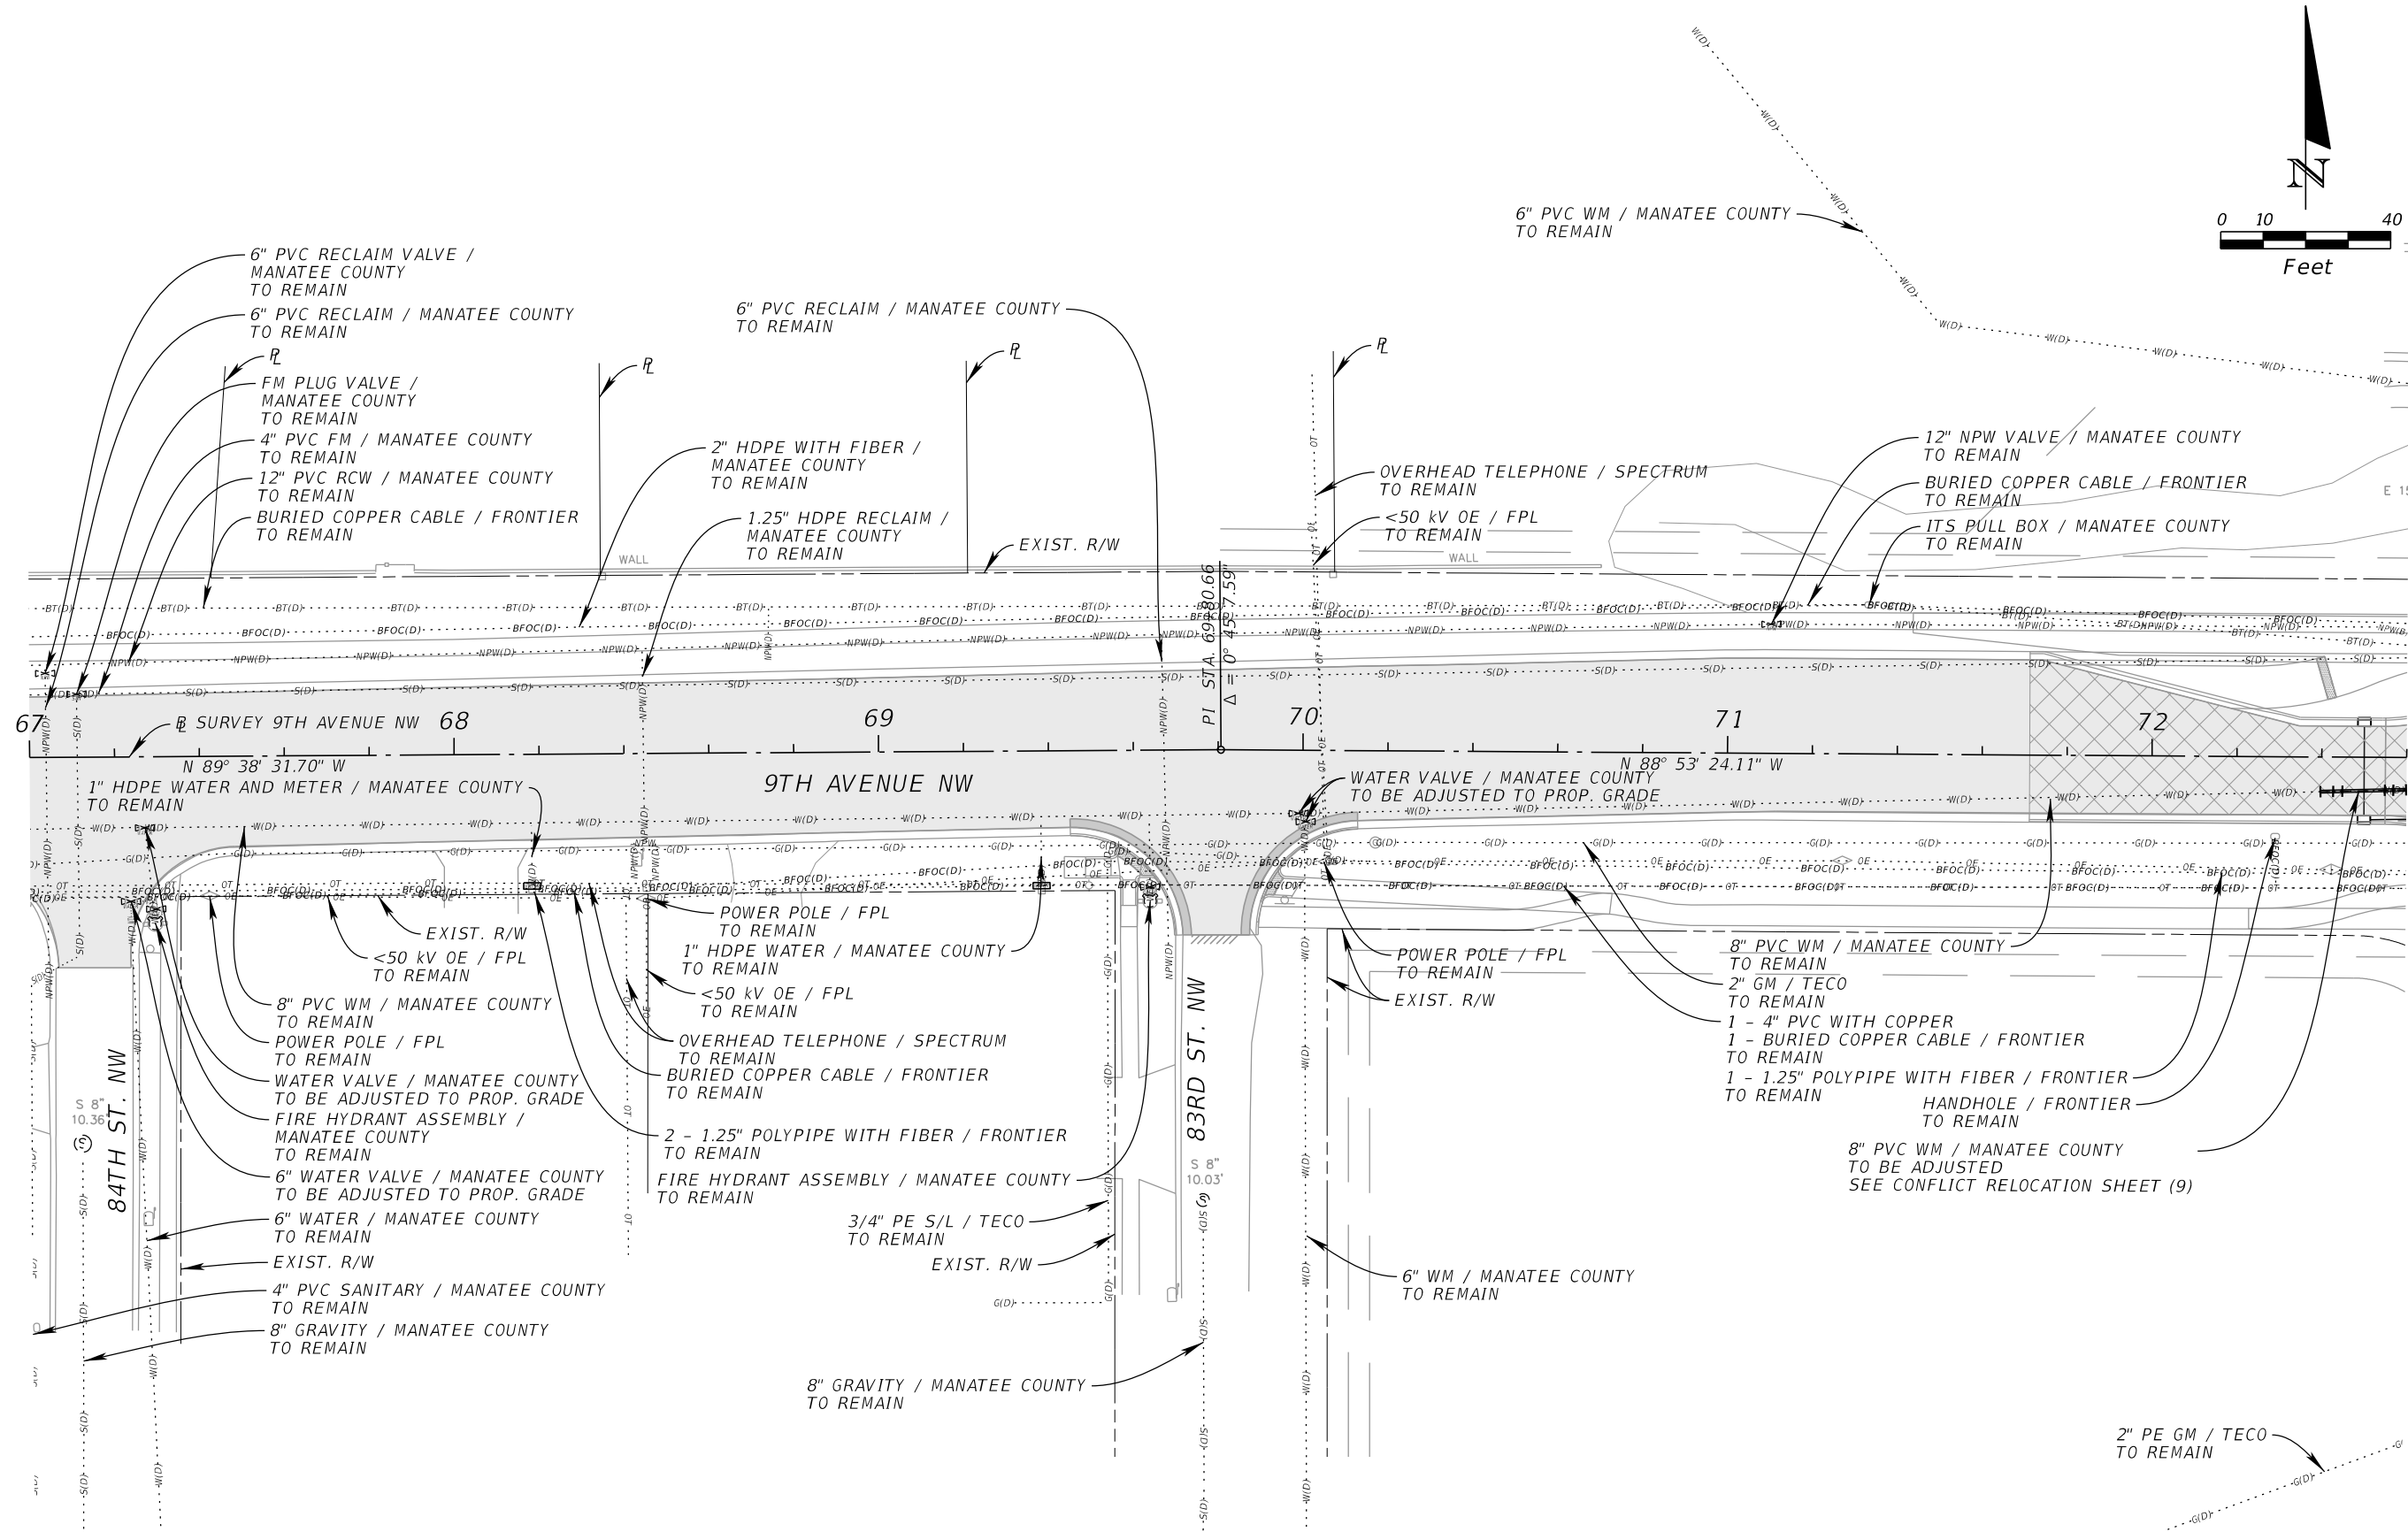SCALE AS SHOWN

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9TH AVENUE NW

MANATEE COUNTY



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JORDAN E. LEEP, P.E.  
FL LICENSE NUMBER 76102

FL DATE:

UTILITY ADJUSTMENT  
SHEET (9)

SHEET NUMBER  
124


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No.	REVISIONS	DATE	BY
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RAISED INTERSECTION PROJECT  
COMPLETED UNDER SEPARATE CONTRACT

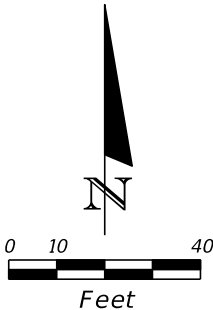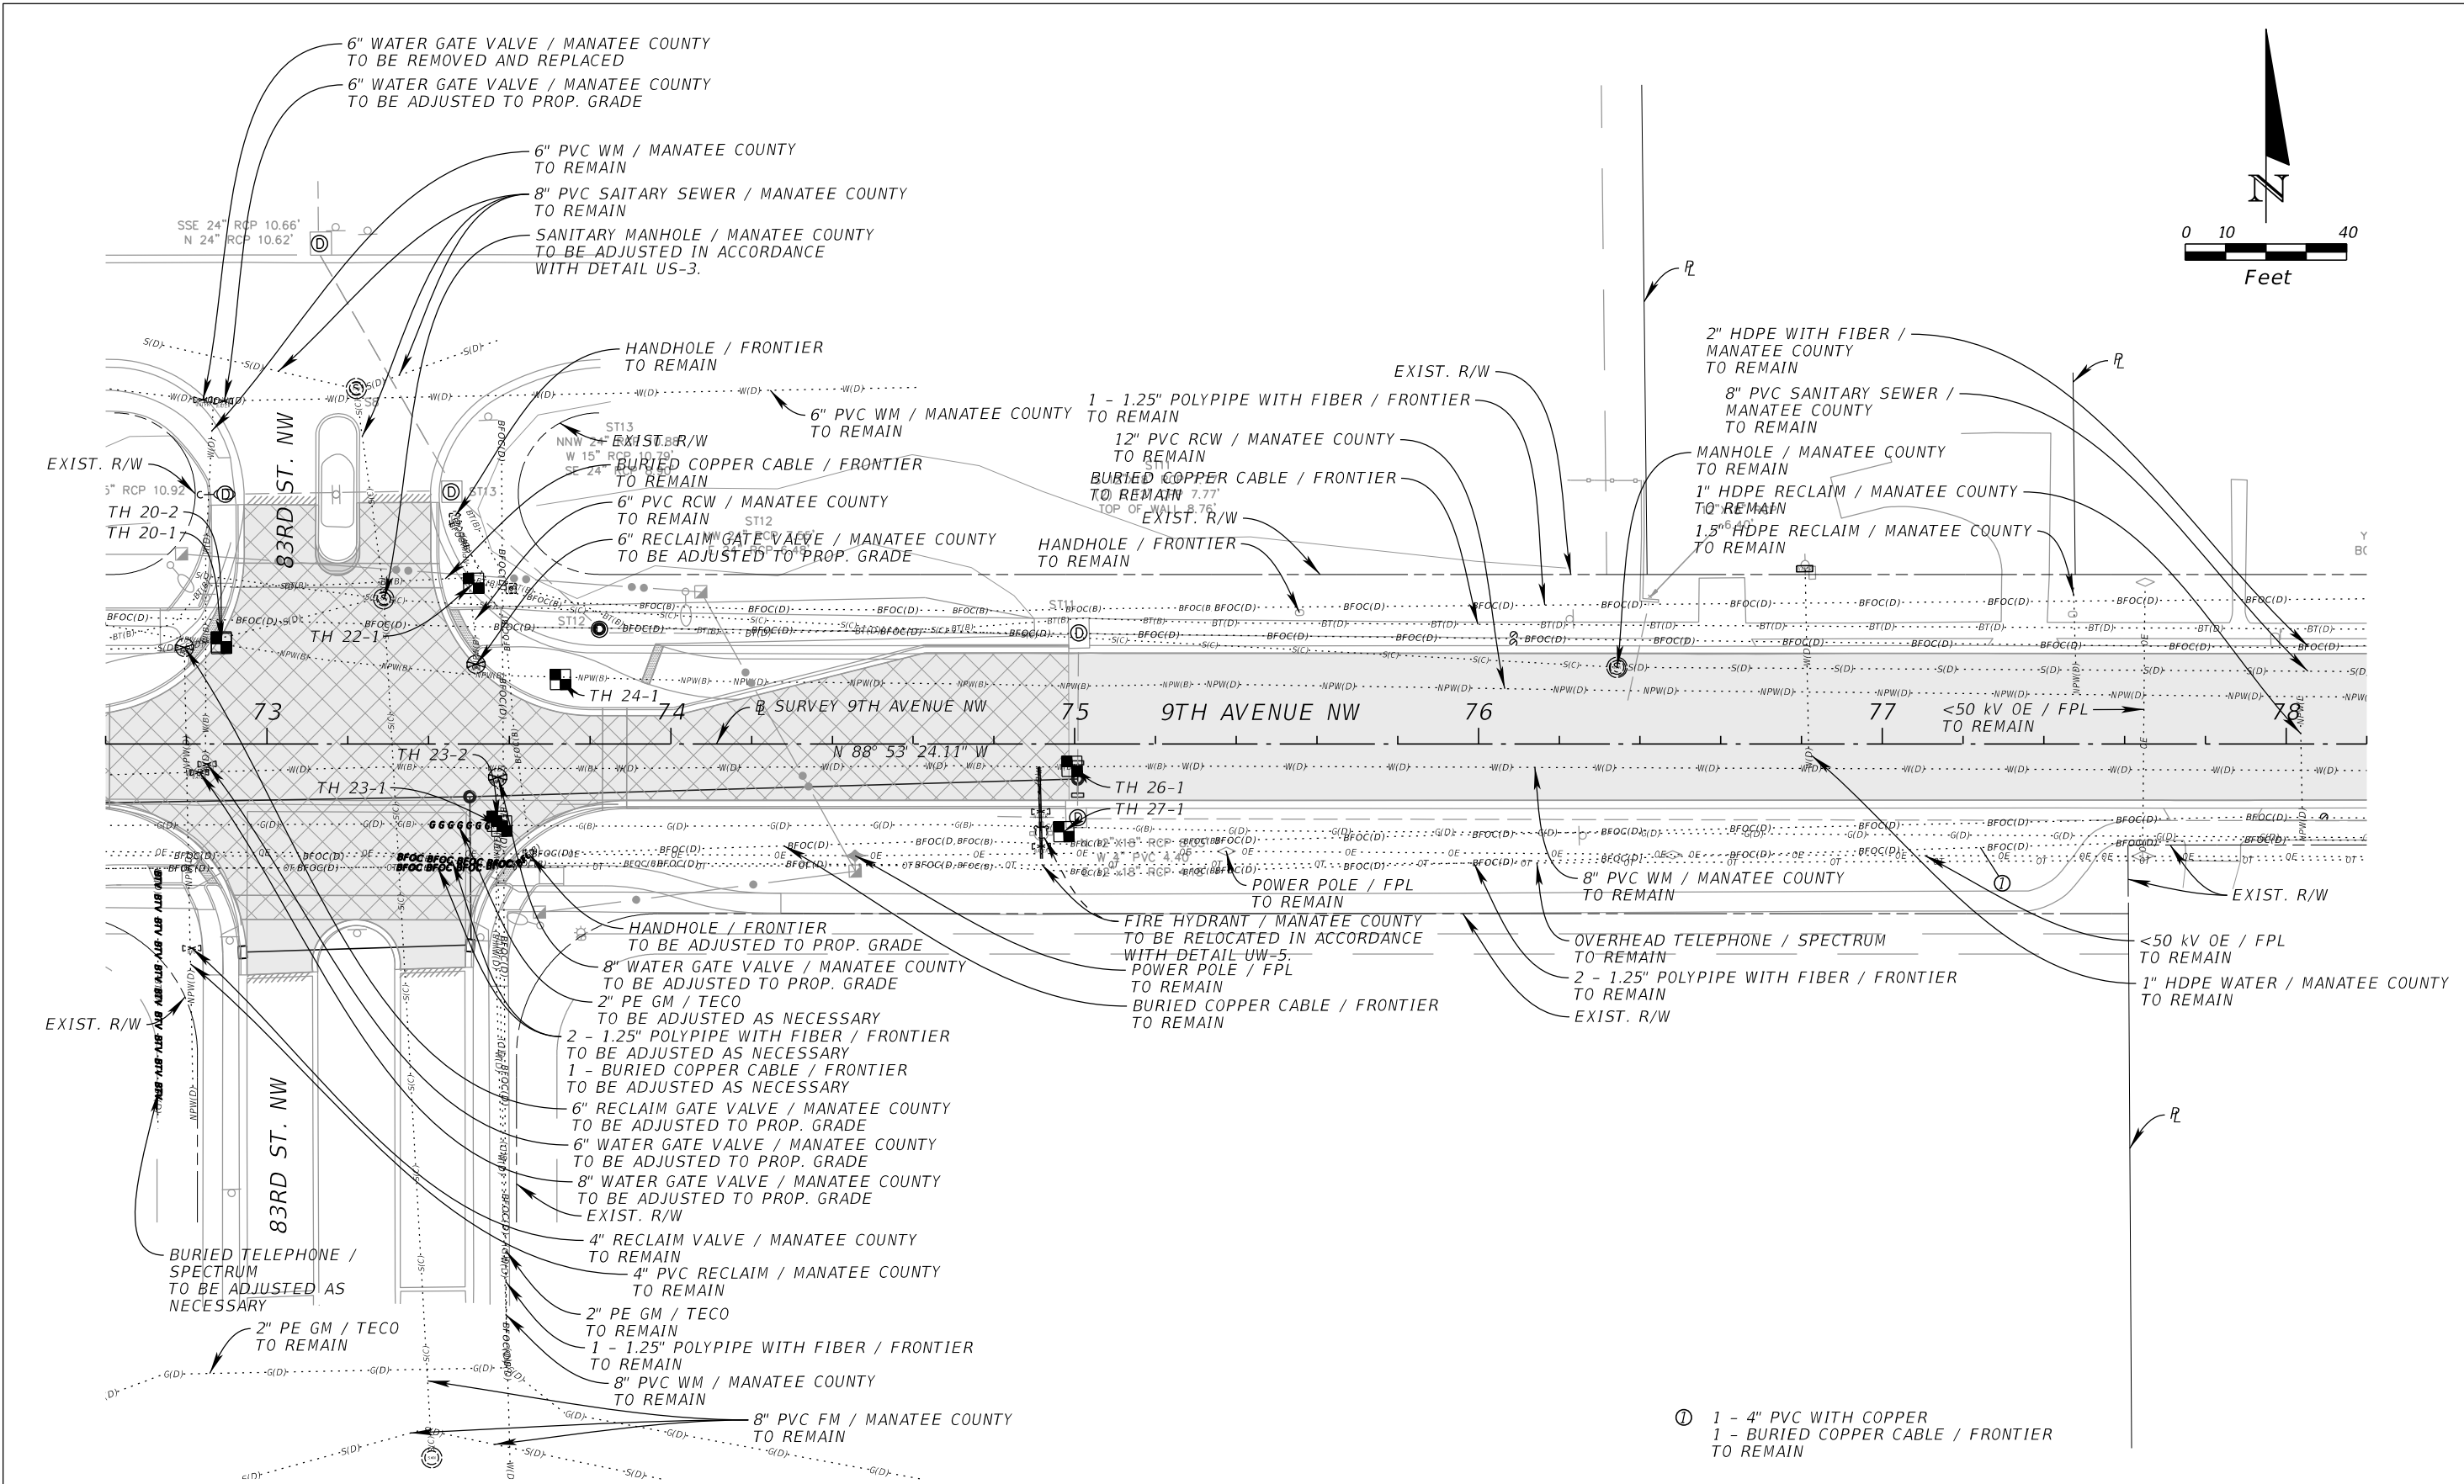No.	REVISIONS	DATE	BY



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9TH AVENUE NW

MANATEE COUNTY

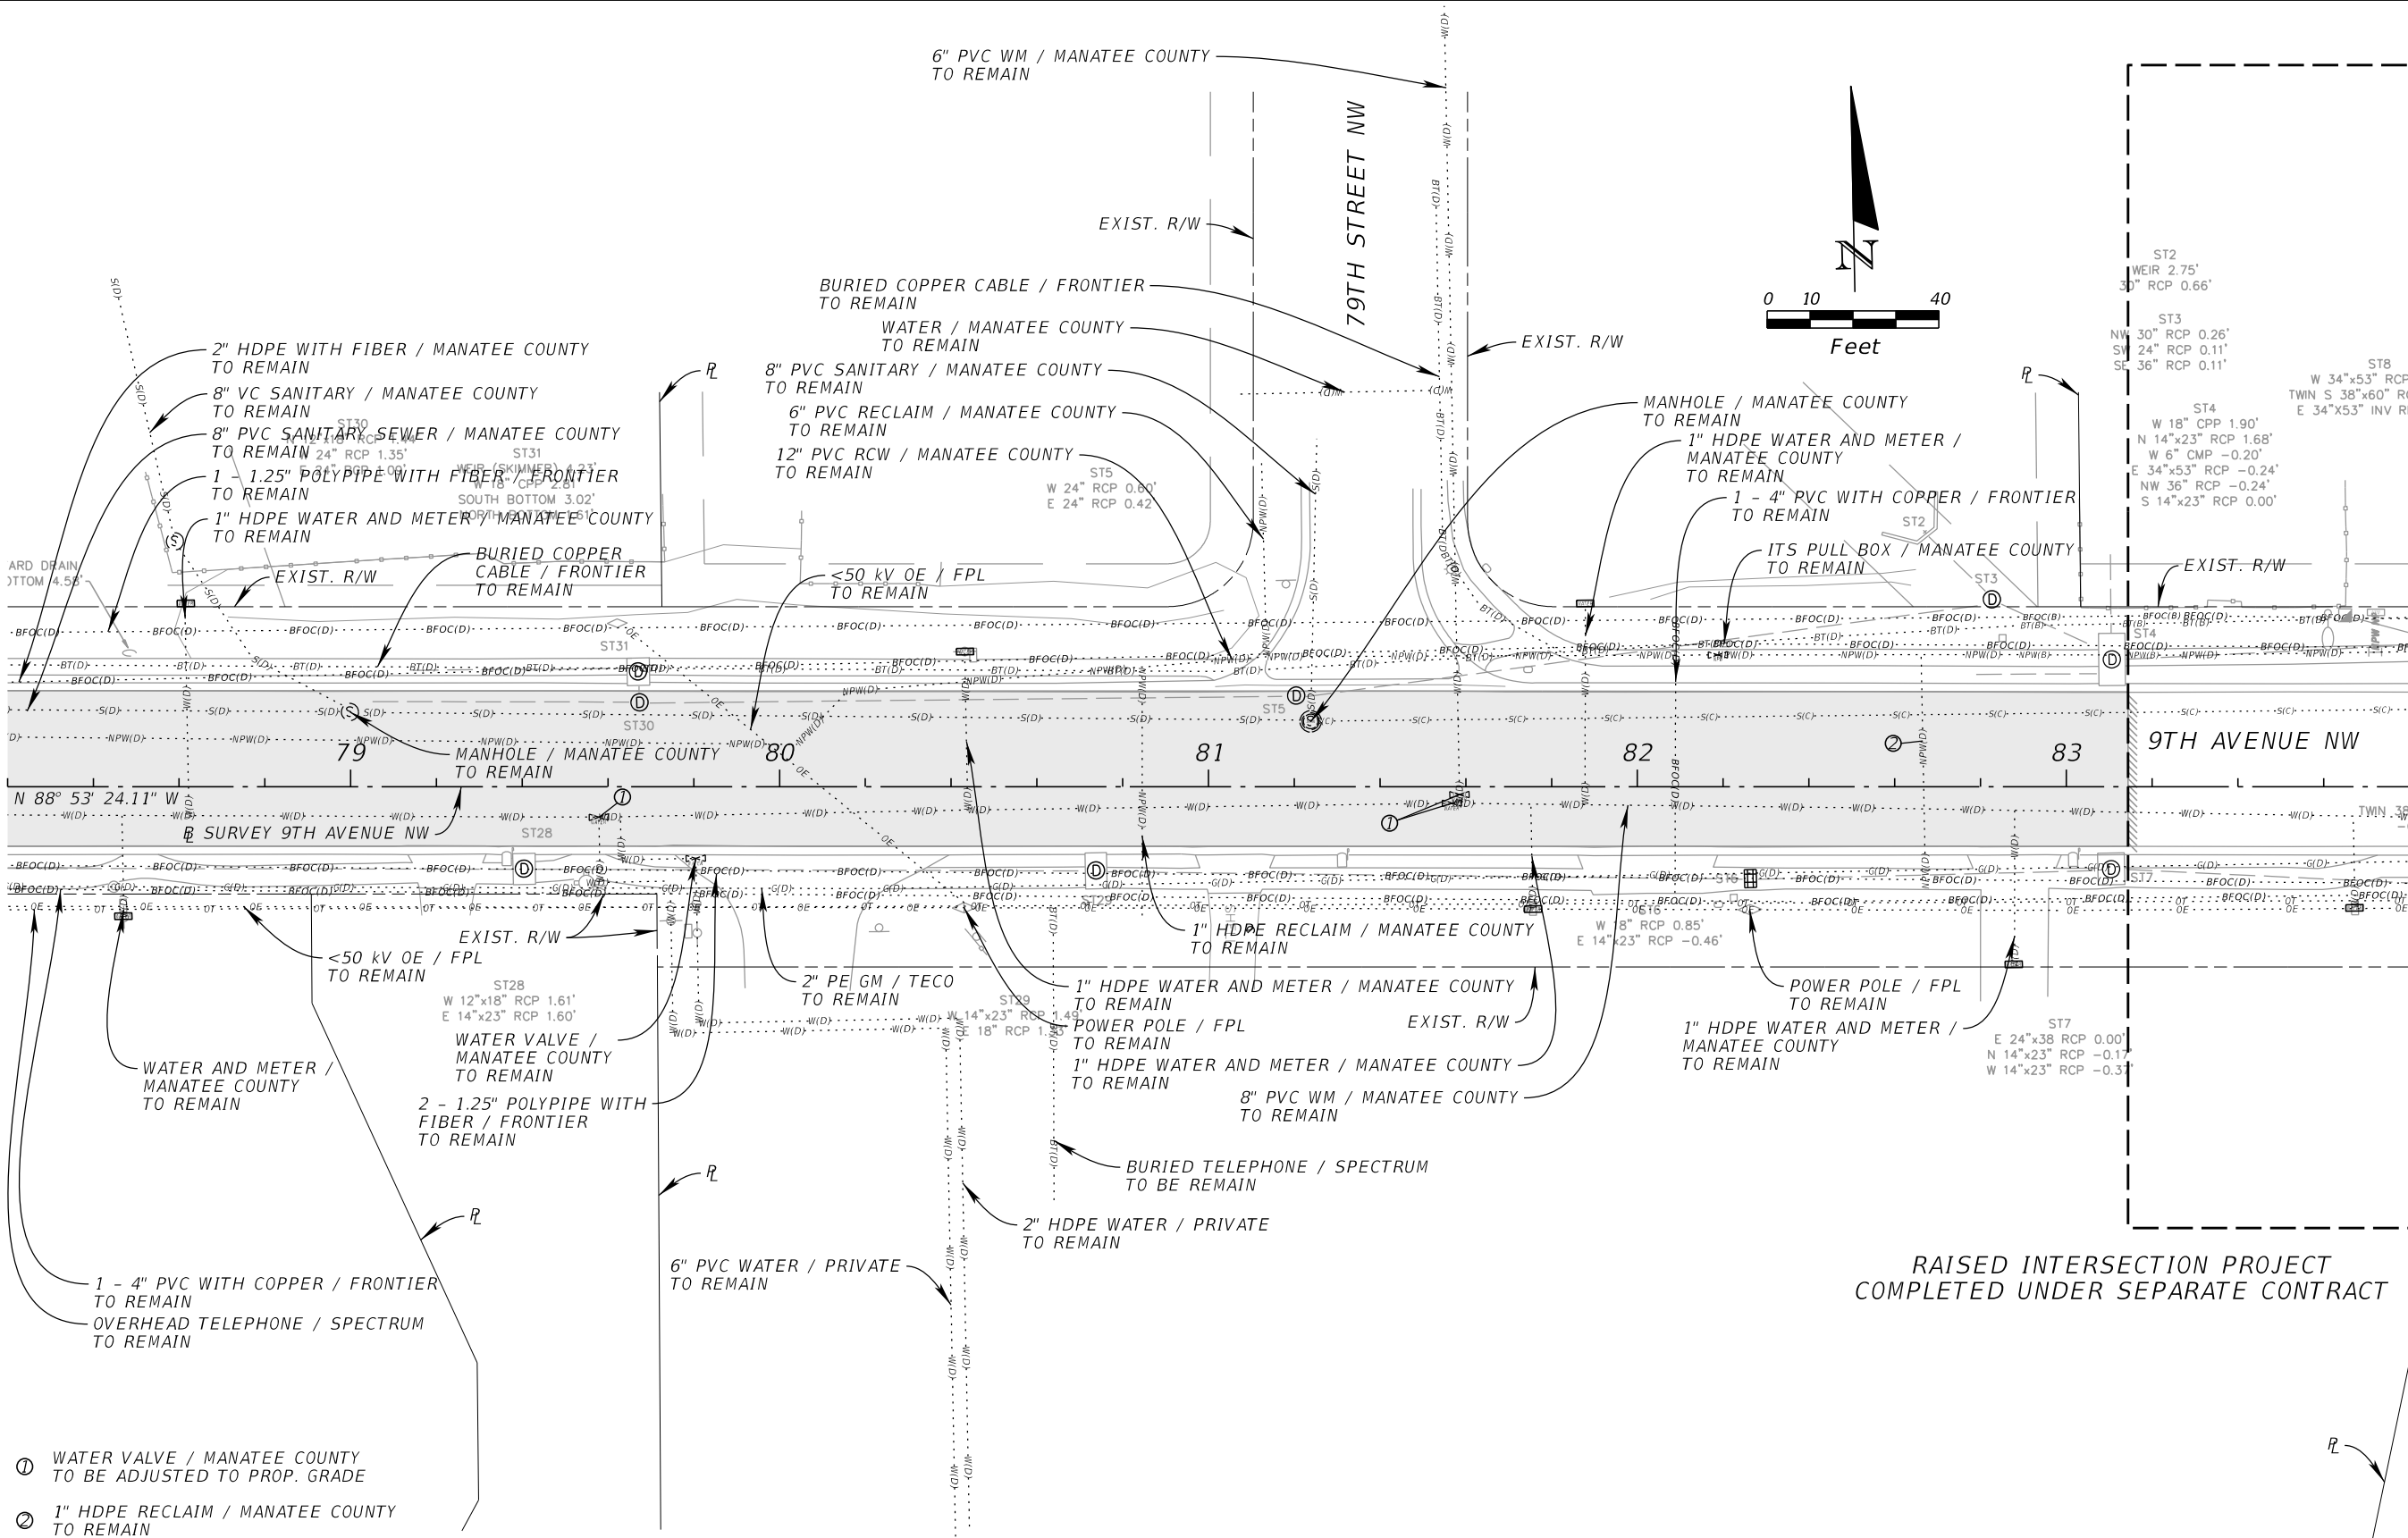LICENSED PROFESSIONAL


JORDAN E. LEEP, P.E.  
FL LICENSE NUMBER 76102

FL DATE:

UTILITY ADJUSTMENT  
SHEET (11)

SHEET NUMBER

126

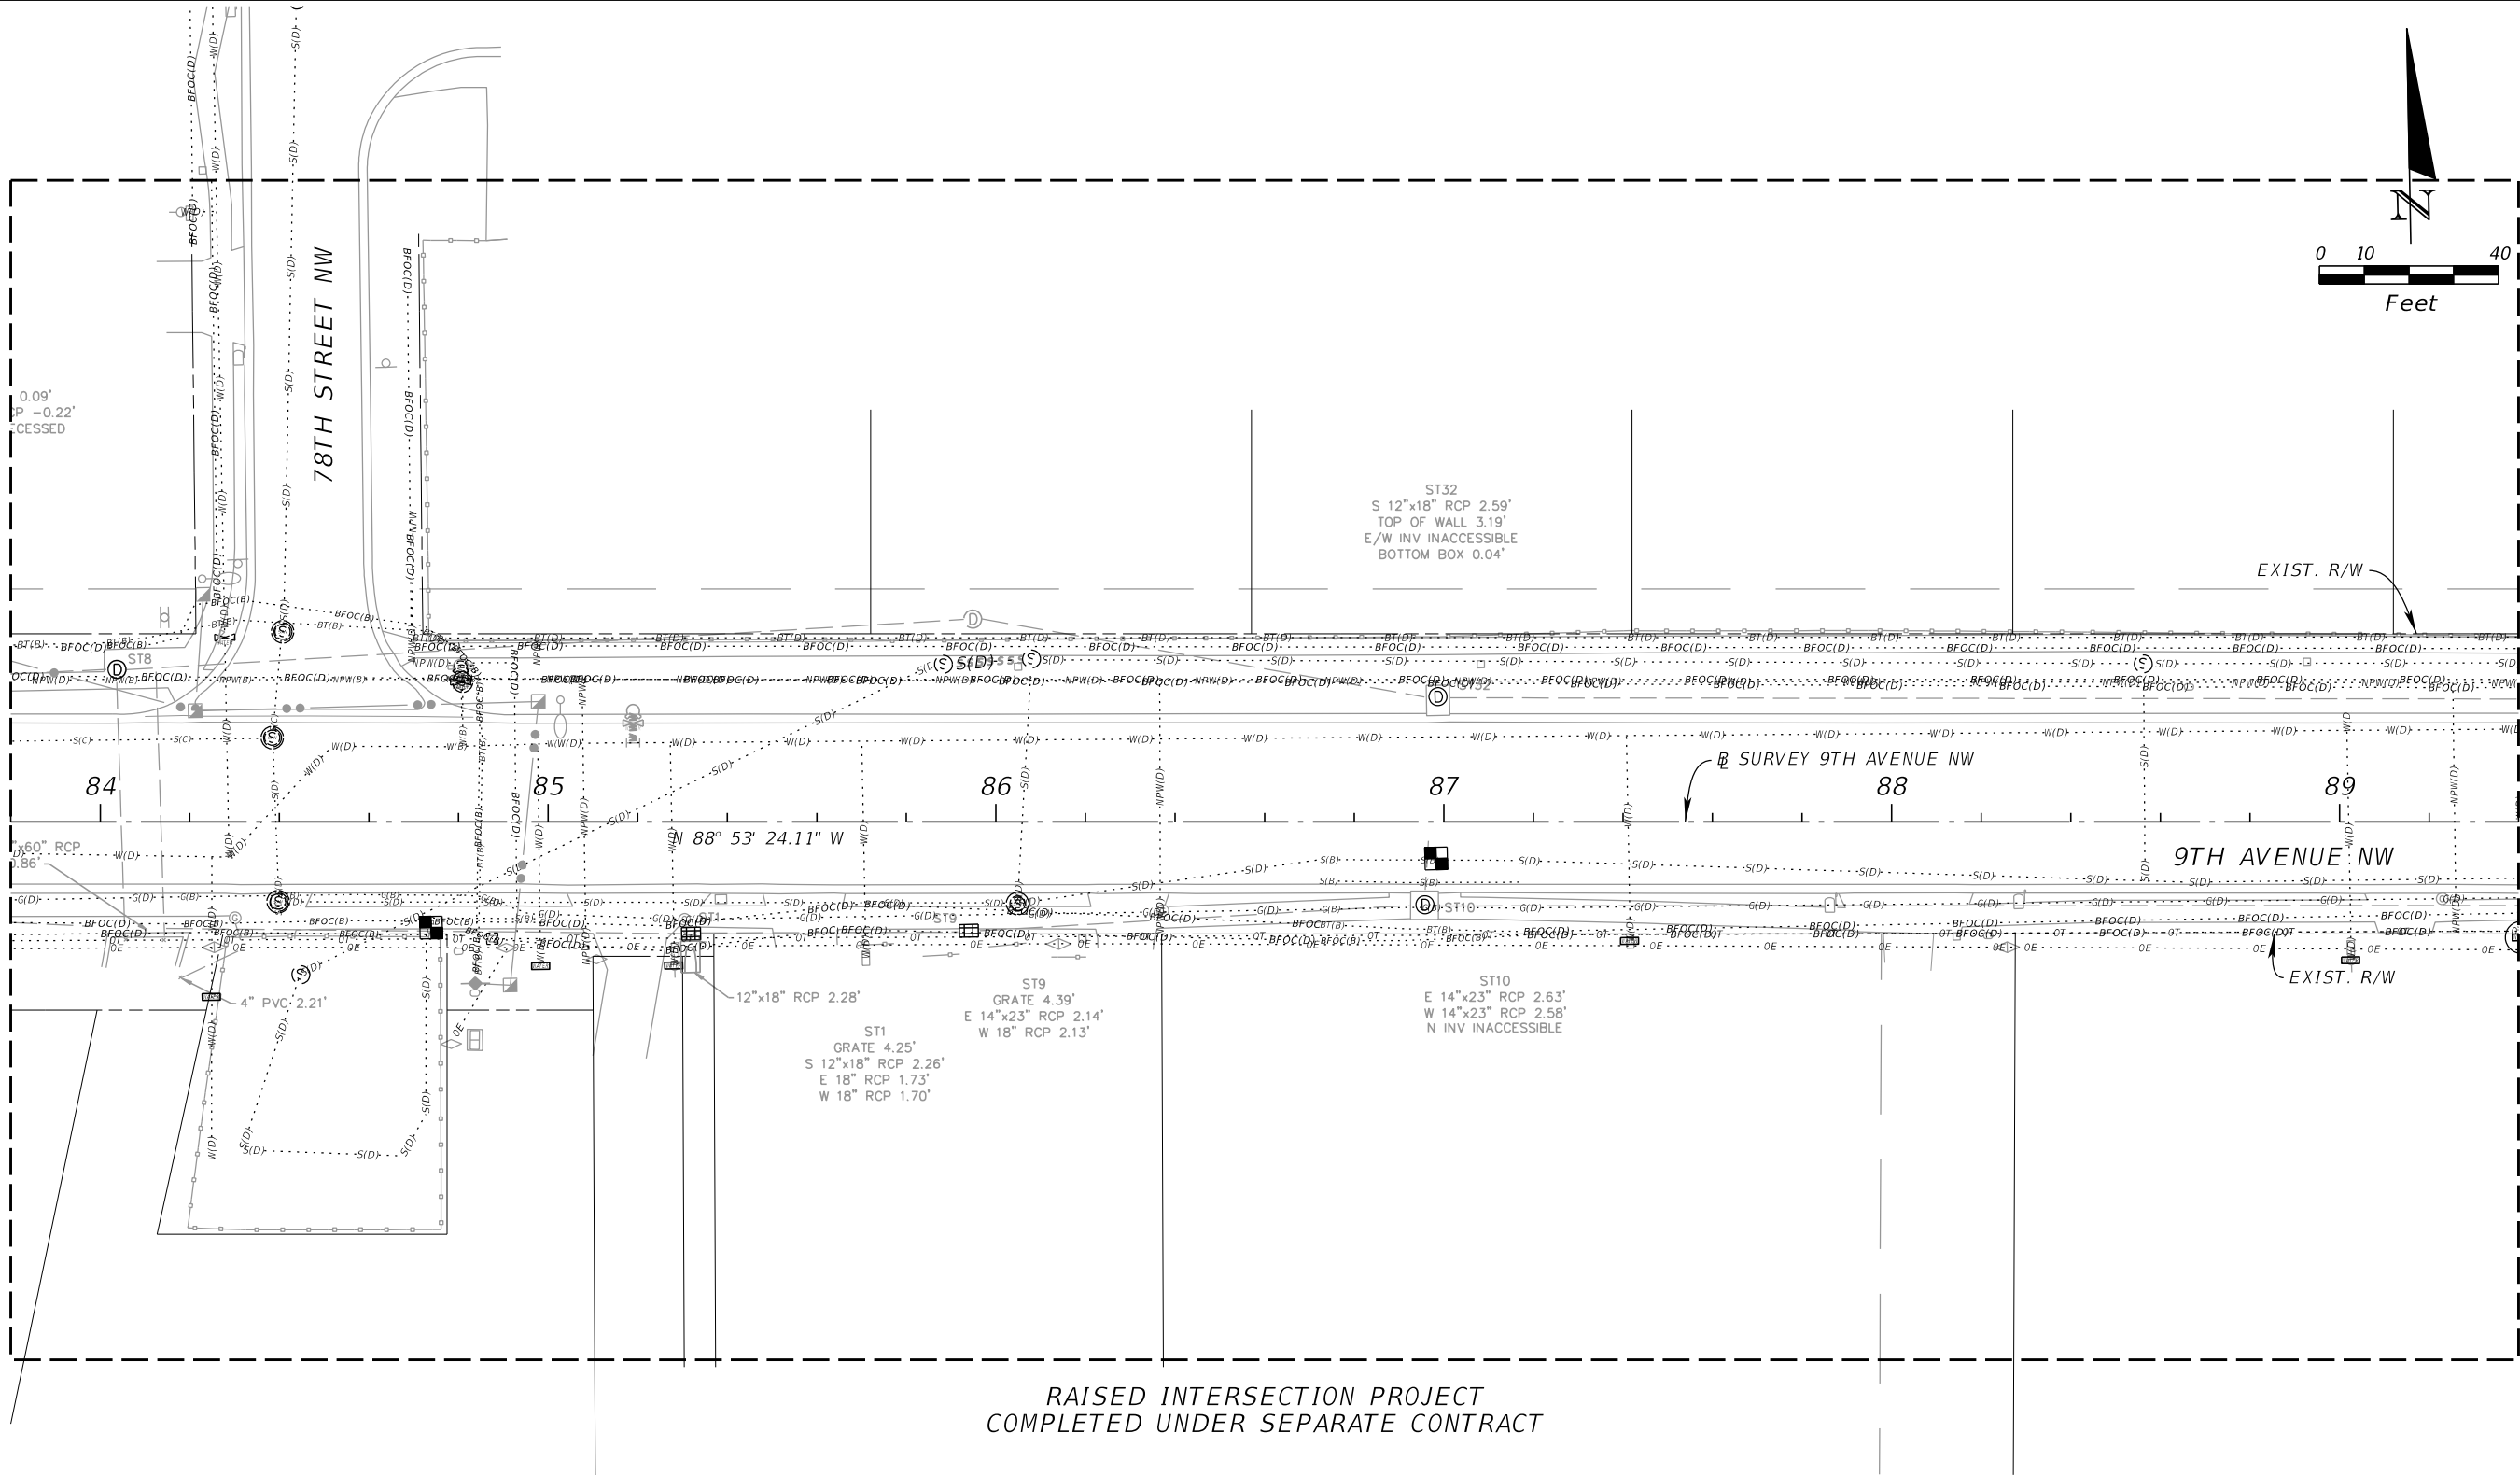


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MANATEE COUNTY

LICENSED PROFESSIONAL

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FL LICENSE NUMBER 76102


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UTILITY ADJUSTMENT  
SHEET (12)

SHEET NUMBER

127

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JORDAN E. LEEP, P.E.  
FL LICENSE NUMBER 76102



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SHEET (13)

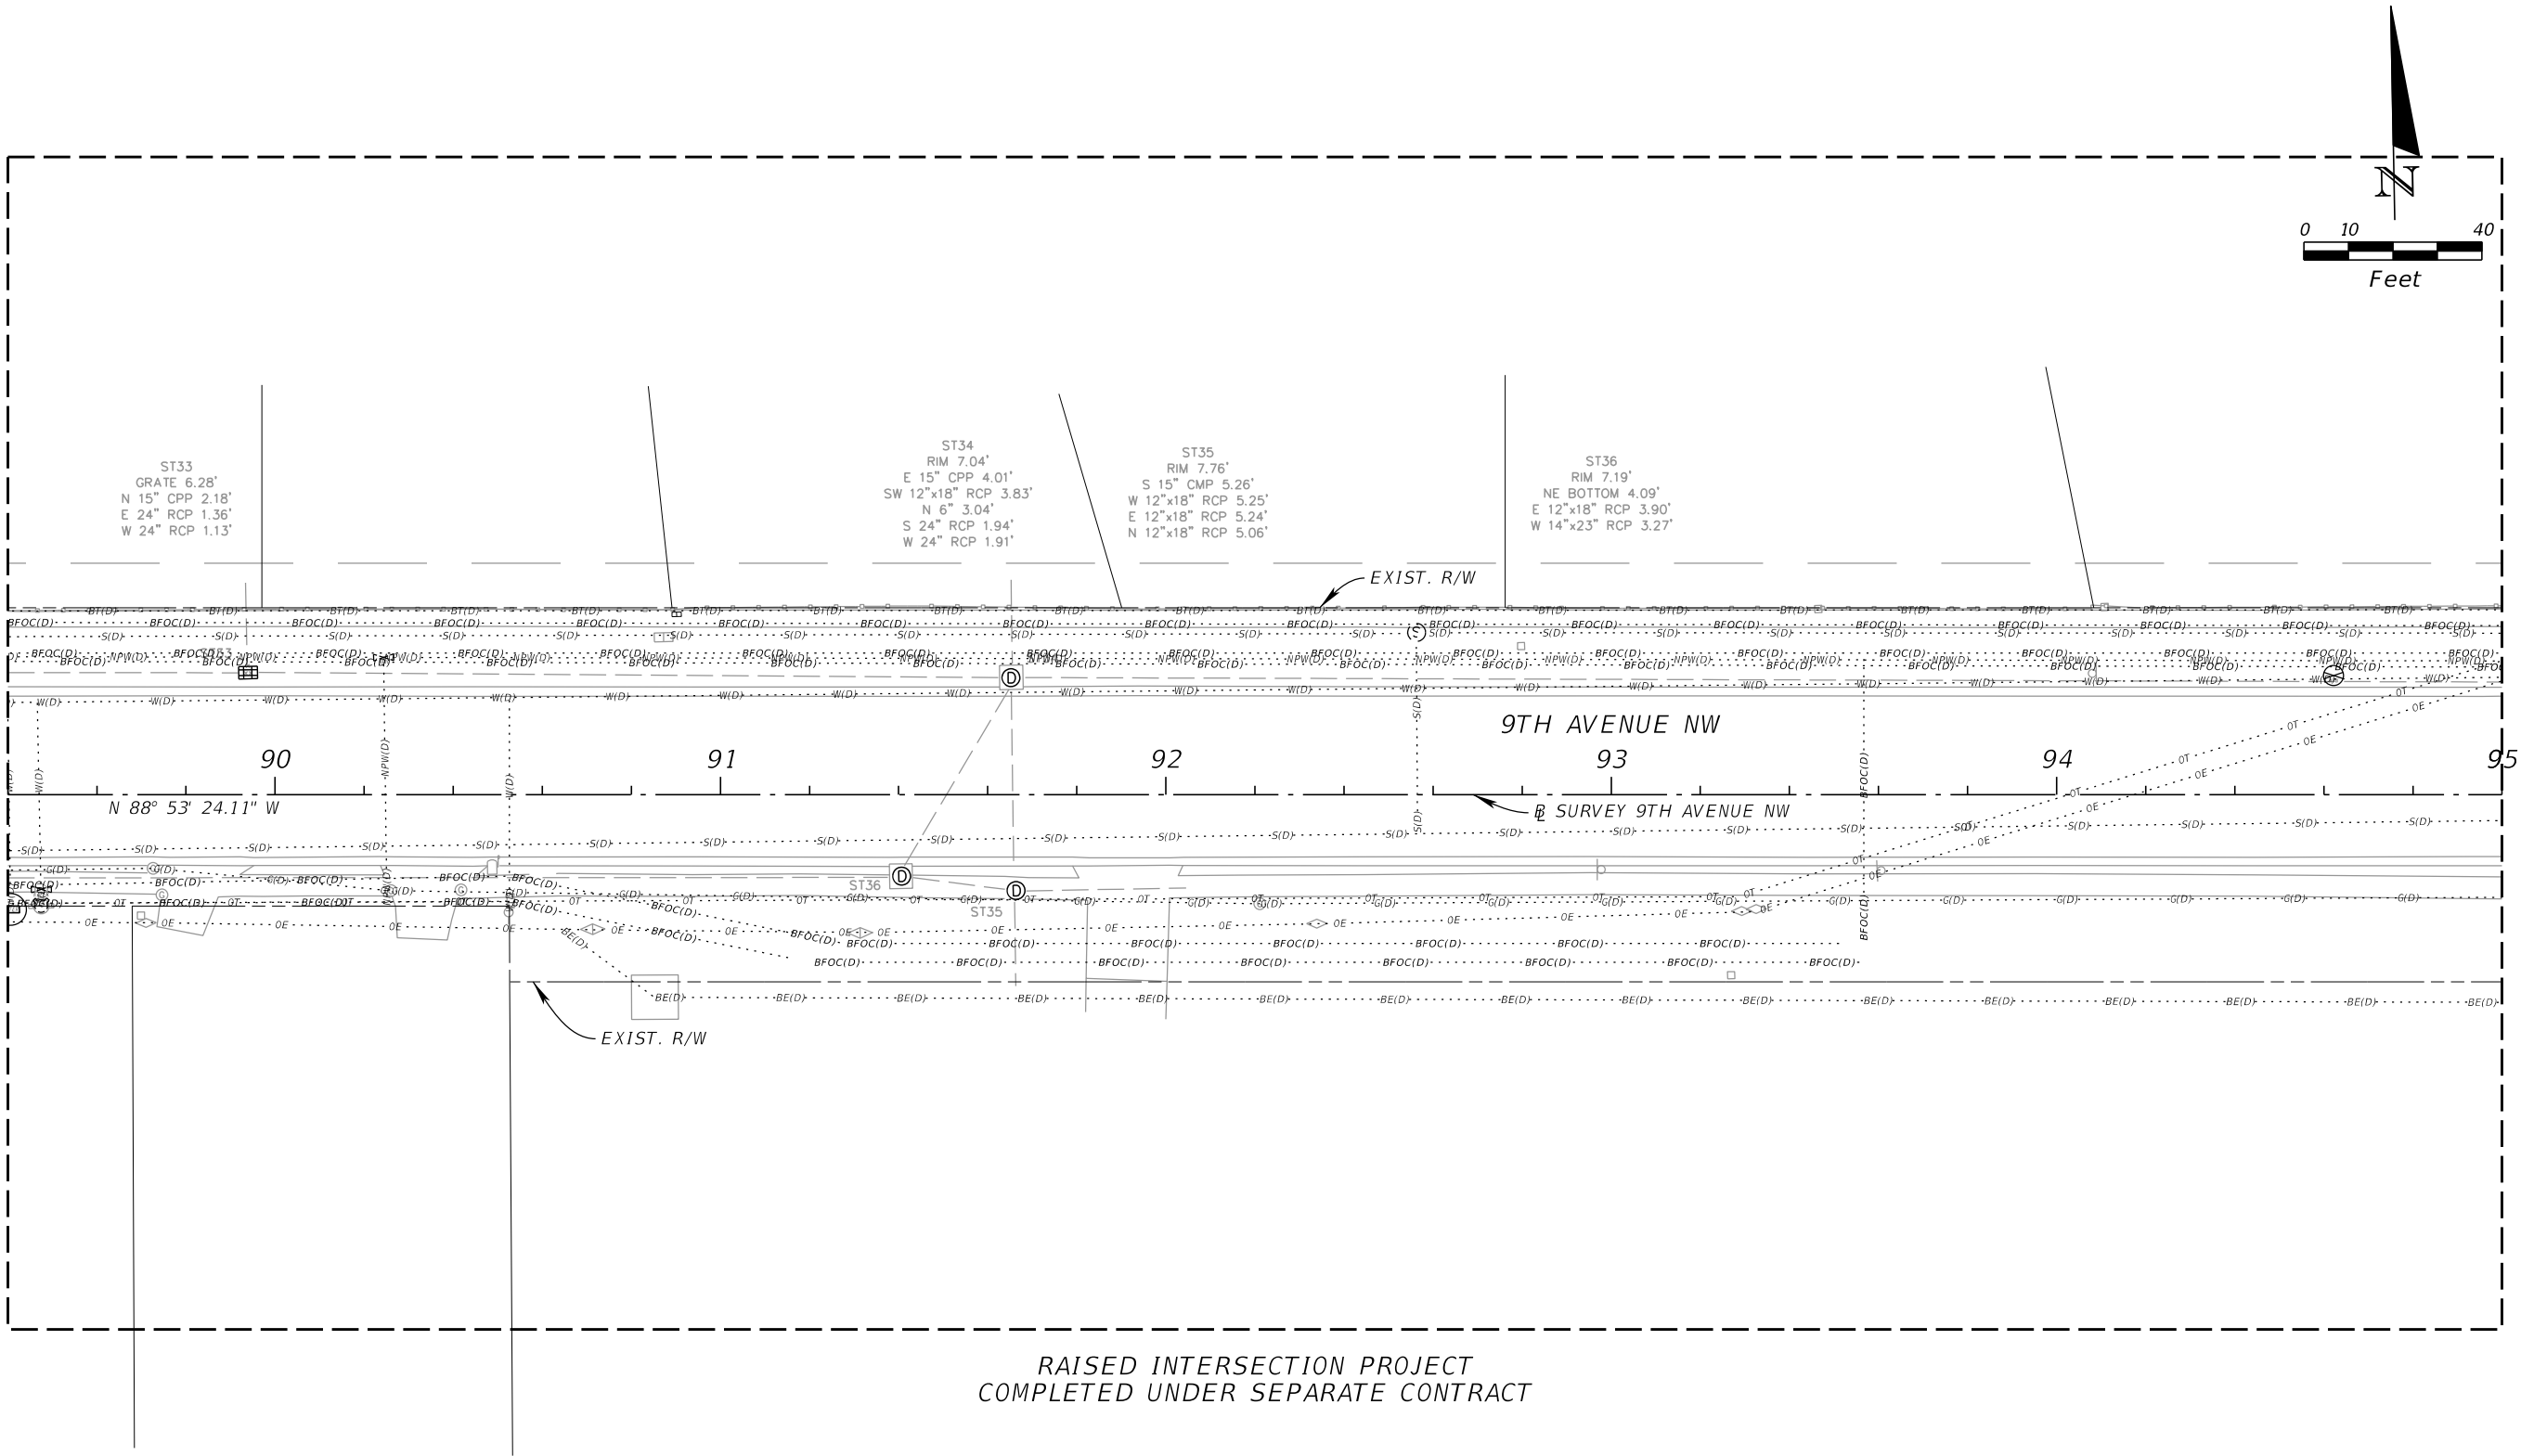SHEET NUMBER  
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
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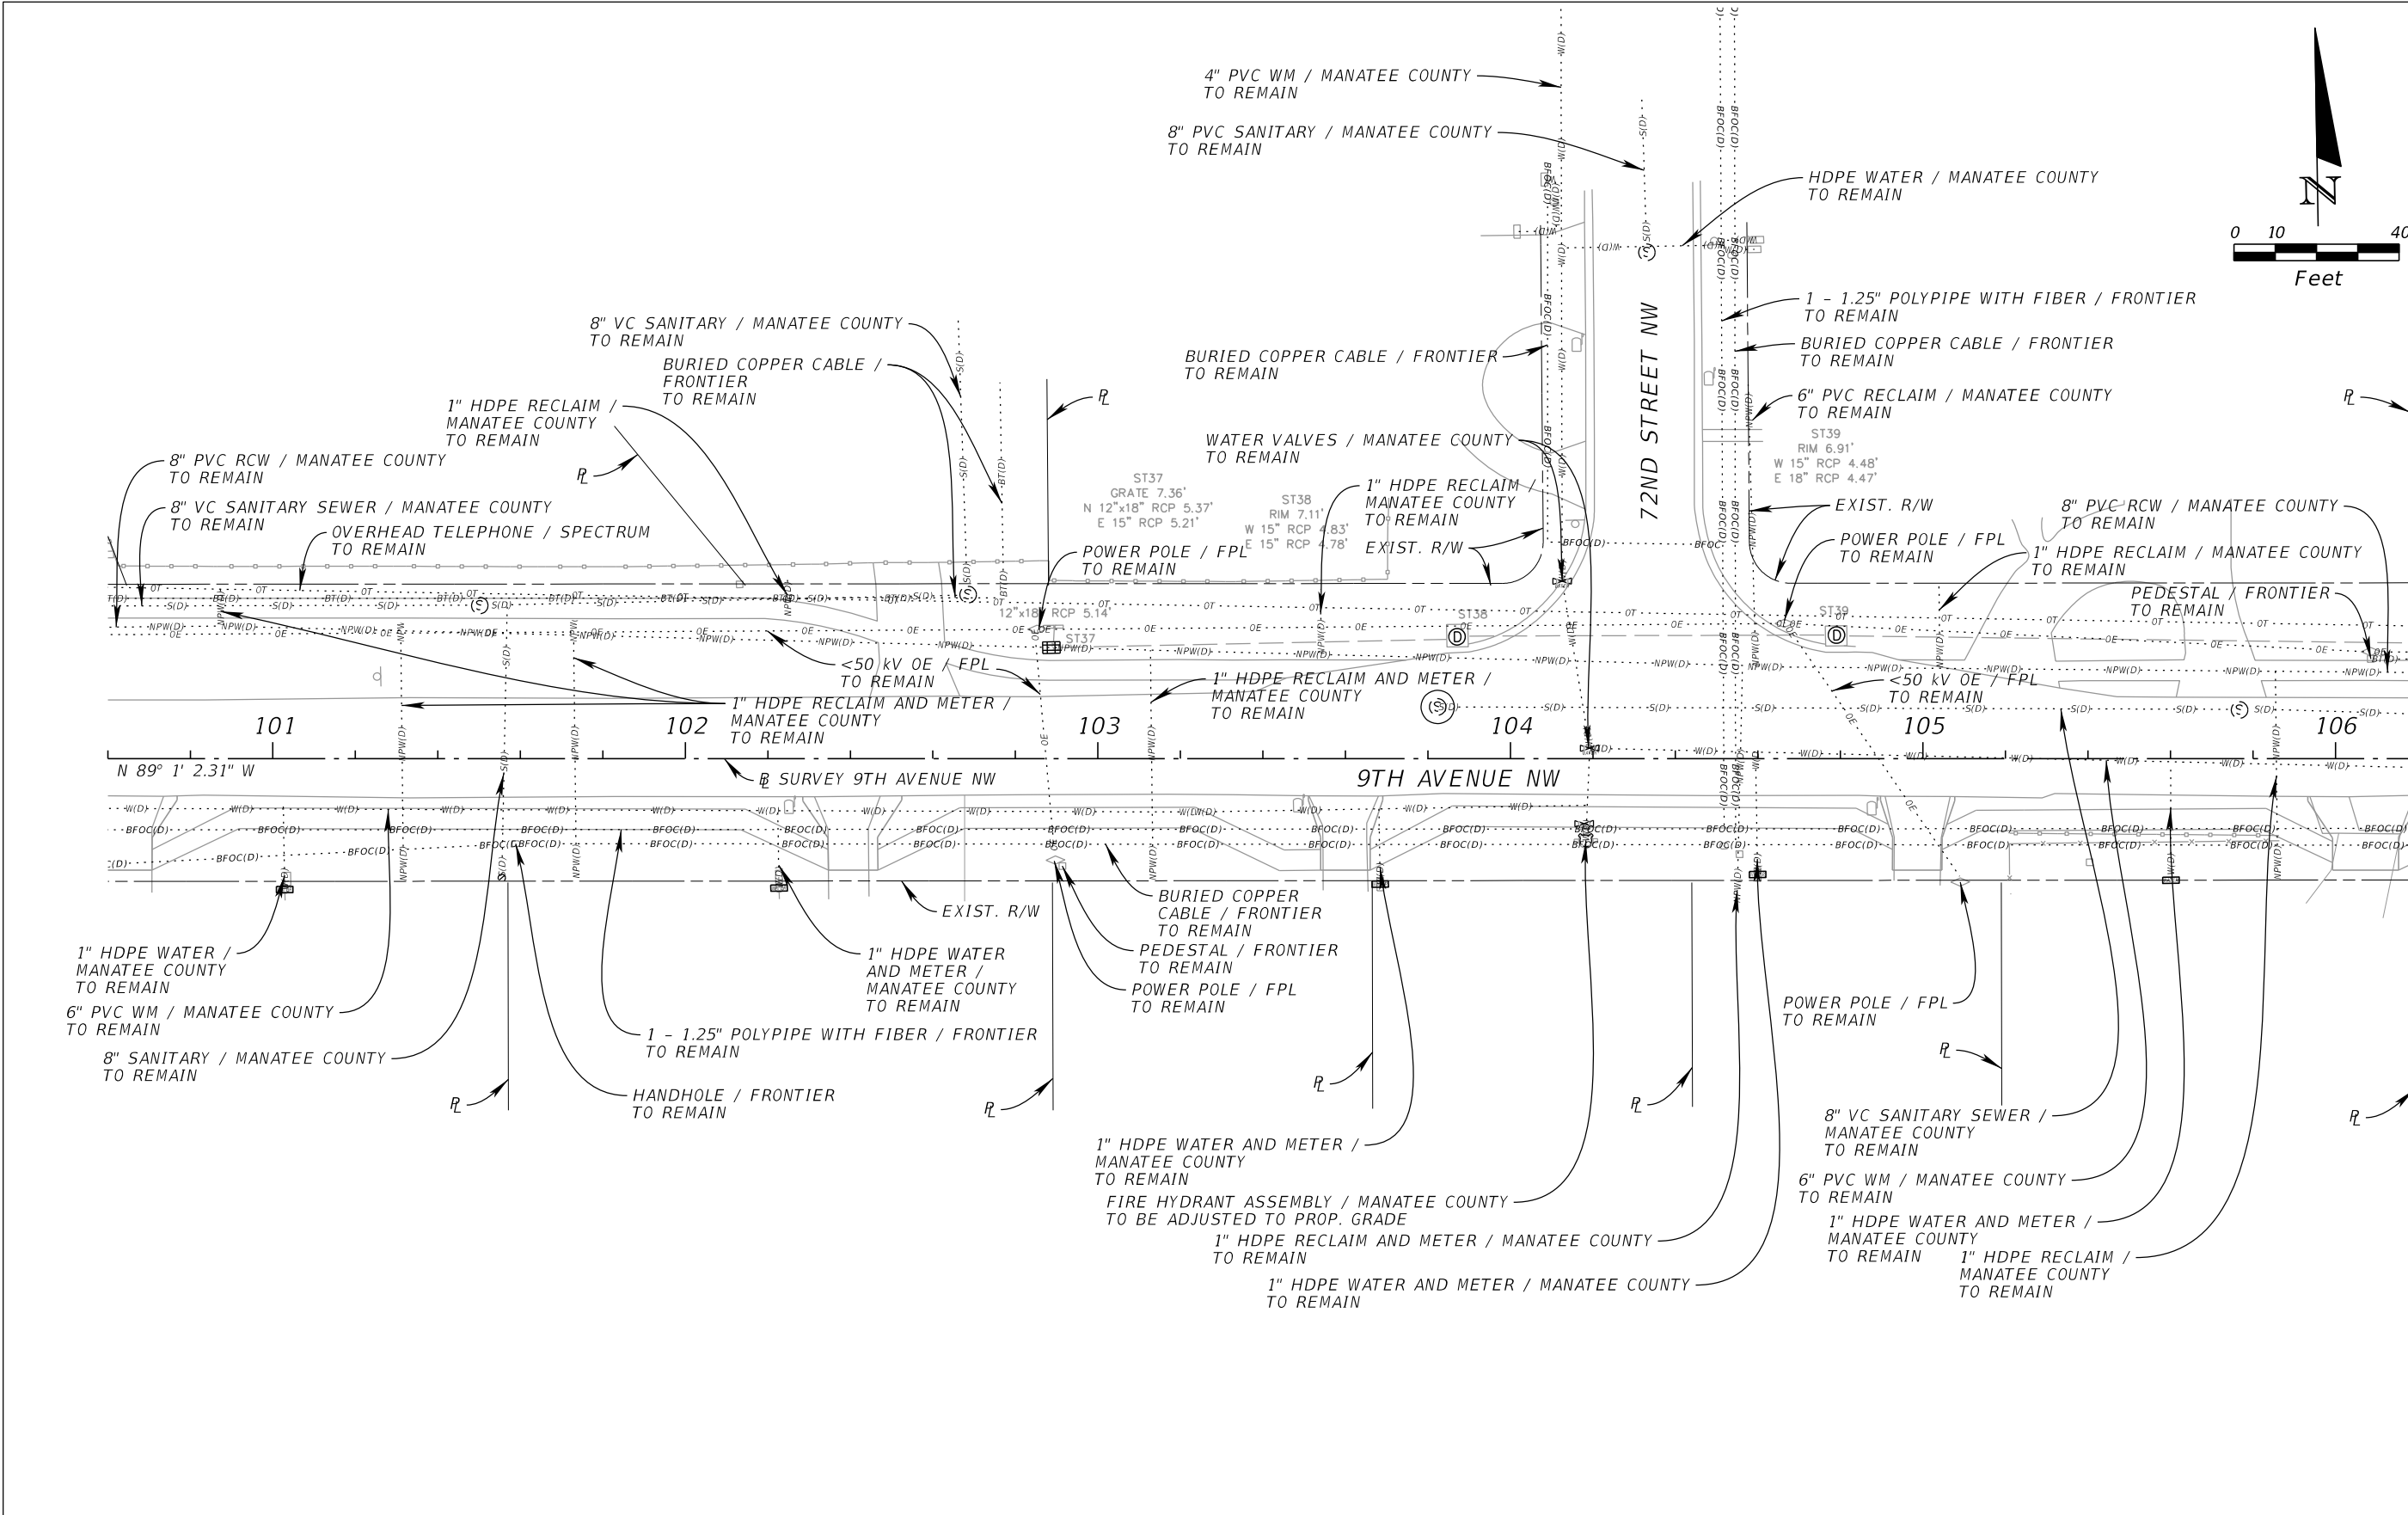
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FL LICENSE NUMBER 76102

FL DATE:

UTILITY ADJUSTMENT  
SHEET (14)


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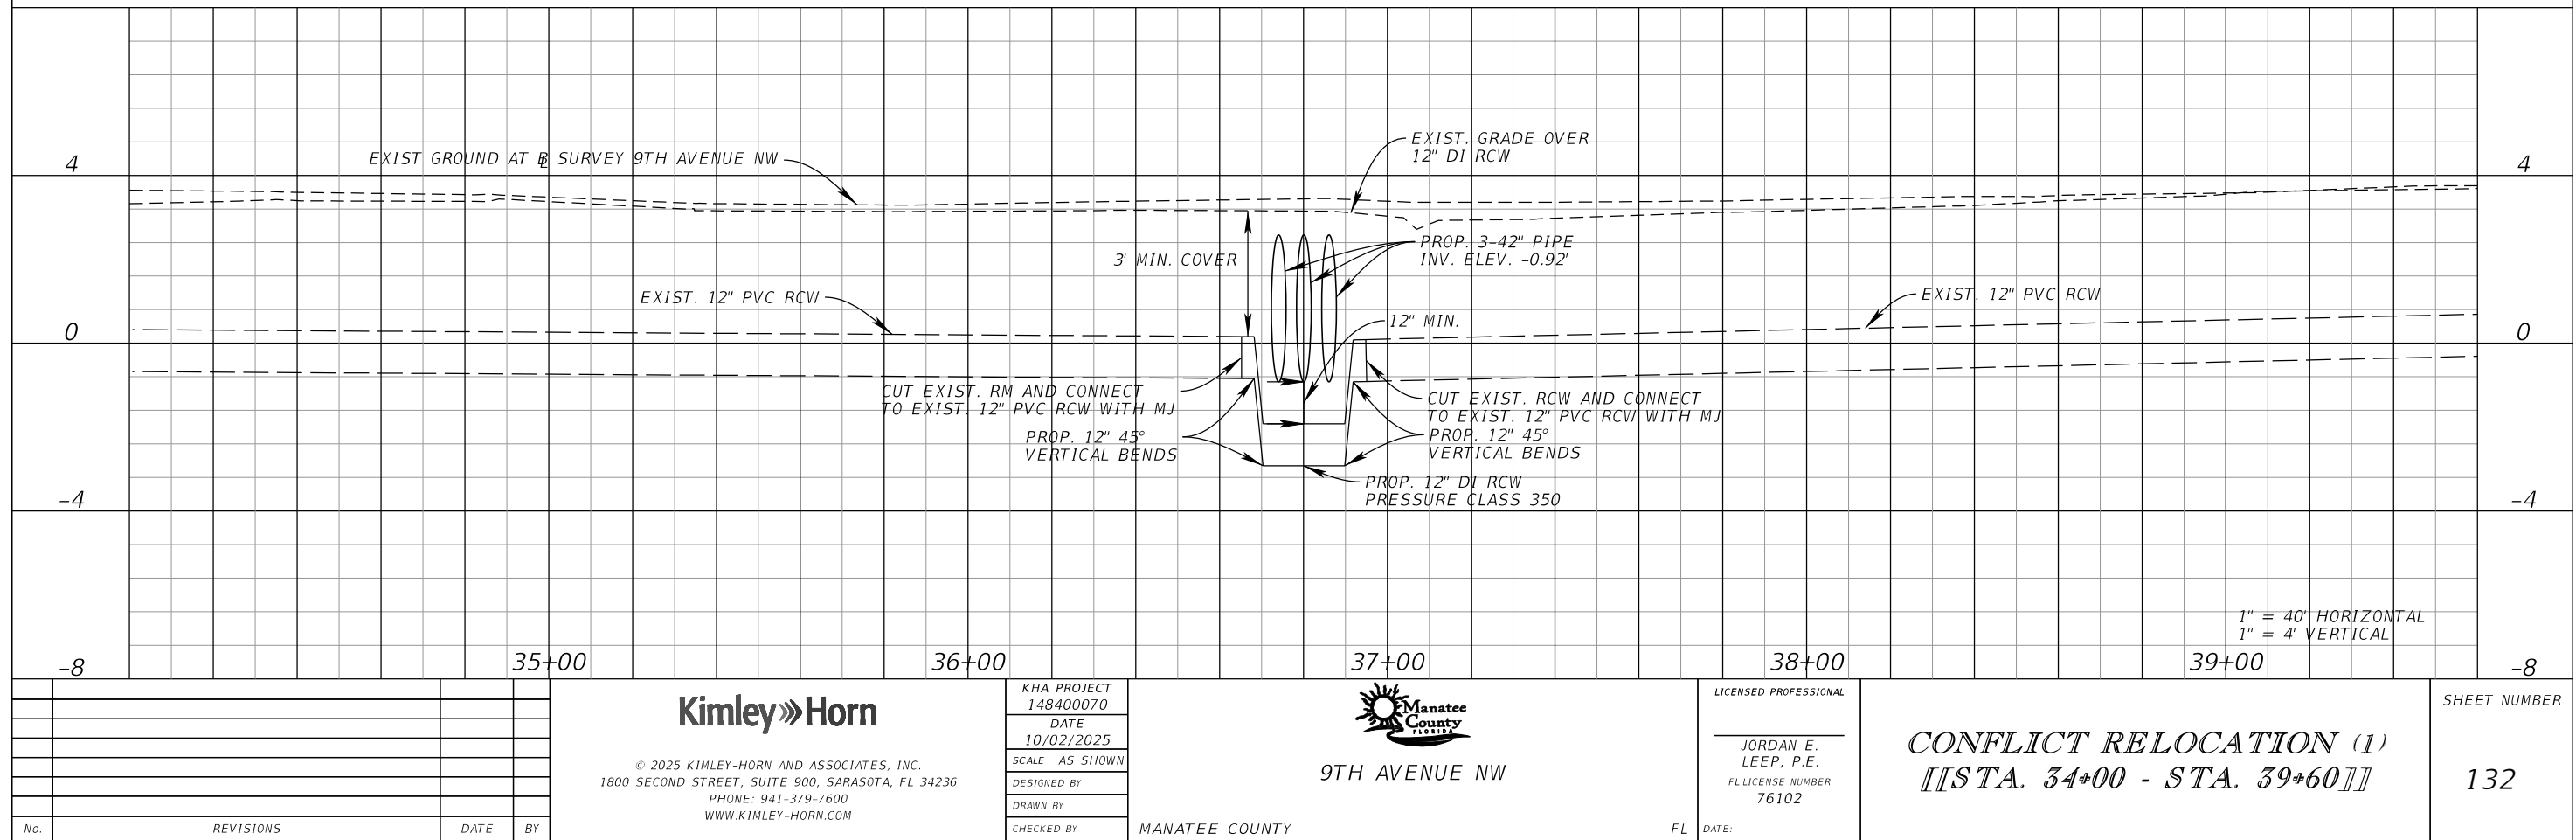
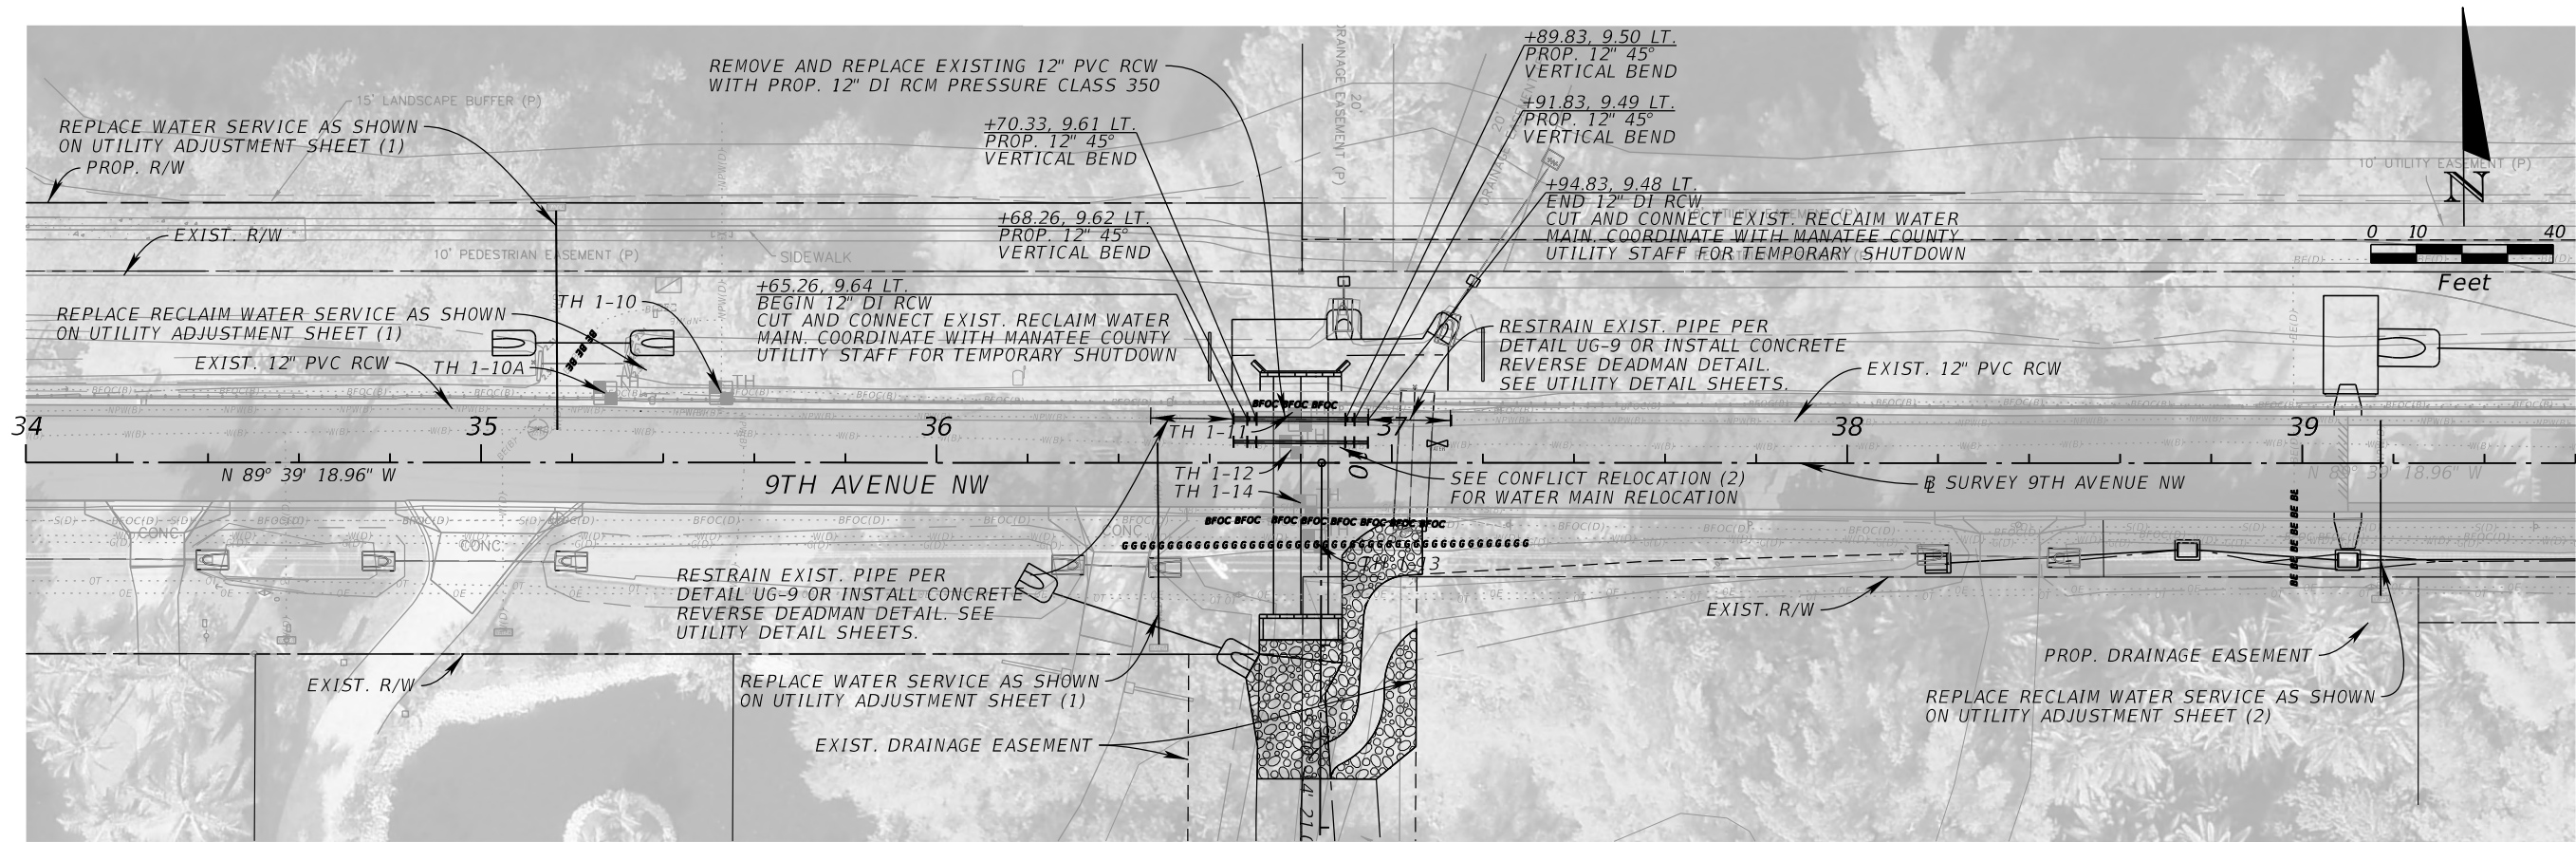

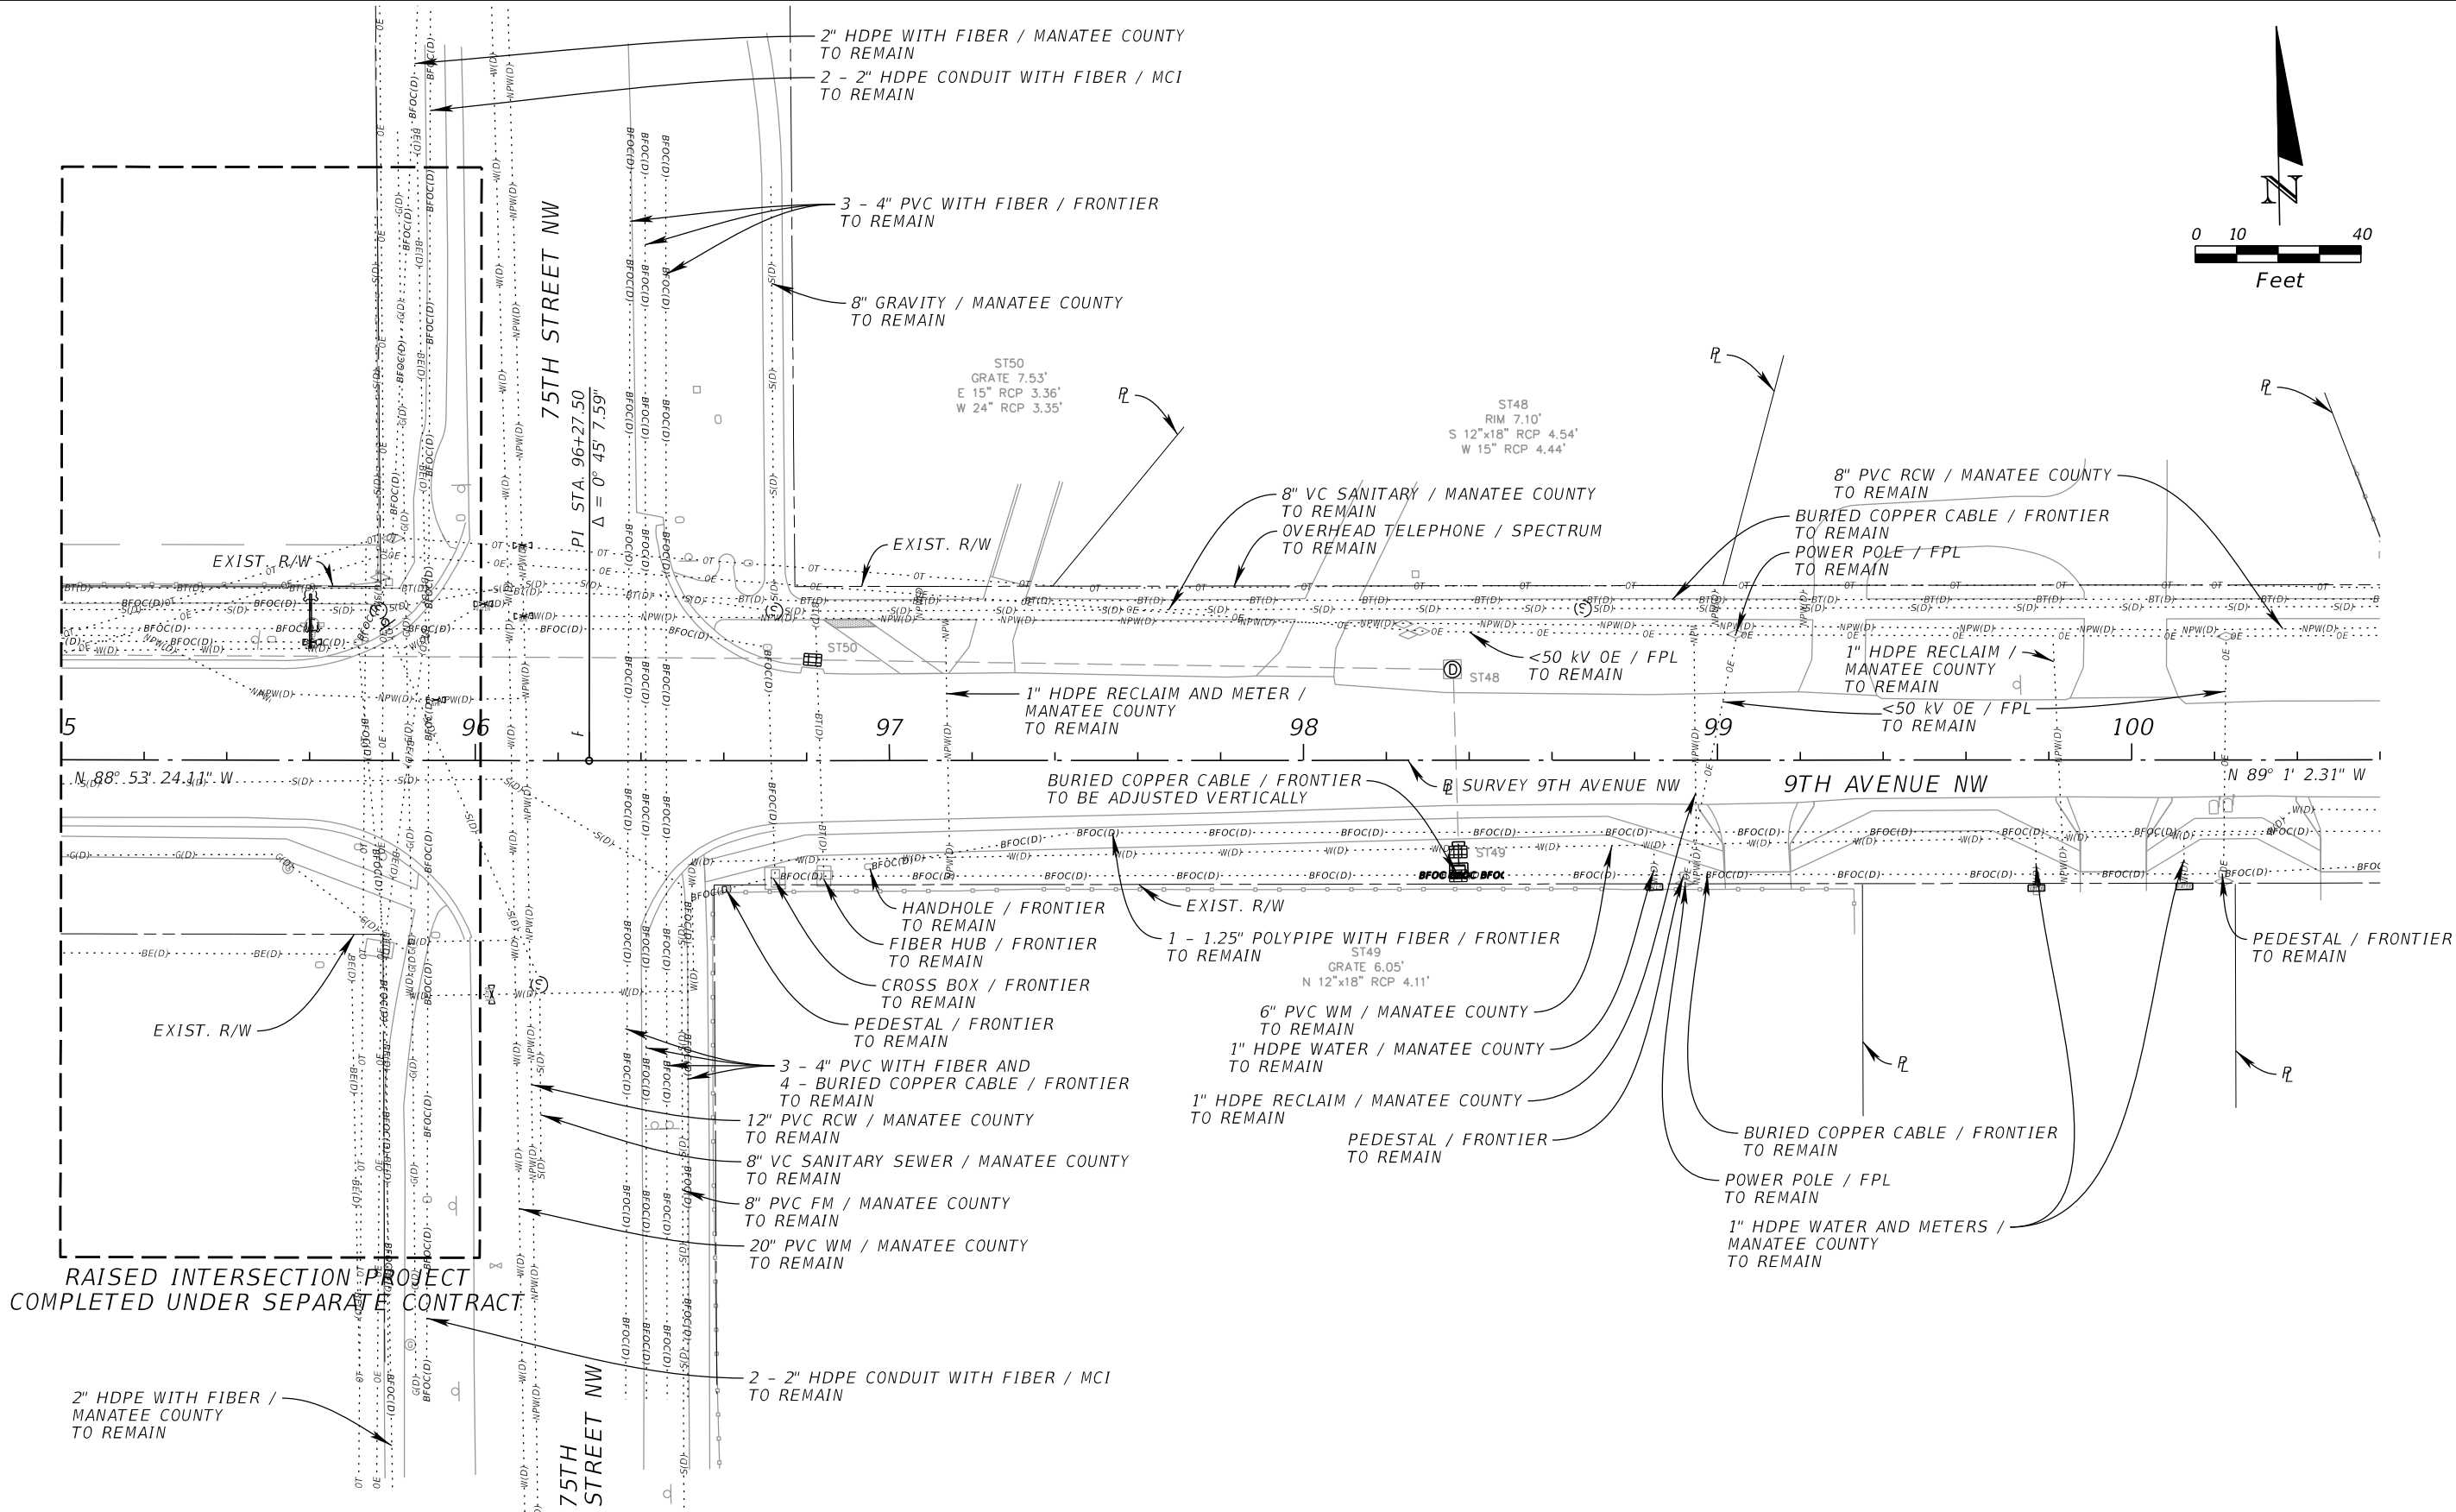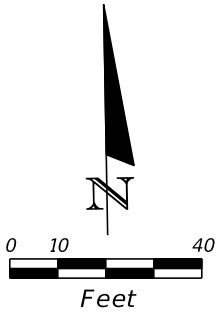
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No.	REVISIONS	DATE	BY	



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No.	REVISIONS	DATE	BY								





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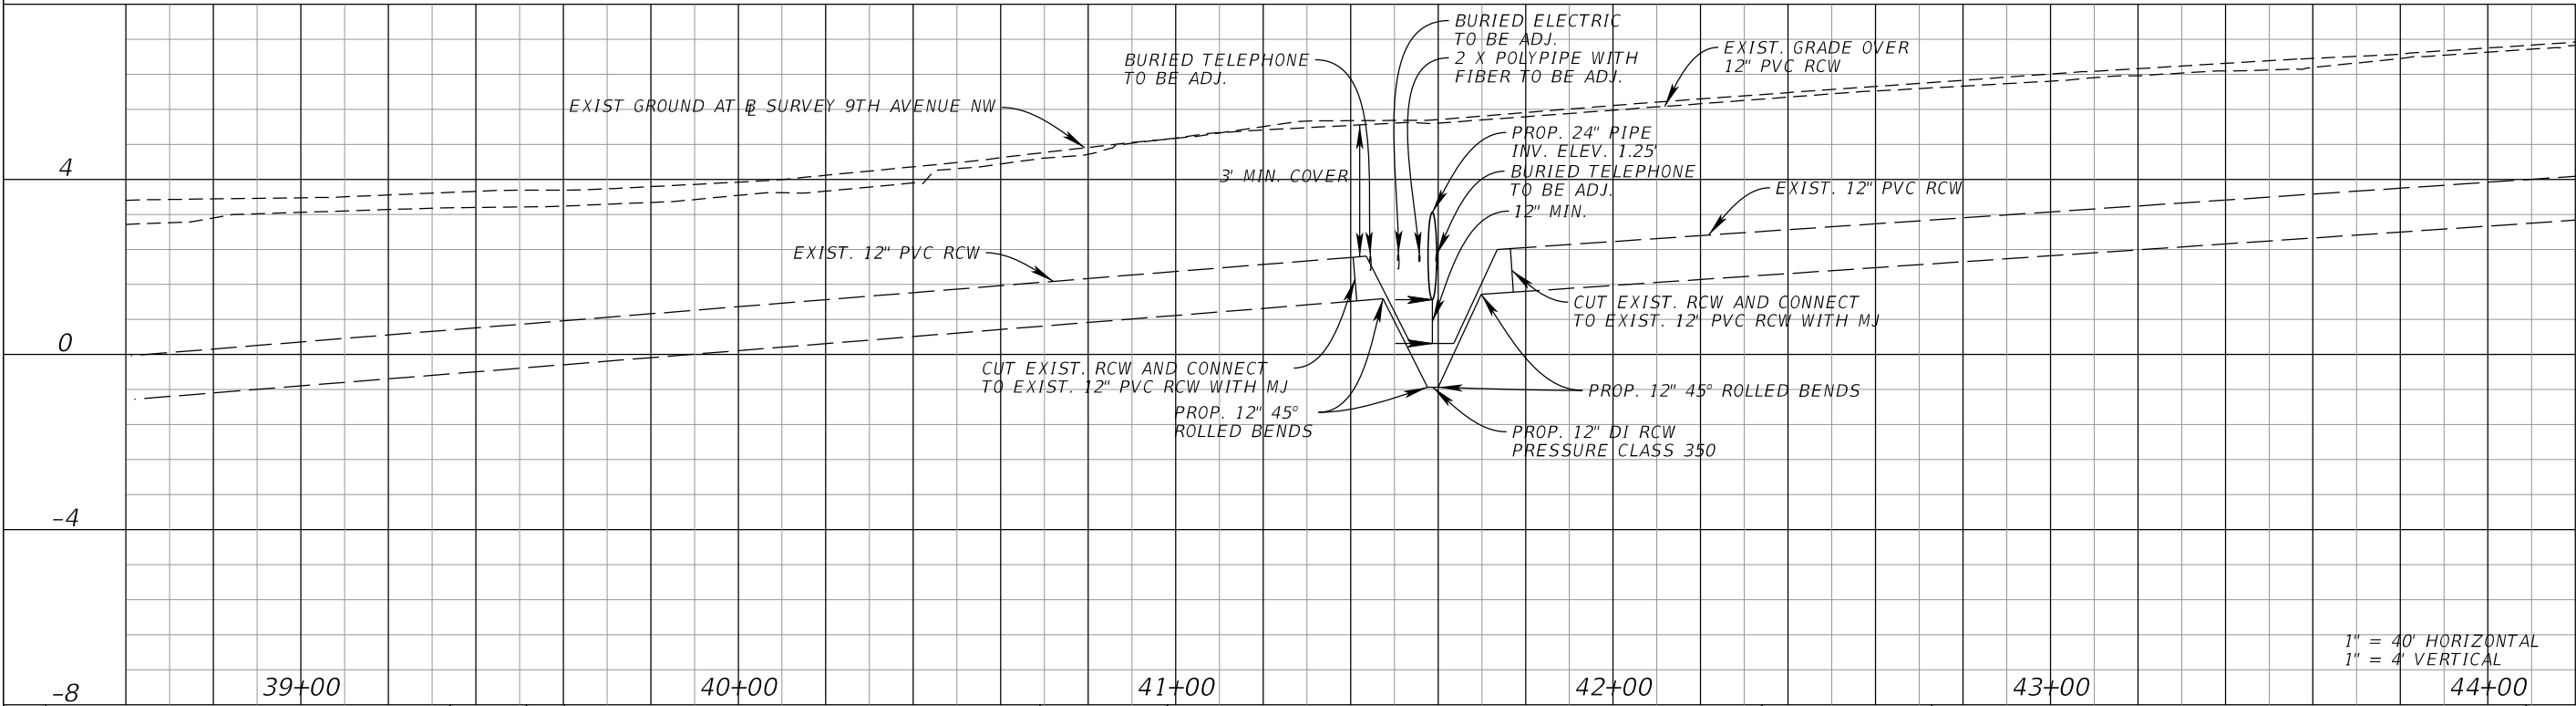
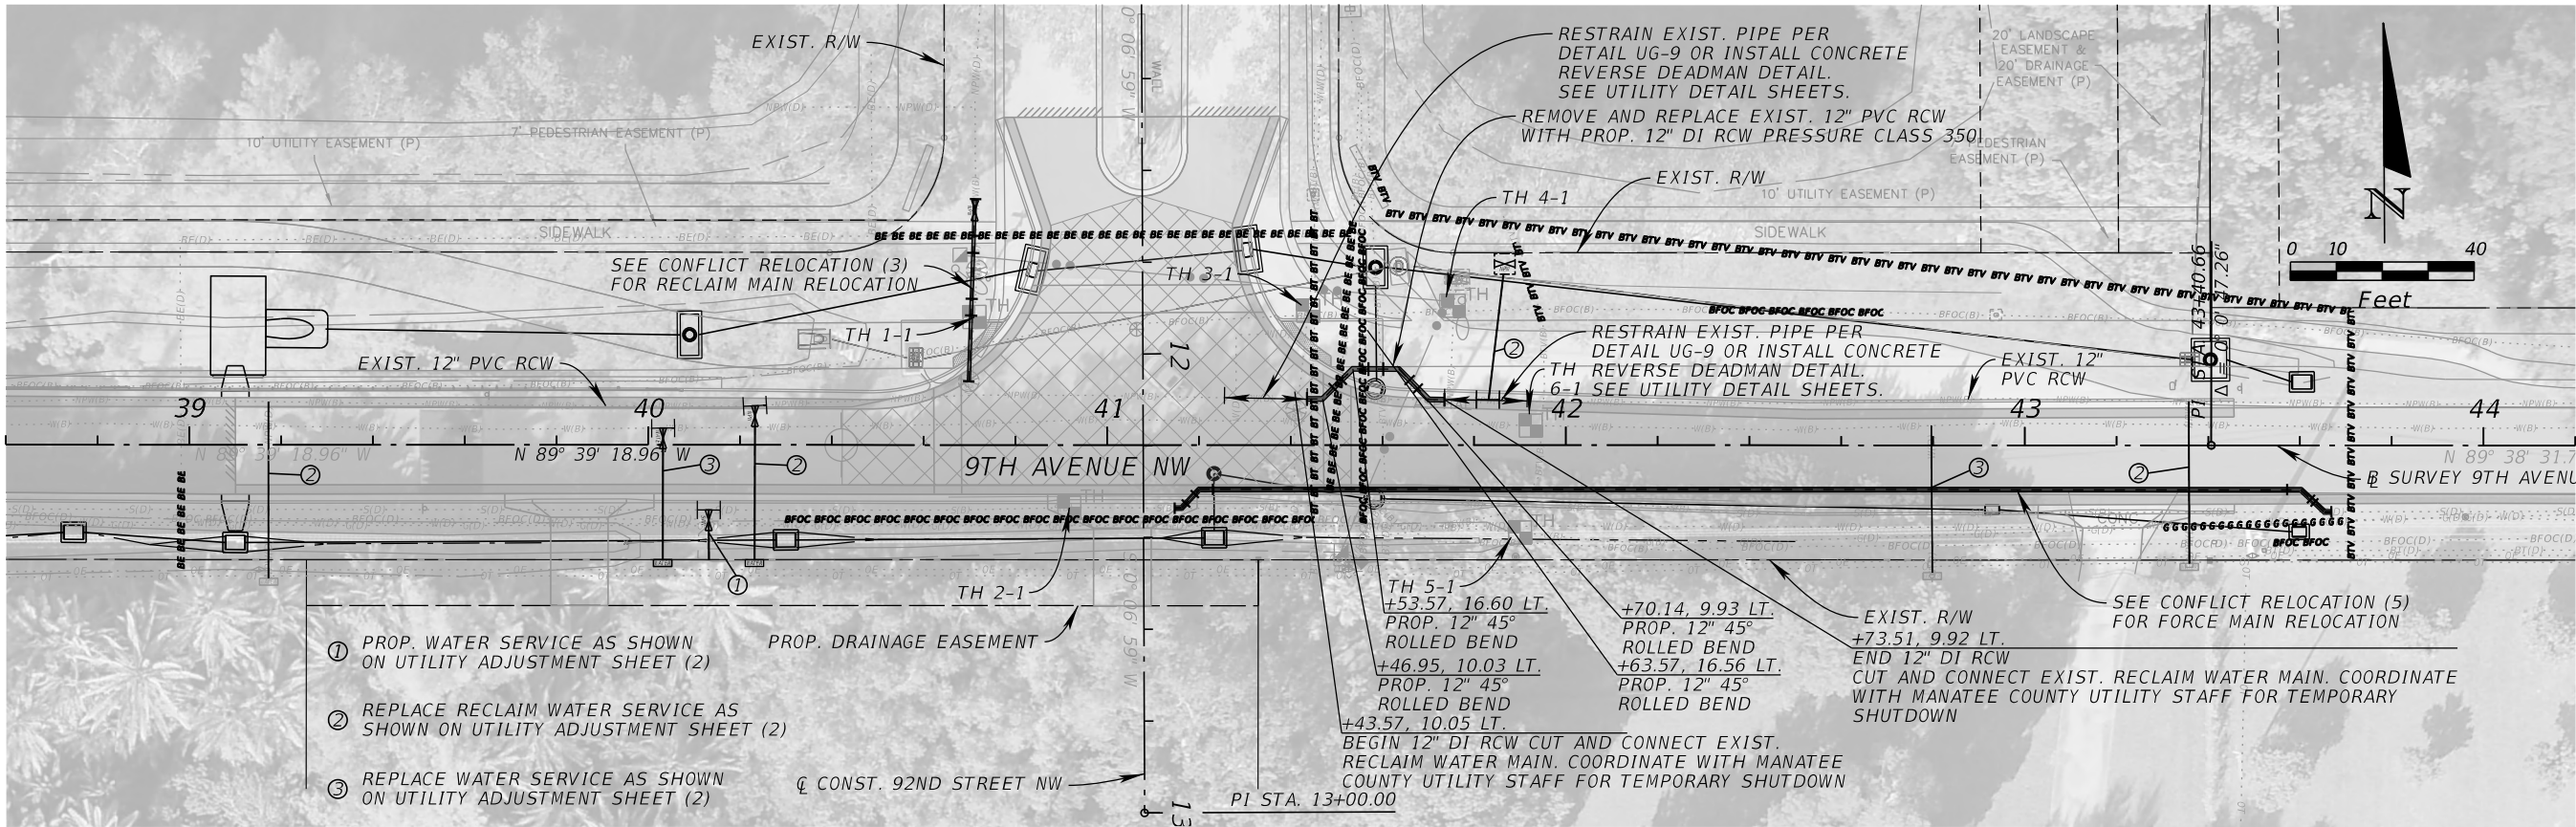
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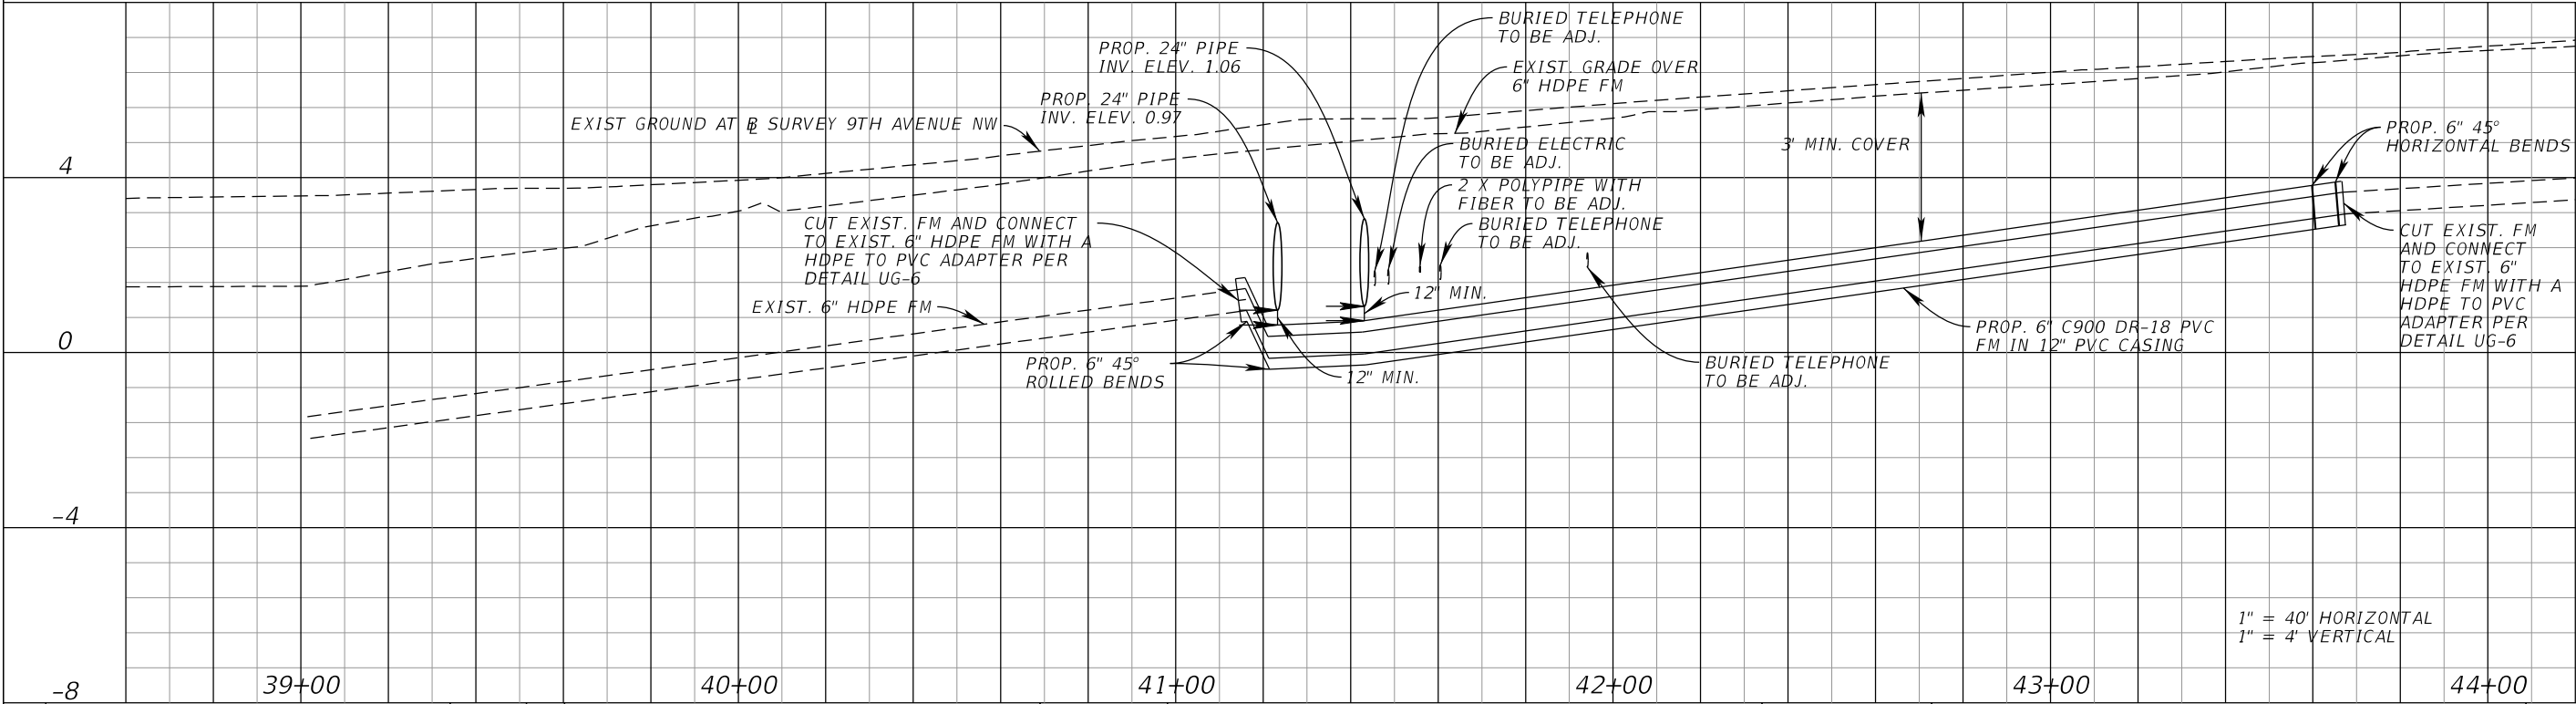
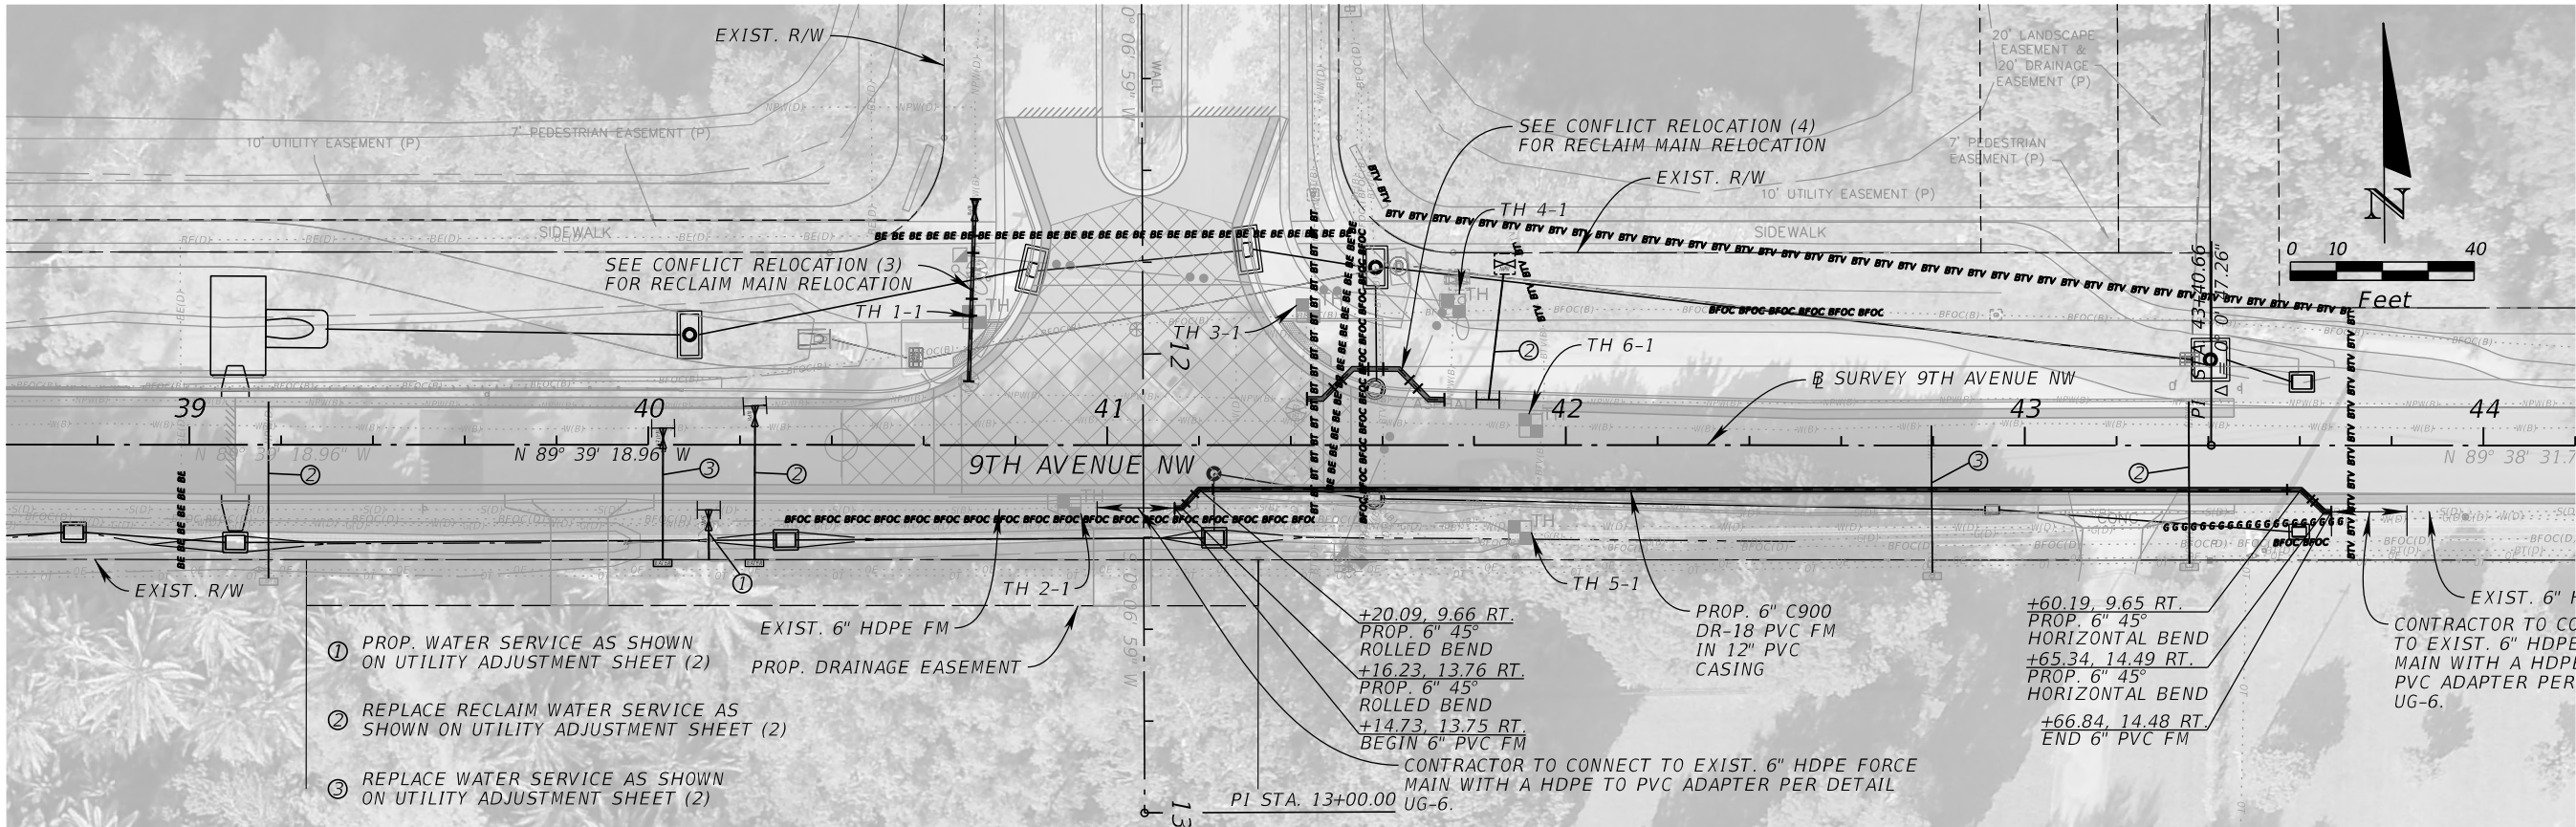
<div>Kimley»Horn</div> <div>© 2025 KIMLEY-HORN AND ASSOCIATES, INC. 1800 SECOND STREET, SUITE 900, SARASOTA, FL 34236 PHONE: 941-379-7600 WWW.KIMLEY-HORN.COM</div>		<div>KHA PROJECT 148400070 DATE 10/02/2025 SCALE AS SHOWN DESIGNED BY DRAWN BY CHECKED BY</div>	<div>Manatee County FLORIDA</div> <div>9TH AVENUE NW</div> <div>MANATEE COUNTY</div>	<div>LICENSED PROFESSIONAL</div> <div>JORDAN E. LEEP, P.E. FL LICENSE NUMBER 76102</div>	<div>CONFLICT RELOCATION (3) [[92ND STREET NW]]</div>	<div>SHEET NUMBER</div> <div>134</div>
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No.		REVISIONS		DATE		BY					


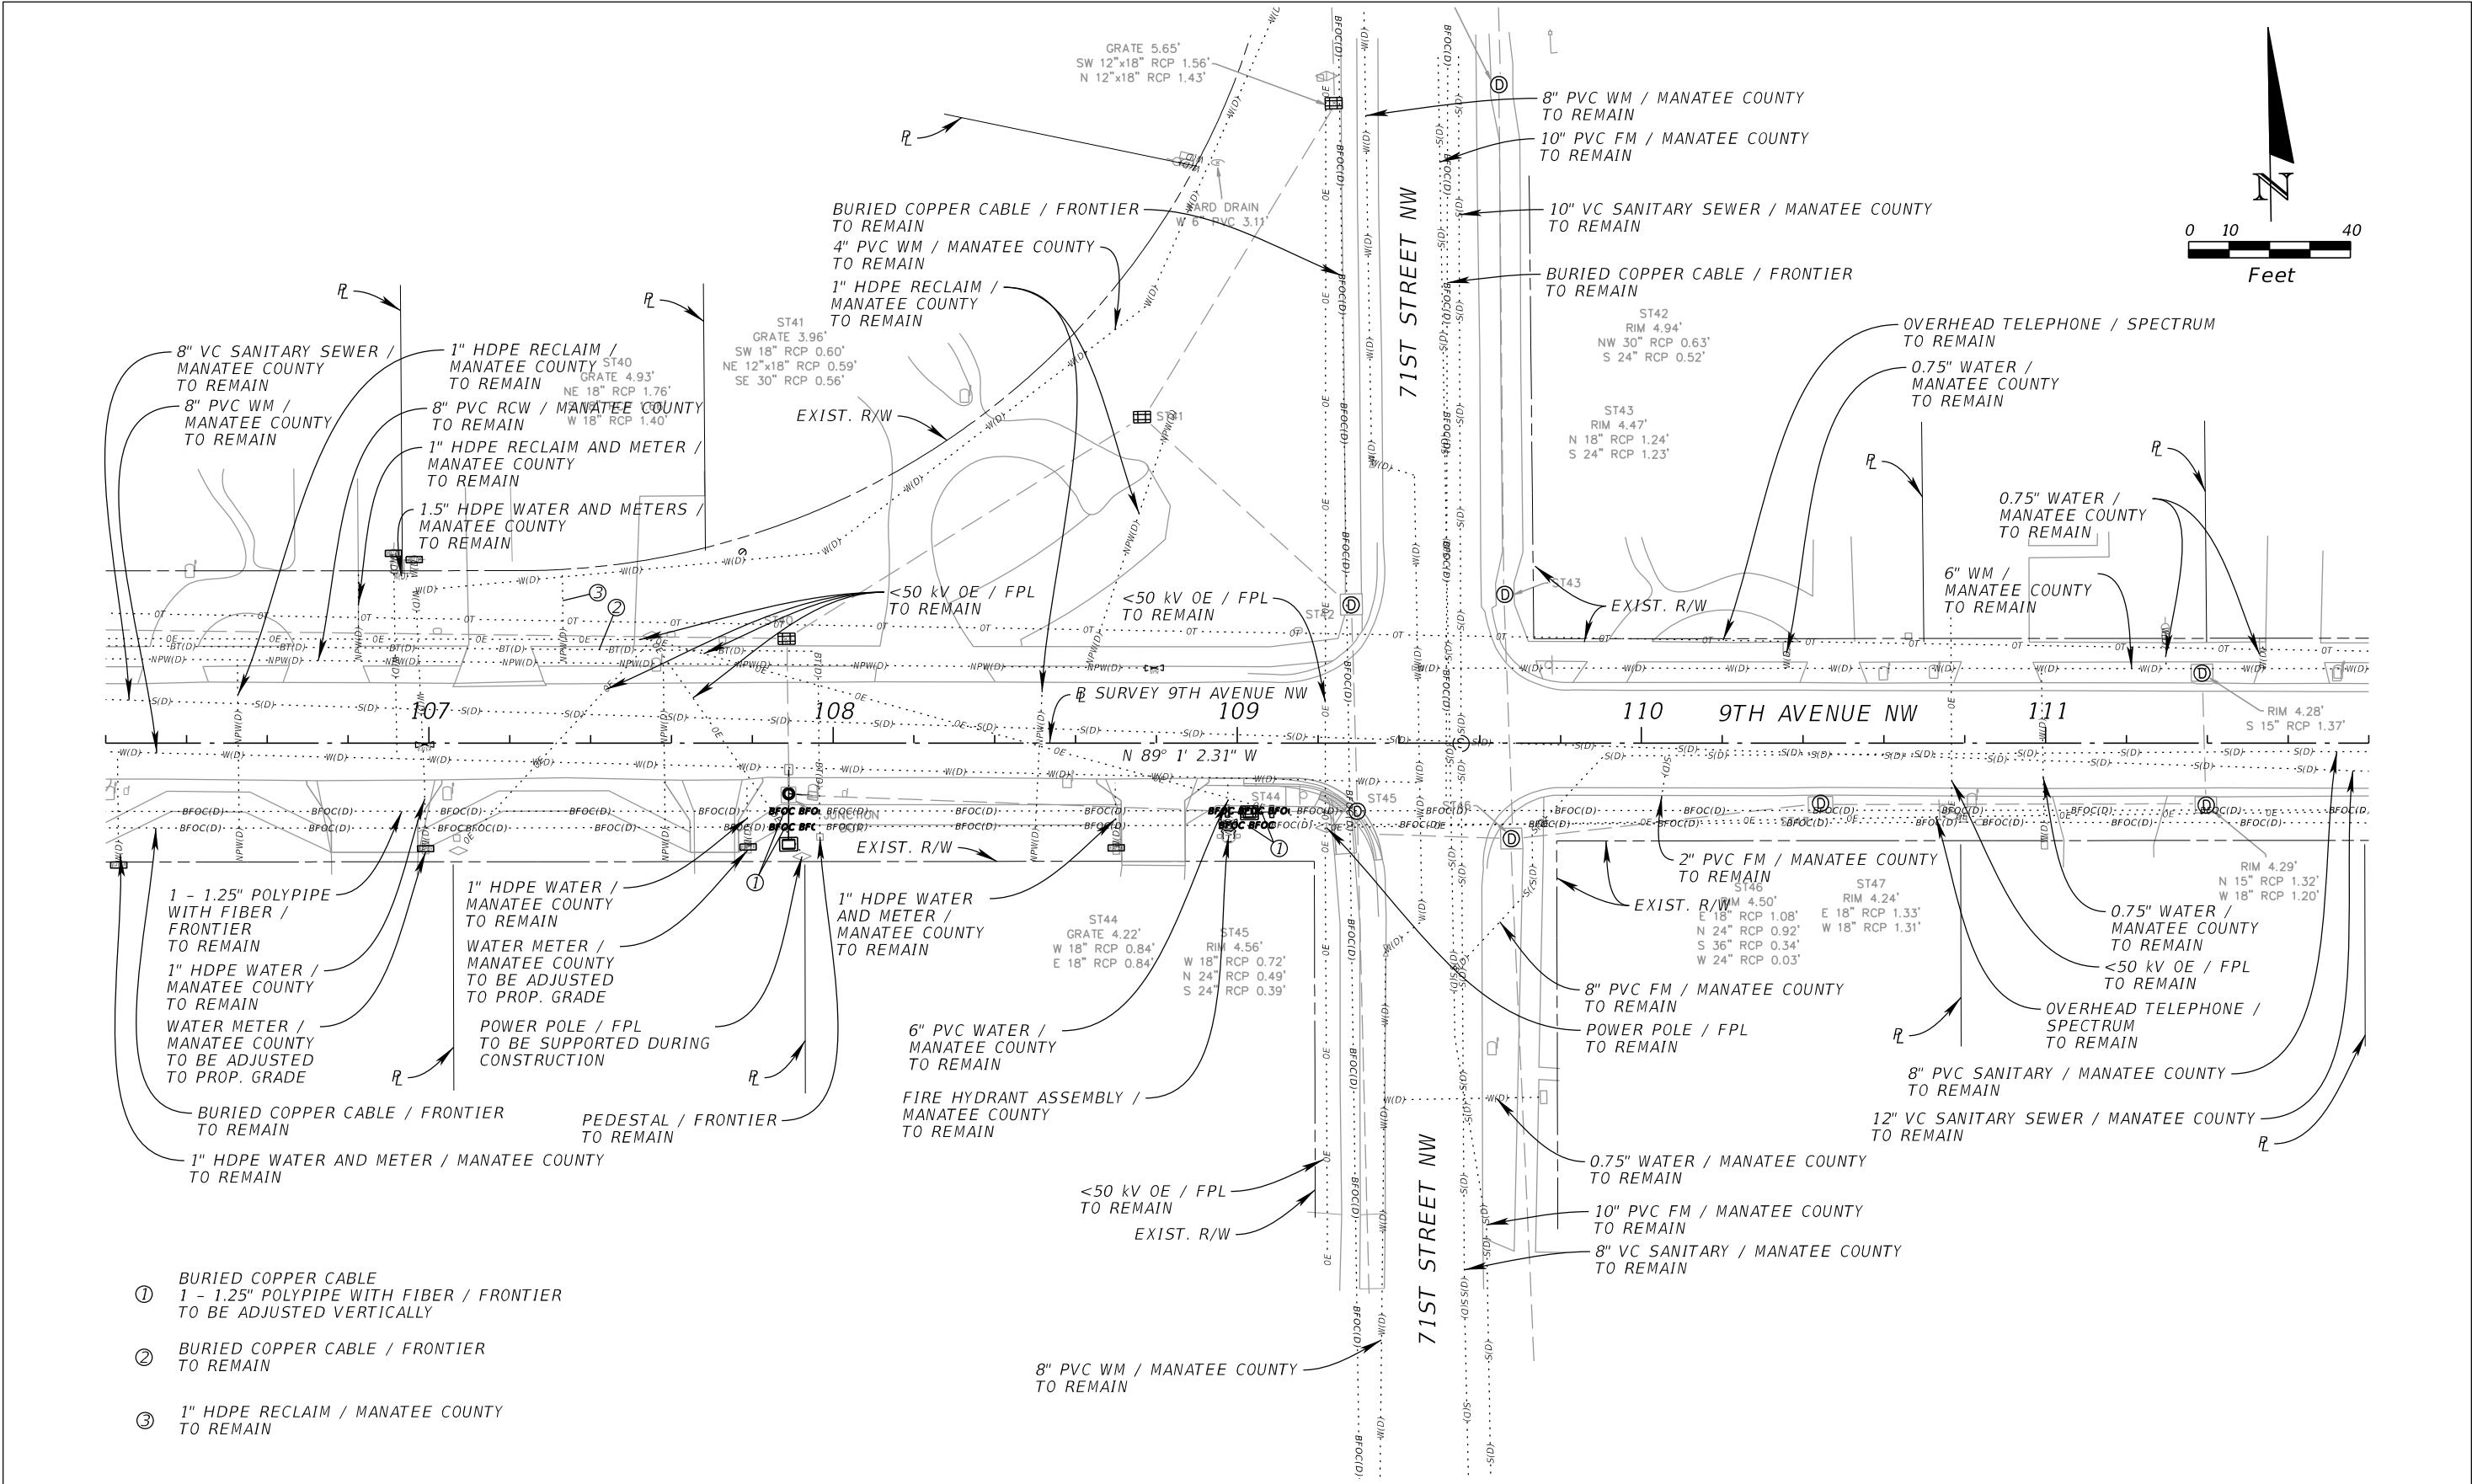
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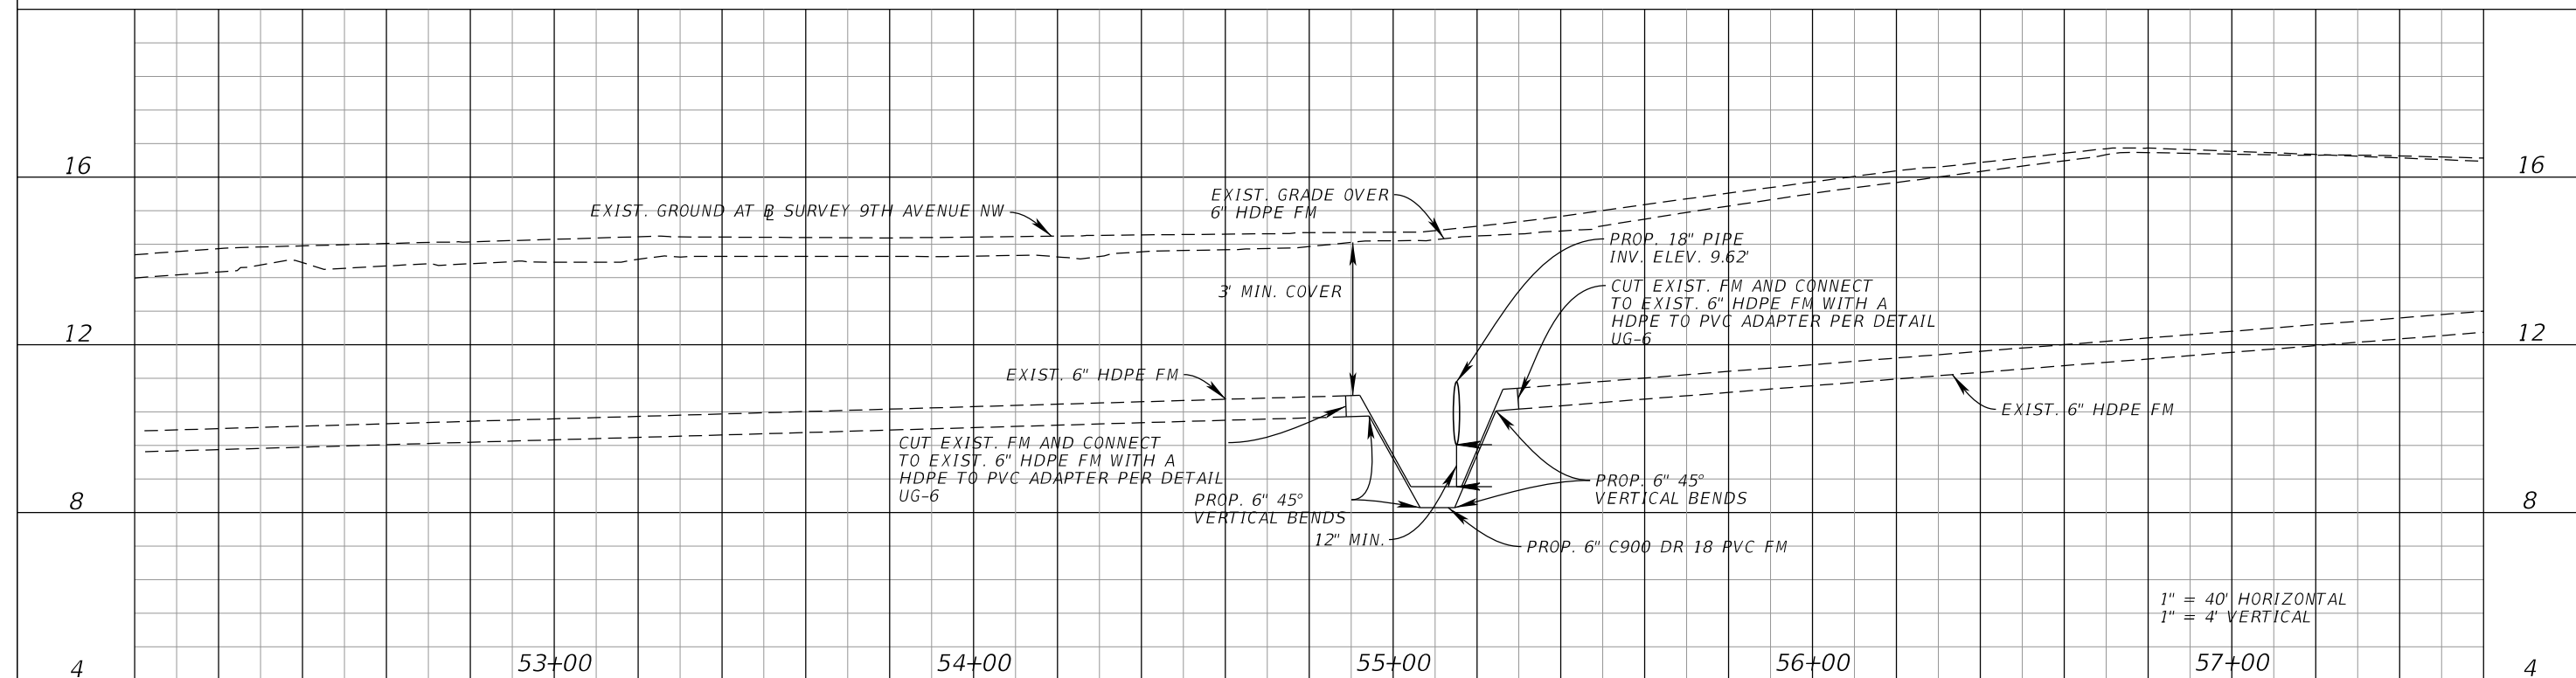
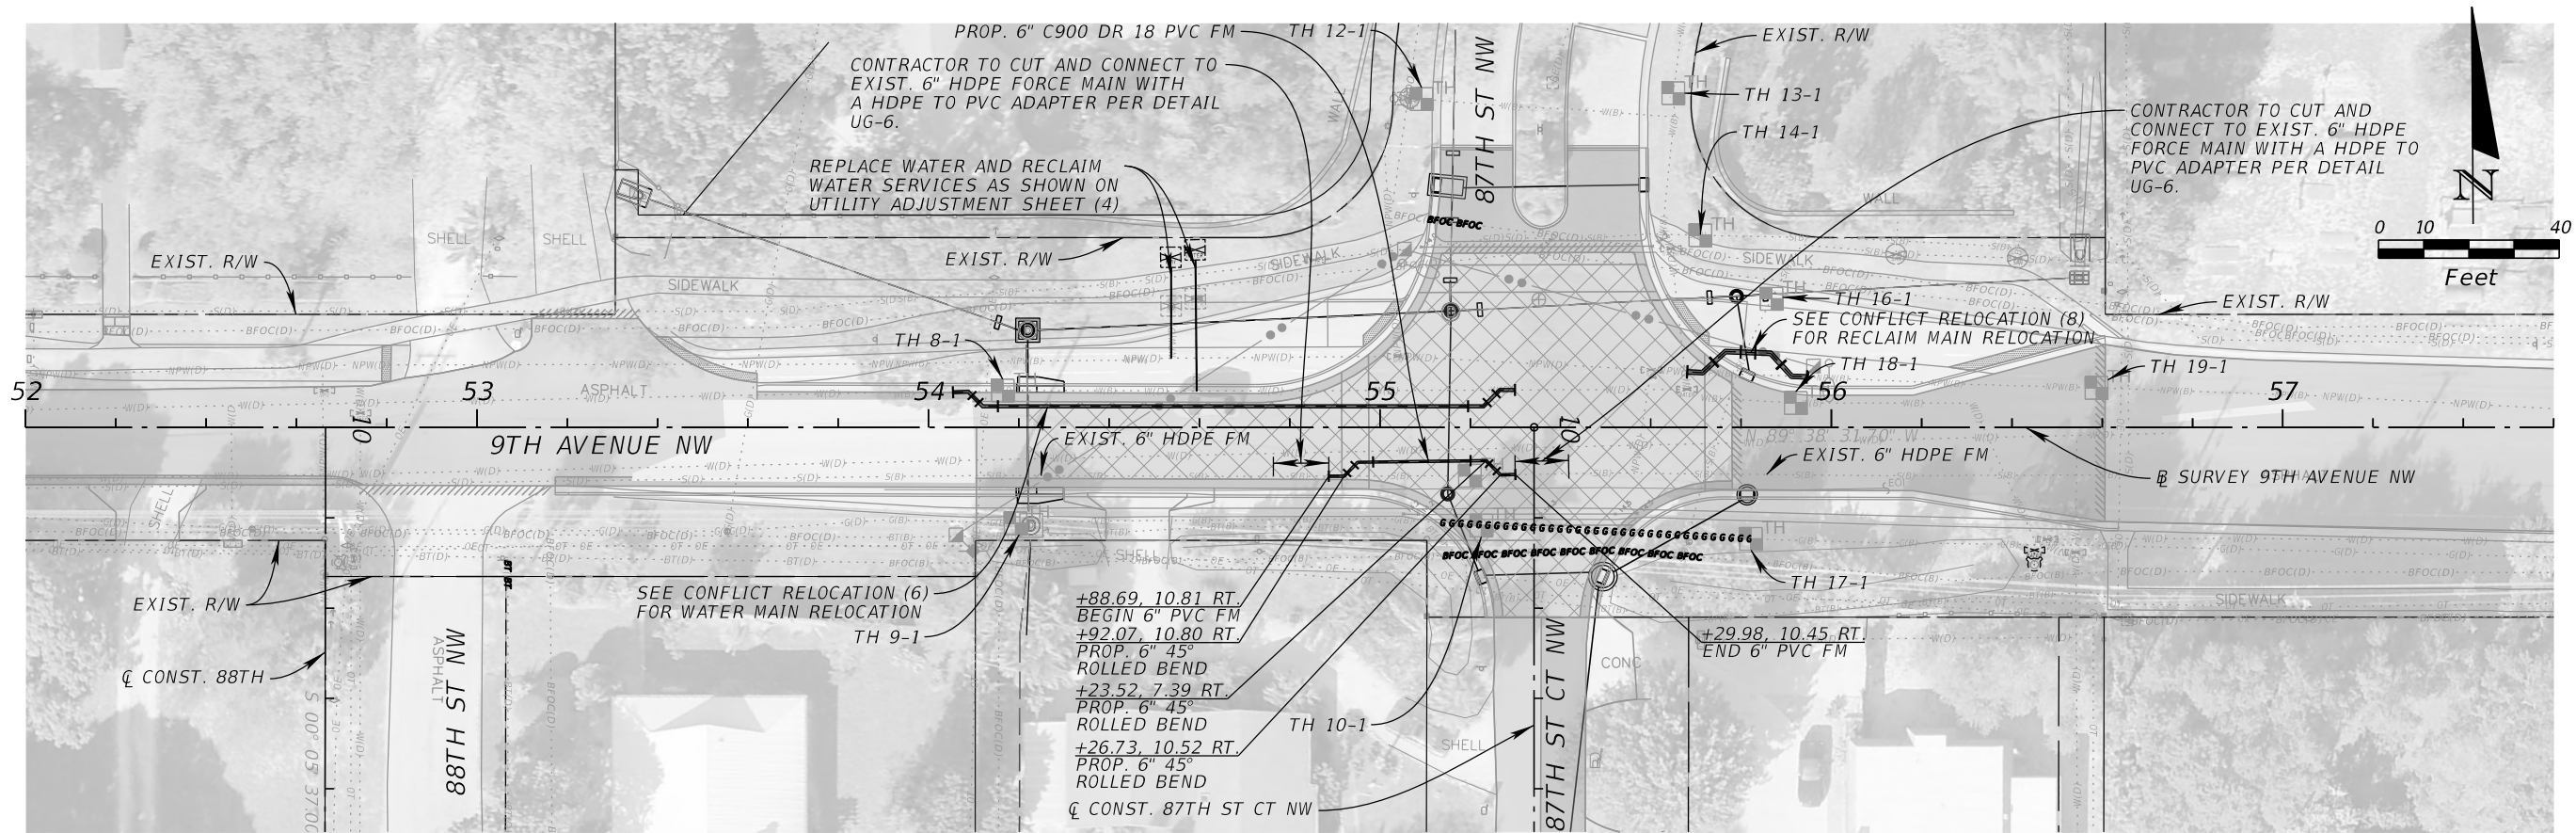


<b>Kimley»Horn</b>		<b>KHA PROJECT</b> 148400070		<b>Manatee County</b> FLORIDA		<b>LICENSED PROFESSIONAL</b>  JORDAN E. LEEP, P.E. FL LICENSE NUMBER 76102		<b>CONFLICT RELOCATION (5)</b> <b>[[STA. 38+60 - STA. 44+20]]</b>		<b>SHEET NUMBER</b>  136	
© 2025 KIMLEY-HORN AND ASSOCIATES, INC. 1800 SECOND STREET, SUITE 900, SARASOTA, FL 34236 PHONE: 941-379-7600 WWW.KIMLEY-HORN.COM		DATE 10/02/2025 SCALE AS SHOWN DESIGNED BY DRAWN BY CHECKED BY		9TH AVENUE NW  MANATEE COUNTY		FL DATE:					
No.	REVISIONS	DATE	BY								
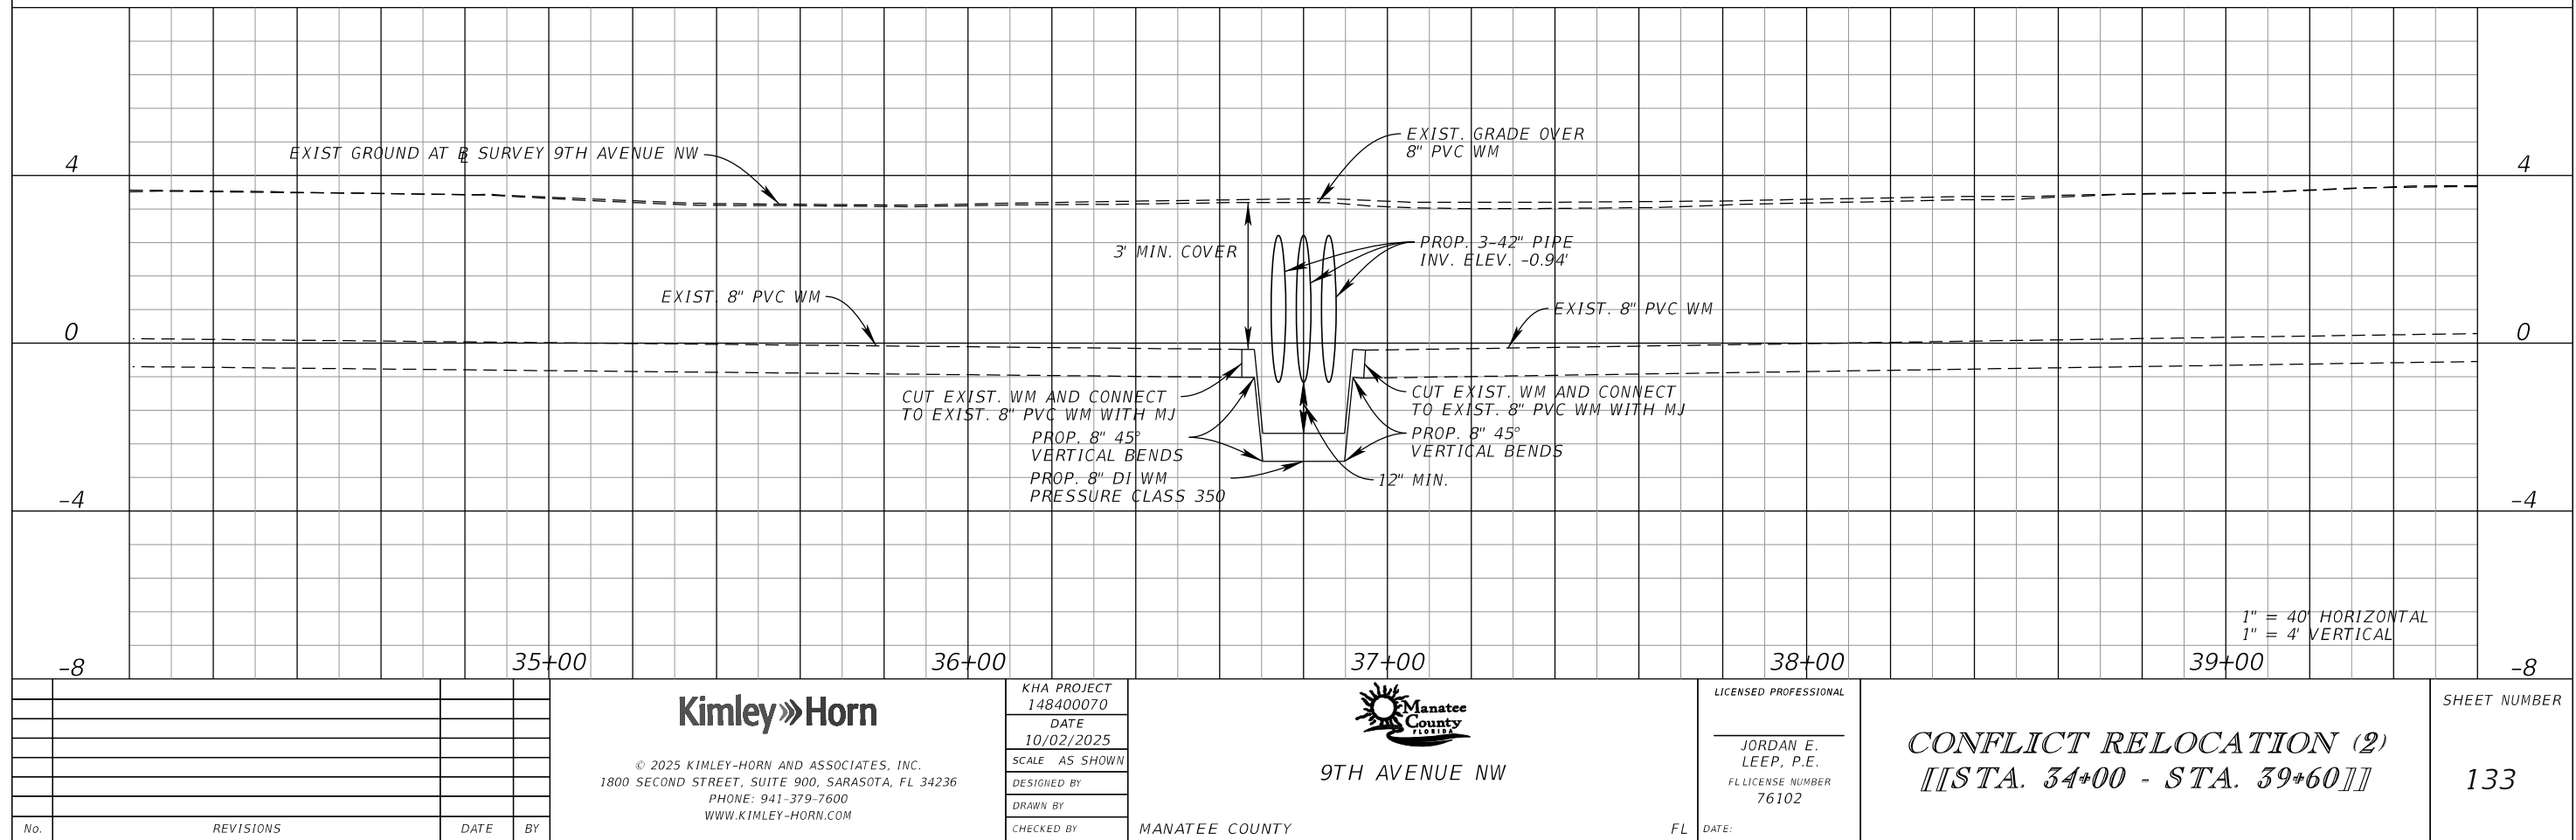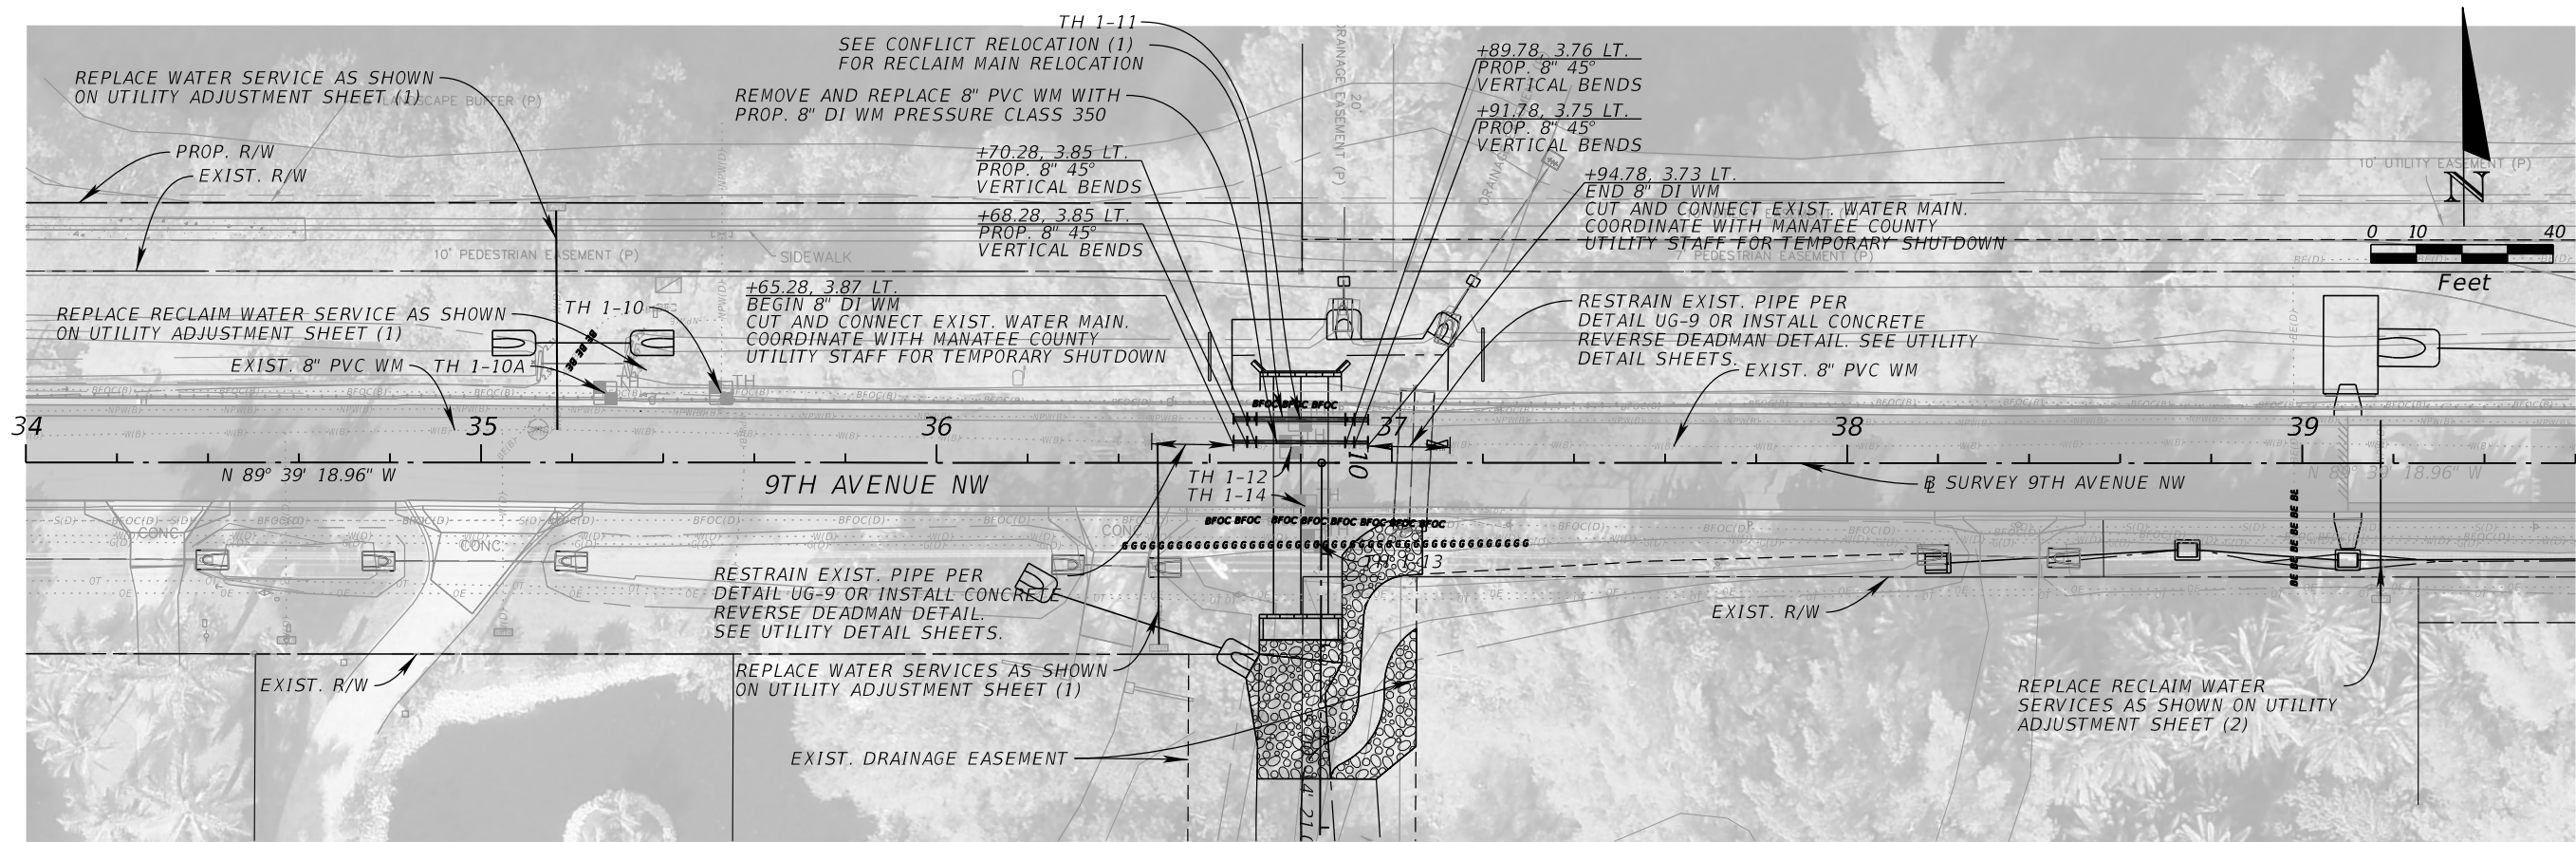
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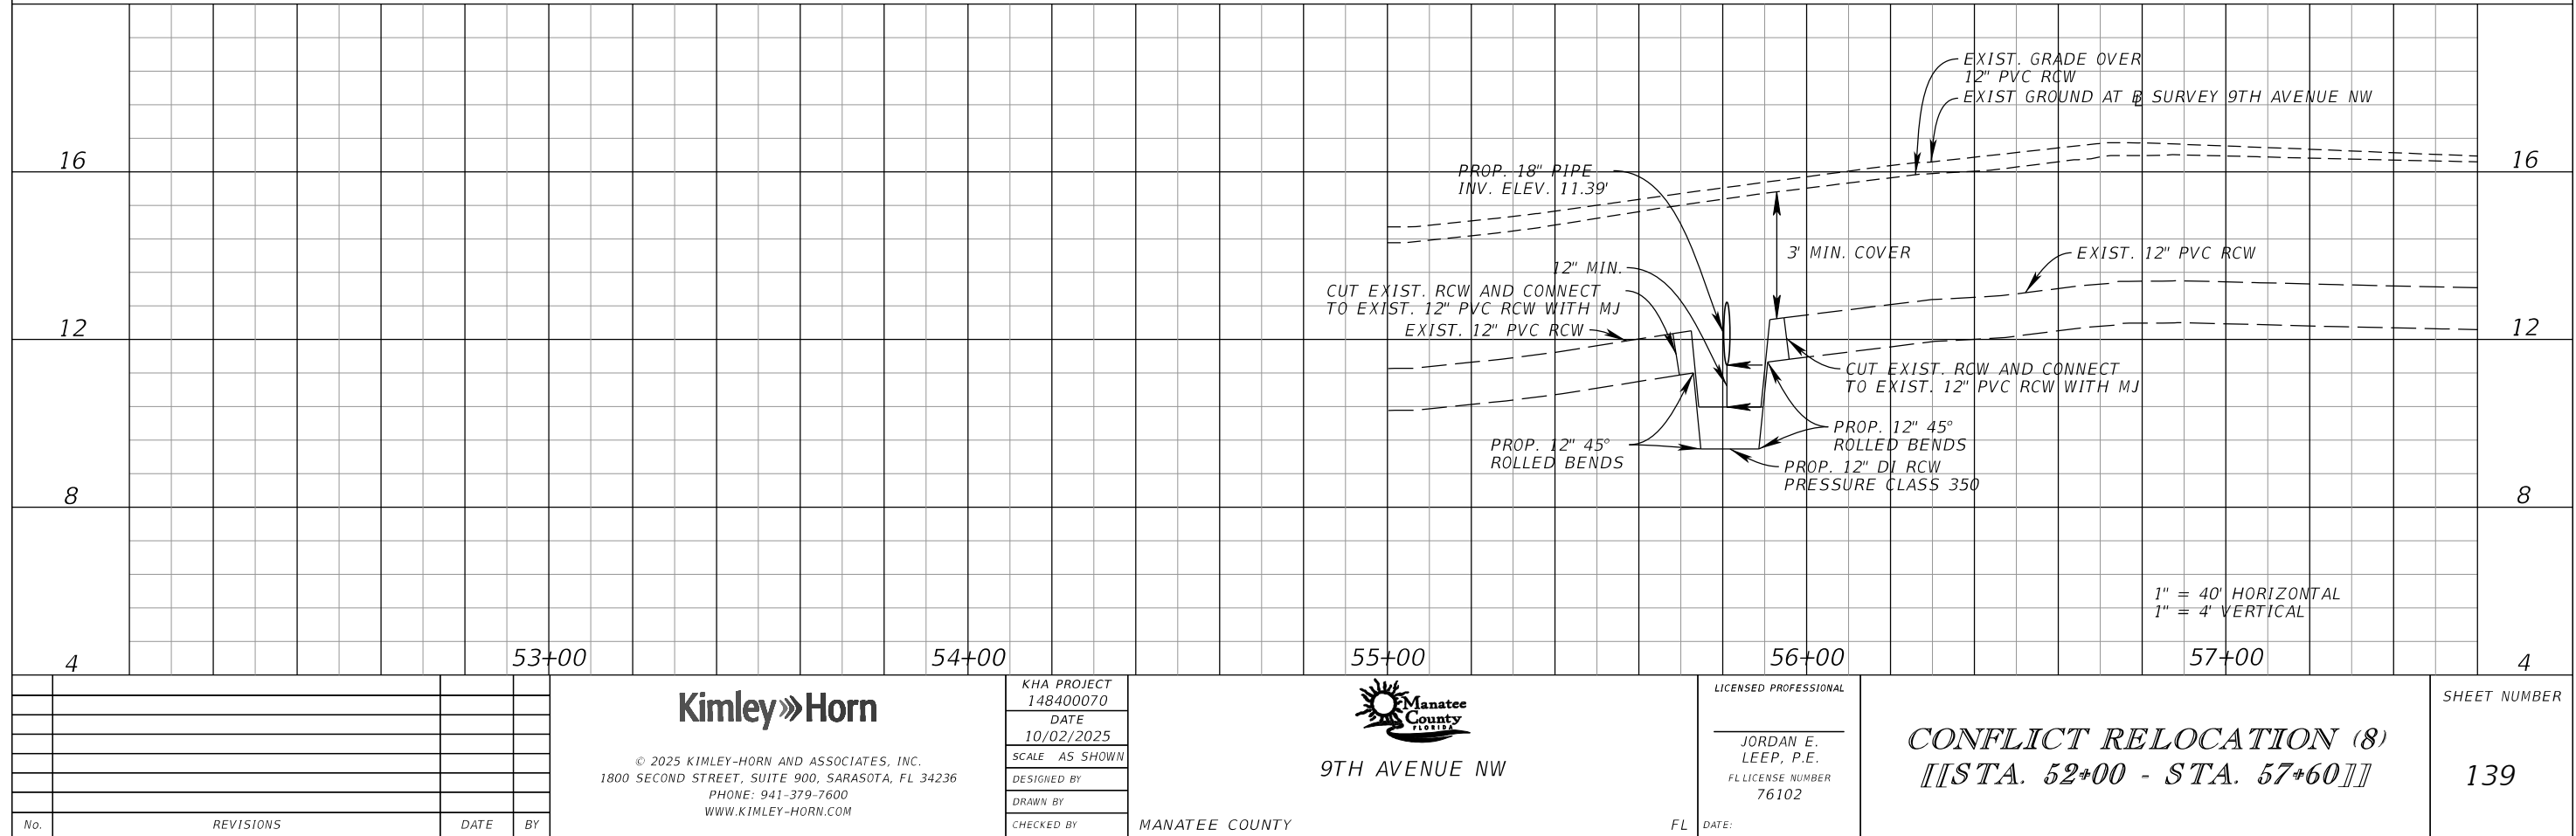
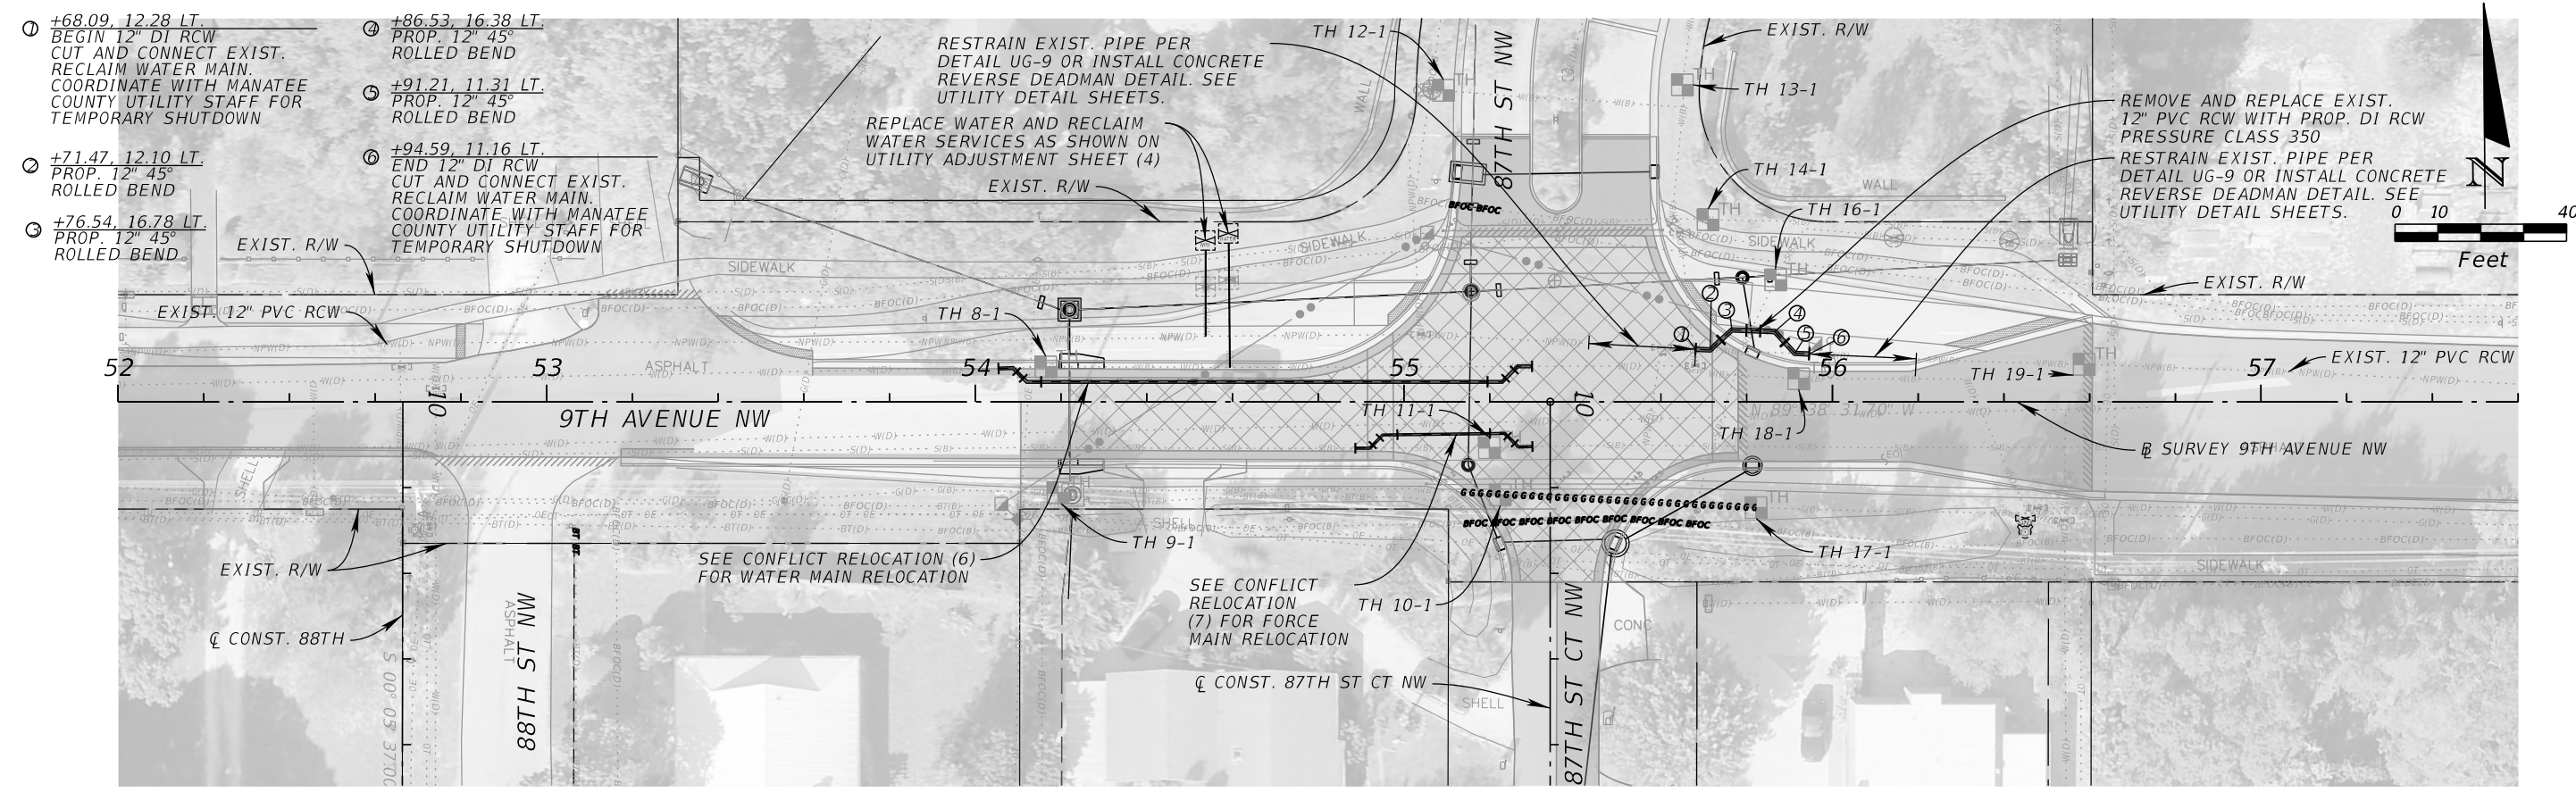


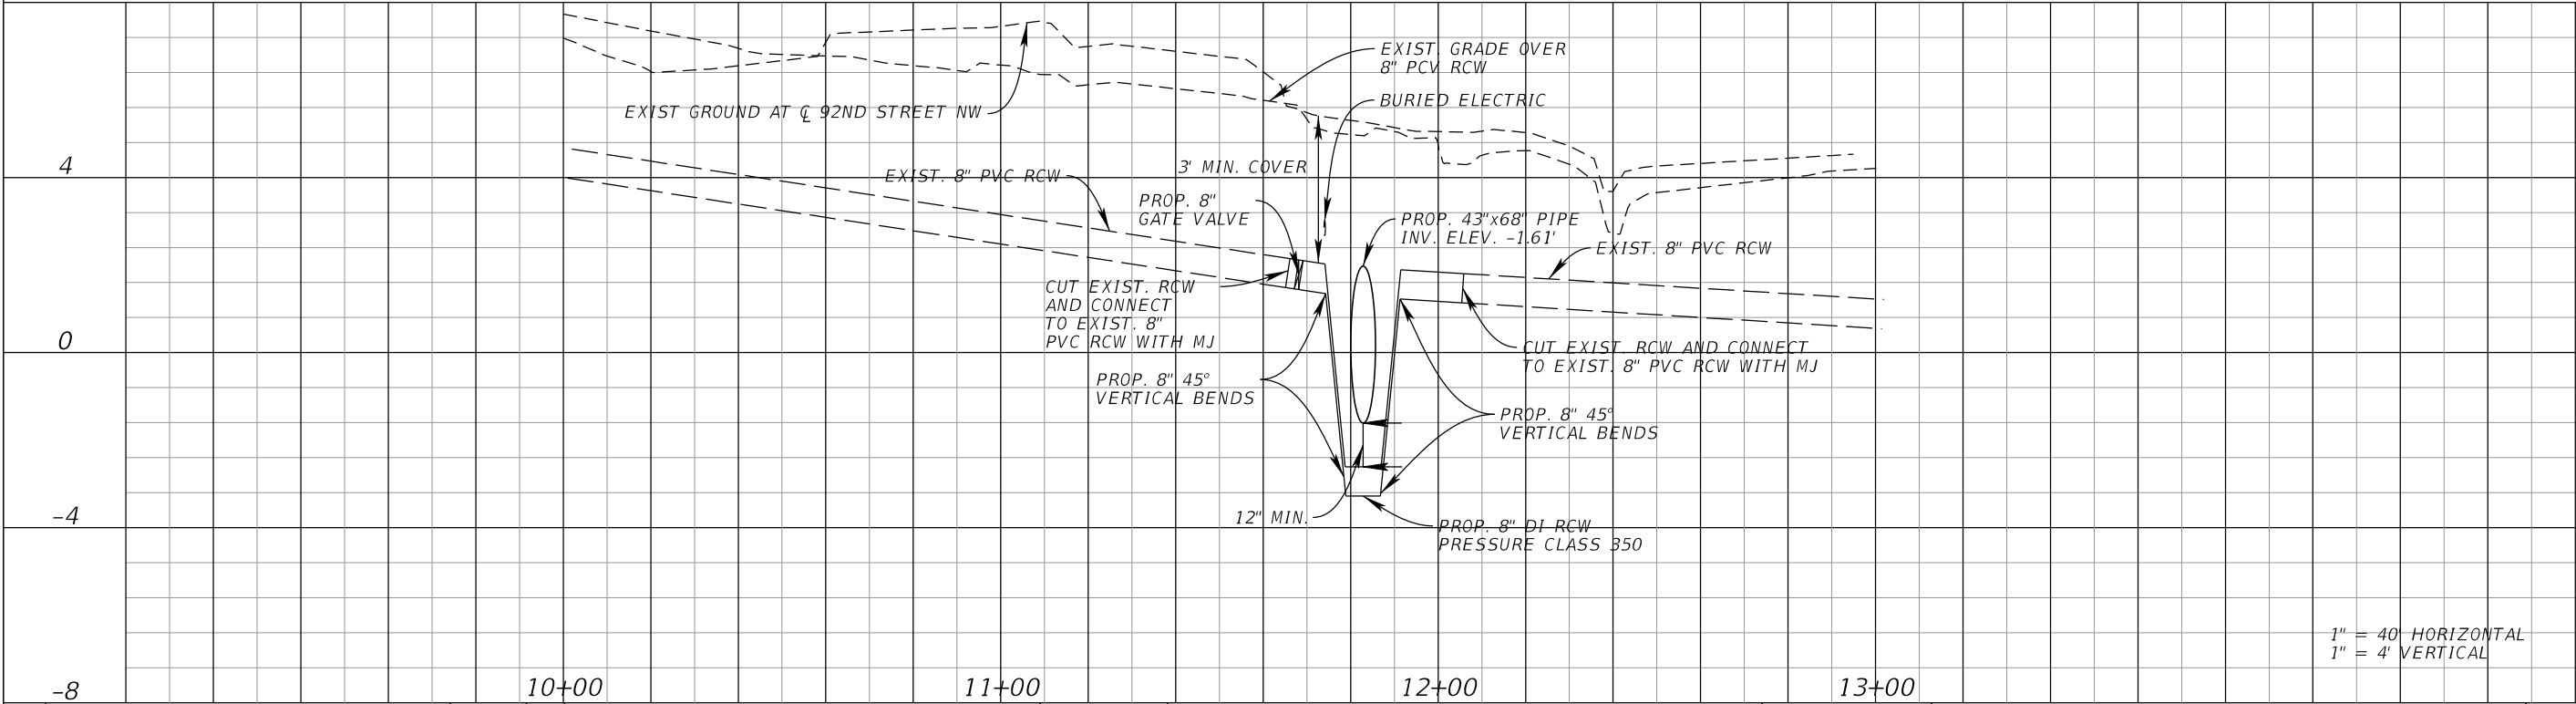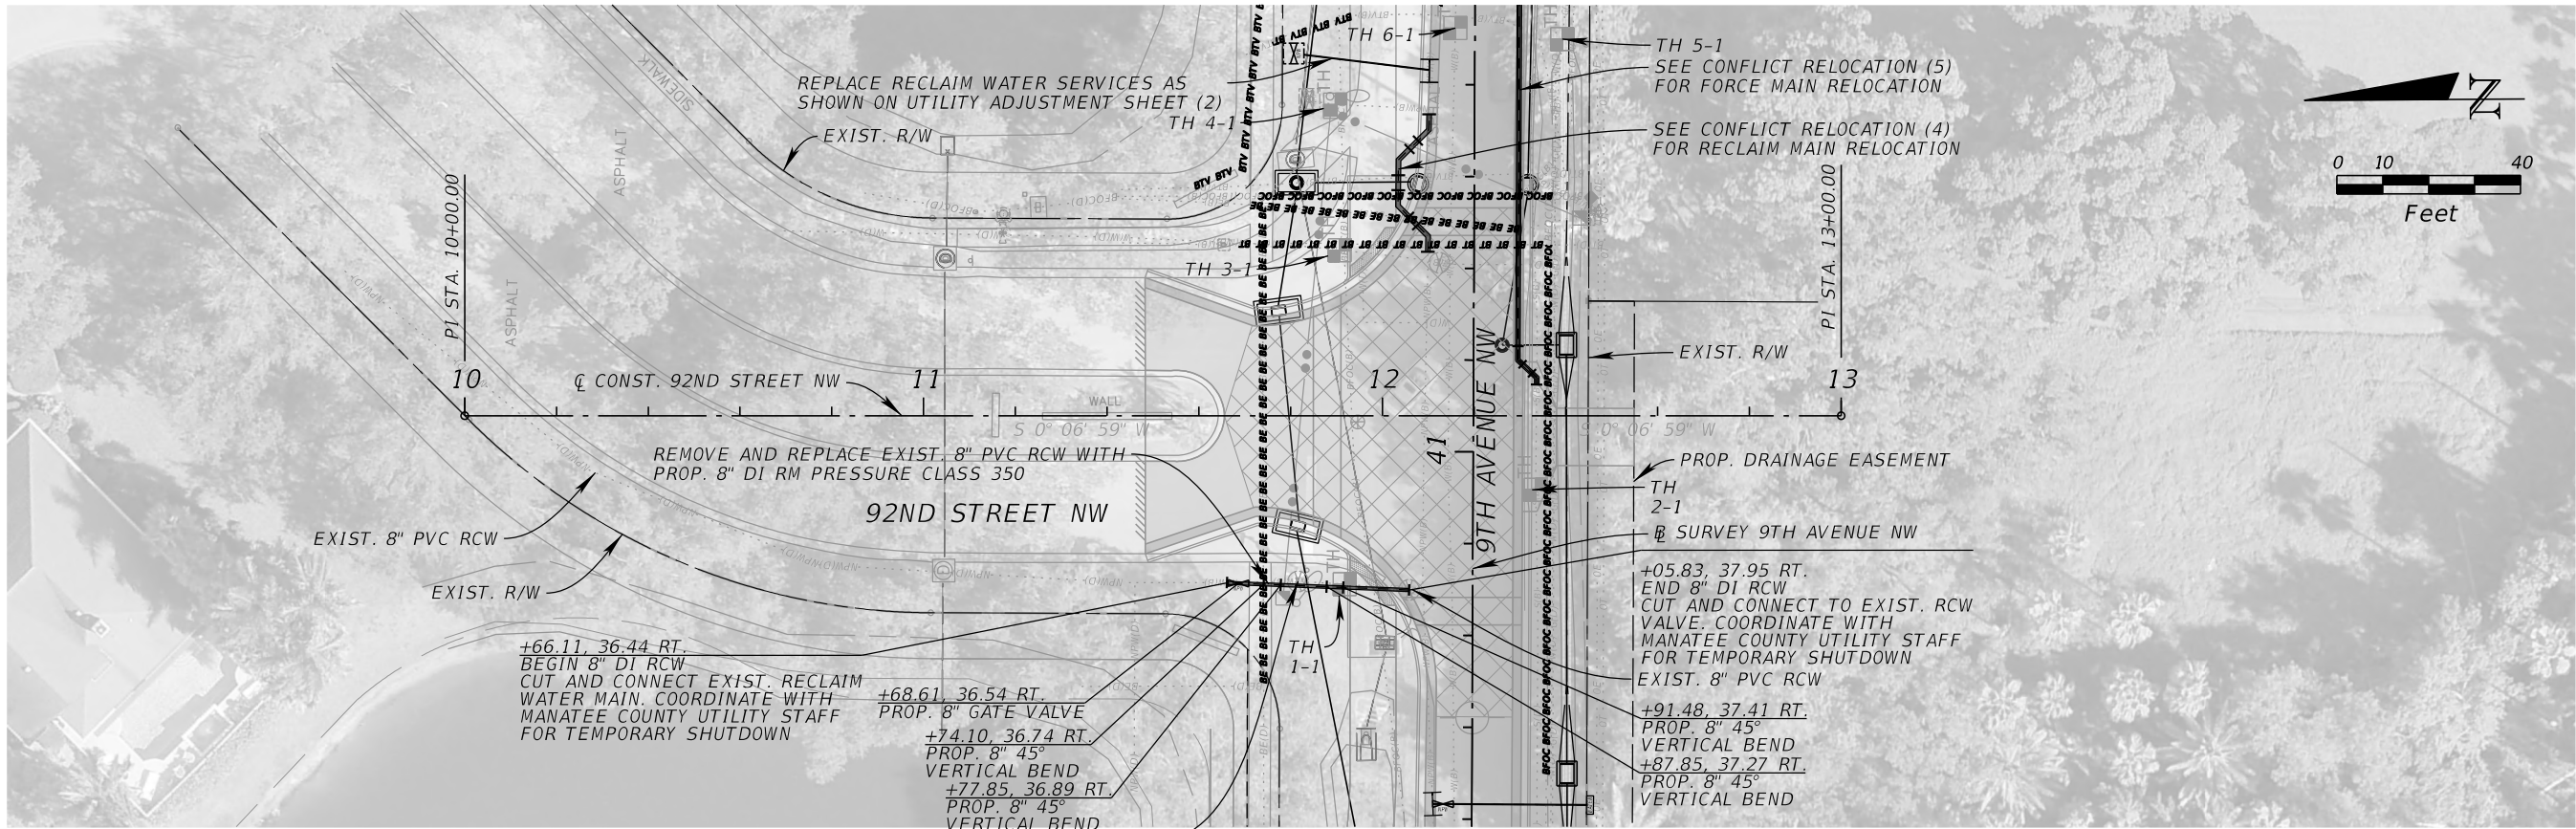

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No.	REVISIONS	DATE	BY			

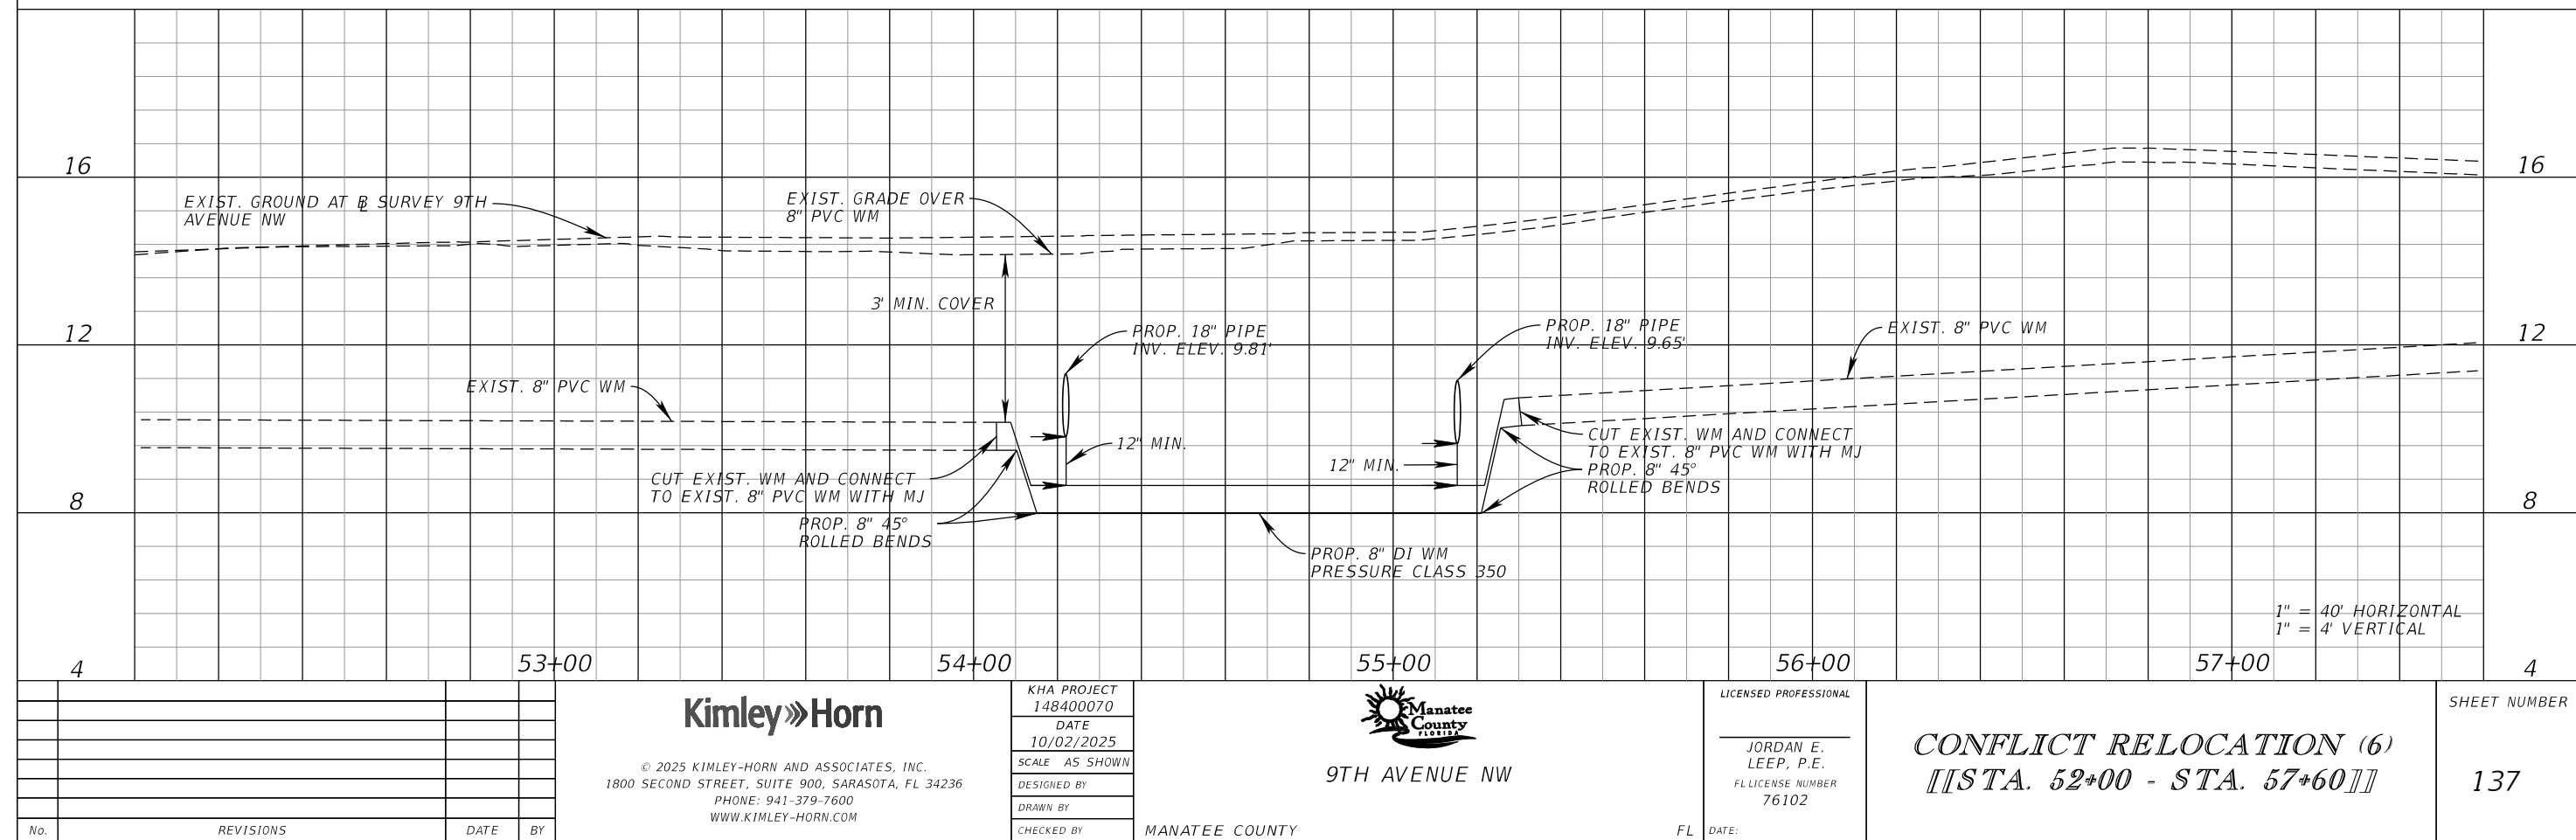
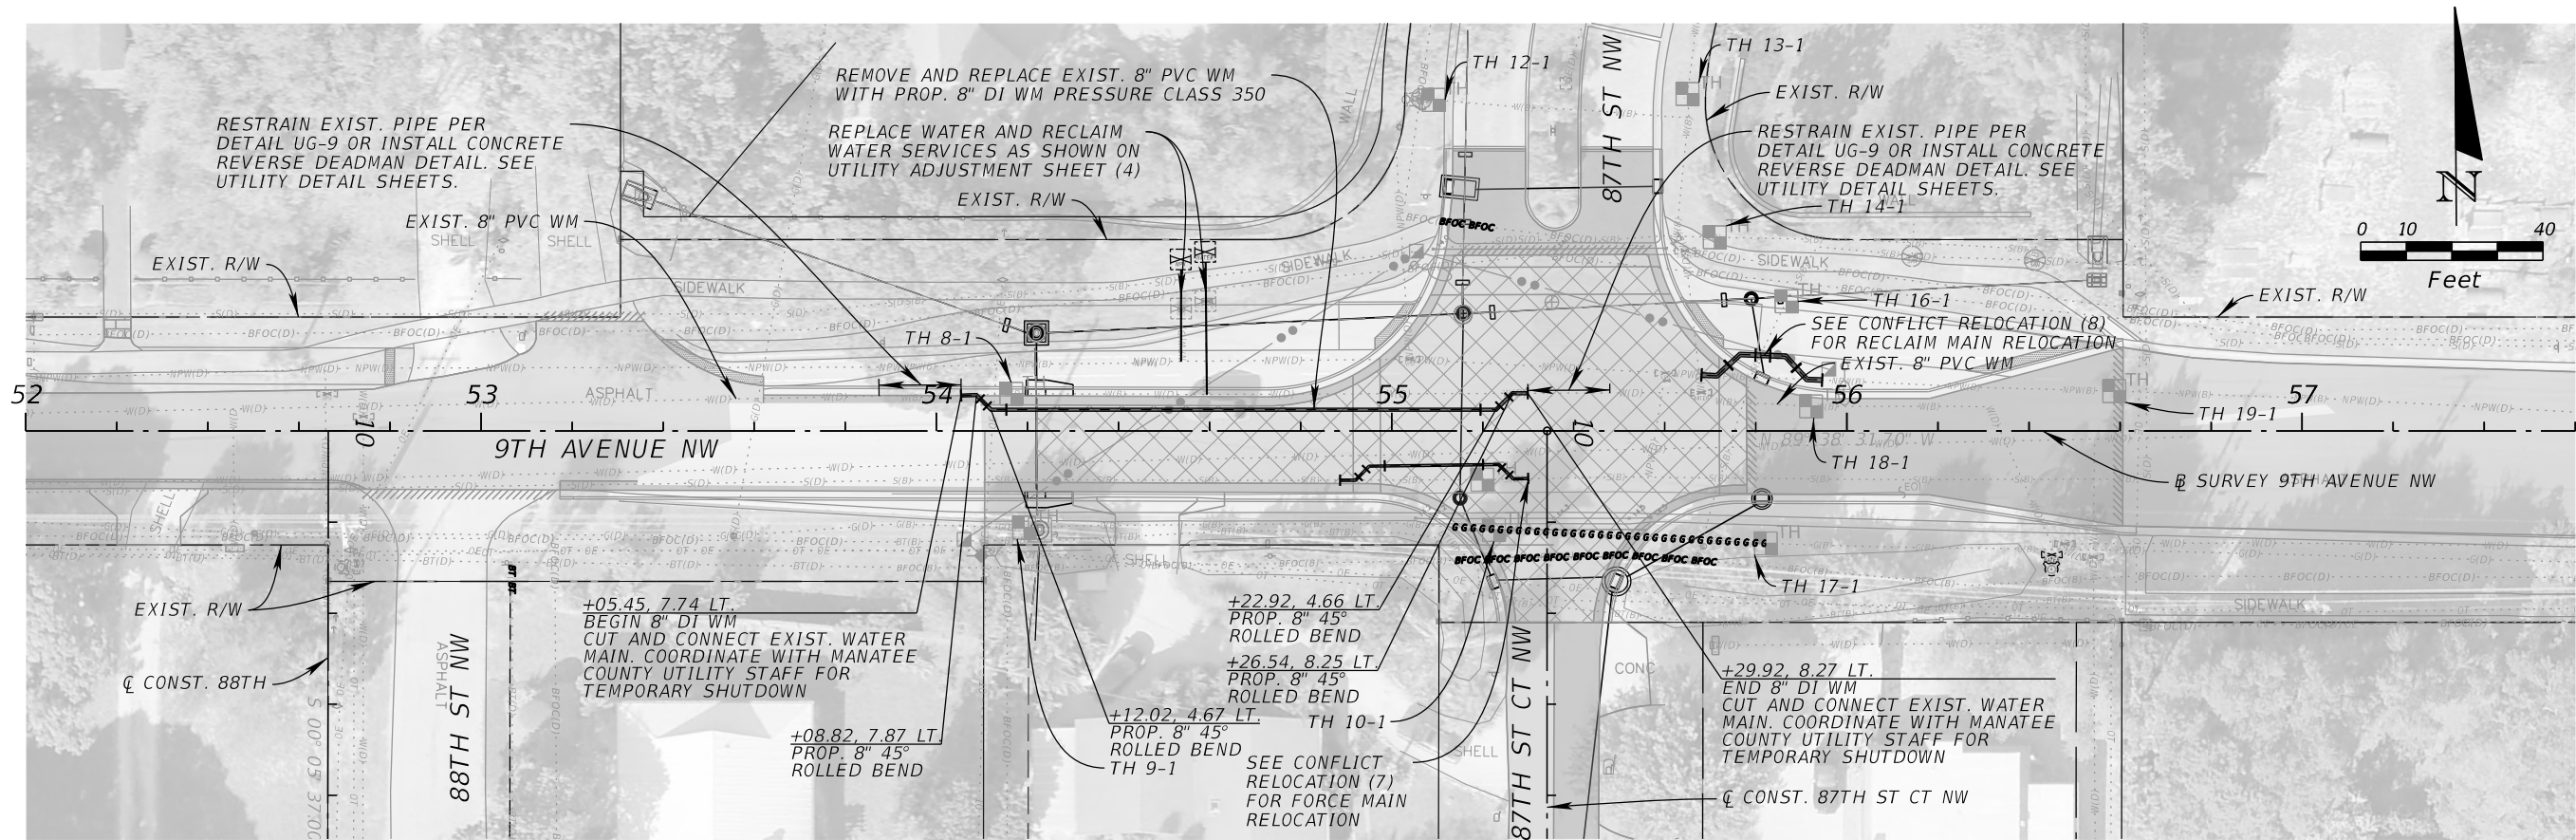
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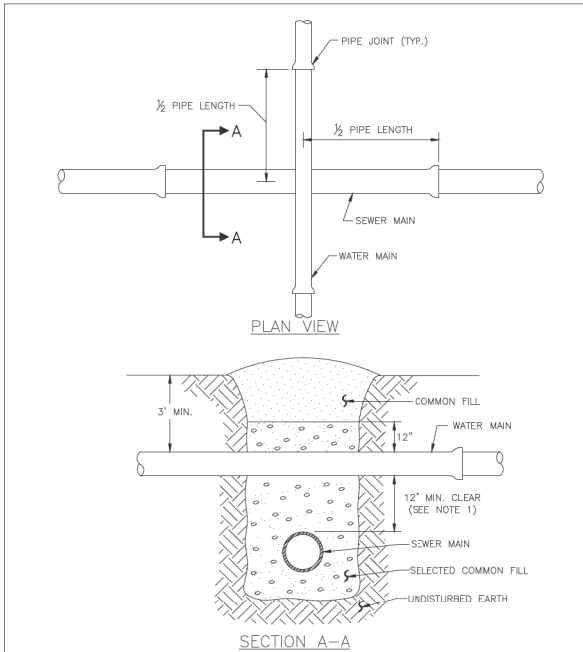
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<div><p>No. REVISIONS DATE BY</p></div>				<div><p>10/2/2025 2:36:29 PM Default</p></div>		<div><p>FL DATE:</p></div>				<div><p>K:\SAR_Roadway\148400070_9thAve\148400070\utils\PLPRUW10A.dgn</p></div>			

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<b>Kimley»Horn</b>		<b>KHA PROJECT</b> 148400070		<b>Manatee County</b> FLORIDA		<b>LICENSED PROFESSIONAL</b>  JORDAN E. LEEP, P.E. FL LICENSE NUMBER 76102		<b>CONFLICT RELOCATION (9)</b> <b>[[STA. 70+00 - STA. 75+60]]</b>		<b>SHEET NUMBER</b>  140	
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No.	REVISIONS	DATE	BY								

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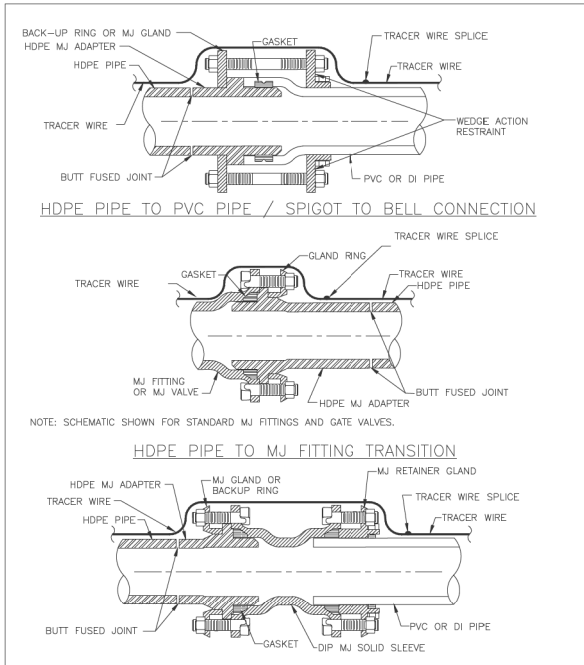


NOTES:

1. CLEARANCE MAY BE REDUCED TO 6" FOR GRAVITY SEWER WHERE WATER MAIN IS DUCTILE IRON.

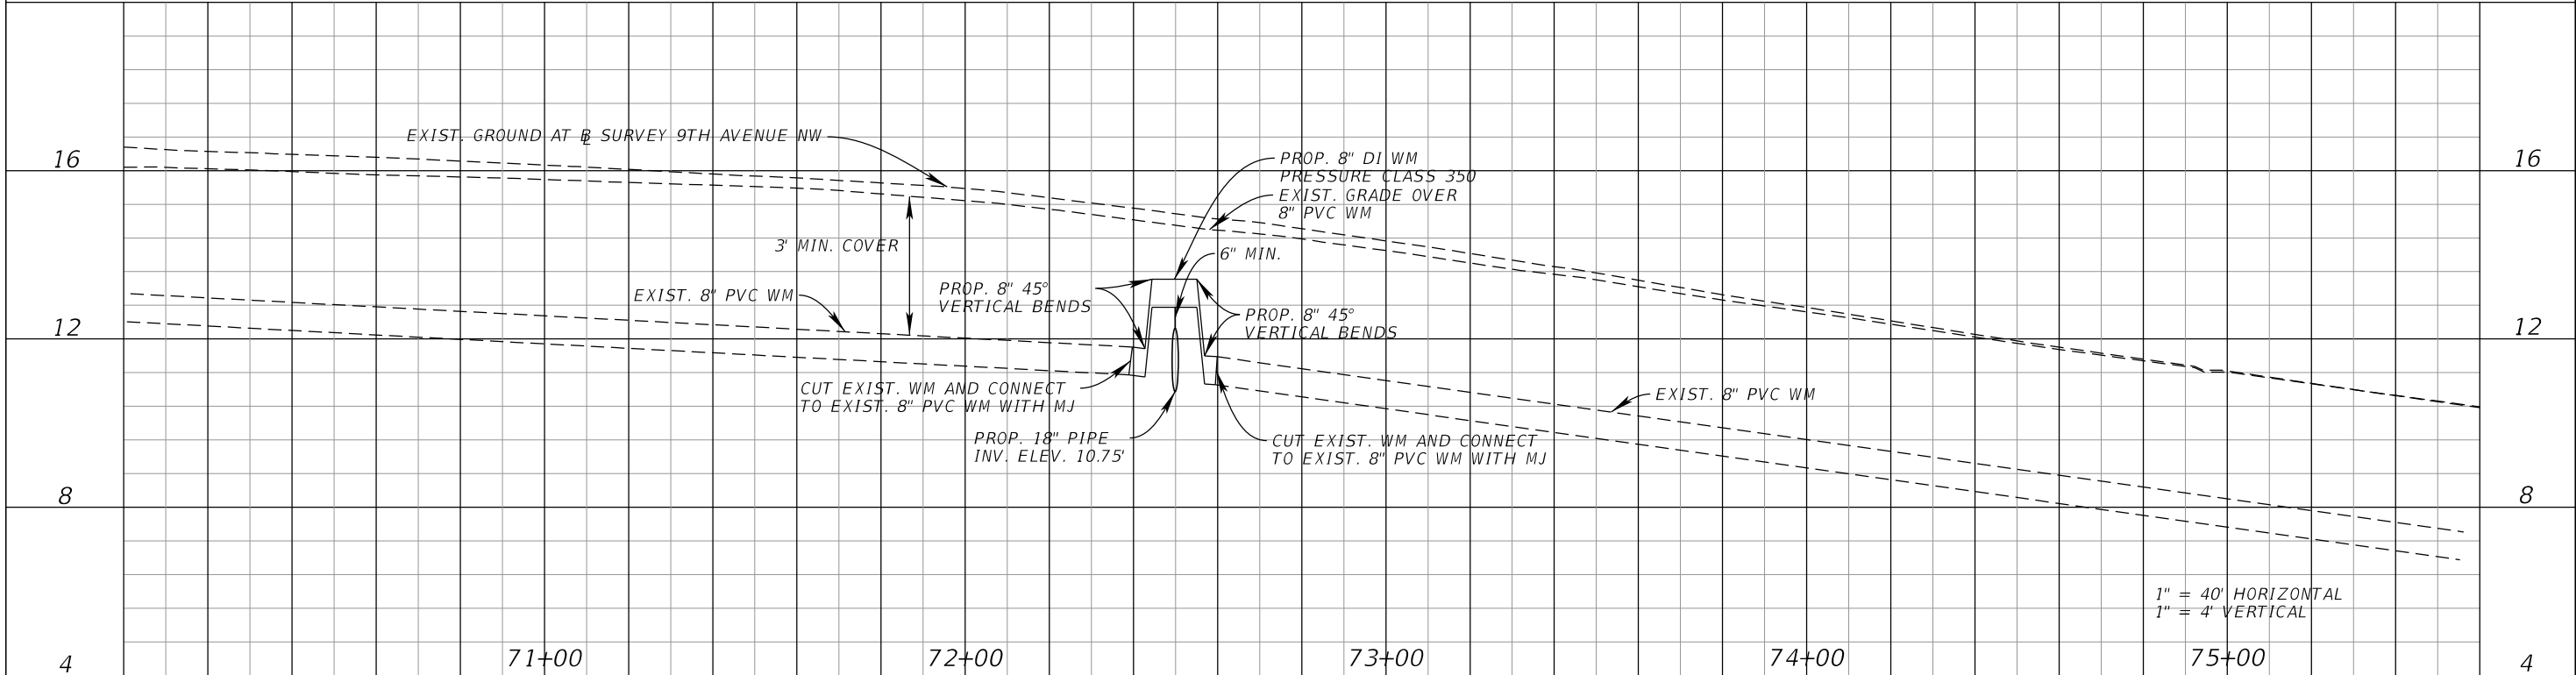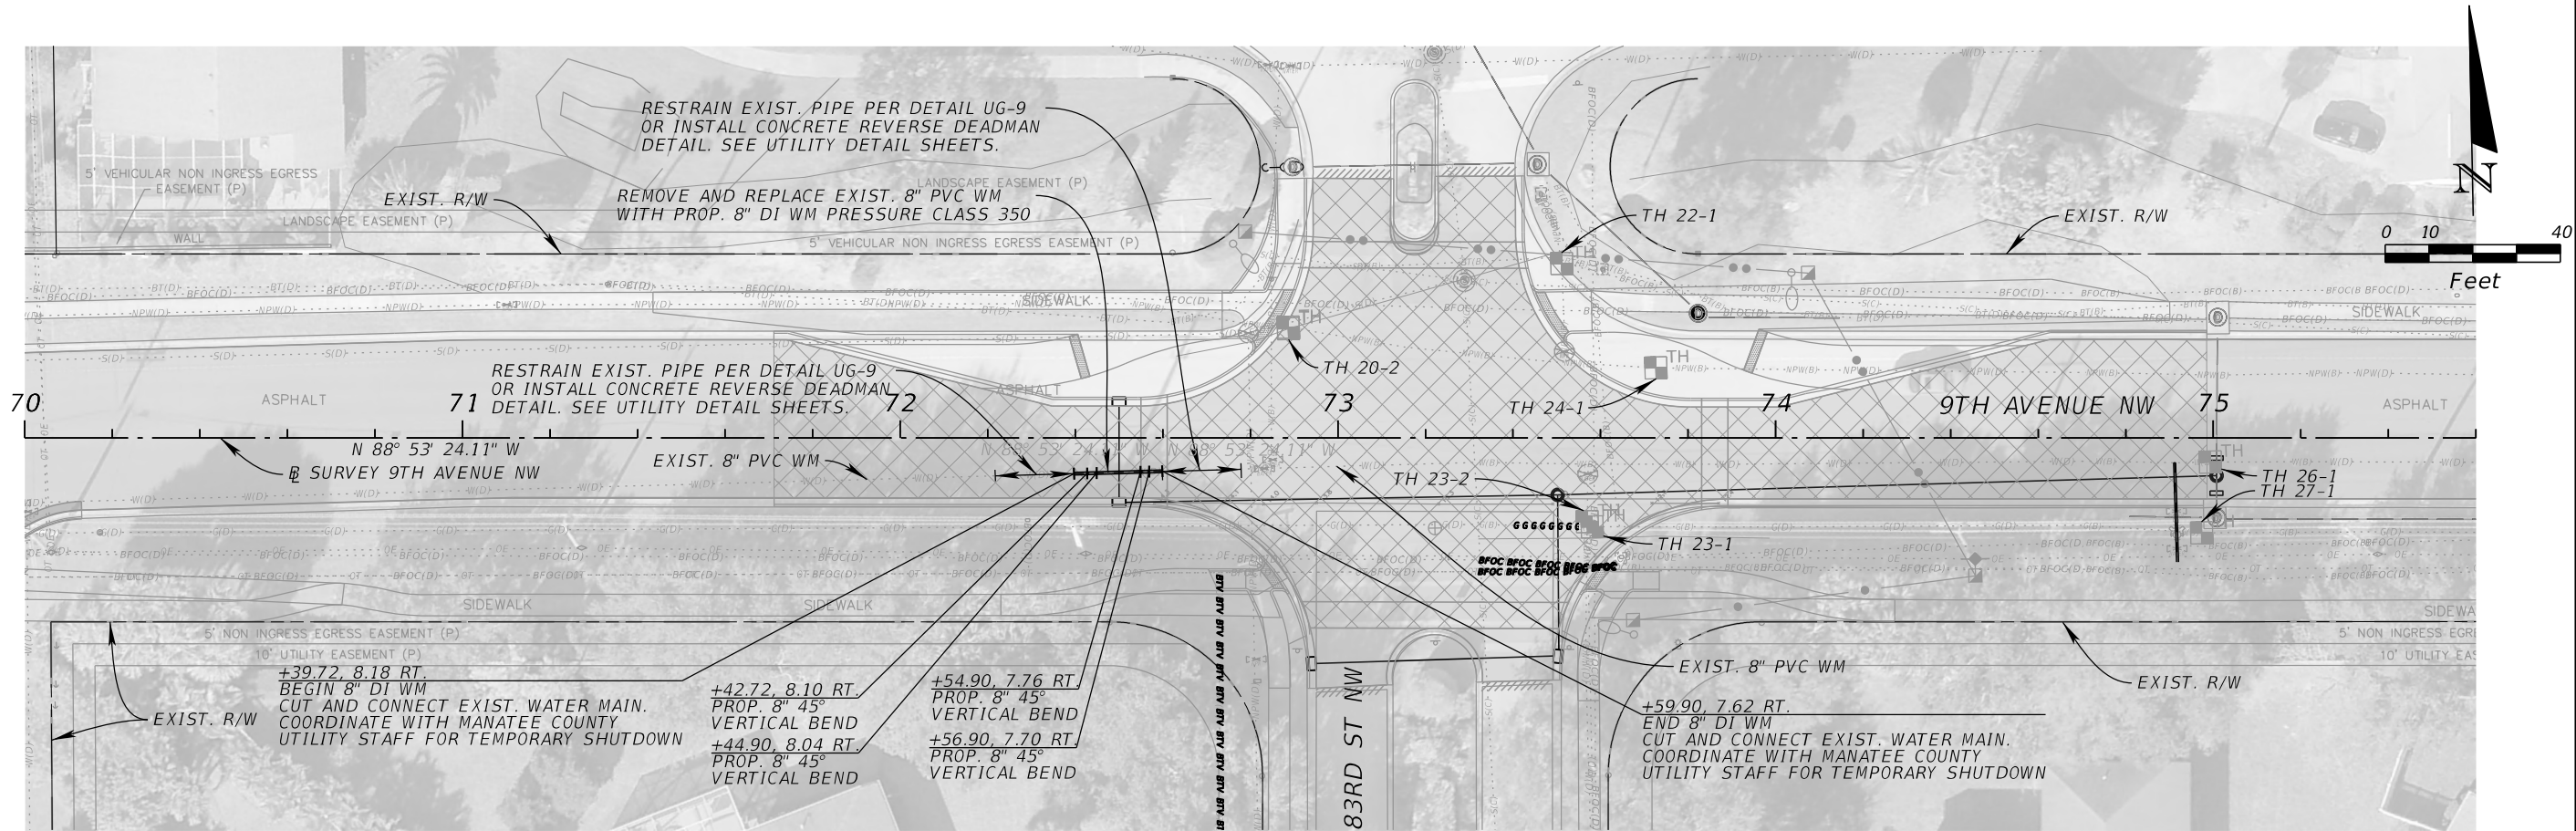2. PIPE SECTIONS SHALL BE FULL-LENGTH AND SHALL BE ADJUSTED HORIZONTALLY, SO THAT THE CROSSING IS AT EACH PIPE SECTION'S MIDPOINT REGARDLESS OF THE VERTICAL CLEARANCE.

MANATEE COUNTY PUBLIC WORKS DEPARTMENT		TYPICAL NEW WATER & SEWER LINE CROSSING	UG-2
REV. BY	DATE		
	SEPT 12, 2023 DATE OF APPROVAL		



NOTES:

1. ONE TRACER WIRE SHALL BE SECURED TO THE PIPE FOR ALL TYPES OF PIPELINE INSTALLATIONS.

2. CONTRACTOR SHALL NOT USE MECHANICAL MEANS TO ALIGN PIPE AND FITTINGS FOR ATTACHMENT. THE PIPE SHALL NOT BE "SPRING" LOADED.

MANATEE COUNTY PUBLIC WORKS DEPARTMENT		HDPE TO PVC OR DI PIPE ADAPTER	UG-6
REV. BY	DATE		
	SEPT 12, 2023		
	DATE OF APPROVAL		

PIPE SIZE (IN.)	90° BEND		45° BEND		22.5° BEND		11.25° BEND		DEAD END & TEE		45° WYE	
	B	d	B	d	B	d	B	d	B	d	B	d
4	1.5	3 1/2	1.1	3 1/2	0.8	3 1/2	0.6	3 1/2	1.3	3 1/2	1.1	3 1/2
6	2.2	5 1/4	1.6	3 3/4	1.2	3 3/4	0.8	3 3/4	1.9	4 1/2	1.6	3 3/4
8	2.9	7	2.1	5	1.5	3 1/2	1.1	3 1/2	2.4	5 1/4	2.0	4 3/4
10	3.5	8 1/2	2.6	6 1/4	1.9	4 1/2	1.3	3 1/2	3.0	7 1/4	2.5	6
12	4.2	10	3.1	7 1/2	2.2	5 1/4	1.6	3 3/4	3.5	8 1/4	3.0	7 1/4
14	4.9	11 1/4	3.6	8 3/4	2.6	6 1/4	1.8	4 1/4	4.1	9 1/4	3.4	8 1/4
16	5.5	13 1/4	4.1	9 3/4	2.9	7	2.1	5	4.7	11 1/4	3.9	9 1/4
18	6.2	15	4.6	11	3.3	8	2.3	5 1/2	5.2	12 1/2	4.4	10 1/2
20	6.9	16 1/2	5.0	12	3.6	8 3/4	2.6	6 1/4	5.8	14	4.9	11 1/4
24	8.2	19 1/4	6.0	14 1/4	4.3	10 1/4	3.1	7 1/2	6.9	16 1/2	5.8	14
30	10.1	24 1/4	7.5	18	5.3	12 1/4	3.8	9	8.5	20 1/2	7.2	17 1/4
36	12.1	29	8.9	21 1/4	6.4	15 1/4	4.5	10 1/4	10.2	24 1/2	8.6	20 1/4

REINFORCEMENT MAT SCHEDULE

FOR DIM. "B" BETWEEN 5.75' & 12.5' USE #4 @ 8" EACH WAY  
FOR DIM. "B" LESS THAN 5.75' USE #3 @ 8" EACH WAY

NOTES:

- ALL THRUST BLOCKS SHALL BE CAST IN PLACE. FITTINGS ADJACENT TO THRUST BLOCKS SHALL BE WRAPPED IN POLYETHYLENE.
- THIS TABLE IS BASED ON WATER PRESSURE=180 PSI WITH AN ALLOWABLE SOIL BEARING PRESSURE=2000 PSF. CONCRETE STRENGTH f<sub>c</sub> =3000 PSI, REINFORCEMENT f<sub>y</sub> =60.0 KSI. THRUST BLOCK SHALL BE CAST AGAINST FIRM UNDISTURBED SOIL.
- FOR LARGER "B" DIMENSIONS IT IS NECESSARY TO CHECK THAT PIPE IS SUFFICIENTLY DEEP TO ALLOW 15" MIN. SOIL COVER OVER TOP EDGE OF THRUST BLOCK.
- RESTRAINED JOINTS MAY BE USED IN LIEU OF THRUST BLOCKS TO SAVE SPACE. HOWEVER, WHERE THRUST BLOCKS AND RESTRAINED JOINTS ARE CALLED OUT/ILLUSTRATED IN THE DETAILS, BOTH SHALL BE INSTALLED.

REQUIRED LENGTH OF RESTRAINED JOINT PIPE FOR C900-16 PVC PIPE (DR-18)												
MAIN PIPE SIZE	HORIZ. BENDS		TEES						REDUCERS		PLUGS & VALVES	
			SIZE			LENGTH			SIZE	LENGTH		
90°	45°	22.5°										
24	90	38	18	X24 169	X20 132	X18 90	X12 38	X10 6	X20 64	X16 117	X12 158	214
20	78	32	16	X20 141	X16 101	X12 53	X10 24	X8 1	X16 65	X12 115	X10 149	184
16	66	27	13	X16 111	X12 67	X10 41	X8 12		X12 64	X10 107	X8 111	151
12	52	22	10	X12 80	X10 56	X8 31	X6 1		X10 58	X8 62	X6 86	118
10	44	18	9	X10 63	X8 40	X6 7			X8 53	X6 61	X4 81	100
8	37	15	7	X8 49	X6 18	X4 1			X6 35	X4 60		83
6	29	12	6	X6 29	X4 1				X4 33			63
4	21	8	4	X4 12								45

NOTES:

- RESTRAIN 11.25° BENDS 50% OF LENGTH FOR 22.5° BENDS.
- ALL VALVES AND FITTINGS SHALL BE RESTRAINED TO THE CONNECTING SECTIONS OF PIPE.
- ALL ISOLATION VALVES MUST BE PROPERLY ANCHORED OR RESTRAINED TO RESIST A 180 PSI TEST PRESSURE IN EITHER DIRECTION.
- PIPE SIZES ARE GIVEN IN INCHES.
- RESTRAINED PIPE LENGTHS ARE GIVEN IN FEET.
- LENGTHS SHOWN ARE FOR A TEST PRESSURE OF 180 PSI.
- THE RESTRAINED LENGTHS SHOWN IN THESE TABLES ARE BASED ON SOIL CLASSIFICATION SP WITH AWWA TYPE 3 TRENCH CONDITIONS, 180 PSI TEST PRESSURE, 3 FEET OF COVER AND 1.5 FACTOR OF SAFETY. ACTUAL BURY CONDITIONS MUST BE DETERMINED BY THE ENGINEER OF RECORD AND THE RESTRAINED LENGTHS MODIFIED ACCORDINGLY.
- RESTRAINED LENGTHS TO BE APPLIED TO PIPELINES PER DETAIL UG-10 RESTRAINED LENGTHS FOR PIPE.
- ALL RESTRAINED JOINT HARDWARE SHALL CONFORM TO 1.11.17 OF THE PUBLIC WORKS UTILITIES STANDARDS MANUAL.
- ALL THREE "LEGS" OF TEES SHALL BE RESTRAINED PER THE STATED LENGTH IN THE TABLE.




MANATEE COUNTY PUBLIC WORKS DEPARTMENT		RESTRAINED LENGTHS FOR PVC PIPE	UG-8
REV. BY	DATE		
	SEPT 12, 2023		
	DATE OF APPROVAL		

REQUIRED LENGTH OF RESTRAINED JOINT PIPE FOR DIP (POLY-WRAPPED)															
MAIN PIPE SIZE	HORIZ. BENDS		TEES								REDUCERS				PLUGS & VALVES
			SIZE								SIZE				
			LENGTH								LENGTH				
36	142	59	28	x36 393	x30 318	x24 233	x20 160	x16 94	x12 64	x30 137	x24 104	x20 80	x16 59	453	
30	124	51	25	x30 333	x24 258	x18 189	x16 116	x12 23	x10 1	x24 137	x20 113	x16 86	x12 61	391	
24	106	44	21	x24 276	x20 211	x16 143	x12 81	x10 39	x8 10	x20 98	x16 76	x12 54	x10 41	327	
20	92	38	18	x20 225	x16 161	x12 85	x10 39	x8 19	x6 1	x16 88	x12 63	x10 41	x8 27	280	
16	77	32	15	x16 177	x12 107	x10 89	x8 50	x6 1	x4 1	x12 68	x10 53	x8 36	x6 23	231	
12	61	25	12	x12 127	x10 89	x8 50	x6 1	x4 1	x3 1	x10 51	x8 36	x6 23	x4 13	181	
10	52	22	10	x10 101	x8 64	x6 11	x4 1	x3 1	x2 1	x8 51	x6 34	x4 25	x3 1	153	
8	44	18	9	x8 78	x6 30	x4 1	x3 1	x2 1	x1 1	x6 54	x4 32	x3 1	x2 1	128	
6	34	14	7	x6 46	x4 1	x3 1	x2 1	x1 1	x1 1	x4 30	x3 1	x2 1	x1 1	98	
4	24	10	5	x4 19	x3 1	x2 1	x1 1	x1 1	x1 1					69	

NOTE:

1. SEE UG-8, RESTRAINED LENGTHS FOR PVC PIPE DETAIL FOR NOTES 1 THROUGH 10 THAT ARE ALSO APPLICABLE TO RESTRAINED LENGTHS FOR DIP.

MANATEE COUNTY PUBLIC WORKS DEPARTMENT		RESTRAINED LENGTHS FOR DIP	UG-9
REV. BY	DATE		
	SEPT 12, 2023		
	DATE OF APPROVAL		

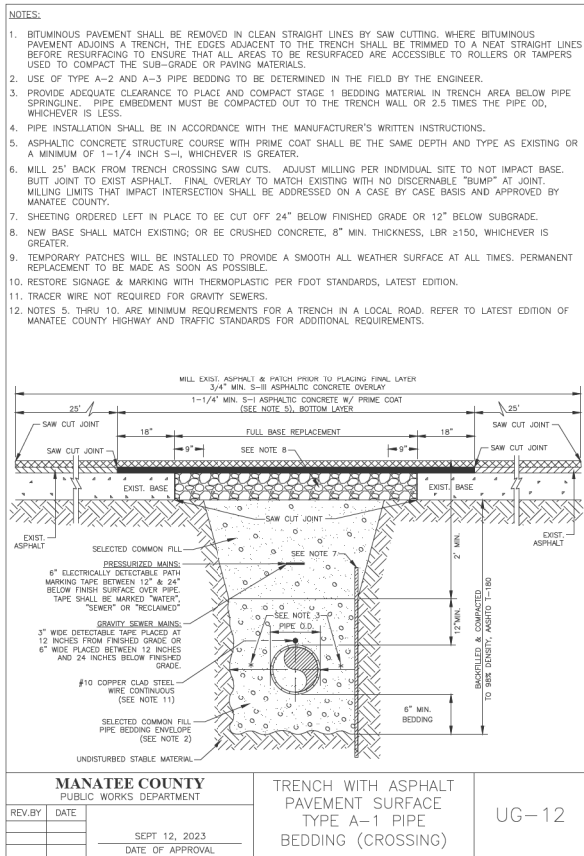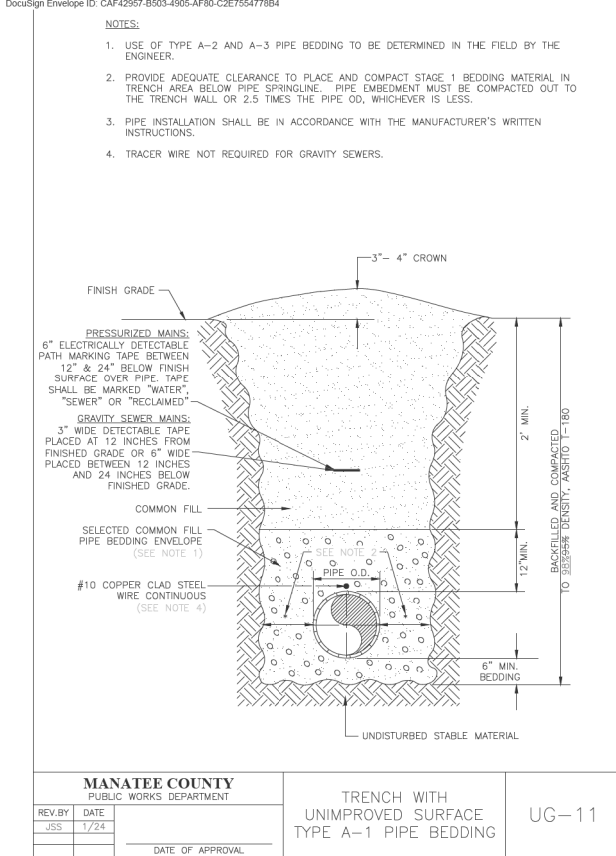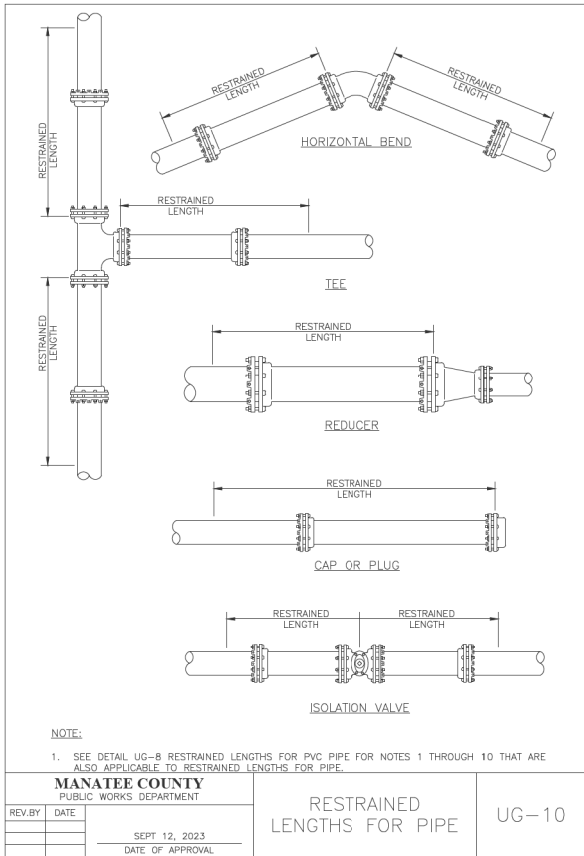

No.	REVISIONS	DATE	BY

Kimley»Horn	
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KHA PROJECT 148400070 DATE 10/02/2025 SCALE AS SHOWN DESIGNED BY DRAWN BY CHECKED BY	



MANATEE COUNTY	
PUBLIC WORKS DEPARTMENT	
DATE OF APPROVAL	

Manatee County Florida	
9TH AVENUE NW	
LICENSED PROFESSIONAL	
JORDAN E. LEEP, P.E. FL LICENSE NUMBER 76102	
FL DATE:	


TRENCH WITH UNIMPROVED SURFACE TYPE A-1 PIPE BEDDING	
UG-11	

TRENCH WITH ASPHALT PAVEMENT SURFACE TYPE A-1 PIPE BEDDING (CROSSING)	
UG-12	

SHEET NUMBER	
141	

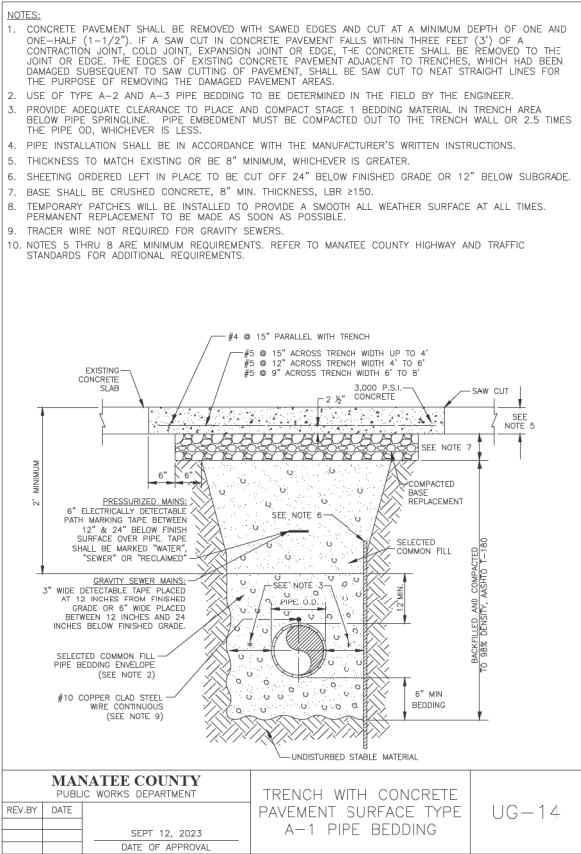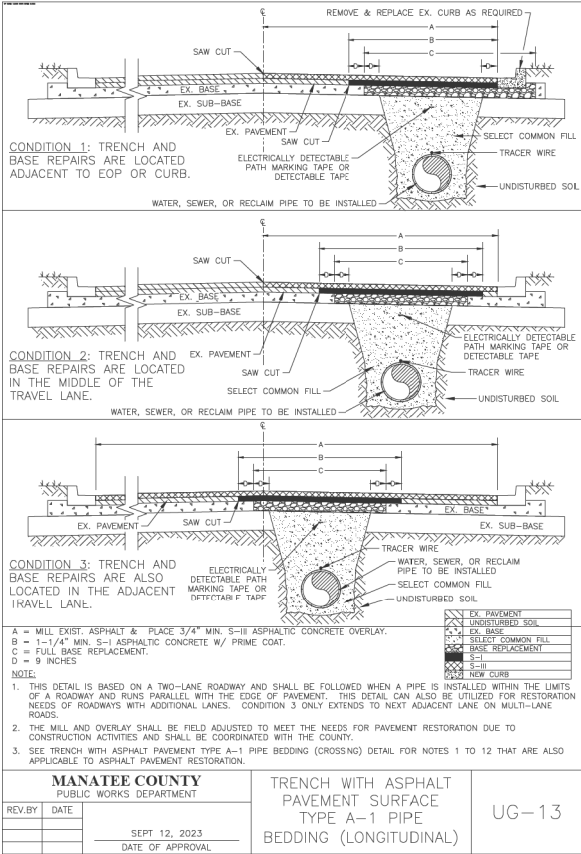




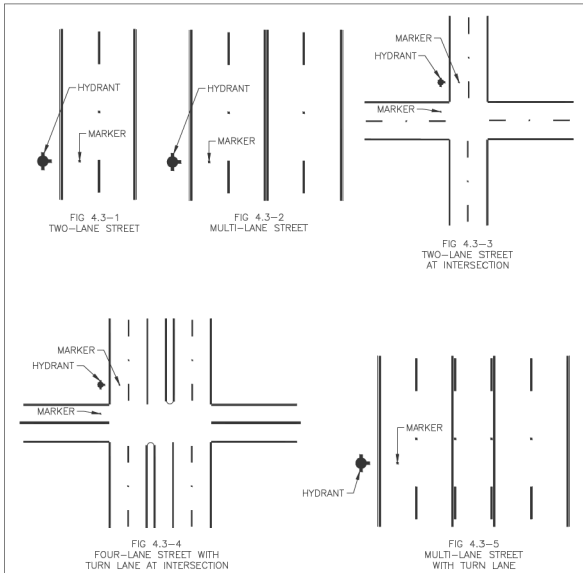


- NOTES:
1. ALL STREETS OR ROADS: MARKER SHOULD BE PLACED IN THE CENTER OF THE TRAVEL LANE CLOSEST TO THE FIRE HYDRANT. SEE FIGURE 4.3-1, 4.3-2, AND 4.3-3.
  2. STREETS WITH LEFT TURN LANE AT INTERSECTION: MARKER SHOULD BE PLACED 6 INCHES FROM EDGE OF PAINTED WHITE CHANNELING LINE OF THE SIDE NEAREST THE FIRE HYDRANT. SEE FIGURE 4.3-4.
  3. STREETS WITH CONTINUOUS TWO-WAY TURN LANE: MARKER SHOULD BE PLACED 6 INCHES FROM THE EDGE OF THE PAINTED YELLOW BARRIER LINE ON THE SIDE NEAREST THE FIRE HYDRANT. SEE FIGURE 4.3-5.
  4. MARKER SHALL BE BLUE/BLUE RAISED RETROREFLECTIVE PAVEMENT MARKER.

MANATEE COUNTY PUBLIC WORKS DEPARTMENT		HYDRANT LOCATION MARKERS - BLUE (RPMs)	UW-6
REV. BY	DATE		
	SEPT 12, 2023		
	DATE OF APPROVAL		

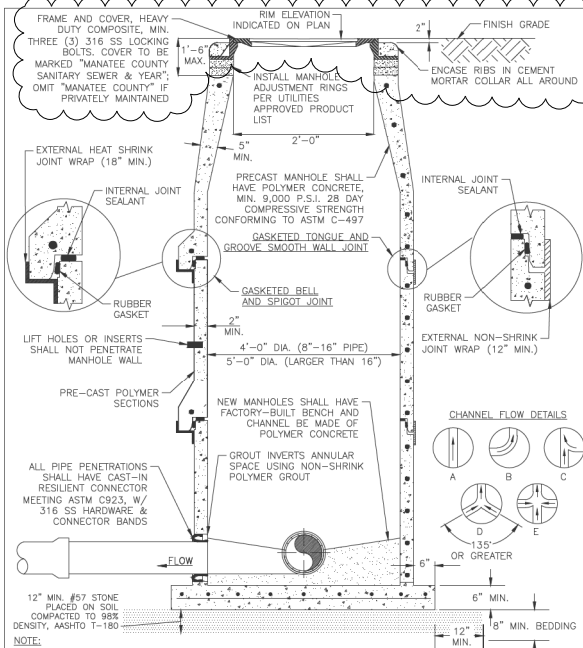


- NOTE:
1. DROP MANHOLES, MANHOLES WITH OPPOSING TURBULENT FLOW (DETAILS D & E), MANHOLES UPSTREAM OF A LIFT STATION WET WELL (SEE US-25), MANHOLES WITH GRAVITY SEWERS GREATER THAN 12 INCHES IN DIAMETER, FORCE MAIN TERMINAL MANHOLE AND THE NEXT TWO DOWNSTREAM MANHOLES SHALL BE MADE OF POLYMER CONCRETE.
  2. MANHOLES SHALL HAVE A GASKETED BELL & SPIGOT OR TONGUE & GROOVE SMOOTH WALL JOINT DESIGN.
  3. ALL JOINTS SHALL MEET THE REQUIREMENTS OF ASTM C-443 AND ASTM C-990 FOR CONCRETE SEWER AND CULVERT PIPE USING RUBBER GASKETS AND FLEXIBLE JOINT SEALANTS.
  4. ALL FRP/STEEL REINFORCEMENT, MANHOLE RISERS, CONES, BASES, AND FLAT LIDS SHALL BE DESIGNED BY MANUFACTURER TO MEET LOADING REQUIREMENTS OF ASTM C-478, ASTM C-857, ACI 350, AND ACI 440.1R AS MODIFIED FOR POLYMER CONCRETE MANHOLES.

MANATEE COUNTY PUBLIC WORKS DEPARTMENT		STANDARD PRECAST POLYMER CONCRETE SANITARY SEWER MANHOLE FOR TURBULENT FLOW	US-3
REV. BY	DATE		
	SEPT 12, 2023		
	DATE OF APPROVAL		

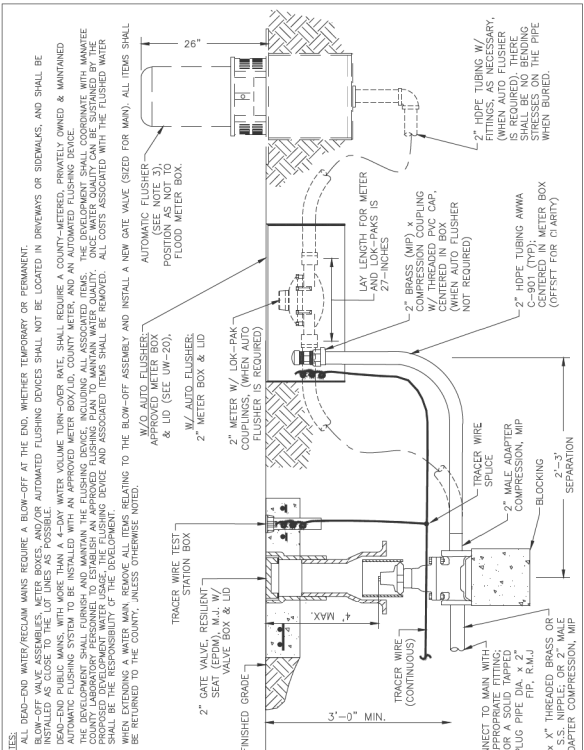


MANATEE COUNTY PUBLIC WORKS DEPARTMENT		2" BLOW-OFF ASSEMBLY	UW-8
REV. BY	DATE		
	SEPT 12, 2023		
	DATE OF APPROVAL		

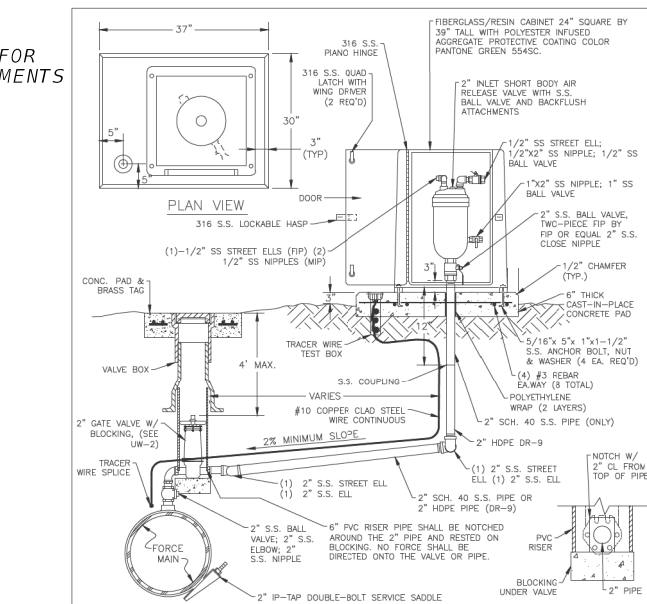


- NOTES:
1. AIR RELEASE VALVES TO BE ABOVE-GROUND INSTALLATIONS, UNLESS IMPRACTICAL. INSTALLATIONS MAY BE BELOW-GROUND ONLY WHERE APPROVED AND SPECIFICALLY INDICATED ON THE PLAN.
  2. AIR RELEASE VALVES TO BE INSTALLED AT HIGH POINTS, OR WHERE AIR WOULD BE ENTRAPPED, ALONG 4" AND LARGER FORCE MAINS.
  3. FORCE MAIN VERTICAL ALIGNMENT TO BE DESIGNED SUCH THAT THE MINIMUM NUMBER OF REQUIRED AIR RELEASE VALVES ARE INSTALLED.
  4. ALL INCIDENTAL FITTINGS AND HARDWARE TO BE 316 STAINLESS STEEL.
  5. ALL PIPE THREADS TO BE SEALED AIR TIGHT.
  6. VENT PIPE TO BE LAID ACCURATELY ON SLOPE, WITHOUT HIGH OR LOW POINTS.
  7. CONCRETE PAD SHALL BE TYPE I CONCRETE W/ 3,000 P.S.I., 28 DAY COMPRESSIVE STRENGTH.
  8. ANY SHALL BE INSTALLED MINIMUM 6 FT FROM EDGE OF PAVEMENT; 10 FT MAXIMUM FROM BACK OF CURB; 4 FT MIN. MAY BE APPROVED BY UTILITIES IN SOME EXISTING AREAS.
  9. SEE UW-2 GATE VALVE, BOX, LID AND TAG STANDARD DETAIL. CENTERING COLLAR IS NOT REQUIRED ON 2" GATE VALVES.

MANATEE COUNTY PUBLIC WORKS DEPARTMENT		ABOVE-GROUND AIR RELEASE VALVE ASSY. FOR FORCE MAINS	US-12
REV. BY	DATE		
	SEPT 12, 2023		
	DATE OF APPROVAL		

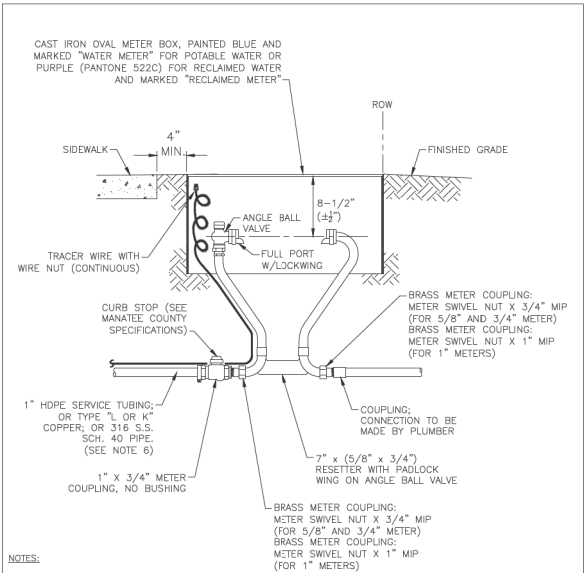


- NOTES:
1. METER BOX AND RESETTER ARE TO BE INSTALLED BY THE INFRASTRUCTURE CONTRACTOR AND SHALL NOT BE SET IN DRAINAGE SWALES, SIDEWALKS OR DRIVEWAYS. WITH PRIOR APPROVAL BY COUNTY, METER BOXES WITH LOCKABLE LIDS MAY BE LOCATED IN SIDEWALKS.
  2. THE METER RESETTER SHALL BE INSTALLED IN SUCH A MANNER AS TO ALLOW REMOVAL AND REPLACEMENT WITHOUT DISTURBING THE STRUCTURAL INTEGRITY OF THE PIPING SYSTEM, THE SHUTOFF VALVES, OR THE RESETTER.
  3. FOR COMPLETE SERVICE CONNECTION ASSEMBLY, SEE DETAIL UW-23 TYPICAL SERVICE CONNECTION.
  4. WHEN THE DISTANCE BETWEEN THE EDGE OF THE SIDEWALK AND THE R/W IS ONE FOOT (CUL-DE-SAC W/ MEDIAN) A 10-FOOT-WIDE PUBLIC UTILITY EASEMENT SHALL BE LOCATED IN THE FRONT OF THE LOTS, ADJACENT TO THE ROW.
  5. 3" MINIMUM CLEARANCE FROM LANDSCAPING PLANTS AND 10' MIN. CLEARANCE FROM TREES TO EDGE OF METER, CLEAR ACCESS OPENING TO STREET.
  6. SERVICE TUBING SHALL NOT BE CRIMPED OR KINKED TO RE-ADJUST CURB STOP LOCATION.
  7. "W" OR "R" SHALL BE IMPRESSED INTO THE NEWLY-POURED CONCRETE CURB (OR ROUTED INTO EXISTING CONCRETE CURB USING AN APPROVED TEMPLATE) AND INSTALL AN ALUMINUM BLUE DISC WITH "W" OR ALUMINUM PURPLE DISC WITH "R" AND THE FOOTAGE FROM THE DISC TO THE METER BOX USING A 1/8" x 1" GALVANIZED STEEL SCREW IN THE EDGE OF PAVEMENT. LETTERS SHALL COMPLY WITH TEMPLATE DETAIL UG-21.

MANATEE COUNTY PUBLIC WORKS DEPARTMENT		METER BOX ASSEMBLY FOR 5/8" X 3/4", 3/4", AND 1" METERS	UW-20
REV. BY	DATE		
	SEPT 12, 2023		
	DATE OF APPROVAL		

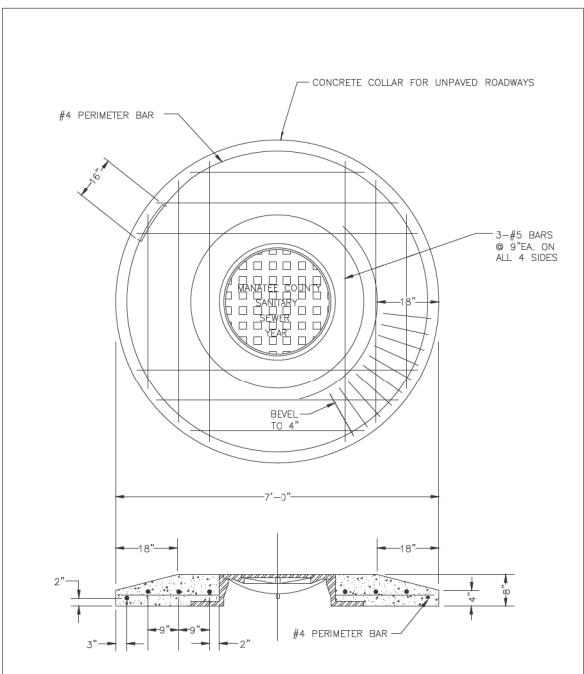


- NOTES:
1. OMIT "MANATEE COUNTY", IF PRIVATELY MAINTAINED.
  2. PORTLAND CEMENT SHALL CONFORM TO ASTM C150, TYPE I, AND CONCRETE SHALL HAVE A MINIMUM COMPRESSIVE STRENGTH OF 4,000 P.S.I.

MANATEE COUNTY PUBLIC WORKS DEPARTMENT		MANHOLE COVER & CONCRETE COLLAR FOR UNPAVED ROADWAYS	US-13
REV. BY	DATE		
	SEPT 12, 2023		
	DATE OF APPROVAL		

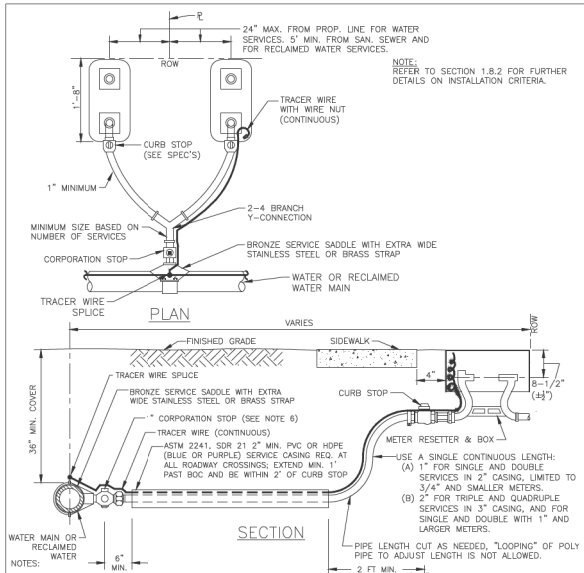

- NOTES:
1. ALL SERVICE TAPS TO BE LOCATED IN THE FIELD. TAPS SHALL BE NO CLOSER THAN 2'-0" STAGGERED INTERVALS OR WITHIN 2'-0" FROM BELL OR SPIGOT ENDS.
  2. METER BOXES & RESETTERS ARE TO BE INSTALLED BY THE INFRASTRUCTURE CONTRACTOR AND SHALL NOT BE SET IN DRAINAGE SWALES, SIDEWALKS OR DRIVEWAYS. WITH PRIOR APPROVAL BY COUNTY, METER BOXES WITH LOCKABLE LIDS MAY BE LOCATED IN SIDEWALKS.
  3. "W" OR "R" SHALL BE IMPRESSED INTO THE NEWLY-POURED CONCRETE CURB (OR ROUTED INTO EXISTING CONCRETE CURB USING AN APPROVED TEMPLATE) AND INSTALL AN ALUMINUM BLUE DISC WITH "W" OR ALUMINUM PURPLE DISC WITH "R" AND THE FOOTAGE FROM THE DISC TO THE METER USING A 1/8" x 1" GALVANIZED STEEL SCREW IN THE EDGE OF PAVEMENT. LETTERS SHALL COMPLY WITH TEMPLATE DETAIL UG-21.
  4. COLOR CODED TRACER WIRE SHALL BE INSTALLED WITH WATER AND RECLAIMED MAIN AND ALL SERVICES. SERVICE WIRE SHALL BE CONNECTED TO THE TRACER WIRE ALONG THE MAIN, ON DOUBLE SERVICES, WHEN SECOND METER IS OVER 8 FT APART, TWO TRACER WIRES SHALL BE INSTALLED, ONE FOR EACH METER.
  5. WATER AND RECLAIMED WATER SERVICE LINES TO BE 5" MINIMUM FROM SEWER SERVICE PIPES.
  6. FOR 2" SERVICES, REPLACE CORPORATION STOP WITH A 2" RESILIENT WEDGE FIP GATE VALVE W/BOX, LID & TAG.
  7. WHEN THE DISTANCE BETWEEN THE EDGE OF THE SIDEWALK AND THE ROW IS ONE FOOT (CUL-DE-SAC W/MEDIAN) A 10-FOOT-WIDE PUBLIC UTILITY EASEMENT SHALL BE LOCATED IN THE FRONT OF THE LOTS, ADJACENT TO THE ROW.
  8. TEMPORARY RESIDENTIAL USE CAN BE PROVIDED BY CONTACTING THE UTILITY CUSTOMER SERVICE. SEE DETAIL UW-21.
  9. SERVICE TUBING SHALL NOT BE CRIMPED OR KINKED TO RE-ADJUST CURB STOP LOCATION.

MANATEE COUNTY PUBLIC WORKS DEPARTMENT		TYPICAL SERVICE CONNECTION	UW-23
REV. BY	DATE		
	SEPT 12, 2023		
	DATE OF APPROVAL		

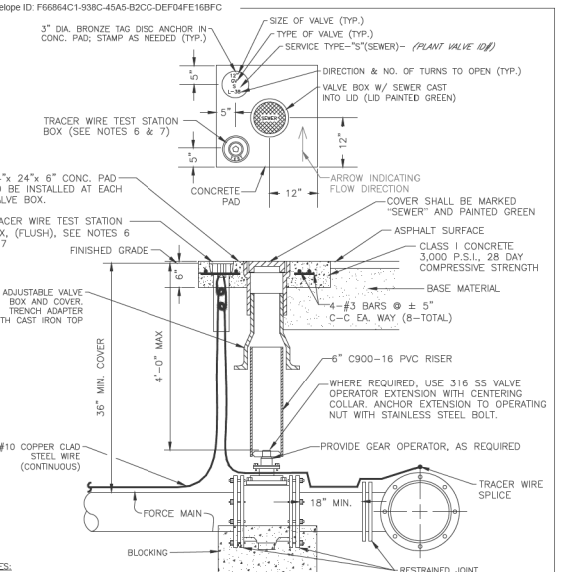

- NOTES:
1. "S" SHALL BE IMPRESSED INTO THE NEWLY-POURED CONCRETE CURB (OR ROUTED INTO EXISTING CONCRETE CURB USING AN APPROVED TEMPLATE) AND INSTALL AN ALUMINUM GREEN DISC WITH "S" AND THE FOOTAGE FROM THE DISC TO THE VALVE USING A 1/8" x 1" GALVANIZED STEEL SCREW IN THE EDGE OF PAVEMENT. LETTERS SHALL COMPLY WITH TEMPLATE DETAIL UG-21.
  2. ALL EXISTING AND PROPOSED VALVE BOXES SHALL BE ADJUSTED TO FINISHED GRADES AS DETERMINED IN THE FIELD. VALVES SHALL NOT BE PLACED IN HANDICAPPED RAMPS, CURBS OR GUTTERS.
  3. PRECAST CONCRETE PADS AND THRUST BLOCKS SHALL NOT BE USED.
  4. ALL EXPOSED EDGES OF CONCRETE SHALL BE CHAMFERED 1/2".
  5. USE NON-TRAFFIC RATED BOXES, WHERE VALVE WILL BE IN STREET OR PARKING UNDER VEHICLE TRAFFIC, USE TRAFFIC RATED BOXES, WHERE POSSIBLE, LOCATE TRACER WIRE TESTING STATION OUTSIDE OF TRAVEL LANE OR IN MEDIAN, CENTERED IN SEPARATE CONCRETE PAD SIMILAR TO STANDARD VALVE BOX PAD.
  7. TRACER WIRE BOX SHALL BE LOCATED OUTSIDE THE ROADWAY ON THROUGHFARES (COLLECTORS & ARTERIAL) AND STATE ROADWAYS.
  8. SHOULD THE TRACER WIRE STATION BOX CONCRETE PAD OVERLAP A SIDEWALK, THE TRACER WIRE TEST STATION BOX SHALL NOT BE LOCATED WITHIN THE SIDEWALK.
  9. THE BRASS TAG SHALL HAVE A "PLANT VALVE ID#" WHEN VALVES ARE INSTALLED WITHIN THE COUNTY TREATMENT PLANT LIMITS. THE PLANT VALVE ID# SHALL BE SHOWN ON THE CONSTRUCTION PLANS AND RECORD DRAWINGS.
  10. REFER TO SECTION 1.11 IN THE PUBLIC WORKS UTILITY STANDARDS MANUAL FOR FURTHER DETAILS.

MANATEE COUNTY PUBLIC WORKS DEPARTMENT		VALVE, BOX, COVER AND TAG	US-14
REV. BY	DATE		
	SEPT 12, 2023		
	DATE OF APPROVAL		

No.	REVISIONS	DATE	BY

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PHONE: 941-379-7600  
WWW.KIMLEY-HORN.COM

KHA PROJECT  
148400070  
DATE  
10/02/2025  
SCALE AS SHOWN  
DESIGNED BY  
DRAWN BY  
CHECKED BY

MANATEE COUNTY

9TH AVENUE NW

LICENSED PROFESSIONAL  
JORDAN E. LEEP, P.E.  
FL LICENSE NUMBER  
76102

UTILITY DETAIL SHEET (3)

143

SHEET NUMBER





SWPP / EROSION CONTROL PLAN  
PROJECT NAME: 9TH AVENUE NW

(7) *SITE MAP:*

THE CONSTRUCTION PLANS ARE BEING USED AS THE SITE MAPS. THE LOCATION OF THE REQUIRED INFORMATION IS DESCRIBED BELOW. THE SHEET NUMBERS FOR THE PLAN SHEETS REFERENCED ARE IDENTIFIED ON THE KEY SHEET OF THESE CONSTRUCTION PLANS.

- (a) APPROXIMATE SLOPES: THE SLOPES OF THE SITE CAN BE SEEN IN CROSS SECTION SHEETS, PLAN SHEETS AND PROFILE SHEETS.
- (b) AREAS OF SOIL DISTURBANCE: THE AREAS TO BE DISTURBED ARE INDICATED ON THE PLAN SHEETS THE CROSS SECTION SHEETS, AND THE DETAIL SHEETS. ANY AREA OF NEW CONSTRUCTION WILL BE DISTURBED.
- (c) AREAS NOT TO BE DISTURBED: THE AREAS NOT TO BE DISTURBED ARE THE EXISTING BANKS BEYOND THE LIMITS OF CONSTRUCTION.
- (d) DISCHARGE POINTS TO SURFACE WATERS: THE DISCHARGE POINTS ARE SHOWN ON THE PLAN SHEETS.

BASIN	WBID	PARAMETER(S) OF CONCERN FOR 303(d) LISTING
PALMA SOLA BAY	1883	N/A

	DESCRIPTION	MIlePOST	LATITUDE	LONGITUDE
(a)	EXIST. MES	N/A	N27°30'26.3"	W82°39'46.0"
(b)	PROP. DITCH	N/A	N27°30'17.2"	W82°39'17.5"
(c)	PROP. DBI	N/A	N27°30'16.0"	W82°38'57.0"

(11) DESCRIPTION OF STORMWATER MANAGEMENT: (EXISTING/PROPOSED):

(A) ROBINSON PRESERVE TO STA. 22+37.00:  
EXISTING - DRAINAGE SWALES RUN ON EACH SIDE OF THE ROADWAY, CONVEYING RUNOFF TO EXISTING OUTFALLS AT THE ROBINSON PRESERVE AND TO AN OUTFALL DITCH SOUTH OF HAWTHORN PARK.  
PROPOSED - A PROPOSED DRAINAGE SYSTEM WILL COLLECT ROADWAY AND OFFSITE RUNOFF TO APPROPRIATE OUTFALLS WITHOUT CREATING ADVERSE IMPACTS.

(B) STA. 22+37.00 TO 92ND STREET NW:  
EXISTING - AN EXISTING INLET AND PIPE SYSTEM CAPTURES ROADWAY RUNOFF AND CONVEYS IT TO THE EXISTING OUTFALL DITCH LOCATED SOUTH OF HAWTHORN PARK.  
PROPOSED - A 10-FOOT WIDE MULTI-USE TRAIL IS PROPOSED TO THE NORTH SIDE OF THE ROADWAY AND EXISTING DITCH SIDE SLOPES WILL BE REGRADED AS NECESSARY.

(C) 92ND STREET NW TO 87TH STREET NW:  
EXISTING - AN EXISTING INLET AND PIPE SYSTEM CAPTURES ROADWAY RUNOFF AND CONVEYS IT TO THE EXISTING OUTFALL DITCH LOCATED SOUTH OF HAWTHORN PARK.  
PROPOSED - A 10-FOOT WIDE MULTI-USE TRAIL IS PROPOSED TO THE NORTH SIDE OF THE ROADWAY AND A NEW INLET AND PIPE SYSTEM IS PROPOSED TO CAPTURE ROADWAY RUNOFF AND IS ANTICIPATED TO TIE INTO THE EXISTING STORM SEWER TRUNK LINE.

(D) 87TH STREET NW TO 83RD STREET NW:  
EXISTING - AN EXISTING INLET AND PIPE SYSTEM CAPTURES ROADWAY RUNOFF AND CONVEYS IT TO THE EXISTING OUTFALL DITCH LOCATED SOUTH OF HAWTHORN PARK.  
PROPOSED - DUE TO A SHIFT IN THE CURB LINE, A NEW INLET AND PIPE SYSTEM IS PROPOSED TO CAPTURE ROADWAY RUNOFF AND IS ANTICIPATED TO TIE INTO THE EXISTING STORM SEWER TRUNK LINE.

(E) 83RD STREET TO 78TH STREET NW:  
EXISTING - AN EXISTING INLET AND PIPE SYSTEM CAPTURES ROADWAY RUNOFF AND CONVEYS IT TO THE EXISTING CROSS DRAIN LOCATED AT 78TH STREET.  
PROPOSED - CONNECTIONS TO THE TRUNK LINE AT THE INTERSECTIONS ARE BEING ADJUSTED BUT THE EXISTING SYSTEM WILL REMAIN INTACT.

THERE IS NOT A PREDOMINANT SOIL WITHIN THE 9TH AVENUE NW PROJECT LIMITS.

SOIL TYPE	HYDROLOGIC GROUP	SHWE DEPTH
CANOVA, ANCIOTE, AND OKEELANTA SOILS	A/D	0"-6"
DELRAY-EAUGALLIE COMPLEX	A/D	0"-18"
DUETTE FINE SAND	A	48"-72"
EAUGALLIE-EAUGALLIE WET, FINE SAND	A/D	3"-18"
ESTERO MUCK, TIDAL	A/D	0"
FLORIDANA-IMMOKALEE-OKEELANTA ASSOCIATION	C/D	0"
ORSINO FINE SAND	A	42"-60"
PARKWOOD VARIANT-CHOBEE, LIMESTONE	A/D	0"-18"
POMELLO FINE SAND	A	18"-42"

REFERENCE: USDA SOIL SURVEY OF MANATEE COUNTY FLORIDA

[illegible]

## II. CONTROLS: SEDIMENT AND EROSION CONTROLS

(1) WATER QUALITY MONITORING:

- (a) WATER QUALITY MONITORING SHALL BE CONDUCTED IN ACCORDANCE WITH THE SPECIAL CONDITIONS OF ANY ENVIRONMENTAL PERMIT OR BY THE CONTRACTOR UPON THE OBSERVATION THAT WATER QUALITY STANDARDS MAY BE VIOLATED BY THE CONTRACTOR'S ACTIVITIES. MONITORING LOCATIONS MAY BE SPECIFIED IN THE ENVIRONMENTAL PERMIT OR MAY BE DESIGNATED BY THE CONTRACTOR AND APPROVED BY THE ENGINEER.
- (b) THE ENGINEER WILL BE RESPONSIBLE FOR MONITORING ANY ACTIVITIES FOR VIOLATION OF WATER QUALITY STANDARDS AS THEY RELATE TO TURBIDITY (NO GREATER THAN 29 NTU'S ABOVE BACKGROUND OR GREATER THAN 0 NTU'S ABOVE BACKGROUND FOR DIRECT DISCHARGES TO OSW'S).
- (c) IF WATER QUALITY STANDARDS ARE VIOLATED, CONSTRUCTION SHALL BE STOPPED IMMEDIATELY, THE ENVIRONMENTAL PERMIT CONDITIONS FOLLOWED AND EROSION AND SEDIMENT CONTROL DEVICES REEVALUATED AND APPROVED BY THE ENGINEER PRIOR TO THE CONTINUATION OF ACTIVITY. MONITORING ACTIVITIES AND TURBIDITY READINGS SHALL BE RECORDED ON THE CONSTRUCTION INSPECTION REPORT AND CONTINUED UNTIL TURBIDITY READINGS FALL BELOW THE SPECIFIED ACCEPTABLE LEVEL.
- (d) WATER QUALITY MONITORING MAY BE CONDUCTED DURING ANY PHASE OF CONSTRUCTION AS DIRECTED BY THE ENGINEER.

(2) *STABILIZATION PRACTICES:*

- (a) STABILIZATION MEASURES SHALL INCLUDE, BUT NOT BE LIMITED TO MAINTAINING, ESTABLISHING AND USING VEGETATION, APPLYING MULCHES, SODDING, SEEDING, BMP'S AND THE USE OF ROLLED EROSION CONTROLLED PRODUCTS. WHEN CONSTRUCTION ACTIVITIES HAVE TEMPORARILY OR PERMANENTLY CEASED, SIDE SLOPES SHALL BE STABILIZED WITH PERFORMANCE SODDING OR SEEDING OR ANY OTHER APPROVED METHOD OF STABILIZATION INCLUDED IN THE STATE OF FLORIDA EROSION AND SEDIMENT CONTROL DESIGNER AND REVIEW MANUAL (E&SC MANUAL).
- (b) STABILIZATION SHALL TAKE PLACE AS SOON AS PRACTICAL IN PORTIONS OF THE PROJECT WHERE CONSTRUCTION ACTIVITIES HAVE CEASED, BUT NO LATER THAN 7 DAYS AFTER ANY CONSTRUCTION ACTIVITY CEASES EITHER TEMPORARILY OR PERMANENTLY.
- (c) ALL EROSION CONTROL DEVICES SHALL BE INSTALLED ACCORDING TO THE CONTRACT DOCUMENTS, AND THE CONTRACTOR'S APPROVED EROSION CONTROL PLAN.
- (d) ANY TEMPORARY MATERIAL USED FOR POLLUTION OR EROSION AND SEDIMENT CONTROL DURING CONSTRUCTION SHALL BE REMOVED AT THE COMPLETION OF THE PROJECT AND FINAL STABILIZATION OF THE PROJECT HAS BEEN ACHIEVED.
- (e) SEDIMENT BARRIERS SHOULD BE USED ALONG THE LENGTH OF THE PROJECT WHERE THE GROUND SLOPES AWAY FROM THE RIGHT OF WAY OR WHERE THERE IS POTENTIAL FOR SEDIMENT TO BE DIRECTED OFF-SITE. PARTICULAR CARE SHOULD BE USED WHEN THERE ARE WETLANDS OR WATERS OF THE U.S. ARE INVOLVED. SEDIMENT BARRIERS SHOULD BE USED AROUND THE PERIMETER OF STOCKPILE AREAS.
- (f) SPACING OF SEDIMENT BARRIERS USED AS DITCH OR SWALE CHECKS/DAMS SHOULD BE BASED UPON THE HEIGHT OF THE BARRIER AND THE SLOPE OF THE DITCH OR SWALE.
- (g) THE CONTRACTOR SHALL BE RESPONSIBLE FOR MODIFYING SOIL TRACKING PREVENTION SYSTEMS OR PROCEDURES AS NEEDED.

### (3) STRUCTURAL PRACTICES FOR EROSION AND SEDIMENT CONTROL

- (a) *SEDIMENT BARRIERS (TEMPORARY SITE BMP'S)*

PURPOSE: SEDIMENT BARRIERS EITHER OBSTRUCT FLOW OR PREVENT THE PASSAGE OF A WATER WHILE CONSTRUCTION ACTIVITIES OCCUR. SMALLER SEDIMENT BARRIERS MAY FUNCTION AS A SMALL SEDIMENT CONTAINMENT SYSTEM OR AS A METHOD TO REDUCE FLOW VELOCITY.

- (1) THESE CONSTRUCTION BMP'S CAN INCLUDE SYNTHETIC BALES, STAKED SILT FENCE, TURBIDITY BARRIER, STORM SEWER INLET BARRIERS, ROCK BARRIERS, GEOSYNTHETIC BARRIERS, ETC.
- (2) APPROPRIATE LOCATIONS INCLUDE SITE PERIMETER, BELOW DISTURBED AREAS SUBJECT TO SHEET AND RILL EROSION, BELOW THE TOE OF EXPOSED AND ERODIBLE SLOPES, ALONG THE TOE OF STREAM AND CHANNEL BANKS, AROUND DRAINS AND INLETS LOCATED IN LOWPOINTS OR THE DOWNSTREAM EDGE OF AREAS UNDERGOING VERTICAL OR BOX CULVERT CONSTRUCTION ACTIVITIES.
- (3) INAPPROPRIATE LOCATIONS OFR THESE SAME MEASURES INCLUDE PARALLEL TO A HILLSIDE CONTOUR, IN CHANNELS WITH CONCENTRATED FLOW (UNLESS PROPERLY REINFORCED), UPSTREAM OR DOWNSTREAM OF CULVERTS WITH CONCENTRATED FLOW, IN FRONT OF OR AROUND INLETS ON A GRADE WITH CONCENTRATED FLOW OR IN FLOWING STREAMS.

- (b) *FLOATING TURBIDITY BARRIER*

PURPOSE: USED IN PERMANENT BODIES OF WATER TO RETAIN SEDIMENT AND FLOATING DEBRIS FROM A CONSTRUCTION AREA SO THAT REMOVAL OR CONTAINMENT OF THE MATERIAL IS POSSIBLE. THEY ARE ALSO USED TO CONTROL MIGRATION OF SUSPENDED SEDIMENTS.

- (1) TYPE I, LIGHT DUTY, IS USED WHERE THERE IS LITTLE OR NO CURRENT, NO WIND OR WAVE ACTION.

SWPP / EROSION CONTROL PLAN  
PROJECT NAME: 9TH AVENUE NW

(c) *INLET PROTECTION SYSTEM*

PURPOSE: ANY OF A NUMBER OF SEDIMENT BARRIERS THAT EITHER PREVENT SEDIMENT FROM ENTERING AN INLET OR TRAP THE SEDIMENTS ONCE THEY ENTER THE INLET.

- (1) TYPICAL APPLICATIONS INCLUDE ROCK BARRIERS, FRAME AND FILTER BARRIERS, CURB INLET "SUMP" BARRIER, CURB INLET DIVERSION BERM, CURB AND GUTTER SEDIMENT CONTAINMENT SYSTEM OR CURB INLET INSET.
- (2) SHOULD BE INSTALLED ONLY WHEN CONSTRUCTION ACTIVITIES ARE ONGOING AND ONLY WHERE SUMP CONDITIONS EXIST.
- (3) SHOULD NOT BE USED WHEN CONSTRUCTION IS COMPLETE AND SHOULD NOT BE USED IN AREAS WHERE FLOODING COULD ENROACH INTO THE TRAVEL LANE

III. OTHER CONTROLS:

- (1) WASTE DISPOSAL
  - (a) THE CONTRACTOR WILL PROVIDE LITTER CONTROL AND COLLECTION WITHIN THE PROJECT BOUNDARIES DURING CONSTRUCTION ACTIVITIES.
  - (b) ALL FERTILIZER AND CHEMICAL CONTAINERS SHALL BE DISPOSED OF BY THE CONTRACTOR ACCORDING TO EPA'S STANDARD PRACTICES AS DETAILED BY THE MANUFACTURER.
  - (c) NO SOLID MATERIALS, INCLUDING BUILDING AND CONSTRUCTION MATERIALS, SHALL BE DISCHARGED TO WETLANDS OR BURIED ON SITE.
  - (d) ALL SANITARY WASTE WILL BE COLLECTED FROM PORTABLE UNITS BY A LICENSED SANITARY WASTE MANAGEMENT CONTRACTOR AS REQUIRED BY STATE REGULATIONS.
- (2) OFF-SITE VEHICLE TRACKING - WILL BE CONTROLLED BY THE FOLLOWING METHODS:
  - (a) LOADED HAUL TRUCKS ARE TO BE COVERED BY A TARPULIN AT ALL TIMES.
  - (b) EXCESS DIRT ON ROAD WILL BE REMOVED DAILY.

#### IV. MAINTENANCE:

THE CONTRACTOR SHALL BE RESPONSIBLE FOR MAINTENANCE AND REPAIRS OF ALL EROSION AND SEDIMENT CONTROL DEVICES AND REMOVAL OF EROSION AND SEDIMENT CONTROL DEVICES WHEN NOTICE OF TERMINATION IS MAILED. THE CONTRACTOR SHALL BE RESPONSIBLE FOR THE REMOVAL AND PROPER DISPOSAL OF SEDIMENT BUILDUP THROUGH THE LIFE OF THE INSTALLED EROSION AND SEDIMENT CONTROL DEVICES.

- (1) ALL CONTROL MEASURES WILL BE MAINTAINED DAILY BY THE CONTRACTOR AND ALL MEASURES WILL BE MAINTAINED IN GOOD WORKING ORDER. IF A REPAIR IS NECESSARY, IT WILL BE INITIATED WITHIN 24 HOURS OF NOTICE.
- (2) SODDING WILL BE INSPECTED FOR BARE SPOTS, WASHOUTS, AND HEALTHY GROWTH.
- (3) SYNTHETIC BALES SHALL BE MAINTAINED TO ENSURE THEIR USEFULNESS AND NOT BLOCK OR IMPEDE STORMWATER FLOW OR DRAINAGE.
- (4) STABILIZED CONSTRUCTION ENTRANCES SHALL BE MAINTAINED TO PREVENT CLOGGING OF ROCK BEDDING WHICH MAY IMPEDE THE USEFULNESS OF THE STRUCTURE.


V. INSPECTION:

- (1) THE CONTRACTOR SHALL INSTALL AND MAINTAIN RAIN GAUGES ON THE PROJECT SITE AND RECORD WEEKLY RAINFALL IN ACCORDANCE WITH THE NPDES PERMIT.
- (2) ALL EROSION AND SEDIMENT CONTROL MEASURES WILL BE INSPECTED DAILY BY CONTRACTOR'S PERSONNEL WHO ARE F.D.E.P. CERTIFIED STORMWATER MANAGEMENT INSPECTORS.
- (3) THE CONTRACTOR SHALL COMPLETE ALL SWPPP INSPECTION REPORT FORMS REQUIRED FOR THE NPDES PERMIT.

#### IV. TRACKING AND REPORTING:


- (1) THE CONTRACTOR SHALL SUBMIT A WEEKLY REPORT TO THE DEPARTMENT DOCUMENTING THE DAILY INSPECTIONS AND MAINTENANCE OR REPAIRS TO THE EROSION AND SEDIMENT CONTROL DEVICES.
- (2) PREPARATION OF ALL THE CONTRACTOR'S REPORTS OF INSPECTION, MAINTENANCE AND REPAIRS REQUIRED FOR THE CONTROL AND ABATEMENT OF EROSION AND WATER POLLUTION, SHALL BE INCLUDED IN THE INDIVIDUAL COSTS OF THE EROSION AND SEDIMENT CONTROL DEVICES.


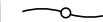
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<div><div>No.</div><div>REVISIONS</div><div>DATE</div><div>BY</div></div>				<div>10/1/2025 5:37:49 PM Default</div>		<div>FL DATE:</div>		<div>K:\SAR_Roadway\148400070_9thAve\148400070\emo\PLANEM01.dgn</div>	

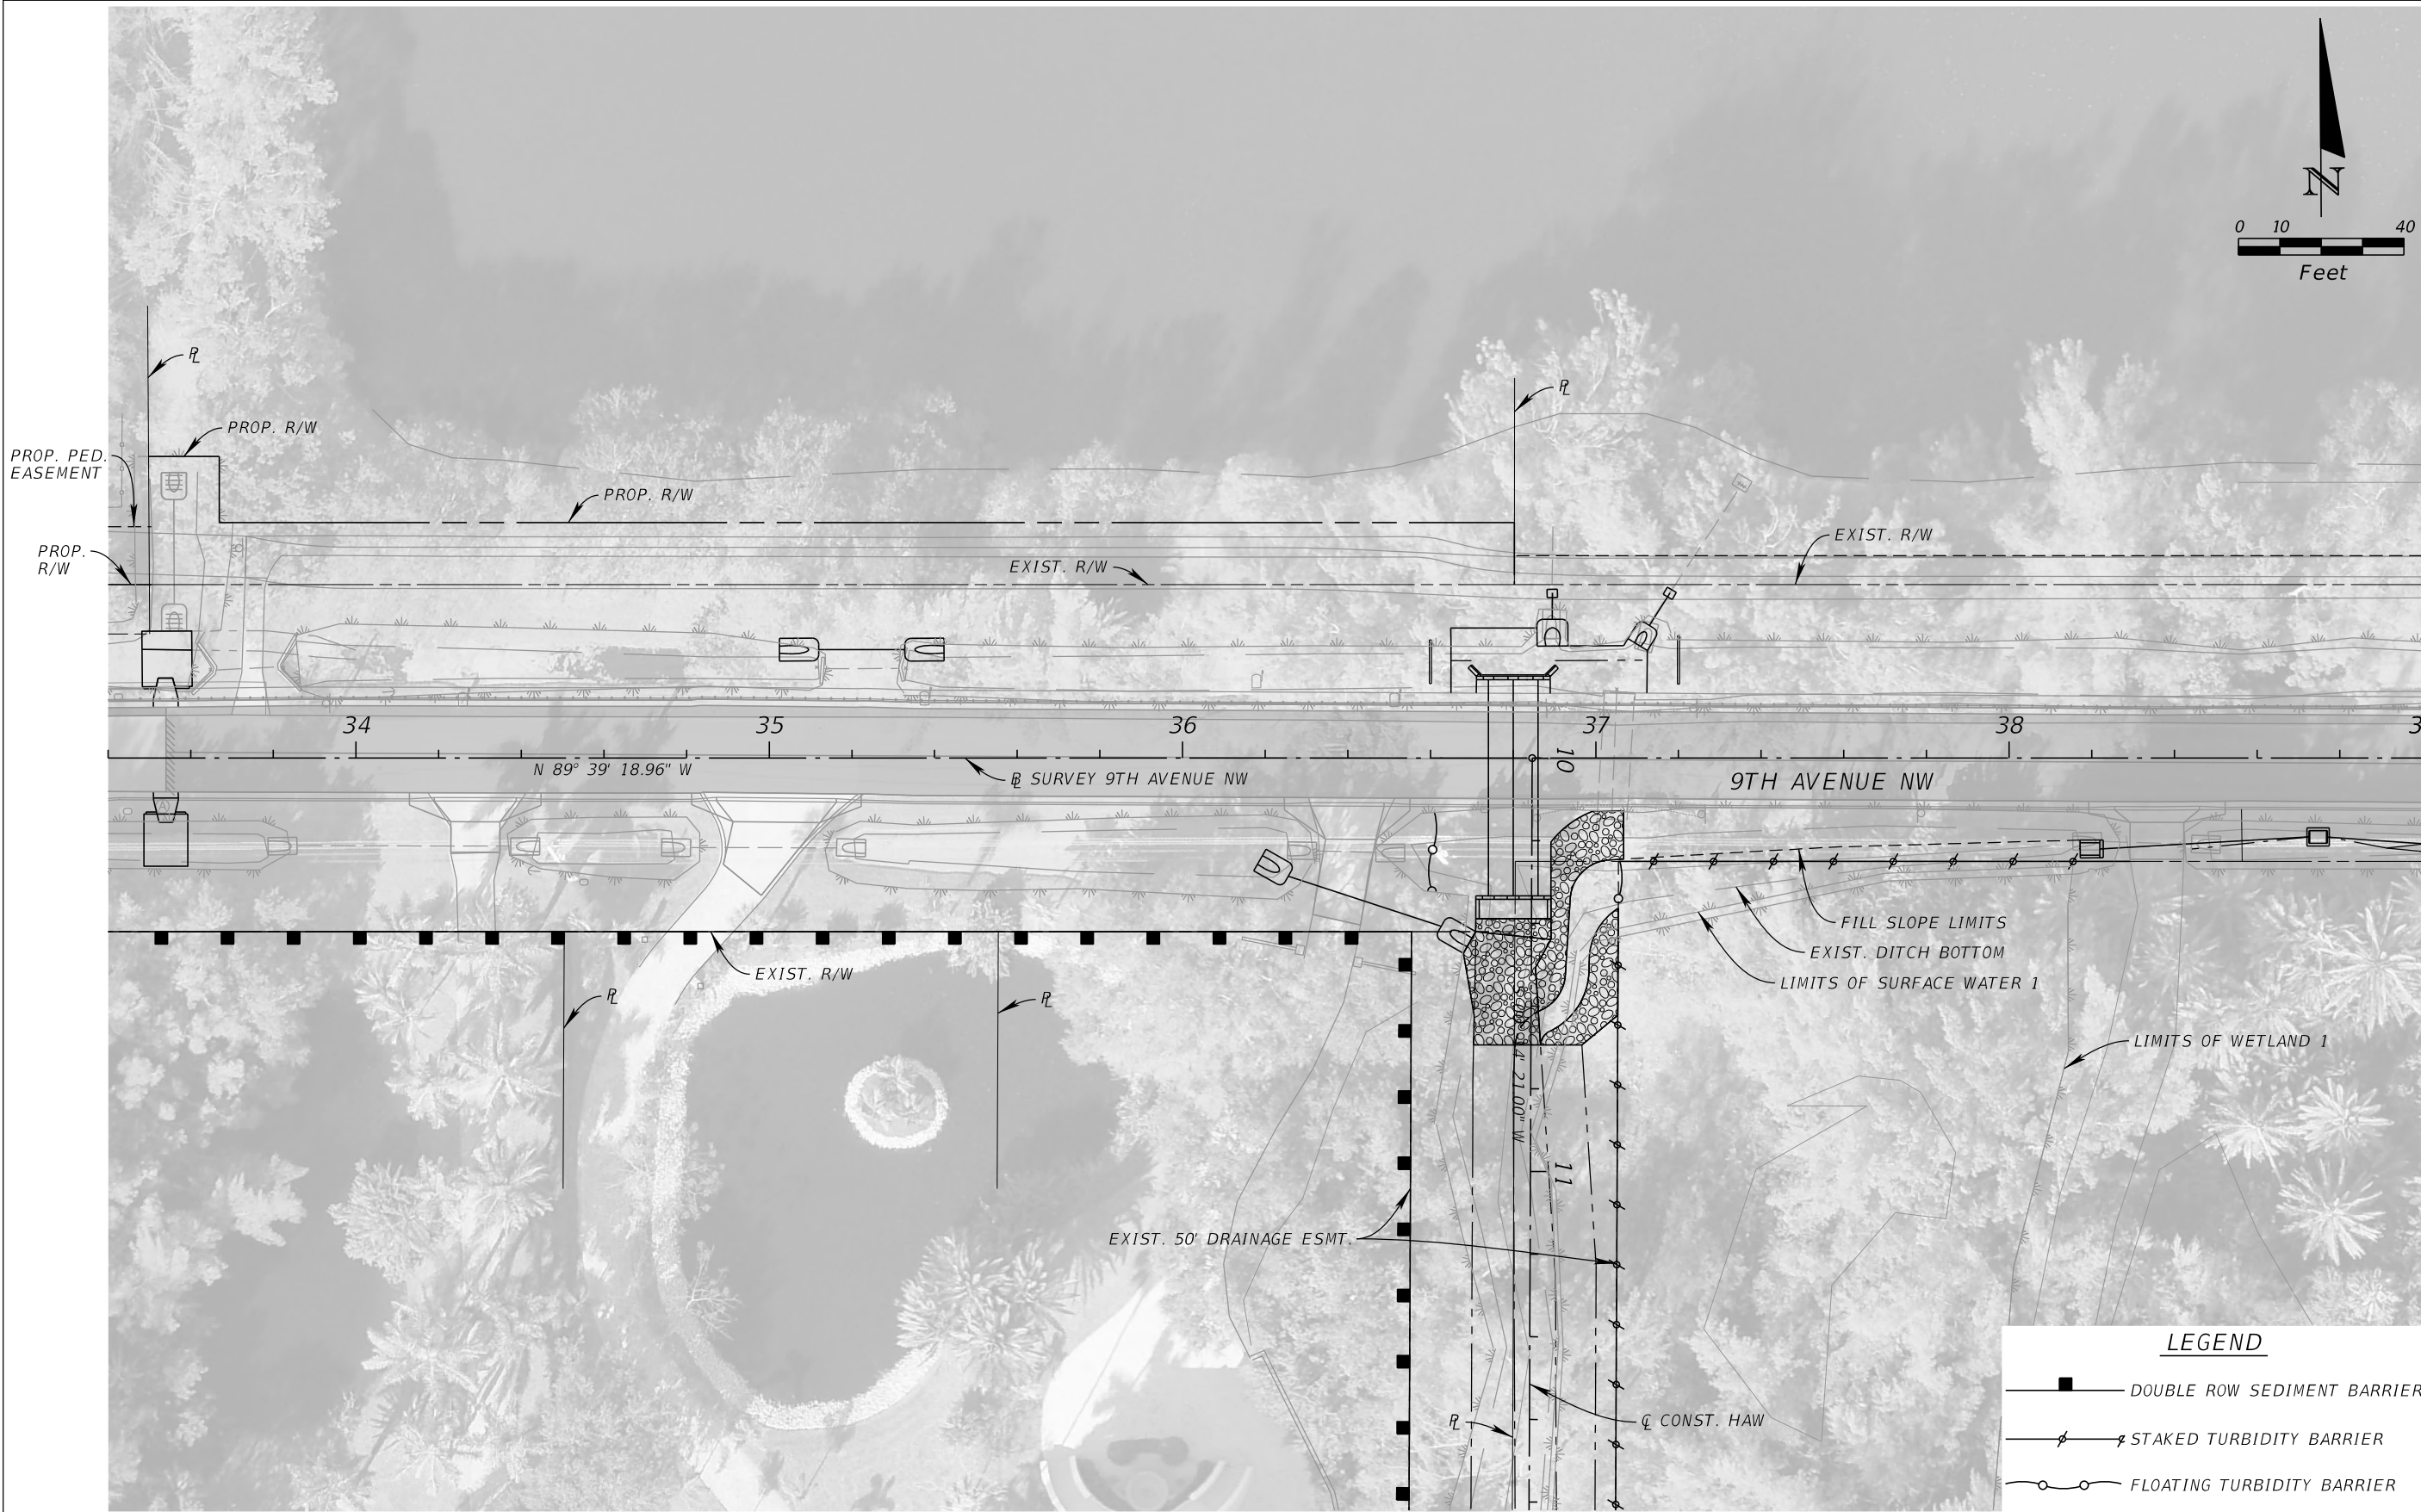





LEGEND	
	DOUBLE ROW SEDIMENT BARRIER
	FLOATING TURBIDITY BARRIER
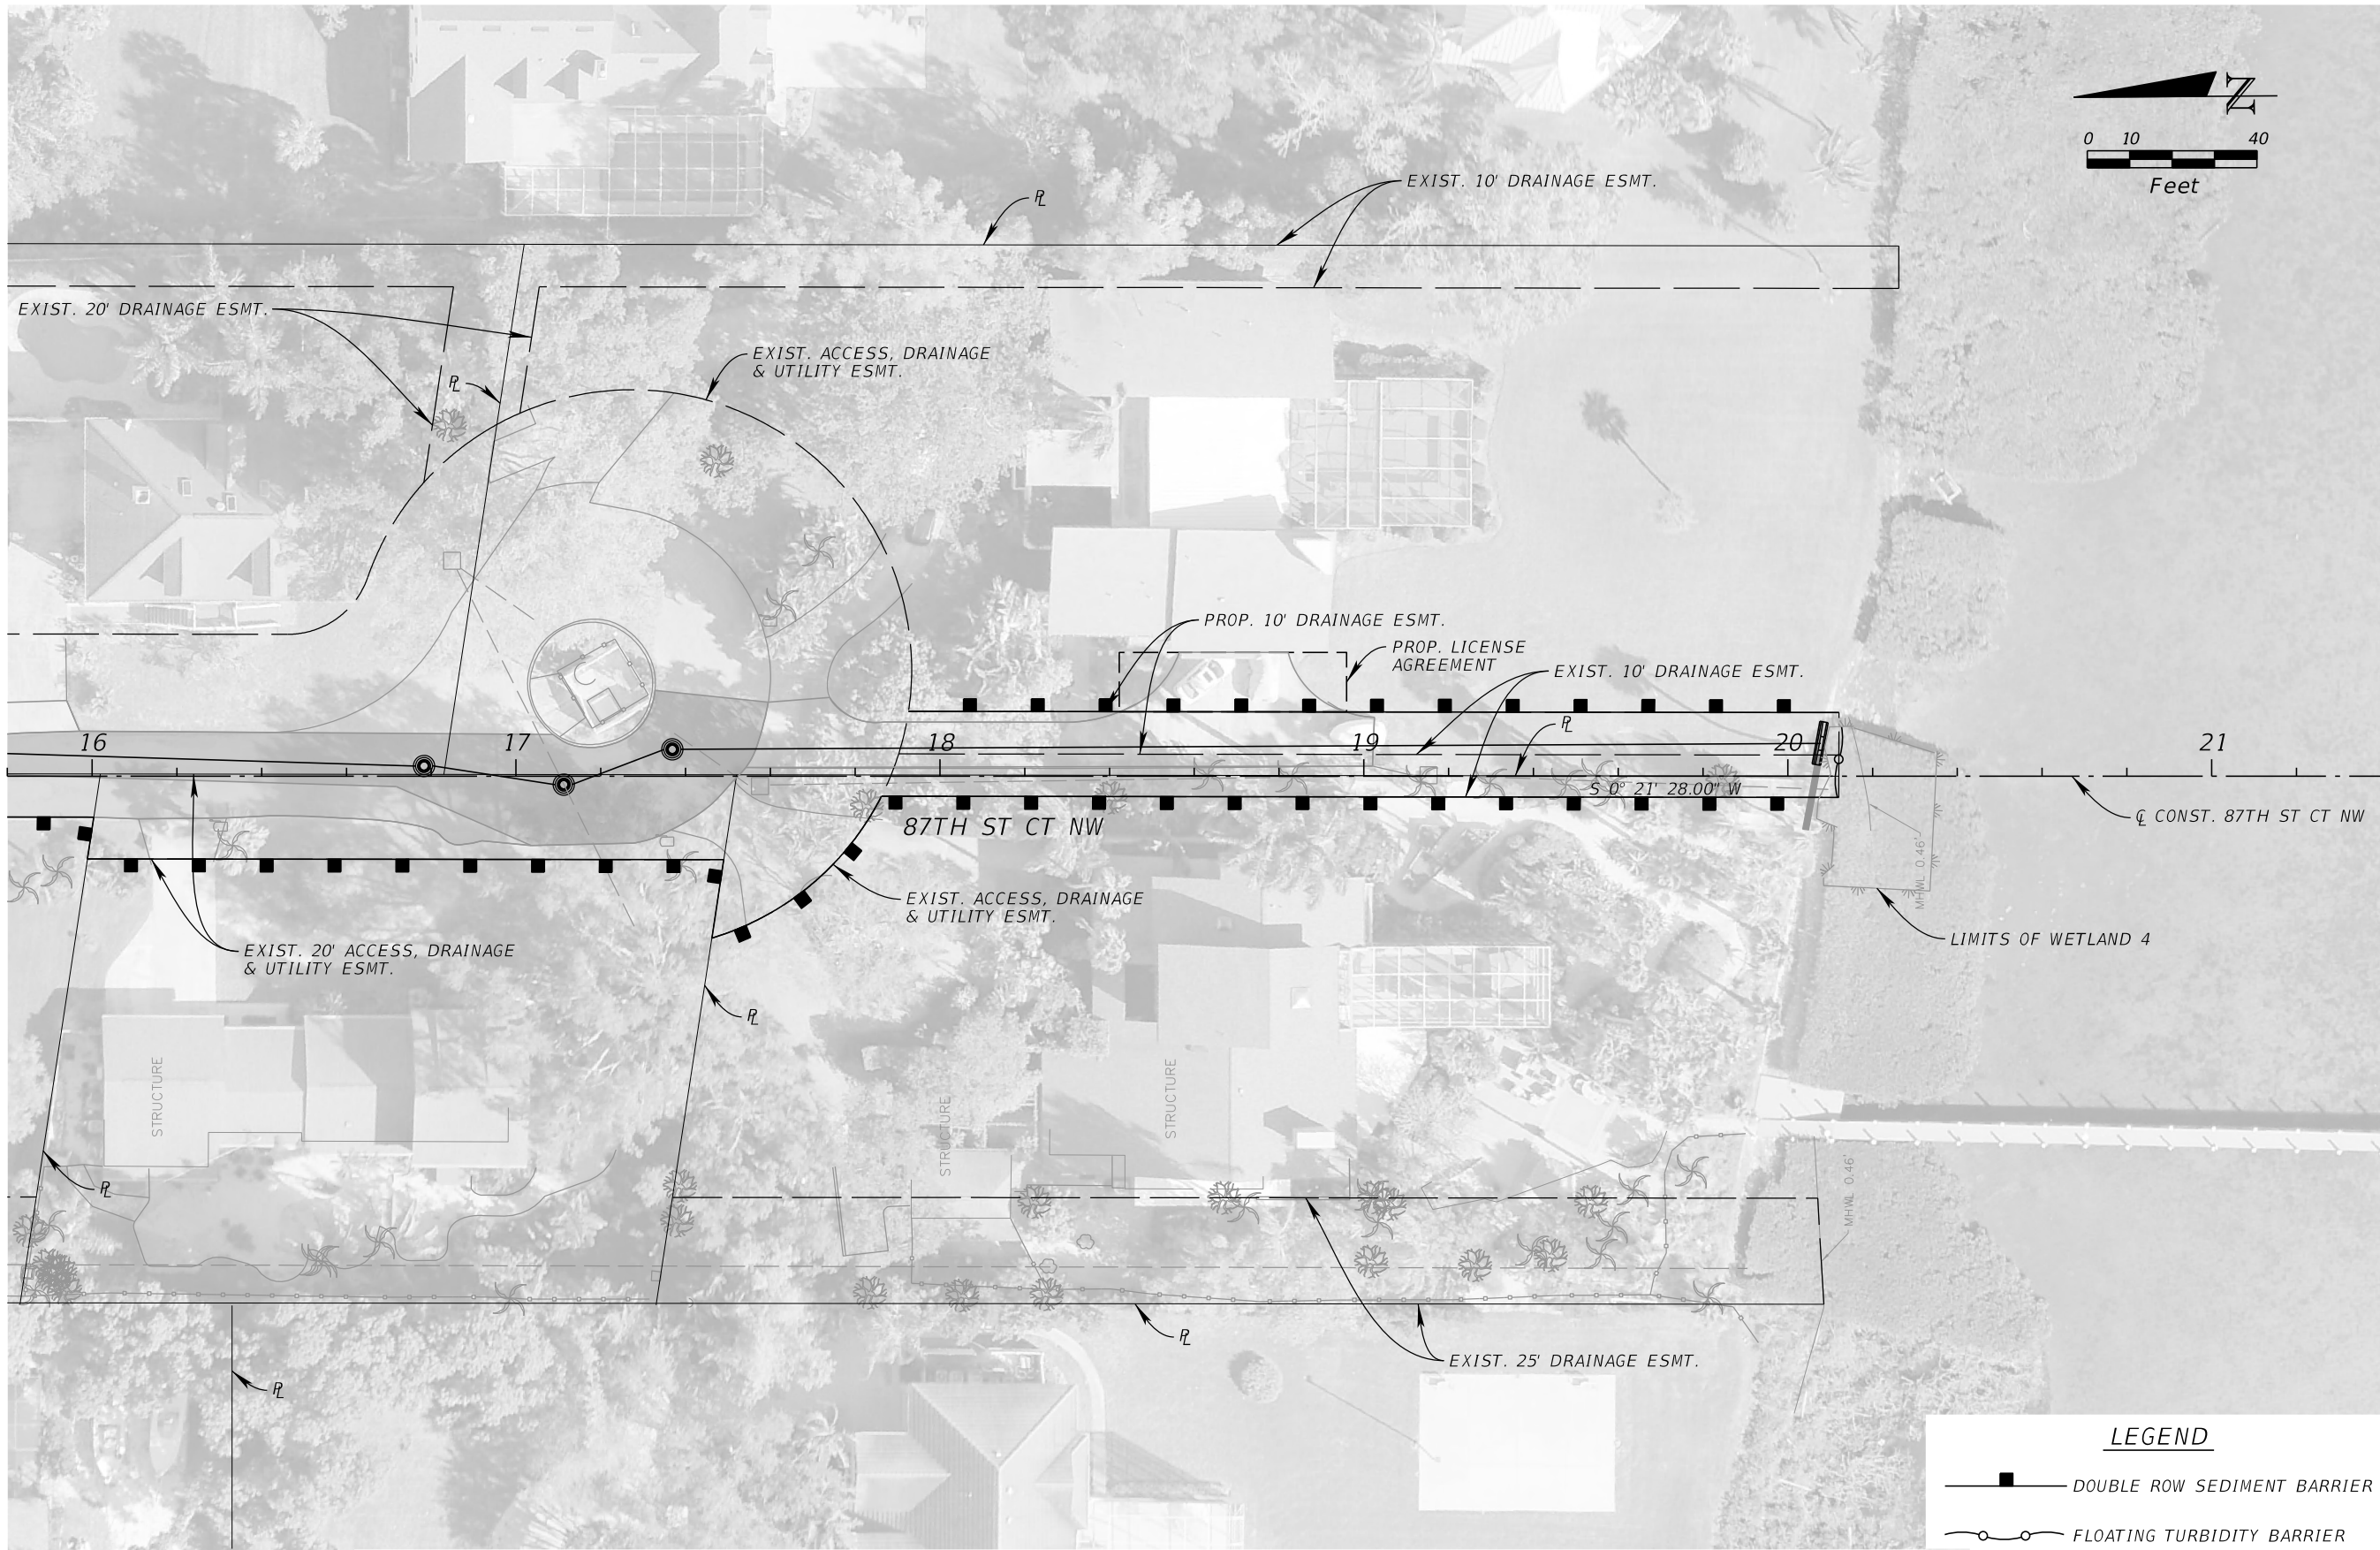
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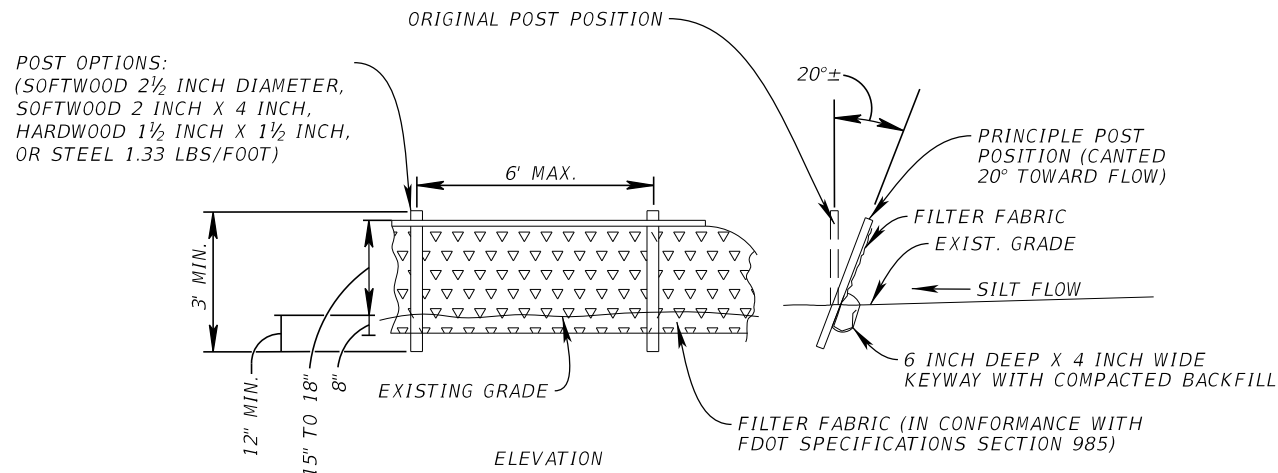


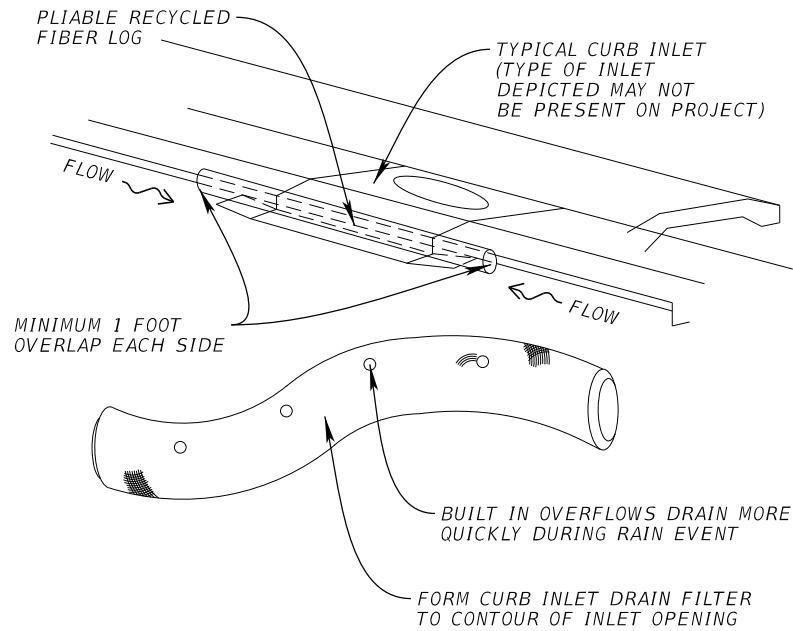


INLET PROTECTION

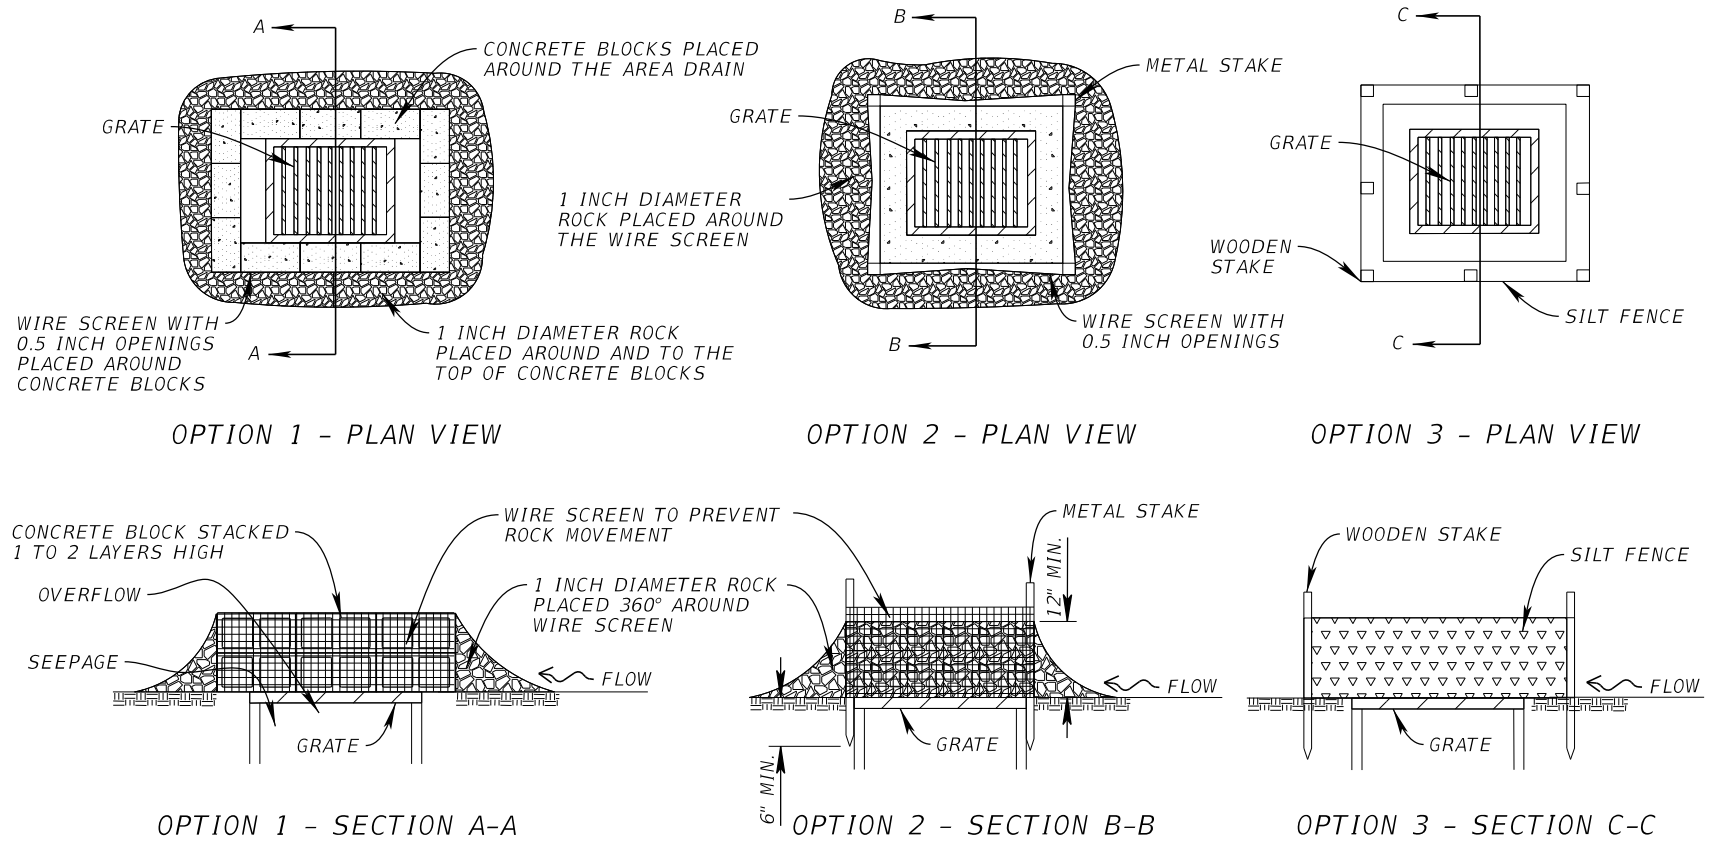

DITCH BOTTOM INLET PROTECTION



TYPE III SILT FENCE DETAIL

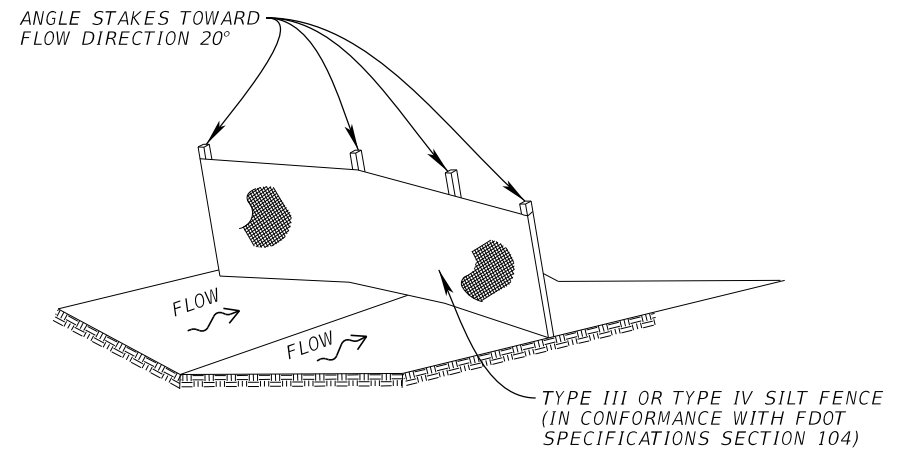

SILT FENCE CHECK DAM

No.	REVISIONS	DATE	BY

**Kimley»Horn**

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KHA PROJECT
148400070
DATE
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SCALE
AS SHOWN
DESIGNED BY
DRAWN BY
CHECKED BY

MANATEE COUNTY



9TH AVENUE NW

LICENSED PROFESSIONAL























JORDAN E. LEEP, P.E.  
FL LICENSE NUMBER  
76102

FL DATE:























**EROSION CONTROL  
DETAIL SHEET**

SHEET NUMBER



149

Date:	12/14 -12/16/2021	Test Hole Data Report										Crew Members:		BH,PK,DS,HG	
ECHO Project #:	21-137	4803 George Road, Ste. 350 Tampa, Florida 33634 400 SR 434, Ste. 1024 Oviedo, Florida 32765				 UTILITY ENGINEERING & SURVEY		ECHO UES, Inc. www.echoues.com 888.778.ECHO - GROW, INSPIRE, MAKE A DIFFERENCE -		City, State:				Bradenton, FL	
Financial Project #:	20-TA003483CD									General Location:				9th Avenue	
Truck No.:	VT-1									Coordinate Unit of Measure:				US Survey Feet	
Utility Type				Utility Material				Identified By:		Abbreviations		Offset Measured From:			
BE = Buried Electrical		RCW = Reclaimed Water		AC = Transite		GALV = Galvanized Pipe		HUB = Survey Hub		N/A = Not Applicable		EP= Edge of Pavement			
GM = Gas Main		TS = Traffic Signal		CI= Cast Iron		HDPE = High Density Polyethylene Pipe		IRC = Iron Rod & Cap "ECHO TEST HOLE"		NAD = North American		BC = Back of Curb			
BT = Buried Telephone		SL = Street Light		CP = Concrete Pipe		PE = Polyethylene Pipe		NL = Nail & Disk "ECHO TEST HOLE"		Datum		BL = Baseline of Survey			
FOC = Fiber Optic Cable		IRR = Irrigation Line		DBC = Direct Buried Cable		PVC = Polyvinyl Chloride		SLEEVE = Sleeve		NAVD = North American		COORD = Survey Coordinates			
WM = Water Main		GS = Gas Service		CMP = Corrugated Metal Pipe		STL = Steel		X = "X" in Concrete		Vertical Datum		CL = Centerline			
SAN = Sanitary Sewer		WS = Water Service		CONC = Concrete		VCP = Vitrified Clay Pipe		Surface Type		UNK = Unknown		HUB = Survey Hub			
STM = Storm Sewer		UNK = Unknown Utility		CPP = Corrugated Plastic Pipe		PCCP = Prestressed Cylinder Concrete Pipe		ASPH = Asphalt				RW = Right of Way			
CATV = Cable Television		BED = Buried Electrical Duct		DCT = Duct				CONC = Concrete				ST = Swing Ties			
FM = Force Main		BTD = Buried Telephone Duct		DIP = Ductile Iron Pipe		RCP = Reinforced Concrete Pipe		NG = Natural Ground				X = "X" in Concrete			
Test Hole	Utility Type	Utility Material	Utility Size Outside Diameter inches	Utility Manual Depth feet	Cross Sectional View	 Utility Direction	Identified By	Surface Type	Surface Thickness inches	Apparent Utility Owner	Datums:	Horizontal: NAD83/11		Ground Elevation	Utility Elevation
												Vertical: NAVD88			
											Station	Offset	BL		
1-1	RCW	PVC	6"	1.18'			IRC	NG	N/A	MANATEE COUNTY	40+71.09	27.89' LT	9THAVE	4.85'	3.67'
2-1	FM	HDPE	6"	2.42'			IRC	NG	N/A	MANATEE COUNTY	40+91.80	13.62' RT	9THAVE	4.63'	2.21'
3-1	WM	PVC	6"	8.32'			NL	ASPH	4"	MANATEE COUNTY	41+43.83	29.28' LT	9THAVE	4.92'	-3.40'
4-1	RCW	PVC	2"	1.32'			IRC	NG	N/A	MANATEE COUNTY	41+75.53	30.37' LT	9THAVE	5.07'	3.75'
5-1	GM	PE	2"	3.98'			IRC	NG	N/A	TECO	41+90.00	19.02' RT	9THAVE	5.06'	1.08'
6-1	WM	PVC	8"	3.66'			NL	ASPH	4"	MANATEE COUNTY	41+92.33	4.26' LT	9THAVE	5.61'	1.95'
8-1	WM	PVC	8"	3.90'			NL	ASPH	4"	MANATEE COUNTY	54+16.48	8.16' LT	9THAVE	14.21'	10.31'
9-1	GM	PE	2"	6.00'			IRC	NG	N/A	TECO	54+19.29	21.24' RT	9THAVE	14.11'	8.11'
10-1	GM	PE	2"	5.78'			IRC	NG	N/A	TECO	55+22.48	21.75' RT	9THAVE	14.37'	8.59'
11-1	FM	AC	8"	3.66'			NL	ASPH	6"	MANATEE COUNTY	55+19.97	10.72' RT	9THAVE	14.67'	11.01'
Notes: TH# 3-1 - POSSIBLE 6" PVC; UNABLE TO VISUALLY VERIFY SIZE AND MATERIAL DUE TO WATER AND CAVE-IN															
TH# 9-1 - POSSIBLE 2" PE; UNABLE TO VISUALLY VERIFY SIZE AND MATERIAL DUE TO WATER AND CAVE-IN															
TH# 10-1 - POSSIBLE 2" PE; UNABLE TO VISUALLY VERIFY SIZE AND MATERIAL DUE TO WATER AND CAVE-IN															
													Prepared by: CM      Date: 01/31/2022		
													Checked by: MA      Date: 02/02/2022		

THE OFFICIAL RECORD OF THIS SHEET IS THE ELECTRONIC FILE DIGITALLY SIGNED AND SEALED UNDER RULE 61G15-23.004, F.A.C.























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Financial Project #:	20-TA003483CD									General Location:		9th Avenue				
Truck No.:	VT-1									Coordinate Unit of Measure:		US Survey Feet				
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CATV = Cable Television		BED = Buried Electrical Duct		DCT = Duct				CONC = Concrete				ST = Swing Ties				
FM = Force Main		BTD = Buried Telephone Duct		DIP = Ductile Iron Pipe		RCP = Reinforced Concrete Pipe		NG = Natural Ground				X = "X" in Concrete				
Test Hole	Utility Type	Utility Material	Utility Size Outside Diameter inches	Utility Manual Depth feet	Cross Sectional View	 Utility Direction	Identified By	Surface Type	Surface Thickness inches	Apparent Utility Owner	Datums:	Horizontal: NAD83/11		Ground Elevation	Utility Elevation	
												Vertical: NAVD88				
											Station	Offset	BL			
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13-1	WM	PVC	8"	3.00'			IRC	NG	N/A	MANATEE COUNTY	55+64.99	73.95' LT	9THAVE	15.09'	12.09'	
14-1	FM	HDPE	4"	4.42'			IRC	NG	N/A	MANATEE COUNTY	55+70.99	42.51' LT	9THAVE	15.19'	10.77'	
16-1	FM	HDPE	2"	4.30'			NL	ASPH	4"	MANATEE COUNTY	55+86.73	28.45' LT	9THAVE	14.85'	10.55'	
17-1	GM	PE	2"	2.00'			IRC	NG	N/A	TECO	55+82.20	24.69' RT	9THAVE	15.39'	13.39'	
18-1	WM	PVC	8"	4.32'			NL	ASPH	4"	MANATEE COUNTY	55+92.12	5.39' LT	9THAVE	15.62'	11.30'	
19-1	RCW	DIP	12"	3.18'			NL	ASPH	4"	MANATEE COUNTY	56+58.73	8.74' LT	9THAVE	16.44'	13.26'	
20-1	RCW	DIP	12"	4.40'			NL	ASPH	4"	MANATEE COUNTY	72+88.67	25.27' LT	9THAVE	14.32'	9.92'	
20-2	UNK	PVC	4"	3.18'			NL	ASPH	4"	UNKNOWN	72+88.68	24.93' LT	9THAVE	14.34'	11.16'	
22-1	RCW	HDPE	6"	3.94'			X	NG	N/A	MANATEE COUNTY	73+51.14	39.80' LT	9THAVE	13.75'	9.81'	
<b>Notes:</b> TH# 14-1 - POSSIBLE 4" HDPE; UNABLE TO VISUALLY VERIFY SIZE AND MATERIAL DUE TO WATER AND CAVE-IN																
TH# 20-2 - POSSIBLE WM; UNABLE TO VISUALLY VERIFY SIZE AND MATERIAL DUE TO WATER AND CAVE-IN																
													Prepared by: CM		Date: 01/31/2022	
													Checked by: MA		Date: 02/02/2022	

THE OFFICIAL RECORD OF THIS SHEET IS THE ELECTRONIC FILE DIGITALLY SIGNED AND SEALED UNDER RULE 61G15-23.004, F.A.C.

Date:	12/14 -12/16/2021	Test Hole Data Report										Crew Members:		BH,PK,DS,HG	
ECHO Project #:	21-137	4803 George Road, Ste. 350 Tampa, Florida 33634 400 SR 434, Ste. 1024 Oviedo, Florida 32765				 UTILITY ENGINEERING & SURVEY		ECHO UES, Inc. www.echoues.com 888.778.ECHO - GROW, INSPIRE, MAKE A DIFFERENCE -		City, State:		Bradenton, FL			
Financial Project #:	20-TA003483CD									General Location:		9th Avenue			
Truck No.:	VT-1									Coordinate Unit of Measure:		US Survey Feet			
Utility Type				Utility Material				Identified By:		Abbreviations		Offset Measured From:			
BE = Buried Electrical		RCW = Reclaimed Water		AC = Transite		GALV = Galvanized Pipe		HUB = Survey Hub		N/A = Not Applicable		EP= Edge of Pavement			
GM = Gas Main		TS = Traffic Signal		CI= Cast Iron		HDPE = High Density Polyethylene Pipe		IRC = Iron Rod & Cap "ECHO TEST HOLE"		NAD = North American		BC = Back of Curb			
BT = Buried Telephone		SL = Street Light		CP = Concrete Pipe		PE = Polyethylene Pipe		NL = Nail & Disk "ECHO TEST HOLE"		Datum		BL = Baseline of Survey			
FOC = Fiber Optic Cable		IRR = Irrigation Line		DBC = Direct Buried Cable		PVC = Polyvinyl Chloride		SLEEVE = Sleeve		NAVD = North American		COORD = Survey Coordinates			
WM = Water Main		GS = Gas Service		CMP = Corrugated Metal Pipe		STL = Steel		X = "X" in Concrete		Vertical Datum		CL = Centerline			
SAN = Sanitary Sewer		WS = Water Service		CONC = Concrete		VCP = Vitrified Clay Pipe		Surface Type		UNK = Unknown		HUB = Survey Hub			
STM = Storm Sewer		UNK = Unknown Utility		CPP = Corrugated Plastic Pipe		PCCP = Prestressed Cylinder Concrete Pipe		ASPH = Asphalt				RW = Right of Way			
CATV = Cable Television		BED = Buried Electrical Duct		DCT = Duct				CONC = Concrete				ST = Swing Ties			
FM = Force Main		BTD = Buried Telephone Duct		DIP = Ductile Iron Pipe		RCP = Reinforced Concrete Pipe		NG = Natural Ground				X = "X" in Concrete			
Test Hole	Utility Type	Utility Material	Utility Size Outside Diameter inches	Utility Manual Depth feet	Cross Sectional View	 Utility Direction	Identified By	Surface Type	Surface Thickness inches	Apparent Utility Owner	Datums:	Horizontal: NAD83/11		Ground Elevation	Utility Elevation
												Vertical: NAVD88			
											Station	Offset	BL		
23-1	GM	PE	2"	5.60'	○	↔	X	CONC	6"	TECO	73+58.11	20.32' RT	9THAVE	12.95'	7.35'
23-2	WM	PVC	8"	2.20'	◯	↕	X	CONC	6"	MANATEE COUNTY	73+56.98	19.13' RT	9THAVE	12.96'	10.76'
24-1	RCW	DIP	12"	4.20'	◯	↔	NL	ASPH	4"	MANATEE COUNTY	73+72.64	15.99' LT	9THAVE	12.98'	8.78'
26-1	WM	PVC	8"	3.70'	◯	↔	NL	ASPH	3"	MANATEE COUNTY	74+99.33	5.52' RT	9THAVE	11.17'	7.47'
27-1	GM	PE	2"	6.48'	○	↔	IRC	NG	N/A	TECO	74+97.33	21.69' RT	9THAVE	10.84'	4.36'
30-1	FM	PVC	8"	4.18'	◯	↕	IRC	NG	N/A	MANATEE COUNTY	84+73.89	23.57' RT	9THAVE	4.41'	0.23'
32-1	FM	PVC	8"	3.46'	◯	↔	NL	ASPH	6"	MANATEE COUNTY	86+98.28	8.15' RT	9THAVE	5.14'	1.68'
Notes: TH# 23-1 - POSSIBLE 2" PE; UNABLE TO VISUALLY VERIFY SIZE AND MATERIAL DUE TO WATER AND CAVE-IN															
TH# 24-1 - POSSIBLE 12" DIP; UNABLE TO VISUALLY VERIFY SIZE AND MATERIAL DUE TO WATER AND CAVE-IN															
TH# 26-1 - POSSIBLE 8" PVC; UNABLE TO VISUALLY VERIFY SIZE AND MATERIAL DUE TO WATER AND CAVE-IN															
TH# 27-1 - POSSIBLE 2" PE; UNABLE TO VISUALLY VERIFY SIZE AND MATERIAL DUE TO WATER AND CAVE-IN															
													Prepared by: CM      Date: 01/31/2022		
													Checked by: MA      Date: 02/02/2022		























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Date:		12/14 - 12/30/2022		Test Hole Data Report								Crew Members: HG,JB,JA,JR,PW,MG,LF,NK,MS			
ECHO Project #:		21-137		4803 George Road, Ste. 350 Tampa, Florida 33634 400 SR 434, Ste. 1024 Oviedo, Florida 32765				<div> UTILITY ENGINEERING &amp; SURVEY</div> <div>ECHO UES, Inc. www.echoues.com 888.778.ECHO - GROW. INSPIRE. MAKE A DIFFERENCE.</div>				City, State: Bradenton, FL			
Financial Project #:		20-TA003483CD										General Location: 9th Avenue			
Truck No.:		VT-1										Coordinate Unit of Measure: US Survey Feet			
Utility Type					Utility Material					Identified By:		Abbreviations		Offset Measured From:	
BE = Buried Electrical		RCW = Reclaimed Water			AC = Transite		GALV = Galvanized Pipe			HUB = Survey Hub		N/A = Not Applicable		EP= Edge of Pavement	
GM = Gas Main		TS = Traffic Signal			CI= Cast Iron		HDPE = High Density Polyethylene Pipe			IRC = Iron Rod & Cap "ECHO TEST HOLE"		NAD = North American Datum		BC = Back of Curb	
BT = Buried Telephone		SL = Street Light			CP = Concrete Pipe		PE = Polyethylene Pipe			NL = Nail & Disk "ECHO TEST HOLE"		NAVD = North American Vertical Datum		BL = Baseline of Survey	
FOC = Fiber Optic Cable		IRR = Irrigation Line			DBC = Direct Buried Cable		PVC = Polyvinyl Chloride			SLEEVE = Sleeve				COORD = Survey Coordinates	
WM = Water Main		GS = Gas Service			CMP = Corrugated Metal Pipe		STL = Steel			X = "X" in Concrete				CL = Centerline	
SAN = Sanitary Sewer		WS = Water Service			CONC = Concrete		VCP = Vitrified Clay Pipe			Surface Type		UNK = Unknown		HUB = Survey Hub	
STM = Storm Sewer		UNK = Unknown Utility			CPP = Corrugated Plastic Pipe		PCCP = Prestressed Cylinder Concrete Pipe			ASPH = Asphalt				RW = Right of Way	
CATV = Cable Television		BED = Buried Electrical Duct			DCT = Duct					CONC = Concrete				ST = Swing Ties	
FM = Force Main		BTD = Buried Telephone Duct			DIP = Ductile Iron Pipe		RCP = Reinforced Concrete Pipe			NG = Natural Ground				X = "X" in Concrete	
Test Hole	Utility Type	Utility Material	Utility Size Outside Diameter inches	Utility Manual Depth feet	Cross Sectional View	<div> Utility Direction</div>	Identified By	Surface Type	Surface Thickness inches	Apparent Utility Owner	Datums:	Horizontal: NAD83/11		Ground Elevation	Utility Elevation
											Station	Vertical: NAVD88			
												Offset	BL		
1-1A	RCW	PVC	6"	3.50'			IRC	NG	4"	MANATEE COUNTY	16+85.48	23.10' RT	9THAVE	3.99'	0.49'
1-2	WM	PVC	6"	3.55'			NL	ASPH	4"	MANATEE COUNTY	16+88.24	21.31' RT	9THAVE	3.76'	0.21'
1-3	FM	HDPE	6"	3.00'			NL	NG	4"	MANATEE COUNTY	17+15.19	24.66' RT	9THAVE	3.22'	0.22'
1-4	FM	AC	8"	2.78'			NL	ASPH	4"	MANATEE COUNTY	17+23.12	11.67' RT	9THAVE	3.43'	0.65'
1-4A	GM	PE	2"	5.40'			X	NG	4"	TECO	17+29.61	21.52' RT	9THAVE	2.72'	-2.68'
1-5	WM	DIP	8"	5.42'			NL	ASPH	4"	MANATEE COUNTY	17+22.17	2.83' LT	9THAVE	3.69'	-1.73'
1-6	RCW	DIP	12"	4.80'			NL	ASPH	4"	MANATEE COUNTY	17+22.35	8.22' LT	9THAVE	3.66'	-1.14'
1-7	GM	PE	2"	5.80'			IRC	NG	N/A	TECO	23+08.38	18.35' RT	9THAVE	3.00'	-2.80'
1-8	WS	PE	1"	2.10'			IRC	NG	N/A	MANATEE COUNTY	30+43.32	16.48' LT	9THAVE	4.12'	2.02'
1-10	WM	PE	1.5"	7.00'			IRC	NG	N/A	MANATEE COUNTY	35+52.69	15.32' LT	9THAVE	2.81'	-4.19'
Notes:															
												Prepared by: EU/CM    Date: 12/23/2022			
												Checked by: MA    Date: 01/03/2023			









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THE OFFICIAL RECORD OF THIS SHEET IS THE ELECTRONIC FILE DIGITALLY SIGNED AND SEALED UNDER RULE 61G15-23.004, F.A.C.

















Date:		12/14 - 12/30/2022			Test Hole Data Report							Crew Members: HG,JB,JA,JR,PW,MG,LF,NK,MS				
ECHO Project #:		21-137			<div>4803 George Road, Ste. 350 Tampa, Florida 33634 400 SR 434, Ste. 1024 Oviedo, Florida 32765</div> <div><b>ECHO</b> UTILITY ENGINEERING &amp; SURVEY</div> <div>ECHO UES, Inc. www.echoues.com 888.778.ECHO - GROW. INSPIRE. MAKE A DIFFERENCE.</div>							City, State: Bradenton, FL				
Financial Project #:		20-TA003483CD										General Location: 9th Avenue				
Truck No.:		VT-1										Coordinate Unit of Measure: US Survey Feet				
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CATV = Cable Television		BED = Buried Electrical Duct			DCT = Duct					CONC = Concrete				ST = Swing Ties		
FM = Force Main		BTD = Buried Telephone Duct			DIP = Ductile Iron Pipe		RCP = Reinforced Concrete Pipe			NG = Natural Ground				X = "X" in Concrete		
Test Hole	Utility Type	Utility Material	Utility Size Outside Diameter inches	Utility Manual Depth feet	Cross Sectional View	 Utility Direction	Identified By	Surface Type	Surface Thickness inches	Apparent Utility Owner	Datums:	Horizontal: NAD83/11		Ground Elevation	Utility Elevation	
											Station	Vertical: NAVD88				
												Offset	BL			
1-10A	WM	PE	1.5"	3.64'			IRC	NG	4"	MANATEE COUNTY	35+27.23	15.23' LT	9THAVE	3.08'	-0.56'	
1-11	RCW	PE	12"	3.10'			IRC	NG	N/A	MANATEE COUNTY	36+79.85	9.48' LT	9THAVE	3.33'	0.23'	
1-12	WM	PVC	8"	3.44'			NL	ASPH	12"	MANATEE COUNTY	36+77.91	3.51' LT	9THAVE	3.51'	0.07'	
1-13	GM	PE	2"	2.10'			IRC	NG	N/A	TECO	36+83.03	17.15' RT	9THAVE	1.85'	-0.25'	
1-14	FM	CI	8"	1.64'			IRC	NG	N/A	MANATEE COUNTY	36+80.98	9.57' RT	9THAVE	2.98'	1.34'	
1-15	RCW	DIP	10"	3.50'			IRC	NG	4"	MANATEE COUNTY	46+00.17	9.10' LT	9THAVE	8.88'	5.38'	
1-16	WM	PVC	8"	3.50'			IRC	NG	4"	MANATEE COUNTY	45+98.81	3.32' LT	9THAVE	8.78'	5.28'	
1-17	GM	PE	2"	5.22'			IRC	NG	4"	TECO	45+98.76	20.23' RT	9THAVE	8.23'	3.01'	
1-17A	FM	HDPE	8"	2.64'			IRC	NG	4"	MANATEE COUNTY	45+99.62	14.23' RT	9THAVE	8.40'	5.76'	
1-17B	WM	AC	8"	2.82'			IRC	NG	4"	MANATEE COUNTY	46+00.18	11.36' RT	9THAVE	8.26'	5.44'	
Notes: TH # 1-10A - POSSIBLE 1.5" PE; UNABLE TO VISUALLY VERIFY SIZE AND MATERIAL DUE TO WATER AND CAVE-IN																
												Prepared by: EU/CM Date: 01/03/2023				
												Checked by: MA Date: 01/03/2023				

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













THE OFFICIAL RECORD OF THIS SHEET IS THE ELECTRONIC FILE DIGITALLY SIGNED AND SEALED UNDER RULE 61G15-23.004, F.A.C.

Date:	12/14 - 12/30/2022	Test Hole Data Report										Crew Members: HG,JB,JA,JR,PW,MG,LF,NK,MS			
ECHO Project #:	21-137	4803 George Road, Ste. 350 Tampa, Florida 33634 400 SR 434, Ste. 1024 Oviedo, Florida 32765				 UTILITY ENGINEERING & SURVEY		ECHO UES, Inc. www.echoues.com 888.778.ECHO - GROW, INSPIRE, MAKE A DIFFERENCE -		City, State: Bradenton, FL					
Financial Project #:	20-TA003483CD									General Location: 9th Avenue					
Truck No.:	VT-1									Coordinate Unit of Measure: US Survey Feet					
Utility Type				Utility Material				Identified By:		Abbreviations		Offset Measured From:			
BE = Buried Electrical		RCW = Reclaimed Water		AC = Transite		GALV = Galvanized Pipe		HUB = Survey Hub		N/A = Not Applicable		EP= Edge of Pavement			
GM = Gas Main		TS = Traffic Signal		CI= Cast Iron		HDPE = High Density Polyethylene Pipe		IRC = Iron Rod & Cap "ECHO TEST HOLE"		NAD = North American		BC = Back of Curb			
BT = Buried Telephone		SL = Street Light		CP = Concrete Pipe		PE = Polyethylene Pipe		NL = Nail & Disk "ECHO TEST HOLE"		Datum		BL = Baseline of Survey			
FOC = Fiber Optic Cable		IRR = Irrigation Line		DBC = Direct Buried Cable		PVC = Polyvinyl Chloride		SLEEVE = Sleeve		NAVD = North American		COORD = Survey Coordinates			
WM = Water Main		GS = Gas Service		CMP = Corrugated Metal Pipe		STL = Steel		X = "X" in Concrete		Vertical Datum		CL = Centerline			
SAN = Sanitary Sewer		WS = Water Service		CONC = Concrete		VCP = Vitrified Clay Pipe		Surface Type		UNK = Unknown		HUB = Survey Hub			
STM = Storm Sewer		UNK = Unknown Utility		CPP = Corrugated Plastic Pipe		PCCP = Prestressed Cylinder Concrete Pipe		ASPH = Asphalt				RW = Right of Way			
CATV = Cable Television		BED = Buried Electrical Duct		DCT = Duct				CONC = Concrete				ST = Swing Ties			
FM = Force Main		BTD = Buried Telephone Duct		DIP = Ductile Iron Pipe		RCP = Reinforced Concrete Pipe		NG = Natural Ground				X = "X" in Concrete			
Test Hole	Utility Type	Utility Material	Utility Size Outside Diameter inches	Utility Manual Depth feet	Cross Sectional View	 Utility Direction	Identified By	Surface Type	Surface Thickness inches	Apparent Utility Owner	Datums:	Horizontal: NAD83/11		Ground Elevation	Utility Elevation
												Vertical: NAVD88			
											Station	Offset	BL		
1-18	RCW	DIP	12"	3.28'		↔	IRC	NG	4"	MANATEE COUNTY	47+95.53	8.63' LT	9THAVE	10.90'	7.62'
1-19	WM	PVC	8"	2.94'		↔	IRC	NG	4"	MANATEE COUNTY	47+95.83	2.25' LT	9THAVE	11.08'	8.14'
1-20	GM	PE	2"	5.96'		↔	IRC	NG	4"	TECO	47+95.39	21.41' RT	9THAVE	10.88'	4.92'
1-20A	FM	HDPE	8"	3.18'		↔	IRC	NG	4"	MANATEE COUNTY	47+96.16	16.61' RT	9THAVE	11.10'	7.92'
1-20B	WM	AC	8"	3.60'		↔	IRC	NG	4"	MANATEE COUNTY	47+96.39	13.48' RT	9THAVE	10.90'	7.30'
1-21	WS	PE	1"	0.60'		↔	IRC	NG	N/A	MANATEE COUNTY	49+74.07	26.27' LT	9THAVE	12.61'	12.01'
1-22	GM	PE	2"	2.86'		↔	IRC	NG	N/A	TECO	50+72.53	23.15' LT	9THAVE	14.02'	11.16'
1-23	RCW	DIP	12"	3.02'		↔	IRC	ASPH	8"	MANATEE COUNTY	50+91.51	6.86' LT	9THAVE	13.77'	10.75'
1-24	WM	PVC	8"	3.18'		↔	NL	ASPH	8"	MANATEE COUNTY	50+91.69	1.96' LT	9THAVE	13.83'	10.65'
1-25	GM	PE	2"	2.30'		↔	IRC	NG	N/A	TECO	51+11.74	16.34' RT	9THAVE	13.55'	11.25'
Notes:															
													Prepared by: EU/CM    Date: 01/03/2023		
													Checked by: MA    Date: 01/03/2023		

THE OFFICIAL RECORD OF THIS SHEET IS THE ELECTRONIC FILE DIGITALLY SIGNED AND SEALED UNDER RULE 61G15-23.004, F.A.C.

Date:	12/14 - 12/30/2022	Test Hole Data Report										Crew Members: HG,JB,JA,JR,PW,MG,LF,NK,MS			
ECHO Project #:	21-137	4803 George Road, Ste. 350 Tampa, Florida 33634 400 SR 434, Ste. 1024 Oviedo, Florida 32765				 UTILITY ENGINEERING & SURVEY		ECHO UES, Inc. www.echoues.com 888.778.ECHO - GROW, INSPIRE, MAKE A DIFFERENCE -		City, State: Bradenton, FL					
Financial Project #:	20-TA003483CD									General Location: 9th Avenue					
Truck No.:	VT-1									Coordinate Unit of Measure: US Survey Feet					
Utility Type					Utility Material					Identified By:		Abbreviations		Offset Measured From:	
BE = Buried Electrical		RCW = Reclaimed Water			AC = Transite		GALV = Galvanized Pipe			HUB = Survey Hub		N/A = Not Applicable		EP= Edge of Pavement	
GM = Gas Main		TS = Traffic Signal			CI= Cast Iron		HDPE = High Density Polyethylene Pipe			IRC = Iron Rod & Cap "ECHO TEST HOLE"		NAD = North American		BC = Back of Curb	
BT = Buried Telephone		SL = Street Light			CP = Concrete Pipe		PE = Polyethylene Pipe			NL = Nail & Disk "ECHO TEST HOLE"		Datum		BL = Baseline of Survey	
FOC = Fiber Optic Cable		IRR = Irrigation Line			DBC = Direct Buried Cable		PVC = Polyvinyl Chloride			SLEEVE = Sleeve		NAVD = North American		COORD = Survey Coordinates	
WM = Water Main		GS = Gas Service			CMP = Corrugated Metal Pipe		STL = Steel			X = "X" in Concrete		Vertical Datum		CL = Centerline	
SAN = Sanitary Sewer		WS = Water Service			CONC = Concrete		VCP = Vitrified Clay Pipe			Surface Type		UNK = Unknown		HUB = Survey Hub	
STM = Storm Sewer		UNK = Unknown Utility			CPP = Corrugated Plastic Pipe		PCCP = Prestressed Cylinder Concrete Pipe			ASPH = Asphalt				RW = Right of Way	
CATV = Cable Television		BED = Buried Electrical Duct			DCT = Duct		Pipe			CONC = Concrete				ST = Swing Ties	
FM = Force Main		BTD = Buried Telephone Duct			DIP = Ductile Iron Pipe		RCP = Reinforced Concrete Pipe			NG = Natural Ground				X = "X" in Concrete	
Test Hole	Utility Type	Utility Material	Utility Size Outside Diameter inches	Utility Manual Depth feet	Cross Sectional View	 Utility Direction	Identified By	Surface Type	Surface Thickness inches	Apparent Utility Owner	Datums:	Horizontal: NAD83/11		Ground Elevation	Utility Elevation
												Vertical: NAVD88			
											Station	Offset	BL		
1-25A	FM	HDPE	6"	1.62'			IRC	NG	4"	MANATEE COUNTY	51+11.12	14.39' RT	9THAVE	13.48'	11.86'
1-25B	WM	AC	8"	3.10'			IRC	NG	4"	MANATEE COUNTY	51+11.11	12.99' RT	9THAVE	13.42'	10.32'
1-26	FM	PVC	4"	4.36'			IRC	NG	N/A	MANATEE COUNTY	61+10.49	8.56' LT	9THAVE	15.27'	10.91'
1-27	RCW	DIP	12"	4.02'			NL	ASPH	4"	MANATEE COUNTY	61+10.56	4.53' LT	9THAVE	15.36'	11.34'
1-28	WM	PVC	8"	5.20'			IRC	NG	N/A	MANATEE COUNTY	61+09.73	26.30' RT	9THAVE	15.07'	9.87'
1-29	WM	PVC	8"	3.80'			IRC	NG	N/A	MANATEE COUNTY	62+79.69	27.14' RT	9THAVE	14.65'	10.85'
1-29A	GM	PE	2"	4.30'			IRC	NG	N/A	TECO	62+80.19	29.09' RT	9THAVE	14.22'	9.92'
Notes:															
													Prepared by: EU/CM    Date: 01/03/2023		
													Checked by: MA    Date: 01/03/2023		

THE OFFICIAL RECORD OF THIS SHEET IS THE ELECTRONIC FILE DIGITALLY SIGNED AND SEALED UNDER RULE 61G15-23.004, F.A.C.

Date:	03/08/2024	Test Hole Data Report										Crew Members:		JB,BP	
ECHO Project #:	21-137	4803 George Road, Ste. 350 Tampa, Florida 33634 400 SR 434, Ste. 1024 Oviedo, Florida 32765				 UTILITY ENGINEERING & SURVEY		ECHO UES, Inc. www.echoues.com 888.778.ECHO - GROW, INSPIRE, MAKE A DIFFERENCE -		City, State:		Bradenton, FL			
Financial Project #:	20-TA003483CD									General Location:		9th Avenue			
Truck No.:	VT-1									Coordinate Unit of Measure:		US Survey Feet			
Utility Type				Utility Material				Identified By:		Abbreviations		Offset Measured From:			
BE = Buried Electrical		RCW = Reclaimed Water		AC = Transite		GALV = Galvanized Pipe		HUB = Survey Hub		N/A = Not Applicable		EP= Edge of Pavement			
GM = Gas Main		TS = Traffic Signal		CI= Cast Iron		HDPE = High Density Polyethylene Pipe		IRC = Iron Rod & Cap "ECHO TEST HOLE"		NAD = North American		BC = Back of Curb			
BT = Buried Telephone		SL = Street Light		CP = Concrete Pipe		PE = Polyethylene Pipe		NL = Nail & Disk "ECHO TEST HOLE"		Datum		BL = Baseline of Survey			
FOC = Fiber Optic Cable		IRR = Irrigation Line		DBC = Direct Buried Cable		PVC = Polyvinyl Chloride		SLEEVE = Sleeve		NAVD = North American		COORD = Survey Coordinates			
WM = Water Main		GS = Gas Service		CMP = Corrugated Metal Pipe		STL = Steel		X = "X" in Concrete		Vertical Datum		CL = Centerline			
SAN = Sanitary Sewer		WS = Water Service		CONC = Concrete		VCP = Vitrified Clay Pipe		Surface Type		UNK = Unknown		HUB = Survey Hub			
STM = Storm Sewer		UNK = Unknown Utility		CPP = Corrugated Plastic Pipe		PCCP = Prestressed Cylinder Concrete Pipe		ASPH = Asphalt		BL = Baseline		RW = Right of Way			
CATV = Cable Television		BED = Buried Electrical Duct		DCT = Duct		Pipe		CONC = Concrete				ST = Swing Ties			
FM = Force Main		BTD = Buried Telephone Duct		DIP = Ductile Iron Pipe		RCP = Reinforced Concrete Pipe		NG = Natural Ground				X = "X" in Concrete			
Test Hole	Utility Type	Utility Material	Utility Size Outside Diameter inches	Utility Manual Depth feet	Cross Sectional View	 Utility Direction	Identified By	Surface Type	Surface Thickness inches	Apparent Utility Owner	Datums:	Horizontal: NAD83/11		Ground Elevation	Utility Elevation
												Vertical: NAVD88			
											Station	Offset	BL		
1-1-1	FM	HDPE	6"	5.92'			IRC	NG	N/A	MANATEE COUNTY	35+38.04	12.89' RT	9THAVE	3.03'	-2.89'
2-1-1	FM	HDPE	6"	5.80'			IRC	NG	N/A	MANATEE COUNTY	35+92.01	13.94' RT	9THAVE	2.63'	-3.17'
3-1-1	FM	HDPE	6"	7.00'			IRC	NG	N/A	MANATEE COUNTY	36+29.11	13.98' RT	9THAVE	2.97'	-4.03'
4-1-1	FM	HDPE	6"	6.48'			IRC	NG	N/A	MANATEE COUNTY	37+41.61	11.78' RT	9THAVE	3.04'	-3.44'
5-1-1	FM	HDPE	6"	4.90'			IRC	NG	N/A	MANATEE COUNTY	38+26.27	13.83' RT	9THAVE	3.06'	-1.84'
6-1-1	WM	PVC	4"	3.62'			IRC	NG	N/A	MANATEE COUNTY	52+74.81	438.18' RT	9THAVE	12.76'	9.14'
Notes: TH# 1-1-1 THRU 5-1-1 - POSSIBLE 6" HDPE; UNABLE TO VISUALLY VERIFY SIZE AND MATERIAL DUE TO WATER, DEPTH AND CAVE-IN.															
														Prepared by: EU/CM Date: 03/15/2024	
														Checked by: MA Date: 03/15/2024	

THE OFFICIAL RECORD OF THIS SHEET IS THE ELECTRONIC FILE DIGITALLY SIGNED AND SEALED UNDER RULE 61G15-23.004, F.A.C.