CONSTRUCTION PLANS FORLENA ROAD UTILITY RELOCATIONS

MANATEE COUNTY, FLORIDA AUGUST 2023 MANATEE COUNTY PROJECT #6107560


Manatee

PROJECT TEAM:

OWNER: MANATEE COUNTY 1022 26TH AVE. E.

BRADENTON, FL 34208 CONTACT: TONY RUSSO, P.E. 941-708-7450 ext. 7349

ENGINEER: KIMLEY-HORN AND ASSOCIATES, INC. 200 CENTRAL AVE, SUITE 600 ST PETERSBURG, FL 33701 CONTACT: JORDAN W. WALKER, P.E. 727-308-4320

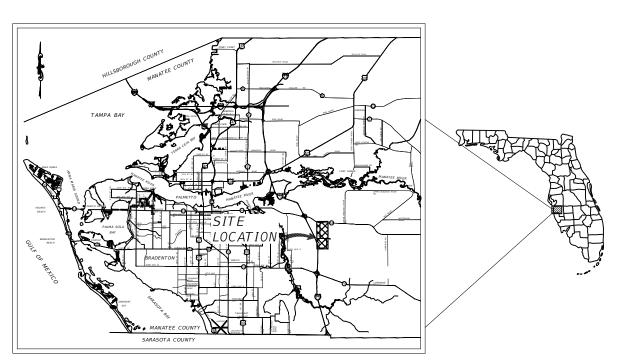

PROJECT VICINITY MAP 90% PLANS SUBMITTAL AUGUST 2023

> PREPARED BY **Kimley** » Horn

| 4 | KEY SHEET |
|----|---------------------------------------|
| 5 | WATER MAIN PLAN & PROFILE [236 - 243] |
| 6 | WATER MAIN PLAN & PROFILE [243 - 250] |
| 7 | WATER MAIN PLAN & PROFILE [250 - 257] |
| 8 | WATER MAIN PLAN & PROFILE [257 - 264] |
| 9 | WATER MAIN PLAN & PROFILE [264 - 271] |
| 10 | WATER MAIN PLAN & PROFILE [271 - 278] |
| 11 | WATER MAIN PLAN & PROFILE [278 - 285] |
| 12 | WATER MAIN PLAN & PROFILE [285 - 292] |
| 13 | WATER MAIN PLAN & PROFILE [292 - 299] |
| 14 | WATER MAIN PLAN & PROFILE [299 - 306] |
| 15 | WATER MAIN PLAN & PROFILE [306 - 313] |
| 16 | WATER MAIN INTERSECTIONS |
| 17 | CONFLICT RELOCATION [243+00 - 250+00] |
| 18 | CONFLICT RELOCATION [250+00 - 257+00] |
| 19 | CONFLICT RELOCATION [257+00 - 264+00] |
| 20 | CONFLICT RELOCATION [264+00 - 271+00] |
| 21 | CONFLICT RELOCATION [271+00 - 278+00] |
| 22 | CONFLICT RELOCATION [278+00 - 285+00] |
| 23 | CONFLICT RELOCATION [292+00 - 299+00] |
| 24 | CONFLICT RELOCATION [299+00 - 306+00] |
| 25 | CONFLICT RELOCATION [306+00 - 313+00] |
| 26 | UTILITY ADJUSTMENT DETAIL |
| 27 | DETAILS 01 |
| 28 | DETAILS 02 |
| 29 | DETAILS 03 |
| 30 | DETAILS 04 |

SHEET INDEX

Sheet Title COVER SHEET GENERAL NOTES SIGNATURE SHEET

THE SITE CONSTRUCTION STAKEOUT SHALL BE PERFORMED UNDER THE DIRECTION OF A FLORIDA REGISTERED SURVEYOR. AUTOCAD FILES WILL BE FURNISHED TO AID IN THE SITE CONSTRUCTION STAKEOUT. ANY DISCREPANCIES FOUND BETWEEN AUTOCAD FILES AND SITE CONSTRUCTION PLANS SHALL BE BROUGHT TO THE ENGINEER'S

| ATTENTION FOR CLARIFICATION PRIOR TO | TUAT CTAKEOUT | |
|--|--|------------------------------|
| ATTENTION FOR CLARIFICATION PRIOR TO | THAT STAKEOUT. | DATE AUGUST 2023 |
| HIS DOCUMENT IS PROTECTED BY SECTION 106 OF | | A00031 2020 |
| HE "UNITED STATES COPYRIGHT ACT". EPRODUCTION OR ALTERATION OF THIS DOCUMENT R THE INFORMATION CONTAINED HEREON BY ANY | | KHA PROJECT NO. 148400103 |
| EANS WHATSOEVER IS STRICTLY PROHIBITED | | SHEET NUMBER |
| ITHOUT THE PRIOR WRITTEN CONSENT OF IMLEY-HORN AND ASSOCIATES, INC. CONSENT IS IEREBY GRANTED SPECIFICALLY TO GOVERNMENTAL GENCIES TO REPRODUCE THIS DOCUMENT IN | JORDAN W. WALKER, P.E. FLORIDA LICENSE NUMBER: 78652 | 1 |
| OMDITANCE WITH ES CHADTED 110 | DATE: 0/2/2022 | |

- ALL CONSTRUCTION ACTIVITIES SHALL BE COORDINATED WITH THE PROJECT MANAGEMENT DIVISION.
 THE PROJECT MANAGER IS: TONY RUSSO, P.E. AND CAN BE REACHED AT (941) 708-7450 X7349
- 2. IF THE CONTRACTOR WANTS A SITE VISIT PRIOR TO BIDDING, THESE SHALL BE ARRANGED THROUGH THE COUNTY'S
- ALL CONSTRUCTION ON THIS PROJECT SHALL BE IN ACCORDANCE WITH THE LATEST EDITION OF MANATEE COUNTY UTILITY
 AND TRANSPORTATION STANDARDS AND/OR FOOT "STANDARD SPECIFICATIONS FOR ROAD AND BRIDGE CONSTRUCTION"
 UNLESS OTHERWISE INDICATED ON THE PLANS.
- 4. THE CONTRACTOR SHALL BE RESPONSIBLE FOR MEETING ALL CONDITIONS AND REQUIREMENTS OF ALL PERMITS AND ALL GOVERNING FEDERAL, STATE, AND LOCAL AGENCIES. THE CONTRACTOR SHALL OBTAIN AND PAY FOR ALL REQUIRED PERMITS THAT ARE NOT PROVIDED IN THE BID DOCUMENTS, AT NO ADDITIONAL COST TO THE OWNER.
- 5. THE INFORMATION PROVIDED IN THESE PLANS IS SOLELY TO ASSIST THE CONTRACTOR IN ASSESSING THE NATURE AND EXTENT OF THE CONDITIONS WHICH MAY BE ENCOUNTERED DURING THE COURSE OF WORK. ALL CONTRACTOR ARE DIRECTED, PRIOR TO BIDDING, TO CONDUCT WHATEVER INVESTIGATION THEY MAY DEEM NECESSARY TO ARRIVE AT THEIR OWN CONCLUSIONS REGARDING THE ACTUAL CONDITIONS THAT WILL BE ENCOUNTERED, AND UPON WHICH THEIR BIDS WILL BE BASED.
- 6. THE CONTRACTOR SHALL REVIEW AND VERIFY ALL DIMENSIONS ON THE PLANS AND REVIEW ALL FIELD CONDITIONS THAT MAY AFFECT CONSTRUCTION. SHOULD DISCREPANCES OCCUR, THE CONTRACTOR SHALL NOTIFY THE ENGINEER TO OBTAIN THE ENGINEER'S CLARIFICATION BEFORE COMMENCING WITH CONSTRUCTION.
- 7. THE CONTRACTOR SHALL NOTIFY SUNSHINE 811 (1-800-432-4770) AT LEAST TWO FULL BUSINESS DAYS PRIOR TO CONSTRUCTION OPERATIONS. THE CONTRACTOR SHALL BE RESPONSIBLE FOR COORDINATING WITH ALL UTILITIES FOR THE POSSIBLE RELOCATION OR THE TEMPORARY MOVEMENT OF AMY EXISTING UTILITIES WITHIN THE RIGHTS-OF-WAY. IT IS THE CONTRACTOR'S RESPONSIBILITY TO PROTECT EXISTING UTILITIES FROM DAMAGE. EXPLORATORY EXCAVATION MAY BE REQUIRED PRIOR TO CONNECTION TO ENISTING UTILITIES.
- 8. NO WORK, EXCEPT FOR EMERGENCY TYPE, SHALL BE PERFORMED AFTER 7:00 PM AND BEFORE 7:00 AM ON WEEKDAYS. NO WORK SHALL BE PERFORMED ON WEEKENDS WITHOUT COUNTY WRITTEN APPROVAL. FOR ADDITIONAL PROJECT RESTRAINTS REFER TO SECTION 0/310 OF THE SPECIFICATIONS.
- 9. THE CONTRACTOR SHALL PROVIDE CERTIFIED RECORD DRAWINGS AS OUTLINED IN THE SPECIFICATIONS. RED-LINI DRAWINGS SHALL BE CURRENT WITH EACH PAY APPLICATION SUBMITTED AND WILL BE CHECKED AS PART OF THE PAY APPLICATION REVIEW PROCESS, PAYMENT WILL NOT BE MADE TO CONTRACTOR WITHOUT APPROVED RED-LINE DRAWINGS. THE MOST CURRENT SET OF RED-LINE DRAWINGS SHALL ALSO BE BROUGHT TO EACH MONTHLY PROGRESS MEETING.
- 10. THE CONTRACTOR SHALL INCLUDE IN HIS BID:BY-PASS PUMPING FACILITIES, PUMPS, FITTINGS, LABOR, ETC. AS NECESSARY, BASED ON METHOD AND SEQUENCE OF CONSTRUCTION TO COMPLETE ALL WORK WHILE MAINTAINING WATER SERVICE OPERATIONS AT ALL TIMES.
- 11. THE CONTRACTOR SHALL PROVIDE THE OWNER AND ENGINEER WITH A DETAILED CONSTRUCTION PHASING PLAN. EXISTING WATER MAINS SHALL REMAIN IN SERVICE UNTIL ALL CONNECTIONS TO THE PROPOSED WATER MAIN ARE CONSTRUCTED.
- 12. ALL PROPOSED WORK SHALL BE COORDINATED WITH MANATEE COUNTY UTILITIES DEPARTMENT AT LEAST TWO WEEKS IN ADVANCE OF PROPOSED CONSTRUCTION.
- 13. THE CONTRACTOR SHALL FURNISH SHOP DRAWINGS TO THE ENGINEER FOR REVIEW OF ALL PIPE CONNECTIONS, TRANSITIONS, AND SPECIAL APPURTENANCES PRIOR TO FABRICATION OR DELIVERY TO THE JOB SITE.
- 14. UNLESS OTHERWISE INDICATED OR APPROVED, ALL PIPE ON ROADWAY SHALL BE PUSH-ON DUCTILE IRON PIPE CLASS 350 AND ALL PIPE INSTALLED IN GREEN AREAS SHALL BE PUSH-ON C900 PVC DR 18.
- 15. WATER MAINS SHALL BE LAID TO PROVIDE A MINIMUM VERTICAL DISTANCE OF 12" BETWEEN THE INVERT OF THE UPPER PIPE AND THE CROWN OF THE LOWER PIPE. WHERE THIS MINIMUM SEPARATION CANNOT BE MAINTAINED, THE CROSSING FIFE AND THE CHOWN OF THE UNDER FIFE. WHERE THIS MINIMOUS SEPARATION CANNOT BE MAINTAINED, THE EXEC SHALL BE ARRANGED SO THAT THE WATER MAIN PIPE JOINTS ARE GOUDSTANT FROM THE POINT OF CROSSING WIT LESS THAN 10 BETWEEN ANY TWO JOINTS. AS AN ALTERNATIVE, THE WATER MAIN MAY BE PLACED IN A WATERTIGH CASING PIPE, CONSISTENT WITH F.A.C. RULE 02-555.314.
- 16 IT SHALL RE THE CONTRACTORS RESPONSIBILITY TO SECURE PROPERTY FOR STAGING MATERIALS AND FOLLOPMENT
- 17. IT WILL BE THE CONTRACTOR'S RESPONSIBILITY TO ACQUIRE, OR ENTER INTO AGREEMENTS, FOR LAND STOR LAY DOWN AREAS AND STAGING. THE COUNTY WILL COORDINATE AND ADVISE, TO HELP IDENTIFY POSSIBLE PARCELS. IT IS FINAL THE CONTRACTOR'S RESPONSIBILITY TO SECURE THE NEEDED AREAS, AND THE COUNTY TAKE NO RESPONSIBILITY FOR DELAYS IN THIS REGARD.
- 18. COORDINATION AND PUBLIC INFORMATION FOR AND WITH AREA RESIDENTS ARE OF THE UTMOST IMPORTANCE. CONTRACTOR WILL INSURE ADHERENCE TO THE COUNTY'S NOISE ORDINANCE, HAZARD AND SAFETY, AND NUISANCE ABATEMENT DIRECTIONS, PLANS, OBLECTIONS AND ORDINANCES. THE ENGINEER WILL HAVE THE FINAL DISCRETIO THIS REGARD, AS REPRESENTED ONSITE BY THE COUNTY INSPECTOR AND ENGINEER'S STAFF.

- 19. THE CONTRACTOR SHALL BE RESPONSIBLE FOR COMPLIANCE WITH THE FLORIDA TRENCH SAFETY ACT, 90-96, LAWS OF FLORIDA EFFECTIVE OCTOBER 1, 1990 AND THE OCCUPATIONAL SAFETY AND HEALTH ADMINISTRATION EXCAVATION SAFETY STANDARDS, 29 CFR 1926.650, SUBPART P, AS AMENDED. THE CONTRACTOR SHALL INCLUDE IN THE TOTAL BID PRICE ALL COSTS FOR COMPLIANCE WITH THESE REGULATIONS.
- 20. THE CONTRACTOR SHALL USE SHEET PILING, SHEETING, BRACING, ETC., AS REQUIRED IN ALL EXCAVATION AREAS AND CONFORM TO ALL OSHA REQUIREMENTS.
- 21. THE CONTRACTOR SHALL USE ALL NECESSARY SAFETY PRECAUTIONS TO AVOID CONTACT WITH OVERHEAD AND UNDERGROUND UTILITIES, POWER LINES, ETC.
- 22. THESE DRAWINGS DO NOT INCLUDE NECESSARY COMPONENTS FOR CONSTRUCTION SAFETY. THIS EXCLUSION DOES NOT ALLEVIATE THE CONTRACTOR FOR PROVIDING A CONTINUOUS SAFE WORKSPACE.

- 23. THE CONTRACTOR SHALL PROVIDE AND INSTALL ALL NECESSARY STORM WATER, EROSION, AND SEDIMENTATION CONTROL MEASURES IN ACCORDANCE WITH THE FORP "FLORIDA STORM WATER, EROSION AND SEDIMENTATION CONTROL INSPECTOR'S MANUAL: IT IS THE RESPONSIBILITY OF THE CONTRACTOR TO CONTROL AND PREVENT EROSION AND TRANSPORT OF SEDIMENT TO SURFACE DRAINS AND TO DITCHES DURING CONSTRUCTION
- 24. STOCKPILES SHALL BE PROTECTED AT ALL TIMES BY ON-SITE DRAINAGE CONTROLS WHICH PREVENT EROSION OF THE STOCKPILED MATERIAL. CONTROL OF DUST FROM SUCH STOCKPILES IS REQUIRED, DEPENDING UPON THEIR LOCATION, THE EXPECTED LENGTH OF TIME THE STOCKPILES WILL BE PRESENT. IN NO CASE SHALL ANY STOCKPILED MATERIAL REMAIN AFTER THIRTY (30) CALENDAR DAYS.
- 25. STORM WATER INLETS IN THE VICINITY OF THE PROJECT SHALL BE PROTECTED BY SEDIMENT TRAPS SUCH AS SEC HAY BALES, SOD, STONE, ETC., WHICH SHALL BE MAINTAINED AND MODIFIED AS REQUIRED BY CONSTRUCTION PROGA AND WHICH MUST BE APPROVED BY THE ENGINEER BEFORE INSTALLATION. THIS WILL BE MAINTAINED TO PREVENT DEGRADATION OF THE WATERS OF THE COUNTY AND STATE.
- 26. SEDIMENT BASINS AND TRAPS, PERIMETER BERMS, SEDIMENT BARRIERS, VEGETATIVE BUFFERS, AND OTHER MEASURES INTENDED TO TRAP SEDIMENT AND/OR PREVENT THE TRANSPORT OF SEDIMENT ONTO ADJACENT PROPERTIES, OR INTO EXISTING BODIES OF WASTER, MUST BE INSTALLED, CONSTRUCTED, OR IN THE CASE OF VEGETATIES, UPSILE BUFFERS, PROTECTED FROM DISTURBANCE, AS A FIRST STEP IN THE LAND ALTERATION PROCESS. SUCH SYSTEMS SHALL BE FULLY OPERATIVE BEFORE ANY OTHER DISTURBANCE OF THE SITE BEGINS. EARTHEN STRUCTURES INCLUDING BUT NOT LIMITED TO BERMS, EARTH FILTERS, DAMS OR DIKES SHALL BE STABILIZED AND PROTECTED FROM DRAINAGE DAMAGE OR ERSOSION WITHIN ONE (1) WEEK OF INSTALLATION.
- 27. ALL SWALES, DITCHES, AND CHANNELS LEADING FROM THE SITE SHALL BE PROTECTED FROM SILTATION AND EROSION DURING CONSTRUCTION AND BE SODDED WITHIN THREE (3) DAYS OF EXCAVATION.
- 28. SOIL DISPLACED BY CONSTRUCTION WILL BE REMOVED. EROSION CONTROL SHALL BE IMPLEMENTED IN AREAS WHICH ARE CONSIDERED ENVIRONMENTALLY SENSITIVE. EROSION CONTROL SHALL BE IMPLEMENTED IN AREAS WHICH CONSIDERED ENVIRONMENTALLY SENSITIVE. EROSION CONTROL SYSTEMS SHALL BE REQUIRED FOR ALL WORK WITHIN JURISDICTIONAL AREAS. THESE SYSTEMS MAY INCLUDE STAKED HAY BALES, SILT SCREENS, FILTER FABRIC, AND TURBIDITY SCREENS.
- 29. ALL EROSION AND POLLUTION CONTROL DEVICES SHALL BE CHECKED REGULARLY, ESPECIALLY AFTER EACH RAINFALL AND
- 30. THE CONTRACTOR SHALL NOT ENTER UPON OR IN ANY WAY ALTER WETLAND AREAS THAT MAY BE ON OR NEAR THE CONSTRUCTION SITE. ALL WORK IN THE VICINITY OF OPEN WATER AND/OR WETLANDS IS TO BE PERFORMED IN COMPLIANCE WITH THE ENVIRONMENTAL REGULATIONS AND/OR PERMITS FOR THE SITE. THE CONTRACTOR WILL BE RESPONSIBLE FOR ANY FINES RESULTING FROM HIS VIOLATION OF ANY REGULATIONS OR PERMIT CONDITIONS.
- 31. CONTRACTOR SHALL PROVIDE PROTECTIVE MATTING, FUEL CONTAINMENT AND ALL OTHER MATERIALS, EQUIPMENT AND LABOR TO PROTECT THE STAGING AREA DURING CONSTRUCTION.

DATE

BY

32. CONTRACTOR SHALL, PRIOR TO BEGINNING CONSTRUCTION, SUBMIT A "FUELING SPILL PREVENTION PLAM" THAT SHALL CLEARLY INDICATE HOW FUEL SPILLS WILL BE PREVENTED WHEN FUELING BOTH WITHIN AND OUTSIDE OF THE STAGING AREA.

REVISIONS

KIMLEY-HORN AND ASSOCIATES, INC.

IS REQUIRED TO 18" BELOW TRENCH BOTTOM

200 CENTRAL AVENUE, SUITE 600, ST. PETERSBURG, FL 33701 PHONF: (727) 547-3999 WWW.KIMLEY-HORN.COM

Kimley»Horn

PROJECT NO 148400103 DATE 8/3/23 SCALE AS SHOWN BMS

33. ALL CONSTRUCTION ACTIVITIES SHALL BE LIMITED TO WITHIN THE COUNTY AND FDOT RIGHT-OF-WAY.

ADDITIONAL COST TO THE OWNER.

34. THE CONTRACTOR SHALL EMPLOY A LAND SURVEYOR REGISTERED IN THE STATE OF FLORIDA TO REFERENCE AND RESTORE PROPERTY CORNER MONUMENTS, PINS, AND LANDMARKS THAT MAY BE DISTURBED BY CONSTRUCTION AT NO

35. THE CONTRACTOR, PRIOR TO CONSTRUCTION AND RESTRICTING ANY TRAFFIC, MUST OBTAIN ANY REQUIRED RIGHTS-OF-WAY USE PERMITS AND A TRAFFIC CONTROL PLAN. THE CONTRACTOR SHALL OBTAIN ALL REQUIRED PERMITS FROM OTHER GOVERNMENTAL AGENCIES HAVING RELEVANT JURISDICTION. ALL MAINTENANCE AND PROTECTION FTRAFFIC SHALL BE IN

36. THE CONTRACTOR SHALL BE RESPONSIBLE FOR REPLACING ALL DAMAGED STORM WATER STRUCTURES, PIPING, ENTRANCE PIPE AND HEADWALLS WHETHER SHOWN ON THE PLANS OR NOT. THE HEADWALLS SHALL BE REPLACED IN ACCORDANCE WITH F.D.O.T. STANDARD.

37. IT IS THE RESPONSIBILITY OF THE CONTRACTOR TO ESTABLISH IN THE FIELD THE RIGHT-OF-WAY LINES, BASE LINES

39. A RIGHT OF ENTRY AGREEMENT SHALL BE OBTAINED BY THE CONSTRUCTION MANAGER FROM THE PROPERTY OWNER BEFORE ANY DRIVEWAY CONSTRUCTION WORK IS DONE OUTSIDE OF THE RIGHT-OF-WAY OR EASEMENT.

40. LOCATIONS, ELEVATIONS AND DIMENSIONS OF EXISTING UTILITIES, STRUCTURES AND OTHER FEATURES ARE SHOWN TO THE BEST INFORMATION AVAILABLE AT THE TIME OF PREPARATION OF THESE PLANS BUT DO NOT PURPORT TO BE ASSOLUTED CORRECT. THERE MAY BE OTHER IMPROVEMENTS, UTILITIES, ETC. WHICH ARE WITH THE PROJECT AREA AND WHICH HAVE NOT BEEN LOCATED OR IDENTIFIED, MAY NOT BE IN THE EXACT LOCATION SHOWN OR RELOCATED SINCE THE PREPARATION OF THESE PLANS. THE CONTRACTOR SHALL VERIEY, PRIOR TO CONSTRUCTION, THE LOCATIONS, ELEVATIONS AND DIMENSIONS OF ALL EXISTING UTILITIES STRUCTURES AND OTHER FEATURES (WHETHER OR NOT SHOWN

SOUNTHE PLANS) THAT MAY EFFECT HIS WORK. ALL EXISTING UTILITIES 3 HOUTERS AND OF THE PLAND, CROSED OR CONNECTION POINTS SHALL BE EXPOSED PRIOR TO CONSTRUCTION TO VERIFY LOCATION AND ELEVATION. ANY DISCREPANCIES OR CONFLICTS FOUND SHALL BE BEROUGHT TO THE ENGINEERS ATTENTION FOR RESOLUTION.

41. THE CONTRACTOR SHALL PROTECT ALL EXISTING STRUCTURES, WATER AND SEWER LINES, STORM DRAINS, UTILITIES, DRIVEWAYS, SIDEWALKS, SIONS, MAIL BOXES, FENCES, TREES, LANDSCAPING, AND ANY OTHER IMPROVEMENT OR FACILITY IN THE CONSTRUCTION AREA THE CONTRACTOR SHALL REPAIR AND/OR REPLACE ANY DAMAGED ITEM DUE TO HIS CONSTRUCTION ACTIVITIES TO EQUAL OR BETTER THAN PRE-CONSTRUCTION CONDITIONS AT NO ADDITIONAL COST TO THE

42. THE CONTRACTOR SHALL USE APPROPRIATE TECHNIQUES, AS APPROVED, RECOMMENDED OR OFFERED BY FLORIDA POWER ADULTION. THOUSAND FOR THE ABOUT TO PREVENT UNDERMINING OF POWER POLES SUBJUING CONSTRUCTION. IF HOLDING OF POWER POLES IS RECOMMENDED OR REQUIRED BY THE UTILITY. THE CONTRACTOR SHALL COORDINATE THIS ACTIVITY WITH THE UTILITY.

43. ANY TEMPORARY SHUTDOWNS FOR MODIFICATIONS OF EXISTING UTILITY SYSTEMS THAT MUST REMAIN IN SERVICE DURING CONSTRUCTIONS SHALL BE KEPT TO A MINIMUM AND SHALL BE COORDINATED WITH AND APPROVED BY THE MANATEE COUNTY UTILITY OPERATIONS DEPARTMENT IN ACCORDANCE WITH THE CONTRACT DOCUMENTS. IT IS NOTED THAT TEMPORARY SHUTDOWNS MAY BE RESTRICTED TO CERTAIN HOURS AT ANY TIME OF THE DAY OR NIGHT AND WILL BE COMPLETED AT NO ADDITIONAL COST TO THE OWNER.

44. THE ELEVATIONS OF THE UTILITY SERVICES AND LATERALS HAVE BEEN ASSUMED ON THE BASIS OF TYPICA THE ELEVATIONS OF THE UTILITY SERVICES AND LATERALS HAVE BEEN ASSUMED ON THE BASIO OF TYPICAL ANTICIPATED SOIL COVERAGE CONTRACTOR SHALL NOT RELY ON THIS INFORMATION FOR CONSTRUCTION, BUT SESPONSIBLE FOR FIELD LOCATIONS (HORIZONTAL AND VERTICAL) OF ALL UTILITIES CROSSING THE PROPOSED MAIN. CONTRACTOR SHALL INCLUDE IN THE UNIT COST OF THE SUBJECT CONSTRUCTION, THE COST OF UTILITY ADJUSTMENTS NECESSARY TO ATTAIN DESIGN MINIMUM SEPARATION FOR UTILITIES CONFLICTING WITH THE CONSTRUCTION OF THE PROPOSED. INTERRUPTIONS OF ANY EXISTING UTILITY SERVICES SHALL BE NOTICED TEFFECTED CUSTOMERS A MINIMUM OF 48 HOURS IN ADVANCE AND SHALL NOT EXCEED 4 HOURS IN DURATION.

45. ALL RESTORATION WORK PERFORMED THROUGHOUT THE PROJECT SHALL CONFORM TO EXISTING LINES AND GRADES UNLESS SHOWN OTHERWISE.

47. ALL CONCRETE THRUST BLOCKS INSTALLED FOR TESTING PURPOSES AND NOT REQUIRED FOR THE OPERATION OF THE PIPELINE SHALL BE REMOVED AND DISPOSED OF BY THE CONTRACTOR, PRIOR TO FINAL ACCEPTANCE, AT NO ADDITIONAL COST TO THE OWNER.

49. CONCRETE DRIVEWAYS OR SIDEWALKS THAT ARE CUT SHALL BE RESTORED TO MATCH EXISTING ACCORDING TO THE CURRENT EDITIONS OF THE F.D.O.T. SPECIFICATIONS FOR ROAD AND BRIDGE DESIGN. SECTION 322, AND SECTION 310 OF THE F.D.O.T. DESIGN STANDARDS AND MANATEE COUNTY PUBLIC WORKS STANDARD UNLESS SHOWN OTHERWISE.

50. WHENEVER A PERMANENT ROADWAY SURFACE IS NOT REPLACED IMMEDIATELY AFTER BACKFILLING AND COMPACTION OF THE NEWLY INSTALLED PIPE LINE IN AREAS WHERE TRAFFIC MUST PASS, THE CONTRACTOR SHALL INSTALL A TEMPORAF SURFACE CONSISTING OF NINE INCHES OF COMPACTED LIME ROCK BASE AND A COAT OF ASPHALT EMULSION. PERMANEN. ROADWAY REPAIR SHALL BE PERFORMED A MAXIMUM OF TWENTY-ONE CALENDAR DAY'S AFTER THE INITIAL OPEN CUTTING.

51. RESTORATION OF CURBS, DRIVEWAYS, SIDEWALKS, AND PLACEMENT OF SOD SHALL BE COMPLETED WITHIN FORTY-FIVE CALENDAR DAYS OF INITIAL DISTURBANCE, OR TWENTY-ONE CALENDAR DAYS OF SUBSTANTIAL COMPLETION, WHICHEVER OCCURS FIRST. THE MINIMUM CUBB REPLACEMENT LENGTH IS TEN (10) FEET. 52. ALL EXISTING FENCES DISTURBED DURING CONSTRUCTION SHALL BE REPAIRED OR REPLACED AND REINSTALLED BY THE CONTRACTOR AT NO ADDITIONAL COST TO THE OWNER UNLESS SHOWN TO BE REMOVED ON CONSTRUCTION PLANS.

53. WHERE CONCRETE REPAIRS ARE NECESSARY AND EXPANSION OR CONTRACTION JOINTS ARE PRESENT, CONTRACTOR SHALL

54. THE EXHAUST SYSTEM OF ALL GASOLINE AND DIESEL ENGINES SHALL BE EQUIPPED WITH MUFFLERS THAT MEET THE EQUIPMENT MANUFACTURER'S REQUIRMENT'S FOR NOISE SUPPRESSION. THE CONTRACTOR SHALL INSTALL NOISE ABATEMENT BAFFLES POSITIONED TO BREAK LINE-OF-SITE FROM THE NOISE SOURCE TO AFFECTED RESIDENCES, AS APPROVED BY THE ENGINEER.

55. NO MATERIAL SHALL BE STOCKPILED IN ROADWAYS. ALL DIRT AND DEBRIS SHALL BE REMOVED FROM THE JOB SITE DAILY. ROADS SHALL BE SWEPT DAILY AS PART OF DAILY CLEAN UP.

56. THE CONTRACTOR IS TO CONTROL ALL FUGITIVE DUST ORIGINATING ON THIS PROJECT BY WATERING OR OTHER METHODS 57. INGRESS AND EGRESS TO ALL THE PROPERTIES IN THE CONSTRUCTION AREA SHALL BE MAINTAINED AT ALL TIMES. 58. PRIOR APPROVAL WILL BE REQUIRED FOR REMOVAL OR TRIMMING OF ANY TREE WITHIN THE CONSTRUCTION AREA.

59. THE CONTRACTOR SHALL PROVIDE ALL DEWATERING EQUIPMENT NECESSARY TO KEEP ALL EXCAVATIONS DRY. DEWATERING

60. ALL PIPING AND FITTINGS USED ON THIS PROJECT SHALL BE AS NOTED ON THE PLANS AND IN THE CONTRACT DOCUMENT AND SHALL BE INSTALLED TO THE LINES AND GRADES SHOWN ON THE PLANS AND PROFILES.

63. ALL ROCKS OR STONES LARGER THAN SIX INCH DIAMETER SHALL BE REMOVED FROM THE BACKFILL MATERIAL. BACKFILL MATERIAL PLACED WITHIN ONE FOOT OF PIPING AND APPURTENANCES SHALL NOT CONTAIN ANY STONES LARGER THAN TWO INCH DIAMETER.

62. WHERE IT IS NECESSARY TO DEFLECT PIPE EITHER HORIZONTALLY OR VERTICALLY, PIPE DEFLECTION SHALL NOT EXCEED 75% OF THE MANUFACTURER'S MAXIMUM ALLOWABLE RECOMMENDED DEFLECTION.

64. ONLY MANATEE COUNTY UTILITY OPERATIONS STAFF ARE AUTHORIZED TO OPERATE VALVES AND PUMP STATIONS ON COUNTY OWNED AND MAINTAINED UTILITY SYSTEMS.

65. THE CONTRACTOR, PRIOR TO ANY TEMPORARY WATER SHUT-OFFS DURING WATER MAIN TIE-IN, ETC., SHALL NOTIFY THE

REMOVE AND REPLACE CONCRETE UP TO THE NEXT EXPANSION OR CONTRACTION JOIN

61. ALL PIPE SHALL BE COLOR CODED TO CONFORM TO MANATEE COUNTY STANDARDS.

48 ALL DRIVEWAYS LINESS OTHERWISE INDICATED SHALL BE RESTORED PER DRIVEWAY RESTORATION DETAIL

BENCH MARKS (FIEV.), CENTER LINES, AND STATIONING AS REQUIRED TO CONSTRUCT THIS PROJECT

ACCORDANCE WITH THE APPLICABLE REQUIREMENTS OF THE CURRENT FLORIDA DEPARTMENT OF TRANSPORTATION
"MANUAL OF TRAFFIC CONTROL AND SAFE PRACTICES". A TRAFFIC CONTROL PLAN SHALL BE SUPPLIED BY THE CONTRACTOR
AT THE PRE-CONSTRUCTION MEETING.

LENA ROAD UTILITY RELOCATIONS CHECKED BY SLB MANATEE COUNTY

TED RESIDENTS BY POSTING INFORMATIONAL SIGNS IN THE NEIGHBORHOOD AT LEAST TWO DAYS (48 HRS) PRI AFFELIEURES DE FOSTIMENT DE FOSTIMENTATION STORM IN THE MEDITION DE RECEIVE WITH DESTRUCTION OF THE SPECIFICATIONS. WHO PAIS HIS TRAIN OF THE SPECIFICATIONS. WHEN FEASIBLE, DOOR HANGERS' SHALL BE DELIVERED TO AFFECTED RESIDENCES AT LEAST TWO DAYS (48 HRS) PRIOR TO WATER SHOT OF THE CONTRACTOR SHALL ASSO MAKE EXTENSIVE SHOT-OFF. FOR LARGE PROJECTS WITH HUNDREDS OF HOMES AFFECTED, THE CONTRACTOR SHALL ASSO MAKE EXTENSIVE USE OF THE MEDIA AND SHALL HAVE PRIOR CONTACT WITH HOMEOWNER'S ASSOCIATIONS AND THE RESPECTIVE CITY'S.
WRITTEN NOTIFICATIONS SHALL ALSO BE FAXED TO THE TAMPA TRIBUNE, BRADENTON HERALD, AMI SUN, ISLANDER,
SARASOTA HERALD TRIBUNE, WBRD RADIO, EMERGENCY COMMUNITY CENTRES, INSPECTIONS, WATER TRATRENT PLANT. NATER MANAGER HEIPLINE CUSTOMER SERVICE AND THE MANATER COUNTY UTILITY OPERATIONS DEPARTMENT

- 66. ALL TEST POINT PIPING SHALL BE CUT LOOSE FROM THE CORPORATION STOP AND COMPLETELY REMOVED AND DISPOSED OF BY THE CONTRACTOR PRIOR TO FINAL ACCEPTANCE. A CORPORATION STOP PLUG SHALL BE INSTALLED AND THE CORPORATION STOP SHALL REMAIN IN PLACE.
- 67. UNLESS OTHERWISE NOTED, ALL EXISTING MAINS THAT ARE BEING REPLACED SHALL BE ABANDONED IN PLACE UP ACCEPTANCE AND ACTIVATION OF THE NEW MAINS. ABANDONED MAINS SHALL BE CUT, GROUTED, AND CAPPED. REFER TO SECTION 02064 OF THE SPECIFICATIONS FOR CUT AND CAPPING ABANDONED PIPE.
- 68. FIELD CONDITIONS MAY NECESSITATE MINOR ALIGNMENT AND GRADE DEVIATION OF THE PROPOSED UTILITIES TO AVOID OBSTACLES, AS ORDERED BY THE ENGINEER.
- DISCHARGE APPLICATION IS REQUIRED. FILL OUT FORM AS COMPLETELY AS POSSIBLE AS MISSING INFORMATION DELAYS THE APPROVAL PROCESS.
- 70. THE MCUD OFFICE OF INDUSTRIAL COMPLIANCE WILL DETERMINE WHETHER A LETTER OF APPROVAL, A DISCHARGE AUTHORIZATION, OR A DISCHARGE PERMIT IS REQUIRED.
- 71. FOR SITES SUSPECTED OF CONTAMINATED GROUNDWATER MANATEE COUNTY WILL REQUIRE AN APPLICANT TO DEMONSTRATE THAT THE DISCHARGE MEETS THE MANATEE COUNTY SEWER USE ORDINANCE.
- . IF ANY RECLAIMED OR WATER MAINS INCLUDING SERVICE LINES ARE DAMAGED DURING CONSTRUCTION, THEY SHALL BE REPLACED FROM THE VALVE TO THE OTHER POINT OF CONNECTION OUTSIDE OF THE ROADWAY PER MANATEE COUNTY'S STANDARDS.

- NEW ADVANCED TRAFFIC MANAGEMENT SYSTEM (ATMS) INFRASTRUCTURE SHOULD BE PLACED WHILE LEAVING EXISTING ATMS INFRASTRUCTURE IN PLACE AND INTACT AS LONG AS FEASIBLE TO LIMIT THE DURATION OF SYSTEM DOWN TIME.
- AT LEAST FIVE (5) WORKING DAYS PRIOR TO BEGINNING CONSTRUCTION, THE CONTRACTOR SHALL CONTACT MUKUNDA GOPALARISHNA, P.E., PTOE OF THE MANATEE COUNTY TRAFFIC ENGINEERING DIVISION AT (941) 749-3500, EXT. 7813 TO INFORM THIN OF CONSTRUCTION OF DEATLOSS.
- 3. THE CONTRACTOR MUST PROVIDE A SPLICE DIAGRAM FOR THE PROPOSED SPLICE ENCLOSURE
- 4. THE CONTRACTOR SHALL NOTIFY UTILITY OWNERS OF ANY EXCAVATION OR DEMOLITION ACTIVITY THROUGH SUNSHINE ONE CALL OF FLORIDA INC. (8)1) AND SHALL ALSO NOTIFY THOSE UTILITY OWNERS/AGENCIES LISTED WITHIN OR IMPACTED BY THESE PLANS, NOT LESS THAN TWO (2) FULL BUSINESS DAYS IN ADVANCE OF BEGINNING CONSTRUCTION ON THE JOB SITE.
- THE CONTRACTOR IS RESPONSIBLE FOR COORDINATING RIGHT-OF-WAY USE PERMITS WITH MATT MERUCCI, MANATEE COUNTY PUBLIC WORKS INFRASTRUCTURE INSPECTION OFFICER, AT (941) 708-7450, EXT. 7342. THE CONTRACTOR IS RESPONSIBLE FOR COORDINATING BOND REQUIREMENTS WITH BRANDY WILKINS, MANATEE COUNTY PUBLIC WORKS SENIOR ADMINISTRATIVE SPECIALIST, AT (941) 708-7450, EXT. 7215
- 6. DELIVER THREE HARD-COPY SETS OF AS-BUILT RECORD DRAWINGS THAT ARE SIGNED AND SEALED BY THE ENGINEER OF RECORD, AND ONE COMPACT DISC OF RECORD DRAWINGS IN ADDBE ACROBAT (POP) AND AUTOCAD (DWD) FORMAT TO THE MANTATE COUNTY TRAFFIC ENGINEERING DIVISION (ATTN: MR. MUKUNDA GOPALAKRISHMA, P.E., PTOE) AT 2101 47TH TERRACE EAST BRADENTON, FL 34203. RECORD DRAWINGS MUST BE DELIVERED TO THE COUNTY AT LEAST TWO (2) BUSINESS DAYS PRIOR TO SCHEDUING THE FINAL INSPECTION.
- UPON PASSING THE FINAL INSPECTION, THE CONTRACTOR SHALL SEND A WRITTEN REQUEST TO THE MANATEE COUNTY TRAFFIC OPERATIONS DIVISION, 2904 12TH STREET COURT EAST, BRADENTON, FLORIDA 3420B (ATTN: MR. AARON BURKETT) REQUESTING TO TRANSFER MAINTENANCE FROM THE CONTRACTOR TO MANATEE COUNTY, MANATEE COUNTY WILL RESPOND WITHIN S WORKING DAYS TO ESTABLISH A TIME TABLE FOR THE TRANSFER OF MAINTENANCE

LEGEND

EXISTING WATER MAIN

EXISTING OVERHEAD

EXISTING SANITARY

PROPOSED PIPE

REMOVE EXISTING PIPE - - - w(D) - - - - w(D) - - -EXISTING RURIED FIRER - - - BE(D) - - - - BE(D) - - -EXISTING BURIED ELECTRIC ---BT(D) ----BT(D) ---EXISTING BURIED TELEPHONE ---S(D) - - - - S(D) - - -

PROPOSED BENDS AND FITTINGS PROPOSED VALVES PROPOSED REDUCERS

ノエム M

DISINFECTION AND TESTING

- 1. ALL PIPES SHALL BE DISINFECTED IN ACCORDANCE WITH AWWA STANDARD C651 (LATEST
- 2. ALLOWABLE LEAKAGE FOR PVC PRESSURE MAINS WILL BE IN ACCORDANCE WITH AWWA M23.
- 3. THE CONTRACTOR SHALL PROVIDE AT HIS OWN EXPENSE ALL NECESSARY TEST PUMPING EQUIPMENT, WATER METERS, PRESSURE GAUGES, AND OTHER COUIPMENT, MATERIAL AND FACILITIES REQUIRED FOR ALL HYDROSTATIC AND LEAKAGE TESTING, CONTRACTOR SHALL CONTACT THE UTILITY AND ENGINEER IN WRITTEN FORM, SEVENTY-TWO (72) HOURS IN ADVANCE OF PROPOSED TESTING. THE CONTRACTOR SHALL PERFORM SATISFACTORY PRETESTING PRIOR TO NOTIFICATION. NO TESTING WILL BE SCHEDULED ON A MONDAY OR FRIDAY.
- THE WATER SYSTEM SHALL BE TESTED FOR LEAKAGE AT 150 PSI FOR TWO (2) HOURS, WITH ALLOWABLE LEAKAGE IN ACCORDANCE WITH AWWA STANDARD C600 (LATEST EDITION) THERE SHALL BE NO WORK OR ACTIVITY DURINE PRESSURE TEST.
- CONTRACTOR SHALL OBTAIN A COPY OF THE FDEP WATER SYSTEM PERMIT AND PULL BACTERIOLOGICAL TEST SAMPLE FROM THE SAMPLE POINTS SPECIFIED IN THAT PERMIT TESTING SHALL BE PERFORMED IN THE FOLLOWING ORDER.

THE ELEVATIONS OF THE UTILITIES MARKED WITH AN ASTERISK (*) HAVE BEEN ASSUMED ON THE THE ELEVATIONS OF THE UTILITIES MARKED WITH AN ASTERISK (*) HAVE BEEN ASSUMED ON THE BASIS OF TYPICAL ANTICIPATED SOIL COVERAGE. CONTRACTOR SHALL NOT RELY ON THIS INFORMATION FOR CONSTRUCTION, BUT SHALL BE RESPONSIBLE FOR FIELD LOCATIONS (HORIZONTAL AND VERTICAL) OF ALL UTILITIES CROSSING THE PROPOSED WATER MAIN. CONTRACTOR SHALL INCLUDE IN THE UNIT COST OF THE SUBJECT WATER MAIN CONSTRUCTION, THE COST OF UTILITY ADJUSTMENTS NECESSARY TO ATTAIN DESIGN MINIMUM SEPARATION FOR UTILITIES COMPLICITION WITH THE CONSTRUCTION OF THE PROPOSED WATER MAIN. INTERRUPTIONS OF ANY EXISTING UTILITY SERVICES SHALL BE NOTICED TO EFFECTED CUSTOMERS A MINIMUM OF 48 HOURS IN ADVANCE AND SHALL NOT EXCEED 4 HOURS IN DURATION.

WHERE CONCRETE REPAIRS ARE NECESSARY AND EXPANSION JOINTS ARE PRESENT, CONTRACTOR THE NEWVE AND REPLACE CONCRETE UP TO THE NEXT EXPANSION JOINT; OTHERWISE, REPLAC CONCRETE AS NECESSARY.

LICENSED PROFESSIONAL

FL DATE:

JORDAN W WAIKER PE FL LICENSE NUMBER 78652

2

SHEET NUMBER

GENERAL NOTES

8/3/2023 10:38 AM DEFAULT

THIS ITEM HAS BEEN DIGITALLY SIGNED AND SEALED BY

ON THE DATE ADJACENT TO THE SEAL

PRINTED COPIES OF THIS DOCUMENT ARE NOT CONSIDERED SIGNED AND SEAFED AND THE SIGNATURE MUST BE VERIFIED ON ANY ELECTRONIC COPIES

KIMLEY-HORN AND ASSOCIATES, INC. 200 CENTRAL AVENUE, SUITE 600, ST. PETERSBURG, FL 33701 JORDAN W. WALKER, P.E. NO.: 78652

THE ABOVE NAMED PROFESSIONAL ENGINEER SHALL BE RESPONSIBLE FOR ALL SHEETS IN THIS PLAN SET ACCORDANCE WITH RULE 61G15-23.004, F.A.C.

No. REVISIONS DATE BY

Kimley≫**Horn**

KIMLEY-HORN AND ASSOCIATES, INC.

200 CENTRAL AVENUE, SUITE 600, ST. PETERSBURG, FL 33701
PHONE: (727) 547-3999
WWW.KIMLEY-HORN.COM

PROJECT NO.
148400103

DATE
8/3/23

SCALE AS SHOWN
DESIGNED BY JWW



DRAWN BY BMS
CHECKED BY SLB MANATEE COUNTY

LENA ROAD UTILITY RELOCATIONS

FL DATE:

LICENSED PROFESSIONAL

78652


JORDAN W.
WALKER, P.E.
FLUCENSE NUMBER


SIGNATURE SHEET


SHEET NUMBER


3


8/3/2023 10:38 AM DEFAULT

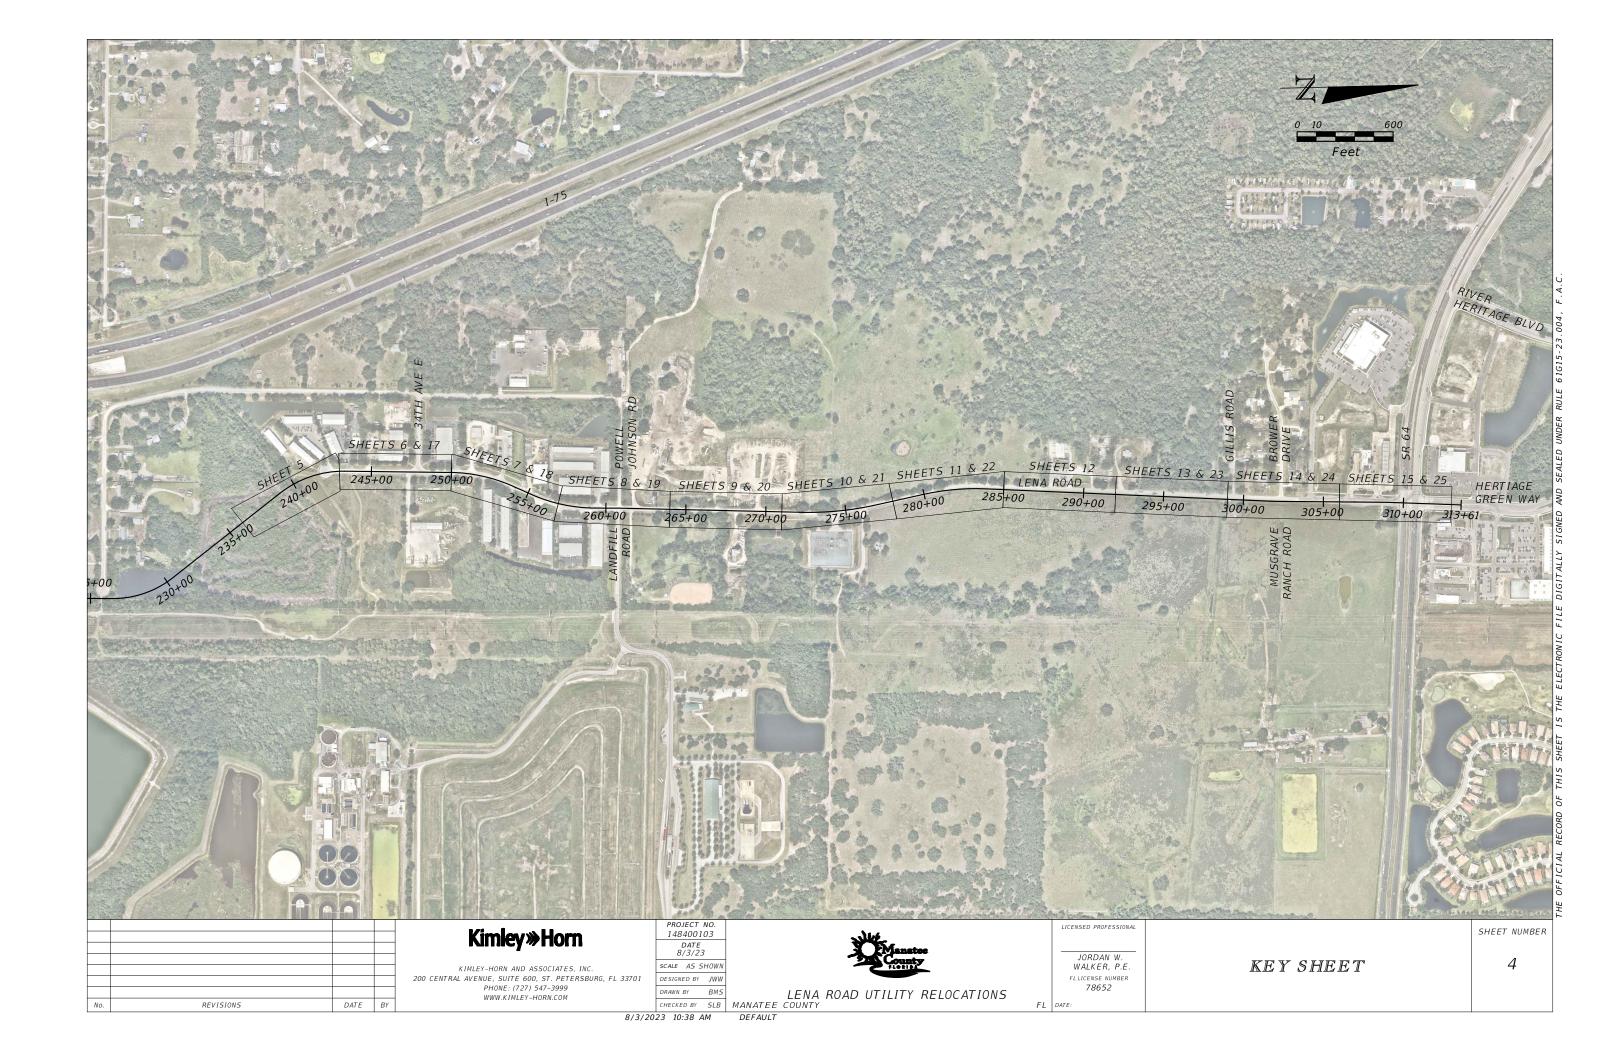


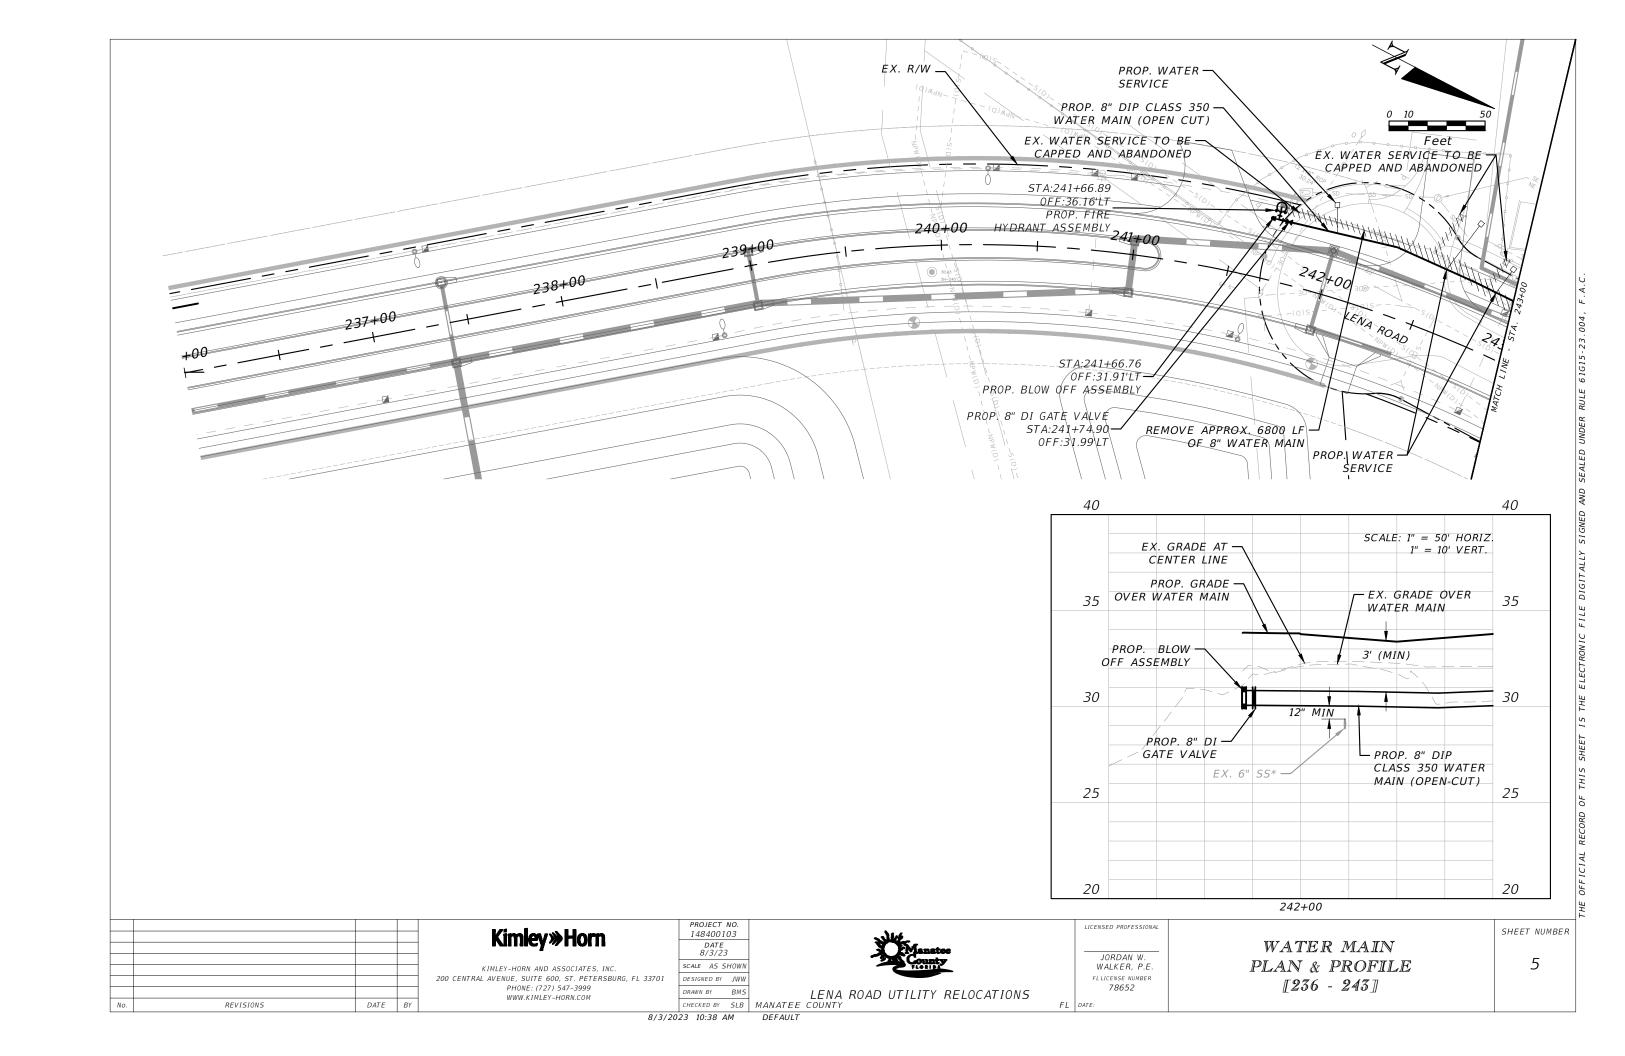


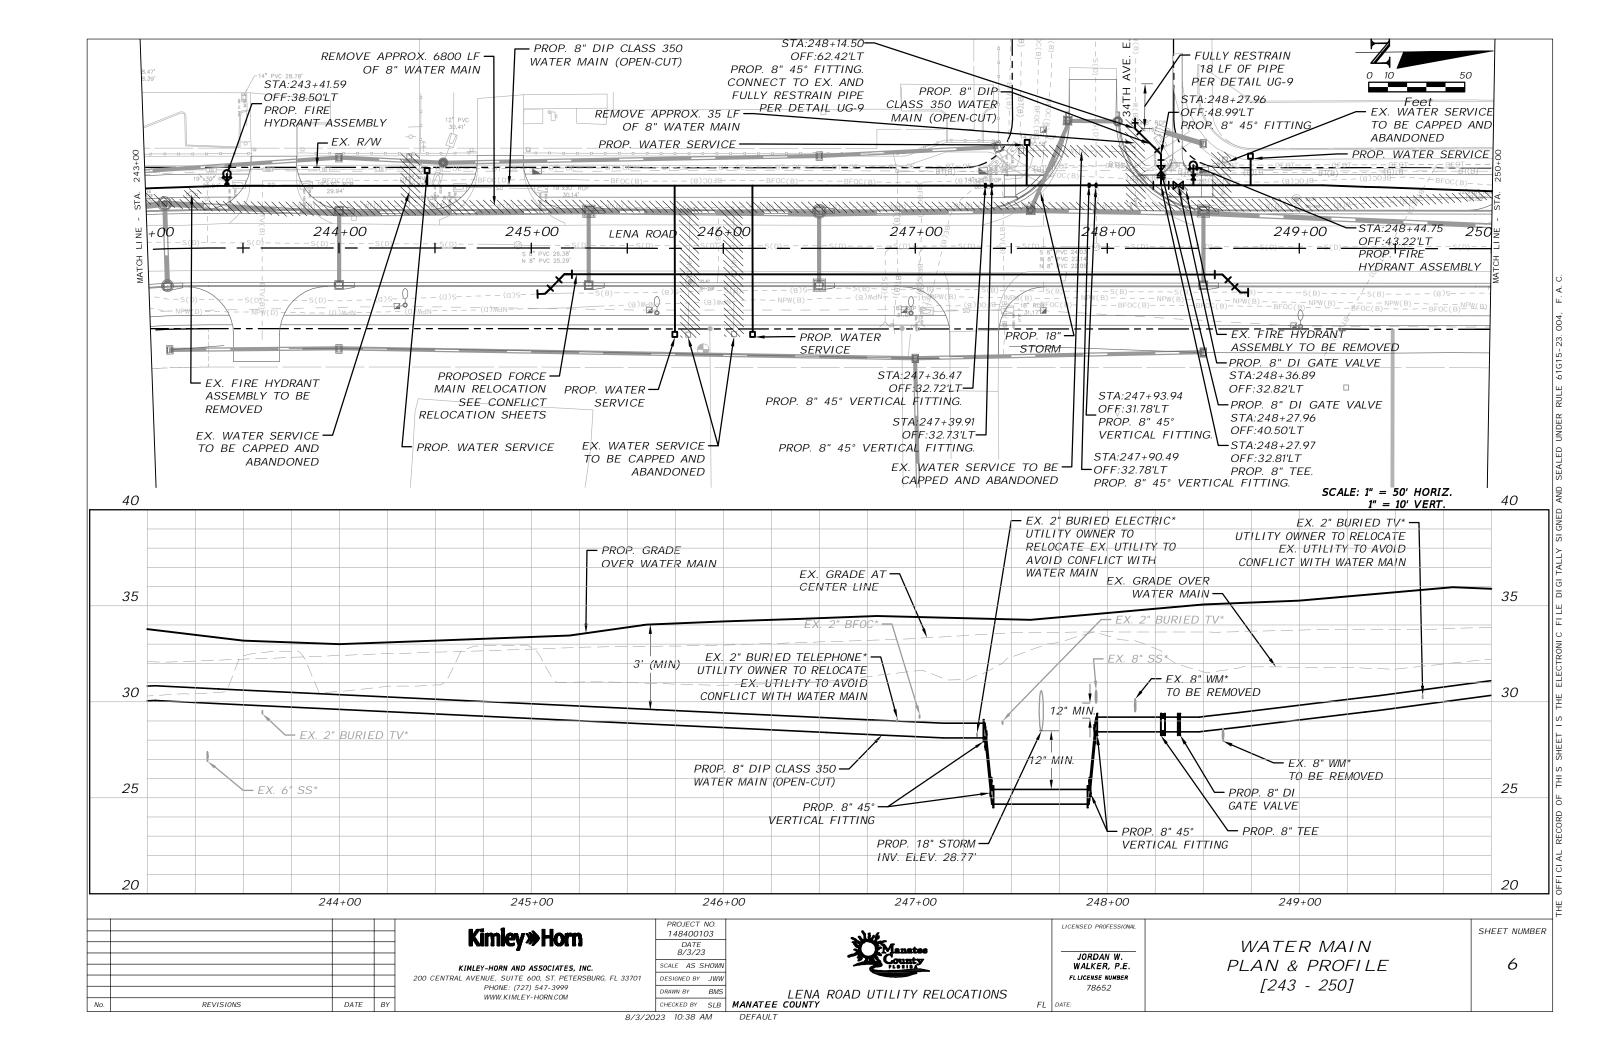


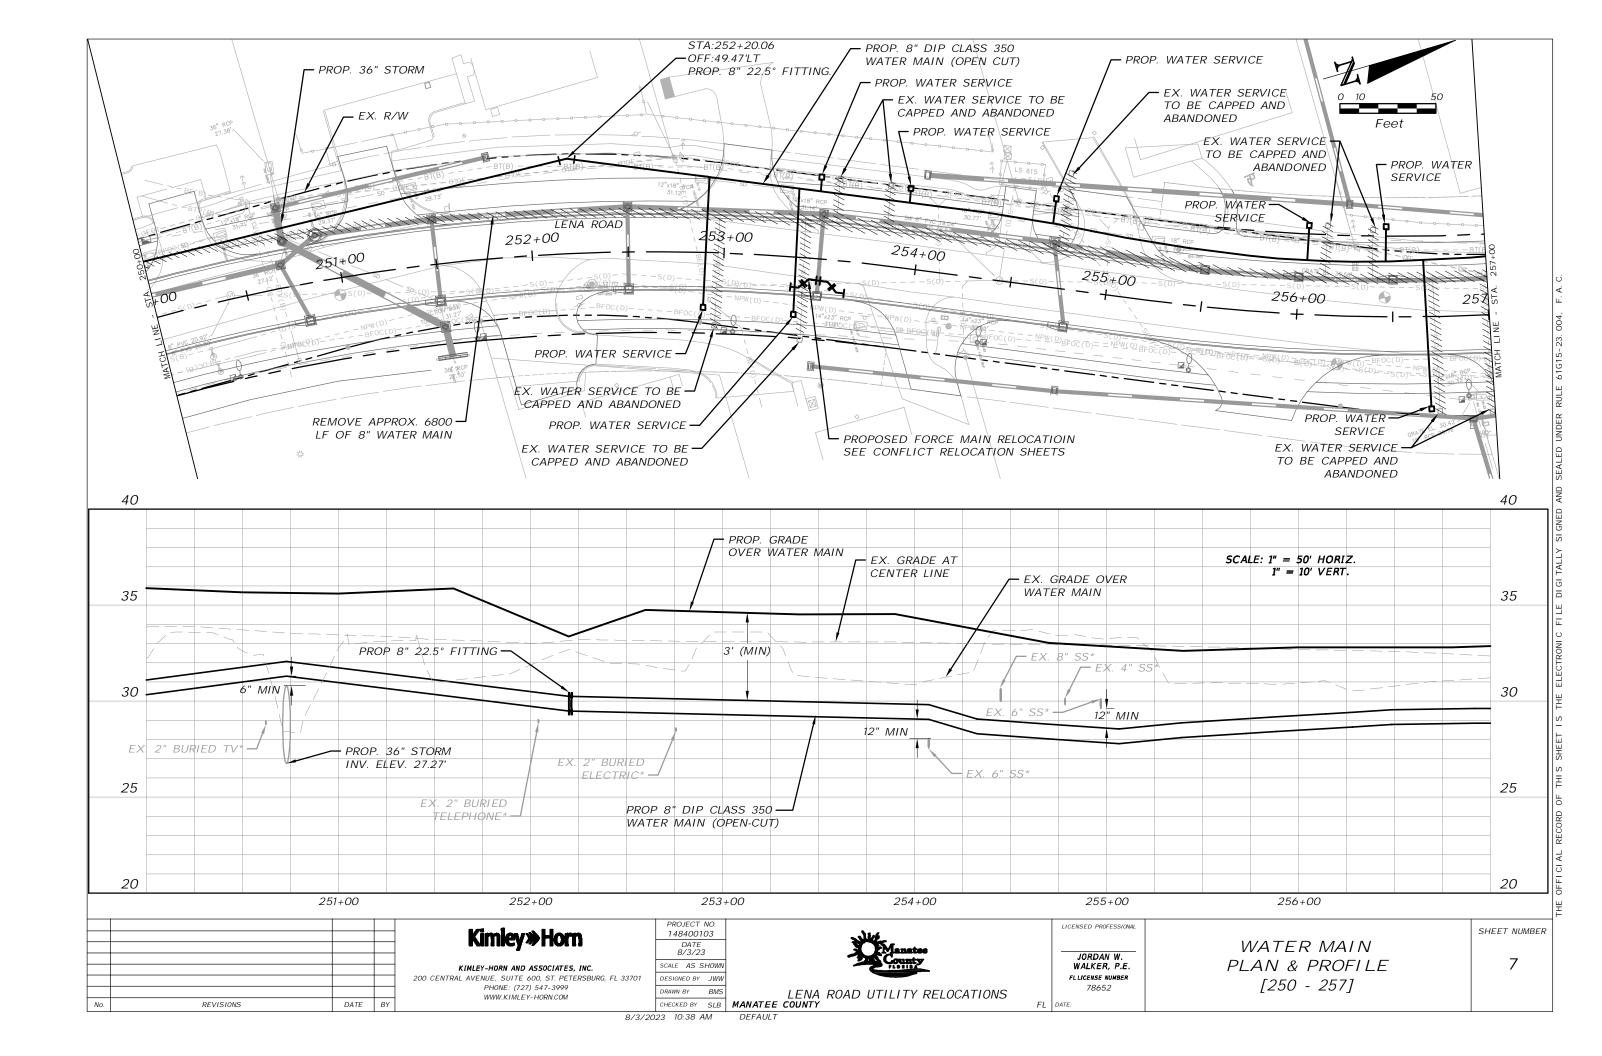


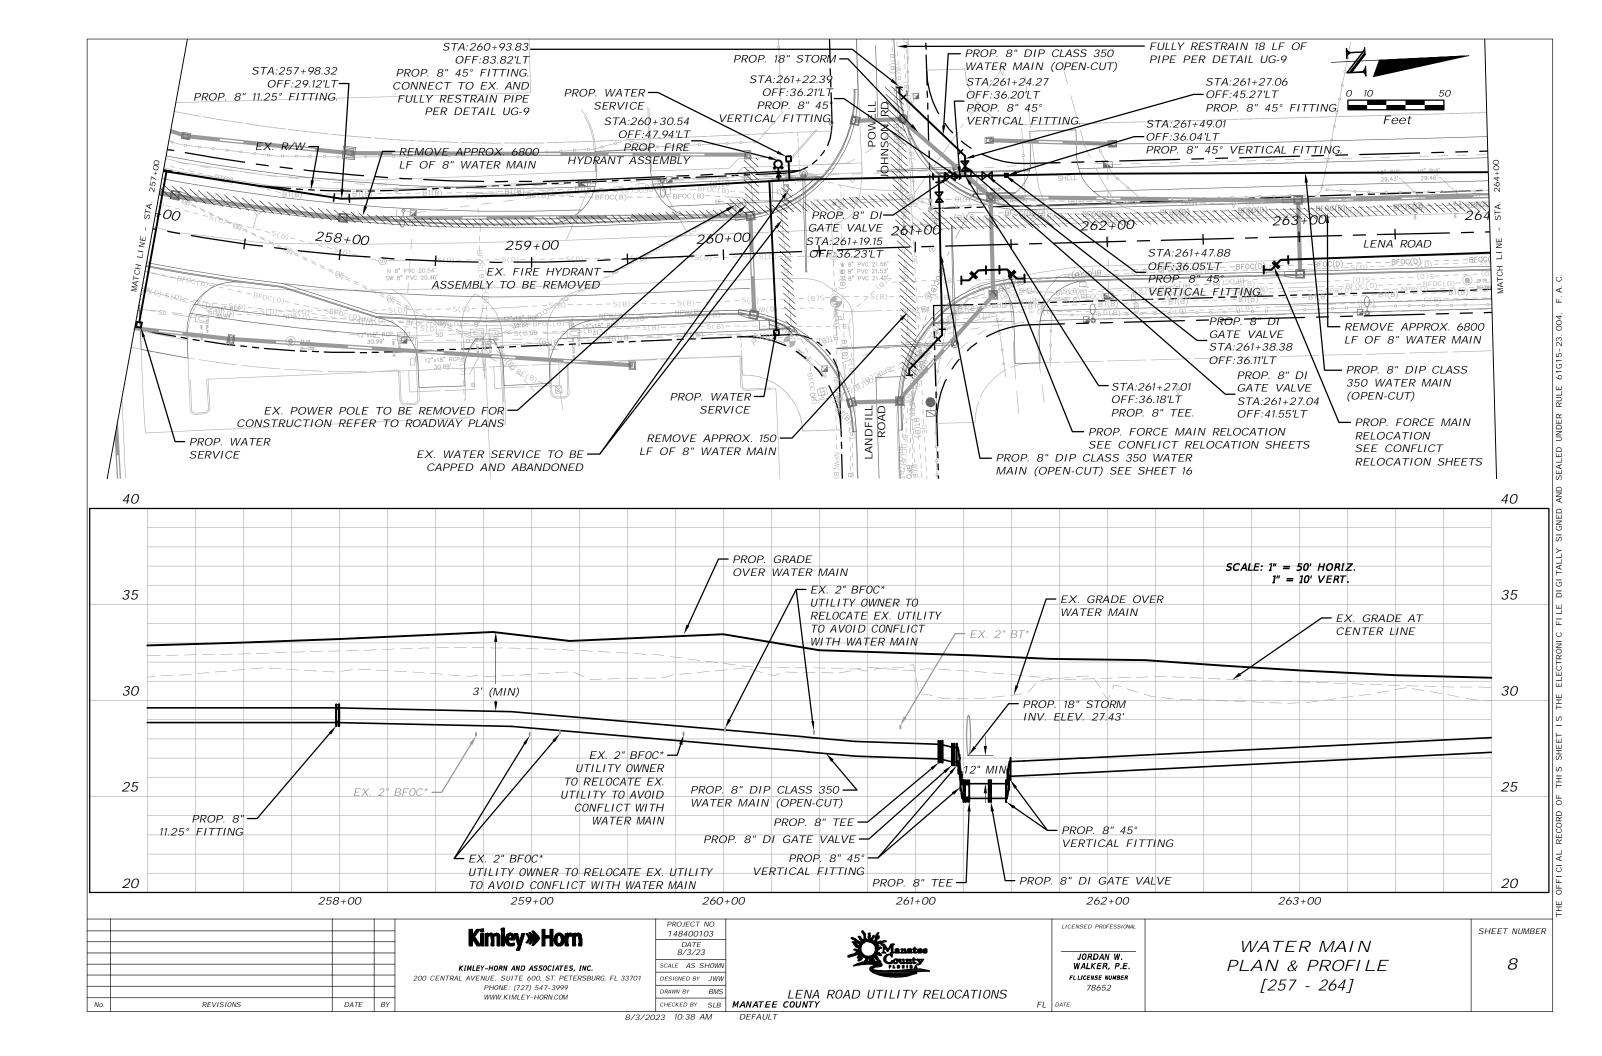


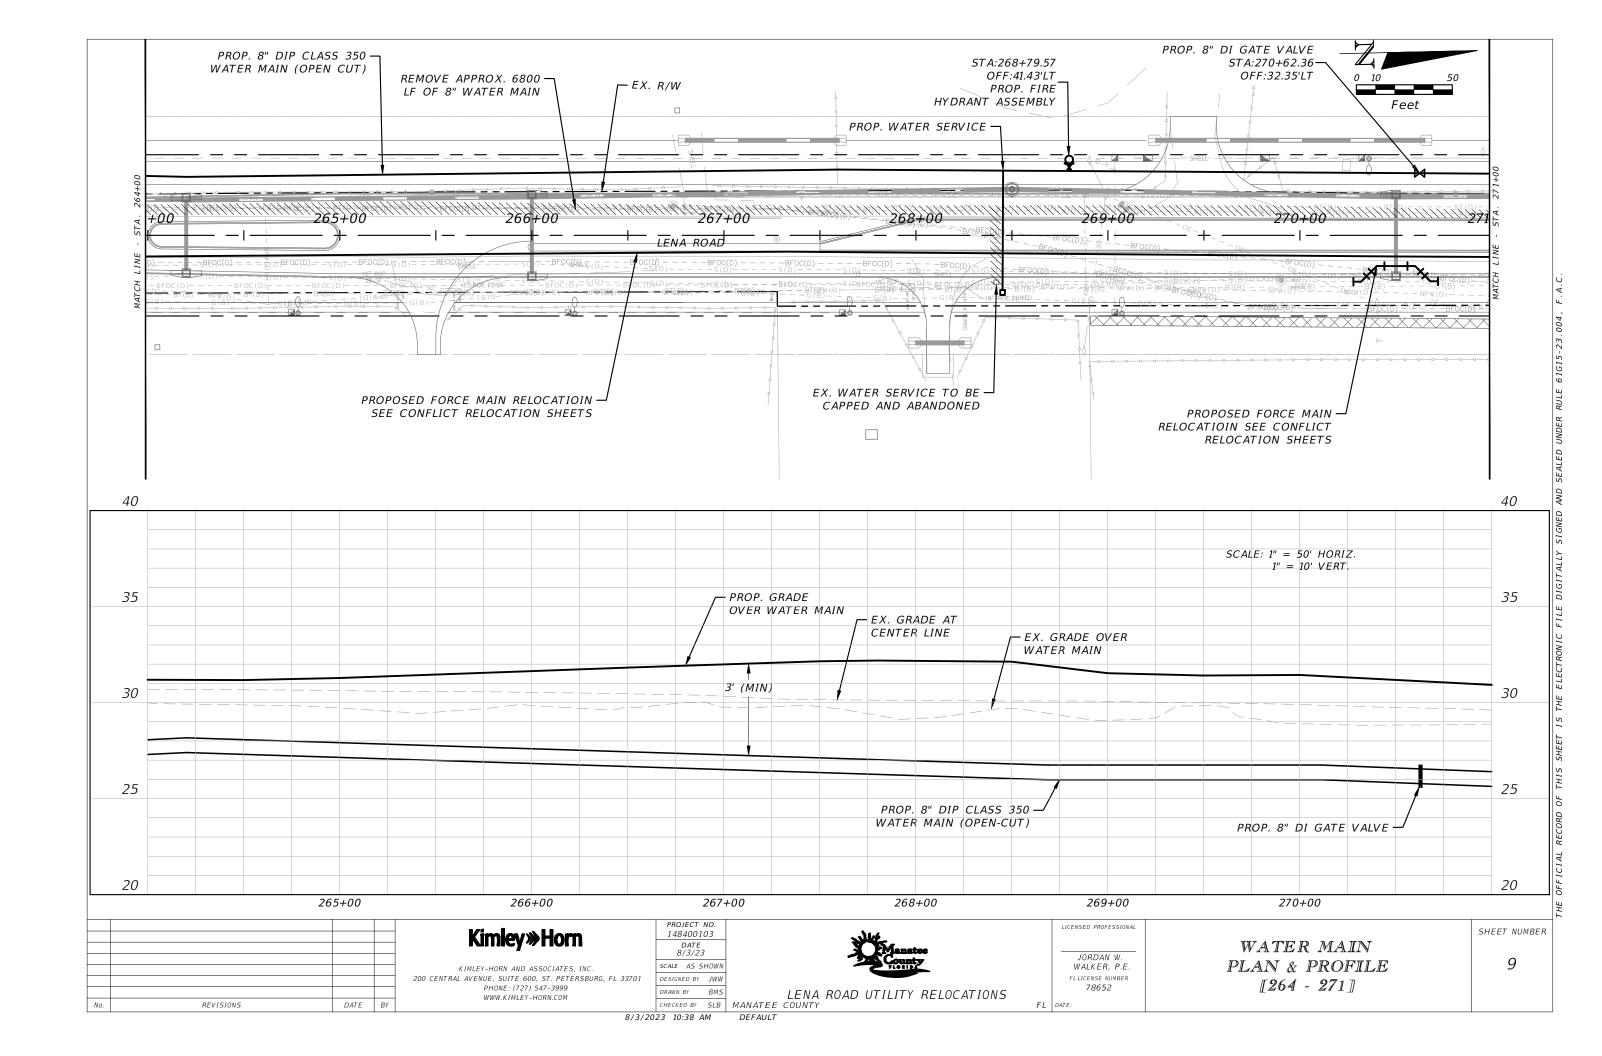


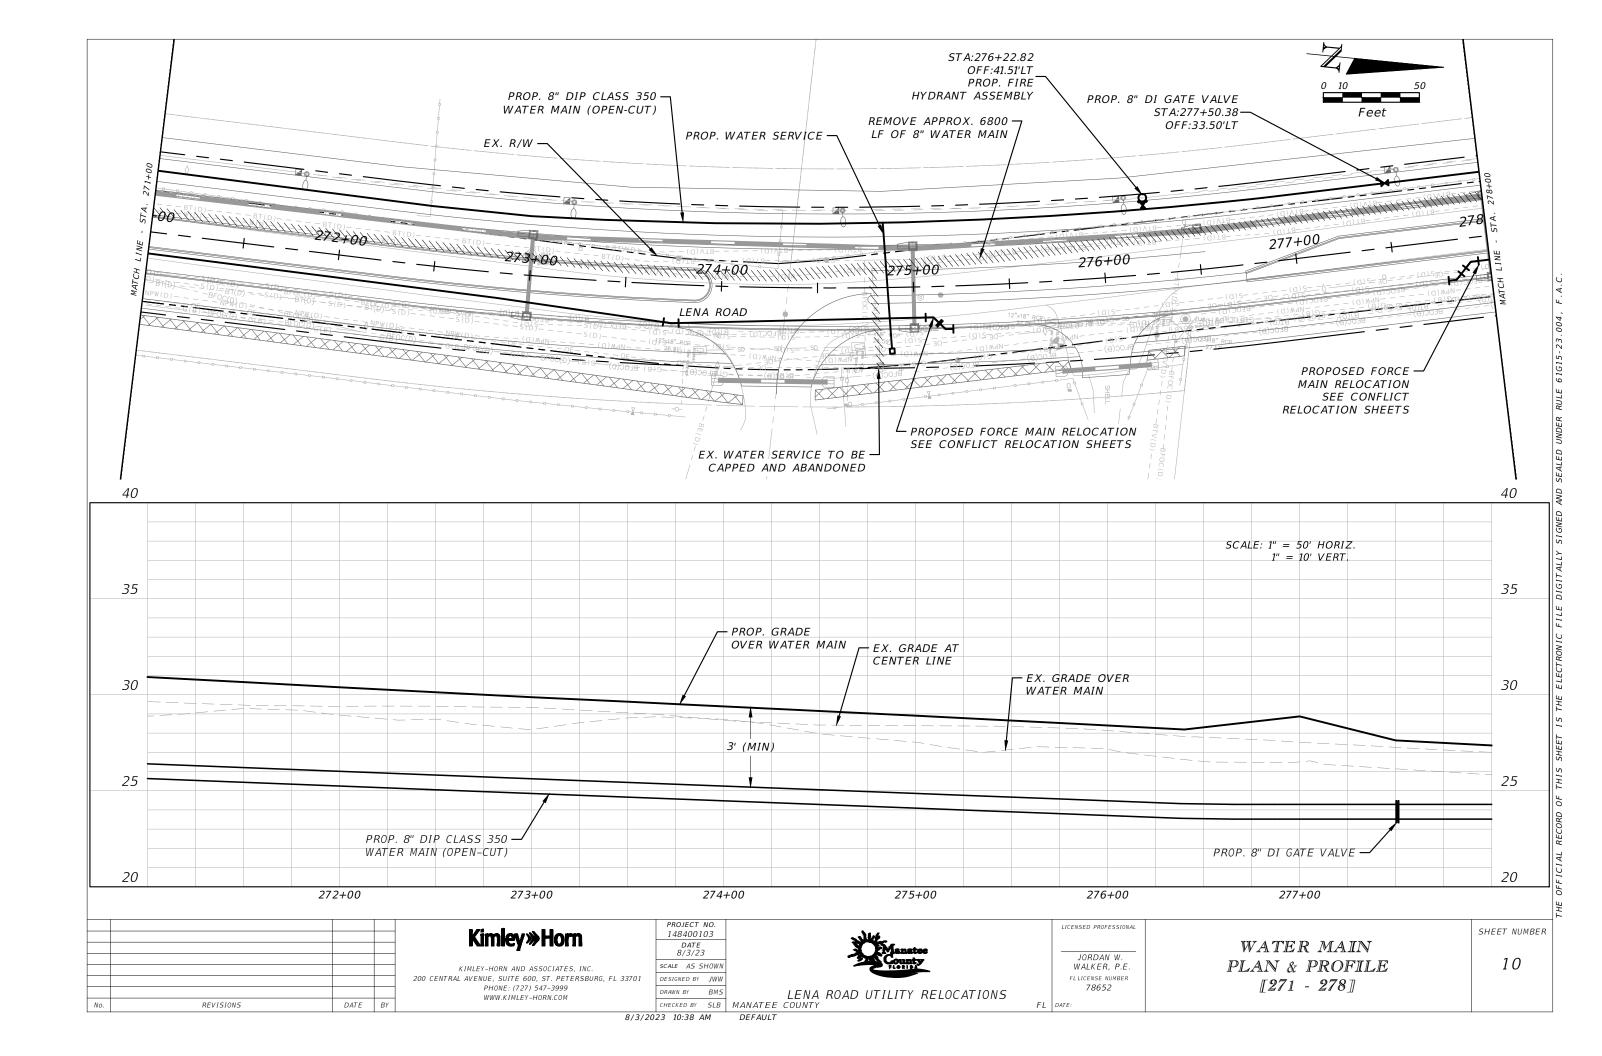


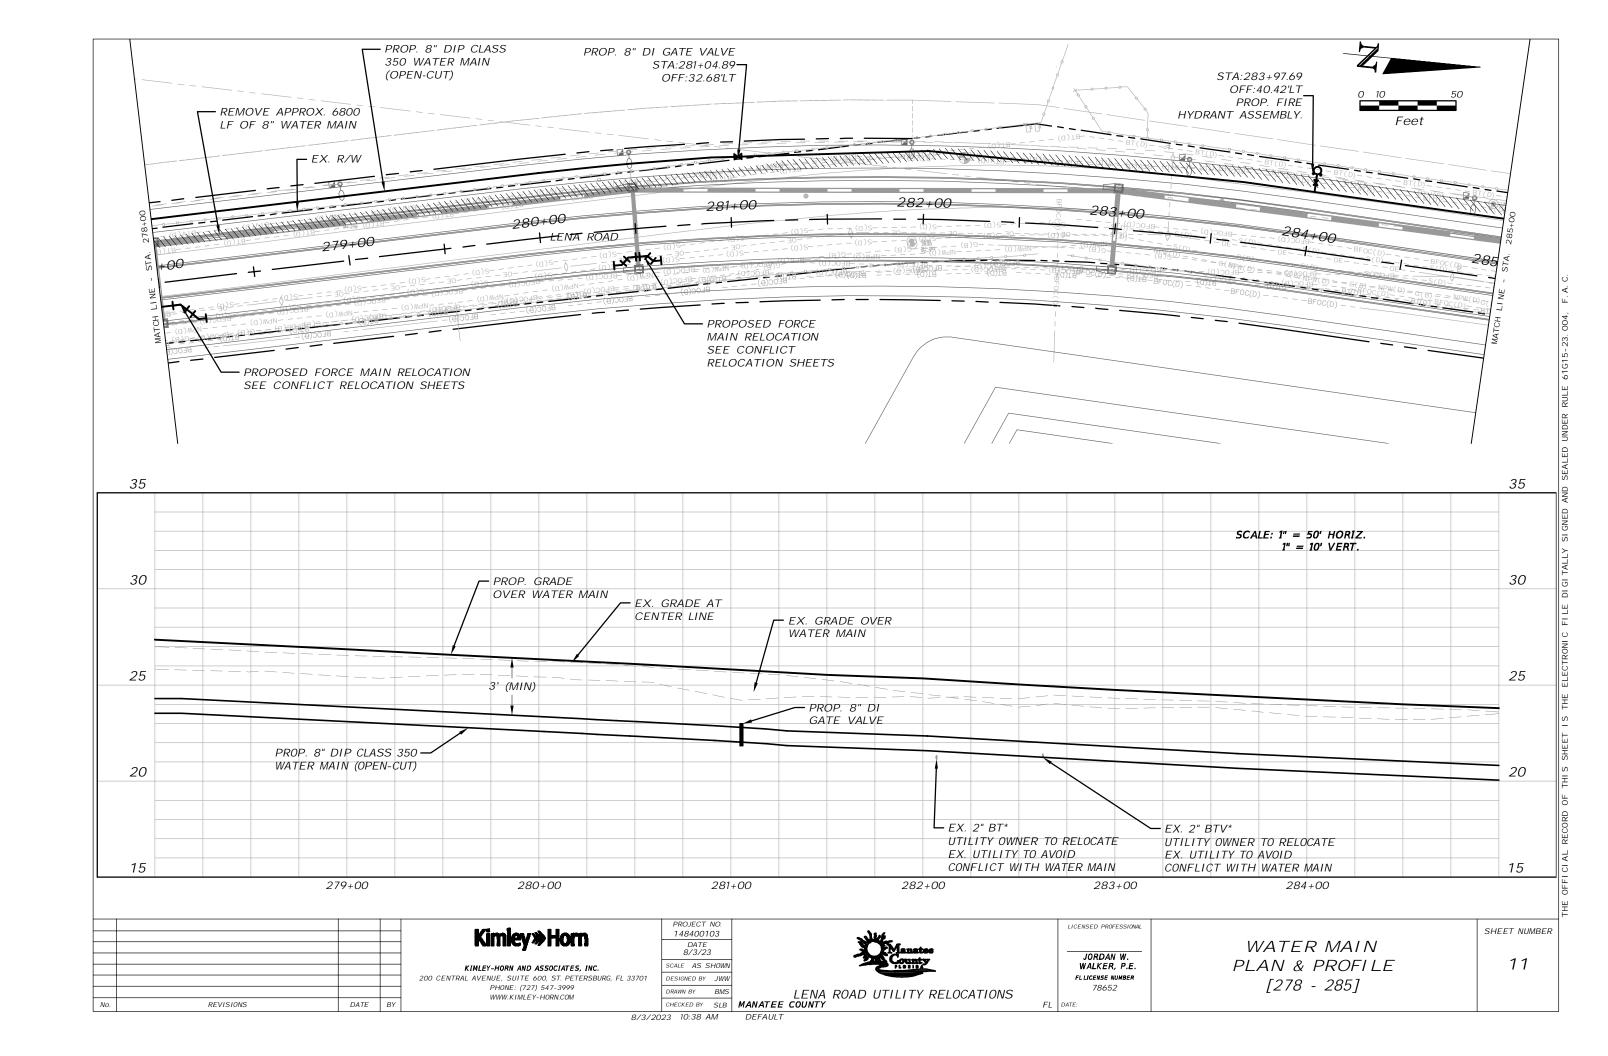


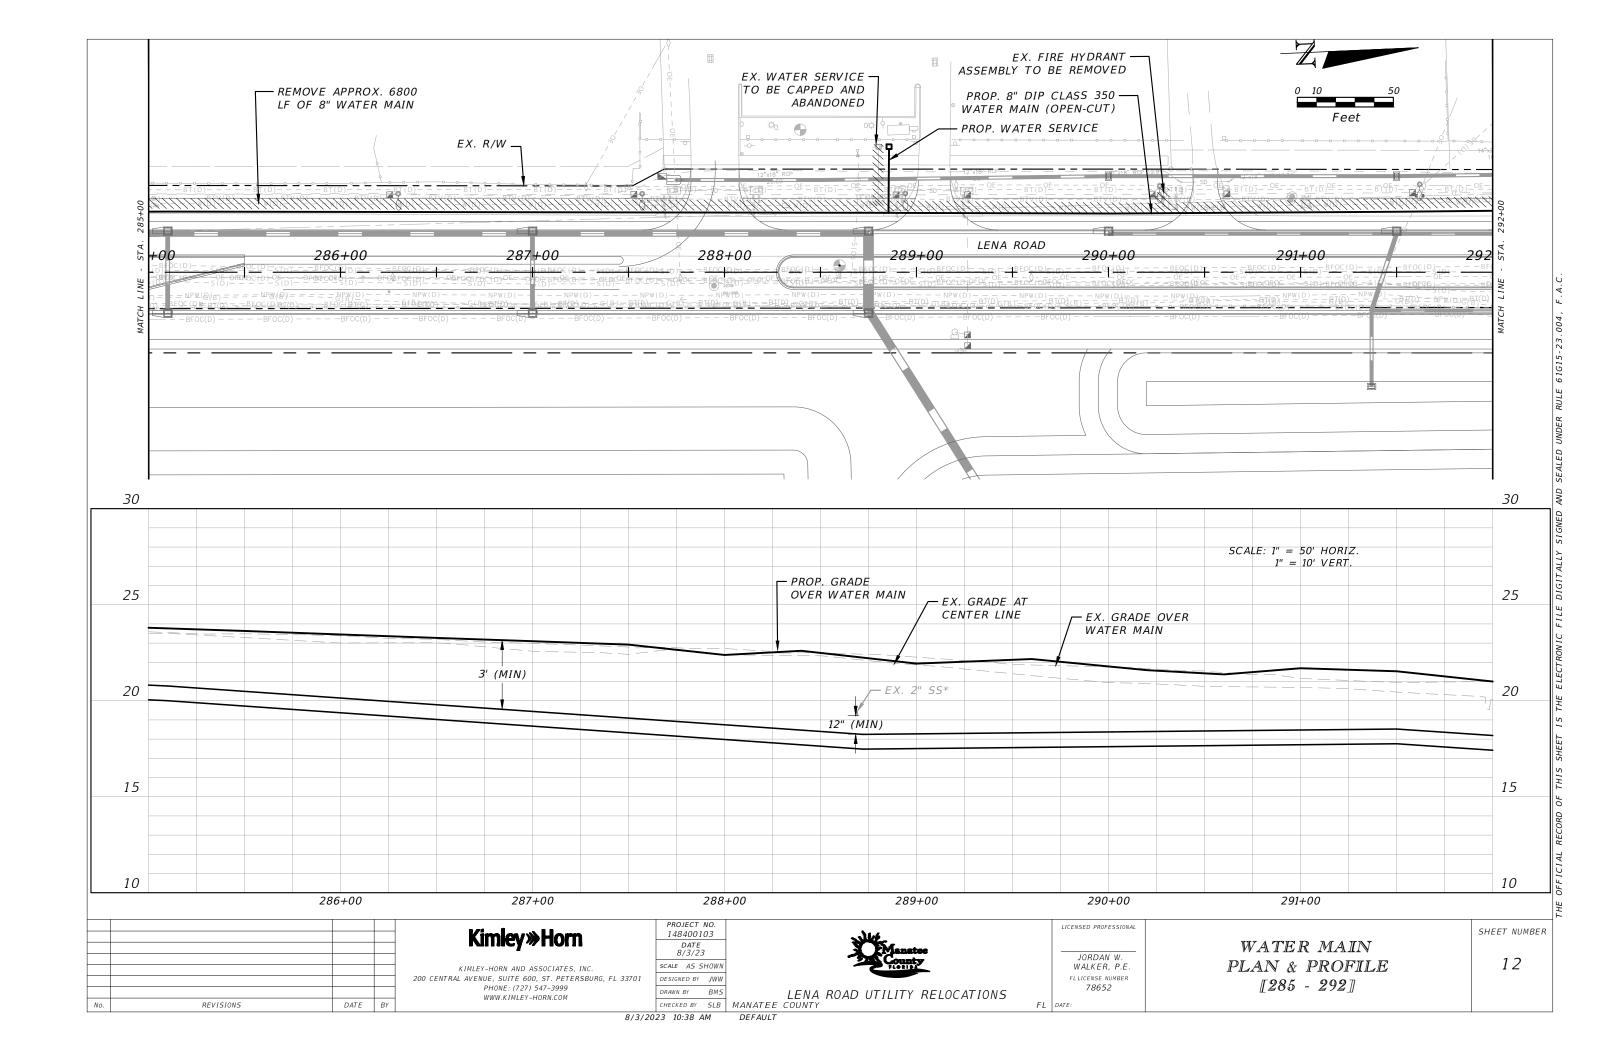


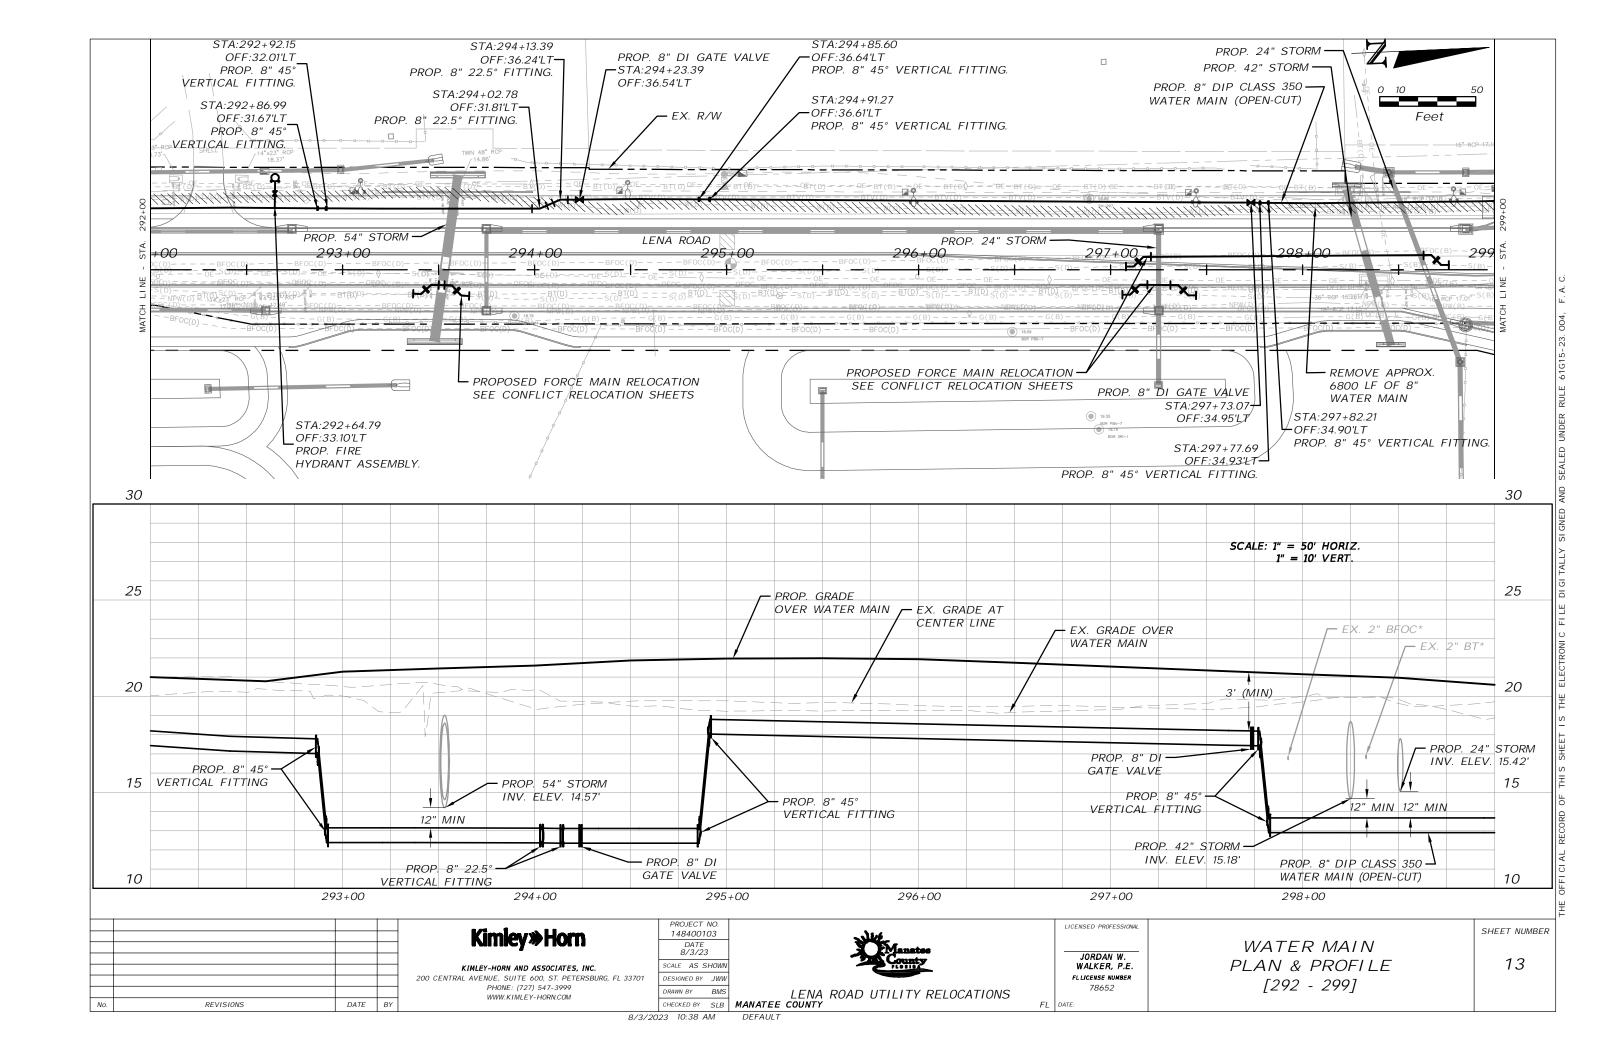


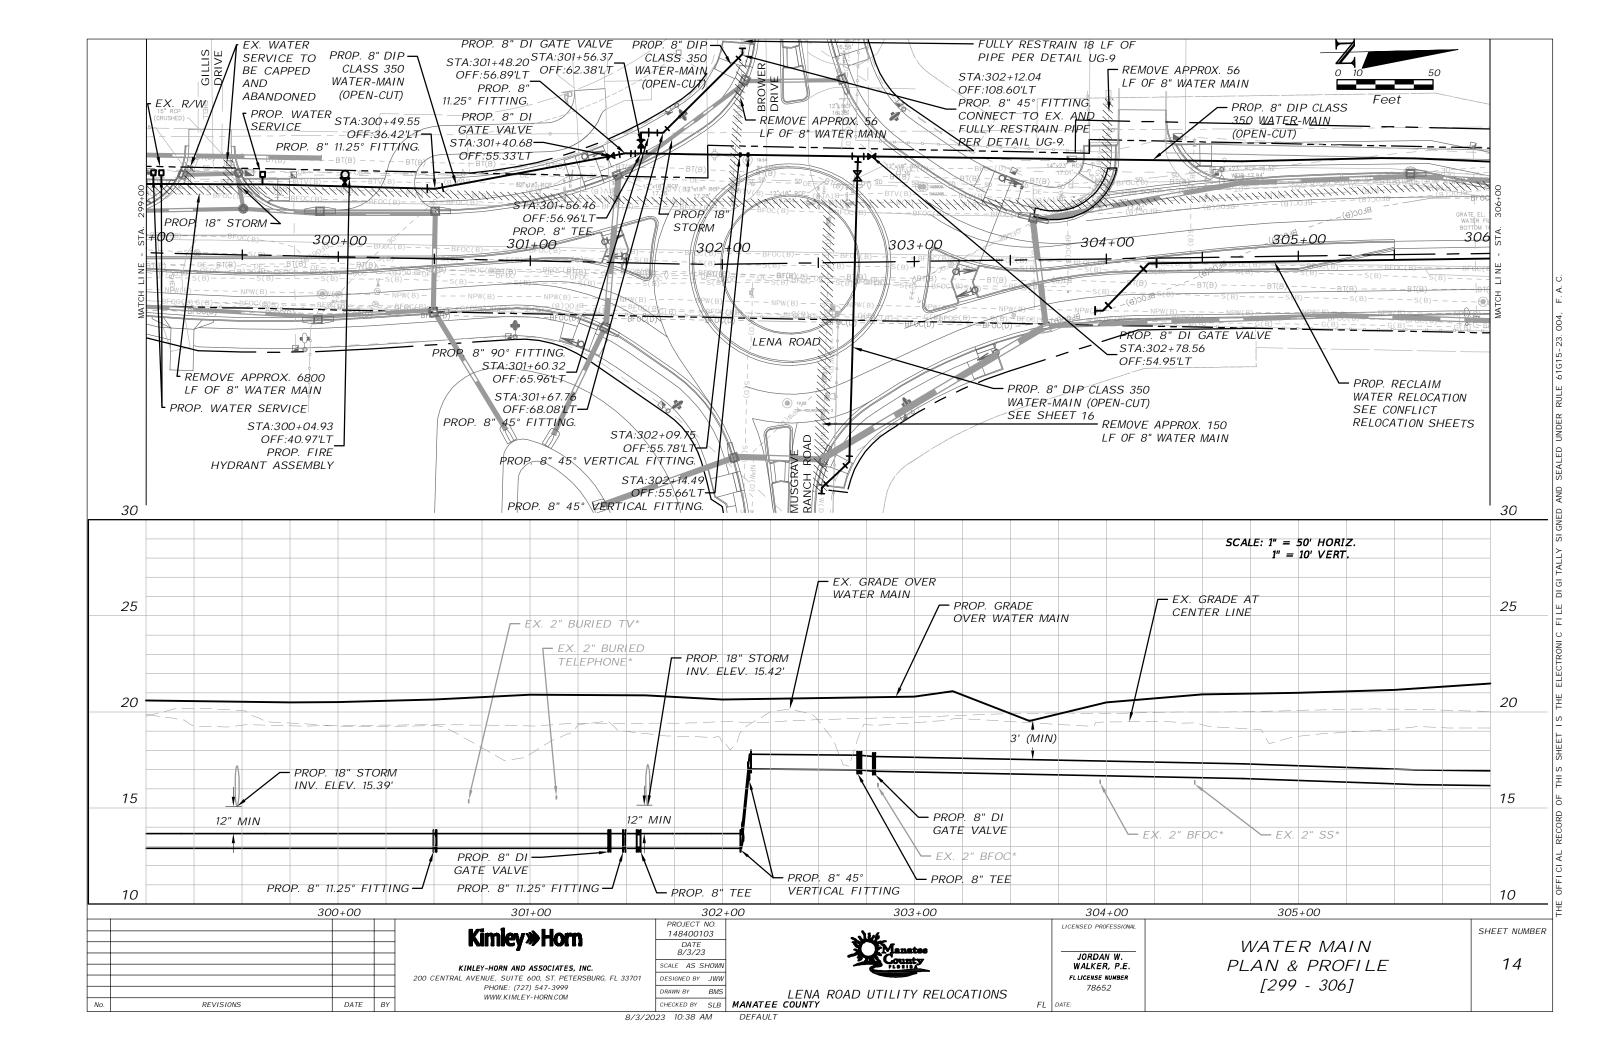


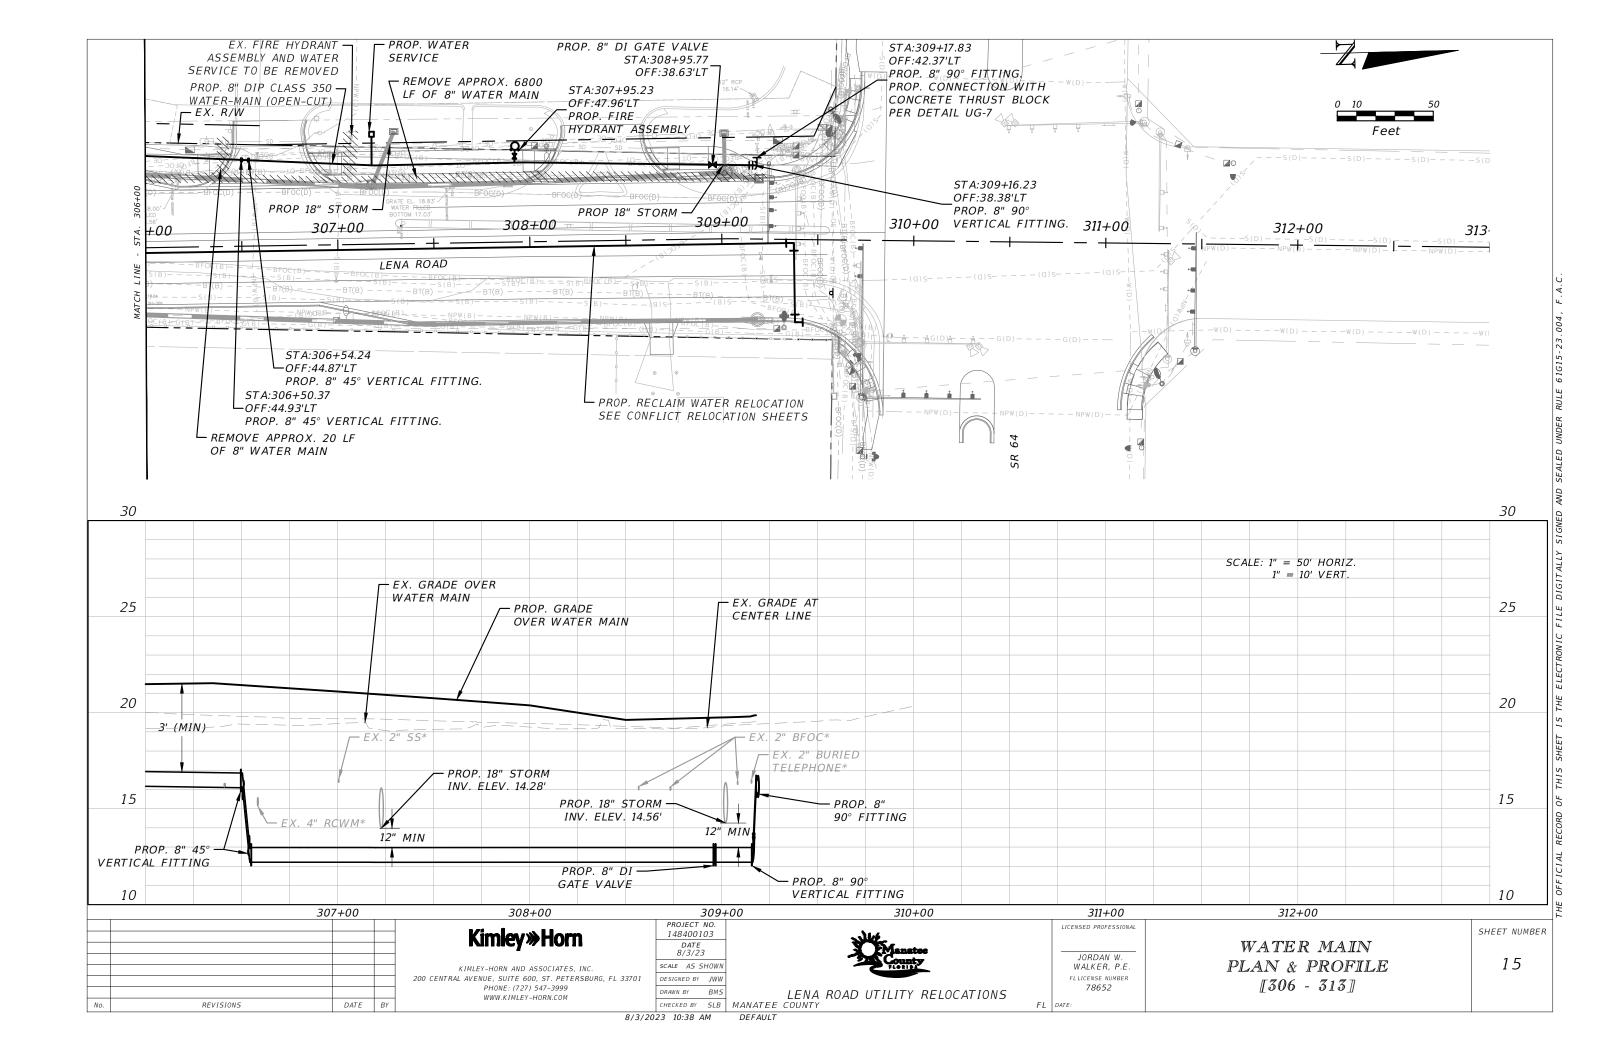


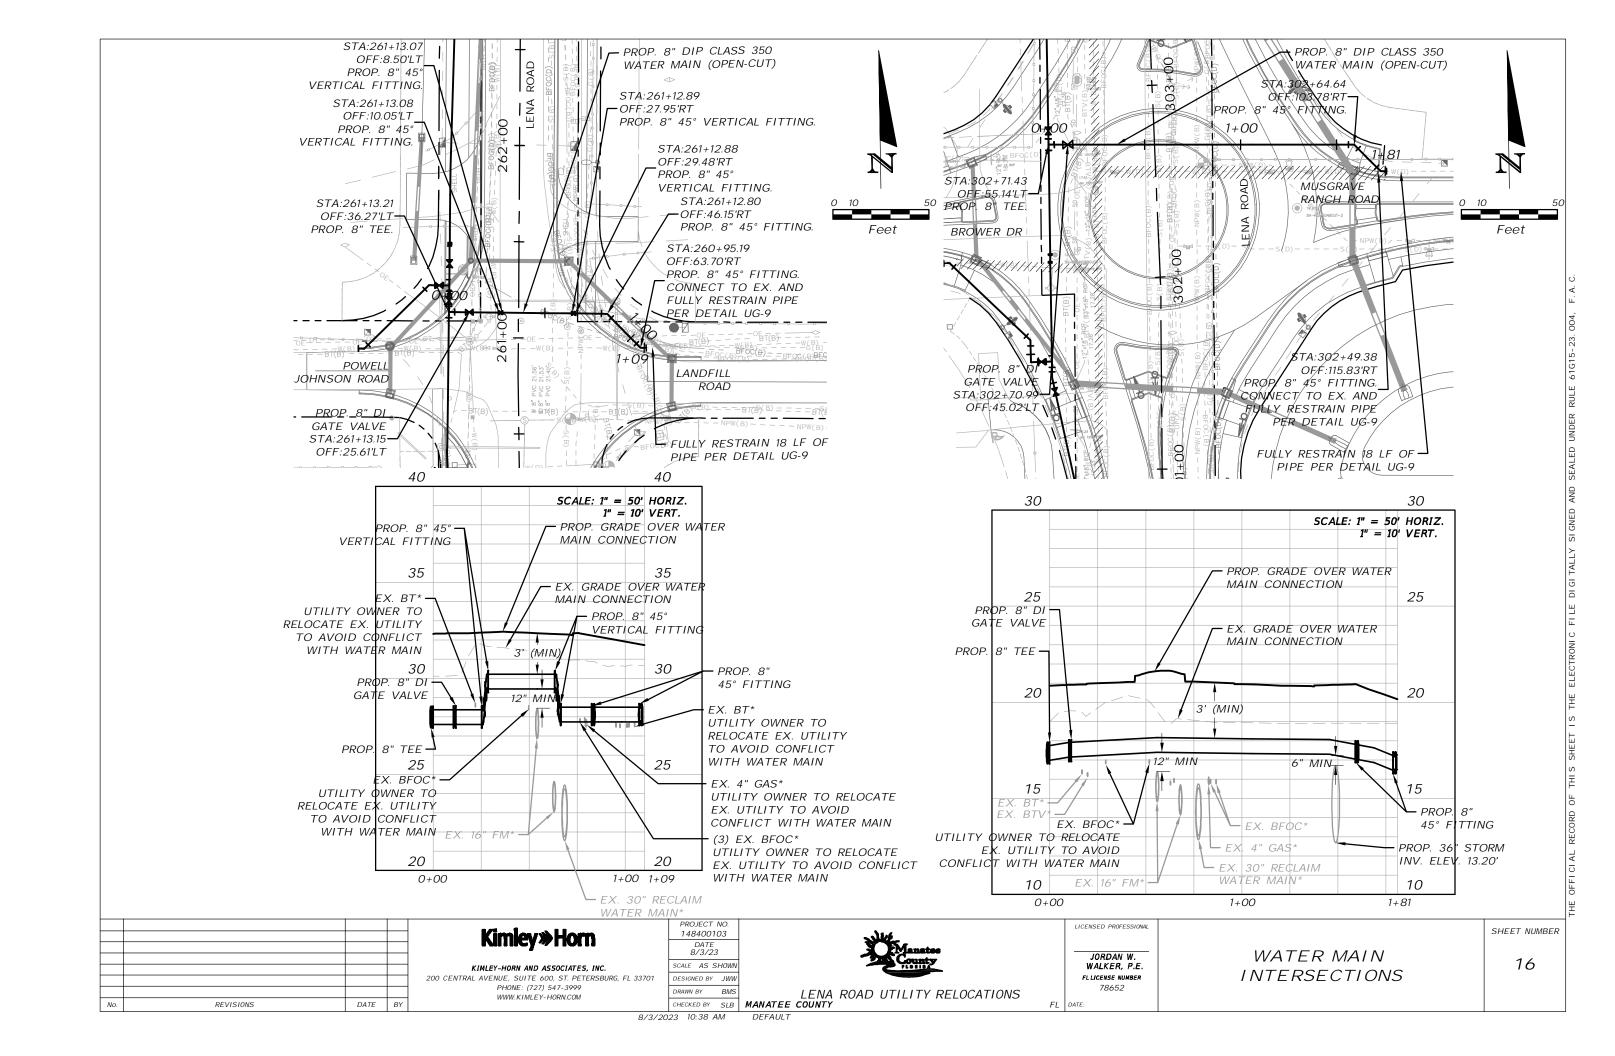


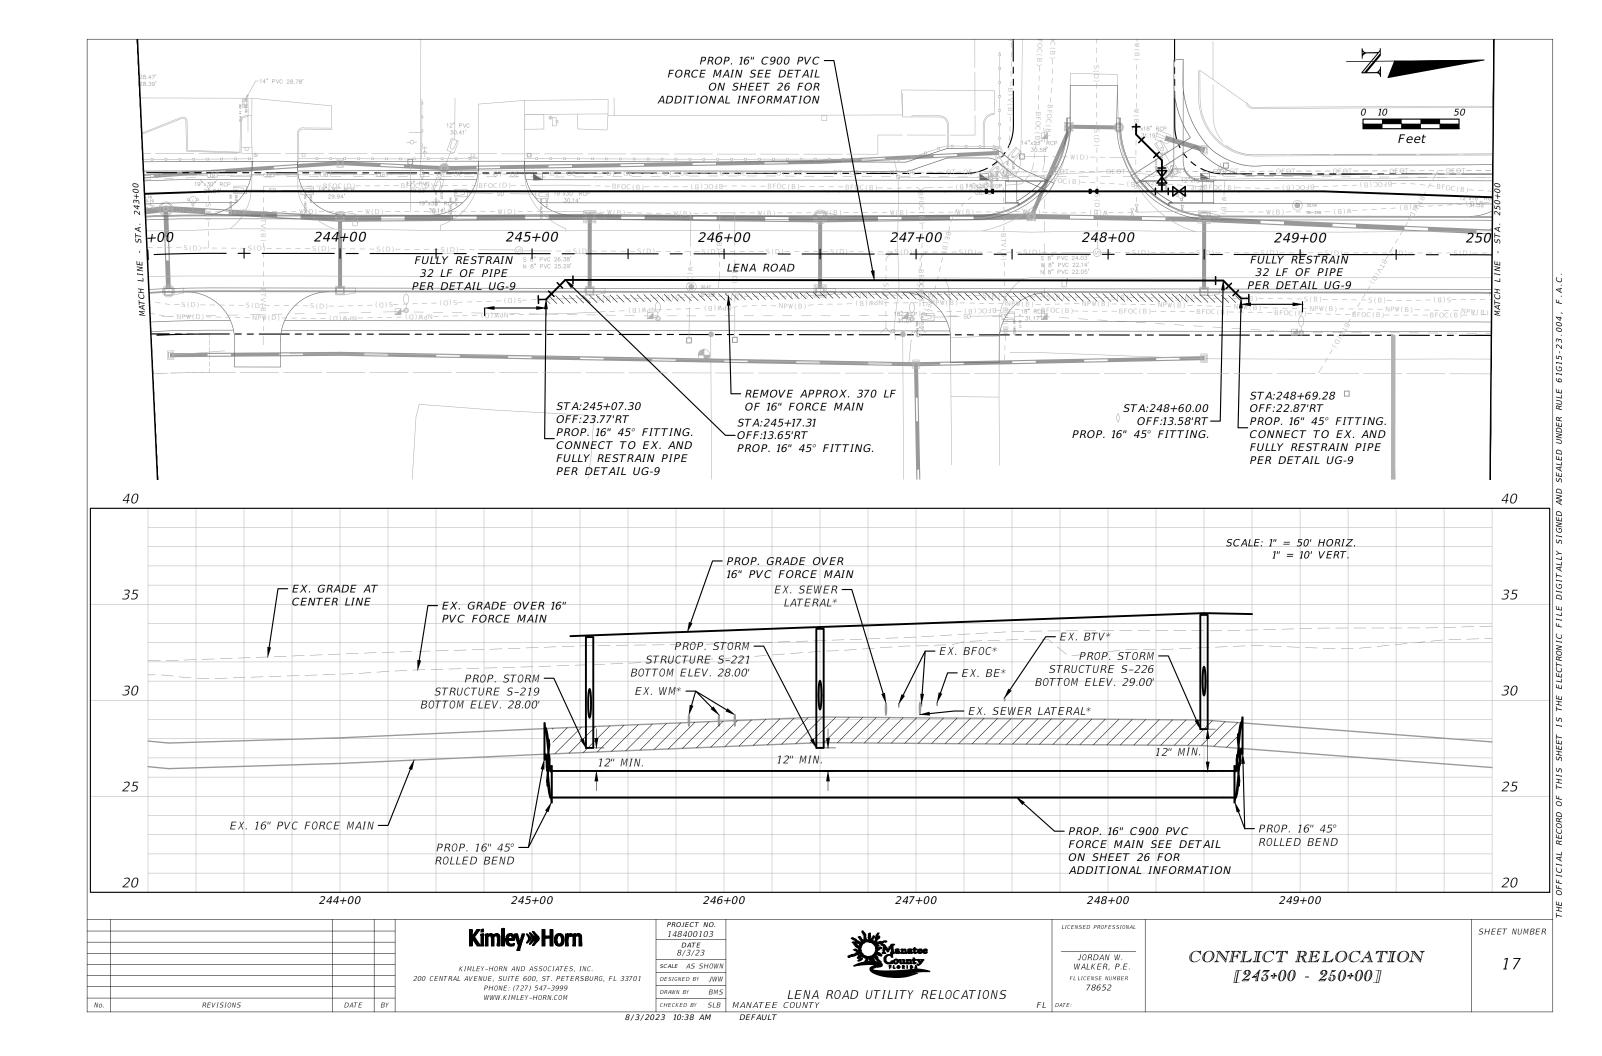


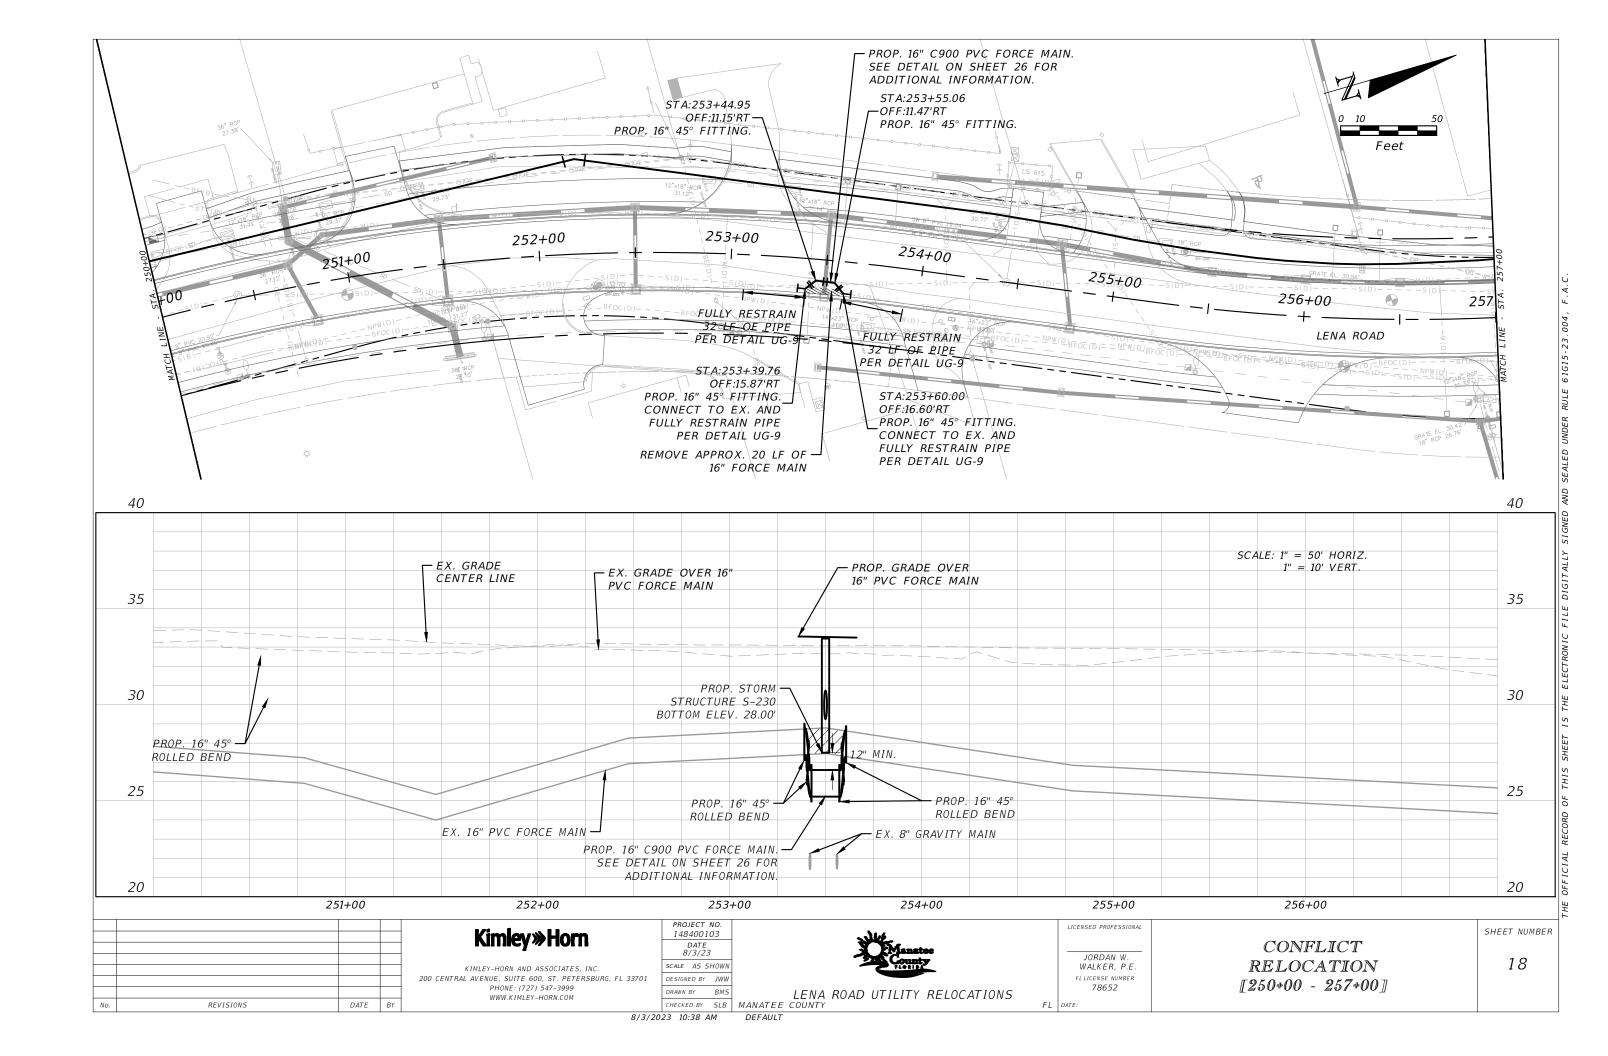


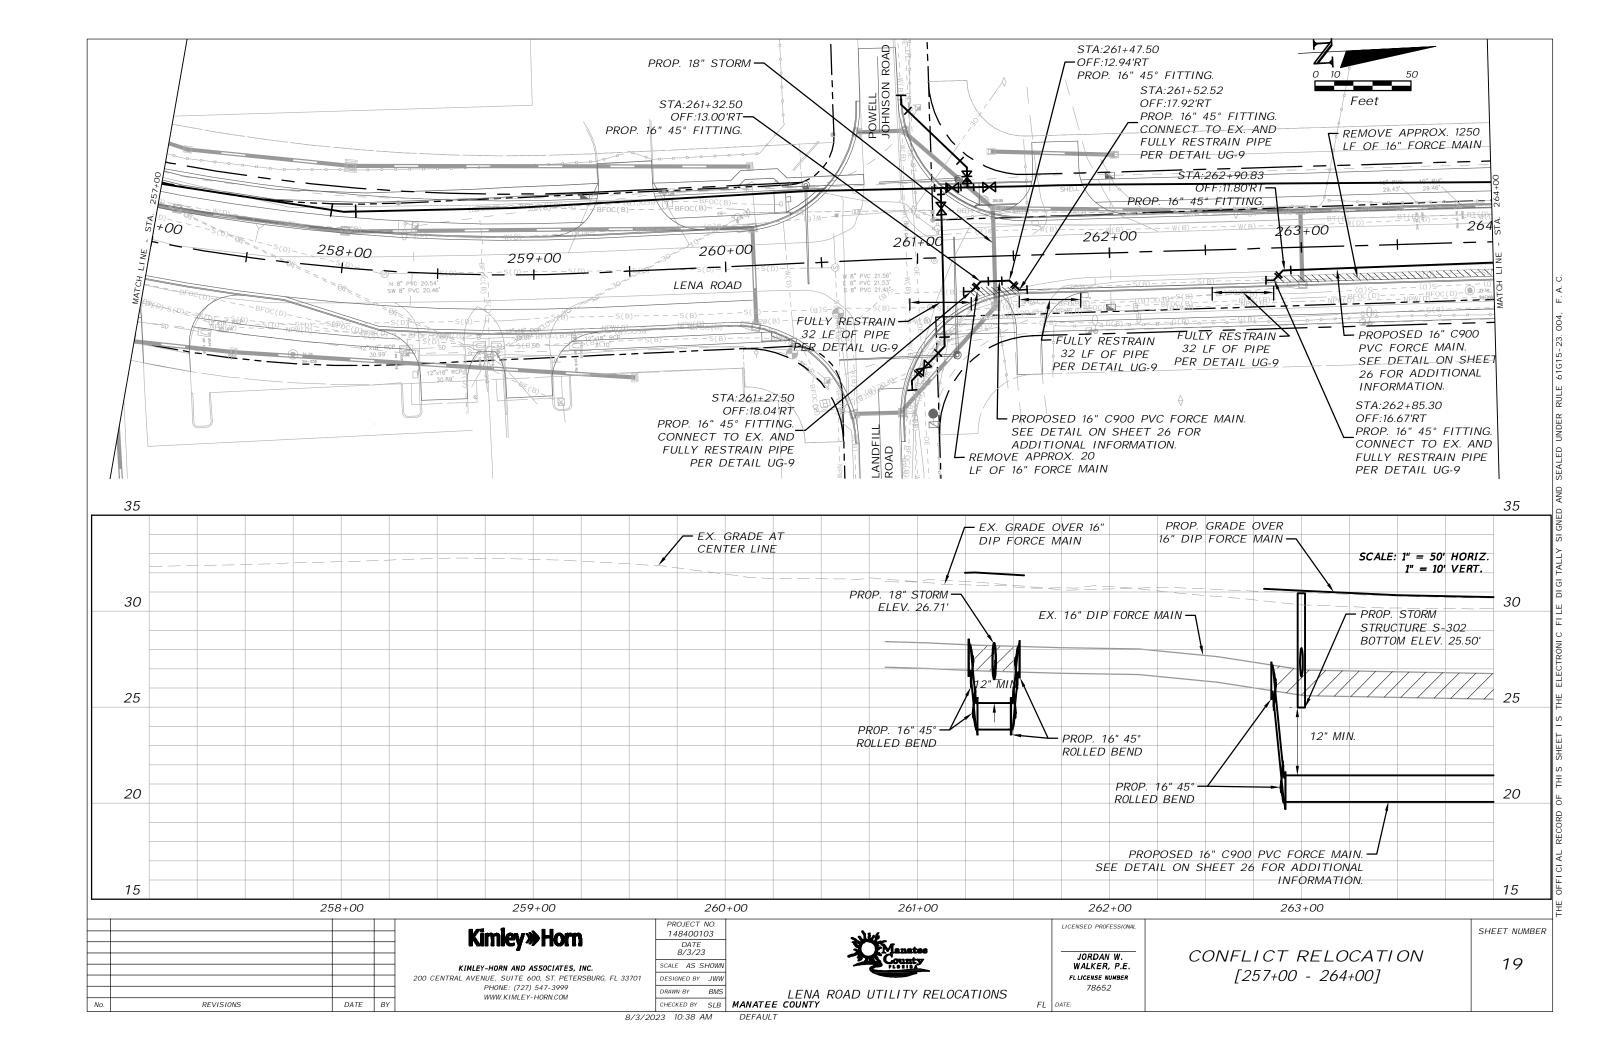


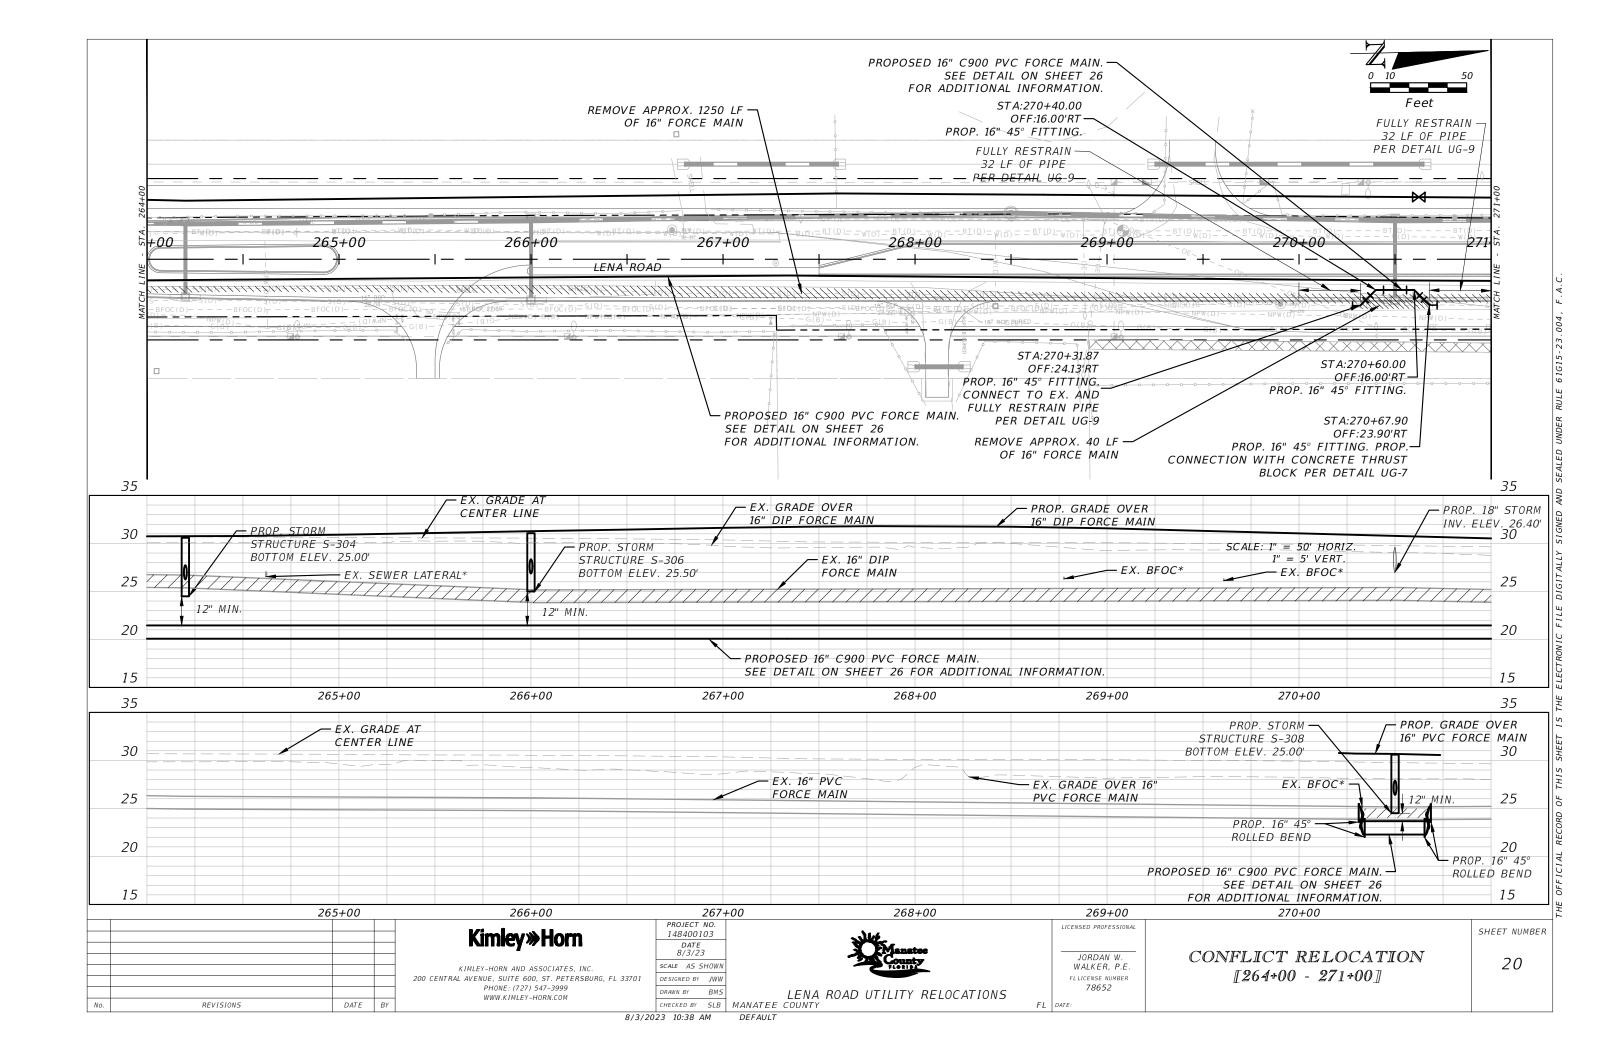


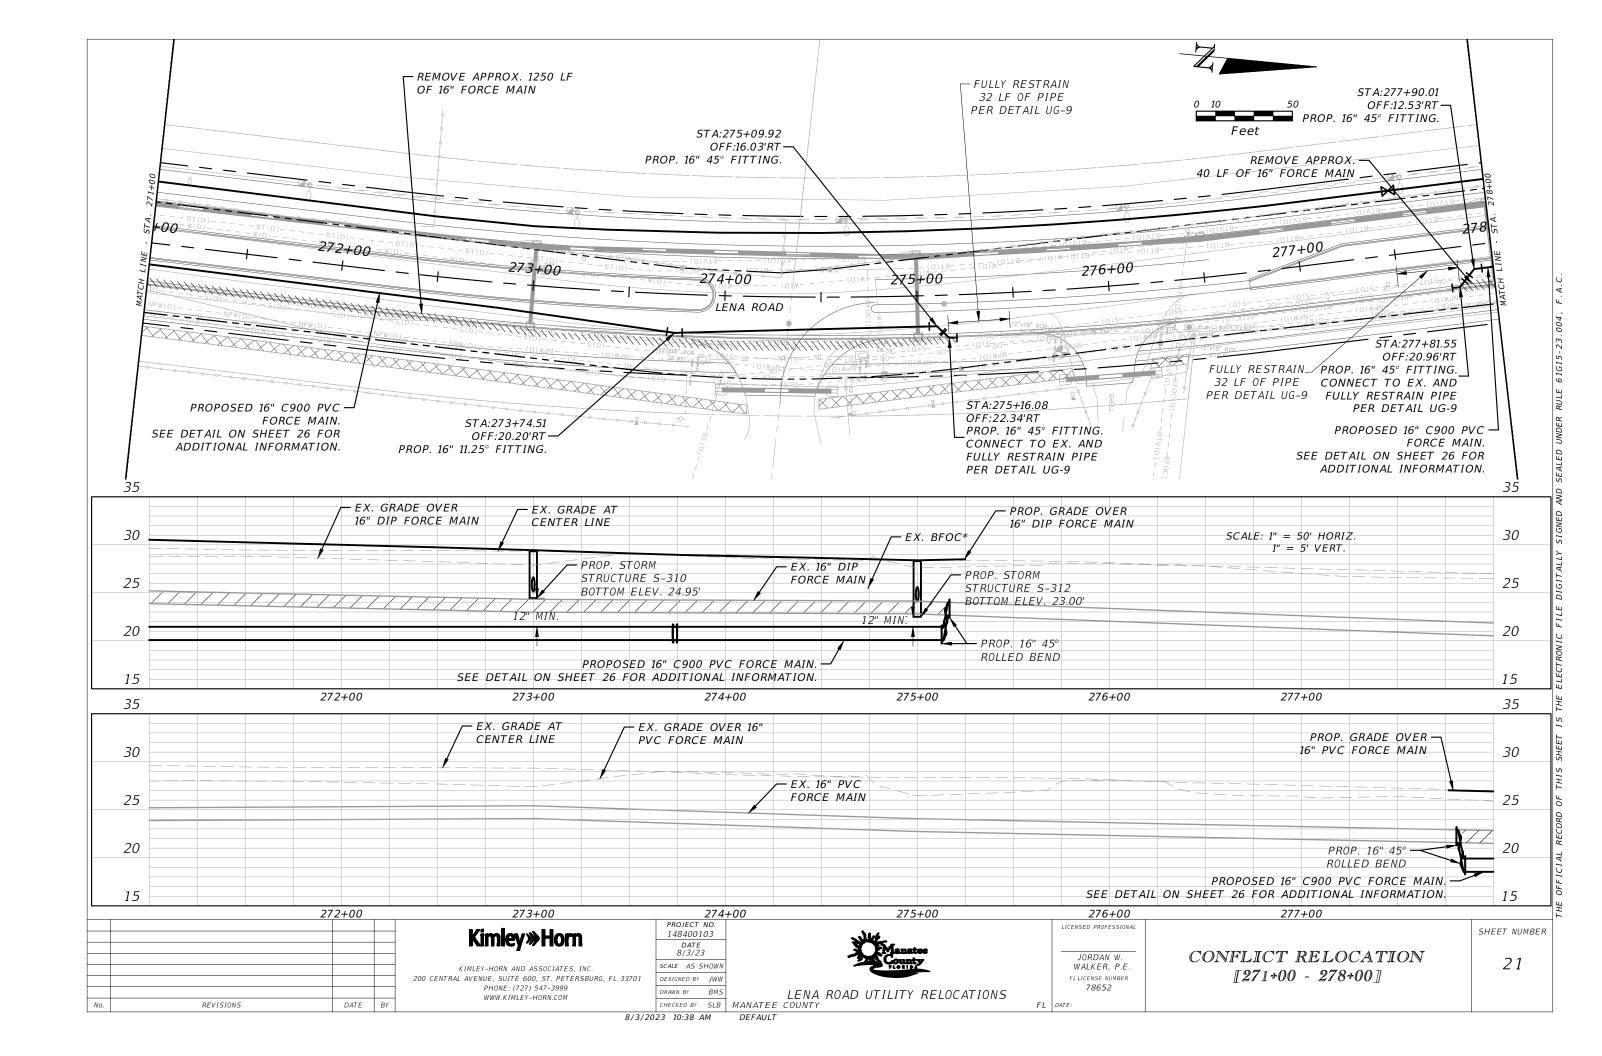


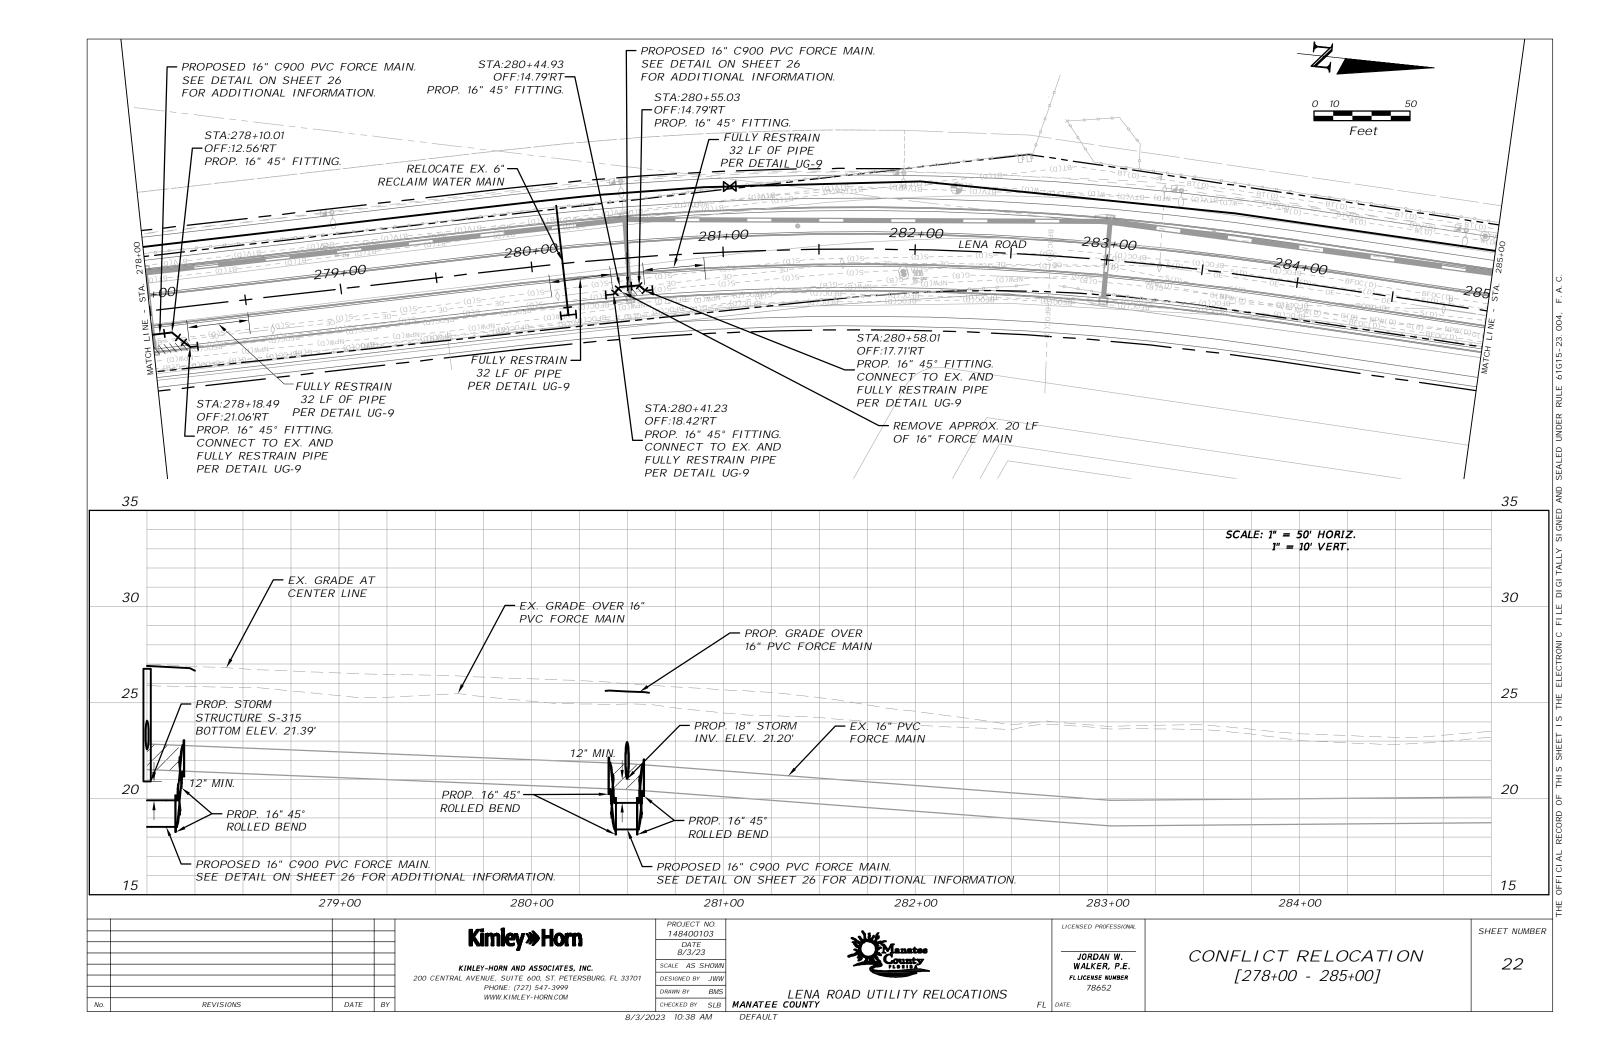


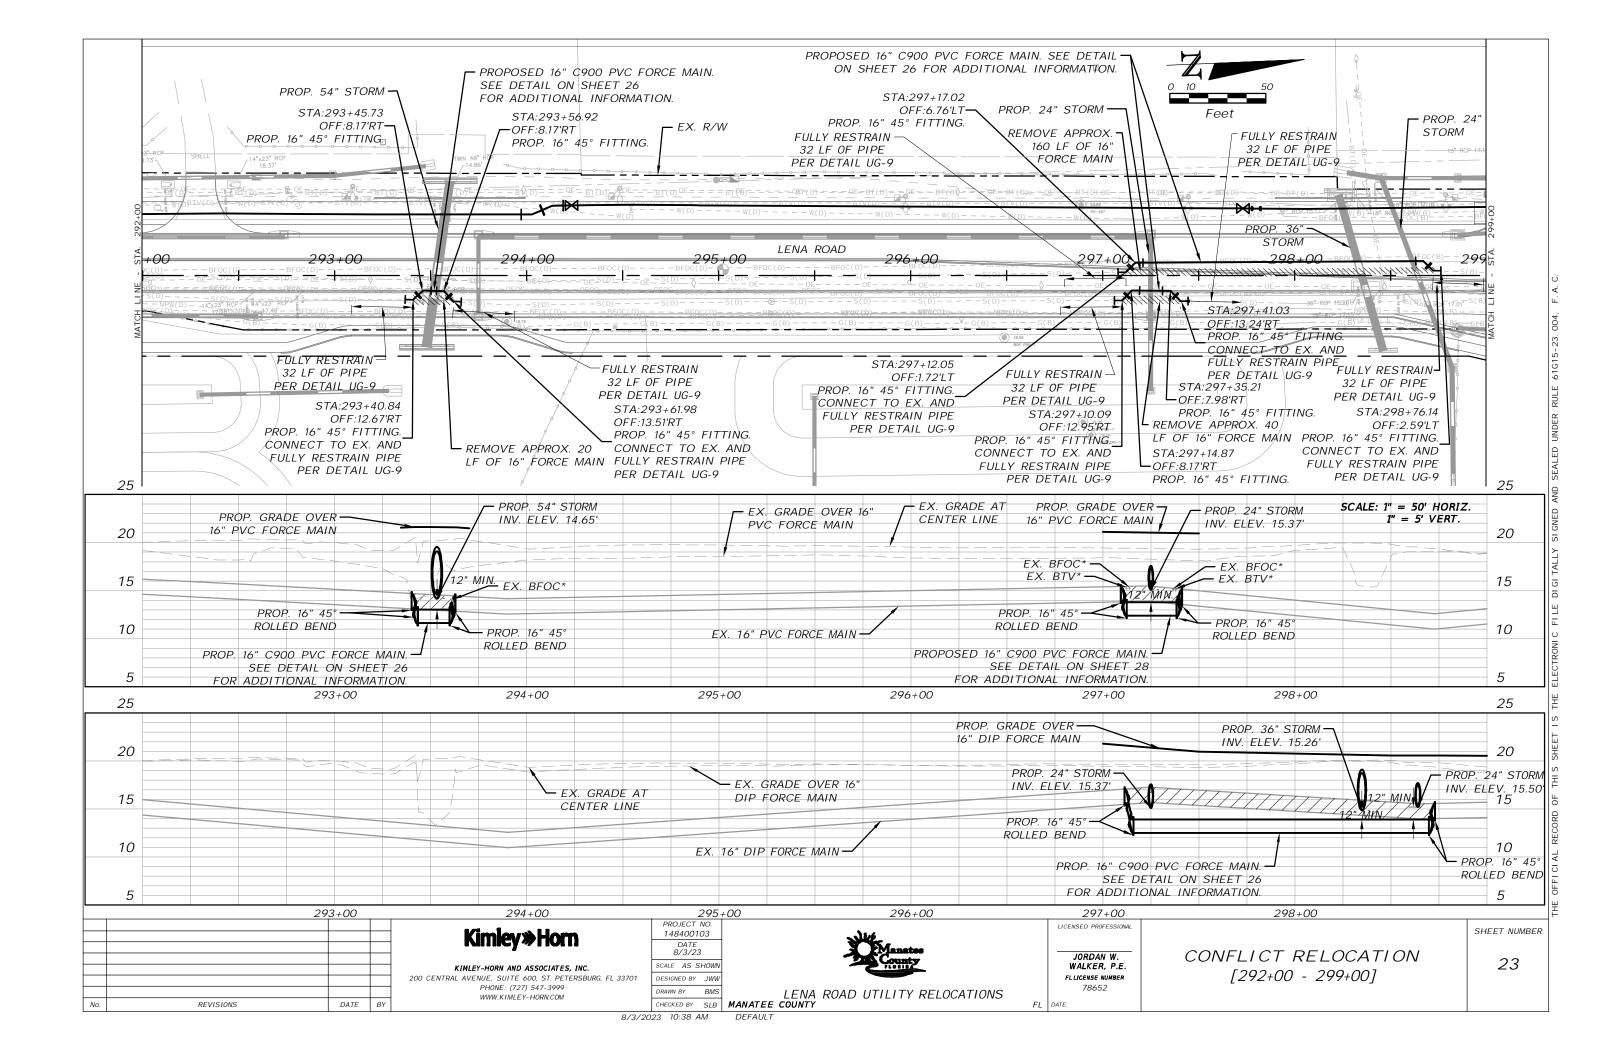

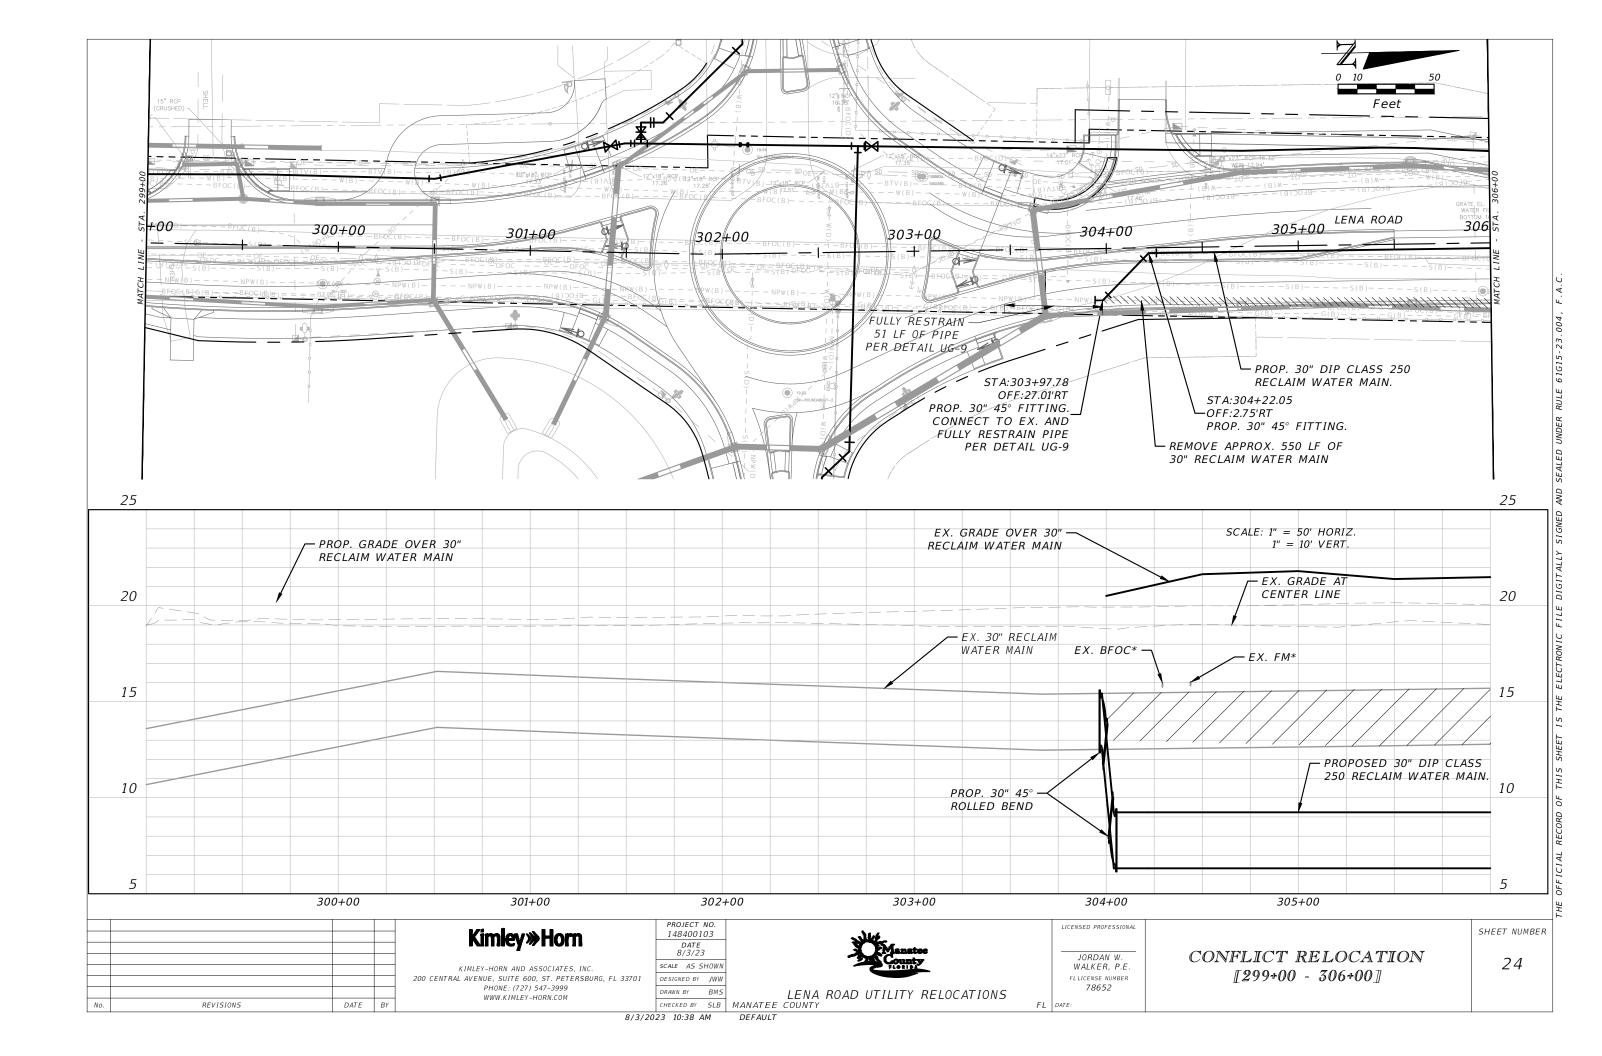

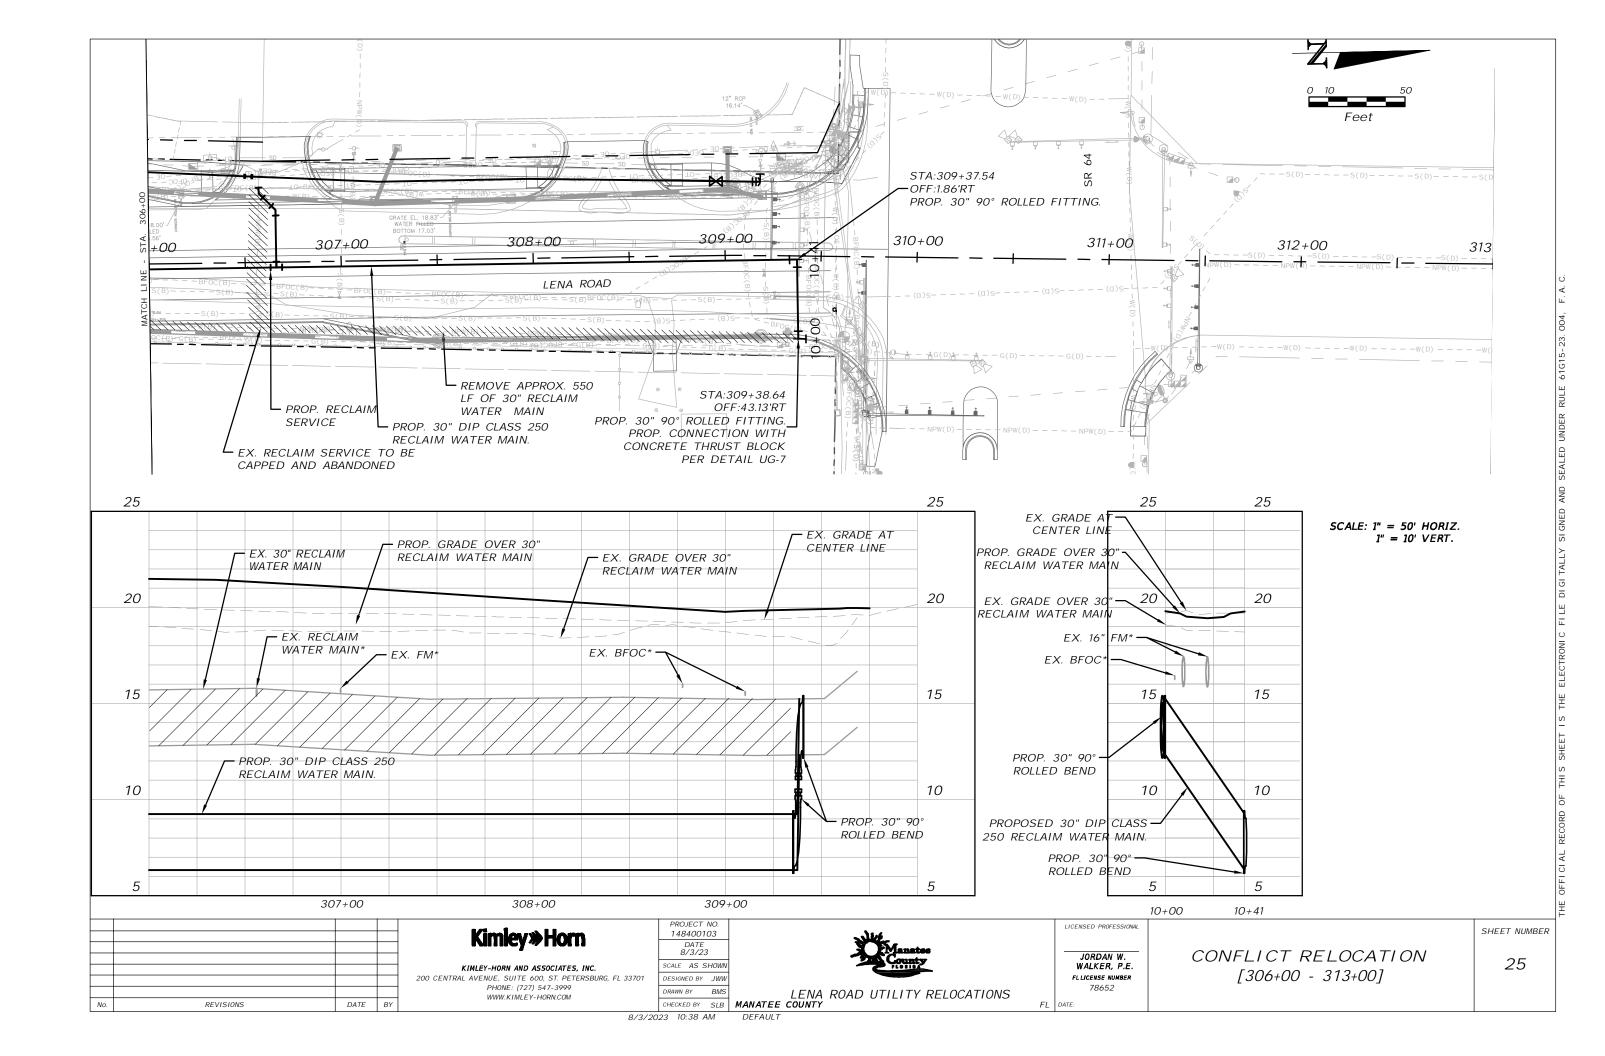

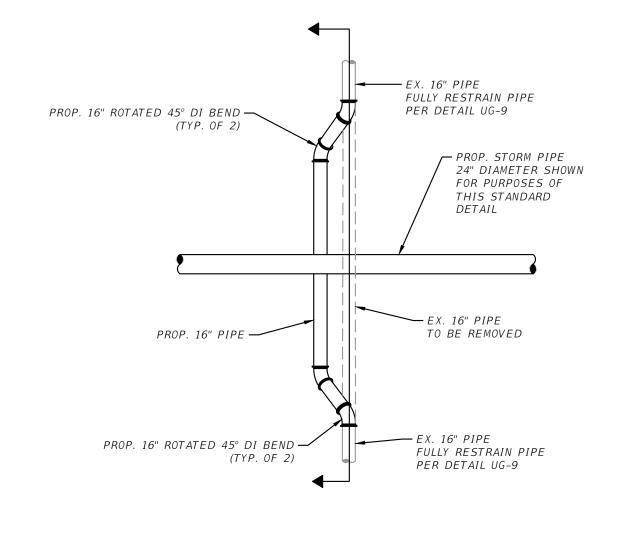

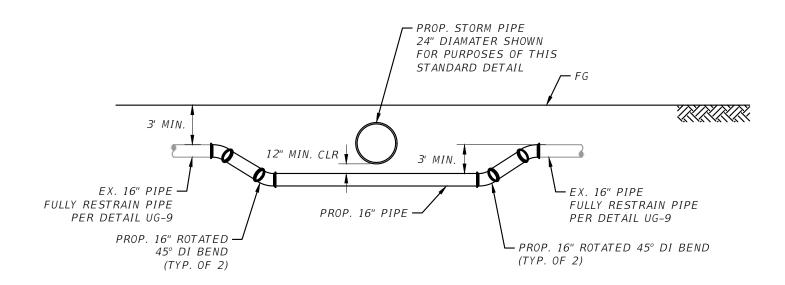

UTILITY ADJUSTMENT DETAIL (16" PIPE) SCALE: 1" = 10'

DATE BY REVISIONS

Kimley»Horn

KIMLEY-HORN AND ASSOCIATES, INC. 200 CENTRAL AVENUE, SUITE 600, ST. PETERSBURG, FL 33701 PHONE: (727) 547-3999 WWW.KIMLEY-HORN.COM

PROJECT NO. 148400103 SCALE AS SHOWN



LICENSED PROFESSIONAL


JORDAN W. WALKER, P.E. FLLICENSE NUMBER 78652 FL DATE:

UTILITY ADJUSTMENT DETAIL

SHEET NUMBER

26

8/3/2023 10:38 AM DEFAULT

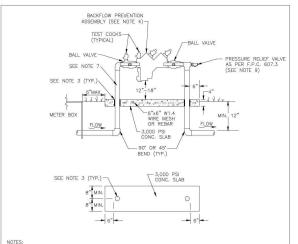

- . BACKFLOW PREVENTION ASSEMBLY MUST BE INSTALLED IMMEDIATELY DOWNSTREAM OF METER, AS SHOWN ABOVE

- BALK-LOW PREVENTION ASSEMBLY MISS BE INSTALLED INMEDIATELY DOWNSTREAM OF MEIRS, AS SHOWN
 REFORM THE TYPE "" (OR "K") OR BRASS PIPE MINIMUM SCHEDULE 40 SHALL BE USED TO A MINIMUM
 DEPTH OF 12" BELOW GRADE.
 PIPES STEMMO THROUGH PROPERTE SLAB SHALL BE PROPERTY PROTECTED, PREYETHYLENE WRAPPED OR
 THE SYSTEM WISS MEET ALL REQUIREMENTS OF THE FLORING PLUMBING CODE (LATEST EDITION) AND
 CHAPTER 2"—31, ARTICLE X OF THE MANATE COUNTY CODE OF ORDINANCES.
 ALL EXPOSED DEGS OF CONDERTE SHALL BE CHAPTERD 17".

 PACKET OW PREVENTER SHALL BE TESTED AT THE TIME OF INSTALLATION.
 PRESSURE EXCEEDS 80 PLANTED UPSTREAM OF BROKETLOW PREVENTION ASSEMBLY, IF SYSTEM
 PRESSURE EXCEEDS 80 PLANTED AT THE TIME OF INSTALLATION.

 3" MINIMUM CLEARANCE FROM LANDSCAPING PLANTS AND 10" MIN. CLEARANCE FROM TREES TO EDGE OF
 CONCRETE SLAB AND CLEAR OPENING FOR ACCESS FROM STREET.

 IN ADDITION TO THE PIPE THE BUILDING DEPT. MAY PEGURE AN APPROVED DEVICE FOR THERMAL

- CUNNIFITE SLAB AND CLEAR OPENING FOR ACCESS FROM STREET.


 IN ADDITION TO THE PRY, THE BUILDING DEFT, MAY REQUIRE AN APPROVED DEVICE FOR THERMAL EXPANSION CONTROL DOWNSTREAM OF THE ASSEMBLY.


 OF ITTINGS AND CONNECTIONS FOR ABOVE—REQUIRED INSTALLATIONS SHALL NOT ALLOW ANY MOVEMENT OR ROTATION OF BACKFLOW PREVENTION ASSEMBLY.

 I. REFER TO DETAIL US—15 WAITER METER & BACKFLOW PREVENTER FOR LIFT STATIONS FOR WATER SERVICE AT SEWAGE PURMENTS STATION.
- AT SEAWAGE POMPINGS STATION.

 BACKFLOW PREVENTION ASSEMBLIES USED FOR POTABLE APPLICATIONS SHALL BE LEAD FREE AS DEFINED THE REDUCTION OF LEAD IN DRINKING WATER ACT, SECTION 1417 OF THE SAFE DRINKING WATER ACT, 42 U.S.C. 3009—6, AS MAY BE AMENDED, AND IN COMPLIANCE WITH ALL APPLICABLE REQUILATIONS

| | | ATEE COUNTY WORKS DEPARTMENT | 3/4" & 1" BACKFLOW | |
|----------|------|------------------------------|-----------------------|-------|
| REV.BY D | DATE | | DI TOTAL LOW | UW-13 |
| | | February 25, 2020 | PREVENTION | |
| | | February 25, 2020 | ACCEMPLY | |

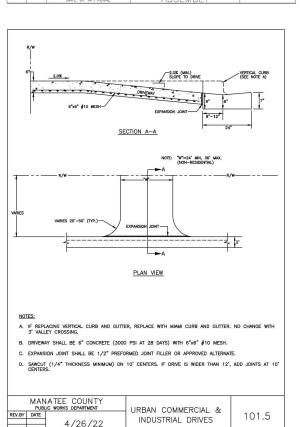

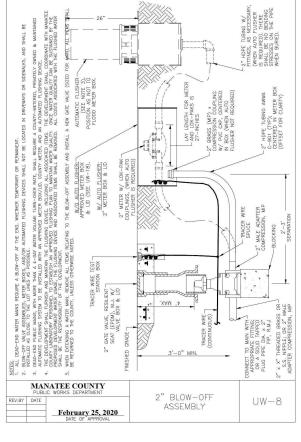


RECLAIMED WATER


BASE MATERIAL


+#5 BASE & 5°± C-C
EA. WAY (8-TOTAL)

ADJUSTABLE VALVE BOX AND LID. SCREW-TYPE

SERVICE TYPE-"RW"(RECLAIM WATER)-(PLANT VALVE ID#)

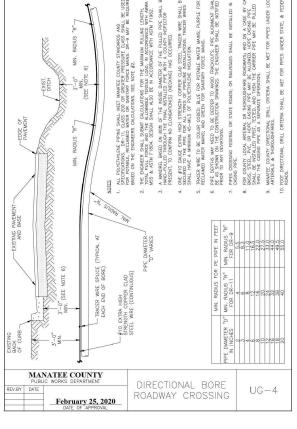

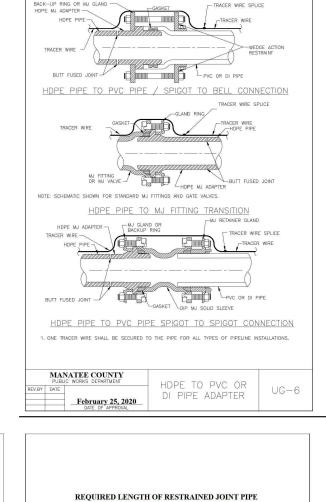

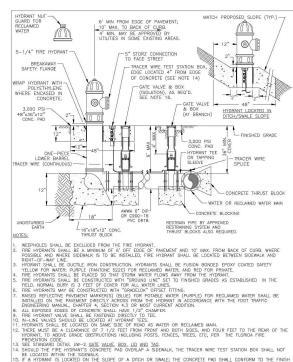

- BE LOCATED WITHIN THE SIDEWALK,

 F A HORBART IS LOCATED ON THE SLOPE OF A DITCH OR SWALE; THE CONCRETE PAD SHALL CONFORM TO THE FINISH

 RRADE/SLOPE. THE CONCRETE PAD SHALL BE LEVEL 2-INCHES BEHIND & N FRONT OF THE HYDRANT.

 THE DISCRETION OF THE COUNTY AN ADDITIONAL SOLUTION GATE VALVE SHALL BE ADODED, WHEN A PHYSICAL

 AMPRIER OF PRESENT, (LE. ROLDWAY, FENCE, WALL, BERN ETC), BETWEEN THE BRANCH GATE VALVE AND THE HYDRANT.

 SEE SECTION 1.11 HYDRANIS IN THE PUBLIC WORKS UITHIT STANDARDS MANUAL FOR FURTHER EEFALE.

| | RIER IS I | | | | | | | | | | | | |
|--------|--|--|--|--|--|--|--|--|-----|-----|-------|-----|--|
| | MANATEE COUNTY PUBLIC WORKS DEPARTMENT | | | | | | | | RF | /DI | D À I | VIТ | |
| REV.BY | DATE | | | | | | | | VC. | _ | | N.I | |
| | | | | | | | | | | | | | |

UW-5February 25, 2020

PIPE SIZES ARE GIVEN IN INCHES.

RESTRANDED PIPE LENCTHS ARE GYEN IN FEET.

LENGTHS SHOWN ARE FOR A TEST PRESSURE OF 180 PSI.

THE RESTRANDED LENGTHS SHOWN IN THESE TABLES ARE BASED ON SOIL CLASSIFICATION ST
WITH AWAM TYPE 3 TRENCH CONDITIONS, 180 PSI TEST PRESSURE, 3 FEET OF COVER AND
15 FACTOR OF SAFETY, ACTUAL BURY CONDITIONS MUST BE DETERMINED BY THE ENGINEER
OF RECORD AND THE RESTRANDED LENGTHS MODIFIED ACCORDINGLY. RESTRAINED LENGTHS TO BE APPLIED TO PIPELINES PER DETAIL UG-10 <u>RESTRAINED LENGTHS</u> FOR PIPE. ON FIFE ALL RESTRANDS JOINT HARDWARE SHALL CONFORM TO 1.11.17 OF THE PUBLIC WORKS UTILITIES STANDARDS MANUAL.
ALL THREE "LEGS" OF TEES SHALL BE RESTRAINED PER THE STATED LENGTH IN THE TABLE. MANATEE COUNTY

February 25, 2020

RESTRAINED LENGTHS FOR PVC

ITES:

RESTRAIN 11.25' BENDS 50% OF LENGTH FOR 22.5' BENDS.

ALL VALVES AND FITTINGS SHALL BE RESTRAINED TO THE CONNECTING SECTIONS OF PIPE.

ALL ISOLATION VALVES MUST BE PROPERLY ANCHORED OR RESTRAINED TO RESIST A 180 PSI
TEST PRESSIZE IN ETHER DIRECTION.

SHEET NUMBER

DATE BY REVISIONS

Kimley **Horn

MANATEE COUNTY

February 25, 2020

- DIRECTION & NO. OF TURNS TO OPEN (TYP.)

CENTERING COLL SIZE VARIES

"NV" OR "RIVE" TO BE WHERSIED HIS THE MENU-COURSE CRUSSET CLUBS, ALVIEW WITH DESTRUCE IN FEET TO THE WAVE. I" NO CLUB, NESTLA, A BUE DOES WITH "Y' OF PHINTED GOS WITH "HAVE' URING A 1/8" x" 1" GALWARDS STEEL SORDW IN THE EDDE OF PHINTED'S THE FORDED FOR THE LOSE OF PHINTED'S WITH DESTRUCE ON THE MALE. ALL DISTRING AND PROVINCES WAVE DOESS. SHALL BE AUXISTED TO PROVIDED WHOSE SO DETERMINED IN THE FILLD.

NAMES SHALL SHOT BE FLOOR TO MANDEL-PETED MARKES, CARRES, OR CUTTERS.

PREDATE PAGE SAUL MY BE USED. AN ANNALY OF MATERIAL PAGE AND ANNALY OF MATERIAL PAGE A

THE BORS TO STREET OF THE PLAT THAT FOR DAY POLY.

BY SHALLED WITHIN TO CONTROL THE PLAT WAVE OF WELL OF WELL OF WELL OF THE PLAT WAVE OF SHALLED WITHIN THE COUNTY TREATMENT PLANT LIMITS. THE PLANT WAVE OF SHALLED WITHIN THE SHOWN OF THE PLANT WAVE OF SHALLED WITHIN THE SHOWN OF THE PLANT WAVE OF TH

GATE VALVE, BOX,

LID AND TAG

TRACER WIRE (CONTINUOUS)

KIMLEY-HORN AND ASSOCIATES, INC. 200 CENTRAL AVENUE, SUITE 600, ST. PETERSBURG, FL 33701 PHONE: (727) 547-3999 WWW.KIMLEY-HORN.COM

148400103 DATE 8/3/23 SCALE AS SHOWN DESIGNED BY JWW DRAWN BY BMS

PROJECT NO

UW-2

LENA ROAD UTILITY RELOCATIONS

JORDAN W. WALKER, P.E. FLLICENSE NUMBER 78652

LICENSED PROFESSIONAL

FL DATE:

DETAILS 01

PLUGS & VALVES

100

83

UG-8

27


CHECKED BY SLB MANATEE COUNTY 8/3/2023 10:38 AM DEFAULT


REQUIRED LENGTH OF RESTRAINED JOINT PIPE FOR DIP (POLY-WRAPPED)


| MAIN | HOR | HORIZ. BENDS | | | HORIZ. BENDS TEES | | | | | REDU | | PLUGS | & VALVES | | | |
|------|-----|--------------|------|------------|-------------------|------------|------------|-----------|-------|------------|------------|-------------|------------|---|-----|--|
| PIPE | 90. | 45 | 22.5 | | SIZE LENGTH | | | | | | | SIZE LENGTH | | | | |
| 36 | 142 | 59 | 28 | x36 393 | x30 318 | x24 232 | ×20 165 | x16 84 | x12 | X30 137 | X24 247 | X20 309 | X16 359 | | 153 | |
| 30 | 124 | 51 | 25 | X30 333 | X24 252 | X20 189 | X16 115 | X12 23 | ×10 1 | X24 137 | X20 213 | X16 276 | | | 391 | |
| 24 | 106 | 44 | 21 | X24 270 | X20 211 | X16 143 | X12 61 | X10 10 | ×8 1 | X20 98 | X16 178 | X12 241 | | 3 | 527 | |
| 20 | 92 | 38 | 18 | X20 225 | X16 161 | X12 85 | X10 39 | ×81 | | K16 98 | X12 176 | X10 227 | | 2 | 280 | |
| 16 | 77 | 32 | 15 | X16 177 | X12 107 | X10 65 | X8 19 | ×61 | | ×12 98 | X10 163 | X8 169 | | 2 | 231 | |
| 12 | 61 | 25 | 12 | X12 127 | X10 89 | X8 50 | x6 | | | X10 88 | X8 96 | X6 131 | | 1 | 181 | |
| 10 | 52 | 22 | 10 | X10 101 | X8 64 | ×6 | | | | X8 51 | X6 94 | X4 125 | | 1 | 53 | |
| 8 | 44 | 18 | 9 | X8 78 | X6 30 | ×41 | | | | X6 54 | X4 92 | | | 1 | 28 | |
| 6 | 34 | 14 | 7 | X6 46 | ×41 | | | | | X4 50 | | | | | 98 | |
| 4 | 24 | 10 | 5 | ×4/10 | | | | | | | | | | 1 | 69 | |


SEE UG-8, <u>RESTRAINED LENGTHS FOR PVC PIPE</u> DETAIL FOR NOTES 1 THROUGH 9 THAT ARE ALSO APPLICABLE TO RESTRAINED LENGTHS FOR DIP.

| | | NATEE COUNTY C WORKS DEPARTMENT | RESTRAINED | |
|--------|------|------------------------------------|-----------------|------|
| REV.BY | DATE | | LENGTHS FOR DIP | UG-9 |
| | | February 25, 2020 | LENGINS FOR DIP | |

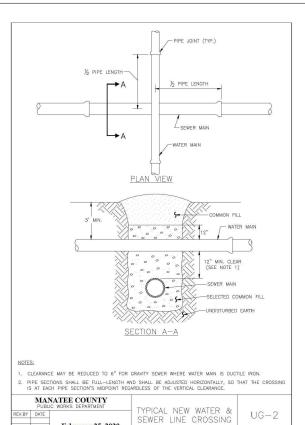

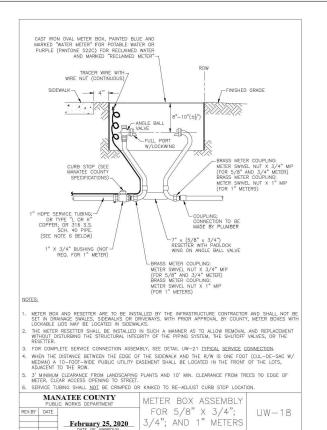

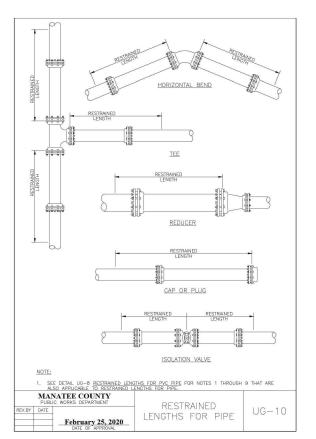

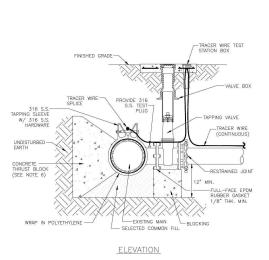

- PRIOR TO TAPPING, CONTRICTOR TO DEMONSTRATE GO MINUTE HYDROSTATIC TEST OF THE TAPPING SLEEVE AND VALVE WITH NO LOSS OF 180 PS PRESSURE FOR WATER AND RECLAIMED WATER.

 ALL FITTINGS TO BE WRAPPED WITH 20 MIL POLYETHYLENE WARD AT THRUST BLOCK.
- 2. ALL THINNS TO BE WRAPPED WITH 20 MIL POLICIENTENE WARP AT INRUST BLOOK.

 3. ALL TARS ON CONDERGE WASTER MAINS AND LARGER THAN 12", ABE TO BE MADE BY A MANATEE COUNTY APPROVED TAPPING COMPANY, ALL MATERIALS TO BE SUPPLIED BY THE CONTRACTOR.

 4. ALL TARS MUST BE OF A SMALLER SIZE THAN THE MAIN BEING TAPPED & PLOCED NO CLOSER THAN 30" OR A DISTANCE EQUAL TO (1) MAIN PIPE DIAMETER PLUS (2) TAP PIPE DIAMETERS (WINCHEVER IS ORBALER) FROM A JOINT OR TITING.

 5. CONTRACTOR TO SUPPLY A DRY HOLE FOR TAPPING CREW TO WORK IN AND A BACK—HOE TO LOWER SHOULD BE SECURED TO SUPPLY A DRY HOLE FOR TAPPING CREW TO WORK IN AND A BACK—HOE TO LOWER SPECIFIED FOR THESE.

- SPECIFIED FUNCTIONS.

 7. TRACER WHIE TEST STATION BOX IS REQUIRED AT CONNECTIONS TO EXISTING MAINS.


 8. SEE SECTION 1.11 TAPPING SLEEVES AND VALVES IN THE PUBLIC WORKS UTILITY STANDARDS MANUAL FOR FURTHER PETALLS.


REVISIONS


| | | C WORKS DEPARTMENT | TAPPING SLEEVE | |
|--------|------|--------------------|-----------------|------|
| REV.BY | DATE | | AND VALVE | UW-3 |
| | - | February 25, 2020 | (WATER/RECLAIM) | |

| | | NATEE COUNTY IC WORKS DEPARTMENT | TAPPING SLEEVE | |
|--------|------|-------------------------------------|-----------------|------|
| REV.BY | DATE | | AND VALVE | UW-3 |
| | | February 25, 2020 DATE OF APPROVAL | (WATER/RECLAIM) | |

DATE BY

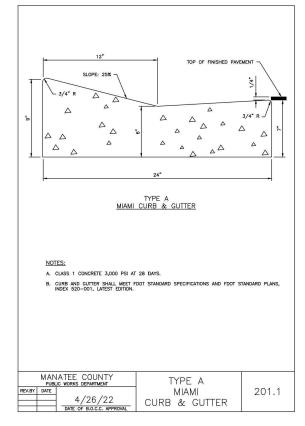

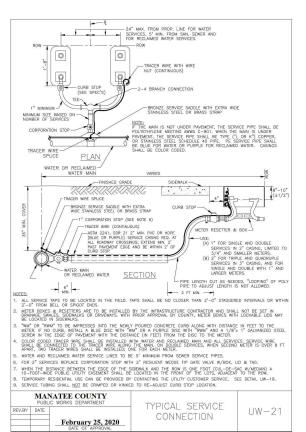

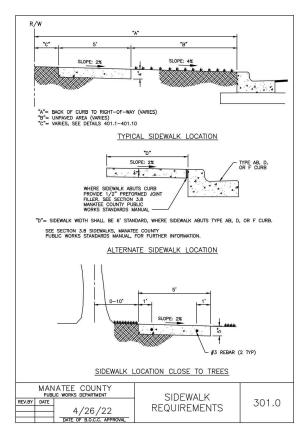



KIMLEY-HORN AND ASSOCIATES, INC. 200 CENTRAL AVENUE, SUITE 600, ST. PETERSBURG, FL 33701 PHONF: (727) 547-3999 WWW.KIMLEY-HORN.COM



JORDAN W. WALKER, P.E. FLLICENSE NUMBER 78652 FL DATE:


LICENSED PROFESSIONAL


DETAILS 02


SHEET NUMBER 28


8/3/2023 10:38 AM


DEFAULT

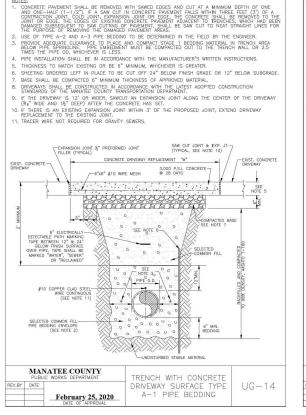


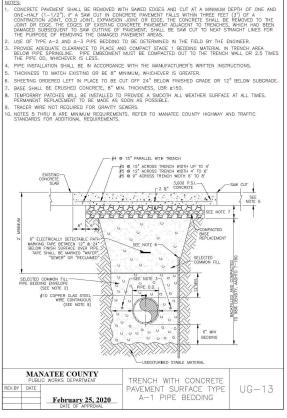


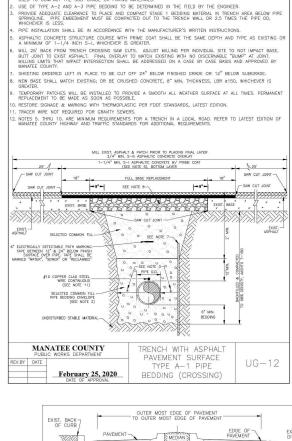


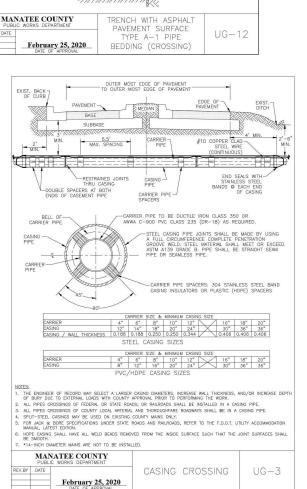


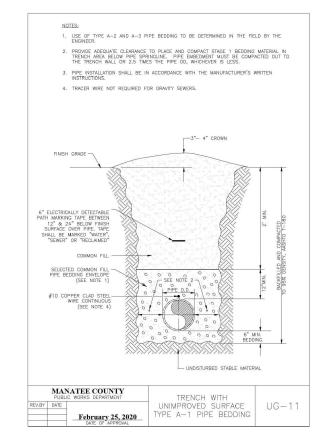

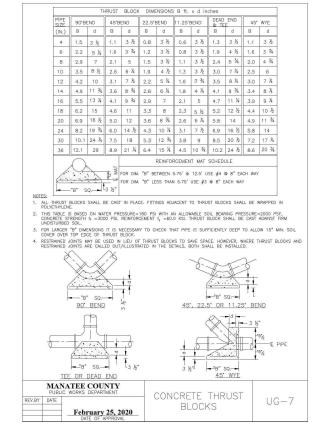

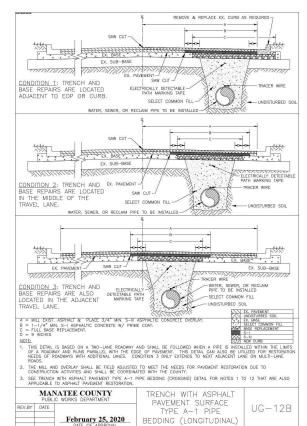

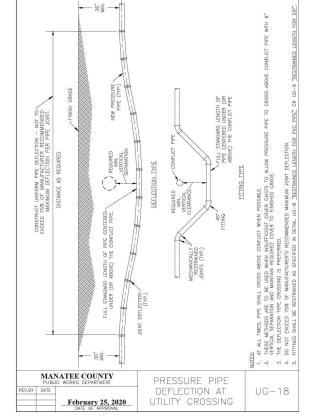

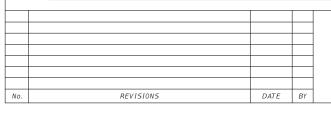

Kimley **Horn

KIMLEY-HORN AND ASSOCIATES, INC. 200 CENTRAL AVENUE, SUITE 600, ST. PETERSBURG, FL 33701 PHONE: (727) 547-3999 WWW.KIMLEY-HORN.COM

PROJECT NO 148400103 DATE 8/3/23 SCALE AS SHOWN DRAWN BY BMS



LENA ROAD UTILITY RELOCATIONS CHECKED BY SLB MANATEE COUNTY

JORDAN W WALKER, P.E. FLLICENSE NUMBER

FL DATE:

LICENSED PROFESSIONAL

78652


DETAILS 03


SHEET NUMBER


29

8/3/2023 10:38 AM

DEFAULT

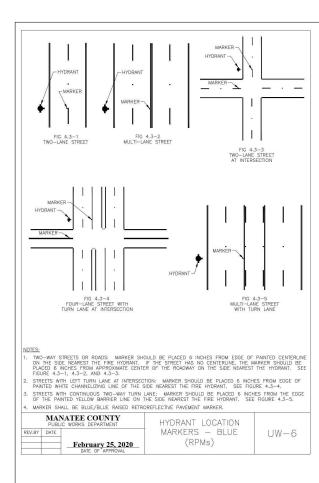

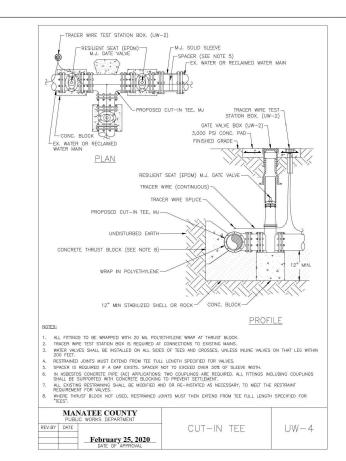

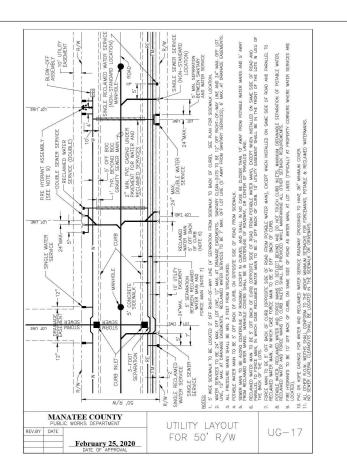

| | | | | Γ |
|-----|-----------|------|----|---|
| | | | | |
| | | | | |
| | | | | |
| | | | | |
| | | | | |
| | | | | |
| No. | REVISIONS | DATE | BY | |
| | | | | |

Kimley≫**Horn**

KIMLEY-HORN AND ASSOCIATES, INC. 200 CENTRAL AVENUE, SUITE 600, ST. PETERSBURG, FL 33701 PHONE: (727) 547-3999 WWW.KIMLEY-HORN.COM

PROJECT NO. 148400103 DATE 8/3/23 SCALE AS SHOWN



JORDAN W. WALKER, P.E. FLLICENSE NUMBER 78652

FL DATE:

LICENSED PROFESSIONAL

DETAILS 04

SHEET NUMBER 30

8/3/2023 10:38 AM DEFAULT