



EXAMPLE OF SECTION CUT AND DETAIL

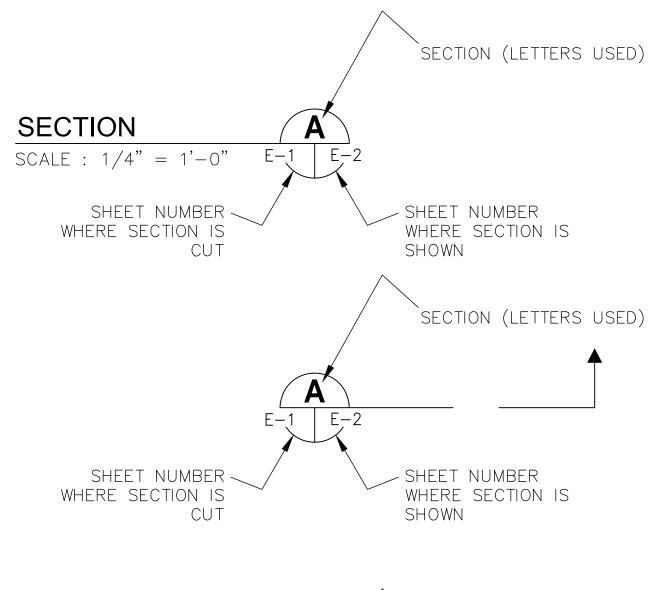

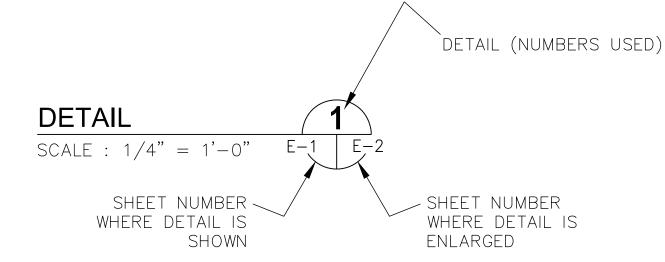

<u>abbreviat</u>	IONS:	
A AFF AFG C DFS DIA EX ELEC GFI GND HP HZ IG KVW MAX MIN N/A PH PLC RECP RPM RTU SPD	AMPS ABOVE FINISHED FLOOR ABOVE FINISHED GRADE CONDUIT DATA FLOW SYSTEMS DIAMETER EXISTING ELECTRICAL GROUND FAULT INTERRUPTER GROUNDING CONDUCTOR HORSEPOWER HERTZ ISOLATED GROUND KILOVOLT AMPERES KILOWATTS MAXIMUM MINIMUM NOT APPLICABLE PHASE PROGRAMMABLE LOGIC CONTROLLER RECEPTACLE REVOLUTIONS PER MINUTE REMOTE TERMINAL UNIT SURGE PROTECTION DEVICE STAINLESS STEEL	
V VFD WP		



·			
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KHA PROJECT
148400020

DATE
4/23/2018

SCALE AS SHOWN

DESIGNED BY TDT

DRAWN BY JLH

HECKED BY

TDT MANATEE COUNTY



TIMOTHY THOMAS, P.E.

FL LICENSE NUMBER


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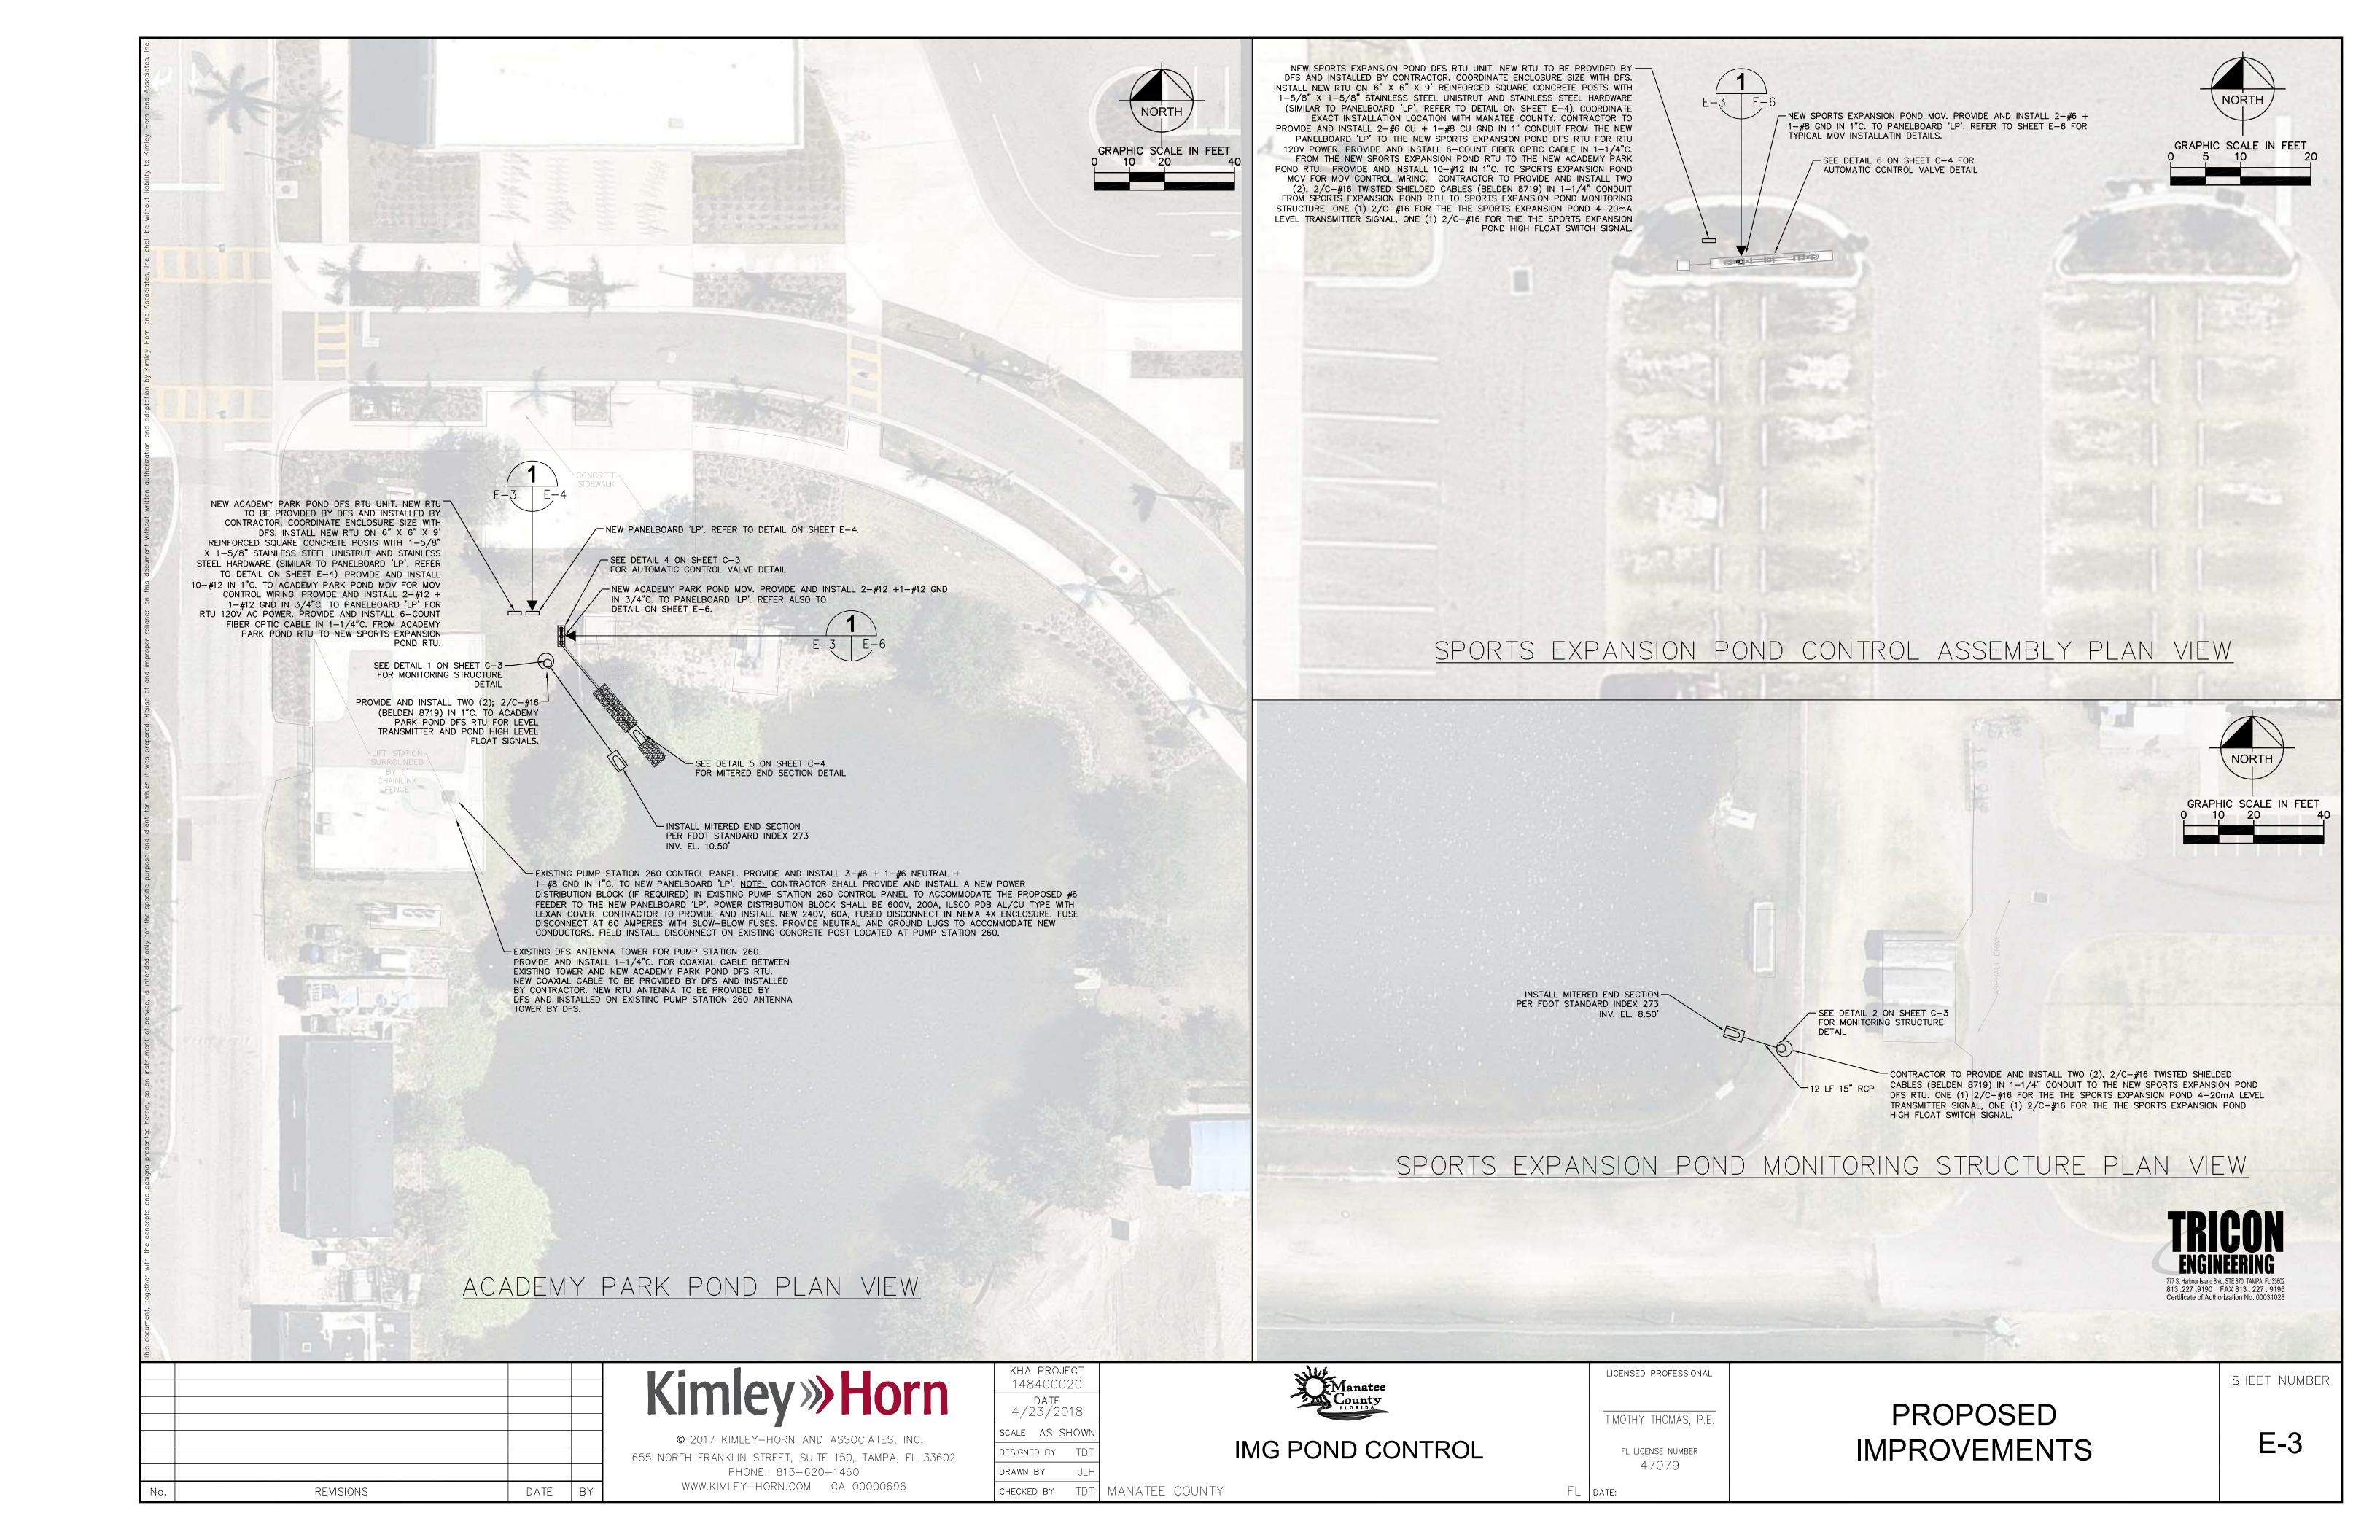
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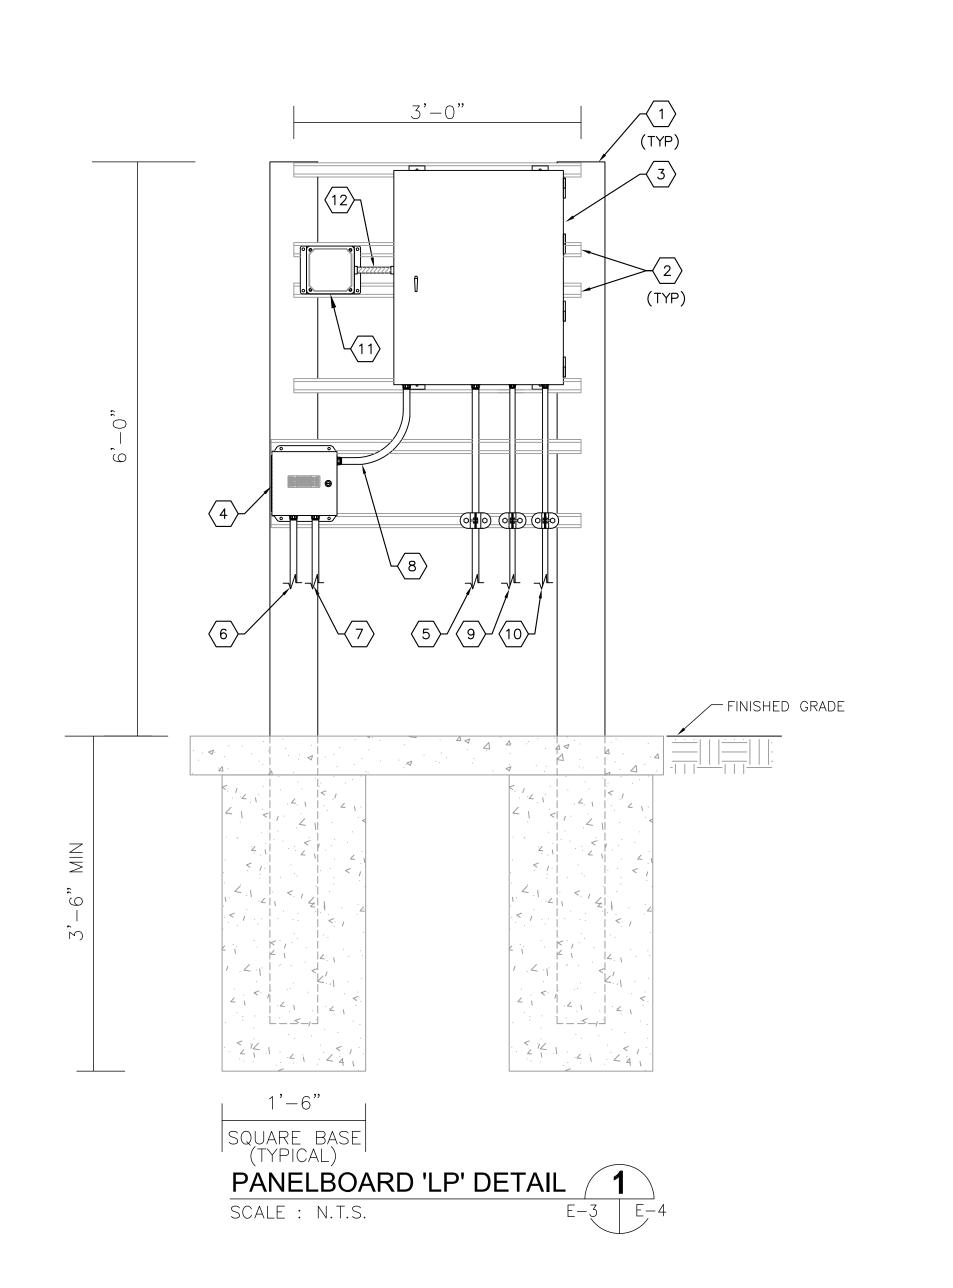
LICENSED PROFESSIONAL


ELECTRICAL LEGEND AND ABBREVIATIONS

SHEET NUMBER





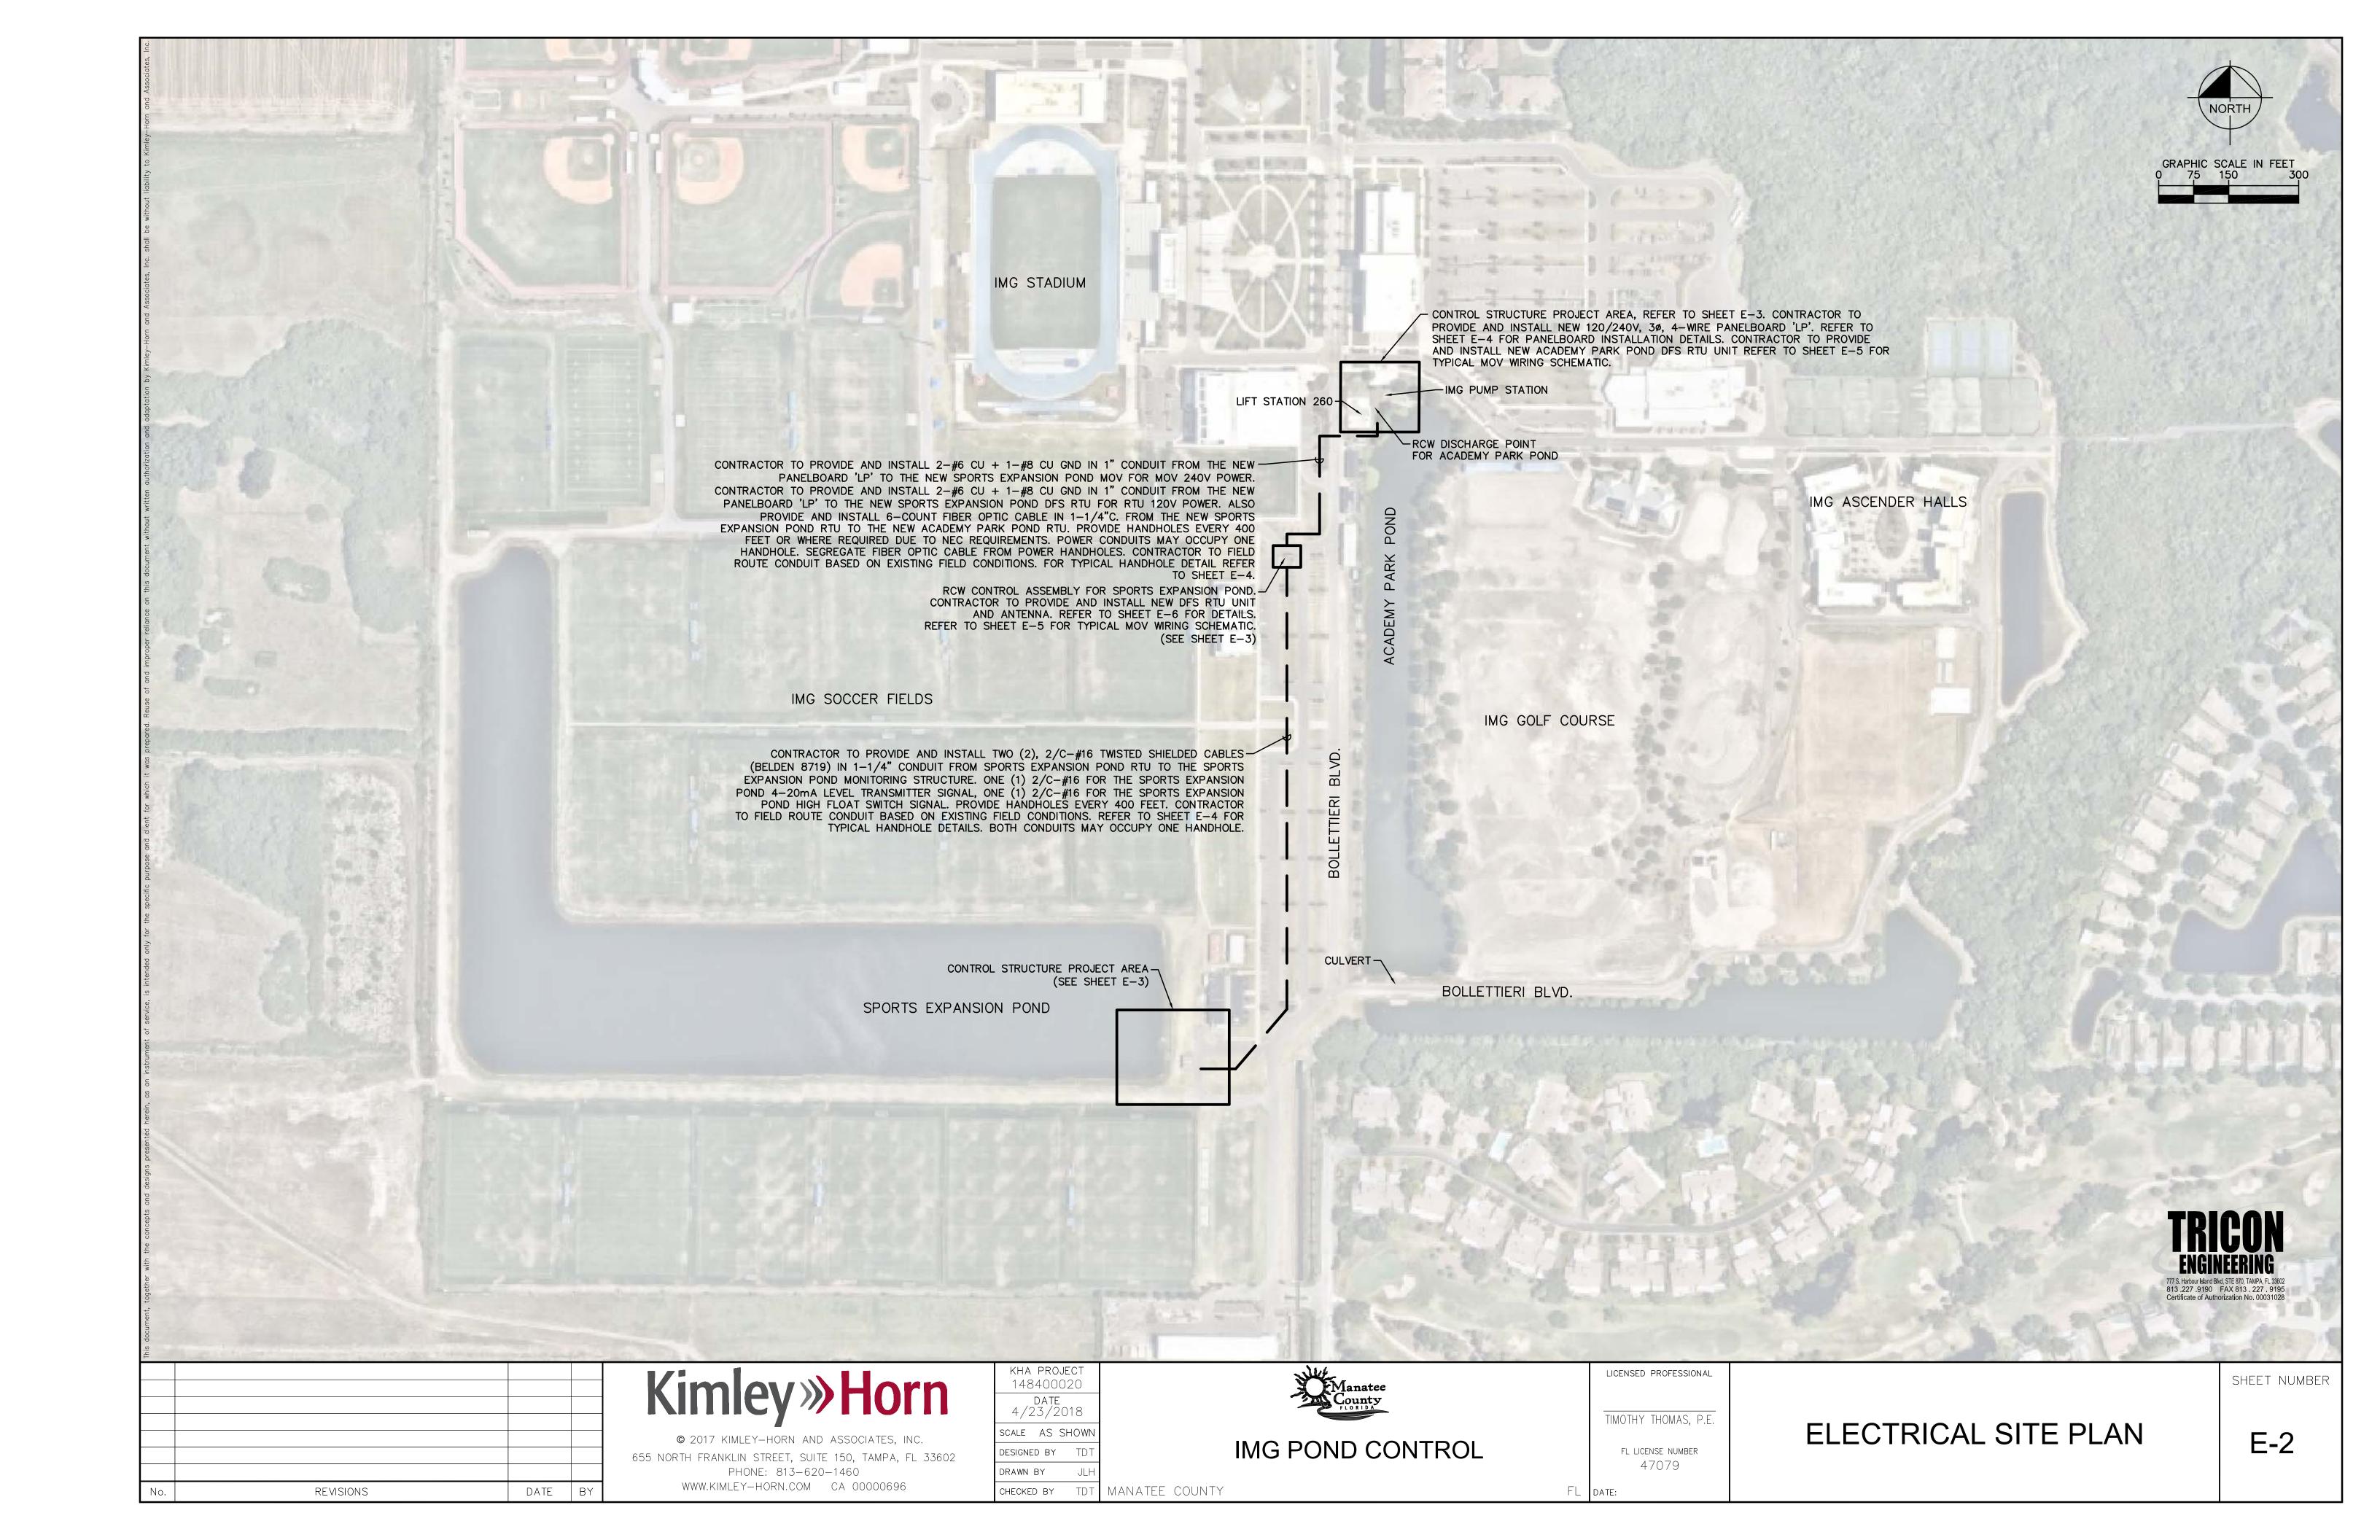

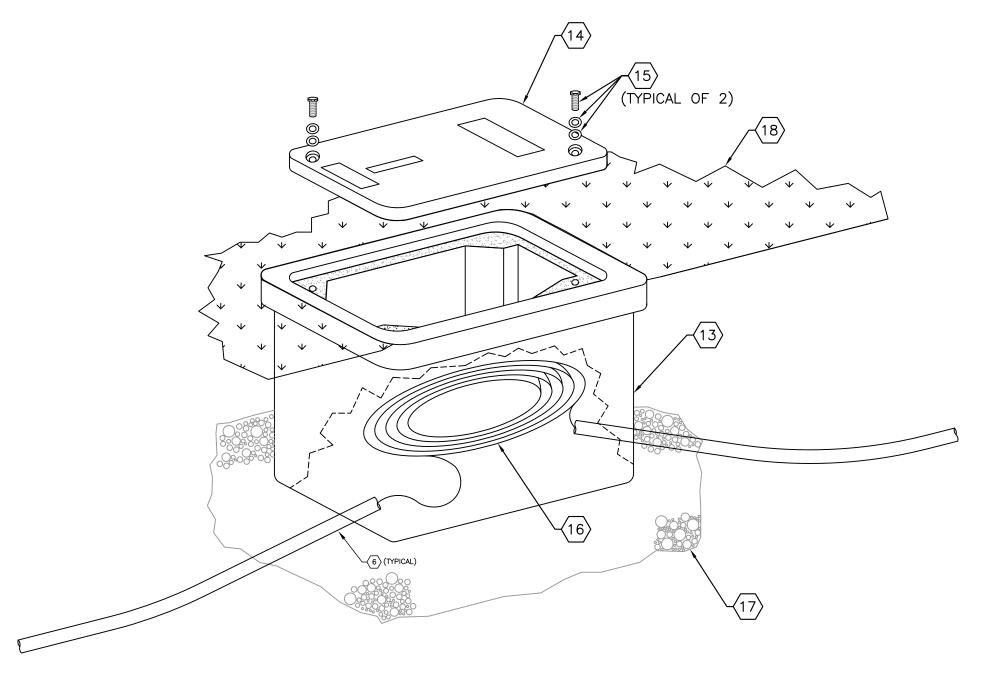

TYPICAL HANDHOLE DETAIL SCALE: N.T.S.

PROPOSED PANEL 'LP' SCHEDULE															
PANEL 'LP'; SQUARE D CO.; 120/208 VOLTS, 3Ø, 4W; 100 AMP MAIN LUGS ONLY; 35K AIC RATING; CU GROUND BUS; TOP AT 5'-6" AFF															
EQUIPMENT SERVED	CIRCI	JIT BRE	AKER FRAME	K\ A	/A/PHAS	SE C	CIRC. NO.	CIRC.	KV A	/A/PHA: B	SE C	CIRC POLE		EAKER FRAME	EQUIPMENT SERVED
ACADEMY PARK MOV	2	15	QOB	0.8			1	2	0.5			1	20	QOB	ACADEMY PARK DFS RTU
" "	_	_	_		0.8		3	4				1	20	QOB	SPARE
SPORTS EXPANSION MOV	2	15	QOB			0.8	5	6							SPACE
"	_	_	_	0.8			7	8							SPACE
SPACE					0.8		9	10		•					SPACE
SPORTS EXPANSION DFS RTU	1	20	QOB			0.5	11	12			•				SPACE
SURGE PROTECTION DEVICE	3	30	QOB	•			13	14	•						SPACE
"	_	_	_				15	16		•					SPACE
" "	_	_	_				17	18							SPACE
	_ KVA	1.6	0.8	1.3			0.5								
TOTAL CONNECTED LOAD = 4.2 KVA TOTAL DEMAND LOAD = 4.2 KV											DEMAND LOAD = 4.2 KVA				

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2. INSURE NO 120V BRANCH CIRCUITS ARE CONNECTED TO 'HIGH LEG' OF PANELBOARD.

NOTES: 1. ALL CIRCUIT BREAKERS TO BE BOLT ON TYPE.

KHA PROJECT 148400020 DATE 4/23/2018 SCALE AS SHOWN ESIGNED BY DRAWN BY

HECKED BY

TDT | MANATEE COUNTY



LICENSED PROFESSIONAL TIMOTHY THOMAS, P.E. FL LICENSE NUMBER 47079

FL DATE:

GENERAL NOTES:

KEY NOTES:

SCHEDULE.

1. CONTRACTOR SHALL FIELD VERIFY EXISTING CONDITIONS PRIOR TO BEGINNING CONSTRUCTION. CONTRACTOR

SHALL NOTIFY ENGINEER OF DISCREPANCIES.

1) PROVIDE AND INSTALL 6" X 6" X 9' REINFORCED

2 PROVIDE AND INSTALL 1-5/8" X 1-5/8" STAINLESS STEEL UNISTRUT WITH STAINLESS STEEL HARDWARE. NOTE: INSTALL ALL BOLTS FOR UNISTRUT COMPLETELY

PANELBOARD 'LP' IN NEMA 3R ENCLOSURE. PROVIDE 60 AMPERE MAIN CIRCUIT BREAKER. SQAURE D TYPE NQ OR EQUAL. REFER ALSO TO THIS SHEET FOR PANEL

STAINLESS STEEL JUNCTION BOX. HAMMOND EJ884S16 WITH STAINLESS STEEL BACKPANEL. PROVIDE AND INSTALL BARRIER TERMINAL BLOCK, COPPER BUSSMAN

PROVIDE AND INSTALL 3-#6 CU + 1-#6 CU NEUTRAL + 1-#8 CU GND. IN 1-1/4"C. FROM PUMP STATION 260 CONTROL PANEL TO NEW PANELBOARD 'LP'.

1"C. FROM PANELBOARD 'LP' (VIA TERMINAL BLOCK) TO NEW SPORTS EXPANSION CONTROL ASSEMBLY MOTOR

1"C. FROM PANELBOARD 'LP' (VIA TERMINAL BLOCK) TO NEW SPORTS EXPANSION CONTROL ASSEMBLY DFS RTU

2-#10 CU + 1-#10 CU GND FOR SPORTS EXPANSIONCONTROL ASSEMBLY MOTOR OPERATED VALVE 240V POWER, 2-#10 CU + 1-#10 CU GND FOR SPORTS EXPANSION CONTROL ASSEMBLY DFS RTU CABINET 120V

14002-6 OR EQUAL TO TRANSITION #6 FEEDER

 $\langle 6 \rangle$ PROVIDE AND INSTALL 2-#6 CU + 1-#8 CU GND IN

 $\langle 7 \rangle$ PROVIDE AND INSTALL 2-#6 CU + 1-#8 CU GND IN

 $\langle 8 \rangle$ PROVIDE AND INSTALL 4-#10 CU + 2-#10 CU GND IN 1"C. FROM TERMINAL BLOCK TO PANELBOARD 'LP'.

 $\langle 9 \rangle$ PROVIDE AND INSTALL 2-#12 CU + 1-#12 CU GND IN 3/4"C. FROM PANELBOARD 'LP' TO NEW ACADEMY PARK CONTROL ASSEMBLY MOTOR OPERATED VALVE FOR 240V

 $\langle 10 \rangle$ PROVIDE AND INSTALL 2-#12 CU + 1-#12 CU GND IN

PROVIDE AND INSTALL SURGE PROTECTION DEVICE (SPD)

12) PROVIDE AND INSTALL 3-#10 THWN + 1-#10 THWN CU

24" x 36" x 30" FIBER-REINFORCED POLYMER CONCRETE HANDHOLE.

(14) "HH" TRAFFIC-RATED LID. PROVIDE RECESSED

BOLTS SHALL BE A MINIMUM OF 5/8".

 $\langle 16 \rangle$ PROVIDE A MINIMUM OF 10 FEET OF SLACK

THE BOTTOM OF THE HANDHOLE.

15 STAINLESS STEEL BOLTS AND ASSOCIATED HARDWARE.

17) PROVIDE A BED OF PEA ROCK GRAVEL (6" MINIMUM

CONDUCTOR(S). CONDUCTOR QUANTITY/TYPE VARY BY

DEPTH, 3" MINIMUM EXTERIOR OF HANDHOLE) INSIDE

NEUTRAL + 1-#10 THWN CU GND IN 3/4 SEAL-TITE CONDUIT TO SPD CIRCUIT BREAKER.

IDENTIFICATION MARKING OF "FIBER OPTIC" PERMANENTLY INDENTED IN THE COVER. LID SHALL BE PROVIDED WITH

UNIT, 120/240V, 3ø, TYPE 1, ASCO SERIES 400, IN

DFS RTU CABINET FOR 120V POWER.

NEMA 4X ENCLOSURE.

NON-SKID SURFACE.

(18) FINISHED GRADE.

3/4"C. FROM PANELBOARD 'LP' TO NEW ACADEMY PARK

(3) PROVIDE AND INSTALL NEW 240V, 3ø, 4-WIRE

 $\langle 4 \rangle$ PROVIDE AND INSTALL 8" X 8" x 4" NEMA 4X

CONDUCTORS TO #10 CONDUCTORS.

OPERATED VALVE FOR 240V POWER.

CABINET FOR 120V POWER.

POWER.


SQUARE CONCRETE POST.

THROUGH CONCRETE POSTS.

SHEET NUMBER

813 227 9190 FAX 813 227 9195

ELECTRICAL DETAILS

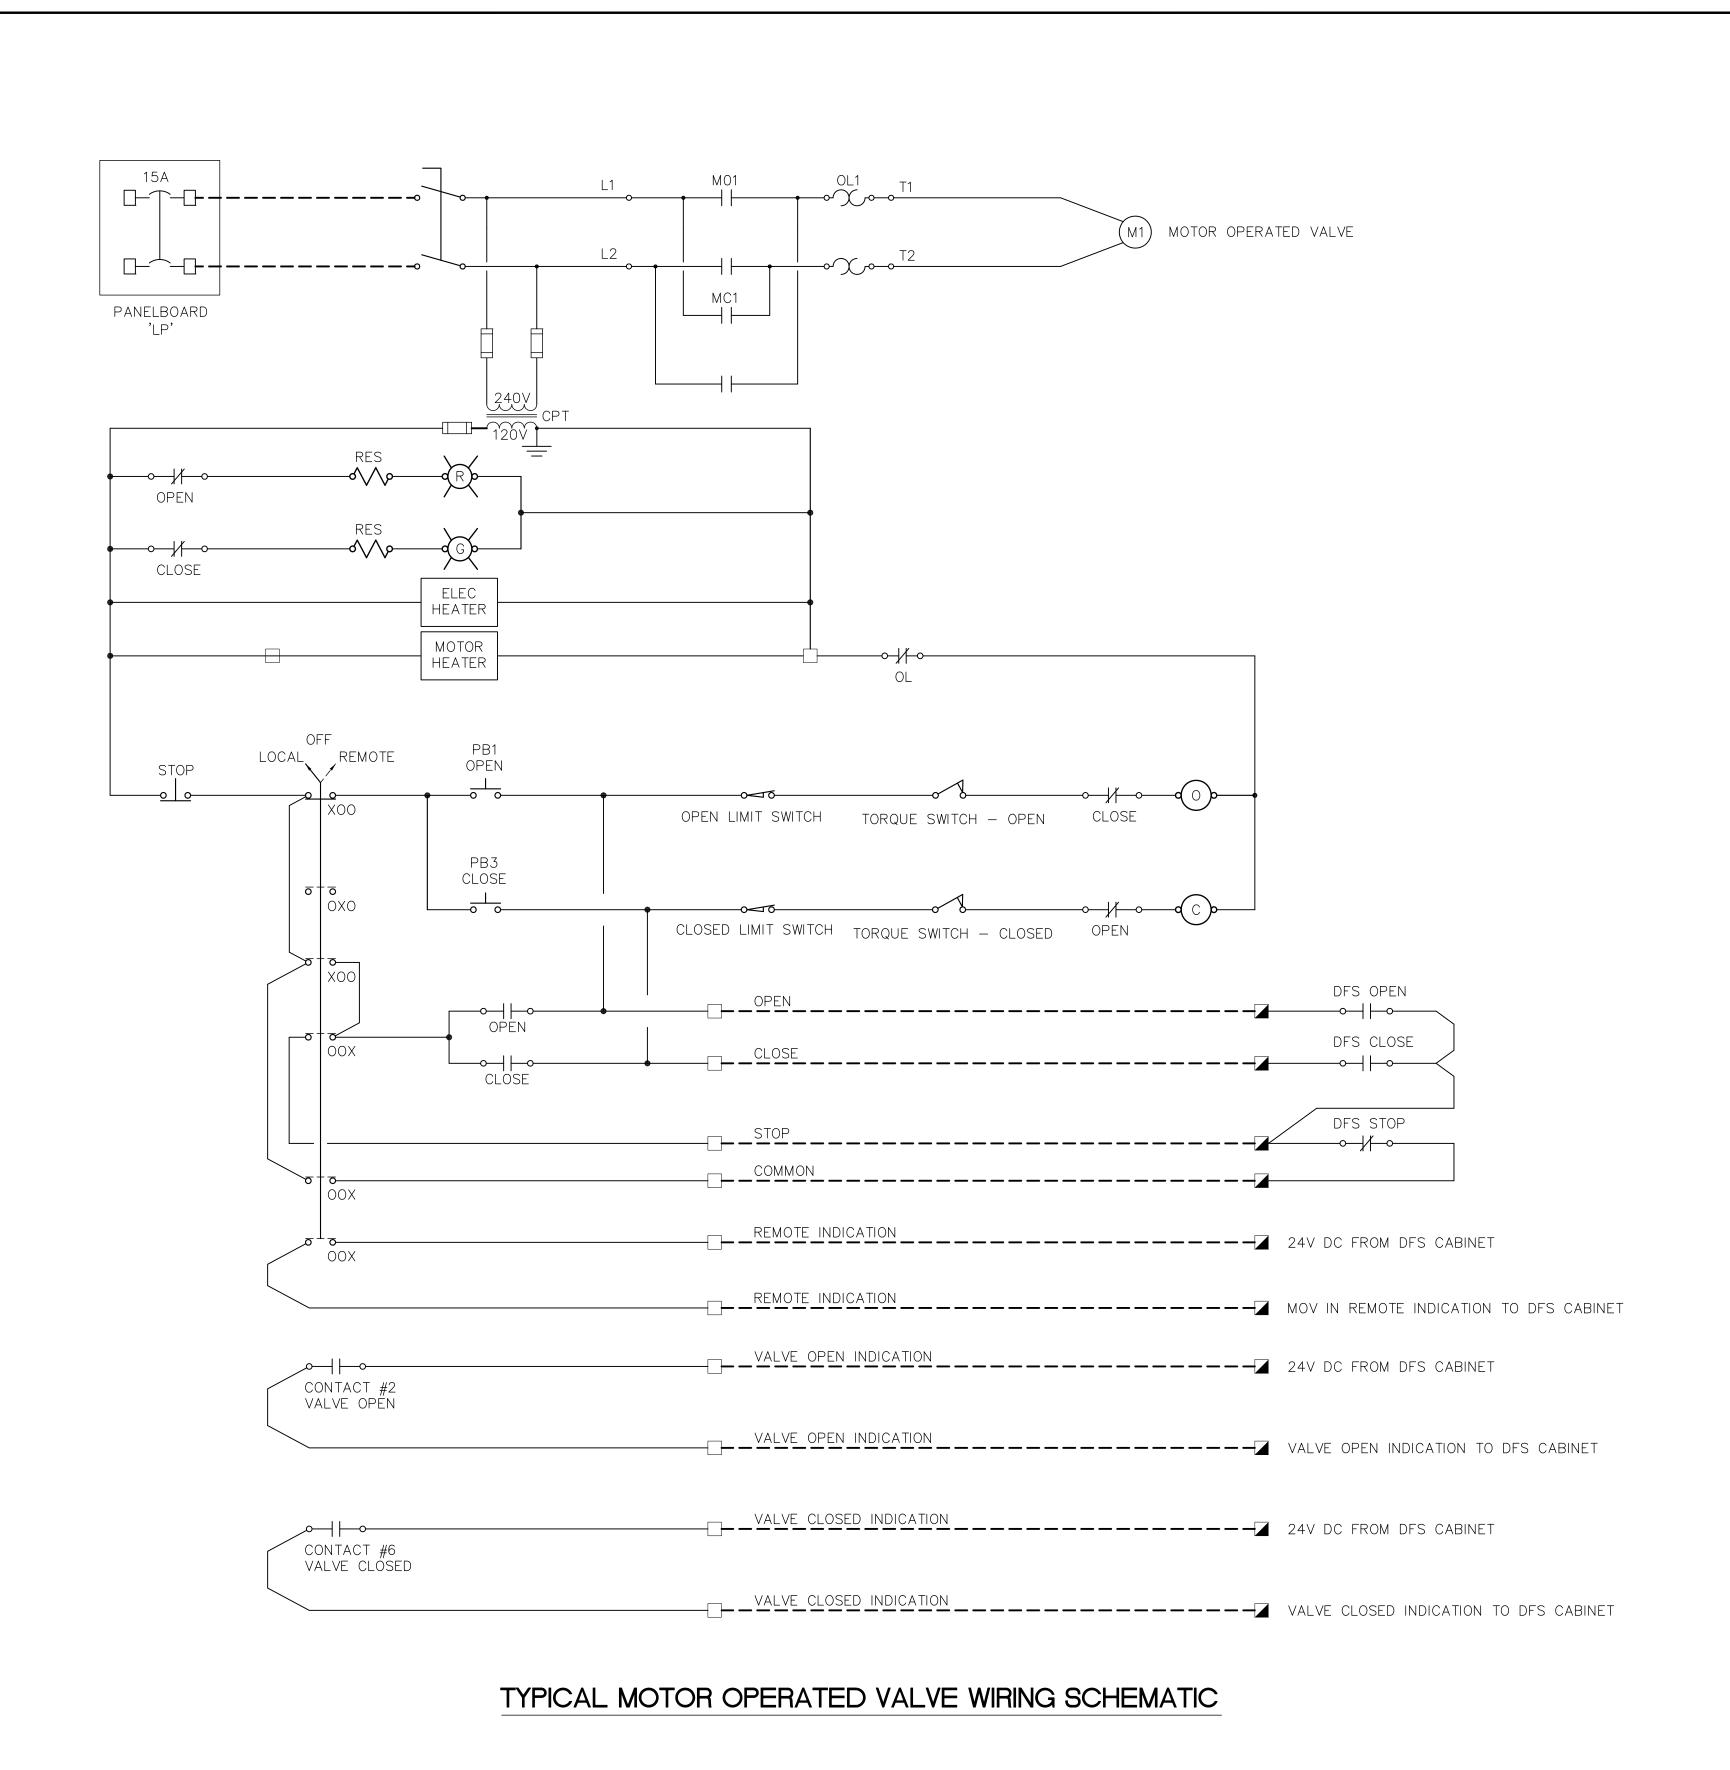

GENERAL NOTES:

1. WIRING SCHEMATIC SHOWN IS BASED ON INFORMATION PROVIDED BY A SPECIFIC MOV MANUFACTURER AND DEPICTS THE I/O AND CONTROLS REQUIRED. THE CONTRACTOR SHALL COORDINATE WITH THE MANUFACTURER OF THE MOV SELECTED/PROVIDED TO INSURE THE PROPER FUNCTIONS ARE PROVIDED.

LEGEND

TERMINAL BLOCK ON MOV

TERMINAL BLOCK IN DFS RTU CABINET

---- FIELD WIRING

TRICON ENGINEERING 777 S. Harbour Island Blvd, STE 870, TAMPA, FL 33602 813.227.9190 FAX 813.227.9195 Confidence of Authorisin No. 90231038

No. REVISIONS DATE BY

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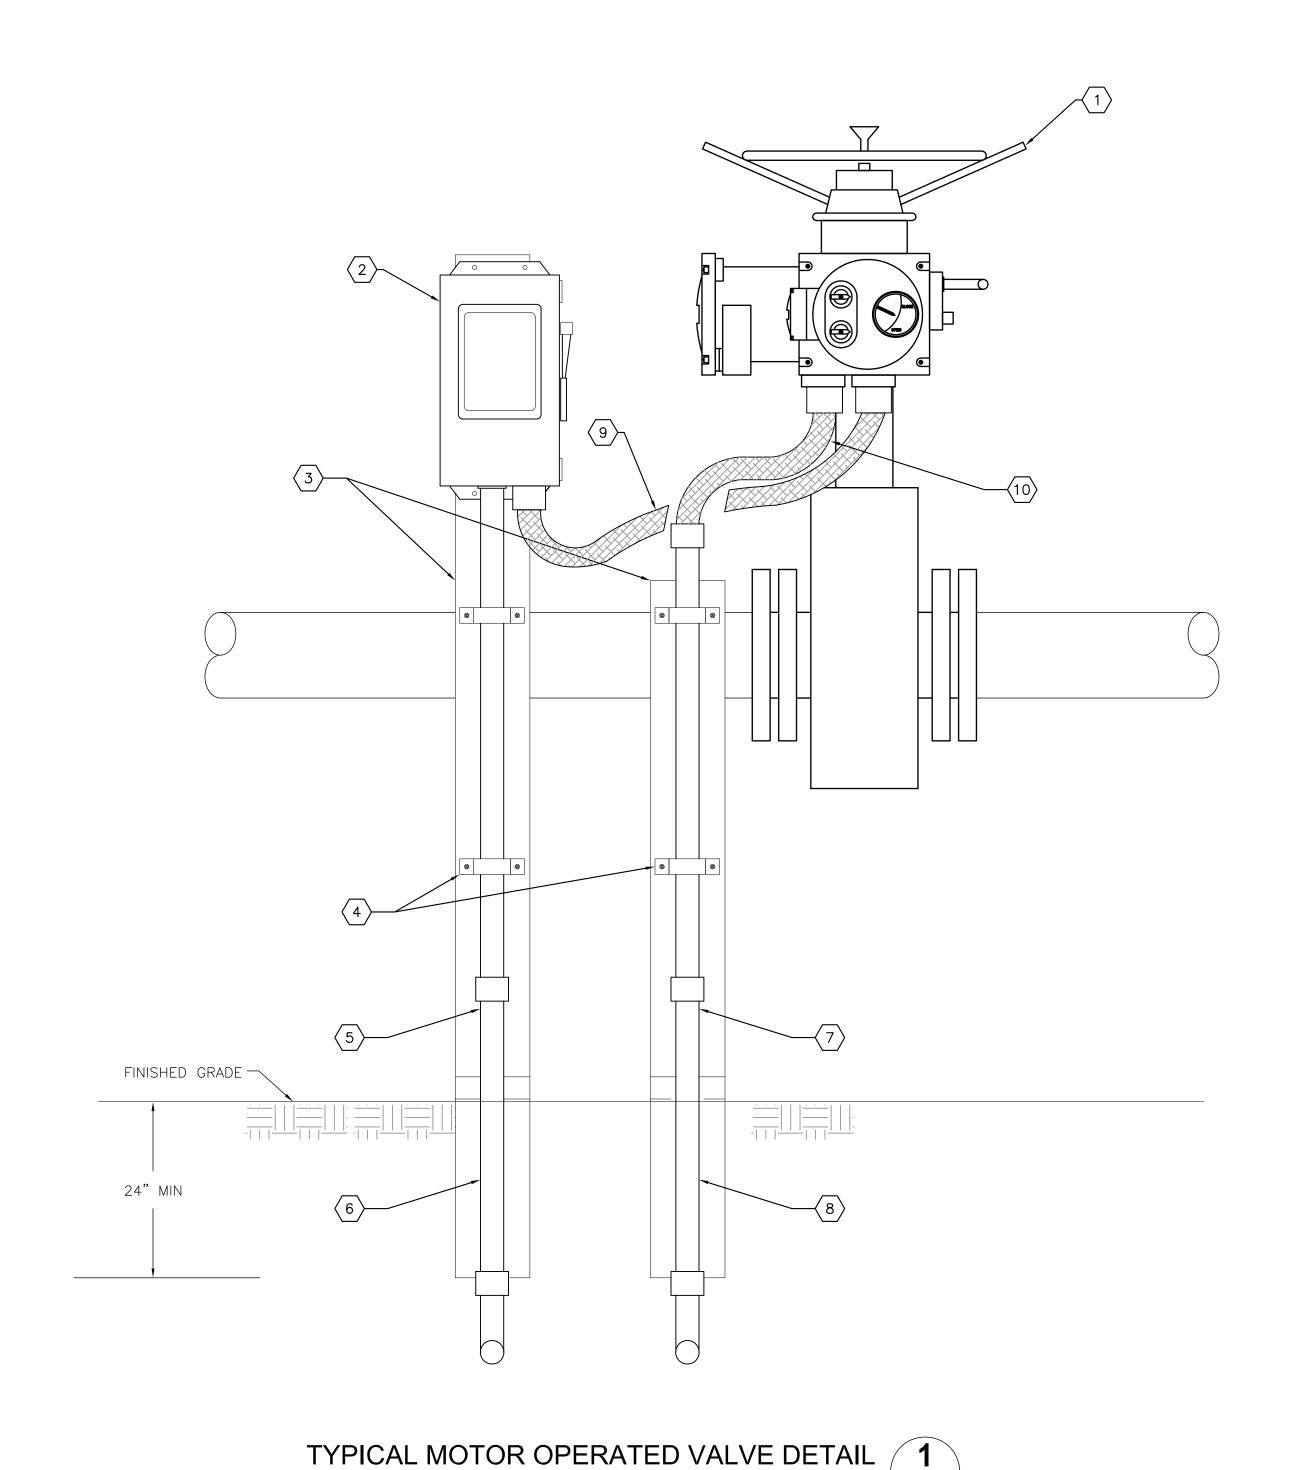
IMG POND CONTROL

TIMOTHY THOMAS, P.E.

FL LICENSE NUMBER 47079

TYPICAL
MOTOR OPERATED VALVE
CONTROL SCHEMATICS

SHEET NUMBER



GENERAL NOTES:

1. MOTOR OPERATED VALVE DETAIL SHOWN IS BASED ON INFORMATION PROVIDED BY A SPECIFIC MOV MANUFACTURER AND DEPICTS THE DIMENSIONS, CONDUIT ENTRY LOCATIONS, ETC. SPECIFIC TO A CERTAIN MANUFACTURER. THE CONTRACTOR SHALL COORDINATE THE INSTALLATION DETAILS WITH THE MOV SELECTED/PROVIDED.

KEY NOTES:

- 1) NEW MOTOR OPERATED VALVE.
- PROVIDE AND INSTALL NEW 30A, 2-POLE, NON-FUSED DISCONNECT IN NEMA 4X STAINLESS STEEL ENCLOSURE.
- 3 PROVIDE AND INSTALL 4" X 4" SQUARE CONCRETE POST
- 4 PROVIDE AND INSTALL CONDUIT STRAPS AS REQUIRED (TYPICAL).
- PROVIDE AND INSTALL 2-#6 CU + 1-#8 CU GND IN 1"
 RIGID ALUMINUM CONDUIT TO PANELBOARD 'LP' FOR
 SPORTS EXPANSION POND MOV 240V POWER. PROVIDE
 AND INSTALL 2-#12 CU + 1-#12 CU GND IN 3/4" RIGID
 ALUMINUM CONDUIT TO PANELBOARD 'LP' FOR ACADEMY
 PARK POND MOV 240V POWER.
- PROVIDE AND INSTALL 2-#6 CU + 1-#8 CU GND IN 1"
 PVC CONDUIT TO PANELBOARD 'LP' FOR SPORTS
 EXPANSION POND MOV 240V POWER. PROVIDE AND
 INSTALL 2-#12 CU + 1-#12 CU GND IN 3/4" PVC
 CONDUIT TO PANELBOARD 'LP' FOR ACADEMY PARK
 POND MOV 240V POWER.
- 7 PROVIDE AND INSTALL 10-#12 CU + 1-#12 CU GND IN 1" RIGID ALUMINUM CONDUIT TO SPORTS EXPANSION POND DFS RTU FOR MOV CONTROL WIRING.
- 8 PROVIDE AND INSTALL 10-#12 CU + 1-#12 CU GND IN 1" PVC CONDUIT TO ACADEMY PARK POND DFS RTU FOR MOV CONTROL WIRING.
- PROVIDE AND INSTALL 2-#12 CU + 1-#12 CU GND IN 3/4" NON-METALLIC WEATHERPROOF, FLEXIBLE CONDUIT FOR ACADEMY PARK POND MOV 240V POWER. PROVIDE AND INSTALL 2-#10 CU + 1-#10 CU GND IN 3/4" NON-METALLIC WEATHERPROOF, FLEXIBLE CONDUIT FOR SPORTS EXPANSION POND MOV 240V POWER.
- PROVIDE AND INSTALL CONTROL CONDUCTORS IN 1" NON-METALLIC WEATHERPROOF, FLEXIBLE CONDUIT.



No. REVISIONS DATE BY

SCALE: N.T.S.

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TDT MANATEE COUNTY



IMG POND CONTROL

TIMOTHY THOMAS, P.E.

47079

FL DATE:

LICENSED PROFESSIONAL

TYPICAL MOTOR OPERATED VALVE INSTALLATION DETAILS

SHEET NUMBER