MANATEE COUNTY PUBLIC WORKS DEPARTMENT

CONTRACT PLANS

INDEX OF UTILITY RELOCATION PLANS

SHEET NO. SHEET DESCRIPTION

KEY SHEET


U-2 SIGNATURE SHEET TABULATION OF QUANTITIES U-3


U-4 PROJECT LAYOUT U-5 GENERAL NOTES

UTILITY RELOCATION PLANS U-6 THRU U-11

U-12 THRU U-18 UTILITY DETAILS

MANATEE COUNTY PROJECT NUMBER 6094360 CANAL ROAD (16TH AVENUE EAST) SEGMENT 1 - US 301 TO 17TH STREET EAST UTILITY RELOCATION PLANS

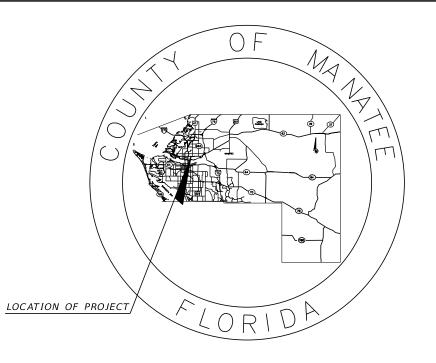

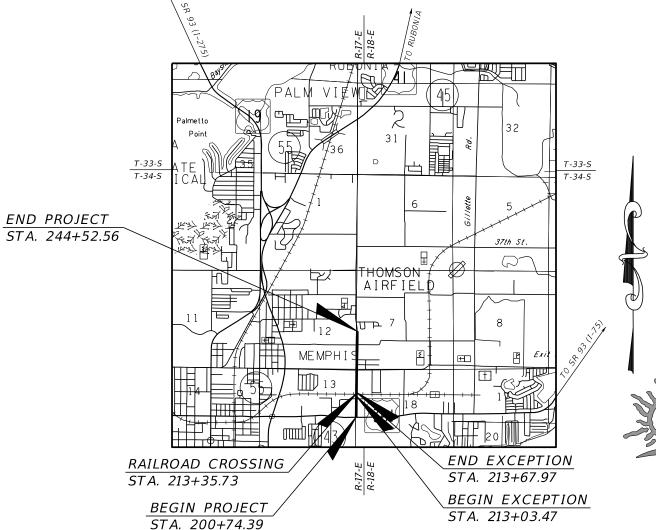

90% SUBMITTAL 12/2021


UTILITY RELOCATION PLANS ENGINEER OF RECORD:

HEATHER L. MANGANIELLO, P.E. P.E. NO.: 68385 HDR ENGINEERING, INC. 2601 CATTLEMEN ROAD, SUITE 400 SARASOTA, FLORIDA 34232 VENDOR NO. 47-0680568 CONTRACT NO.: 15-0909JE

MANATEE CO. PROJECT MANAGER: MICHAEL L. STURM, P.E.

NOTE: THE SCALE OF THESE PLANS MAY HAVE CHANGED DUE TO REPRODUCTION.

FISCAL	SHEET
YEAR	NO.
21	U-1

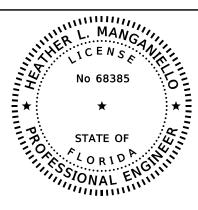

ON THE DATE ADJACENT TO THE SEAL

PRINTED COPIES OF THIS DOCUMENT ARE NOT CONSIDERED SIGNED AND SEALED AND THE SIGNATURE MUST BE VERIFIED ON ANY ELECTRONIC COPIES.

HDR ENGINEERING, INC. 2601 CATTLEMEN ROAD, SUITE 400 SARASOTA, FLORIDA 34232-6212 HEATHER L. MANGANIELLO, PE NO. 68385

THE ABOVE NAMED PROFESSIONAL ENGINEER SHALL BE RESPONSIBLE FOR THE FOLOWING SHEETS IN ACCORDANCE WITH RULE 61G15-23.004, F.A.C.

TABULATION OF QUANTITIES

UTILITY RELOCATION PLANS

U-3

SHEET NO. SHEET DESCRIPTION

U-1KEY SHEET U-2 SIGNATURE SHEET

U-4 PROJECT LAYOUT U-5 GENERAL NOTES

U-6 THRU U-11 UTILITY RELOCATION PLANS

U-12 THRU U-18 UTILITY DETAILS

				SCALE	NOTED
				DESIGNED BY	
				1	HLM
				DRAWN BY	
					JTT
1	90% SUBMITTAL	12/2021	JTT	CHECKED BY	
N/a	DEVICIONS	DATE	DV	1	иси

12/8/2021

HDR Engineering, Inc. 2601 Cattlemen Road Suite 400

Sarasota, FL 34232-6233

County PROJECT NO.

DATE

12/2021

Manatee MANATEE COUNTY PUBLIC WORKS

DESIGN ENGINEER HEATHER L. MANGANIELLO FL. LICENSE NO.

68385

SIGNATURE SHEET

SHEET NO.

U-2

PW:\3658\10001573\10131245\6.0_CAD_BIM\6.2_WIP\12345615201\utils\signuw01.dgn.DGN

	UTILITY PLANS (POTABLE	WATER MA	IN)						
ITEM NO.	ITEM	UNIT	U-6	U-7	U-8	U-9	U-10	U-11	TOTAL
MC-01-01	MOBILIZATION, WASTEWATER	LS							1
MC-01-02	6" DUCTILE IRON PIPE (RESTRAINED JOINT), POTABLE WATER	LF		20	41	44	65		170
MC-01-03	8" DUCTILE IRON PIPE (RESTRAINED JOINT), POTABLE WATER	LF		81		130		178	389
MC-01-04	10" DUCTILE IRON PIPE (RESTRAINED JOINT), POTABLE WATER	LF	495	700	700	700	700	678	3973
MC-01-05	12" DUCTILE IRON PIPE (RESTRAINED JOINT), POTABLE WATER	LF				41			41
MC-01-06	20" STEEL CASING, POTABLE WATER	LF		13	143				156
MC-01-07	REMOVE 6" PIPE, POTABLE WATER	LF				48	120		168
MC-01-08	REMOVE 8" PIPE, POTABLE WATER	LF		51		112		168	331
MC-01-09	REMOVE 10" PIPE, POTABLE WATER	LF	530	700	700	700	700	682	4012
MC-01-10	REMOVE 12" PIPE, POTABLE WATER	LF				41			41
MC-01-11	6" DUCTILE IRON ELBOW (RESTRAINED JOINT), POTABLE WATER	EA			2	4	4		10
MC-01-12	8" DUCTILE IRON ELBOW (RESTRAINED JOINT), POTABLE WATER	EA		4		6		10	20
MC-01-13	10" DUCTILE IRON ELBOW (RESTRAINED JOINT), POTABLE WATER	EA	8	2	2	6	4	4	26
MC-01-14	12" DUCTILE IRON ELBOW (RESTRAINED JOINT), POTABLE WATER	EA				4			4
MC-01-15	6" DUCTILE IRON UNION (RESTRAINED JOINT), POTABLE WATER	EA				1	2		3
MC-01-16	8" DUCTILE IRON UNION (RESTRAINED JOINT), POTABLE WATER	EA		1		1		3	5
MC-01-17	10" DUCTILE IRON UNION (RESTRAINED JOINT), POTABLE WATER	EA	1						2
MC-01-18	12" DUCTILE IRON UNION (RESTRAINED JOINT), POTABLE WATER	EA				1			1
MC-01-19	6" GATE VALVE (RESTRAINED JOINT), POTABLE WATER	EA		1	2	3	2		8
MC-01-20	8" GATE VALVE (RESTRAINED JOINT), POTABLE WATER	EA		1		1		4	6
MC-01-21	10" GATE VALVE (RESTRAINED JOINT), POTABLE WATER	EA		2	2	2	2	2	10
MC-01-22	12" GATE VALVE (RESTRAINED JOINT), POTABLE WATER	EA				1			1
MC-01-23	8"x6" DUCTILE IRON TEE (RESTRAINED JOINT), POTABLE WATER	EA				1			1
MC-01-24	10"x6" DUCTILE IRON TEE (RESTRAINED JOINT), POTABLE WATER	EA		1	2	1	2	1	7
MC-01-25	10"x8" DUCTILE IRON TEE (RESTRAINED JOINT), POTABLE WATER	EA		1		1		2	4
MC-01-26	10"x10" DUCTILE IRON TEE (RESTRAINED JOINT), POTABLE WATER	EA				1			1
MC-01-27	12"x6" DUCTILE IRON TEE (RESTRAINED JOINT), POTABLE WATER	EA				1			1
MC-01-28	12"x10" DUCTILE IRON REDUCER (RESTRAINED JOINT), POTABLE WATER	EA				1			1
MC-01-29	SAMPLE POINT, 6", POTABLE WATER	EA				1	2		3
MC-01-30	SAMPLE POINT, 8", POTABLE WATER	EA		1		1		3	5
MC-01-31	SAMPLE POINT, 10", POTABLE WATER	EA	1					1	2
MC-01-32	SAMPLE POINT, 12", POTABLE WATER	EA				1			1
MC-01-33	FIRE HYDRANT ASSEMBLY RELOCATION, POTABLE WATER	EA		1	2	1			4
MC-01-34	BLOWFOFF REMOVAL, POTABLE WATER	EA						1	1
MC-01-35	METER/BACKFLOW TO PREVENTOR RELOCATION, POTABLE WATER	EA		2	3	2			7
MC-01-36	METER/BACKFLOW TO REMAIN/CONNECT TO PROP. WM, POTABLE WATER	EA		1	1	1	1		4
MC-01-37	RECORD DRAWINGS, POTABLE WATER	LS		· ·	· ·	-	<u> </u>		1

	UTILITY PLANS (WASTEWATER FORCE MAIN)										
ITEM NO.	ITEM	UNIT	U-6	U-7	U-8	U-9	U-10	U-11	TOTAL		
MC-02-01	MOBILIZATION, WASTEWATER	LS							1		
MC-02-02	MANHOLE (ADJ.)	EA					3	2	5		
MC-02-03	VALVE (ADJ./MODIFY)	EA		1					1		
MC-02-04	SEWER SERVICE (REPLACE/ADJ.)	EA					1	1	2		

				SCALE AS NO	TED	
					ILU	
				DESIGNED BY		
					HLM	
				DRAWN BY	ITT	
1	90% SUBMITTAL	12/2021	JTT	CHECKED BY		
No.	REVISIONS	DATE	BY	1 <i>+</i>	HEH	

FJS

HDR Engineering, Inc. 2601 Cattlemen Road Suite 400 Sarasota, FL 34232-6233 DATE
12/2021

PROJECT NO.




DESIGN ENGINEER
HEATHER L.
MANGANIELLO
FL. LICENSE NO.

68385

TABULATION
OF QUANTITIES

SHEET NO.

U-3

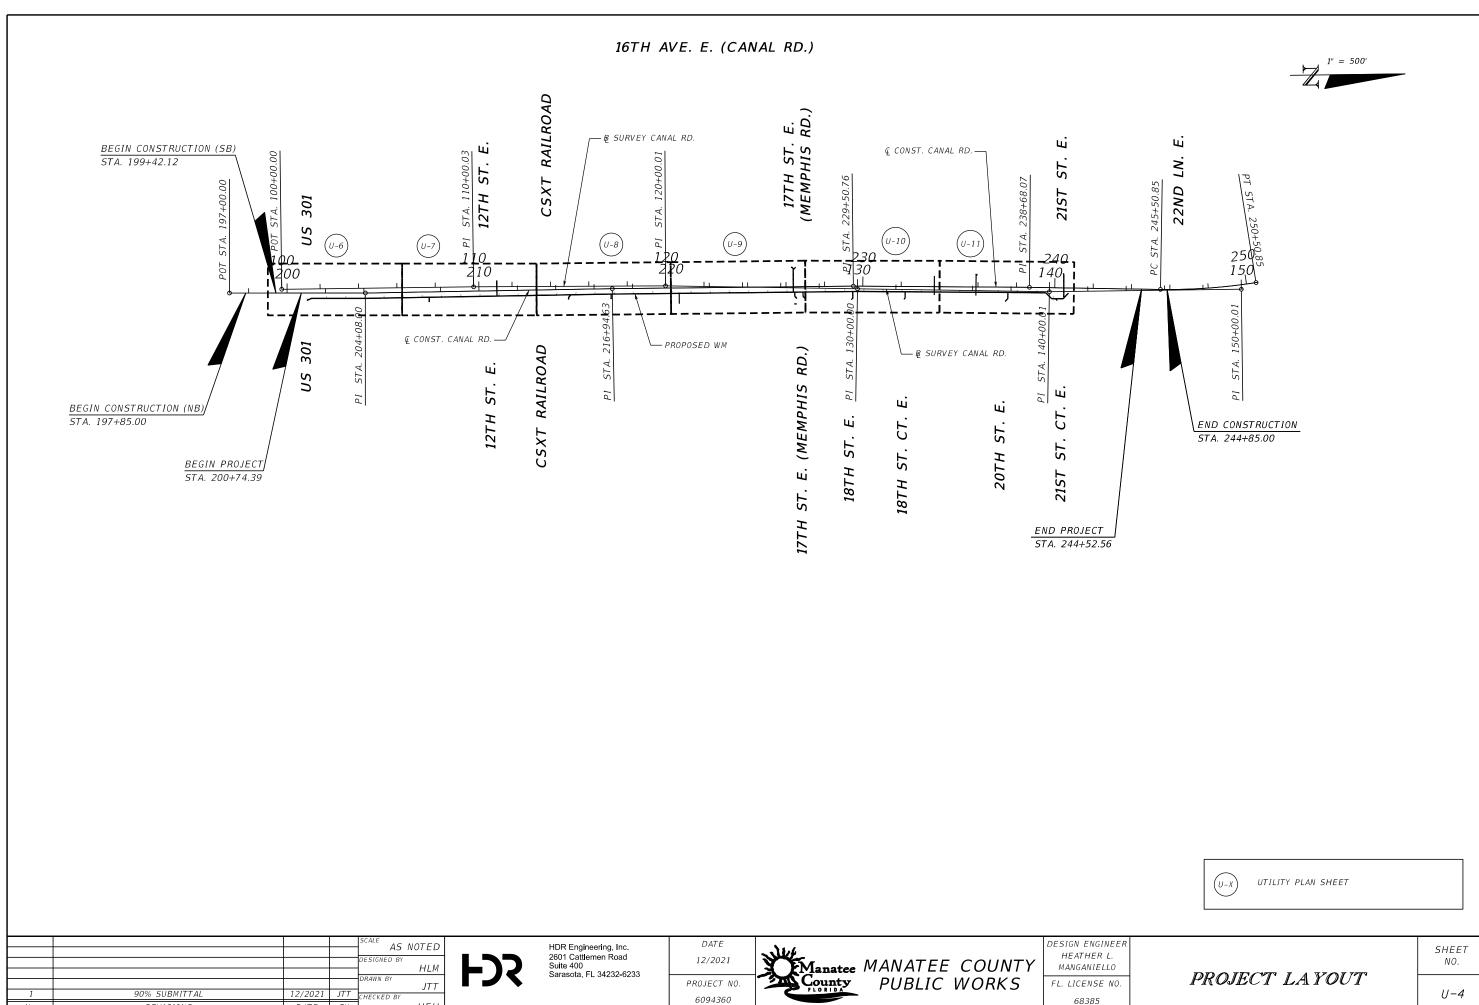

REVISIONS

12/8/2021

DATE BY

PW:\3658\10001573\10131245\6.0_CAD_BIM\6.2_WIP\12345615201\utils\playuw01.dgn

- 2. RECORD DRAWING INFORMATION SHALL BE SUPPLIED IN ACCORDANCE WITH THE MANATEE COUNTY PUBLIC WORKS UTILITY STANDARDS INCLUDING, BUT NOT LIMITED TO FINISHED GRADE ELEVATIONS, TIES TO MAINS, VALVES, FITTINGS, ELEVATIONS OF PIPES, AND LOCATIONS OF SAMPLE POINTS FOR COMPLIANCE TESTING, LOCATIONS, DIMENSIONS, AND ELEVATIONS OF ALL OTHER CONSTRUCTION COMPONENTS WHICH VARY FROM THE DESIGN.
- 3. RESPECTIVE PROPERTY OWNERS SHALL BE NOTIFIED A MINIMUM OF 48
 HOURS IN ADVANCE OF ANY AND ALL WORK REQUIRING DISRUPTION OF
 ACCESS, POTABLE WATER, RECLAIMED WATER, AND WASTEWATER SERVICE.
 DISRUPTION IN SERVICE TO ANY PROPERTY OWNER SHALL NOT EXCEED 2
 HOURS FOR WATER AND WASTEWATER.
- MAINTAIN AND PROTECT THE INTEGRITY OF THE UTILITY POLES DURING CONSTRUCTION.
- ALL WATER COLLECTED AND PUMPED DURING TRENCH DEWATERING ACTIVITIES SHALL COMPLY WITH AND BE PERFORMED IN ACCORDANCE WITH NPDES REQUIREMENTS.
- 6. COVER AS MEASURED FROM FINISHED (PROPOSED) GRADE TO TOP OF THE PIPELINE SHALL BE A MINIMUM OF 36 INCHES UNLESS OTHERWISE INDICATED.
- 7. PIPELINE ALIGNMENTS SHALL BE ADJUSTED (AS REQUIRED) HORIZONTALLY AND/OR VERTICALLY TO AVOID CONFLICTS WITH ACTUAL FIELD CONDITIONS AS UNCOVERED DURING CONSTRUCTION. FIELD ADJUSTMENT SHALL BE COORDINATED WITH, AND APPROVED BY, THE ENGINEER.
- 8. ALL FITTINGS, VALVES, PIPE AND APPURTENANCES TO BE RESTRAINED VIA MECHANICAL RESTRAINTS OR INTERNAL JOINT RESTRAINTS PER DETAIL UG-9. THRUST BLOCKS TO BE FURNISH AND INSTALLED IN ADDITION TO MECHANICAL RESTRAINTS WHERE NOTED.
- 9. REFER TO FDEP REQUIREMENTS AND TO AWWA CHAPTER C651-05 WHEN CONNECTING TO, AND DISINFECTING NEW AND EXISTING WATER MAINS. ALL FIRE HYDRANT ASSEMBLIES AND CONNECTING PIPES MUST BE INSPECTED, CLEANED, FLUSHED, AND DISINFECTED BEFORE THEY ARE CONNECTED TO THE NEWLY-INSTALLED PIPING. CLEARANCE MUST BE RECEIVED PRIOR TO TIE-ING TO EXISTING MAINS.
- 10. CONTRACTOR TO COORDINATE WITH COUNTY PUBLIC WORKS DEPARTMENT AND FIRE MARSHALL WHEN TAKING FIRE HYDRANTS OFFLINE. CONTRACTOR MUST RECEIVE APPROVAL FROM THE FIRE MARSHALL PRIOR TO TAKING FIRE HYDRANTS OUT OF SERVICE.
- 11. PROVIDE ALL DEWATERING EQUIPMENT NECESSARY TO KEEP EXCAVATIONS DRY AND SHALL PROVIDE ALL SHORING, SHEETING, AND BRACING NECESSARY TO PROTECT WORKMEN, ADJACENT STRUCTURES, UTILITIES, EXISTING PAVEMENT, OR TO MINIMIZE TRENCH WIDTH. PROVIDE ADEQUATE TRENCH SAFETY FOR TRENCH EXCAVATIONS, AND COMPLY WITH OSHA AND THE STATE OF FLORIDA TRENCH SAFETY REGULATIONS. THE COST OF DEWATERING SHALL BE INCLUDED IN THE PIPING PAY ITEMS.
- 12. CONTRACTOR TO COORDINATE WITH FPL AND/OR OTHER POWER COMPANIES
 PRESENT WITHIN RIGHT-OF-WAY FOR POWER POLE STABILIZATION AND
 DE-ENEGIZING OF POWER LINES DURING CONSTRUCTION. CONTRACTOR TO
 SUPPORT POWER POLES AND OTHER UTILITIES DURING CONSTRUCTION.
- 13. JACK AND BORE OF STEEL PIPE SHALL ALSO COMPLY WITH MANATEE COUNTY STANDARDS DETAIL UG-3.

- 14. ARV(S) ARE SHOWN IN LOCATIONS BASED ON DESIGN PROFILE. ARV(S) ARE TO BE INSTALLED AT ALL HIGH POINTS CREATED DURING CONSTRUCTION.

 LOCATIONS TO BE APPROVED BY COUNTY PRIOR TO CONSTRUCTION OF ARV.
- 15. THE CONTRACTOR SHALL PROTECT ALL EXISTING STRUCTURES, WATER AND SEWER LINES, STORM DRAINS, UTILITIES, DRIVEWAYS, SIDEWALKS, SIGNS, MAILBOXES, FENCES, TREES, LANDSCAPING, AND ANY OTHER IMPROVEMENT OR FACILITY IN THE CONSTRUCTION AREA. THE CONTRACTOR SHALL REPAIR AND/OR REPLACE ANY DAMAGED ITEMS DUE TO CONSTRUCTION ACTIVITIES TO EQUAL OR BETTER THAN PRE-CONSTRUCTION CONDITIONS AT NO ADDITIONAL COST TO THE OWNER.

SPECIAL CONDITIONS

- 1. BENCH MARK DATUM IN NORTH AMERICAN VERTICAL DATUM OF 1988 (NAVD 88).
- 2. CONSTRUCT HORIZONTAL AND VERTICAL TRANSITION OF PIPELINE BY
 DEFLECTION OF PIPE JOINTS USING NOT MORE THAN 75% OF THE MAXIMUM
 DEFLECTION RECOMMENED BY THE MANUFACTURER. SHOP DRAWINGS SHALL
 BE FURNISHED FOR APPROVAL OF ALL PIPE CONNECTIONS, TRANSITIONS, AND
 SPECIAL FITTINGS PRIOR TO FABRICATION OR DELIVERY TO JOB SITE.
- 3. PROVIDE TEMPORARY THRUST RESTRAINT, BRACING, TESTING PLUGS, AND OTHER DEVICES NECESSARY TO SUCCESSFULLY COMPLETE PRESSURE TESTING OF PIPING SYSTEMS.
- 4. ALL PROPOSED PIPE AND FITTINGS WITHIN PROJECT LIMITS SHALL BE
 RESTRAINED JOINT PER DETAIL UG-9. DUCTILE IRON PIPE AND FITTINGS ARE
 TO BE WRAPPED IN BLUE (WATER), PURPLE (RECLAIMED), OR GREEN
 (WASTERWATER) POLYETHYLENE WRAP IN ACCORDANCE WITH AWWA STANDARD
 C-105. POLYETHYLENE WRAP SHALL BE INCLUDED IN THE PRICE OF THE
 PIPE. EXISTING MAINS TO BE POST RESTRAINED PER DETAIL UG-9.
- 5. ALL EXISTING WATER MAINS, WASTEWATER FORCE MAINS, AND RECLAIMED WATER MAINS IDENTIFIED TO BE REMOVED OR PLACED OUT OF SERVICE CANNOT BE REMOVED OR PLACED OUT OF SERVICE UNTIL PROPOSED FACILITIES HAVE BEEN CONSTRUCTED, TESTED, CLEARED, AND PLACED IN SERVICE
- 6. WATER, RECLAIMED, AND WASTEWATER SERVICE CONVEYANCE MUST BE MAINTAINED FOR ALL CUSTOMERS AT ALL TIMES, EXCEPT FOR MINOR DISRUPTIONS DURING CONNECTIONS/CHANGEOVERS. COORDINATE ALL SYSTEM SHUT DOWNS WITH COUNTY OPERATIONS STAFF AND AS REQUIRED IN THE SPECIFICATIONS.
- 7. ALL UTILITY RELOCATION MUST BE IN PLACE, TESTED, CLEARED AND OPERATIONAL PRIOR TO ROADWAY CONSTRUCTION THAT IMPACTS EXISTING UTILITIES.
- 8. PROPOSED PIPE SYMBOLOGY

PROPOSED WATER MAINS, RECLAIMED, AND WASTEWATER

PROPOSED CASING

REMOVE, RELOCATE, AND/OR ABANDON

© CONST. CANAL RD.
OFFSET DISTANCE FROM
© CONST. CANAL RD.
STA 344+56, 124.6 LT

PROPOSED FITTING:

J (EXAMPLE)

PROPOSED GATE VALVE:
PROPOSED PLUG VALVE:

K

VVH BY MANATEE COUNTY:



- 9. IN THE EVENT OF A WATER OR SEWER MAIN BREAK, CALL 24 HOUR EMERGENCY NUMBER (941) 792-8811 EXT. 5216
- 10. ALL CONCRETE SHOWN IN THESE DRAWINGS, UNLESS
 OTHERWISE NOTED, SHALL CONFORM TO CLASS NS CONCRETE.
- 11. THESE CONTRACT DOCUMENTS INCLUDE BY REFERENCE THE MANATEE COUNTY PUBLIC WORKS UTILITY STANDARDS APPROVED FEBRUARY 2020.
- 12. SUBMIT WATER MAIN BACTERIOLOGICAL SAMPLING PLAN FOR REVIEW. SAMPLE LOCATIONS INCLUDE, AT A MINIMUM, ALL POINTS OF CONNECTION TO EXISTING WATER MAIN. ALL TERMINAL ENDS AND MAXIMUM INTERVALS OF 1,200 FEET BETWEEN TWO SAMPLING LOCATIONS. SAMPLE POINT FURNISH AND INSTALLATION AND REMOVAL COST TO BE INCORPORATED INTO COST OF NEW MAINS. NOTE SAMPLE POINT CORPORATION STOP LOCATIONS ON AS-BUILTS. COST FOR SAMPLING PLAN(S) DEVELOPMENT TO BE INCORPORATED INTO COST OF POTABLE WATER MAIN.
- 13. SUBMIT AND OBTAIN APPROVAL OF SHOP DRAWINGS,
 CONSTRUCTION SCHEDULE AND THE FOLLOWING PLANS PRIOR
 TO BEGINNING CONSTRUCTION (NOT LIMITED TO):

A. SHUTDOWN SCHEDULE AND PLAN TO INCLUDE BUT NOT LIMITED TO PIPE DEWATERING AND DISPOSAL PLANS; FOR WASTEWATER, POTABLE WATER, AND RECLAIMED WATER MAIN CONNECTION SCHEDULE FOR MAINS (INCLUDING LINESTOPS); WATER MAIN SAMPLING PLAN AND LOCATIONS FOR BACTRIOLOGICAL TESTING; PRESSURE TESTING SCHEDULE; LINESTOP LOCATIONS.

B. EROSION CONTROL AND STORMWATER POLLUTION
PROTECTION PLANS TO BE COORDINATED WITH ROADWAY
PROJECT.

C. COST FOR PLANS DEVELOPMENT TO BE INCORPORATED INTO COST OF PROPOSED MAINS.

- 14. ALL CONCRETE THRUST BLOCKS INSTALLED FOR TESTING PROCESS SHALL BE REMOVED AND DISPOSED OF PRIOR TO FINAL ACCEPTANCE.
- 15. ADJUST ALL VALVES (LIDS AND STEMS), ARVS, MANHOLE LIDS, VAULT ACCESS HATCHES, AND FIRE HYDRANTS WITHIN PROJECT LIMITS TO NEW/PROPOSED GRADE. COST TO BE INCORPORATED INTO INITIAL BID PRICE.

ABBREVIATIONS

ASBESTOS CEMENT AC ADJ. AD IIIST APPROX. APPROXIMATE AIR RELEASE VALVE BASELINE ARV CAST IRON CENTERLINE CONSTRUCT DUCTILE IRON DIAMETER ČŌNST DUCTILE IRON PIPE ELEVATION ELEVATION ELEVATION EDGE OF PAVEMENT ĒLEV. EXIST XISTING FIRE HYDRANT FLOW LINE FH FL FM GR FORCE MAIN GAS MAIN GRADE GRADE GRAVITY SEWER HORIZONTAL DIRECTIONAL GS HDD DRILL HIGH DENSITY

HDPE HIGH DENSITY
POLYETHYLENE
INV. INVERT
LA LIMITED ACCESS
LT LEFT
MCU MANATEE COUNTY
UTILITIES
MIN MINIMUM

NPW NON-POTABLE WATER MAIN (RECLAIMED)
PCCP PRESTRESSED CONCRETE CYLINDER PIPE
P.E. POLYETHYLENE

P.E. POLYETHYLENE
P&F PLUG AND FILL
PROP. PROPOSED
PVC POLYVINYL CHLORIDE
RWM RECLAIMED WATER MAIN
R/W RIGHT OF WAY
RJ RESTRAINED JOINT
RT RIGHT
SD STORM DRAIN
STA. STATION
TOP TOP OF PIPE
TYP
TYPICAL
WM WATER MAIN

TYPICAL WATER MAIN WITH WITH IN

SCALE AS NOTED

DESIGNED BY

HLM

DRAWN BY

JTT

1 90% SUBMITTAL 12/2021 JTT CHECKED BY

HDR Engineering, Inc. 2601 Cattlemen Road Suite 400 Sarasota, FL 34232-6233 DATE
12/2021
PROJECT NO



Manatee MANATEE COUNTY
County PUBLIC WORKS

DESIGN ENGINEER HEATHER L. MANGANIELLO


FL. LICENSE NO.
68385


GENERAL NOTES


SHEET NO.


U-5


 No.
 REVISIONS
 DATE
 BY
 HEH
 BY
 HEH
 BY
 BY
 No.
 PW:\3658\10001573\10131245\6.0_CAD_BIM\6.2_WIP\12345615201\utils\gnntuw01.dgn

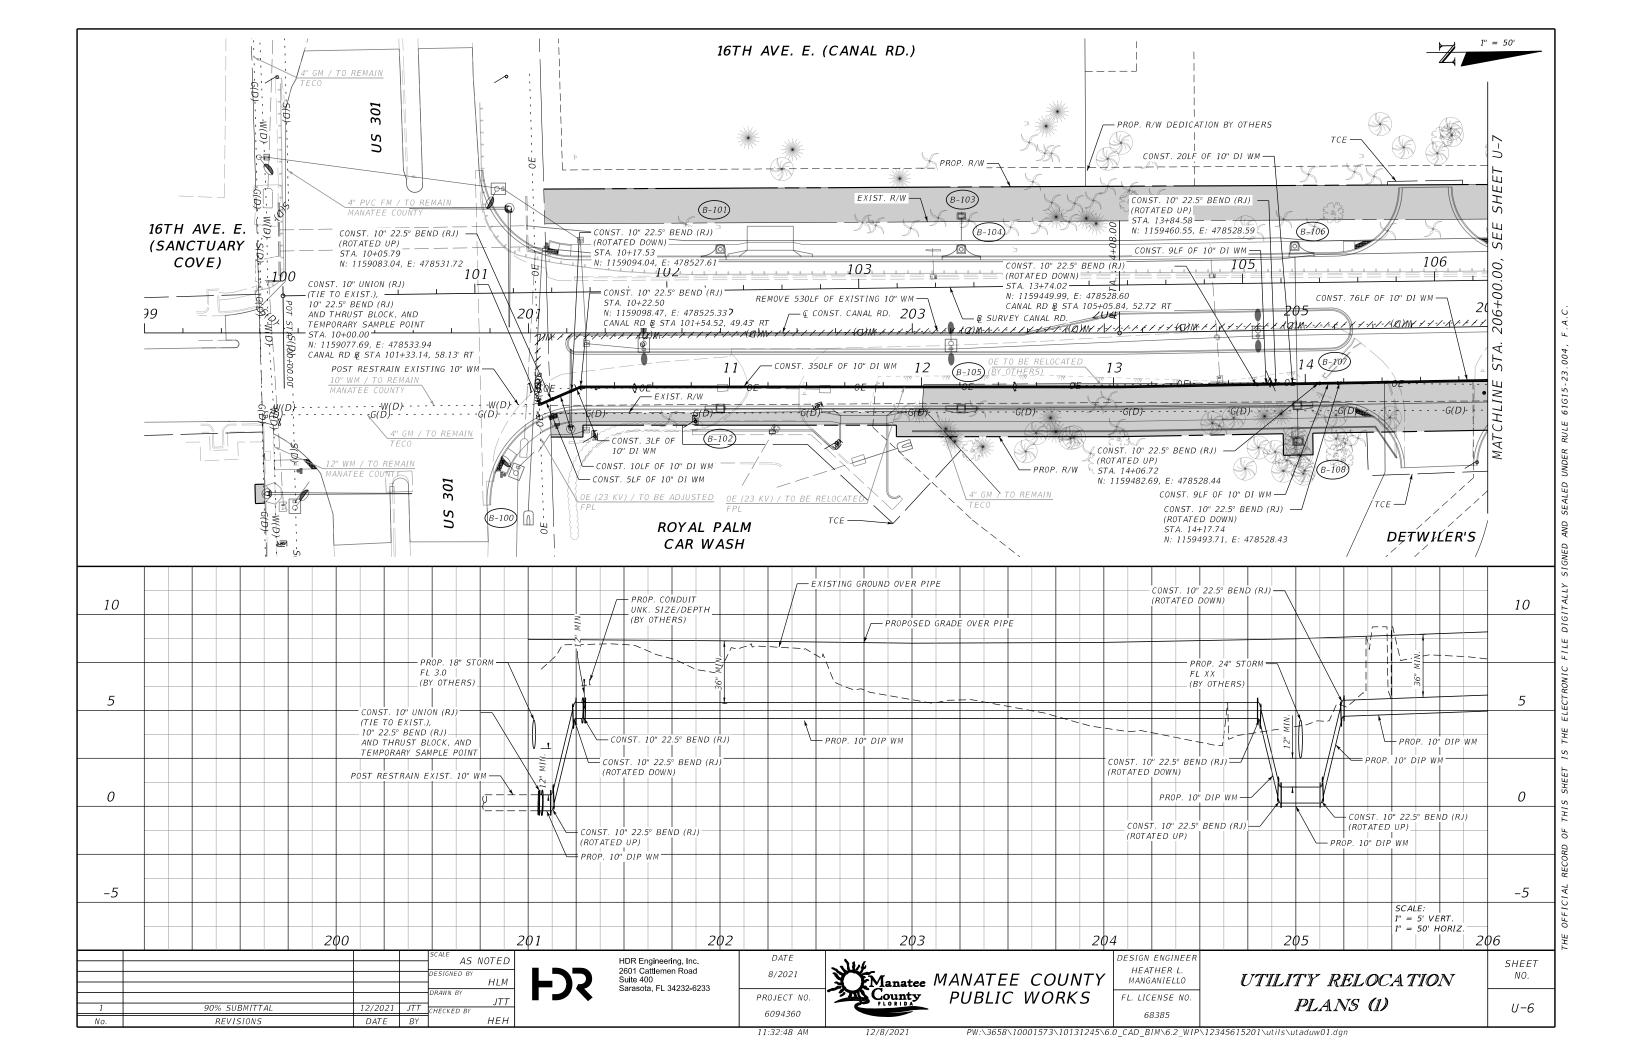


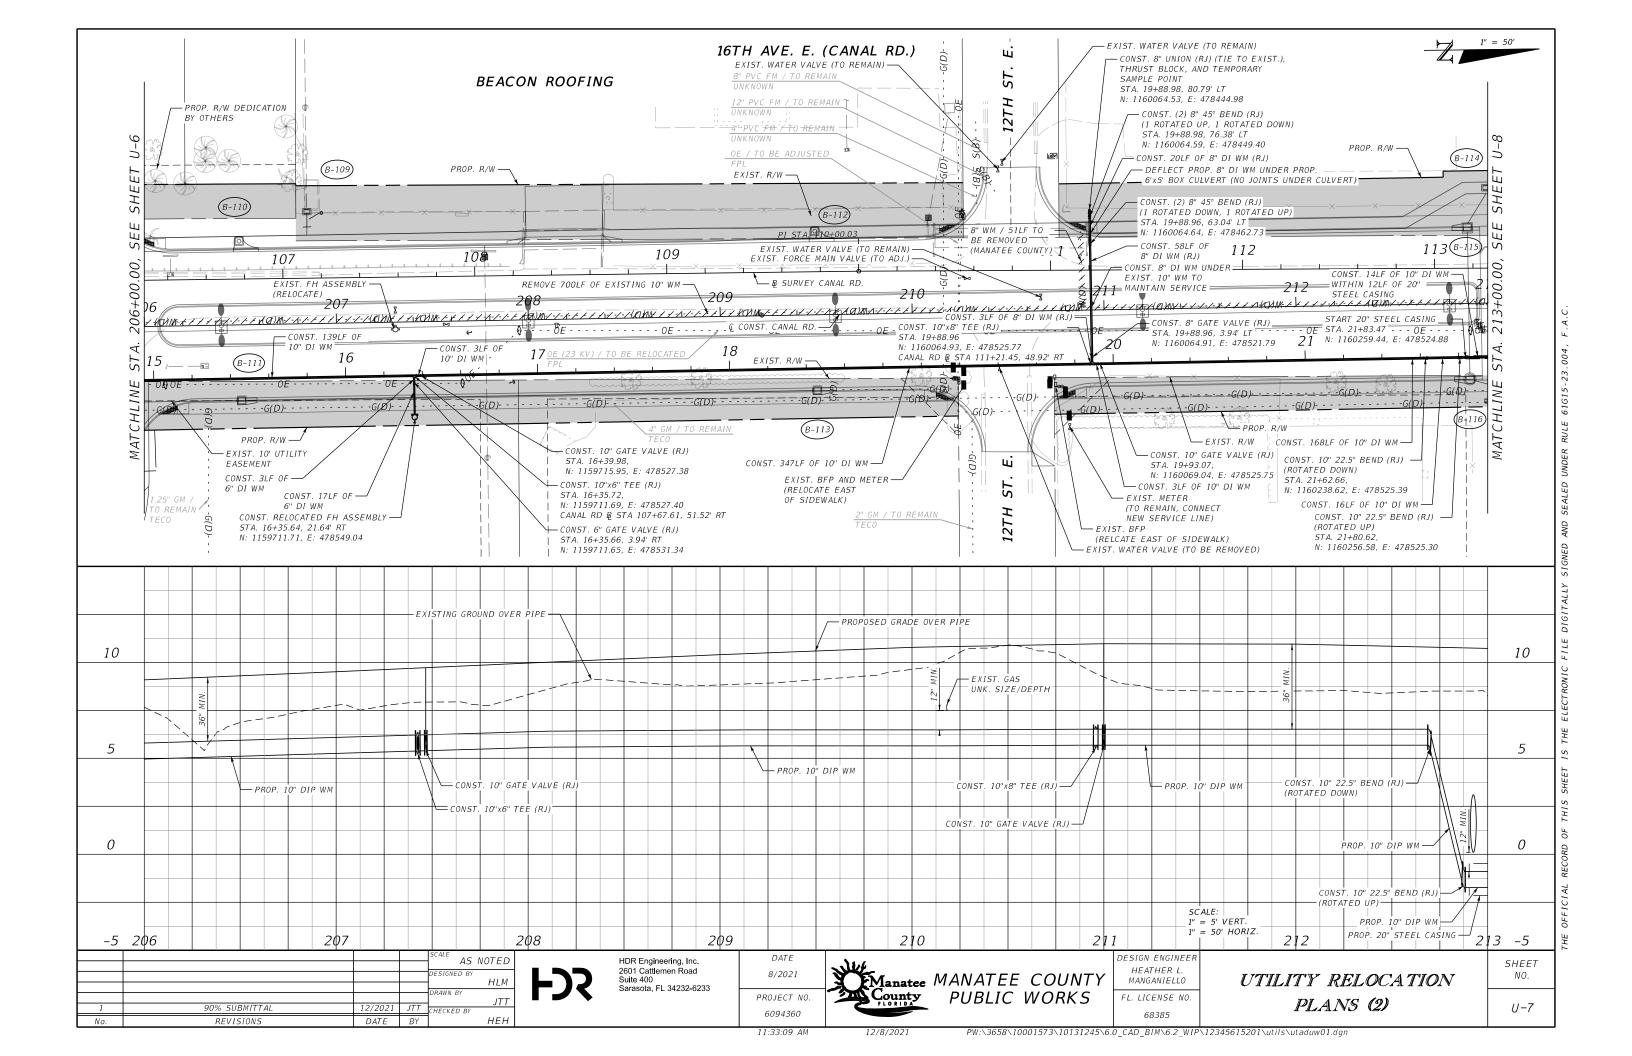


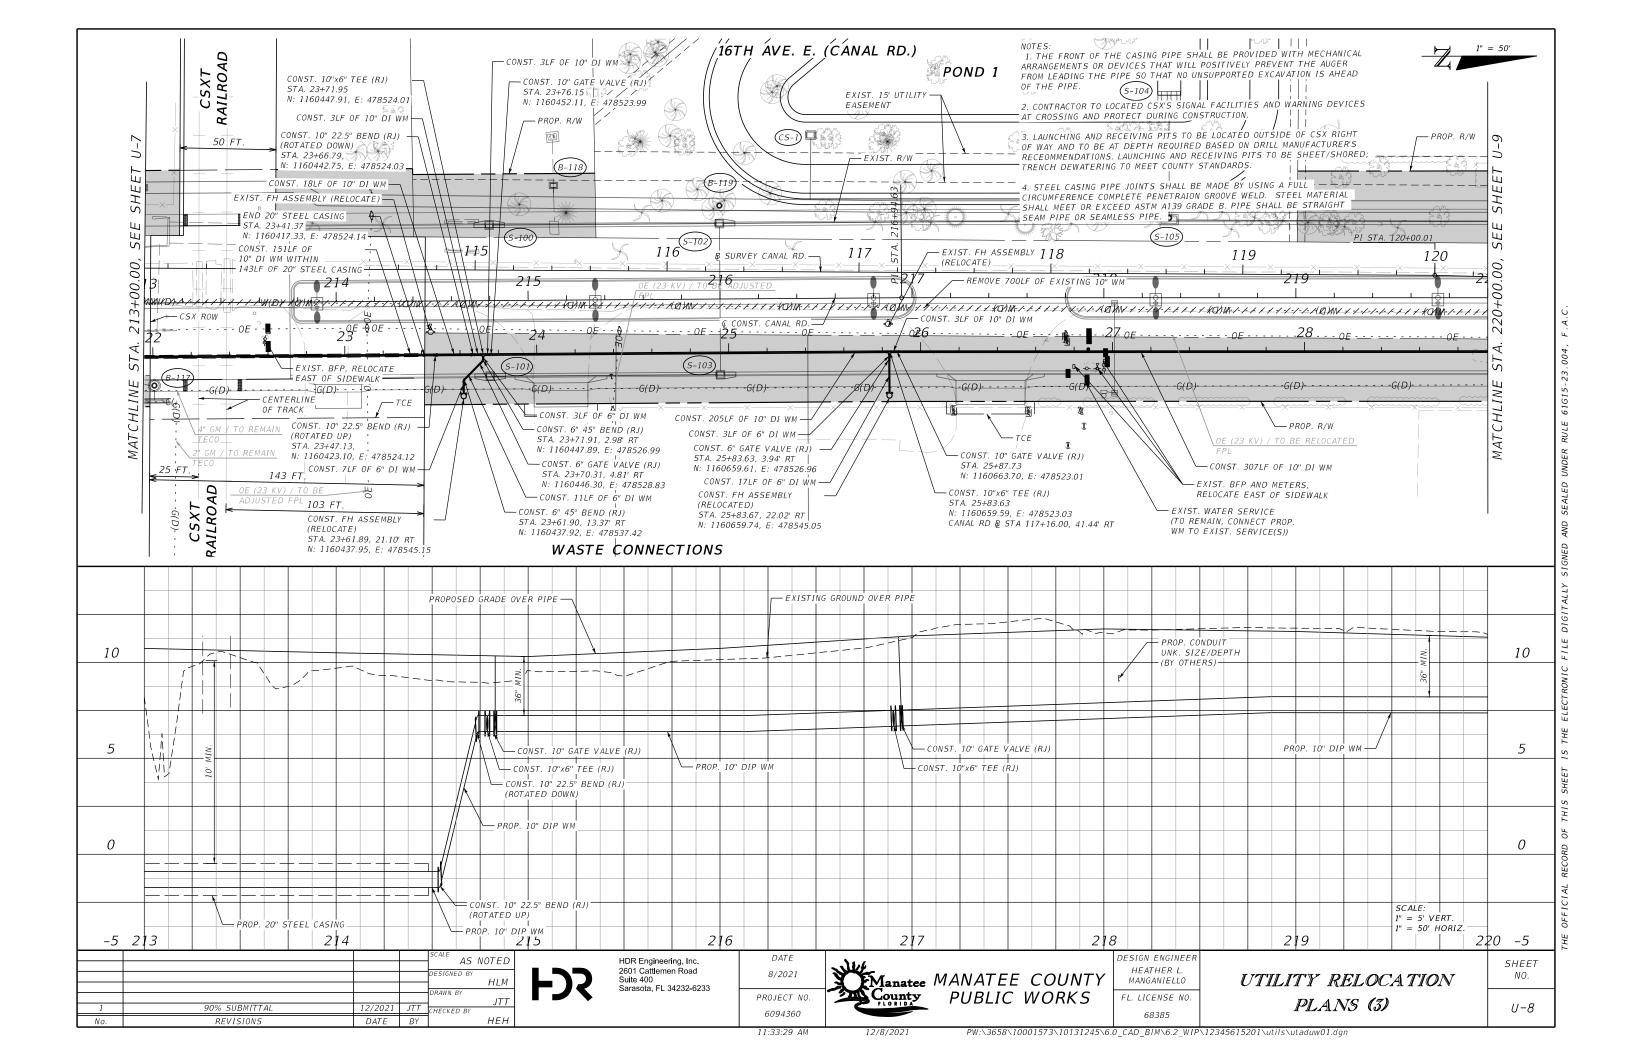


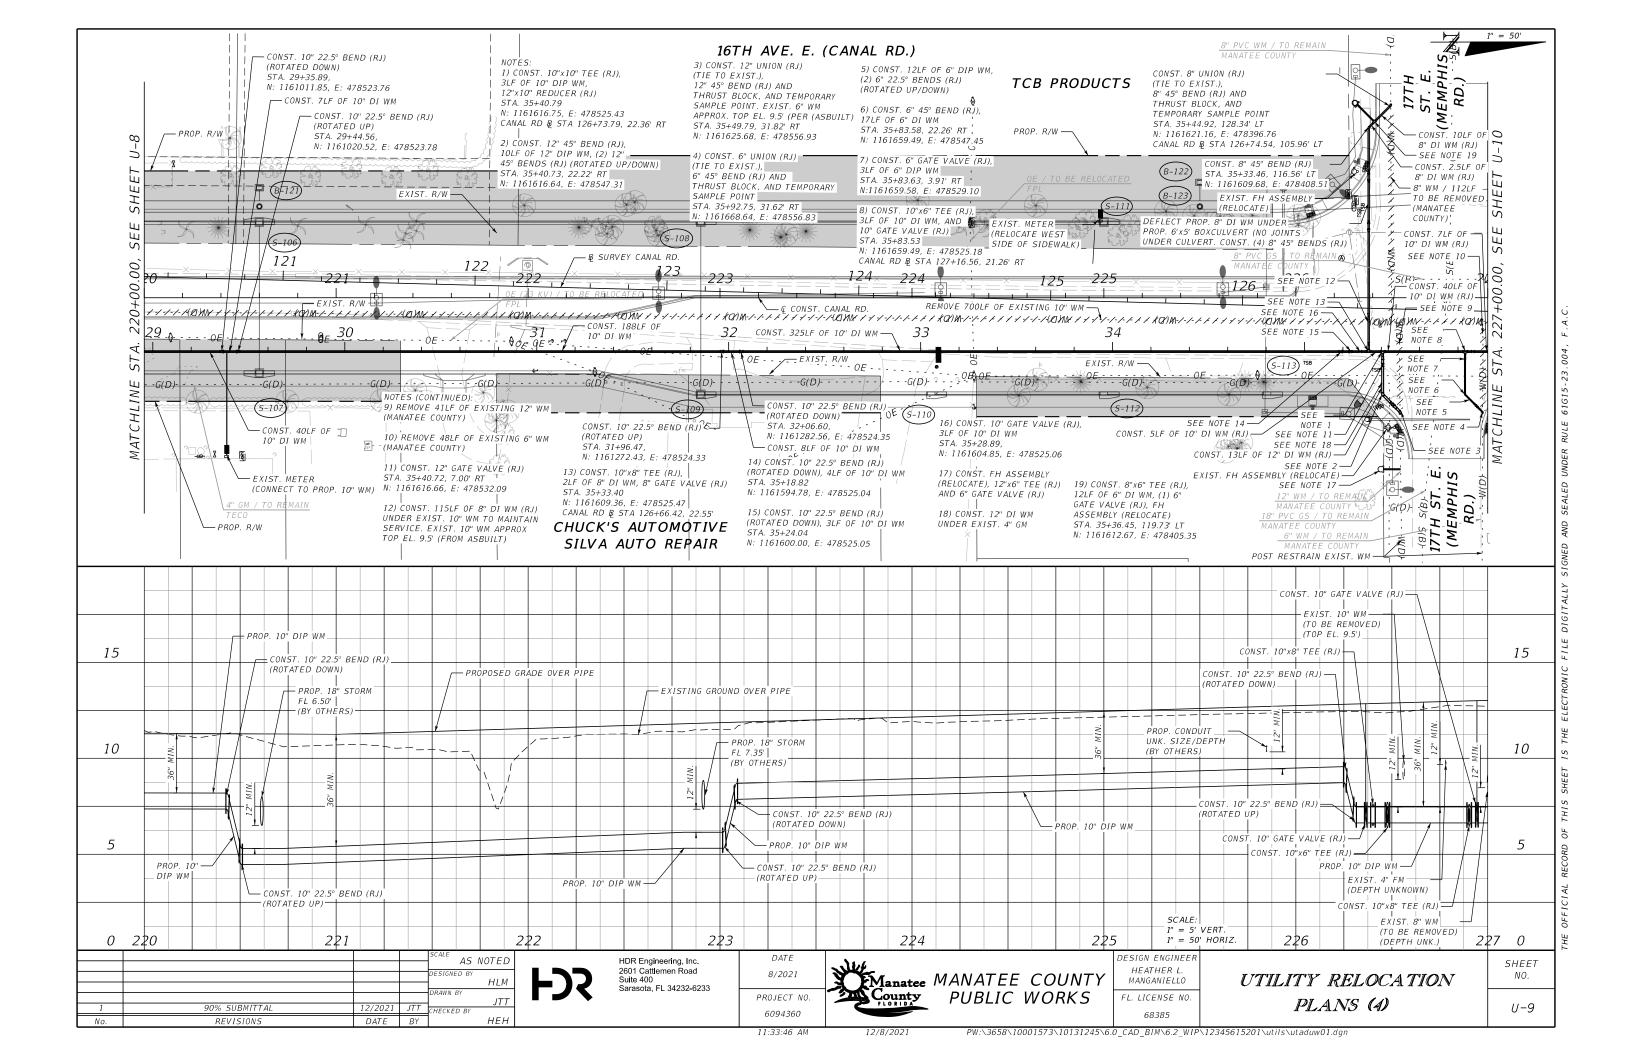

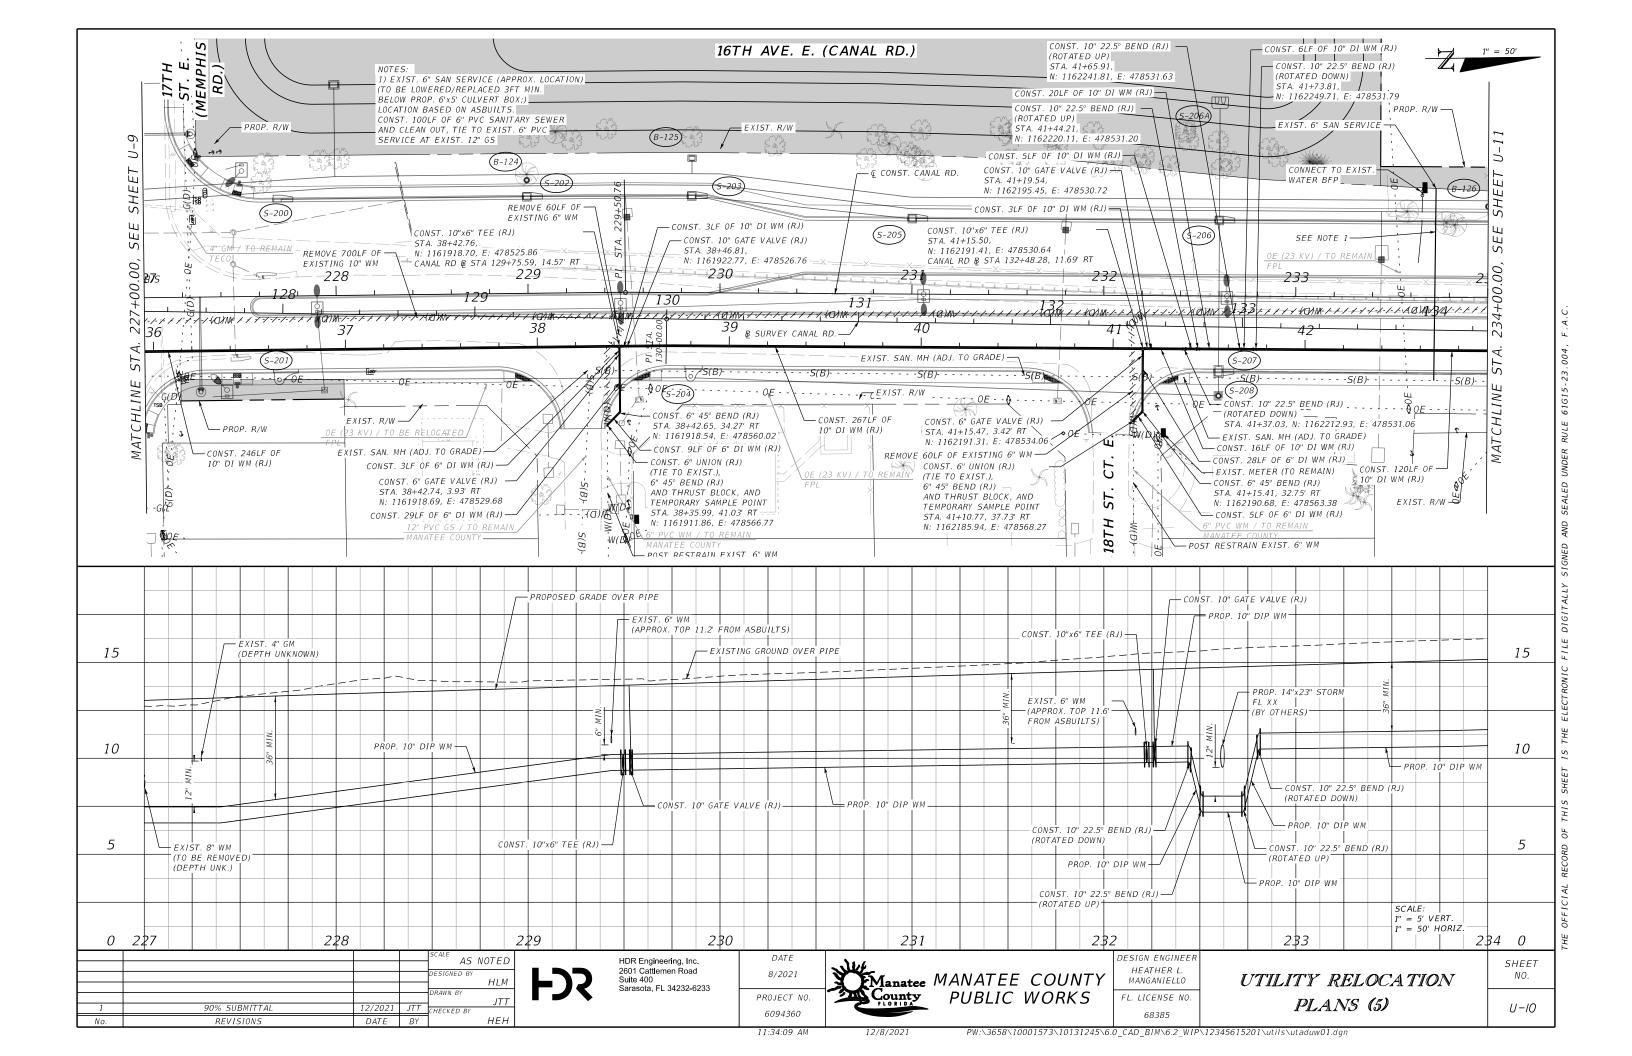


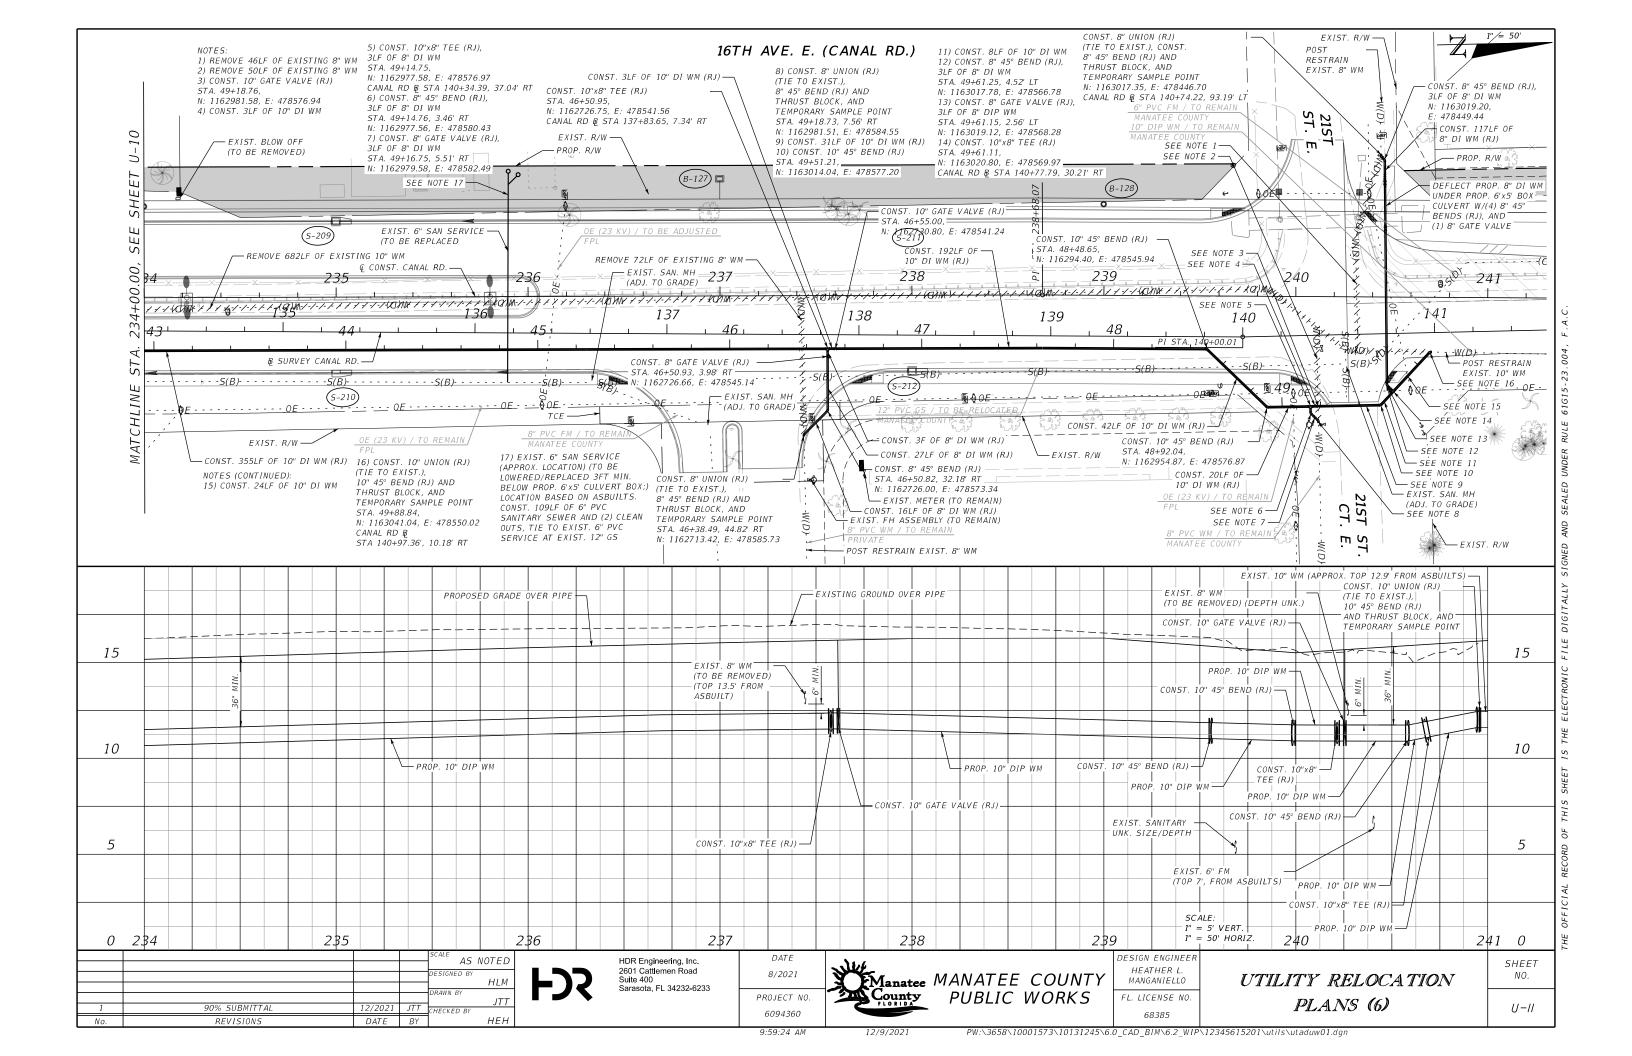

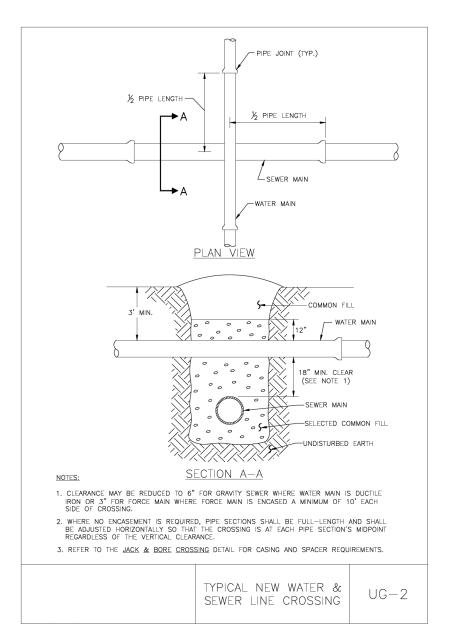

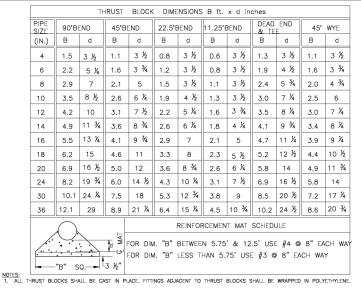

- 2. THIS TABLE IS BASED ON WATER PRESSURE=180 PSI WITH AN ALLOWABLE SOIL BEARING PRESSURE=2000 PSF, CONCRETE STRENGTH 16 = 3000 PSI, REINFORCEMENT 1, = 60.0 KSI. THRUST BLOCK SHALL BE CAST AGAINST FIRM UNDISTURBED SOIL.
- 3. FOR LARGER "B" DIMENSIONS IT IS NECESSARY TO CHECK THAT PIPE IS SUFFICIENTLY DEEP TO ALLOW 15" MIN. SOIL COVER OVER TOP EDGE OF THRUST BLOCK.
- 4. RESTRAINED JOINTS MAY BE USED IN LIEU OF THRUST BLOCKS TO SAVE SPACE, THRUST BLOCKS SHALL BE USED IN SITUATIONS WHERE THRUST BLOCKS AND RESTRAINED JOINTS ARE BOTH REQUIRED.
- THRUST BLOCKS ARE ONLY TO BE USED IN THE FDOT RIGHT OF WAY WHEN IT IS NOT POSSIBLE TO RESTRAIN PIPE JOINTS OR IF THERE IS INSUFFICIENT LENGTH OF RESTRAINED PIPE TO RESTRAIN THRUST.

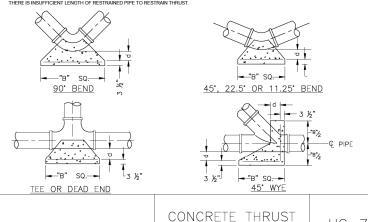

BLOCKS

REQUIRED LENGTH OF RESTRAINED JOINT PIPE FOR DR-18 PVC PIPE

MAIN PIPF	HORIZ. BENDS					TEES			R	EDUCER	S	PLUGS &	VALVES
			22.5°	SIZE LENGTH						SIZE LEN	IGTH		
24	90	38	18	X24 169	X20 132	X16 90	X12 38	X10 ₆	X20 64	X16 117	X12 158	21	4
20	78	32	16	X20 141	X16 101	X12 53	X10 24	X8 ₁	X16 65	X12 115	X10 149	18	4
16	66	27	13	X16 111	X12 67	X10 41	X8 12		X12 64	X10 107	X8 111	15	1
12	52	22	10	X12 80	X10 56	X8 31	X6 ₁		X10 58	X8 62	X6 86	11	8
10	44	18	9	X10 63	X8 40	X6 7			X8 33	X6 61	X4 81	10	0
8	37	15	7	X8 49	X6 18	X4 ₁			X6 35	X4 60		83	5
6	29	12	6	X6 29	X4 ₁				X4 33			63	5
4	21	8	4	X4 12								45	5

- 1. RESTRAIN 11.25° BENDS 50% OF LENGTH FOR 22.5° BENDS.
- 2. ALL VALVES AND FITTINGS SHALL BE RESTRAINED TO THE CONNECTINGSECTIONS
- 3. ALL ISOLATIONVALVES MUST BE PROPERLY ANCHORED OR RESTRAINED TO RESIST A 180 PSI TEST PRESSURE IN EITHER DIRECTION.
- 4. PIPE SIZES ARE GIVEN IN INCHES.
- 5. RESTRAINED PIPE LENGTHS ARE GIVEN IN FEET.
- 6. LENGTHS SHOWN ARE FOR A TEST PRESURE OF 180 PSI.
- 7. THE RESTRAINED LENGTHS SHOWN IN THESE TABLES ARE BASED ON SOIL CLASSIFICATION SP WITH AWWA TYPE 3 TRENCH CONDITIONS, 180 PSI TEST PRESSURE, 3 FEET OF COVER AND 1.5 "ACTOR OF SAFTEY. ACTUAL BURY CONDITIONS MUST BE DETERMINED BY THE ENGINEER OF RECORD AND THE RESTRAINED LENGTHS MODIFIED ACCORDINGLY.
- 8. RESTRAINED LENGTHS TO BE APPLIED TO PIPELINES PER DETAIL <u>RESTRAINED</u> LENGTHS FOR PIPE.

RESTRAINED LENGTHS FOR PVC UG-8PIPE

				AS NOTED	
					l
				DESIGNED BY	
				HLM	1
				DRAWN BY	
1	90% SUBMITTAL	12/2021	JTT	CHECKED BY	ł
Ma	DEVICIONS	DATE	DV	UEU	ı

12/8/2021

11:34:44 AM

HDR Engineering, Inc. 2601 Cattlemen Road Suite 400 Sarasota, FL 34232-6233

DATE 12/2021 PROJECT NO.



UG-7

DESIGN ENGINEER HEATHER L. MANGANIELLO FL. LICENSE NO.

UTILITY DETAILS (1 OF 7) 68385

SHEET NO.

U-12

PW:\3658\10001573\10131245\6.0_CAD_BIM\6.2_WIP\12345615201\utils\UTDTUW01.dgn


REQUIRED LENGTH OF RESTRAINED JOINT PIPE FOR DIP (POLY-WRAPPED)

MAIN	HOR	IZ. B	ENDS	S TEES							REDU	CERS		PLUGS	& VALVES
SIZE	90°	45°	22.5°			SIZE	LENGTI	+			SIZE	LENGTI	+		
36	142	59	28	x36 393	30 318	×24 232	x20 165	x16 84	x12 1	X30 137	X24 247		X16 359	4	153
30	124	51	25	X30 X	252	X20 189	X15 115	X12 23	x10 1	X24 137	X20 213	X16 276			391
24	106	44	21	X24 Z70	20 211	X16 143	X12 61	X10 10	x8 1	X20 98	X16 178	X12 241			327
20	92	38	18	X20 X	161	X12 85	X10 39	x8 ₁		X16 98	X12 176	X10 227		2	280
16	77	32	15	X16 77	12	X10 65	X8 19	×6 ₁		X12 98	X10 163	X8 169		:	231
12	61	25	12	127	10 89	X8 50	χŝ ₁			X10 88	X8 96	X6 131			181
10	52	22	10	X10 101	X8 64	x6 11				X8 51	X6 94	X4 125		1	53
8	44	18	9	X8 78	X6 30	×4_1				X6 54	X4 92			1	28
6	34	14	7	X6 46	×4_1					X4 50					98
4	24	10	5	x4 19											69

NOTE:


 SEE UG-8, <u>RESTRAINED LENGTHS FOR PVC PIPE</u> DETAIL FOR NOTES 1 THROUGH 9 THAT ARE ALSO APPLICABLE TO RESTRAINED LENGTHS FOR DIP.

MANATEE COUNTY PUBLIC WORKS DEPARTMENT RESTRAINED	
REV.BY DATE	UG-9
E-125 2020 LENGTHS FOR DIP	
February 25, 2020 DATE OF APPROVAL	

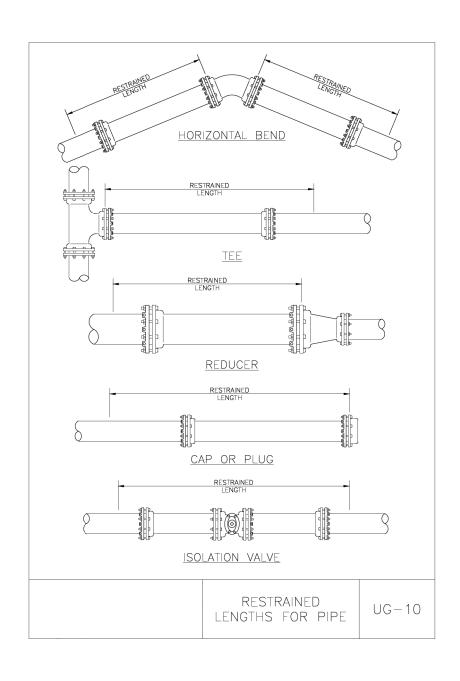

NOTES:

- 1. USE OF TYPE A-2 AND A-3 PIPE BEDDING TO BE DETERMINED IN THE FIELD BY THE ENGINEER.
- PROVIDE ADEQUATE CLEARANCE TO PLACE AND COMPACT STAGE 1 BEDDING MATERIAL IN TRENCH AREA BELOW PIPE SPRINGLINE. PIPE EMBEDMENT MUST BE COMPACTED OUT TO THE TRENCH WALL OR 2.5 TIMES THE PIPE OD, WHICHEVER IS LESS.
- PIPE INSTALLATION SHALL BE IN ACCORDANCE WITH THE MANUFACTURER'S WRITTEN INSTRUCTIONS.
- 4. TRACER WIRE NOT REQUIRED FOR GRAVITY SEWERS.

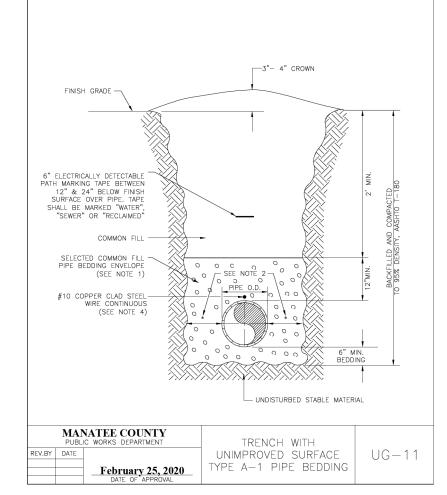

				AS NOTED
				DESIGNED BY HLM
				DRAWN BY
				JTT
1	90% SUBMITTAL	12/2021	JTT	CHECKED BY

12/8/2021



HDR Engineering, Inc. 2601 Cattlemen Road Suite 400 Sarasota, FL 34232-6233 DATE
12/2021
PROJECT NO.



DESIGN ENGINEER
HEATHER L.
MANGANIELLO
FL. LICENSE NO.

68385

UTILITY DETAILS
(2 OF 7)


SHEET NO.


U-13

DATE BY HEH | 0094-360 PW:\3658\10001573\10131245\6.0_CAD_BIM\6.2_WIP\12345615201\utils\UTDTUW02.dgn

NOTES:

- 1. USE OF TYPE A-2 AND A-3 PIPE BEDDING TO BE DETERMINED IN THE FIELD BY THE ENGINEER.
- PROVIDE ADEQUATE CLEARANCE TO PLACE AND COMPACT STAGE 1 BEDDING MATERIAL IN TRENCH AREA BELOW PIPE SPRINGLINE. PIPE EMBEDMENT MUST BE COMPACTED OUT TO THE TRENCH WALL OR 2.5 TIMES THE PIPE OD, WHICHEVER IS LESS.
- 3. TYPICALLY 4" TO 6".
- 4. PIPE INSTALLATION SHALL BE IN ACCORDANCE WITH THE MANUFACTURER'S WRITTEN INSTRUCTIONS.
- 5. ASPHALTIC CONCRETE STRUCTURE COURSE WITH PRIME COAT SHALL BE THE SAME DEPTH AND TYPE AS EXISTING OR A MINIMUM OF 1 1/4 INCH, WHICHEVER IS GREATER.
- 6. MILL 25' BACK FROM TRENCH SAW CUT. ADJUST MILLING PER INDIVIDUAL SITE TO NOT IMPACT BASE. BUTT JOINT TO EXIST ASPHALT. FINAL OVERLAY LIMITS ARE FROM EDGE OF PAVEMENT TO EDGE OF PAVEMENT. FINAL OVERLAY TO MATCH EXISTING WITH NO DISCERNABLE "BUMP" AT JOINT. MILLING LIMITS THAT IMPACT INTERSECTION SHALL BE ADDRESSED ON A CASE BY CASE BASIS AND APPROVED BY MANATEE COUNTY.
- 7. SHEETING ORDERED LEFT IN PLACE TO BE CUT OFF 24" BELOW FINISHED GRADE OR 12" BELOW
- 8. BASE SHALL BE 8" MINIMUM THICKNESS CRUSHED CONCRETE.
- 9. TEMPORARY PATCHES WILL BE INSTALLED TO PROVIDE A SMOOTH ALL WEATHER SURFACE AT ALL TIMES. PERMANENT REPLACEMENT TO BE MADE AS SOON AS POSSIBLE.
- 10. RESTORE SIGNAGE & MARKING WITH THERMOPLASTIC PER FDOT STANDARDS, LATEST EDITION.
- 11. TRACER WIRE NOT REQUIRED FOR GRAVITY SEWERS.
- 12. NOTES 5. THRU 10. ARE MINIMUM REQUIREMENTS FOR A TRENCH IN A ROAD. REFER TO LATEST EDITION OF MANATEE COUNTY HIGHWAY AND TRAFFIC STANDARDS FOR ADDITIONAL REQUIREMENTS.

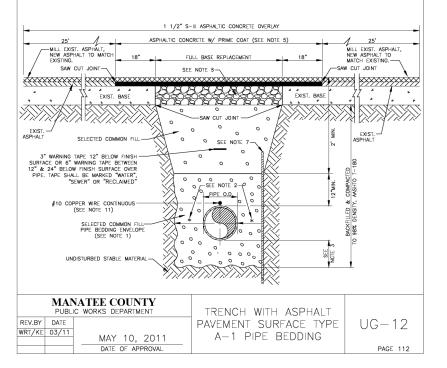

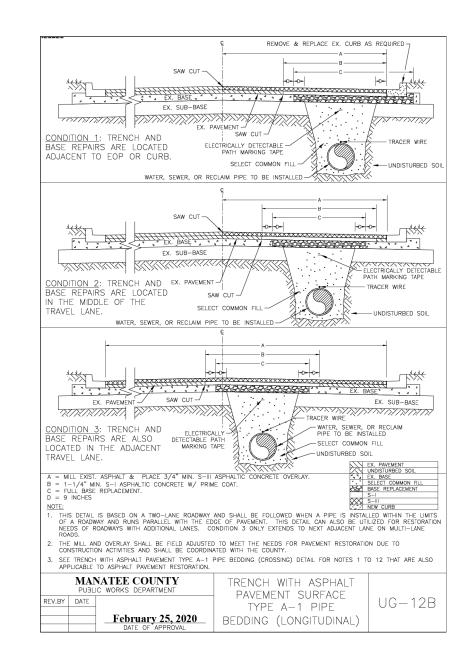

NOTES:


- NOTES:

 1. CONCRETE PAVEMENT SHALL BE REMOVED WITH SAWED EDGES AND CUT AT A MINIMUM DEPTH OF ONE AND ONE—HALF (1—1/2"). IF A SAW CUT IN CONCRETE PAVEMENT FALLS WITHIN THREE FEET (3") OF A CONTRACTION JOINT, COLD JOINT, EXPANSION JOINT OR EDGE, THE CONCRETE SHALL BE REMOVED TO THE JOINT OR EDGE. THE EDGES OF EXISTING CONCRETE PAVEMENT ADJACENT TO THENCHES, WHICH HAD BEEN DAMAGED SUBSEQUENT TO SAW CUTTING OF PAVEMENT, SHALL BE SAW CUT TO NEAT STRAIGHT LINES FOR THE PURPOSE OF REMOVING THE DAMAGED PAVEMENT, AREAS.

 2. USE OF TYPE A—2 AND A—3 PIPE BEDDING TO BE DETERMINED IN THE FIELD BY THE ENGINEER.

 3. PROVIDE ADEQUATE CLEARANCE TO PLACE AND COMPACT STAGE 1 BEDDING MATERIAL IN TRENCH AREA BELOW PIPE SPRINGLINE. PIPE EMBEDMENT MUST BE COMPACTED OUT TO THE TRENCH WALL OR 2.5 TIMES THE PIPE OD, WHICHEVER IS LESS.

- 4. PIPE INSTALLATION SHALL BE IN ACCORDANCE WITH THE MANUFACTURER'S WRITTEN INSTRUCTIONS.
- 5. THICKNESS TO MATCH EXISTING OR BE 6" MINIMUM, WHICHEVER IS GREATER. 6. SHEETING ORDERED LEFT IN PLACE TO BE CUT OFF 24" BELOW FINISH GRADE OR 12" BELOW SUBGRADE.
- BASE SHALL BE COMPACTED 6" MINIMUM THICKNESS OF APPROVED MATERIAL.
- 8. DRIVEWAYS SHALL BE CONSTRUCTED IN ACCORDANCE WITH THE LATEST ADOPTED CONSTRUCTION STANDARDS OF THE MANATEE COUNTY TRANSPORTATION DEPARTMENT.
- IF THE DRIVEWAY IS 12' OR WIDER, SAWCUT AN EXPANSION JOINT ALONG THE CENTER OF THE DRIVEWAY $(rac{1}{3}f_6")$ WIDE AND $1rac{1}{2}"$ DEEP) AFTER THE CONCRETE HAS SET.
- 10. IF THERE IS AN EXISTING EXPANSION JOINT WITHIN 3' OF THE PROPOSED JOINT, EXTEND DRIVEWAY REPLACEMENT TO THE EXISTING JOINT.
- 11. TRACER WIRE NOT REQUIRED FOR GRAVITY SEWERS.

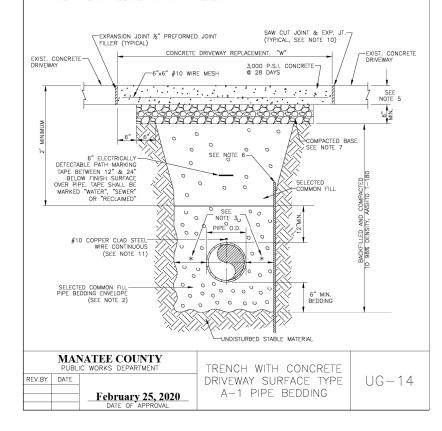

				AS NOTED	Γ
					ļ
				DESIGNED BY HLM	l
				DRAWN BY	ł
				JTT	l
1	90% SUBMITTAL	12/2021	JTT	CHECKED BY	l
Ma	DEVICIONS	DATE	DV	1 454	ı



HDR Engineering, Inc 2601 Cattlemen Road Suite 400 Sarasota, FL 34232-6233

DATE 12/2021 PROJECT NO.

Manatee MANATEE COUNTY
County PUBLIC WORKS


DESIGN ENGINEER HEATHER I. MANGANIELLO FL. LICENSE NO. 68385


UTILITY DETAILS (3 OF 7)

SHEET NO.


U-14

DATE | BY | 12/8/2021 PW:\3658\10001573\10131245\6.0_CAD_BIM\6.2_WIP\12345615201\utils\UTDTUW03.dgn

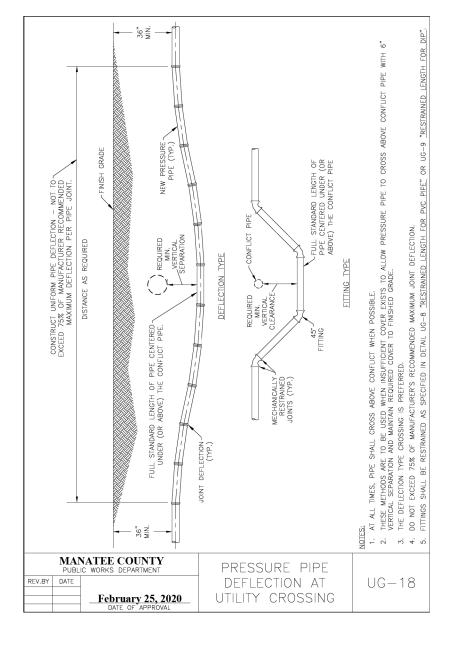

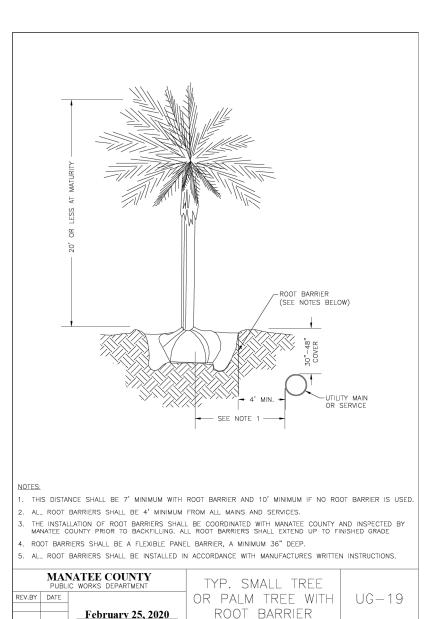

ROOT BARRIER February 25, 2020

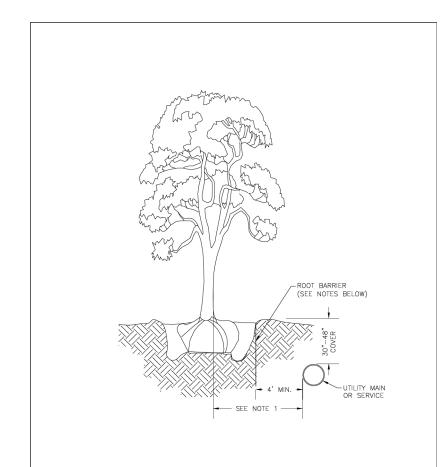

- NOTES:

 1. THIS DISTANCE SHALL BE 10' MINIMUM WITH ROOT BARRIER AND 15' MINIMUM IF NO ROOT BARRIER IS USED.
- . ALL ROOT BARRIERS SHALL BE 4' MINIMUM FROM ALL MAINS AND SERVICES.
- . THE INSTALLATION OF ROOT BARRIERS SHALL BE COORDINATED WITH MANATEE COUNTY AND INSPECTED BY MANATEE COUNTY PRIOR TO BACKFILLING. ALL ROOT BARRIERS SHALL EXTEND UP TO FINISHED GRADE
- . ROOT BARRIERS SHALL BE MINIMUM 36" DEEP. FLEXIBLE BARRIERS SHALL BE 36" PANELS.
- 5. ALL ROOT BARRIERS SHALL BE INSTALLED IN ACCORDANCE WITH MANUFACTURES WRITTEN INSTRUCTIONS.

6. LARGE PALM TREES INCLUDE ROYAL, WASHINGTONIAN, BISMARK AND SIMILAR SIZED SPECIES.

		NATEE COUNTY IC WORKS DEPARTMENT	TYP. CANOPY TREE,	
REV.BY	DATE		EXOTIC TREE WITH	UG-20
		February 25, 2020	ROOT BARRIFR	

				SCALE AS N	OTED
					OILD
				DESIGNED BY	HLM
				DRAWN BY	TLM
				DRAWN BI	ITT
1	90% SUBMITTAL	12/2021	JTT	CHECKED BY	0,,,
No.	REVISIONS	DATE	BY	1	HEH

12/8/2021



HDR Engineering, Inc. 2601 Cattlemen Road Suite 400 Sarasota, FL 34232-6233

DATE 12/2021 PROJECT NO.

Manatee MANATEE COUNTY
County PUBLIC WORKS

DESIGN ENGINEER HEATHER L. MANGANIELLO FL. LICENSE NO.


68385

UTILITY DETAILS (4 OF 7)


SHEET NO.


U-15

PW:\3658\10001573\10131245\6.0_CAD_BIM\6.2_WIP\12345615201\utils\UTDTUW04.dgn

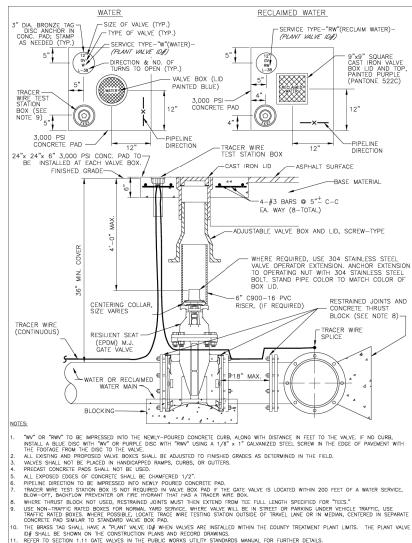



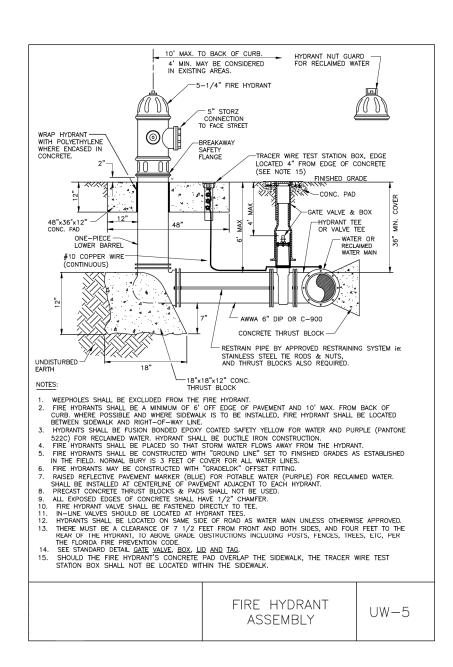

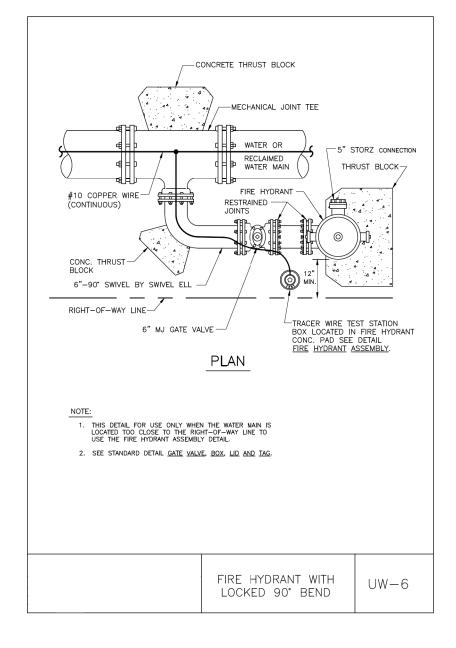

AS NOTED HLMJTT 90% SUBMITTAL DATE

12/8/2021

HDR Engineering, Inc 2601 Cattlemen Road Suite 400 Sarasota, FL 34232-6233

DATE 12/2021 PROJECT NO.

Manatee MANATEE COUNTY
County PUBLIC WORKS


DESIGN ENGINEER HEATHER I. MANGANIELLO FL. LICENSE NO. 68385


UTILITY DETAILS (5 OF 7)


SHEET NO.

U-16

PW:\3658\10001573\10131245\6.0_CAD_BIM\6.2_WIP\12345615201\utils\UTDTUW05.dgn

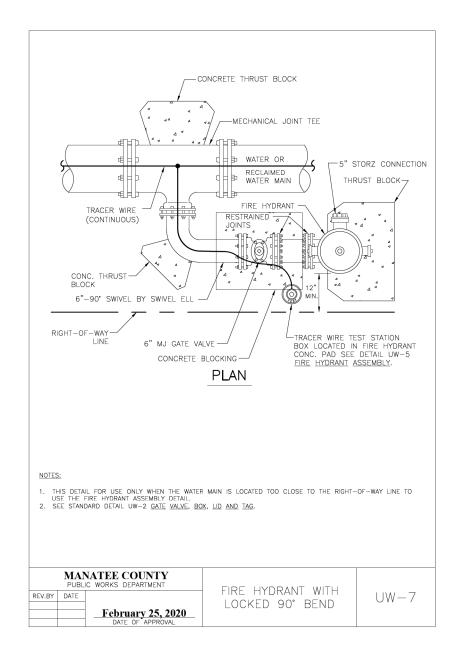

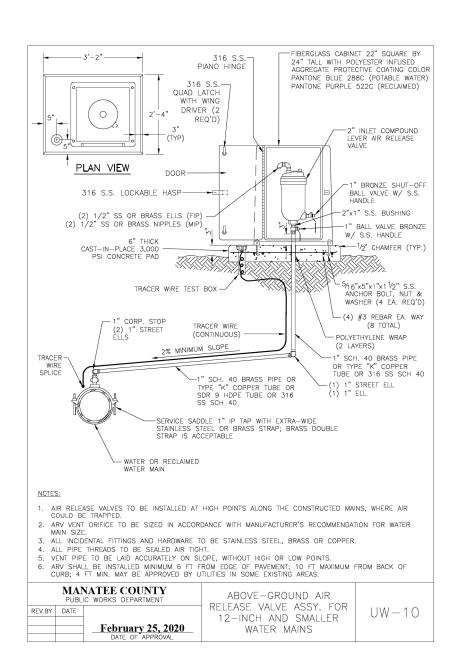


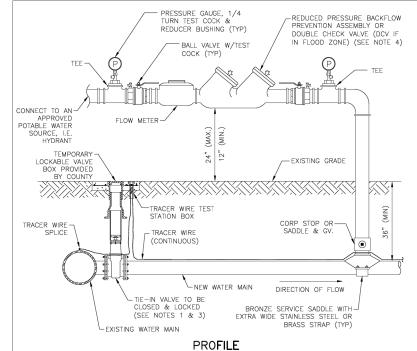

- 1. FOR TIE-IN VALVE, SEE DETAIL UW-3 FOR TAPPING SLEEVE VALVE AND UW-2 FOR GATE VALVE. 2. CORPORATION STOP CONNECTIONS TO WATER MAINS SHALL BE AT A SUFFICIENT DISTANCE FROM NEW
- TAPPING SLEEVE & VALVE (TIE-IN VALVE). ALL CORPORATION STOP TAPS SHALL BE PLACED NO CLOSER THAN 30" OR A DISTANCE EQUAL TO (1) MAIN PIPE DIAMETER PLUS (2) TAP DIAMETERS (WHICHEVER IS LARGER) FROM THE NEW TIE-IN VALVE (TAPPING VALVE & SLEEVE). SIZE-ON-SIZE TAPS ARE NOT ALLOWED. A CUT-IN TEE SHALL BE USED.
- IF THE EXISTING WATER MAIN IS LOCATED UNDER PAVEMENT OR CLOSE TO THE ROADWAY, BOTH JUMPER CORPORATION STOPS MAY CONNECT TO THE NEW WATER MAIN LOCATED OUTSIDE OF THE PAVEMENT. AN ADDITIONAL GATE VALVE SHALL BE INSTALLED AND THE VALVE MAY BE LOCATED AT THE ROW LINE. PIPING AND APPURTENANCES BETWEEN THE EXISTING MAIN AND ISOLATION VALVE AND JUMPER SHALL BE DISINFECTED BY SPRAYING OR SWABBING.
- BACKFLOW PREVENTION ASSEMBLY SHALL BE STRUCTURALLY SUPPORTED.

 THE TIE—IN VALVE SHALL REMAIN CLOSED AND THE LOCKABLE VALVE BOX SHALL BE LOCKED BY MANATEE COUNTY. THE TIE—IN VALVE SHALL REMAIN CLOSED AND LOCKED UNTIL THE NEW SYSTEM HAS BEEN CLEARED FOR USE BY THE FDEP AND ALL OTHER PERTINENT AGENCIES. AFTER CLEARANCE IS OBTAINED, THE LOCKABLE VALVE BOX SHALL BE REMOVED, RETURNED TO THE COUNTY, AND REPLACED WITH A STANDARD VALVE BOX.
- . IN THE EVENT THE LOCKED TIE—IN VALVE MUST BE OPENED, THE VALVE SHALL ONLY BE OPERATED BY MANATEE COUNTY PERSONNEL.
- 7. SEE DETAIL UW-24 FOR ADDITIONAL JUMPER CONNECTION NOTES.

MANATEE COUNTY PUBLIC WORKS DEPARTMENT			TEMPORARY JUMPER	
REV.BY	DATE		CONNECTION-HYDRANT	luw-23a
		February 25, 2020	AVAILABLE	
		DATE OF APPROVAL		

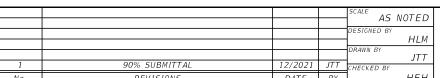



HDR Engineering, Inc. 2601 Cattlemen Road Suite 400 Sarasota, FL 34232-6233

DATE 12/2021 PROJECT NO.



DESIGN ENGINEER HEATHER L. MANGANIELLO FL. LICENSE NO.


68385

UTILITY DETAILS (6 OF 7)

SHEET NO.

U - 17

DATE12/8/2021 PW:\3658\10001573\10131245\6.0_CAD_BIM\6.2_WIP\12345615201\utils\UTDTUW06.dgn

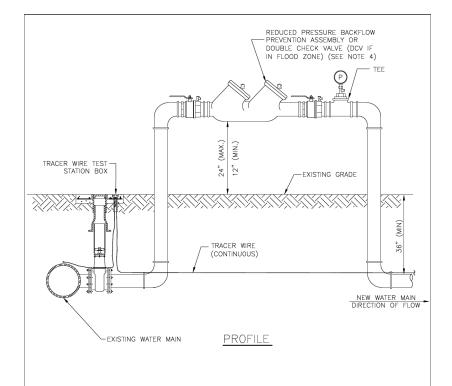

- NOTES:

 1. FOR TIE-IN VALVE, SEE DETAIL UW-3 FOR TAPPING SLEEVE VALVE AND UW-2 FOR GATE VALVE. 2. CORPORATION STOP CONNECTIONS TO WATER MAINS SHALL BE AT A SUFFICIENT DISTANCE FROM NEW TAPPING SLEEVE & VALVE (TIE-IN VALVE). ALL CORPORATION STOP TAPS SHALL BE PLACED NO CLOSER THAN 30° OR A DISTANCE EQUAL TO (1) MAIN PIPE DIAMETER PLUS (2) TAP DIAMETERS (WHICHEVER IS LARGER) FROM THE NEW TIE-IN VALVE (TAPPING VALVE & SLEEVE). SIZE-ON-SIZE TAPS ARE NOT ALLOWED. A CUT-IN TEE SHALL BE USED.
- JIF THE EXISTING WATER MAIN IS LOCATED UNDER PAVEMENT OR CLOSE TO THE ROADWAY, BOTH JUMPER CORPORATION STOPS MAY CONNECT TO THE NEW WATER MAIN LOCATED OUTSIDE OF THE PAVEMENT. AN ADDITIONAL CATE VALVE SHALL BE INSTALLED AND THE VALVE MAY BE LOCATED AT THE ROW LINE. PIPING AND APPURTENANCES BETWEEN THE EXISTING MAIN AND ISOLATION VALVE AND JUMPER SHALL BE
- 4. BACKFLOW PREVENTION ASSEMBLY SHALL BE STRUCTURALLY SUPPORTED.
- 5. SEE DETAIL UW-24 FOR ADDITIONAL JUMPER CONNECTION NOTES.

MANATEE COUNTY PUBLIC WORKS DEPARTMENT	TEMPORARY JUMPER CONNECTION —	
REV.BY DATE	NO HYDRANT	UW-23B
February 25, 2020	AVAILABLE	

- A 2-INCH MINIMUM TEMPORARY JUMPER CONNECTION IS REQUIRED AT ALL CONNECTIONS BETWEEN EXISTING ACTIVE POTABLE WATER MAINS AND PROPOSED NEW WATER MAIN IMPROVEMENTS WITH THE FOLLOWING EXCEPTIONS:
- PROJECTS THAT INCLUDE A PERMANENT BACKFLOW PREVENTER AT THE RIGHT-OF-WAY WHICH IS ADJACENT TO THE EXISTING WATER MAIN;
- b. PROJECTS THAT INCLUDE NEW WATER MAINS THAT ARE LESS THAN OR EQUAL TO 18 LINEAR FEET IN
- OTHER PROPOSED CASES THAT ARE APPROVED BY MANATEE COUNTY AND THE CONSTRUCTION DRAWINGS SPECIFICALLY STATE THAT A TEMPORARY JUMPER CONNECTION IS NOT REQUIRED.
- 2. A TEMPORARY JUMPER SHALL BE USED AND BE CONNECTED TO AN APPROVED POTABLE WATER SOURCE (E.G., EXISTING FIRE HYDRANT, EXISTING MAIN, EXISTING SERVICE TAP OR TANK TRUCK, ETC.) AS SHOWN IN THE STANDARD TEMPORARY JUMPER DETAIL UW-23A OR UW-23B.
- A TEMPORARY JUMPER SHALL BE USED FOR FILLING, FLUSHING AND FOR DISINFECTION OF ANY NEW MAIN OF ANY SIZE. THE TEMPORARY JUMPER CONNECTION SHALL BE MAINTAINED UNTIL AFTER THE FILLING, FLUSHING, TESTING AND DISINFECTION OF THE NEW MAIN HAS BEEN SUCCESSFULLY COMPLETED AND CLEARANCE FOR USE FROM THE FLORIDA DEPARTMENT OF ENVIRONMENTAL PROTECTION (FDEP) HAS
- 3. THE LOCATION AND ORIENTATION OF TEMPORARY JUMPERS ASSOCIATED WITH CONNECTIONS TO EXISTING WATER MAINS THAT ARE LOCATED UNDER THE ROADWAY PAVEMENT SHALL BE APPROVED ON A CASE-BY-CASE BASIS.
- 4. PIPE AND FITTINGS USED FOR CONNECTING THE NEW PIPE TO THE EXISTING PIPE SHALL BE DISINFECTED PRIOR TO INSTALLATION IN ACCORDANCE WITH AWWA C651, LATEST EDITION. UNLESS APPROVED OTHERWISE, THE TAPPING SLEEVE, AND EXTERIOR OF THE EXISTING MAIN TO BE TAPPED, PIPING WITHIN THE JUMPER, AND NEW PIPING SHOWN ON STANDARD TEMPORARY JUMPER DETAIL UW-23A OR UW-23B SHALL BE DISINFECTED BY SPRAYING OR SWABBING PER SECTION 4.6 OF AWWA C651.
- 5. THE JUMPER SHALL INCLUDE A FLOW METER TO ENSURE THAT THE FLOW FROM THE SUPPLY SOURCE IS AT A CONSTANT MEASURED RATE WHILE CHLORINATING THE NEW MAIN. THE CHLORINE CONCENTRATION SHALL BE MEASURED AT REGULAR INTERVALS TO ENSURE THAT IT IS FED AT A CONSTANT RATE OF NOT LESS THAN 25 MILLIGRAMS PER LITER (MG/L) OF FREE CHLORINE.
- 6. THE JUMPER CONNECTION SHALL ALSO BE USED TO MAINTAIN A MINIMUM PRESSURE OF 20 PSI IN THE NEW MAINS CONTINUOUSLY AFTER DISINFECTION AND UNTIL FDEP CLEARANCE LETTER IS OBTAINED.
- 7. ALL TEMPORARY BACKFLOW PREVENTION ASSEMBLY OR "JUMPERS" UTILIZED DURING PIPELINE CONSTRUCTION MUST SHOW CERTIFICATION THAT THEY HAVE BEEN TESTED ANNUALLY AND PASSED ACCORDING TO THE FLORIDA BUILDING CODE, PLUMBING SECTION, CHAPTER 3, SECTION 312.9.1, 312.9.2, CHAPTER 6, SECTION 608, AND RESOLUTION R87-125. ANNUAL CERTIFICATION MUST BE VALID AT TIME OF INSTALLATION AND PROVIDED TO THE MANATEE COUNTY INSPECTOR UPON REQUEST.
- 8. ALL INSTALLATION AND MAINTENANCE OF THE TEMPORARY JUMPER CONNECTION AND ASSOCIATED BACKFLOW PREVENTION ASSEMBLY, FLOW METER, FITTINGS, VALVES, ETC., SHALL BE THE RESPONSIBILITY OF THE CONTRACTOR.
- 9. TEMPORARY JUMPER SIZE DEPENDS ON THE SITUATION: JUMPERS LARGER THAN 2-INCHES MAY BE USED FOR FLUSHING PURPOSES OR IF PARTIAL FIRE PROTECTION IS REQUIRED DURING INITIAL CONSTRUCTION, AS DETERMINED BY THE ENGINEER OF RECORD OR FIRE DEPARTMENT.
- 10. PRIOR TO REMOVAL OF THE TEMPORARY JUMPER, THE NEWLY-CONSTRUCTED WATER SYSTEM SHALL HAVE RECEIVED CLEARANCE FROM THE FDEP.
- 11.AFTER RECEIPT OF CLEARANCE FOR USE BY FDEP, MANATEE COUNTY, AND ALL OTHER PERTINENT AGENCIES, THE CONTRACTOR SHALL REMOVE THE TEMPORARY JUMPER CONNECTION AND COMPLETE THE WATER MAIN. ALL CORPORATION STOPS LEFT—IN—PLACE ARE TO BE CLOSED AND PLUGGED WITH 2—INCH
- 12. IF THE TEMPORARY JUMPER IS LOCATED WITHIN A STANDARD PIPE LENGTH AWAY FROM THE PROPOSED TIE-IN AND A SINGLE STANDARD LENGTH OF PIPE IS USED FOR COMPLETING THE CONNECTION, THEN THE COUNTY WILL PERFORM A VISUAL INSPECTION AND A SEPARATE HYDROSTATIC TEST MAY NOT BE
- IF MULTIPLE LENGTHS OF PIPES ARE USED TO COMPLETE THE CONNECTION, THEN A SEPARATE HYDROSTATIC TEST WILL BE REQUIRED. THE HYDROSTATIC TEST SHALL BE PERFORMED BETWEEN THE PROPOSED TIE-IN VALVE AND THE FIRST DOWNSTREAM VALVE FROM THE TEMPORARY JUMPER LOCATION.

MANATEE COUNTY PUBLIC WORKS DEPARTMENT			TEMPODADY HIMDED	
REV.BY	DATE		TEMPORARY JUMPER	UW-24
			CONNECTION NOTES	
		February 25, 2020		1
		DATE OF APPROVAL		1

				SCALE AS NOTED	
				DESIGNED BY	
				HLM	
				DRAWN BY	
1	90% SUBMITTAL	12/2021	JTT	CHECKED BY	
Mo	DEVICIONS	DATE	DV	1 <i>ueu</i> l	

12/8/2021

HDR Engineering, Inc 2601 Cattlemen Road Suite 400 Sarasota, FL 34232-6233

DATE

12/2021

PROJECT NO.

Manatee MANATEE COUNTY
County PUBLIC WORKS

DESIGN ENGINEER HEATHER I. MANGANIELLO FL. LICENSE NO.

68385

UTILITY DETAILS (7 OF 7)

SHEET NO.

U-18

PW:\3658\10001573\10131245\6.0_CAD_BIM\6.2_WIP\12345615201\utils\UTDTUW07.dgn