


SHEET NUMBER

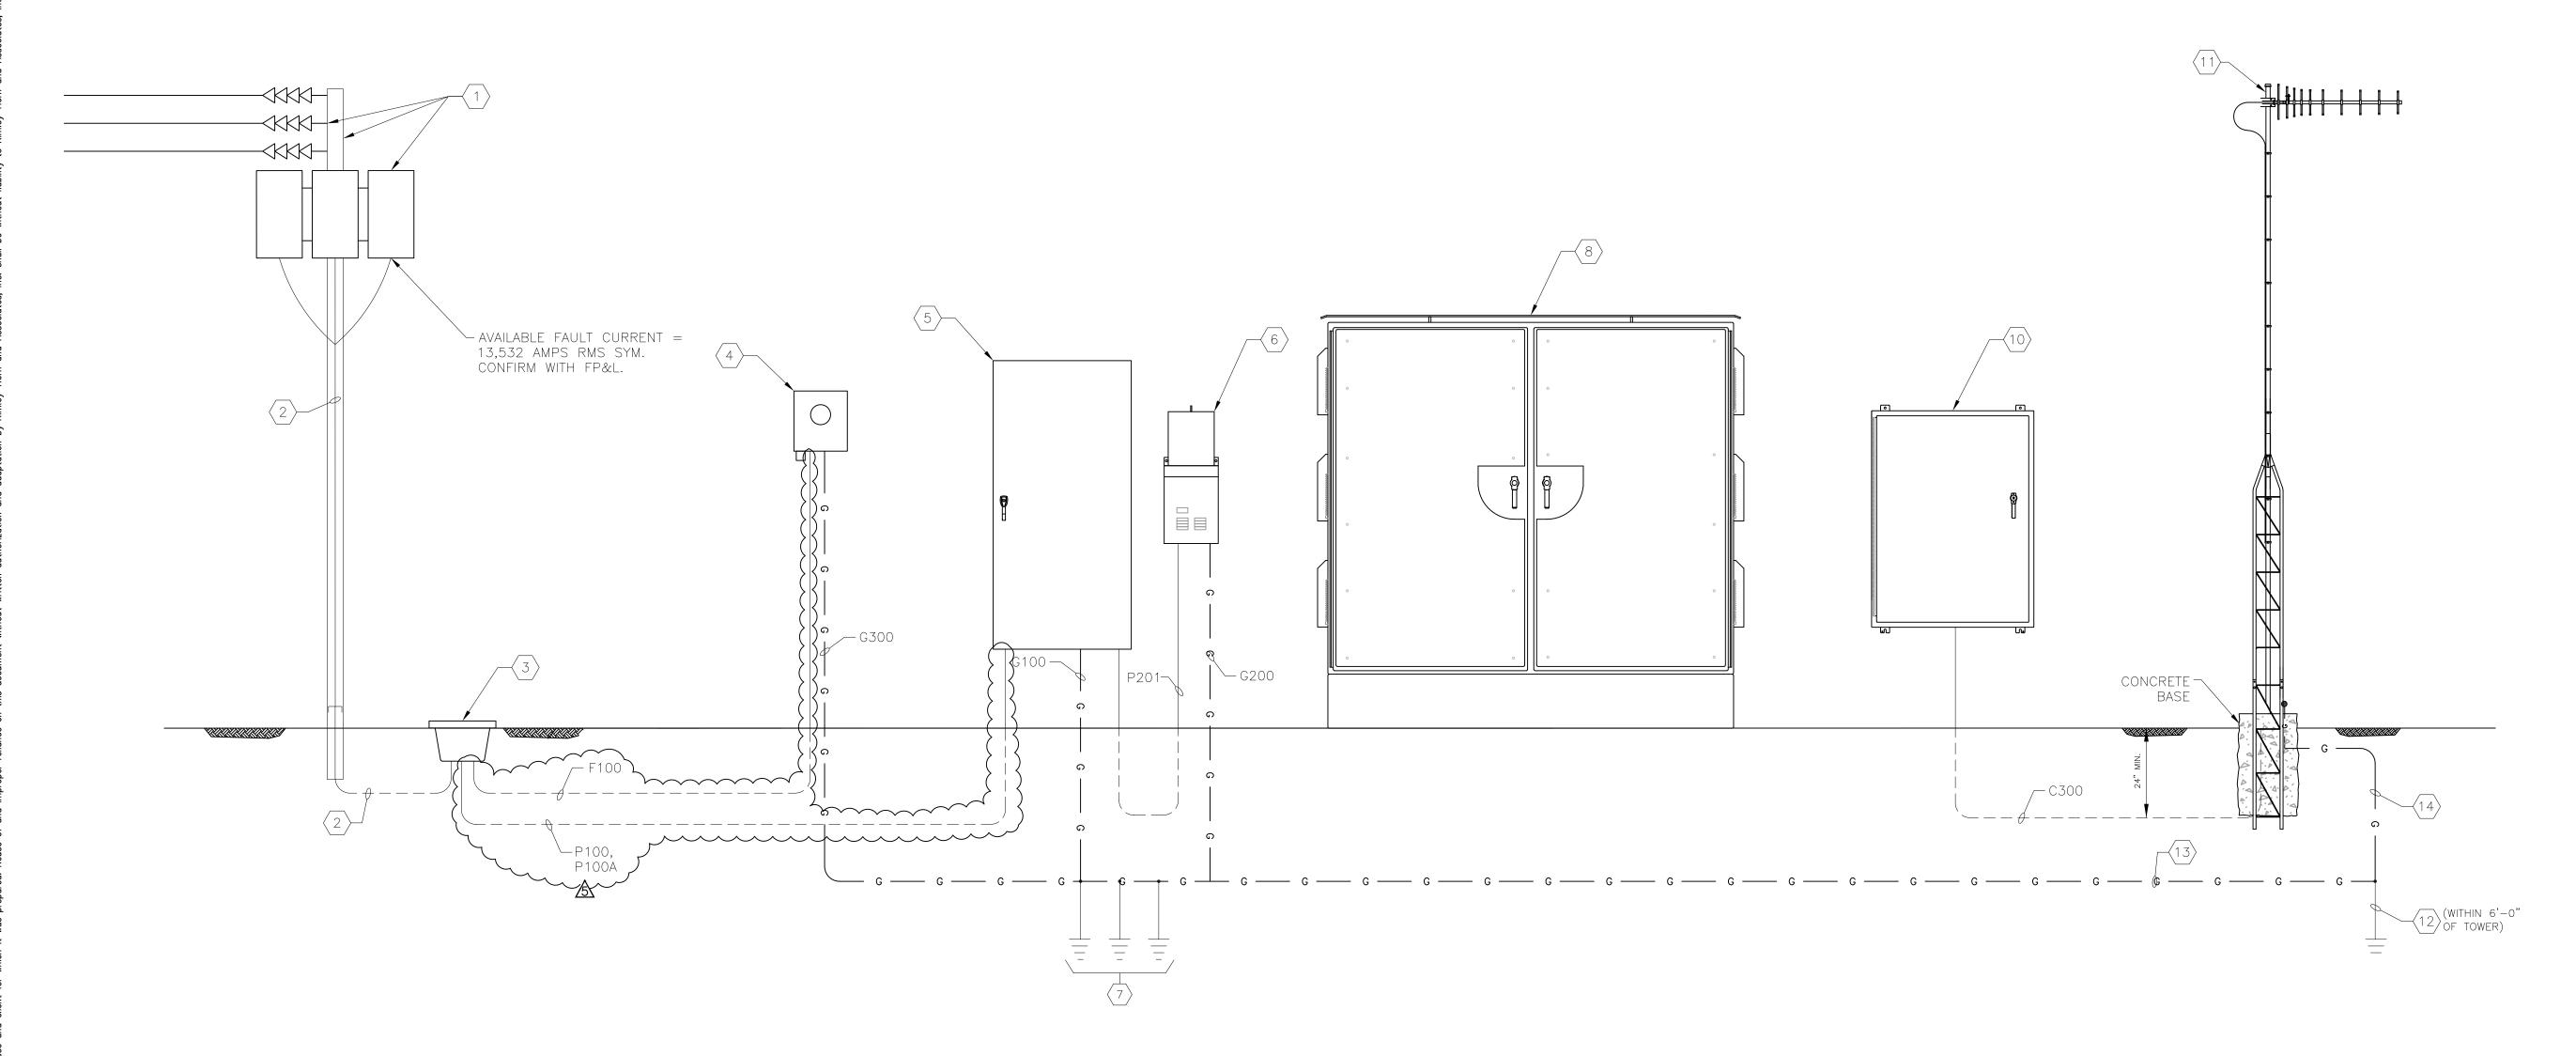

CENTRAL PUMP STATION ELECTRICAL ONE-LINE DIAGRAM

KEYED NOTES:

- 1) NEW 15KV DISTRIBUTION POLE, DISTRIBUTION TRANSFORMERS AND 15KV OVERHEAD DISTRIBUTION BY FP&L.
- $\langle 2 \rangle$ CONDUIT AND CONDUCTORS BY FP&L.
- (3) PROVIDE AND INSTALL NEW HANDHOLE. COORDINATE REQUIREMENTS WITH FP&L.
- PROVIDE AND INSTALL FP&L APPROVED CT METER SOCKET. GROUND METER PER FP&L REQUIREMENTS. COORDINATE ALL REQUIREMENTS WITH FP&L. CONTRACTOR TO VERIFY FEED—THRU VERSUS C.T. METER WITH FP&L. IF FP&L REQUIRES MEETING TO BE VIA FEED—THROUGH METER, THE CONTRACTOR SHALL PROVIDE A 600V, 600A, NON—FUSED DISCONNECTING MEANS AHEAD OF THE METER. THE CONTRACTOR'S BID PRICE SHALL INCLUDE THE COST OF THE FP&L DISCONNECTING MEANS. PROVIDE METER FOR LIGHTNING SURGE PROTECTION PER FP&L REQUIREMENTS.
- 5 PROVIDE AND INSTALL 600V, 600A, 3Ø, 4-WIRE MAIN DISTRIBUTION PANELBOARD 'MDP' WITH 600A MAIN CIRCUIT BREAKER IN NEMA 3R STAINLESS STEEL ENCLOSURE.
- 6 480-120/240V, 10, 10KVA MINI POWER ZONE 'LP' IN NEMA 3R, 316 STAINLESS STEEL ENCLOSURE. SQUARE-D MPZ10S40FSS.
- PROVIDE AND INSTALL THREE (3) 5/8" X 20'-0" COPPER CLAD GROUND RODS. SPACE GROUND RODS A MINIMUM OF 10'-0" APART. BOND GROUND RODS TOGETHER WITH 2/0 BARE COPPER GROUNDING ELECTRODE CONDUCTORS. ALL CONNECTIONS SHALL BE VIA EXOTHERMIC WELDS.
- $\langle 8 \rangle$ MOTOR CONTROL CABINET. REFER TO SHEET I-2 FOR DETAILS.
- $\langle 10 \rangle$ PUMP CONTROL PANEL. REFER TO SHEET I-5 FOR DETAILS.
- $\langle 11 \rangle$ NEW RADIO ANTENNA AND ASSOCIATED TOWER.
- PROVIDE AND INSTALL ONE (1) 5/8" X 20'-0" COPPER CLAD GROUND ROD ADJACENT TO RADIO TOWER.
- PROVIDE AND INSTALL BARE 1/0 AWG COPPER GROUNDING ELECTRODE CONDUCTOR IN 1" CONDUIT FROM RADIO TOWER TO GROUNDING ELECTRODE GRID (REFER TO KEYED NOTE #7). G400.

GENERAL NOTES:


- 1. NOT ALL CONDUITS AND CONDUCTORS SHOWN FOR CLARITY. REFER ALSO TO OTHER ELECTRICAL SHEETS.
- 2. TOWER & FOUNDATION SHALL BE DESIGNED FOR 130 MPH WINDSPEED.
- 3. CONTRACTOR SHALL SUBMIT SHOP DRAWINGS FOR TOWER AND TOWER FOUNDATION. SHOP DRAWINGS SHALL BE SIGNED AND SEALED BY A PROFESSIONAL ENGINEER REGISTERED IN THE STATE OF FLORIDA.
- 4. ALL GROUNDING ELECTRODE CONDUCTOR CONNECTIONS MADE OUTSIDE OF EQUIPMENT SHALL BE VIA EXOTHERMIC WELDS.



\triangle	ADDENDUM #5 - PUMP MOTOR REVISIONS	5/26/20	TDT
No.	REVISIONS	DATE	BY

Kimley» Horn

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TIMOTHY THOMAS, P.E

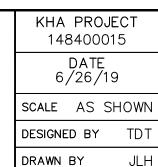
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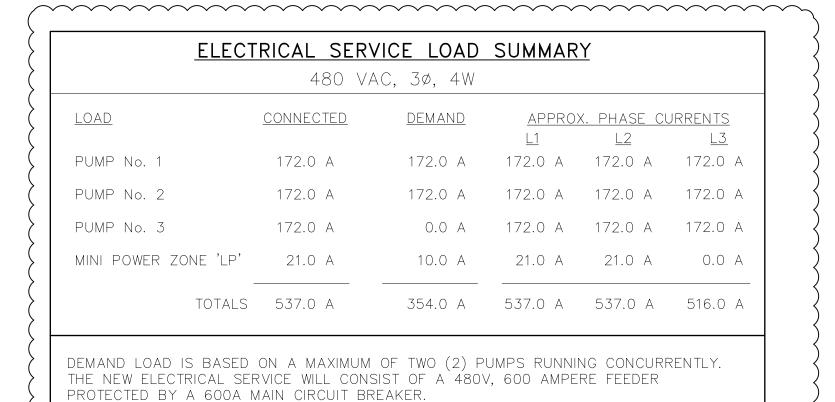
47079

FL DATE:

CENTRAL PUMP STATION
ELECTRICAL
ONE-LINE DIAGRAM

SHEET NUMBER



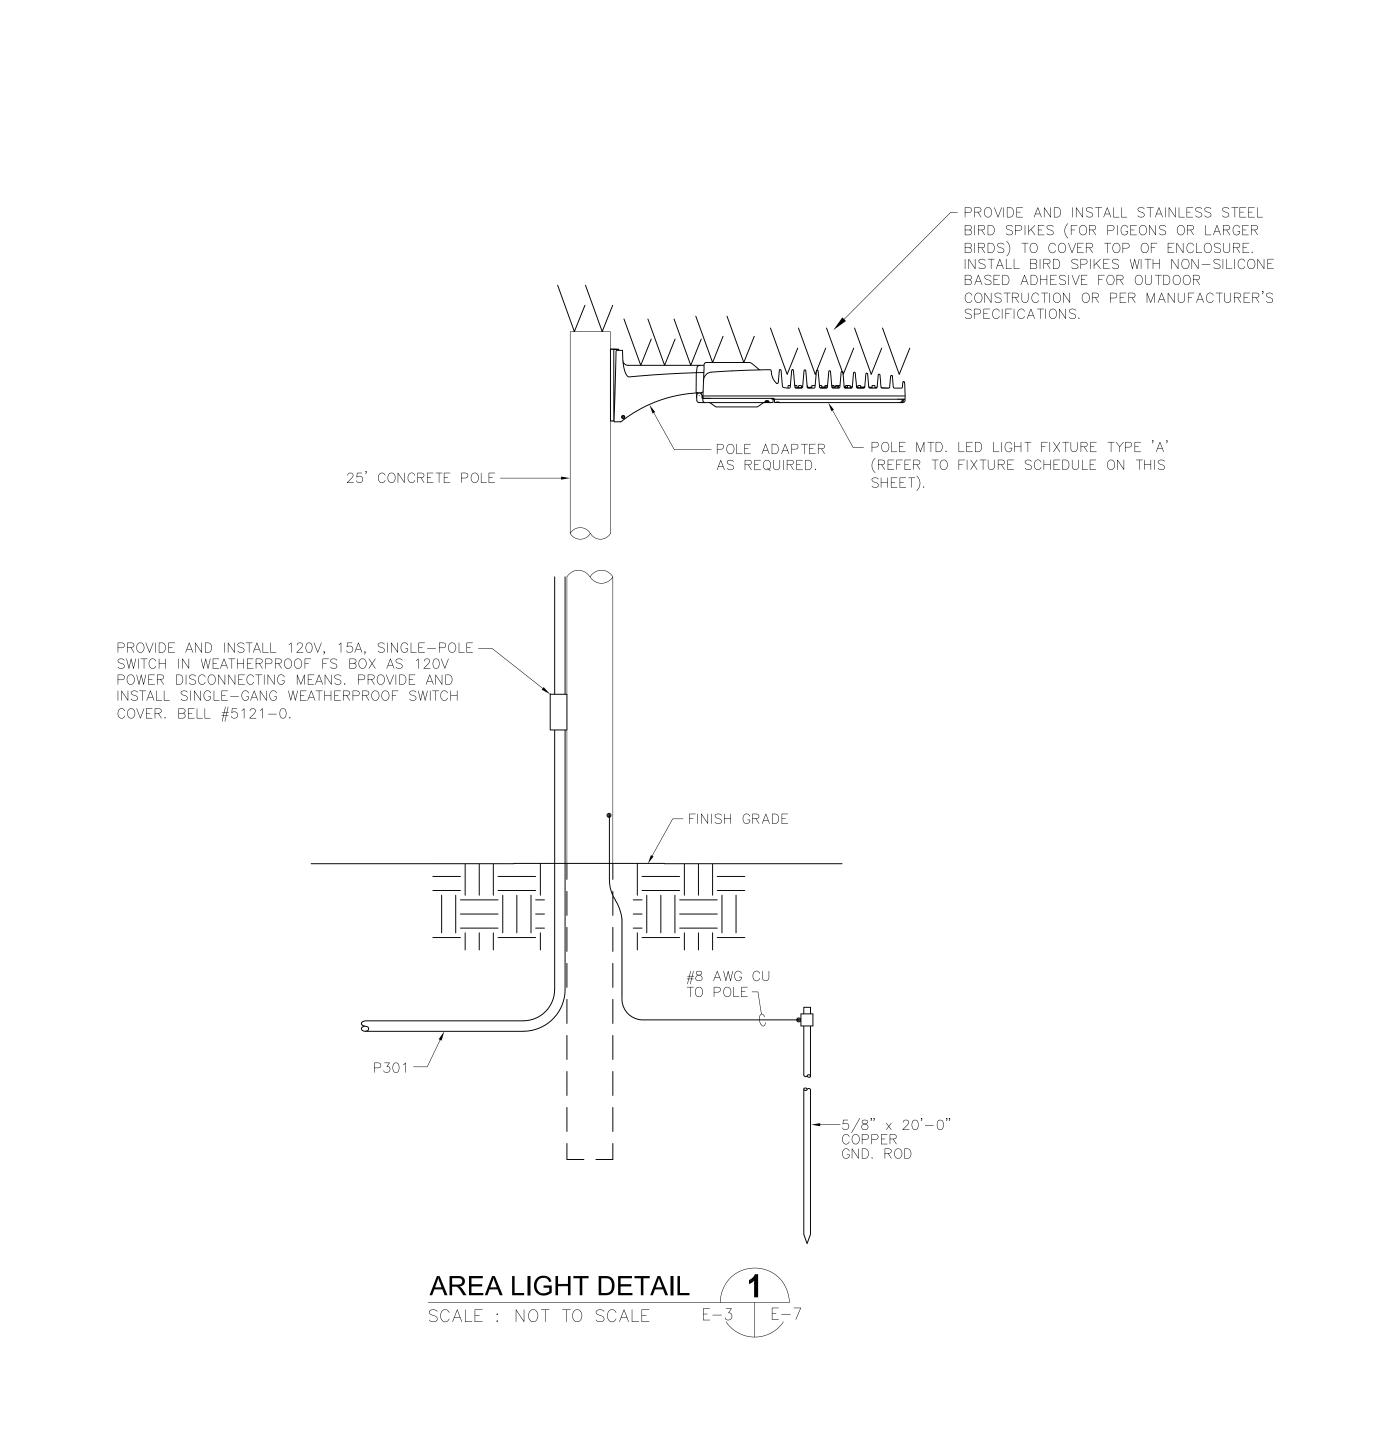

600V

MAIN DISTRIBUTION PANELBOARD 'MOP' CIRCUIT BREAKER SCHEDULE BREAKER POLES AMPERAGE AIC RATING SERVICE VOLTAGE 600V PUMP No. 1 VFD 3P 350A 600V 35K PUMP No. 2 VFD 600V 35K PUMP No. 3 VFD 2P 20A 35K MINI POWER ZONE 'LP' 600V

35K

COLLADE D. CO						70 AME) MAAINI						CUDEACE ENGLOCUE
PANEL 'LP'; SQUARE D CO. MPZ	; 120/	/240 V	OLTS, 1	Ø, 3W		30 AMF IRCUIT		; 1	OK AIC	RATIN(3		SURFACE ENCLOSUF ' TOP AT 5'-6" AFF
EQUIPMENT SERVED	CIRCI	JIT BRE	AKER	KVA/I	PHASE	CIRC.	CIRC.	KVA/F	PHASE	CIRC	:UIT BR	EAKER	FOLUDIALIT SERVED
EQUIPMENT SERVED	POLE	AMPS	FRAME	А	В	NO.	NO.	А	В	POLE	AMPS	FRAME	EQUIPMENT SERVED
PUMP CONTROL PANEL	1	20	QOB	0.8		1	2		0.2	1	20	QOB	AREA LIGHT
PUMP CONTROL PANEL	1	20	QOB		0.8	3	4	0.2		1	20	QOB	MOTOR CONTROL CABINET
MOTOR CONTROL CABINET	1	20	QOB	0.4		5	6		0.2	1	20	QOB	MOTOR CONTROL CABINET
SURGE PROTECTION DEVICE (SPD)	2	30	QOB			7	8	0.2		1	20	QOB	MOTOR CONTROL CABINET
37 27	_	_	_			9	10		0.2	1	20	QOB	FLOW METER TRANSMITTER
SI	B-TOTAL	K///		1.2	0.8			0.4	0.6				

SURGE PROTECTION DEVICE (SPD)

LIGHTING FIXTURE SCHEDULE								
TYPE	MANUFACTURER	CATALOG NUMBER	LAMP(S)	VOLTS	MOUNTING	REMARKS		
А	GENERAL ELECTRIC	EASC0E2F550ADKBZ	(1) 119 W LED	120/277	POLE	LED AREA LIGHT		



\triangle	ADDENDUM #5 — PUMP MOTOR REVISIONS	5/26/20	TDT	
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KHA PROJECT
148400015

DATE
6/26/19

SCALE AS SHOWN

DESIGNED BY TDT

DRAWN BY JLH

TDT MANATEE COUNTY

SEWRF RECLAIMED PUMP BACK STATION

3P

30A


TIMOTHY THOMAS, P.E


FL LICENSE NUMBER
47079

FL DATE:

ELECTRICAL DETAILS
AND PANEL SCHEDULE

SHEET NUMBER

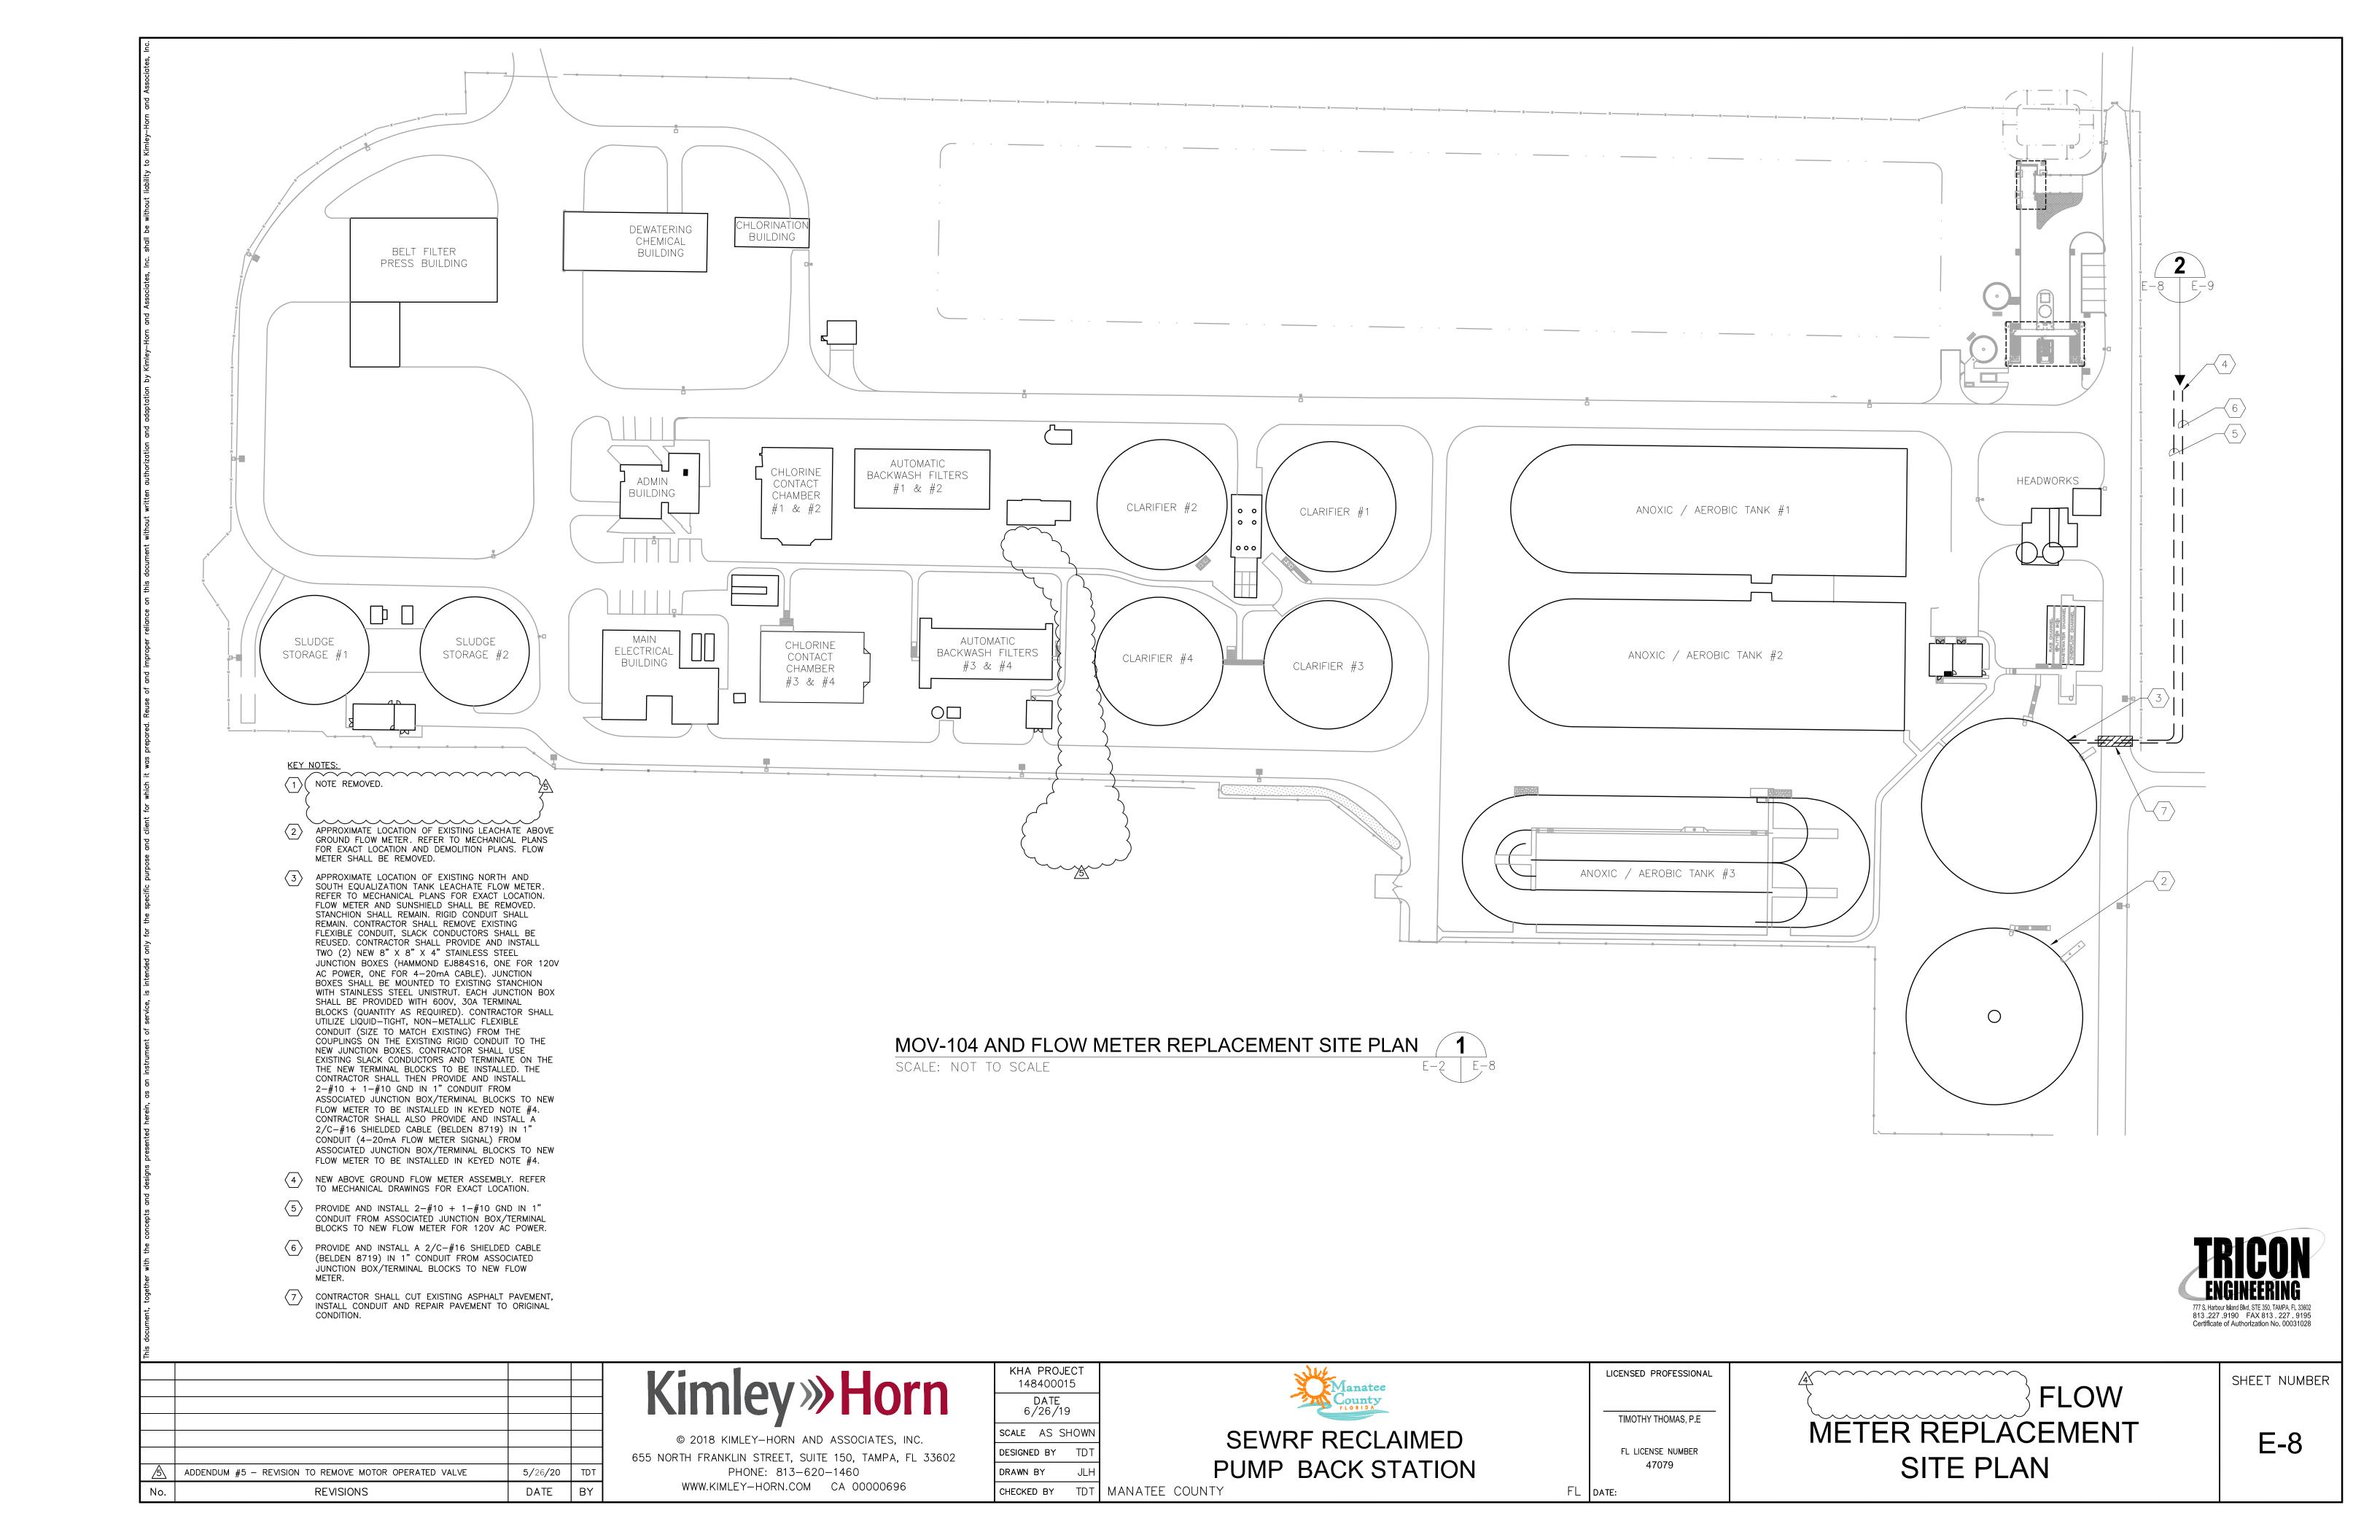

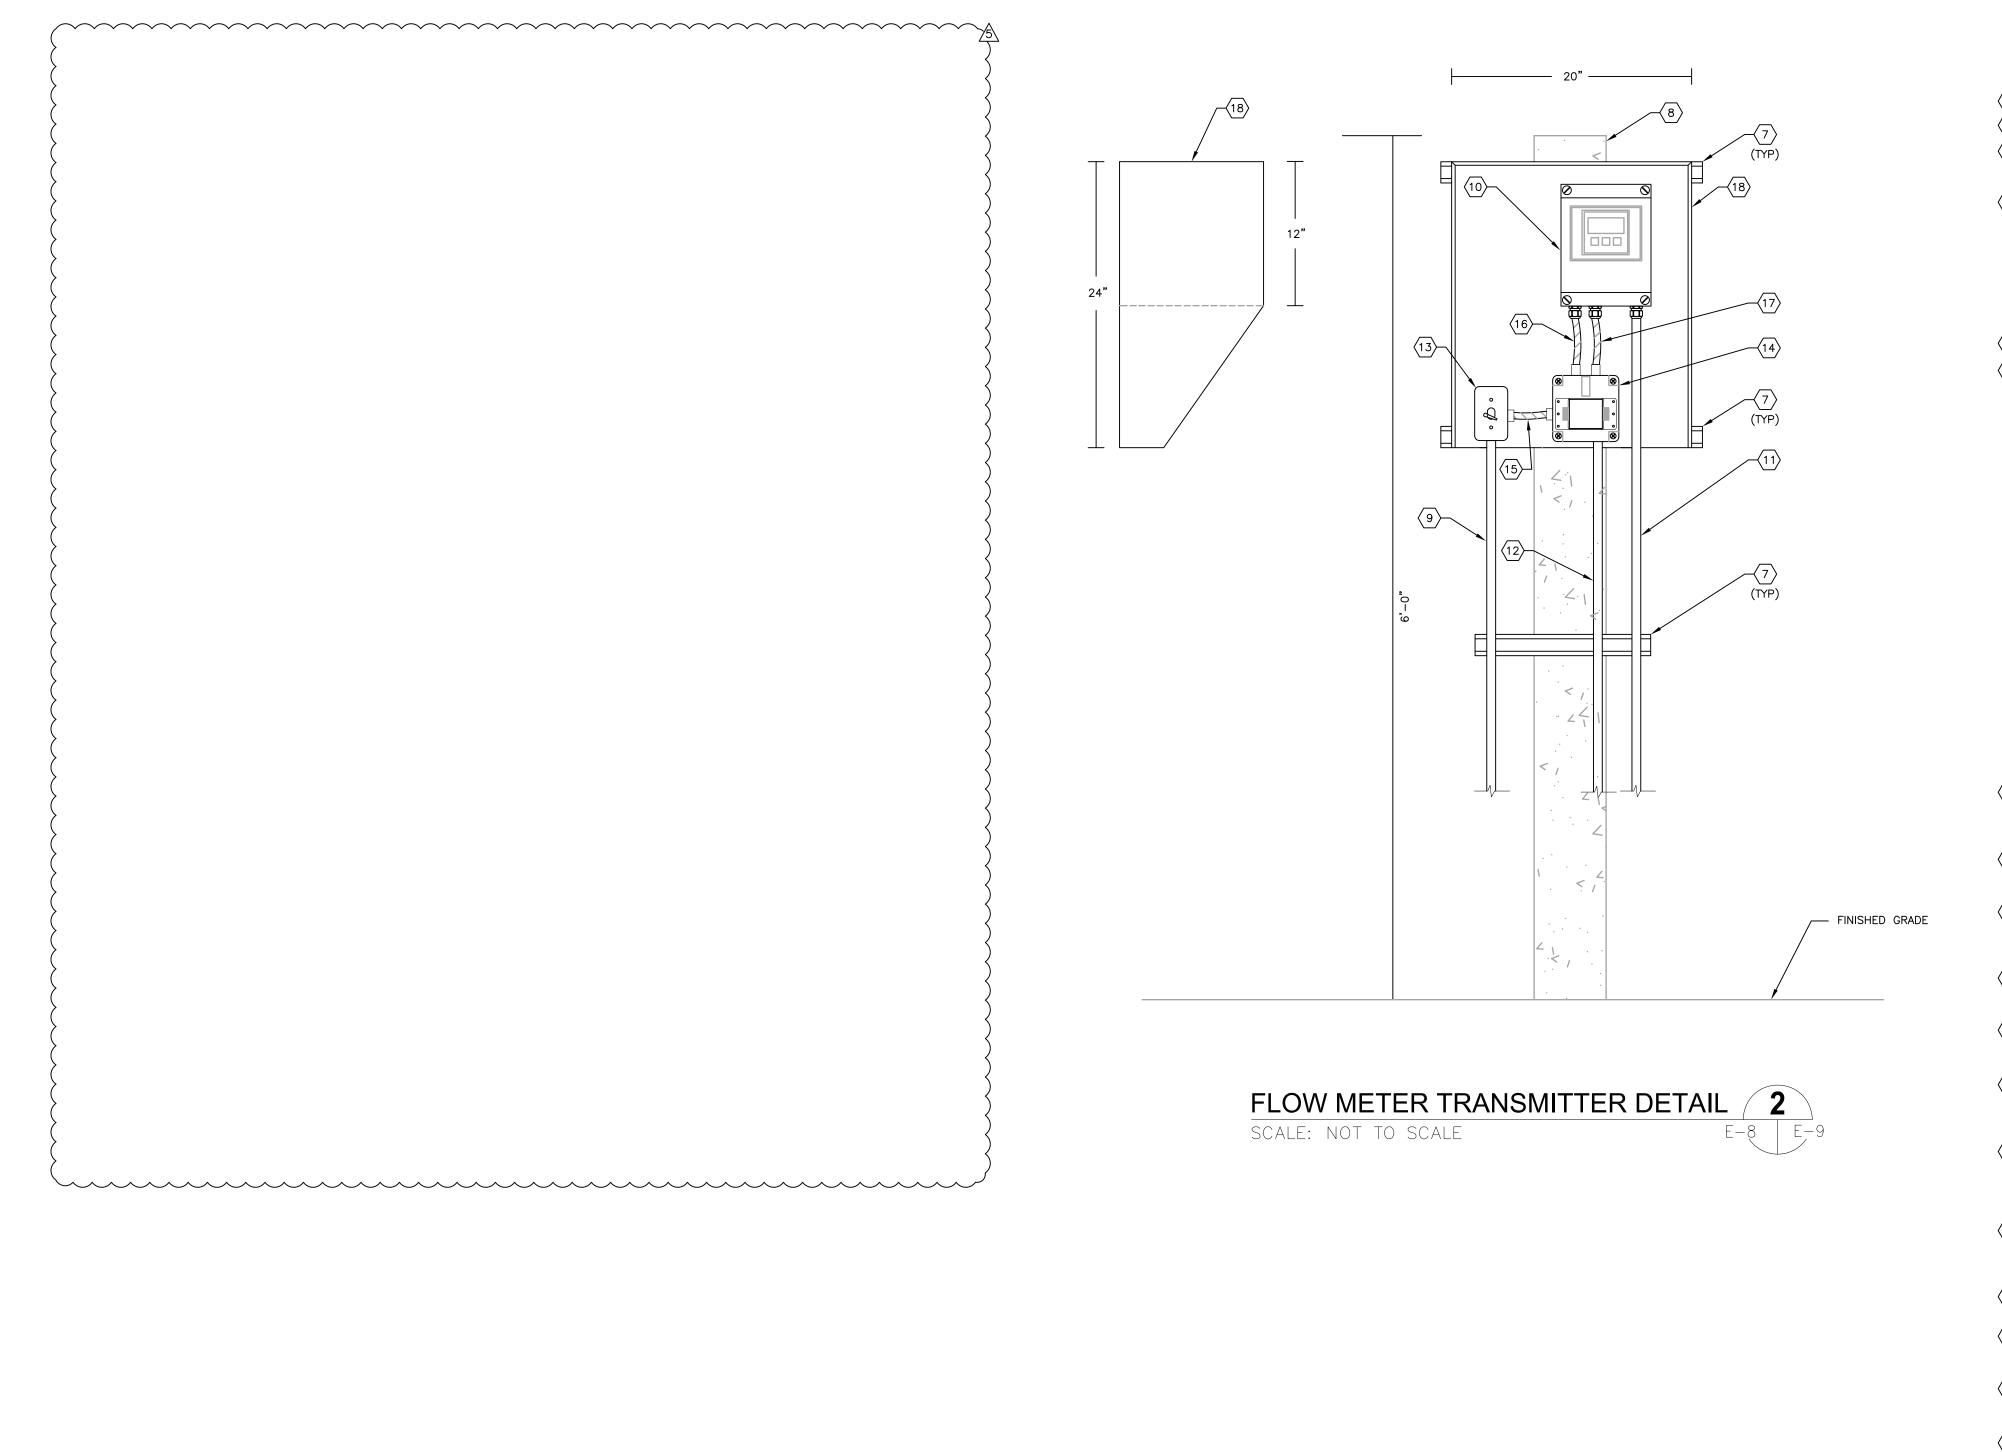

NOTE REMOVED.

GENERAL NOTES:

 THE CONTRACTOR SHALL FIELD VERIFY THE EXISTING CONTROL CONDUCTORS FOR MOV-104 (QUANTITY AND

FUNCTION) PRIOR TO ORDERING EQUIPMENT OR SUBMITTING SHOP DRAWINGS. THE CONTRACTOR SHALL

2. THE CONTRACTOR SHALL FIELD VERIFY THE EXISTING POWER SUPPLY UTILIZED FOR THE FLOW METER BEING RELOCATED IS 120V AC PRIOR TO ORDERING EQUIPMENT

CAPABILITY AS THE EXISTING VALVE.

OR SUBMITTING SHOP DRAWINGS.

INSURE THE NEW MOTOR OPERATED VALVE PROVIDES THE SAME CONTROL FUNCTIONS AND MONITORING

PROVIDE AND INSTALL 1-5/8" STAINLESS STEEL
UNISTRUT (OR EQUAL). BOLTS TO SECURE UNISTRUT
SHALL BE INSTALLED COMPLETELY THROUGH CONCRETE
POST.

PROVIDE AND INSTALL 6" X 6" CONCRETE POST. POST SHALL BE EMBEDDED A MINIMUM OF 3 FEET INTO SOIL.

PROVIDE AND INSTALL 2-#10 + 1-#10 GND IN 1" CONDUIT TO NEW JUNCTION BOX INSTALLED FOR FLOW METER TRANSMITTER FOR 120V POWER. REFER TO KEYED NOTE #5 ON SHEET E-8.

PROVIDE AND INSTALL ENDRESS HAUSER MAG METER PROMAG W400 REMOTE TRANSMITTER. PROVIDE 1/4" ALUMINUM PLATE FOR MOUNTING.

PROVIDE AND INSTALL MANUFACTURER SUPPLIED SENSOR CABLES IN 1" CONDUIT. VERIFY CONDUIT SIZE WITH MANUFACTURER.

PROVIDE AND INSTALL 2/C-#16 SHIELDED (BELDEN 8719) IN 1" CONDUIT TO JUNCTION BOX INSTALLED FOR FLOW METER 4-20mA SIGNAL. REFER TO KEYED NOTE #6 ON SHEET E-8.

PROVIDE AND INSTALL 120V, 15A, SINGLE-POLE SWITCH IN WEATHERPROOF FS BOX AS 120V POWER DISCONNECTING MEANS. PROVIDE AND INSTALL SINGLE-GANG WEATHERPROOF SWITCH COVER. BELL #5121-0.

PROVIDE AND INSTALL EDCO — SLAC SERIES AC POWER/SIGNAL TVSS DEVICE IN NEMA 4X ENCLOSURE TO PROTECT 120V POWER CIRCUIT AND 4—20mA ANALOG OUTPUT SIGNAL.

PROVIDE AND INSTALL 2-#10 + 1-#10 GND IN 3/4" FLEXIBLE, SEALTITE CONDUIT FOR 120V POWER.

PROVIDE AND INSTALL 2-#10 + 1-#10 GND IN 3/4" FLEXIBLE, SEALTITE CONDUIT TO FLOW METER TRANSMITTER FOR 120V POWER.

PROVIDE AND INSTALL 2/C-#16 SHIELDED (BELDEN 8719) IN 3/4" FLEXIBLE, SEALTITE CONDUIT. (4-20mA FLOW METER SIGNAL).

PROVIDE AND INSTALL SUN-SHIELD, CONSTRUCTED FROM 1/8" ALUMINUM STOCK. PROVIDE FULL FILLET WELDS. 20" WIDE, 24" TALL.

TRICOR ENGINEERING 777 S, Harbour Island Blvd, STE 350, TAMPA, FL 33602 813 .227 .9190 FAX 813 . 227 . 9195

Certificate of Authorization No. 00031028

ADDENDUM #5 - REVISION TO REMOVE MOTOR OPERATED VALVE

S/26/20 TDT

No. REVISIONS

DATE BY

Kimley Horn AND ASSOCIATES INC

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KHA PROJECT
148400015

DATE
6/26/19

SCALE AS SHOWN

DESIGNED BY TDT

DRAWN BY JLH

CHECKED BY



SEWRF RECLAIMED

JLH
TDT MANATEE COUNTY

TIMOTHY THOMAS, P.E

FL LICENSE NUMBER

FL DATE:

47079

ELECTRICAL DETAILS

SHEET NUMBER


CONDUIT	AND CABLE	SCHEDULE			
CONDUIT No	o. QTY/SIZE	NUMER OF CONDUCTORS/SIZE	FROM	TO	REMARKS
P100	4"	3-#350 + 1-#250 NEUTRAL	FP&L HANDHOLE	MAIN DISTRIBUTION PANELBOARD 'MDP'	
P100A	4"	3-#350 + 1-#250 NEUTRAL	FP&L HANDHOLE	MAIN DISTRIBUTION PANELBOARD 'MDP'	
P101	2"	3-4/0 + 1-#4 GND	MAIN DISTRIBUTION PANELBOARD 'MDP'	MOTOR CONTROL CABINET	PUMP No. 1 VFD FEEDER.
P101A	2"	3-4/0 + 1-#4 GND	MOTOR CONTROL CABINET	PUMP No. 1 JUNCTION BOX	
PTOTB ~	4,,,,	PUMP CABLE BY MANUFACTURER	PUMP No. 1 JUNCTION BOX	PUMP No. T	CABLE TO INCLUDE CONDUCTORS FOR PUMP LEAK AND TEMPERATURE SENSOR.
P102	2"	3-4/0 + 1-#4 GND	MAIN DISTRIBUTION PANELBOARD 'MDP'	MOTOR CONTROL CABINET	PUMP No. 2 VFD FEEDER.
P102A	2"	3-4/0 + 1-#4 GND	MOTOR CONTROL CABINET	PUMP No. 2 JUNCTION BOX	
P102B	4"	PUMP CABLE BY MANUFACTURER	PUMP No. 2 JUNCTION BOX	PUMP No. 2	CABLE TO INCLUDE CONDUCTORS FOR PUMP LEAK AND TEMPERATURE SENSOR.
P103	2"	3-4/0 + 1-#4 GND	MAIN DISTRIBUTION PANELBOARD 'MDP'	MOTOR CONTROL CABINET	PUMP No. 3 VFD FEEDER.
P103A	2"	3-4/0 + 1-#4 GND	MOTOR CONTROL CABINET	PUMP No. 3 JUNCTION BOX	
P103B	4"	PUMP CABLE BY MANUFACTURER	PUMP No. 3 JUNCTION BOX	PUMP No. 3	CABLE TO INCLUDE CONDUCTORS FOR PUMP LEAK AND TEMPERATURE SENSOR.
P200	1"	3-#10 + 1-#10 NEU + 1-#10 GND	MAIN DISTRIBUTION PANELBOARD 'MDP'	'MDP' SURGE PROTECTION DEVICE	PROVIDE NON-METALLIC WEATHERPROOF FLEXIBLE CONDUIT.
P201	1"	2-#10 + 1-#10 GND	MAIN DISTRIBUTION PANELBOARD 'MDP'	MINI POWER ZONE 'LP' TRANSFORMER	
P300	3/4"	2-#12 + 1-#12 GND	PANELBOARD 'LP'	FLOW METER TRANSMITTER	120V AC FLOW TRANSMITTER POWER. CIRCUIT LP-10.
P301	3/4"	2-#12 + 1-#12 GND	PANELBOARD 'LP'	AREA LIGHT	120V AC AREA LIGHT POWER. CIRCUIT LP-2.
P302	3/4"	2-#12 + 2-#12 NEU + 1-#12 GND	PANELBOARD 'LP'	PUMP CONTROL PANEL	120V AC PUMP CONTROL CABINET POWER. CIRCUITS LP-1 AND LP-3.
⊇303	1"	4-#12 + 4-#12 NEU + 1-#12 GND	PANELBOARD 'LP'	MOTOR CONTROL CABINET	120V AC POWER. CIRCUITS LP-4, LP-5, LP-6 AND LP-8.
² 304	3/4"	2-#10 + 1-#10 NEU + 1-#10 GND	PANELBOARD ZONE 'LP'	'LP' SURGE PROTECTION DEVICE	PROVIDE NON-METALLIC WEATHERPROOF FLEXIBLE CONDUIT.
G100	1-1/4"	2/0 BARE COPPER	MAIN DISTRIBUTION PANELBOARD 'MDP'	GROUNDING ELECTRODE GRID	
G200	3/4"	#8 BARE COPPER	PANELBOARD 'LP'	GROUNDING ELECTRODE GRID	
G300	1"	#4 BARE COPPER	METER SOCKET	GROUNDING ELECTRODE GRID	
G400	1-1/4"	1/0 BARE COPPER	RADIO ANTENNA TOWER	GROUNDING ELECTRODE GRID	
C100	1"	2/C-#16 SHIELDED CABLE	PUMP CONTROL CABINET	FLOW METER TRANSMITTER	FLOW METER 4-20mA SIGNAL. CABLE TO BE BELDEN 8719.
C100A	1"	SENSOR CABLE	FLOW METER ELEMENT	FLOW METER TRANSMITTER	FLOW METER ELEMENT SENSOR CABLE TO BE PROVIDED BY MANUFACTURER.
C101	2"	FIVE (5) 2/C-#14 + 1-#14 GND	WET WELL FLOAT SWITCHES	WET WELL JUNCTION BOX	CABLES TO BE PROVIDED BY FLOAT SWITCH MANUFACTURER.
C101A	2"	10-#14 + 1-#14 GND	WET WELL JUNCTION BOX	PUMP CONTROL PANEL	FLOAT SIGNALS.
C102	2"	LEVEL TRANSMITTER CABLE	WET WELL LEVEL TRANSDUCER	WET WELL JUNCTION BOX	CABLE TO BE PROVIDED BY LEVEL TRANSDUCER MANUFACTURER.
C102A	1"	2/C-!6 SHIELDED CABLE	WET WELL JUNCTION BOX	PUMP CONTROL CABINET	WET WELL LEVEL 4-20mA SIGNAL. CABLE TO BE BELDEN 8719.
C200	1"	20-#14 + 1-#14 GND	MOTOR CONTROL CABINET	PUMP CONTROL CABINET	VFD MINI CAS II AND NORMAL POWER MONITORING. CONDUCTOR COUNT INCLUDES SPARES.
C300	1-1/4"	COAXIAL CABLE	PUMP CONTROL PANEL	RADIO ANTENNA TOWER	
C401	3/4"	2-#14 + 1-#14 GND	PUMP No. 1 JUNCTION BOX	MOTOR CONTROL CABINET	MINI CAS II FROM PUMP No. 1.
C402	3/4"	2-#14 + 1-#14 GND	PUMP No. 2 JUNCTION BOX	MOTOR CONTROL CABINET	MINI CAS II FROM PUMP No. 2.
C403	3/4"	2-#14 + 1-#14 GND	PUMP No. 3 JUNCTION BOX	MOTOR CONTROL CABINET	MINI CAS II FROM PUMP No. 3.
E100	2"	ETHERNET CABLE	PUMP CONTROL CABINET	MOTOR CONTROL CABINET	VFD ETHERNET CONTROL
F100	1"	EMPTY	METER SOCKET	FP&L CT'S	COORDINATE CONDUIT SIZE AND ALL OTHER REQUIREMENTS WITH FP&L. PROVIDE PULL—STRING.



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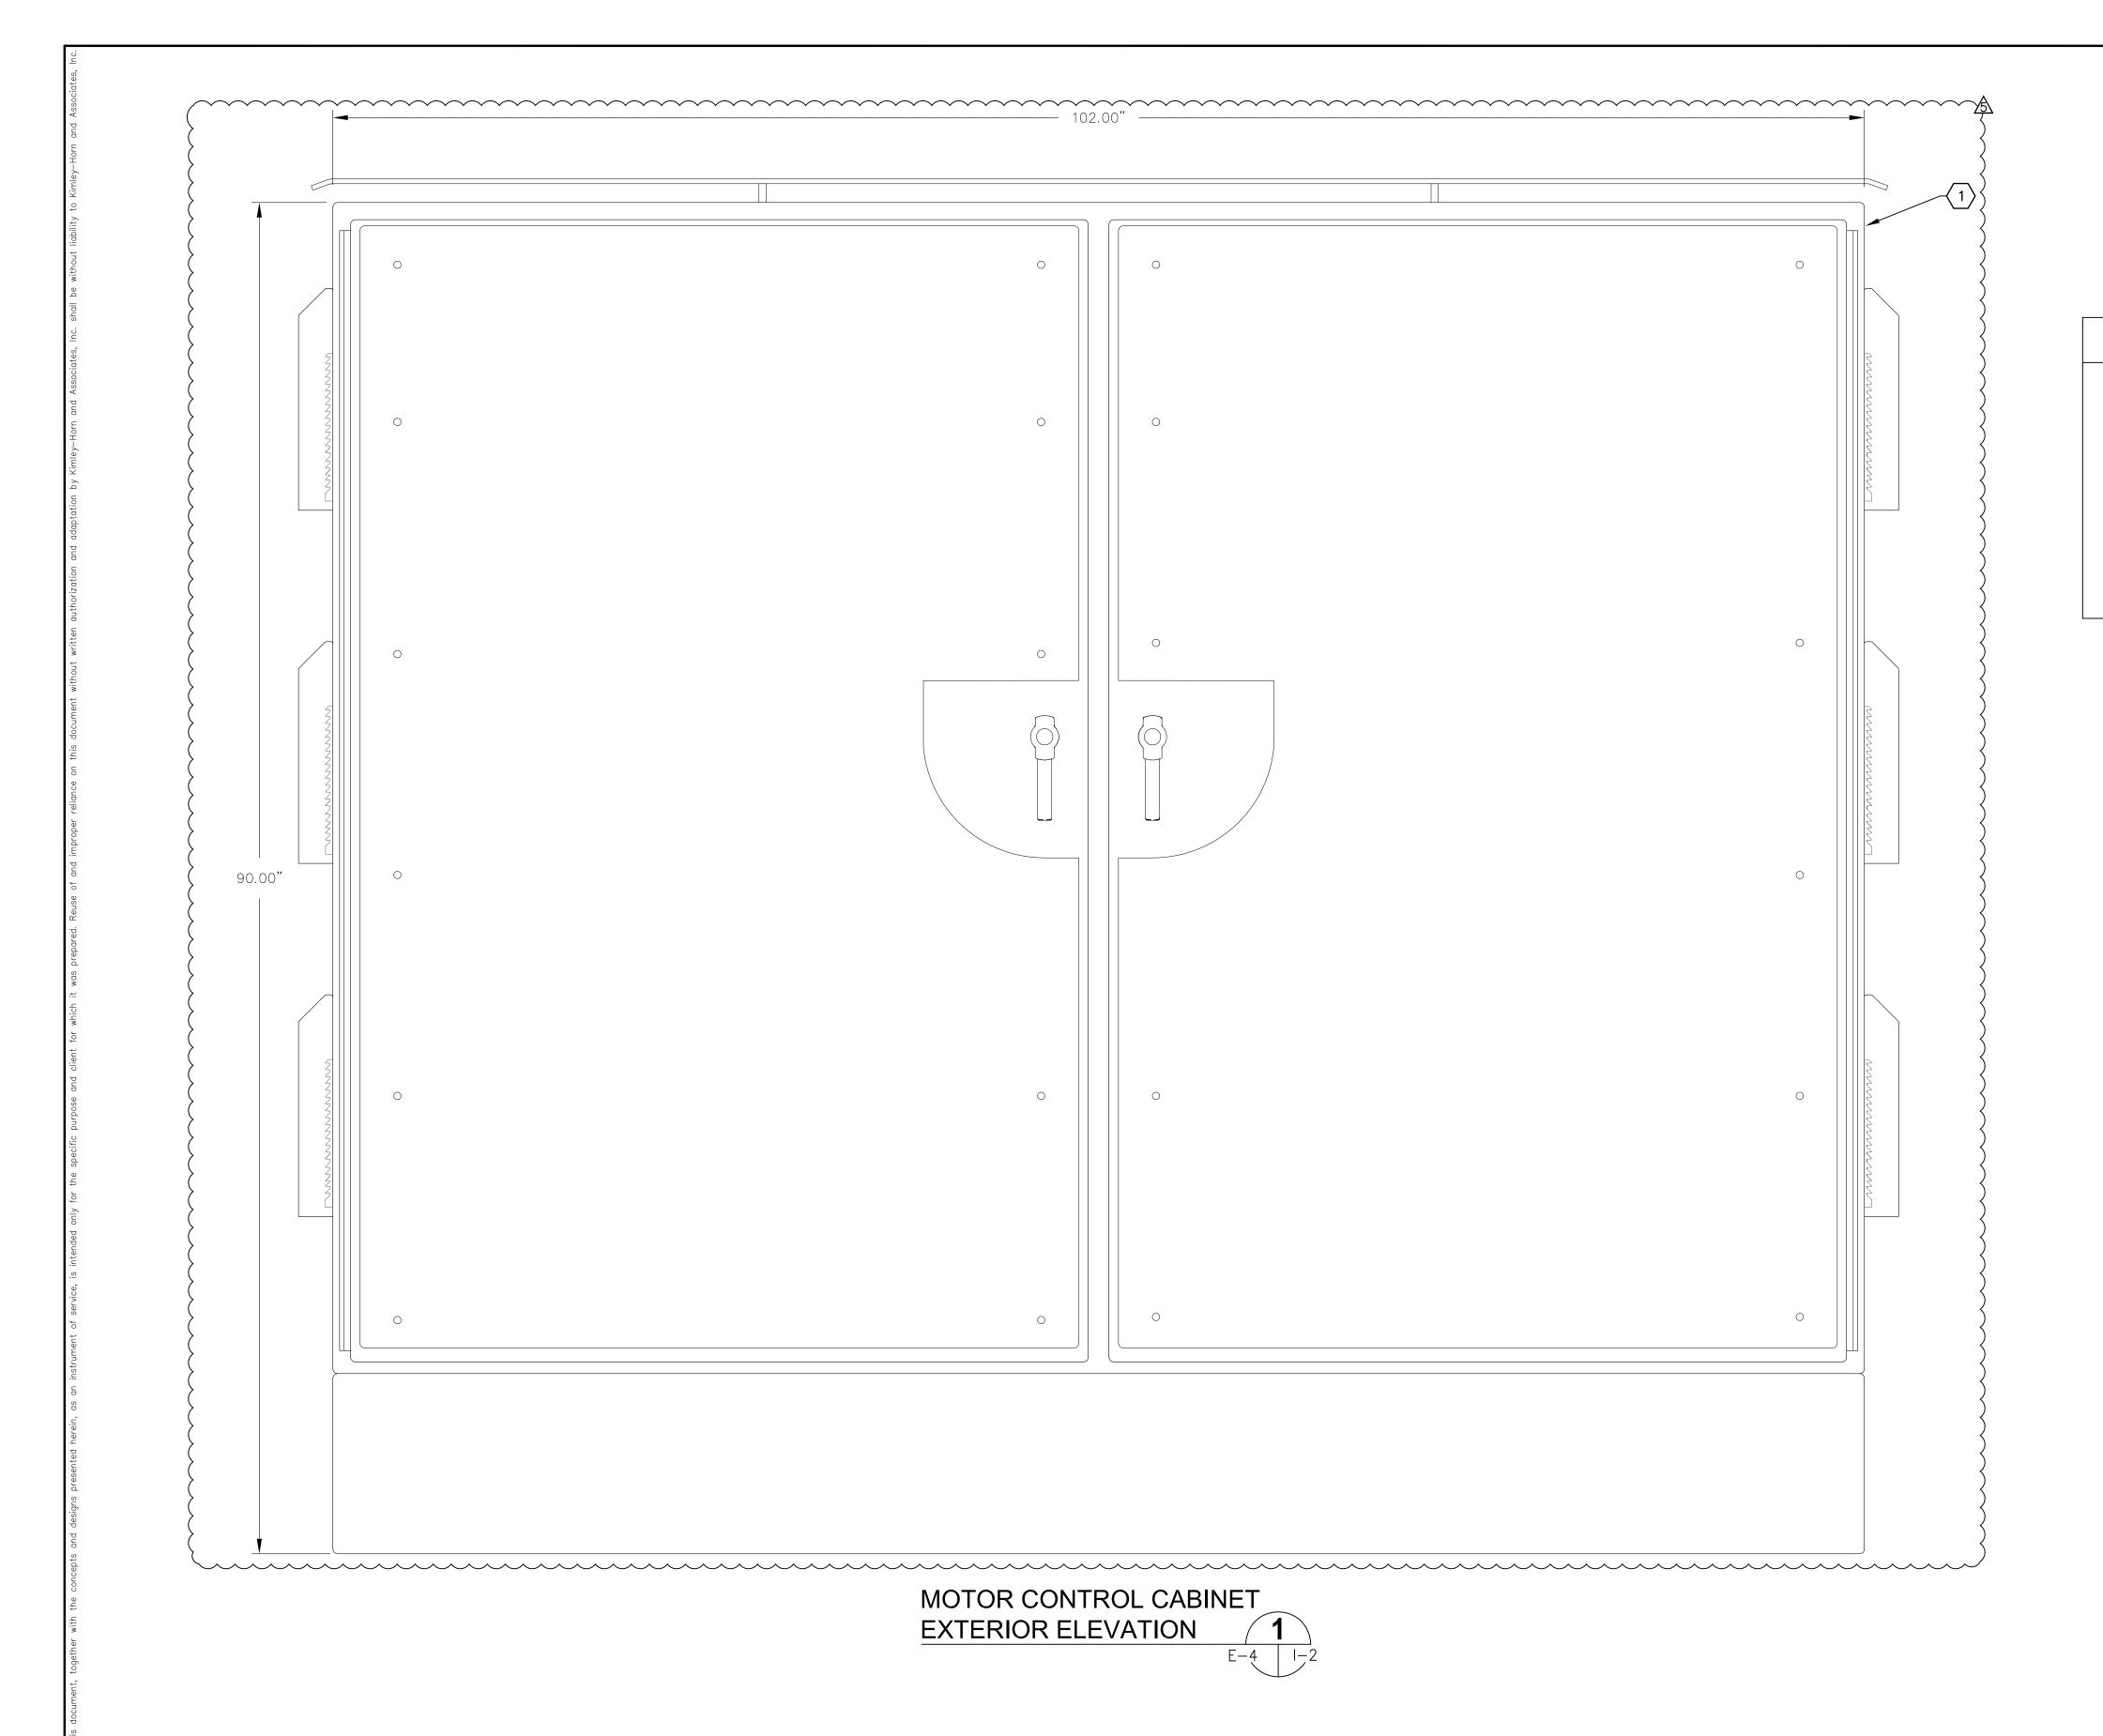


LICENSED PROFESSIONAL
TIMOTHY THOMAS, P.E
FL LICENSE NUMBER
47070

FL DATE:

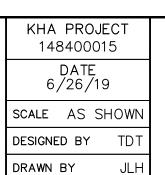CONDUIT AND CABLE SCHEDULE

SHEET NUMBER



GENERAL NOTES:

- 1. REFER TO SHEET I-5 FOR BILL OF MATERIALS.
- 2. PROVIDE AND INSTALL ALL ASSOCIATED END BARRIERS, TERMINAL JUMPERS AND SPACERS AS REQUIRED FOR TERMINAL BLOCKS AS SHOWN OR
- 3. PROVIDE AND INSTALL 35mm ALUMINUM DIN RAIL. QUANTITY AS REQUIRED.
- 4. PROVIDE AND INSTALL CORROSION INHIBITOR, HOFFMAN # AHCI10E.
- 5. PROVIDE AND INSTALL STAINLESS STEEL BIRD SPIKES (FOR PIGEONS OR LARGER BIRDS) TO COVER TOP OF ENCLOSURE. INSTALL BIRD SPIKES WITH NON-SILICONE BASED ADHESIVE FOR OUTDOOR CONSTRUCTION OR PER MANUFACTURER'S SPECIFICATIONS.

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No.	REVISIONS	DATE	BY	WWW.KIMLEY-HORN.COM CA 00000696

KHA PROJECT 148400015 DATE 6/26/19 SCALE AS SHOWN ESIGNED BY



LICENSED PROFESSIONAL TIMOTHY THOMAS, P.E

FL LICENSE NUMBER

FL DATE:

MOTOR CONTROL CABINET **EXTERIOR ELEVATION**

SHEET NUMBER

1-2



GENERAL NOTES:

- 1. REFER TO SHEET I-5 FOR BILL OF MATERIALS.
- 2. PROVIDE AND INSTALL ALL ASSOCIATED END BARRIERS, TERMINAL JUMPERS AND SPACERS AS REQUIRED FOR TERMINAL BLOCKS AS SHOWN OR REQUIRED
- 3. PROVIDE AND INSTALL 35mm ALUMINUM DIN RAIL. QUANTITY AS REQUIRED.
- 4. PROVIDE AND INSTALL CORROSION INHIBITOR, HOFFMAN # AHCI10E.
- 5. PROVIDE AND INSTALL STAINLESS STEEL BIRD SPIKES (FOR PIGEONS OR LARGER BIRDS) TO COVER TOP OF ENCLOSURE. INSTALL BIRD SPIKES WITH NON-SILICONE BASED ADHESIVE FOR OUTDOOR CONSTRUCTION OR PER MANUFACTURER'S SPECIFICATIONS.

TRICOR
ENGINEERING

777 S. Harbour Island Blvd, STE 350, TAMPA, FL 33602
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Certificate of Authorization No. 00031028

ADDENDUM #5 - PUMP MOTOR REVISIONS

No. REVISIONS

DATE BY

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KHA PROJECT
148400015

DATE
6/26/19

SCALE AS SHOWN
DESIGNED BY TDT

TDT MANATEE COUNTY

SEWRF RECLAIMED
PUMP BACK STATION

TIMOTHY THOMAS, P.E

FL LICENSE NUMBER


FL DATE:

LICENSED PROFESSIONAL

MOTOR CONTROL CABINET DEADFRONT ELEVATION

SHEET NUMBER

I-2A

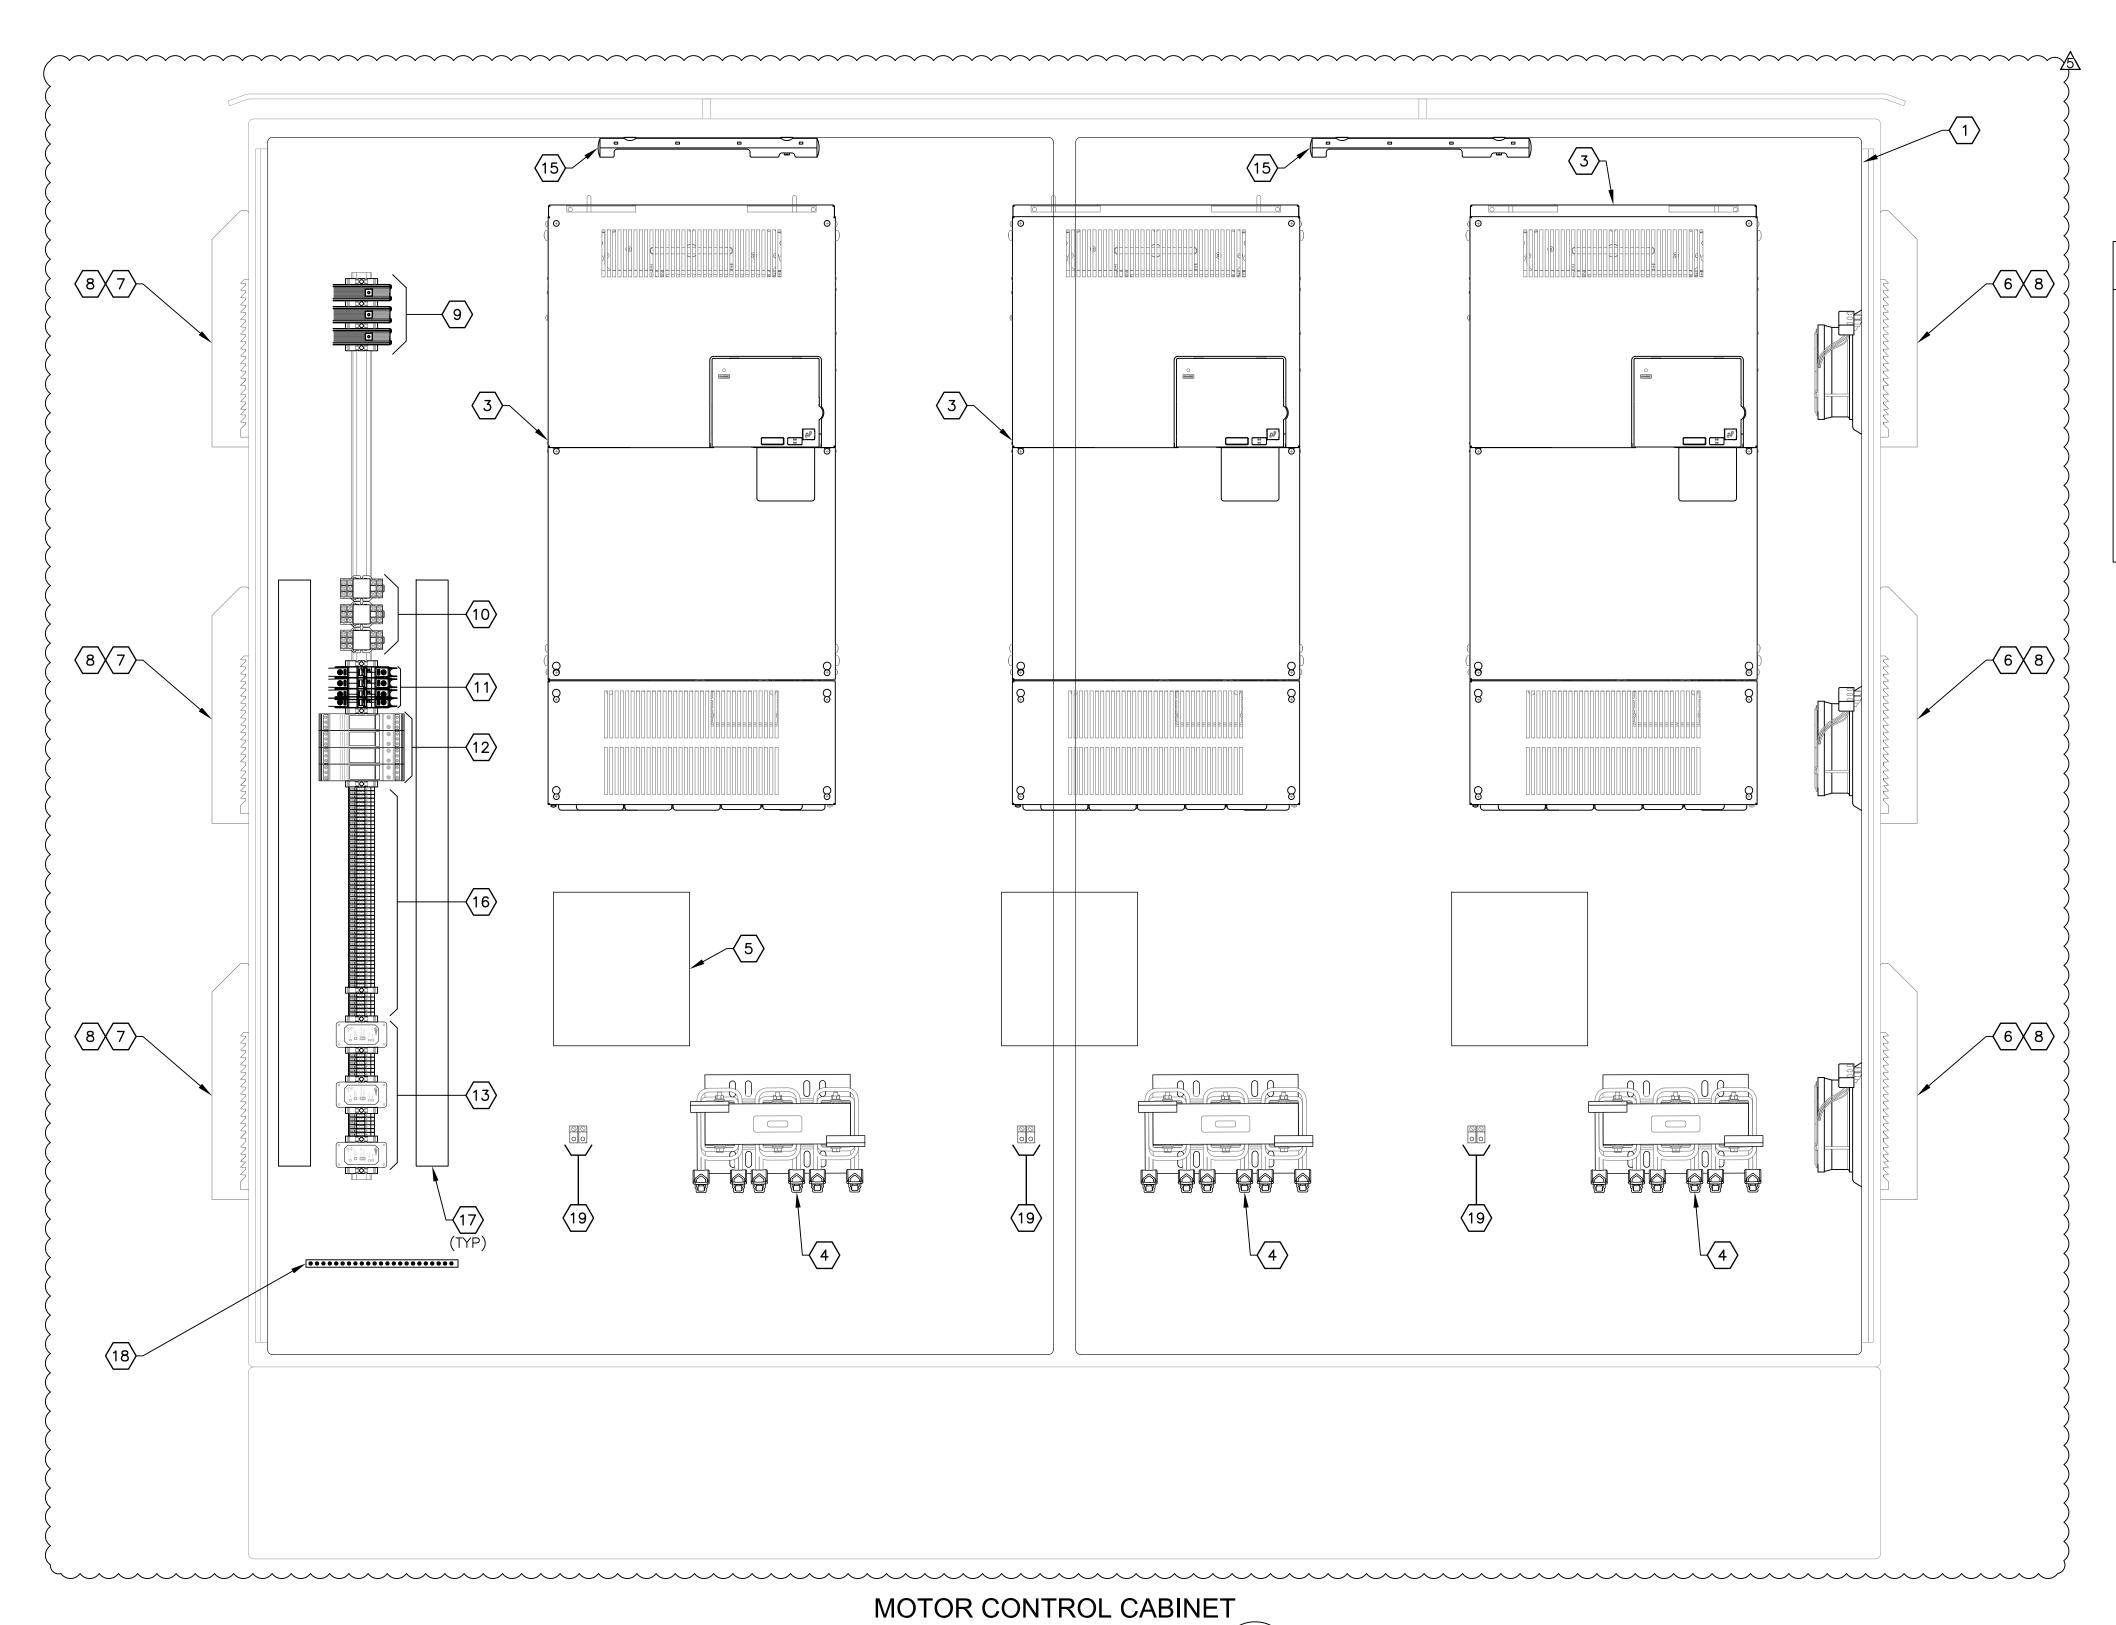

GENERAL NOTES:

- 1. REFER TO SHEET I-5 FOR BILL OF MATERIALS.
- 2. PROVIDE AND INSTALL ALL ASSOCIATED END BARRIERS, TERMINAL JUMPERS AND SPACERS AS REQUIRED FOR TERMINAL BLOCKS AS SHOWN OR
- 3. PROVIDE AND INSTALL 35mm ALUMINUM DIN RAIL. QUANTITY AS REQUIRED.
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- 5. PROVIDE AND INSTALL STAINLESS STEEL BIRD SPIKES (FOR PIGEONS OR LARGER BIRDS) TO COVER TOP OF ENCLOSURE. INSTALL BIRD SPIKES WITH NON-SILICONE BASED ADHESIVE FOR OUTDOOR CONSTRUCTION OR PER MANUFACTURER'S SPECIFICATIONS.

MOTOR CONTROL CABINET
DEADFRONT ELEVATION 1
SCALE: NOT TO SCALE E-4 1-4

(SHOWN WITH ENCLOSURE DOOR OPEN)

TRICOR
ENGINEERING

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A	ADDENDUM #5 - PUMP MOTOR REVISIONS	5/26/20	TDT
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MANATEE COUNTY

SEWRF RECLAIMED
PUMP BACK STATION

TIMOTHY THOMAS, P.E

LICENSED PROFESSIONAL

FL LICENSE NUMBER
47079

FL DATE:

MOTOR CONTROL CABINET DEADFRONT ELEVATION

SHEET NUMBER

I-2B

NOTE#	QTY	DESCRIPTION	PART NUMBER	MANUFACTURER	NOTES
1	1	102" X 90" X 24", NEMA 4X, POWDER COATED WHITE	CUSTOM	CUSTOM	316 STIAINLESS STEEL, POWDER COATED WHITE WITH HINGED AND DEADFRONT DOORS, HANDLES, PADLOCKABLE 3-POINT LATCHING, DOOR STOP KITS ALUMINUM BACKPANEL AND SUNSHIELDS.
$\frac{2}{2}$	3	DOOR KEYPAD MOUNTING KIT	UUX000527	YASKAWA	REMOVAL KEYPAD FOR VARIABLE FREQUENCY DRIVE CONTROL.
3	3	VARIABLE FREQUENCY DRIVE	CIMR-PW4A0208AFF	YASKAWA	480V, 208 AMP OUTPUT CAPACITY FOR 125 HP DRIVE. PROVIDE WITH ETHERNET IP CARD, YASKAWA PART # SI-EN3.
4	3	IEEE 519 COMPLIANT FILTER			SIZE AND PART NUMBER BY MOTOR CONTROL PANEL FABRICATOR.
5	3	MOTOR OUTPUT FILTER			SIZE AND PART NUMBER BY MOTOR CONTROL PANEL FABRICATOR.
6	3	CABINET FAN, UL TYPE 12	PF 67000-11667154055	PFANNENBERG	368 CFM, 115V, 50/60 HZ WITH FILTER.
7	3	CABINET EXHAUST FILTER	PFA 6000-11740004055	PFANNENBERG	
8	6	WASHDOWN SHROUD	PF-RH-60000-1818200020	PFANNENBERG	STAINLESS STEEL
9	3	CAT 6 SURGE PROTECTION DEVICE	#2858991	PHOENIX CONTACT	
(10)	3	FAN CONTROL RELAYS	CLASS 8501, TYPE R	SQUARE D	10A CONTACTS WITH 120V AC COILS.
(11)	4	POWER CIRCUIT BREAKERS	TYPE 1489M	ALLEN BRADLEY	120V, 5 AMPERE.
(12)	4	120V SURGE PROTECTION DEVICE	#2905228	PHOENIX CONTACT	
(13)	3	PUMP MOTOR SUPERVISORY RELAY	MINI CAS II	XYLEM	RELAYS TO BE PROVIDED BY PUMP MANUFACTURER.
(14)	1	DUPLEX GFI RECEPTACLE	GFR5352IA	HUBBELL	
(15)	2	120V AC LED CABINET LIGHT	LEDA1S35	HOFFMAN	120V AC LED FIXTURE WITH INTEGRAL ON/OFF SWITCH. PROVIDE CUSTOM BRACKET TO MOUNT FIXTURE TO PANEL.
(16)		TERMINAL BLOCKS	DN-T10B-A	AUTOMATION DIRECT	QUANTITY AS REQUIRED.
(17)		2" X 3" SLOTTED WIRING DUCT	G2X3LG6	PANDUIT	QUANTITY AS REQUIRED.
(18)	1	EQUIPMENT GROUND BAR SYSTEM	UGB2/0-414-18	PANDUIT	PROVIDE BONDING STANDOFFS (PANDUIT UGB-B-S0).
<u>(19)</u>	3	GROUNDING LUGS			PROVIDE GROUNDING LUGS AS REQUIRED FOR PUMP MOTOR CABLE GROUNDING.



◬	ADDENDUM #5 - PUMP MOTOR REVISIONS	5/26/20	TDT
No.	REVISIONS	DATE	BY

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PHONE: 813—620—1460
WWW.KIMLEY—HORN.COM CA 00000696

KHA PROJECT
148400015

DATE
6/26/19

SCALE AS SHOWN
DESIGNED BY TDT

SEWRF RECLAIMED

TDT

JLH

TDT

MANATEE COUNTY

TIMOTHY THOMAS, P.E


FL LICENSE NUMBER
47079

FL DATE:

MOTOR CONTROL CABINET BILL OF MATERIALS

SHEET NUMBER

I-3

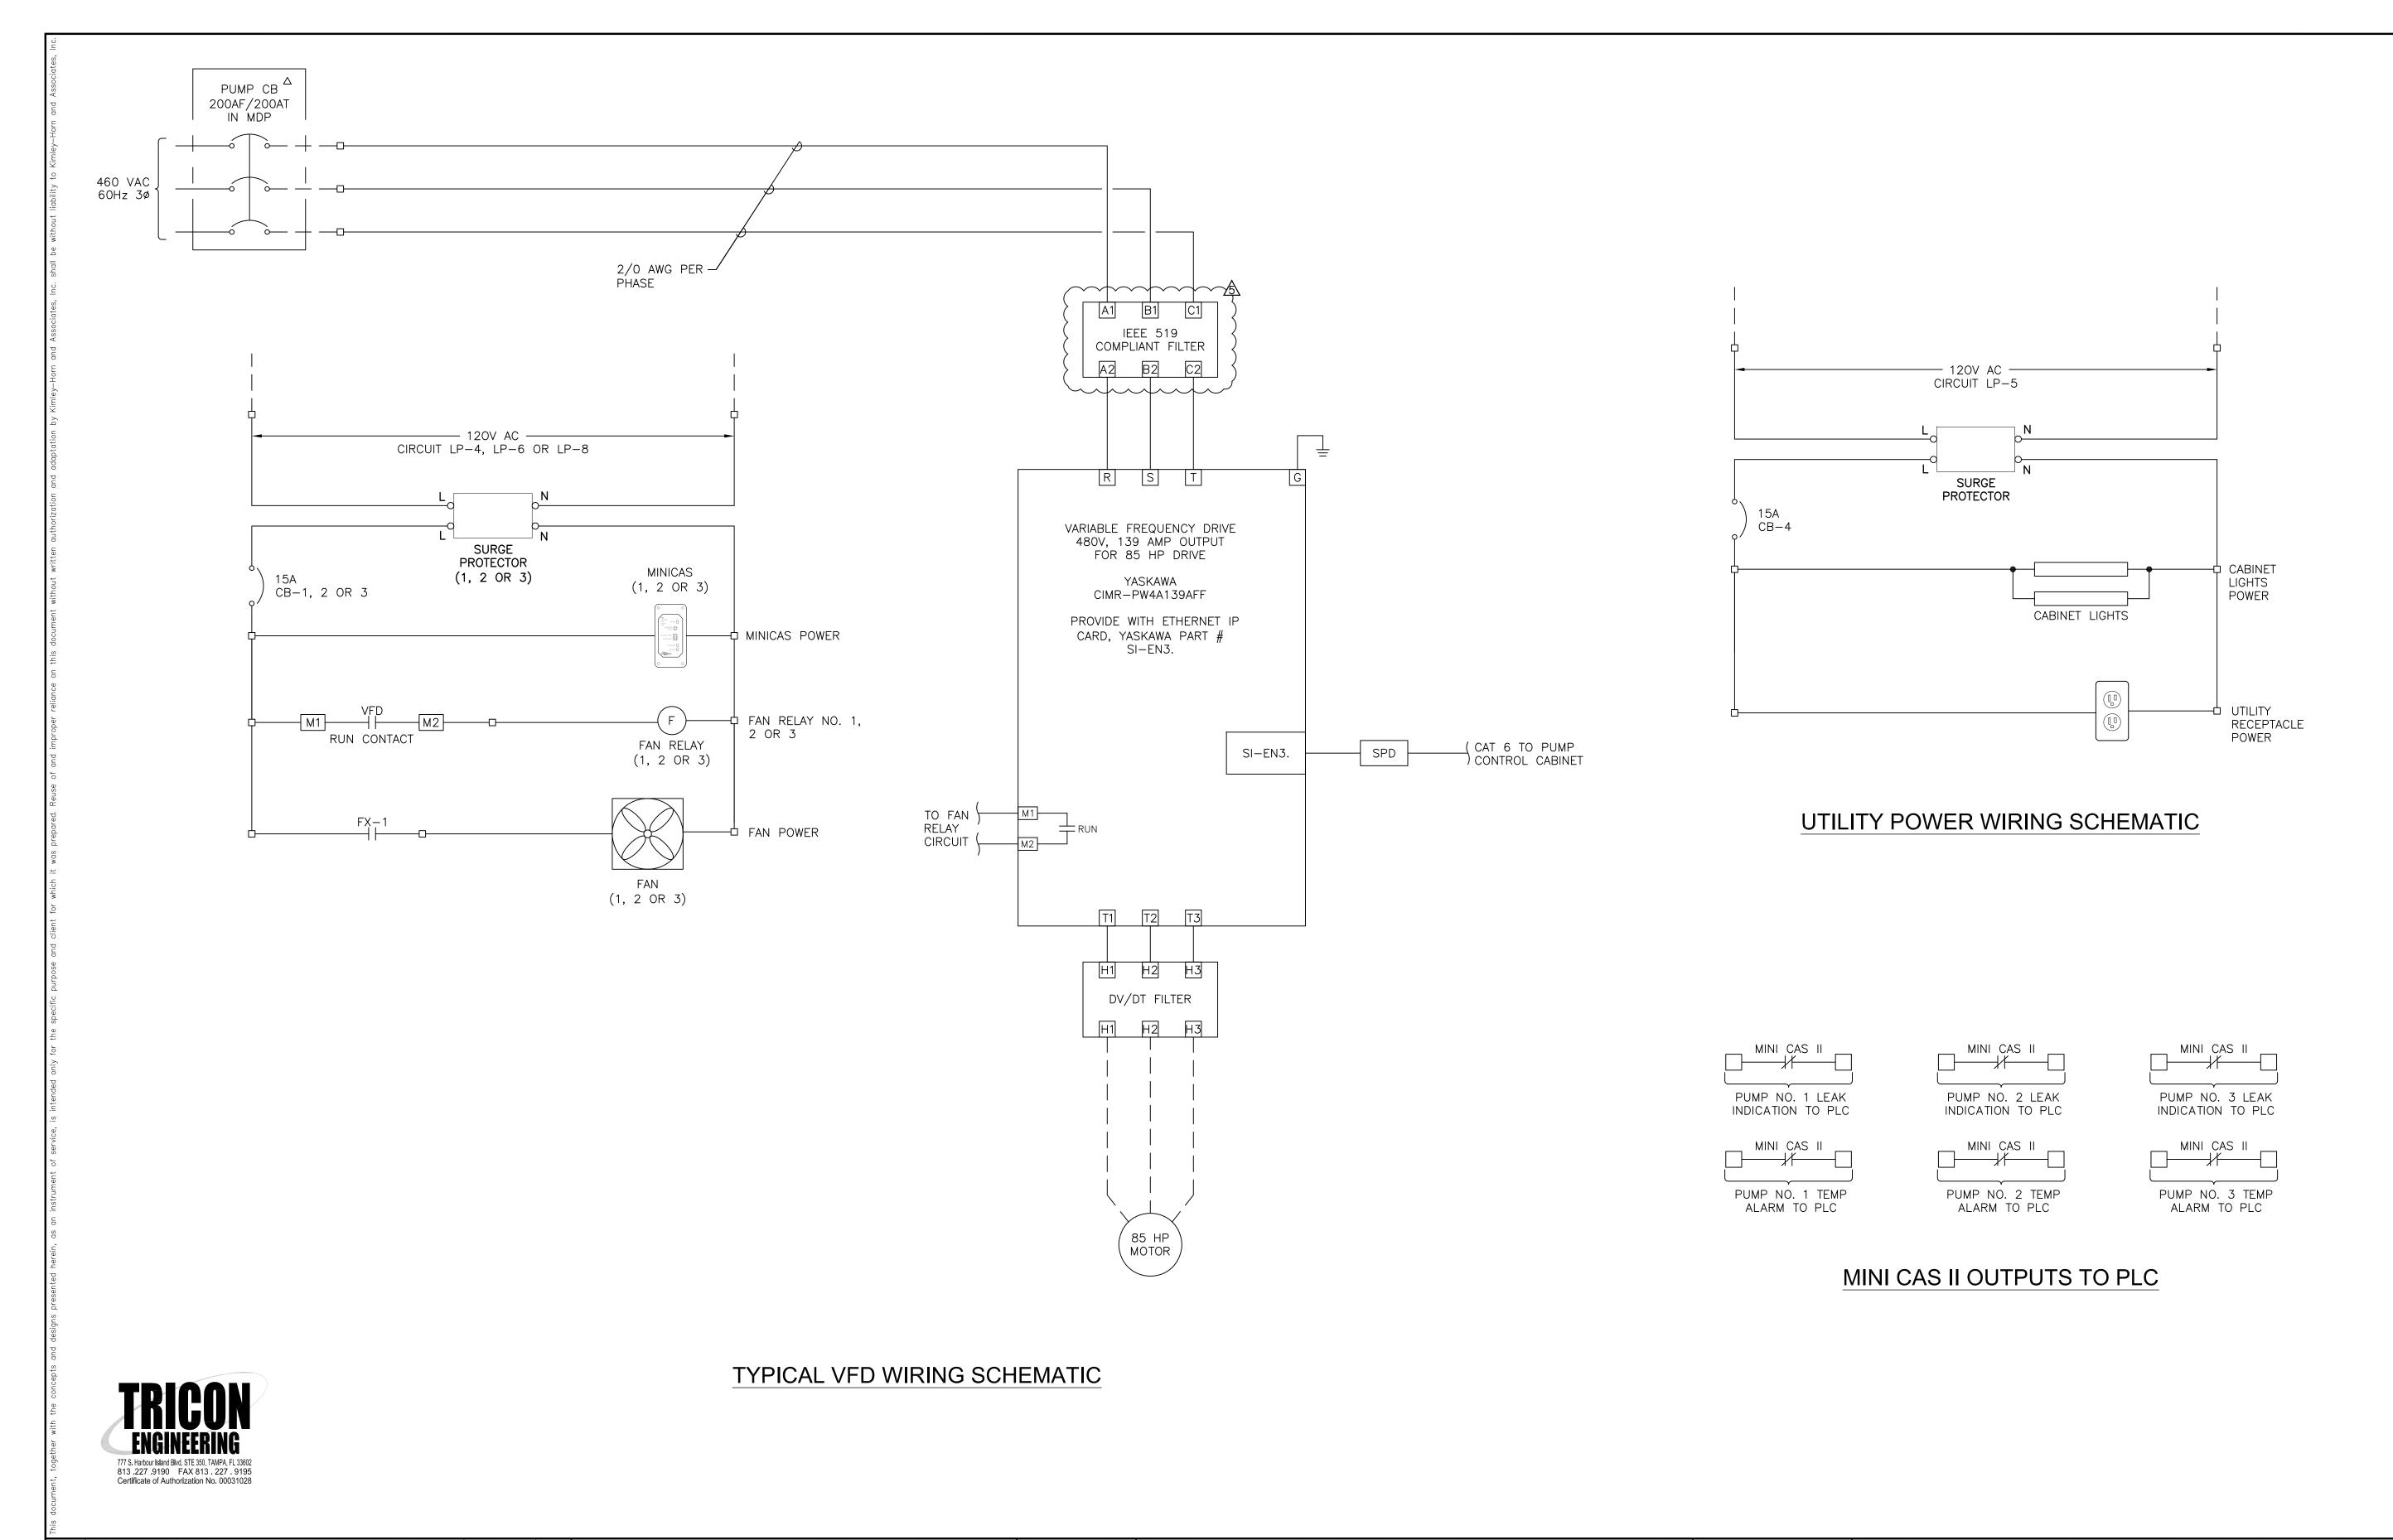

ADDENDUM #5 - PUMP MOTOR REVISIONS

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TDT MANATEE COUNTY

TIMOTHY THOMAS, P.E


FL LICENSE NUMBER
47079

FL DATE:

TYPICAL VFD WIRING SCHEMATIC

I-4

SHEET NUMBER

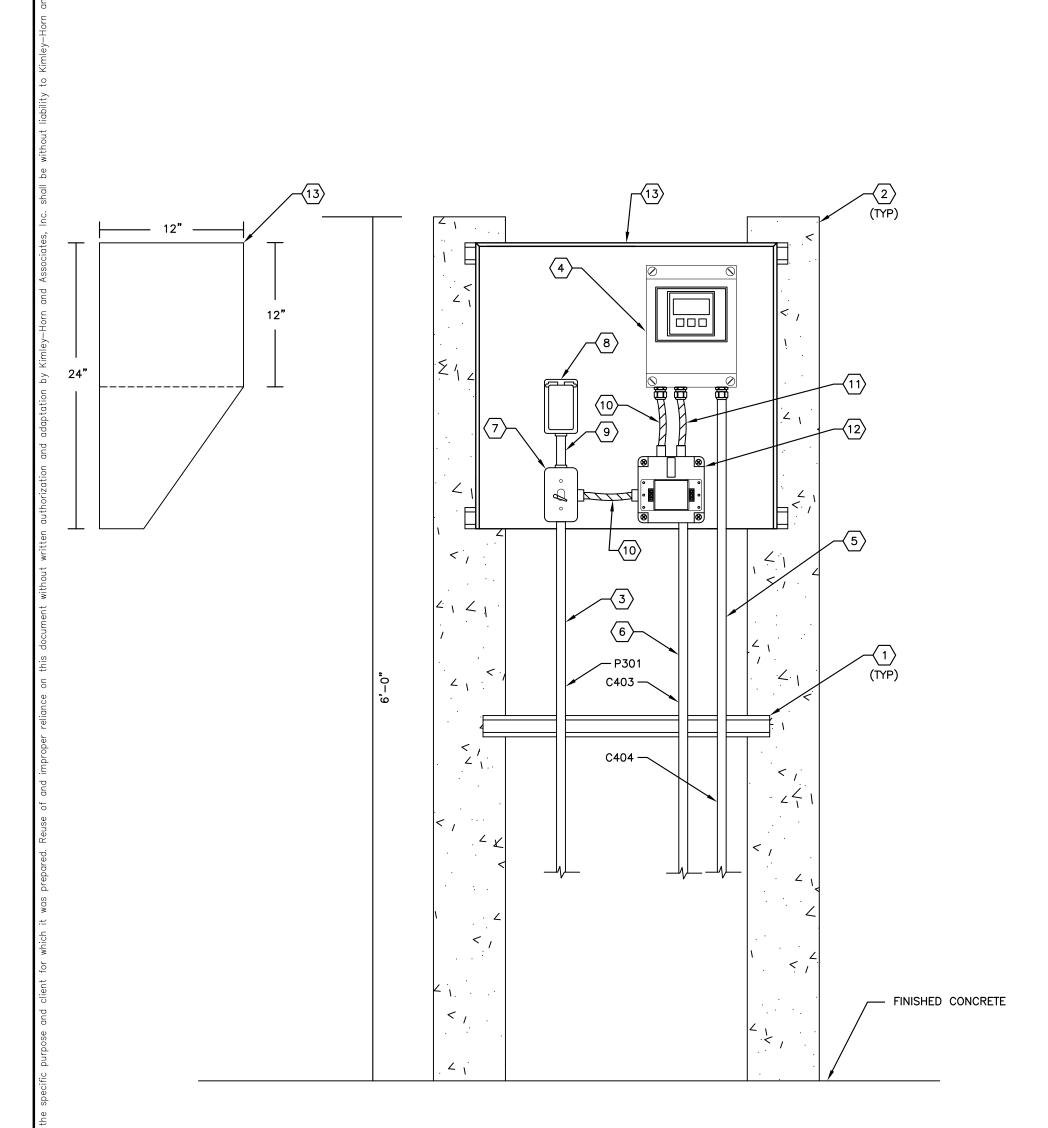


FLOW TRANSMITTER RACK ELEVATION SCALE: NOT TO SCALE E-3

KEY NOTES:

- PROVIDE AND INSTALL 1-5/8" STAINLESS STEEL UNISTRUT (OR EQUAL). BOLTS TO SECURE UNISTRUT SHALL BE INSTALLED COMPLETELY THROUGH CONCRETE
- PROVIDE AND INSTALL 6" X 6" CONCRETE POST. POST SHALL BE EMBEDDED A MINIMUM OF 3 FEET INTO CONCRETE SLAB/SOIL.
- PROVIDE AND INSTALL 2-#12 THWN CU + 1-#12
 THWN CU GND IN 3/4"C. FOR FLOW METER
 TRANSMITTER AND RECEPTACLE FOR 120V POWER,
 (P300).
- PROVIDE AND INSTALL FLOW METER TRANSMITTER.
 REFER TO SPECIFICATIONS. PROVIDE 1/4" ALUMINUM PLATE FOR MOUNTING.
- PROVIDE AND INSTALL MANUFACTURER SUPPLIED SENSOR CABLES IN 1"C. TO FIELD SENSORS, (C100A).
- PROVIDE AND INSTALL 2/C-#16 SHIELDED (BELDEN 8719) IN 1"C. (4-20mA FLOW METER SIGNAL) TO DFS
- PROVIDE AND INSTALL 120V, 15A, SINGLE-POLE SWITCH IN WEATHERPROOF FS BOX AS 120V POWER DISCONNECTING MEANS. PROVIDE AND INSTALL SINGLE-GANG WEATHERPROOF SWITCH COVER. BELL #5121-0.

KEY NOTES:

- PROVIDE AND INSTALL DUPLEX GFCI RECEPTACLE,
 HUBBELL, GFR5352IA OR EQUAL. PROVIDE AND INSTALL
 SINGLE—GANG WEATHERPROOF GFCI COVER. BELL
- 9 PROVIDE AND INSTALL 2-#12 THWN CU + 1-#12 THWN CU GND IN 3/4"C. TO RECEPTACLE FOR 120V
- PROVIDE AND INSTALL 2-#12 THWN CU + 1-#12
 THWN CU GND IN 3/4" FLEXIBLE, SEALTITE CONDUIT
 TO FLOW METER TRANSMITTER FOR 120V POWER.
- PROVIDE AND INSTALL 2/C-#16 SHIELDED (BELDEN 8719) IN 3/4" FLEXIBLE, SEALTITE CONDUIT. (4-20mA FLOW METER SIGNAL).
- PROVIDE AND INSTALL EDCO SLAC SERIES AC POWER/SIGNAL TVSS DEVICE IN NEMA 4X ENCLOSURE TO PROTECT 120V POWER CIRCUIT AND 4—20mA ANALOG OUTPUT SIGNAL.
- PROVIDE AND INSTALL SUN—SHIELD, CONSTRUCTED FROM 1/8" ALUMINUM STOCK. PROVIDE FULL FILLET WELDS. 24" WIDE, 24" TALL.

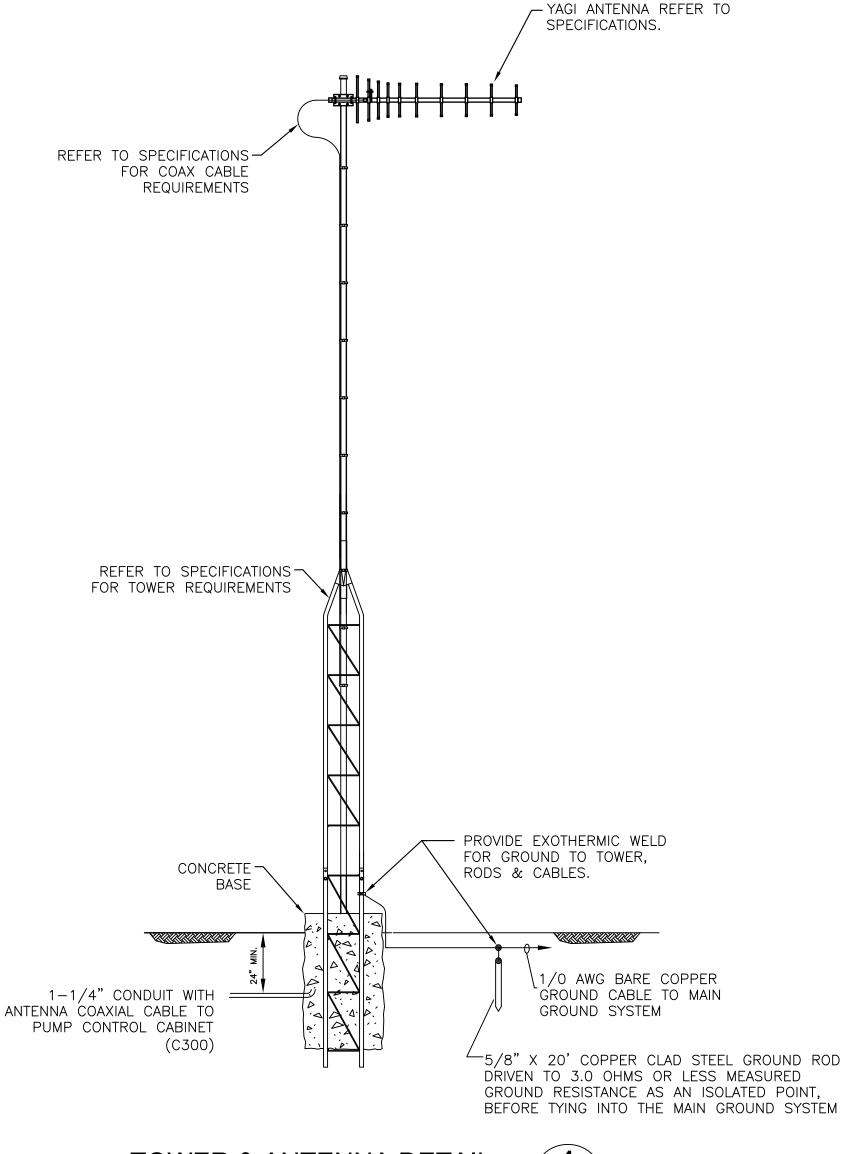




NOTES:

- 2. CONTRACTOR SHALL SUBMIT SHOP DRAWINGS FOR ANTENNA FOUNDATION. SHOP DRAWINGS SHALL BE SIGNED AND SEALED BY A PROFESSIONAL ENGINEER REGISTERED IN THE STATE OF FLORIDA.
- 3. CONTRACTOR TO PROVIDE RADIO SURVEY TO DETERMINE TOWER HEIGHT REQUIREMNT AND ANTENNA AIMING. REFER ALSO TO SPECIFICATIONS.

1. TOWER & FOUNDATION DESIGNED FOR 150 MPH WINDSPEED.

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COMMUNICATIONS RISER

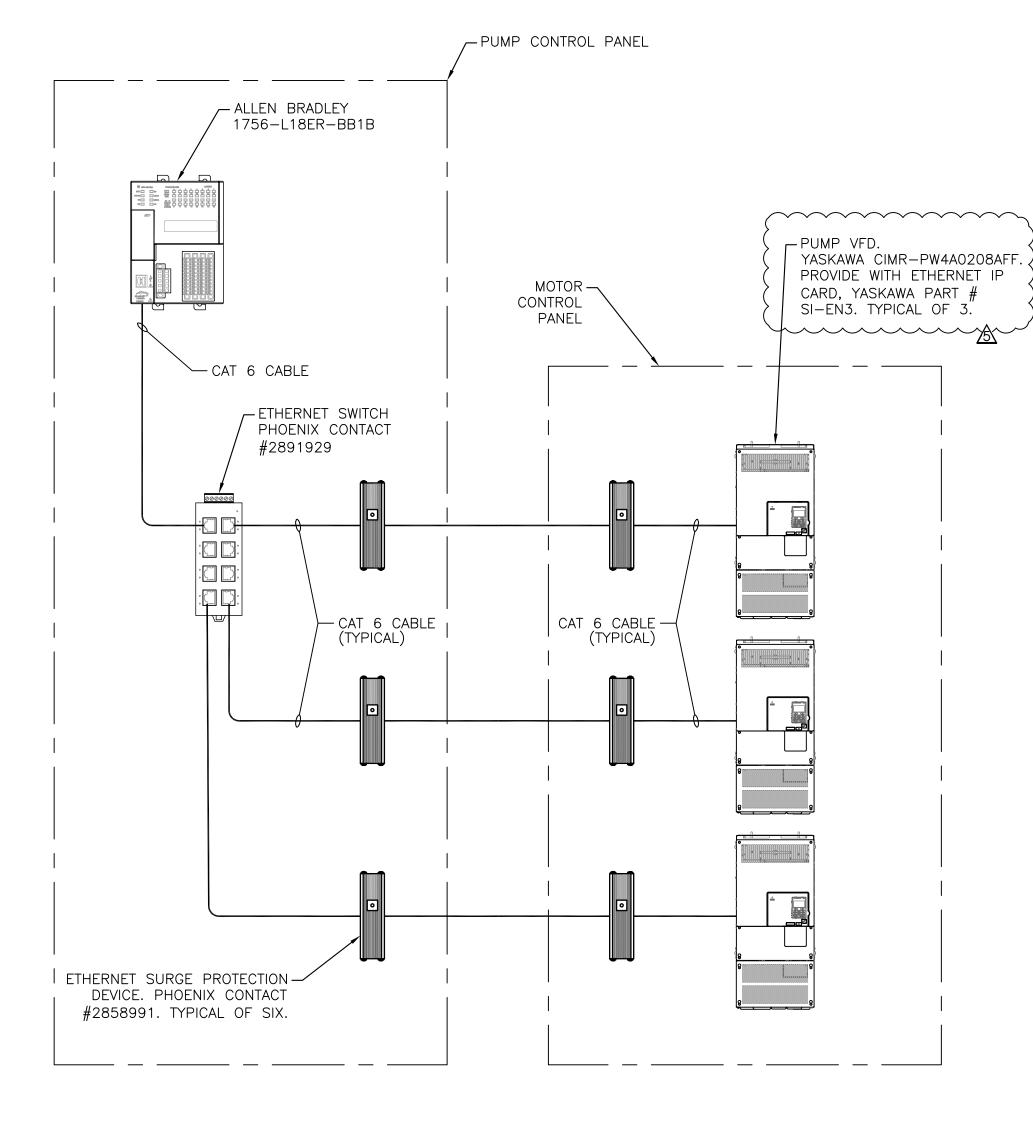

ADDENDUM #5 — PUMP MOTOR REVISIONS

REVISIONS

DATE BY

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KHA PROJECT
148400015

DATE
6/26/19

SCALE AS SHOWN
DESIGNED BY TDT

DRAWN BY JLH

HECKED BY

SEWRF RECLAIMED
PUMP BACK STATION

TIMOTHY THOMAS, P.E


FL LICENSE NUMBER
47079

FL DATE:

INSTRUMENTATION DETAILS

SHEET NUMBER

I-7

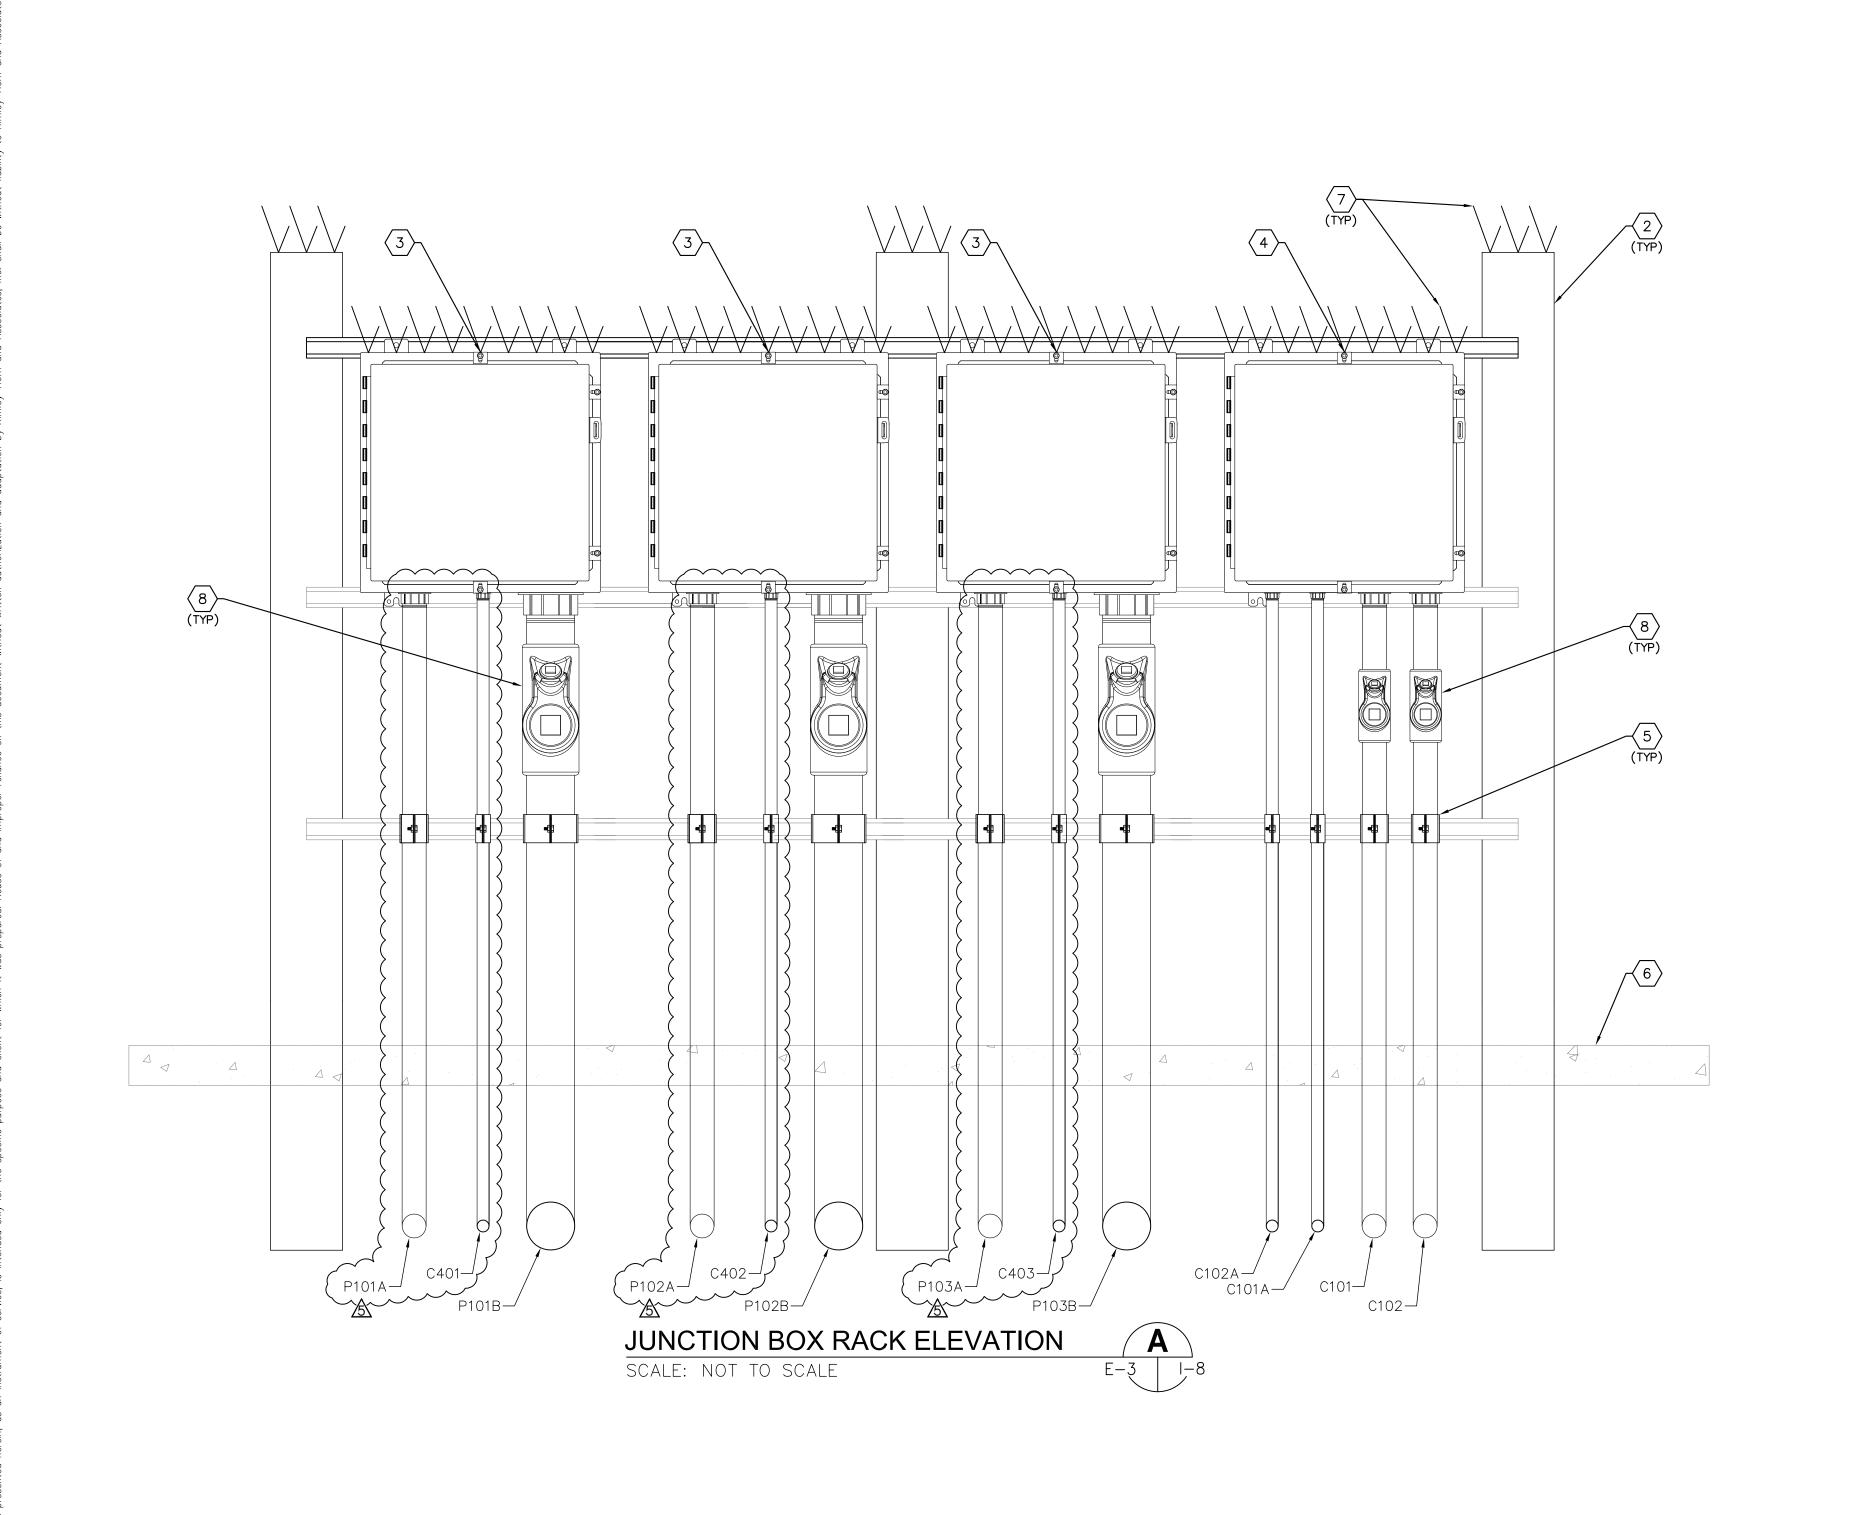

KEY NOTES:

- PROVIDE AND INSTALL 1-5/8" STAINLESS STEEL UNISTRUT (OR EQUAL). BOLTS TO SECURE UNISTRUT SHALL BE INSTALLED COMPLETELY THROUGH CONCRETE POST.
- PROVIDE AND INSTALL 6" X 6" CONCRETE POST. POST SHALL BE EMBEDDED A MINIMUM OF 3 FEET INTO CONCRETE SLAB/SOIL (TYP OF 3).
- PUMP MOTOR CONNECTIONS JUNCTION BOX USED AS A DEMARCATION BOX TO PROVIDE ISOLATION BETWEEN THE WET WELL AND MOTOR CONTROL CABINET.
 PROVIDE AND INSTALL A 24"x24"x12" NEMA 4X,
 STAINLESS STEEL JUNCTION BOX WITH HINGED DOOR,
 HAMMOND #1418N4S16j12. PROVIDE INNER PANEL.
 REFER TO SHEET I—9 FOR DETAILS. TYPICAL OF 3.
- WET WELL JUNCTION BOX USED AS A DEMARCATION BOX TO PROVIDE ISOLATION BETWEEN THE WET WELL AND PUMP CONTROL CABINET. PROVIDE AND INSTALL A 20"x20"x6" NEMA 4X, STAINLESS STEEL JUNCTION BOX WITH HINGED DOOR, HAMMOND #1418N4S16D6. PROVIDE INNER PANEL. REFER TO SHEET I—9 FOR DETAILS.
- 5 PROVIDE AND INSTALL ALUMINUM CONDUIT CLAMP.
- PROPOSED CONCRETE SLAB. REFER TO STRUCTURAL DRAWINGS.
- PROVIDE AND INSTALL STAINLESS STEEL BIRD SPIKES (FOR PIGEONS OR LARGER BIRDS) TO COVER TOP OF ENCLOSURE. INSTALL BIRD SPIKES WITH NON-SILICONE BASED ADHESIVE FOR OUTDOOR CONSTRUCTION OR PER MANUFACTURER'S SPECIFICATIONS.
- 8 PROVIDE AND INSTALL EYS SEAL. SIZE AS REQUIRED.

TRICOR
ENGINEERING

777 S. Harbour Island Blvd, STE 350, TAMPA, FL 33602
813 .227 .9190 FAX 813 . 227 . 9195
Certificate of Authorization No. 00031028

				6
\triangle	ADDENDUM #5 - PUMP MOTOR REVISIONS	5/26/20	TDT	
No.	REVISIONS	DATE	BY	

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TDT MANATEE COUNTY

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PUMP BACK STATION

LICENSED PROFESSIONAL

FL DATE:


FL LICENSE NUMBER
47079

TIMOTHY THOMAS, P.E

WET WELL JUNCTION BOX RACK DETAILS

SHEET NUMBER


I-8

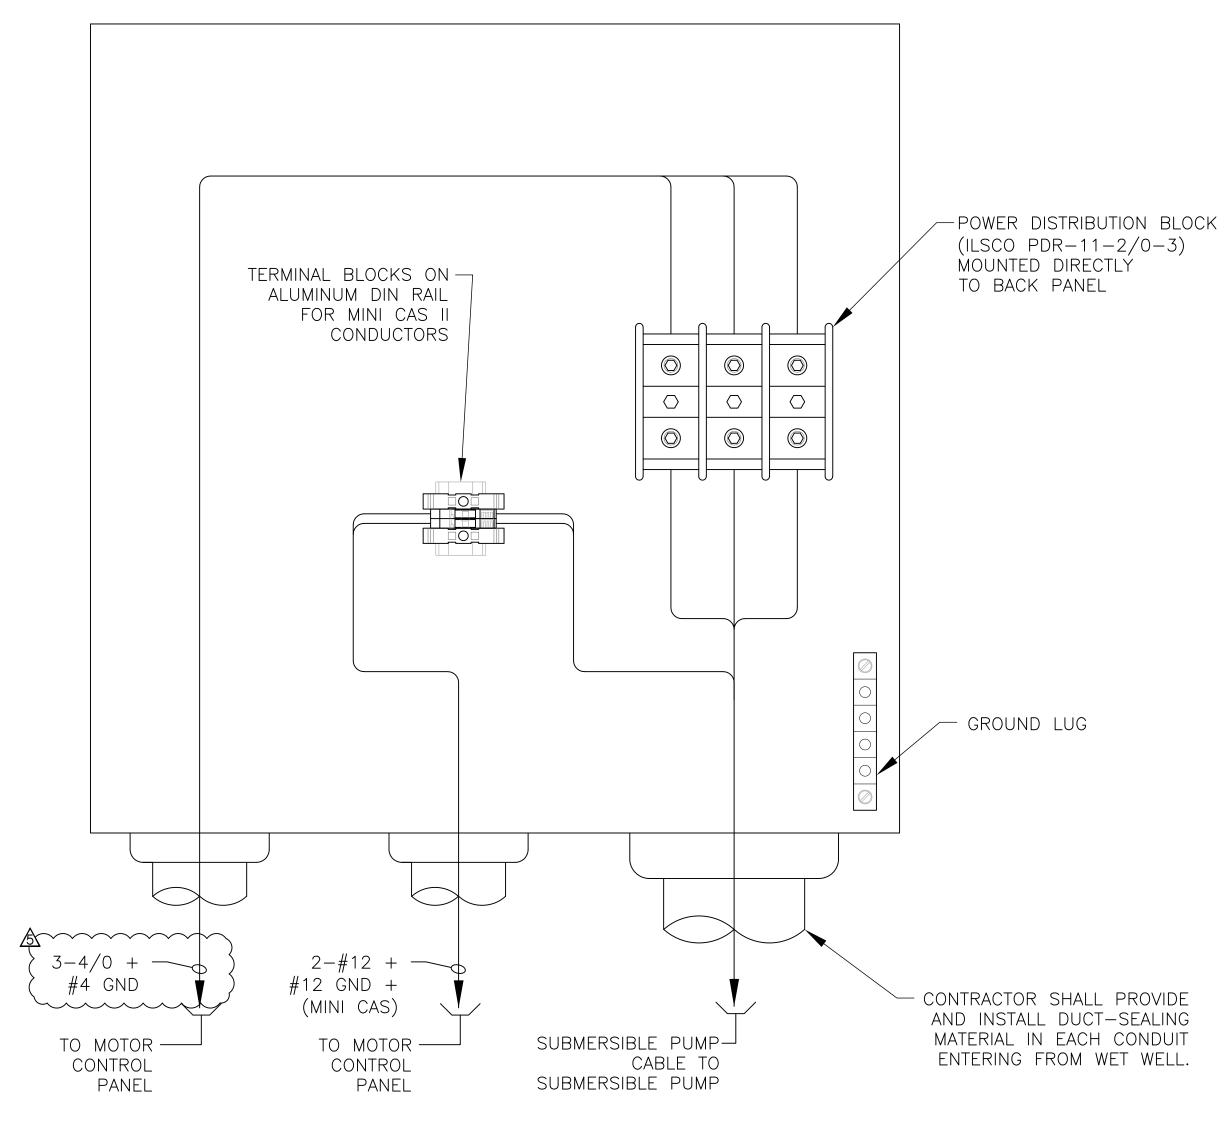



NOTES:

- 1. COVER NOT SHOWN FOR CLARITY
- 2. BOND GROUNDING CONDUCTORS TO ENCLOSURE BACK PANEL.

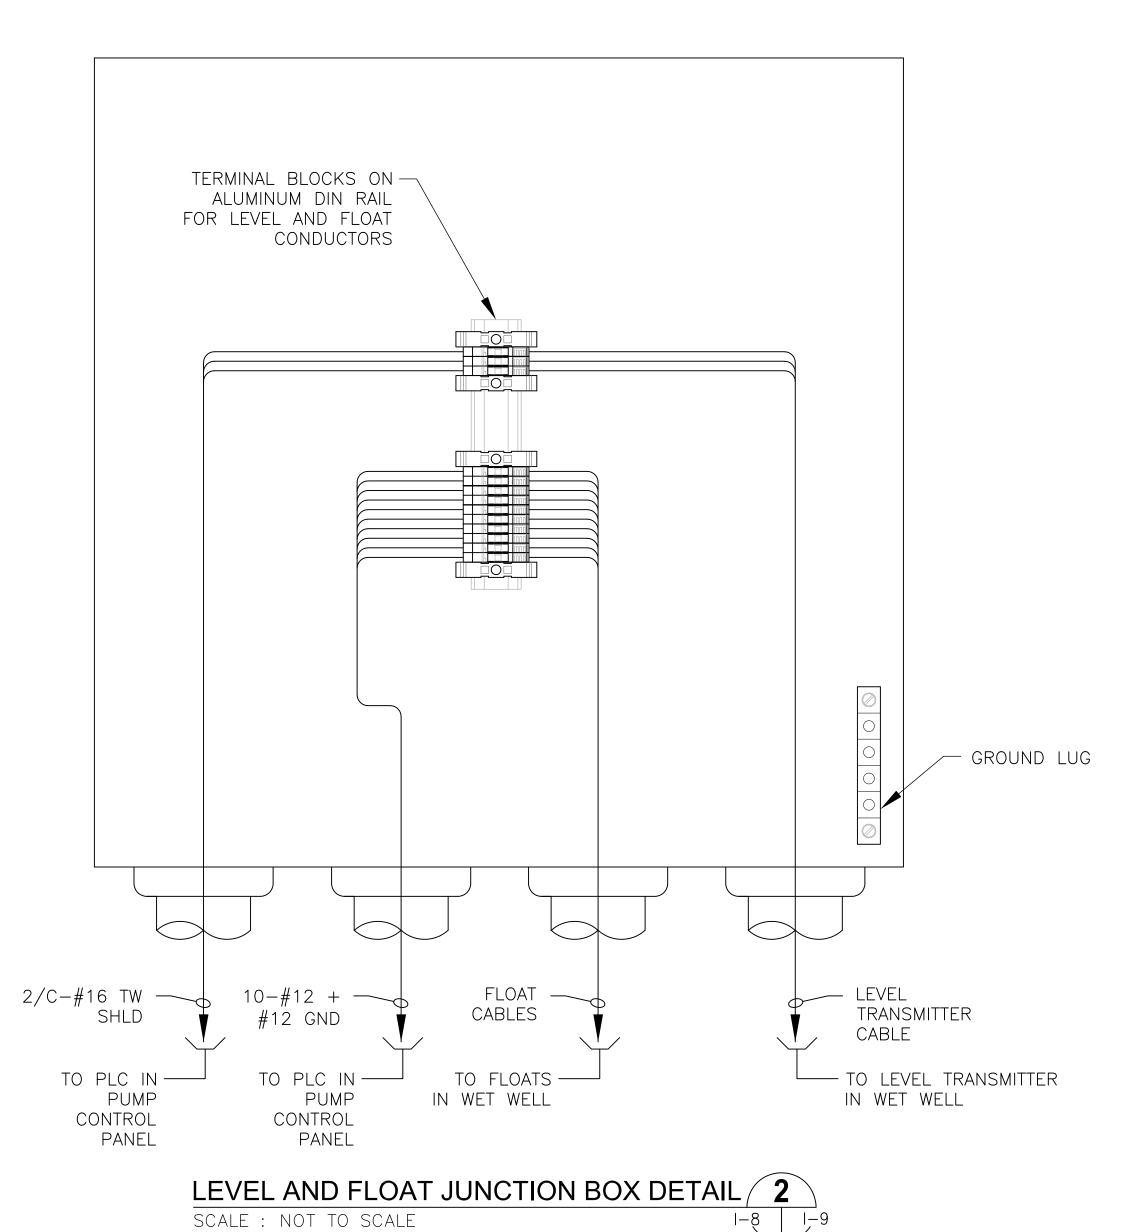

NOTES:

- 1. COVER NOT SHOWN FOR CLARITY
- 2. BOND GROUNDING CONDUCTORS TO ENCLOSURE BACK PANEL.



		Vimlow\\ Horn	KHA PROJECT 148400015	Manatee	LICENSED PROFESSIONAL		SHEET NUMBER
	NIIIIE MITTOLLI		DATE 6/26/19	County	TIMOTHY THOMAS, P.E	JUNCTION BOX	
		© 2018 KIMLEY—HORN AND ASSOCIATES, INC. 655 NORTH FRANKLIN STREET, SUITE 150, TAMPA, FL 33602	SCALE AS SHOWN DESIGNED BY TDT	SEWRF RECLAIMED	FL LICENSE NUMBER	DETAILS	I - 9
ADDENDUM #5 - PUMP MOTOR REVISIONS No. REVISIONS	5/26/20 TDT DATE BY	PHONE: 813-620-1460 WWW.KIMLEY-HORN.COM CA 00000696	DRAWN BY JLH CHECKED BY TDT	PUMP BACK STATION ANATEE COUNTY	47079 FL DATE:		