



EXAMPLE OF SECTION CUT AND DETAIL

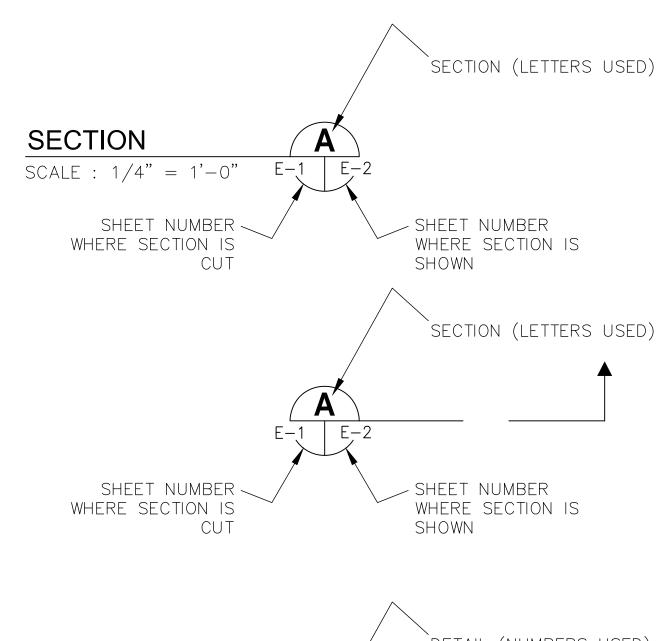

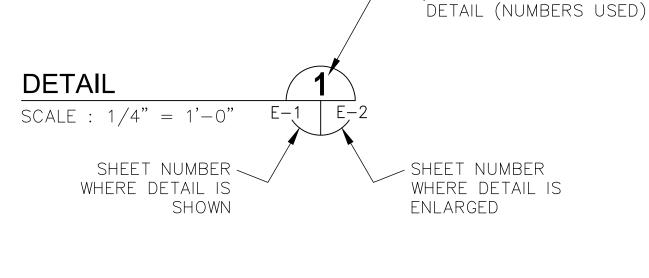

A AMPS AFF ABOVE FINISHED FLOOR AFG ABOVE FINISHED GRADE C CONDUIT DFS DATA FLOW SYSTEMS DIA DIAMETER EX EXISTING ELEC ELECTRICAL GFI GROUND FAULT INTERRUPTER GND GROUNDING CONDUCTOR HP HORSEPOWER HZ HERTZ	ABBREVIATIONS:
KVA KILOVOLT AMPERES KW KILOWATTS MAX MAXIMUM MIN MINIMUM N/A NOT APPLICABLE PH PHASE PLC PROGRAMMABLE LOGIC CONTROLLER RECP RECEPTACLE RPM REVOLUTIONS PER MINUTE RTU REMOTE TERMINAL UNIT SPD SURGE PROTECTION DEVICE SS STAINLESS STEEL TYP TYPICAL V VOLTS VFD VARIABLE FREQUENCY DRIVE WP WEATHERPROOF XFMR TRANSFORMER	AFF ABOVE FINISHED FLOOR AFG ABOVE FINISHED GRADE C CONDUIT DFS DATA FLOW SYSTEMS DIA DIAMETER EX EXISTING ELEC ELECTRICAL GFI GROUND FAULT INTERRUPTER GND GROUNDING CONDUCTOR HP HORSEPOWER HZ HERTZ IG ISOLATED GROUND KVA KILOVOLT AMPERES KW KILOWATTS MAX MAXIMUM MIN MINIMUM N/A NOT APPLICABLE PH PHASE PLC PROGRAMMABLE LOGIC CONTROLLER RECP RECEPTACLE RPM REVOLUTIONS PER MINUTE RTU REMOTE TERMINAL UNIT SPD SURGE PROTECTION DEVICE SS STAINLESS STEEL TYP TYPICAL V VOLTS VFD VARIABLE FREQUENCY DRIVE WP WEATHERPROOF



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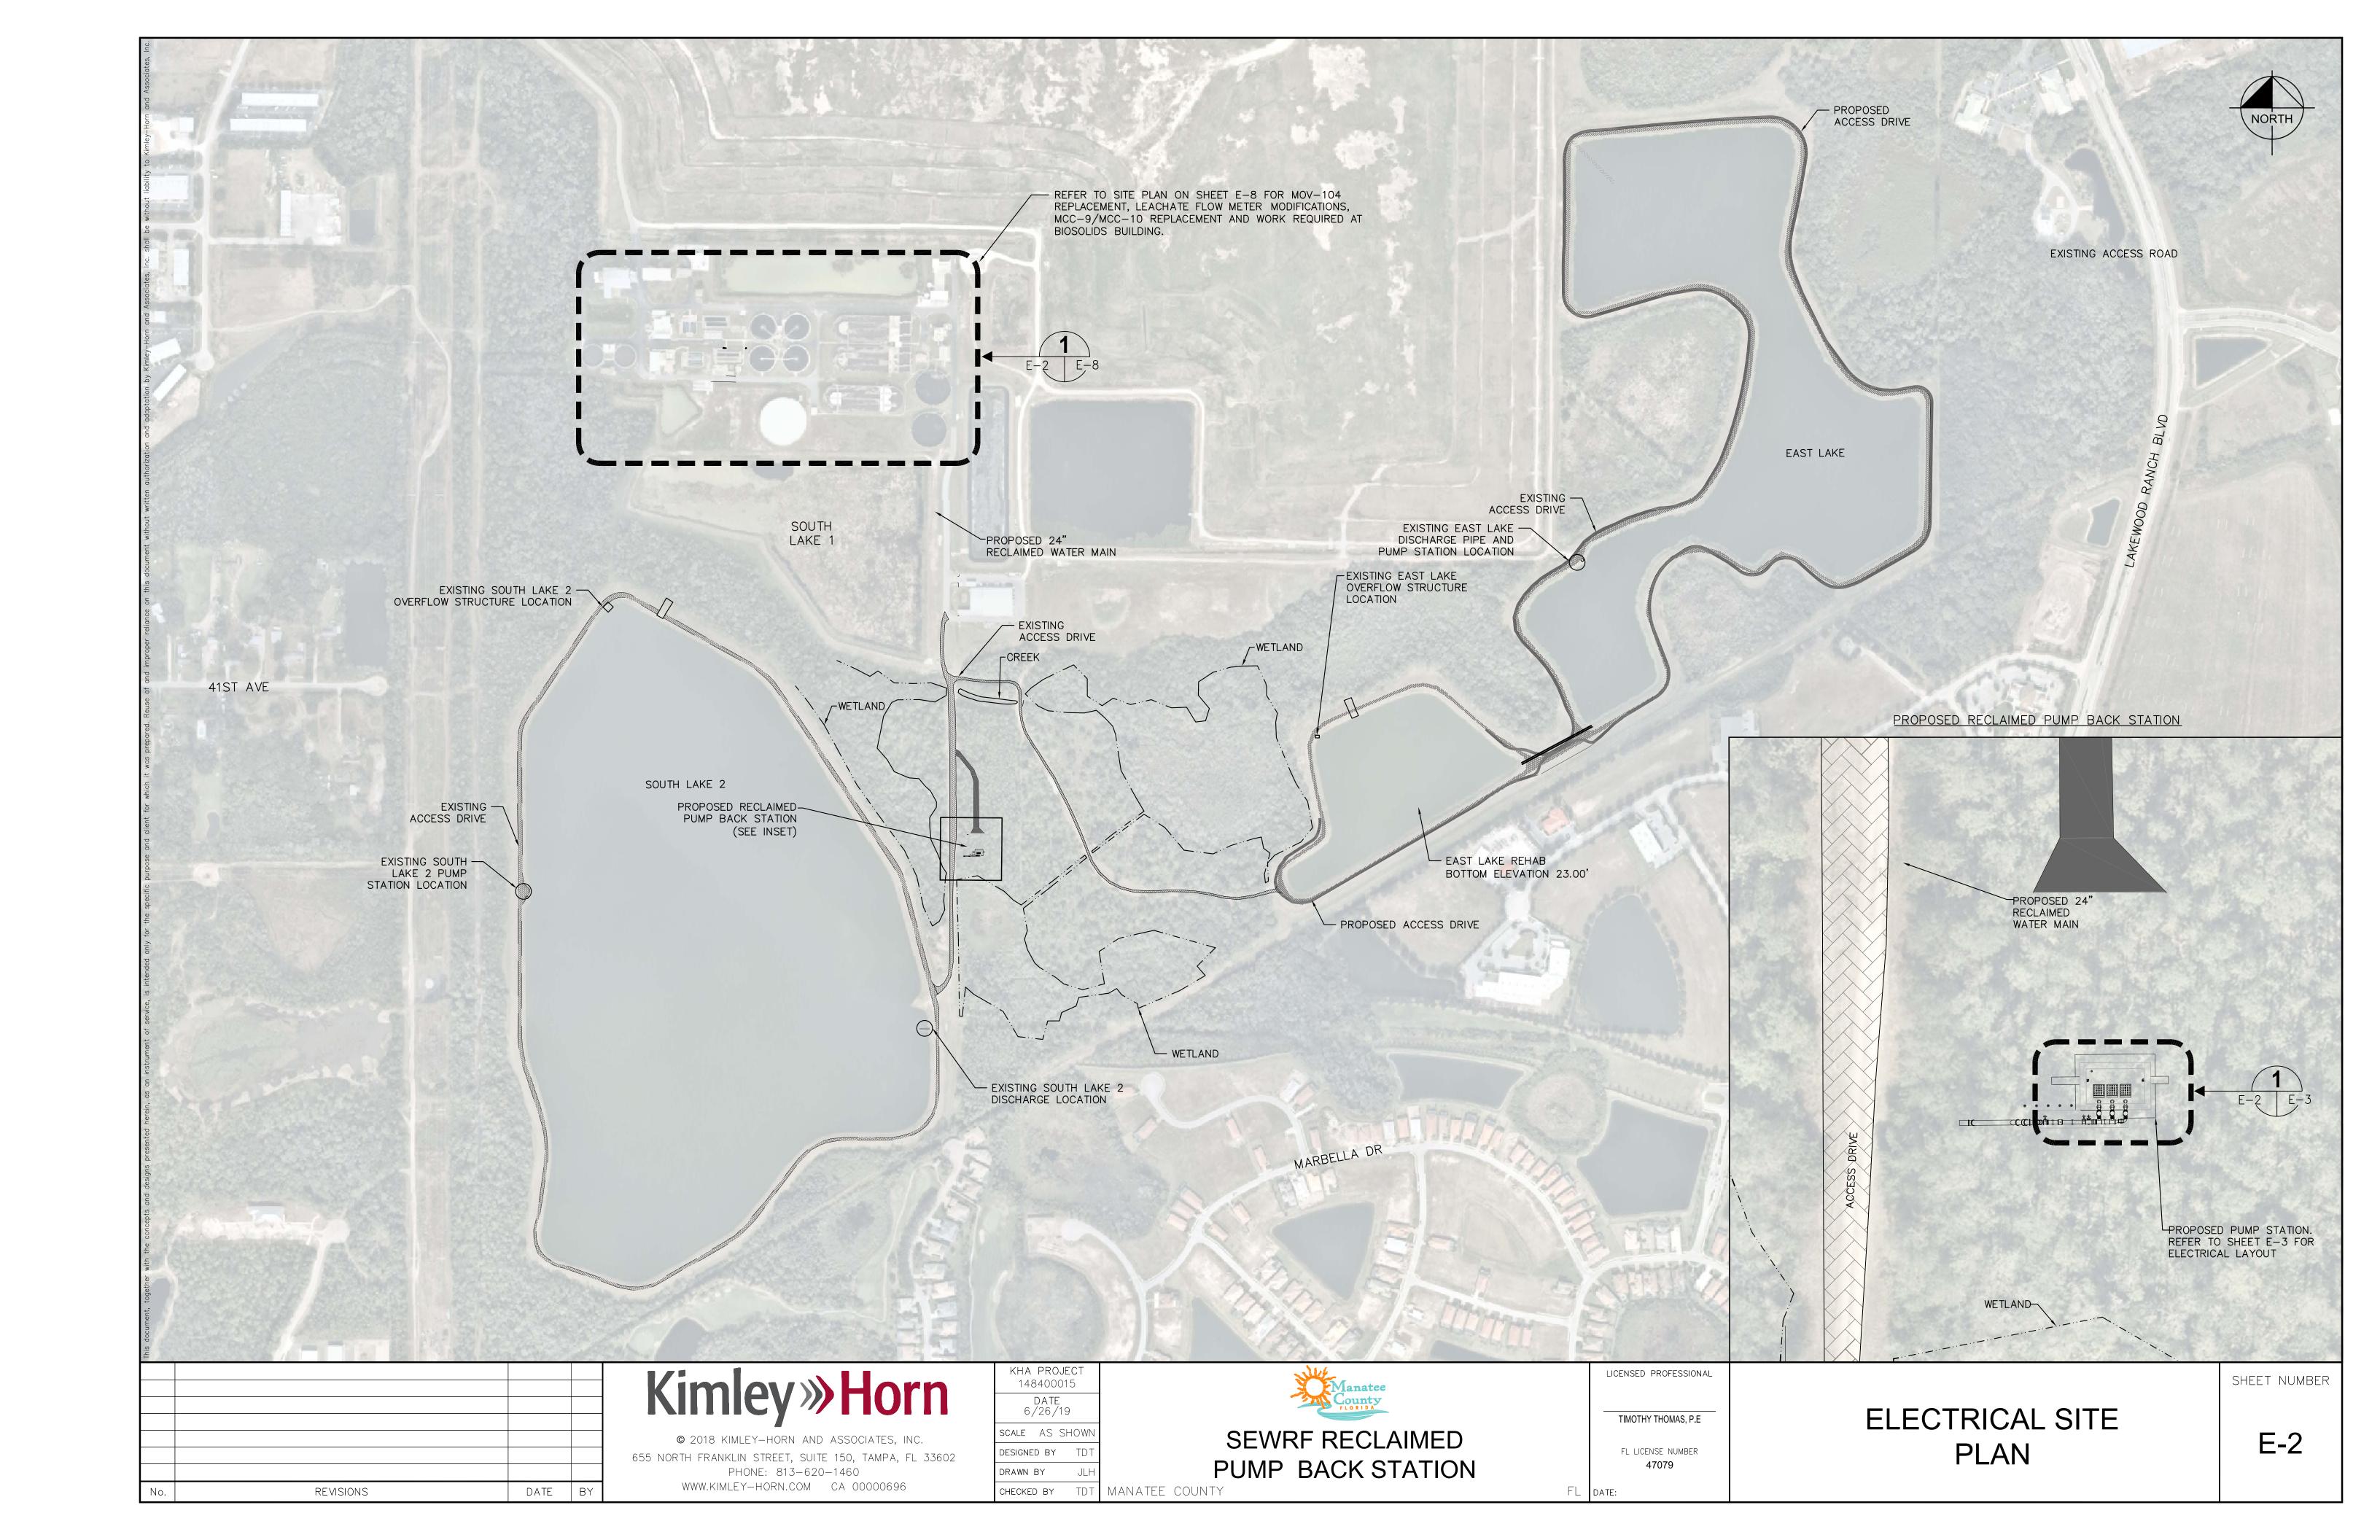
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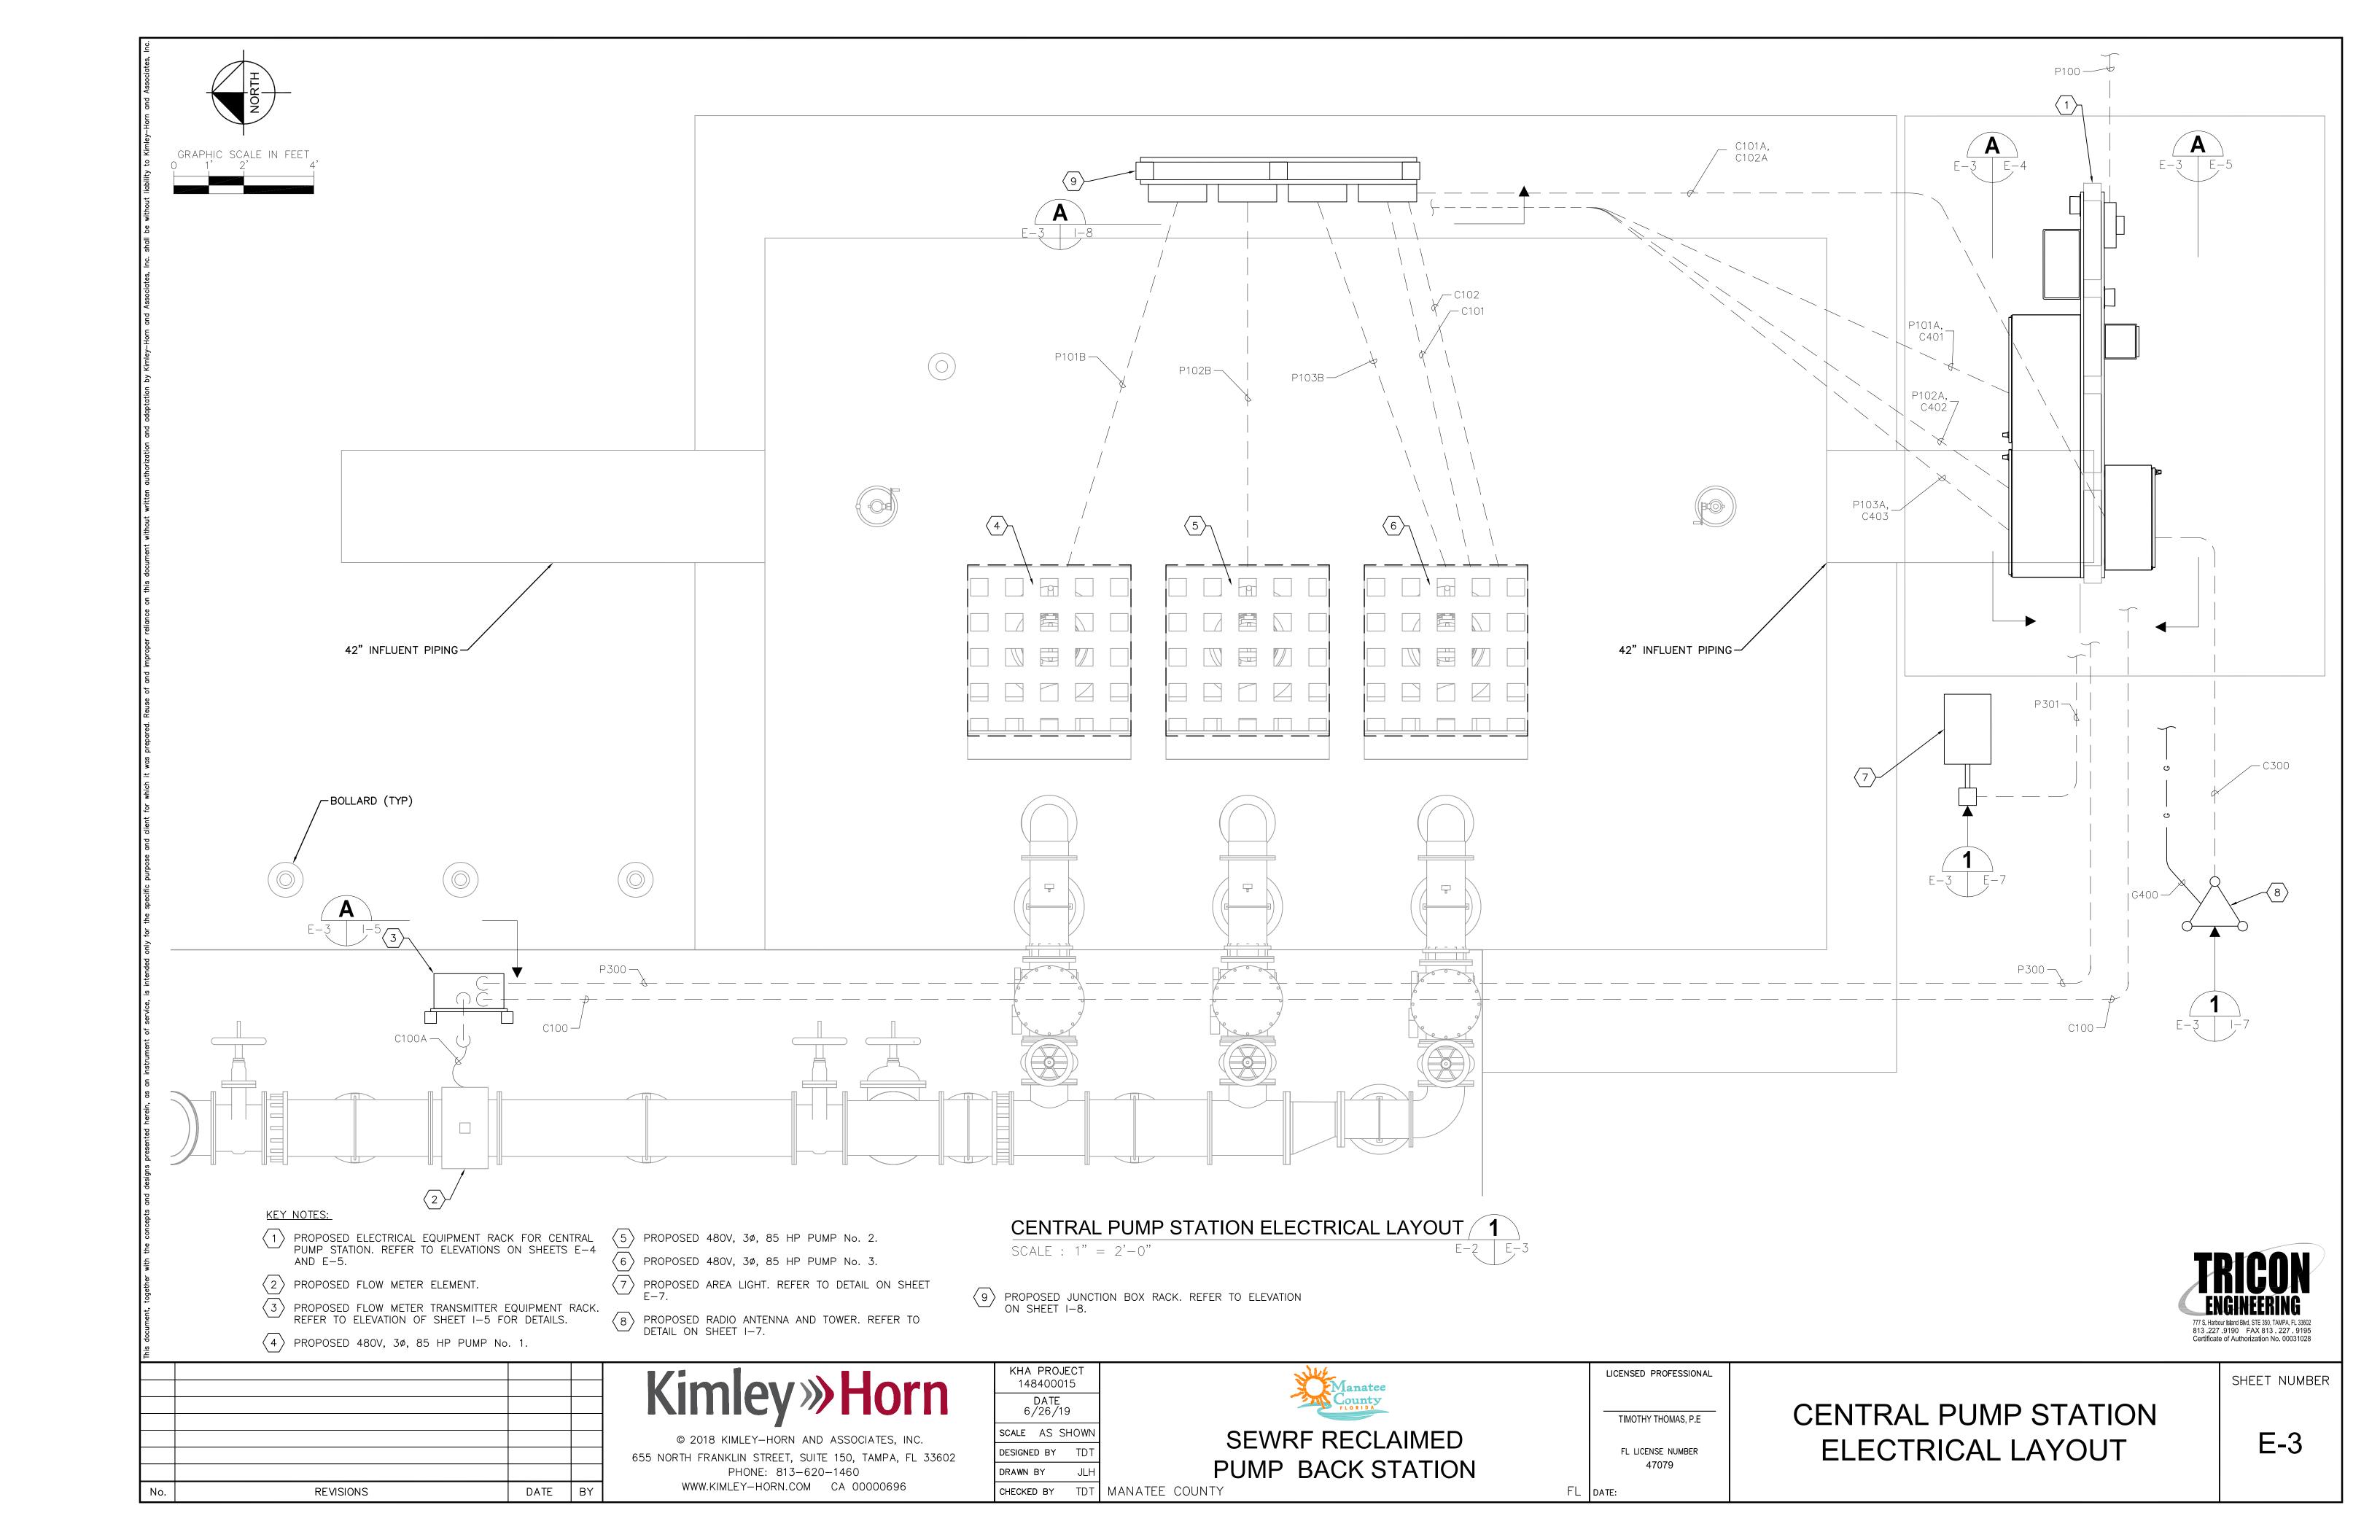
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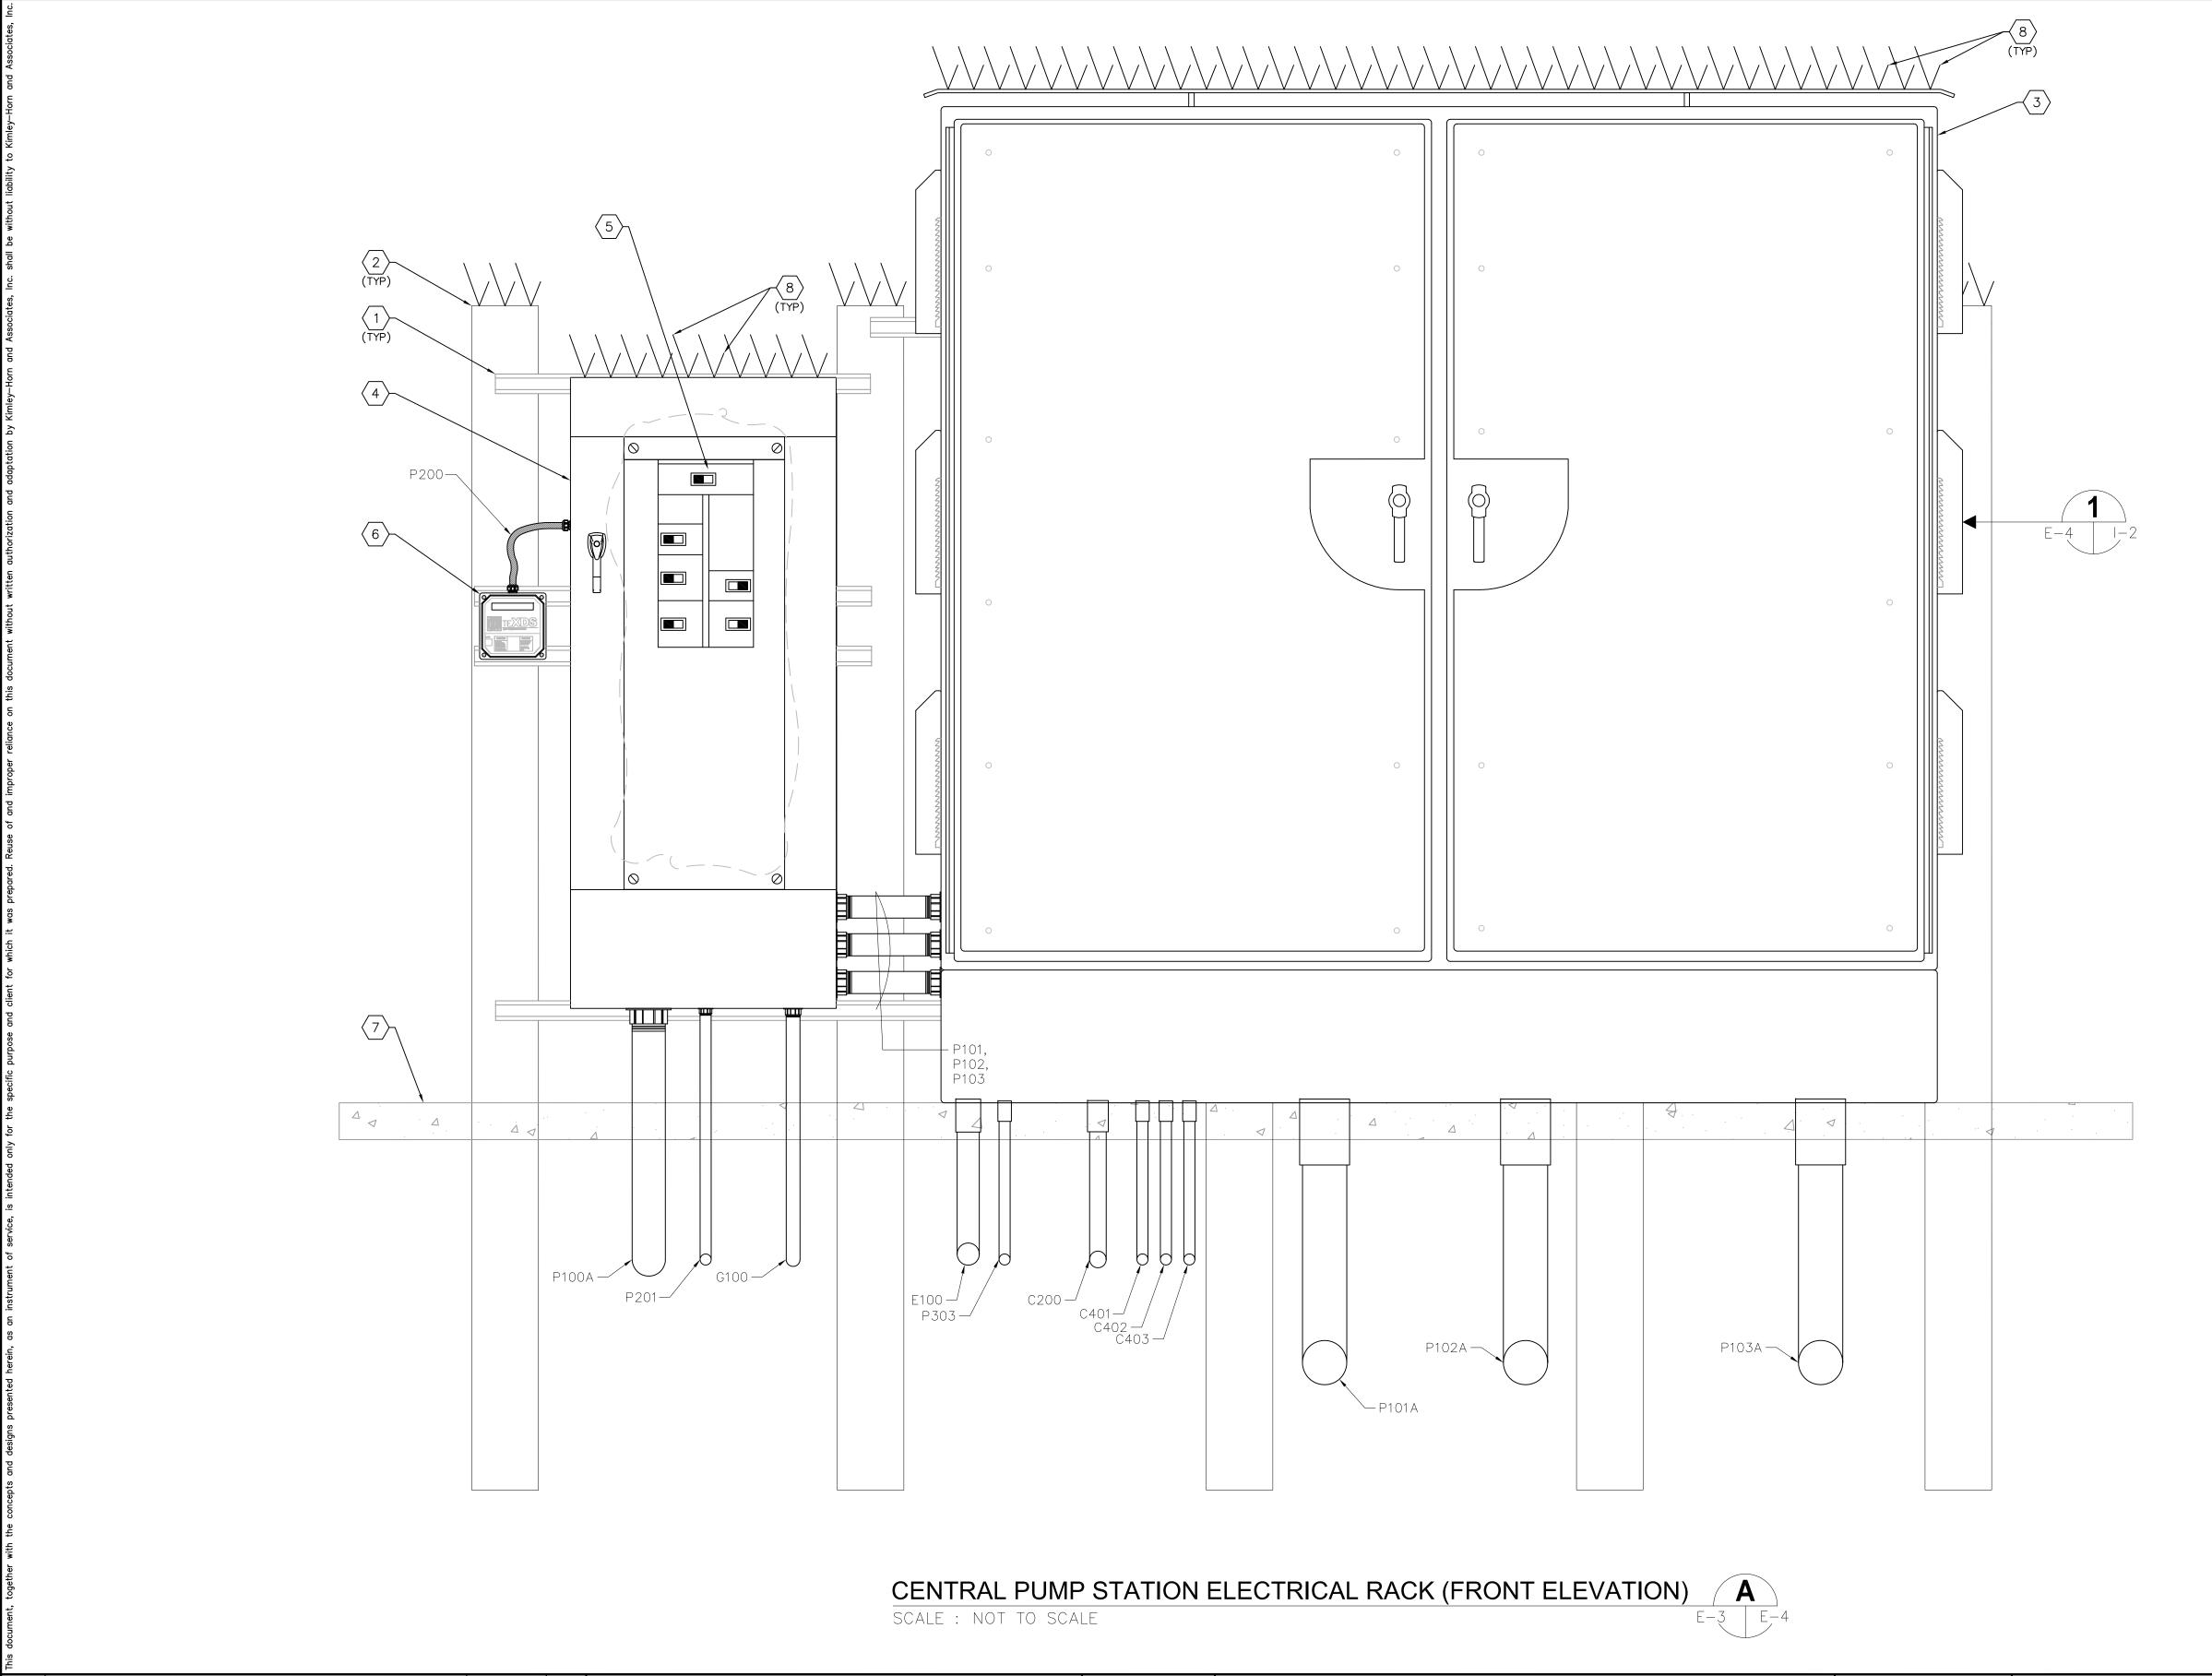
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ELECTRICAL LEGEND AND ABBREVIATIONS

SHEET NUMBER







- 1 PROVIDE AND INSTALL 1-5/8" STAINLESS STEEL UNISTRUT (OR EQUAL). BOLTS TO SECURE UNISTRUT SHALL BE INSTALLED COMPLETELY THROUGH CONCRETE POST.
- PROVIDE AND INSTALL 6" X 6" CONCRETE POST. POST SHALL BE EMBEDDED A MINIMUM OF 3 FEET INTO CONCRETE SLAB/SOIL.
- PROVIDE AND INSTALL MOTOR CONTROL CABINET. REFER TO SHEET I-2 FOR DETAILS.
- PROVIDE AND INSTALL 600V, 400A, 3Ø, 4—WIRE MAIN DISTRIBUTION PANELBOARD 'MDP' WITH 400A MAIN CIRCUIT BREAKER (EATON PRL4 PANELBOARD WITH EATON CHKD3400FT38W MAIN CIRCUIT BREAKER). PROVIDE IN NEMA 3R STAINLESS STEEL ENCLOSURE. PROVIDE MAINTENANCE MODE SWITCH IN DOOR OF PANELBOARD FOR MAIN CIRCUIT BREAKER MAINTENANCE MODE SELECTION.
- INTERIOR VIEW OF MAIN DISTRIBUTION PANELBOARD 'MDP'. PROVIDE MAIN CIRCUIT BREAK AS INDICATED IN KEYED NOTE #4). PROVIDE THREE (3) 3-POLE, 600V, 200A CIRCUIT BREAKERS (ONE FOR EACH VFD), ONE (1) 3-POLE, 600V, 30A CIRCUIT BREAKER FOR MDP SURGE PROTECTION DEVICE AND ONE (1) 2-POLE, 600V, 20A CIRCUIT BREAKER FOR MINI-POWER ZONE FEEDER
- PROVIDE AND INSTALL SURGE PROTECTION DEVICE (SPD). 480V, 3-PHASE, 4-WIRE WITH GROUND. ASCO CAT# 430277YP20ACJ10. PROVIDE AND INSTALL 3-#10 + 1-#10 NEUTRAL +1-#10 GND IN 3/4" NON-METALLIC, WEATHERPROOF FLEXIBLE CONDUIT TO MAIN DISTRIBUTION PANELBOARD 'MDP'.
- PROPOSED CONCRETE SLAB. REFER TO STRUCTURAL DRAWINGS.
- PROVIDE AND INSTALL STAINLESS STEEL BIRD SPIKES (FOR PIGEONS OR LARGER BIRDS) TO COVER TOP OF ENCLOSURE. INSTALL BIRD SPIKES WITH NON-SILICONE BASED ADHESIVE FOR OUTDOOR CONSTRUCTION OR PER MANUFACTURER'S SPECIFICATIONS.



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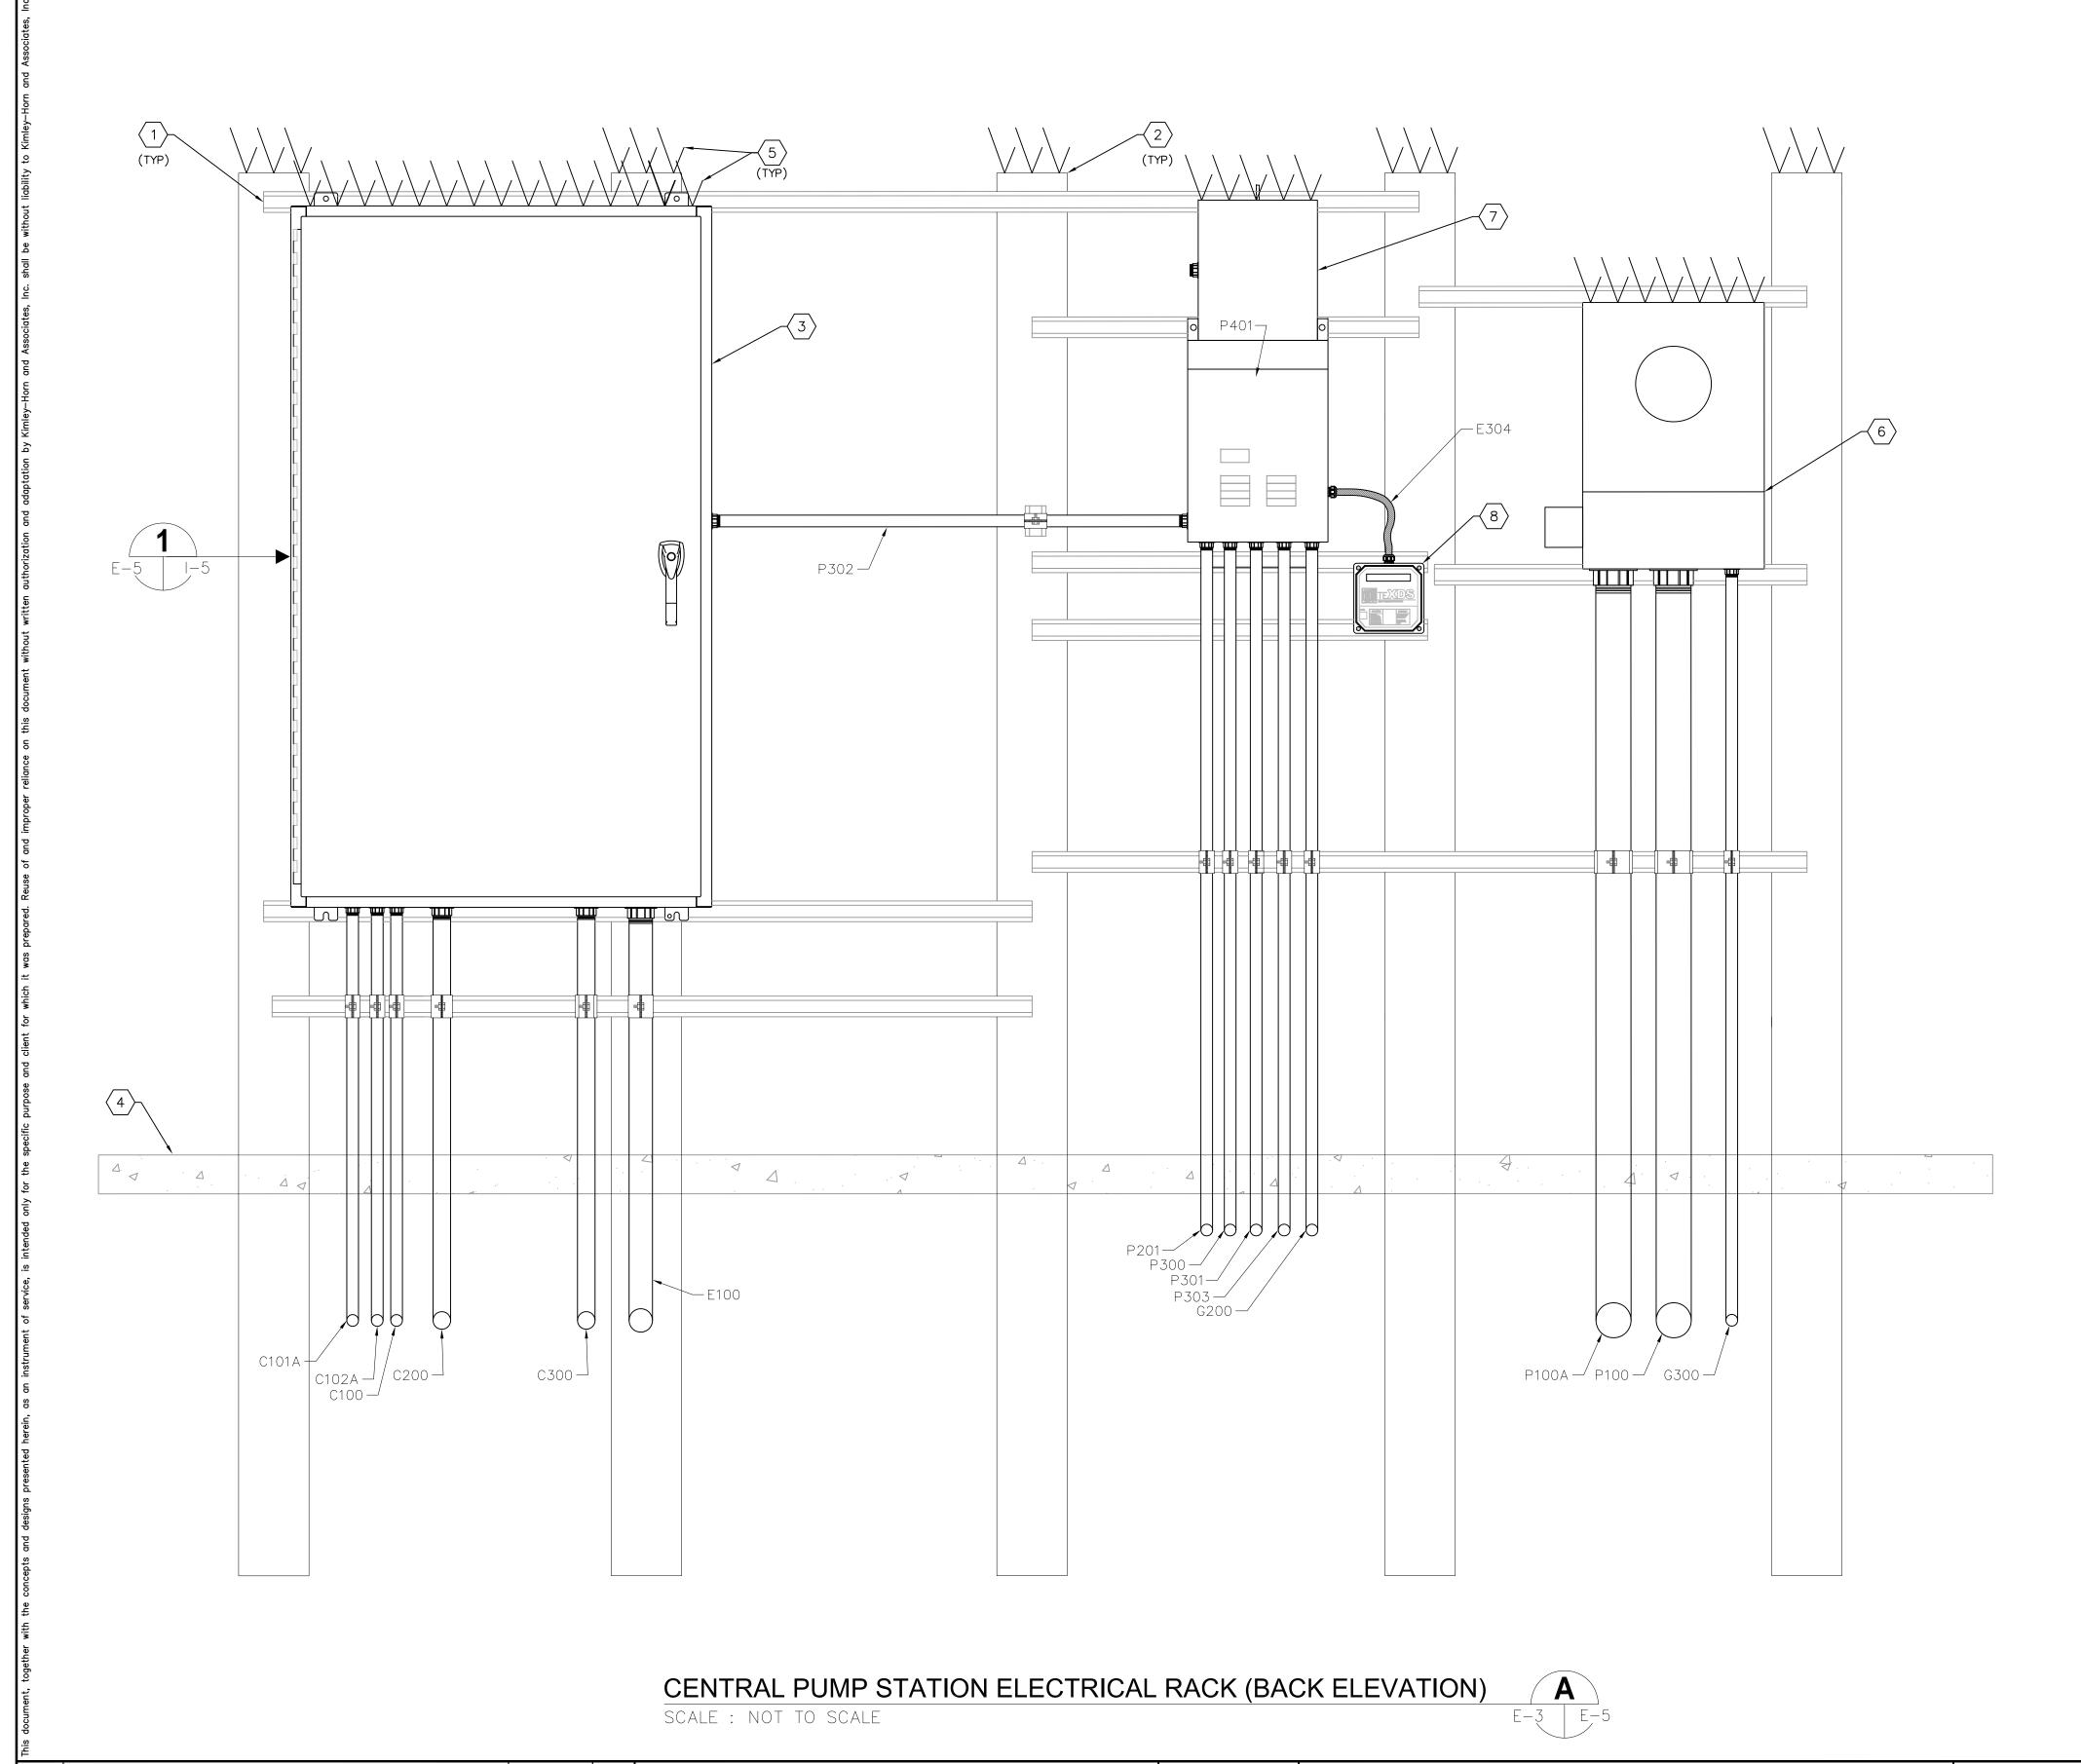
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CENTRAL PUMP STATION
ELECTRICAL EQUIPMENT
RACK LAYOUTS

SHEET NUMBER



- PROVIDE AND INSTALL 1-5/8" STAINLESS STEEL
 UNISTRUT (OR EQUAL). BOLTS TO SECURE UNISTRUT
 SHALL BE INSTALLED COMPLETELY THROUGH CONCRETE
- PROVIDE AND INSTALL 6" X 6" CONCRETE POST. POST SHALL BE EMBEDDED A MINIMUM OF 3 FEET INTO CONCRETE SLAB/SOIL.
- PROVIDE AND INSTALL PUMP CONTROL PANEL. REFER TO SPECIFICATIONS AND DETAILS ON SHEET I-5.
- PROPOSED CONCRETE SLAB. REFER TO STRUCTURAL DRAWINGS.
- PROVIDE AND INSTALL STAINLESS STEEL BIRD SPIKES (FOR PIGEONS OR LARGER BIRDS) TO COVER TOP OF ENCLOSURE. INSTALL BIRD SPIKES WITH NON-SILICONE BASED ADHESIVE FOR OUTDOOR CONSTRUCTION OR PER MANUFACTURER'S SPECIFICATIONS.
- PROVIDE AND INSTALL 277/480V, 400A, 3-PHASE, 4-WIRE, METER SOCKET. PROVIDE FP&L APPROVED LIGHTNING SURGE PROTECTOR. GROUND METER PER FP&L REQUIREMENTS. COORDINATE ALL REQUIREMENTS WITH FP&L. CONTRACTOR TO VERIFY FEED-THRU VERSUS C.T. METER WITH FP&L.
- PROVIDE AND INSTALL NEW 480-120/240V, 10, 10KVA MINI POWER ZONE 'LP' IN NEMA 3R, 316 STAINLESS STEEL ENCLOSURE. SQUARE-D MPZ10S40FSS. REFER TO SHEET E-7 FOR PANEL SCHEDULE.
- PROVIDE AND INSTALL SURGE PROTECTION DEVICE (SPD). 120/240V, SINGLE-PHASE, 3-WIRE WITH GROUND. ASCO CAT# 430120SP10ACJ10. PROVIDE AND INSTALL 2-#10 + 1-#10 NEUTRAL +1-#10 GND IN 3/4" NON-METALLLIC, WEATHERPROOF FLEXIBLE CONDUIT TO MINI POWER ZONE 'LP'.



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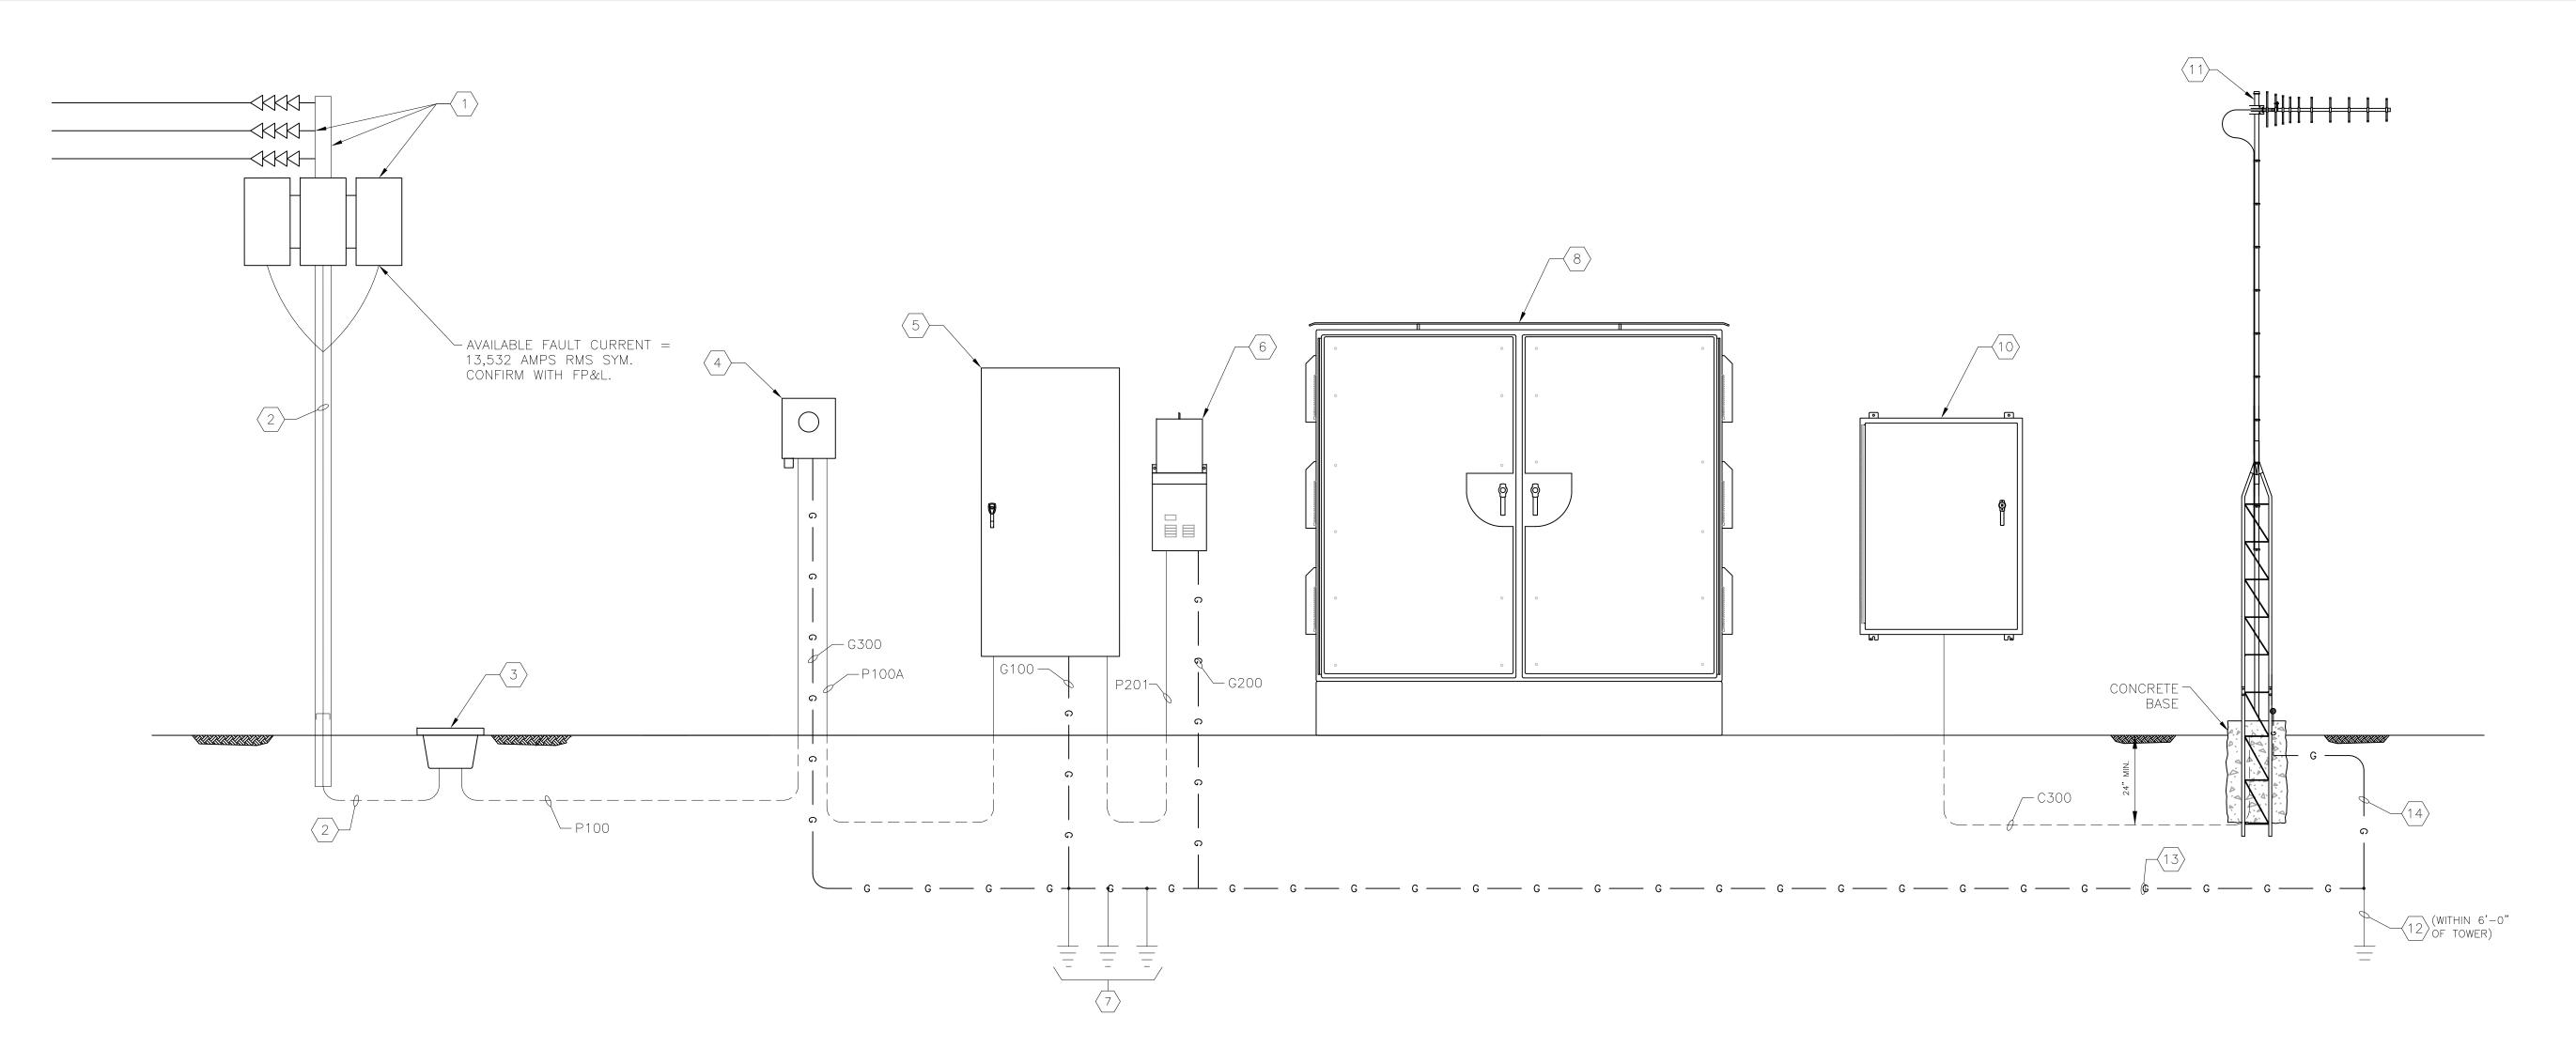
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ELECTRICAL EQUIPMENT
RACK LAYOUTS

SHEET NUMBER



CENTRAL PUMP STATION ELECTRICAL ONE-LINE DIAGRAM

KEYED NOTES:

- NEW 15KV DISTRIBUTION POLE, DISTRIBUTION TRANSFORMERS AND 15KV OVERHEAD DISTRIBUTION BY FP&L.
- (2) CONDUIT AND CONDUCTORS BY FP&L.
- (3) PROVIDE AND INSTALL NEW HANDHOLE. COORDINATE REQUIREMENTS WITH FP&L.
- PROVIDE AND INSTALL METER SOCKET. COORDINATE MOUNTING, SURGE PROTECTION AND GROUNDING REQUIREMENTS WITH FP&L.
- PROVIDE AND INSTALL 600V, 400A, 3Ø, 4-WIRE MAIN DISTRIBUTION PANELBOARD 'MDP' WITH 400A MAIN CIRCUIT BREAKER IN NEMA 3R STAINLESS STEEL ENCLOSURE.
- 6 480-120/240V, 10, 10KVA MINI POWER ZONE 'LP' IN NEMA 3R, 316 STAINLESS STEEL ENCLOSURE. SQUARE-D MPZ10S40FSS.
- PROVIDE AND INSTALL THREE (3) 5/8" X 20'-0" COPPER CLAD GROUND RODS. SPACE GROUND RODS A MINIMUM OF 10'-0" APART. BOND GROUND RODS TOGETHER WITH 2/0 BARE COPPER GROUNDING ELECTRODE CONDUCTORS. ALL CONNECTIONS SHALL BE VIA EXOTHERMIC WELDS.
- $\langle 8 \rangle$ MOTOR CONTROL CABINET. REFER TO SHEET I-2 FOR DETAILS.
- 10 PUMP CONTROL PANEL. REFER TO SHEET I-5 FOR DETAILS.
- $\left\langle 11\right\rangle$ NEW RADIO ANTENNA AND ASSOCIATED TOWER.
- PROVIDE AND INSTALL ONE (1) 5/8" X 20'-0" COPPER CLAD GROUND ROD ADJACENT TO RADIO
- PROVIDE AND INSTALL BARE 1/0 AWG COPPER GROUNDING ELECTRODE CONDUCTOR IN 1" CONDUIT FROM RADIO TOWER TO GROUNDING ELECTRODE GRID (REFER TO KEYED NOTE #7). G400.

GENERAL NOTES:

- 1. NOT ALL CONDUITS AND CONDUCTORS SHOWN FOR CLARITY. REFER ALSO TO OTHER ELECTRICAL SHEETS.
- 2. TOWER & FOUNDATION SHALL BE DESIGNED FOR 130 MPH WINDSPEED.
- 3. CONTRACTOR SHALL SUBMIT SHOP DRAWINGS FOR TOWER AND TOWER FOUNDATION. SHOP DRAWINGS SHALL BE SIGNED AND SEALED BY A PROFESSIONAL ENGINEER REGISTERED IN THE STATE OF FLORIDA.
- 4. ALL GROUNDING ELECTRODE CONDUCTOR CONNECTIONS MADE OUTSIDE OF EQUIPMENT SHALL BE VIA EXOTHERMIC WELDS.



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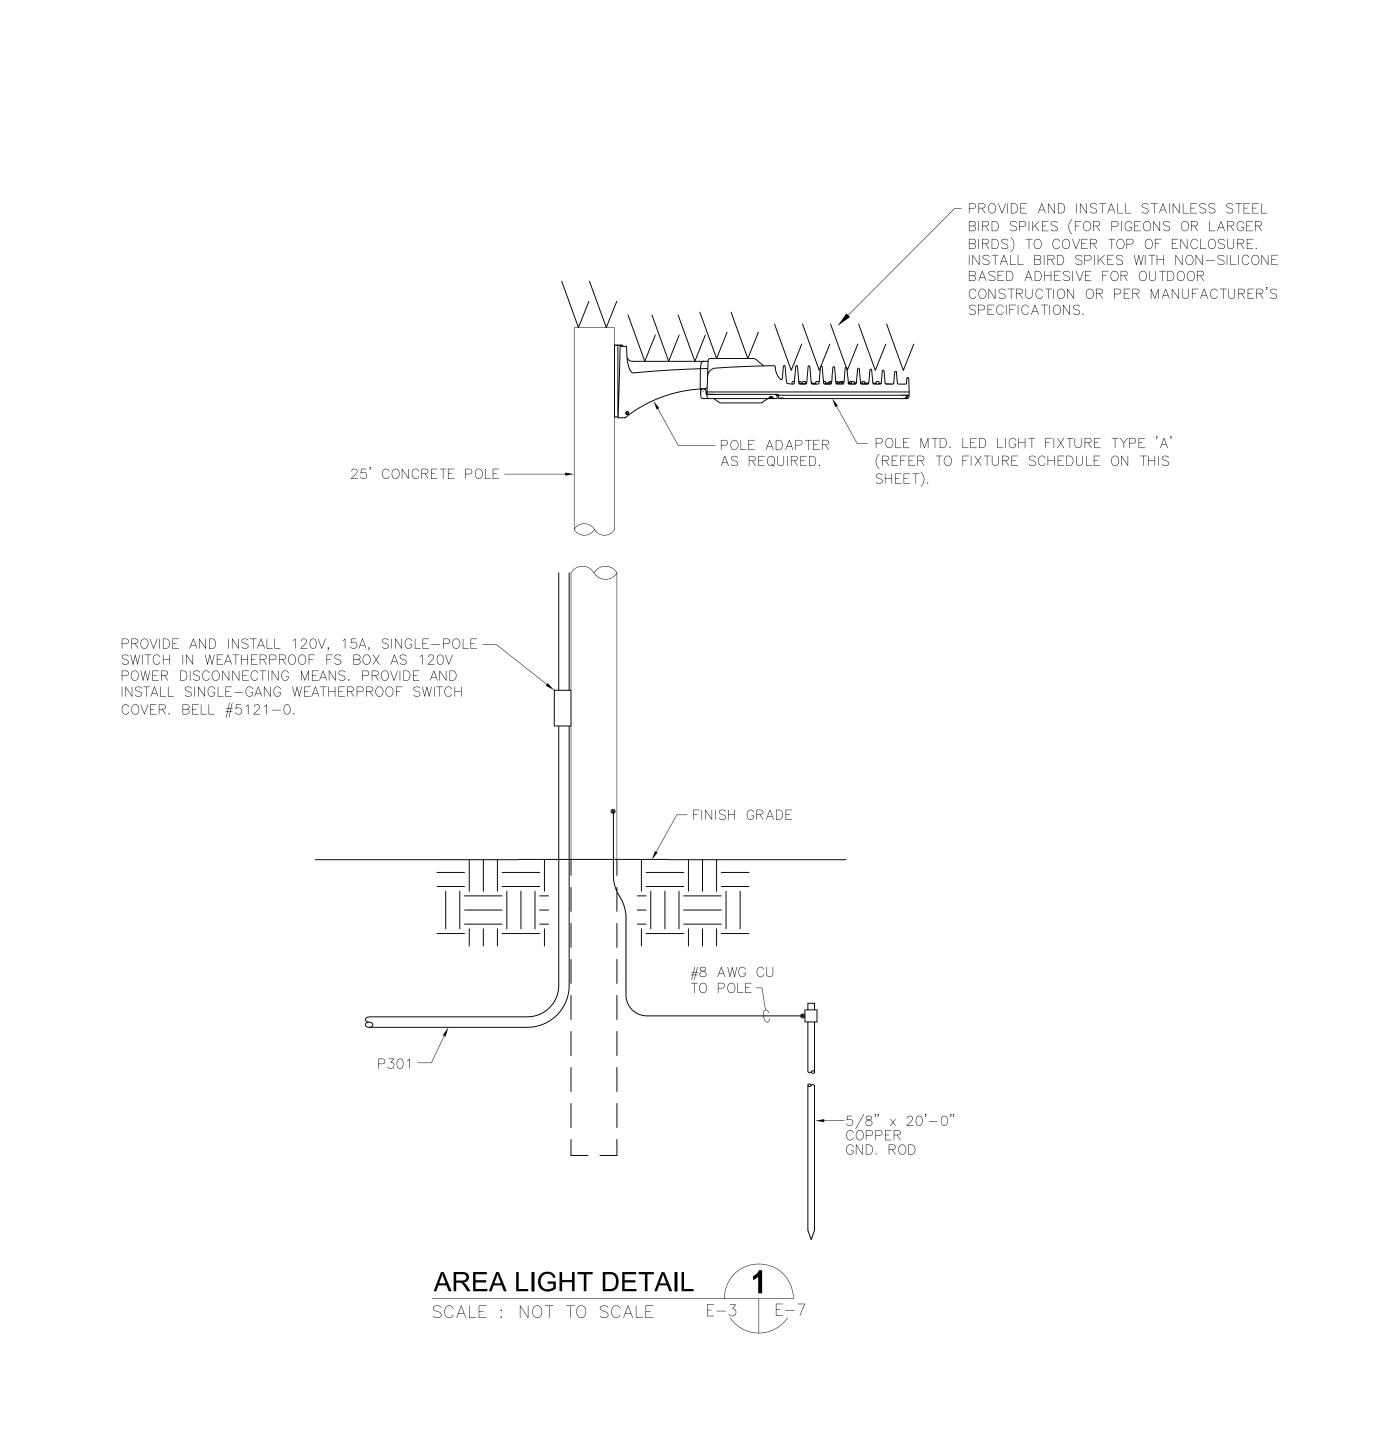
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CENTRAL PUMP STATION
ELECTRICAL
ONE-LINE DIAGRAM

SHEET NUMBER



<u>ELEC</u>	TRICAL SERV	/ICE LOAD	SUMMAR	Y					
480 VAC, 3Ø, 4W									
LOAD	CONNECTED	<u>DEMAND</u>	<u>APPRO</u> L1	X. PHASE CU L2	<u>JRRENTS</u> <u>L3</u>				
PUMP No. 1	109.0 A	109.0 A		109.0 A					
PUMP No. 2	109.0 A	109.0 A	109.0 A	109.0 A	109.0 A				
PUMP No. 3	109.0 A	109.0 A	109.0 A	109.0 A	109.0 A				
MINI POWER ZONE 'LP'	21.0 A	10.0 A	21.0 A	21.0 A	0.0 A				
TOTAL CONNECTED LOAD	348.0 A	337.0 A	348.0 A	348.0 A	327.0 A				
THE NEW ELECTRICAL SERVICE WILL CONSIST OF A 480V, 400 AMPERE FEEDER PROTECTED BY A 400A MAIN CIRCUIT BREAKER.									

MAIN DISTRIBUTION PANELBOARD 'MDP' CIRCUIT BREAKER SCHEDULE									
BREAKER	POLES AMPERAGE VOLTAGE AIC			AIC RATING	SERVICE				
А	3P	200A	600V	35K	PUMP No. 1 VFD				
В	3P	200A	600V	35K	PUMP No. 2 VFD				
С	3P	200A	600V	35K	PUMP No. 3 VFD				
D	2P	20A	600V	35K	MINI POWER ZONE 'LP'				
E	3P	30A	600V	35K	SURGE PROTECTION DEVICE (SPD)				

PANEL 'LP'; SQUARE D CO. ; 120/240 VOLTS, 10, 3W; SURFACE ENCLOSU CIRCUIT BREAKER; 10K AIC RATING; TOP AT 5'-6" AFF													
FOLUDIMENT SERVED		JIT BRE			PHASE	CIRC.	CIRC.		PHASE	CIRC	:UIT BR	EAKER	EQUIPMENT SERVED
EQUIPMENT SERVED		AMPS	FRAME	А	В	NO.	NO.	А	В	POLE	AMPS	FRAME	EQUIPIVIENT SERVED
PUMP CONTROL PANEL	1	20	QOB	0.8		1	2		0.2	1	20	QOB	AREA LIGHT
PUMP CONTROL PANEL	1	20	QOB		0.8	3	4	0.2		1	20	QOB	MOTOR CONTROL CABINET
MOTOR CONTROL CABINET	1	20	QOB	0.4		5	6		0.2	1	20	QOB	MOTOR CONTROL CABINET
SURGE PROTECTION DEVICE (SPD)	2	30	QOB			7	8	0.2		1	20	QOB	MOTOR CONTROL CABINET
"	_	_	_			9	10		0.2	1	20	QOB	FLOW METER TRANSMITTER
SUB-TOTAL KVA					0.8			0.4	0.6				

LIGH	LIGHTING FIXTURE SCHEDULE									
TYPE	MANUFACTURER	CATALOG NUMBER	LAMP(S)	VOLTS	MOUNTING	REMARKS				
А	GENERAL ELECTRIC	EASC0E2F550ADKBZ	(1) 119 W LED	120/277	POLE	LED AREA LIGHT				



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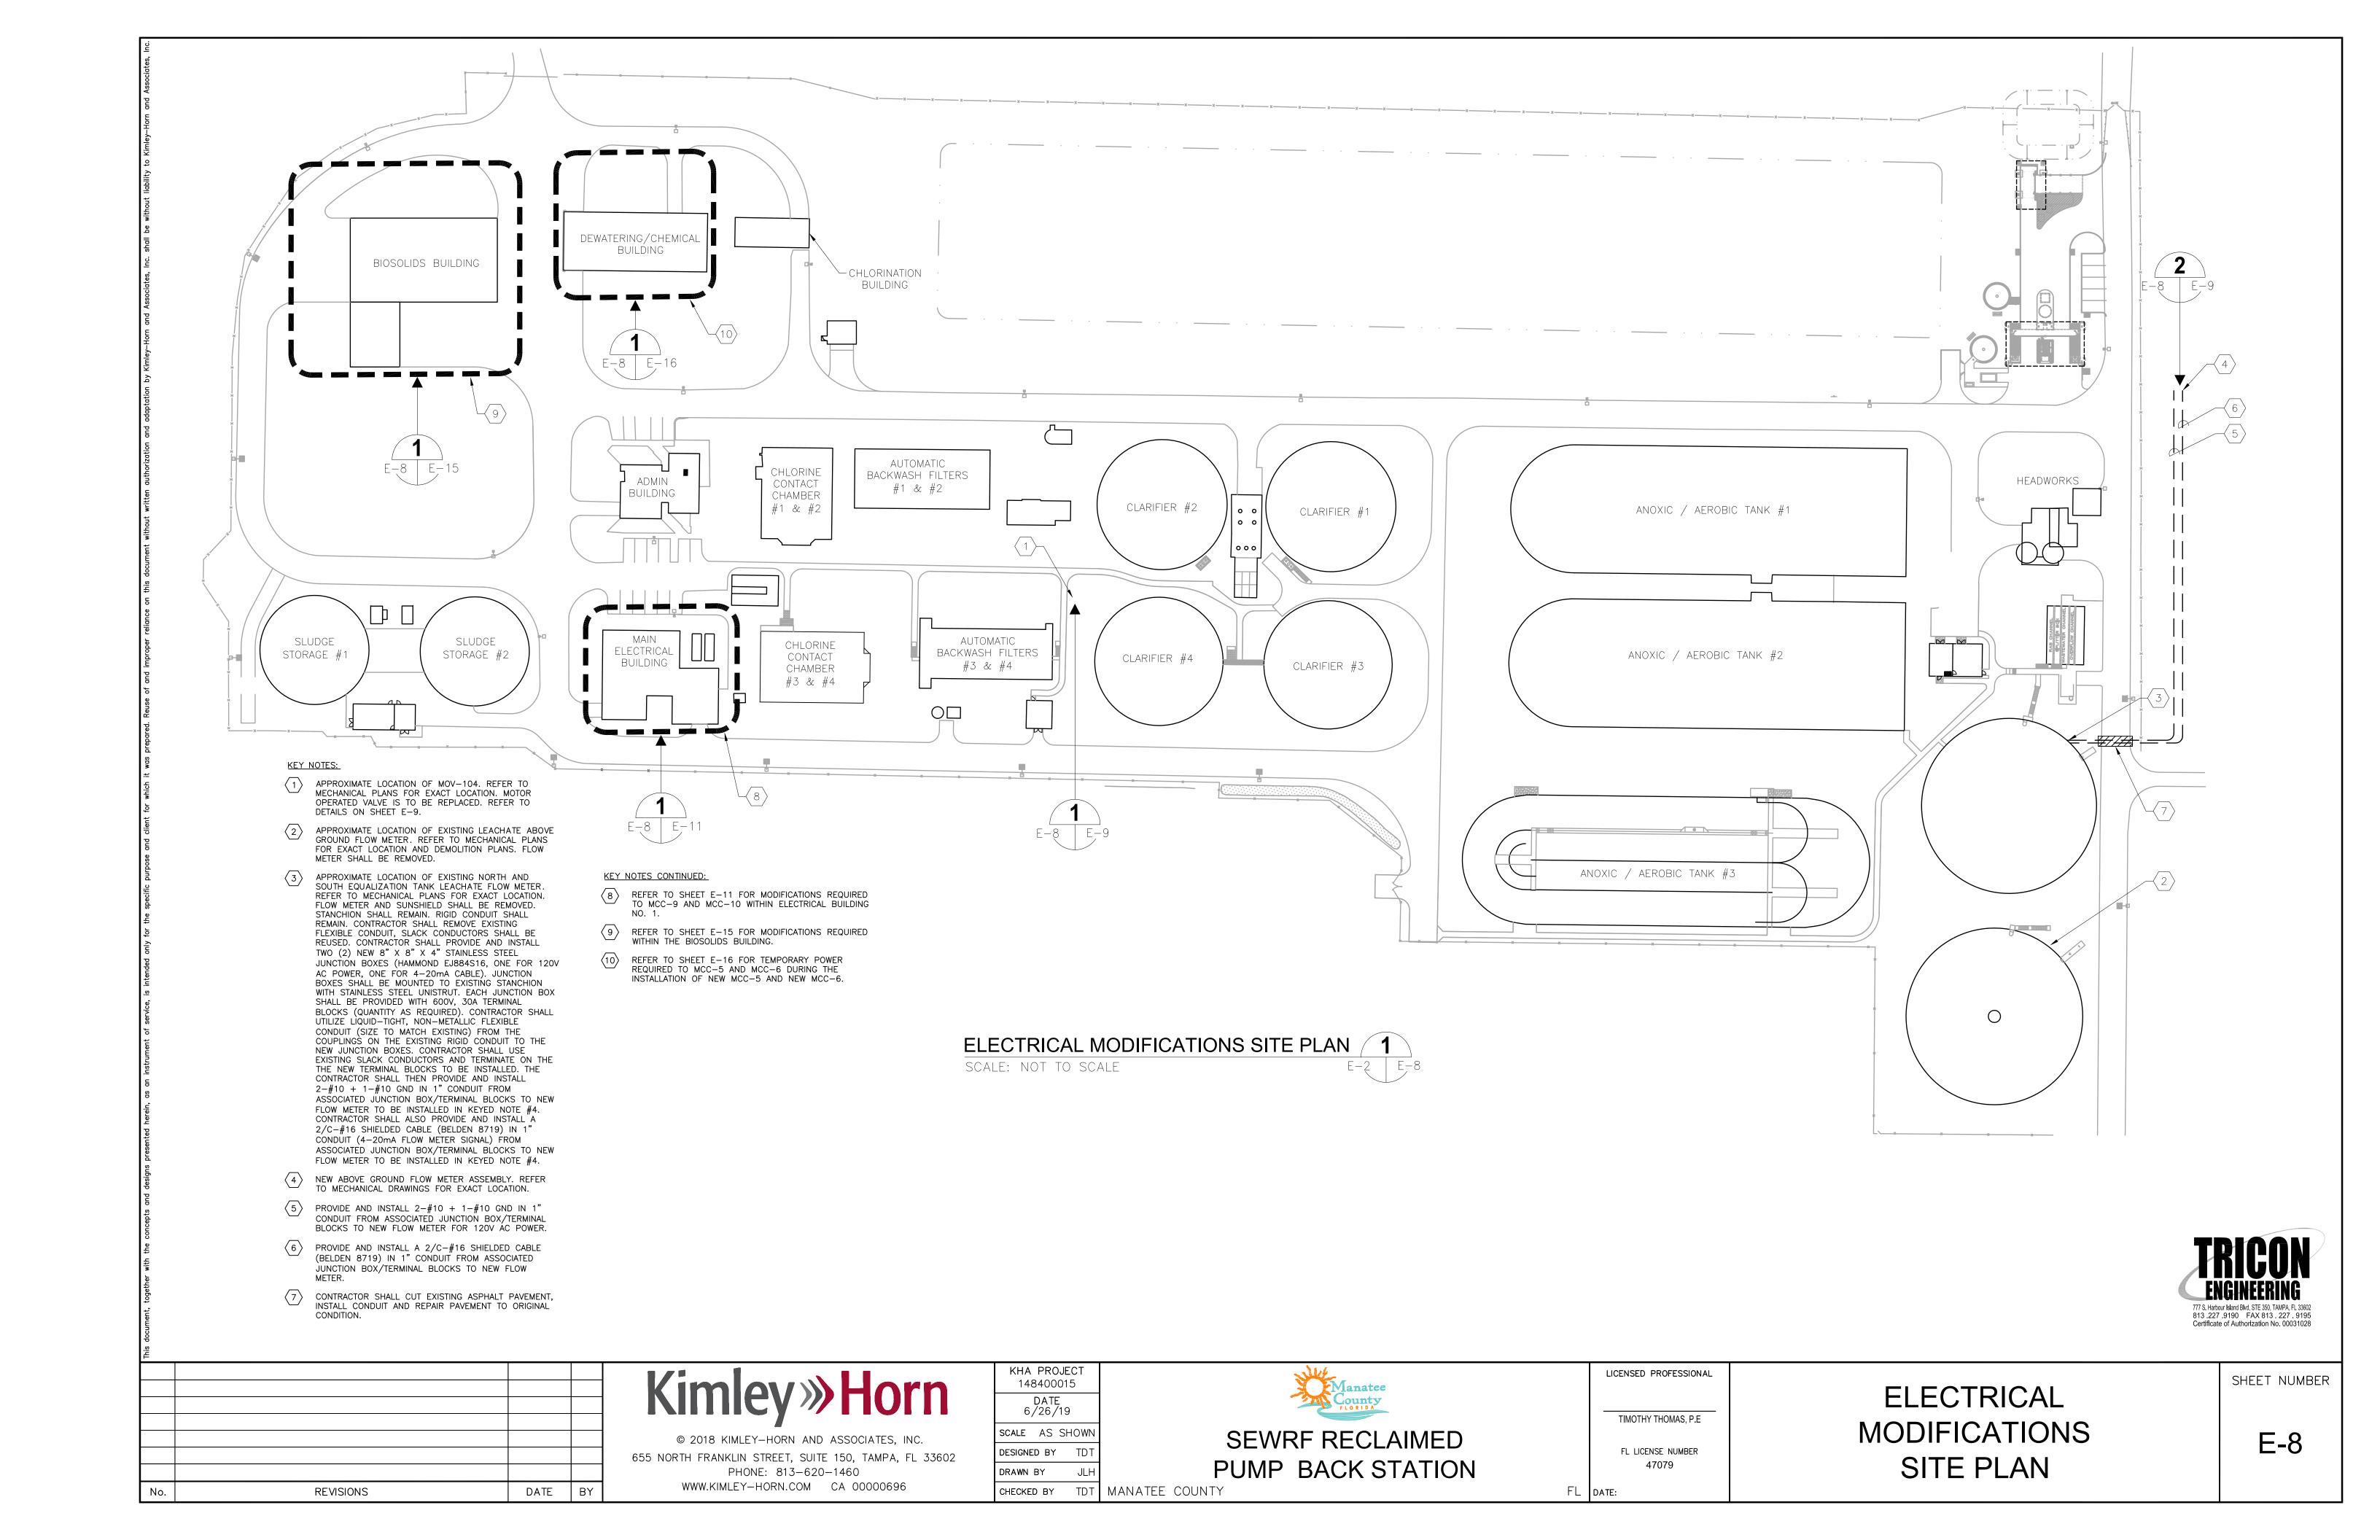
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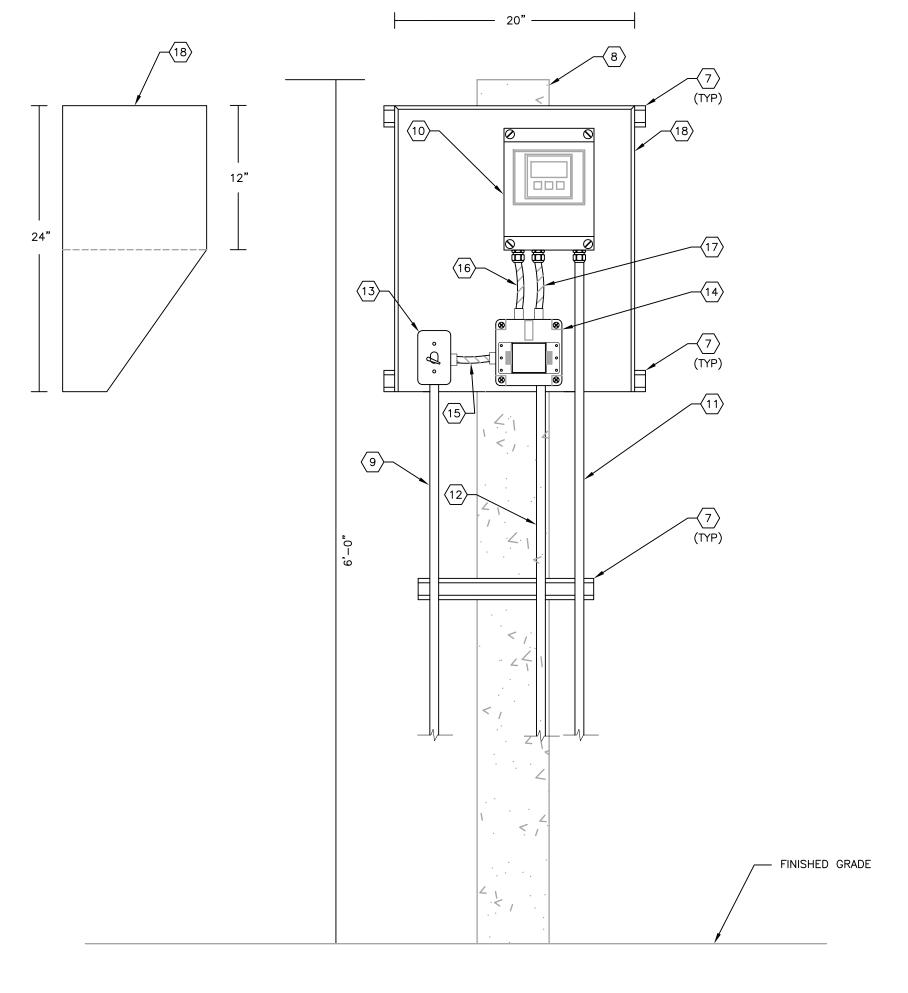
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ELECTRICAL DETAILS
AND PANEL SCHEDULE

SHEET NUMBER











SCALE: NOT TO SCALE



KEY NOTES:

- $\langle 1 \rangle$ EXISTING MOV-104 TO BE REPLACED.
- \langle 2 angle EXISTING MOV-104 DISCONNECT TO REMAIN.
- EXISTING CONDUIT AND CONDUCTORS FOR MOV-104 480V POWER TO REMAIN. EXISTING CONDUCTORS CONNECTED TO LINE SIDE OF DISCONNECT.

GENERAL NOTES:

 THE CONTRACTOR SHALL FIELD VERIFY THE EXISTING CONTROL CONDUCTORS FOR MOV-104 (QUANTITY AND

FUNCTION) PRIOR TO ORDERING EQUIPMENT OR SUBMITTING SHOP DRAWINGS. THE CONTRACTOR SHALL

CAPABILITY AS THE EXISTING VALVE.

OR SUBMITTING SHOP DRAWINGS.

INSURE THE NEW MOTOR OPERATED VALVE PROVIDES

POWER SUPPLY UTILIZED FOR THE FLOW METER BEING RELOCATED IS 120V AC PRIOR TO ORDERING EQUIPMENT

THE SAME CONTROL FUNCTIONS AND MONITORING

2. THE CONTRACTOR SHALL FIELD VERIFY THE EXISTING

- EXISTING CONDUIT AND CONDUCTORS FOR MOV-104
 480V POWER TO BE REPLACED. PROVIDE NEW
 LIQUID-TIGHT, NON-METALLIC FLEXIBLE CONDUIT (SIZE
 TO MATCH EXISTING) FROM DISCONNECT TO NEW
 MOTOR OPERATED VALVE. PROVIDE NEW CONDUCTORS
 (QUANTITY AND SIZE TO MATCH EXISTING TO BE
 REPLACED) FROM LOAD SIDE OF DISCONNECT TO NEW
 MOTOR OPERATED VALVE. LENGTH AS REQUIRED TO
 ACCOMMODATE NEW MOTOR OPERATED VALVE.
- EXISTING CONDUIT AND CONDUCTORS FOR MOV-104 CONTROLS TO REMAIN AND BE REUSED.
- EXISTING CONDUIT AND CONDUCTORS FOR MOV-104 CONTROLS TO BE REUSED IF EXISTING LENGTH WILL ACCOMMODATE THE NEW MOTOR OPERATED VALVE. IF CONDUCTOR/CONDUIT LENGTH WILL NOT ACCOMMODATE THE NEW MOTOR OPERATED VALVE, THE CONTRACTOR SHALL PROVIDE AND INSTALL A NEW 8" X 8" X 4" STAINLESS STEEL JUNCTION BOX (HAMMOND EJ884S16). JUNCTION BOX SHALL BE INSTALLED ON CONCRETÉ POST WITH STAINLESS STEEL UNISTRUT. INSTALL JUNCTION BOX AT A HEIGHT TO ALLOW FOR THE INSTALLATION OF A SHORT (8 TO 12 INCHES) LIQUID-TIGHT, NON-METALLIC FLEXIBLE CONDUIT (SIZE TO MATCH EXISTING) FROM THE JUNCTION BOX TO THE EXISTING RIGID COUPLING ON THE EXISTING CONTROL CONDUIT. THE CONTRACTOR SHALL UTILIZE THE EXISTING SLACK CONDUCTOR TO TRAVERSE TO THE NEW JUNCTION BOX. THE JUNCTION BOX SHALL BE PROVIDED WITH 600V, 30A TERMINAL BLOCKS (QUANTITY AS REQUIRED). CONTRACTOR SHALL TERMINATE EXISTING SLACK CONDUCTOR ON THE NEW TERMINAL BLOCKS INSTALLED WITHIN THE NEW JUNCTION BOX. THE CONTRACTOR SHALL THEN PROVIDE AND INSTALL A NEW LIQUID-TIGHT, NON-METALLIC FLEXIBLE CONDUIT (SIZE TO MATCH EXISTING) WITH ASSOCIATED CONTROL CONDUCTORS (QUANTITY AND SIZE TO MATCH EXISTING) THE FROM THE MOTOR OPERATED VALVE TO THE NEW TERMINAL BLOCKS WITHIN THE NEW JUNCTION BOX. CONDUCTOR/CONDUIT LENGTH SHALL BE AS REQUIRED TO ACCOMMODATE THE NEW MOTOR OPERATED VALVE.
- PROVIDE AND INSTALL 1-5/8" STAINLESS STEEL UNISTRUT (OR EQUAL). BOLTS TO SECURE UNISTRUT SHALL BE INSTALLED COMPLETELY THROUGH CONCRETE POST.
- PROVIDE AND INSTALL 6" X 6" CONCRETE POST. POST SHALL BE EMBEDDED A MINIMUM OF 3 FEET INTO
- PROVIDE AND INSTALL 2-#10 + 1-#10 GND IN 1"
 CONDUIT TO NEW JUNCTION BOX INSTALLED FOR
 FLOW METER TRANSMITTER FOR 120V POWER. REFER
 TO KEYED NOTE #5 ON SHEET E-8.
- PROVIDE AND INSTALL ENDRESS HAUSER MAG METER PROMAG W400 REMOTE TRANSMITTER. PROVIDE 1/4" ALUMINUM PLATE FOR MOUNTING.
- PROVIDE AND INSTALL MANUFACTURER SUPPLIED SENSOR CABLES IN 1" CONDUIT. VERIFY CONDUIT SIZE WITH MANUFACTURER.
- PROVIDE AND INSTALL 2/C-#16 SHIELDED (BELDEN 8719) IN 1" CONDUIT TO JUNCTION BOX INSTALLED FOR FLOW METER 4-20mA SIGNAL. REFER TO KEYED NOTE #6 ON SHEET E-8.
- PROVIDE AND INSTALL 120V, 15A, SINGLE-POLE SWITCH IN WEATHERPROOF FS BOX AS 120V POWER DISCONNECTING MEANS. PROVIDE AND INSTALL SINGLE-GANG WEATHERPROOF SWITCH COVER. BELL #5121-0.
- PROVIDE AND INSTALL EDCO SLAC SERIES AC POWER/SIGNAL TVSS DEVICE IN NEMA 4X ENCLOSURE TO PROTECT 120V POWER CIRCUIT AND 4—20mA ANALOG OUTPUT SIGNAL.
- PROVIDE AND INSTALL 2-#10 + 1-#10 GND IN 3/4" FLEXIBLE, SEALTITE CONDUIT FOR 120V POWER.
- PROVIDE AND INSTALL 2-#10 + 1-#10 GND IN 3/4" FLEXIBLE, SEALTITE CONDUIT TO FLOW METER TRANSMITTER FOR 120V POWER.
- PROVIDE AND INSTALL 2/C-#16 SHIELDED (BELDEN 8719) IN 3/4" FLEXIBLE, SEALTITE CONDUIT. (4-20mA FLOW METER SIGNAL).
- PROVIDE AND INSTALL SUN-SHIELD, CONSTRUCTED FROM 1/8" ALUMINUM STOCK. PROVIDE FULL FILLET WELDS. 20" WIDE, 24" TALL.



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ELECTRICAL DETAILS

SHEET NUMBER

CONDUIT AND CABLE SCHEDULE							
CONDUIT No.	QTY/SIZE	NUMER OF CONDUCTORS/SIZE	FROM	ТО	REMARKS		
P100	4"	3-#600 + 1-#250 NEUTRAL	FP&L HANHOLE	METER SOCKET			
P100A	4"	3-#600 + 1-#250 NEUTRAL	METER SOCKET	MAIN DISTRIBUTION PANELBOARD 'MDP'			
P101	2"	3-2/0 + 1-#6 GND	MAIN DISTRIBUTION PANELBOARD 'MDP'	MOTOR CONTROL CABINET	PUMP No. 1 VFD FEEDER.		
P101	2"	3-2/0 + 1-#6 GND	MOTOR CONTROL CABINET	PUMP No. 1 JUNCTION BOX			
P101B	4"	PUMP CABLE BY MANUFACTURER	PUMP No. 1 JUNCTION BOX	PUMP No. 1	CABLE TO INCLUDE CONDUCTORS FOR PUMP LEAK AND TEMPERATURE SENSOR.		
P102	2"	3-2/0 + 1-#6 GND	MAIN DISTRIBUTION PANELBOARD 'MDP'	MOTOR CONTROL CABINET	PUMP No. 2 VFD FEEDER.		
P102A	2"	3-2/0 + 1-#6 GND	MOTOR CONTROL CABINET	PUMP No. 2 JUNCTION BOX			
P102B	4"	PUMP CABLE BY MANUFACTURER	PUMP No. 2 JUNCTION BOX	PUMP No. 2	CABLE TO INCLUDE CONDUCTORS FOR PUMP LEAK AND TEMPERATURE SENSOR.		
P103	2"	3-2/0 + 1-#6 GND	MAIN DISTRIBUTION PANELBOARD 'MDP'	MOTOR CONTROL CABINET	PUMP No. 3 VFD FEEDER.		
P103A	2"	3-2/0 + 1-#6 GND	MOTOR CONTROL CABINET	PUMP No. 3 JUNCTION BOX			
P103B	4"	PUMP CABLE BY MANUFACTURER	PUMP No. 3 JUNCTION BOX	PUMP No. 3	CABLE TO INCLUDE CONDUCTORS FOR PUMP LEAK AND TEMPERATURE SENSOR.		
P200	1"	3-#10 + 1-#10 NEU + 1-#10 GND	MAIN DISTRIBUTION PANELBOARD 'MDP'	'MDP' SURGE PROTECTION DEVICE	PROVIDE NON-METALLIC WEATHERPROOF FLEXIBLE CONDUIT.		
P201	1"	2-#10 + 1-#10 GND	MAIN DISTRIBUTION PANELBOARD 'MDP'	MINI POWER ZONE 'LP' TRANSFORMER			
P300	3/4"	2-#12 + 1-#12 GND	PANELBOARD 'LP'	FLOW METER TRANSMITTER	120V AC FLOW TRANSMITTER POWER. CIRCUIT LP-10.		
P301	3/4"	2-#12 + 1-#12 GND	PANELBOARD 'LP'	AREA LIGHT	120V AC AREA LIGHT POWER. CIRCUIT LP-2.		
P302	3/4"	2-#12 + 2-#12 NEU + 1-#12 GND	PANELBOARD 'LP'	PUMP CONTROL PANEL	120V AC PUMP CONTROL CABINET POWER. CIRCUITS LP-1 AND LP-3.		
P303	1"	4-#12 + 4-#12 NEU + 1-#12 GND	PANELBOARD 'LP'	MOTOR CONTROL CABINET	120V AC POWER. CIRCUITS LP-4, LP-5, LP-6 AND LP-8.		
P304	3/4"	2-#10 + 1-#10 NEU + 1-#10 GND	PANELBOARD ZONE 'LP'	'LP' SURGE PROTECTION DEVICE	PROVIDE NON-METALLIC WEATHERPROOF FLEXIBLE CONDUIT.		
G100	1-1/4"	2/0 BARE COPPER	MAIN DISTRIBUTION PANELBOARD 'MDP'	GROUNDING ELECTRODE GRID			
G200	3/4"	#8 BARE COPPER	PANELBOARD 'LP'	GROUNDING ELECTRODE GRID			
G300	1"	#4 BARE COPPER	METER SOCKET	GROUNDING ELECTRODE GRID			
G400	1-1/4"	1/0 BARE COPPER	RADIO ANTENNA TOWER	GROUNDING ELECTRODE GRID			
C100	1"	2/C-#16 SHIELDED CABLE	PUMP CONTROL CABINET	FLOW METER TRANSMITTER	FLOW METER 4-20mA SIGNAL. CABLE TO BE BELDEN 8719.		
C100A	1"	SENSOR CABLE	FLOW METER ELEMENT	FLOW METER TRANSMITTER	FLOW METER ELEMENT SENSOR CABLE TO BE PROVIDED BY MANUFACTURER.		
C101	2"	FIVE (5) 2/C-#14 + 1-#14 GND	WET WELL FLOAT SWITCHES	WET WELL JUNCTION BOX	CABLES TO BE PROVIDED BY FLOAT SWITCH MANUFACTURER.		
C101A	2"	10-#14 + 1-#14 GND	WET WELL JUNCTION BOX	PUMP CONTROL PANEL	FLOAT SIGNALS.		
C102	2"	LEVEL TRANSMITTER CABLE	WET WELL LEVEL TRANSDUCER	WET WELL JUNCTION BOX	CABLE TO BE PROVIDED BY LEVEL TRANSDUCER MANUFACTURER.		
C102A	1"	2/C-!6 SHIELDED CABLE	WET WELL JUNCTION BOX	PUMP CONTROL CABINET	WET WELL LEVEL 4-20mA SIGNAL. CABLE TO BE BELDEN 8719.		
C200	1"	20-#14 + 1-#14 GND	MOTOR CONTROL CABINET	PUMP CONTROL CABINET	VFD MINI CAS II AND NORMAL POWER MONITORING. CONDUCTOR COUNT INCLUDES SPARES.		
C300	1-1/4"	COAXIAL CABLE	PUMP CONTROL PANEL	RADIO ANTENNA TOWER			
C401	3/4"	2-#14 + 1-#14 GND	PUMP No. 1 JUNCTION BOX	MOTOR CONTROL CABINET	MINI CAS II FROM PUMP No. 1.		
C402	3/4"	2-#14 + 1-#14 GND	PUMP No. 2 JUNCTION BOX	MOTOR CONTROL CABINET	MINI CAS II FROM PUMP No. 2.		
C403	3/4"	2-#14 + 1-#14 GND	PUMP No. 3 JUNCTION BOX	MOTOR CONTROL CABINET	MINI CAS II FROM PUMP No. 3.		
E100	2"	ETHERNET CABLE	PUMP CONTROL CABINET	MOTOR CONTROL CABINET	VFD ETHERNET CONTROL		



REVISIONS DATE BY Kimley» Horn © 2018 KIMLEY-HORN AND ASSOCIATES, INC.

655 NORTH FRANKLIN STREET, SUITE 150, TAMPA, FL 33602

PHONE: 813-620-1460 WWW.KIMLEY-HORN.COM CA 00000696

KHA PROJECT 148400015 DATE 6/26/19 SCALE AS SHOWN DESIGNED BY TDT




LICENSED PROFESSIONAL TIMOTHY THOMAS, P.E

FL LICENSE NUMBER

FL DATE:

CONDUIT AND CABLE SCHEDULE

SHEET NUMBER

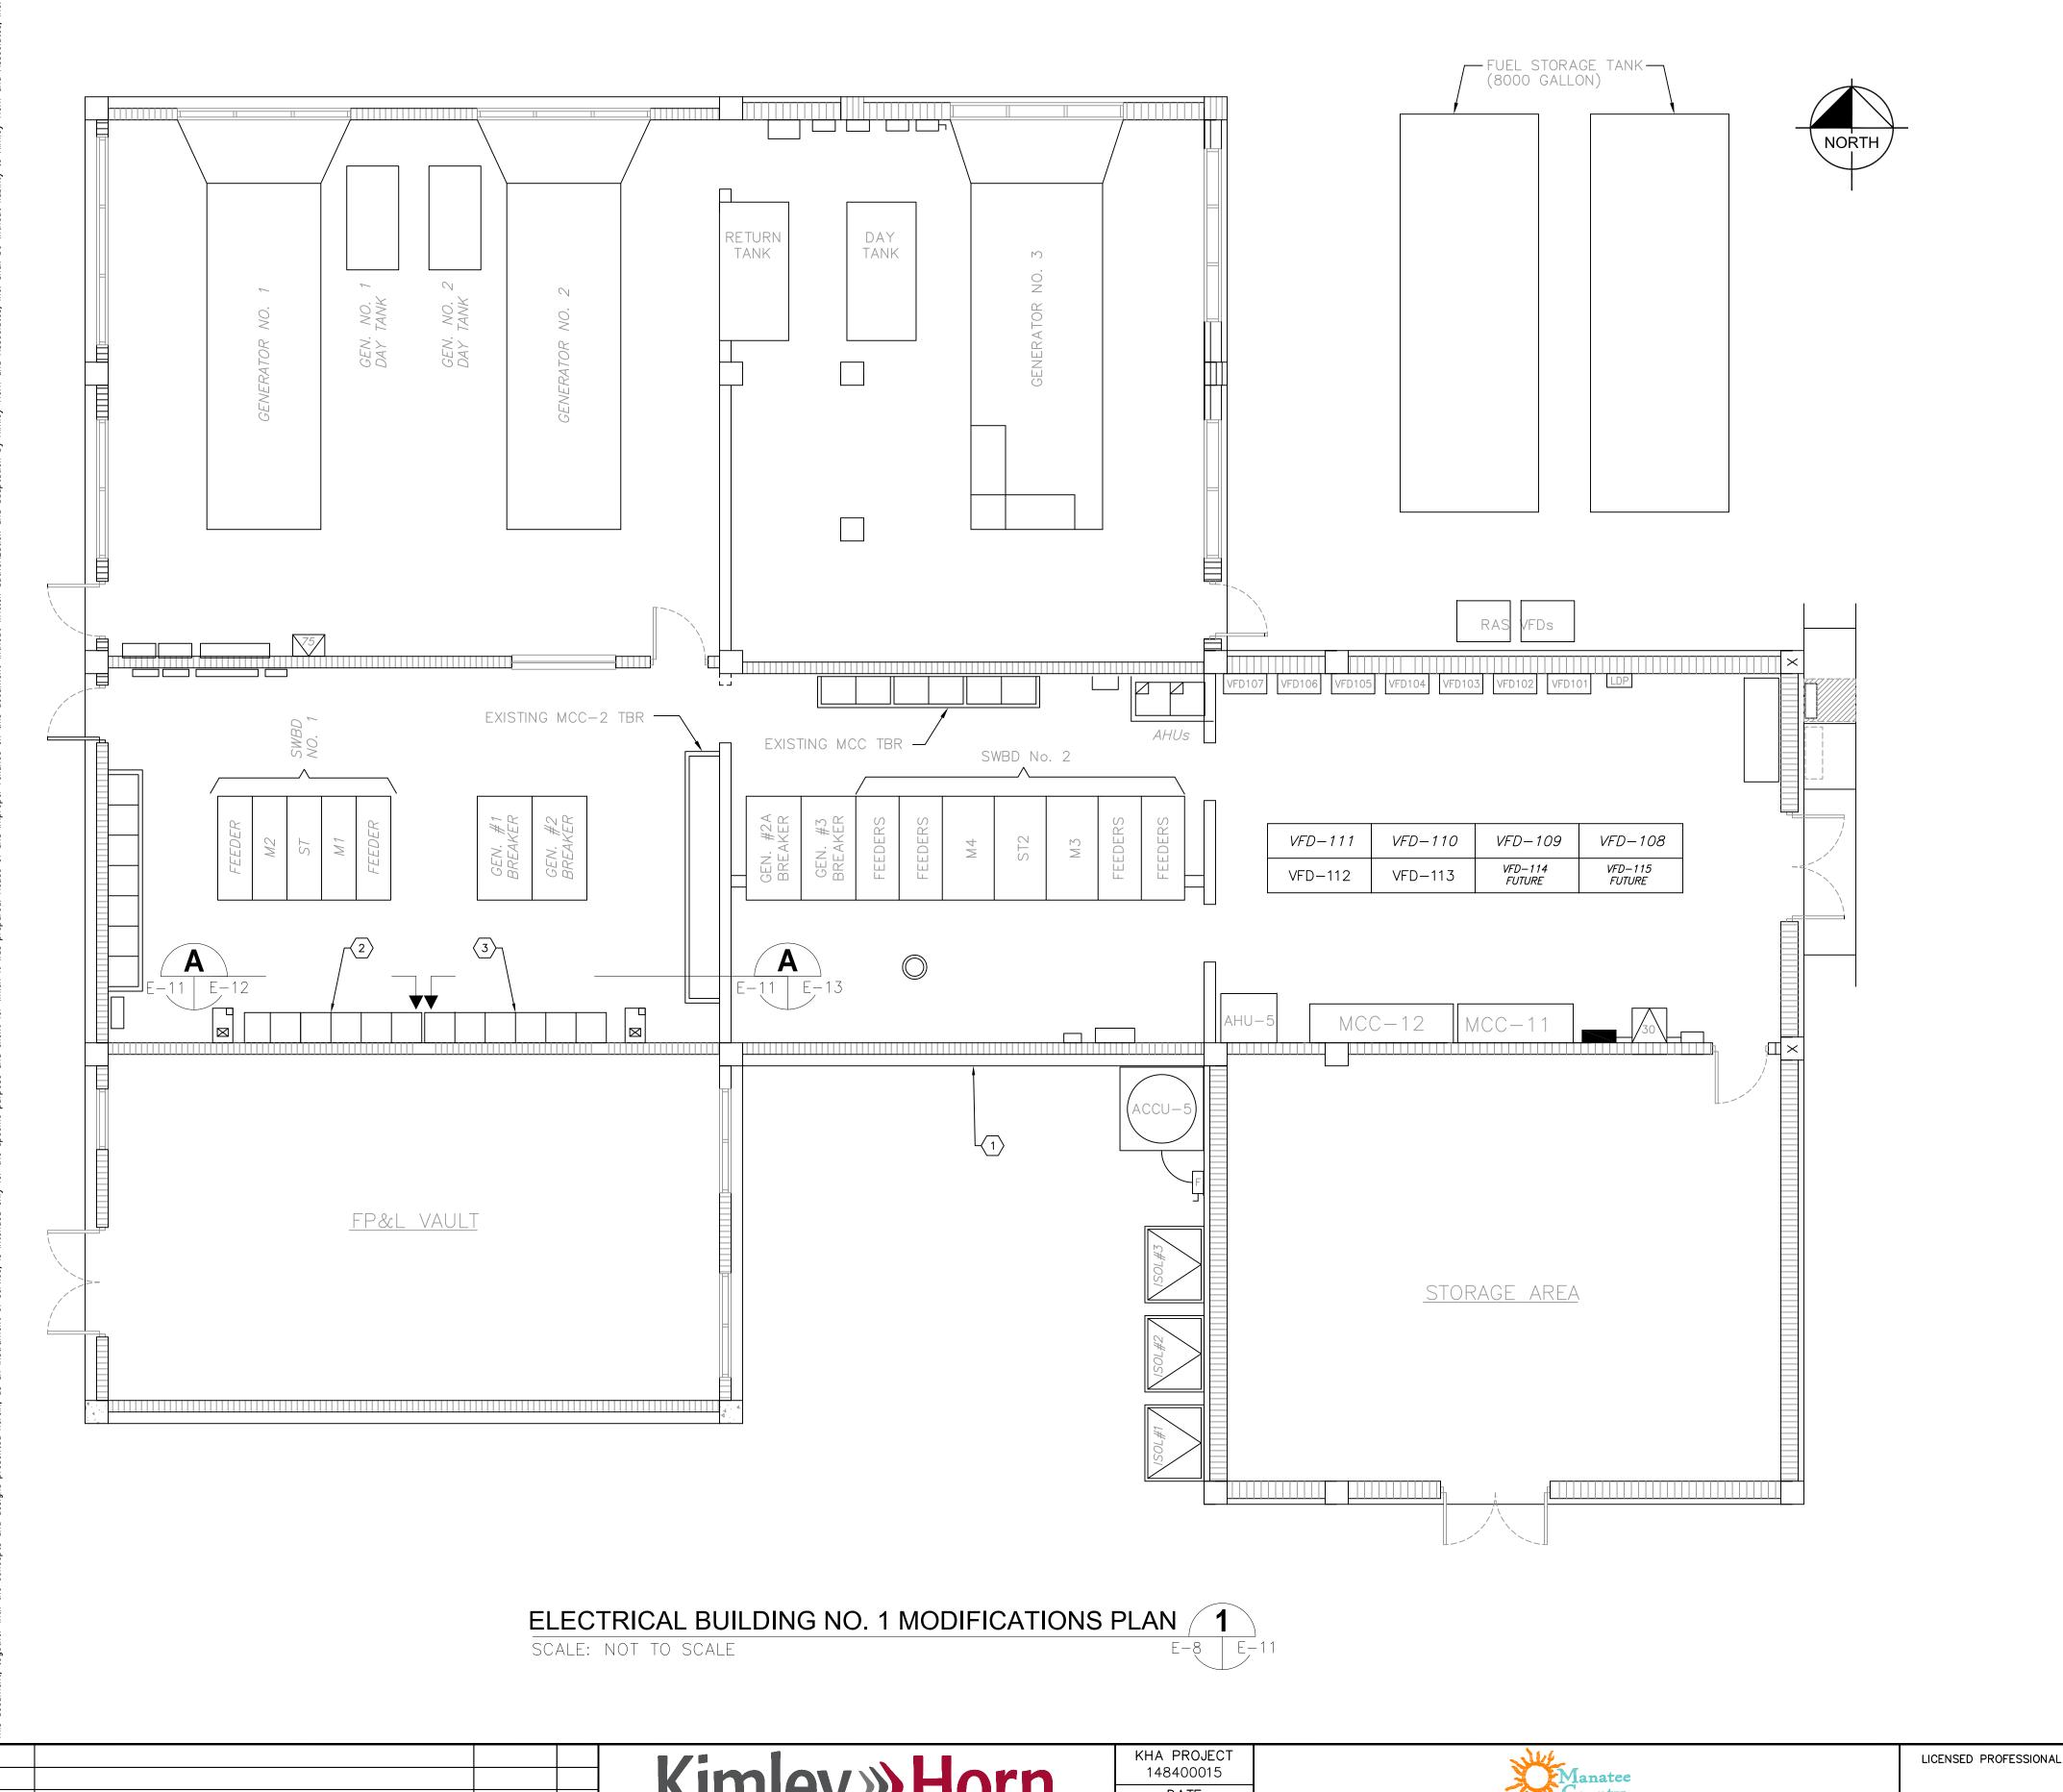

- 1) EXISTING ELECTRICAL BUILDING No. 1.
- 2 EXISTING MOTOR CONTROL CENTER 'MCC-9'. REFER TO SHEET E-12 FOR ELEVATION AND DETAILS.
- 3 EXISTING MOTOR CONTROL CENTER 'MCC-10'. REFER TO SHEET E-12 FOR ELEVATION AND DETAILS.

<u>GENERAL NOTES:</u>

- 1. THE CONTRACTOR SHALL NOT COMMENCE INSTALLATION OF THE TEMPORARY FEEDERS, THE DISCONNECTION OF THE THE 480V POWER FEEDERS FROM MCC-9 AND MCC-10, OR THE INSTALLATION OF MCC-9 AND MCC-10 UNTIL THE CENTRAL PUMP BACK STATION TO BE INSTALLED AS PART OF THIS CONTRACT IS COMPLETE, TESTED AND ACCEPTED BY MANATEE COUNTY.
- 2. THE CONTRACTOR SHALL NOTIFY MANATEE COUNTY IN WRITING A MINIMUM OF ONE (1) WEEK IN ADVANCE OF ANY PROPOSED SHUTDOWN OF MCC-9 OR MCC-10. THE CONTRACTOR SHALL NOT COMMENCE SHUTDOWNS WITHOUT WRITTEN APPROVAL OF MANATEE COUNTY.
- MCC-9 AND MCC-10 SHALL NOT BE REPLACED CONCURRENTLY. THE CONTRACTOR SHALL ONLY REPLACE ONE (1) MOTOR CONTROL CENTER AT A TIME.

TRICOR
ENGINEERING

777 S, Harbour Island Blvd, STE 350, TAMPA, FL 33602
813 .227 .9190 FAX 813 . 227 . 9195
Certificate of Authorization No. 00031028

REVISIONS

DATE BY

Kimley» Horn

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655 NORTH FRANKLIN STREET, SUITE 150, TAMPA, FL 33602
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CALE AS SHOWN
DESIGNED BY TDT

SEWRF RECLAIMED

TDT

JLH

TDT

MANATEE COUNTY


TIMOTHY THOMAS, P.E

FL LICENSE NUMBER
47079

FL DATE:

ELECTRICAL BUILDING NO. 1 FLOOR PLAN

SHEET NUMBER

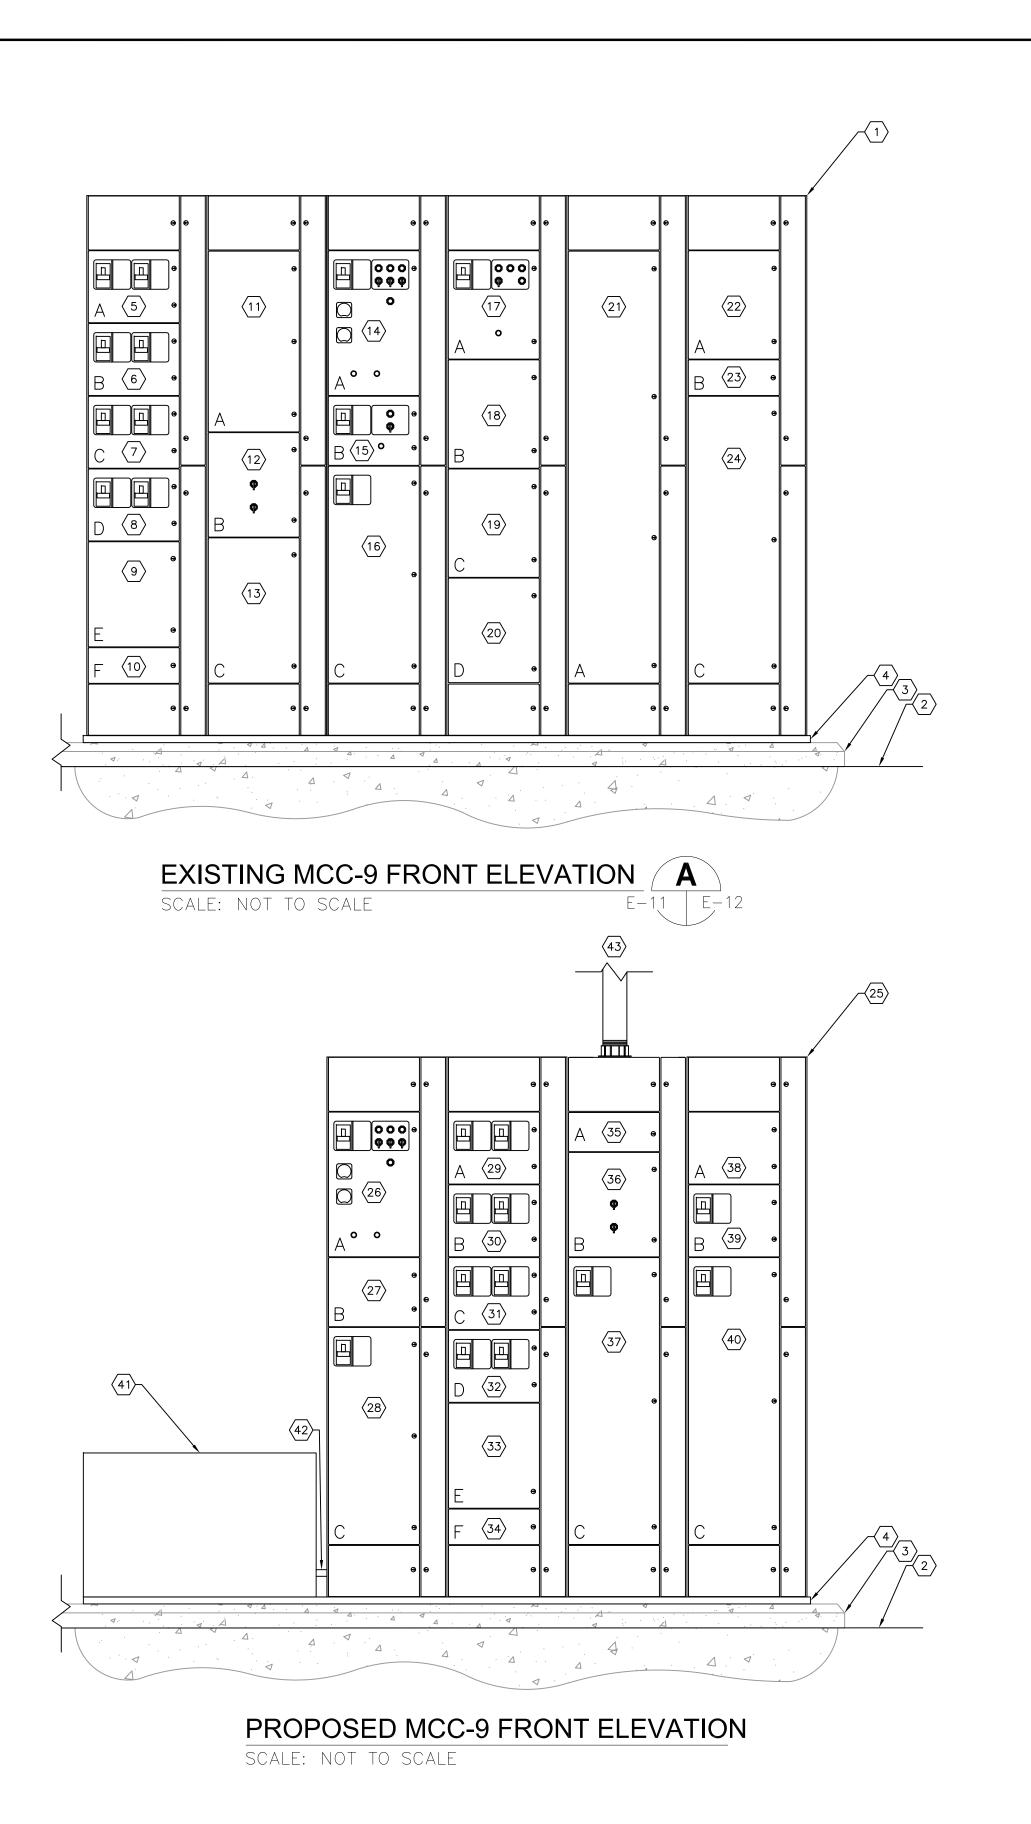

EXISTING MOTOR CONTROL CENTER 'MCC-9'. EXISTING MOTOR CONTROL CENTER SHALL BE REPLACED.

2 EXISTING FINISHED FLOOR.

(3) EXISTING HOUSEKEEPING PAD.

EXISTING MOTOR CONTROL CENTER IS INSTALLED ON CHANNEL.

5 EXISTING SECTION 1A CONTAINING CIRCUIT BREAKERS FOR PANEL P1 TRANSFER SWITCH AND SOUTH AUTO BACK WASH. THESE CIRCUIT BREAKERS SHALL BE DUPLICATED IN THE NEW MCC-9.

6 EXISTING SECTION 1B CONTAINING CIRCUIT BREAKERS FOR PANEL LE TRANSFER SWITCH AND ACCU-2. THESE CIRCUIT BREAKERS SHALL BE DUPLICATED IN THE NEW MCC-9.

7 EXISTING SECTION 1C CONTAINING CIRCUIT BREAKER FOR THE FLOCCULATOR CONTROL PANEL AND A SPARE CIRCUIT BREAKER. THESE CIRCUIT BREAKERS SHALL BE DUPLICATED IN THE NEW MCC-9.

8 EXISTING SECTION 1D CONTAINING CIRCUIT BREAKER FOR WEIR OPERATOR NO. 2 AND A SPARE CIRCUIT BREAKER. THESE CIRCUIT BREAKERS SHALL BE DUPLICATED IN THE NEW MCC-9.

9 EXISTING SECTION 1E IS A SPARE BUCKET THAT WILL BE DUPLICATED IN THE NEW MCC-9.

EXISTING SECTION 1F IS A SPARE BUCKET THAT WILL BE DUPLICATED IN THE NEW MCC-9.

EXISTING SECTION SECTION 2A IS THE ELR AND LDR RELAY COMPARTMENT. THE ELR AND LDR RELAY COMPARTMENT WILL NOT BE DUPLICATED IN THE NEW MCC-9.

EXISTING SECTION 2B CONTAINS THE A/C CONTROLS.
THIS COMPARTMENT WILL BE DUPLICATED IN THE NEW MCC-9.

EXISTING SECTION 2C CONTAINS 400A CURRENT LIMITING FUSES. THIS COMPARTMENT WILL NOT BE DUPLICATED IN THE NEW MCC-9.

EXISTING SECTION 3A CONTAINS THE CIRCUIT BREAKER AND MOTOR STARTER FOR FLASH MIXER NO. 1. THIS COMPARTMENT WILL BE DUPLICATED IN THE NEW MCC-9.

EXISTING SECTION 3B CONTAINS THE CIRCUIT BREAKER AND MOTOR STARTER FOR EXHAUST FAN NO. 1. THIS COMPARTMENT WILL NOT BE DUPLICATED IN THE NEW MCC-9.

EXISTING SECTION 3C CONTAINING CIRCUIT BREAKER FOR MCC-5 (BELT PRESS WEST). THIS CIRCUIT BREAKER SHALL BE DUPLICATED IN THE NEW MCC-9.

EXISTING SECTION 4A CONTAINS A SPARE STARTER THAT WILL NOT BE DUPLICATED IN THE NEW MCC-9.

EXISTING SECTION 4B CONSISTS OF A SPARE BUCKET THAT WILL NOT BE DUPLICATED IN THE NEW MCC-9.

EXISTING SECTION 4C CONSISTS OF A SPARE BUCKET THAT WILL NOT BE DUPLICATED IN THE NEW MCC-9.

(20) EXISTING SECTION 4D CONSISTS OF A SPARE BUCKET THAT WILL NOT BE DUPLICATED IN THE NEW MCC-9.

21) EXISTING SECTION 5A CONSISTS OF A SPARE BUCKET THAT WILL NOT BE DUPLICATED IN THE NEW MCC-9.

22 EXISTING SECTION 6A CONSISTS OF A SPARE BUCKET THAT WILL NOT BE DUPLICATED IN THE NEW MCC-9.

EXISTING SECTION 6B CONTAINS LIGHTNING ARRESTERS THAT SHALL BE DUPLICATED IN THE NEW MCC-9.

4) EXISTING SECTION 6C CONTAINS 800A CURRENT LIMITING FUSES (MCC-9 INCOMING FEED FROM SWITCHGEAR 1). THE FUSES SHALL NOT BE DUPLICATED IN THE NEW MCC-9.

PROPOSED MOTOR CONTROL CENTER 'MCC-9'. REFER ALSO TO SPECIFICATIONS.

26 SECTION 1A SHALL CONTAIN THE NEW CIRCUIT
BREAKER AND NEW MOTOR STARTER FOR FLASH MIXER
NO. 1.

SECTION 1B SHALL BE A SPARE CUBICLE.

8) SECTION 1C SHALL CONTAIN THE NEW CIRCUIT BREAKER FOR MCC-5 (BELT PRESS WEST).

SECTION 2A SHALL CONTAIN THE CIRCUIT BREAKERS FOR PANEL P1 TRANSFER SWITCH AND SOUTH AUTO BACK WASH.

SECTION 2B SHALL CONTAIN THE CIRCUIT BREAKERS FOR PANEL LE TRANSFER SWITCH AND ACCU-2.

SECTION 2C SHALL CONTAIN THE CIRCUIT BREAKER FOR THE FLOCCULATOR CONTROL PANEL AND A SPARE CIRCUIT BREAKER.

SECTION 2D SHALL CONTAIN THE CIRCUIT BREAKER FOR WEIR OPERATOR NO. 2 AND A SPARE CIRCUIT

33 SECTION 2E SHALL CONSIST OF A SPARE BUCKET.

SECTION 2F SHALL CONSIST OF A SPARE BUCKET.

KEY NOTES CONTINUED:

SECTION 3A SHALL CONSIST OF A SPARE BUCKET.

36 SECTION 3B SHALL CONTAIN THE A/C CONTROLS.

SECTION 3C SHALL CONTAIN A 3-POLE, 400A, TIE

38 SECTION 4A SHALL CONSIST OF A SPARE BUCKET.

39) SECTION 4B SHALL CONSIST OF A SURGE PROTECTION DEVICE (SPD).

SECTION 4C SHALL CONTAIN A 3-POLE, 800A, MAIN CIRCUIT BREAKER THAT SHALL BE FED FROM SWITCHBOARD No. 1.

THE CONTRACTOR SHALL PROVIDE A 24" X 20" X 20" STAINLESS STEEL JUNCTION BOX TO BE UTILIZED TO REROUTE THE ASSOCIATED CONDUCTORS FOR THE PANEL P1 TRANSFER SWITCH, THE SOUTH AUTO BACK WASH, THE PANEL LE TRANSFER SWITCH, ACCU-2, THE FLOCCULATOR CONTROL PANEL, WEIR OPERATOR NO. 2, ETC.. AS THE EXISTING CONDUCTORS WILL NOT REACH THE NEW LOCATION OF THEIR ASSOCIATED CIRCUIT BREAKER OF STARTER, THE CONTRACTOR SHALL INSTALL 600V, POWER DISTRIBUTION BLOCKS (AMPACITY AS REQUIRED) FOR THE TERMINATION OF THE EXISTING CONDUCTORS AND THE INSTALLATION OF THE NEW

THE CONTRACTOR SHALL PROVIDE CONDUITS AS REQUIRED FOR THE NEW CONDUCTORS TO BE INSTALLED IN KEYED NOTE #41.

THE CONTRACTOR SHALL PROVIDE AND INSTALL
3-#600 kcmil THWN CU + 1/0 THWN CU GND. IN 4"
CONDUIT TO THE NEW MCC-10 FOR THE TIE FEEDER.
CONTRACTOR SHALL FIELD ROUTE CONDUIT AS
REQUIRED. REFER ALSO TO MCC-10 ELEVATION ON
SHEFT F-13

GENERAL NOTES:

1. THE CONTRACTOR SHALL NOT COMMENCE INSTALLATION OF THE TEMPORARY FEEDERS, THE DISCONNECTION OF THE THE 480V POWER FEEDERS TO MCC-5 AND MCC-6, OR THE INSTALLATION OF MCC-9 AND MCC-10 UNTIL THE CENTRAL PUMP BACK STATION TO BE INSTALLED AS PART OF THIS CONTRACT IS COMPLETE, TESTED AND ACCEPTED BY MANATEE COUNTY.

2. THE CONTRACTOR SHALL NOTIFY MANATEE COUNTY IN WRITING A MINIMUM OF ONE (1) WEEK IN ADVANCE OF ANY PROPOSED SHUTDOWN OF MCC-9 OR MCC-10. THE CONTRACTOR SHALL NOT COMMENCE SHUTDOWNS WITHOUT WRITTEN APPROVAL OF MANATEE COUNTY.



No. REVISIONS DATE BY

(imley») Horn

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KHA PROJECT
148400015

DATE
6/26/19

SCALE AS SHOWN
DESIGNED BY TDT

TDT | MANATEE COUNTY

DRAWN BY

CHECKED BY

WRF RECLAIME

SEWRF RECLAIMED PUMP BACK STATION

TIMOTHY THOMAS, P.E

FL DATE:


LICENSED PROFESSIONAL

FL LICENSE NUMBER 47079

MCC-9 ELEVATION AND DETAILS

_ . .

SHEET NUMBER

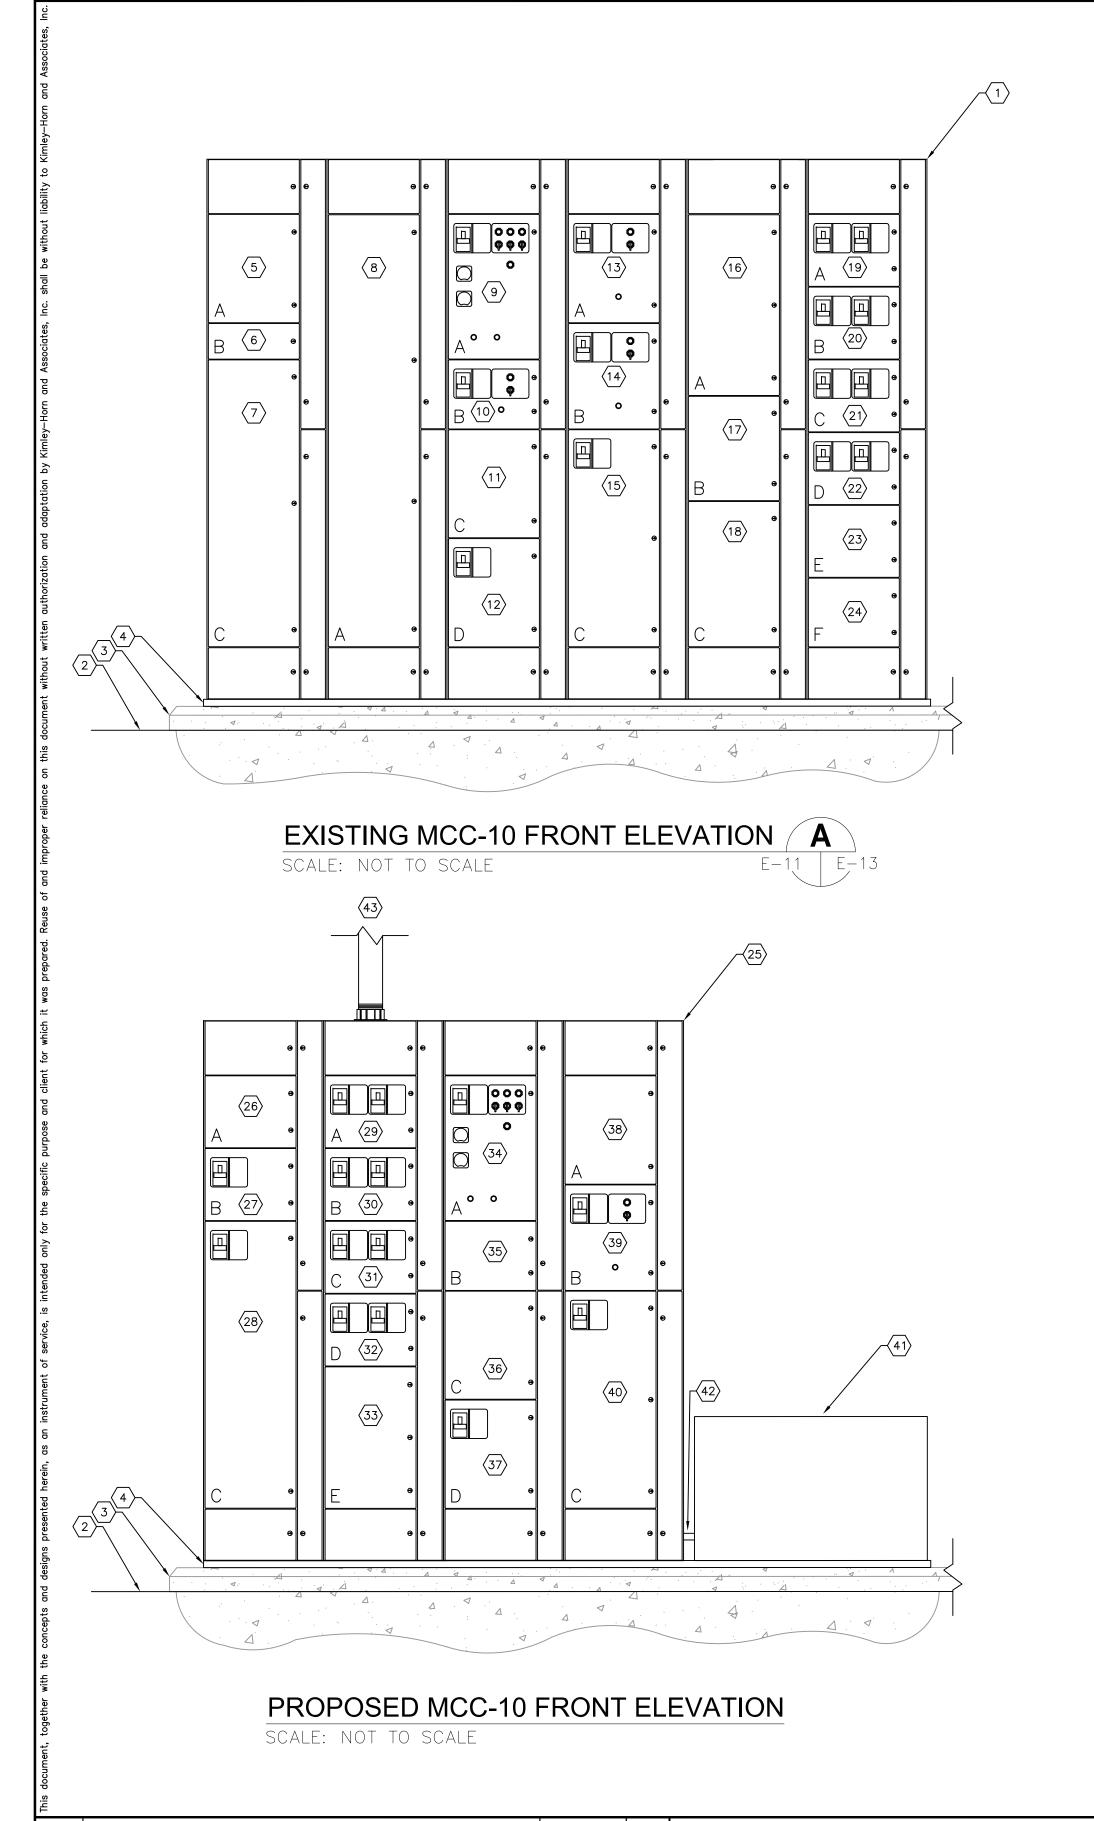

- (1) EXISTING MOTOR CONTROL CENTER 'MCC-10'. EXISTING MOTOR CONTROL CENTER SHALL BE REPLACED.
- $\langle 2 \rangle$ EXISTING FINISHED FLOOR.
- 3 EXISTING HOUSEKEEPING PAD.
- EXISTING MOTOR CONTROL CENTER IS INSTALLED ON
- EXISTING SECTION 1A CONSISTS OF A SPARE BUCKET. THE SPARE SHALL BE DUPLICATED IN THE NEW
- 6 EXISTING SECTION 1B CONTAINS LIGHTNING ARRESTERS THAT SHALL BE DUPLICATED IN THE NEW MCC-10.
- $\langle 7 \rangle$ EXISTING SECTION 1C CONTAINS 800A CURRENT LIMITING FUSES (MCC-10 INCOMING FEED FROM SWITCHGEAR 1). THE FUSES SHALL NOT BE DUPLICATED IN THE NEW MCC-10.
- EXISTING SECTION 2A CONSISTS OF A SPARE BUCKET THAT WILL NOT BE DUPLICATED IN THE NEW MCC-10.
- EXISTING SECTION 3A CONTAINS THE CIRCUIT BREAKER AND MOTOR STARTER FOR FLASH MIXER NO. 2. THIS COMPARTMENT WILL BE DUPLICATED IN THE NEW
- EXISTING SECTION 3B CONTAINS THE CIRCUIT BREAKER AND MOTOR STARTER FOR EXHAUST FAN NO. 2. THIS COMPARTMENT WILL NOT BE DUPLICATED IN THE NEW
- EXISTING SECTION 3C CONSISTS OF A SPARE BUCKET THAT WILL NOT BE DUPLICATED IN THE NEW MCC-10.
- EXISTING SECTION 3D CONTAINS THE CIRCUIT BREAKER FOR THE SOUTH LAKE FEEDER. THIS COMPARTMENT WILL NOT BE DUPLICATED IN THE NEW MCC-10.
- (13) EXISTING SECTION 4A CONTAINS A SPARE STARTER THAT WILL NOT BE DUPLICATED IN THE NEW MCC-10.
- EXISTING SECTION 4B CONTAINS THE CIRCUIT BREAKER FOR A SAMPLE PUMP. THIS COMPARTMENT WILL BE DUPLICATED IN THE NEW MCC-10.
- EXISTING SECTION 4C CONTAINING CIRCUIT BREAKER FOR MCC-6 (BELT PRESS EAST). THIS CIRCUIT BREAKER SHALL BE DUPLICATED IN THE NEW MCC-10.
- EXISTING SECTION 5A CONSISTS OF A SPARE BUCKET THAT WILL NOT BE DUPLICATED IN THE NEW MCC-10.
- (17) EXISTING SECTION SECTION 5B IS THE ELR AND LDR RELAY COMPARTMENT. THE ELR AND LDR RELAY COMPARTMENT WILL NOT BE DUPLICATED IN THE NEW MCC-10.
- (18) EXISTING SECTION 5C CONTAINS 400A CURRENT LIMITING FUSES. THIS COMPARTMENT WILL NOT BE DUPLICATED IN THE NEW MCC-10.
- (19) EXISTING SECTION 6A CONTAINING THE CIRCUIT BREAKERS FOR PANEL P1 TRANSFER SWITCH AND NORTH AUTO BACK WASH. THESE CIRCUIT BREAKERS SHALL BE DUPLICATED IN THE NEW MCC-10.
- EXISTING SECTION 6B CONTAINING CIRCUIT BREAKERS FOR PANEL LE TRANSFER SWITCH AND ACCU-1. THESE CIRCUIT BREAKERS SHALL BE DUPLICATED IN THE NEW
- EXISTING SECTION 6C CONTAINING CIRCUIT BREAKERS FOR PLANT DRAIN PUMP STATION AND PANEL LE TRANSFER SWITCH. THESE CIRCUIT BREAKERS SHALL BE DUPLICATED IN THE NEW MCC-10.
- EXISTING SECTION 6D CONTAINING CIRCUIT BREAKERS FOR PANEL PFC AND WEIR OPERATOR NO. 1. THESE CIRCUIT BREAKERS SHALL BE DUPLICATED IN THE NEW
- EXISTING SECTION 6E CONSISTS OF A SPARE BUCKET THAT WILL NOT BE DUPLICATED IN THE NEW MCC-10.
- EXISTING SECTION 6F CONSISTS OF A SPARE BUCKET THAT WILL NOT BE DUPLICATED IN THE NEW MCC-10.
- PROPOSED MOTOR CONTROL CENTER 'MCC-10'. REFER ALSO TO SPECIFICATIONS.
- (26) SECTION 1A SHALL CONSIST OF A SPARE BUCKET.
- SECTION 1B SHALL CONSIST OF A SURGE PROTECTION DEVICE (SPD).
- SECTION 1C SHALL CONTAIN A 3-POLE, 800A, MAIN CIRCUIT BREAKER THAT SHALL BE FED FROM SWITCHBOARD No. 1.
- SECTION 2A SHALL CONTAIN THE CIRCUIT BREAKERS FOR PANEL P1 TRANSFER SWITCH AND NORTH AUTO
- SECTION 2B SHALL CONTAIN THE CIRCUIT BREAKERS FOR PANEL LE TRANSFER SWITCH AND ACCU-1.
- SECTION 2C SHALL CONTAIN THE CIRCUIT BREAKERS FOR THE PLANT DRAIN PUMP STATION AND SCUM
- SECTION 2D SHALL CONTAIN THE CIRCUIT BREAKERS FOR PANEL PFC AND WEIR OPERATOR NO. 1.

KEY NOTES CONTINUED:

- 33 SECTION 2E SHALL CONSIST OF A LUG CONNECTION FOR THE MCC-9 TIE FEEDER.
- SECTION 3A SHALL CONTAIN THE CIRCUIT BREAKER AND MOTOR STARTER FOR FLASH MIXER NO. 2.
- SECTION 3B SHALL CONSIST OF A SPARE BUCKET.
- SECTION 3C SHALL CONSIST OF A SPARE BUCKET.
- SECTION 3D SHALL CONSIST OF A 3-POLE, 150A CIRCUIT BREAKER FOR THE FUTURE PLANT DRAIN PUMP
- $\langle 38 \rangle$ SECTION 4A SHALL CONSIST OF A SPARE BUCKET.
- SECTION 4B SHALL CONSIST OF THE CIRCUIT BREAKER FOR A SAMPLE PUMP.
- SECTION 4C SHALL CONSIST OF THE CIRCUIT BREAKER

FOR MCC-6 (BELT PRESS EAST).

- THE CONTRACTOR SHALL PROVIDE A 24" X 20" X 20" STAINLESS STEEL JUNCTION BOX TO BE UTILIZED TO REROUTE THE ASSOCIATED CONDUCTORS FOR THE PANEL P1 TRANSFER SWITCH, THE NORTH AUTO BACK WASH, THE PANEL LE TRANSFER SWITCH, ACCU-1, AND WEIR OPERATOR NO. 1, ETC.. AS THE EXISTING CONDUCTORS WILL NOT REACH THE NEW LOCATION OF THEIR ASSOCIATED CIRCUIT BREAKER OF STARTER, THE CONTRACTOR SHALL INSTALL 600V, POWER DISTRIBUTION BLOCKS (AMPACITY AS REQUIRED) FOR THE TERMINATION OF THE EXISTING CONDUCTORS AND THE INSTALLATION OF THE NEW CONDUCTORS.
- THE CONTRACTOR SHALL PROVIDE CONDUITS AS REQUIRED FOR THE NEW CONDUCTORS TO BE INSTALLED IN KEYED NOTE #41.
- THE CONTRACTOR SHALL PROVIDE AND INSTALL 3-#600 kcmil THWN CU + 1/0 THWN CU GND. IN 4" CONDUIT TO THE NEW MCC-9 FOR THE TIE FEEDER. CONTRACTOR SHALL FIELD ROUTE CONDUIT AS REQUIRED. REFER ALSO TO MCC-9 ELEVATION ON SHEET E-12.

GENERAL NOTES:

- 1. THE CONTRACTOR SHALL NOT COMMENCE INSTALLATION OF THE TEMPORARY FEEDERS, THE DISCONNECTION OF THE THE 480V POWER FEEDERS TO MCC-5 AND MCC-6, OR THE INSTALLATION OF MCC-9 AND MCC-10 UNTIL THE CENTRAL PUMP BACK STATION TO BE INSTALLED AS PART OF THIS CONTRACT IS COMPLETE, TESTED AND ACCEPTED BY MANATEE COUNTY.
- 2. THE CONTRACTOR SHALL NOTIFY MANATEE COUNTY IN WRITING A MINIMUM OF ONE (1) WEEK IN ADVANCE OF ANY PROPOSED SHUTDOWN OF MCC-9 OR MCC-10. THE CONTRACTOR SHALL NOT COMMENCE SHUTDOWNS WITHOUT WRITTEN APPROVAL OF MANATEE COUNTY.



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PHONE: 813-620-1460

WWW.KIMLEY-HORN.COM CA 00000696

148400015 DATE 6/26/19 SCALE AS SHOWN ESIGNED BY TDT 655 NORTH FRANKLIN STREET, SUITE 150, TAMPA, FL 33602 DRAWN BY

KHA PROJECT

CHECKED BY

TDT | MANATEE COUNTY

SEWRF RECLAIMED PUMP BACK STATION

TIMOTHY THOMAS, P.E FL LICENSE NUMBER 47079


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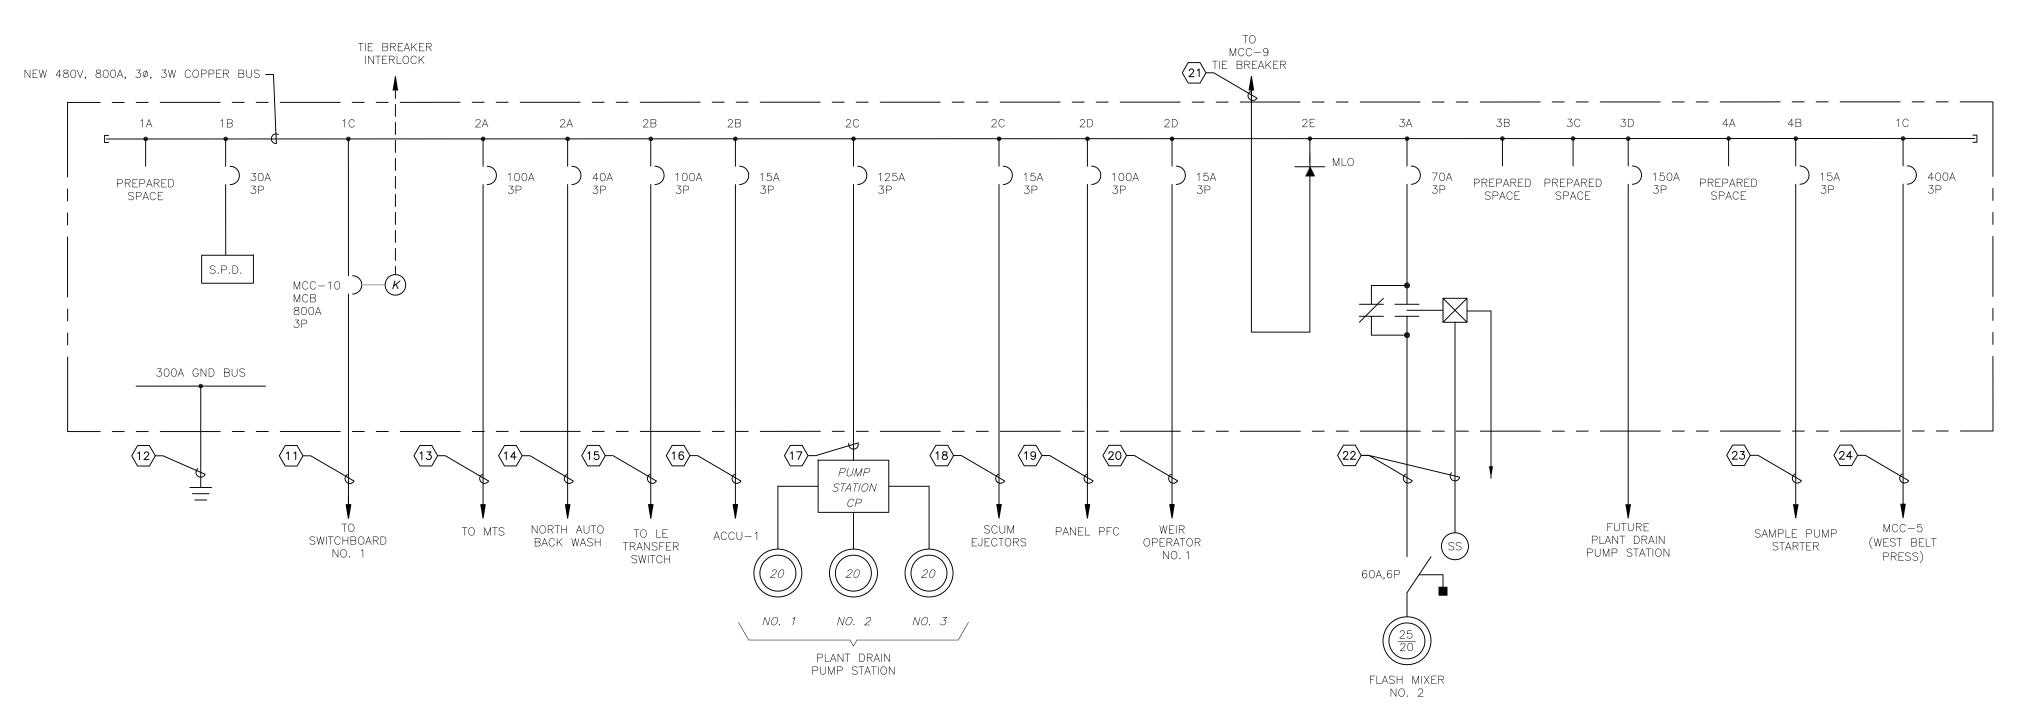
MCC-10 ELEVATION AND DETAILS

E-13

SHEET NUMBER



NEW MOTOR CONTROL CENTER 'MCC-9' ONE-LINE DIAGRAM

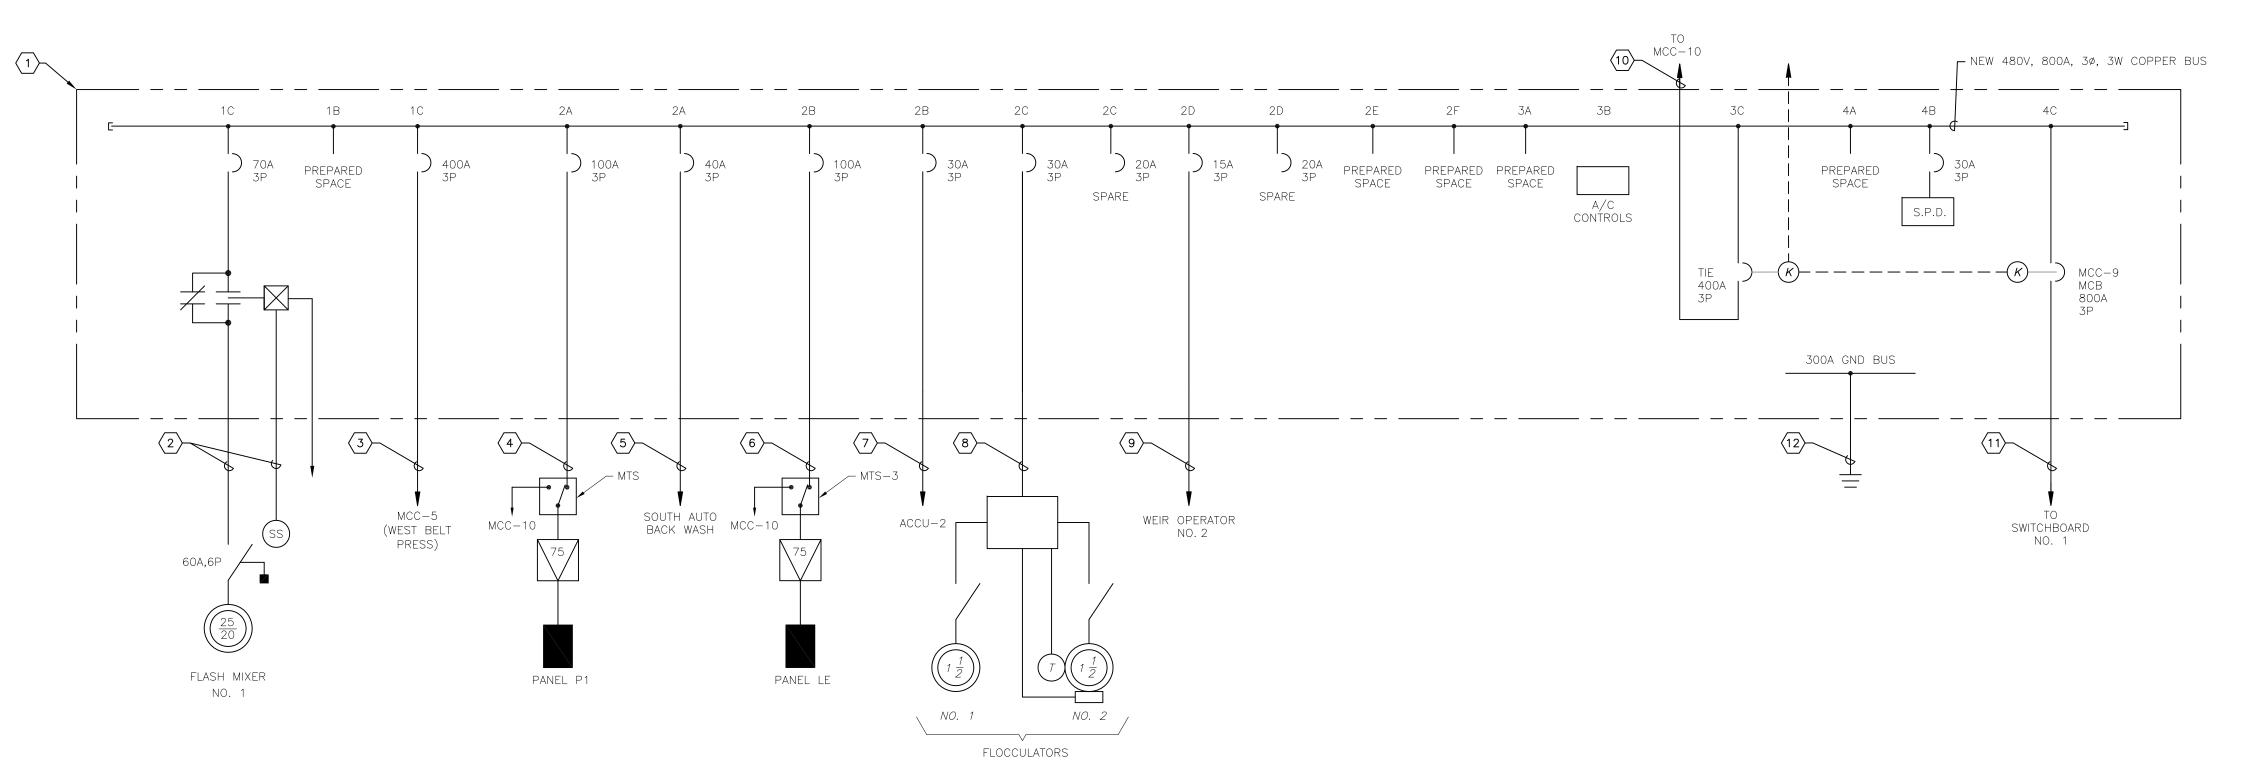

NEW MOTOR CONTROL CENTER 'MCC-10' ONE-LINE DIAGRAM



KEY NOTES:

1 NEW MOTOR CONTROL CENTER 'MCC-9'.

 $\sqrt{7}$ 3-#10 + 1-#10 IN 1"C. FOR ACCU-2.

FLASH MIXER NO. 1.

PRESS WEST).

CONTROL PANEL.

SWITCHBOARD No. 1.

 $\langle 12 \rangle$ #1/0 GROUND TO GROUND GRID.

(16) 3-#10 + 1-#10 IN 1"C. FOR ACCU-1.

PLANT DRAIN PUMP STATION.

CIRCUIT BREAKER.

FLASH MIXER NO. 2.

PRESS EAST).

GENERAL NOTES:

BRËAKER.

2 3-#6 + 1-#8 GND + 4-#12 IN 1-1/4"C. FOR

3 3-#600 MCM + 1-#2 IN 4"C. FOR MCC-5 (BELT

4 3-#3 + 1-#8 IN 1-1/4"C. FOR PANEL P1 TRANSFER

5 3-#8 + 1-#10 IN 1-1/4"C. FOR SOUTH AUTO BACK

6 3-#3 + 1-#8 IN 1-1/4"C. FOR PANEL LE TRANSFER

8 3-#8 + 1-#10 IN 1-1/4"C. FOR THE FLOCCULATOR

9 3-#10 + 1-#10 IN 1"C. FOR WEIR OPERATOR NO. 2.

3-#500 MCM + 1-#3 IN 4"C. FOR 400A TIE CIRCUIT

TWO (2) PARALLEL RUNS OF 3-#500 MCM + 1-#3 IN 4"C. FOR 800A MAIN CIRCUIT BREAKER FED FROM

3-#3 + 1-#8 IN 1-1/4°C. FOR PANEL P1 TRANSFER

 $\langle 15 \rangle$ 3-#3 + 1-#8 IN 1-1/4"C. FOR PANEL LE TRANSFER

3-#1/0 + 1-#6 IN 1-1/2°C. FOR THE EXISTING

 $\langle 18 \rangle$ 3-#10 + 1-#10 IN 1"C. FOR THE SCUM EJECTORS.

 $\langle 20 \rangle$ 3-#10 + 1-#10 IN 1"C. FOR WEIR OPERATOR NO. 1.

21) 3-#500 MCM + 1-#3 IN 4"C. TO THE 400A TIE

(22) 3-#6 + 1-#8 GND + 4-#12 IN 1-1/4"C. FOR

23 3-#10 + 1-#10 IN 1"C. FOR THE SAMPLE PUMP.

24 3-#600 MCM + 1-#2 IN 4"C. FOR MCC-6 (BELT


1. THE CONDUIT AND CONDUCTOR INFORMATION PRESENTED HERE IS DERIVED FROM BEST AVAILABLE RECORD DRAWINGS. EXISTING CONDITIONS MAY NOT REFLECT WHAT IS DEPICTED. THE CONTRACTOR SHALL FIELD VERIFY THE EXISTING CONDITIONS AND NOTIFY THE


ENGINEER OF ANY DISCREPANCIES PRIOR TO ORDERING MATERIALS OR COMMENCING WORK.

 $\sqrt{19}$ 3-#3 + 1-#8 IN 1-1/4"C. FOR PANEL PFC.

3-#8 + 1-#10 IN 1-1/4°C. FOR NORTH AUTO BACK

KHA PROJECT 148400015 Kimley» Horn LICENSED PROFESSIONAL SHEET NUMBER DATE 6/26/19 MCC-9 AND MCC-10 TIMOTHY THOMAS, P.E SCALE AS SHOWN SEWRF RECLAIMED E-14 © 2018 KIMLEY-HORN AND ASSOCIATES, INC. ONE-LINE DIAGRAMS FL LICENSE NUMBER ESIGNED BY 655 NORTH FRANKLIN STREET, SUITE 150, TAMPA, FL 33602 PUMP BACK STATION PHONE: 813-620-1460 WWW.KIMLEY-HORN.COM CA 00000696 FL DATE: DATE BY TDT MANATEE COUNTY **REVISIONS**

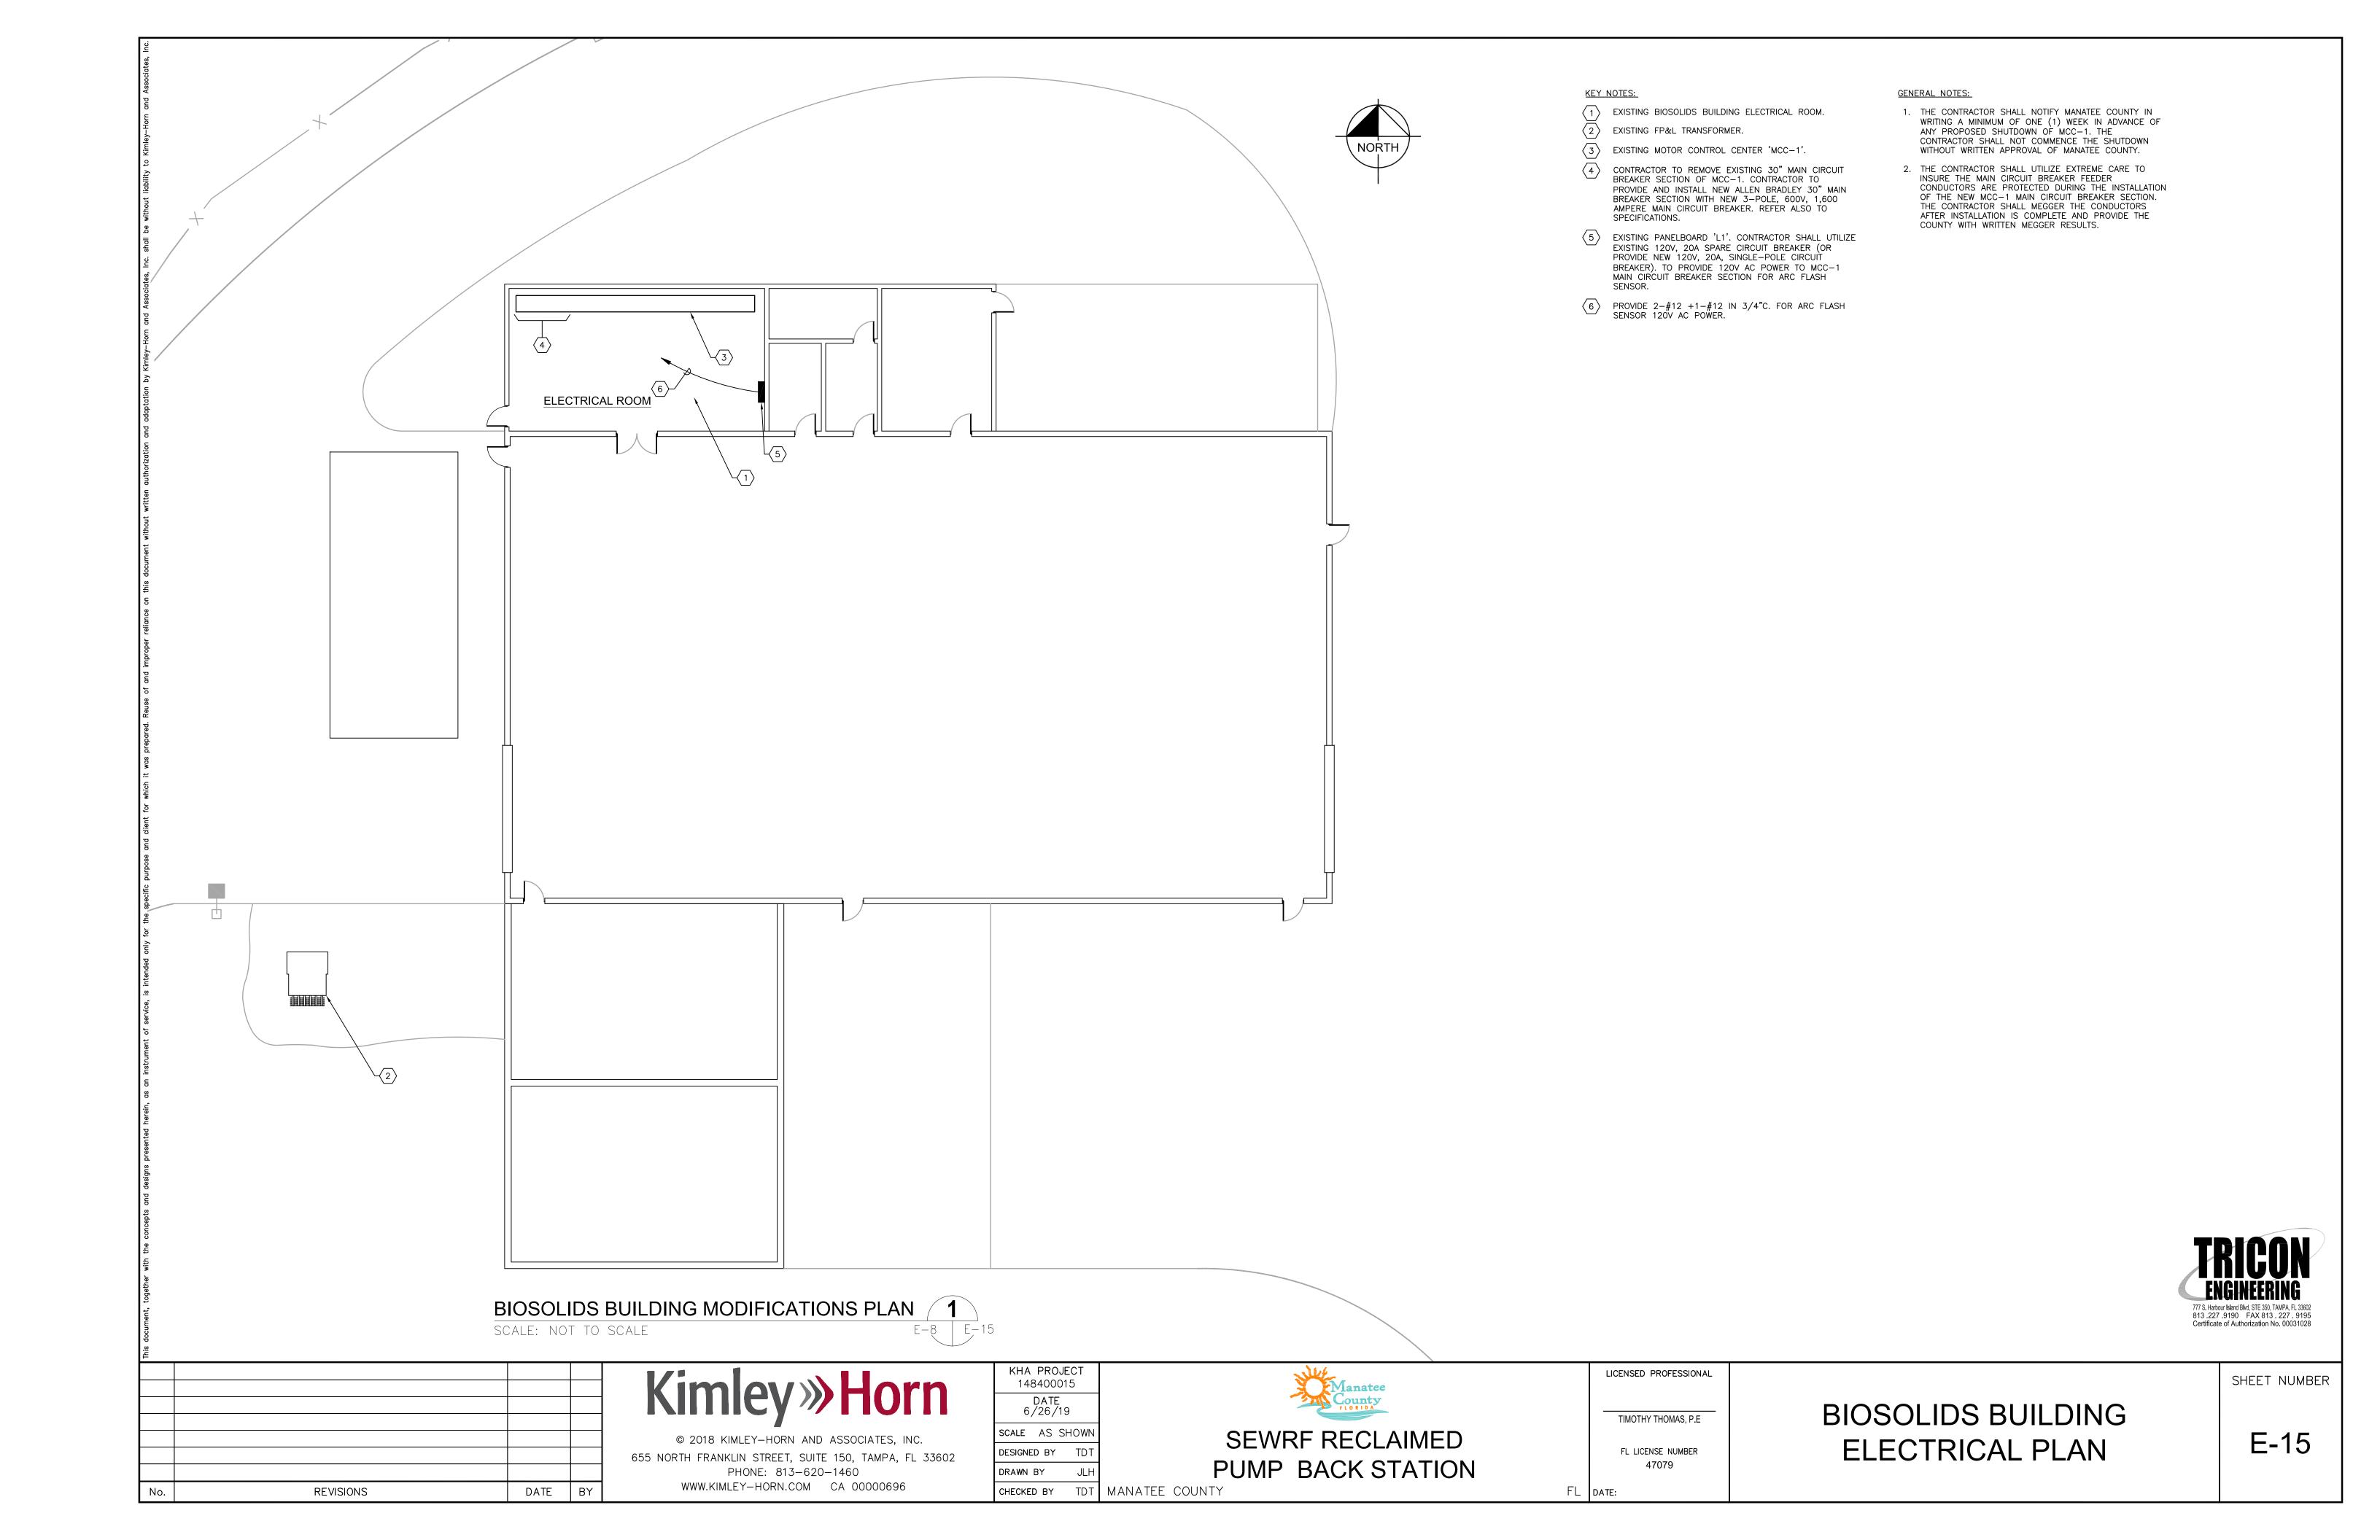

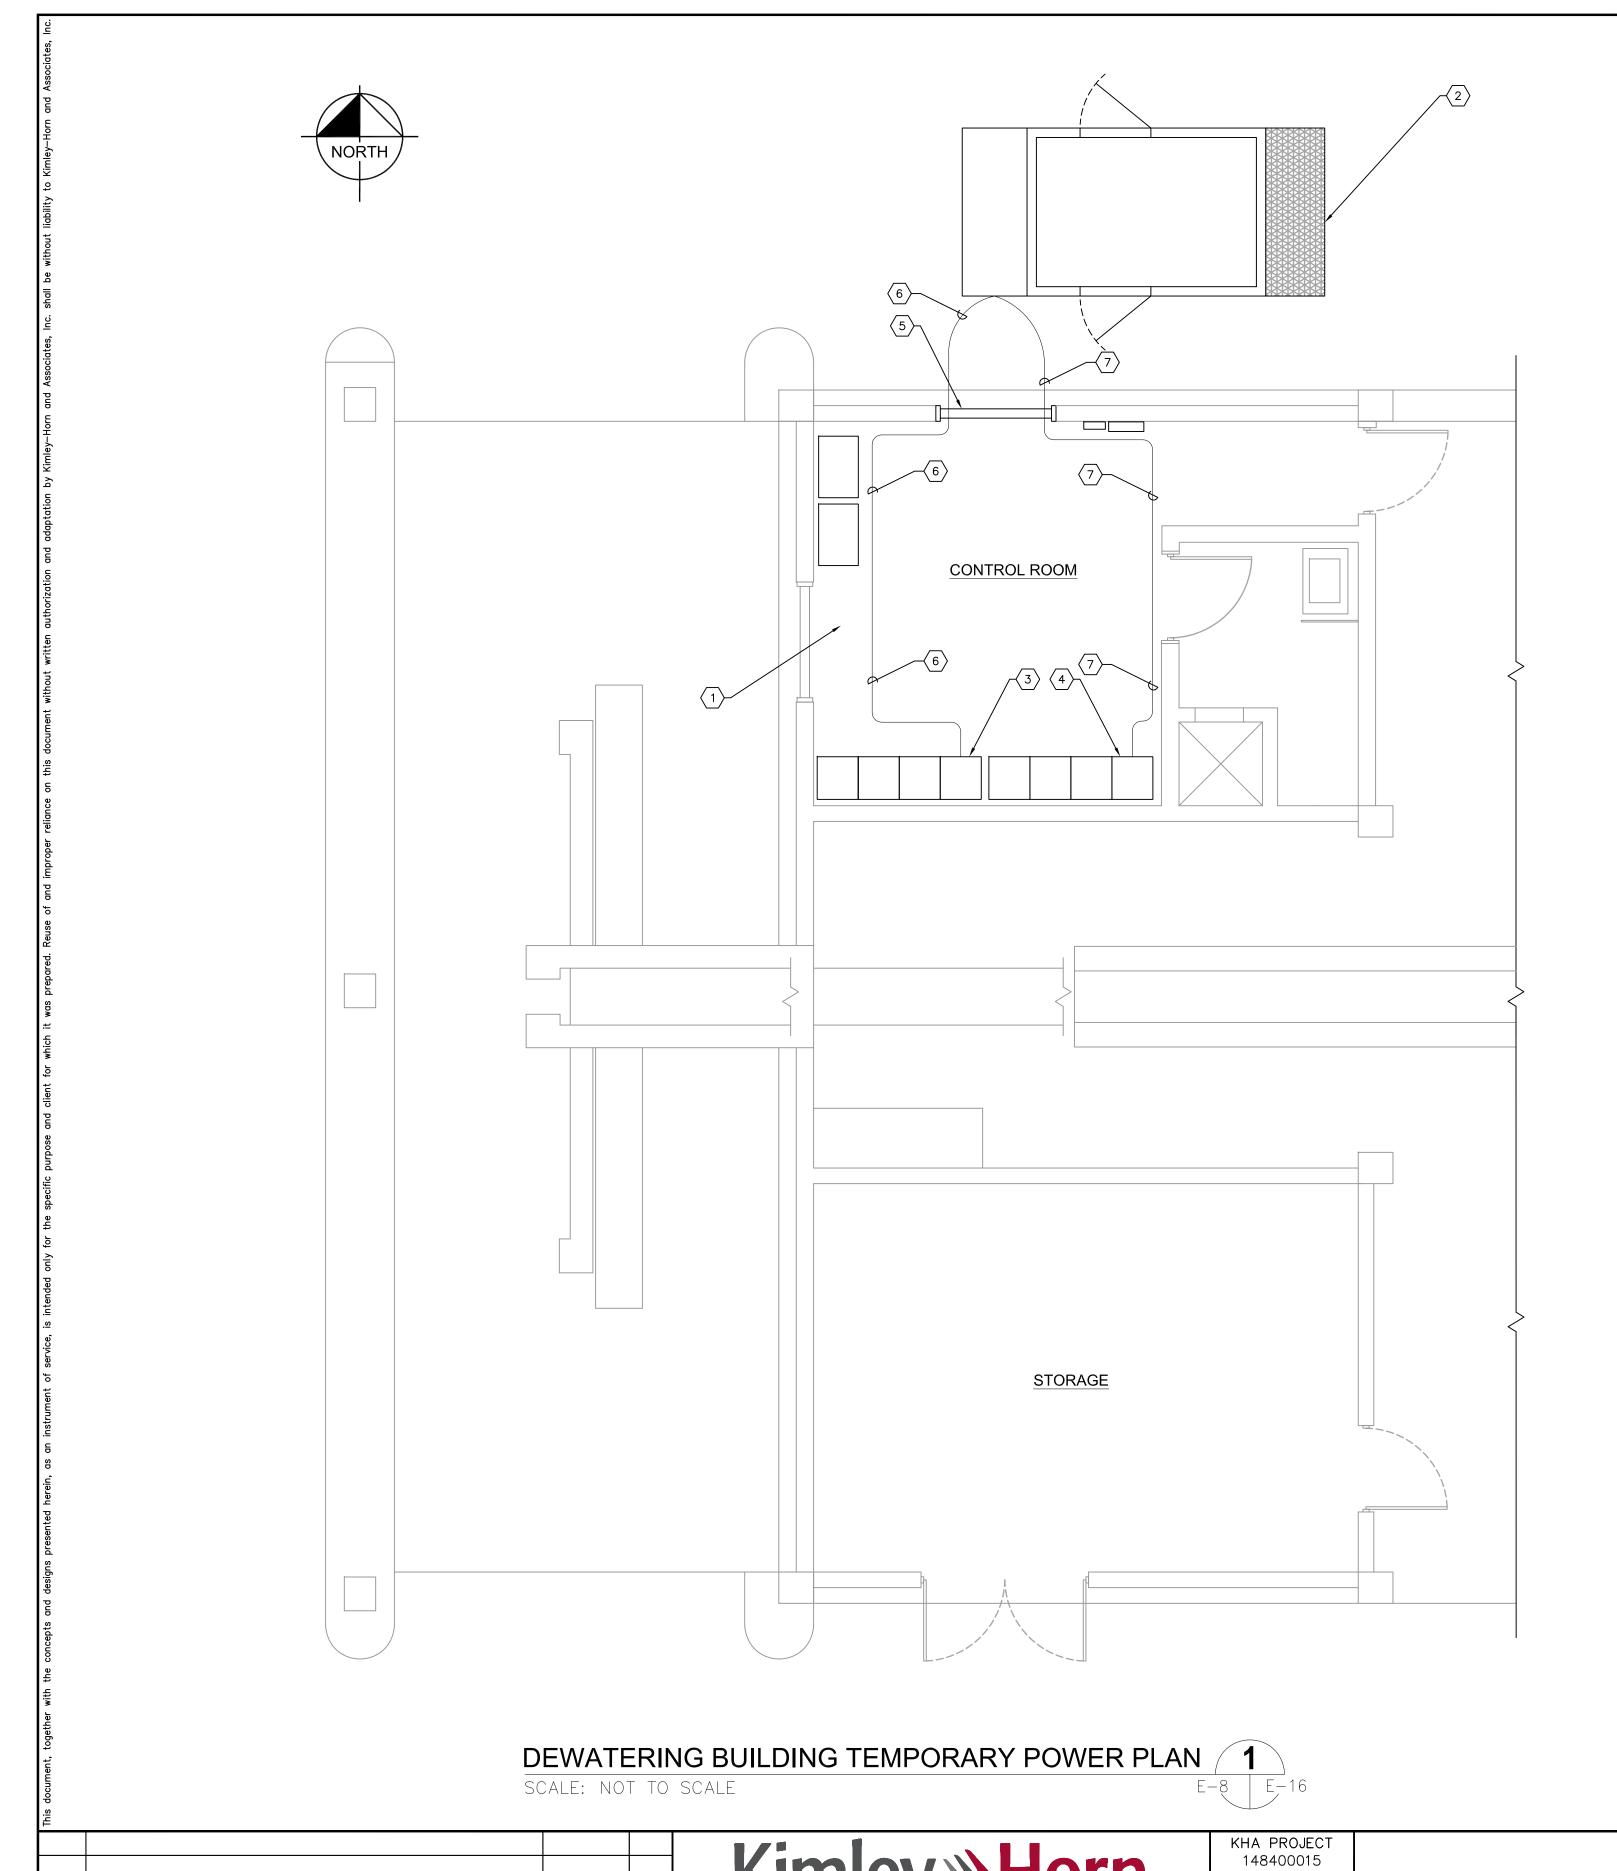

 $\langle 1 \rangle$ EXISTING DEWATERING BUILDING CONTROL ROOM.

CONTRACTOR TO PROVIDE TEMPORARY 400 KW, 480V, 3-PHASE, 3-WIRE GENERATOR TO PROVIDE POWER TO MCC-5 AND MCC-6 DURING REPLACEMENT OF MCC-9 AND MCC-10. TEMPORARY GENERATOR SHALL BE CONTRACTOR OWNED OR RENTAL, BUT THE UNIT MUST BE PROVIDED IN WEATHERPROOF, SOUND- ATTENUATED ENCLOSURE AND MUST HAVE TWO (2) INDIVIDUAL 300 AMPERE CIRCUIT BREAKERS TO POWER THE INDIVIDUAL MOTOR CONTROL CENTERS.

- EXISTING MOTOR CONTROL CENTER 'MCC-5'. MCC-5 TO BE POWERED TEMPORARILY BY GENERATOR IN KEYED NOTE #2 DURING THE REPLACEMENT OF MCC-9 AND MCC-10." CONTRACTOR SHALL TEMPORARILY DISCONNECT 480V FEEDER CONDUCTORS FROM MCC-9 AND FEED MOTOR CONTROL CENTER FROM TEMPORARY GENERATOR IN KEYED NOTE #2.
- EXISTING MOTOR CONTROL CENTER 'MCC-6'. MCC-6 TO BE POWERED TEMPORARILY BY GENERATOR IN KEYED NOTE #2 DURING THE REPLACEMENT OF MCC-9 AND MCC-10. CONTRACTOR SHALL TEMPORARILY DISCONNECT 480V FEEDER CONDUCTORS FROM MCC-10 AND FEED MOTOR CONTROL CENTER FROM TEMPORARY GENERATOR IN KEYED NOTE #2.
- EXISTING WINDOW ON NORTH WALL OF DEWATERING BUILDING CONTROL ROOM. CONTRACTOR SHALL TEMPORARILY REMOVE EXISTING SCREEN AND OPEN WINDOW AS REQUIRED TO FEED TEMPORARY CONDUCTORS FROM GENERATOR TO ASSOCIATED MOTOR CONTROL CENTER. CONTRACTOR SHALL PROTECT WINDOW AS REQUIRED IN ORDER TO INSURE TEMPORARY CONDUCTOR INSTALLATION DOES NOT DAMAGE THE WINDOW. AFTER THE INSTALLATION AND ACCEPTANCE OF MCC-9 AND MCC-10, THE CONTRACTOR SHALL BE RESPONSIBLE FOR REPLACING THE WINDOW SCREEN.
- CONTRACTOR TO PROVIDE AND INSTALL TEMPORARY CONDUCTORS. 600V, COPPER CONDUCTORS CONSISTING OF 3-#350 kcmil + 1-#4 GND FROM TEMPORARY GENERATOR TO MCC-5. CONTRACTOR SHALL CONNECT TEMPORARY CONDUCTORS TO LINE SIDE OF MCC-5 MAIN CIRCUIT BREAKER. REFER ALSO TO KEYED NOTE
- CONTRACTOR TO PROVIDE AND INSTALL TEMPORARY CONDUCTORS. 600V, COPPER CONDUCTORS CONSISTING OF 3-#350 kcmil + 1-#4 GND FROM TEMPORARY GENERATOR TO MCC-6. CONTRACTOR SHALL CONNECT TEMPORARY CONDUCTORS TO LINE SIDE OF MCC-6 MAIN CIRCUIT BREAKER. REFER ALSO TO KEYED NOTE

GENERAL NOTES:

- 1. THE CONTRACTOR SHALL NOT COMMENCE INSTALLATION OF THE TEMPORARY FEEDERS, THE DISCONNECTION OF THE THE 480V POWER FEEDERS FROM MCC-9 AND MCC-10, OR THE INSTALLATION OF MCC-9 AND MCC-10 UNTIL THE CENTRAL PUMP BACK STATION TO BE INSTALLED AS PART OF THIS CONTRACT IS COMPLETE, TESTED AND ACCEPTED BY MANATEE COUNTY.
- 2. THE CONTRACTOR SHALL FIELD ROUTE THE TEMPORARY CONDUCTORS FROM THE TEMPORARY GENERATOR TO MCC-5 AND MCC-6. ROUTE SHALL AVOID TRIPPING HAZARD AS MUCH AS POSSIBLE. COORDINATE ROUTING /LOCATION WITH MANATEE COUNTY.
- 3. THE TEMPORARY GENERATOR SHALL NOT BLOCK VEHICULAR TRAFFIC. CONTRACTOR SHALL PROVIDE A PROPOSED LOCATION TO THE ENGINEER/COUNTY PRIOR TO DELIVERY. THE PROPOSED LOCATION MUST BE APPROVED BY THE ENGINEER/COUNTY PRIOR TO DELIVERY TO THE SITE.
- 4. THE CONTRACTOR SHALL NOTIFY MANATEE COUNTY IN WRITING A MINIMUM OF ONE (1) WEEK IN ADVANCE OF ANY PROPOSED SHUTDOWN OF MCC-5 OR MCC-6. THE CONTRACTOR SHALL NOT COMMENCE SHUTDOWNS WITHOUT WRITTEN APPROVAL OF MANATEE COUNTY.

Certificate of Authorization No. 00031028

DATE BY **REVISIONS**

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DATE 6/26/19 SCALE AS SHOWN DESIGNED BY 655 NORTH FRANKLIN STREET, SUITE 150, TAMPA, FL 33602

TDT MANATEE COUNTY

SEWRF RECLAIMED PUMP BACK STATION

TIMOTHY THOMAS, P.E


FL DATE:

LICENSED PROFESSIONAL


FL LICENSE NUMBER

DEWATERING BUILDING **TEMPORARY** POWER PLAN

SHEET NUMBER

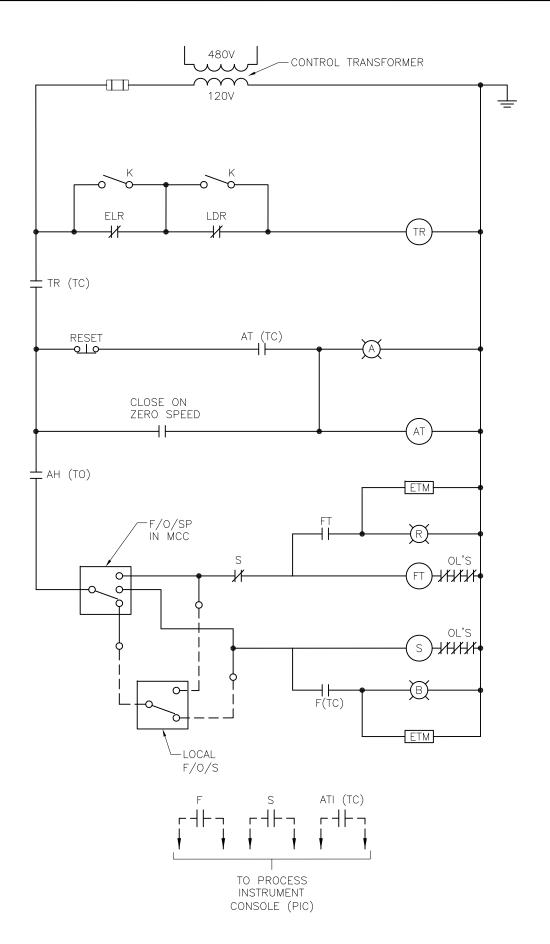

TYPICAL FLASH MIXER
MOTOR CONTROL WIRING DIAGRAM

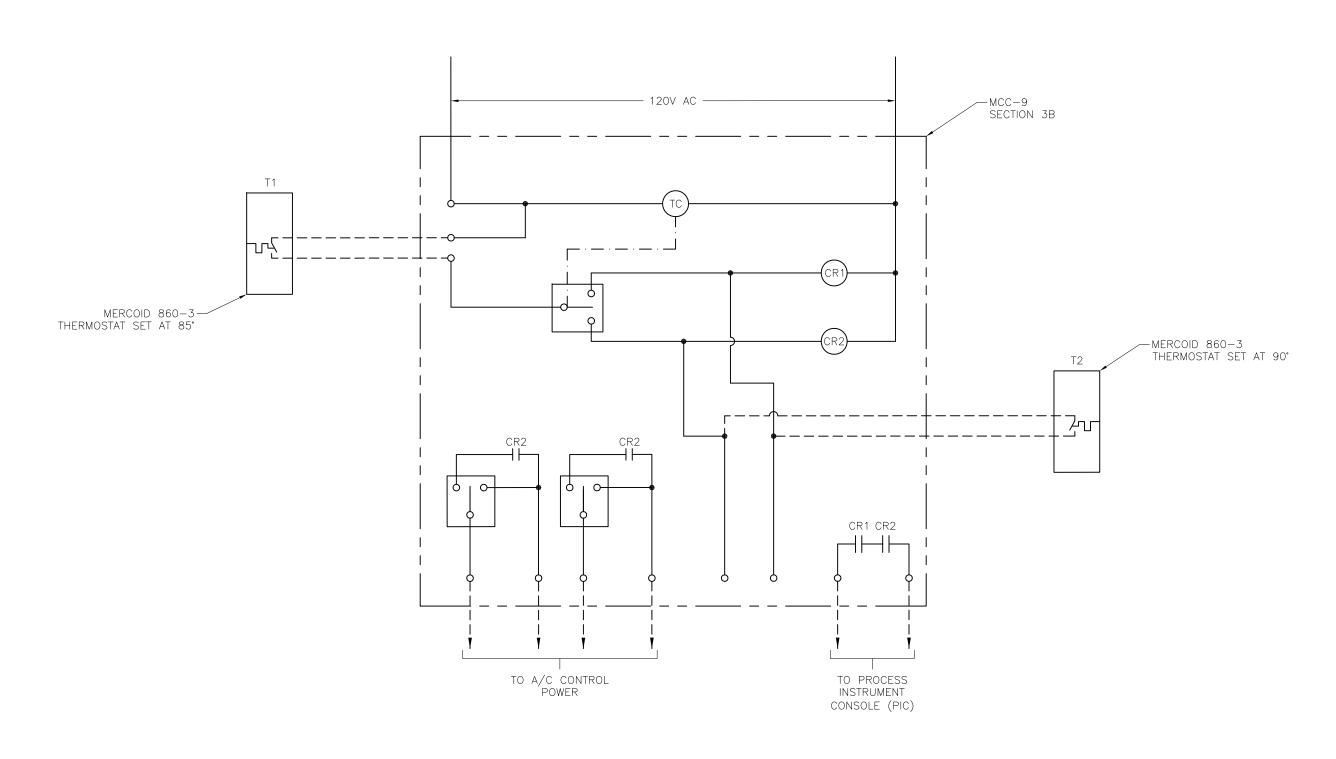

ELECTRICAL ROOM A/C CONTROLS WIRING DIAGRAM



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148400015							
DATE 6/26/19							
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DESIGNE	D BY	TDT					
DRAWN	BY	JLH					

CHECKED BY TOT MANATEE COUNTY

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LICENSED PROFESSIONAL
TIMOTHY THOMAS, P.E
FL LICENSE NUMBER 47079

FL DATE:

WIRING DIAGRAMS

GENERAL NOTES:


COMMENCING WORK.

1. THE WIRING DIAGRAMS PRESENTED HERE ARE DERIVED FROM THE BEST AVAILABLE RECORD DRAWINGS. EXISTING CONDITIONS MAY NOT REFLECT WHAT IS DEPICTED. THE CONTRACTOR SHALL FIELD VERIFY THE EXISTING CONDITIONS AND NOTIFY THE ENGINEER OF ANY DISCREPANCIES PRIOR TO ORDERING MATERIALS OR

SHEET NUMBER

FUNCTION SYMBOL SCHEDULE

		IDENTIF	TICATION LETTER	S	
	FIRST L	ETTER		SUCCEEDING LETTERS	
	MEASURED OR INITIATING VARIABLE	MODIFIER	READOUT OR PASSIVE FUNCTION	OUTPUT FUNCTION	MODIFIER
Α	ANALYSIS		ALARM		
В	BURNER, COMBUSTION		PROGRAMMER		
С	CONDUCTIVITY			CONTROL	CLOSED
D	DENSITY	DIFFERENTIAL			
Ε	VOLTAGE		SENSOR (PRIMARY ELEMENT)		
F	FLOW RATE	RATIO (FRACTION)			
G	GAGING		GLASS VIEWING DEVICE		
Н	HAND				HIGH
1	CURRENT (ELECTRICAL)		INDICATE		
J	POWER	SCAN			
K	TIME, TIME SCHEDULE	TIME RATE OF CHANGE		CONTROL STATION	
L	LEVEL		LIGHT (PILOT)		LOW
М	MOTOR	MOMENTARY			MIDDLE, INTERMEDIATE
Ν	VIBRATION		IGNITOR	ISOLATOR	
0	OPERATION	OFFSET	ORIFICE, RESTRICTION		OPEN
Р	PRESSURE, VACUUM		POINT (TEST) CONNECTION		
Q	QUANTITY, EVENT	INTEGRATE, TOTALIZE	INTEGRATE		
R	RADIATION		RECORD, PRINT		
S	SPEED, FREQUENCY	SAFETY		SWITCH	
Т	TEMPERATURE			TRANSMIT	
U	MULTIVARIABLE	TREND	MULTIFUNCTION	MULTIFUNCTION	MULTIFUNCTIO
V	VISCOSITY	VACUUM		VALVE, DAMPER, LOUVER, GATE	
W	WEIGHT, FORCE, TORQUE		WELL		
Χ	UNCLASSIFIED		UNCLASSIFIED	UNCLASSIFIED	UNCLASSIFIED
Υ				RELAY, COMPUTE, CONVERT	
Z	POSITION			FINAL CONTROL ELEMEN	T UNCLASSIFIED

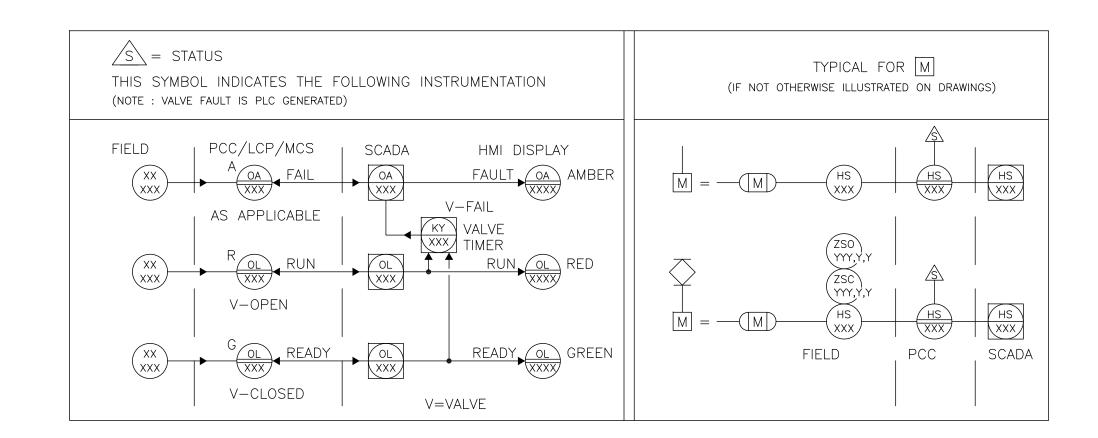

MISCELLANEOUS NOTATIONS LINE DESIGNATIONS

INSTRUMENTATION SIGNAL	
ELECTRICAL POWER	·
DATA LINK	— D —— D —
RADIO LINK	— R —— R —
FIBER OPTIC DATA	— F —— F —

CONTROLLER NOTATION

PV= PROCESS VARIABLE INPUT SP= SET POINT INPUT C= CONTROL OUTPUT

INPUT/OUTPUT NOTATIONS

AI = ANALOG INPUT AO = ANALOG OUTPUT DI = DISCRETE INPUT DO= DISCRETE OUTPUT

S/D = SHUTDOWN

O/R = OVERRIDE

MCS = MASTER CONTROL STATIONVFD = VARIABLE FREQUENCY DRIVE

PCC = PROCESS CONTROL CABINET LCP = LOCAL CONTROL PANEL

ES = ELECTRICAL SUPPLY (120VAC)

EQUIPMENT NOTATION

B = BLOWER OR FAN

E = ENGINE

G = GENERATOR

F = FILTER

GS = GRINDER/SCREEN

K = COMPRESSOR

H = HOIST

ME = MECHANICAL EQUIPMENT

MX = MIXER

P = PUMP

T = TANK OR SUMP

HAND SWITCH NOTATION

HOA = HAND-OFF-AUTOS/S = START/STOP

SEL = SELECTORO/C = OPEN/CLOSE

0/0 = ON/OFF

LOS = LOCKOUT-STARTLOR = LOCAL - OFF - REMOTE

OAC = OPEN-AUTO CLOSE

CAO = CLOSED-AUTO OPEN

VALVE DESIGNATIONS

MOV = MOTOR OPERATED VALVE

GENERAL ABBREVIATIONS

SCADA - SUPERVISORY CONTROL AND DATA ACQUISITION.

PLC - PROGRAMMABLE LOGIC CONTROL

SA - SURGE SUPPRESSOR DEVICE



DATA FLOW SYSTEMS RTU INPUT/OUTPUT

BASIC SYMBOLS

SINGLE FUNCTION		MUTIPLE FUNCTION	·
	OR		FIELD MOUNTED INSTRUMENT OR DEVICE
	OR		FRONT OF PANEL MOUNTED INSTRUMENT ON LCP, PCC, MCS, OR VFD
	OR		REAR OF PANEL MOUNTED INSTRUMENT ON LCP, PCC, MCS, OR VFD
	OR		FRONT OF PANEL MOUNTED INSTRUMENT ON MAIN PANEL
	OR		REAR OF PANEL MOUNTED INSTRUMENT ON MAIN PANEL
	OR		PLC AND/OR COMPUTER SOFTWARE COMPONENT (OPERATOR ACCESSIBLE UNDER NORMAL CONDITIONS) OR
	OR		PLC AND/OR COMPUTER GENERATED COMPONENT (NOT OPERATOR ACCESSIBLE UNDER NORMAL CONDITIONS)



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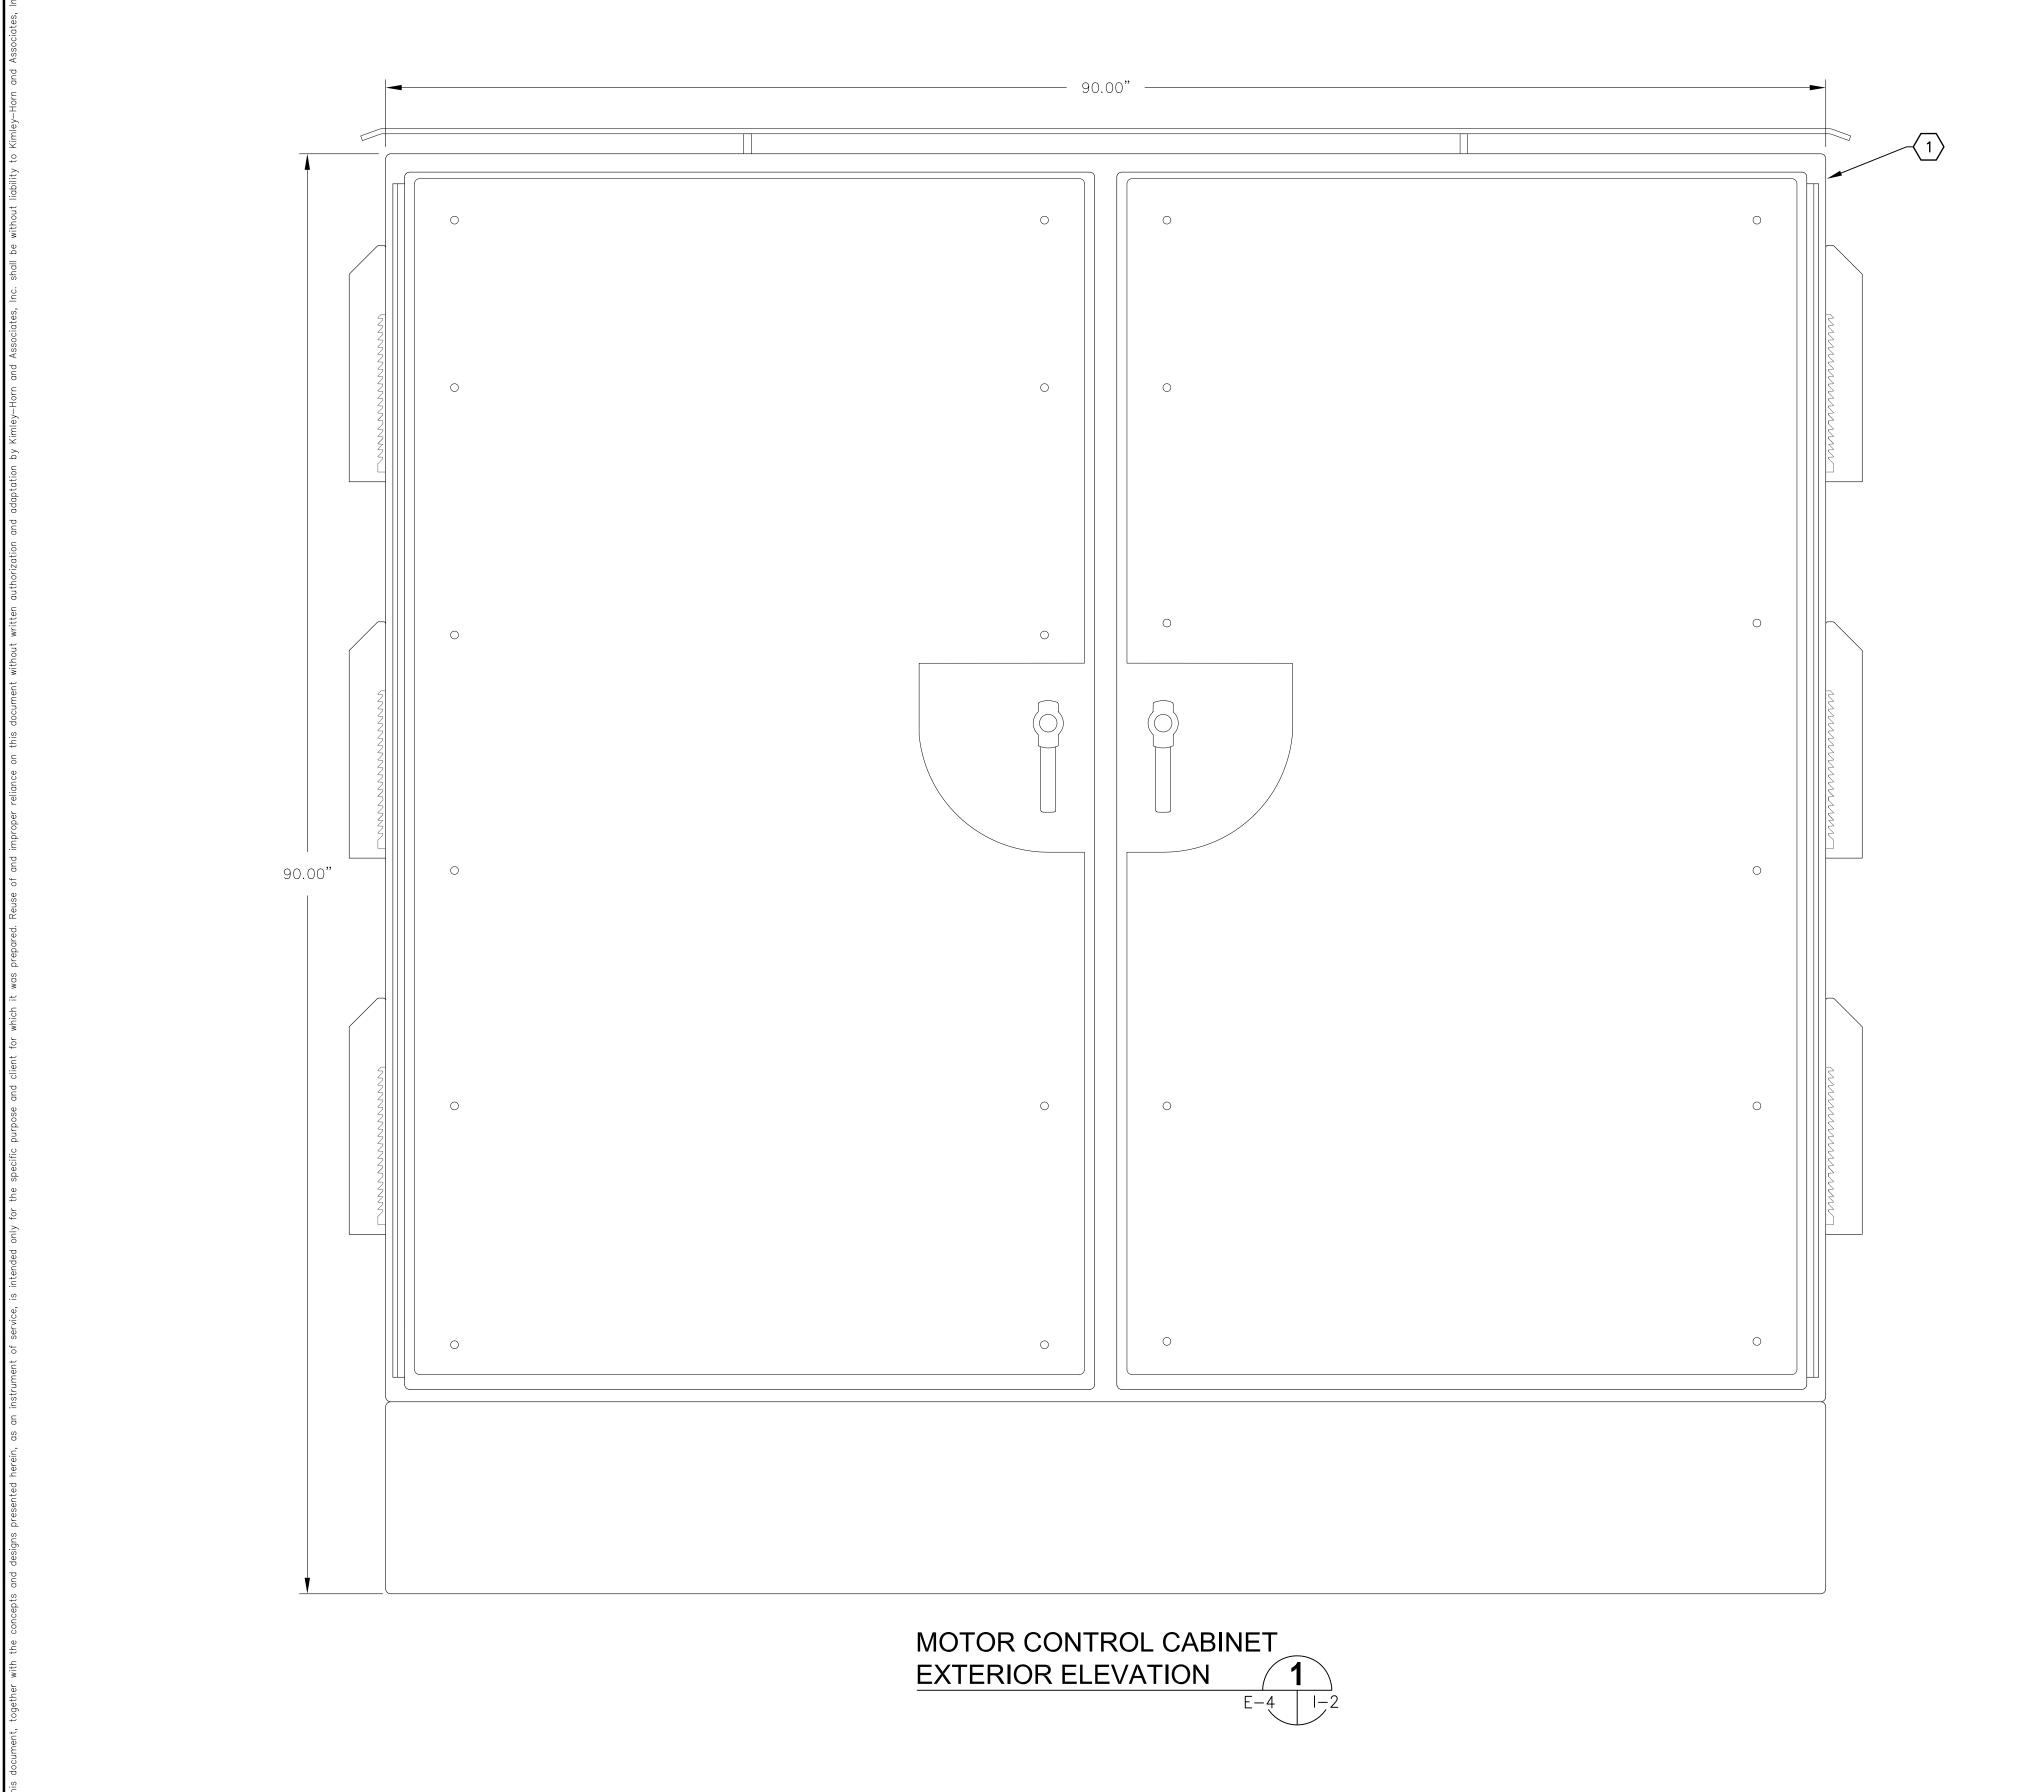
LICENSED PROFESSIONAL TIMOTHY THOMAS, P.E FL LICENSE NUMBER 47079

FL DATE:

INSTRUMENTATION LEGEND AND **ABBREVIATIONS**

SHEET NUMBER

1-1



GENERAL NOTES:

- 1. REFER TO SHEET I-5 FOR BILL OF MATERIALS.
- 2. PROVIDE AND INSTALL ALL ASSOCIATED END BARRIERS, TERMINAL JUMPERS AND SPACERS AS REQUIRED FOR TERMINAL BLOCKS AS SHOWN OR REQUIRED
- 3. PROVIDE AND INSTALL 35mm ALUMINUM DIN RAIL. QUANTITY AS REQUIRED.
- 4. PROVIDE AND INSTALL CORROSION INHIBITOR, HOFFMAN # AHCI10E.
- 5. PROVIDE AND INSTALL STAINLESS STEEL BIRD SPIKES (FOR PIGEONS OR LARGER BIRDS) TO COVER TOP OF ENCLOSURE. INSTALL BIRD SPIKES WITH NON-SILICONE BASED ADHESIVE FOR OUTDOOR CONSTRUCTION OR PER MANUFACTURER'S SPECIFICATIONS.

TRICOR
ENGINEERING

777 S. Harbour Island Blvd, STE 350, TAMPA, FL 3360,
813 .227 .9190 FAX 813 .227 .9198

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TDT MANATEE COUNTY

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TIMOTHY THOMAS, P.E


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LICENSED PROFESSIONAL

MOTOR CONTROL CABINET EXTERIOR ELEVATION

SHEET NUMBER

I-2

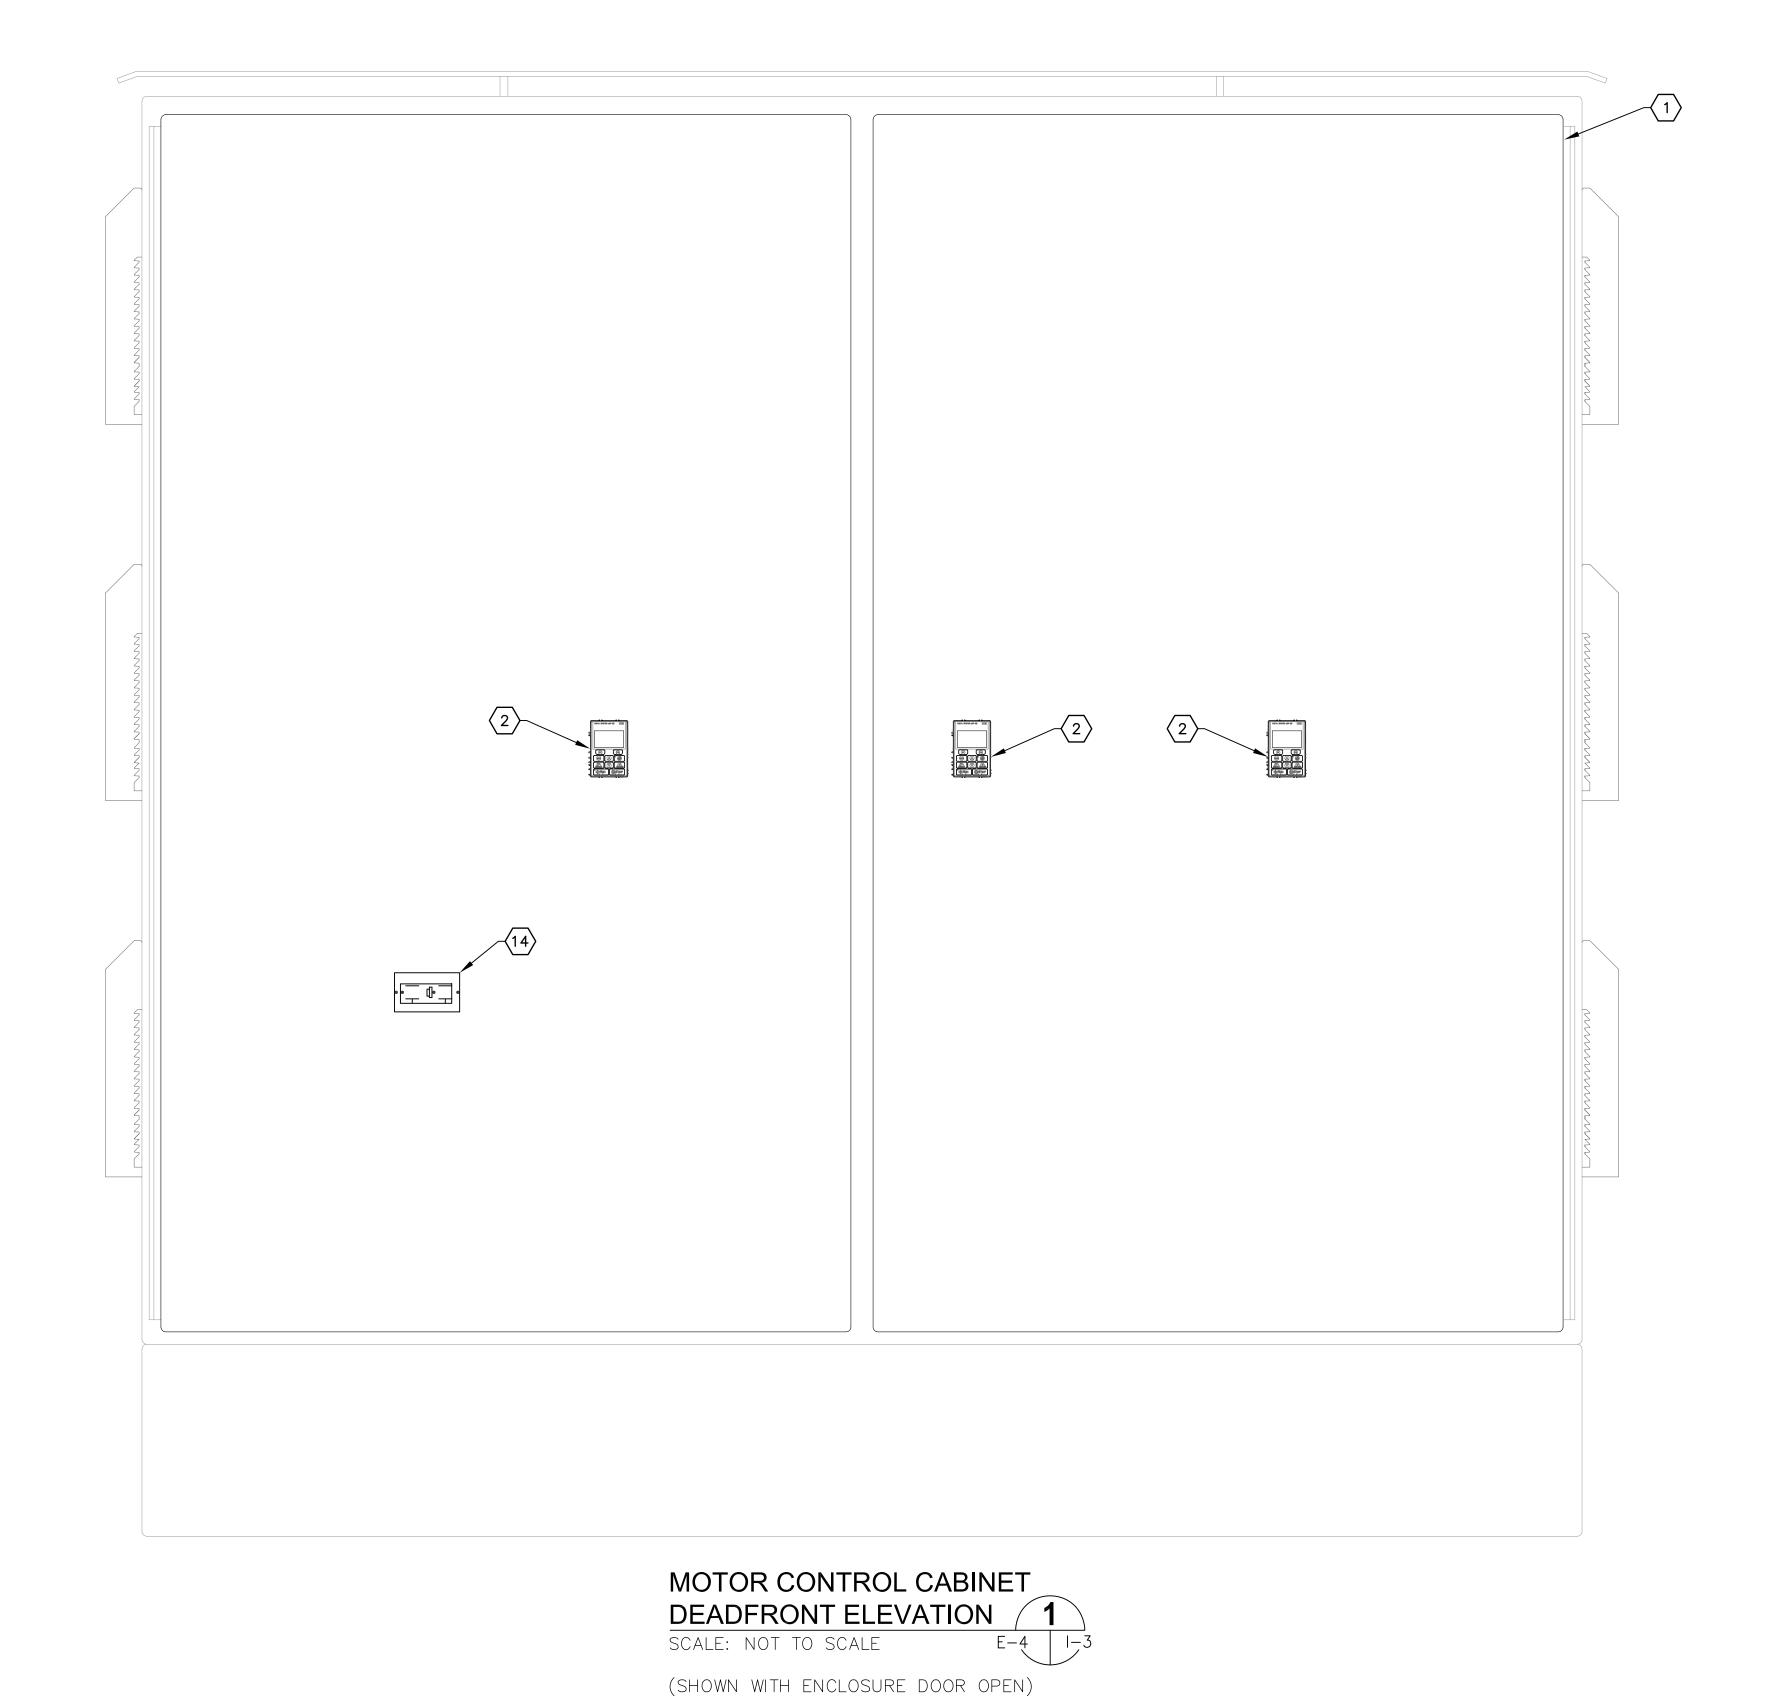

GENERAL NOTES:

- 1. REFER TO SHEET I-5 FOR BILL OF MATERIALS.
- 2. PROVIDE AND INSTALL ALL ASSOCIATED END BARRIERS, TERMINAL JUMPERS AND SPACERS AS REQUIRED FOR TERMINAL BLOCKS AS SHOWN OR REQUIRED.
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TRICOL ENGINEERING 777 S. Harbour Island Blvd, STE 350, TAMPA, FL 33602 813 .227 .9190 FAX 813 . 227 . 9195 Certificate of Authorization No. 00031028

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TDT MANATEE COUNTY

SEWRF RECLAIMED
PUMP BACK STATION

TIMOTHY THOMAS, P.E

LICENSED PROFESSIONAL


FL LICENSE NUMBER
47079

FL DATE:

MOTOR CONTROL CABINET DEADFRONT ELEVATION

SHEET NUMBER

I-2A

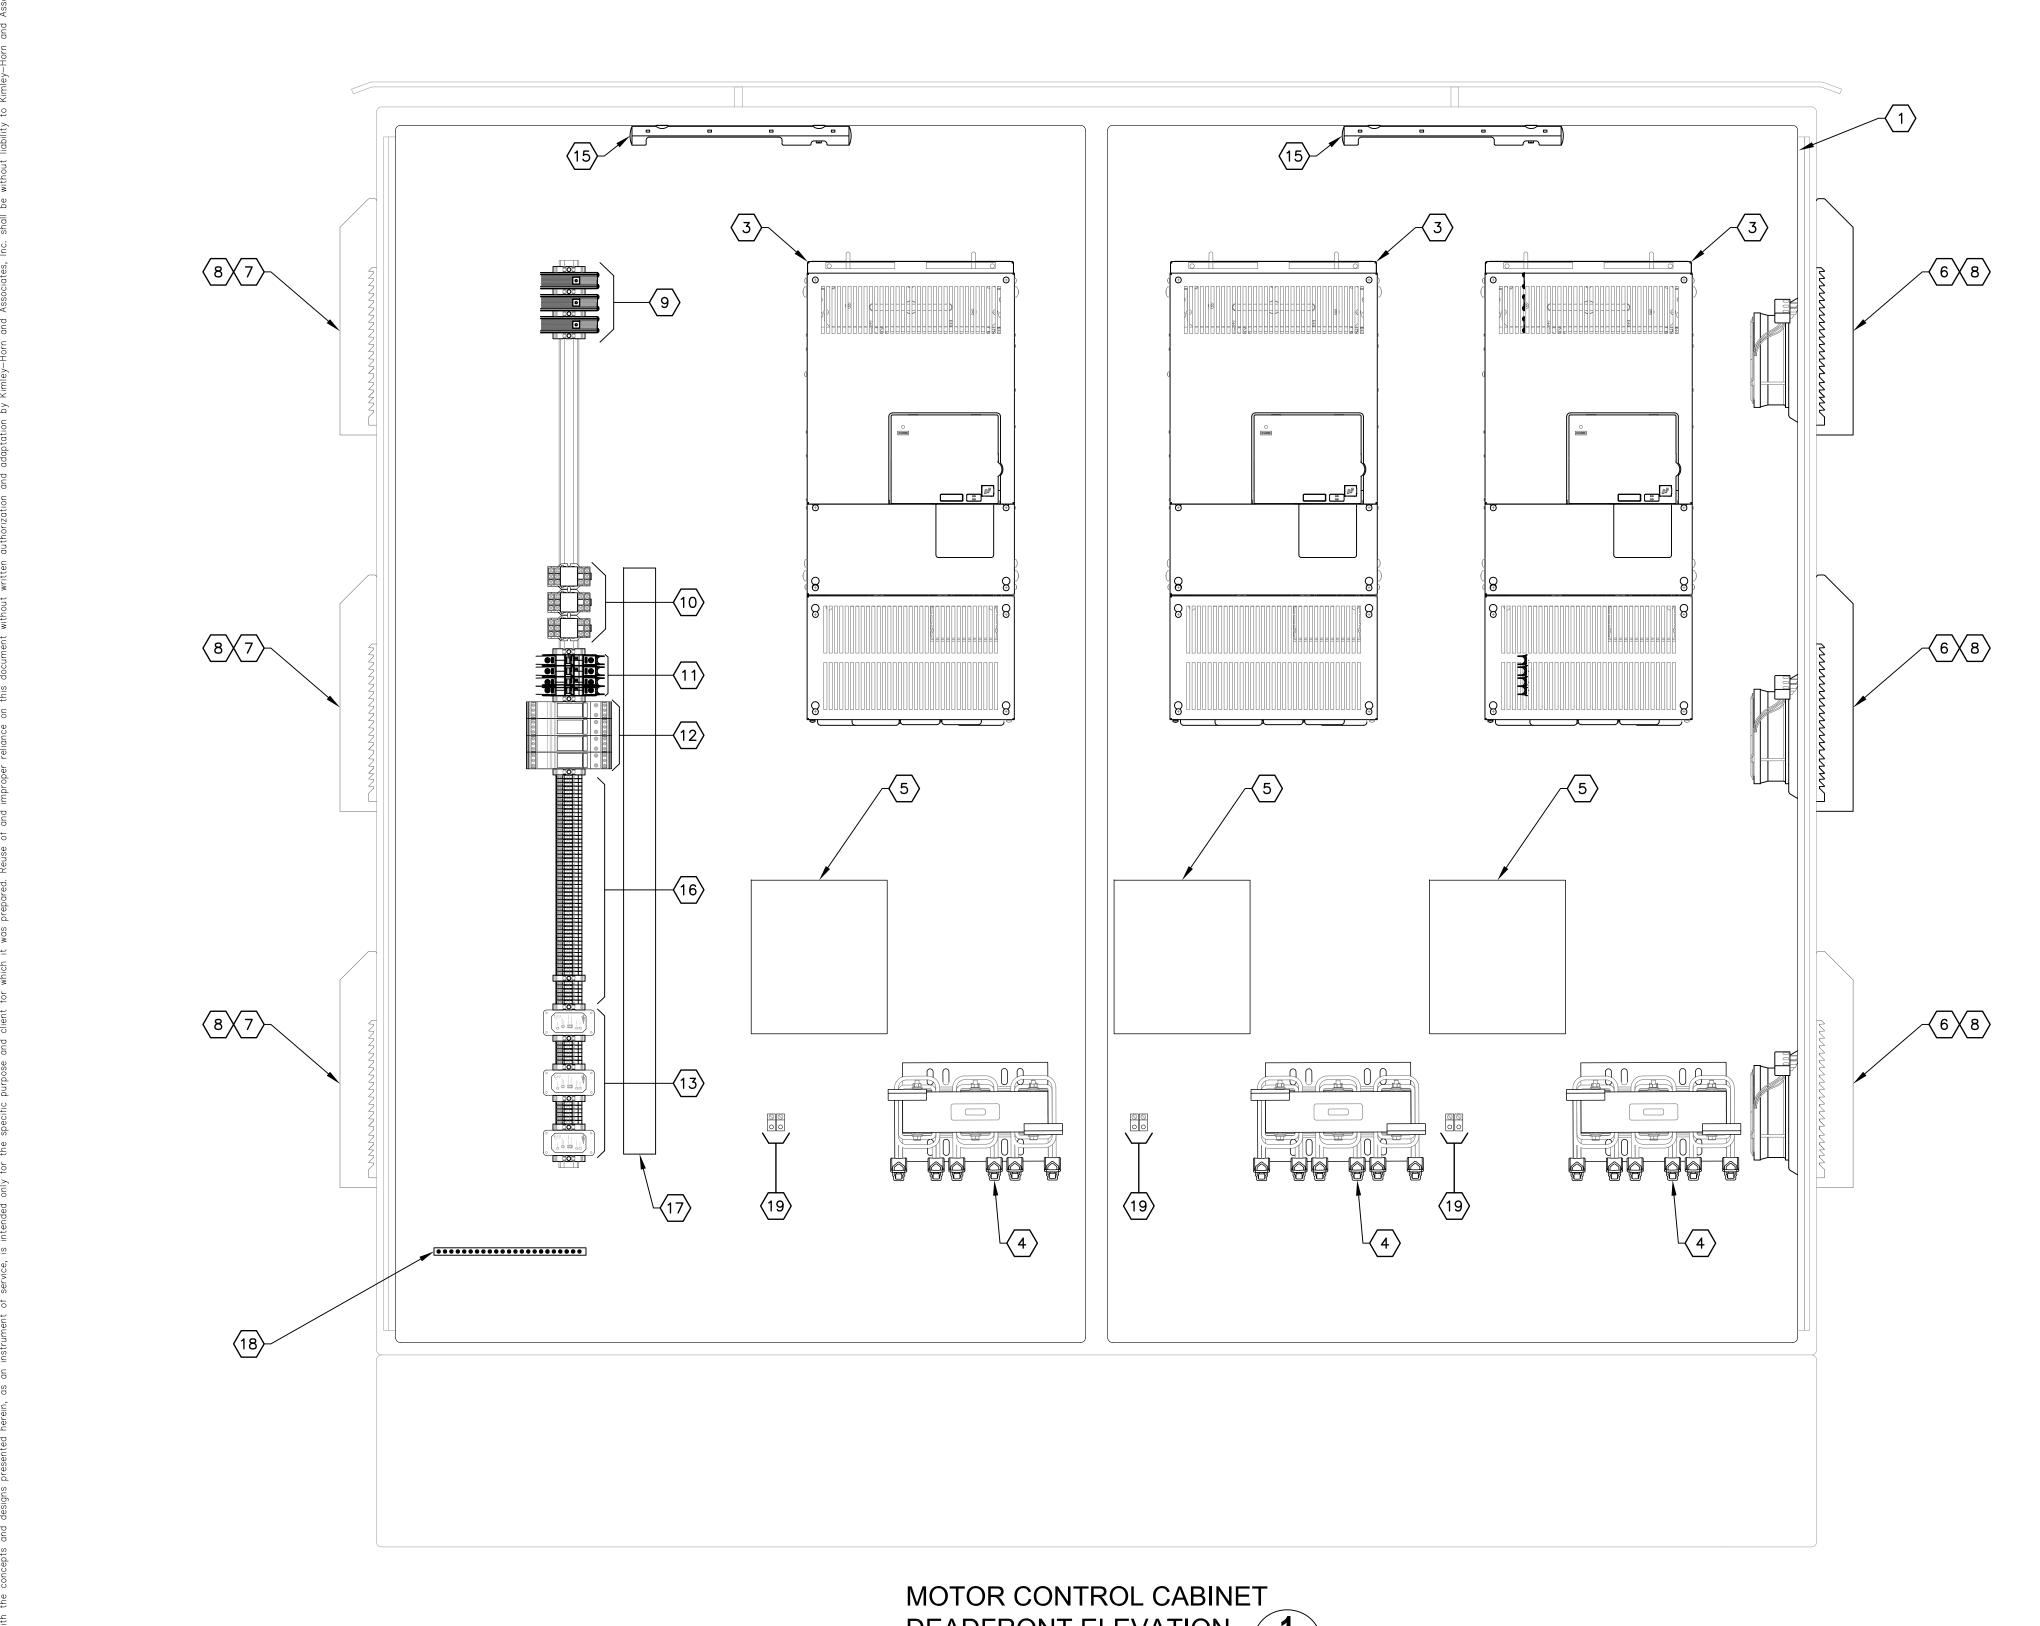

GENERAL NOTES:

- 1. REFER TO SHEET I-5 FOR BILL OF MATERIALS.
- 2. PROVIDE AND INSTALL ALL ASSOCIATED END BARRIERS, TERMINAL JUMPERS AND SPACERS AS REQUIRED FOR TERMINAL BLOCKS AS SHOWN OR
- 3. PROVIDE AND INSTALL 35mm ALUMINUM DIN RAIL. QUANTITY AS REQUIRED.
- 4. PROVIDE AND INSTALL CORROSION INHIBITOR, HOFFMAN # AHCI10E.
- 5. PROVIDE AND INSTALL STAINLESS STEEL BIRD SPIKES (FOR PIGEONS OR LARGER BIRDS) TO COVER TOP OF ENCLOSURE. INSTALL BIRD SPIKES WITH NON-SILICONE BASED ADHESIVE FOR OUTDOOR CONSTRUCTION OR PER MANUFACTURER'S SPECIFICATIONS.

DEADFRONT ELEVATION SCALE: NOT TO SCALE

(SHOWN WITH ENCLOSURE DOOR OPEN)

REVISIONS DATE BY

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TDT MANATEE COUNTY

SEWRF RECLAIMED PUMP BACK STATION TIMOTHY THOMAS, P.E

LICENSED PROFESSIONAL

FL LICENSE NUMBER

FL DATE:

MOTOR CONTROL CABINET DEADFRONT ELEVATION

SHEET NUMBER

I-2B

MOTOR CONTROL CABINET BILL OF MATERIALS

NOTE#	QTY	DESCRIPTION	PART NUMBER	MANUFACTURER	NOTES
1	1	90" X 90" X 24", NEMA 4X, POWDER COATED WHITE	CUSTOM	CUSTOM	316 STIAINLESS STEEL, POWDER COATED WHITE WITH HINGED AND DEADFRONT DOORS, HANDLES, PADLOCKABLE 3—POINT LATCHING, DOOR STOP KITS ALUMINUM BACKPANEL AND SUNSHIELDS.
2	3	DOOR KEYPAD MOUNTING KIT	UUX000527	YASKAWA	REMOVAL KEYPAD FOR VARIABLE FREQUENCY DRIVE CONTROL.
3	3	VARIABLE FREQUENCY DRIVE	CIMR-PW4A139AFF	YASKAWA	480V, 139 AMP OUTPUT CAPACITY FOR 85 HP DRIVE. PROVIDE WITH ETHERNET IP CARD, YASKAWA PART # SI-EN3.
4	3	124 AMP, 3% INPUT LINE REACTOR	KDRULH3L	ABB	OPEN STYLE PANEL MOUNT.
5	3	124 AMP, MOTOR OUTPUT FILTER	V1K130A00	ABB	
6	3	CABINET FAN, UL TYPE 12	PF 67000-11667154055	PFANNENBERG	368 CFM, 115V, 50/60 HZ WITH FILTER.
7	3	CABINET EXHAUST FILTER	PFA 6000-11740004055	PFANNENBERG	
8	6	WASHDOWN SHROUD	PF-RH-60000-1818200020	PFANNENBERG	STAINLESS STEEL
9	3	CAT 6 SURGE PROTECTION DEVICE	#2858991	PHOENIX CONTACT	
(10)	3	FAN CONTROL RELAYS	CLASS 8501, TYPE R	SQUARE D	10A CONTACTS WITH 120V AC COILS.
(11)	4	POWER CIRCUIT BREAKERS	TYPE 1489M	ALLEN BRADLEY	120V, 5 AMPERE.
(12)	4	120V SURGE PROTECTION DEVICE	#2905228	PHOENIX CONTACT	
(13)	3	PUMP MOTOR SUPERVISORY RELAY	MINI CAS II	XYLEM	RELAYS TO BE PROVIDED BY PUMP MANUFACTURER.
(14)	1	DUPLEX GFI RECEPTACLE	GFR5352IA	HUBBELL	
(15)	2	120V AC LED CABINET LIGHT	LEDA1S35	HOFFMAN	120V AC LED FIXTURE WITH INTEGRAL ON/OFF SWITCH. PROVIDE CUSTOM BRACKET TO MOUNT FIXTURE TO PANEL.
(16)		TERMINAL BLOCKS	DN-T10B-A	AUTOMATION DIRECT	QUANTITY AS REQUIRED.
(17)		2" X 3" SLOTTED WIRING DUCT	G2X3LG6	PANDUIT	QUANTITY AS REQUIRED.
(18)	1	EQUIPMENT GROUND BAR SYSTEM	UGB2/0-414-18	PANDUIT	PROVIDE BONDING STANDOFFS (PANDUIT UGB-B-S0).
(19)	3	GROUNDING LUGS			PROVIDE GROUNDING LUGS AS REQUIRED FOR PUMP MOTOR CABLE GROUNDING.



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LICENSED PROFESSIONAL

TIMOTHY THOMAS, P.E


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MOTOR CONTROL CABINET BILL OF MATERIALS

SHEET NUMBER

I-3



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HECKED BY

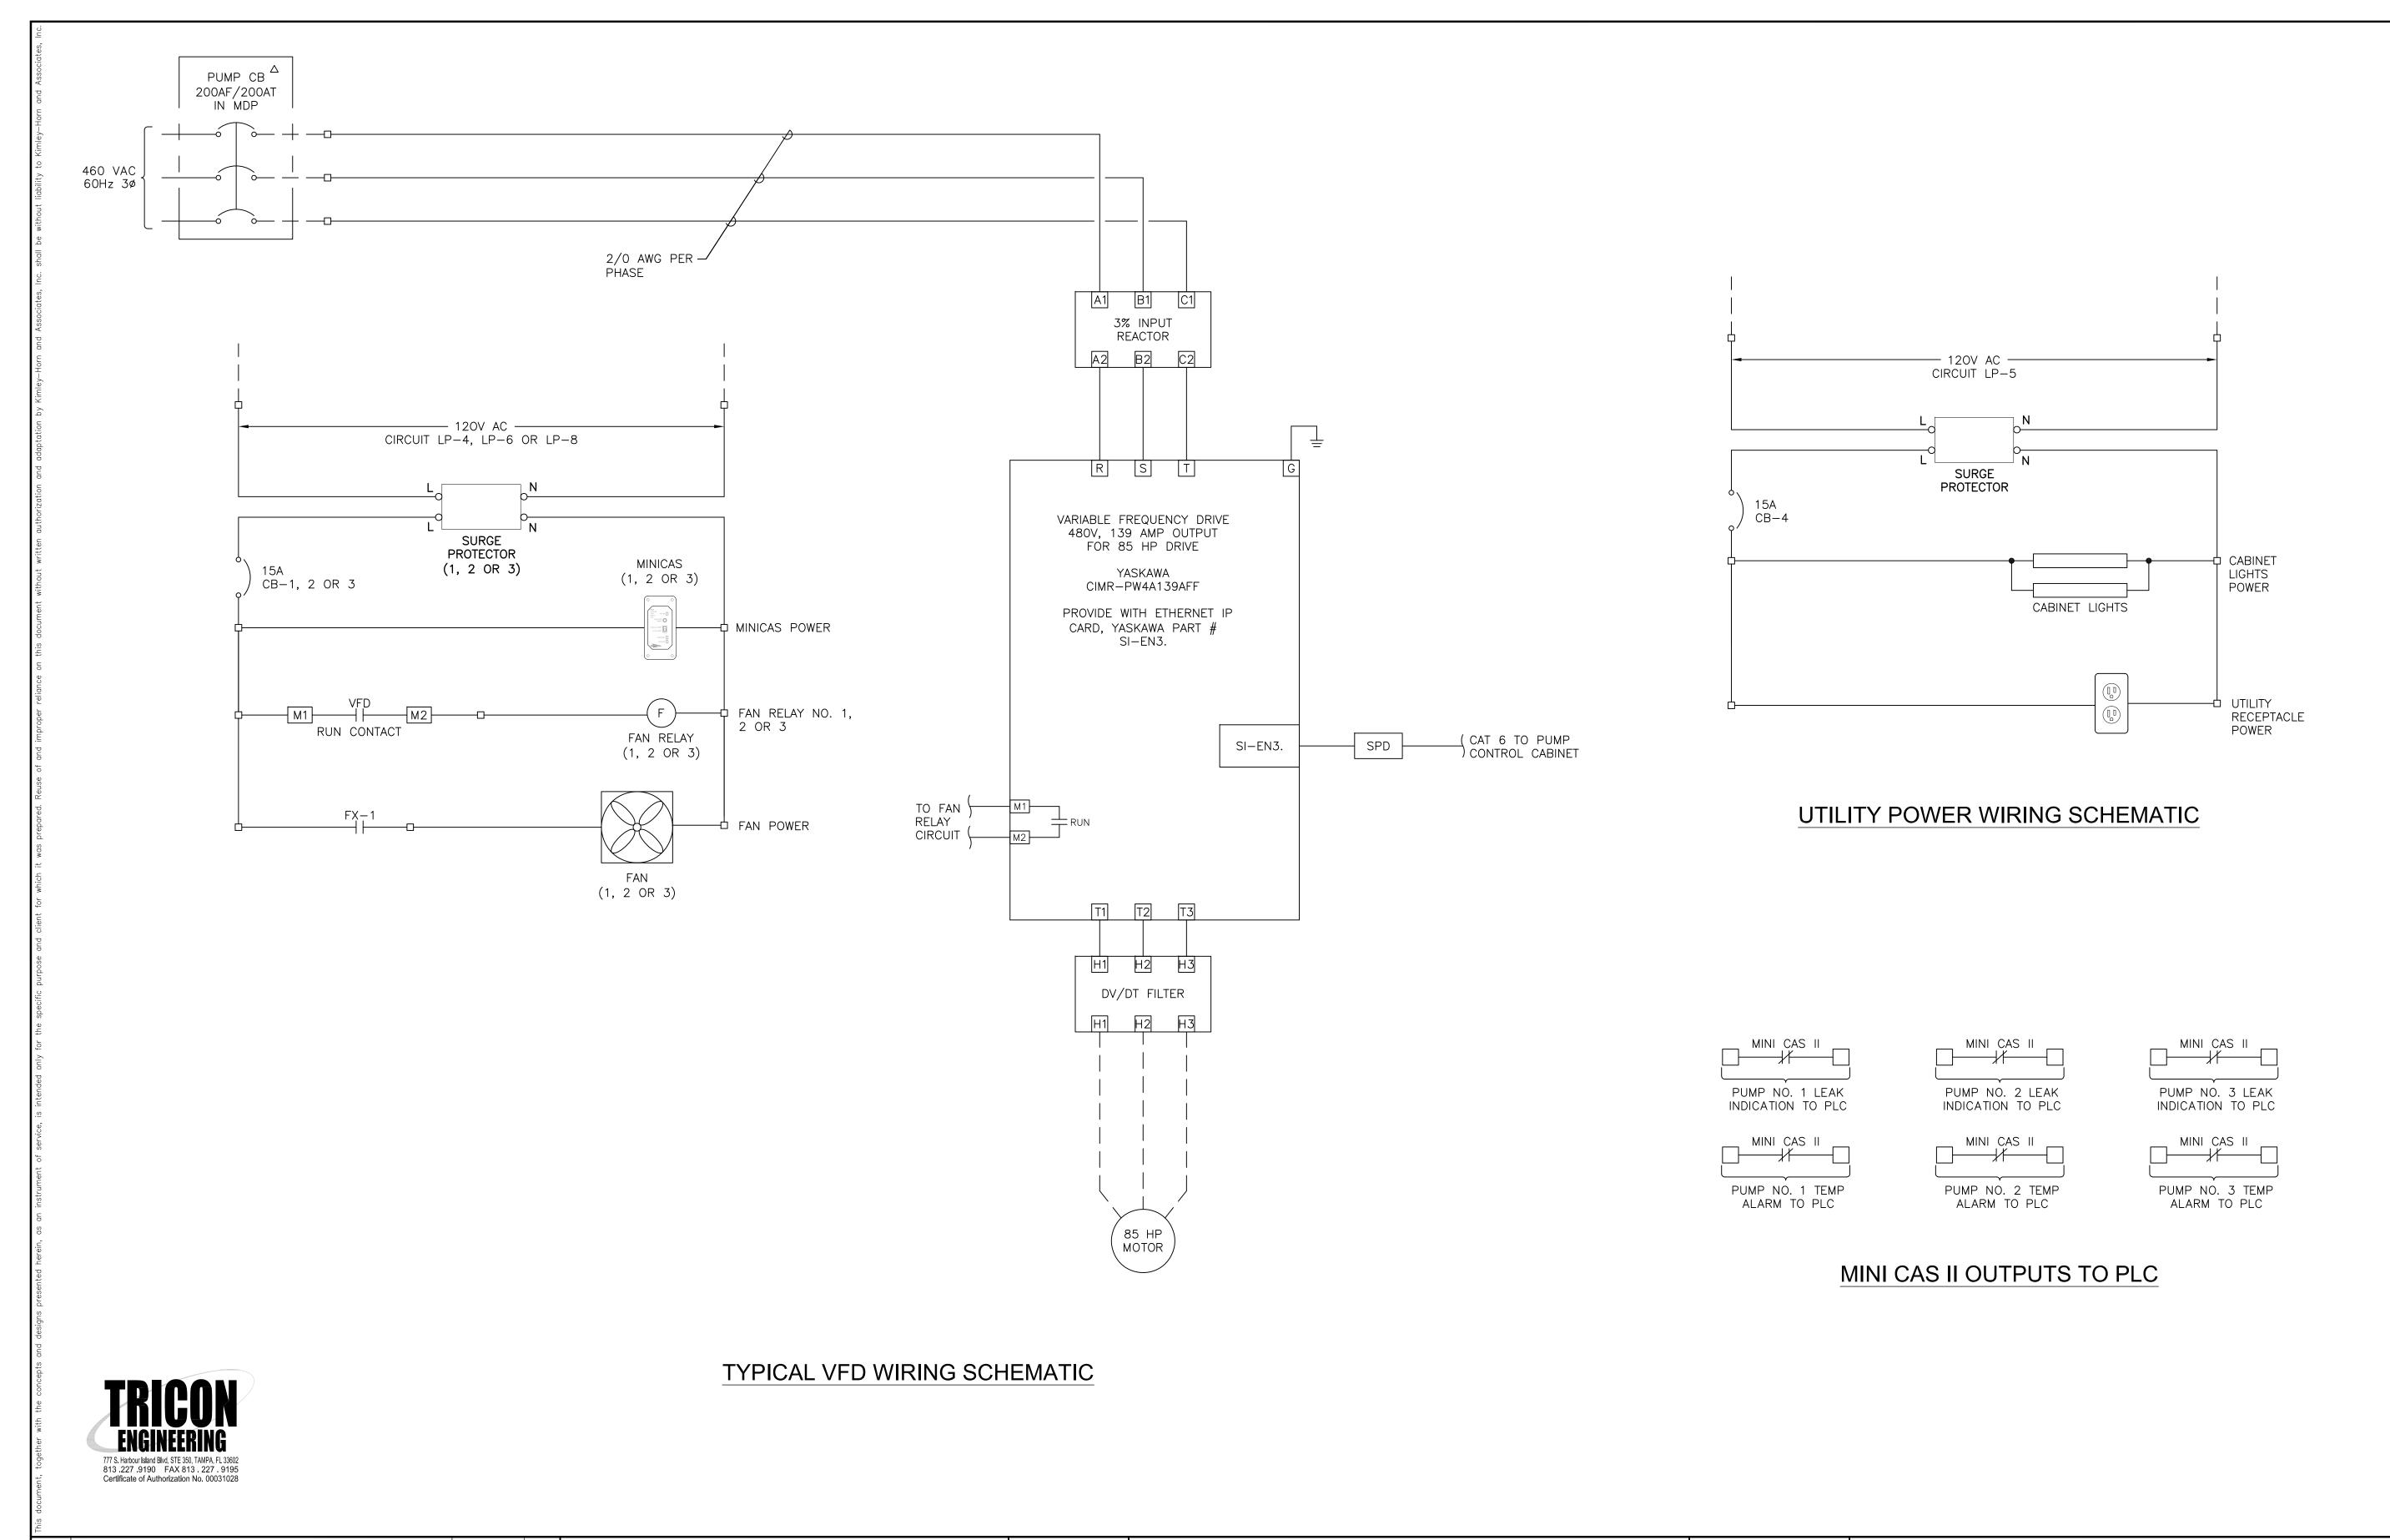SEWRF RECLAIMED

TDT

JLH

TDT MANATEE COUNTY

TIMOTHY THOMAS, P.E


FL LICENSE NUMBER
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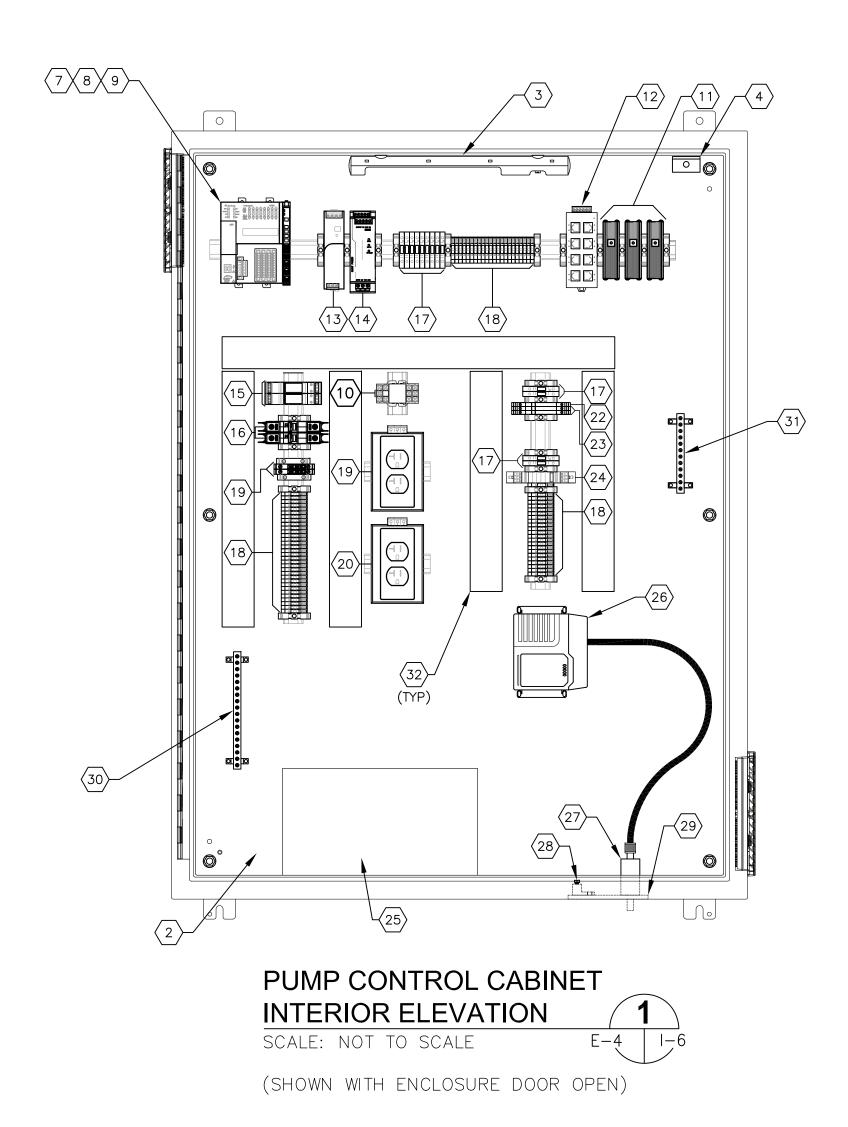
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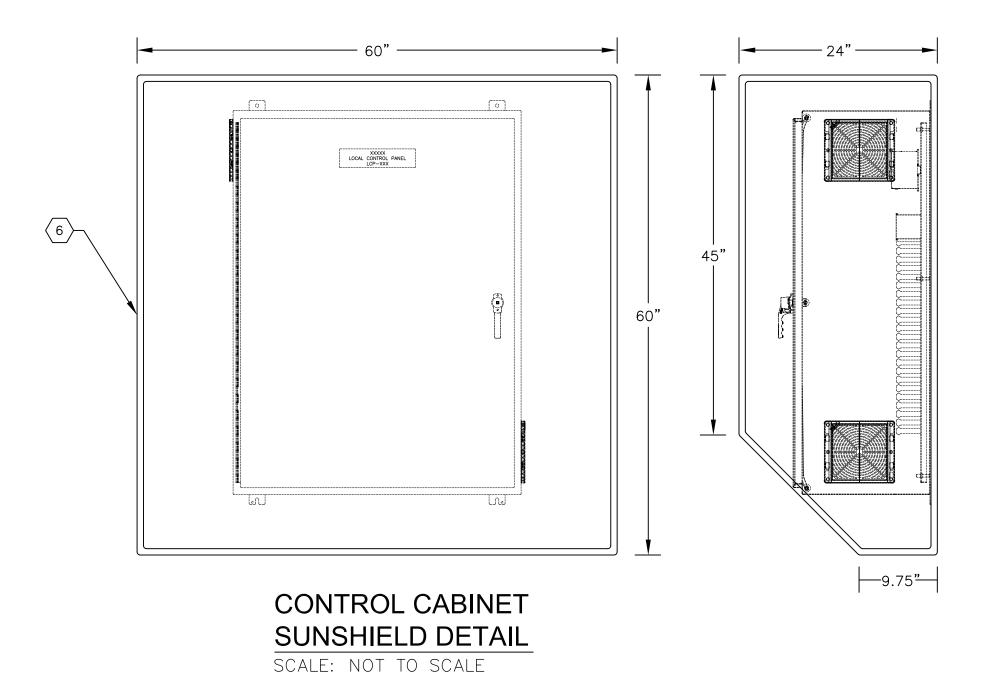
TYPICAL VFD WIRING SCHEMATIC

I**-**4

SHEET NUMBER





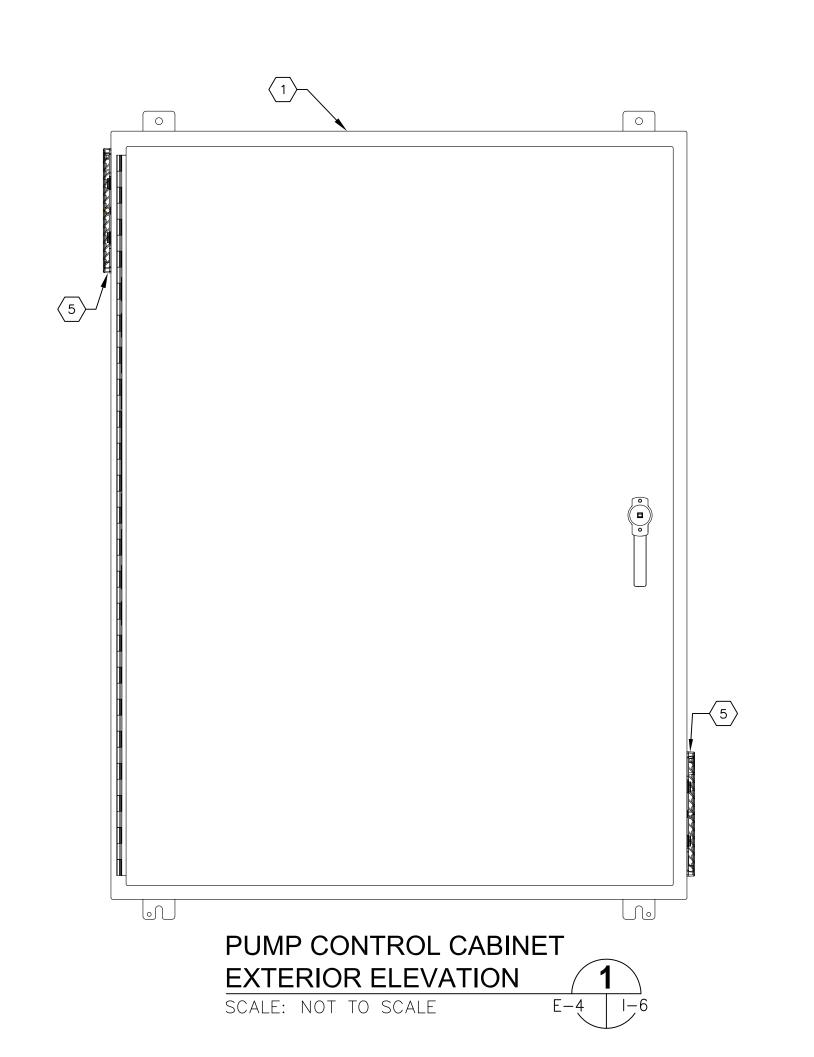

GENERAL NOTES :

- 1. REFER TO SHEET I-5A FOR BILL OF MATERIALS.
- 2. PROVIDE AND INSTALL ALL ASSOCIATED END BARRIERS, TERMINAL JUMPERS AND SPACERS AS REQUIRED FOR TERMINAL BLOCKS, FUSE HOLDERS AND SURGE PROTECTION DEVICES SHOWN OR REQUIRED.
- 3. PROVIDE AND INSTALL 35mm ALUMINUM DIN RAIL, QUANTITY AS REQUIRED.
- 4. PROVIDE AND INSTALL CORROSION INHIBITOR, HOFFMAN # AHCI10E.



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TDT MANATEE COUNTY

SEWRF RECLAIMED
PUMP BACK STATION

TIMOTHY THOMAS, P.E

FL LICENSE NUMBER
47079

FL DATE:

LICENSED PROFESSIONAL

PUMP CONTROL CABINET ELEVATIONS AND DETAIL

SHEET NUMBER

I-5

PUMP	CONT	ROL CABINET BILL OF MATERIALS			
NOTE#	QTY	DESCRIPTION	PART NUMBER	MANUFACTURER	NOTES
1	1	48" X 36" X 16", NEMA 4X, 316 STAINLESS STEEL ENCLOSURE	A48H3616SS6LP3PT	HOFFMAN	POWDER COATED WHITE WITH 3-POINT LATCHING SYSTEM. PROVIDE DOOR STOP KIT.
2	1	45" X 33" STAINLESS STEEL BACKPANEL	A48P36SS6	HOFFMAN	
3	1	24V DC LED CABINET LIGHT	LED24V15	HOFFMAN	PROVIDE CUSTOM BRACKET TO MOUNT FIXTURE TO BACKPANEL.
4	1	REMOTE DOOR SWITCH SWITCH AND ASSOCIATED DOOR SWITCH CABLE	ALFSWD	HOFFMAN	FOR 24V DC LED CABINET LIGHT. PROVIDE CUSTOM BRACKET TO MOUNT SWITCH TO BACKPANEL.
5	2	6" X 6" STAINLESS STEEL EXHAUST GRILLE	TEP6SS	HOFFMAN	
6	1	60" X 60" X 24" ALUMINUM SUNSHIELD		CUSTOM	PROVIDE FULL FILLET WELDS.
7	1	PLC PROCESSOR	1769-L18ER-BB1B	ALLEN BRADLEY	
8	1	POINT I/O CURRENT INPUT ANALOG MODULE	1734-IE4C	ALLEN BRADLEY	4 CHANNEL, 24V DC.
9	1	POINT I/O MOUNTING BASE	1734-TB	ALLEN BRADLEY	
(10)	1	NORMAL POWER FAIL RELAY	CLASS 8501, TYPE R	SQUARE D	10A CONTACTS WITH 120V AC COILS.
(11)	3	CAT 6 SURGE PROTECTION DEVICE	#2858991	PHOENIX CONTACT	
(12)	1	ETHERNET SWITCH	#2891929	PHOENIX CONTACT	
(13)	1	120VAC-24VDC POWER SUPPLY	1606-XLE80E	ALLEN BRADLEY	DUAL 24V DC OUTPUTS
(14)	1	120VAC-24VDC POWER SUPPLY	#2866750	PHOENIX CONTACT	5 AMPERE OUTPUT
(15)	2	INCOMING 120V POWER SURGE PROTECTION DEVICE	#2905228	PHOENIX CONTACT	
(16)	2	120V, SINGLE POLE, 15A CIRCUIT BREAKER	1489-M1C150	ALLEN BRADLEY	
(17)	13	FUSED TERMINAL BLOCK WITH LED INDICATOR, 24V DC	AB1FUSE435U5XB	SQUARE D	PROVIDE FUSE FOR TERMINAL BLOCK. EACH FUSE SHALL BE BUSSMANN 5 X 20mm GMC SERIES. REFER TO SHEETS I-6 AND I-6A FOR AMPERAGES.
(18)		TERMINAL BLOCKS	DN-T10B-A	AUTOMATION DIRECT	QUANTITY AS REQUIRED.
(19)	2	120V, THERMAL CIRCUIT BREAKERS	DN-SUPP-2-1	AUTOMATION DIRECT	PROVIDE EACH BREAKER WITH AUTOMATION DIRECT DN-FE EURO F SERIES SOCKET. REFER TO SHEET I-6 FOR AMPERAGE.
20	1	120V, 20A DUPLEX UTILITY RECEPTACLE	#5600525	PHOENIX CONTACT	
21	1	120V, 20A UPS RECEPTACLE	#5600525	PHOENIX CONTACT	
(22)	1	POWER TERMINAL BLOCK MINI MCR-SL-PTB FOR ANALOG ISOLATORS	#2864134	PHOENIX CONTACT	PROVIDE DIN RAIL BUS CONNECTORS AS REQUIRED, PHOENIX CONTACT #2869728.
23	2	ANALOG ISOLATOR MINI MCR-2-RPSS-I-I FOR ANALOG I/O	#2902014	PHOENIX CONTACT	REFER TO LOOP DIAGRAMS FOR WIRING CONNECTIONS BASED ON TRANSMITTER TYPE.
24	1	SURGE PROTECTION PLUG PT 2X2-24DC-ST	#2838228	PHOENIX CONTACT	PROVIDE SURGE PROTECTION BASE ELEMENT PT 2X2-BE, PHOENIX CONTACT #2839208 FOR EACH UNIT. PROVIDE TERMINAL BLOCK FOR SHIELD GROUNDING AUTOMATION DIRECT DN-GTO.
25	1	UNITERRUPTIBLE POWER SUPPLY (UPS)	BR700G	APC	APC PRO 700, 120V AC OUTPUT, 700VA.
(26)	1	ECR ORBIT 900 Mhz RADIO	MDSECRU91NNNNN S1S1USUNNN	GE	
27	1	698-2700 Mhz COAXIAL CABLE PROTECTION	TSX-NFF	iPOLYPHASER	
28	1	SINGLE BARREL ONE-HOLE COPPER GROUNDING LUG	HL1-25-X	PANDUIT	
29	1	2"W X 5"L X 1/4"D COPPER GROUNDING PLATE		CUSTOM	
(30)	1	EQUIPMENT GROUND BAR SYSTEM	UGB2/0-414-18	PANDUIT	PROVIDE BONDING STANDOFFS (PANDUIT UGB-B-S0).
(31)	1	SIGNAL GROUND BAR SYSTEM	UGB2/0-414-12	PANDUIT	PROVIDE ISOLATION STANDOFFS (PANDUIT UGB-IN-SO).
32		2" X 3" SLOTTED WIRING DUCT	G2X3LG6	PANDUIT	QUANTITY AS REQUIRED.
					



No.	REVISIONS	DATE	BY	

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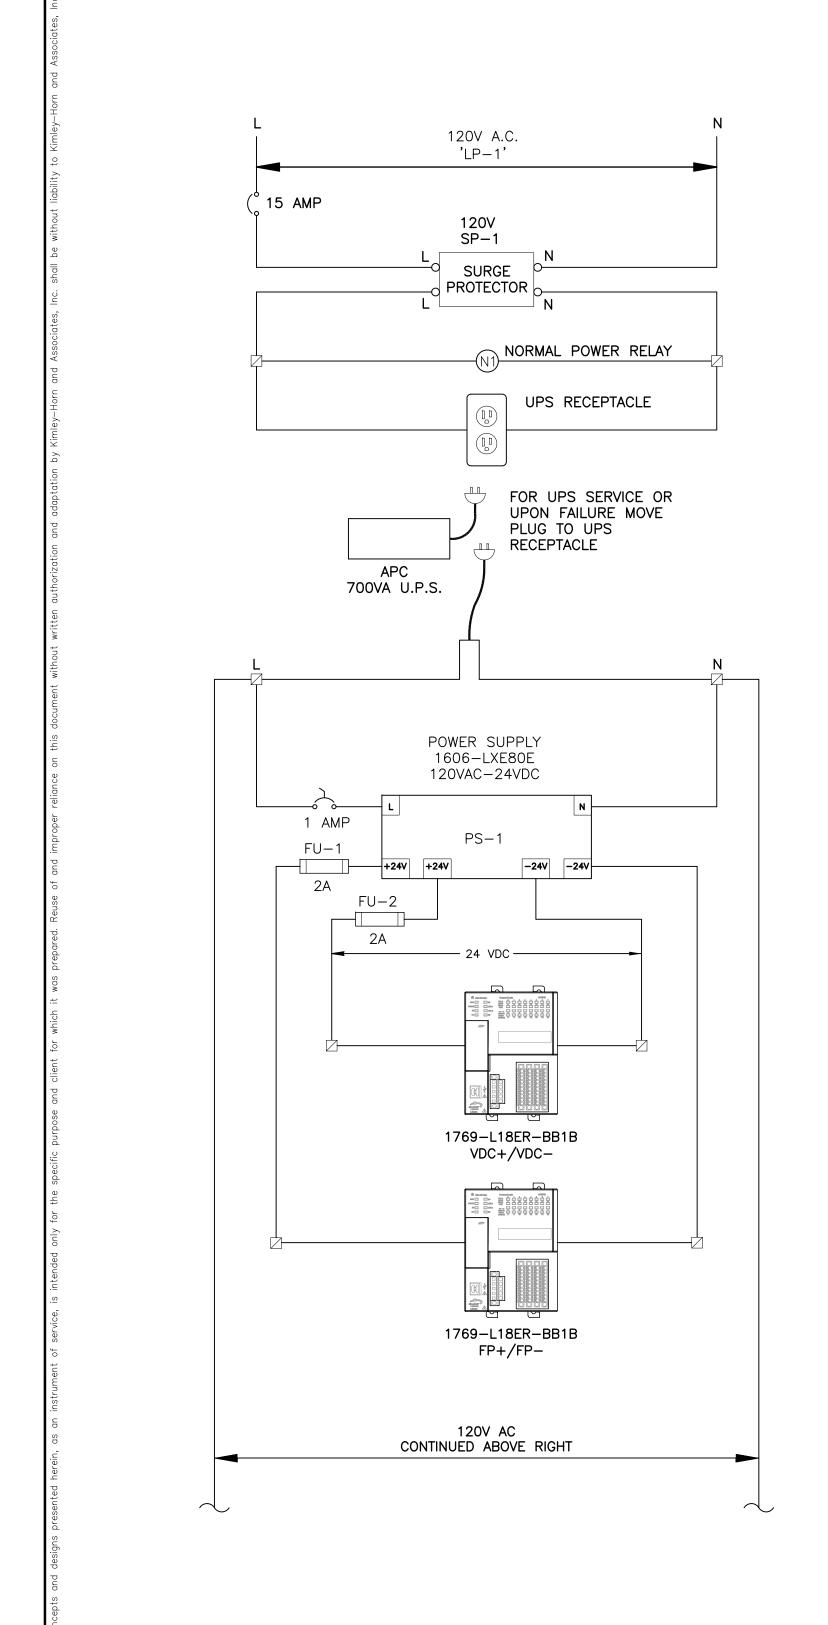
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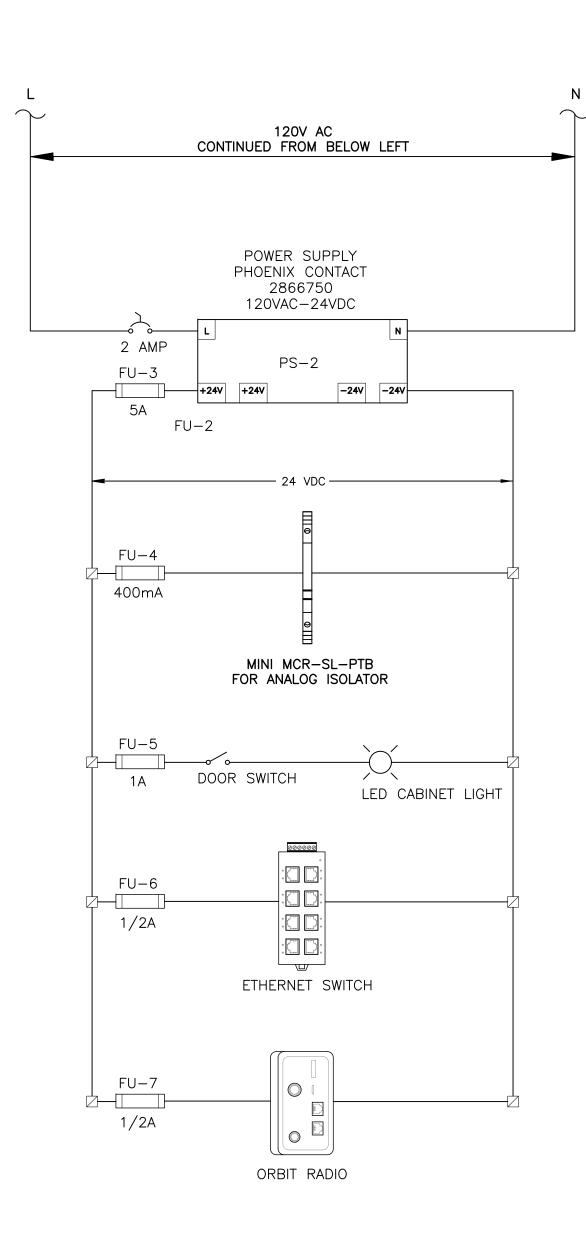
TIMOTHY THOMAS, P.E


PUMP CONTROL CABINET BILL OF MATERIALS

SHEET NUMBER

I-5A





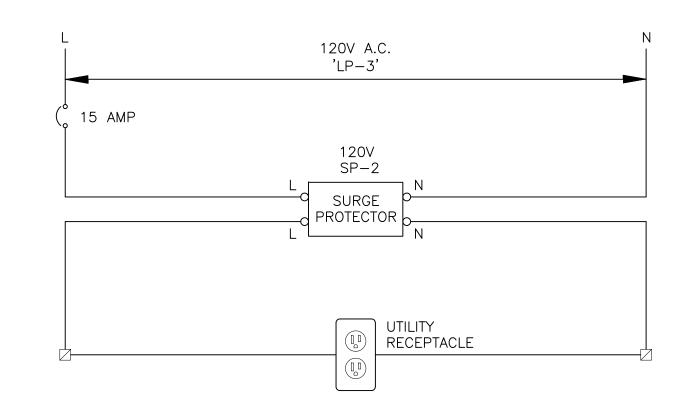

LEGEND

DENOTES TERMINAL IN FIELD DEVICE

DENOTES NEW FIELD WIRING

DENOTES TERMINAL IN PUMP CONTROL CABINET

DENOTES TERMINAL ON PLC



No.	REVISIONS	DATE	BY	

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SEWRF RECLAIMED

TDT

JLH

TDT

MANATEE COUNTY

TIMOTHY THOMAS, P.E

FL LICENSE NUMBER


47079


FL DATE:

PUMP CONTROL CABINET POWER WIRING SCHEMATICS

SHEET NUMBER

I-6

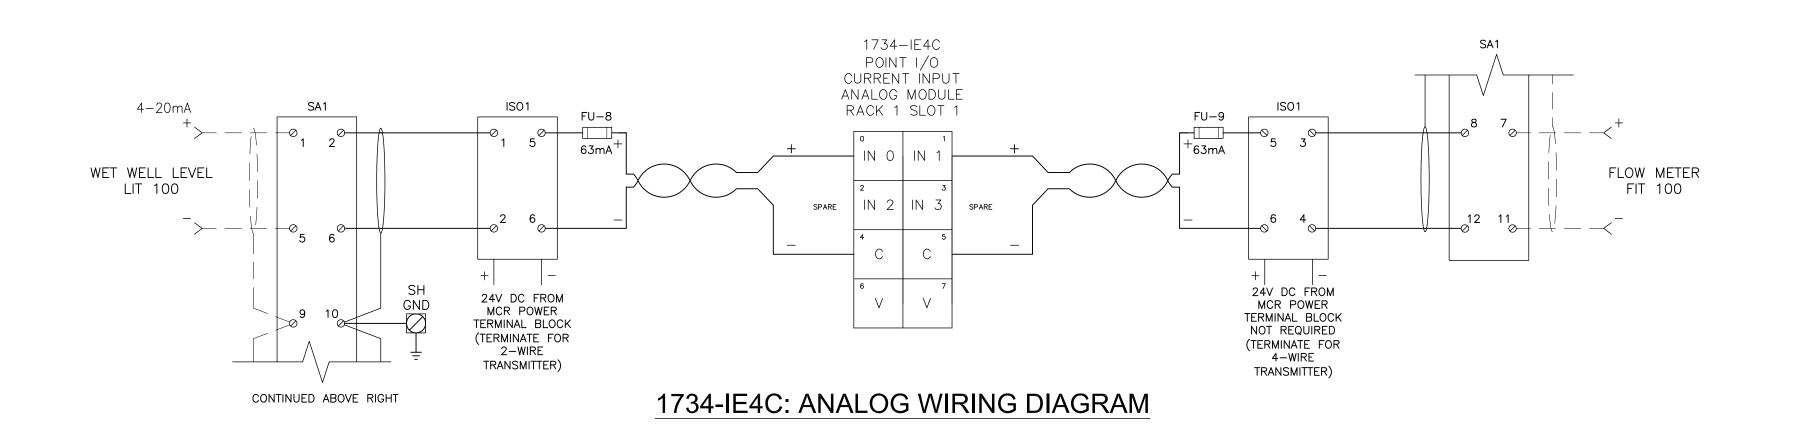

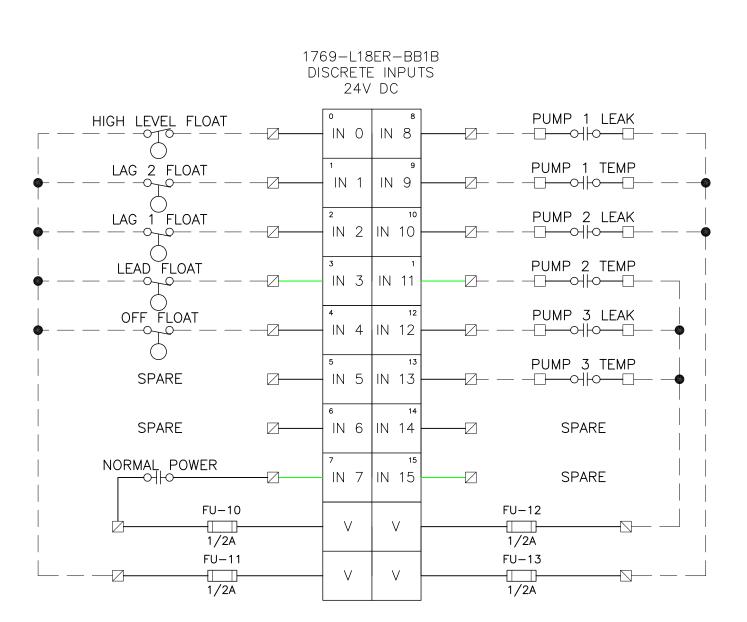

1769 L18ER-BB1B DISCRETE INPUT I/O WIRING DIAGRAM

LEGEND

DENOTES TERMINAL IN FIELD DEVICE

----- DENOTES NEW FIELD WIRING

DENOTES TERMINAL IN PUMP CONTROL CABINET



·			
No.	REVISIONS	DATE	BY

Kimley Horn
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655 NORTH FRANKLIN STREET, SUITE 150, TAMPA, FL 33602

PHONE: 813-620-1460 WWW.KIMLEY-HORN.COM CA 00000696 KHA PROJECT
148400015

DATE
6/26/19

SCALE AS SHOWN

DESIGNED BY TDT

DRAWN BY JLH

SEWRF RECLAIMED

PUMP BACK STATION

MANATEE COUNTY

TIMOTHY THOMAS, P.E


FL LICENSE NUMBER

FL DATE:

PUMP CONTROL CABINET
PLC I/O
WIRING SCHEMATICS

SHEET NUMBER

I-6A

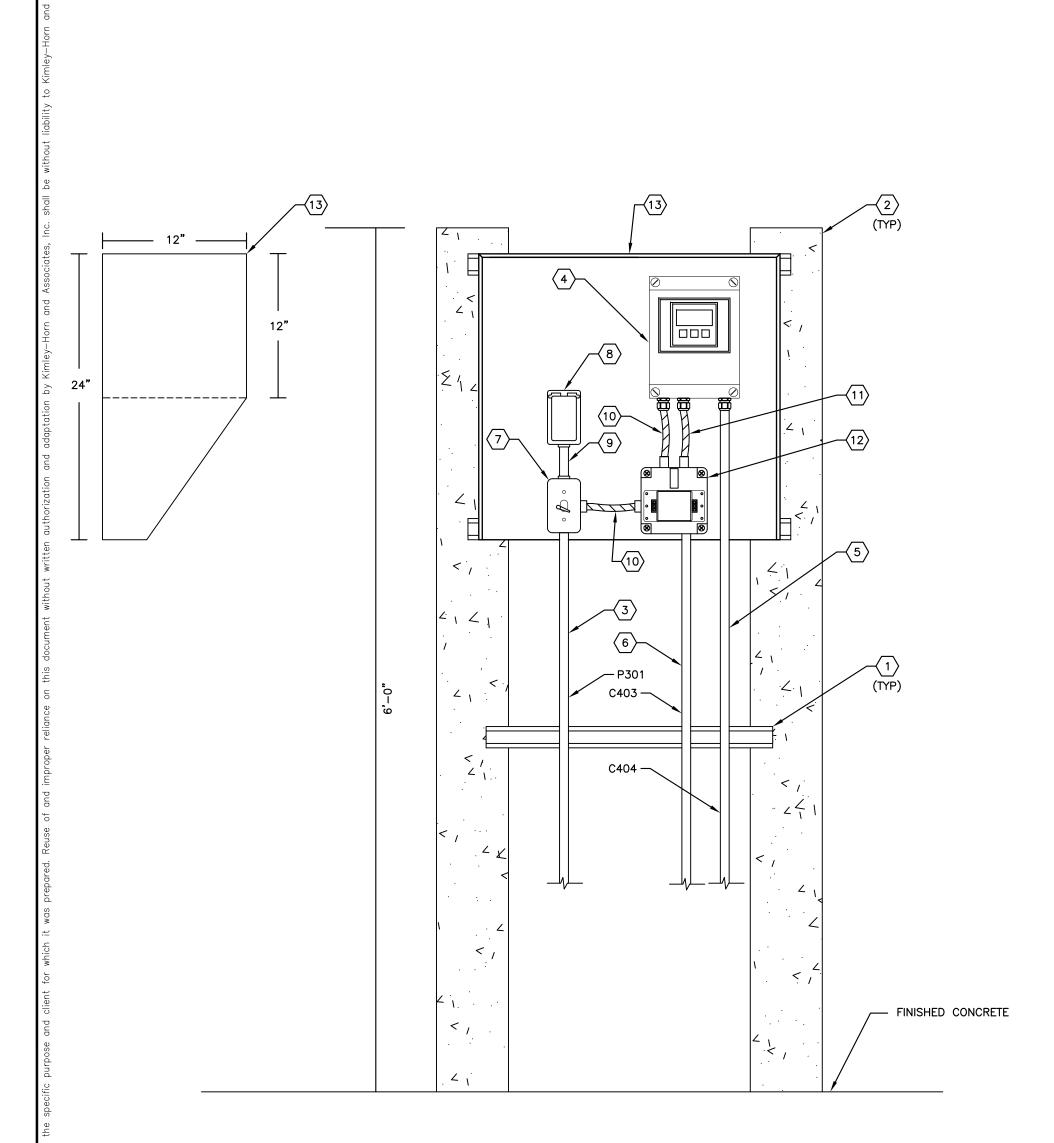


FLOW TRANSMITTER RACK ELEVATION SCALE: NOT TO SCALE

KEY NOTES:

- 1 PROVIDE AND INSTALL 1-5/8" STAINLESS STEEL UNISTRUT (OR EQUAL). BOLTS TO SECURE UNISTRUT SHALL BE INSTALLED COMPLETELY THROUGH CONCRETE POST.
- PROVIDE AND INSTALL 6" X 6" CONCRETE POST. POST SHALL BE EMBEDDED A MINIMUM OF 3 FEET INTO CONCRETE SLAB/SOIL.
- PROVIDE AND INSTALL 2-#12 THWN CU + 1-#12
 THWN CU GND IN 3/4"C. FOR FLOW METER TRANSMITTER AND RÉCEPTACLE FOR 120V POWER,
- PROVIDE AND INSTALL FLOW METER TRANSMITTER. REFER TO SPECIFICATIONS. PROVIDE 1/4" ALUMINUM PLATE FOR MOUNTING.
- PROVIDE AND INSTALL MANUFACTURER SUPPLIED SENSOR CABLES IN 1"C. TO FIELD SENSORS, (C100A).
- PROVIDE AND INSTALL 2/C-#16 SHIELDED (BELDEN 8719) IN 1"C. (4-20mA FLOW METER SIGNAL) TO DFS
- PROVIDE AND INSTALL 120V, 15A, SINGLE-POLE SWITCH IN WEATHERPROOF FS BOX AS 120V POWER DISCONNECTING MEANS. PROVIDE AND INSTALL SINGLE-GANG WEATHERPROOF SWITCH COVER. BELL #5121*-*0.

KEY NOTES:

- 8 PROVIDE AND INSTALL DUPLEX GFCI RECEPTACLE, HUBBELL, GFR5352IA OR EQUAL. PROVIDE AND INSTALL SINGLE-GANG WEATHERPROOF GFCI COVER. BELL
- 9 PROVIDE AND INSTALL 2-#12 THWN CU + 1-#12 THWN CU GND IN 3/4"C. TO RECEPTACLE FOR 120V
- PROVIDE AND INSTALL 2-#12 THWN CU + 1-#12 THWN CU GND IN 3/4" FLEXIBLE, SEALTITE CONDUIT TO FLOW METER TRANSMITTER FOR 120V POWER.
- PROVIDE AND INSTALL 2/C-#16 SHIELDED (BELDEN 8719) IN 3/4" FLEXIBLE, SEALTITE CONDUIT. (4-20mA FLOW METER SIGNAL).
- PROVIDE AND INSTALL EDCO SLAC SERIES AC POWER/SIGNAL TVSS DEVICE IN NEMA 4X ENCLOSURE TO PROTECT 120V POWER CIRCUIT AND 4-20mA ANALOG OUTPUT SIGNAL.
- PROVIDE AND INSTALL SUN-SHIELD, CONSTRUCTED FROM 1/8" ALUMINUM STOCK. PROVIDE FULL FILLET WELDS. 24" WIDE, 24" TALL.

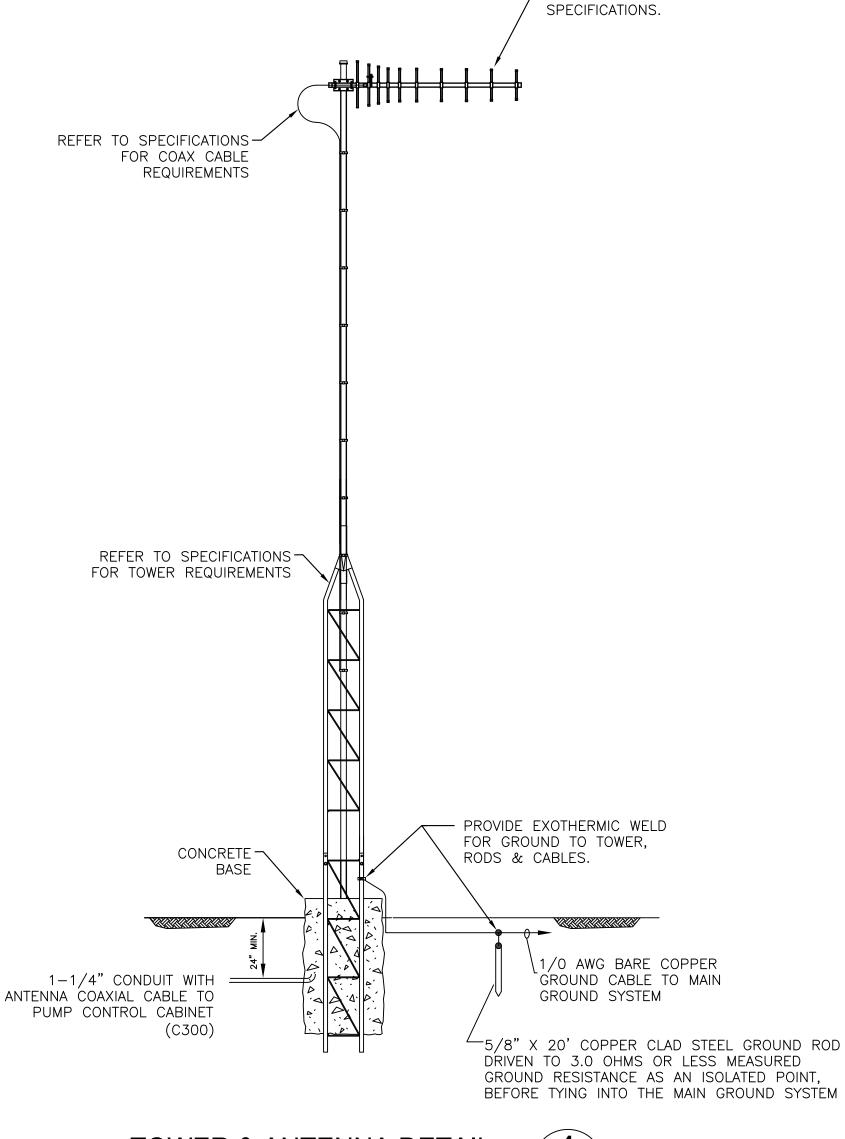

— YAGI ANTENNA REFER TO




NOTES:

CONTRACTOR SHALL SUBMIT SHOP DRAWINGS FOR ANTENNA FOUNDATION. SHOP DRAWINGS SHALL BE SIGNED AND SEALED BY A PROFESSIONAL ENGINEER REGISTERED IN THE STATE OF FLORIDA.

1. TOWER & FOUNDATION DESIGNED FOR 150 MPH WINDSPEED.

TDT | MANATEE COUNTY

3. CONTRACTOR TO PROVIDE RADIO SURVEY TO DETERMINE TOWER HEIGHT REQUIREMNT AND ANTENNA AIMING. REFER ALSO TO SPECIFICATIONS.

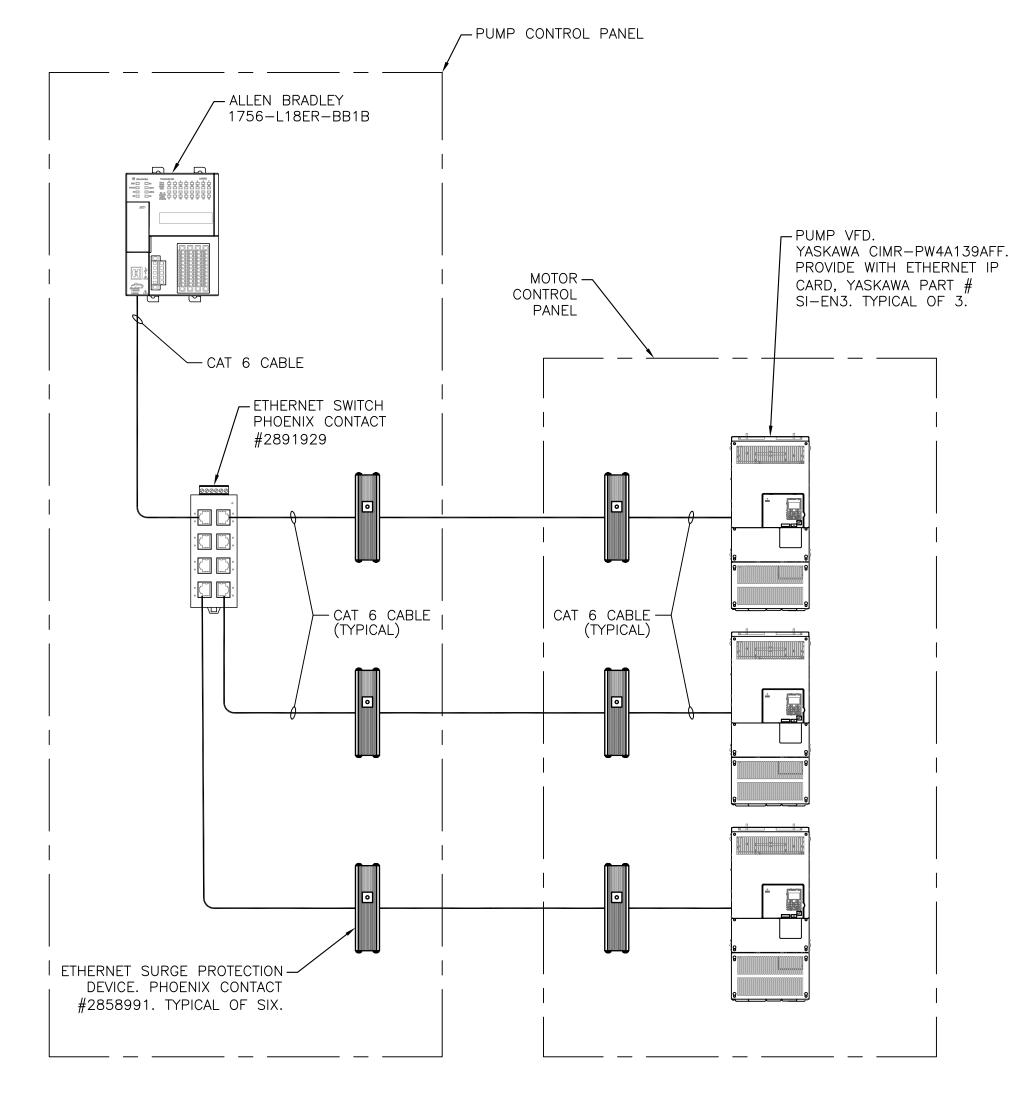

COMMUNICATIONS RISER



813 .227 .9190 FAX 813 .227 .9195 Certificate of Authorization No. 00031028

REVISIONS DATE BY

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KHA PROJECT 148400015 DATE 6/26/19 SCALE AS SHOWN ESIGNED BY

DRAWN BY

HECKED BY


SEWRF RECLAIMED PUMP BACK STATION LICENSED PROFESSIONAL TIMOTHY THOMAS, P.E FL LICENSE NUMBER

FL DATE:

47079

INSTRUMENTATION **DETAILS**

SHEET NUMBER

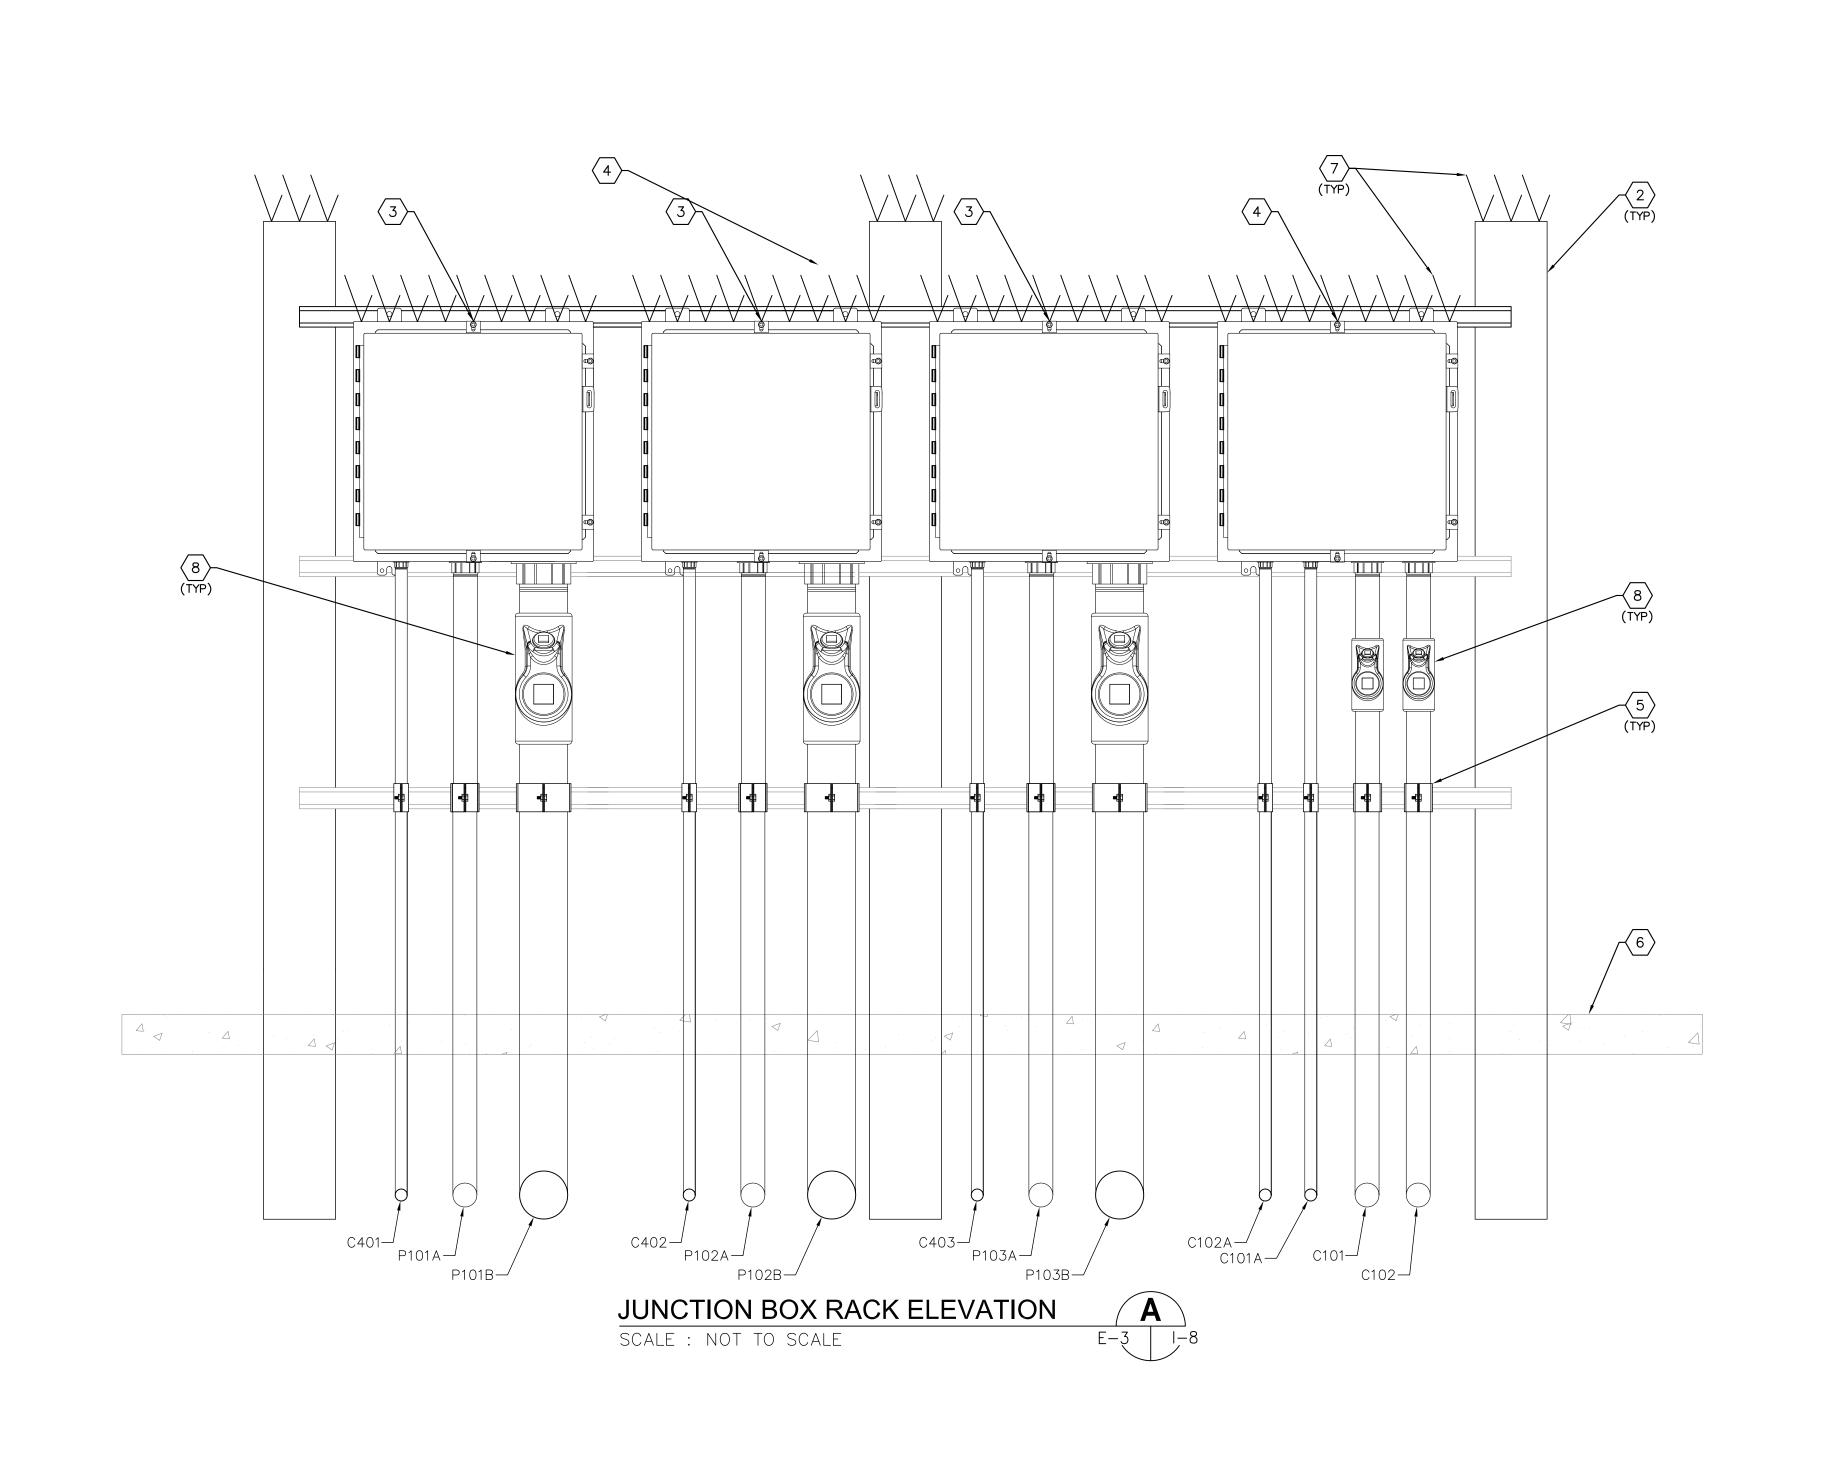

- PROVIDE AND INSTALL 1-5/8" STAINLESS STEEL UNISTRUT (OR EQUAL). BOLTS TO SECURE UNISTRUT SHALL BE INSTALLED COMPLETELY THROUGH CONCRETE POST
- PROVIDE AND INSTALL 6" X 6" CONCRETE POST. POST SHALL BE EMBEDDED A MINIMUM OF 3 FEET INTO CONCRETE SLAB/SOIL (TYP OF 3).
- PUMP MOTOR CONNECTIONS JUNCTION BOX USED AS A DEMARCATION BOX TO PROVIDE ISOLATION BETWEEN THE WET WELL AND MOTOR CONTROL CABINET. PROVIDE AND INSTALL A 20"x20"x8" NEMA 4X, STAINLESS STEEL JUNCTION BOX WITH HINGED DOOR, HAMMOND #1418N4S16D8.PROVIDE INNER PANEL. REFER TO SHEET I—9 FOR DETAILS. TYPICAL OF 3.
- WET WELL JUNCTION BOX USED AS A DEMARCATION BOX TO PROVIDE ISOLATION BETWEEN THE WET WELL AND PUMP CONTROL CABINET. PROVIDE AND INSTALL A 20"x20"x6" NEMA 4X, STAINLESS STEEL JUNCTION BOX WITH HINGED DOOR, HAMMOND #1418N4S16D6. PROVIDE INNER PANEL. REFER TO SHEET I—9 FOR DETAILS.
- 5 PROVIDE AND INSTALL ALUMINUM CONDUIT CLAMP.
- PROPOSED CONCRETE SLAB. REFER TO STRUCTURAL DRAWINGS.
- PROVIDE AND INSTALL STAINLESS STEEL BIRD SPIKES (FOR PIGEONS OR LARGER BIRDS) TO COVER TOP OF ENCLOSURE. INSTALL BIRD SPIKES WITH NON-SILICONE BASED ADHESIVE FOR OUTDOOR CONSTRUCTION OR PER MANUFACTURER'S SPECIFICATIONS.
- 8 PROVIDE AND INSTALL EYS SEAL. SIZE AS REQUIRED.



No. REVISIONS DATE BY

Kimley » Horn
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KHA PROJECT
148400015

DATE
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TDT MANATEE COUNTY

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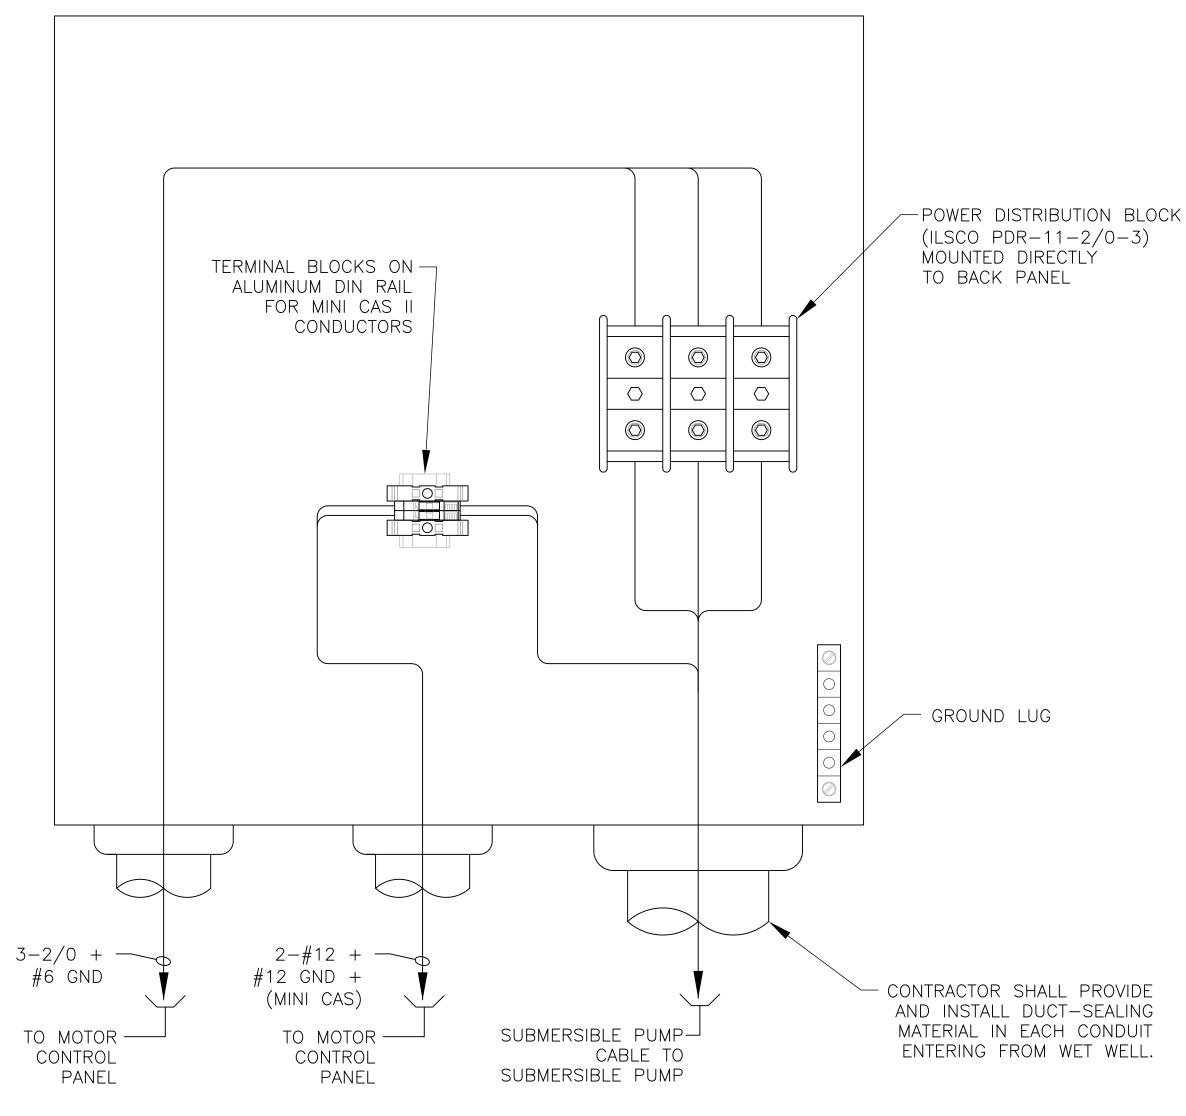
FL LICENSE NUMBER

FL DATE:

WET WELL JUNCTION BOX RACK DETAILS

SHEET NUMBER


I-8





NOTES:

- 1. COVER NOT SHOWN FOR CLARITY
- 2. BOND GROUNDING CONDUCTORS TO ENCLOSURE BACK PANEL.

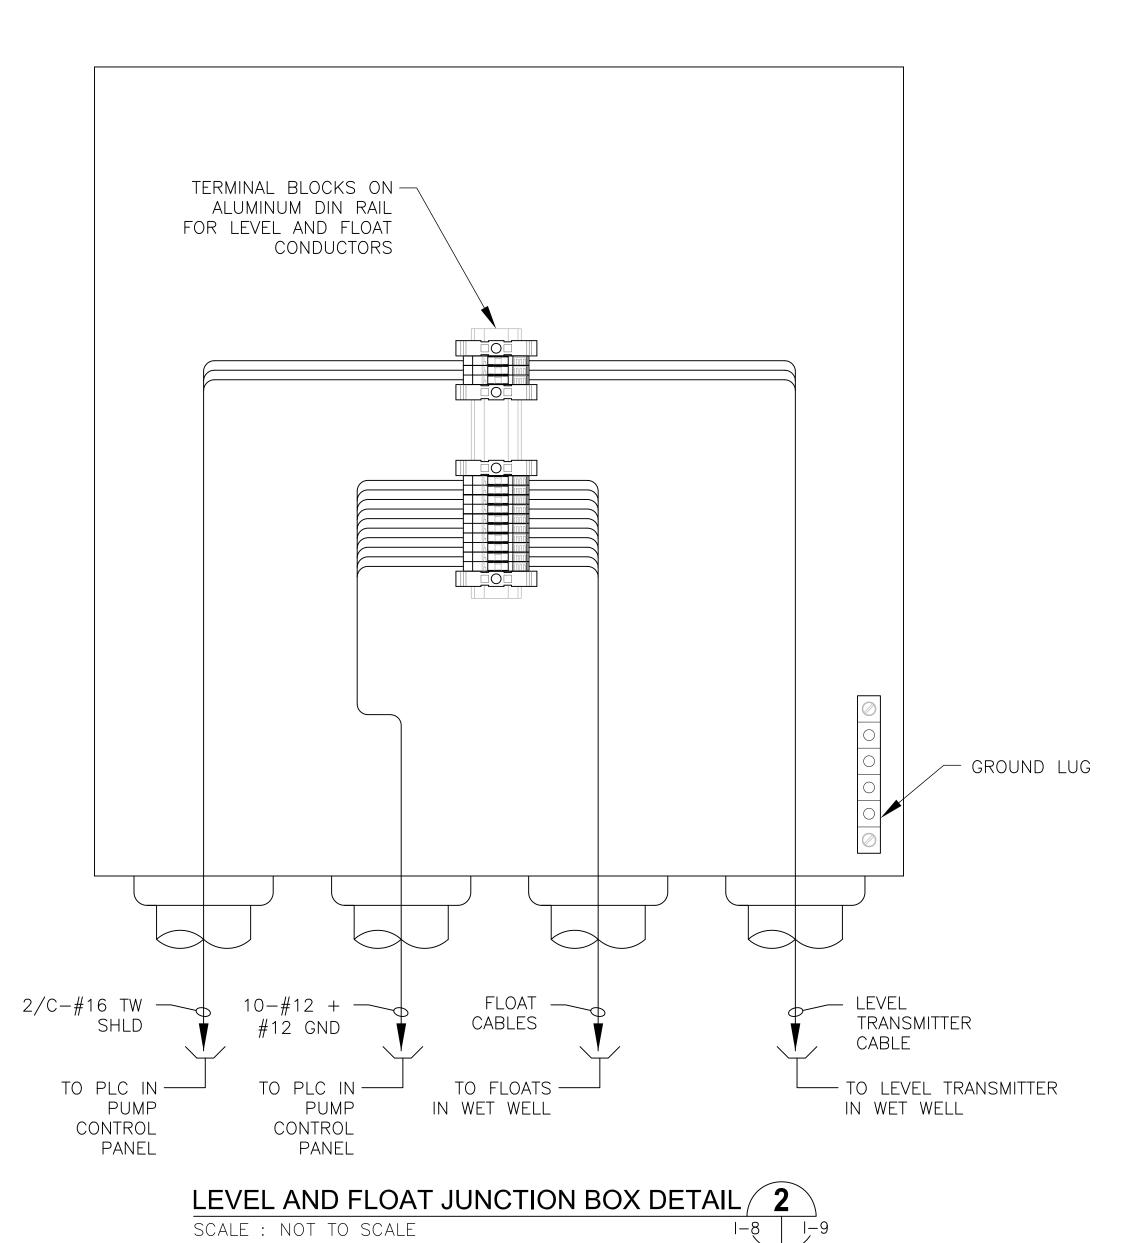

NOTES:

- 1. COVER NOT SHOWN FOR CLARITY
- 2. BOND GROUNDING CONDUCTORS TO ENCLOSURE BACK PANEL.



This								
F			Vimlay W Horn	KHA PROJECT 148400015	Manatee	LICENSED PROFESSIONAL		SHEET NUMBER
			Kimley» Horn	DATE 6/26/19	County	TIMOTHY THOMAS, P.E	JUNCTION BOX	
			© 2018 KIMLEY—HORN AND ASSOCIATES, INC.	SCALE AS SHOWN	SEWRE RECLAIMED	FL LICENSE NUMBER 47079		I-9
			655 NORTH FRANKLIN STREET, SUITE 150, TAMPA, FL 33602	DESIGNED BY TDT			DETAILS	
			PHONE: 813-620-1460	DRAWN BY JLH	PUMP BACK STATION	47079		
١	o. REVISIONS	DATE BY	WWW.KIMLEY—HORN.COM CA 00000696	CHECKED BY TDT	MANATEE COUNTY	FL date:		