STRUCTURAL NOTES

- 1. GENERAL:
- (A) THESE NOTES ARE NOT INTENDED TO REPLACE THE PROJECT SPECIFICATIONS OR CONSTRUCTION DRAWING NOTES AND DETAILS. IN CASE OF CONFLICT BETWEEN THE REQUIREMENTS OF THE SPECIFICATIONS/CONSTRUCTION DRAWINGS AND THESE NOTES, THE MORE STRINGENT REQUIREMENT SHALL APPLY.
- (B) PROTECT EXISTING FACILITIES, STRUCTURES AND UTILITY LINES FROM ALL DAMAGE. CONTRACTOR SHALL PROTECT THE WORK, ADJACENT PROPERTY, AND THE PUBLIC. CONTRACTOR IS SOLELY RESPONSIBLE FOR DAMAGE OR INJURY DUE TO HIS ACT OR NEGLECT
- (C) THE CONTRACTOR IS SOLELY RESPONSIBLE FOR JOB SAFETY AND CONSTRUCTION PROCEDURES.
- (D) PRIOR TO CONSTRUCTION, FIELD VERIFY ALL DIMENSIONS IN THE DRAWINGS AND DETAILS AND REPORT ANY DISCREPANCIES IMMEDIATELY TO THE ENGINEER.
- (E) REFER TO THE ENGINEER FOR INSTRUCTION FOR ANY DIMENSION NOT GIVEN ON DRAWINGS. SCALING OF DRAWINGS SHALL NOT BE USED TO OBTAIN OR VERIFY ANY DIMENSION SHOWN ON THE DRAWINGS.
- 2. CONCRETE:
- (A) ALL CONCRETE MATERIALS, PLACING AND HANDLING SHALL BE IN ACCORDANCE WITH THE LATEST EDITION OF ACI 301, ACI 318 AND ACI 350. CURING OF CONCRETE SHALL BE IN STRICT ACCORDANCE WITH ACI 301 PROVISIONS.
- (B) STRUCTURAL CONCRETE SHALL HAVE THE FOLLOWING MINIMUM 28-DAY COMPRESSIVE STRENGTH:

1. FOUNDATIONS 5000 PSI 2. TANK 5000 PSI 3. SLAB-ON-GRADE 4000 PSI

- (C) USE NORMAL WEIGHT CONCRETE (135 PCF MIN.) FOR ALL STRUCTURAL MEMBERS. DO NOT USE CALCIUM CHLORIDE IN ANY CONCRETE.
- (D) PROVIDE 3 INCH \pm 1 INCH SLUMP.
- (E) ALL CONCRETE TO HAVE A MAXIMUM WATER/CEMENT RATIO OF 0.40. MINIMUM CEMENTITIOUS CONTENT SHALL BE 515 LBS/CY. FLY ASH SHALL BE TYPE F ONLY.
- (F) PROVIDE 3" CONCRETE COVER OVER REINFORCING BARS EXCEPT AS OTHERWISE NOTED.
- (G) FORM TIES AND REINFORCING BAR SUPPORTS SHALL BE OF NON-CORROSIVE MATERIAL INCLUDING, BUT NOT LIMITED TO, FIBERGLASS, PLASTIC, AND/OR PRECAST CONCRETE MEETING THESE SPECIFICATIONS.
- (H) CONCRETE FINISHES:
 - FORMED SURFACE—SMOOTH FORM FINISH PER ACI 301.
 BROOM FINISH FOR SLAB ON GRADE SUCH AS DISCHARGE PIPING CONCRETE PAD AND TOP SLAB OF CENTRAL PUMP STATION
- (I) ALL GROUT SHALL BE NON-SHRINK, NON-METALLIC.
- (J) ALL CONCRETE CONSTRUCTION SHALL BE DONE IN THE DRY.
- (K) PROVIDE 3/4" CHAMFER ON ALL EXPOSED EDGES UNLESS OTHERWISE NOTED.
- (L) CONTRACTOR IS RESPONSIBLE FOR THE PROPER DESIGN AND CONSTRUCTION OF ALL FORMWORK AND SHORING. DESIGN SHALL BE PERFORMED BY A LICENSED FLORIDA PROFESSIONAL ENGINEER.
- (M) CONTRACTOR SHALL REFER TO MECHANICAL DRAWINGS FOR LOCATIONS AND SIZES OF SLEEVES, OPENINGS, EMBEDDED ITEMS, SLAB RECESSES, SLOPES, ETC. THESE ITEMS SHALL BE COORDINATED WITH OTHER TRADES AND INSTALLED PRIOR TO CONCRETE
- (M) A QUALIFIED TESTING LABORATORY SHALL BE RETAINED TO PERFORM THE FOLLOWING
 - CONCRETE TESTS:

 1. CYLINDER STRENGTH TESTS ASTM C39. ONE SET OF FIVE CYLINDERS FOR EACH 50 CUBIC YARDS OR FRACTION THEREOF PLACED. TEST ONE AT 3 DAYS, ONE AT 7 DAYS, TWO AT 28 DAYS, AND HOLD ONE.

 2. SLUMP TESTS ASTM C143
- (N) ONE COPY OF ALL TEST REPORTS SHALL BE SENT DIRECTLY TO OWNER, ENGINEER, AND CONTRACTOR.
- (O) SUBMITTALS:
 - 1. SUBMIT PROPOSED CONCRETE MIX DESIGN PRIOR TO CONSTRUCTION
 2. SUBMIT DETAILED SHOP DRAWINGS OF REINFORCING BARS SHOWING NUMBER,
 SIZE, AND LOCATION. INCLUDE BAR LISTS AND BEND DIAGRAMS.
- 3. REINFORCEMENT:
- (A) REINFORCING STEEL SHALL BE A.S.T.M. A-615 WITH SUPPLEMENT, GRADE 60: MINIMUM WORKING STRESS 24,000 PSI.
- (B) ALL REINFORCEMENT SHALL BE UNCOATED (BLACK).
- (C) ALL DIMENSIONS PERTAINING TO LOCATION OF REINFORCING BARS ARE TO CENTERLINE OF BARS EXCEPT WHERE THE CLEAR DIMENSION IS SHOWN TO FACE OF CONCRETE.
- (D) ACI STANDARD HOOKS SHALL BE USED UNLESS OTHERWISE NOTED.
- (E) ALL LAP AND SPLICE LENGTHS SHALL BE IN ACCORDANCE WITH THE LATEST EDITION OF ACI 318, ACI 350 AND CRSI STANDARD PRACTICES, EXCEPT AS OTHERWISE NOTED.

- 4. FOUNDATIONS:
- (A) A GEOTECHNICAL REPORT OF SUBSURFACE CONDITIONS HAS BEEN PREPARED BY ARDAMAN & ASSOCIATES (DATED SEPTEMBER 12, 2018, PROJECT # 17-7261). ANY ADDITIONAL GEOTECHNICAL WORK WILL BE THE RESPONSIBILITY OF THE CONTRACTOR.
- (B) NOTIFY THE ENGINEER IMMEDIATELY OF ANY EXISTING FOUNDATION CONDITIONS OR DETAILS THAT ARE IN CONFLICT WITH THOSE INDICATED AND SHOWN IN THE DRAWINGS.
- (C) ADHERE TO THE RECOMMENDATIONS MADE IN THE SOIL PREPARATION SECTION OF THE GEOTECHNICAL REPORT.
- (D) ALL FILL AND COMPACTION SHALL BE IN ACCORDANCE WITH THE RECOMMENDATIONS IN THE GEOTECHNICAL REPORT.
- (E) IN ACCORDANCE WITH THE RECOMMENDATION OF THE FEBRUARY 28, 2020 EMAIL FROM JERRY KUEHN, P.E. OF ARDAMAN AND ASSOCIATES TO KEVIN GERSZUNY OF KIMLEY—HORN AND ASSOCIATES, EMBANKMENT FILL SHALL BE PLACED DURING THE CONSTRUCTION OF THE PUMP STATION.

DESIGN CRITERIA:

EXPOSURE

RISK CATEGORY

2017 FLORIDA BUILDING CODE WITH SUPPLEMENTS
LIVE LOADS:
A. TANK ROOF SLAB
200 PSF
WIND LOAD:
BASIC WIND SPEED
150 MPH

No. REVISIONS DATE BY

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PHONE: 727-547-3999

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KHA PROJECT
148400015

DATE
1/28/2020

SCALE AS SHOWN
DESIGNED BY SS

CHECKED BY WEW MANATEE COUNTY

DRAWN BY

SEWRF RECLAIMED PUMP BACK STATION LICENSED PROFESSIONAL


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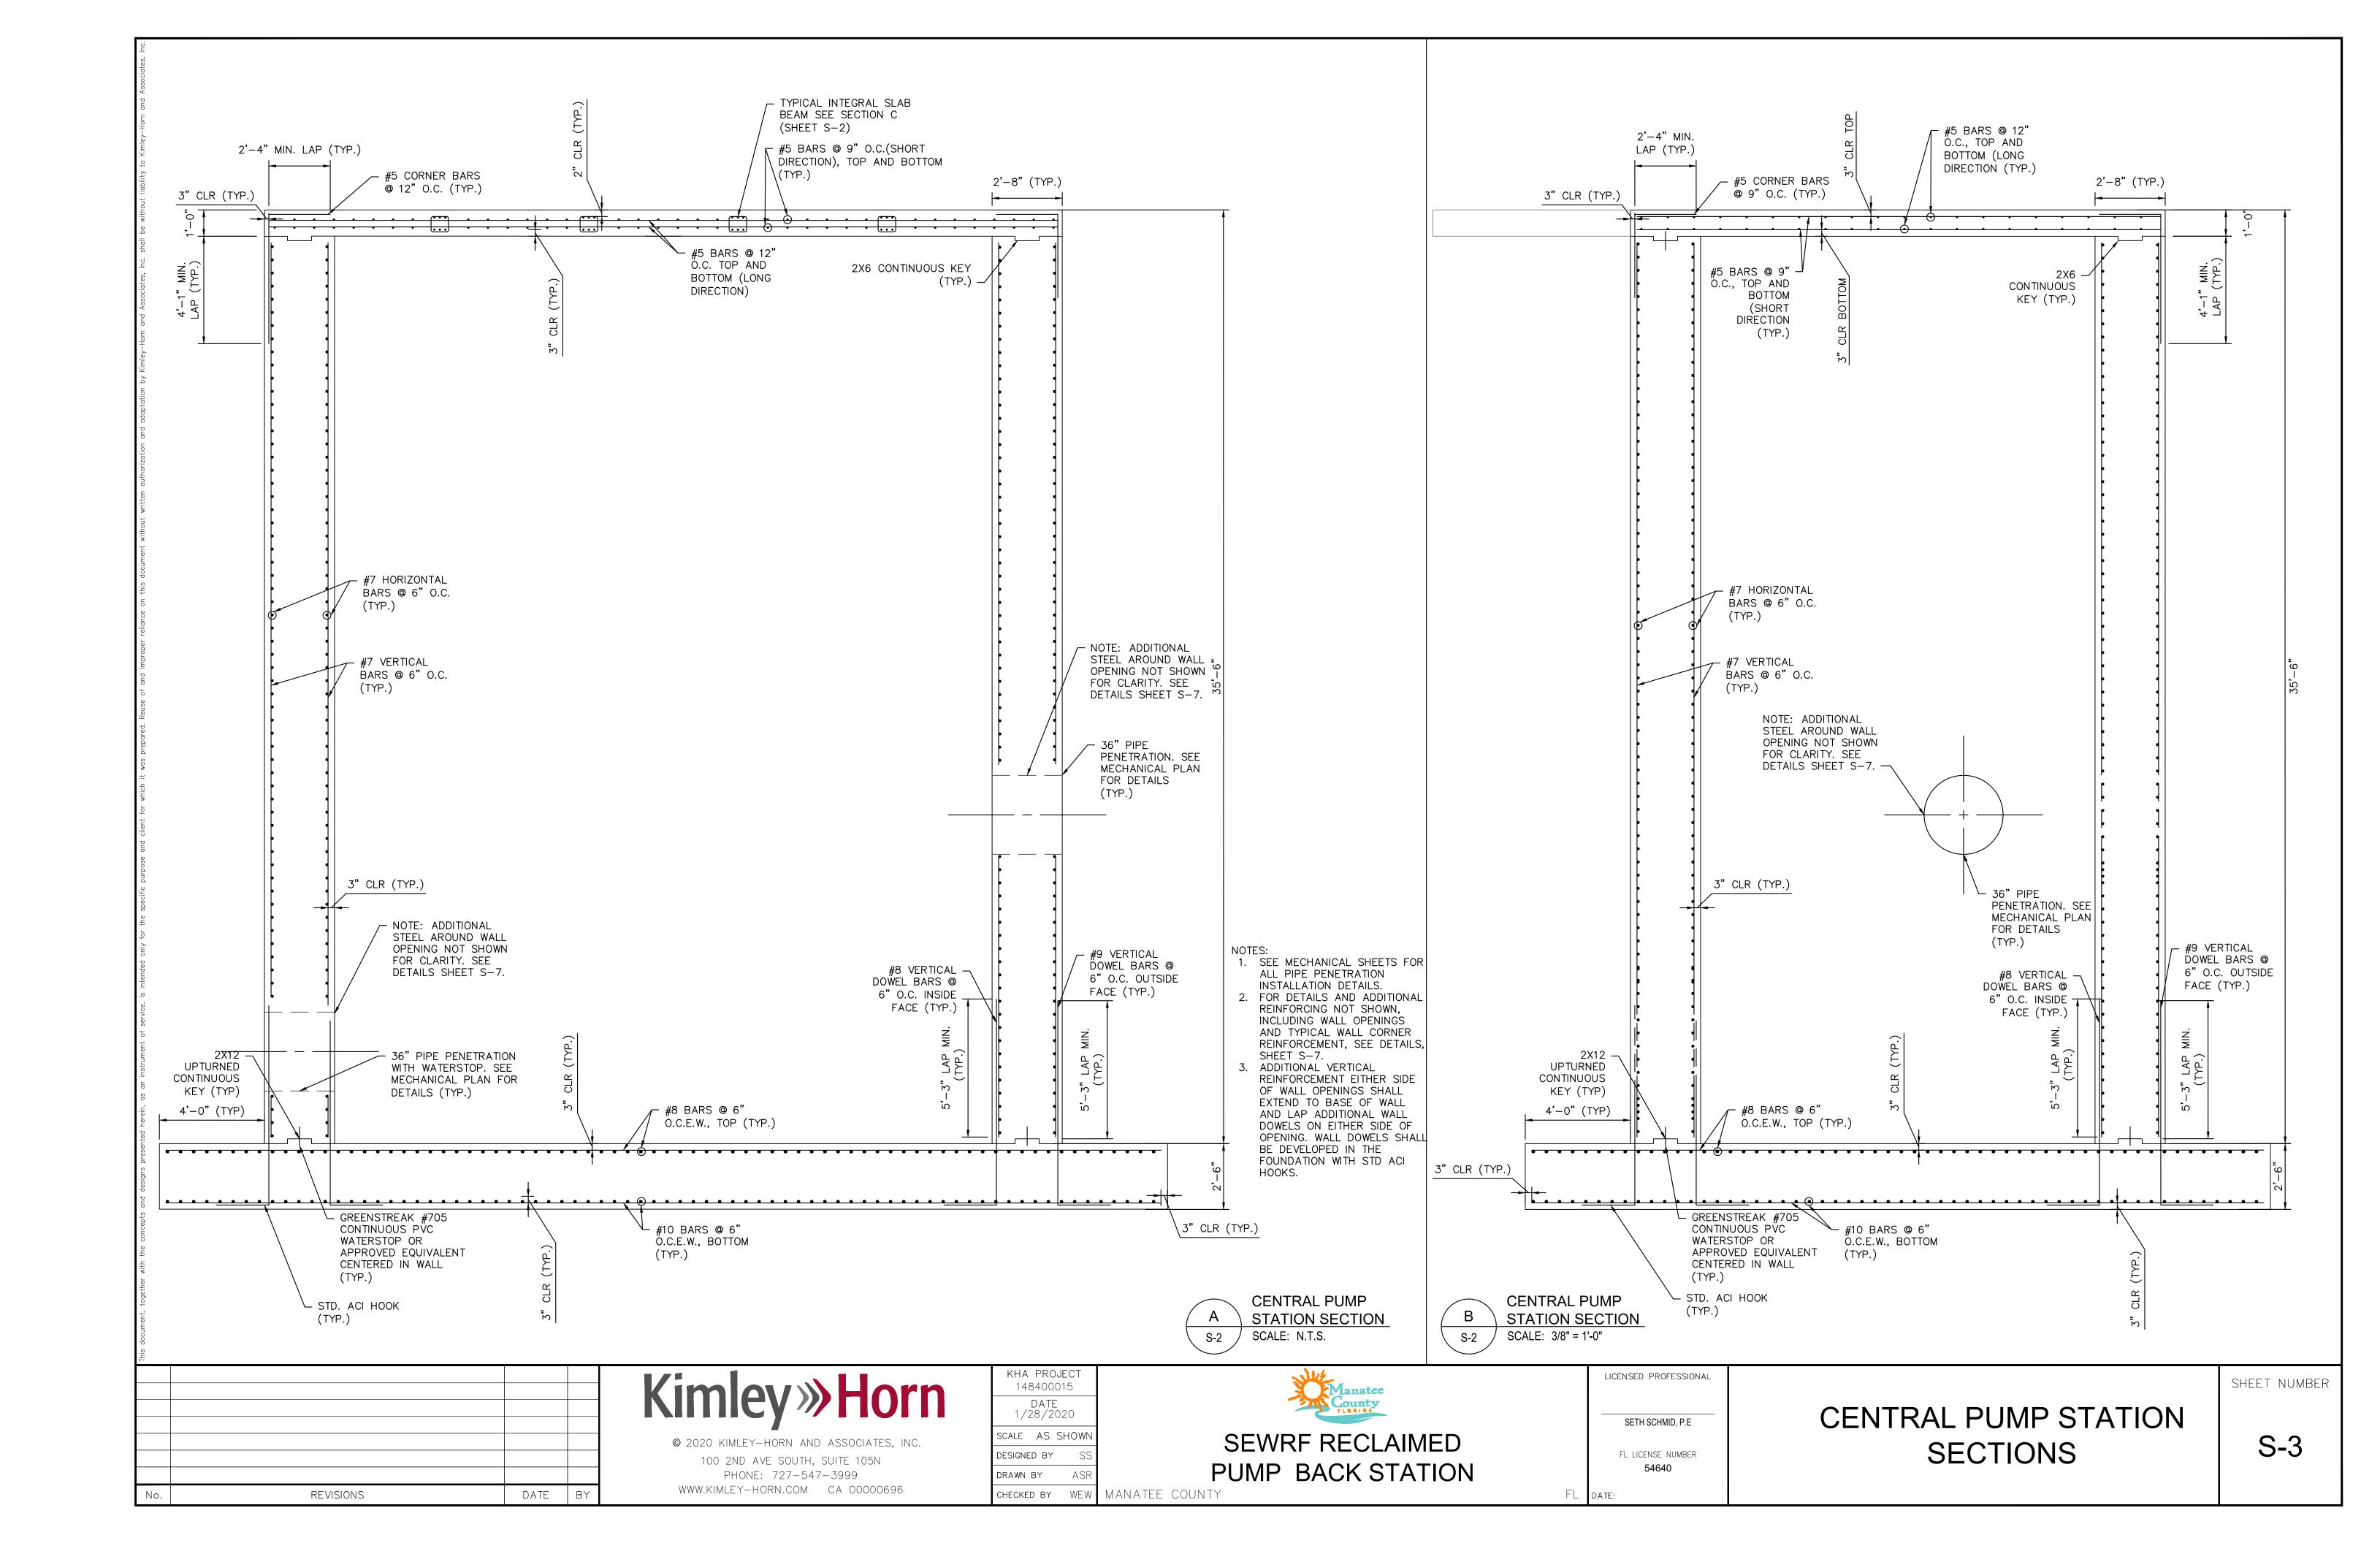
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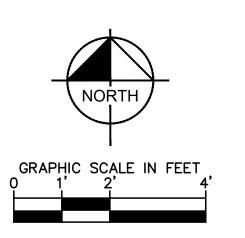
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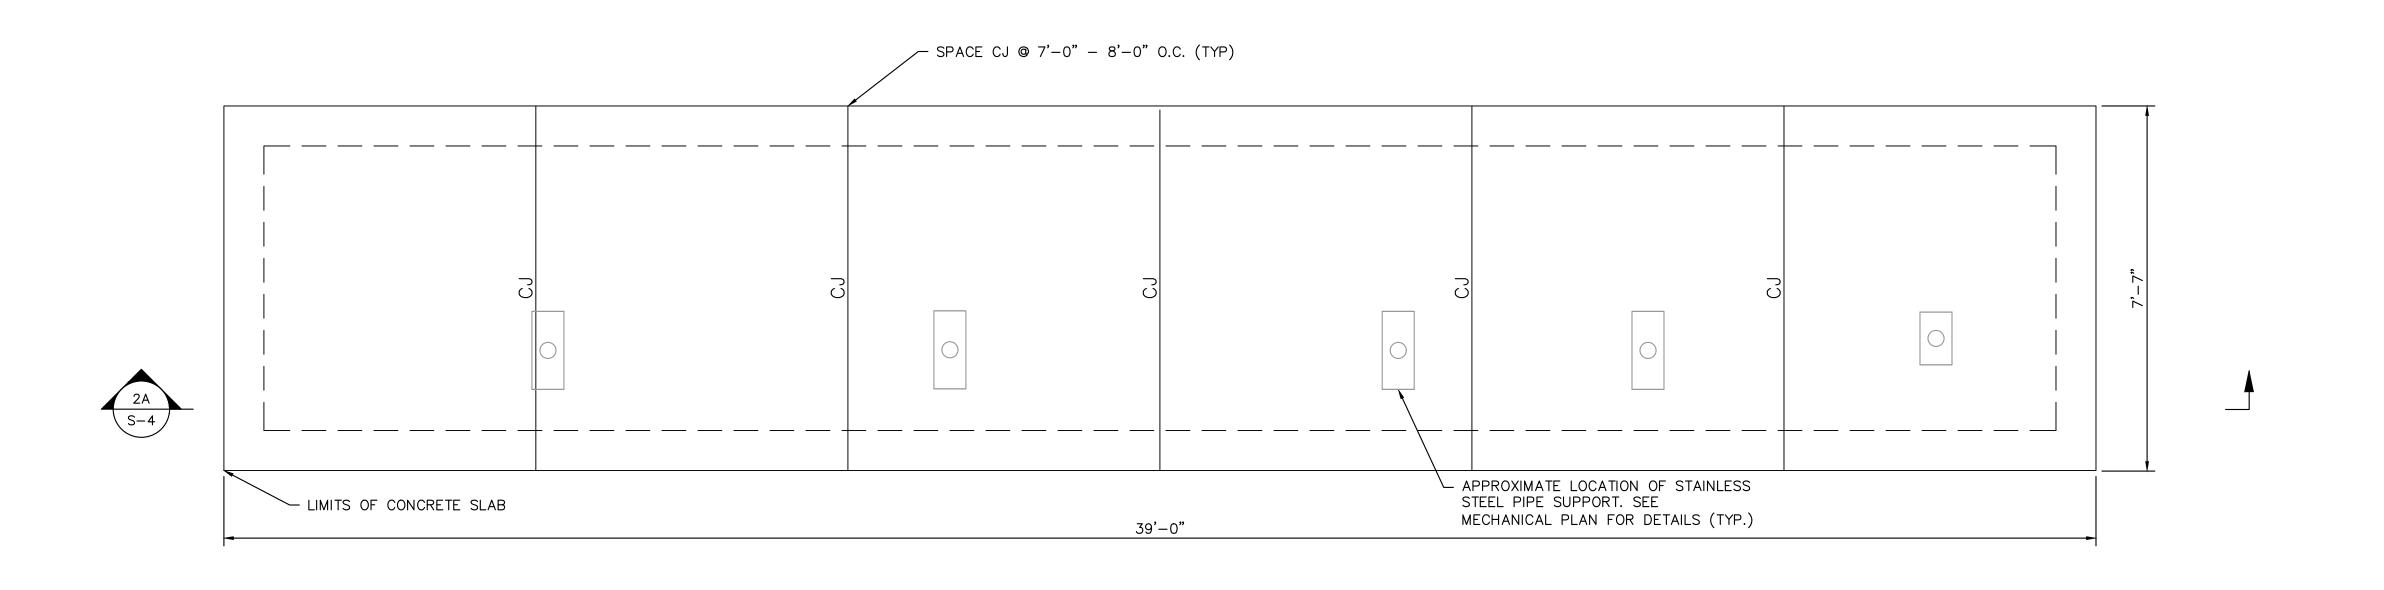
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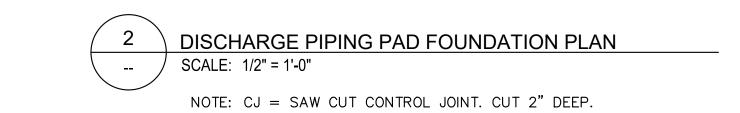
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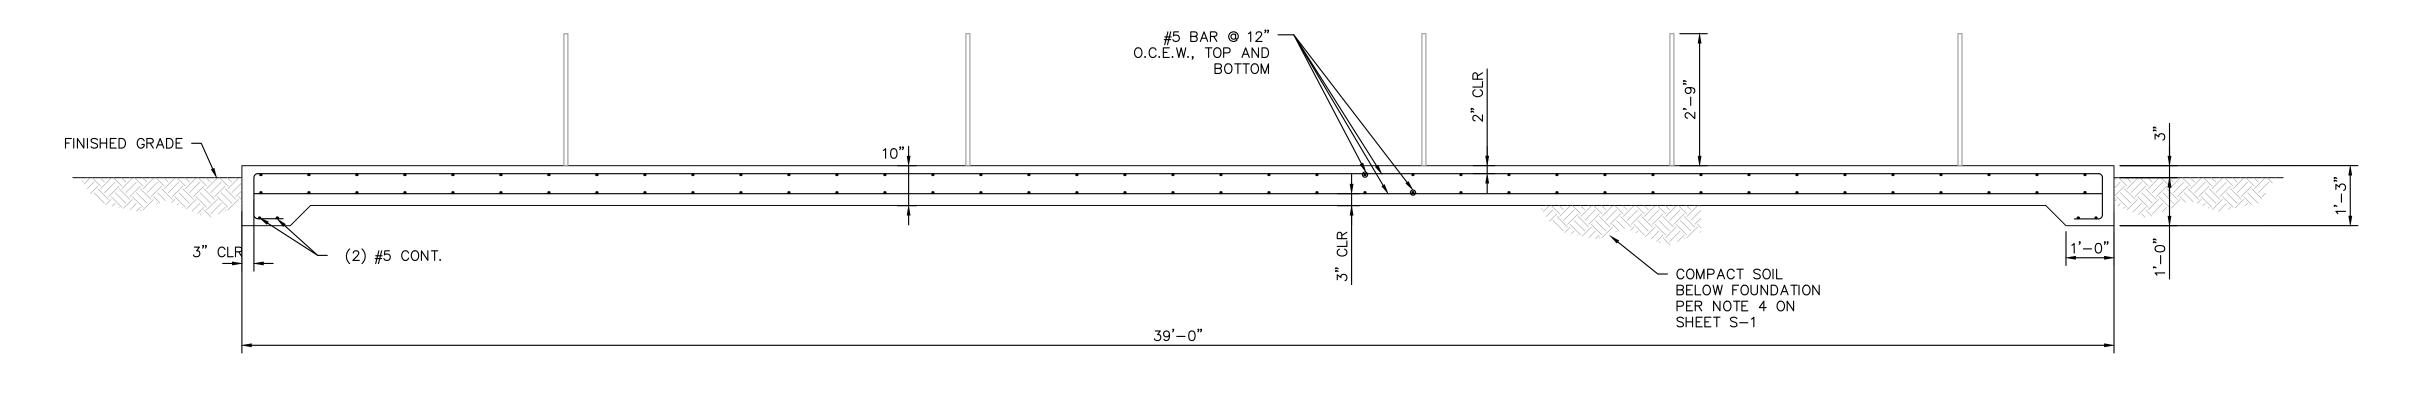










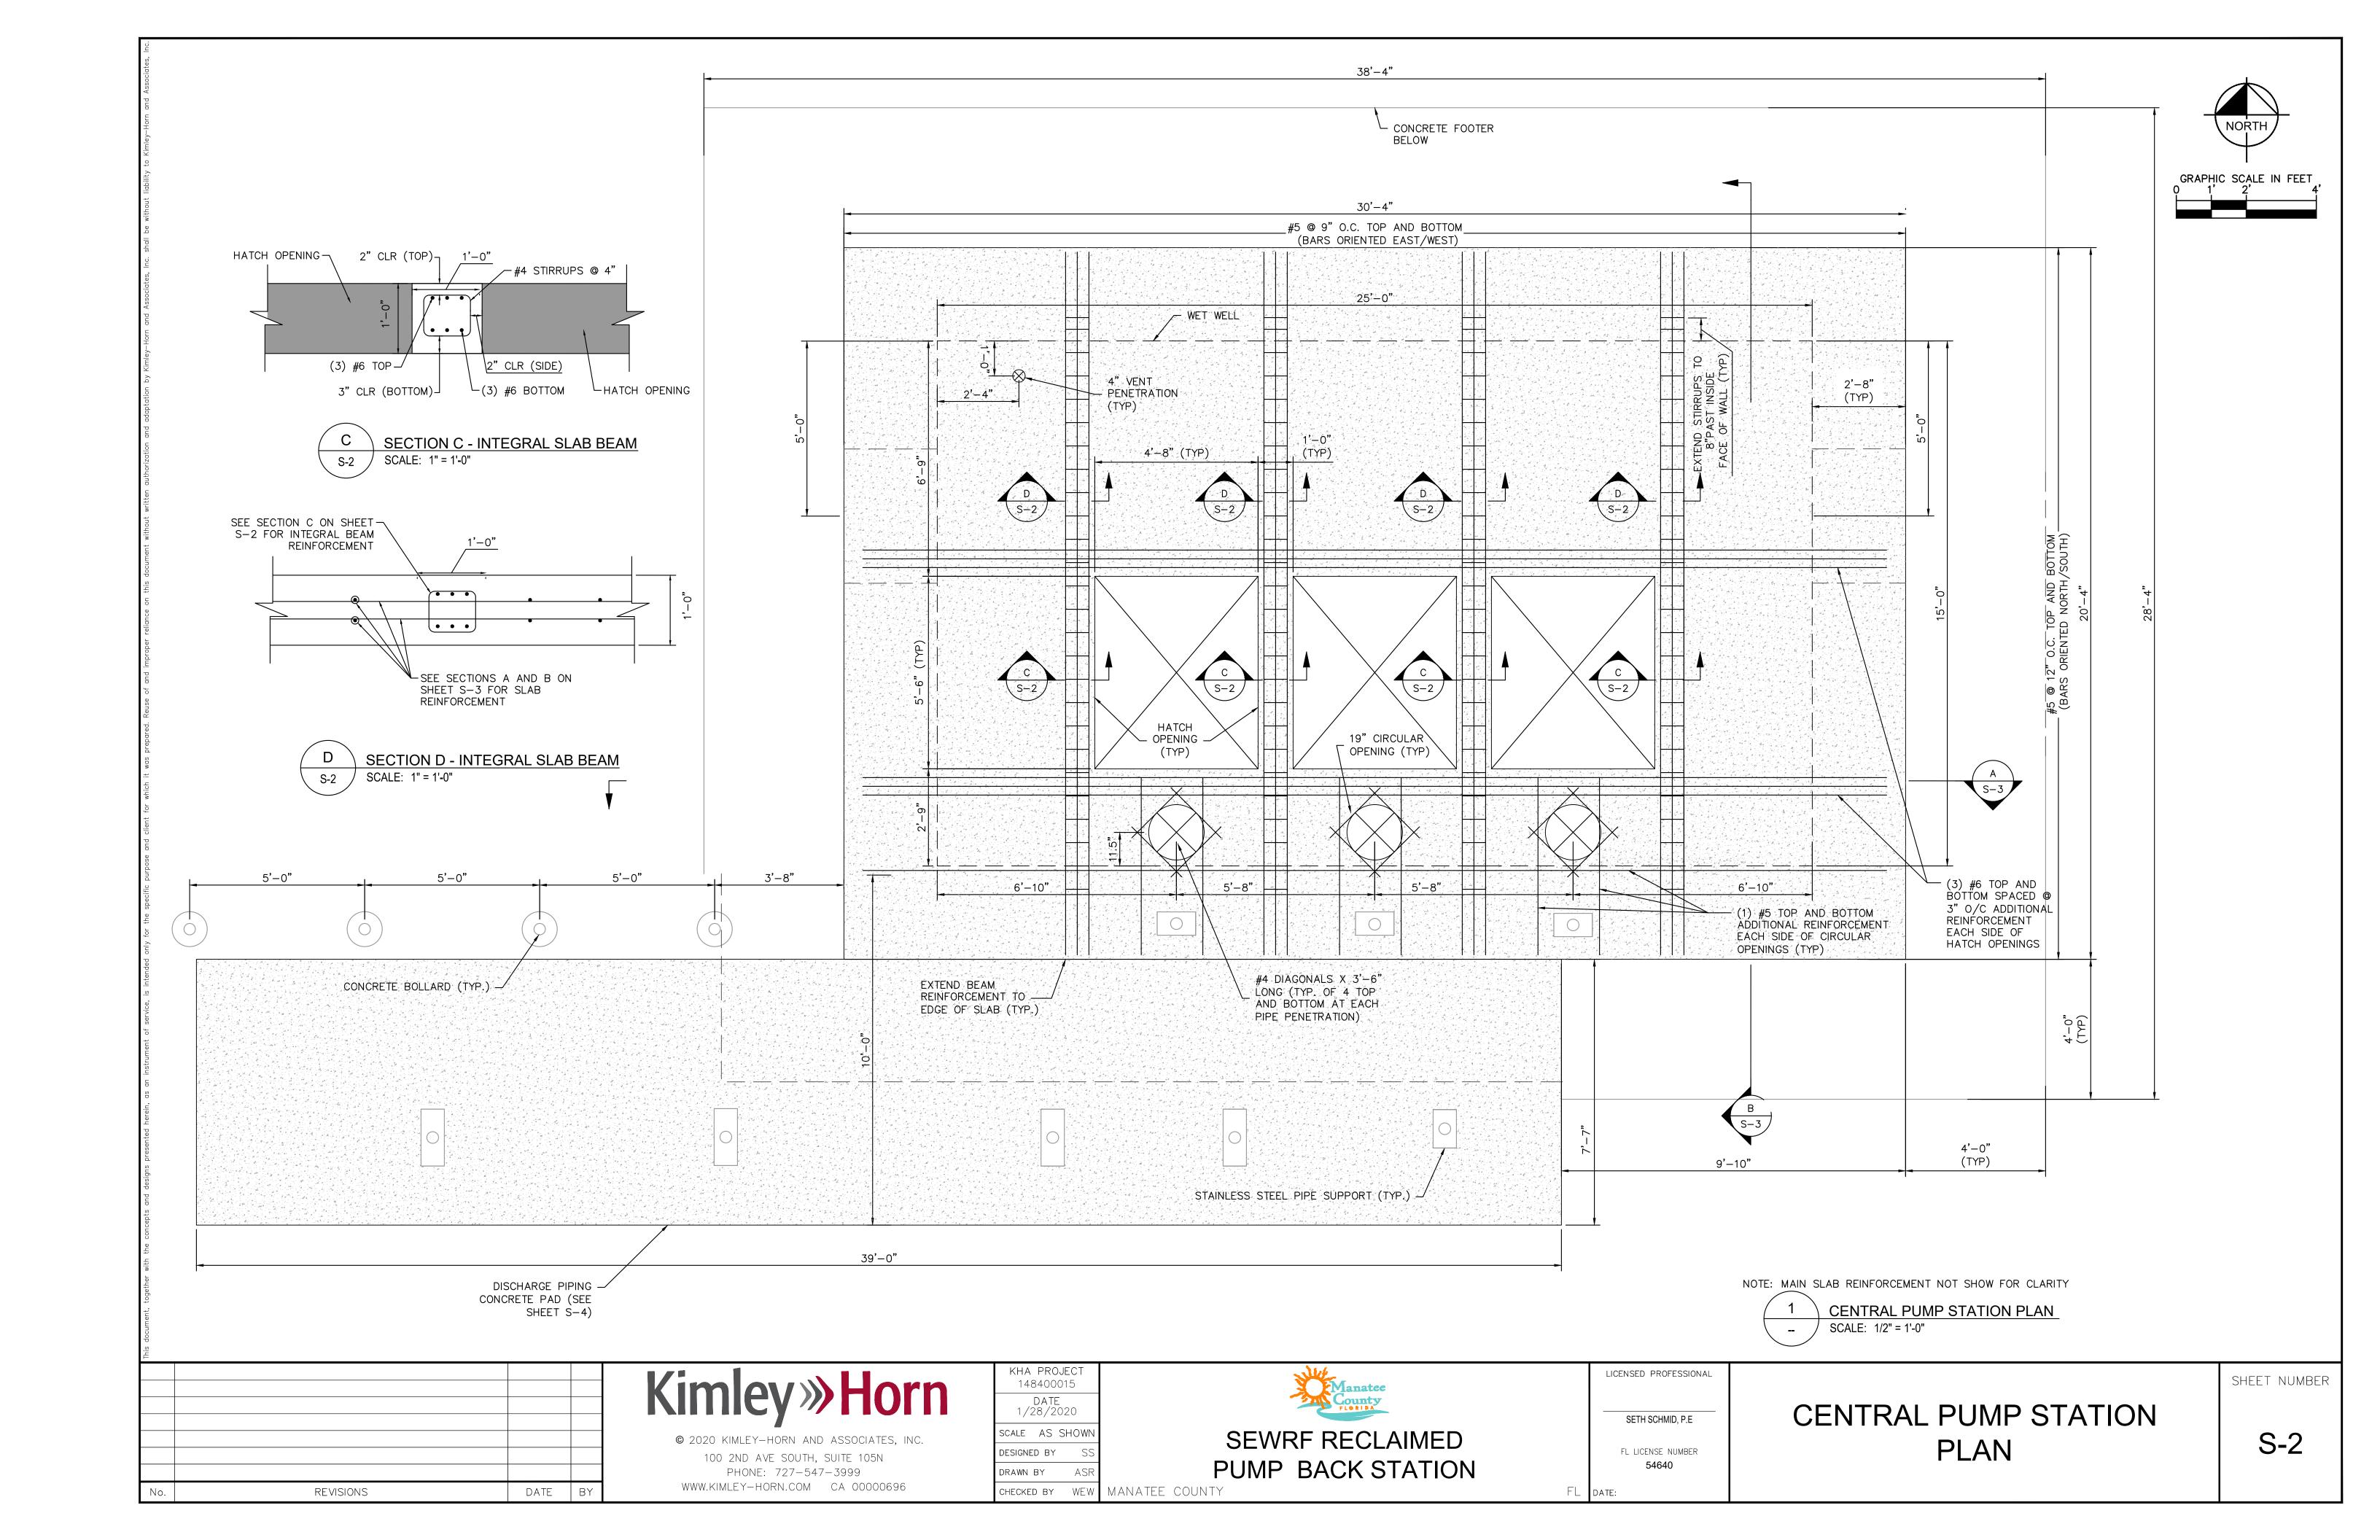



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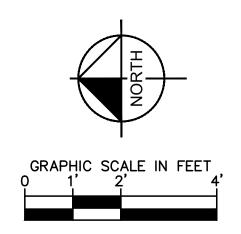
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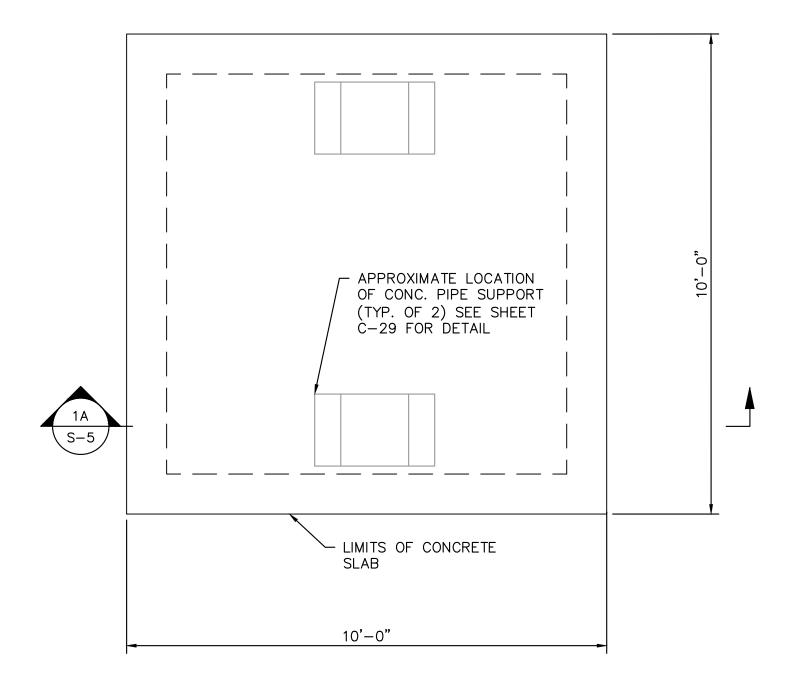
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DISCHARGE PIPING FOUNDATION


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1 INTAKE SCREEN PAD FOUNDATION PLAN

- SCALE: 1/2" = 1'-0"



1A INTAKE SCREEN PAD FOUNDATION SECTION
S-5 SCALE: 1/2" = 1'-0"

NOTES

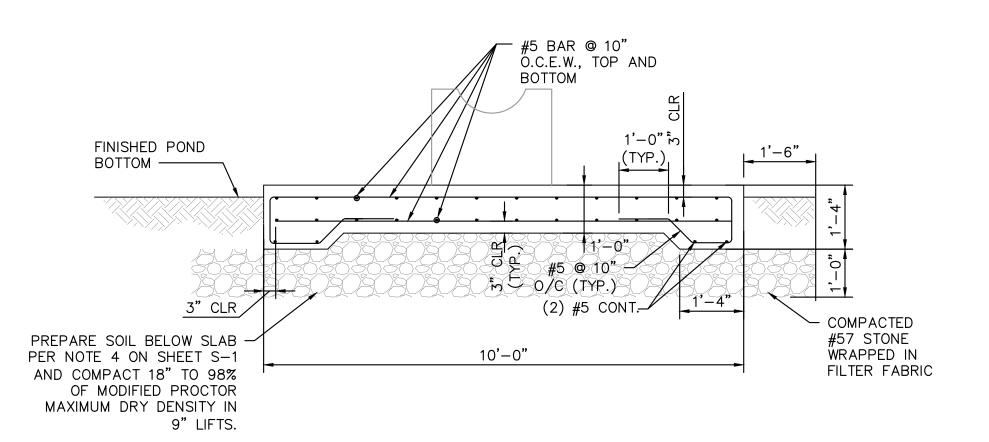- 1. CONTRACTOR SHALL BE RESPONSIBLE FOR PERFORMING THEIR OWN GEOTECHNICAL INVESTIGATION AT THE INTAKE STRUCTURE PRIOR TO AND DURING CONSTRUCTION
- PRIOR TO AND DURING CONSTRUCTION.

 2. THE INTAKE STRUCTURE SHALL BE CONSTRUCTED IN DRY CONDITIONS.

INTAKE SCREEN SLAB

CONDITIONS.

3. PREPARATION AND COMPACTION OF THE LAKE BOTTOM BELOW THE INTAKE STRUCTURE SHALL BE INSPECTED AND APPROVED BY THE CONTRACTOR'S GEOTECHINCAL ENGINEER PRIOR TO PLACEMENT OF THE #57 STONE

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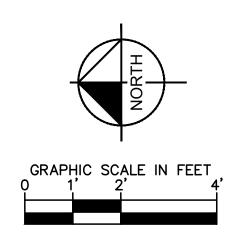
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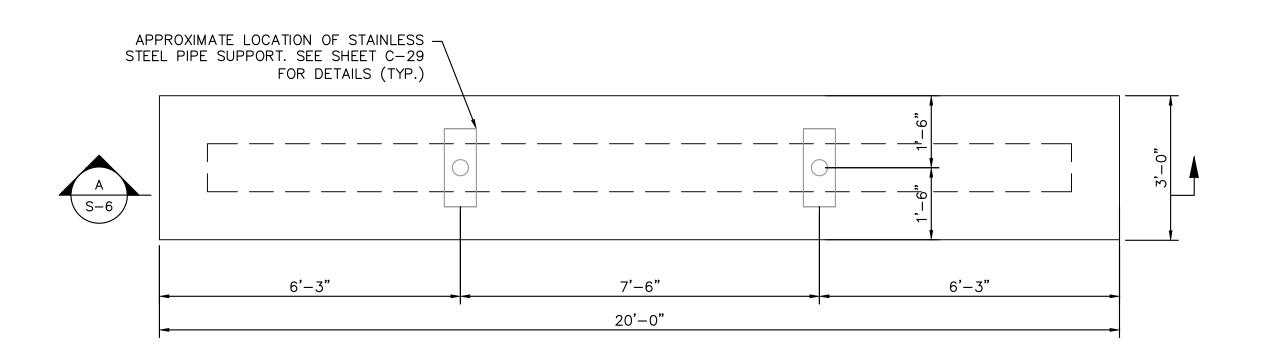
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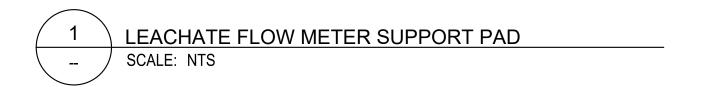
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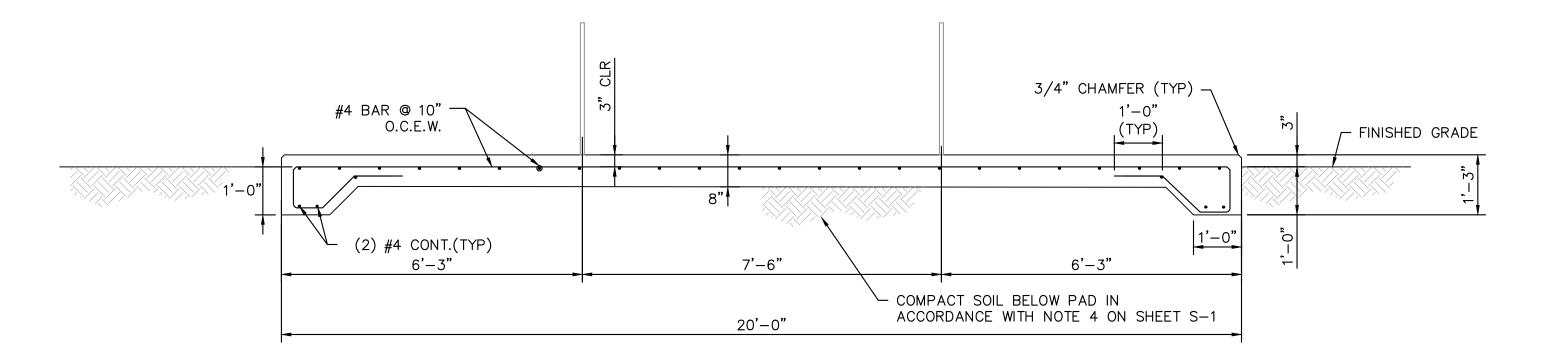
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A LEACHATE FLOW METER SUPPORT PAD SECTION SCALE: NTS

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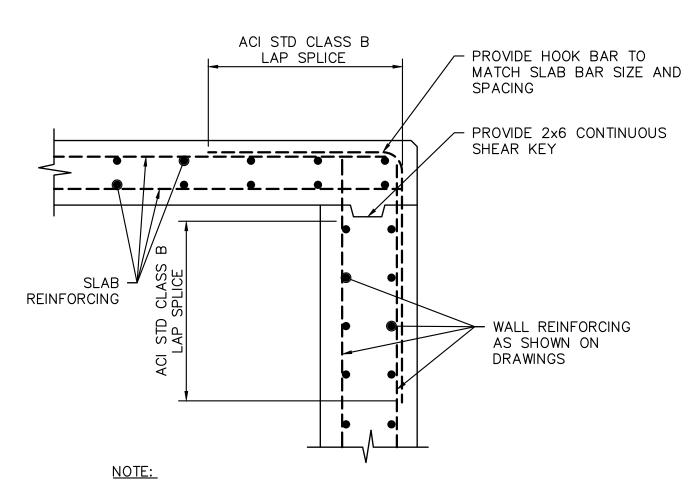
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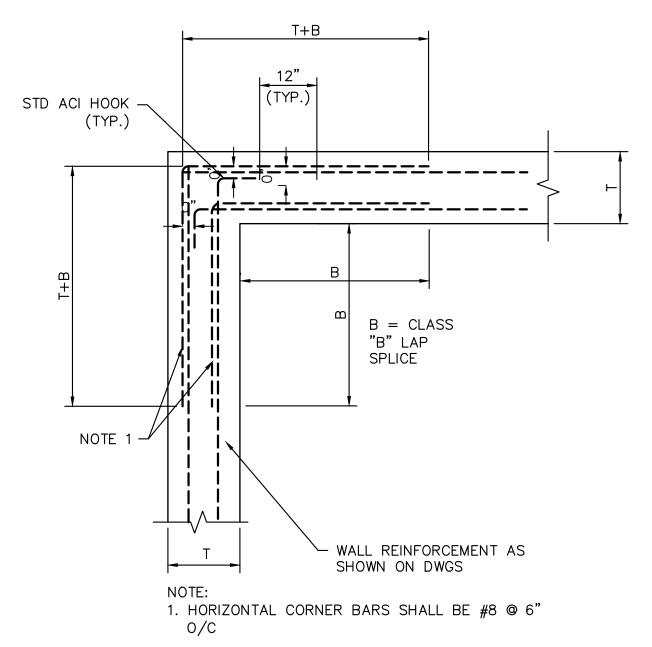
LEACHATE METERING ASSEMBLY PAD

SHEET NUMBER




1. REFER TO INDIVIDUAL STRUCTURE PLANS FOR WALL AND SLAB THICKNESSES AND REINFORCING








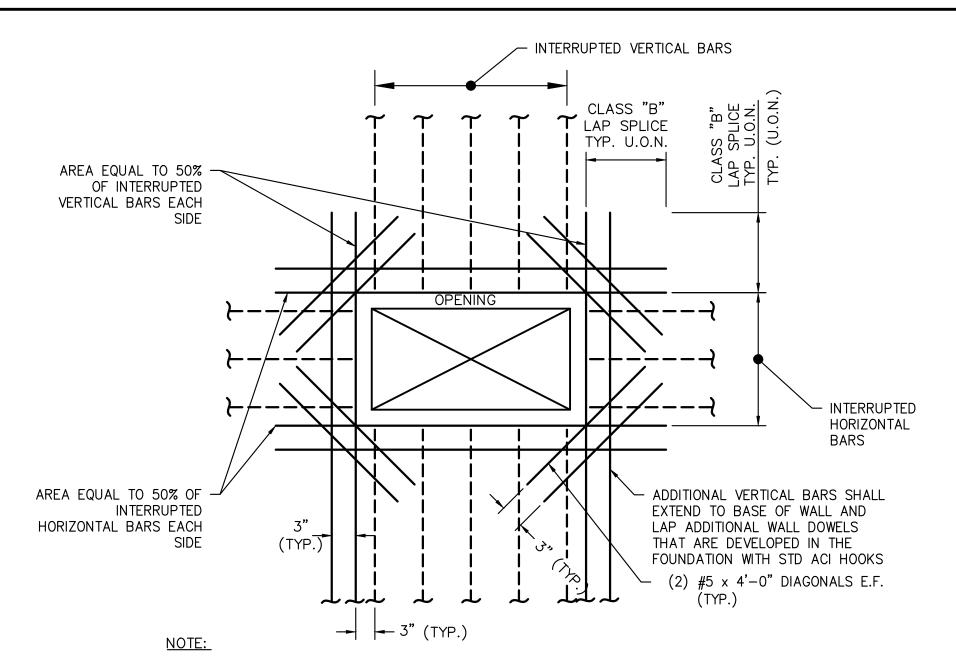


- 1. WHERE INTEGRAL BEAMS OR DROP DOWN BEAMS ARE ADJACENT TO OPENING, ADDITIONAL REINFORCING IS NOT REQUIRED.
- 2. PROVIDE 3" CLEAR AROUND OPENINGS, UNLESS NOTED OTHERWISE.
- 3. ADDITIONAL VERTICAL REINFORCING SHALL BE DEVELOPED IN FOOTING WITH STD ACI HOOKS



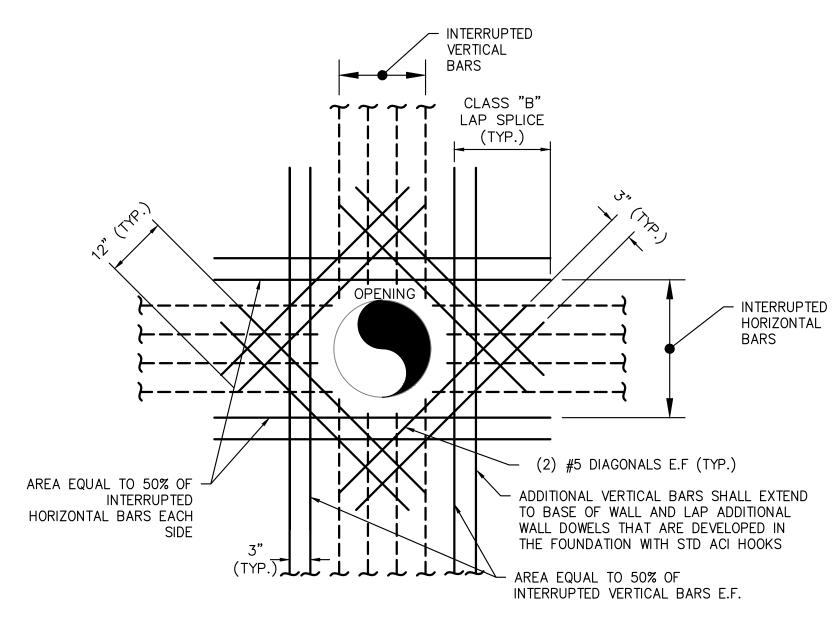

- 1. WHERE INTEGRAL BEAMS OR DROP DOWN BEAMS ARE ADJACENT TO OPENING, ADDITIONAL REINFORCING IS NOT REQUIRED.
- 2. PROVIDE 3" CLEAR AROUND OPENINGS, UNLESS NOTED OTHERWISE.
- 3. ADDITIONAL VERTICAL REINFORCING SHALL BE DEVELOPED IN FOOTING WITH STD ACI HOOKS

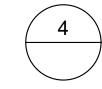

TYPICAL CIRCULAR OPENING REINFORCING DETAIL SCALE: NTS FOR WALL OPENINGS 12" OR GREATER IN DIAMETER


─/ INITIAL CAST ─── WALL SEE DETAIL "A" TYP. EA. FACE T/3 GREENSTREAK #679 CONT. PVC WATERSTOP OR APPROVED EQUAL

CLASS B SPLICE (TYP)

STOP WATERSTOP 6" BELOW TOP OF WALL.

- 1. CONTRACTOR SUBMIT LOCATION IF NOT SPECIFIED
- 2. DO NOT LOACTE VERTICAL CONTRUCTION JOINTS WITHIN 10' OF WET WELL CORNERS



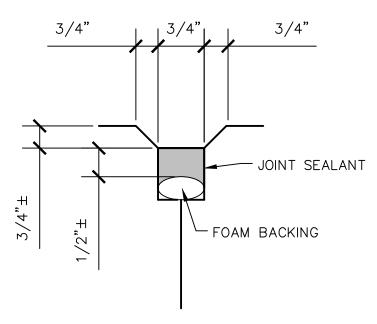


NOTE:


1. JOINT SEALANT SHALL BE SIKAFLEX - 2C NS EZ MIX OR APPROVED EQUIVALENT. INSTALL PER MANUFACTURERS REQUIREMENTS



DETAIL "A' CONTROL/CONSTRUCTION JOINT SCALE: NTS

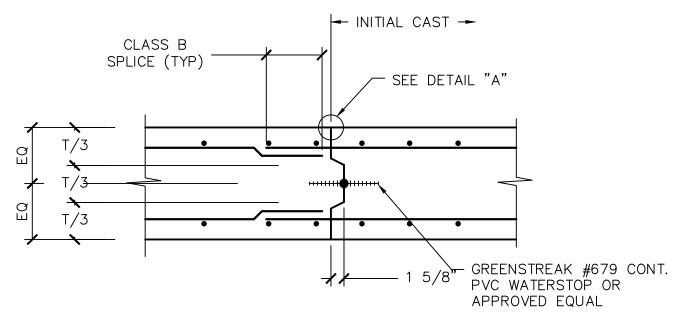

CONTRACTOR SUBMIT LOCATION IF NOT SPECIFIED

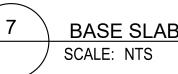

BASE SLAB CONSTRUCTION JOINT DETAIL

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SETH SCHMID, P.E FL LICENSE NUMBER 54640

FL DATE:

LICENSED PROFESSIONAL

STRUCTURAL DETAILS

SHEET NUMBER

