


SEWRF 10 MG STORAGE TANK AND INTERCONNECTION


COUNTY PROJECT No. 6084880

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MANATEE COUNTY, FLORIDA

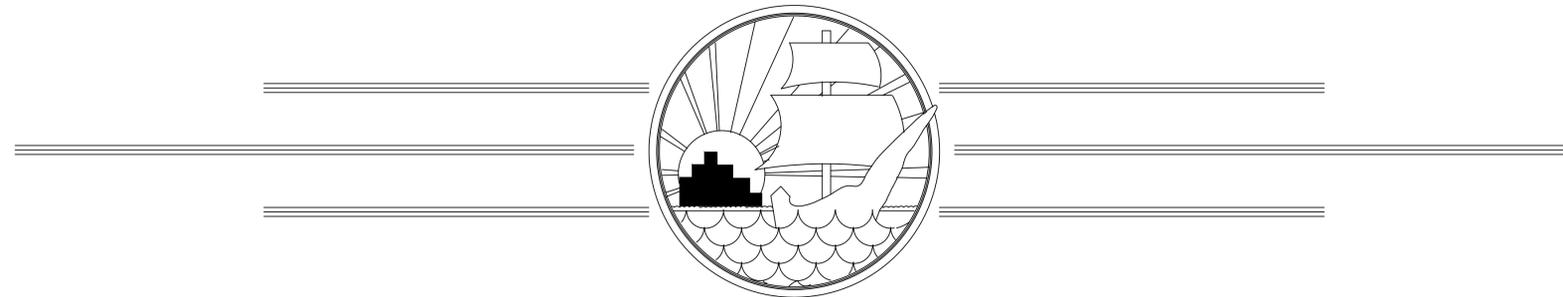



PROJECT VICINITY MAP
SECTION 35S, TOWNSHIP 18E, RANGE 1

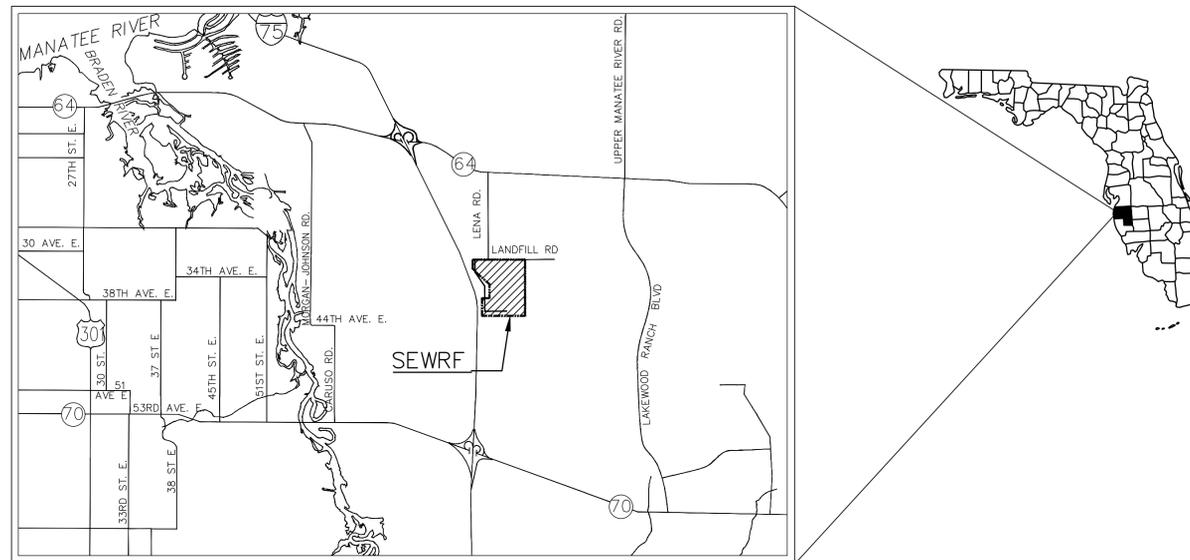

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No. 66118



LEGEND

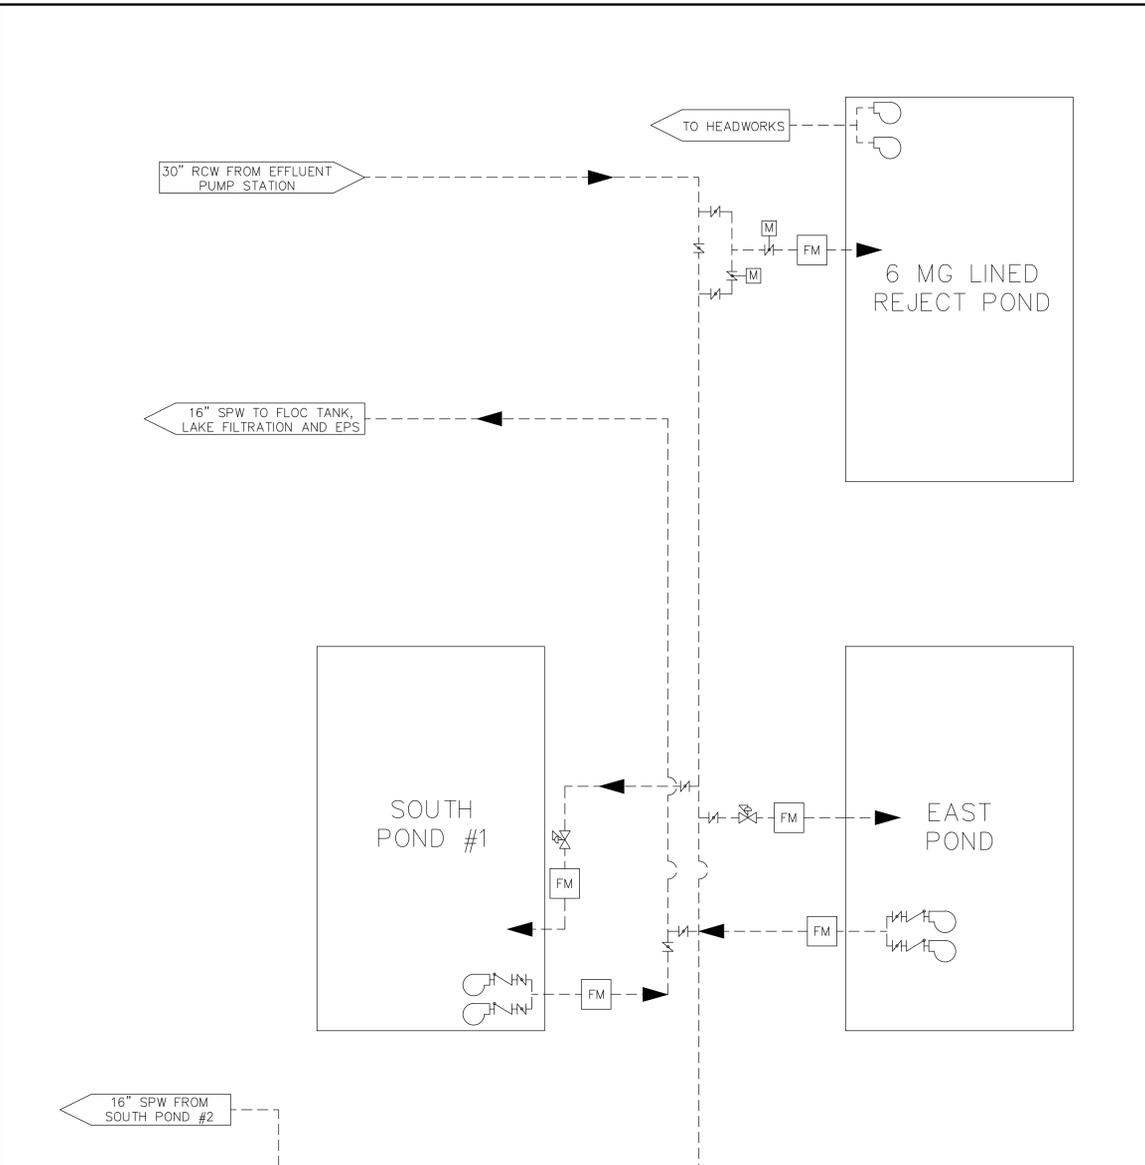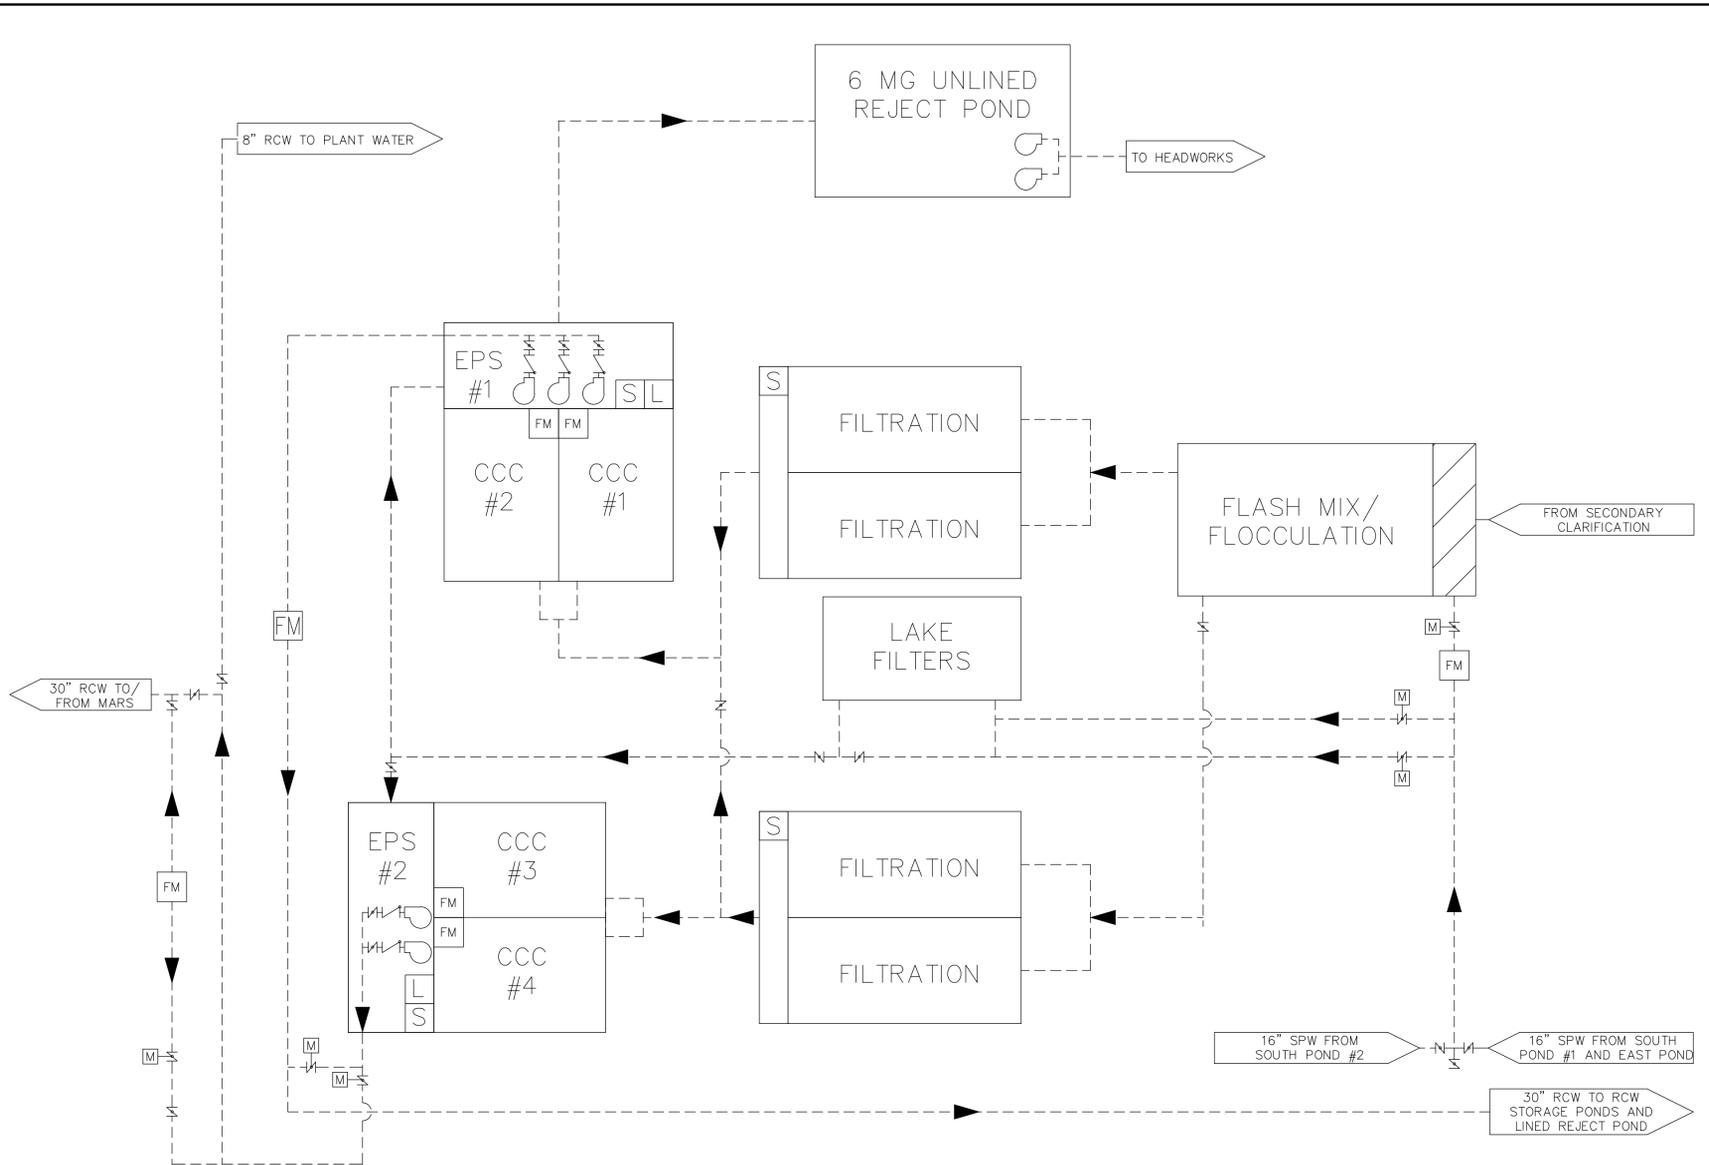- | | | | |
|-------|-----------------------------|-------|--------------------------------|
| [L] | LEVEL SENSOR/FLOW INDICATOR | [P] | PUMP |
| [S] | SAMPLING LOCATION | [CV] | CHECK VALVE |
| [FM] | FLOW METER | [BV] | BUTTERFLY VALVE |
| [—] | EXISTING EQUIPMENT | [MOV] | MOTOR OPERATED VALVE |
| [---] | EXISTING PIPING | [BSV] | BACK PRESSURE SUSTAINING VALVE |
| | | [SAV] | SURGE ANTICIPATOR VALVE |

REV. NO.	DESCRIPTIONS	DATE

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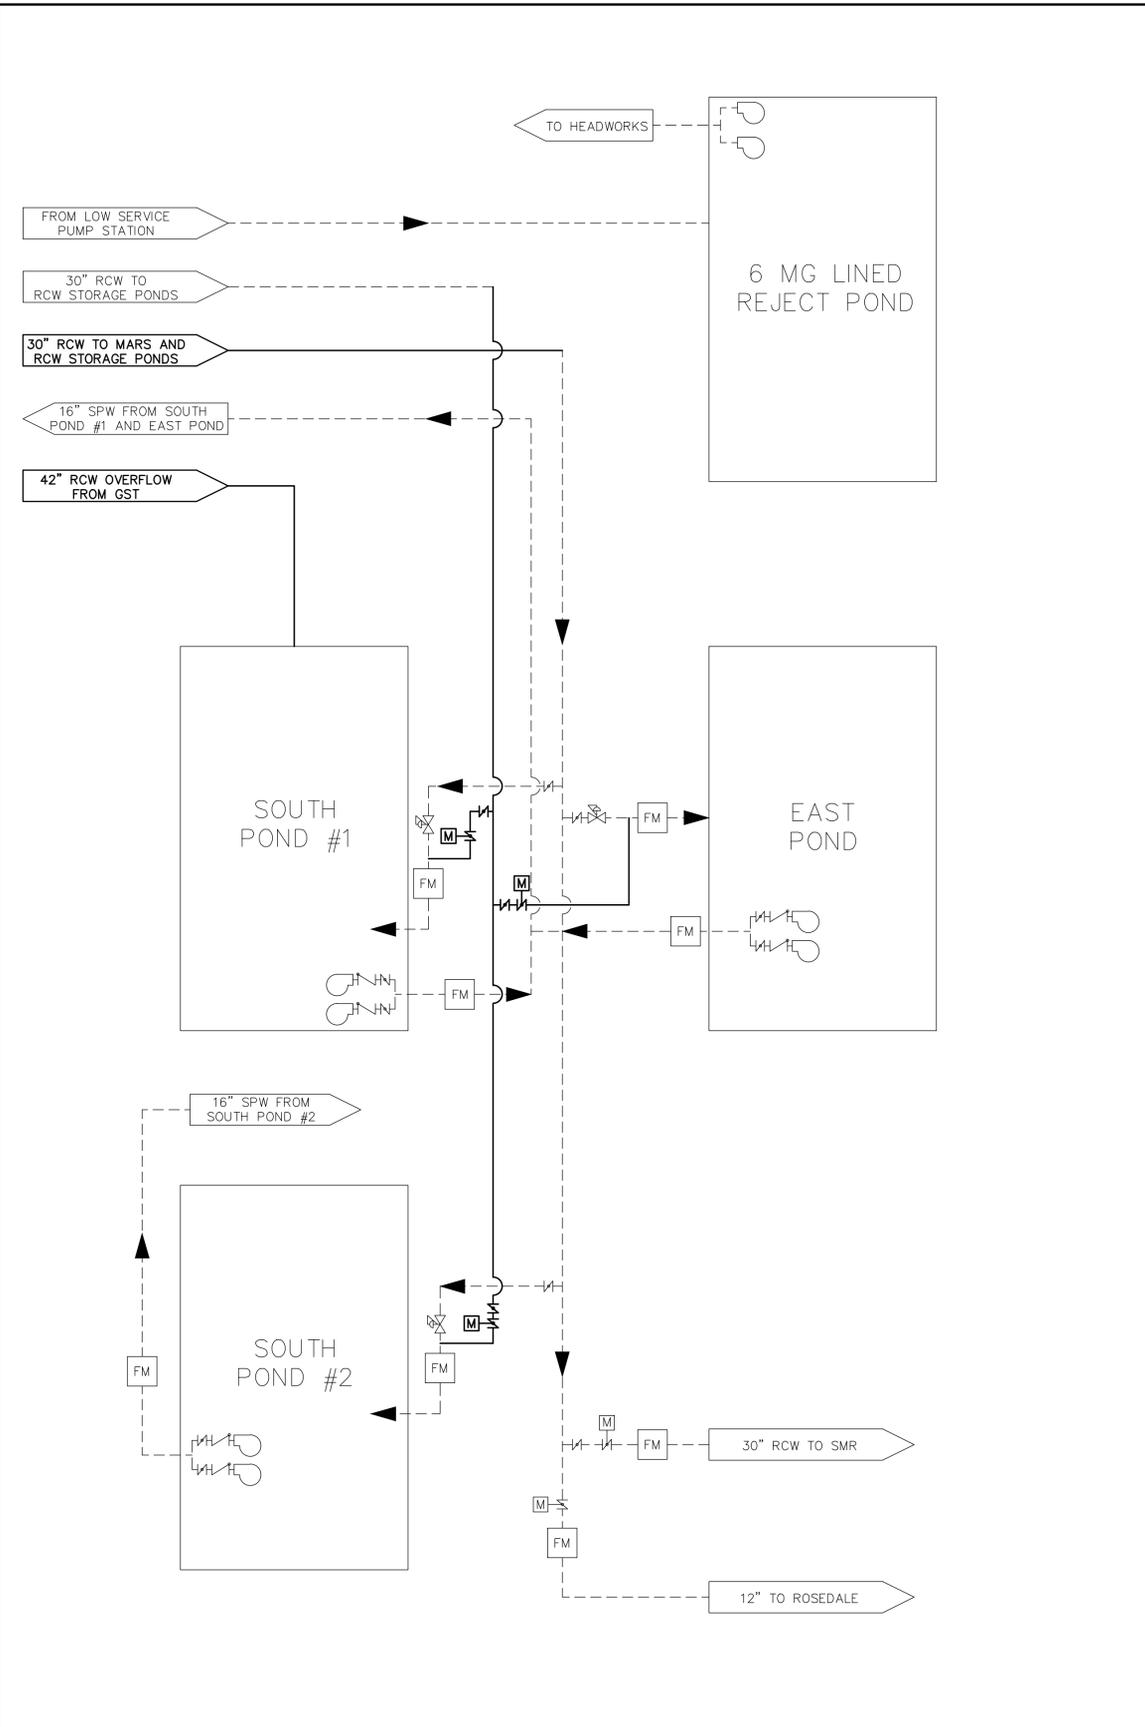
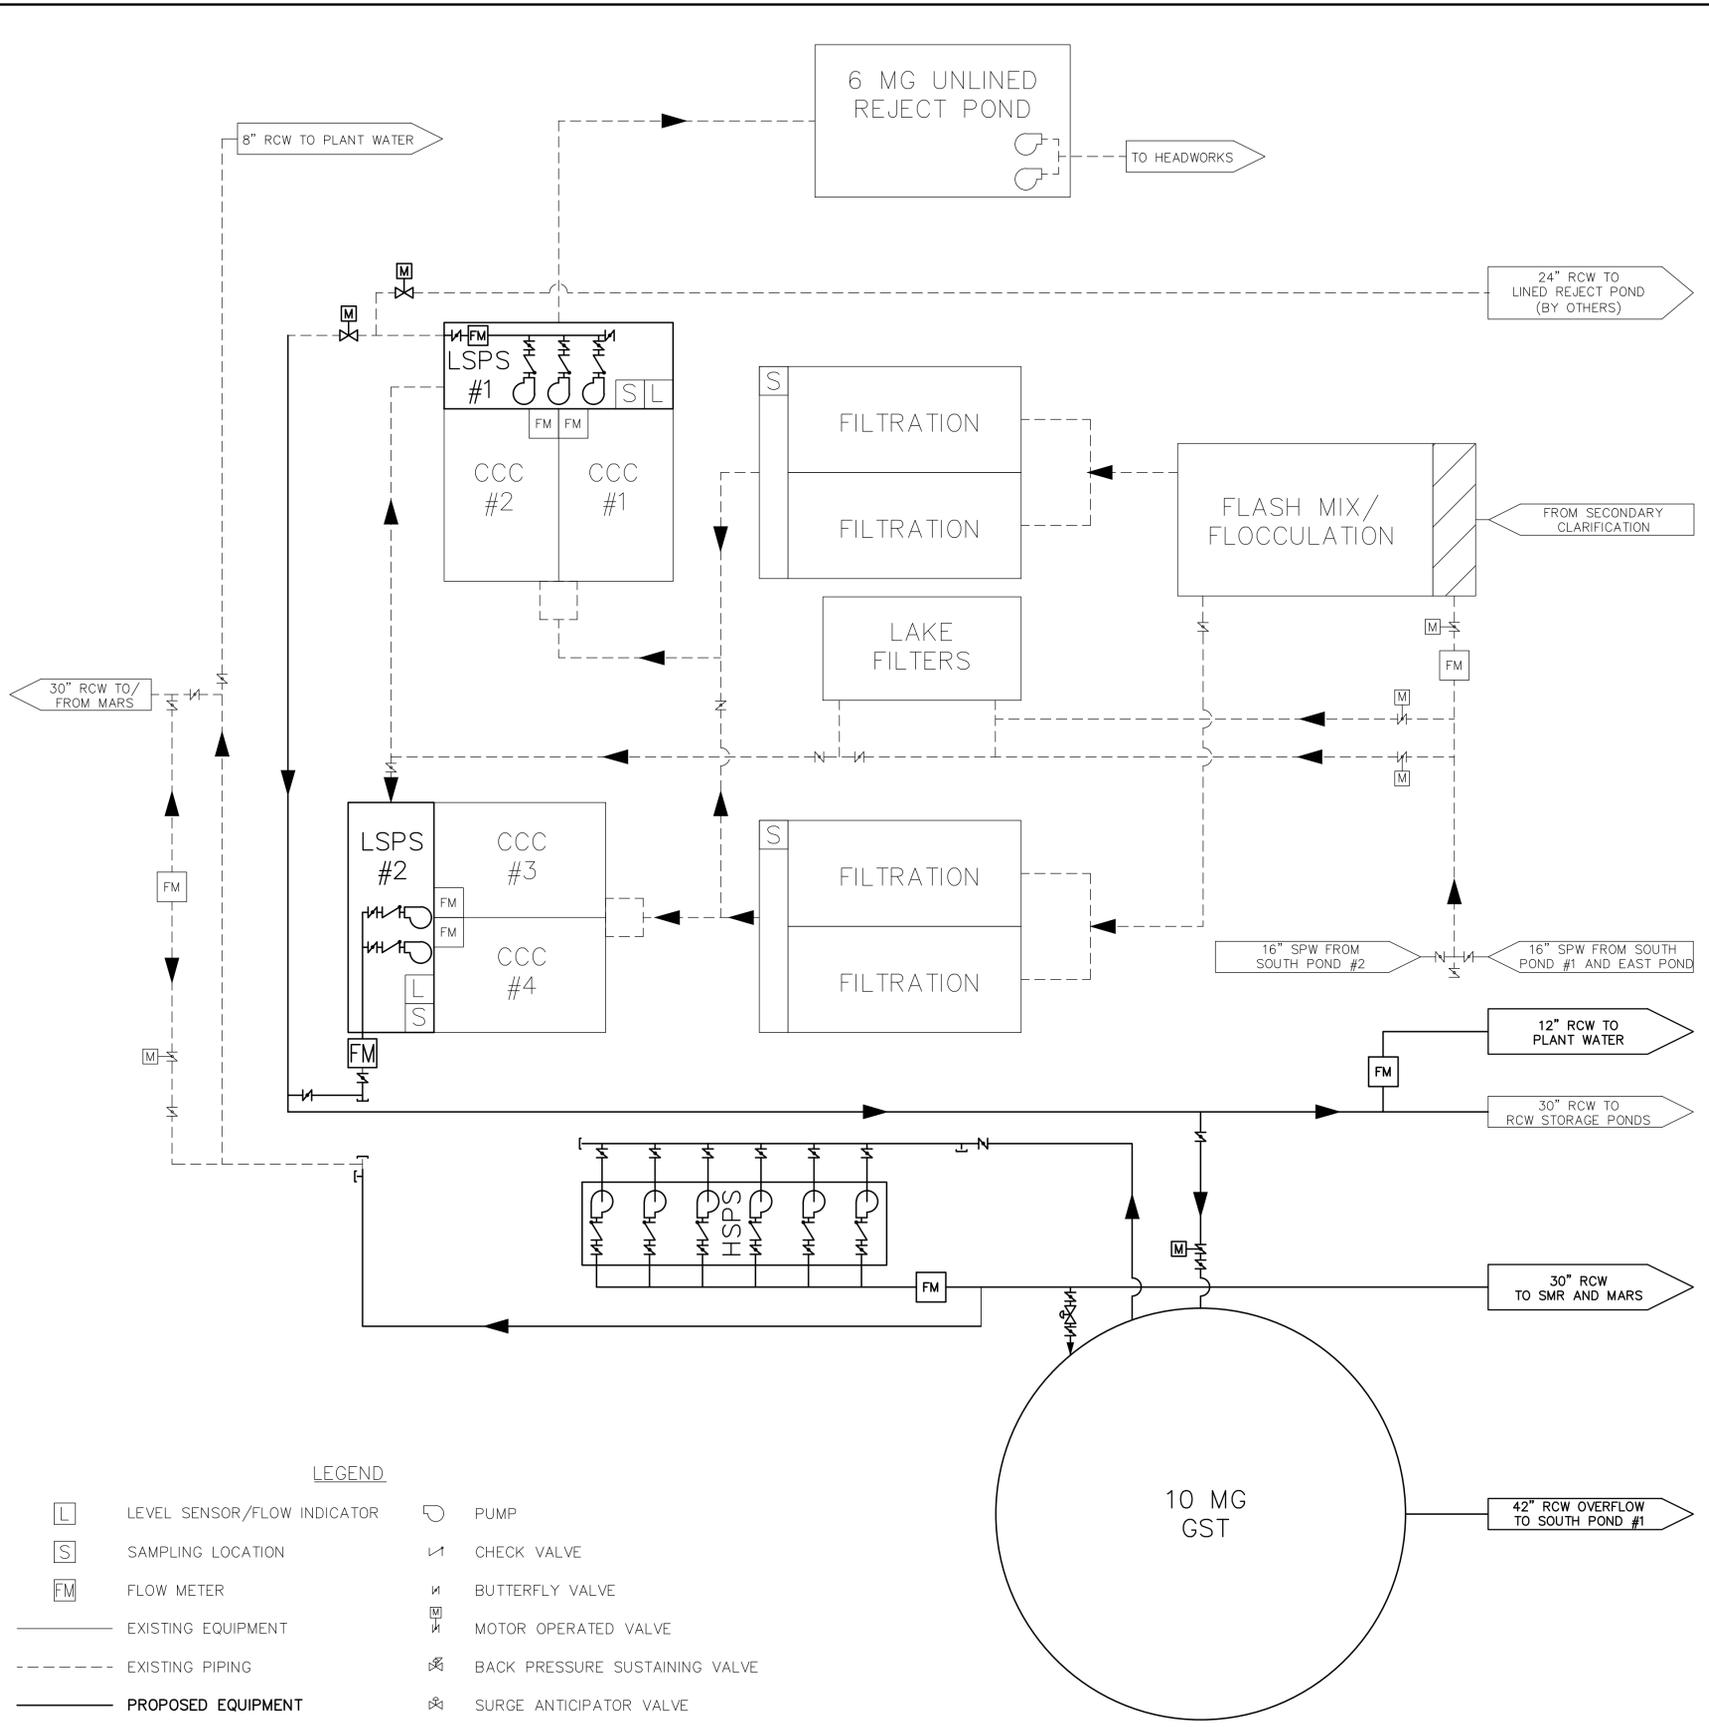
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SEWRF 10 MG STORAGE TANK AND INTERCONNECTION
EXISTING EFFLUENT TREATMENT PROCESS FLOW DIAGRAM

DATE: APRIL 2014	SCALE: NA	DRAWING NUMBER: G-0.4
MCE PROJ. # 1024-0160	HORIZONTAL: NA	
DRAWN: BFN	VERTICAL: NA	
DESIGNED: MSL		
CHECKED: JSL		
PROJ. MGR. MSL		
STATUS: ISSUE FOR BID		REVISION

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LEGEND

- | | | | |
|-------|-----------------------------|--------|--------------------------------|
| [L] | LEVEL SENSOR/FLOW INDICATOR | [P] | PUMP |
| [S] | SAMPLING LOCATION | [CV] | CHECK VALVE |
| [FM] | FLOW METER | [BV] | BUTTERFLY VALVE |
| — | EXISTING EQUIPMENT | [MOV] | MOTOR OPERATED VALVE |
| - - - | EXISTING PIPING | [BPSV] | BACK PRESSURE SUSTAINING VALVE |
| — | PROPOSED EQUIPMENT | [SAV] | SURGE ANTICIPATOR VALVE |
| — | PROPOSED PIPING | | |

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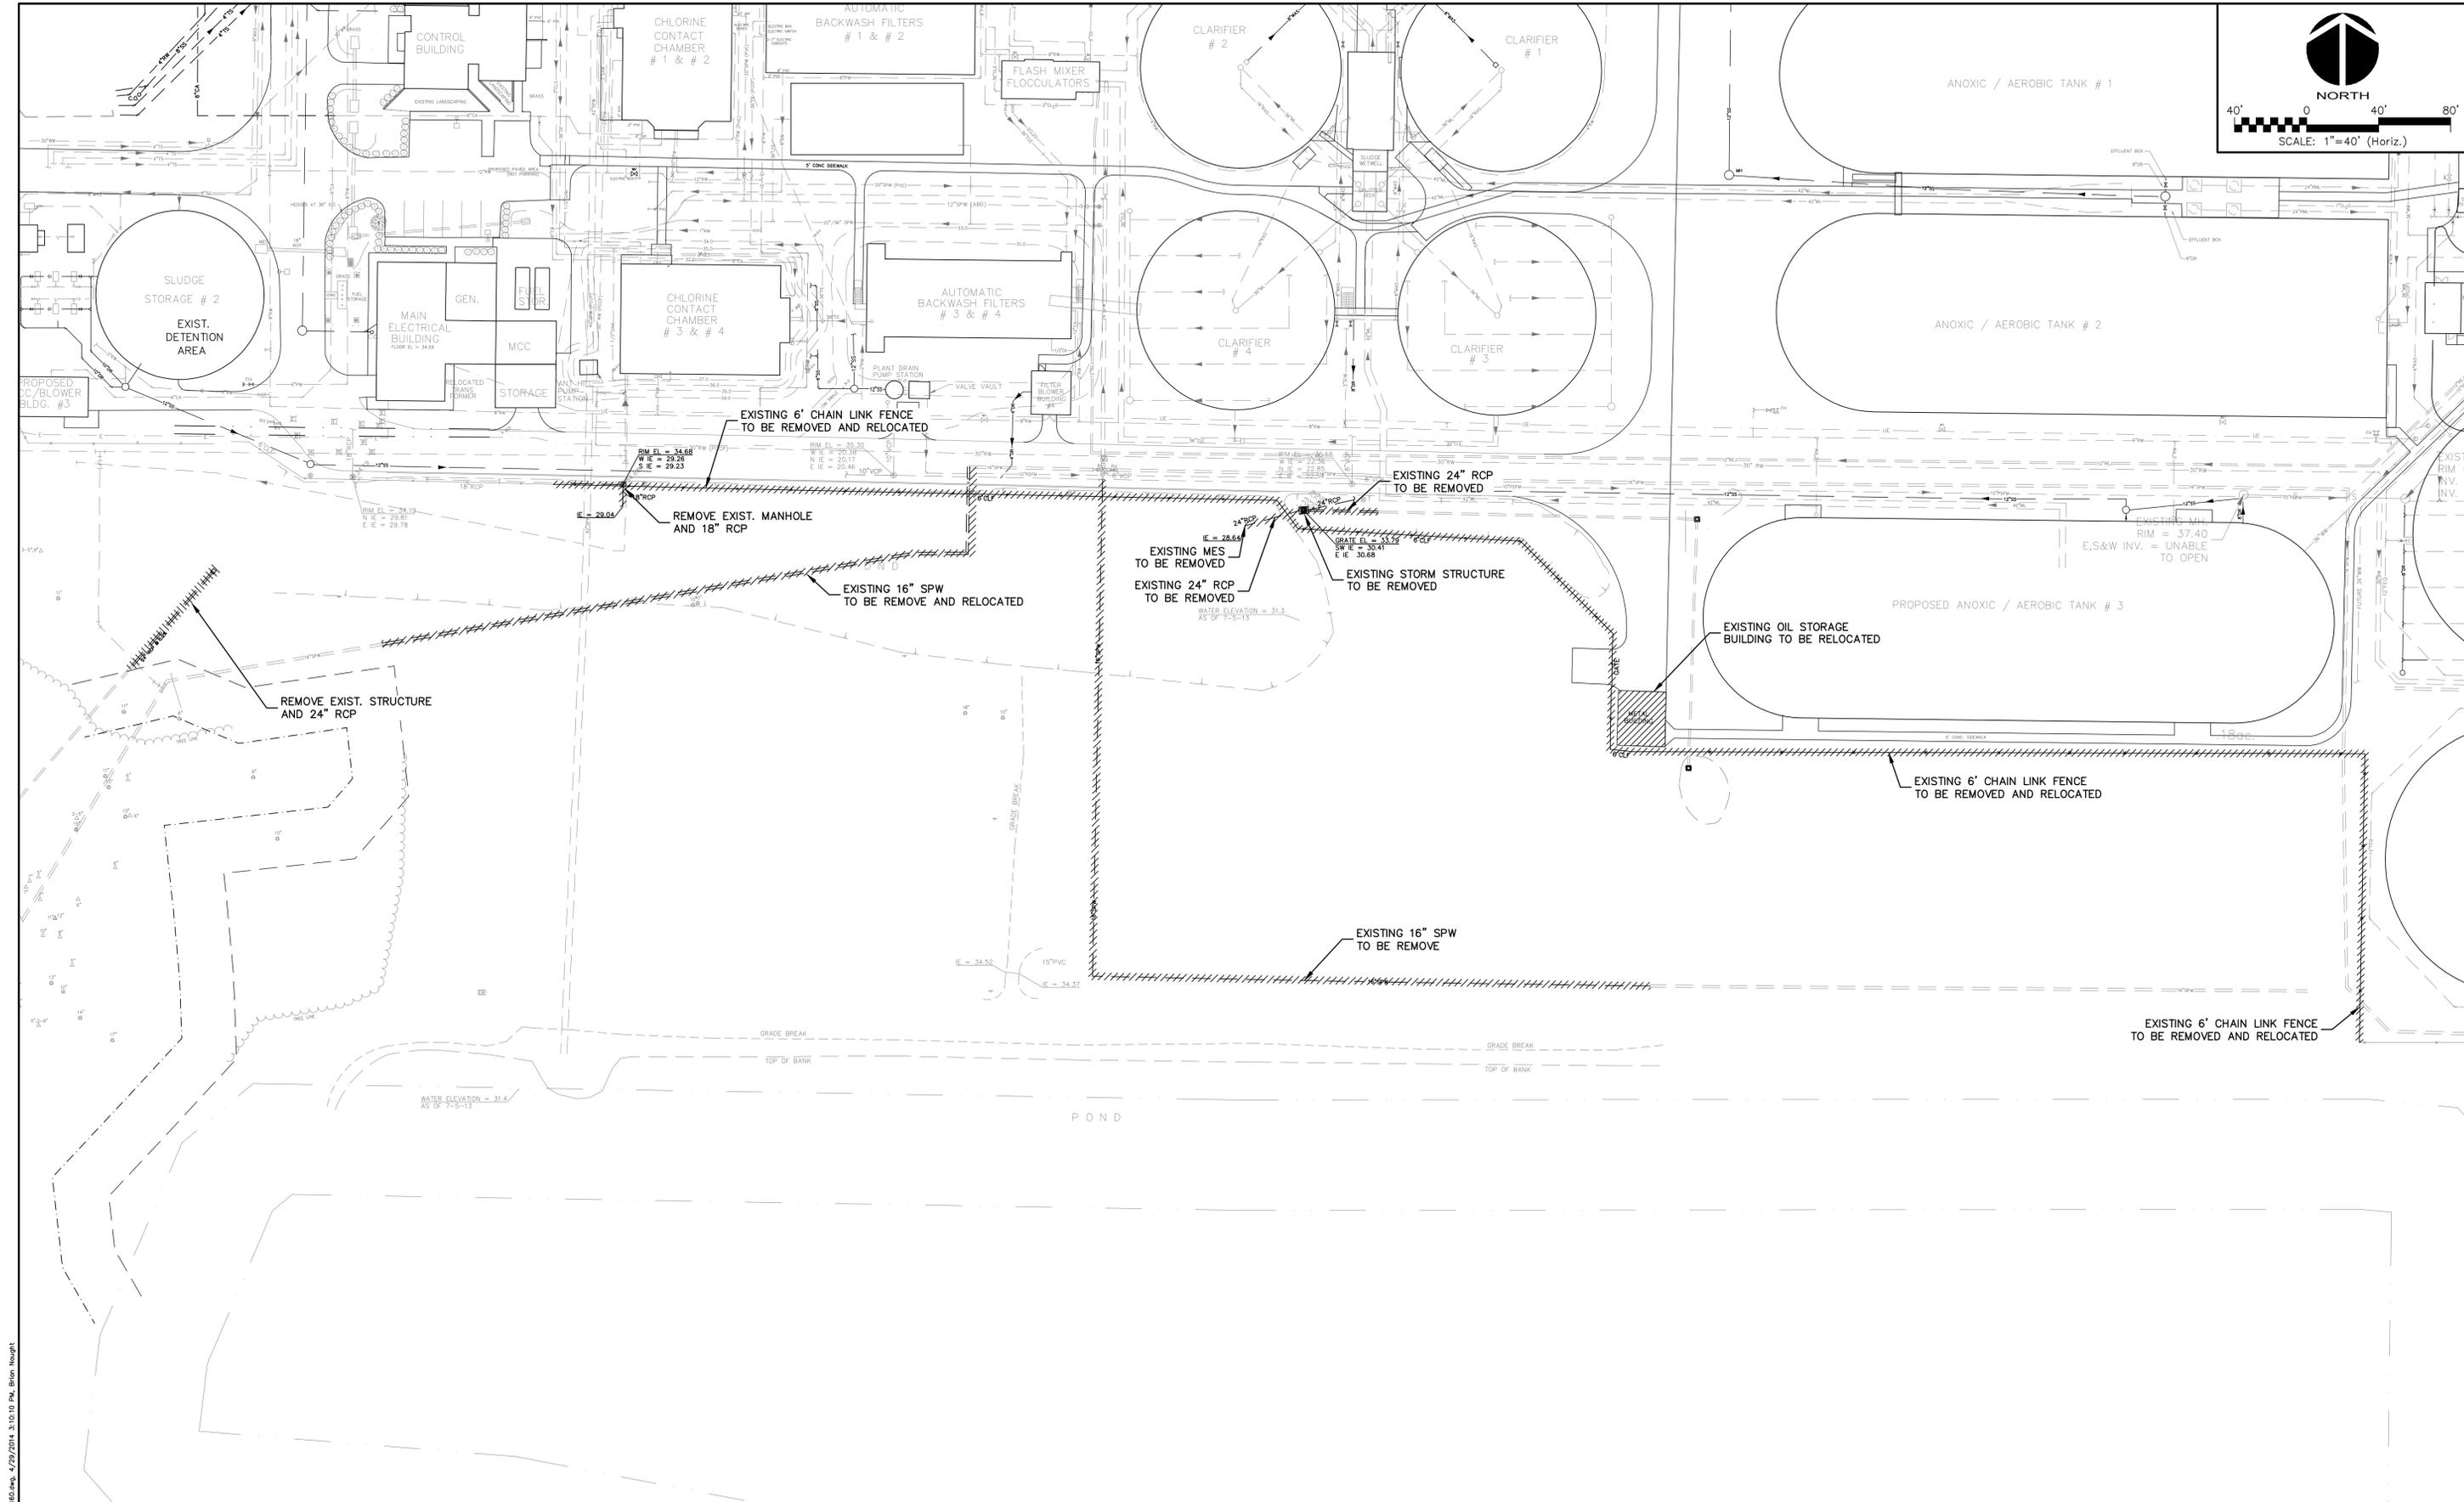
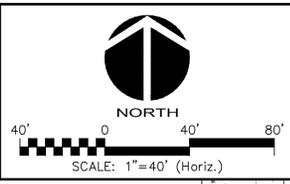
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SEWRF 10 MG STORAGE TANK AND INTERCONNECTION
PROPOSED EFFLUENT TREATMENT PROCESS FLOW DIAGRAM

DATE: APRIL 2014	SCALE: NA	DRAWING NUMBER: G-0.5
MCE PROJ. # 1024-0160	HORIZONTAL: NA	
DRAWN: BFN	VERTICAL: NA	
DESIGNED: MSL		
CHECKED: JSL		
PROJ. MGR: MSL		
STATUS: ISSUE FOR BID		REVISION

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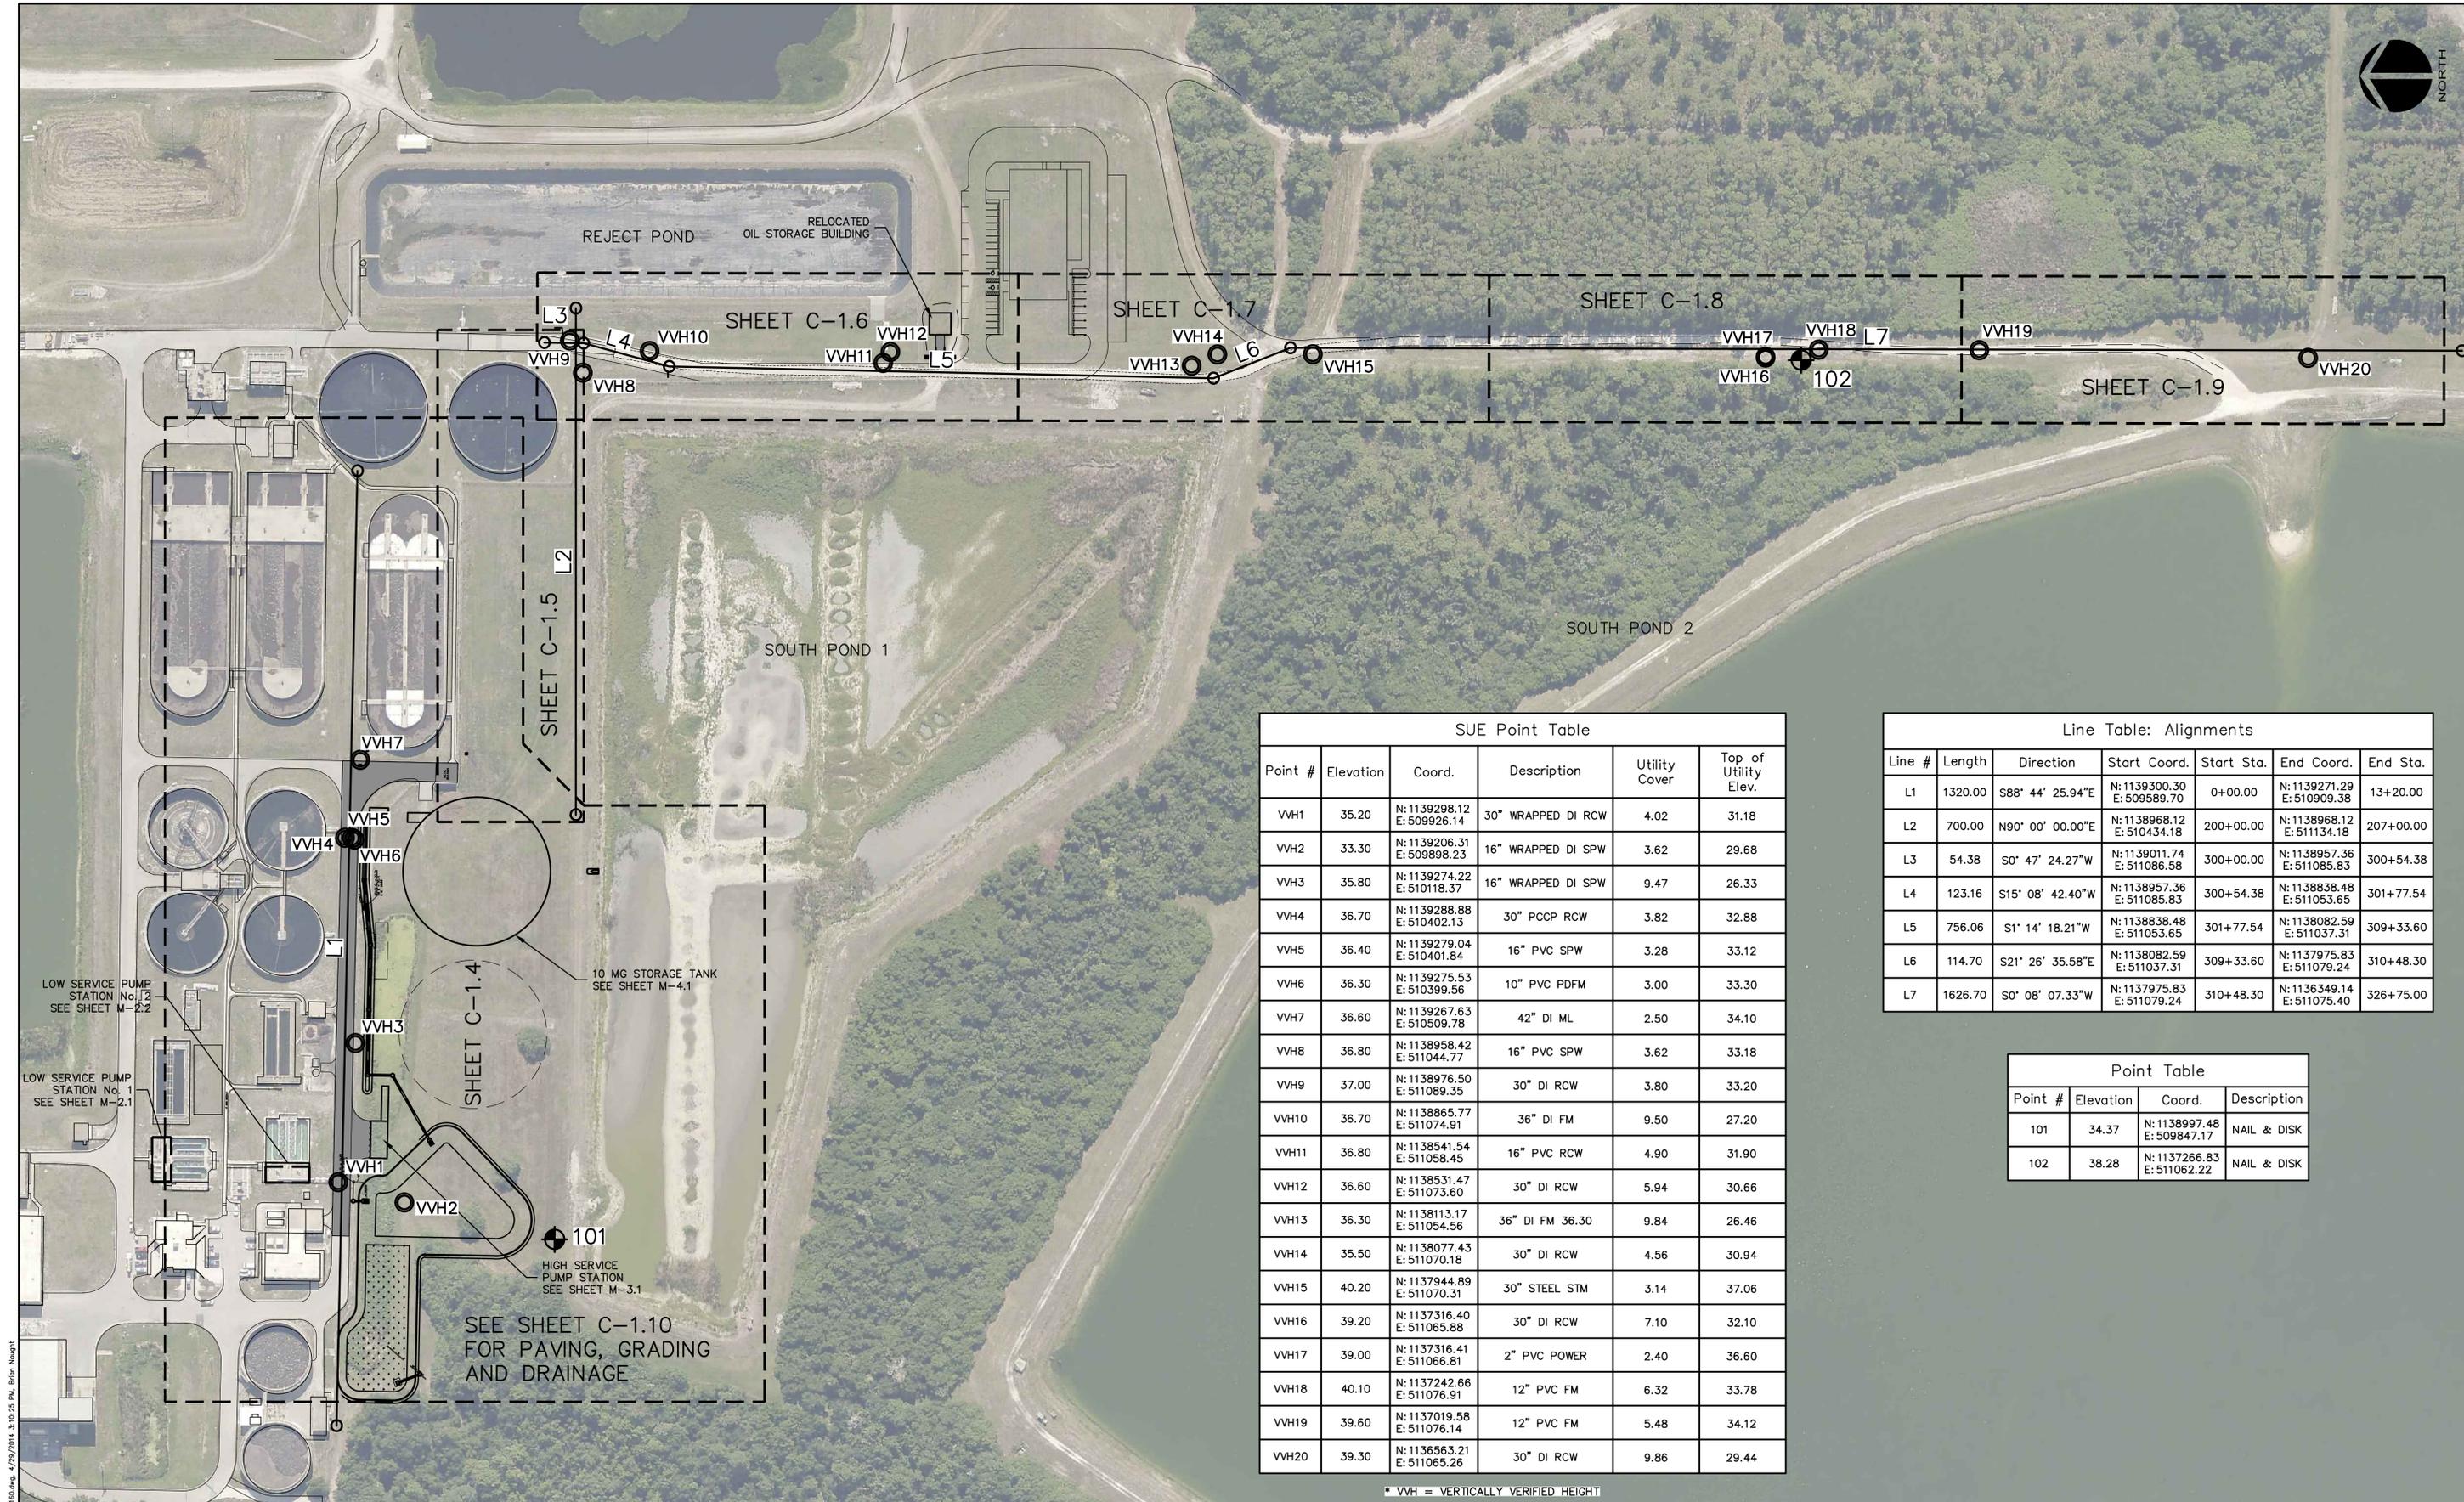
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SEWRF 10 MG STORAGE TANK AND INTERCONNECTION

DEMOLITION PLAN

DATE: APRIL 2014	SCALE: HORIZONTAL: 1" = 40'	DRAWING NUMBER: D-1.1
MCE PROJ. # 1024-0160	VERTICAL: NA	
DRAWN: BFN		
DESIGNED: MSL		
CHECKED: JSL		
PROJ. MGR: MSL		
STATUS: ISSUE FOR BID		



SUE Point Table					
Point #	Elevation	Coord.	Description	Utility Cover	Top of Utility Elev.
VWH1	35.20	N: 1139298.12 E: 509926.14	30" WRAPPED DI RCW	4.02	31.18
VWH2	33.30	N: 1139206.31 E: 509898.23	16" WRAPPED DI SPW	3.62	29.68
VWH3	35.80	N: 1139274.22 E: 510118.37	16" WRAPPED DI SPW	9.47	26.33
VWH4	36.70	N: 1139288.88 E: 510402.13	30" PCCP RCW	3.82	32.88
VWH5	36.40	N: 1139279.04 E: 510401.84	16" PVC SPW	3.28	33.12
VWH6	36.30	N: 1139275.53 E: 510399.56	10" PVC PDFM	3.00	33.30
VWH7	36.60	N: 1139267.63 E: 510509.78	42" DI ML	2.50	34.10
VWH8	36.80	N: 1138958.42 E: 511044.77	16" PVC SPW	3.62	33.18
VWH9	37.00	N: 1138976.50 E: 511089.35	30" DI RCW	3.80	33.20
VWH10	36.70	N: 1138865.77 E: 511074.91	36" DI FM	9.50	27.20
VWH11	36.80	N: 1138541.54 E: 511058.45	16" PVC RCW	4.90	31.90
VWH12	36.60	N: 1138531.47 E: 511073.60	30" DI RCW	5.94	30.66
VWH13	36.30	N: 1138113.17 E: 511054.56	36" DI FM 36.30	9.84	26.46
VWH14	35.50	N: 1138077.43 E: 511070.18	30" DI RCW	4.56	30.94
VWH15	40.20	N: 1137944.89 E: 511070.31	30" STEEL STM	3.14	37.06
VWH16	39.20	N: 1137316.40 E: 511065.88	30" DI RCW	7.10	32.10
VWH17	39.00	N: 1137316.41 E: 511066.81	2" PVC POWER	2.40	36.60
VWH18	40.10	N: 1137242.66 E: 511076.91	12" PVC FM	6.32	33.78
VWH19	39.60	N: 1137019.58 E: 511076.14	12" PVC FM	5.48	34.12
VWH20	39.30	N: 1136563.21 E: 511065.26	30" DI RCW	9.86	29.44

Line Table: Alignments						
Line #	Length	Direction	Start Coord.	Start Sta.	End Coord.	End Sta.
L1	1320.00	S88° 44' 25.94"E	N: 1139300.30 E: 509589.70	0+00.00	N: 1139271.29 E: 510909.38	13+20.00
L2	700.00	N90° 00' 00.00"E	N: 1138968.12 E: 510434.18	200+00.00	N: 1138968.12 E: 511134.18	207+00.00
L3	54.38	S0° 47' 24.27"W	N: 1139011.74 E: 511086.58	300+00.00	N: 1138957.36 E: 511085.83	300+54.38
L4	123.16	S15° 08' 42.40"W	N: 1138957.36 E: 511085.83	300+54.38	N: 1138838.48 E: 511053.65	301+77.54
L5	756.06	S1° 14' 18.21"W	N: 1138838.48 E: 511053.65	301+77.54	N: 1138082.59 E: 511037.31	309+33.60
L6	114.70	S21° 26' 35.58"E	N: 1138082.59 E: 511037.31	309+33.60	N: 1137975.83 E: 511079.24	310+48.30
L7	1626.70	S0° 08' 07.33"W	N: 1137975.83 E: 511079.24	310+48.30	N: 1136349.14 E: 511075.40	326+75.00

Point Table			
Point #	Elevation	Coord.	Description
101	34.37	N: 1138997.48 E: 509847.17	NAIL & DISK
102	38.28	N: 1137266.83 E: 511062.22	NAIL & DISK

* VWH = VERTICALLY VERIFIED HEIGHT

REV. NO.	DESCRIPTIONS	DATE

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MANATEE COUNTY, FLORIDA

SEWRF 10 MG STORAGE TANK AND INTERCONNECTION

KEY SHEET, SUE LOCATES AND HORIZONTAL CONTROL PLAN

DATE: APRIL 2014	SCALE: HORIZONTAL: 1" = 100'	DRAWING NUMBER: C-1.1
MCE PROJ. # 1024-0160	VERTICAL: NA	
DRAWN: BFN		
DESIGNED: MSL		
CHECKED: JSL		
PROJ. MGR: MSL		
STATUS: ISSUE FOR BID		

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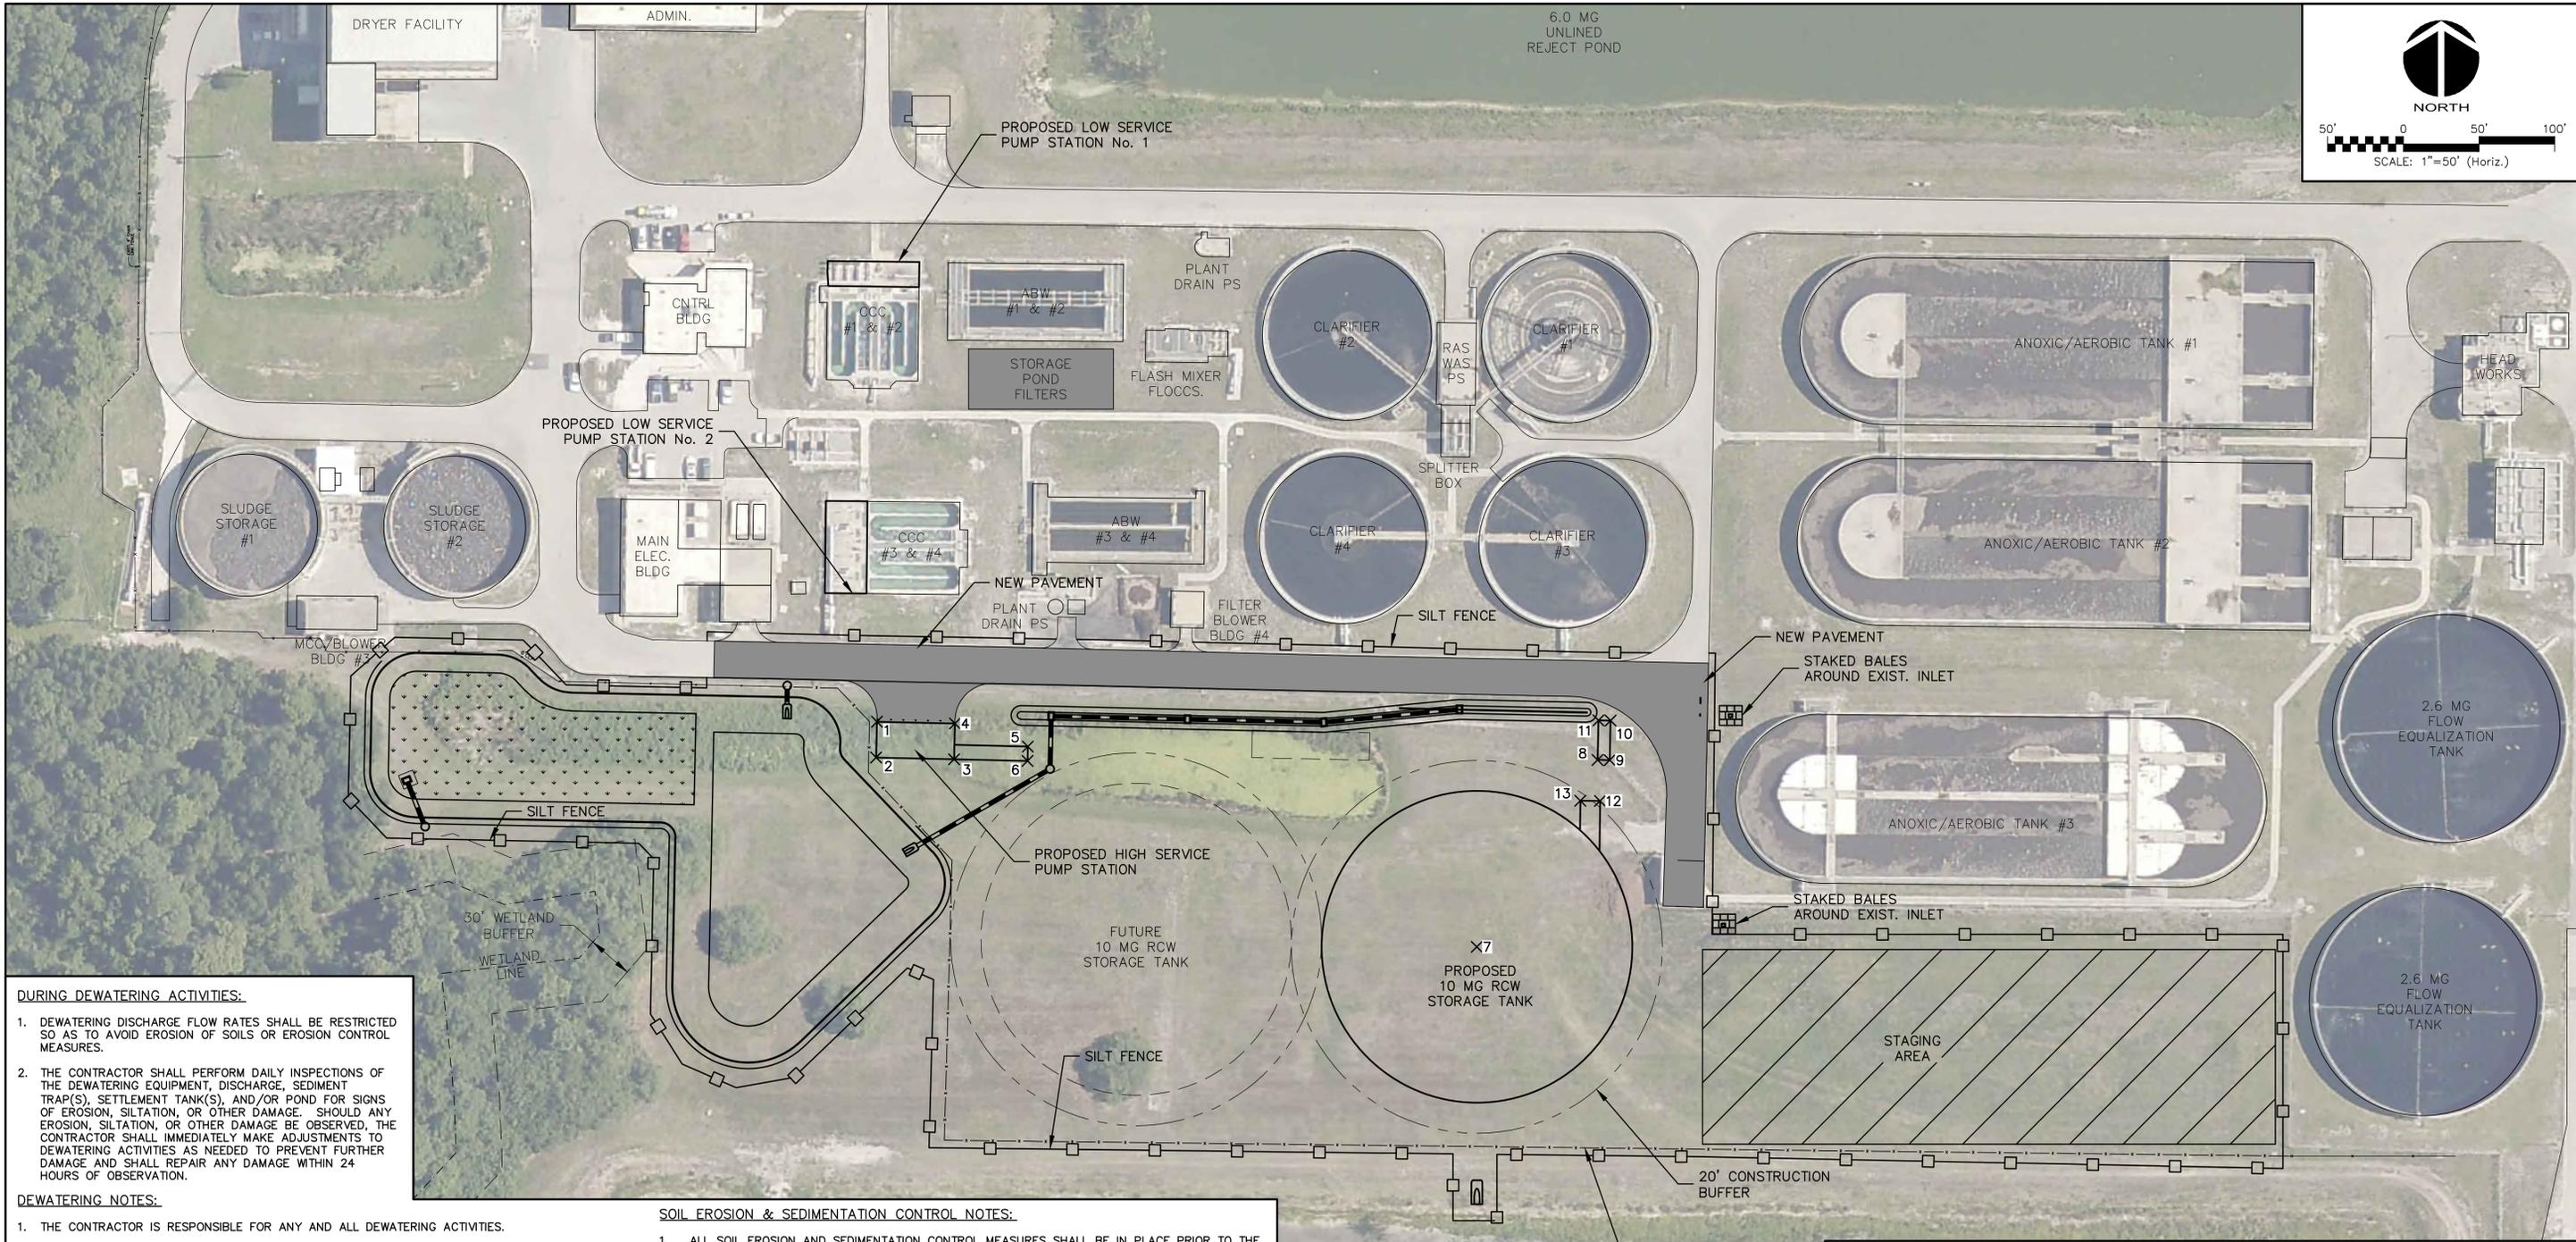
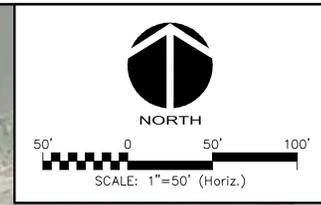
MANATEE COUNTY, FLORIDA

SEWRF 10 MG STORAGE TANK AND INTERCONNECTION

EXISTING SITE PLAN

DATE: APRIL 2014	SCALE: HORIZONTAL: 1" = 50'	DRAWING NUMBER: C-1.2
MCE PROJ. # 1024-0160	VERTICAL: NA	REVISION
DRAWN: BFN		
DESIGNED: MSL		
CHECKED: MSL		
PROJ. MGR: MSL		
STATUS: ISSUE FOR BID		

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DURING DEWATERING ACTIVITIES:

1. DEWATERING DISCHARGE FLOW RATES SHALL BE RESTRICTED SO AS TO AVOID EROSION OF SOILS OR EROSION CONTROL MEASURES.
2. THE CONTRACTOR SHALL PERFORM DAILY INSPECTIONS OF THE DEWATERING EQUIPMENT, DISCHARGE, SEDIMENT TRAP(S), SETTLEMENT TANK(S), AND/OR POND FOR SIGNS OF EROSION, SILTATION, OR OTHER DAMAGE. SHOULD ANY EROSION, SILTATION, OR OTHER DAMAGE BE OBSERVED, THE CONTRACTOR SHALL IMMEDIATELY MAKE ADJUSTMENTS TO DEWATERING ACTIVITIES AS NEEDED TO PREVENT FURTHER DAMAGE AND SHALL REPAIR ANY DAMAGE WITHIN 24 HOURS OF OBSERVATION.

DEWATERING NOTES:

1. THE CONTRACTOR IS RESPONSIBLE FOR ANY AND ALL DEWATERING ACTIVITIES.
2. THE CONTRACTOR IS RESPONSIBLE FOR OBTAINING A GENERIC PERMIT FOR THE DISCHARGE OF PRODUCED GROUND WATER FROM ANY NON-CONTAMINATED SITE ACTIVITY (FORM 62-621.300(2)) FROM THE FDEP INDUSTRIAL WASTEWATER DEPARTMENT. THE CONTRACTOR SHALL PROVIDE THE AUTHORIZED GENERIC PERMIT AND WATER SAMPLING DATA TO THE FDEP ERP PROGRAM PRIOR TO THE PRE-CONSTRUCTION MEETING AND PRIOR TO ANY CONSTRUCTION ACTIVITIES.
3. THE CONTRACTOR IS RESPONSIBLE FOR OBTAINING ANY AND ALL ADDITIONAL AUTHORIZATIONS OR PERMITS ASSOCIATED WITH DEWATERING ACTIVITIES INCLUDING OBTAINING ANY APPLICABLE WATER TESTING.
4. CONTRACTOR SHALL PREPARE AND SUBMIT A DEWATERING PLAN SHOWING APPLICABLE BEST MANAGEMENT PRACTICES TO FDEP ERP PROGRAM FOR REVIEW AND APPROVAL PRIOR TO ANY DEWATERING ACTIVITIES. THE PROPOSED DEWATERING PLAN SHALL ALSO INCLUDE THE PROPOSED POINT(S) OF DISCHARGE.
5. APPLICABLE SOIL EROSION AND SEDIMENTATION CONTROL (SESC) MEASURES INCLUDING, BUT NOT LIMITED TO TEMPORARY SEDIMENT TRAP(S), SETTLEMENT TANK(S), STAKED BALES, RIP RAP, SILT FENCE, AND/OR ROCK CHECK DAMS, SHALL BE INSTALLED PRIOR TO ANY DEWATERING ACTIVITIES. THE CONTRACTOR SHALL MAINTAIN AND INSPECT DAILY.
6. THE CONTRACTOR IS RESPONSIBLE FOR STABILIZING AND MAINTAINING ALL DEWATERING EQUIPMENT AND S.E.S.C. MEASURES.
7. THE CONTRACTOR SHALL BE RESPONSIBLE FOR COLLECTING AND HAULING OFF SITE IN A TIMELY MANNER ANY AQUATIC LIFE IMPACTED BY DEWATERING AND CONSTRUCTION ACTIVITIES TO AN APPROVED LANDFILL FACILITY.

SOIL EROSION & SEDIMENTATION CONTROL NOTES:

1. ALL SOIL EROSION AND SEDIMENTATION CONTROL MEASURES SHALL BE IN PLACE PRIOR TO THE START OF ANY CONSTRUCTION, DEMOLITION, DEWATERING, OR MOBILIZATION ACTIVITIES, MAINTAINED THROUGHOUT CONSTRUCTION AND SHALL REMAIN IN PLACE UNTIL WORK IS COMPLETE.
2. CONTRACTOR SHALL FOLLOW BEST MANAGEMENT PRACTICES THROUGHOUT DEMOLITION AND CONSTRUCTION.
3. HAY BALES AND/OR SILT SCREENS SHALL BE INSTALLED ADJACENT TO THE WORK AREAS TO PREVENT SEDIMENT TRANSPORT PRIOR TO THE COMMENCEMENT OF WORK.
4. INLET PROTECTION SHALL BE PLACED AT ALL INLETS IN OR ADJACENT TO THE PROJECT AREA.
5. AS SOON AS PRACTICAL, ALL DRESSED SLOPES AND DISTURBED AREAS SHALL BE SODDED OR SEEDED AND MULCHED TO PREVENT EROSION.
6. NO EXCAVATION SHALL EXTEND BELOW THE DEPTHS/ELEVATIONS SHOWN ON THE DRAWINGS OR IN THE SPECIFICATIONS WITHOUT PRIOR APPROVAL.
7. CONTRACTOR SHALL PREPARE AND SUBMIT A STORM WATER POLLUTION PREVENTION PLAN (SWPPP) FOR REVIEW AND APPROVAL PRIOR TO COMMENCEMENT OF ANY CONSTRUCTION ACTIVITIES AND PROVIDE APPROVED FDEP NOI TO COUNTY.
8. CONTRACTOR SHALL PREPARE AND SUBMIT A DISPOSAL PLAN FOR EXCAVATION MATERIAL INCLUDING THE LOCATION OF DISPOSAL SITE(S) AND DISPOSAL PLANS SHOWING APPLICABLE BEST MANAGEMENT PRACTICES FOR REVIEW AND APPROVAL PRIOR TO ANY EARTHWORK ACTIVITIES.

DEWATERING SEQUENCE:

1. ALL SOIL EROSION AND SEDIMENTATION CONTROL MEASURES SHALL BE IN PLACE PRIOR TO THE START OF ANY CONSTRUCTION AND/OR DEWATERING ACTIVITIES AND SHALL REMAIN IN PLACE UNTIL WORK IS COMPLETE.
2. FOLLOWING THE COMPLETION OF DEWATERING, THE CONTRACTOR SHALL REMOVE ALL WELL POINTS, PIPES, PUMPS, AND ANY ADDITIONAL DEWATERING EQUIPMENT FROM THE PROJECT SITE.
3. FOLLOWING THE REMOVAL OF DEWATERING EQUIPMENT, THE CONTRACTOR SHALL EXCAVATE ANY SEDIMENT OR MUCK ACCUMULATED WITHIN THE TEMPORARY SEDIMENT TRAP(S), SETTLEMENT TANK(S), AND/OR POND(S) AND DISPOSE OF SEDIMENT TO A QUALIFIED LAND FILL.
4. FOLLOWING REMOVAL OF SEDIMENT, THE CONTRACTOR SHALL REMOVE THE SETTLEMENT TANK(S) AND/OR FILL THE SEDIMENT TRAP(S) WITH CLEAN SANDY SOIL TO RESTORE THE NATURAL GRADE AND SOD OVER AS SOON AS PRACTICALLY POSSIBLE.

Point Table		
Point #	Description	Location
1	HSPS CORNER	N:1139253.60 E:509959.49
2	HSPS CORNER	N:1139230.11 E:509958.96
3	HSPS CORNER	N:1139228.96 E:510010.45
4	HSPS CORNER	N:1139252.45 E:510010.97
5	METER CORNER	N:1139237.33 E:510059.15
6	METER CORNER	N:1139227.87 E:510058.93
7	STORAGE TANK CENTER	N:1139105.70 E:510355.60

Point Table		
Point #	Description	Location
8	PLANT WATER METER CORNER	N:1139228.53 E:510435.35
9	PLANT WATER METER CORNER	N:1139228.35 E:510443.35
10	PLANT WATER METER CORNER	N:1139254.35 E:510443.93
11	PLANT WATER METER CORNER	N:1139254.52 E:510435.93
12	TANK FILL STATION CORNER	N:1139201.55 E:510436.98
13	TANK FILL STATION CORNER	N:1139201.70 E:510423.98

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 No. 66118






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SEWRF 10 MG STORAGE TANK AND INTERCONNECTION
PROPOSED SITE PLAN AND SUGGESTED SOIL EROSION AND SEDIMENTATION CONTROL

DATE: APRIL 2014	SCALE: HORIZONTAL: 1" = 50'	DRAWING NUMBER C-1.3
MCE PROJ. # 1024-0160	VERTICAL: NA	
DRAWN: BFN		
DESIGNED: MSL		
CHECKED: MSL		
PROJ. MGR: MSL		
STATUS: ISSUE FOR BID		REVISION

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GENERAL NOTES:
 1. EXISTING OIL STORAGE BUILDING SHALL BE RELOCATED. SEE SHEET C-1.6.

MATCHLINE SEE SHEET C-1.5 FOR CONTINUATION

REVNO.	DESCRIPTIONS	DATE
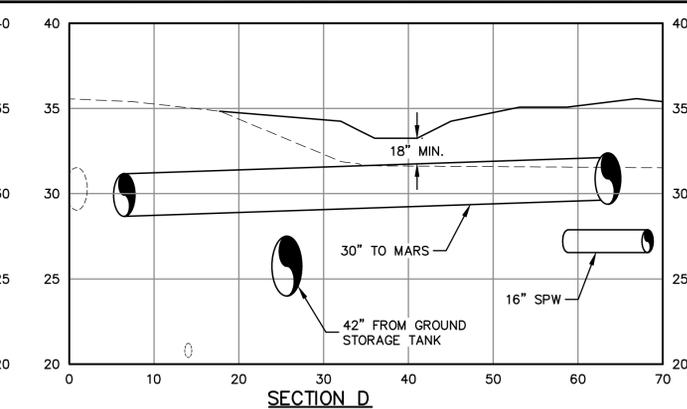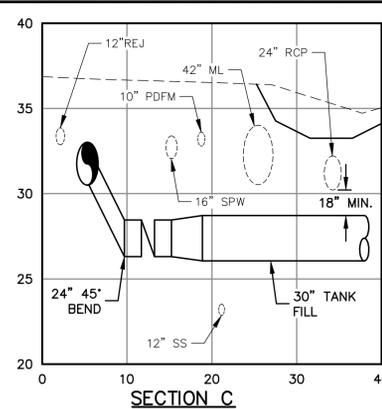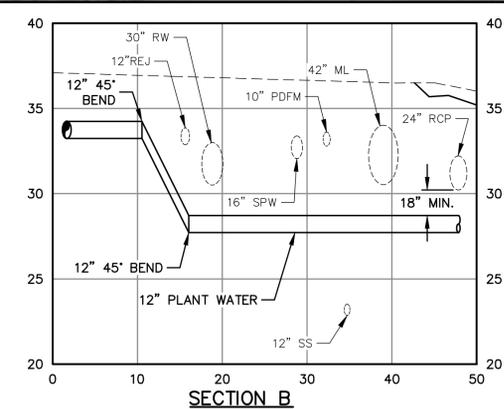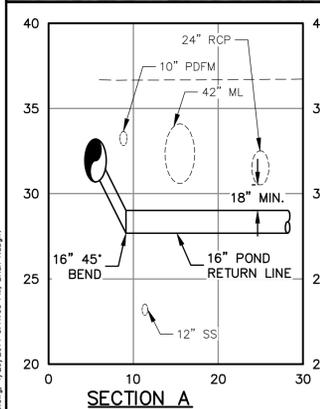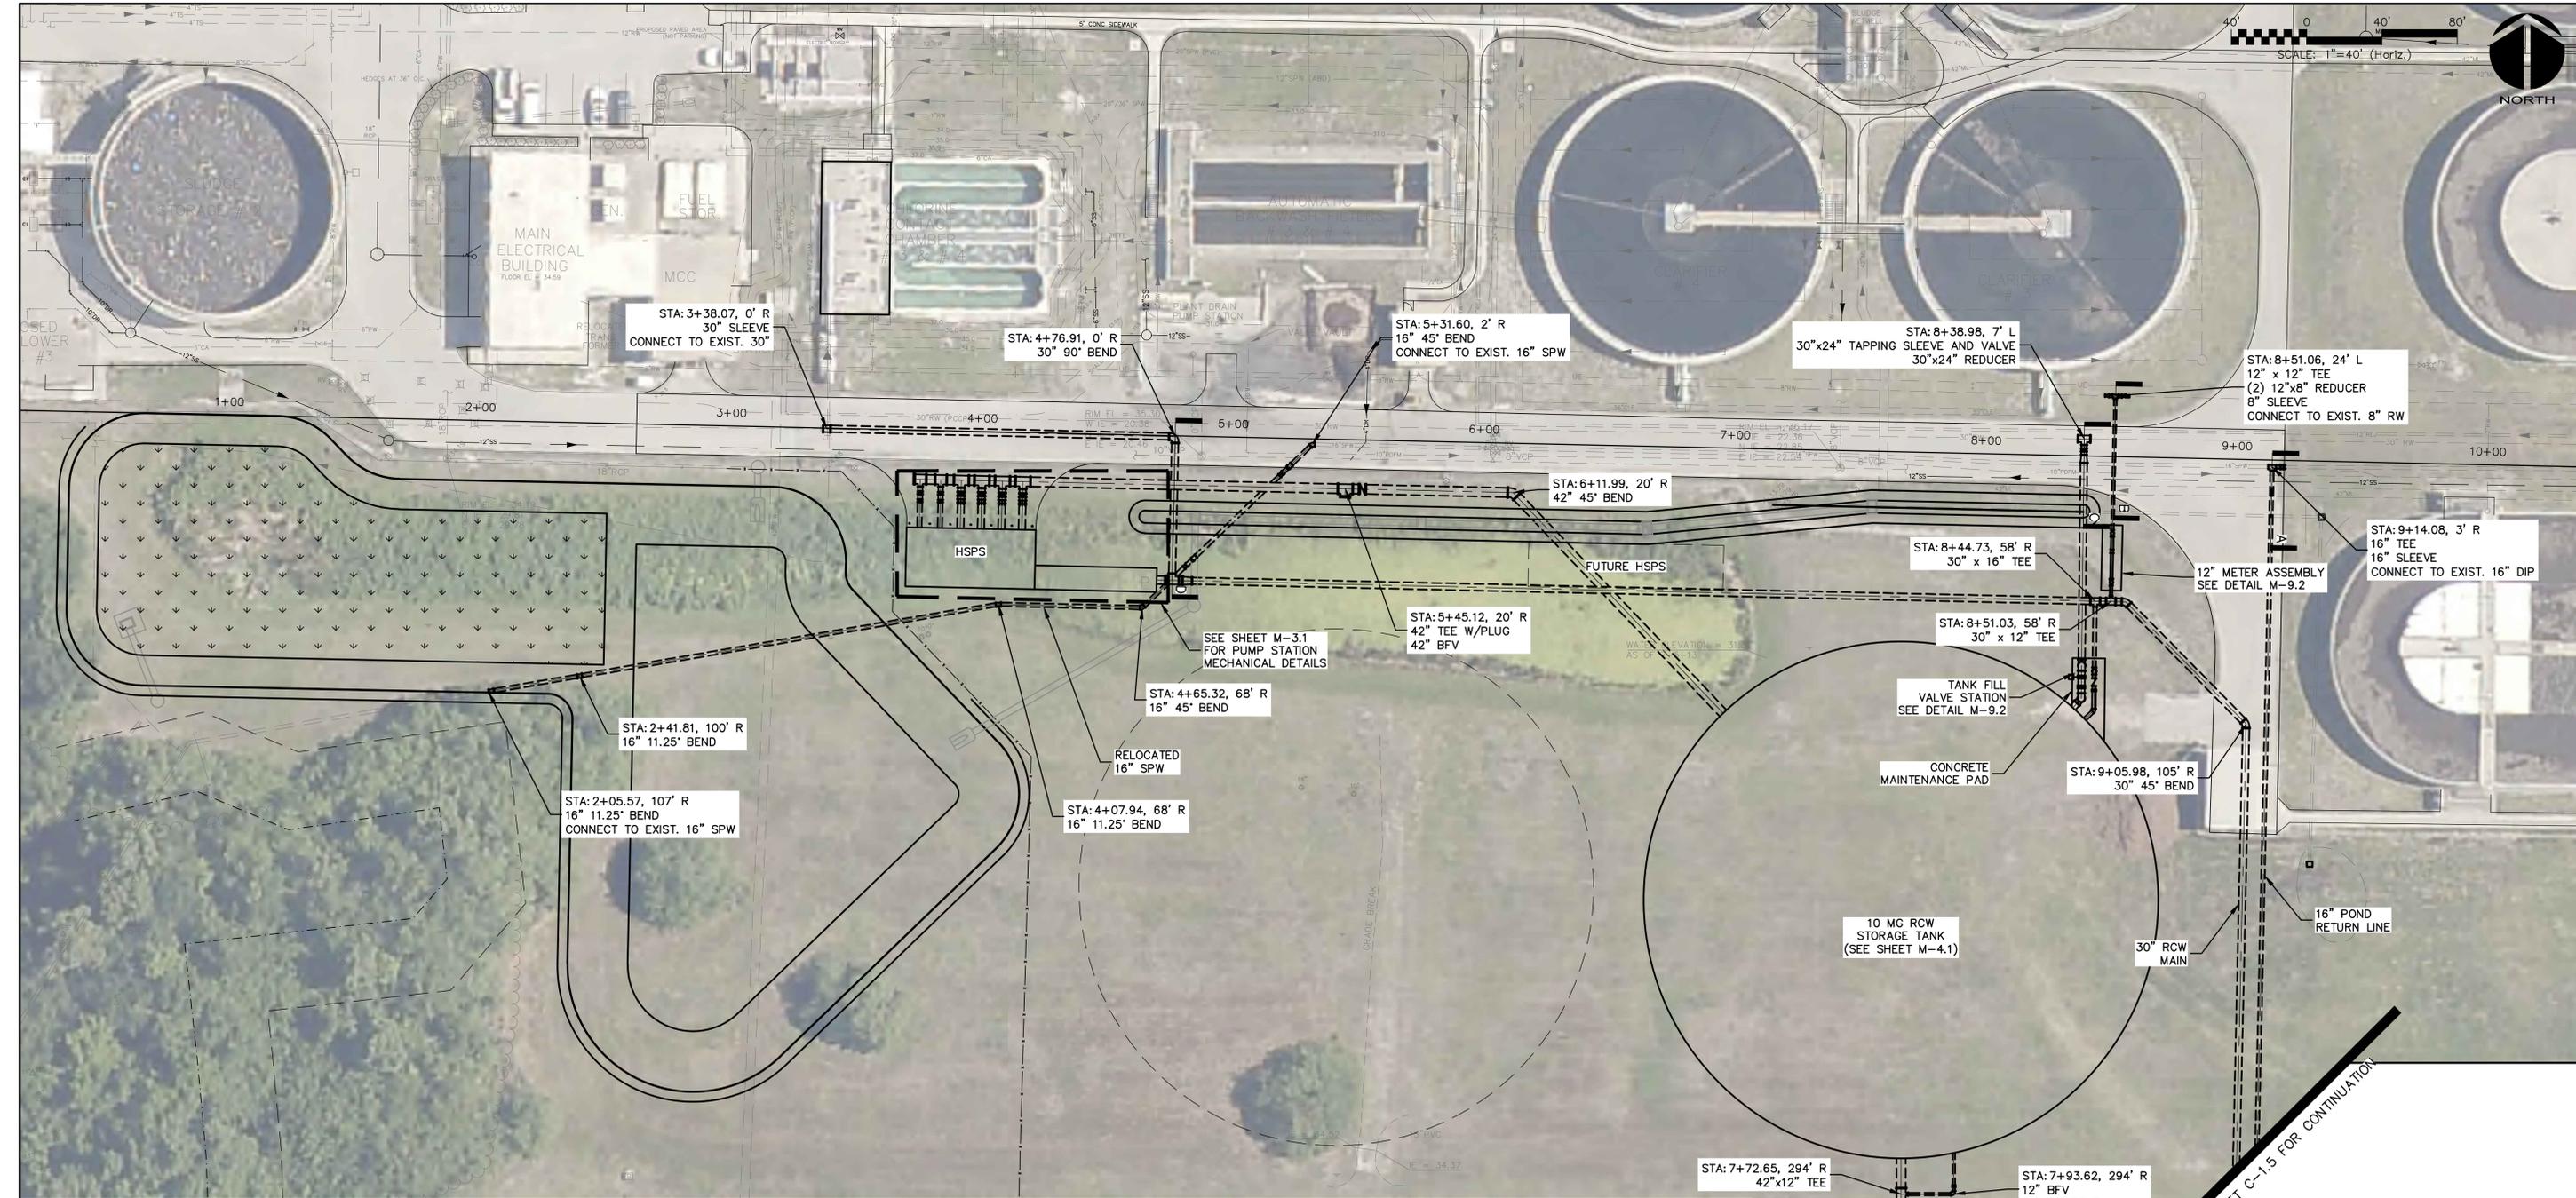
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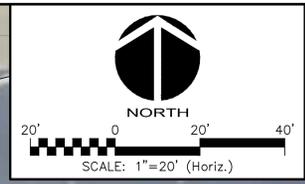
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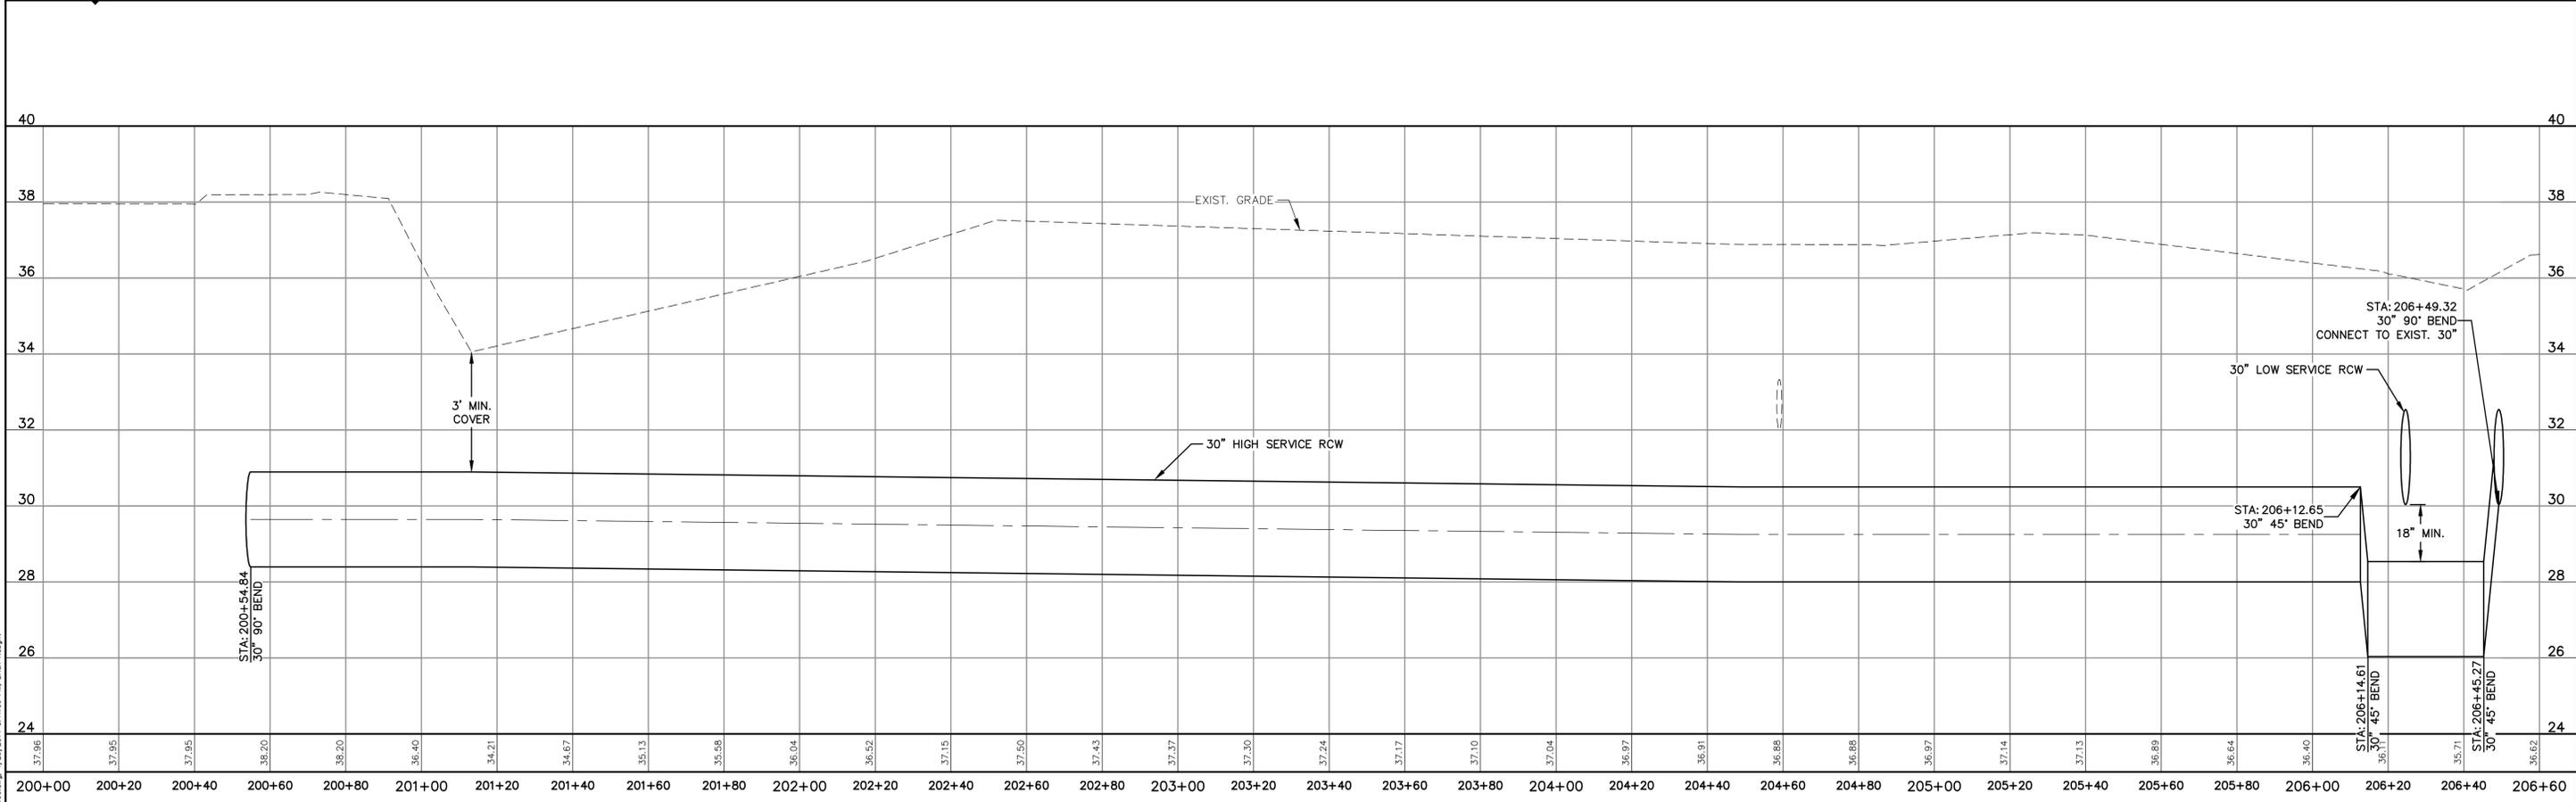
SEWRF 10 MG STORAGE TANK AND INTERCONNECTION
YARD PIPING PLAN

DATE: APRIL 2014	SCALE: HORIZONTAL: 1" = 40'	DRAWING NUMBER: C-1.4
MCE PROJ. # 1024-0160	VERTICAL: NA	
DRAWN: BFN		
DESIGNED: MSL		
CHECKED: MSL		
PROJ. MGR: MSL		
STATUS: ISSUE FOR BID		

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DISCONNECT AND CAP EXIST.



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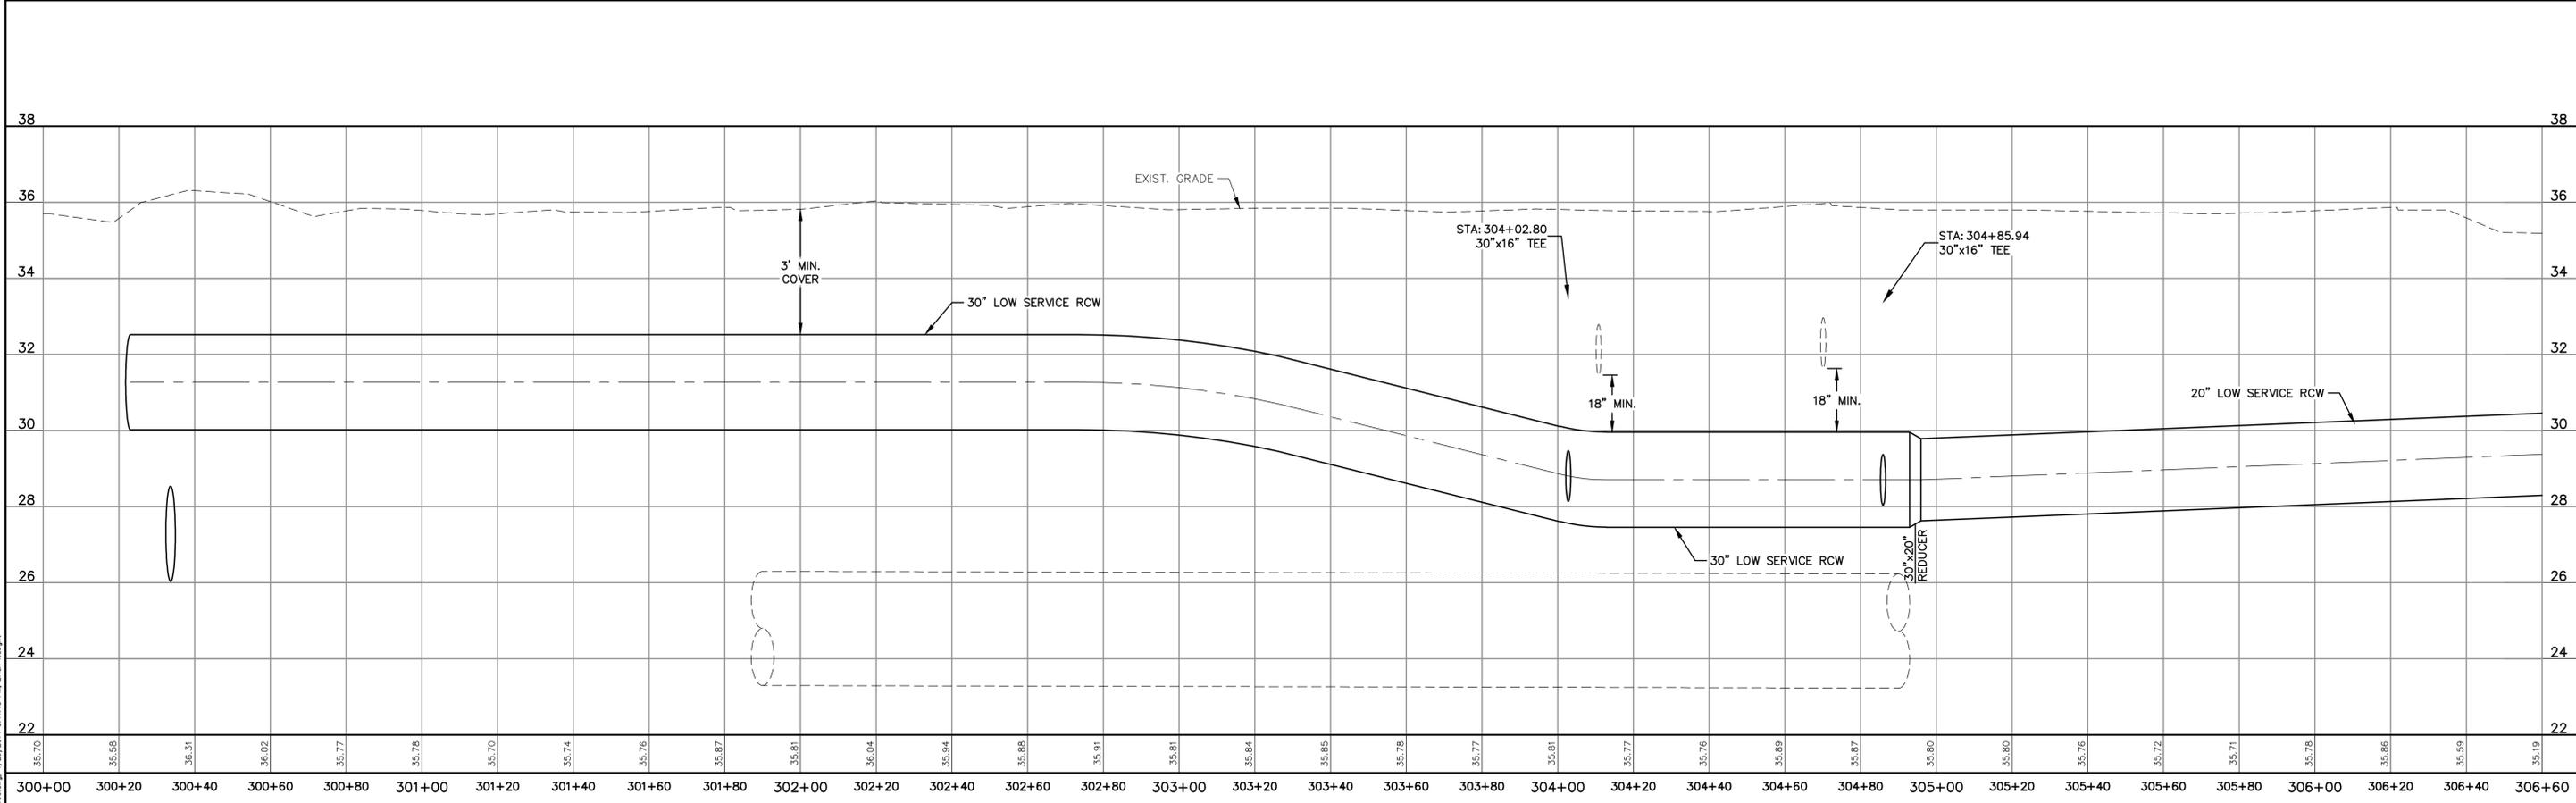
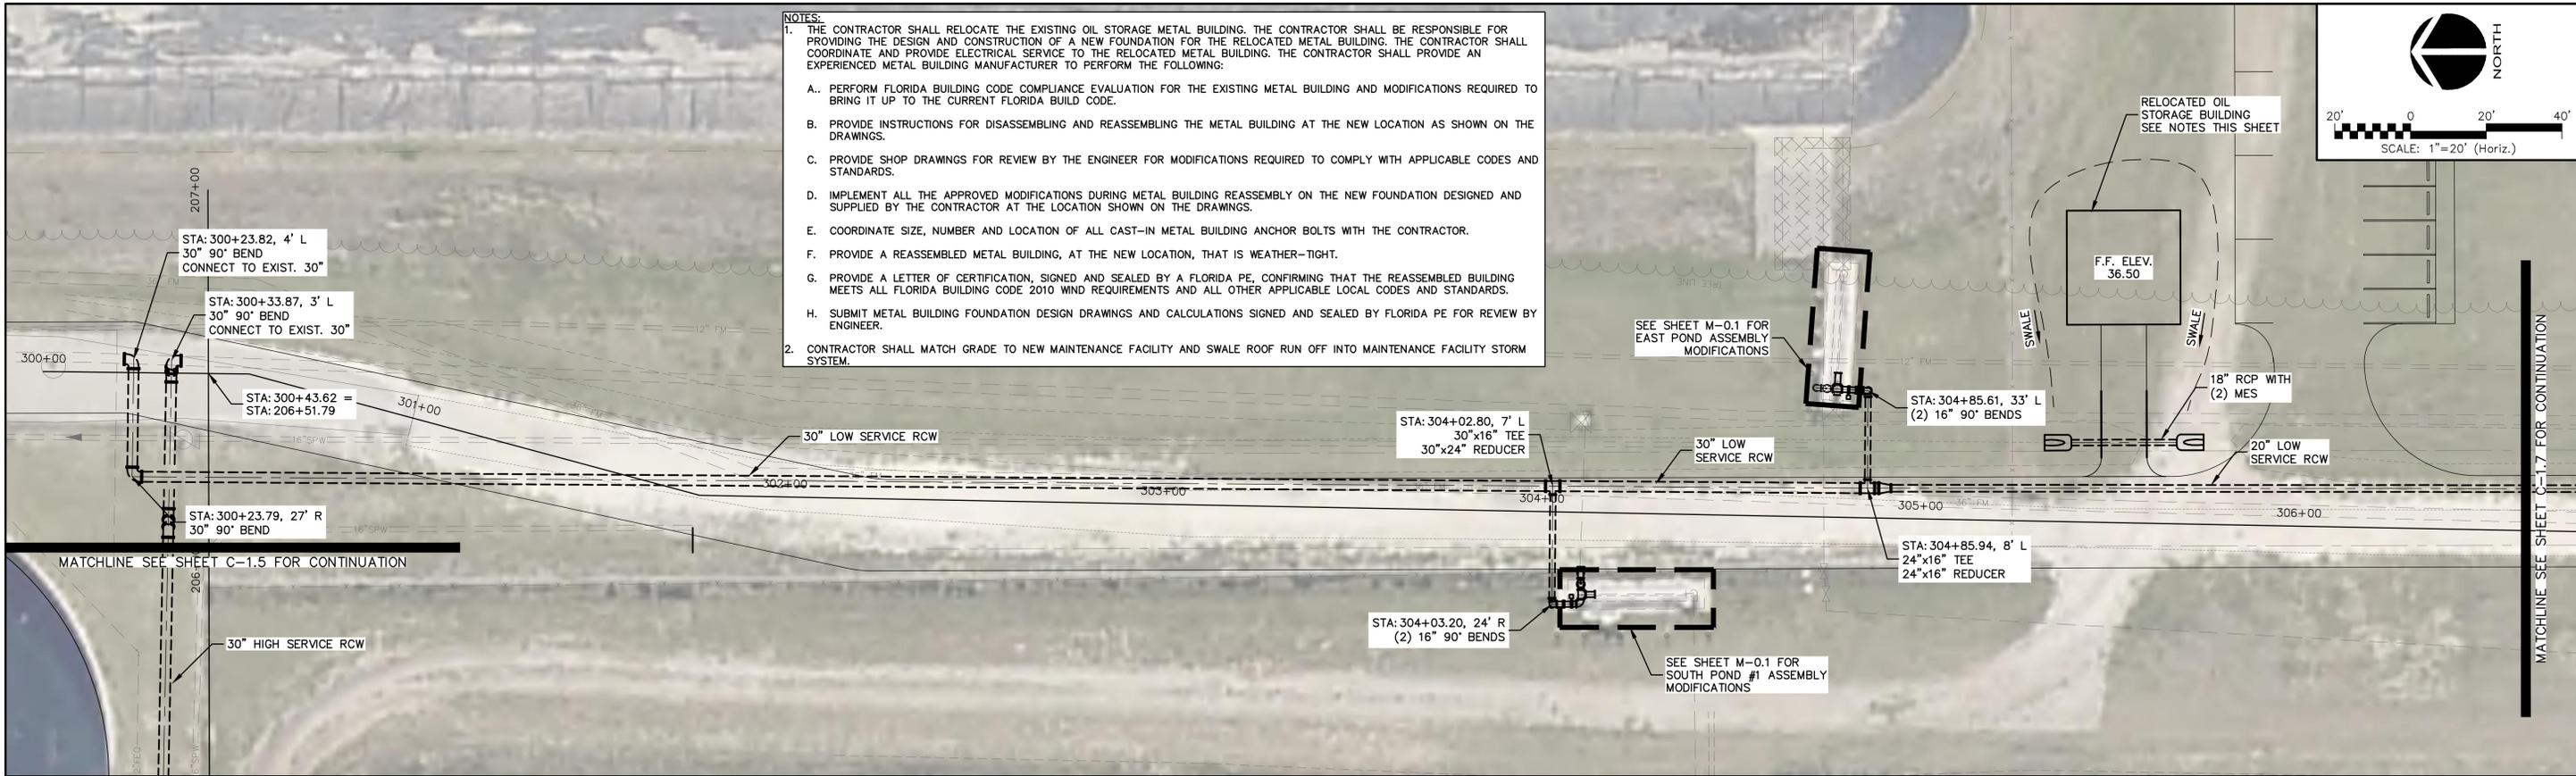
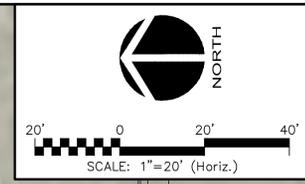
SEWRF 10 MG STORAGE TANK AND INTERCONNECTION

YARD PIPING PLAN AND PROFILE
1 OF 5

DATE: APRIL 2014	SCALE: HORIZONTAL: 1" = 20' VERTICAL: 1" = 2'	DRAWING NUMBER: C-1.5
MCE PROJ. # 1024-0160		
DRAWN: BFN		
DESIGNED: MSL		
CHECKED: MSL	STATUS: ISSUE FOR BID	
PROJ. MGR: MSL	REVISION	

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- NOTES:**
- THE CONTRACTOR SHALL RELOCATE THE EXISTING OIL STORAGE METAL BUILDING. THE CONTRACTOR SHALL BE RESPONSIBLE FOR PROVIDING THE DESIGN AND CONSTRUCTION OF A NEW FOUNDATION FOR THE RELOCATED METAL BUILDING. THE CONTRACTOR SHALL COORDINATE AND PROVIDE ELECTRICAL SERVICE TO THE RELOCATED METAL BUILDING. THE CONTRACTOR SHALL PROVIDE AN EXPERIENCED METAL BUILDING MANUFACTURER TO PERFORM THE FOLLOWING:
 - PERFORM FLORIDA BUILDING CODE COMPLIANCE EVALUATION FOR THE EXISTING METAL BUILDING AND MODIFICATIONS REQUIRED TO BRING IT UP TO THE CURRENT FLORIDA BUILD CODE.
 - PROVIDE INSTRUCTIONS FOR DISASSEMBLING AND REASSEMBLING THE METAL BUILDING AT THE NEW LOCATION AS SHOWN ON THE DRAWINGS.
 - PROVIDE SHOP DRAWINGS FOR REVIEW BY THE ENGINEER FOR MODIFICATIONS REQUIRED TO COMPLY WITH APPLICABLE CODES AND STANDARDS.
 - IMPLEMENT ALL THE APPROVED MODIFICATIONS DURING METAL BUILDING REASSEMBLY ON THE NEW FOUNDATION DESIGNED AND SUPPLIED BY THE CONTRACTOR AT THE LOCATION SHOWN ON THE DRAWINGS.
 - COORDINATE SIZE, NUMBER AND LOCATION OF ALL CAST-IN METAL BUILDING ANCHOR BOLTS WITH THE CONTRACTOR.
 - PROVIDE A REASSEMBLED METAL BUILDING, AT THE NEW LOCATION, THAT IS WEATHER-TIGHT.
 - PROVIDE A LETTER OF CERTIFICATION, SIGNED AND SEALED BY A FLORIDA PE, CONFIRMING THAT THE REASSEMBLED BUILDING MEETS ALL FLORIDA BUILDING CODE 2010 WIND REQUIREMENTS AND ALL OTHER APPLICABLE LOCAL CODES AND STANDARDS.
 - SUBMIT METAL BUILDING FOUNDATION DESIGN DRAWINGS AND CALCULATIONS SIGNED AND SEALED BY FLORIDA PE FOR REVIEW BY ENGINEER.
 - CONTRACTOR SHALL MATCH GRADE TO NEW MAINTENANCE FACILITY AND SWALE ROOF RUN OFF INTO MAINTENANCE FACILITY STORM SYSTEM.



REVNO.	DESCRIPTIONS	DATE

SEAL

MATTHEW S. LOVE, P.E.
No. 66118

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Clearwater, Florida 33756
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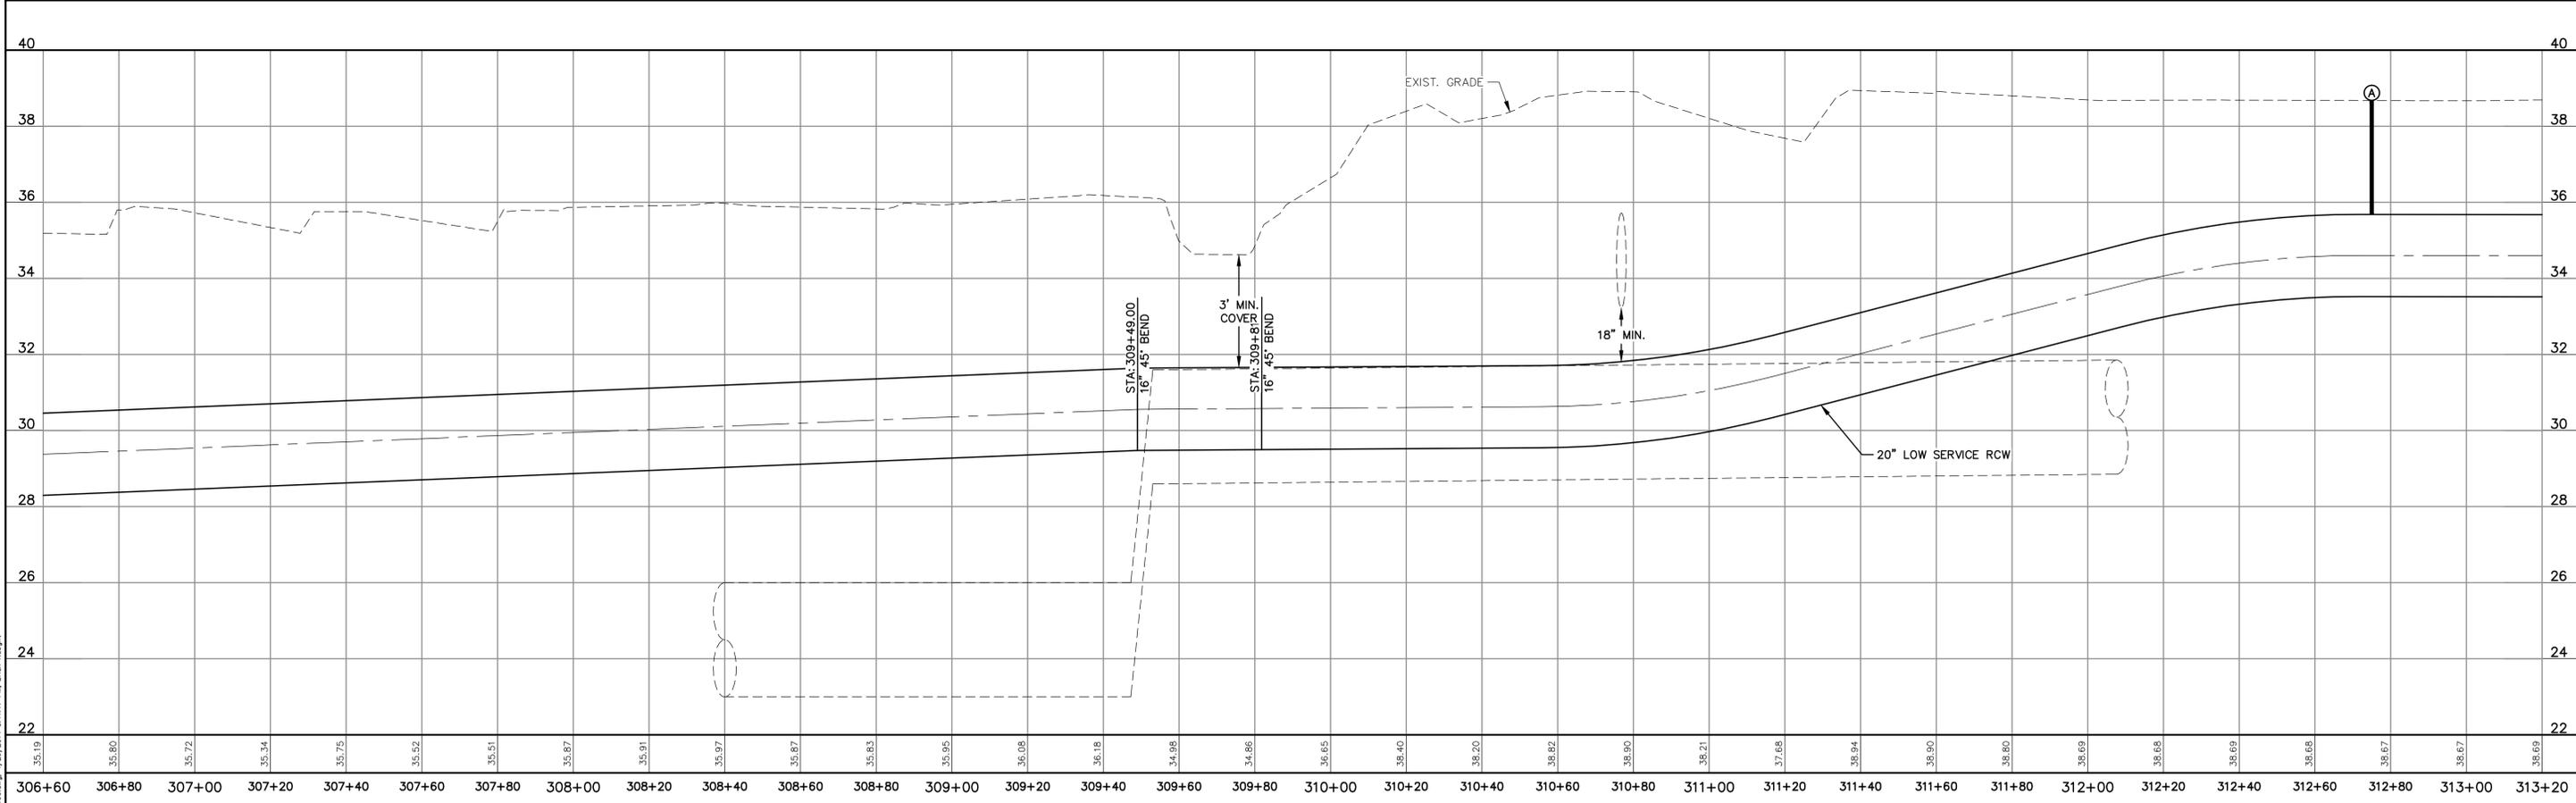
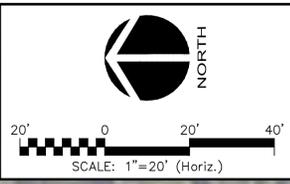
MANATEE COUNTY, FLORIDA

SEWRF 10 MG STORAGE TANK AND INTERCONNECTION

YARD PIPING PLAN AND PROFILE
2 OF 5

DATE: APRIL 2014	SCALE: HORIZONTAL: 1" = 20'	DRAWING NUMBER: C-1.6
MCE PROJ. # 1024-0160	VERTICAL: 1" = 2'	
DRAWN: BFN		
DESIGNED: MSL		
CHECKED: MSL		
PROJ. MGR: MSL		
STATUS: ISSUE FOR BID		

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MANATEE COUNTY, FLORIDA



SEWRF 10 MG STORAGE TANK
AND INTERCONNECTION

YARD PIPING PLAN AND PROFILE
3 OF 5

DATE:	APRIL 2014
MCE PROJ. #	1024-0160
DRAWN	BFN
DESIGNED	MSL
CHECKED	MSL
PROJ. MGR.	MSL
STATUS:	ISSUE FOR BID

SCALE	DRAWING NUMBER
HORIZONTAL: 1" = 20'	C-1.7
VERTICAL: 1" = 2'	REVISION

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REVNO.	DESCRIPTIONS	DATE
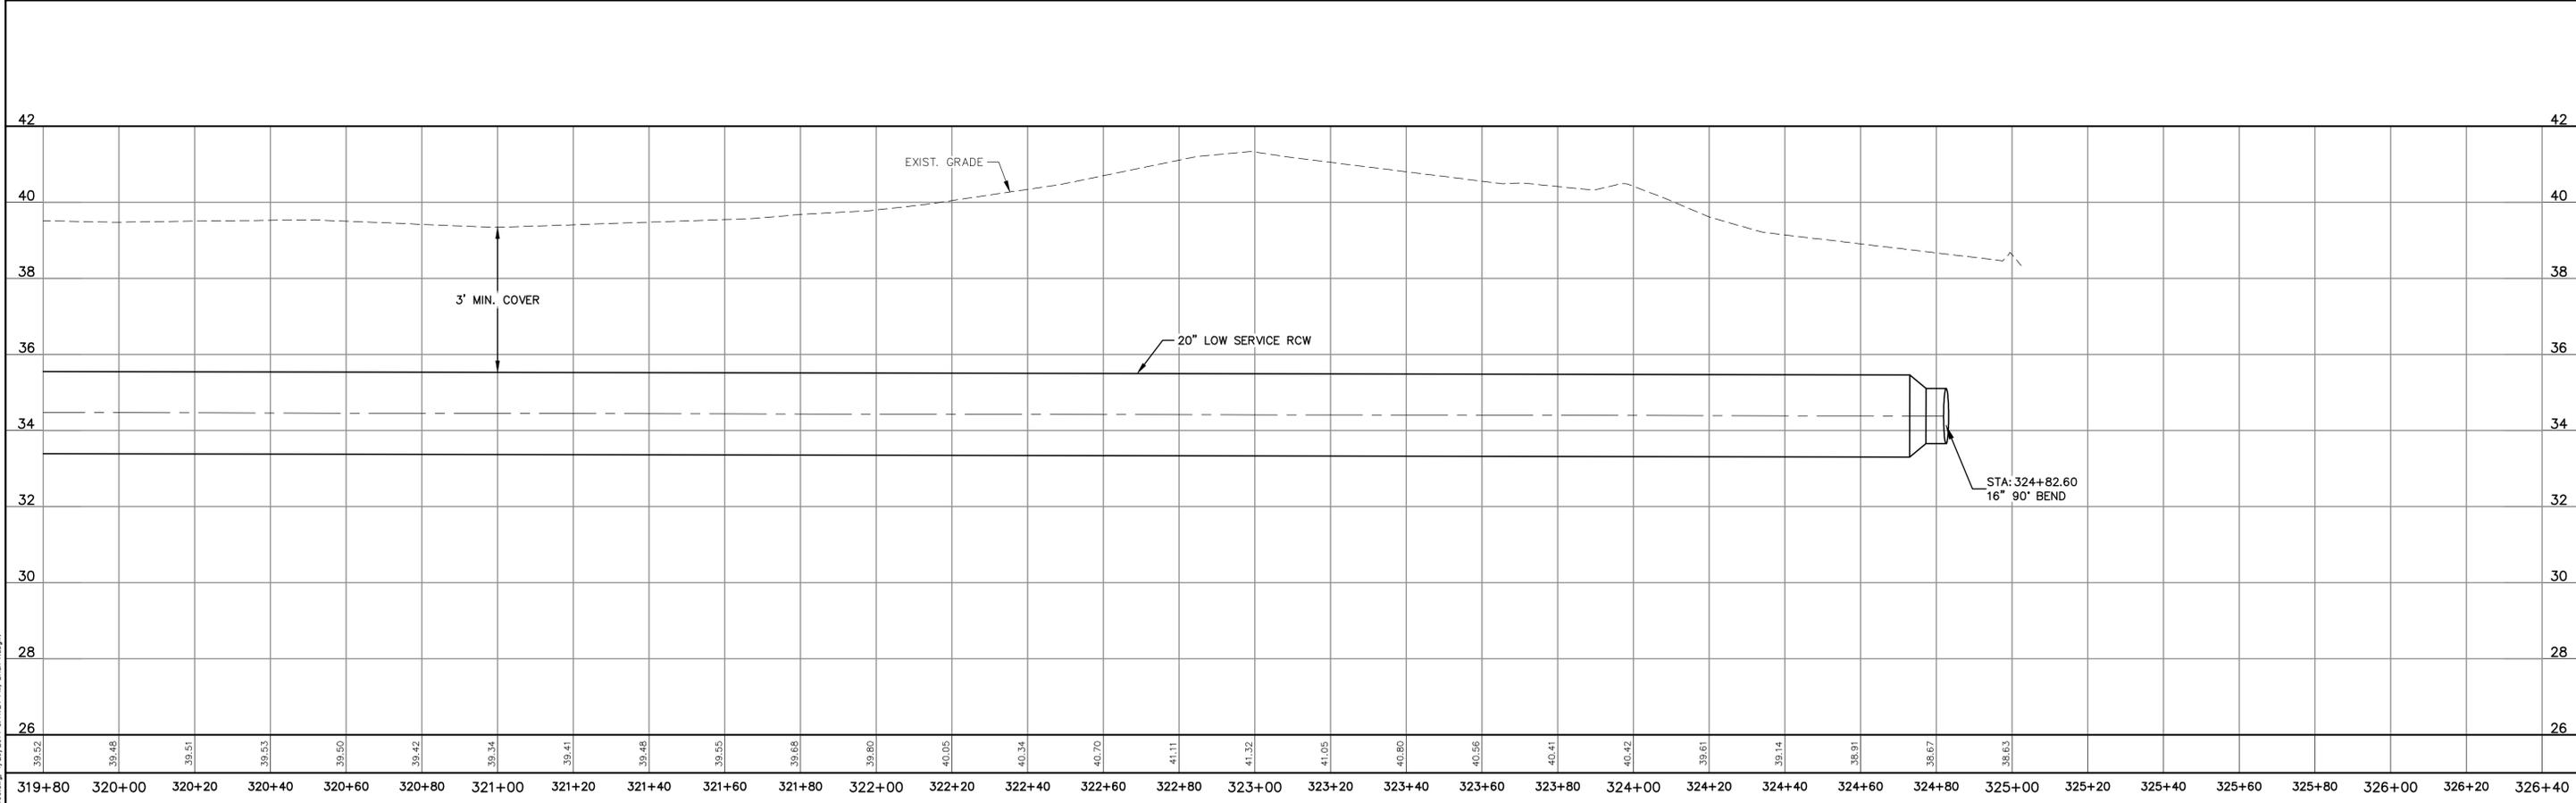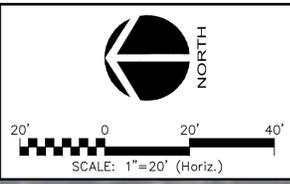
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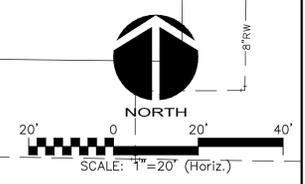
MANATEE COUNTY, FLORIDA

SEWRF 10 MG STORAGE TANK
AND INTERCONNECTION


YARD PIPING PLAN AND PROFILE
5 OF 5

DATE: APRIL 2014	SCALE: HORIZONTAL: 1" = 20'	DRAWING NUMBER: C-1.9
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DESIGNED: MSL		
CHECKED: MSL		
PROJ. MGR: MSL		
STATUS: ISSUE FOR BID		REVISION

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LITTORAL ZONE PLANTINGS:
 40% DUCK POTATO - 24" O.C.
 40% PICKERELWEED - 24" O.C.
 20% SAW-GRASS - 24" O.C.



MATCHLINE SEE SHEET C-1.11 FOR CONTINUATION
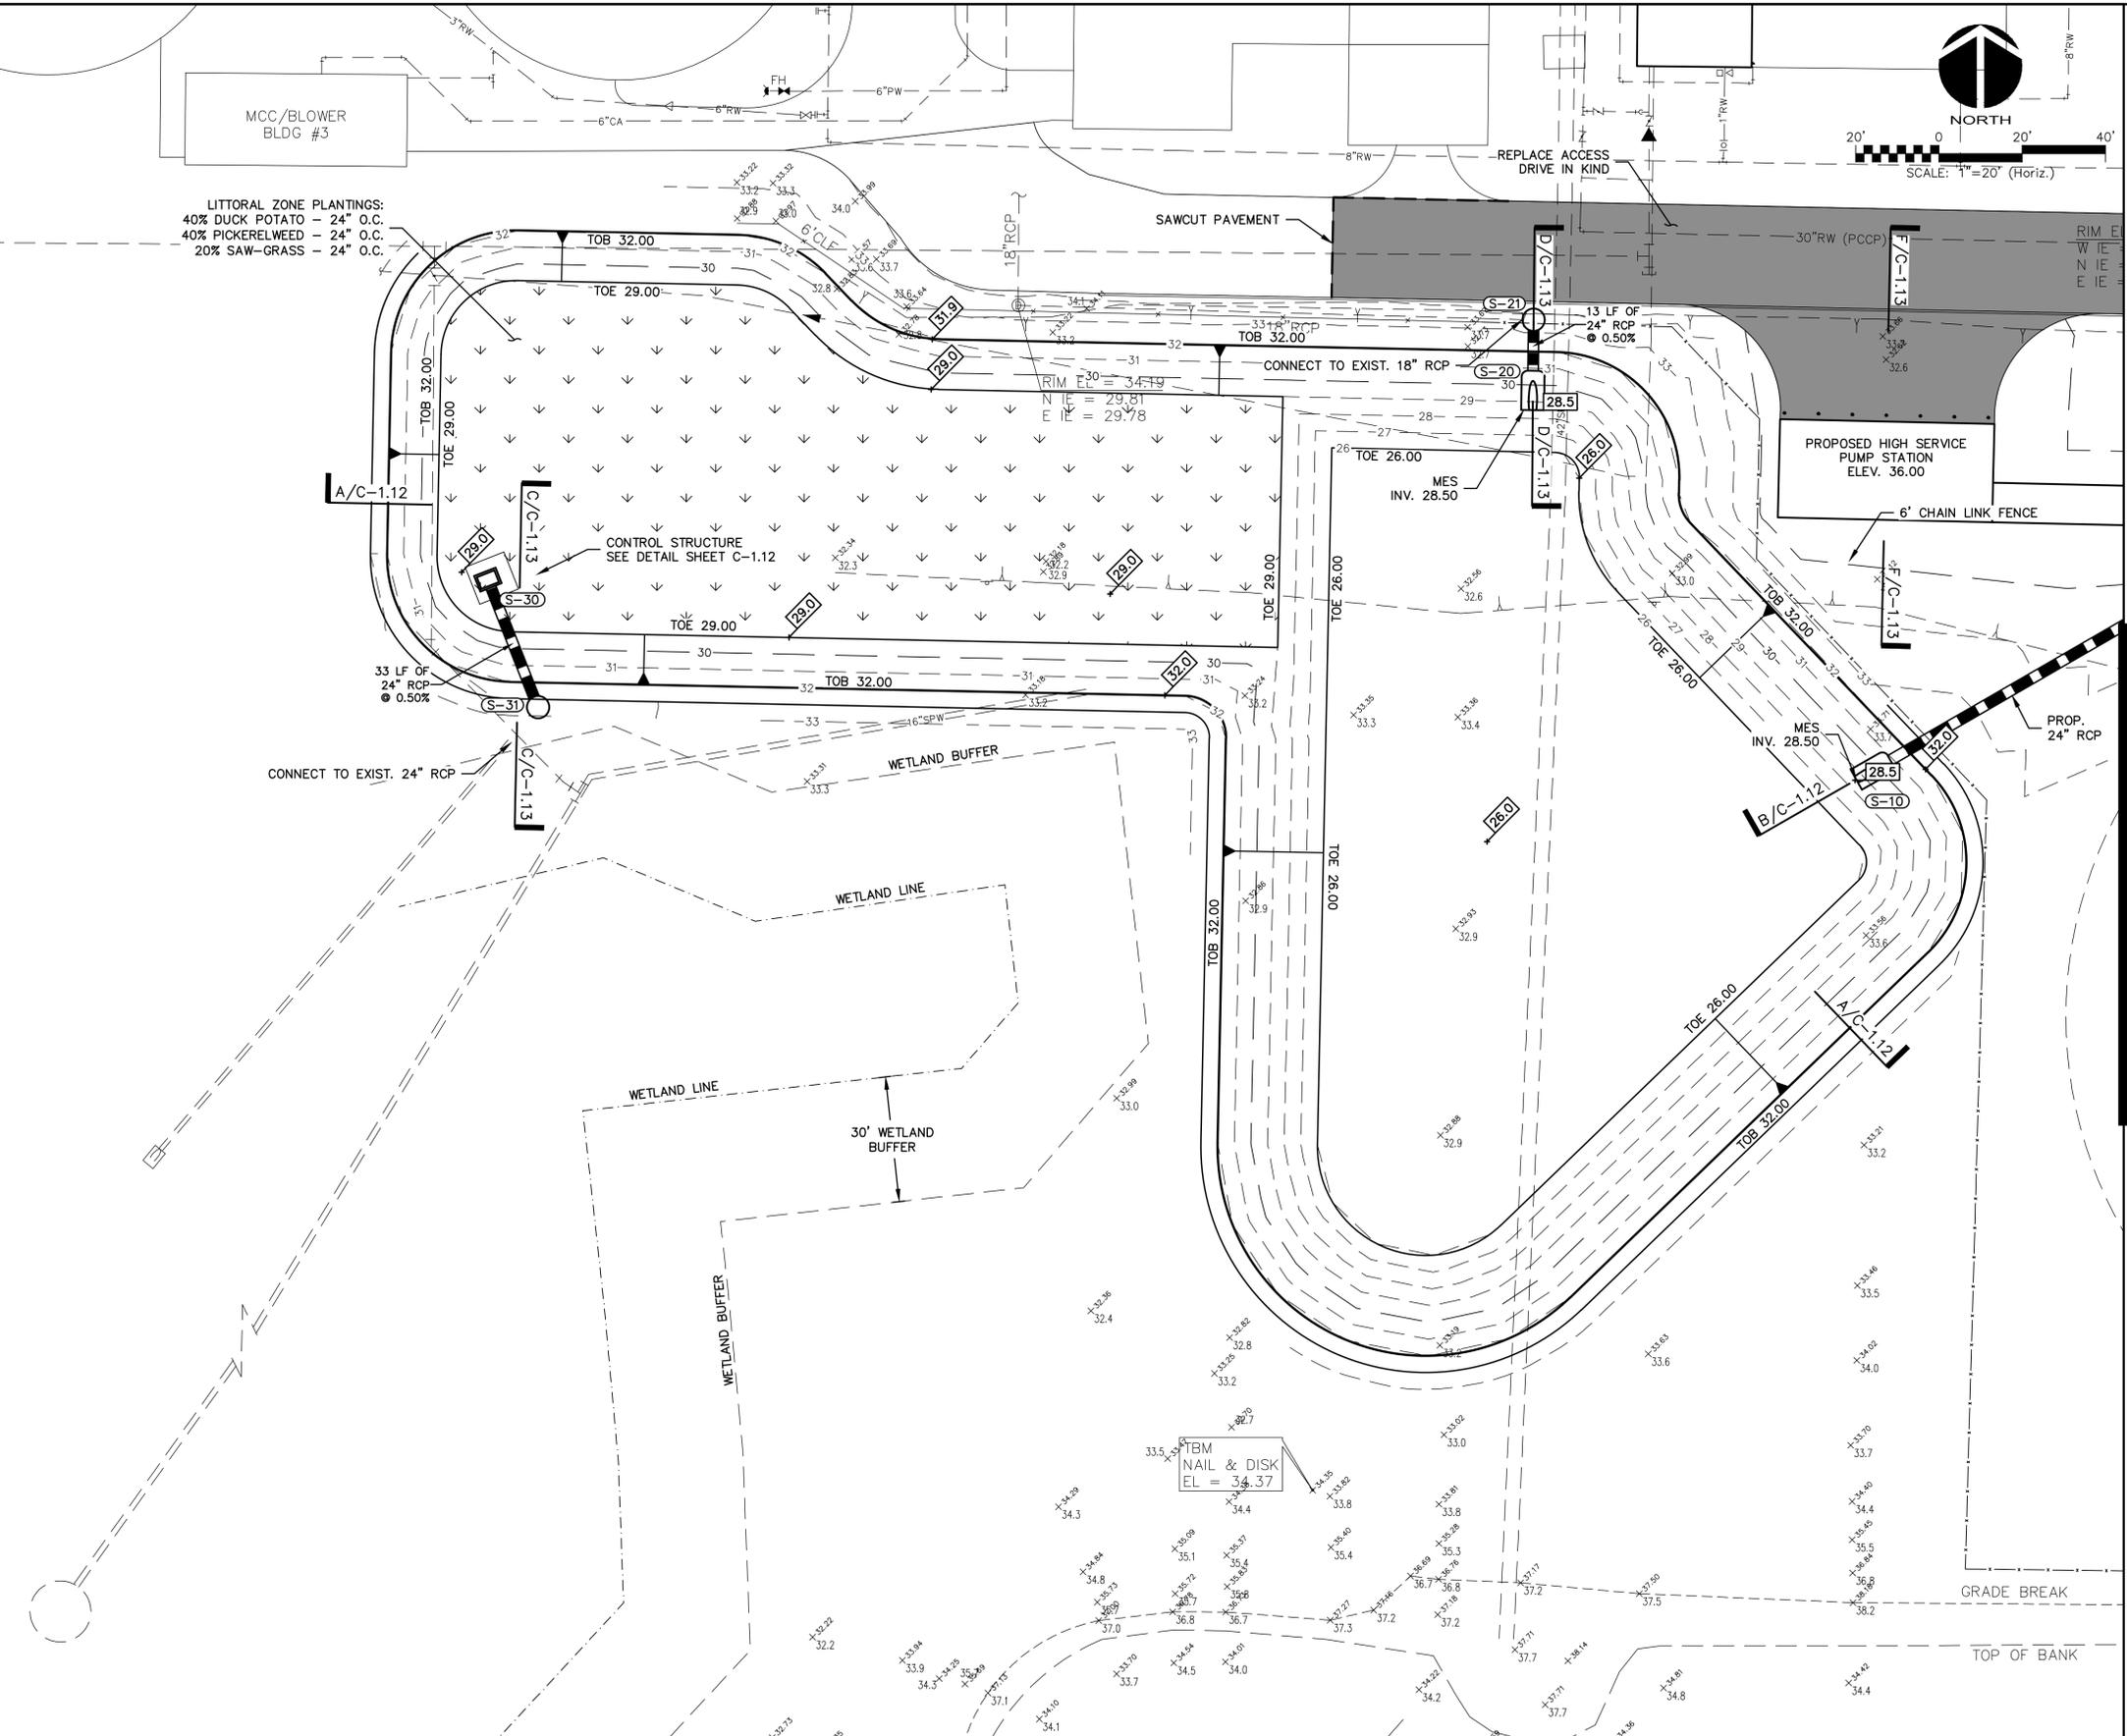
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REV. NO.	DESCRIPTIONS	DATE

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 No. 66118

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MANATEE COUNTY, FLORIDA

SEWRF 10 MG STORAGE TANK AND INTERCONNECTION

PAVING, GRADING AND DRAINAGE
 PLAN 1 OF 2




DATE: APRIL 2014
 MCE PROJ. # 1024-0160
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 DESIGNED: MSL
 CHECKED: MSL
 PROJ. MGR: MSL

SCALE:
 HORIZONTAL: 1" = 30'
 VERTICAL: NA

DRAWING NUMBER: C-1.10

STATUS: ISSUE FOR BID

REVISION

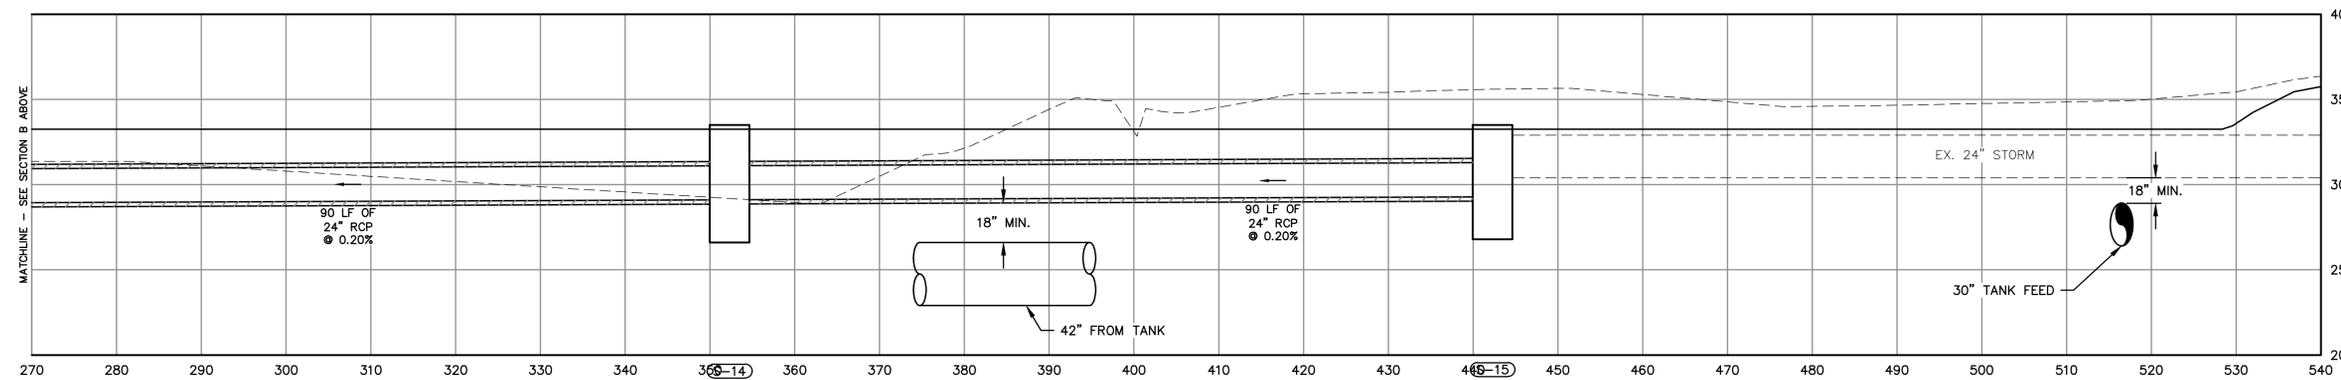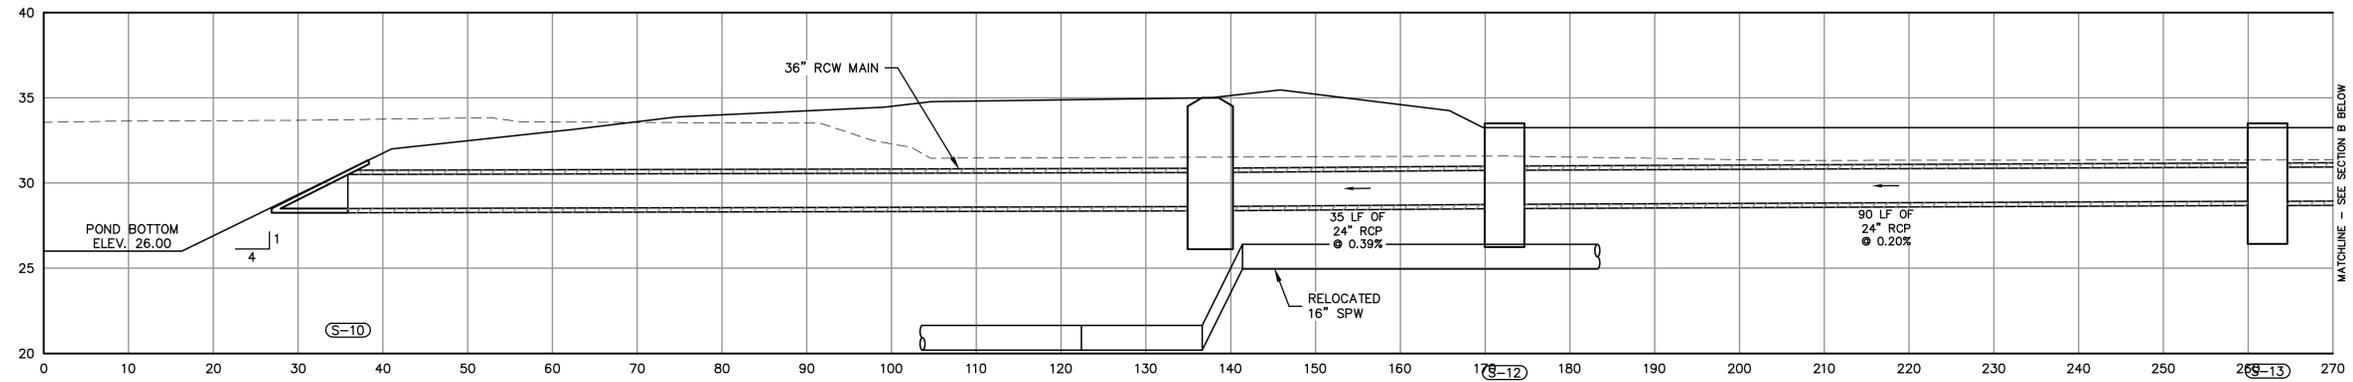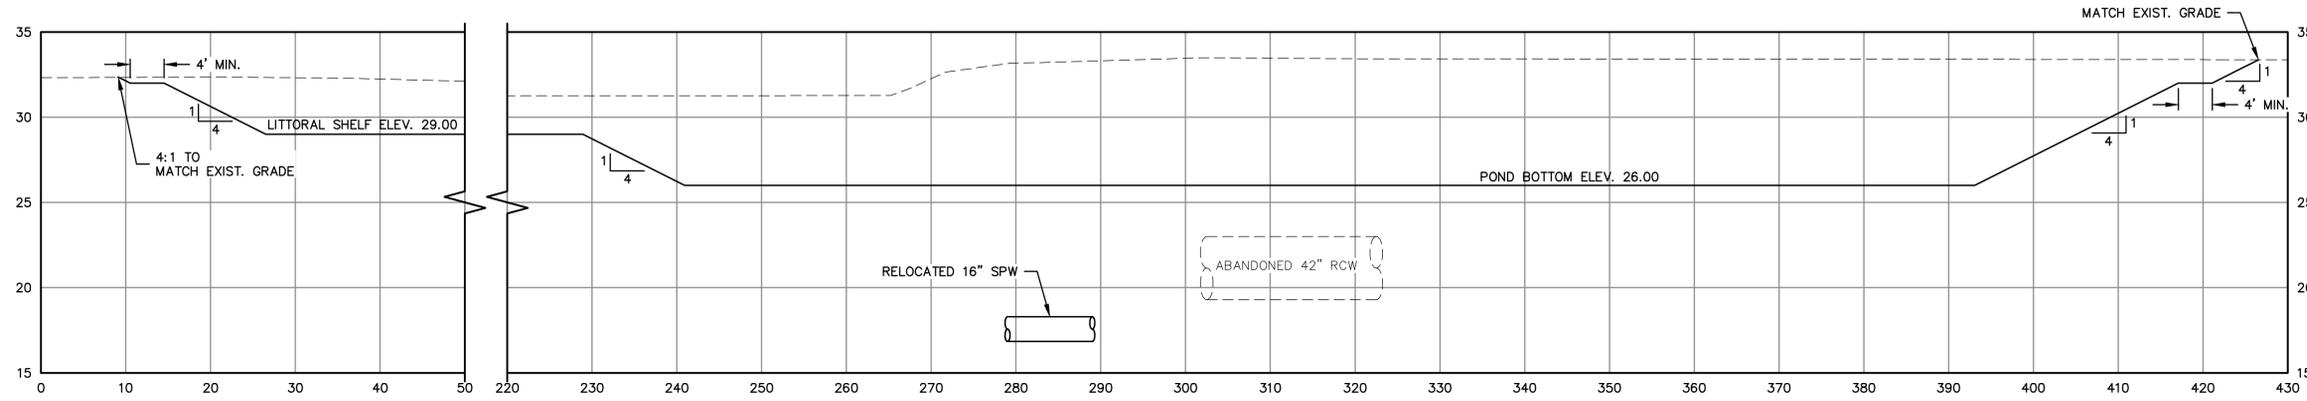

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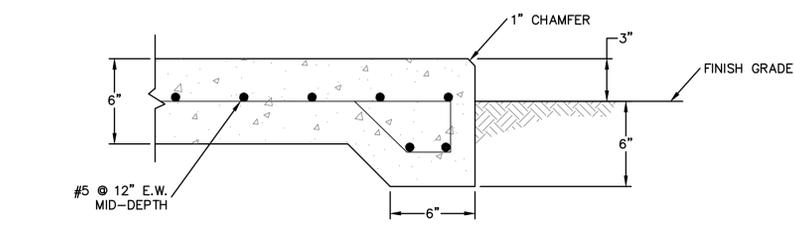
MANATEE COUNTY, FLORIDA

SEWRF 10 MG STORAGE TANK AND INTERCONNECTION


PAVING, GRADING AND DRAINAGE SECTIONS

DATE: APRIL 2014
 MCE PROJ. # 1024-0160
 DRAWN: BFN
 DESIGNED: MSL
 CHECKED: MSL
 PROJ. MGR: MSL


SCALE: HORIZONTAL: 1" = 30' VERTICAL: NA
 DRAWING NUMBER: C-1.12
 STATUS: ISSUE FOR BID



TYPICAL EQUIPMENT PAD DETAIL
NOT TO SCALE

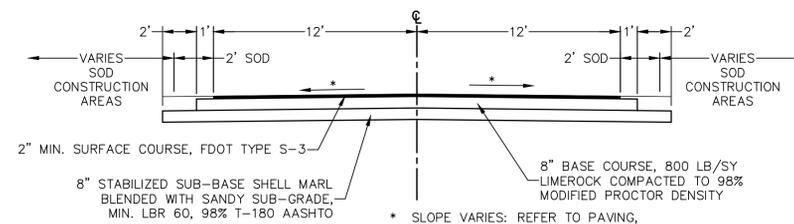


INTERIOR PLANT ROADWAY TYPICAL SECTION
NOT TO SCALE

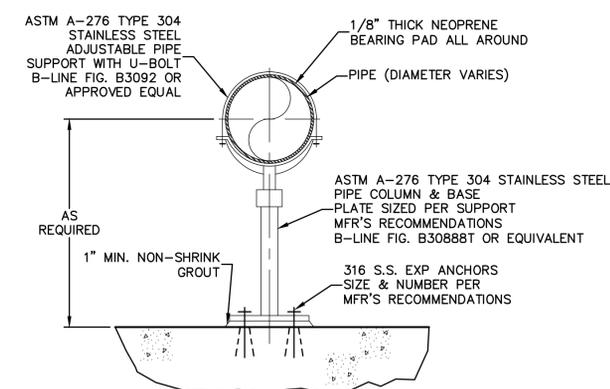


STANCHION PIPE SUPPORT
NOT TO SCALE

- NOTES:**
- USE OF TYPE A-2 AND A-3 PIPE BEDDING TO BE DETERMINED IN THE FIELD BY THE ENGINEER.
 - 10" MAX. FOR PIPE DIAMETER LESS THAN 24"; 12" MAX. FOR PIPE DIAMETER 24" AND LESS THAN 42"; 24" MAX. FOR PIPE DIAMETER 42" AND OVER.
 - 4" MAX. FOR PIPE 16" DIAMETER & LESS; 6" MAX. FOR PIPE 18" TO 36" DIAMETER; AND 9" MAX. FOR PIPE 42" DIAMETER AND LARGER.
 - PIPE INSTALLATION SHALL BE IN ACCORDANCE WITH THE MANUFACTURER'S WRITTEN INSTRUCTIONS.
 - THICKNESS TO MATCH EXISTING OR BE 6" MINIMUM, WHICHEVER IS GREATER.
 - SHEETING ORDERED LEFT IN PLACE TO BE CUT OFF 24" BELOW FINISH GRADE OR 12" BELOW SUBGRADE.
 - BASE SHALL BE COMPACTED 6" MINIMUM THICKNESS OF APPROVED MATERIAL.
 - BACKFILL ASHTO M-145 SHALL BE PLACED IN LAYERS NOT TO EXCEED 6 INCHES. EACH LAYER SHALL BE THOROUGHLY TAMPED AND/OR ROLLED TO 98% ASHTO T-180 DENSITY.
 - DRIVEWAYS SHALL BE CONSTRUCTED IN ACCORDANCE WITH THE LATEST ADOPTED CONSTRUCTION STANDARDS OF THE MANATEE COUNTY TRANSPORTATION DEPARTMENT.
 - IF THE DRIVEWAY IS 12" OR WIDER, SAWCUT AN EXPANSION JOINT ALONG THE CENTER OF THE DRIVEWAY (3/16" WIDE AND 1 1/2" DEEP) AFTER THE CONCRETE HAS SET.
 - IF THERE IS AN EXISTING EXPANSION JOINT WITHIN 3' OF THE PROPOSED JOINT, EXTEND DRIVEWAY REPLACEMENT TO THE EXISTING JOINT.
 - TRACER WIRE NOT REQUIRED FOR GRAVITY SEWERS.

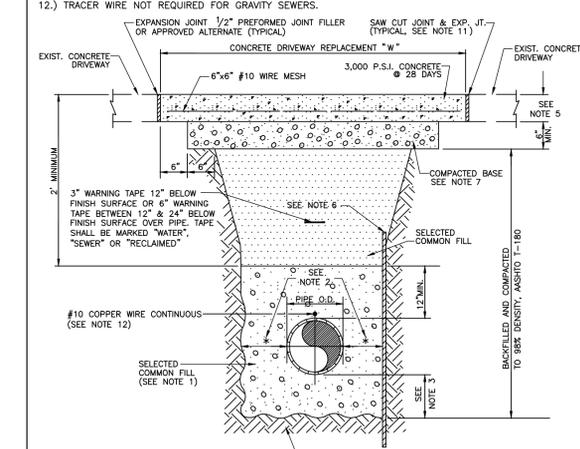


MANATEE COUNTY PUBLIC WORKS DEPARTMENT
TRENCH WITH CONCRETE DRIVEWAY SURFACE
TYPE A-1 PIPE BEDDING
UG-14
REVISIONS: 02/05, 10/08, 02/09
DATE OF APPROVAL: MARCH 17, 2009

- NOTES:**
- USE OF TYPE A-2 AND A-3 PIPE BEDDING TO BE DETERMINED IN THE FIELD BY THE ENGINEER.
 - 10" MAX. FOR PIPE DIAMETER LESS THAN 24"; 12" MAX. FOR PIPE DIAMETER 24" AND LESS THAN 42"; 24" MAX. FOR PIPE DIAMETER 42" AND OVER.
 - 4" MAX. FOR PIPE 16" DIAMETER & LESS; 6" MAX. FOR PIPE 18" TO 36" DIAMETER; AND 9" MAX. FOR PIPE 42" DIAMETER AND LARGER.
 - PIPE INSTALLATION SHALL BE IN ACCORDANCE WITH THE MANUFACTURER'S WRITTEN INSTRUCTIONS.
 - BACKFILL ASHTO M-145 SHALL BE PLACED IN LAYERS NOT TO EXCEED 6 INCHES FOR COMMON FILL AND NOT TO EXCEED 12 INCHES FOR COMMON FILL. EACH LAYER SHALL BE THOROUGHLY TAMPED AND/OR ROLLED TO 98% ASHTO T-180 DENSITY.
 - TRACER WIRE NOT REQUIRED FOR GRAVITY SEWERS.

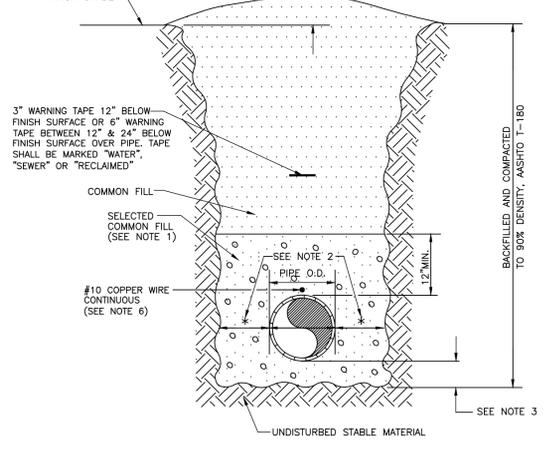


MANATEE COUNTY PUBLIC WORKS DEPARTMENT
TRENCH WITH UNIMPROVED SURFACE
TYPE A-1 PIPE BEDDING
UG-11
REVISIONS: 02/05, 10/08, 02/09
DATE OF APPROVAL: MARCH 17, 2009

- NOTES:**
- USE OF TYPE A-2 AND A-3 PIPE BEDDING TO BE DETERMINED IN THE FIELD BY THE ENGINEER.
 - 10" MAX. FOR PIPE DIAMETERS LESS THAN 24"; 12" MAX. FOR PIPE DIAMETER 24" AND LESS THAN 42"; 24" MAX. FOR PIPE DIAMETER 42" AND OVER.
 - 4" MAX. FOR PIPE 16" DIAMETER & LESS; 6" MAX. FOR PIPE 18" TO 36" DIAMETER; AND 9" MAX. FOR PIPE 42" DIAMETER AND LARGER.
 - PIPE INSTALLATION SHALL BE IN ACCORDANCE WITH THE MANUFACTURER'S WRITTEN INSTRUCTIONS.
 - ASPHALTIC CONCRETE FRICTION COURSE WITH PRIME COAT SHALL BE THE SAME DEPTH AND TYPE AS EXISTING OR A MINIMUM OF ONE INCH, WHICHEVER IS GREATER.
 - SHEETING ORDERED LEFT IN PLACE TO BE CUT OFF 24" BELOW FINISHED GRADE OR 12" BELOW SUBGRADE.
 - BASE SHALL BE 8" MINIMUM THICKNESS CRUSHED CONCRETE. SAND ASPHALT BASE WILL BE AN ACCEPTABLE ALTERNATIVE.
 - BACKFILL ASHTO M-145 SHALL BE PLACED IN LAYERS NOT TO EXCEED 6 INCHES. EACH LAYER SHALL BE THOROUGHLY TAMPED AND/OR ROLLED TO 98% ASHTO T-180 DENSITY.
 - TEMPORARY PATCHES WILL BE INSTALLED TO PROVIDE A SMOOTH ALL WEATHER SURFACE AT ALL TIME. PERMANENT REPLACEMENT TO BE MADE AS SOON AS POSSIBLE.
 - RESTORE SIGNAGE & MARKING WITH THERMOPLASTIC PER FDOT STANDARDS, LATEST EDITION.
 - TRACER WIRE NOT REQUIRED FOR GRAVITY SEWERS.
 - NOTES 5), THRU 11.) ARE MINIMUM REQUIREMENTS. REFER TO MANATEE COUNTY HIGHWAY AND TRAFFIC STANDARDS FOR ADDITIONAL REQUIREMENTS.

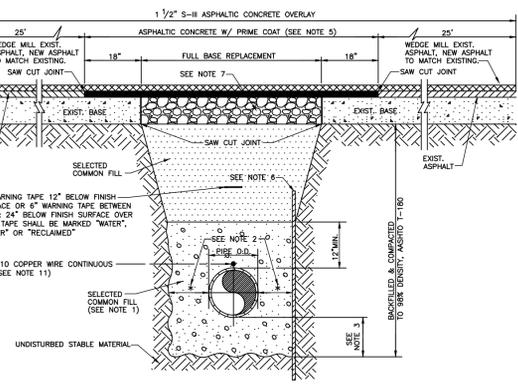

MANATEE COUNTY PUBLIC WORKS DEPARTMENT
TRENCH WITH ASPHALT PAVEMENT SURFACE
TYPE A-1 PIPE BEDDING
UG-12
REVISIONS: 02/05, 11/08, 02/09
DATE OF APPROVAL: MARCH 17, 2009

- NOTES:**
- 10" MAX. FOR PIPE DIAMETER LESS THAN 24"; 12" MAX. FOR PIPE DIAMETER 24" AND LESS THAN 42"; 24" MAX. FOR PIPE DIAMETER 42" AND OVER.
 - 4" MAX. FOR PIPE 16" DIAMETER AND LESS; 6" MAX. FOR PIPE DIAMETER 18" TO 36" AND 9" MAX. FOR PIPE DIAMETER 42" AND OVER.
 - PIPE INSTALLATION SHALL BE IN ACCORDANCE WITH MANUFACTURER'S WRITTEN INSTRUCTIONS.
 - BACKFILL ASHTO M-145 SHALL BE PLACED IN LAYERS NOT TO EXCEED 6 INCHES. EACH LAYER SHALL BE THOROUGHLY TAMPED AND/OR ROLLED TO 98% ASHTO T-180 DENSITY.
 - TRACER WIRE NOT REQUIRED FOR GRAVITY SEWERS.

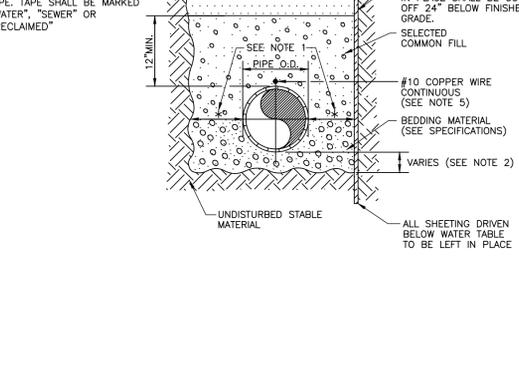


MANATEE COUNTY PUBLIC WORKS DEPARTMENT
TRENCH WITH TYPE A-2 PIPE BEDDING
UG-15
REVISIONS: 08/05, 11/08, 02/09
DATE OF APPROVAL: MARCH 17, 2009



THRUST BLOCK DIMENSIONS B ft. x d inches

PIPE SIZE (IN.)	90° BEND			45° BEND			22.5° BEND			11.25° BEND			DEAD END & TEE			45° WYE		
	B	d	B	B	d	B	d	B	d	B	d	B	d	B	d	B	d	
4	1.5	3 1/2	1.1	3 1/2	0.8	3 1/2	0.6	3 1/2	1.3	3 1/2	1.1	3 1/2						
6	2.2	5 1/4	1.6	3 3/4	1.2	3 3/2	0.8	3 1/2	1.9	4 1/2	1.6	3 3/4						
8	2.9	7	2.1	5	1.5	3 1/2	1.1	3 1/2	2.4	5 3/4	2.0	4 3/4						
10	3.5	8 1/2	2.6	6 1/4	1.9	4 1/2	1.3	3 1/2	3.0	7 1/4	2.5	6						
12	4.2	10	3.1	7 1/2	2.2	5 1/4	1.6	3 3/4	3.5	8 1/2	3.0	7 1/4						
14	4.9	11 3/4	3.6	8 3/4	2.6	6 1/4	1.8	4 1/4	4.1	9 3/4	3.4	8 1/4						
16	5.5	13 1/4	4.1	9 3/4	2.9	7	2.1	5	4.7	11 1/4	3.9	9 1/4						
18	6.2	15	4.6	11	3.3	8	2.3	5 1/2	5.2	12 1/2	4.4	10 1/2						
20	6.9	16 1/2	5.0	12	3.6	8 3/4	2.6	6 1/4	5.8	14	4.9	11 3/4						
24	8.2	19 1/4	6.0	14 1/2	4.3	10 1/4	3.1	7 1/2	6.9	16 1/2	5.8	14						
30	10.1	24 1/4	7.5	18	5.3	12 3/4	3.8	9	8.5	20 1/2	7.2	17 1/4						
36	12.1	29	8.9	21 1/4	6.4	15 1/4	4.5	10 3/4	10.2	24 1/2	8.6	20 3/4						



REINFORCEMENT MAT SCHEDULE
FOR DIM. "B" BETWEEN 5.75' & 12.5' USE #4 @ 8" EACH WAY
FOR DIM. "B" LESS THAN 5.75' USE #3 @ 8" EACH WAY

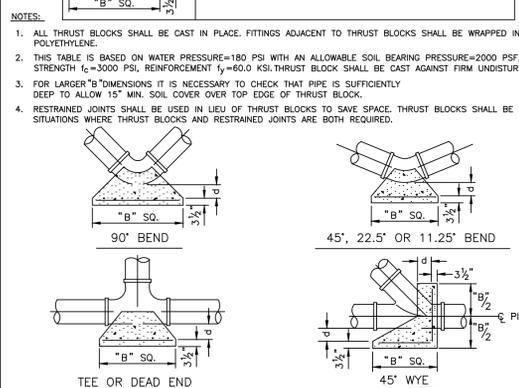

MANATEE COUNTY PUBLIC WORKS DEPARTMENT
CONCRETE THRUST BLOCKS
UG-7
REVISIONS: 2/05, 7/09
DATE OF APPROVAL: MARCH 17, 2009

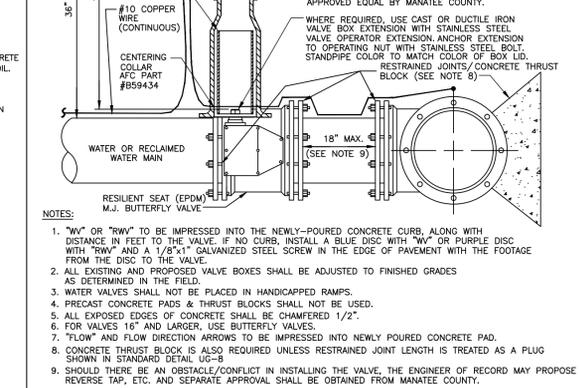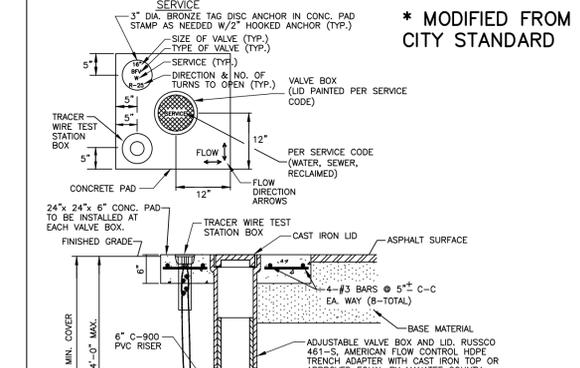

MANATEE COUNTY PUBLIC WORKS DEPARTMENT
BUTTERFLY VALVE, BOX, LID AND TAG
UW-3
REVISIONS: 08/05, 10/08, 02/09
DATE OF APPROVAL: MARCH 17, 2009

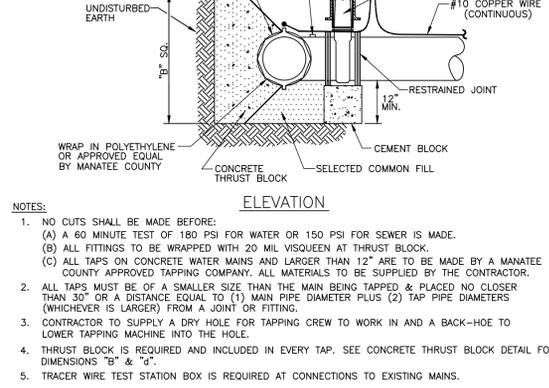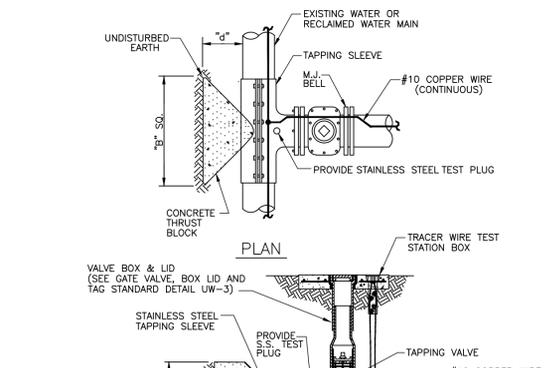

MANATEE COUNTY PUBLIC WORKS DEPARTMENT
TAPPING SLEEVE AND VALVE
UW-4
REVISIONS: 08/05, 10/08, 02/09
DATE OF APPROVAL: MARCH 17, 2009

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MANATEE COUNTY, FLORIDA

SEWRF 10 MG STORAGE TANK AND INTERCONNECTION
CIVIL DETAILS 1 OF 3

DATE: APRIL 2014
MCE PROJ. # 1024-0160
DRAWN: BFN
DESIGNED: MSL
CHECKED: MSL
PROJ. MGR. MSL

SCALE:
HORIZONTAL: NA
VERTICAL: NA

DRAWING NUMBER: C-9.1

STATUS: ISSUE FOR BID

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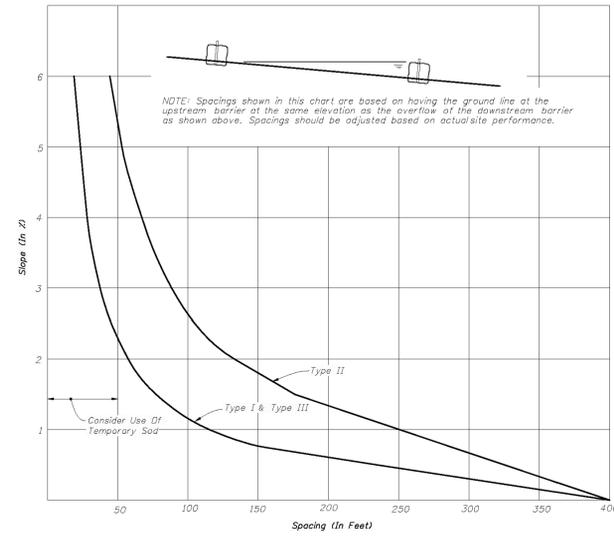
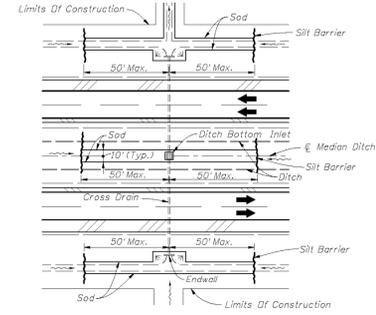
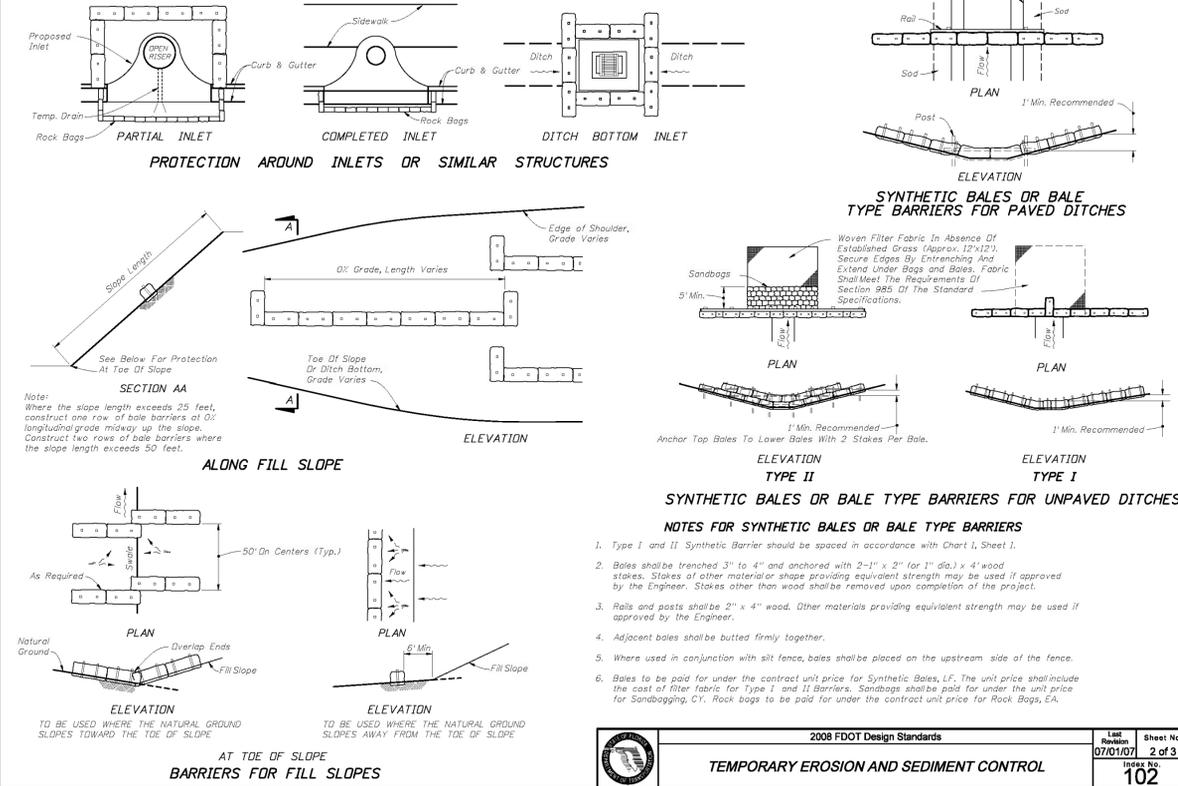


CHART I
RECOMMENDED SPACING FOR SYNTHETIC BALES OR BALE TYPE BARRIERS AND TYPE III SILT FENCE




DITCH INSTALLATIONS AT DRAINAGE STRUCTURES

	2008 FDOT Design Standards	Last Revision 07/01/07	Sheet No. 1 of 3
	TEMPORARY EROSION AND SEDIMENT CONTROL	Index No. 102	



PROTECTION AROUND INLETS OR SIMILAR STRUCTURES
ALONG FILL SLOPE
AT TDE OF SLOPE
BARRIERS FOR FILL SLOPES

	2008 FDOT Design Standards	Last Revision 07/01/07	Sheet No. 2 of 3
	TEMPORARY EROSION AND SEDIMENT CONTROL	Index No. 102	

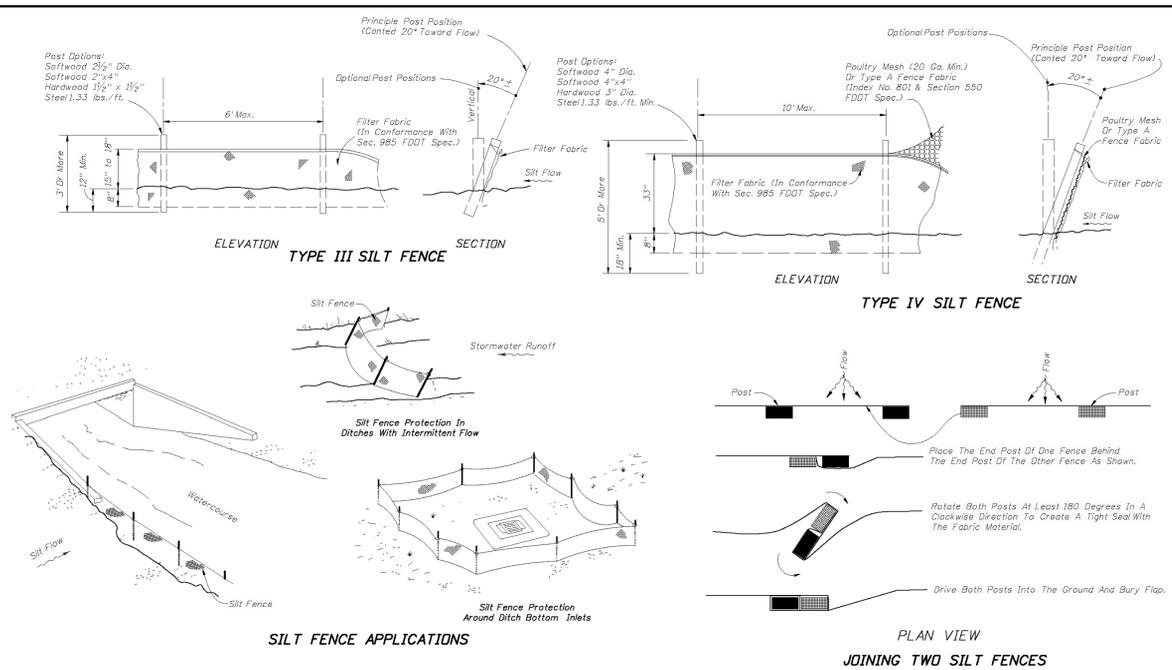

NOTES FOR SILT FENCES

- Type III Silt Fence to be used at most locations. Where used in ditches, the spacing for Type III Silt Fence shall be in accordance with Chart I, Sheet 1.
- Type IV Silt Fence to be used where large sediment loads are anticipated. Suggested use is where fill slope is 1:2 or steeper and length of slope exceeds 25 feet. Avoid use where the retained water may back into travel lanes or off the right of way.
- Do not construct silt fences across permanent flowing watercourses. Silt fences are to be at upland locations and turbidity barriers used at permanent bodies of water.
- Where used as slope protection, Silt Fence is to be constructed on 0% longitudinal grade to avoid channelizing runoff along the length of the fence.
- Silt Fence to be paid for under the contract unit price for Staked Silt Fence, (L.F.).

	2008 FDOT Design Standards	Last Revision 07/01/06	Sheet No. 3 of 3
	TEMPORARY EROSION AND SEDIMENT CONTROL	Index No. 102	

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REVNO.	DESCRIPTIONS	DATE

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MATTHEW S. LOVE, P.E.
No. 66118


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MANATEE COUNTY, FLORIDA


SEWRF 10 MG STORAGE TANK AND INTERCONNECTION
CIVIL DETAILS 3 OF 3

DATE: APRIL 2014	SCALE: HORIZONTAL: NA	DRAWING NUMBER: C-9.3
MCE PROJ. # 1024-0160	VERTICAL: NA	REVISION: ISSUE FOR BID
DRAWN: BFN		
DESIGNED: MSL		
CHECKED: MSL		
PROJ. MGR: MSL		




NOTES:
 1. (*) - HORZ. REINF. CLASS B LAP SPLICE.
 2. PROVIDE A WATERSTOP WHERE JOINT BORDERING SOIL AND/OR WATER. REFERENCE PROJECT SPECIFICATIONS FOR WATERSTOP REQUIREMENTS.

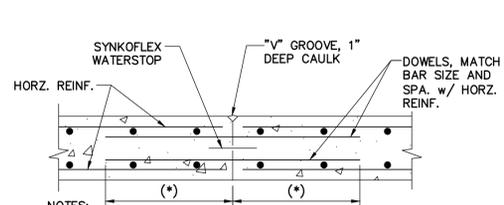1 - DETAIL-TYP. C.I.P. CONC. SLAB CONST. JT. (C.J)
 SCALE: 3/4" = 1'-0"

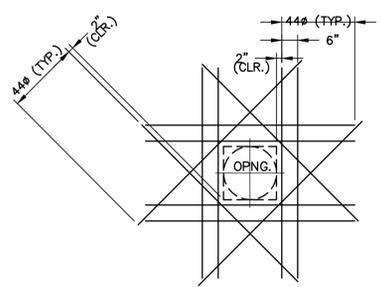


2 - DETAIL-TYP. REINF. @ SLAB / WALL OPNG
 SCALE: 3/8" = 1'-0"

NOTES:
 1. USE THIS DETAIL FOR PENETRATIONS 8" OR LARGER. FOR SMALLER OPENINGS BEND BARS IN FIELD PER ACI 350 LATEST EDITION.
 2. PLACE EXTRA BARS OF THE SAME SIZE AS THE INTERRUPTED BARS AT EACH SIDE OF OPENINGS. QUANTITY OF EXTRA BARS AT EACH SIDE SHALL EQUAL HALF THE QUANTITY OF INTERRUPTED BARS, EXCEPT WHERE NOTED OTHERWISE. PROVIDE ONE DIAGONAL BAR EACH SIDE OF OPENING, SIZE TO BE EQUAL TO MAIN REINFORCING. (TYP. EA. FACE).
 3. Ø SYMBOL = BAR DIAMETERS.

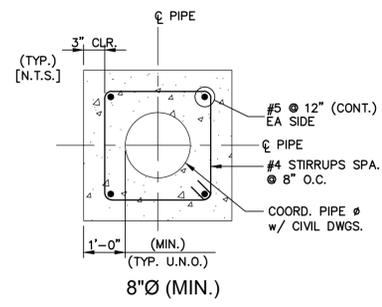

3- DETAIL - TYP. CONC. ENCASED PIPE
 SCALE: 1/2" = 1'-0"

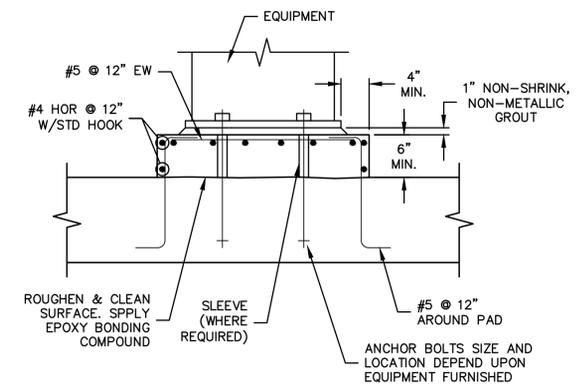

6- DETAIL - TYP. EQUIPMENT SUPPORT PAD
 SCALE: NTS

DEVELOPMENT LENGTH OF STANDARD HOOKS
 FOR BARS IN TENSION
 fy = 60,000 psi
 fc = 4000 psi OR GREATER

BAR SIZE	DEVELOPMENT LENGTH, l_d	
	BASIC	W/ CONC COVER *
#3	8"	6"
#4	10"	7"
#5	1'-0"	9"
#6	1'-2"	10"
#7	1'-5"	1'-0"
#8	1'-7"	1'-1"
#9	1'-9"	1'-3"
#10	2'-0"	1'-5"
#11	2'-2"	1'-6"

*SIDE COVER NORMAL TO PLANE OF HOOK AT LEAST 2 1/2"; AND FOR 90° HOOK END COVER BEYOND OUTSIDE END OF HOOK AT LEAST 2".

BASIC DEVELOPMENT LENGTH AND SPLICE LENGTH
 FOR BARS IN COMPRESSION
 fy = 60,000 psi
 fc = 4000 psi OR GREATER


BASIC DEVELOPMENT LENGTH		BAR SIZE	SPLICE LENGTH	
BASIC	CONFINEMENT *		BASIC	CONFINEMENT **
8"	8"	# 3	12"	12"
10"	8"	# 4	1'-3"	13"
1'-0"	9"	# 5	1'-7"	1'-4"
1'-3"	1'-0"	# 6	1'-11"	1'-7"
1'-5"	1'-1"	# 7	2'-2"	1'-10"
1'-7"	1'-3"	# 8	2'-6"	2'-1"
1'-9"	1'-4"	# 9	2'-10"	2'-4"
2'-0"	1'-6"	# 10	3'-2"	2'-7"
2'-2"	1'-8"	# 11	3'-6"	2'-10"

* BAR ENCLOSED WITHIN SPIRALS OF NOT LESS THAN 1/4 INCH DIAMETER AND NOT MORE THAN 4 INCH PITCH OR WITHIN #4 TIES IN CONFORMANCE WITH ACI 318, SECTION 7.10.5 AT NOT MORE THAN 4 INCHES ON CENTER, FACTOR 0.75 USED.
 ** BAR ENCLOSED WITHIN TIES PER ACI 350-01 SECTION 12.17.2.4.


BASIC DEVELOPMENT LENGTH AND SPLICE LENGTH
 FOR BARS IN TENSION
 fy = 60,000 psi
 fc = 4000 psi OR GREATER, NORMAL WEIGHT CONCRETE

BASIC DEVELOPMENT LENGTH **				BAR SIZE	CLASS B SPLICE LENGTH **			
CLEAR SPACING $\geq 2d_b$		CLEAR SPACING $< 2d_b$			1.3 x l_d		$< 2d_b$	
BASIC	TOP *	BASIC	TOP *	BASIC	TOP *	BASIC	TOP *	
1'-3"	1'-7"	1'-10"	2'-4"	# 3	1'-7"	2'-0"	2'-4"	3'-0"
1'-7"	2'-1"	2'-5"	3'-1"	# 4	2'-1"	2'-8"	3'-1"	4'-0"
2'-0"	2'-7"	3'-0"	3'-10"	# 5	2'-7"	3'-4"	3'-10"	5'-0"
2'-5"	3'-1"	3'-7"	4'-8"	# 6	3'-1"	4'-0"	4'-8"	6'-0"
3'-6"	4'-6"	5'-2"	6'-9"	# 7	4'-6"	5'-10"	6'-9"	8'-9"
4'-0"	5'-2"	6'-0"	7'-9"	# 8	5'-2"	6'-8"	7'-9"	10'-0"
4'-6"	5'-9"	6'-8"	8'-8"	# 9	5'-9"	7'-6"	8'-8"	11'-3"
4'-11"	6'-5"	7'-5"	9'-8"	# 10	6'-5"	8'-4"	9'-8"	12'-6"
5'-5"	7'-1"	8'-2"	10'-8"	# 11	7'-1"	9'-2"	10'-8"	13'-9"

* TOP REINFORCEMENT IS HORIZONTAL REINFORCEMENT SO PLACED THAT MORE THAN 12 INCHES OF FRESH CONCRETE IS CAST IN THE MEMBER BELOW THE REINFORCEMENT.
 ** LENGTHS SHOWN IN CHART SHALL BE MODIFIED WHERE REQUIRED TO CONFORM TO THE PROVISIONS OF ACI 318, SECTION 12.2.

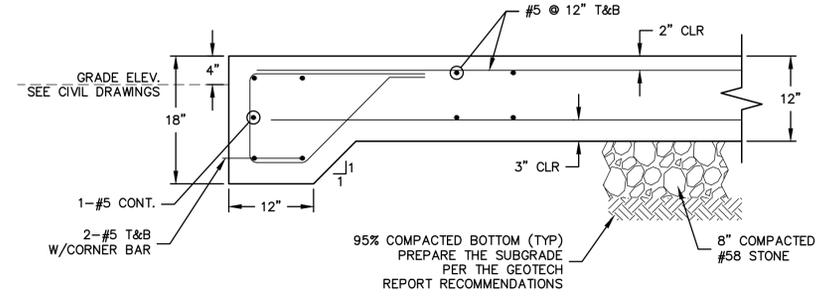


5- DETAIL - TYP. EQUIPMENT PAD
 SCALE: NTS

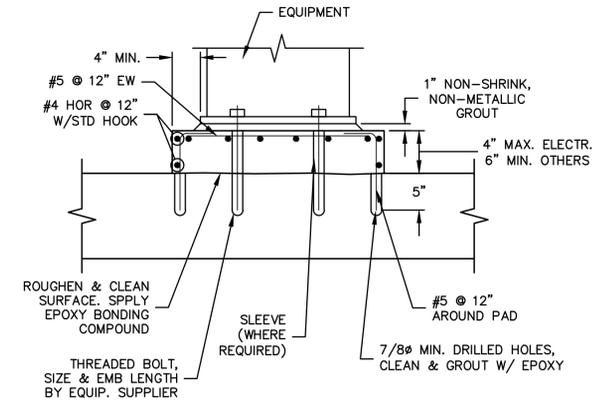


7- DETAIL - TYP. EQUIPMENT SUPPORT PAD ON EXISTING CONCRETE
 SCALE: NTS

4 - SCHEDULE - REINF. BAR SPLICE REQUIREMENTS
 SCALE: N.T.S.

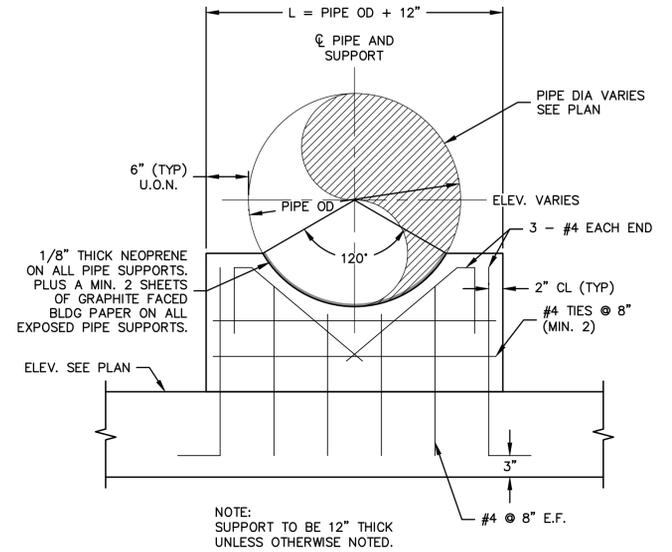

8- DETAIL - TYP. PIPE SUPPORT DETAIL
 SCALE: NTS

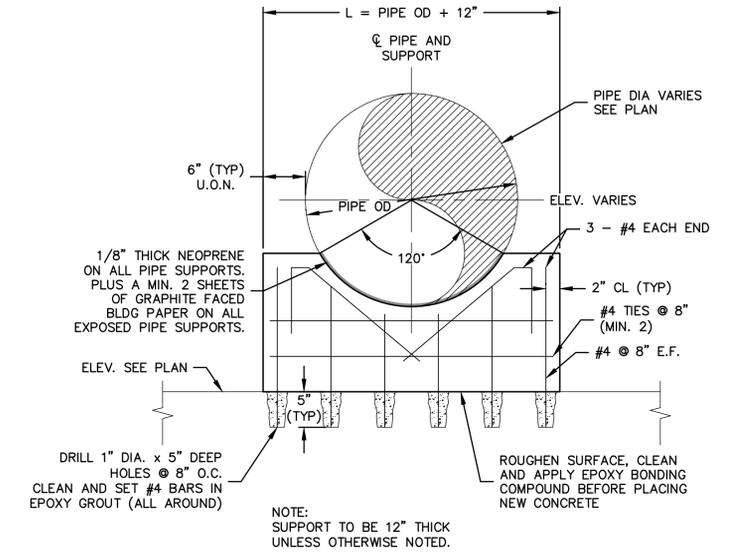

9- DETAIL - TYP. PIPE SUPPORT DETAIL ON EXISTING CONCRETE
 SCALE: NTS

REV. NO.	DESCRIPTIONS	DATE

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H.A. HOBI, PE No. 59360	

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 MANATEE COUNTY, FLORIDA


SEWRF 10 MG STORAGE TANK AND INTERCONNECTION
 STRUCTURAL SECTIONS AND DETAILS

DATE: APRIL 2014	SCALE: HORIZONTAL: NA	DRAWING NUMBER: S-0.2
MCE PROJ. # 1024-0160	VERTICAL: NA	
DRAWN: BFN		
DESIGNED: HAH		
CHECKED: JSL		
PROJ. MGR: MSL		
STATUS: ISSUE FOR BID		REVISION


S:\VDC\A\0100\01-Drawings\STRUCTURAL\0003-1024\0160.dwg, 4/29/2014, 3:12:15 PM, Brian Naught



- NOTES:
1. SEE CIVIL DRAWINGS FOR GRADE ELEVATIONS.
 2. ALLOWABLE SOIL BEARING 1500 PSF.
 3. DESIGN LIVE LOAD 250 PSF.
 4. COORDINATE WITH MECHANICAL DRAWINGS FOR FINAL PUMP SIZE, LOCATION AND ELEVATION.
 5. COORDINATE WITH MECHANICAL DRAWINGS FOR PIPE SUPPORTS AND PENETRATIONS.
 6. DEWATERING IS REQUIRED DURING EXCAVATION. SEE GEOTECHNICAL REPORT.
 7. CONTRACTOR SHALL VERIFY PUMP ELEVATIONS WITH PUMP MANUFACTURER.
 8. MATERIAL EXCAVATED DURING CONSTRUCTION OF PUMP SHAFTS CAN BE USED FOR BACKFILL AFTER APPROVAL OF GEOTECHNICAL ENGINEER. ALL EXCESS MATERIAL SHALL BE REMOVED FROM SITE.
 9. SEE DRIGGERS ENGINEERING GEOTECHNICAL REPORT FOR BACKFILL INSTRUCTIONS.
 10. ALL SLAB OPENINGS SHALL BE REINFORCED PER DETAIL 2/S-0.2.

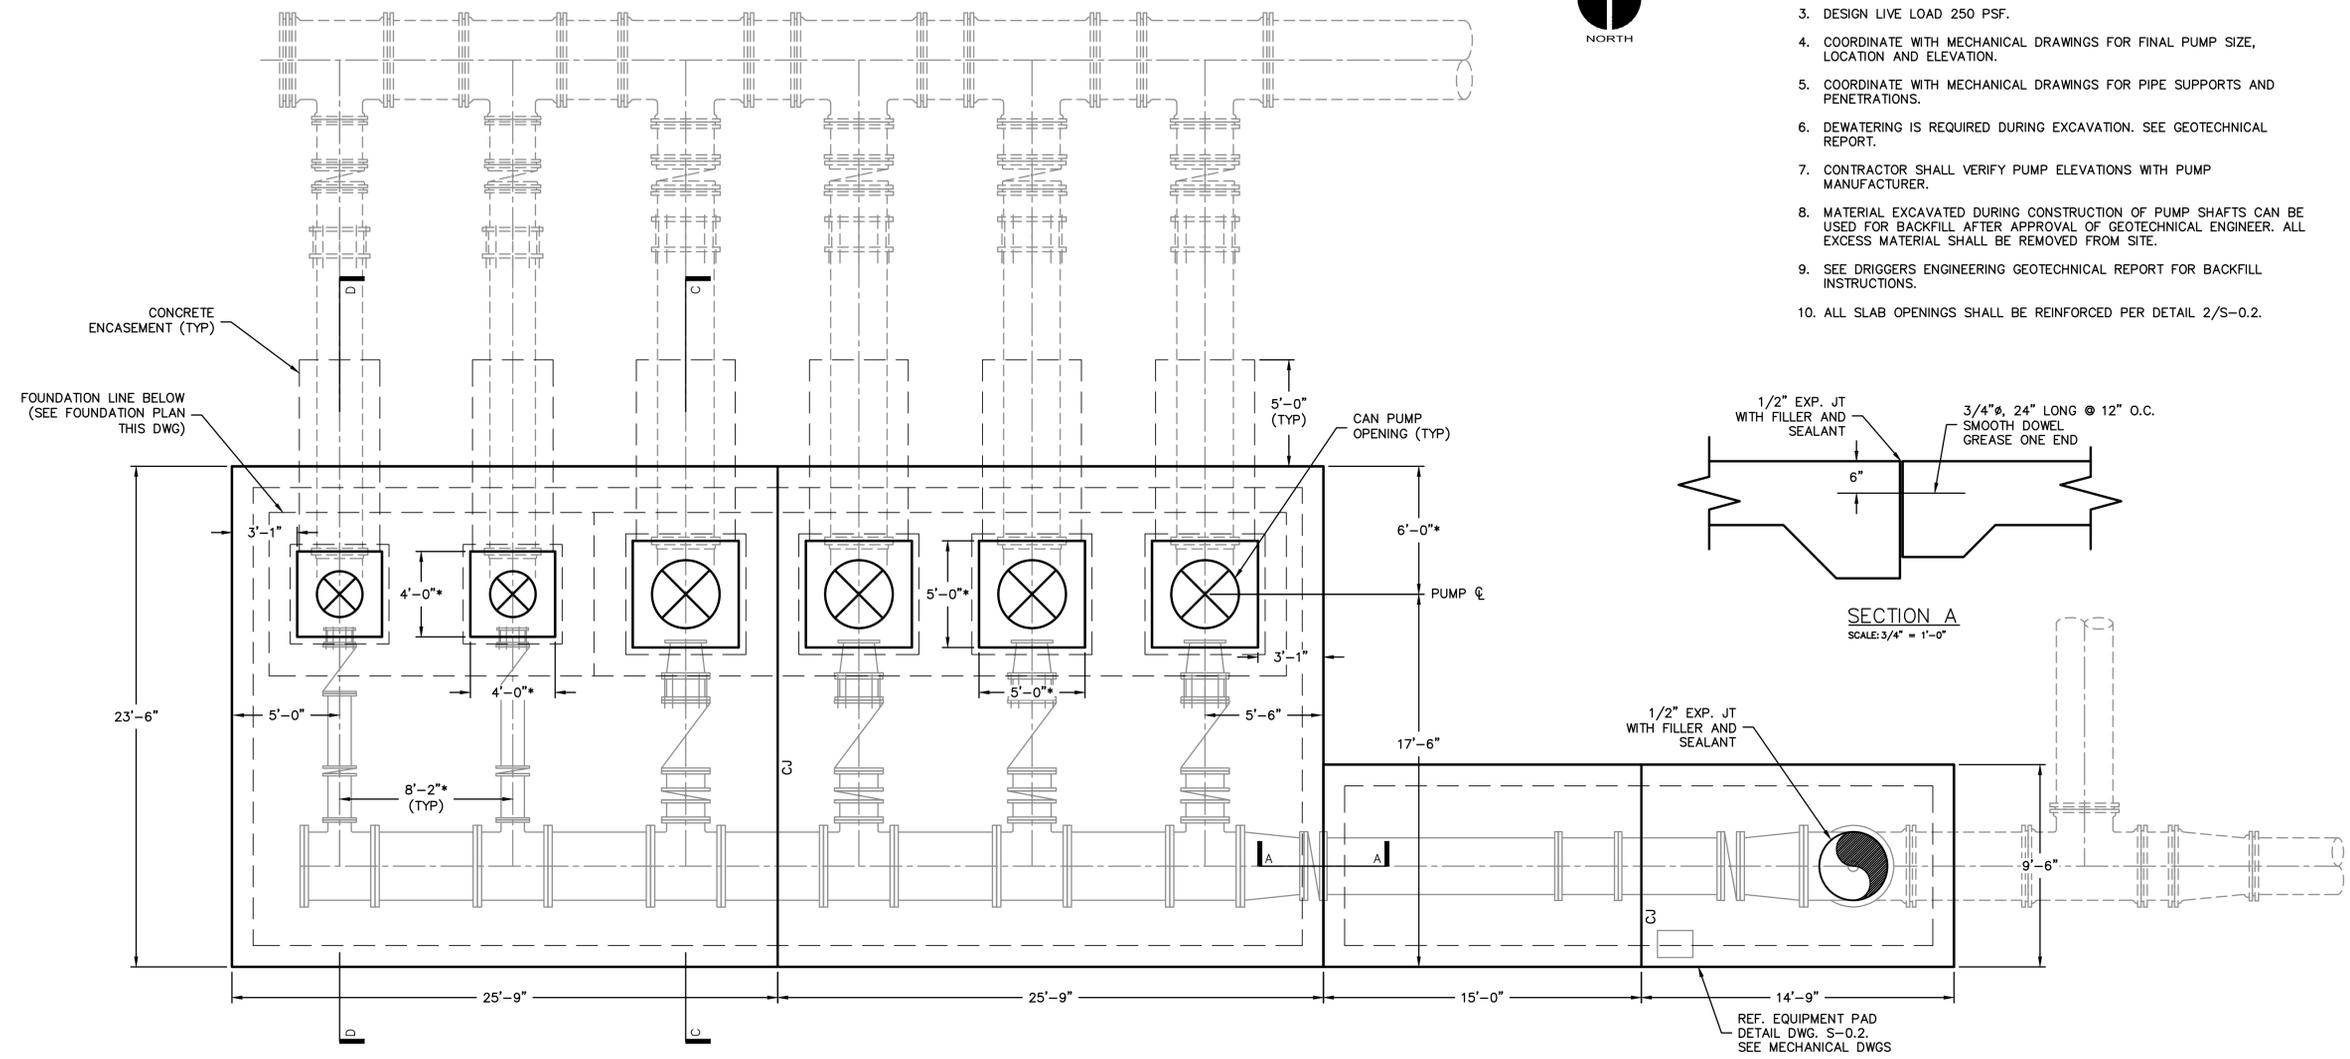

PLAN
SCALE: 1/4" = 1'-0"

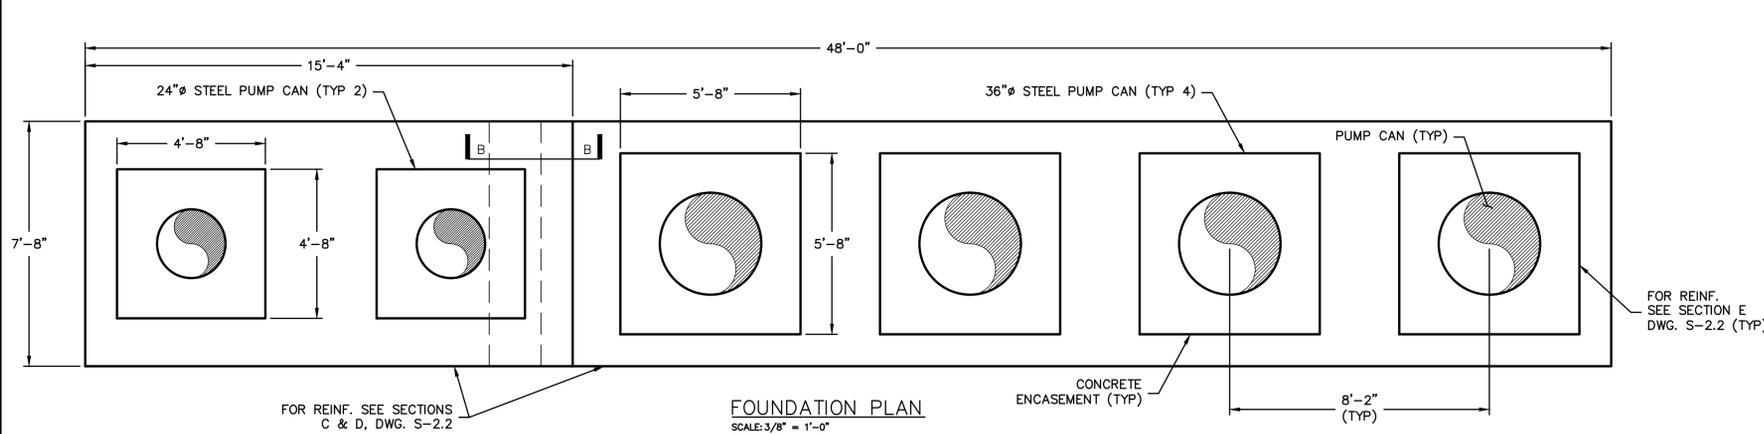

SECTION B
SCALE: 3/4" = 1'-0"

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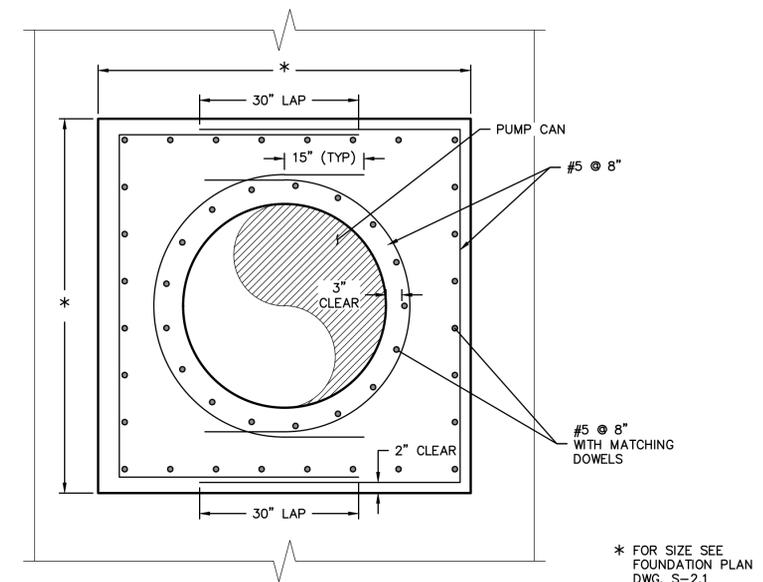
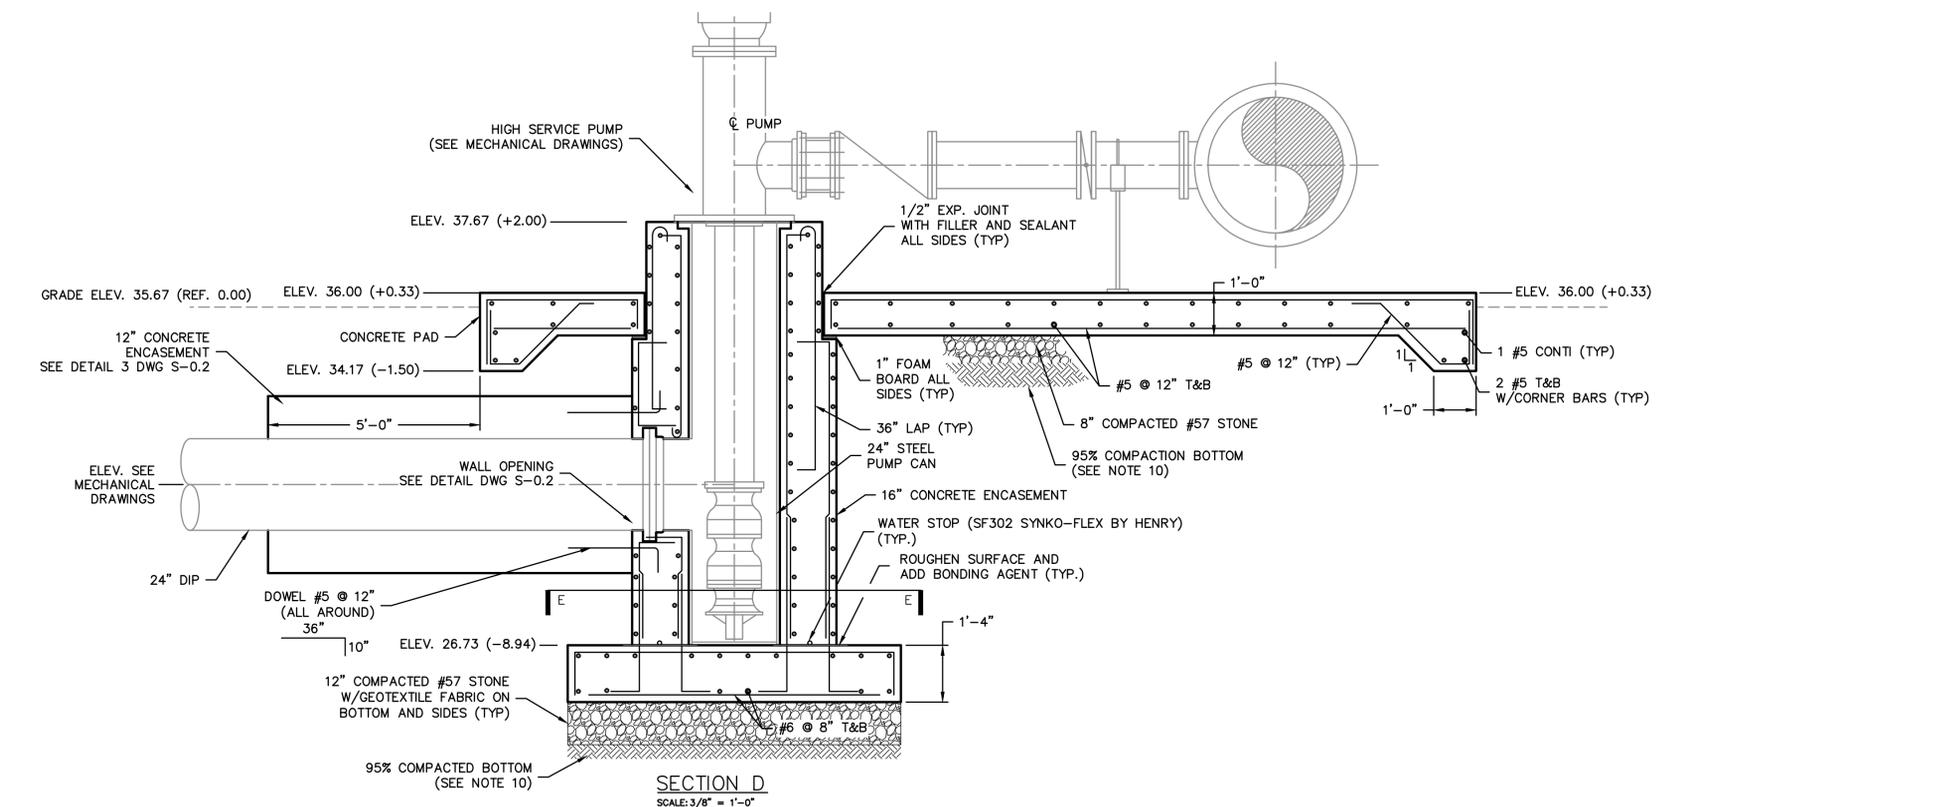
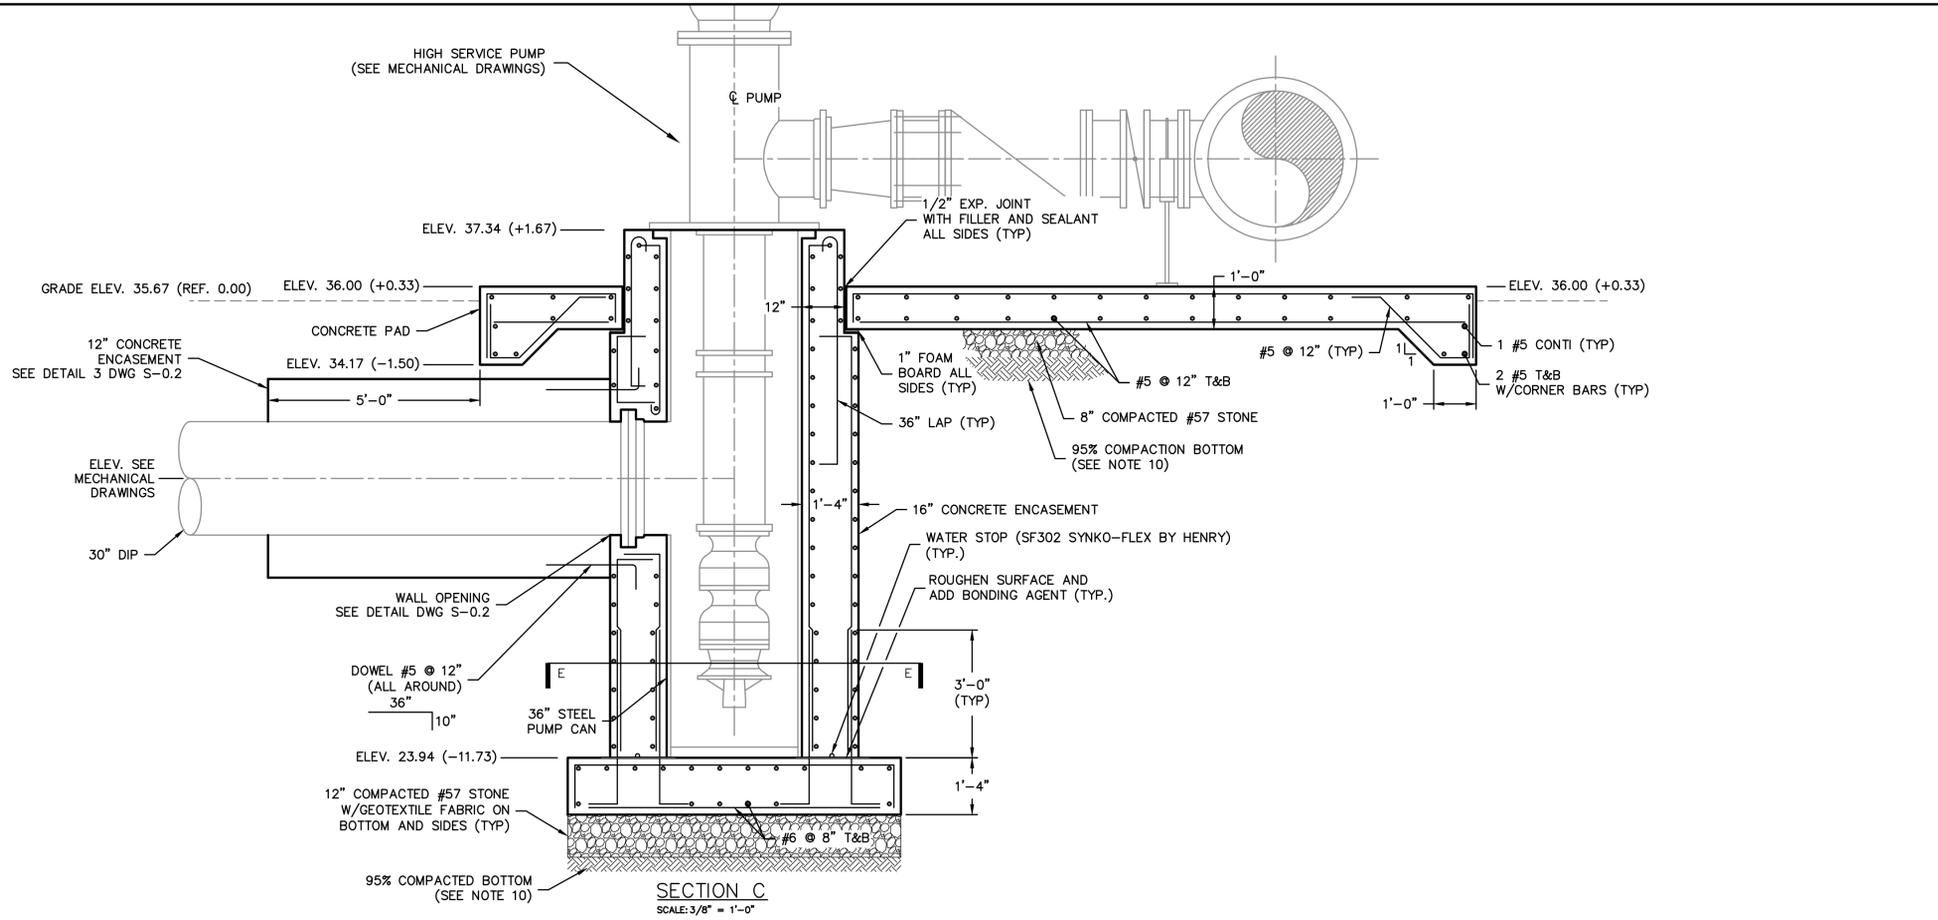
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MANATEE COUNTY, FLORIDA

SEWRF 10 MG STORAGE TANK AND INTERCONNECTION

HIGH SERVICE PUMP STATION PLAN AND SECTION

DATE: APRIL 2014	SCALE:	DRAWING NUMBER:
MCE PROJ. # 1024-0160	HORIZONTAL: AS SHOWN	S-2.1
DRAWN: BFN	VERTICAL: NA	
DESIGNED: HAH		
CHECKED: JSL		
PROJ. MGR. MSL		
STATUS: ISSUE FOR BID		



- NOTES:**
1. SEE CIVIL DRAWINGS FOR GRADE ELEVATIONS.
 2. ALLOWABLE SOIL BEARING 1500 PSF.
 3. DESIGN LIVE LOAD 250 PSF.
 4. COORDINATE WITH MECHANICAL DRAWINGS FOR FINAL PUMP SIZE, LOCATION AND ELEVATION.
 5. COORDINATE WITH MECHANICAL DRAWINGS FOR PIPE SUPPORTS.
 6. DEWATERING IS REQUIRED DURING EXCAVATION. SEE GEOTECHNICAL REPORT.
 7. CONTRACTOR SHALL VERIFY PUMP ELEVATIONS WITH PUMP MANUFACTURER.
 8. MATERIAL EXCAVATED DURING CONSTRUCTION OF PUMP SHAFTS CAN BE USED FOR BACKFILL AFTER APPROVAL OF GEOTECHNICAL ENGINEER. ALL EXCESS MATERIAL SHALL BE REMOVED FROM SITE.
 9. SEE DRIGGERS ENGINEERING GEOTECHNICAL REPORT FOR BACKFILL INSTRUCTIONS.
 10. REFERENCE PROJECT GEOTECH REPORT FOR SUBGRADE PREPARATION & COMPACTED FILL REQUIREMENTS.

REV. NO.	DESCRIPTIONS	DATE

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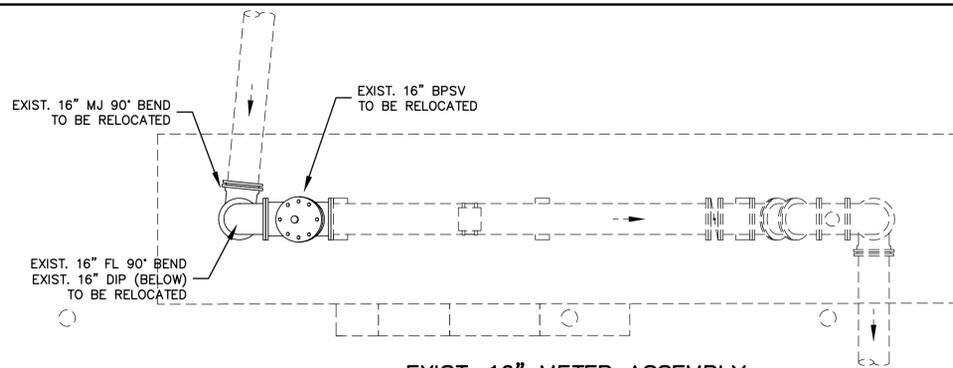
MANATEE COUNTY, FLORIDA

SEWRF 10 MG STORAGE TANK AND INTERCONNECTION

HIGH SERVICE PUMP STATION SECTIONS


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MCE PROJ. # 1024-0160	HORIZONTAL: NA	
DRAWN: BFN	VERTICAL: NA	
DESIGNED: HAH		
CHECKED: JSL		
PROJ. MGR: MSL		
STATUS: ISSUE FOR BID		

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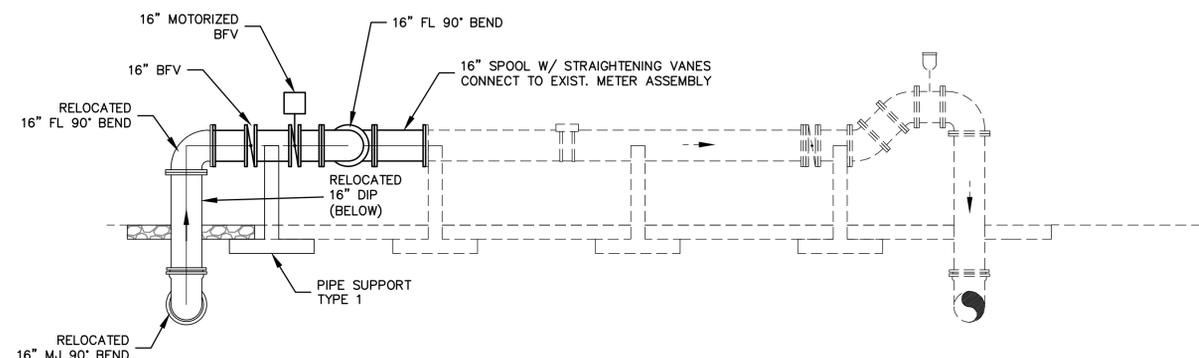
**EXIST. 16" METER ASSEMBLY
(SOUTH POND 1)**

SCALE: 1/4" = 1'-0"




**EXIST. 16" METER ASSEMBLY
MODIFICATION PLAN
(SOUTH POND 1)**

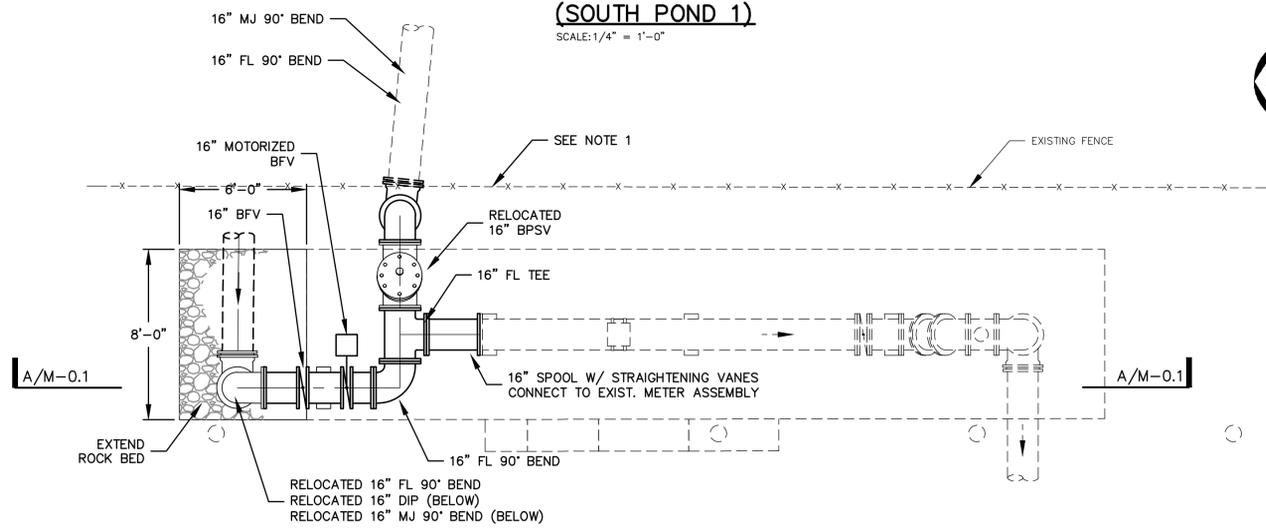SCALE: 1/4" = 1'-0"




SECTION A/M-0.1

SCALE: 1/4" = 1'-0"

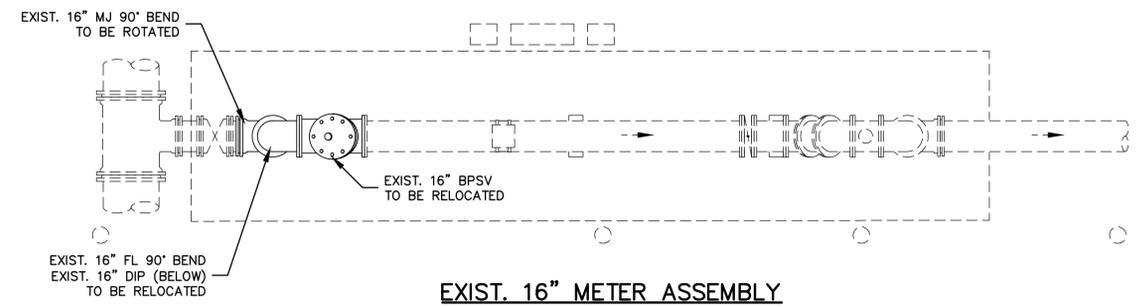


**EXIST. 16" METER ASSEMBLY
(EAST POND)**

SCALE: 1/4" = 1'-0"

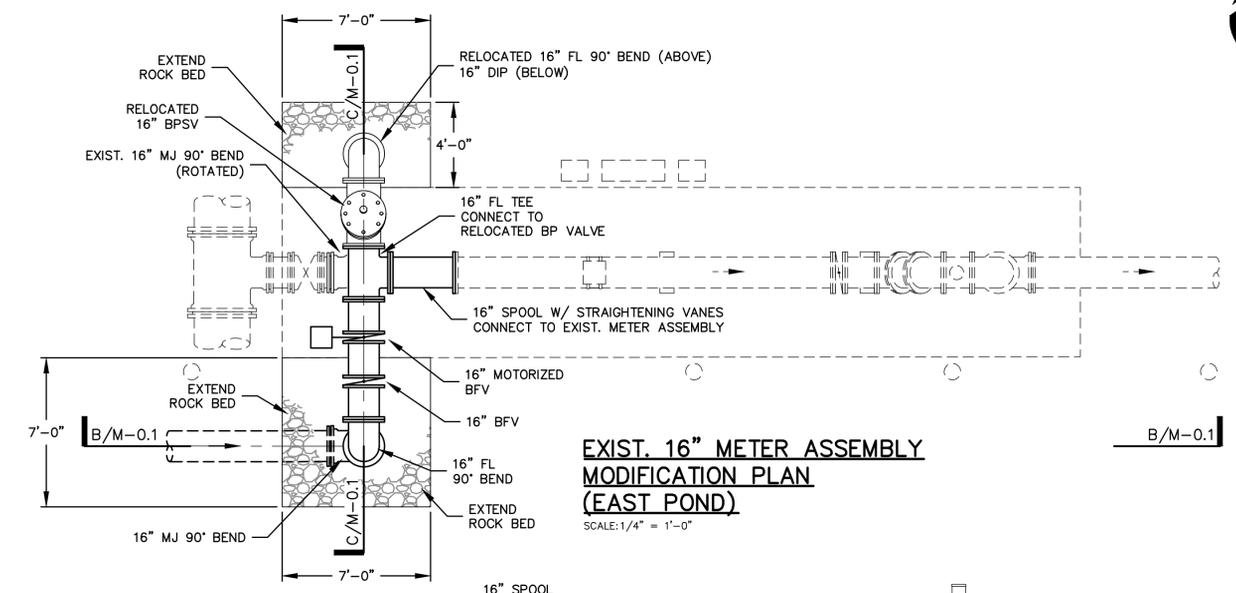


**EXIST. 16" METER ASSEMBLY
MODIFICATION PLAN
(EAST POND)**

SCALE: 1/4" = 1'-0"

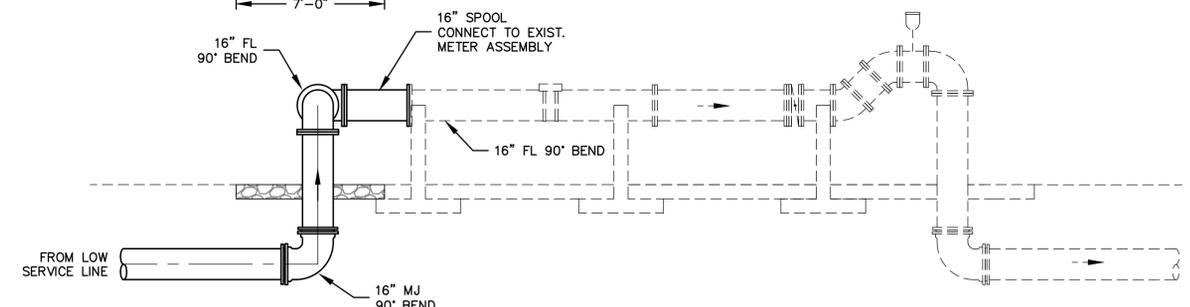

SECTION B/M-0.1

SCALE: 1/4" = 1'-0"

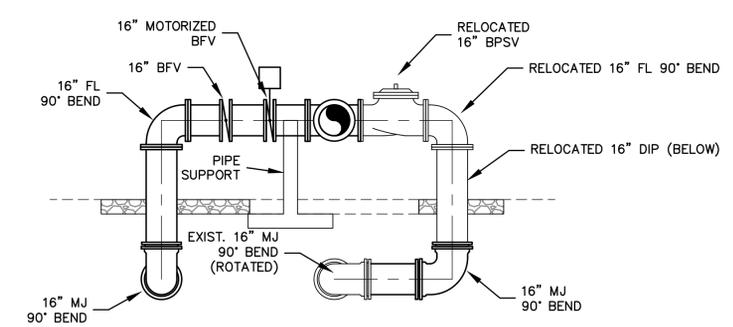

SECTION C/M-0.1

SCALE: 1/4" = 1'-0"

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No. 66118

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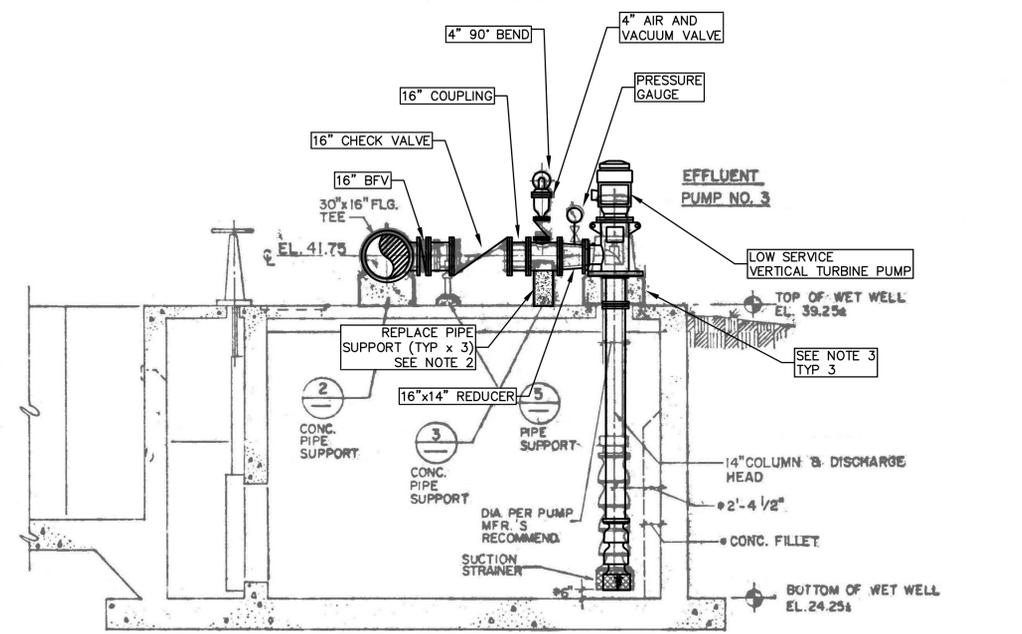
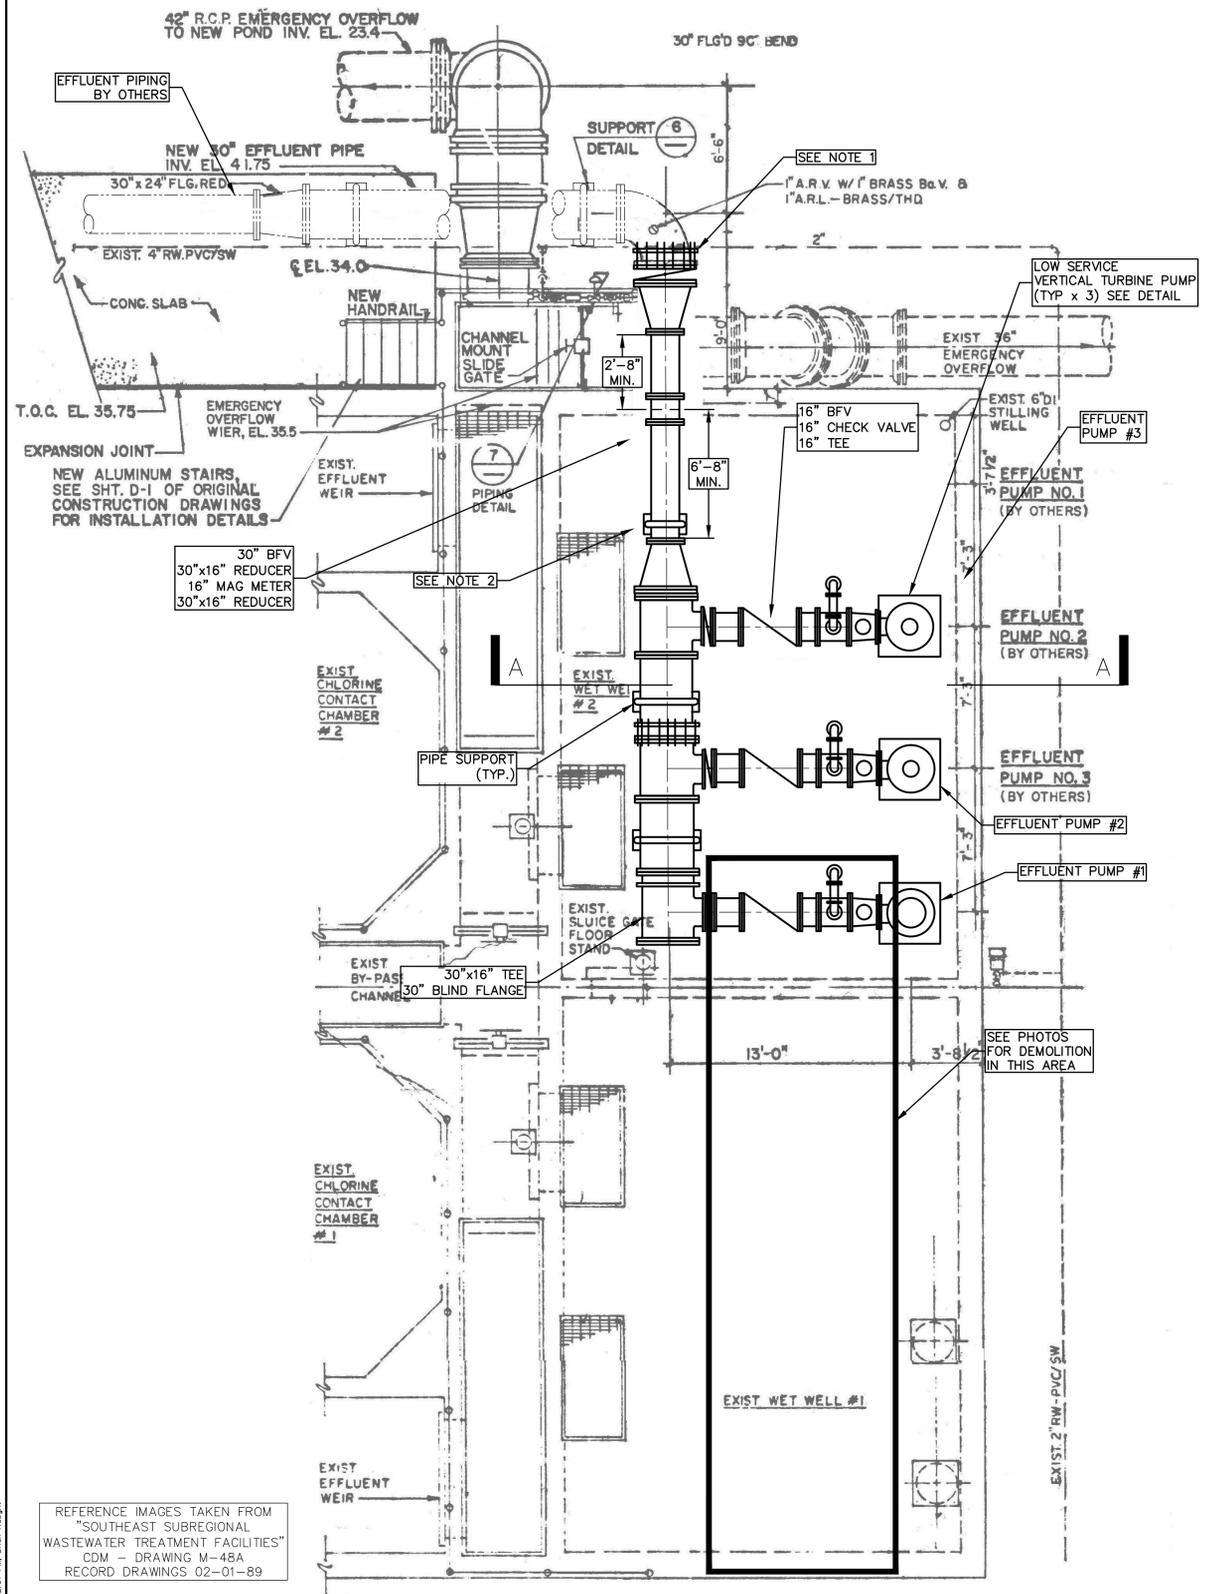
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SEWRF 10 MG STORAGE TANK
AND INTERCONNECTION

EXIST. 16" METER ASSEMBLY
MODIFICATIONS 1 OF 2

DATE: APRIL 2014	SCALE: HORIZONTAL: 1/4" = 1'-0"	DRAWING NUMBER: M-0.1
MCE PROJ. # 1024-0160	VERTICAL: NA	REVISION
DRAWN: MSL		
DESIGNED: MSL		
CHECKED: JSL		
PROJ. MGR: MSL		
STATUS: ISSUE FOR BID		



NOTE:
PUMP AND PIPING LAY-OUT FOR EFFLUENT PUMP NO. 3
IS TYPICAL FOR EFFLUENT PUMPS NO.'S 1 & 2

* AS PER MFR.'S EQUIPMENT

LOW SERVICE VERTICAL
TURBINE PUMP DETAIL (TYP 3)
SCALE: NTS

- NOTES:
- CONTRACTOR SHALL REMOVE STEEL DISCHARGE HEADER UP TO THE 90° BEND AND INSTALL A FLANGED ADAPTER TO CONNECT TO NEW DUCTILE IRON PIPE.
 - CONTRACTOR SHALL REMOVE CONCRETE PIPE SUPPORTS FOR THE DISCHARGE HEADER TO THE FINISHED FLOOR. CONTRACTOR SHALL SUPPLY 316 STAINLESS STEEL STANCHION TYPE PIPE SUPPORTS BEING SPACED NO FURTHER THAN 10' APART ON CENTER OR AS SHOWN.
 - CONTRACTOR SHALL RESTORE AND MODIFY THE EXISTING PUMP SUPPORT PER PUMP MANUFACTURER'S RECOMMENDATIONS. 316 STAINLESS STEEL ANCHOR BOLTS (TYP.) SHALL BE PROVIDED, SIZED PER PUMP MANUFACTURER'S RECOMMENDATIONS.
 - CONTRACTOR SHALL REMOVE 12" PLANT WATER FEED TO 3 FEET BELOW GRADE AND CAP LINE.



PHOTO 1
SCALE: NTS



PHOTO 2
SCALE: NTS

LEGEND
 TO BE REMOVED

REFERENCE IMAGES TAKEN FROM
"SOUTHEAST SUBREGIONAL
WASTEWATER TREATMENT FACILITIES"
CDM - DRAWING M-48A
RECORD DRAWINGS 02-01-89

REVNO.	DESCRIPTIONS	DATE

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MATTHEW S. LOVE, P.E.
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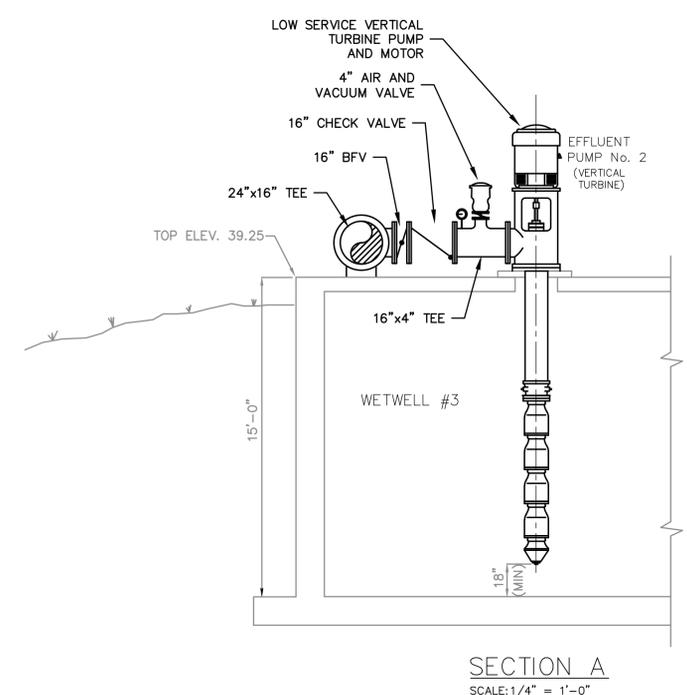
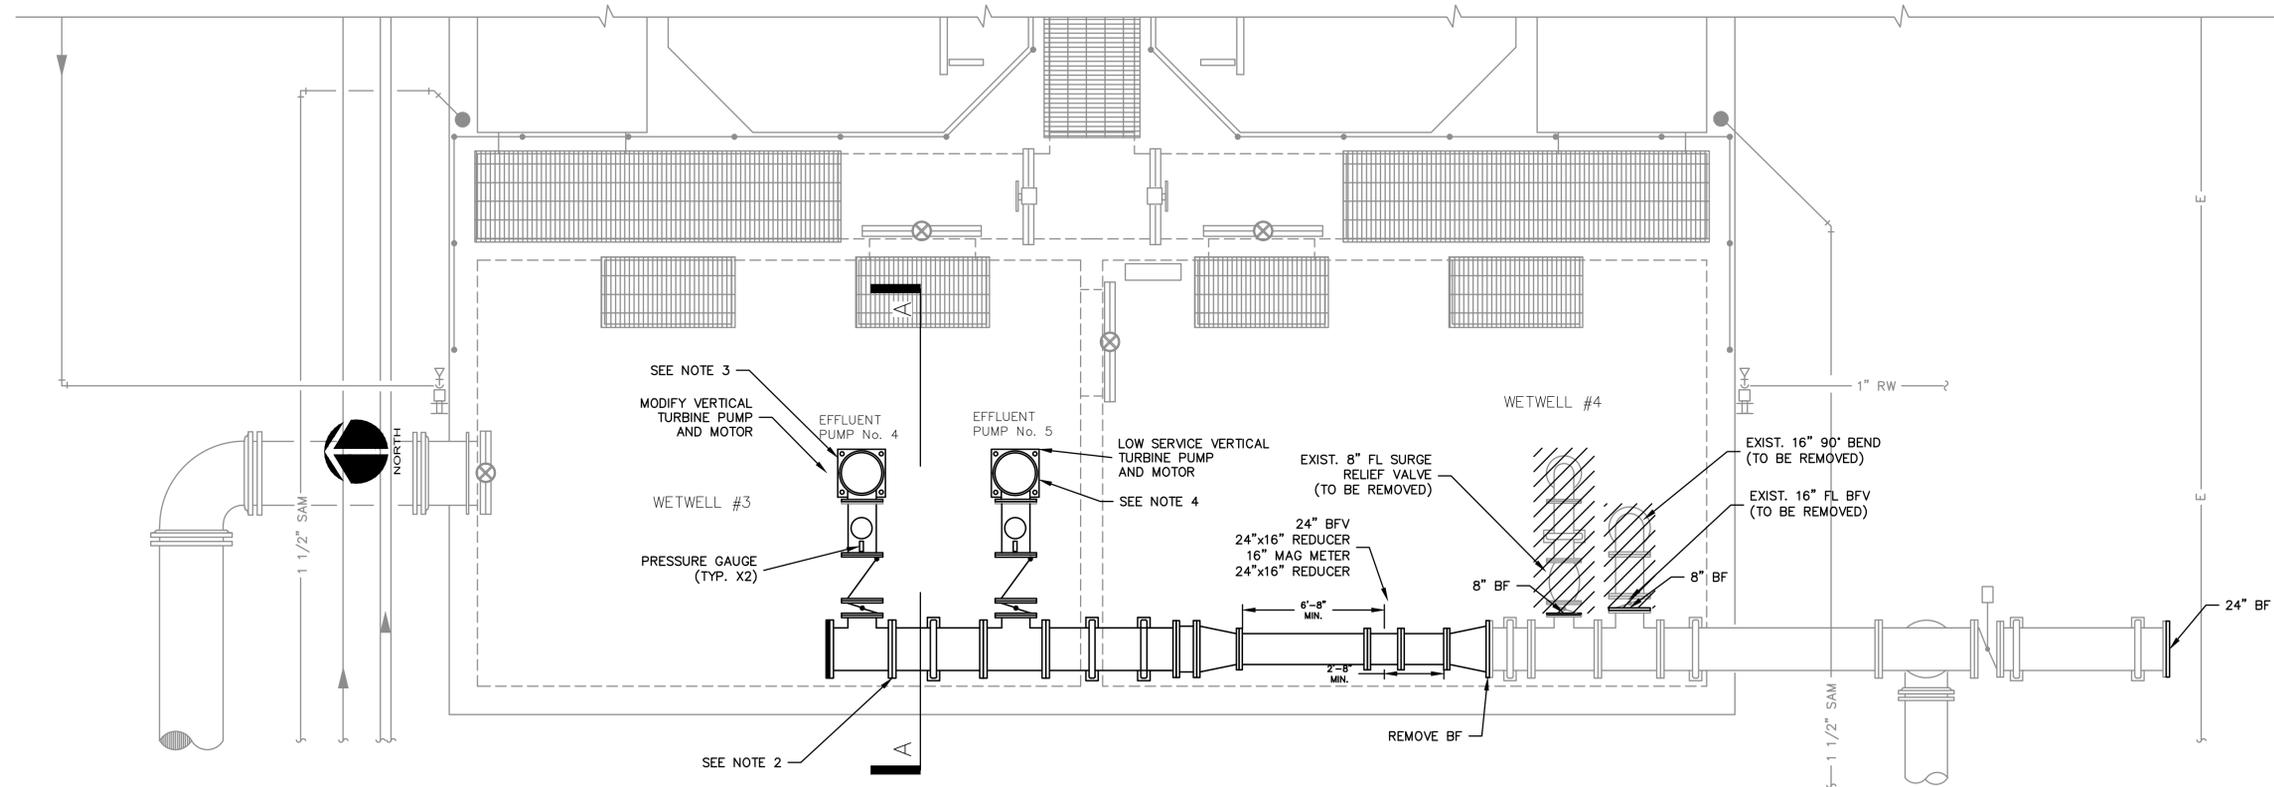
MANATEE COUNTY, FLORIDA

SEWRF 10 MG STORAGE TANK
AND INTERCONNECTION

LOW SERVICE PUMP STATION NO. 1
PLAN, SECTIONS AND DETAILS

DATE: APRIL 2014	SCALE: HORIZONTAL: NA	DRAWING NUMBER: M-2.1
MCE PROJ. # 1024-0160	DESIGNED: MSL	CHECKED: MSL
PROJ. MGR. MSL	CHECKED: MSL	STATUS: ISSUE FOR BID

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- NOTES:
- CONTRACTOR SHALL REMOVE DISCHARGE HEADER IN IT'S ENTIRETY.
 - CONTRACTOR SHALL REMOVE CONCRETE PIPE SUPPORTS FOR THE DISCHARGE HEADER TO THE FINISHED FLOOR. CONTRACTOR SHALL SUPPLY 316 STAINLESS STEEL STANCHION TYPE PIPE SUPPORTS BEING SPACED NO FURTHER THAN 10' APART ON CENTER OR AS SHOWN.
 - CONTRACTOR SHALL RESTORE AND MODIFY THE EXISTING PUMP SUPPORT PER PUMP MANUFACTURER'S RECOMMENDATIONS. 316 STAINLESS STEEL ANCHOR BOLTS (TYP.) SHALL BE PROVIDED, SIZED PER PUMP MANUFACTURER'S RECOMMENDATIONS.
 - CONTRACTOR SHALL CORE DRILL THE EXISTING TOP SLAB FOR PUMP INSTALLATION PER THE PUMP MANUFACTURER'S RECOMMENDATIONS. CONTRACTOR SHALL PROVIDE PUMP SUPPORTS PER PUMP MANUFACTURER'S RECOMMENDATIONS WITH A MINIMUM OF 23" LONG #5 REBAR DOWELS INTO EXISTING CONCRETE SLAB WITH EPOXY, 316 STAINLESS ANCHOR BOLTS (TYP.) SHALL BE PROVIDED, SIZED PER PUMP MANUFACTURER'S RECOMMENDATIONS.
 - CONTRACTOR SHALL SUPPLY CHECKERED ALUMINUM PLATING COVERS ANCHORED WITH 316 STAINLESS STEEL BOLTS OVER EXISTING CORE HOLES NOT BEING REUSED FOR REMOVING PUMPS

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REV. NO.	DESCRIPTIONS	DATE

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SEWRF 10 MG STORAGE TANK
AND INTERCONNECTION



LOW SERVICE PUMP STATION NO. 2
PLAN AND SECTION

DATE:	APRIL 2014
MCE PROJ. #	1024-0160
DRAWN	BFN
DESIGNED	MSL
CHECKED	MSL
PROJ. MGR.	MSL

SCALE	DRAWING NUMBER
HORIZONTAL: 1/4" = 1'-0"	M-2.2
VERTICAL: NA	
STATUS:	REVISION
ISSUE FOR BID	



FROM PROPOSED GST

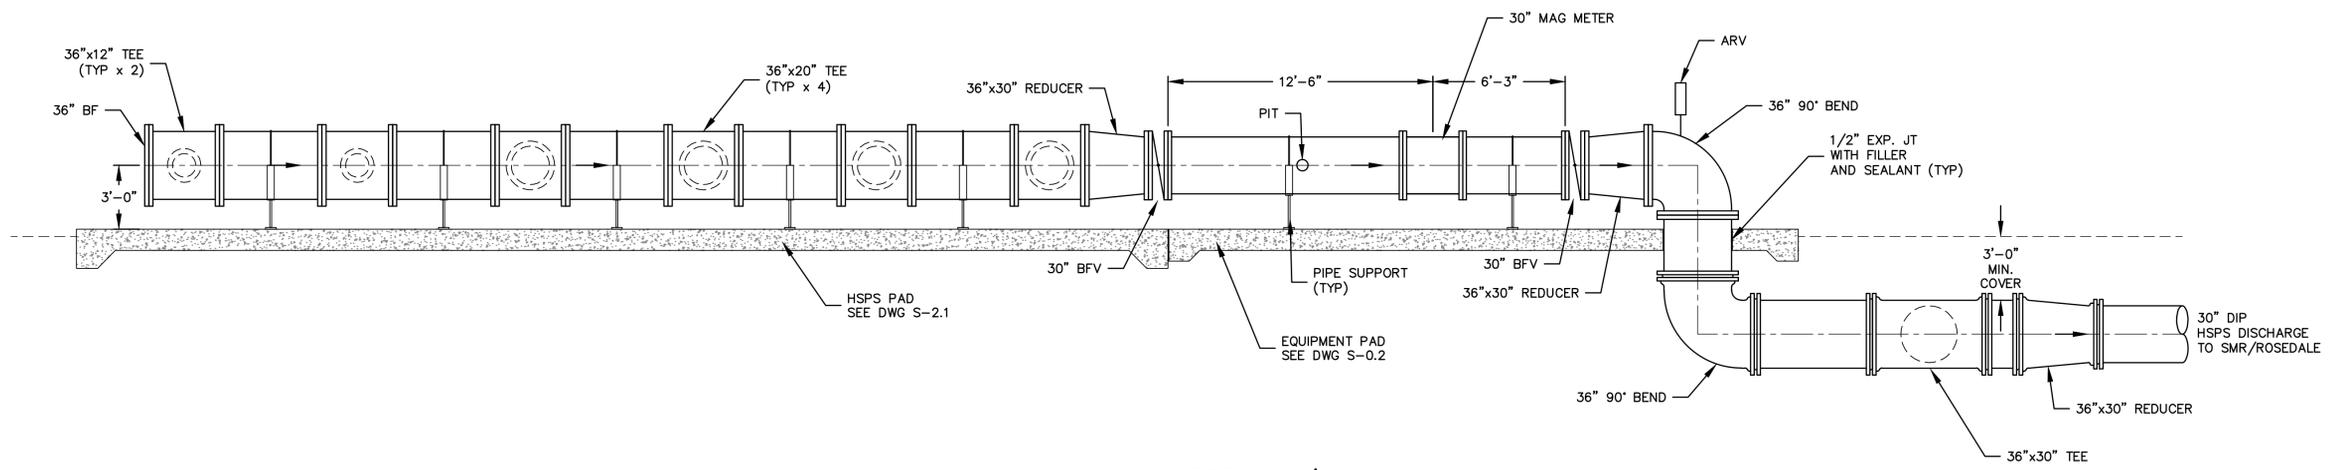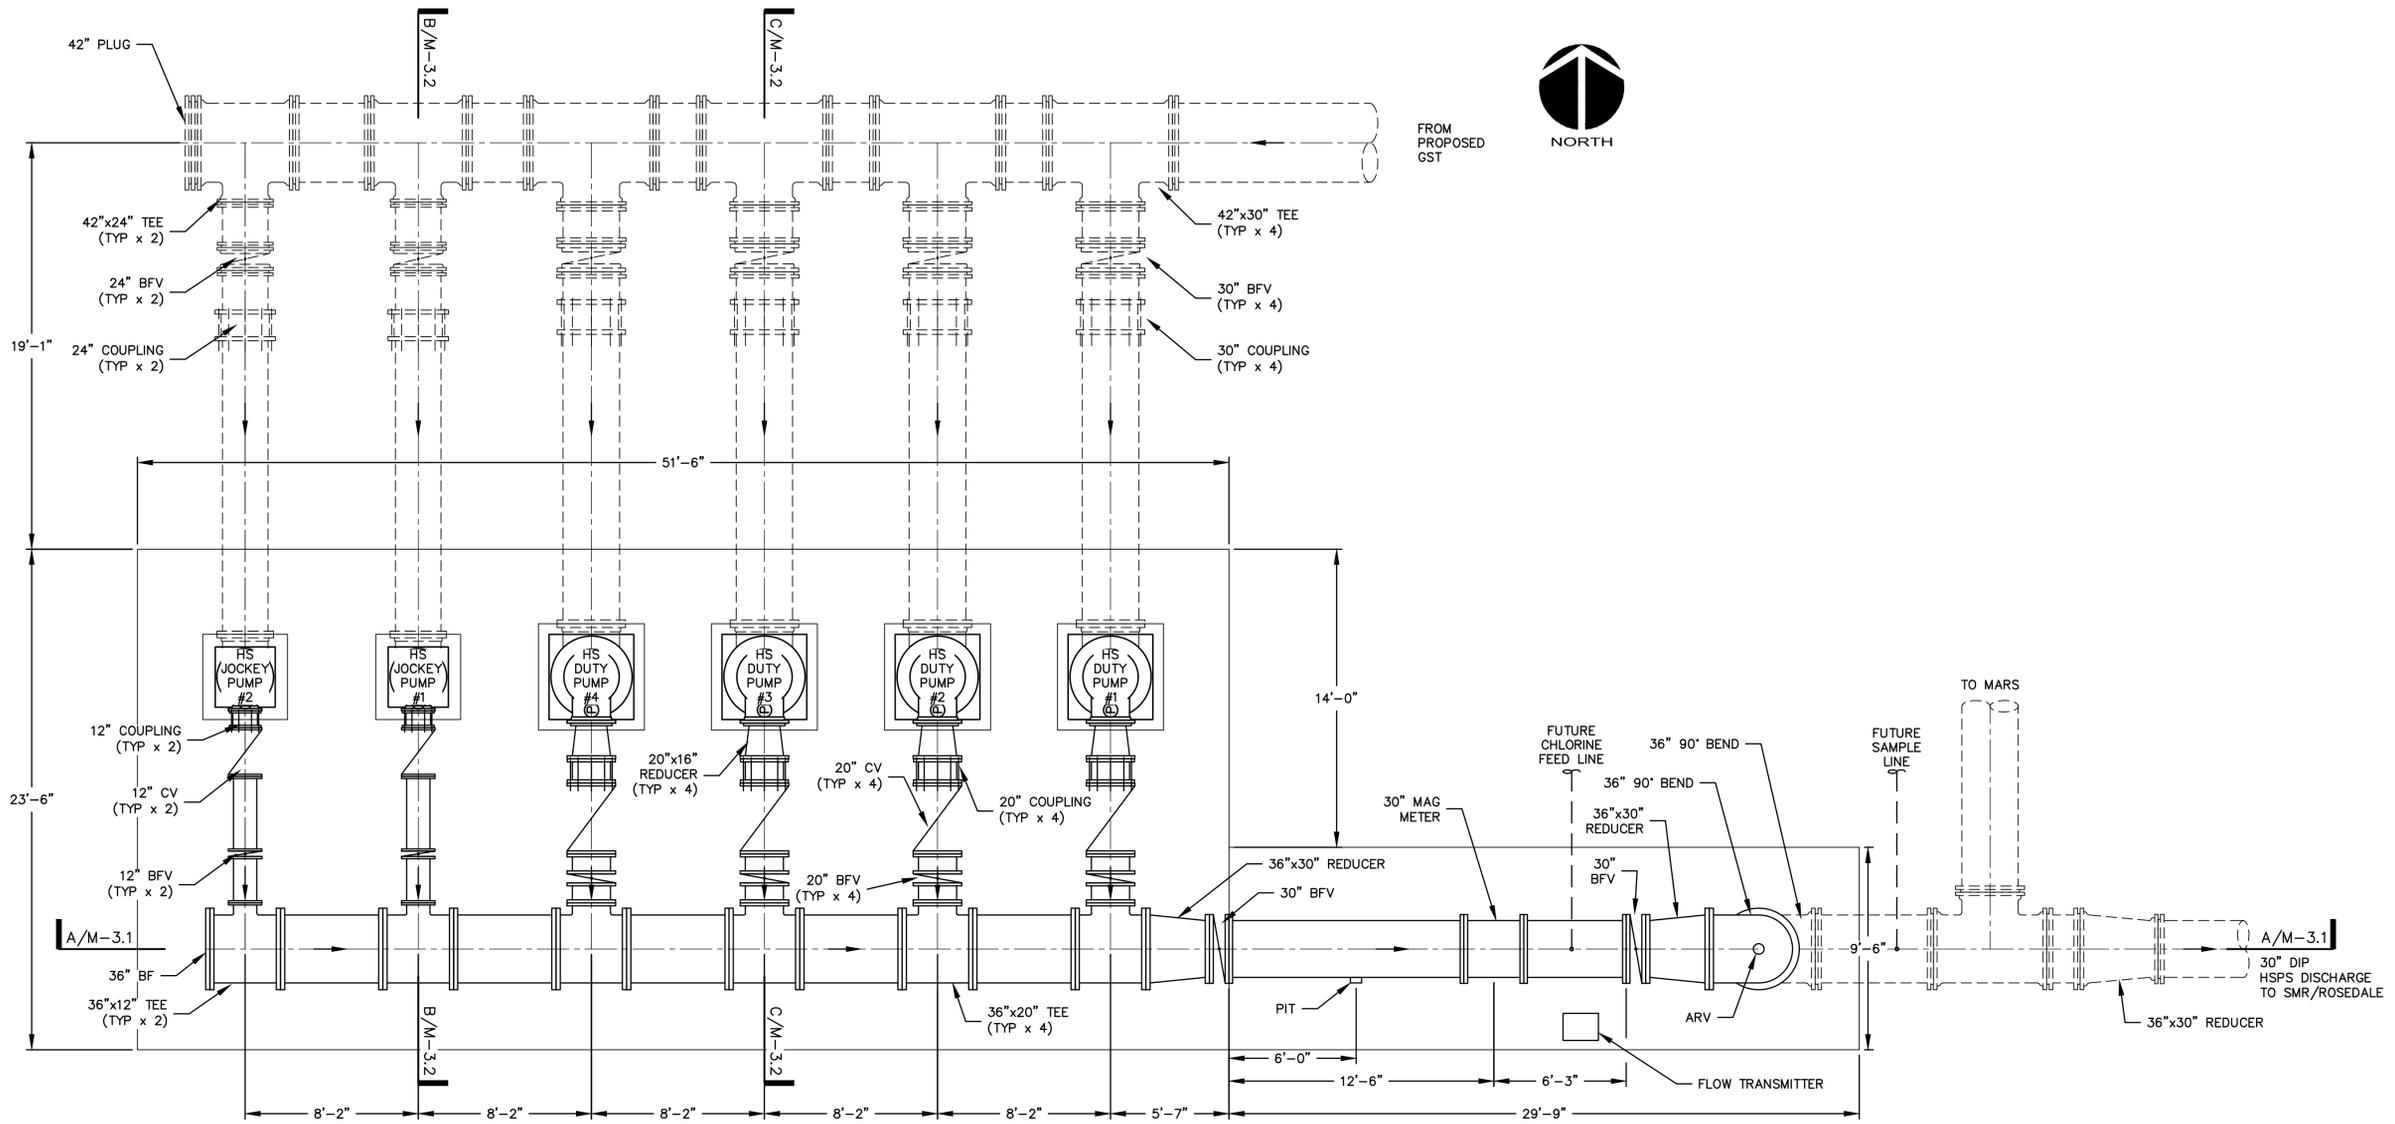

SECTION A/M-3.1
SCALE: X" = 1'-0"

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REV. NO.	DESCRIPTIONS	DATE

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No. 66118

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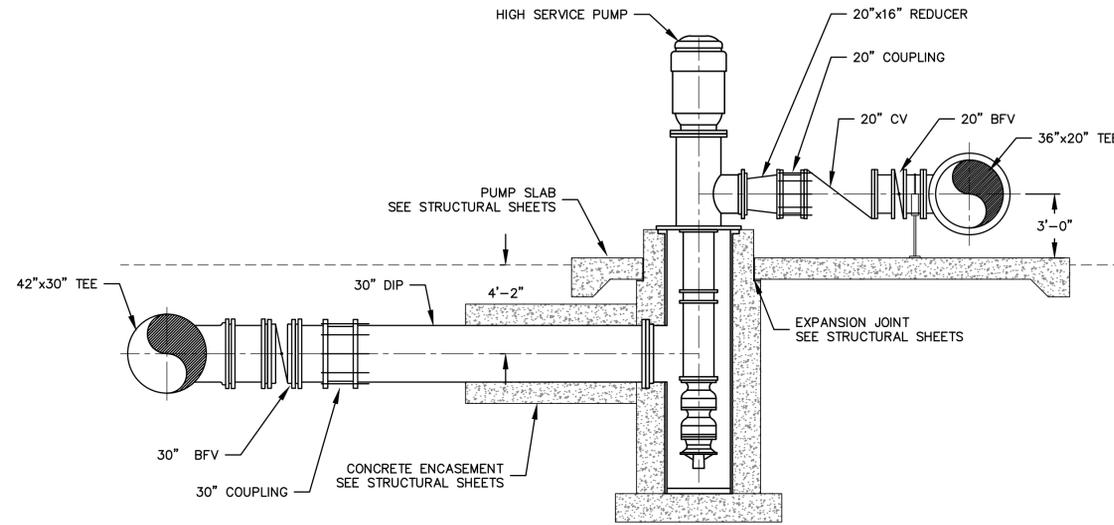
SEWRF 10 MG STORAGE TANK AND INTERCONNECTION

HIGH SERVICE PUMP STATION PLAN AND SECTION

DATE:	APRIL 2014
MCE PROJ. #	1024-0160
DRAWN	BFN
DESIGNED	MSL
CHECKED	MSL
PROJ. MGR.	MSL
STATUS:	


SCALE:	DRAWING NUMBER:
HORIZONTAL: 1/4" = 1'-0"	M-3.1
VERTICAL: NA	REVISION:

ISSUE FOR BID



SECTION B/M-3.1

SCALE: X" = 1'-0"

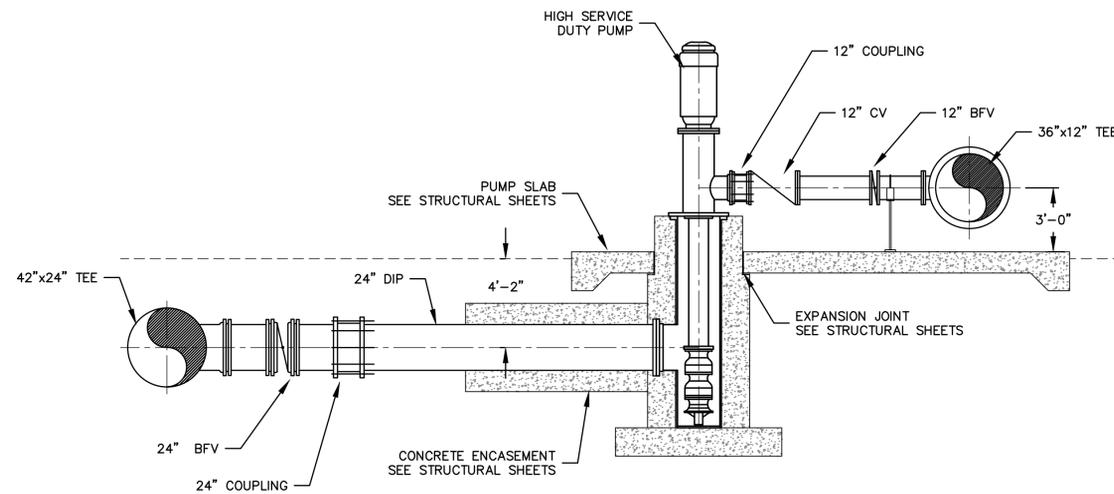

SECTION C/M-3.1

SCALE: X" = 1'-0"

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REV. NO.	DESCRIPTIONS	DATE

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No. 66118

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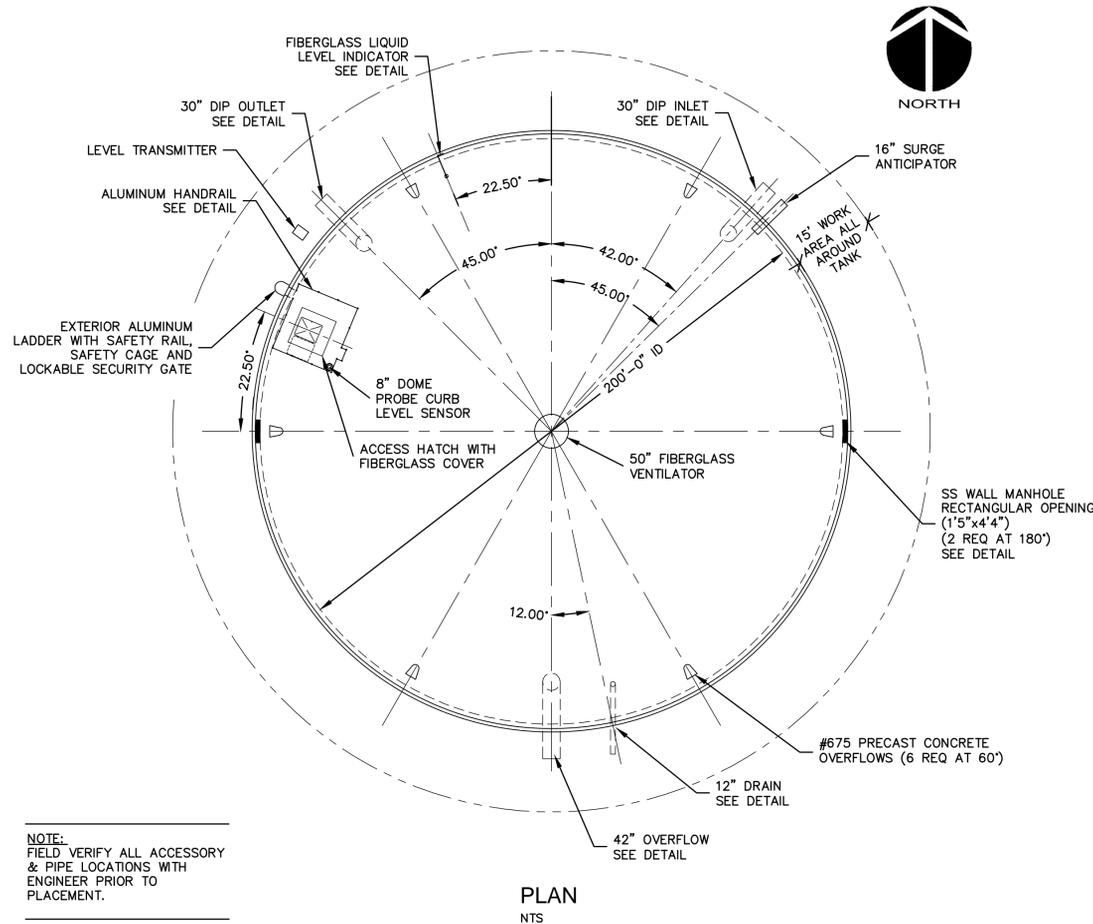
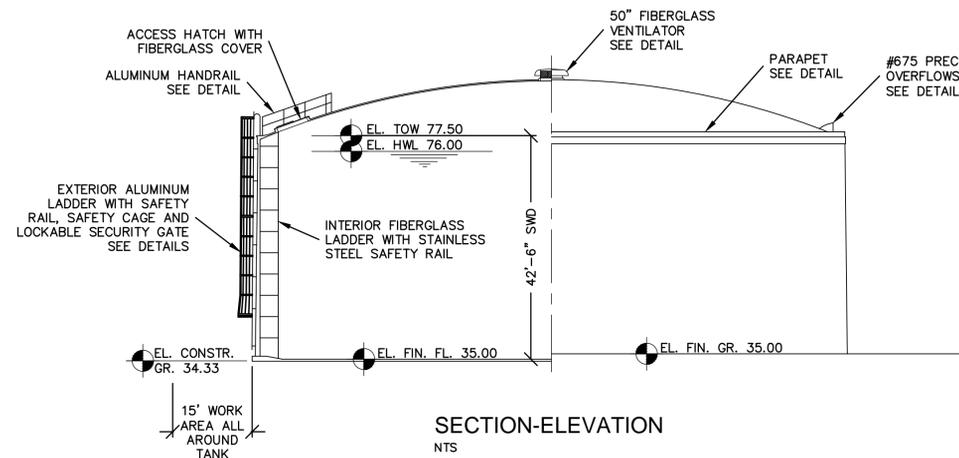
MANATEE COUNTY, FLORIDA



SEWRF 10 MG STORAGE TANK AND INTERCONNECTION



HIGH SERVICE PUMP STATION SECTIONS

DATE: APRIL 2014	SCALE: HORIZONTAL: 1/4" = 1'-0"	DRAWING NUMBER: M-3.2
MCE PROJ. # 1024-0160	VERTICAL: NA	
DRAWN: BFN		
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PROJ. MGR: MSL		
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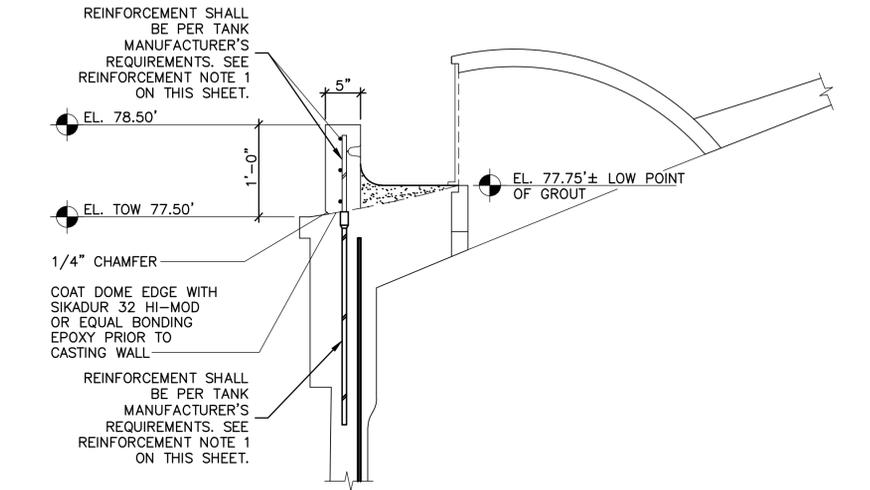


NOTE:
FIELD VERIFY ALL ACCESSORY
& PIPE LOCATIONS WITH
ENGINEER PRIOR TO
PLACEMENT.


- NOTES:
- SHOTCRETE SHALL BE APPLIED BY OR UNDER DIRECT SUPERVISION OF NOZZLEMEN CERTIFIED BY THE AMERICAN CONCRETE INSTITUTE AS OUTLINED IN ACI CERTIFICATION PUBLICATION CP-60.
 - TENSION IN PRESTRESSING WIRE SHALL BE MEASURED BY AN ELECTRONIC DIRECT-READING STRESSMETER ACCURATE TO WITHIN 2%.

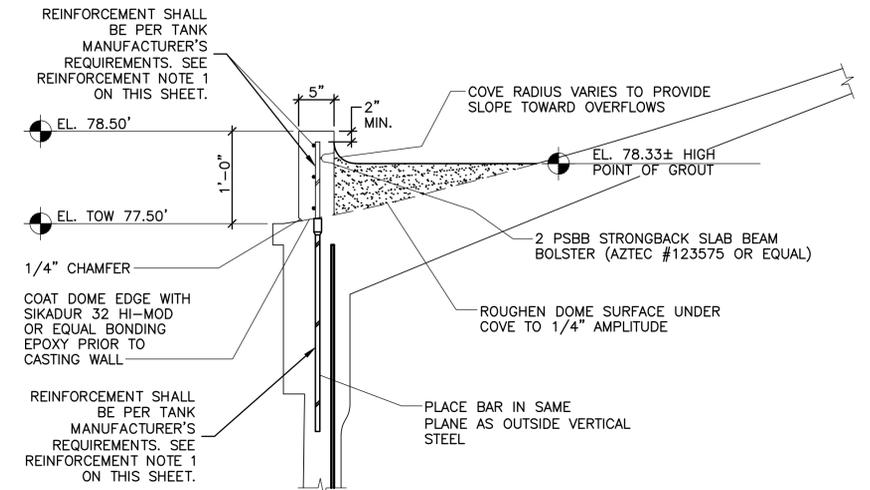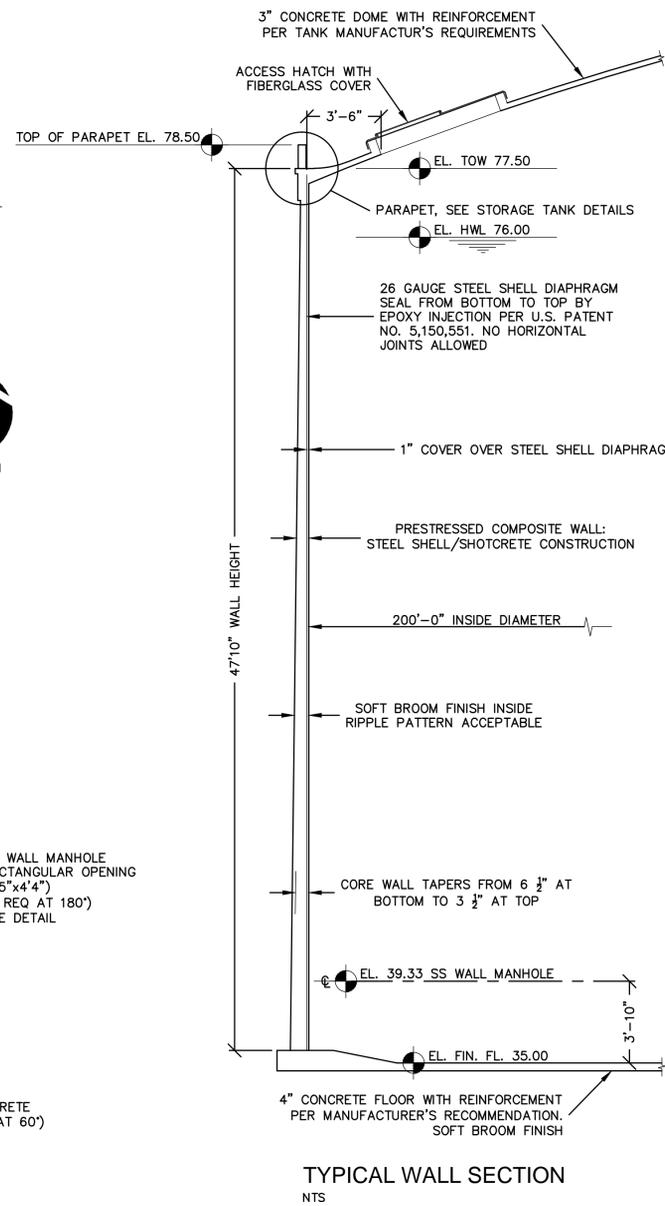

PARAPET WALL DETAIL
SCALE: 1" = 1'-0"





PARAPET WALL DETAIL W/OVERFLOW
SCALE: 1" = 1'-0"

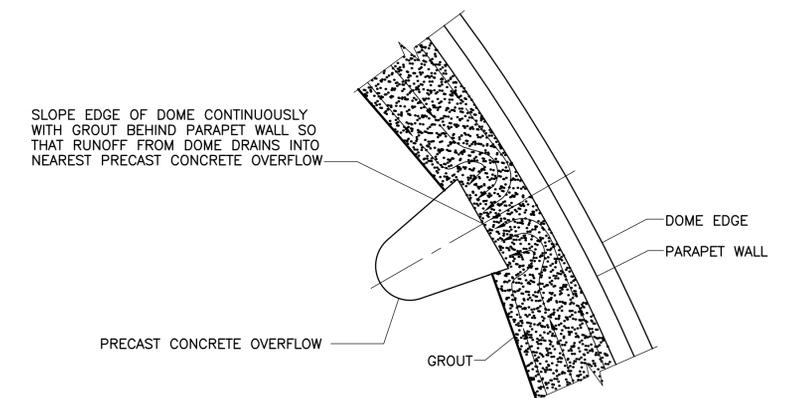

PARAPET WALL PLAN W/OVERFLOW
SCALE: NTS

REINFORCEMENT NOTE:
1. THE INFORMATION PROVIDED ON THIS DRAWING IS FOR BIDDING PURPOSES ONLY. THE TANK MANUFACTURER SHALL SUBMIT COMPLETE DESIGN ANALYSES, WORKING DRAWINGS AND DETAILS OF THE STRUCTURE SIGNED AND SEALED BY A REGISTERED FLORIDA PROFESSIONAL ENGINEER.

REV. NO.	DESCRIPTIONS	DATE

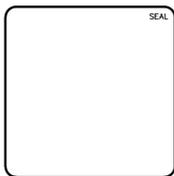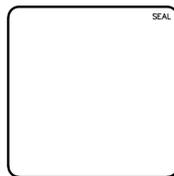


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MANATEE COUNTY, FLORIDA

SEWRF 10 MG STORAGE TANK AND INTERCONNECTION
PRESTRESSED CONCRETE TANK
DETAILS 1 OF 3


DATE: APRIL 2014	SCALE:	DRAWING NUMBER:
MCE PROJ. # 1024-0160	HORIZONTAL: NA	M-4.1
DRAWN: BFN	VERTICAL: NA	
DESIGNED: MSL		
CHECKED: MSL		
PROJ. MGR: MSL		
STATUS: ISSUE FOR BID		

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50" FIBERGLASS VENTILATOR

NTS

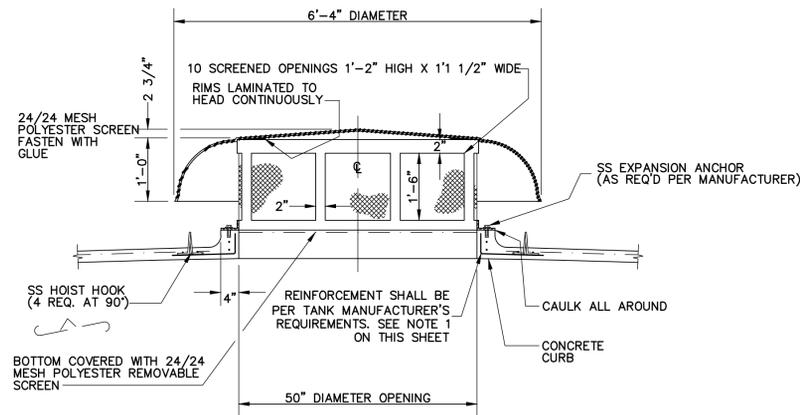


SECTION A/M-10.3

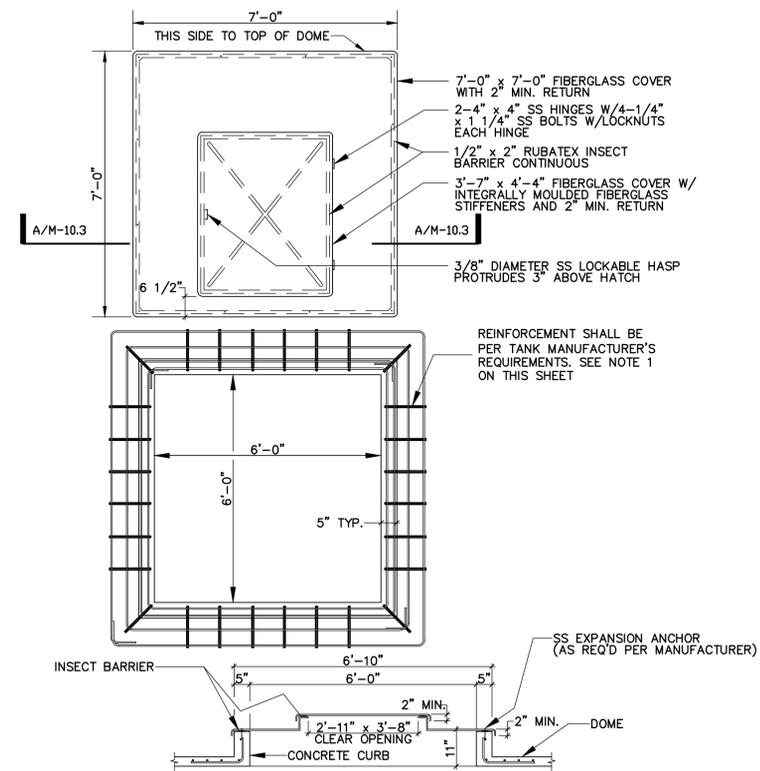NTS


FIBERGLASS HATCH COVER

NTS

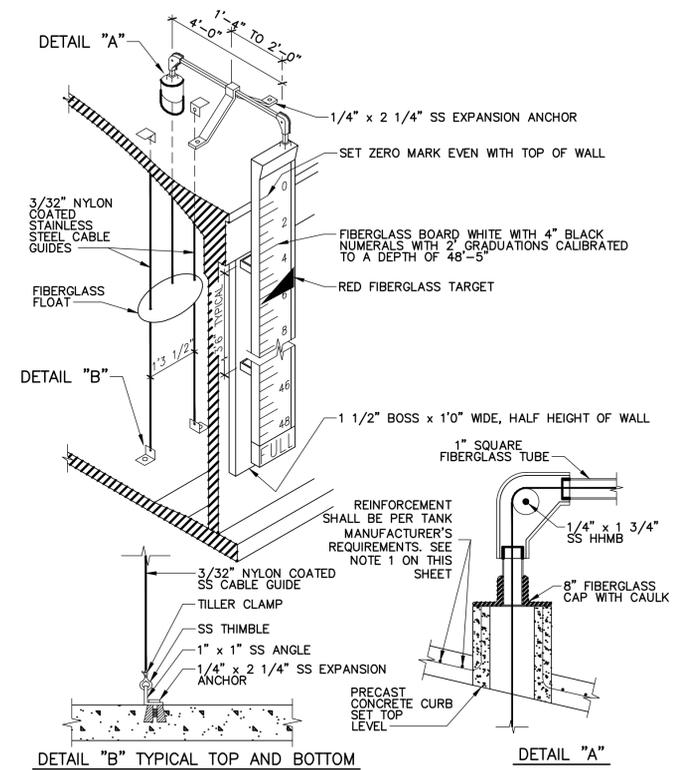


FIBERGLASS LIQUID LEVEL INDICATOR

NTS

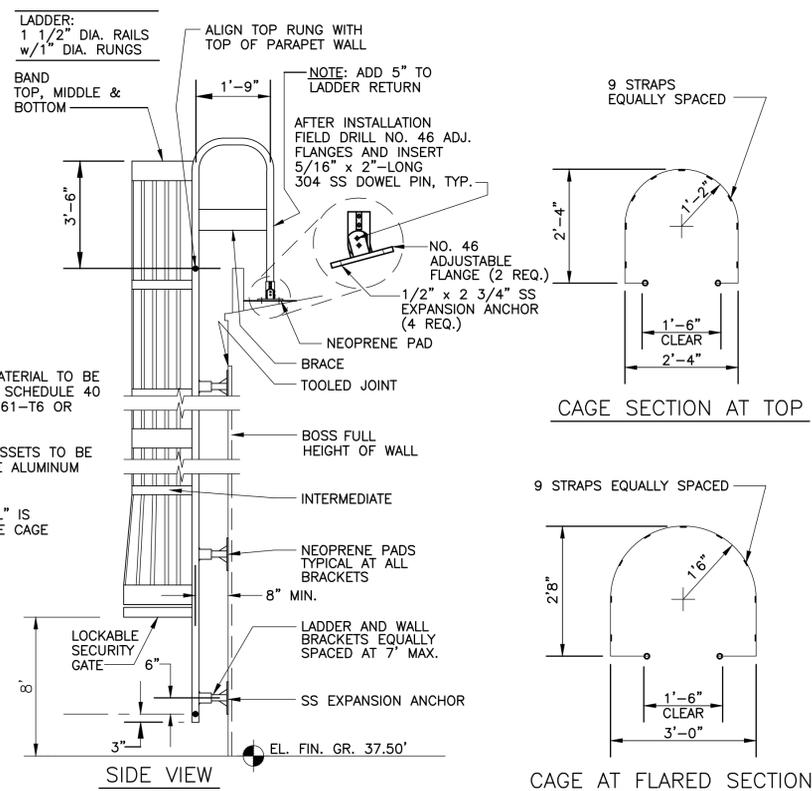


EXTERIOR ALUMINUM LADDER WITH SAFETY RAIL, SAFETY CAGE AND LOCKABLE SECURITY GATE

NTS

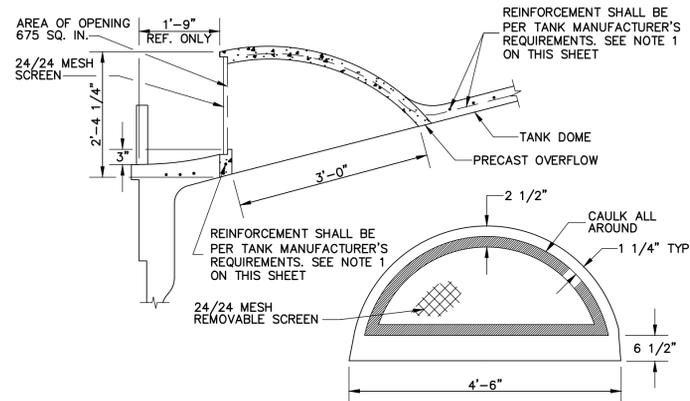

#675 PRECAST CONCRETE OVERFLOW (6 REQ.)

NTS

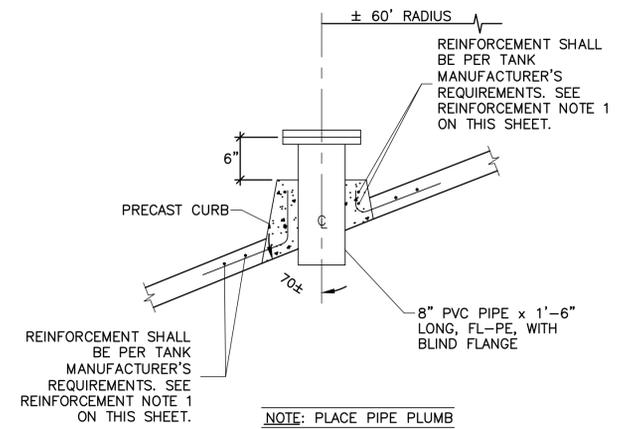

8" DOME PROBE CURB

SCALE: NTS

REINFORCEMENT NOTE:
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REV. NO.	DESCRIPTIONS	DATE

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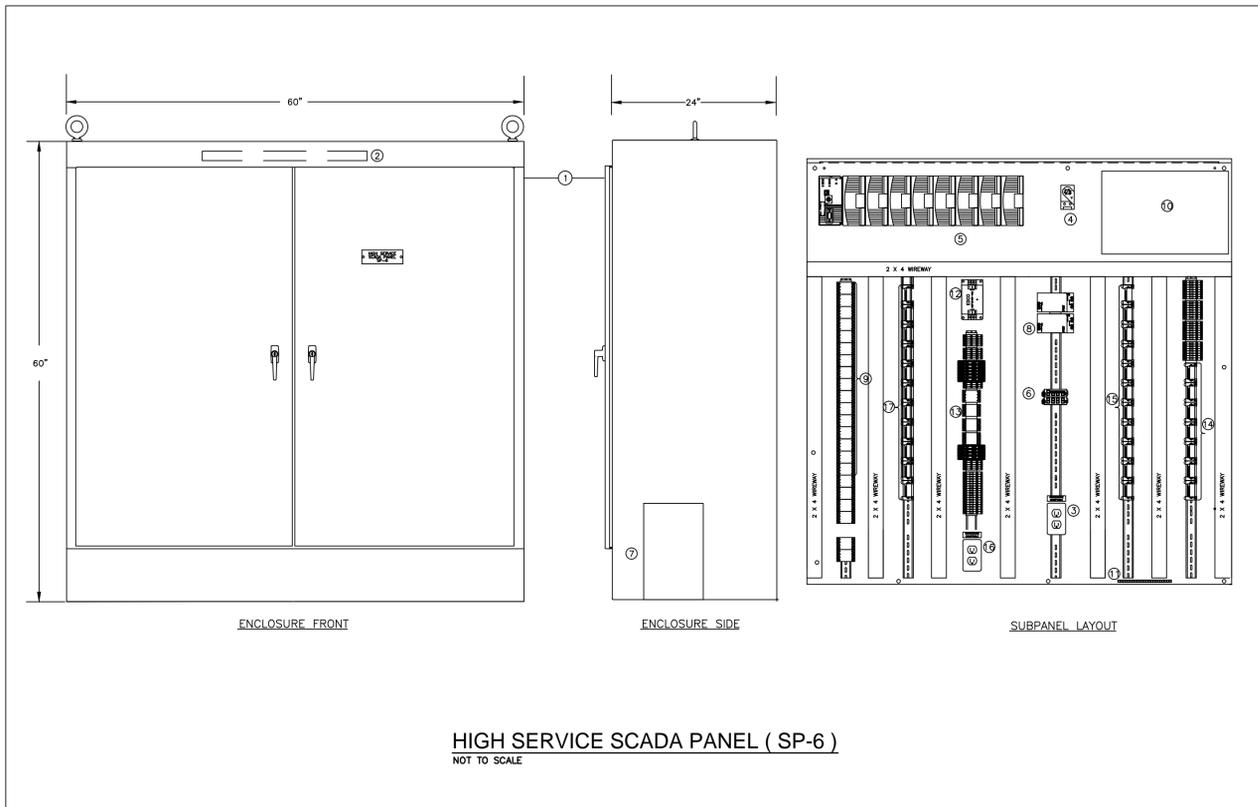
MANATEE COUNTY, FLORIDA

SEWRF 10 MG STORAGE TANK AND INTERCONNECTION

PRESTRESSED CONCRETE TANK

DETAILS 3 OF 3

DATE: APRIL 2014	SCALE: HORIZONTAL: NA	DRAWING NUMBER: M-4.3
MCE PROJ. # 1024-0160	VERTICAL: NA	
DRAWN: BFN		
DESIGNED: MSL		
CHECKED: MSL		
PROJ. MGR: MSL		
STATUS: ISSUE FOR BID		



NOTES:



1. ENCLOSURE, NEMA 12, 60"H x 60"W x 24"D
2. FLUORESCENT LIGHT
3. UPS CONVENIENCE RECEPTACLE
4. TEMPERATURE SWITCH
5. PLC HARDWARE
6. ETHERNET NETWORK SWITCHES(SCADA SWITCH, WITH EXPANSION MODULE AS REQUIRED.
7. UPS
8. POWER SUPPLY, REDUNDANT, 24VDC
9. DC CONTROL RELAYS
10. FIBER OPTIC TERMINATION PATCH PANEL
11. GROUND CONNECTOR
12. AC LINE SURGE SUPPRESSOR
13. AC CONTROL RELAYS
14. SIGNAL ISOLATOR, 120VAC, 4-20MA IN/OUT
15. ANALOG SURGE SUPPRESSORS
16. CONVENIENCE RECEPTACLE
17. DISCRETE SURGE SUPPRESSORS

MISC.NOTES:

1. SUBPANEL TO BE POWDER EPOXY COATED WHITE.
2. PROVIDE HOUSEKEEPING PATH

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REV.NO.	DESCRIPTIONS REVISIONS	DATE

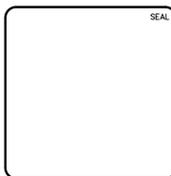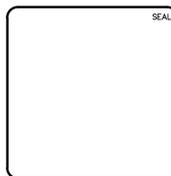


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 **MANATEE COUNTY, FLORIDA**

SEWRF 10 MG STORAGE TANK AND INTERCONNECTION

CONTROL PANEL DETAILS

DATE: APRIL 2014	SCALE	DRAWING NUMBER
MCE PROJ. # 1024-0160	HORIZONTAL:	I-0.4
DRAWN NMH	VERTICAL:	
DESIGNED NMH	NA	
CHECKED MSL		
PROJ. MGR. MSL		
STATUS: ISSUE FOR BID		REVISION

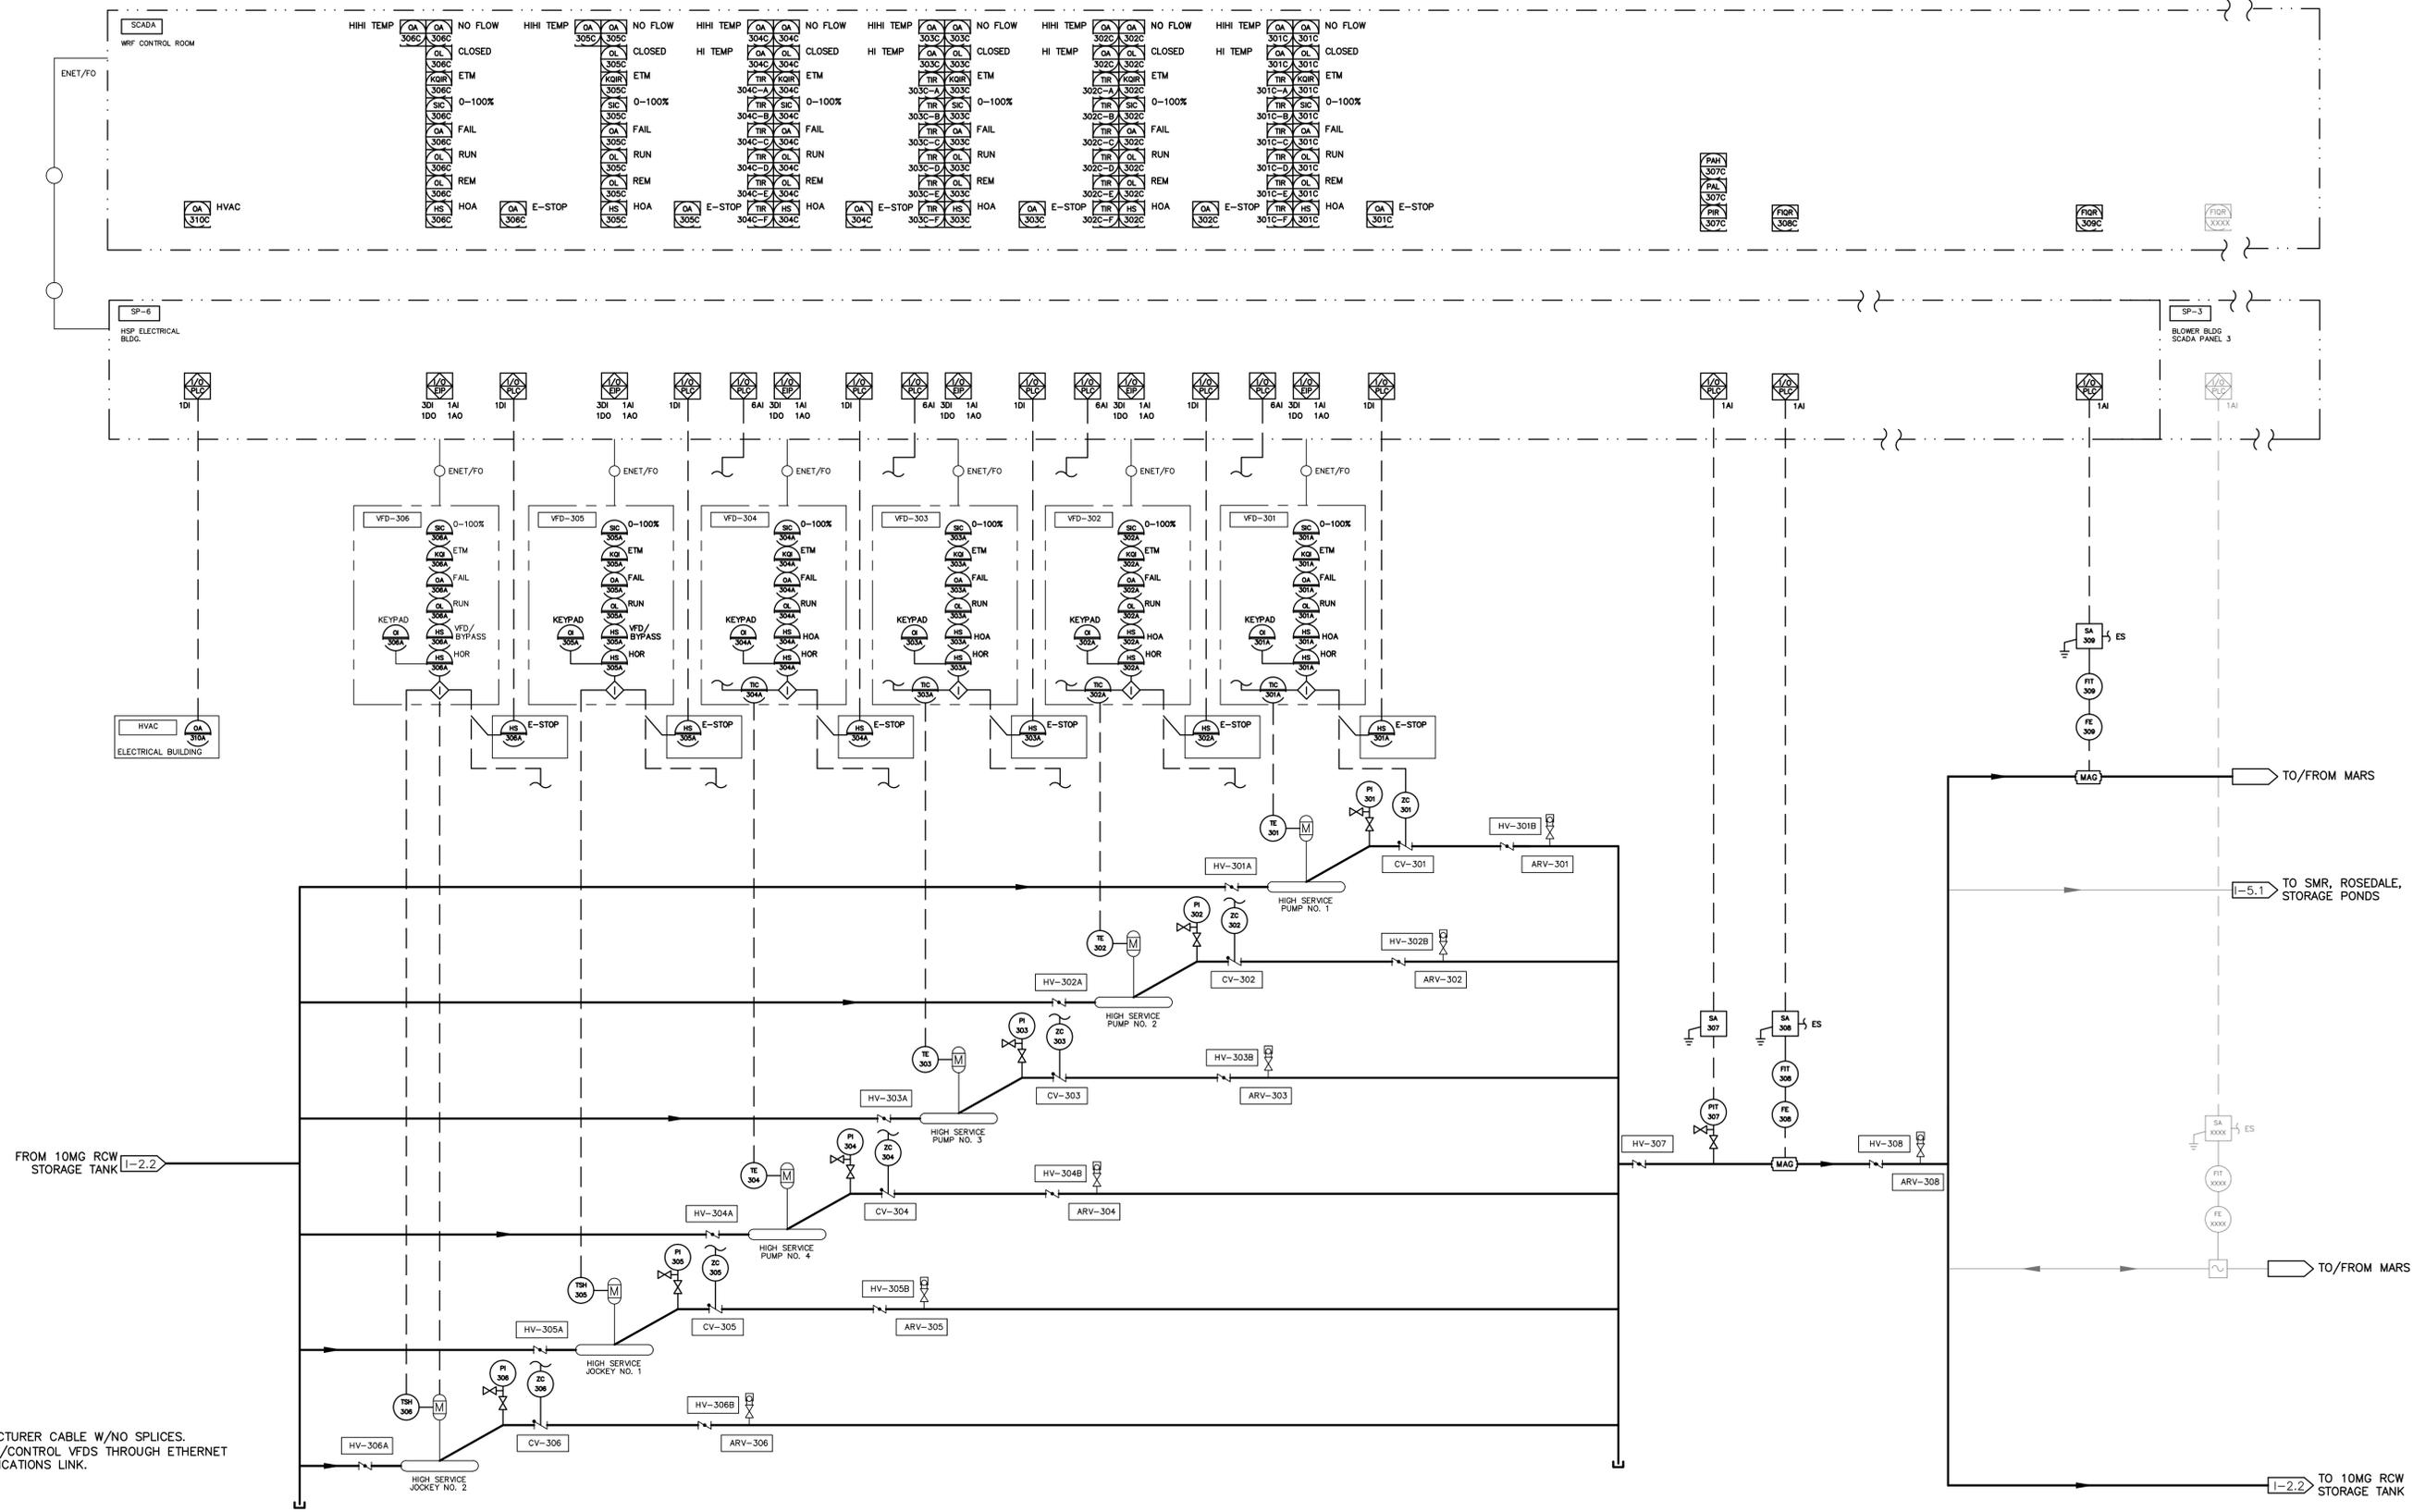

- NOTES:
 1. MANUFACTURER CABLE W/NO SPLICES.
 2. MONITOR/CONTROL VFDS THROUGH ETHERNET COMMUNICATIONS LINK.

S:\1024\10160\10160-0160\Drawings\Instrumentation\I-3.1-1024-0160.dwg, 4/29/2014, 4:35:58 PM, Brian Knight

REV. NO.	DESCRIPTIONS	DATE

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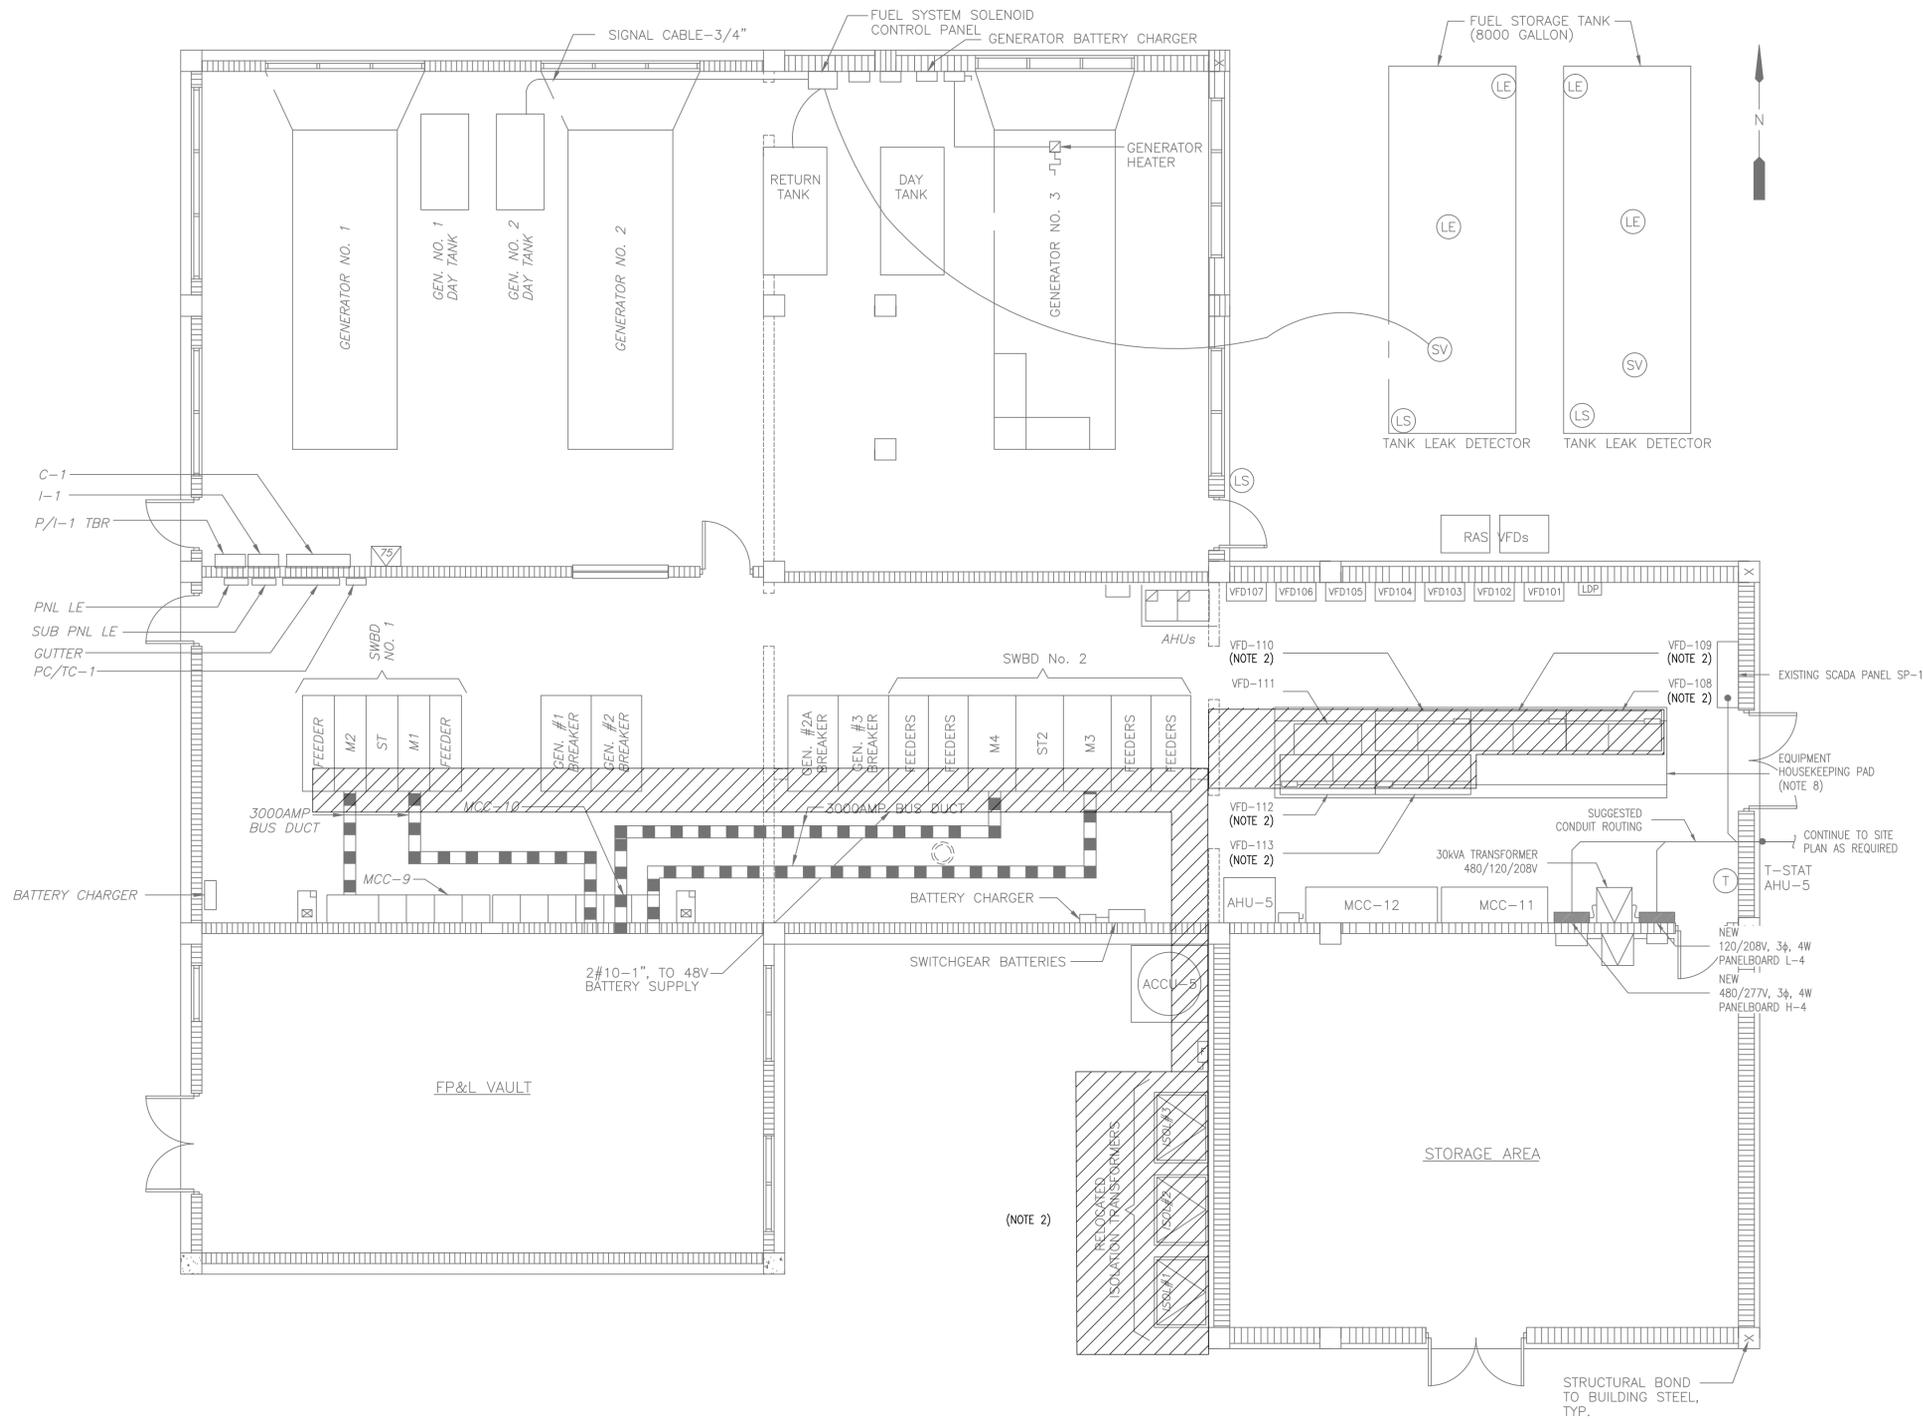
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MANATEE COUNTY, FLORIDA

SEWRF 10 MG STORAGE TANK AND INTERCONNECTION
HIGH SERVICE PUMP STATION

DATE: APRIL 2014	SCALE: HORIZONTAL:	DRAWING NUMBER: I-3.1
MCE PROJ. # 1024-0160	DESIGNED: NMH	CHECKED: MSL
PROJ. MGR. MSL	STATUS: ISSUE FOR BID	REVISION:



- NOTES:**
- REFER TO DRAWING E1 FOR GENERAL NOTES.
 - EXISTING HIGH SERVICE PUMP VFD'S, TRANSFORMERS AND ALL ASSOCIATED CONDUIT AND WIRE ARE TO BE REMOVED. NEW VFD'S WILL BE INSTALLED IN SAME LOCATIONS FOR NEW LOW SERVICE PUMPS. CONTRACTOR SHALL COORDINATE REMOVAL OF OLD VFD'S AND INSTALLATION OF NEW VFD'S WITH THE SEQUENCE OF CONSTRUCTION REQUIREMENTS.

1 - ELECTRICAL POWER PLAN
3/16"=1'-0"

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REV. NO.	DESCRIPTIONS	DATE

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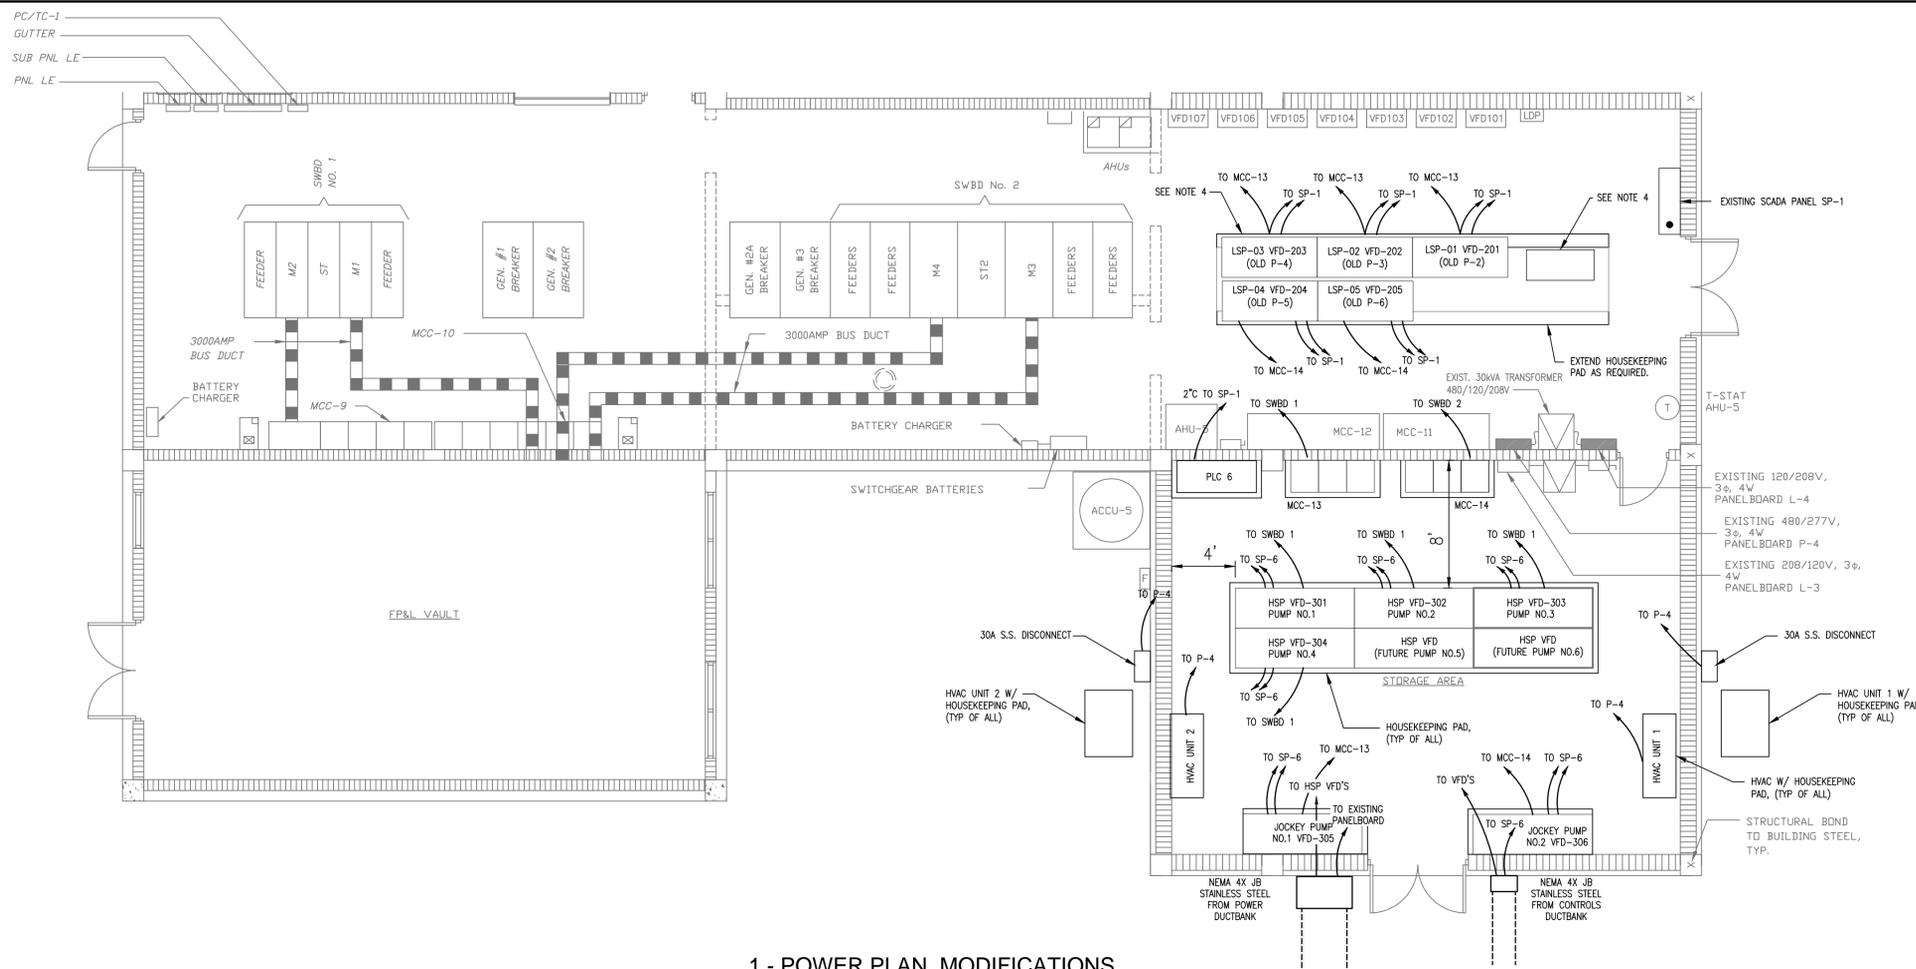
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SEWRF 10 MG STORAGE TANK AND INTERCONNECTION


POWER PLAN MAIN ELECTRICAL BUILDING DEMOLITION

DATE: APRIL 2014	SCALE: NA	DRAWING NUMBER: E-0.7
MCE PROJ. # 1024-0160	HORIZONTAL: NA	
DRAWN: EJB	VERTICAL: NA	
DESIGNED: ALA		
CHECKED: MSA		
PROJ. MGR.: MSL		
STATUS: ISSUE FOR BID	REVISION:	



NOTES:

1. ALL CONDUITS NOT SHOWN FOR CLARITY. SEE ONE LINE FOR MORE INFORMATION.
2. REFER TO DRAWING E0.1 FOR GENERAL NOTES.
3. EXISTING HIGH SERVICE PUMP VFD'S TO BE REMOVED AND REPLACED WITH VFD'S FOR LOW SERVICE PUMPS. CONTRACTOR SHALL COORDINATE REMOVAL OF OLD VFD'S AND INSTALLATION OF NEW VFD'S WITH THE SEQUENCE OF CONSTRUCTION REQUIREMENTS.
4. CONTRACTOR TO REMOVE EXISTING JUNCTION BOX (JB) AND INSTALL NEW VFD-203. WHERE EXISTING VFD FOR PUMP 1 IS BEING REMOVED, CLEAN AND CAP CONDUITS. FOR OTHER NEW VFD'S, CONTRACTOR IS TO UTILIZE EXISTING CONDUITS TO PUMP LOCATIONS AT LOW SERVICE PUMPS STATIONS 1 & 2.
5. CONTRACTOR SHALL ADJUST EXISTING LIGHTING TO ACCOMMODATE THE MOUNTING OF CONDUIT FROM THE CEILING. REMOVE AND REINSTALL LIGHT FIXTURES AS NECESSARY. IF CONDUIT CAUSES SHADOWS REINSTALL ON PENDANTS AS NECESSARY..
6. PROVIDE NEW BREAKERS AS SHOWN ON PANEL SCHEDULE. MATCH EXISTING WITHSTAND RATING.

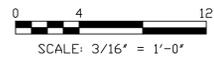


1 - POWER PLAN MODIFICATIONS
3/16"=1'-0"

CKT NO.	TRIP AMPS	DESCRIPTION OF LOAD	LOAD KVA	AMPS	POLES	KVA PER PHASE			POLES	AMPS	LOAD KVA	DESCRIPTION OF LOAD	TRIP AMPS	CKT NO.
						A	B	C						
1	20	MOV-101 (EXISTING)	0.33	1.2	3	0.7			3	1.2	0.33	MOV-102 (EXISTING)	20	2
			0.33			0.7		0.33						
			0.33				0.7	0.33						
7	20	MOV-105 (EXISTING)	0.33	1.2	3	0.7			3	1.2	0.33	MOV-104 (EXISTING)	20	8
			0.33			0.7		0.33						
			0.33				0.7	0.33						
13	20	MOV-255	0.33	1.2	3	1.8			3	5.4	1.5	HVAC UNIT 2 CONDENSOR	30	14
			0.33				1.8	1.5						
			0.33				1.8	1.5						
19	30	HVAC UNIT 1 CONDESOR	1.5	5.4	3	2.2			3	2.4	0.66	HVAC UNIT 2 AIR HANDLER	15	20
			1.5			2.2		0.66						
			1.5				2.2	0.66						
25	15	HVAC UNIT 1 AIR HANDLER	0.66	2.4	3	0.7			3			SPARE	20	26
			0.66			0.7								
			0.66				0.7							
PANEL P-4 LOCATION: SOUTH WALL BUILDING: ELECTRICAL BUIDING NOTES: EXISTING PANEL			TOTAL KVA			6.0	6.0	6.0	SERVICE CHARACTERISTICS VOLTS: 480Y/277 _____ 225 A MLO PHASE: 3 _____ A MCB WIRE: 4 35k MIN AIC SYMM, FULLY RATED ASSEMBLY					
			GRAND CONNECTED TOTAL KVA				17.9							

2 - EXISTING POWER PANEL P-4
SEE NOTE 6

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REVNO.	DESCRIPTIONS	DATE

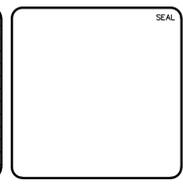






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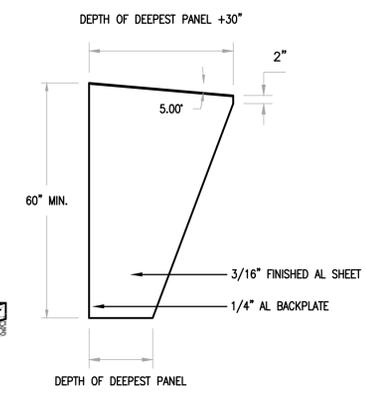
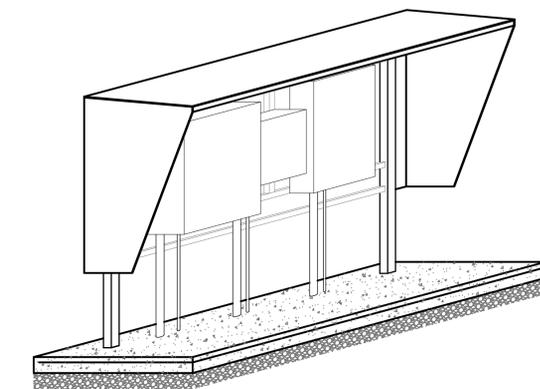
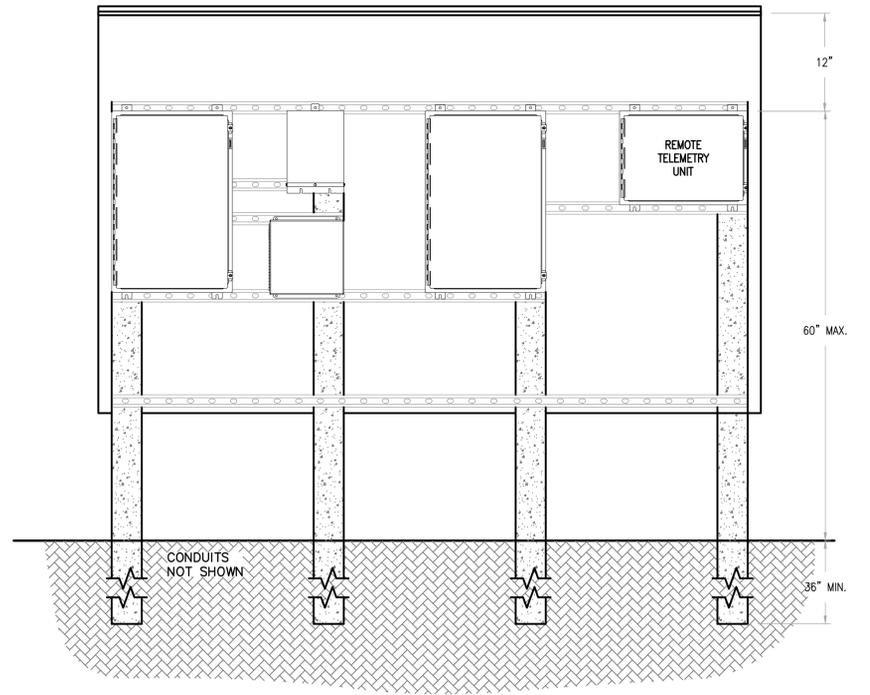
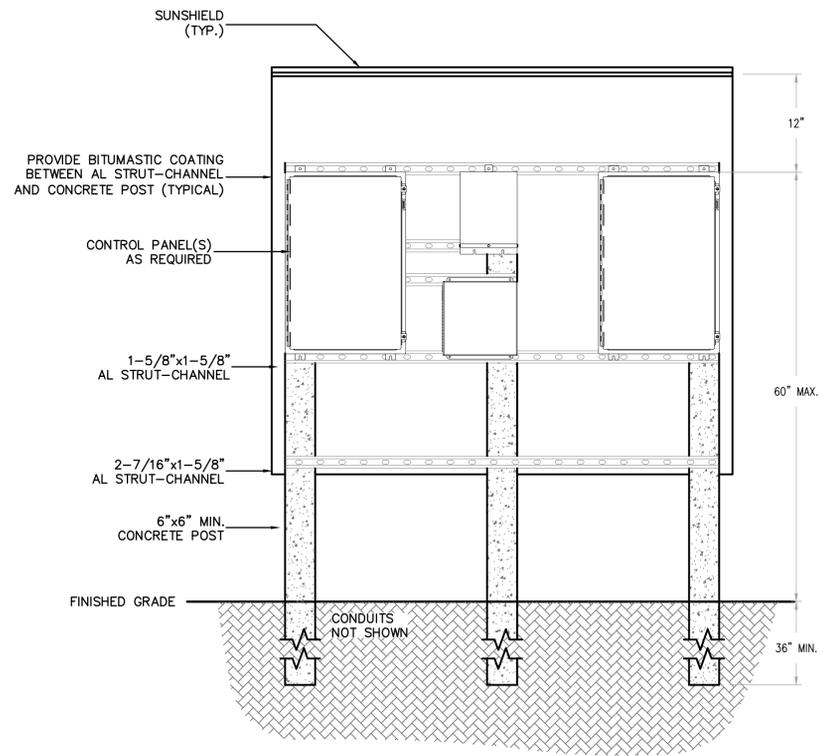
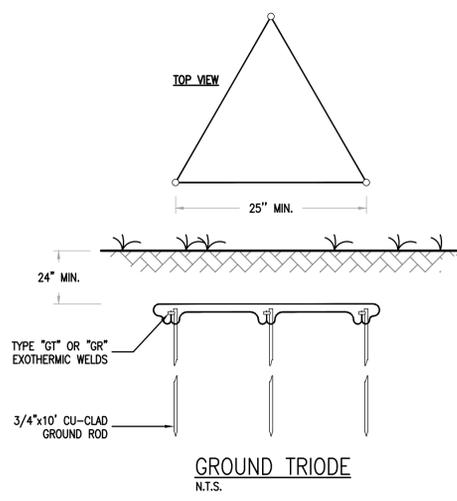
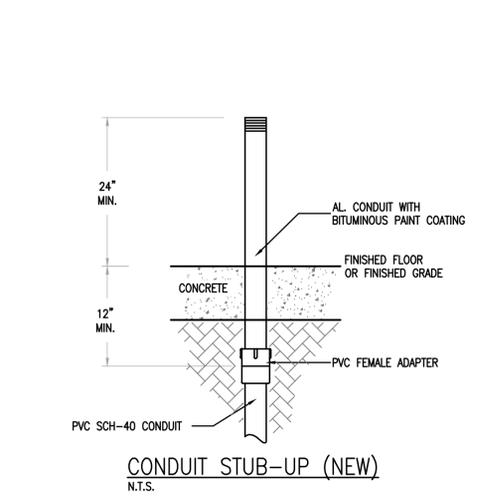
SEWRF 10 MG STORAGE TANK AND INTERCONNECTION

MAIN ELECTRICAL BUILDING POWER PLAN MODIFICATIONS

DATE: APRIL 2014	SCALE:	DRAWING NUMBER:
MCE PROJ. # 1024-0160	HORIZONTAL: NA	E-0.8
DRAWN: EJB	VERTICAL: NA	
DESIGNED: ALA	STATUS: ISSUE FOR BID	REVISION:
CHECKED: MSA		
PROJ. MGR.: MSL		



- GENERAL NOTES:**
1. REFER TO SHEET E1 FOR GENERAL ELECTRICAL NOTES, ABBREVIATIONS, SYMBOLS AND LIGHTING FIXTURE SCHEDULE.
 2. ALL ELECTRICAL WORK SHALL COMPLY WITH THE NEC, NESC AND LOCAL CODES INCLUDING OWNERS STANDARDS AND REQUIREMENTS.
 3. THE NEW ELECTRICAL SERVICE SHALL BE 480/277-VOLT, 3-PHASE, 4-WIRE.
 4. ALL POWER CONDUCTORS SHALL BE 600V RATED XHHW-2 STRANDED CU.
 5. ALL CONTROL CONDUCTORS SHALL BE 600V RATED THHN/THWN STRANDED CU.
 6. ALL EXPOSED CONDUITS SHALL BE RIGID ALUMINUM (AL).
 7. ALL UNDERGROUND CONDUITS SHALL BE DIRECT BURIED PVC SCH-80.
 8. SERVICE LATERAL CONDUIT SHALL BE CONCRETE ENCASED PVC SCH-80.

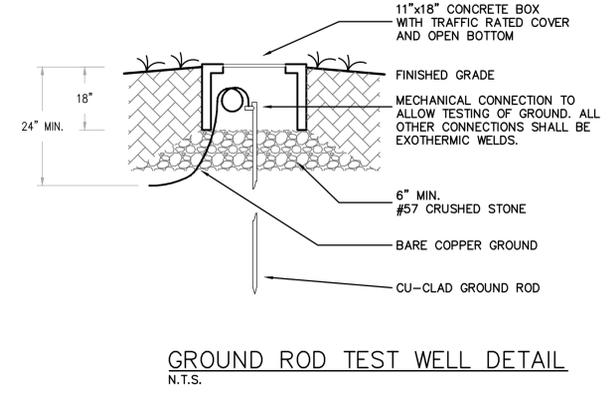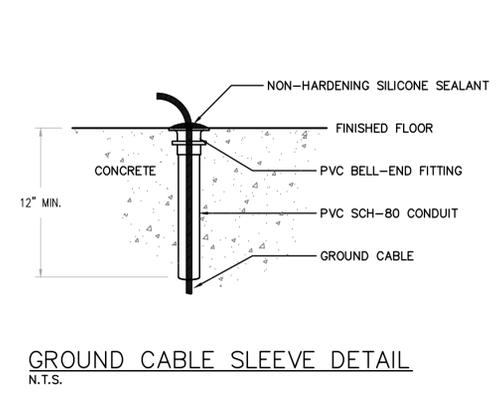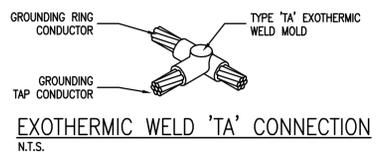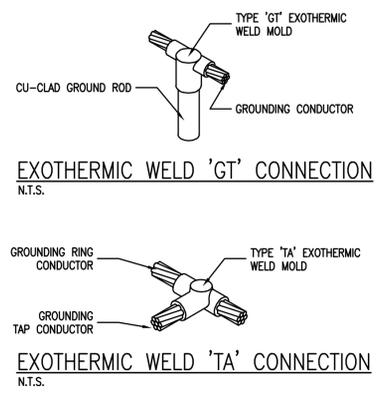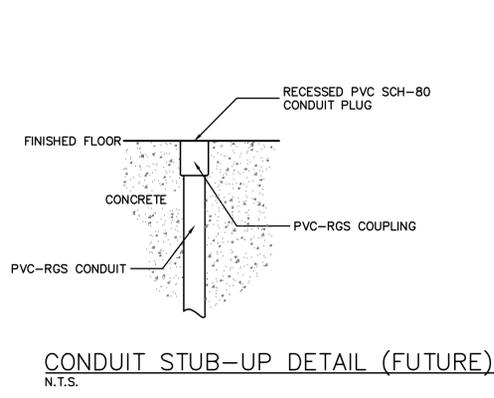

- DETAIL NOTES:**
1. CONTRACTOR SHALL SUBMIT LAYOUT OF ELECTRICAL EQUIPMENT RACK.
 2. CONTRACTOR SHALL NOT CONSTRUCT ELECTRICAL EQUIPMENT RACK PRIOR TO RECEIVING APPROVED SUBMITAL, INCLUDING ORDERING AND FABRICATION OF MATERIALS.
 3. ALL EQUIPMENT MOUNTING HARDWARE SHALL BE 316 STAINLESS-STEEL.
 4. CONCRETE SHALL BE 3000PSI. CONCRETE PADS SHALL BE REINFORCED WITH 6x6-1.4Wx1.4W WWF. PAD SHALL EXTEND 36" OUT FROM DEEPEST PANEL AND 6" OUT FROM SIDES OF SUN/RAIN HOOD.
 5. PROVIDE ADDITIONAL VERTICAL 6" 'I-BEAM' POSTS AND BASES LIKE THOSE SHOWN ON PLANS TO SPAN GREATER DISTANCES GREATER THAN 96".
 6. ALARM STROBE SHALL BE MOUNTED, WATER-TIGHT, ATOP PUMP CONTROL PANEL "PCP".
 7. PROVIDE WEATHERPROOF CORROSION RESISTANT FLUORESCENT FIXTURE MOUNTED UNDERNEATH SUN/RAIN HOOD, LIGHT SWITCH AND GFCI RECEPTACLE.
 8. STRUT-CHANNEL SHALL BE MOUNTED TO 'I-BEAM' POSTS WITH STAINLESS-STEEL FASTENERS AND GALVANIZED CLAMPING HARDWARE.
 9. THE BOTTOM OF EQUIPMENT SHALL BE MOUNTED NO LESS THAN 20" ABOVE FINISHED CONCRETE PERSONNEL PAD.
 10. CONDUITS SHALL BE INSTALLED UNBROKEN (NO FITTINGS, COUPLINGS, UNIONS, ETC.) THROUGH CLASS-1/DIV-II BOUNDARY.

ELECTRICAL EQUIPMENT RACK LAYOUT (FRONT ELEVATION)
N.T.S.

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REV. NO.	DESCRIPTIONS	DATE

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	SEAL

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SEWRF 10 MG STORAGE TANK AND INTERCONNECTION

ELECTRICAL
DETAILS - 2 OF 2

DATE: APRIL 2014	SCALE:	DRAWING NUMBER:
MCE PROJ. # 1024-0180	HORIZONTAL: NA	E-9.2
DRAWN: EJB	VERTICAL: NA	
DESIGNED: ALA		
CHECKED: MSA		
PROJ. MGR: MSL		
STATUS: ISSUE FOR BID	REVISION:	

HVAC LEGEND

PIPING SYMBOLS

- RS — REFRIGERANT SUCTION
- RL — REFRIGERANT LIQUID
- D — DRAIN LINE
- Ball Valve Symbol — BALL VALVE
- Arrow — DIRECTION OF FLOW
- Floor Drain Symbol — FLOOR DRAIN
- Down Arrow — PIPE TURNING DOWN
- Up Arrow — PIPE TURNING UP
- TEE with Branch Top — TEE WITH BRANCH OFF TOP OF MAIN
- TEE with Branch Bottom — TEE WITH BRANCH OFF BOTTOM OF MAIN

DUCTWORK SYMBOLS

- RAISE IN ELEVATION OF HORIZONTAL DUCTWORK IN DIRECTION OF AIRFLOW
- DROP IN ELEVATION OF HORIZONTAL DUCTWORK IN DIRECTION OF AIRFLOW
- MOTOR OPERATED DAMPER (MOD) W/ACCESS DOOR
- MANUAL VOLUME DAMPER (MVD)
- AD — ACCESS DOOR
- SUPPLY OR OA DUCT – TURNING UP
- RETURN/EXHAUST/RELIEF DUCT TURNING UP
- SUPPLY OR OA DUCT TURNING DOWN
- RETURN/EXHAUST/RELIEF DUCT TURNING DOWN
- 8" — FLEXIBLE DUCT

SINGLE LINE DUCTWORK

- MEDIUM OR HIGH PRESSURE SUPPLY
- LOW PRESSURE SUPPLY
- RA — RETURN AIR
- EA — EXHAUST AIR
- RFA — RELIEF AIR
- OA — OUTSIDE AIR

MISCELLANEOUS SYMBOLS AND ABBREVIATIONS

- A) OA INTAKE
- B) RELIEF
- C) EXHAUST OUTLET
- D) EXHAUST FAN
- CEILING MOUNTED EXHAUST FAN
- SWITCH
- THERMOSTAT OR TEMP. INDICATOR; SUBSCRIPT INDICATES ITEM SERVED
- TEMPERATURE SENSOR
- AFF — ABOVE FINISH FLOOR
- AHU — AIR HANDLING UNIT
- CL — CENTER LINE
- EF — EXHAUST FAN
- ESP — EXTERNAL STATIC PRESSURE
- FCU — FAN COIL UNIT
- EC — ELECTRICAL CONTRACTOR
- GC — GENERAL CONTRACTOR
- MC — MECHANICAL CONTRACTOR
- PC — PLUMBING CONTRACTOR
- EA — EXHAUST AIR
- OA — OUTSIDE AIR
- RA — RETURN AIR
- SA — SUPPLY AIR
- RF — RETURN FAN
- SF — SUPPLY FAN
- TSP — TOTAL STATIC PRESSURE
- UH — UNIT HEATER
- NC — NORMALLY CLOSED
- NO — NORMALLY OPEN
- DETAIL OR SECTION NUMBER
- SHEET ON WHICH DETAIL OR SECTION APPEARS
- SHEET ON WHICH DETAIL OR SECTION IS CUT
- UC — UNDERCUT DOOR BY G.C.
- CFM — SPECIFIC OR NEW WORK NOTES
- REVISION NOTES
- 21x12 — RECTANGULAR DUCT
- 12" — ROUND DUCT
- DEVICE TYPE
- NECK SIZE
- CFM
- FLOW PATTERN
- GRILLE, REGISTER OR DIFFUSER DESIGNATION

NOTES:
1. ALL DUCT DIMENSIONS SHOWN ARE IN INCHES AND ARE FREE AREA SIZES UNLESS OTHERWISE SHOWN.

GENERAL NOTE: ALL ITEMS IN LEGEND MAY NOT BE REQUIRED ON THIS PROJECT

GENERAL NOTES

- THE CONTRACTOR SHALL COORDINATE HIS WORK WITH THAT OF THE OTHER TRADES PRIOR TO INSTALLATION OF ANY OF HIS PIPING, DUCTWORK, OR EQUIPMENT.
- THE MECHANICAL CONTRACTOR SHALL MAKE A COMPLETE REVIEW OF THE MECHANICAL PLANS, SCHEDULES, AND DETAILS PRIOR TO INSTALLATION OF THE MECHANICAL SYSTEMS AND REVIEW ANY CONFLICTS THAT ARE NOTED WITH THE ENGINEER.
- IT WILL BE THE RESPONSIBILITY OF THE MECHANICAL CONTRACTOR TO ENSURE THAT ITEMS TO BE FURNISHED UNDER HIS CONTRACT WILL FIT THE SPACE AVAILABLE. HE SHALL MAKE NECESSARY FIELD MEASUREMENTS TO ASCERTAIN SPACE REQUIREMENTS, INCLUDING THOSE FOR CONNECTIONS, AND SHALL FURNISH AND INSTALL SUCH SIZES AND SHAPES OF EQUIPMENT THAT ARE THE TRUE INTENT AND MEANING OF THE PLANS AND SPECIFICATIONS. HE SHALL PROVIDE TO THE ENGINEER, SCALED DRAWINGS OF ALL MECHANICAL SPACES.
- ALL EQUIPMENT SHALL BE LOCATED AND INSTALLED TO PROVIDE MAXIMUM SPACE FOR MAINTENANCE AND SERVICE.
- THE MECHANICAL CONTRACTOR SHALL BE RESPONSIBLE FOR ALL CONTROL WIRING AND CONNECTIONS TO THE EQUIPMENT PROVIDED UNDER THIS CONTRACT. DO NOT INSTALL PIPING OR DUCTWORK OVER ANY ELECTRICAL SWITCHGEAR.
- THE MECHANICAL CONTRACTOR SHALL PROVIDE AND INSTALL HIS OWN SUPPORT DEVICES. ALL LOCATIONS SHALL BE COORDINATED WITH THE GENERAL CONTRACTOR AND OTHER PRIME CONTRACTORS PRIOR TO INSTALLATION.
- THE MECHANICAL CONTRACTOR SHALL REFER TO THE ARCHITECTURAL PLANS FOR FLOOR PLAN DIMENSIONS. DO NOT SCALE THESE DRAWINGS.
- THE MECHANICAL CONTRACTOR SHALL BE RESPONSIBLE FOR ALL PENETRATIONS (PERTAINING TO HIS WORK) THROUGH THE ROOF, WALLS, FLOORS AND THE WATERPROOFING AROUND THE OPENINGS. PENETRATIONS THROUGH FIRE RATED ASSEMBLY SHALL BE PROTECTED AS REQUIRED BY SPECIFICATIONS AND CODE (FIRE DAMPERS, SLEEVES, FIRE CAULK, ETC.).
- THE MECHANICAL CONTRACTOR SHALL BE RESPONSIBLE FOR ALL CUTTING AND PATCHING OF FLOORS AND WALLS PERTAINING TO HIS WORK.
- CONDENSATE DRAINS SHALL BE A MINIMUM OF 3/4" COPPER PIPE INSULATED WITH A 25/50 RATED CLOSED CELL FLEXIBLE ELASTOMERIC HAVING A NOMINAL WALL THICKNESS OF 1/2". A P-TRAP SHALL BE INSTALLED IN PIPE AT THE UNIT. ALL CONDENSATE LINES SHALL BE ROUTED TO A FLOOR DRAIN OR AS INDICATED ON PLANS.
- LOCATE ROOM TEMPERATURE SENSORS 48" ABOVE FINISHED FLOOR OR AS NOTED ON THE PLANS.
- ALL SENSORS, WIRING, AND CONDUIT ARE TO BE FURNISHED AND INSTALLED BY THE MECHANICAL CONTRACTOR.
- ALL DUCTWORK, PIPING, EQUIPMENT, ETC. SHALL BE SUPPORTED FROM THE BUILDING SUPPORT STRUCTURE AND NOT THE ROOF.
- ALL EQUIPMENT SHALL MEET OR EXCEED ALL REQUIREMENTS AS DESCRIBED IN THE LATEST VERSION OF ASHRAE STANDARD 90.1 AND THE FLORIDA BUILDING ENERGY CODE.
- THE MECHANICAL CONTRACTOR SHALL COORDINATE THE ROUGH-IN OF PIPING WITH THE GENERAL CONTRACTOR AND OTHER PRIME CONTRACTORS.
- THE CONTRACT DRAWINGS ARE DIAGRAMMATIC AND ARE INDICATIVE OF THE WORK TO BE PERFORMED. IT IS NOT INTENDED THAT THEY SHOW EVERY DUCT, PIPE FITTING OR APPARATUS REQUIRED FOR A COMPLETE INSTALLATION. THEY ARE NOT INTENDED TO INDICATE EVERY BEND, OFFSET, CHANGE IN DIRECTION AND APPURTENANCE REQUIRED TO PROVIDE A COMPLETE AND WORKABLE SYSTEM. ALL MATERIALS AND EQUIPMENT USED SHALL BE INSTALLED IN STRICT ACCORDANCE WITH THE STANDARDS UNDER WHICH THE MATERIALS ARE ACCEPTED AND APPROVED, AND IN STRICT ACCORDANCE WITH THE MANUFACTURER'S INSTRUCTIONS.

SPLIT SYSTEM AIR HANDLING UNIT SCHEDULE

OUTDOOR UNIT MARK	BASIS OF DESIGN	OUTDOOR UNIT DATA						INDOOR UNIT DATA										NOTES				
		COOLING		REF. CHARGE	ELECTRICAL			INDOOR UNIT MARK	BASIS OF DESIGN	COOLING SUPPLY CFM	OUTSIDE AIR CFM	TOTAL COOLING MBH	SENSIBLE COOLING MBH	LEAVING AIR TEMP. (°F)		SUPPLY FAN HP	ELECTRICAL					
		TOTAL	SEER/EER		VOLTS	PHASE	MCA							MOP	°B		WB		VOLTS	PHASE	MCA	MOP
ACCU-6	TRANE TTA120F4	10 TONS	11.2 EER	21.2 LBS	460	3	24.1	30	AHU-6	TRANE TWE120	4,000	0	117.9	91.0	59.4	57.7	2	460	3	4.0	15	1 - 15
ACCU-7	TRANE TTA120F4	10 TONS	11.2 EER	21.2 LBS	460	3	24.1	30	AHU-7	TRANE TWE120	4,000	0	117.9	91.0	59.4	57.7	2	460	3	4.0	15	1 - 15

NOTES:

- UNITS SHALL BE CONTROLLED OFF OF ONE WALL MOUNTED PROGRAMMABLE THERMOSTAT.
- UNIT TO BE PROVIDED WITH MERV 8, 1" THICK PLEATED MEDIA FILTERS. PROVIDE 2 ADDITIONAL SETS OF FILTERS.
- UNIT TO BE PROVIDED WITH A ONE YEAR COMPREHENSIVE UNIT WARRANTY AND A FIVE YEAR COMPRESSOR WARRANTY.
- PROVIDE UL LISTED DISCONNECT FOR OUTDOOR UNIT, INDOOR UNIT TO HAVE UL LISTED UNIT MOUNTED LOCKING TYPE DISCONNECT.
- UNITS TO UTILIZE REFRIGERANT R-410A.
- COOLING OUTPUT CAPACITY RATED AT 95° OAT, 80°DB/67°WB EAT.
- UNIT SHALL BE CAPABLE OF LOW AMBIENT COOLING DOWN TO 20°F.
- PROVIDE INDOOR UNIT WITH CONDENSATE OVERFLOW SWITCH WITH AUDIBLE AND VISUAL ALARMS (COORDINATE ALARM LOCATIONS WITH THE OWNER). UNIT SHALL SHUT OFF WHEN CONDENSATE OVERFLOW SWITCH IS ACTIVATED.
- INDOOR UNIT SHALL BE PROVIDED WITH A TOP MOUNTED DISCHARGE PLENUM WITH 4-WAY ADJUSTABLE GRILLE.
- INDOOR UNIT SHALL BE PROVIDED WITH A RETURN GRILLE.
- INDOOR UNIT SHALL BE PROVIDED WITH SUBBASE AND RUBBER ISOLATORS.
- CONDENSER COIL SHALL BE EPOXY COATED AND PROVIDED WITH VANDAL GUARD KIT.
- UNIT SHALL BE DUAL COMPRESSOR AND DUAL CIRCUIT.
- UNITS SHALL BE INSTALLED WITH MANUFACTURER'S RECOMMENDED CLEARANCES.
- "BASIS OF DESIGN" SHALL BE TRANE; EQUALS BY JCI, AND CARRIER ARE ACCEPTABLE.

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REV. NO.	DATE	DESCRIPTIONS	REVISIONS

SEAL

ROGER M. WOODS, P.E.
No. 76793

SEAL





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MANATEE COUNTY, FLORIDA

SEWRF 10 MG STORAGE TANK AND INTERCONNECTION

HVAC LEGEND, GENERAL NOTES AND SCHEDULES

DATE: APRIL 2014	SCALE: HORIZONTAL: N/A	DRAWING NUMBER: H-0.1
MCE PROJ. # 1024-0160	VERTICAL: N/A	REVISION: N/A
DRAWN: SMT		
DESIGNED: SMT		
CHECKED: RMW		
PROJ. MGR.: MSL		
STATUS: ISSUE FOR BID		

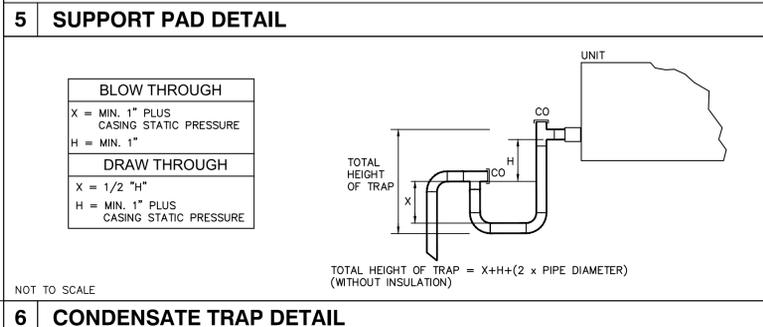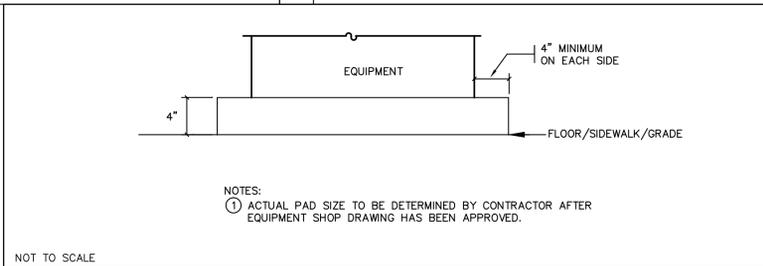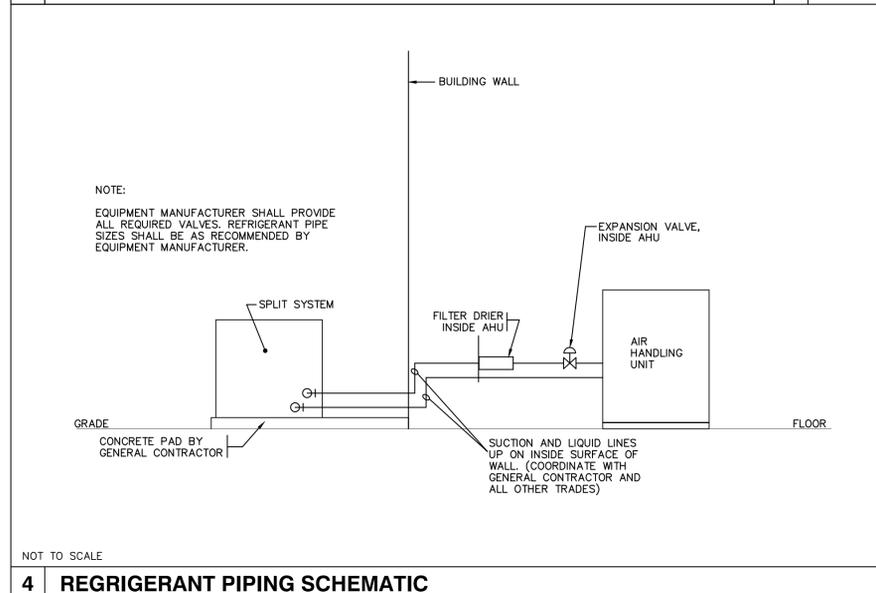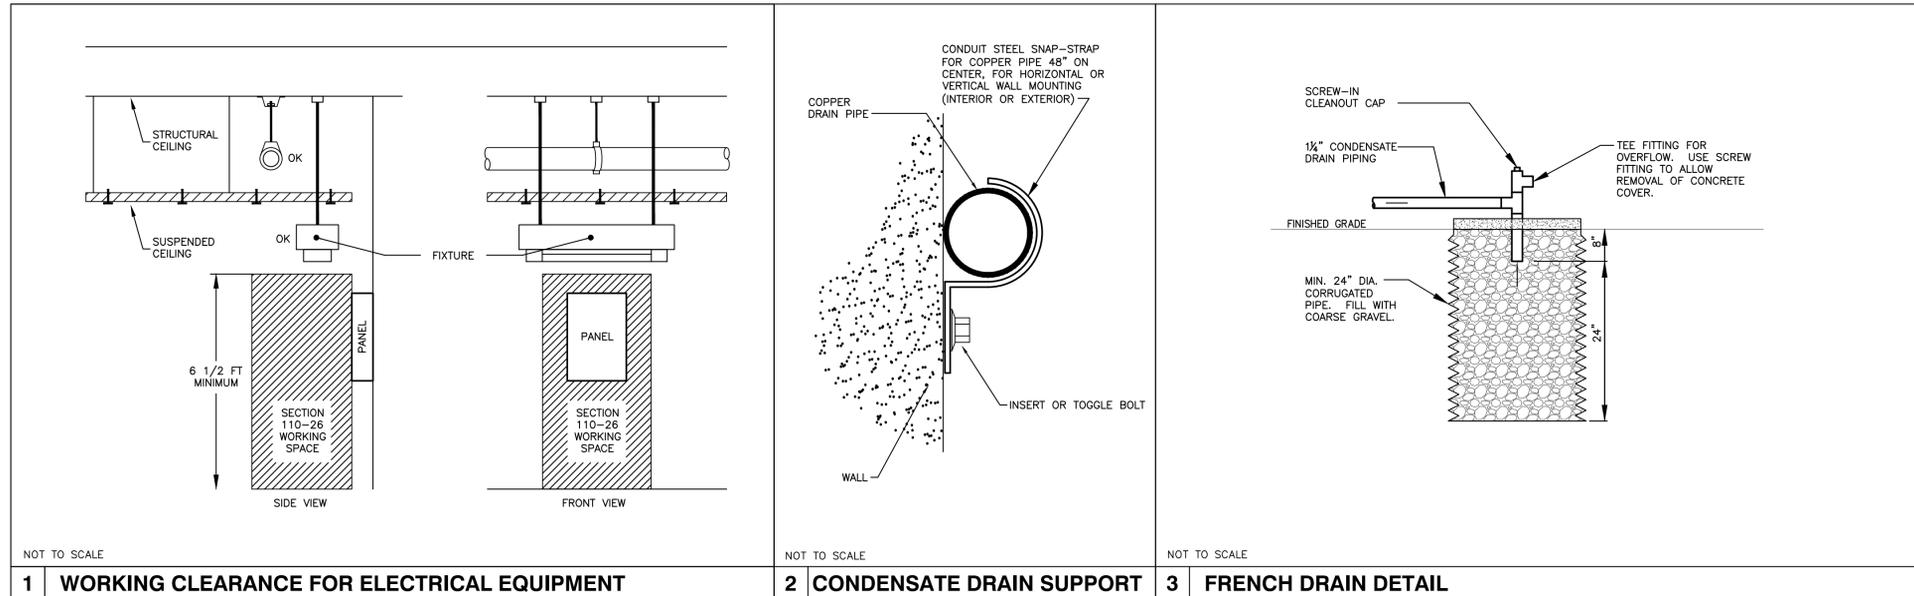

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REV. NO.	DESCRIPTIONS	DATE

SEAL

ROGER M. WOODS, P.E.
No. 76793

SEAL

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MANATEE COUNTY, FLORIDA

SEWRF 10 MG STORAGE TANK AND INTERCONNECTION

HVAC DETAILS

DATE:	APRIL 2014
MCE PROJ. #	1024-0160
DRAWN	SMT
DESIGNED	SMT
CHECKED	RMW
PROJ. MGR.	MSL

STATUS: **ISSUE FOR BID**

SCALE:	HORIZONTAL: N/A	VERTICAL: N/A
DRAWING NUMBER:	H-0.2	

