

1 GENERAL ELECTRICAL SYMBOLS

	LIGHTING, INSTRUMENT OR RECEPTACLE PANELBOARD
	POWER PANELBOARD
	CONTROL PANEL
	MOTOR CONTROL CENTER
	POWER MONITOR
	AMMETER
	AMMETER SWITCH
	VOLTMETER
	VOLTMETER SWITCH
	FLOAT/FLOW SWITCH
	LIMIT SWITCH
	PRESSURE SWITCH
	THERMOSTAT
	JUNCTION BOX, SIZE PER NEC
	ELECTRICAL EQUIPMENT CONNECTION
	ELECTRICAL MANHOLE / HANDHOLE AND THE LETTERS INDICATE THE TYPE OF THE HOLE
	RACEWAY SYSTEM CALL-OUTS: CT - CABLE TRAY BD - BUS DUCT DB - DUCTBANK EC - EXPOSED CONDUIT WW - WIRE WAY/TROUGH
	RACEWAY AND/OR CABLE ID NUMBER
	RACEWAY HOMERUN TO EQUIPMENT ID TAG AS SHOWN. LINE TYPE DESIGNATES CONCEALED, EXPOSED, ETC. NUMBERS/TEXT DESIGNATE HOMERUN EQUIPMENT (I.E. PANEL BOARD CIRCUIT NUMBER).
	TO PLC-1 CONDUCTOR/CABLE CALL-OUT WITHIN RACEWAY 9#14 #12G 0.75°C
	CONCEALED CONDUIT IN FLOOR SLAB, UNDERGROUND, ETC.
	EXISTING CABLE OR CONDUIT
	CONDUIT TURNED DOWN
	CONDUIT TURNED UP
	CONDUIT TURNED UP
	CONDUIT TURNED UP
	SITE ELECTRICAL
	EXISTING SITE ELECTRICAL
	SITE TELEPHONE
	EXISTING SITE TELEPHONE
	OVERHEAD ELECTRICAL UTILITY
	OVERHEAD TELEPHONE UTILITY
	UNDERGROUND ELECTRICAL UTILITY
	UNDERGROUND TELEPHONE UTILITY
	SITE GROUND
	EXISTING SITE GROUND

2 POWER SYMBOLS

	CLASS 1/2 DIVISION III CONDUIT SEAL-OFF FITTING		TRANSFORMER, POWER TYPE AND RATINGS AS NOTED ON THE DRAWINGS
	LOCAL CONTROL STATION WITH THREE OR MORE SELECTOR/PUSH SWITCHES LOWER-RIGHT SYMBOL INDICATES MOUNTING LOCATION		TRANSFORMER, SHIELDED ISOLATION TYPE AND RATINGS AS NOTED ON THE DRAWINGS
	LOCAL CONTROL STATION WITH TWO SELECTOR/PUSH SWITCHES LOWER-RIGHT SYMBOL INDICATES MOUNTING LOCATION		TRANSFORMER, CURRENT 'CT' TYPE AND RATINGS AS NOTED ON THE DRAWINGS
	LOCAL CONTROL STATION WITH ONE SELECTOR/PUSH SWITCH LOWER-RIGHT SYMBOL INDICATES MOUNTING LOCATION		TRANSFORMER, POTENTIAL 'PT' OR 'VT' TYPE AND RATINGS AS NOTED ON THE DRAWINGS
	LOCATED AT FIELD DEVICE		AUTOMATIC OR MANUAL TRANSFER SWITCH, STAND-ALONE TYPE AND RATINGS AS NOTED ON THE DRAWINGS
	LOCATED AT MAIN CONTROL PANEL		SAFETY / DISCONNECT SWITCH TOP NUMBER DENOTES FUSE SIZE (NF=NON-FUSED) BOTTOM NUMBER DENOTES NEMA ENCLOSURE RATING
	LOCATED AT LOCAL CONTROL PANEL		MOTOR CONTROLLER, STAND-ALONE WITH EXTERNAL DISCONNECT: UPPER LEFT NUMBER DENOTES NEMA FRAME SIZE UPPER RIGHT NUMBERS DENOTE AMPERE AND FRAME RATINGS CENTER RIGHT NUMBER DENOTES NEMA ENCLOSURE RATING LETTERS WITHIN THE SYMBOL DENOTE THE FOLLOWING: FVNR FULL VOLTAGE NON-REVERSE FVR FULL VOLTAGE REVERSIBLE TS1W TWO SPEED - SINGLE WINDING TS2W TWO SPEED - DUAL WINDING RVSS REDUCED VOLTAGE SOFT STARTER RVAT REDUCED VOLTAGE AUTO TRANSFORMER VFD VARIABLE FREQUENCY DRIVE
	MOUNTED ON DOOR		MOTOR CONTROLLER, FULL-VOLTAGE MCC UNIT: UPPER LEFT NUMBER DENOTES NEMA FRAME SIZE LETTERS WITHIN THE SYMBOL DENOTE THE FOLLOWING: FVNR FULL VOLTAGE NON-REVERSE FVR FULL VOLTAGE REVERSIBLE
	DRAW-OUT POWER CIRCUIT BREAKER WITH PROGRAMMABLE SOLID STATE RELAY 'EO' DENOTES ELECTRICALLY OPERATED		MOTOR CONTROLLER, PART-WINDING MCC UNIT: UPPER LEFT NUMBER DENOTES NEMA FRAME SIZE LETTERS WITHIN THE SYMBOL DENOTE THE FOLLOWING: TS1W TWO SPEED - SINGLE WINDING TS2W TWO SPEED - DUAL WINDING
	FIXED-MOUNT POWER CIRCUIT BREAKER WITH ADJUSTABLE SOLID STATE RELAY		MOTOR CONTROLLER, REDUCED-VOLTAGE MCC UNIT: UPPER LEFT NUMBER DENOTES NEMA FRAME SIZE LETTERS WITHIN THE SYMBOL DENOTE THE FOLLOWING: RVSS REDUCED VOLTAGE SOFT STARTER RVAT REDUCED VOLTAGE AUTO TRANSFORMER
	CIRCUIT BREAKER, GENERIC FIXED-MOUNT 'TMTU' THERMAL-MAGNETIC TRIP UNIT 'ELTU' ELECTRONIC TRIP UNIT		MOTOR CONTROLLER, VARIABLE FREQUENCY DRIVE, MCC UNIT: UPPER LEFT NUMBER DENOTES NEMA FRAME SIZE LETTERS WITHIN THE SYMBOL DENOTE THE FOLLOWING: VFD VARIABLE FREQUENCY DRIVE
	CIRCUIT BREAKER, GENERIC		LINE OR LOAD REACTOR CENTER RIGHT NUMBER DENOTES PERCENT IMPEDANCE
	CIRCUIT BREAKER, THERMAL		MOTOR PROTECTION FILTER
	CIRCUIT BREAKER, MOTOR CIRCUIT PROTECTOR		AC MOTOR SINGLE OR THREE PHASE AS NOTED
	CIRCUIT BREAKER, MOTOR CIRCUIT PROTECTOR		CABLE-TRAY TYPE AS NOTED ON THE DRAWINGS
	FUSE, GENERIC		
	FUSE, GENERIC TOP NUMBER DENOTES TRIP BOTTOM NUMBER DENOTES VOLTAGE CLASS MIDDLE NUMBER DENOTES TYPE		
	WIRING DEVICE, POWER RECEPTACLE WITH INTEGRAL DISCONNECT / LOAD BREAK NEMA CONFIGURATION SHOWN LOWER RIGHT		
	WIRING DEVICE, POWER RECEPTACLE NEMA CONFIGURATION SHOWN LOWER RIGHT		

NOTES:
ALL SYMBOLS MAY NOT BE UTILIZED FOR THIS PROJECT.
ADDITIONAL SYMBOLS NOT SHOWN ON THIS DRAWING MAY BE SHOWN ELSEWHERE ON THE ELECTRICAL DRAWINGS. IF REQUIRED, IEC RATINGS WILL INCLUDE THE "IEC" AND "IP" PREFIX.


3 SCHEMATIC SYMBOLS

	MOMENTARY PUSH BUTTON NORMALLY OPENED		CONTROL RELAY, GENERIC DESIGNATIONS: CR CONTROL RELAY MX AUXILIARY RELAY TR TIMING RELAY AR ALARM RELAY RR READY RELAY
	MOMENTARY PUSH BUTTON NORMALLY CLOSED		CONTROL RELAY, LATCHING
	MUSHROOM PUSH BUTTON NORMALLY OPENED		CONTACT, NORMALLY OPENED TOP ID TAG DENOTES PARENT RELAY
	MUSHROOM PUSH BUTTON NORMALLY CLOSED		CONTACT, NORMALLY CLOSED TOP ID TAG DENOTES PARENT RELAY
	TOGGLE SWITCH NORMALLY OPENED		SOLENOID, GENERIC
	TOGGLE SWITCH NORMALLY CLOSED		HEATING ELEMENT, GENERIC
	TWO-POSITION SWITCH NORMALLY OPENED		ELAPSED TIME METER, ELECTRONIC
	THREE-POSITION BUTTON NORMALLY OPENED		HORN, ALARM
	LIMIT SWITCH NORMALLY OPENED		HORN, ALARM AUDIO AND VISUAL ANNUNCIATION
	LIMIT SWITCH NORMALLY CLOSED		TRANSFORMER, CONTROL POWER RATINGS AS NOTED ON THE DRAWINGS
	LIMIT SWITCH HELD OPENED		BATTERY OR DC POWER SOURCE
	LIMIT SWITCH HELD CLOSED		MOTOR ACTUATED VALVE M MODULATING O/C OPEN/CLOSE
	TEMPERATURE SWITCH NORMALLY OPENED		MOTOR ACTUATED VALVE M MODULATING O/C OPEN/CLOSE
	TEMPERATURE SWITCH NORMALLY CLOSED		
	FLOAT SWITCH NORMALLY OPENED		
	FLOAT SWITCH NORMALLY CLOSED		
	FLOW SWITCH NORMALLY OPENED		
	FLOW SWITCH NORMALLY CLOSED		
	PRESSURE SWITCH NORMALLY OPENED		
	PRESSURE SWITCH NORMALLY CLOSED		
	ON DELAY TIME RELAY NORMALLY OPENED TIMED CLOSED NOTC		
	ON DELAY TIME RELAY NORMALLY CLOSED TIMED OPENED NCTO		
	OFF DELAY TIME RELAY NORMALLY OPENED TIMED OPENED NOTO		
	OFF DELAY TIME RELAY NORMALLY CLOSED TIMED CLOSED NCTC		
	INDICATION LIGHT W - WHITE G - GREEN A - AMBER R - RED B - BLUE C - CLEAR		
	INDICATION LIGHT, PUSH-TO-TEST W - WHITE G - GREEN A - AMBER R - RED B - BLUE C - CLEAR		


NOTES:
ALL SYMBOLS MAY NOT BE UTILIZED FOR THIS PROJECT.
ADDITIONAL SYMBOLS NOT SHOWN ON THIS DRAWING MAY BE SHOWN ELSEWHERE ON THE ELECTRICAL DRAWINGS. IF REQUIRED, IEC RATINGS WILL INCLUDE THE "IEC" AND "IP" PREFIX.

REV. NO.	DESCRIPTION	DATE

SEAL
AUBREY A. HAUDRICOURT, P.E.
No. 66861

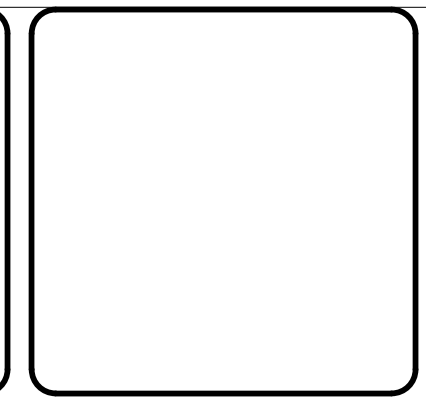

MCKIM & CREED
1365 Hamlet Avenue
Clearwater, Florida 33756-3331
Phone: (727) 442-7196, Fax: (727) 461-3827
CA Lic. No. 29588
www.mckimcreed.com

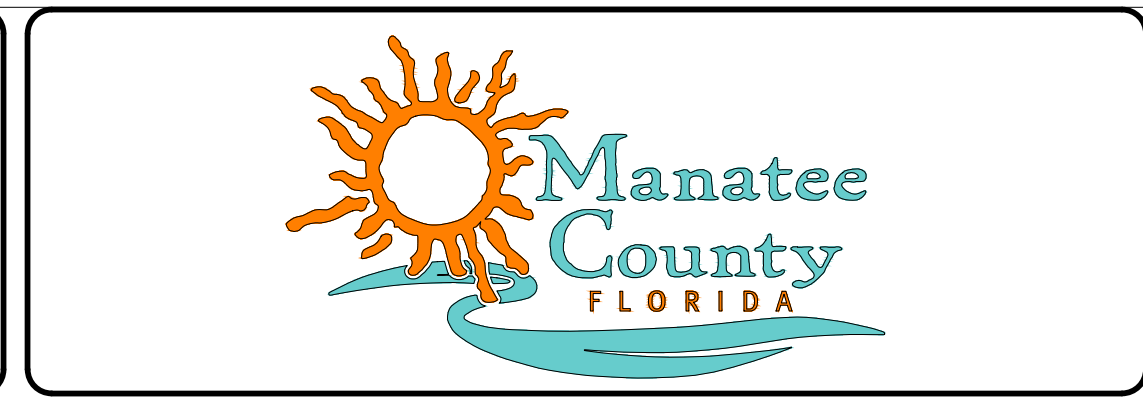

CORTEZ BOOSTER PUMP STATION UPGRADES
ELECTRICAL
ELECTRICAL SYMBOLS 1 OF 2

PROJ. START DATE: MAR. 2020	SCALE
MCE PROJ. # 01024-0193	HORIZONTAL: E002
DRAWN JG	TBD
DESIGNED AAH	VERTICAL: TBD
CHECKED MAC	REVISION
PROJ. MGR. BP	

STATUS:
ISSUED FOR BID

4 LIGHTING SYMBOLS

- 1-3 FLUORESCENT LIGHTING FIXTURE - SURFACE OR PENDANT MOUNTED. FIRST NUMERAL DENOTES LIGHTING PANEL (LP1), SECOND NUMBER DENOTES BRANCH CIRCUIT NUMBER. LOWER CASE LETTER DENOTES SWITCHED CIRCUIT.
- FLUORESCENT LIGHTING FIXTURE WITH BATTERY PACK SURFACE OR PENDANT.
- PENDANT OR CEILING MOUNTED LIGHTING FIXTURE.
- WALL MOUNTED LIGHTING FIXTURE.
- POLE OR STANCHION MOUNTED LIGHTING FIXTURE.
- TWO (2) POLE OR STANCHION MOUNTED LIGHTING FIXTURES
- POLE MOUNTED FIXTURE WITH GF RECEPTACLE
- 2 LAMP SELF CONTAINED DC EMERGENCY LIGHTING UNIT. LETTER DENOTES FIXTURE TYPE.
- EXIT SIGN WALL MOUNTED (SINGLE FACE WITH INDICATING ARROWS) WITH BATTERY PACK ARROW INDICATES DIRECTION OF EXIT DOOR
- EXIT SIGN PENDANT MOUNTED (DOUBLE FACE WITH INDICATING ARROWS) WITH BATTERY PACK ARROWS INDICATE DIRECTION OF EXIT DOOR
- FIXTURE DESIGNATION SYMBOL. SEE LIGHTING FIXTURE SCHEDULE FOR DESCRIPTION AND TYPE. ALL FIXTURES SHOWN IN A ROOM WITH THIS SYMBOL SHALL BE OF TYPE INDICATED BY LETTER. NUMBER IN SYMBOL INDICATES LAMP WATTAGE AND NUMBER OF LAMPS WHERE MORE THAN ONE (UNLESS OTHERWISE NOTED). NUMBER BELOW SYMBOL INDICATES MOUNTING HEIGHT ABOVE FINISHED FLOOR OR AS NOTED.
- DUPLEX CONVENIENCE RECEPTACLE, 2 POLE, 3 WIRE, 120 VOLTS A.C. 20 AMP RECEPTACLE DESIGNATIONS, FIRST NUMBER DENOTES PANEL, SECOND NUMBER DENOTES CIRCUIT NUMBER. GF-DENOTES GROUND FAULT TYPE. SS-DENOTES SURGE SUPPRESSION TYPE WP-DENOTES WEATHERPROOF ENCLOSURE
- SINGLE CONVENIENCE RECEPTACLE, 2 POLE, 3 WIRE; 120 VOLTS AC. 20 AMP UNLESS NOTED OTHERWISE ON DRAWINGS.
- POWER RECEPTACLE, 2 POLE, 3 WIRE 250 VOLTS A.C. 20 AMP UNLESS NOTED OTHERWISE ON DRAWINGS.
- CLASS 1 DIV 2 WALL OUTLET BOX AND SPECIAL PURPOSE RECEPTACLE, NEMA 7, 20A.
- QUADRAPLEX RECEPTACLE
- HEAT-TRACE OR SPECIAL PURPOSE RECEPTACLE REFERENCE DRAWINGS FOR ADDITIONAL DETAILS
- PAGING UNIT
- PAGING UNIT SPEAKER
- LIGHTING CONTROL SWITCHES:
UPPER-LEFT CHARACTER "a" DENOTES SWITCH DESIGNATION. LOWER-RIGHT CHARACTER "4" DENOTES SWITCH CONTROL
1- SINGLE POLE
2 - TWO POLE
3 - THREE-WAY SWITCH CONTROL
4 - FOUR-WAY SWITCH CONTROL
D - DIMMER CONTROL
OS - OCCUPANCY SENSOR
M - MOTOR RATED SWITCH
T - 24V DC MOMENTARY CONTACT SWITCH
V - VARIABLE SPEED FAN SWITCH

- LP1-2 BRANCH CIRCUIT HOME RUN TO PANELBOARD LETTERS AND NUMERALS INDICATE PANEL AND CIRCUIT NUMBER. AS A MINIMUM, ALL WIRING SHALL BE 3#12 AWG IN 3/4" CONDUIT. #10 AWG WIRE SHALL BE USED FOR RUNS BETWEEN PANEL AND FIRST LIGHTING FIXTURE OR RECEPTACLE EXCEEDING 50 FEET, UNLESS OTHERWISE NOTED ON DRAWING.
- LETTERS AND NUMBERS INDICATE PANEL AND CIRCUIT NUMBER (LP1-2). CROSS LINES INDICATE NUMBER OF CONDUCTORS. HALF HASH MARKS INDICATES NEUTRAL. NUMBER (10) DENOTES WIRE SIZE WHEN NOT #12 AWG. CONTINUE CONDUIT AND WIRE RUN FROM BOX TO DEVICE IN ROOM OR AREA AS NOTED BY BRANCH CIRCUIT NUMBER. #10 AWG WIRING SHALL BE USED FOR RUNS BETWEEN PANEL AND FIRST LIGHTING FIXTURE OR RECEPTACLE EXCEEDING 50 FEET, UNLESS OTHERWISE NOTED ON DRAWING.
- INDICATES GROUND CONDUCTOR
- INDICATES HOMERUN AND CONDUIT TAG OR CONDUCTORS WITHIN RACEWAY
- 042000 9#14 #12G 0.75°C

5 FIRE ALARM SYSTEM

- AUDIO/VISUAL ALARM INDICATOR (HORN/STROBE) NUMBER INDICATES STROBE CANDELLA RATING WHEN OTHER THAN 15
- HORN
- MANUAL PULL STATION
- FIRE ALARM CONTROL PANEL
- BELL
- FIRE ALARM ANNUNCIATOR STATION
- FLOW SWITCH (AIR)
- VALVE TAMPER SWITCH
- END OF LINE RESISTOR
- FLAME DETECTOR
- SMOKE DETECTOR, MULTISENSOR
- SMOKE DETECTOR IONIZATION
- SMOKE DETECTOR PHOTOELECTRIC
- DUCT MOUNTED SMOKE DETECTOR
- THERMAL DETECTOR (FIXED AND RATE OF RISE)
H-HIGH TEMPERATURE
- SIGNAL INPUT MODULE
- SIGNAL MODULE

6 GROUND SYMBOLS

- CADWELD
- GROUNDING ROD
- GROUND TEST WELL
- GROUNDING
- POWER


7 AUXILIARY SYSTEMS

- AUXILIARY DETECTOR
DC - DOOR CONTACT
GD - GLASS-BREAK DETECTOR
MS - MOTION SENSOR
CR - CARD READER
- CONTROL PANEL. THE MIDDLE LETTERS DENOTE AS THE FOLLOWING:
IACP - INTRUSION ALARM CONTROL PANEL
ACP - ALARM CONTROL PANEL
FOPP - FIBER OPTIC PATCH PANEL
- CAMERA
- ALARM BEACON
LETTER INDICATES COLOR
- SPEAKER/HORN
H = HORN
PS = PAGING SPEAKER
- CEILING MOUNTED SPEAKER
- VOICE/DATA COMBINATION OUTLETS:
WIRING DEVICE NOTES: IF SHOWN, UPPER-LEFT CHARACTERS DENOTE PANEL BOARD CIRCUIT FOR POWER OUTLETS. IF SHOWN, LOWER-RIGHT CHARACTERS DENOTE NEMA PLUG AND/OR RECEPTACLE CONFIGURATION.
- DATA OUTLET
- FLOOR MOUNTED DATA OUTLET
- SOUND POWERED TELEPHONE
- FLAT CABLE TRANSITION BOX
- TELEPHONE PUNCH DOWN BLOCK
- PRIVATE BRANCH EXCHANGE
- EXTERNAL PORT NODE
- FIBER CONVERTER
- LINE EXTENDER
- PAGING CONTROL CABINET
- MULTIPLEXOR
- TRANSCEIVER
- MONITOR
- T1 DEMARCATION
- UNINTERRUPTIBLE POWER SUPPLY

REV. NO.	DESCRIPTION	DATE


SEAL

AUBREY A. HAUDRICOURT, P.E.
No. 66861

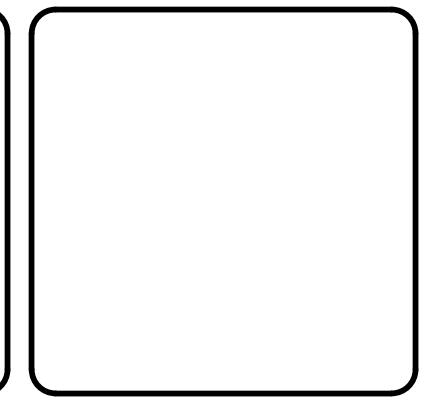

1365 Hamlet Avenue
Clearwater, Florida 33756-3331
Phone: (727) 442-7196, Fax: (727) 461-3827

CA Lic. No. 29588
www.mckimcreed.com

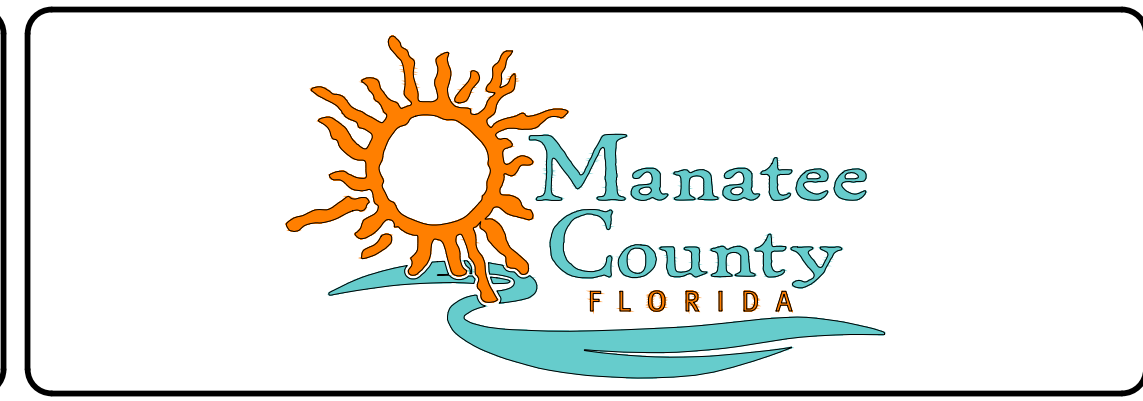

**CORTEZ BOOSTER PUMP STATION
UPGRADES**


ELECTRICAL

ELECTRICAL SYMBOLS 2 OF 2

PROJ. START DATE: MAR. 2020 MCE PROJ. # 01024-0193 DRAWN JG DESIGNED AAH CHECKED MAC PROJ. MGR. BP	SCALE HORIZONTAL: E003 TDB VERTICAL: TDB	DRAWING NUMBER E003 REVISION ----
STATUS: <p align="center">ISSUED FOR BID</p>		



20 0 20 40
SCALE: 1" = 40'

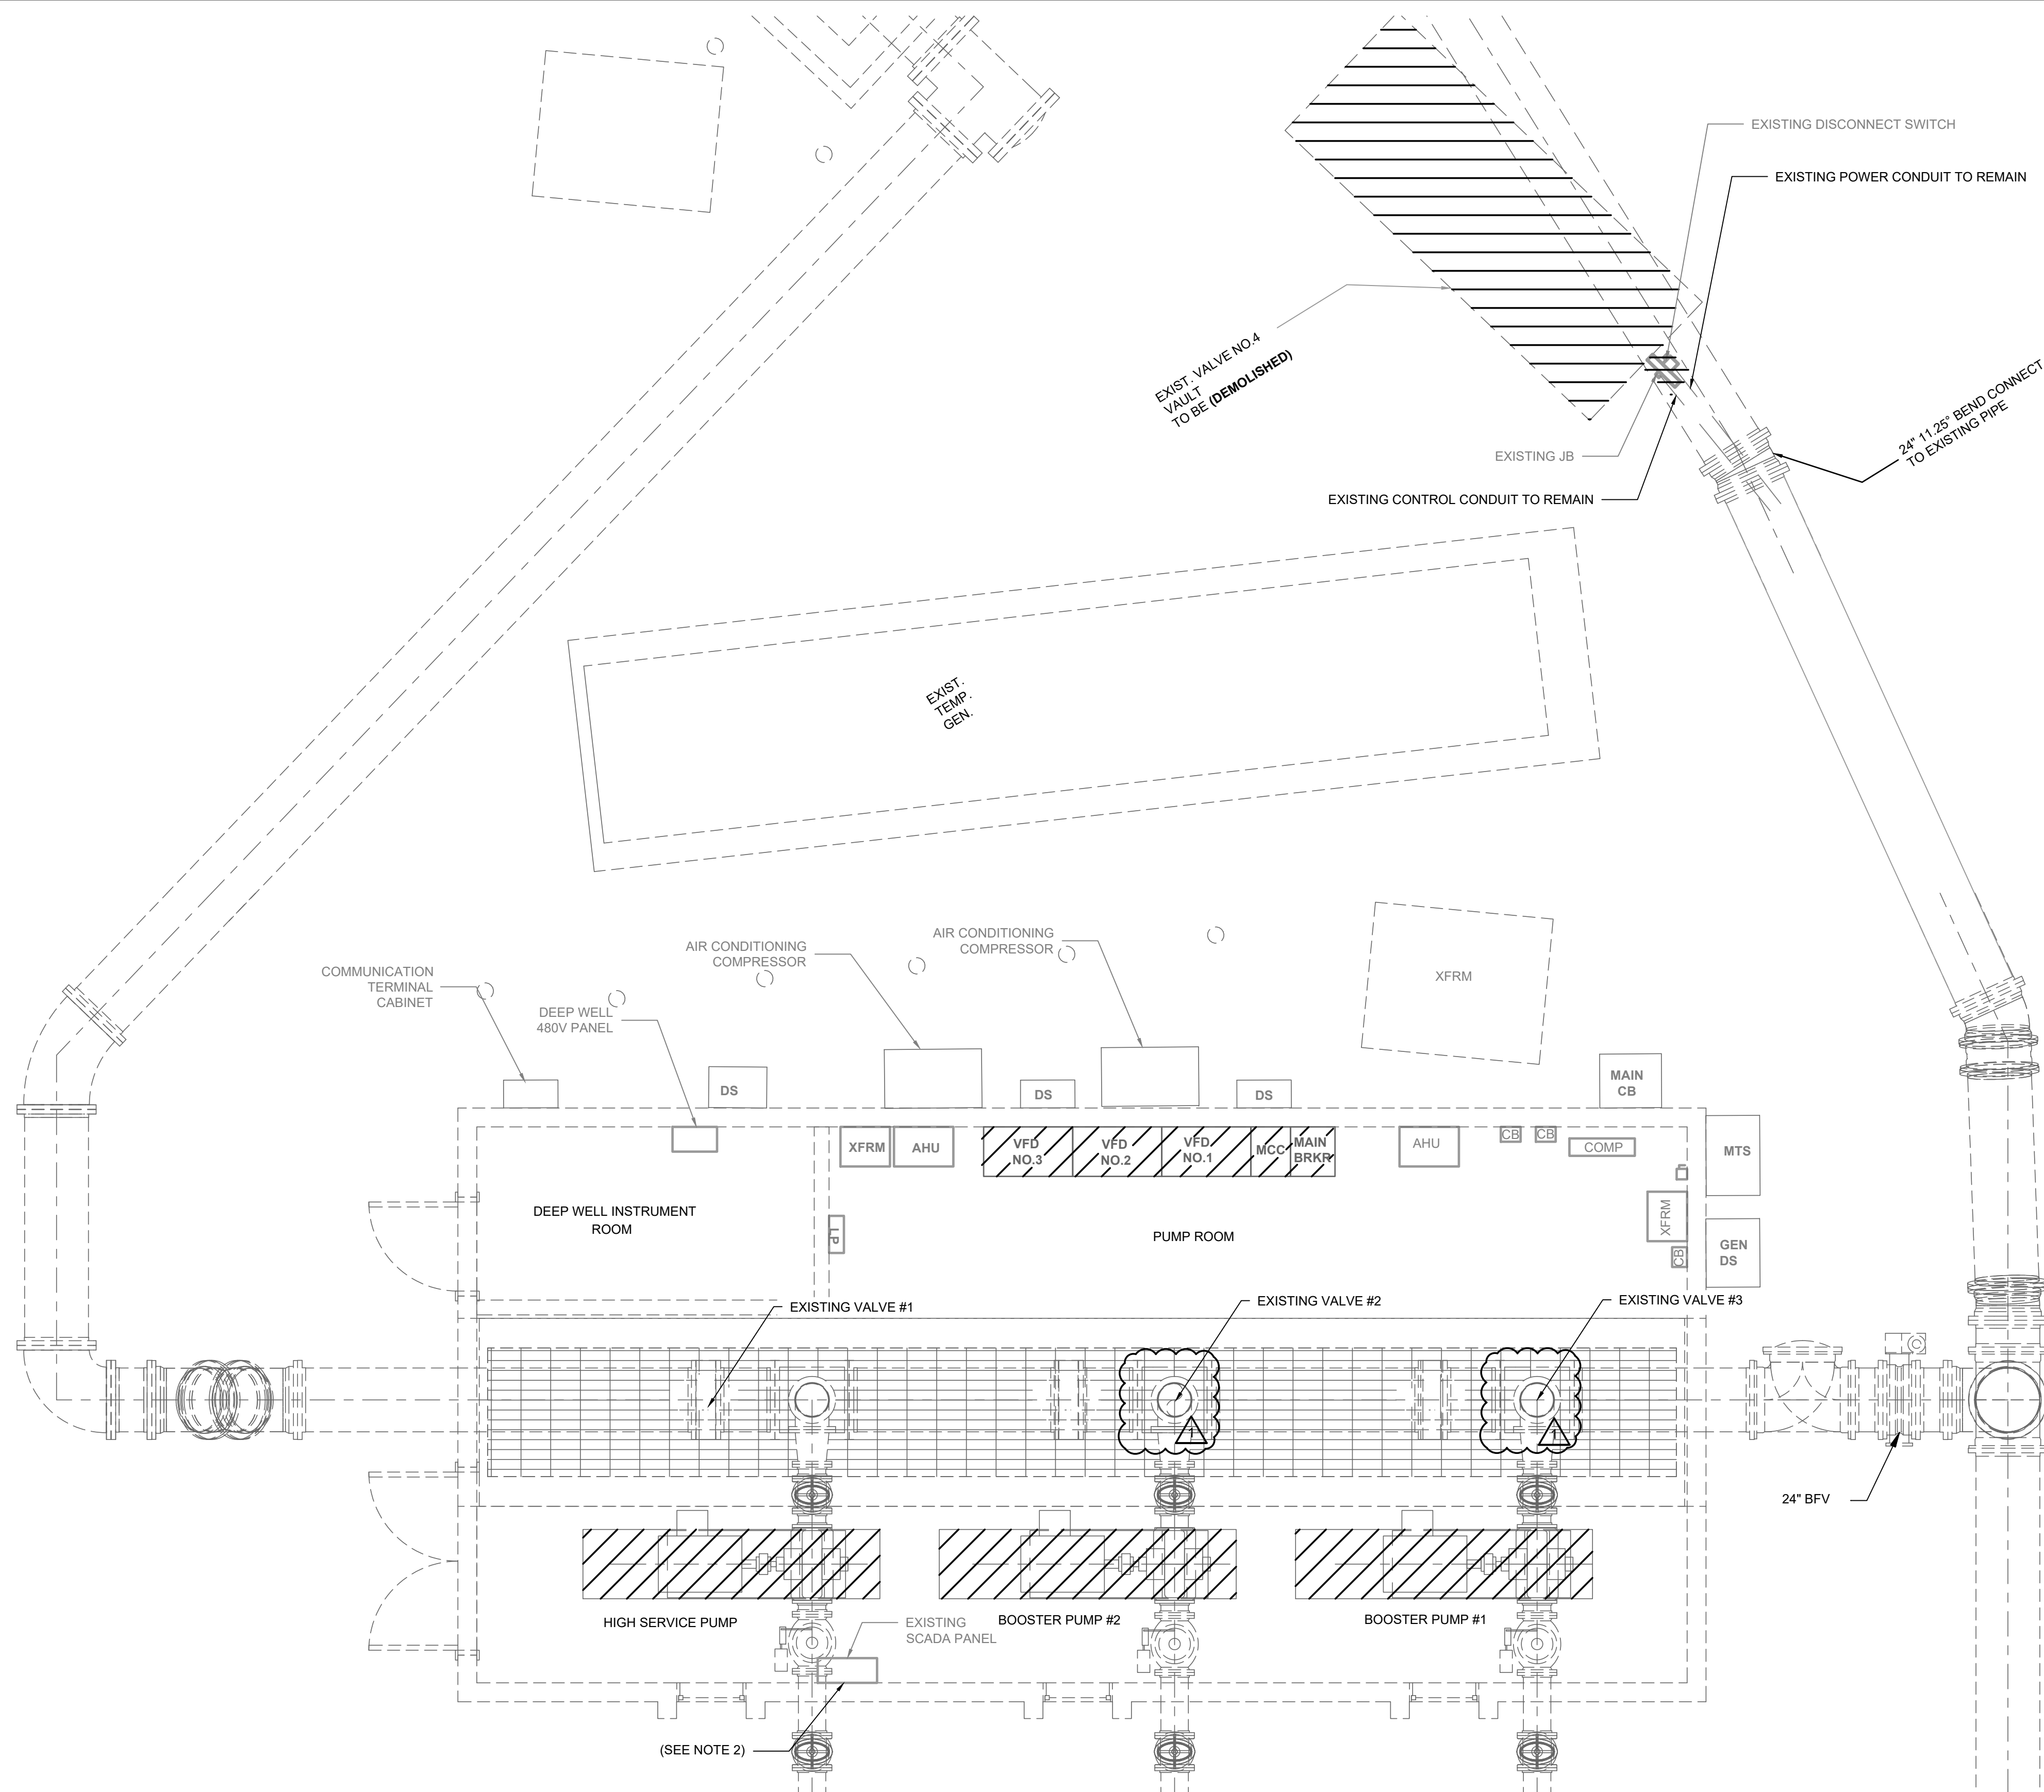

- NOTES:
- CONTRACTOR TO PROVIDE TEMPORARY POWER FOR PUMP #1 (125HP) USING TEMPORARY MOTOR STARTER. USE ACROSS THE LINE STARTER.
 - SCADA PANEL TO BE REMOVED AND REPLACED AS PART OF SEPARATE CONTRACT IN NEW LOCATION SEE E1.02.
 - REMOVE ANY USED CONDUIT AND WIRE DURING INSTALLATION. UNDER GROUND OR SLAB CONDUIT CAP AND ABANDON AFTER EXTRACTING WIRE.

DEMOLITION LEGEND



REV. NO.	DESCRIPTION	DATE
1	ADDENDUM - REMOVAL OF PROPOSED VALVES	11-14-22
REVISIONS		

SEAL

AUBREY A. HAUDRICOURT, P.E.
No. 66861

1365 Hamlet Avenue
Clearwater, Florida 33756-3331
Phone: (727) 442-7196, Fax: (727) 461-3827

CA Lic. No. 29588
www.mckimcreed.com




CORTEZ BOOSTER PUMP STATION UPGRADES

ELECTRICAL


SITE AND PUMP ROOM DEMOLITION PLAN

PROJ. START DATE: MAR. 2020	SCALE
MCE PROJ. # 01024-0193	HORIZONTAL: E1.01
DRAWN: JG	TBD
DESIGNED: AAH	VERTICAL: TBD
CHECKED: MAC	REVISION
PROJ. MGR: BP	----

STATUS: ISSUED FOR BID

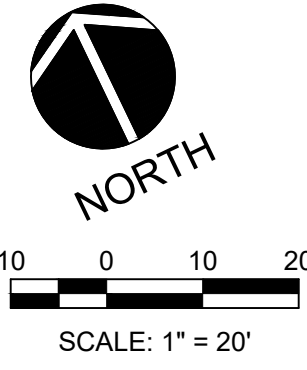

- NOTES:
1. ALL THE NEW JUNCTION BOXES SHOULD BE NEMA 4X, SS.
 2. INSTALL CONDUIT SUPPORT FROM VFD TO SCADA PANEL FOR SIGNAL WIRE.
 3. REUSE EXISTING CONDUIT WHERE POSSIBLE BUT PULL IN NEW WIRE, REUSE EXISTING CONDUIT SUPPORT WHERE POSSIBLE.

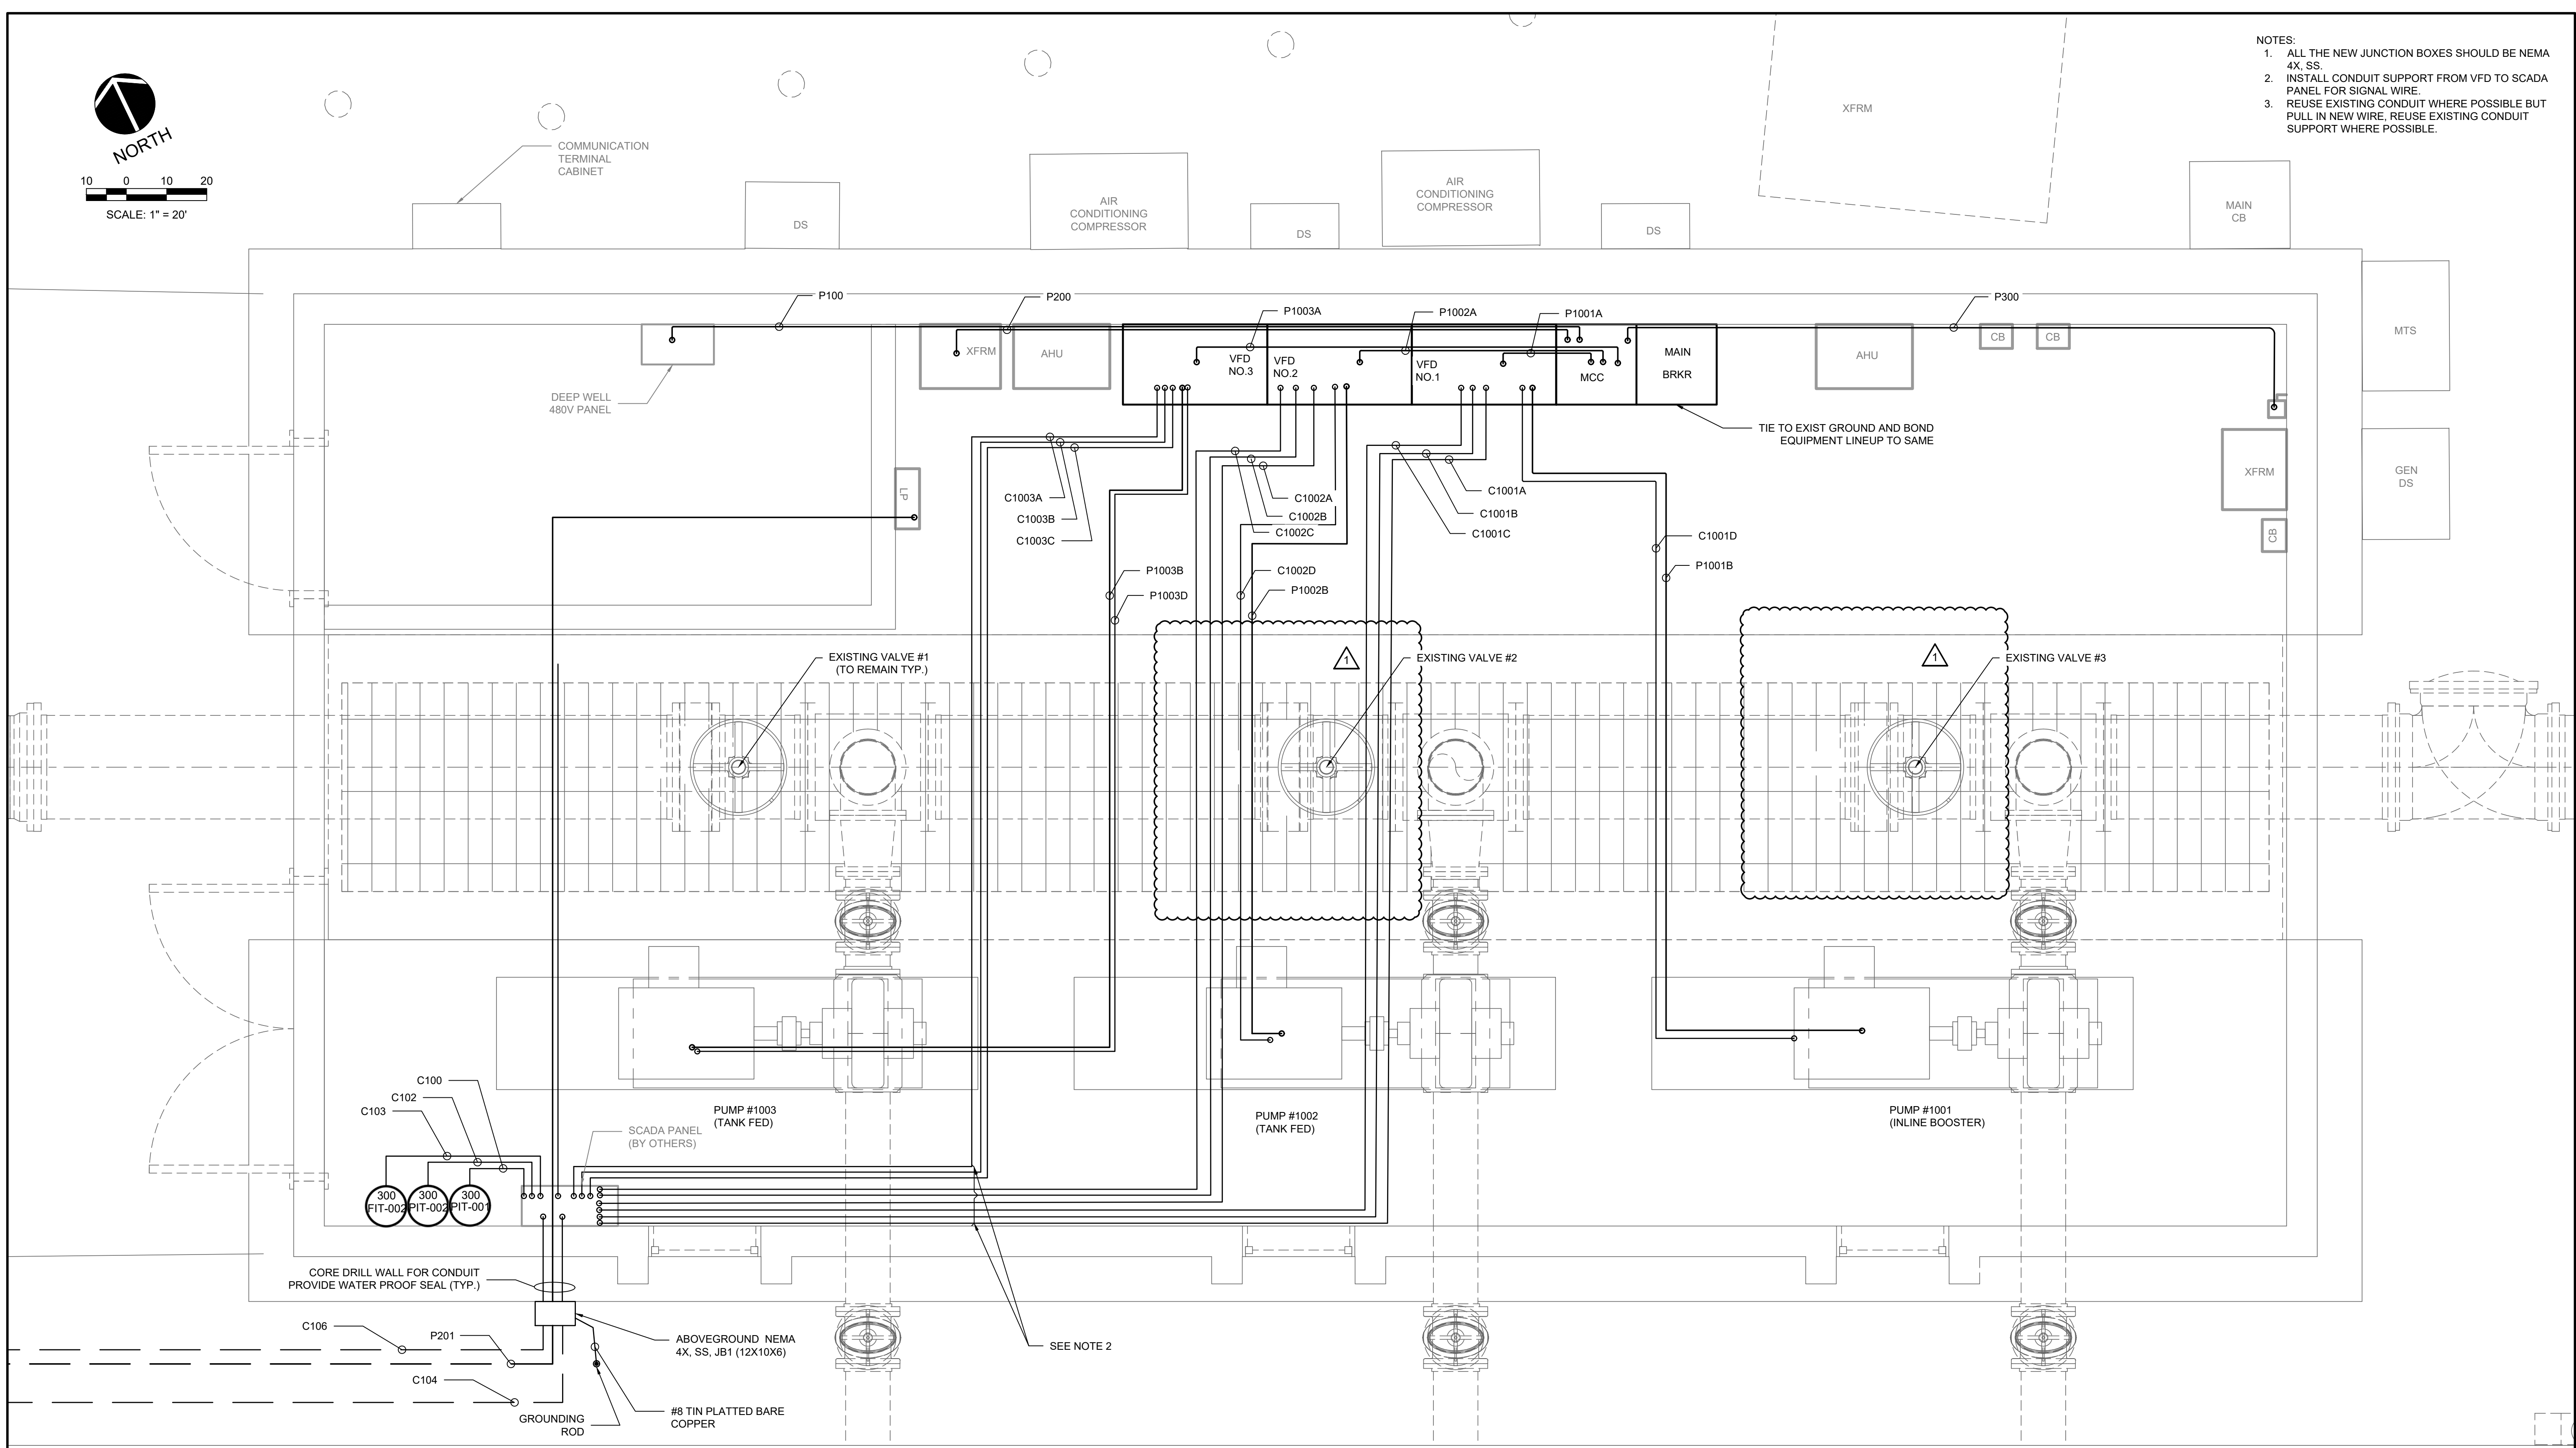

PROPOSED ELECTRICAL PUMP ROOM PLAN
SCALE: 1"=20'-0"

REV. NO.	DESCRIPTION	DATE
1	ADDENDUM - REMOVAL OF PROPOSED VALVES	11/14/2022
REVISIONS		

SEAL

AUBREY A. HAUDRICOURT, P.E.
No. 66861

1365 Hamlet Avenue
Clearwater, Florida 33756-3331
Phone: (727) 442-7196, Fax: (727) 461-3827

CA Lic. No. 29598
www.mckimcreed.com





CORTEZ BOOSTER PUMP STATION UPGRADES

ELECTRICAL


PROPOSED ELECTRICAL BUILDING PLAN

PROJ. START DATE: MAR. 2020	SCALE	E1.02 DRAWING NUMBER 1 REVISION
MCE PROJ. # 01024-0193	HORIZONTAL: TBD	
DRAWN: JG	VERTICAL: TBD	
DESIGNED: AAH		
CHECKED: MAC		
PROJ. MGR: BP		
STATUS: ISSUED FOR BID		

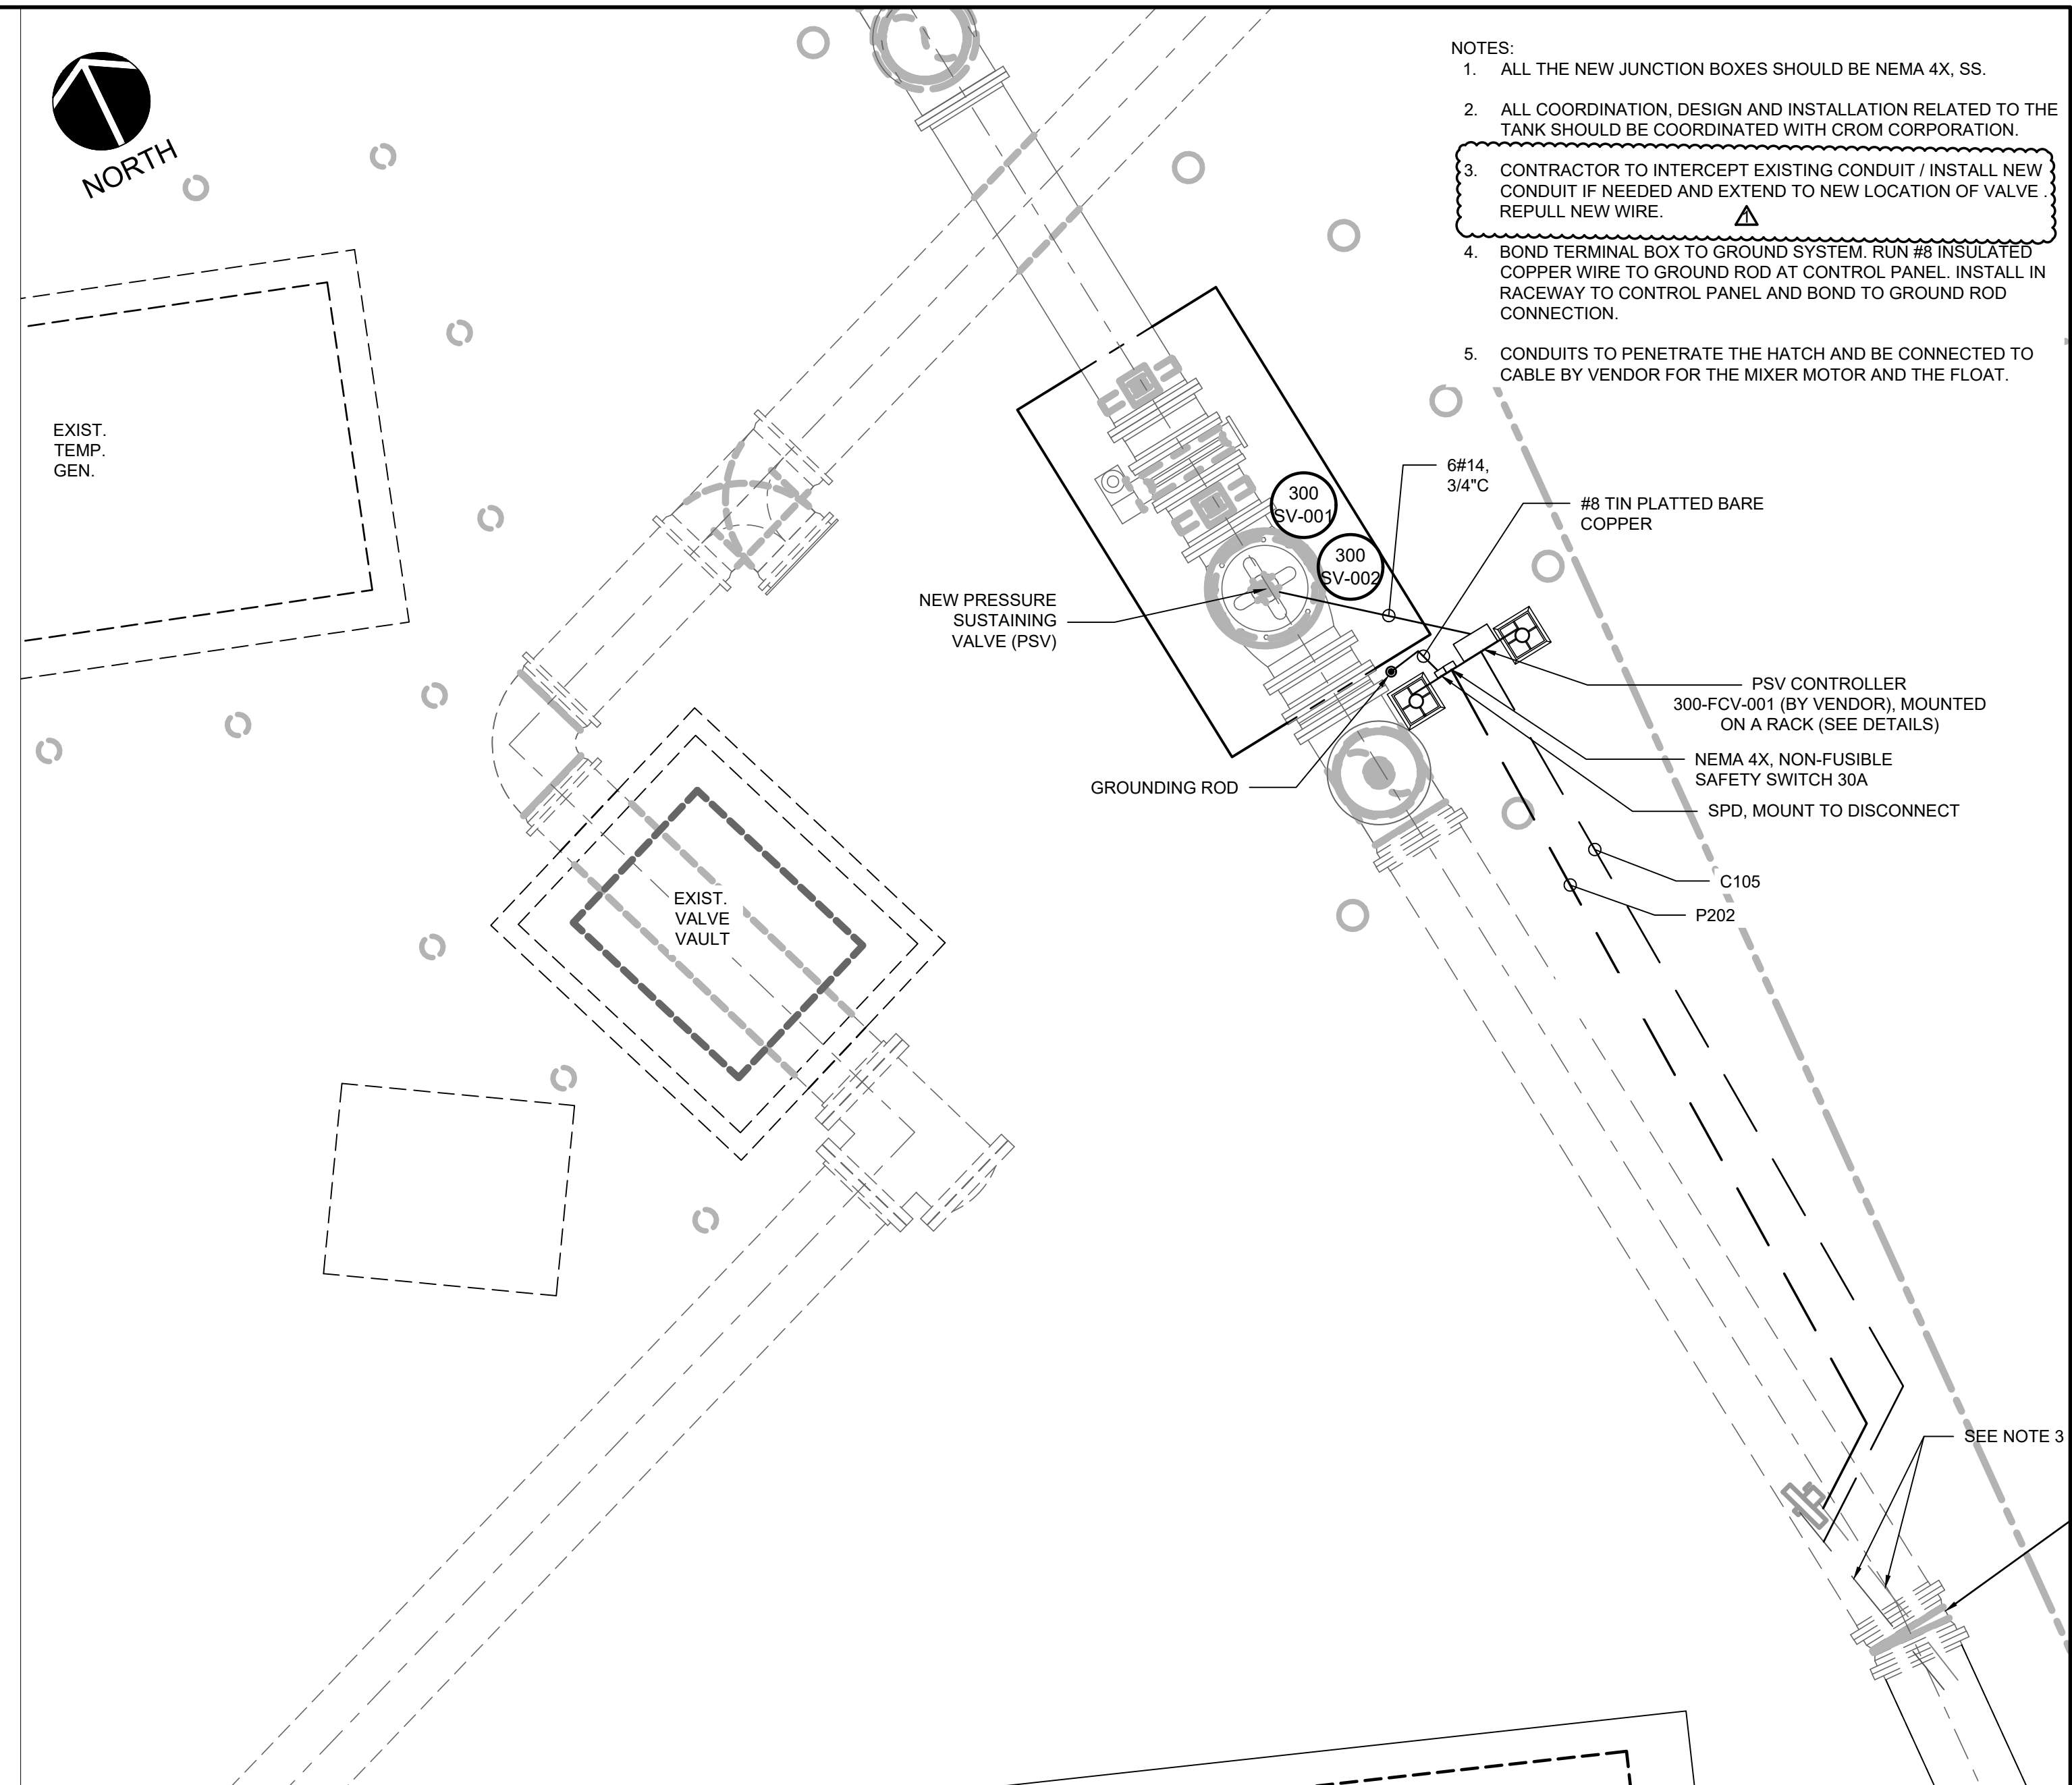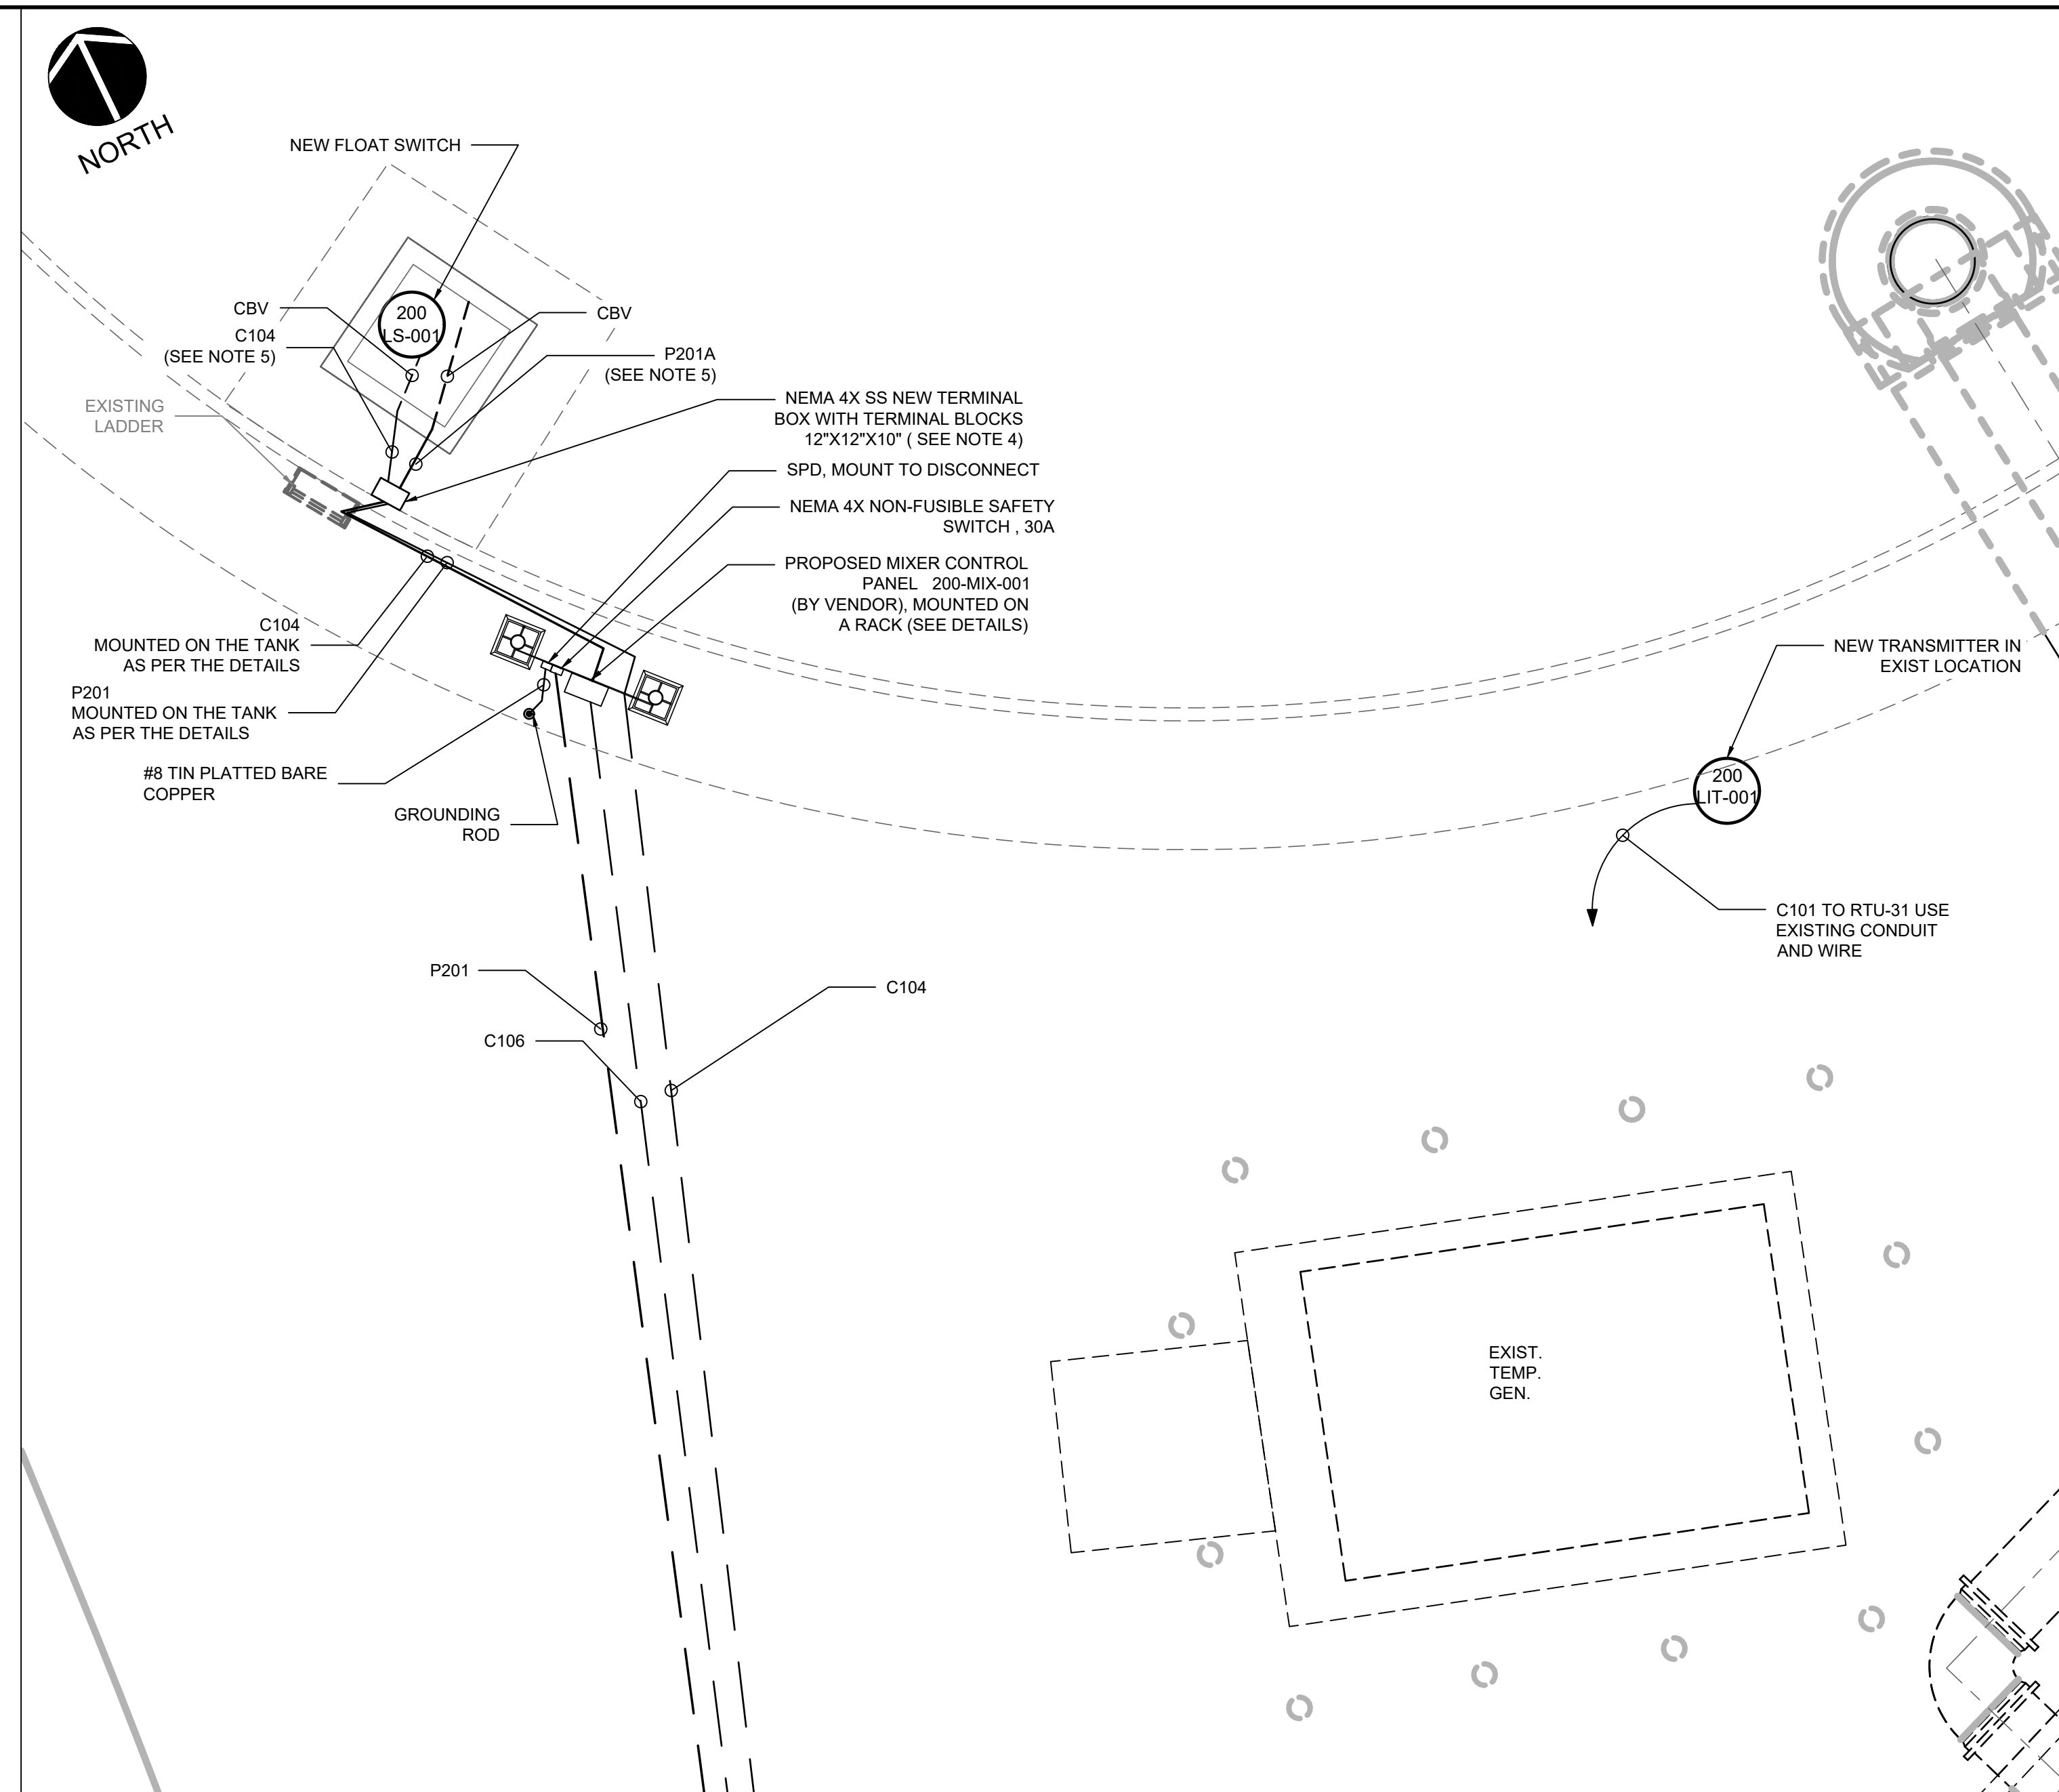


- NOTES:
1. ALL THE NEW JUNCTION BOXES SHOULD BE NEMA 4X, SS.
 2. ALL COORDINATION, DESIGN AND INSTALLATION RELATED TO THE TANK SHOULD BE COORDINATED WITH CROM CORPORATION.
 3. CONTRACTOR TO INTERCEPT EXISTING CONDUIT / INSTALL NEW CONDUIT IF NEEDED AND EXTEND TO NEW LOCATION OF VALVE. REPULL NEW WIRE.
 4. BOND TERMINAL BOX TO GROUND SYSTEM. RUN #8 INSULATED COPPER WIRE TO GROUND ROD AT CONTROL PANEL. INSTALL IN RACEWAY TO CONTROL PANEL AND BOND TO GROUND ROD CONNECTION.
 5. CONDUITS TO PENETRATE THE HATCH AND BE CONNECTED TO CABLE BY VENDOR FOR THE MIXER MOTOR AND THE FLOAT.

PROPOSED PARTIAL ELECTRICAL SITE PLAN 1

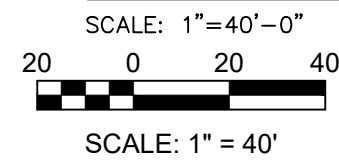

PROPOSED PARTIAL ELECTRICAL SITE PLAN 2

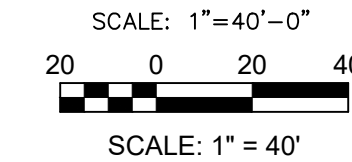

REV. NO.	DESCRIPTION	DATE
1	ADDENDUM - REMOVAL OF PROPOSED VALVES	11/14/2022
REVISIONS		

SEAL

AUBREY A. HAUDRICOURT, P.E.
No. 66861

1365 Hamlet Avenue
Clearwater, Florida 33756-3331
Phone: (727) 442-7196, Fax: (727) 461-3827

CA Lic. No. 29588
www.mckimcreed.com



CORTEZ BOOSTER PUMP STATION UPGRADES

ELECTRICAL

PROPOSED PARTIAL ELECTRICAL SITE PLAN

PROJ. START DATE: MAR. 2020	SCALE
MCE PROJ. # 01024-0193	HORIZONTAL: TBD
DRAWN JG	VERTICAL: TBD
DESIGNED AAH	
CHECKED MAC	
PROJ. MGR. BP	

E1.03


DRAWING NUMBER

1

REVISION

STATUS: ISSUED FOR BID

- NOTES:
- PANEL TO REMAIN. REUSE THE EXISTING CONDUIT.
 - XFMR TO REMAIN. REUSE THE EXISTING CONDUIT.
 - CONDUIT TO REMAIN. REPULL NEW WIRE. REFER TO SHEET E1.01 FOR ADDITIONAL INFORMATION.

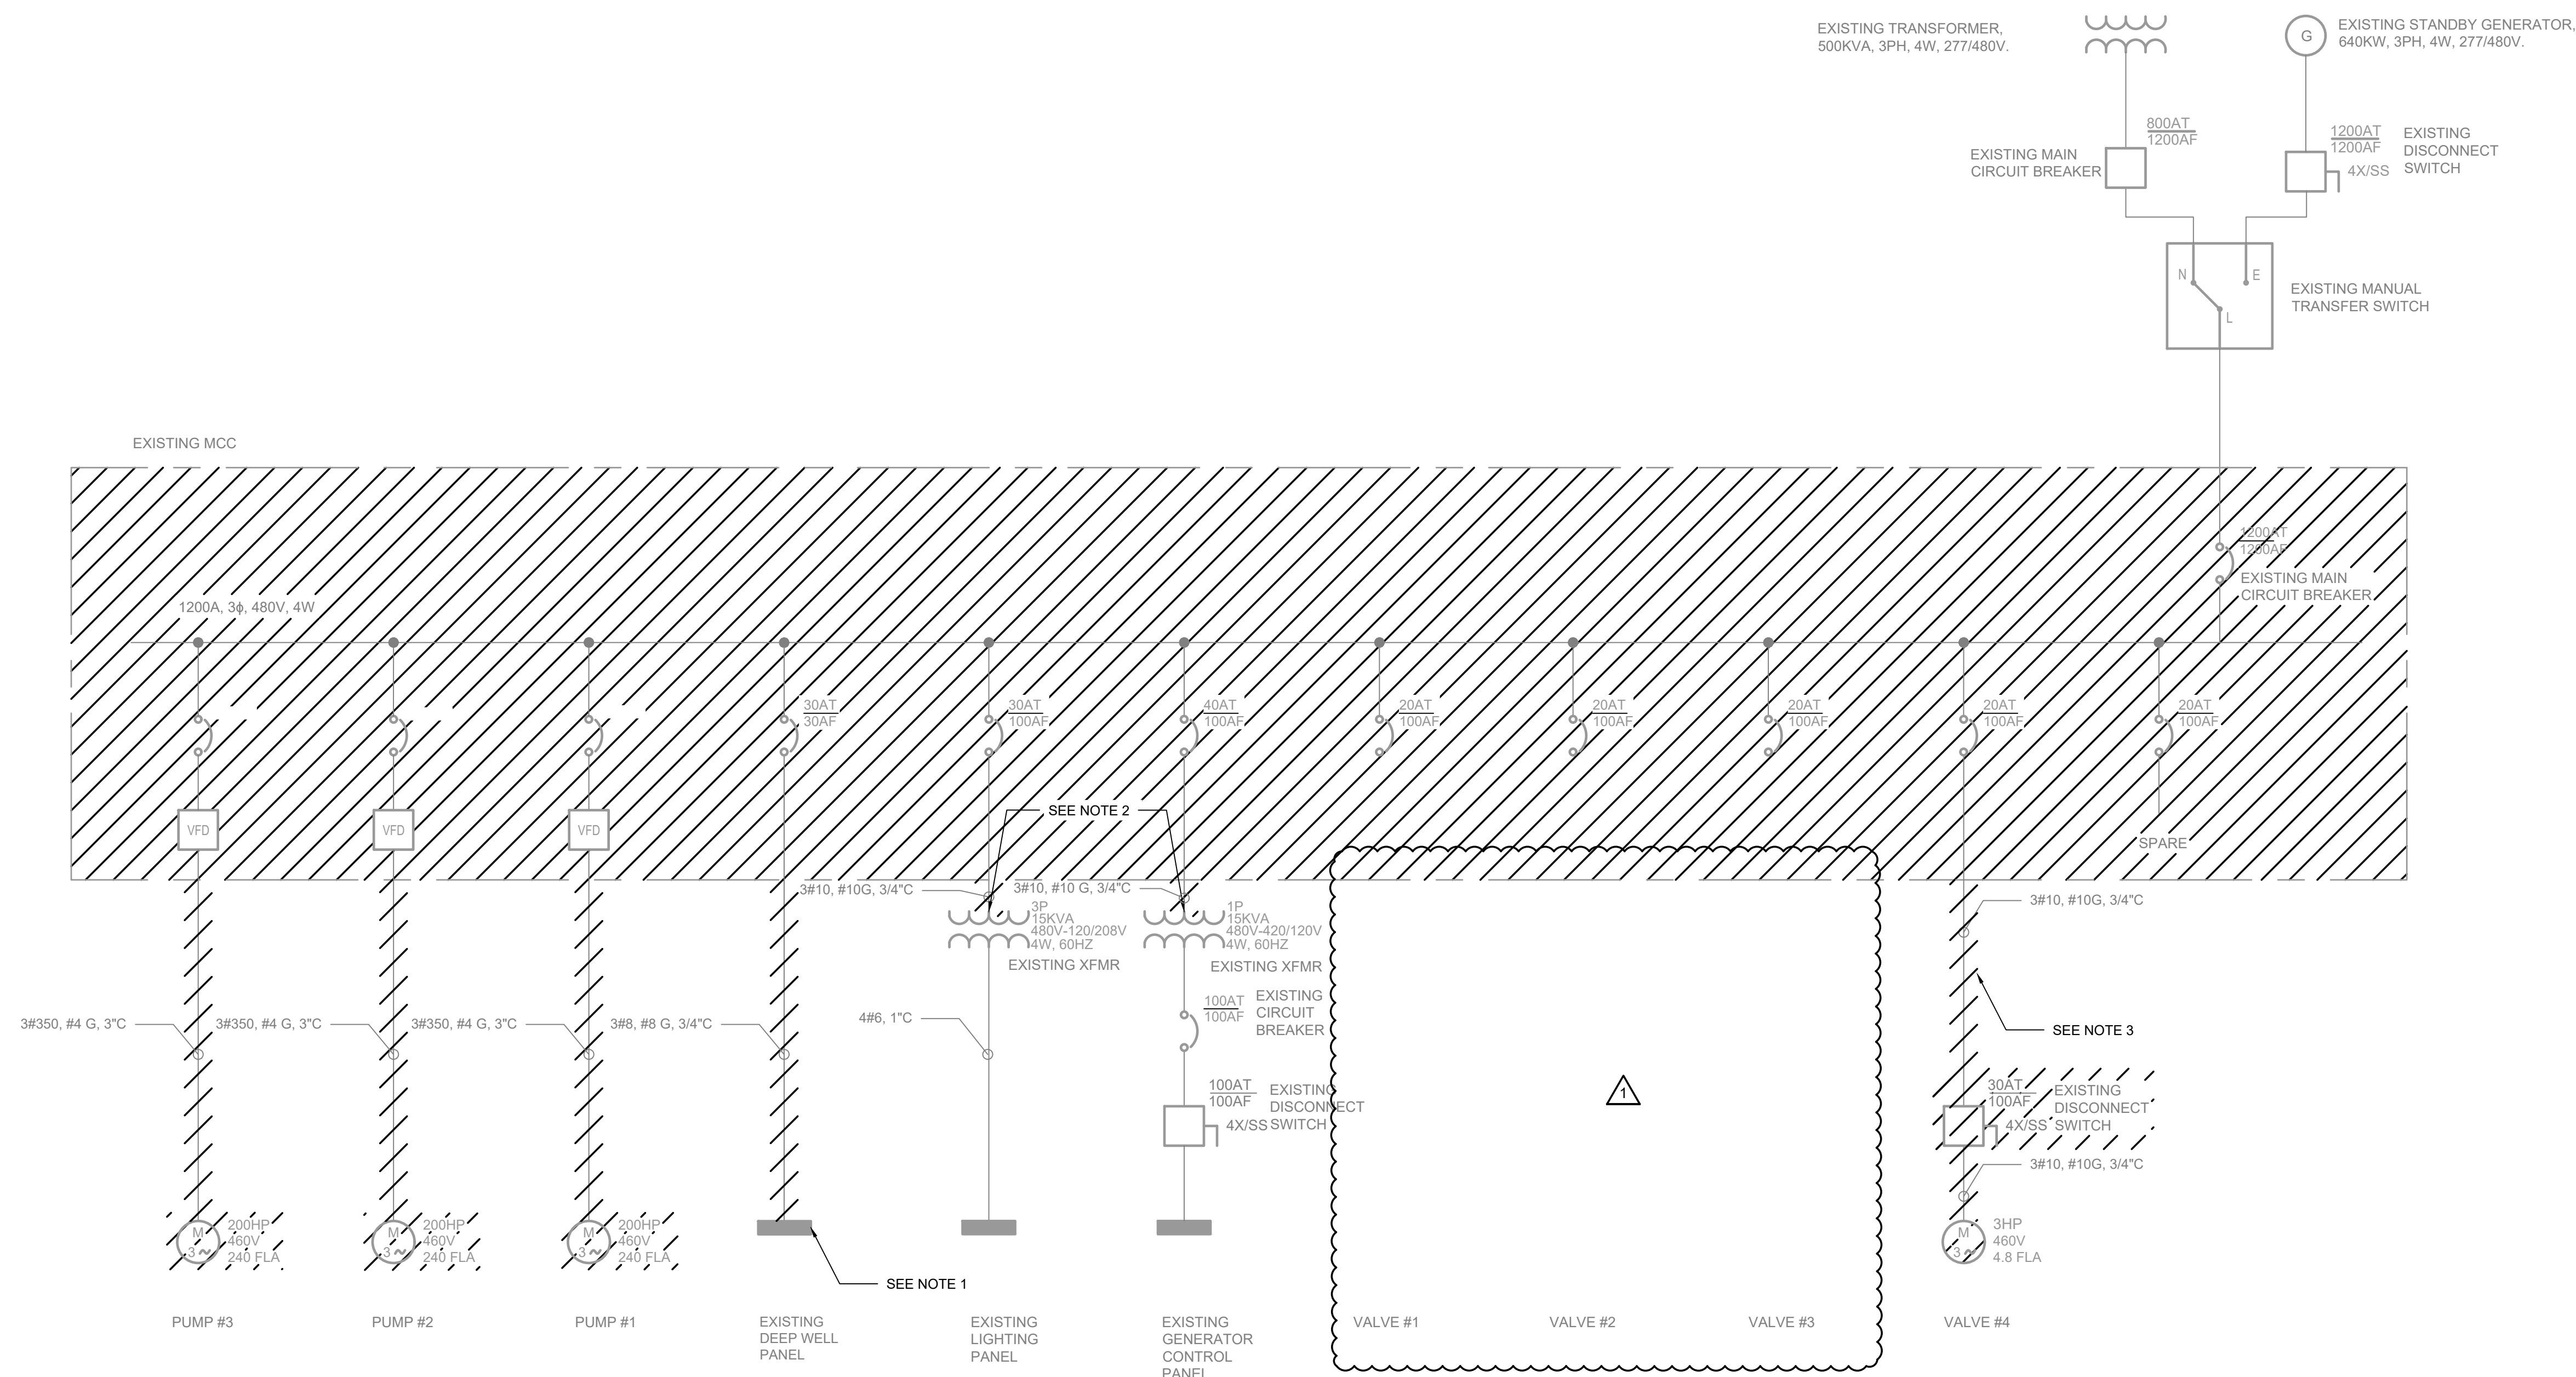

REV. NO.	DESCRIPTION	DATE
1	ADDENDUM - REMOVAL OF PROPOSED VALVES	11/14/2022
REVISIONS		

SEAL

AUBREY A. HAUDRICOURT, P.E.
No. 66861

MCKIM & CREED

1365 Hamlet Avenue
Clearwater, Florida 33756-3331
Phone: (727) 442-7196, Fax: (727) 461-3827

CA Lic. No. 29588
www.mckimcreed.com



CORTEZ BOOSTER PUMP STATION UPGRADES

ELECTRICAL

EXISTING & DEMOLITION ONE LINE

PROJ. START DATE: MAR. 2020
MCE PROJ. # 01024-0193
DRAWN JG
DESIGNED AAH
CHECKED MAC
PROJ. MGR. BP

SCALE

HORIZONTAL: **E2.01**

TBD


VERTICAL: **1**

TBD

REVISION

STATUS: **ISSUED FOR BID**

NOTES:
 1. ALL THE VFDS ARE SIZED FOR 200HP WITH ADJUSTING SETTINGS FOR 125HP FOR ANY FUTURE UPGRADES.

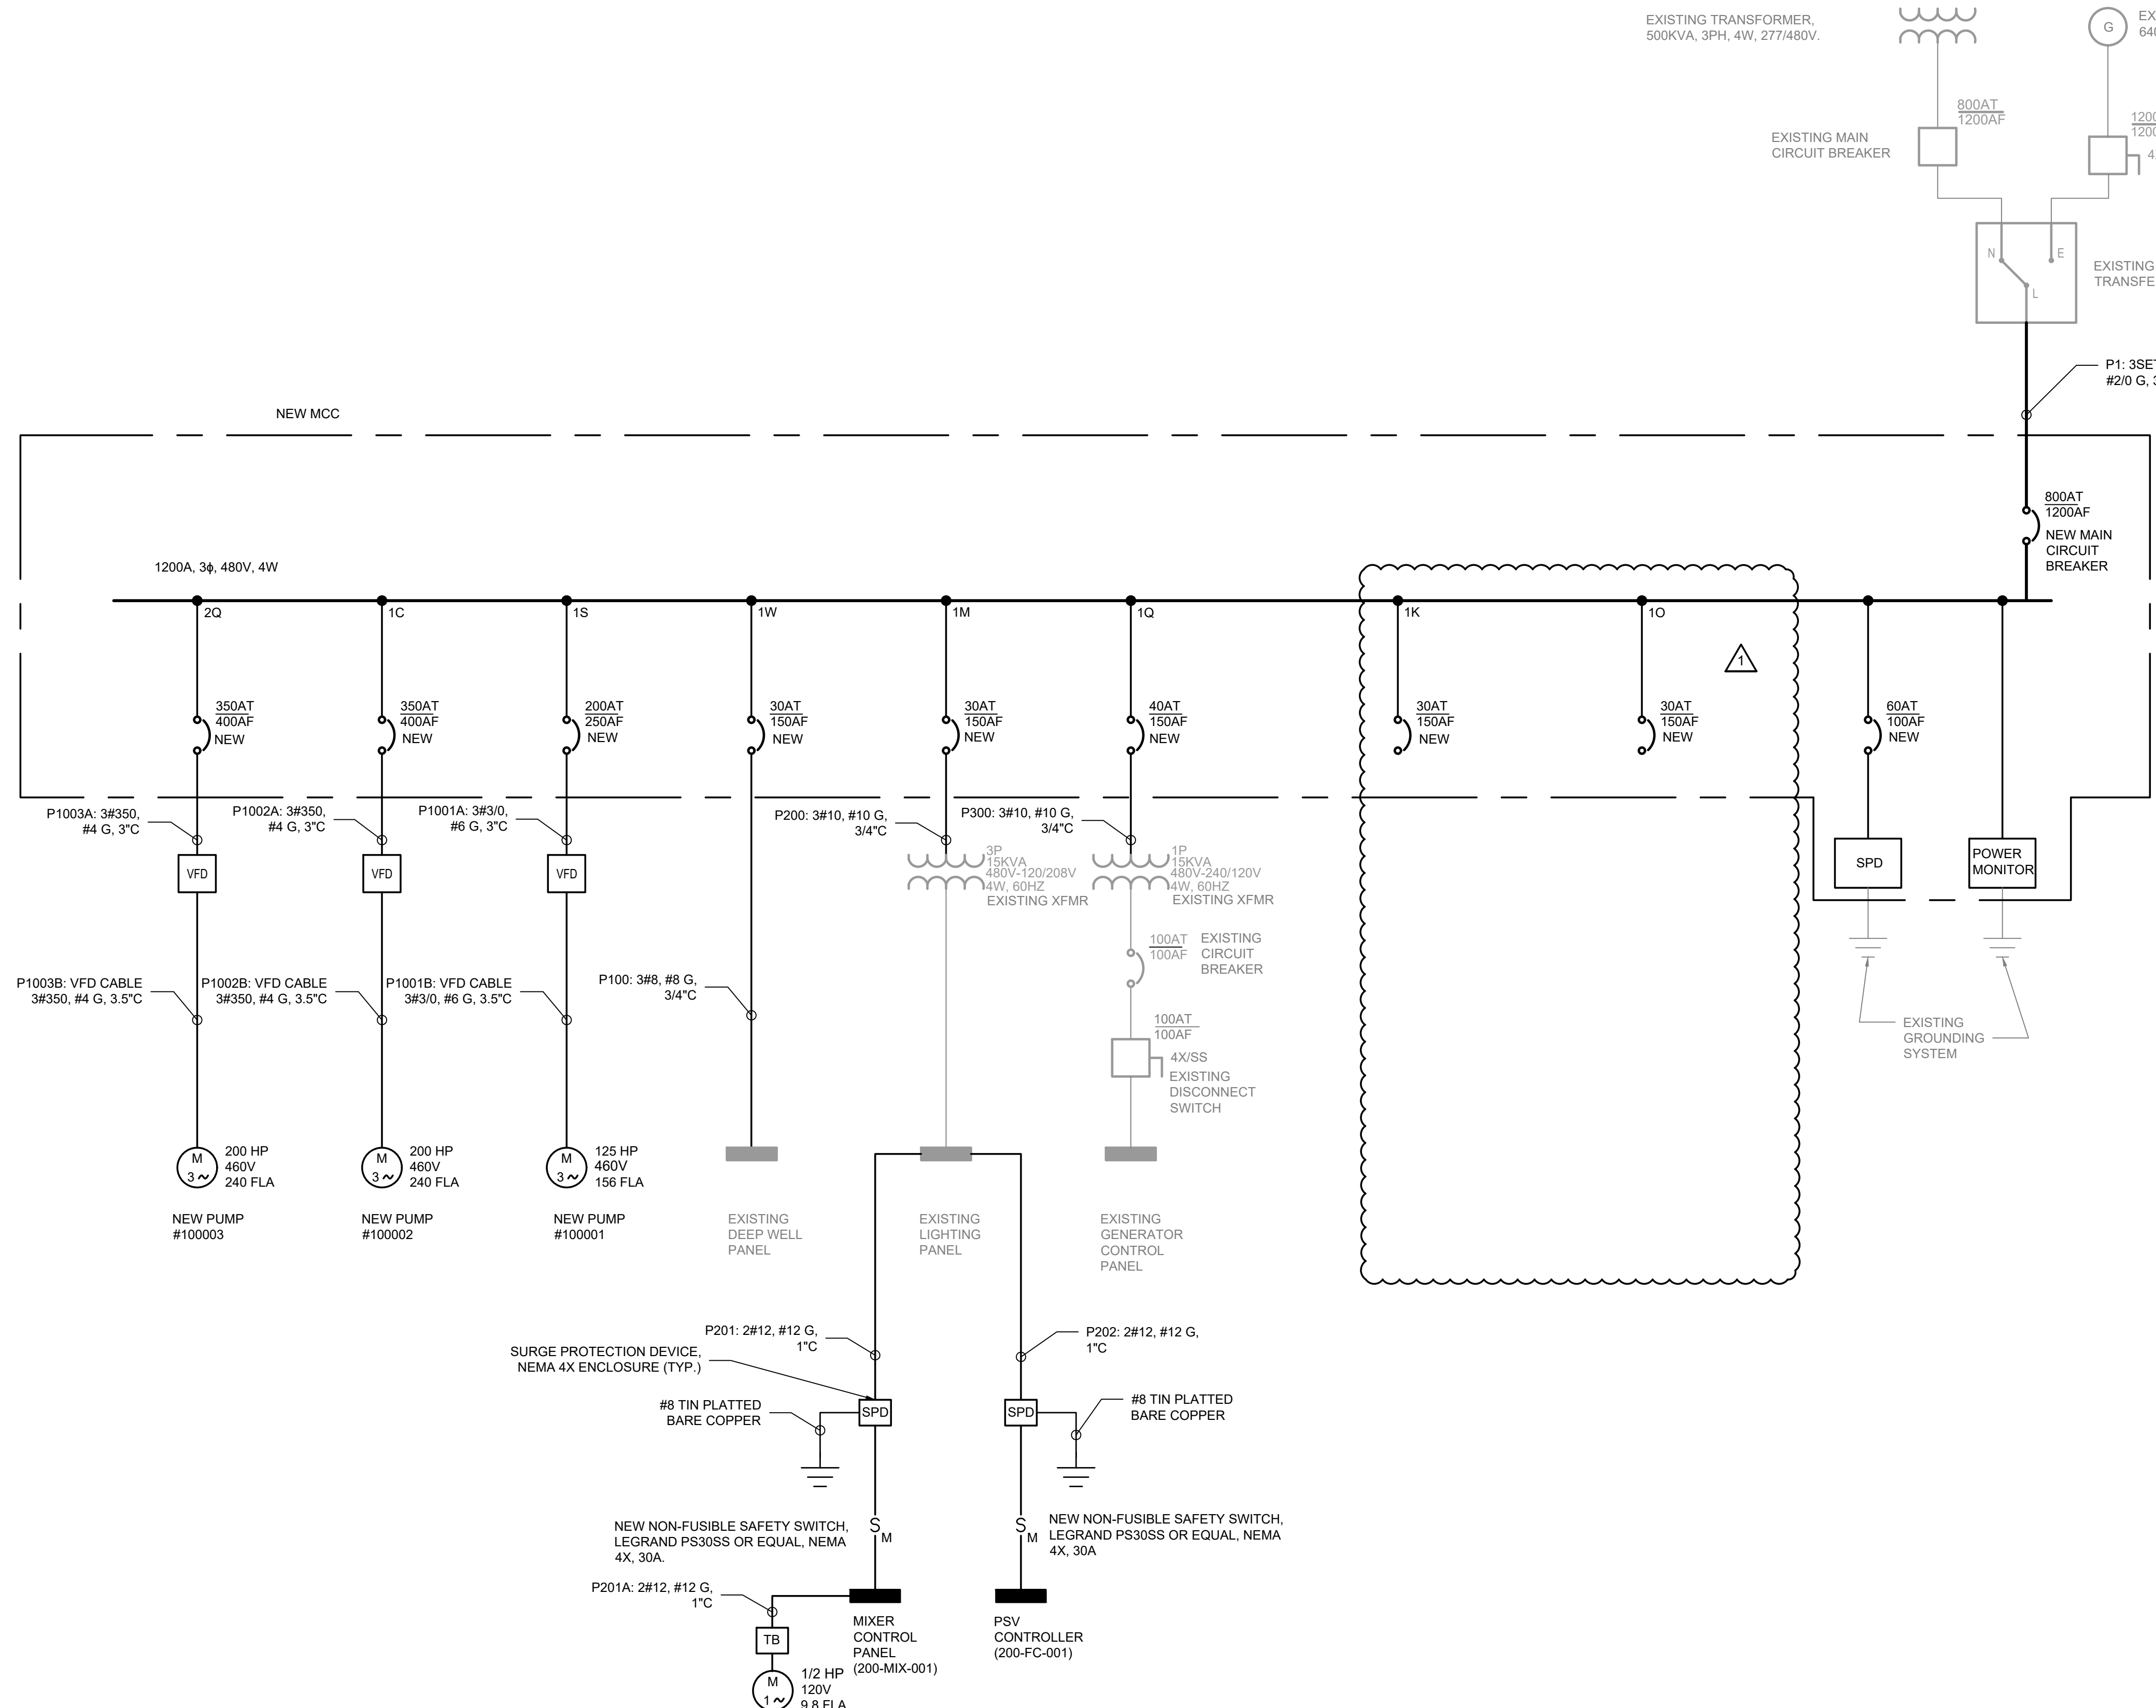


EXISTING TRANSFORMER, 500KVA, 3PH, 4W, 277/480V.
 EXISTING MAIN CIRCUIT BREAKER
 EXISTING STANDBY GENERATOR, 640KW, 3PH, 4W, 277/480V.
 EXISTING DISCONNECT SWITCH
 EXISTING MANUAL TRANSFER SWITCH


LOAD TABLE						
	480V	500 KVA	XFR	106%		
		640 KW	GEN	66%		
MOTOR CONTROL CENTER	3 Ph	800 AT	MCB	80%		
CORTEZ BOOSTER PUMP	3 WIRE	1200 AF	BUSS	53%		
NAME	CONT?	#DUTY	#CON	KVA	HP	FLA
PUMP #2-3	Y	2	2		200.0	480.0
PUMP #1	Y	0	1		125	0.0
XFRM #1	Y		1	15		18.0
XFRM #2	Y		1	15		18.0
DEEP WELL PANEL	Y		1	23		27.6
SUM		DUTY:	0.6819	53.0	540.0	564.6
TOTAL CONNECTED LOAD (A)						564.6
TOTAL RUNNING LOAD					531.9	640.5
		DUTY:	1.134431	NEC 230.42 SE:		700.5 A

REV. NO.	DESCRIPTION	DATE
1	ADDENDUM - REMOVAL OF PROPOSED VALVES	11/14/2022
	REVISIONS	

SEAL
 AUBREY A. HAUDRICOURT, P.E.
 No. 66861

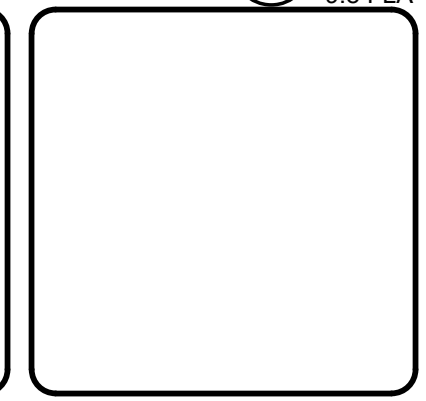

MCKIM & CREED
 1365 Hamlet Avenue
 Clearwater, Florida 33756-3331
 Phone: (727) 442-7196, Fax: (727) 461-3827
 CA Lic. No. 29588
 www.mckimcreed.com

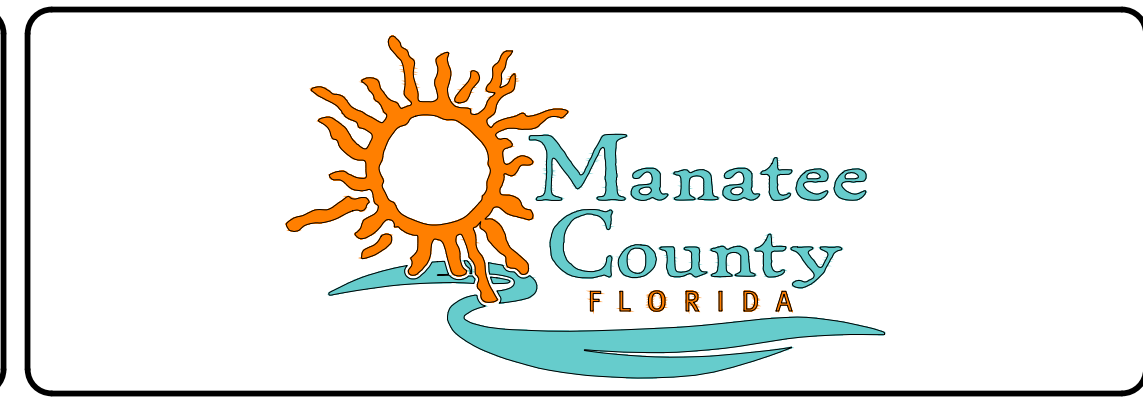


CORTEZ BOOSTER PUMP STATION UPGRADES
 ELECTRICAL
 PROPOSED ONE LINE


PROJ. START DATE: MAR. 2020	SCALE
MCE PROJ. # 01024-0193	HORIZONTAL: E2.02
DRAWN JG	TBD
DESIGNED AAH	VERTICAL: TBD
CHECKED MAC	TBD
PROJ. MGR. BP	1 REVISION

STATUS:
ISSUED FOR BID

EXISTING PUMP ROOM BUILDING

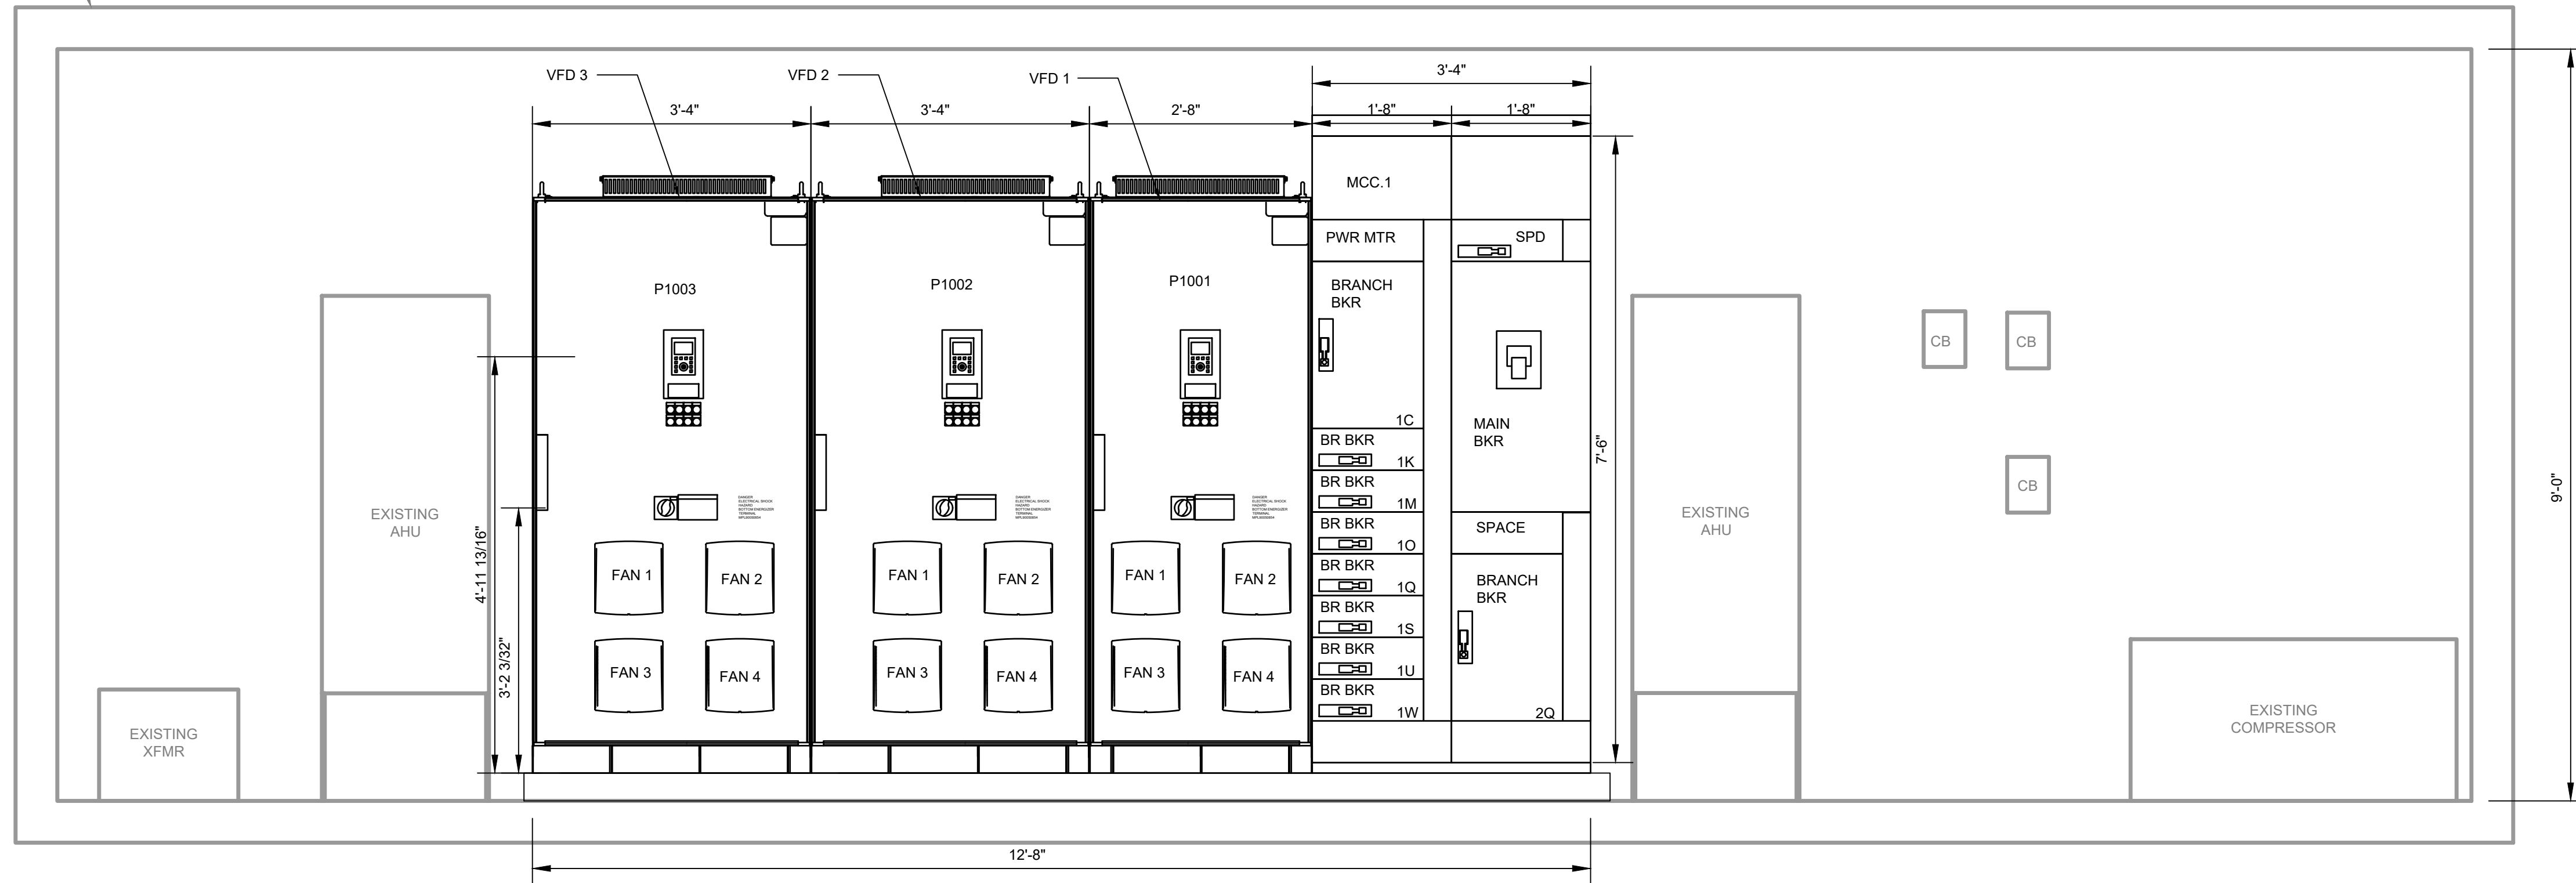

ELEVATION
SCALE: 3/4"=1'-0"

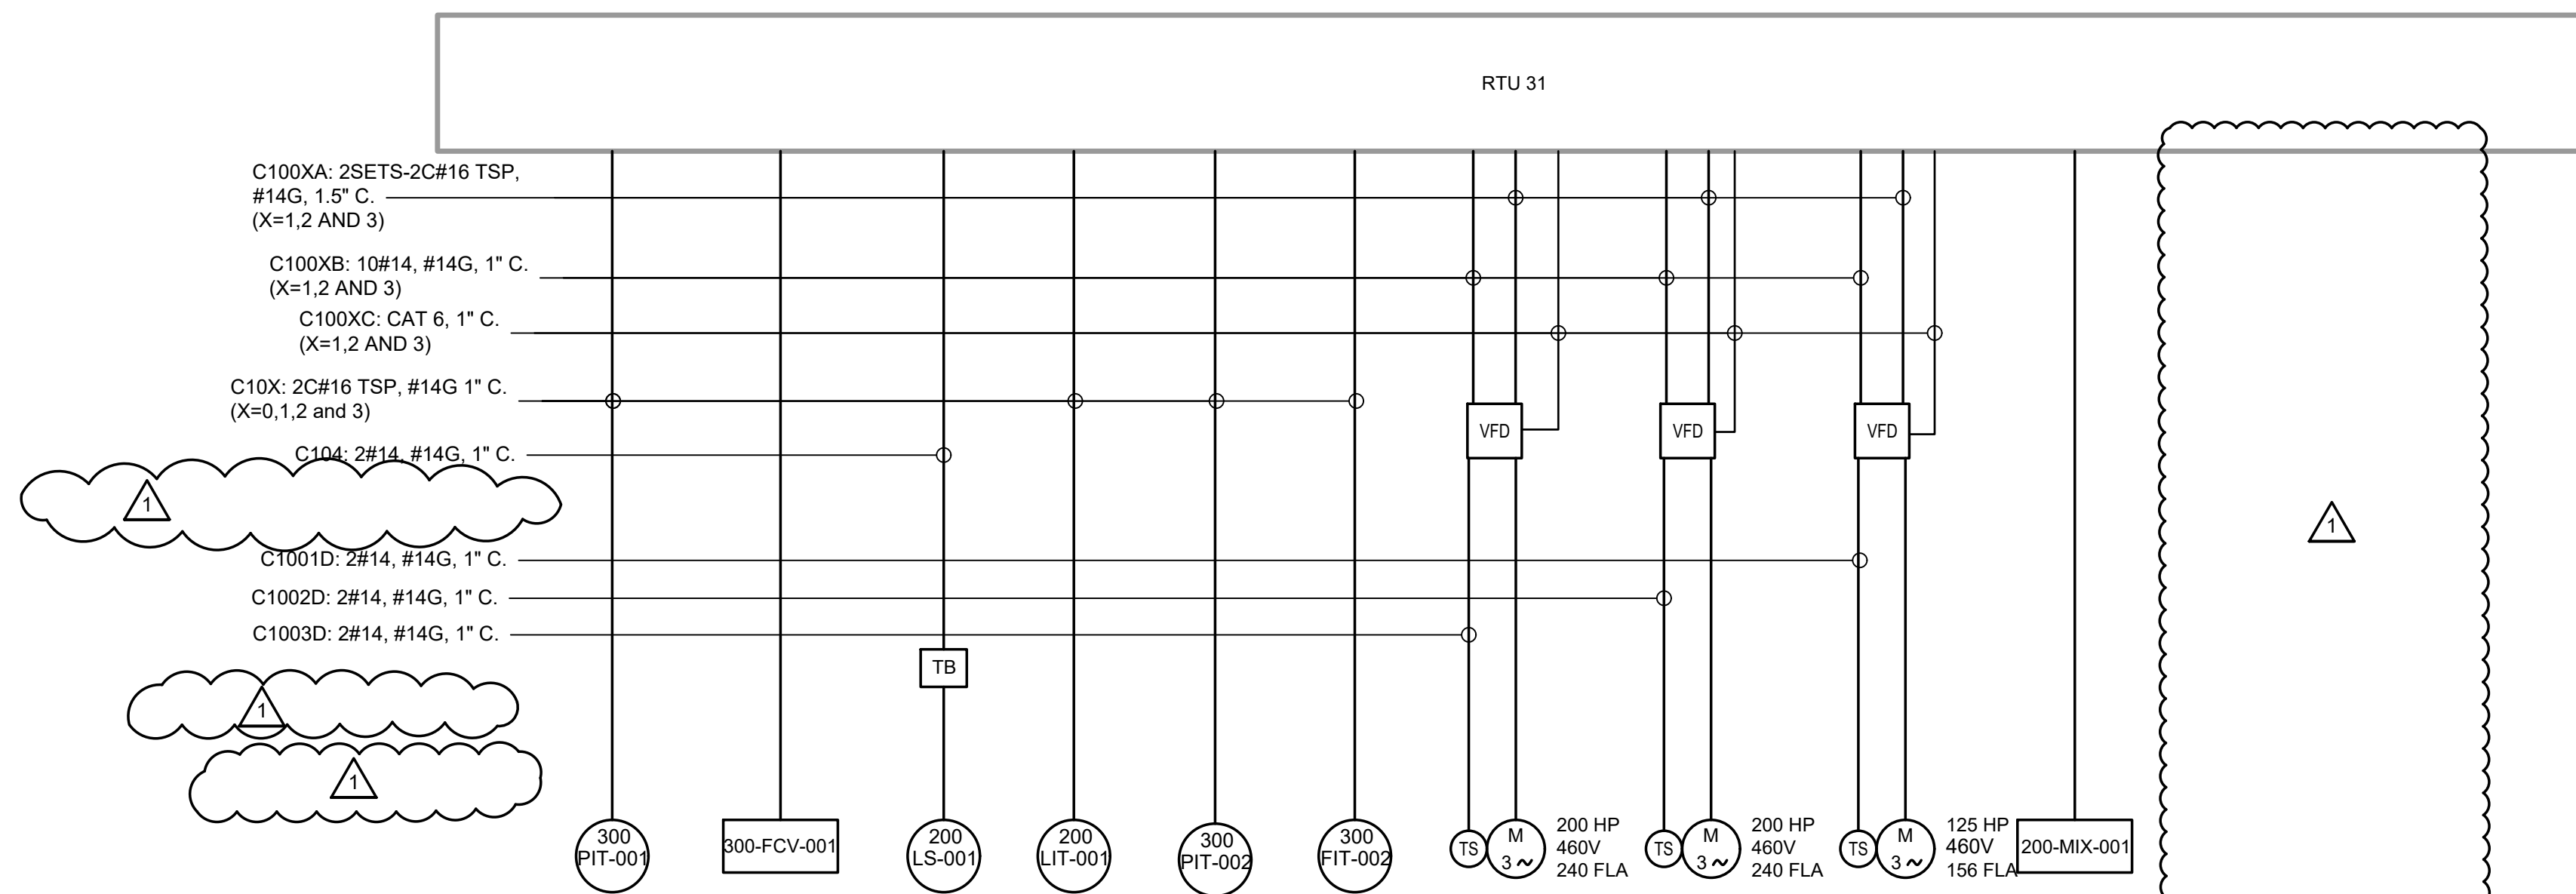

ELECTRICAL INTERCONNECTION DIAGRAM
SCALE: NTS

REV. NO.	DESCRIPTION	DATE
1	ADDENDUM - REMOVAL OF PROPOSED VALVES	11/14/2022
REVISIONS		

SEAL

AUBREY A. HAUDRICOURT, P.E.
No. 66861

MCKIM & CREED

1365 Hamlet Avenue
Clearwater, Florida 33756-3331
Phone: (727) 442-7196, Fax: (727) 461-3827

CA Lic. No. 29598
www.mckimcreed.com



CORTEZ BOOSTER PUMP STATION UPGRADES



ELECTRICAL

ELEVATION AND INTERCONNECT

PROJ. START DATE: MAR. 2020
MCE PROJ. # 01024-0193
DRAWN JG
DESIGNED AAH
CHECKED MAC
PROJ. MGR. BP

SCALE	E3.01
HORIZONTAL: TBD	
VERTICAL: TBD	
1	REVISION

STATUS: ISSUED FOR BID

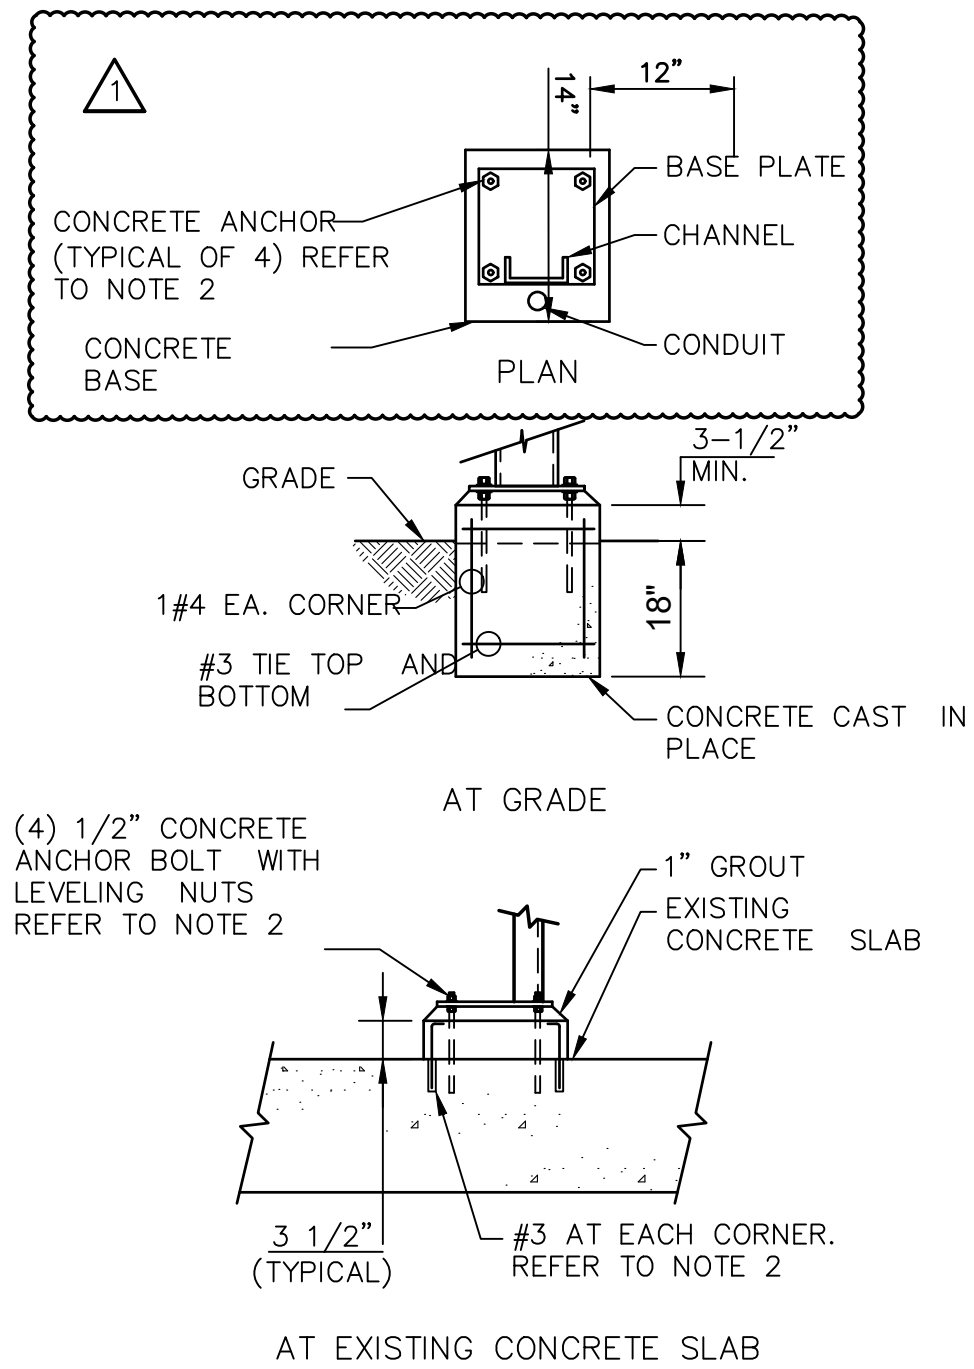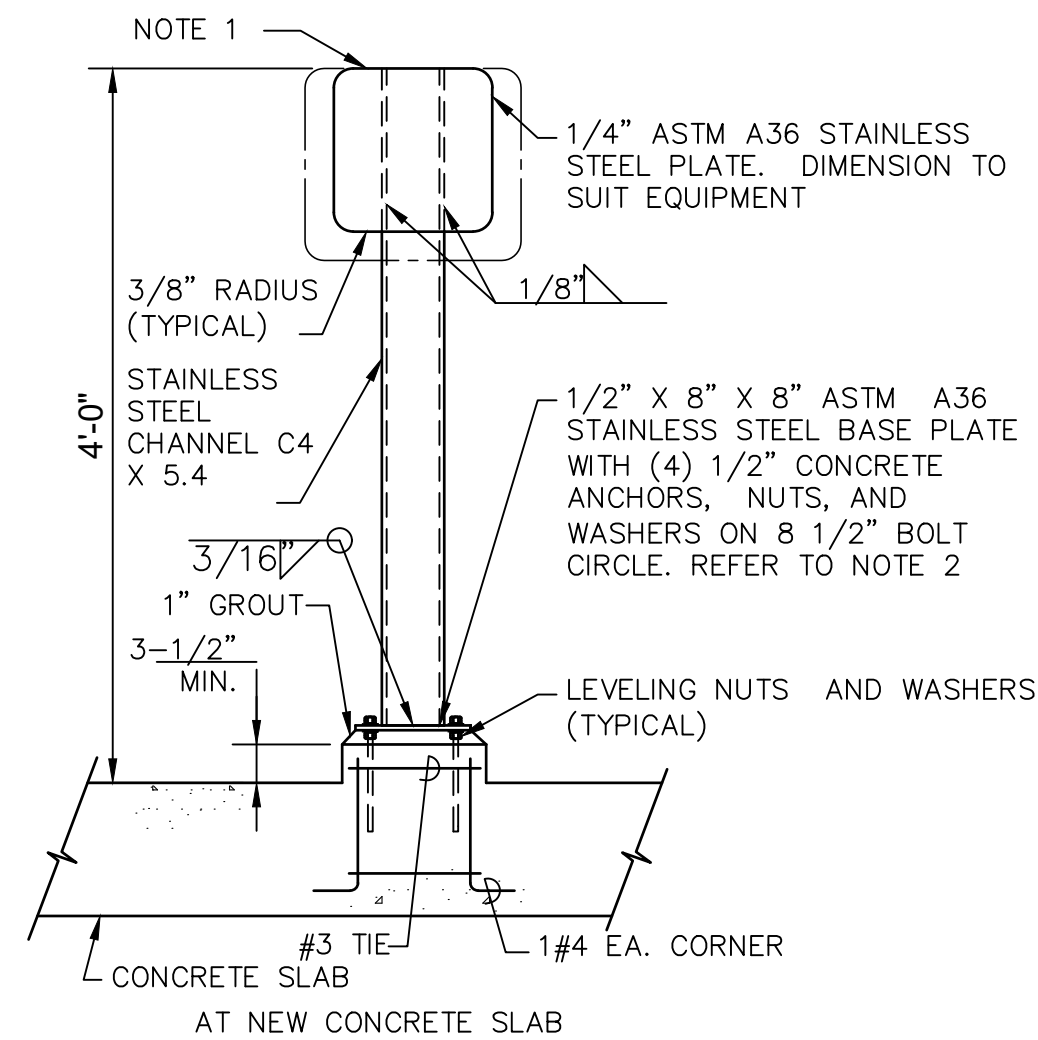

- NOTES:
- MOUNTING STAND PLATE: 2X2 MAXIMUM
A. DRILL PLATE FOR NUMBER OF HOLES REQUIRED.
B. REMOVE ALL SHARP EDGES.
C. CLEAN AND HOT DIP GALVANIZE AFTER FABRICATION.
 - SEE TYPICAL CONCRETE ANCHOR OR THREADED ROD DETAIL FOR CONCRETE ANCHOR REQUIREMENTS.
 - PROVIDE 316 STAINLESS STEEL ANCHOR BOLTS AND HARDWARE
 - ALUMINUM SYSTEM MAY SUBSTITUTE STAINLESS STEEL AS AN ALTERNATE MATERIAL

CONTROL STATION OR INSTRUMENT STAND
SCALE: N.T.S.

DETAIL **A**
TYP

CKT NO.	TRIP AMPS	DESCRIPTION OF LOAD	LOAD KVA	AMPS	POLES	KVA PER PHASE			POLES	AMPS	LOAD KVA	DESCRIPTION OF LOAD	TRIP AMPS	CKT NO.
						A	B	C						
1	20	CHART REC/RTU	0.18	1.5	1	1.1			1	7.2	0.87	OUTSIDE BYPASS VALVE	20	2
3	50	WELL TRANSFORMER ROOM	3	28.8	2		3.6		1	4.7	0.56	LIGHTS	20	4
			3				3.6		1	4.7	0.56	LIGHTS	20	6
7	50	WELL RW XFMR	3	28.8	2	4.7			1	14.2	1.7	SUMP PUMP REC.	20	8
			3				3.2		1	1.5	0.18	OUTLET WELL ROOM	20	10
11	20	RTU RADIO	0.9	7.5	1			1.4	1	4.2	0.5	LIGHT WELL ROOM	20	12
13	20	VEEDER ROOT	0.9	7.5	1	1.1			1	1.5	0.18	OUTLET EAST & SOUTH WALL	20	14
15	50	AIR HANDLER #1	0.3	2.9	2		0.5		1	1.5	0.18	OUTLET OUTSIDE VAULTS	20	16
			0.3				1.7		3	11.7	1.4	AIR COMP #1	30	18
19	30	MIXER CONTROL PANEL(200-MIX-001)	0.58	4.8	1	2.0					1.4			
21	30	PSV CONTROLLER (200-FC-001)	0.6	5.0	1	2.0					1.4			
23					1			0.0	1					24
25					1	0.3			2	2.9	0.3	NEW AIR HANDLER	20	26
27					1		0.3				0.3			
29					1			2.1	3	17.5	2.1	NEW COMP	30	30
31					1	2.1					2.1			
33					1		2.1				2.1			
35					1			0.0	1					36
37					1	0.0			1					38
39					1		0.0		1					40

PANEL LP - EXISTING
LOCATION
BUILDING
NOTES:

TOTAL KVA	11.2	11.6	8.8
GRAND CONNECTED TOTAL KVA	31.6		

SERVICE CHARACTERISTICS
VOLTS: 208/120
PHASE: 3
WIRE: 4
22K MIN AIC SYMM, FULLY RATED ASSEMBLY

EXISTING LIGHTING PANEL -LP
N.T.S.

REV NO.	DESCRIPTION	DATE
1	ADDENDUM - REMOVAL OF PROPOSED VALVES REVISIONS	11/14/2022

SEAL
AUBREY A. HAUDRICOURT, P.E.
No. 66861

MCKIM & CREED
1365 Hamlet Avenue
Clearwater, Florida 33756-3331
Phone: (727) 442-7196, Fax: (727) 461-3827
CA Lic. No. 29588
www.mckimcreed.com





CORTEZ BOOSTER PUMP STATION UPGRADES
ELECTRICAL
DETAILS AND PANEL SCHEDULE

PROJ. START DATE: MAR. 2020	SCALE
MCE PROJ. # 01024-0193	HORIZONTAL: E3.02
DRAWN: JG	VERTICAL: TBD
DESIGNED: AAH	REVISION: ----
CHECKED: MAC	
PROJ. MGR: BP	


ISSUED FOR BID

CONDUIT SUPPORT DETAIL (SUSPENDED SUPPORT)
SCALE: N.T.S.

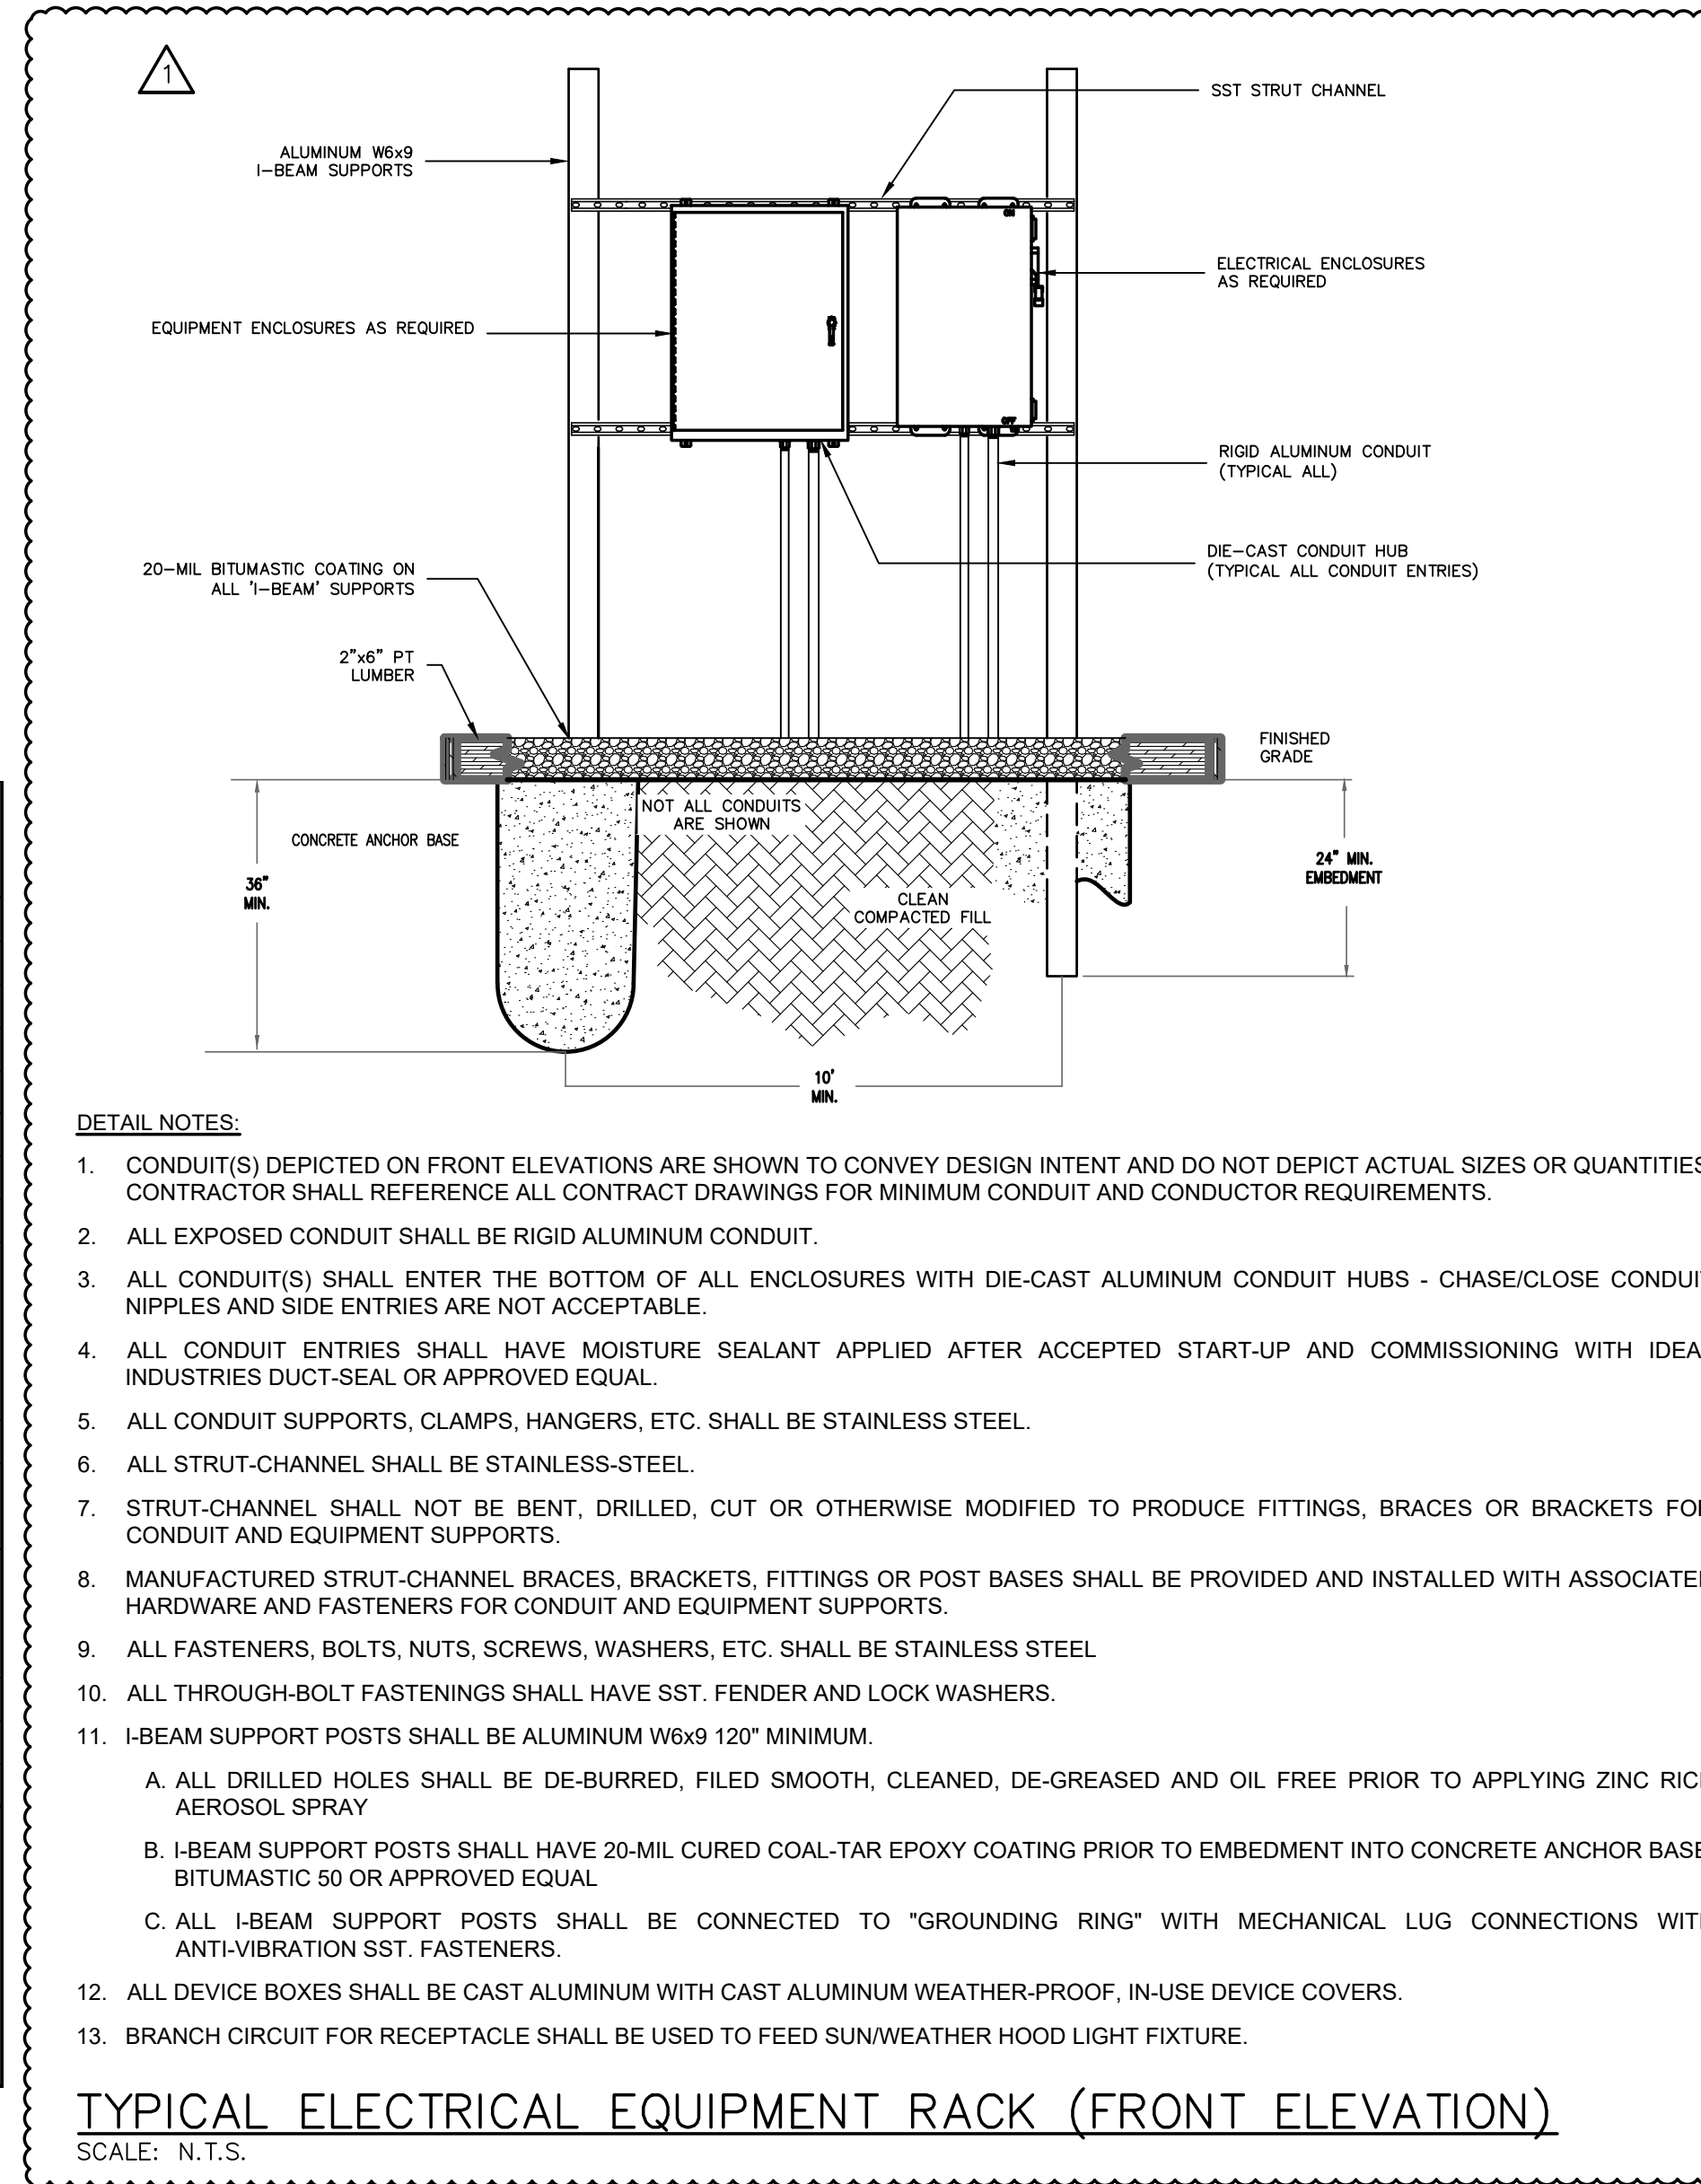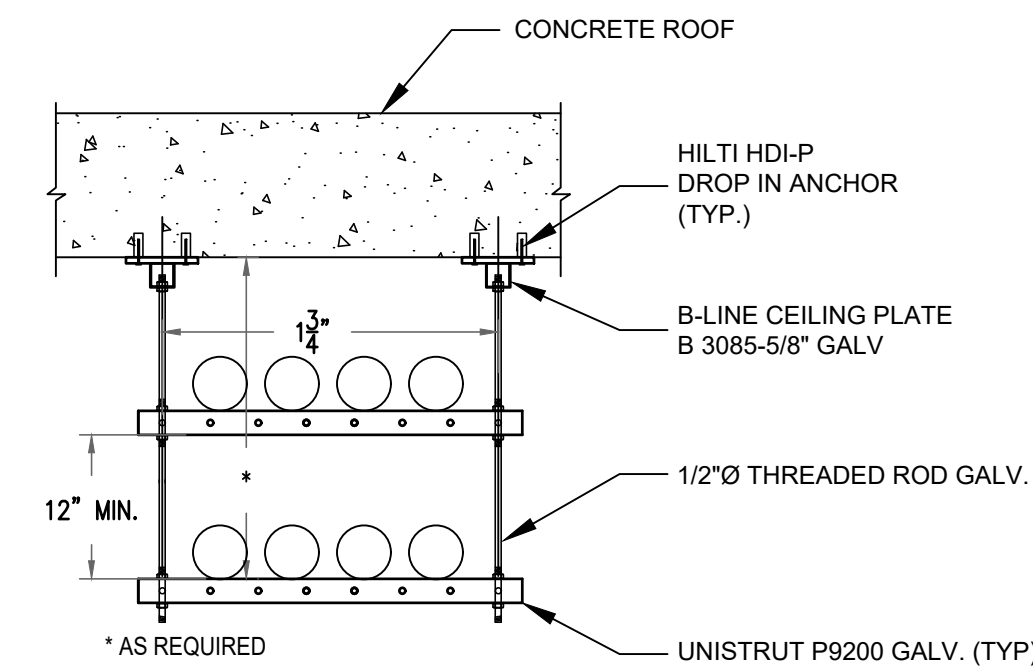


- DETAIL NOTES:
- CONDUIT(S) DEPICTED ON FRONT ELEVATIONS ARE SHOWN TO CONVEY DESIGN INTENT AND DO NOT DEPICT ACTUAL SIZES OR QUANTITIES. CONTRACTOR SHALL REFERENCE ALL CONTRACT DRAWINGS FOR MINIMUM CONDUIT AND CONDUCTOR REQUIREMENTS.
 - ALL EXPOSED CONDUIT SHALL BE RIGID ALUMINUM CONDUIT.
 - ALL CONDUIT(S) SHALL ENTER THE BOTTOM OF ALL ENCLOSURES WITH DIE-CAST ALUMINUM CONDUIT HUBS - CHASE/CLOSE CONDUIT NIPPLES AND SIDE ENTRIES ARE NOT ACCEPTABLE.
 - ALL CONDUIT ENTRIES SHALL HAVE MOISTURE SEALANT APPLIED AFTER ACCEPTED START-UP AND COMMISSIONING WITH IDEAL INDUSTRIES DUCT-SEAL OR APPROVED EQUAL.
 - ALL CONDUIT SUPPORTS, CLAMPS, HANGERS, ETC. SHALL BE STAINLESS STEEL.
 - ALL STRUT-CHANNEL SHALL BE STAINLESS-STEEL.
 - STRUT-CHANNEL SHALL NOT BE BENT, DRILLED, CUT OR OTHERWISE MODIFIED TO PRODUCE FITTINGS, BRACES OR BRACKETS FOR CONDUIT AND EQUIPMENT SUPPORTS.
 - MANUFACTURED STRUT-CHANNEL BRACES, BRACKETS, FITTINGS OR POST BASES SHALL BE PROVIDED AND INSTALLED WITH ASSOCIATED HARDWARE AND FASTENERS FOR CONDUIT AND EQUIPMENT SUPPORTS.
 - ALL FASTENERS, BOLTS, NUTS, SCREWS, WASHERS, ETC. SHALL BE STAINLESS STEEL.
 - ALL THROUGH-BOLT FASTENINGS SHALL HAVE SST. FENDER AND LOCK WASHERS.
 - I-BEAM SUPPORT POSTS SHALL BE ALUMINUM W6x9 120" MINIMUM.
A. ALL DRILLED HOLES SHALL BE DE-BURRED, FILED SMOOTH, CLEANED, DE-GREASED AND OIL FREE PRIOR TO APPLYING ZINC RICH AEROSOL SPRAY
B. I-BEAM SUPPORT POSTS SHALL HAVE 20-MIL CURED COAL-TAR EPOXY COATING PRIOR TO EMBEDMENT INTO CONCRETE ANCHOR BASE, BITUMASTIC 50 OR APPROVED EQUAL
C. ALL I-BEAM SUPPORT POSTS SHALL BE CONNECTED TO "GROUNDING RING" WITH MECHANICAL LUG CONNECTIONS WITH ANTI-VIBRATION SST. FASTENERS.
 - ALL DEVICE BOXES SHALL BE CAST ALUMINUM WITH CAST ALUMINUM WEATHER-PROOF, IN-USE DEVICE COVERS.
 - BRANCH CIRCUIT FOR RECEPTACLE SHALL BE USED TO FEED SUN/WEATHER HOOD LIGHT FIXTURE.

TYPICAL ELECTRICAL EQUIPMENT RACK (FRONT ELEVATION)
SCALE: N.T.S.

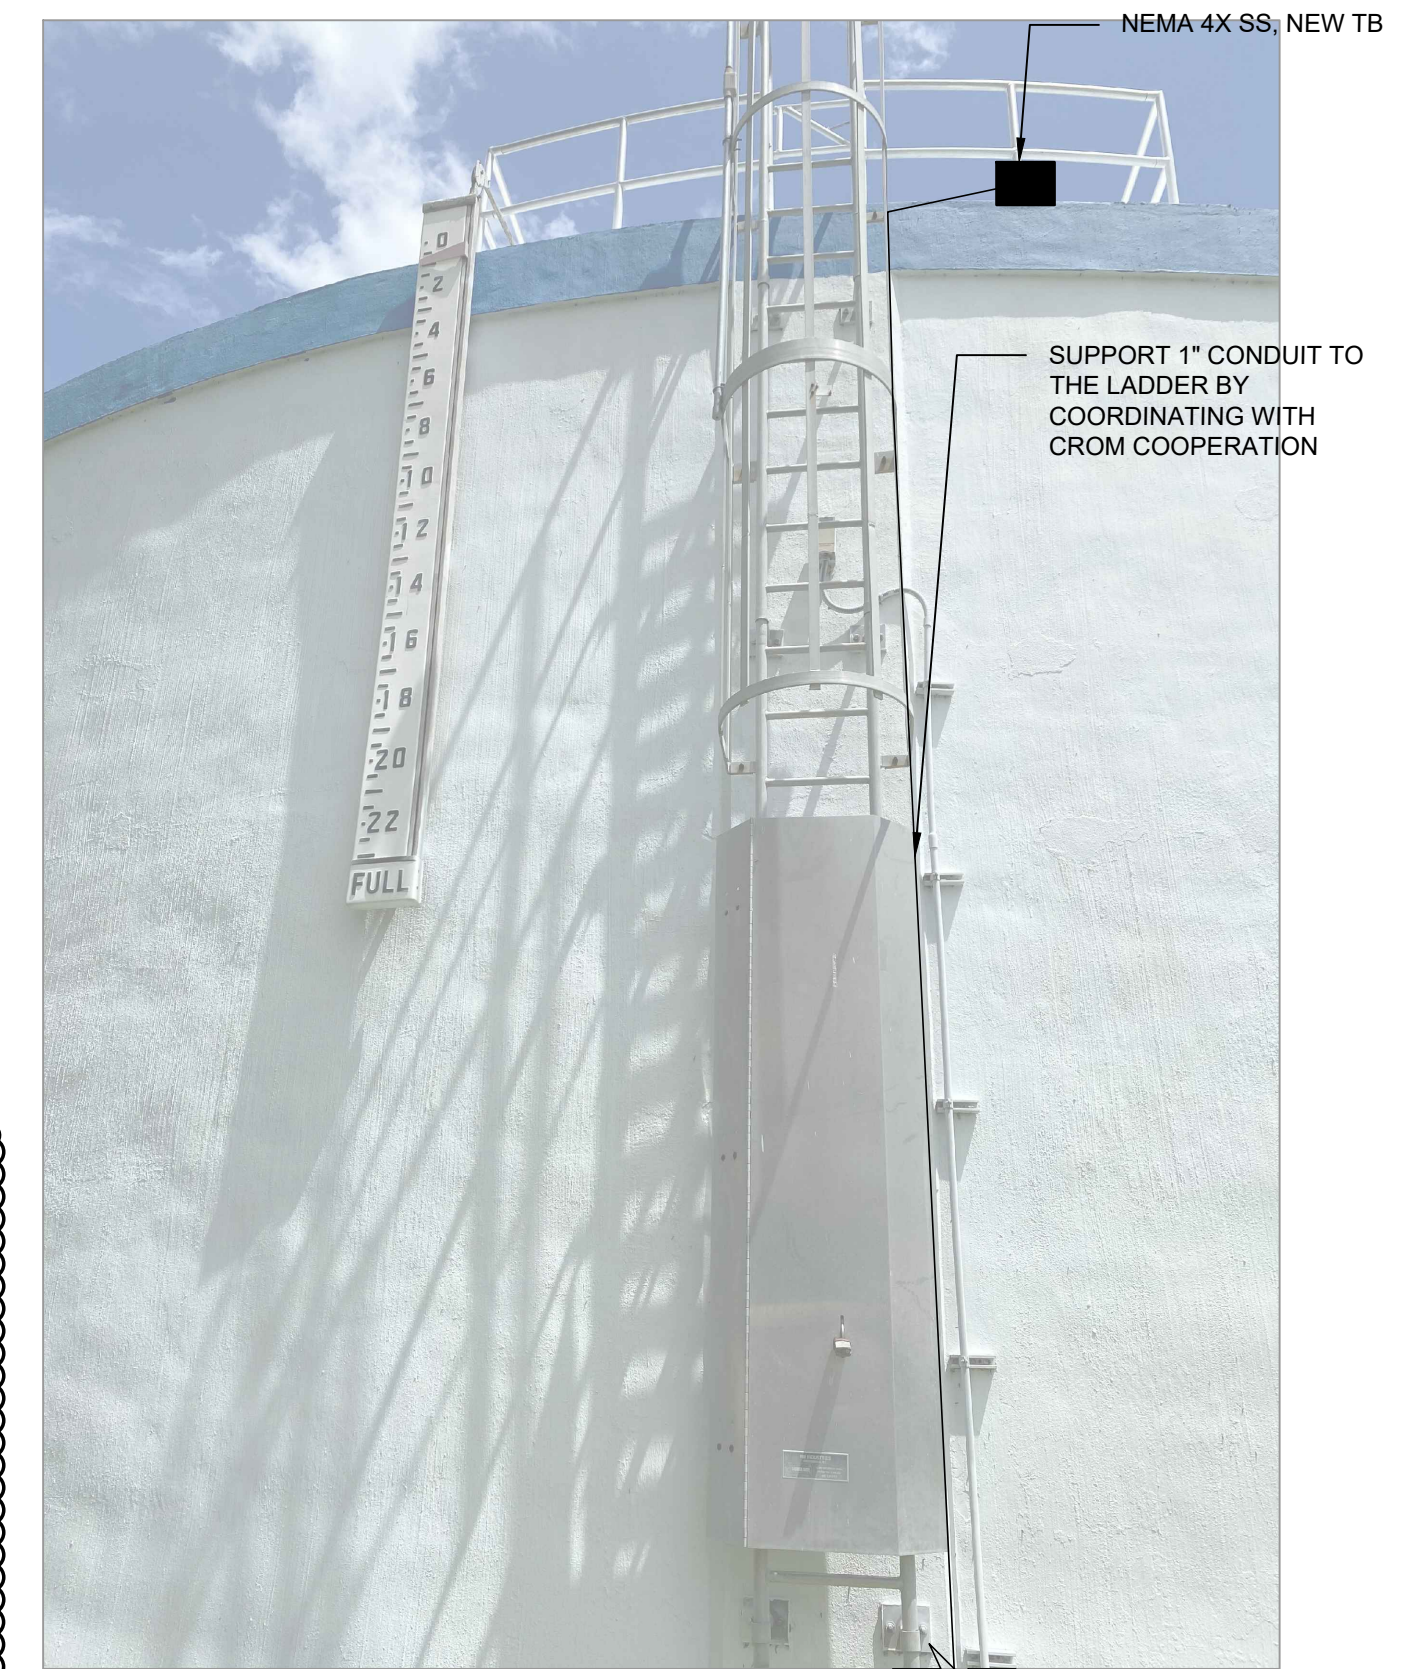

CONDUIT SUPPORT TO THE TANK
SCALE: N.T.S.

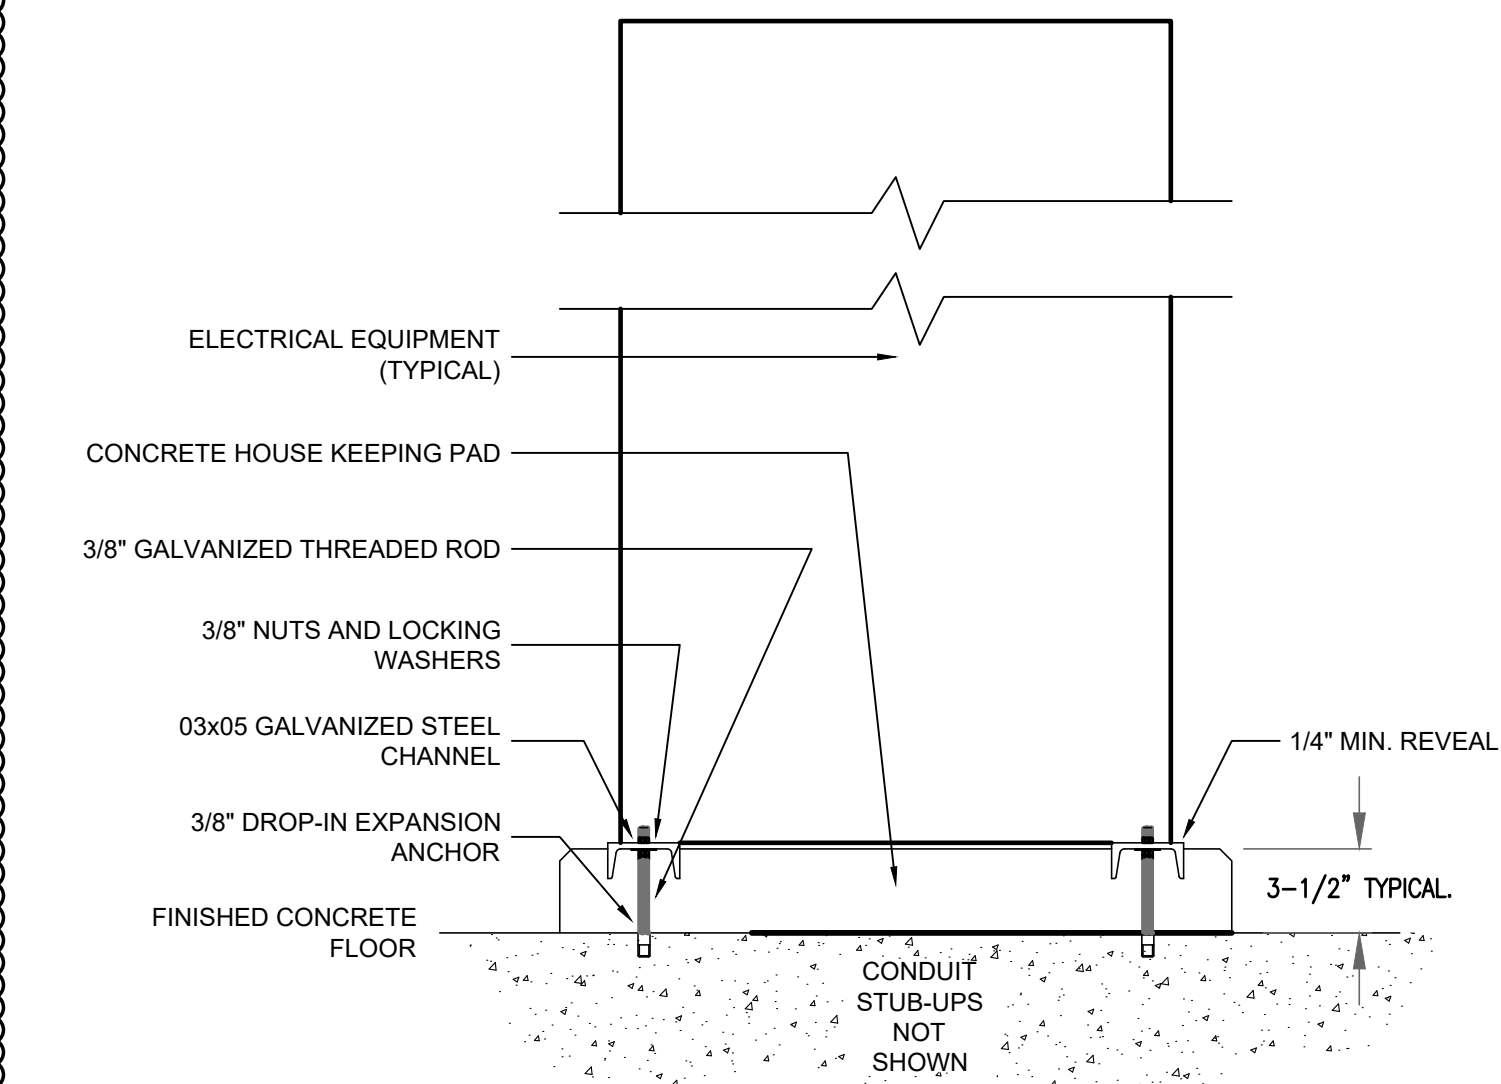

- DETAIL NOTES:
- CHANNELS SHALL BE MADE CONTINUOUS IN REQUIRED LENGTHS
 - INSTALL CHANNELS PRIOR TO PLACING HOUSE KEEPING CONCRETE
 - INSTALL CHANNELS LEVEL WITHIN (+/-) 1/16" THROUGHOUT SPAN
 - CHANNEL SHALL BE 1/4" MINIMUM ABOVE HOUSE KEEPING CONCRETE FINISH
 - PROVIDE CHANNELS AS REQUIRED TO SUPPORT THE FULL LENGTH AND DEPTH OF EQUIPMENT
 - TOUCH-UP CHANNELS WITH ZINC RICH PAINT PRIOR TO PLACING CONCRETE AND AFTER INSTALLING EQUIPMENT

TYPICAL FLOOR-MOUNTED ELECTRICAL EQUIPMENT PAD DETAIL
SCALE: N.T.S.