STATE OF FLORIDA

COUNTY OF MANATEE


INDEX OF LIGHTING PLANS

SHEET DESCRIPTION NO. KEY SHEET L-1 GENERAL L-2 **NOTES** LIGHTING DATA 1-3 AND LEGEND L-4 LIGHTING PLAN SERVICE L-5 POINT DETAILS

PROPOSED LIGHTING PLANS FOR 69TH STREET EAST INTERSECTION IMPROVEMENTS ELLENTON, FLORIDA

MANATEE COUNTY PROJECT No: 6083160

MANATEE COUNTY PROJECT MANAGER: JIM SHULER, P.E.

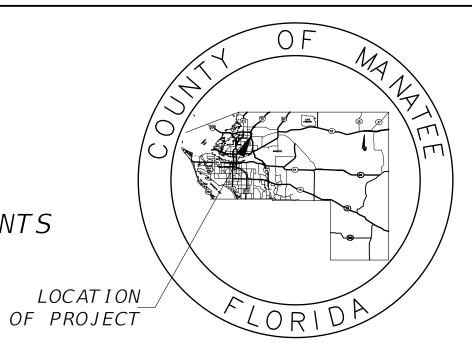

CONSTRUCTION PLANS JANUARY 2023

THIS ITEM HAS BEEN DIGITALLY SIGNED AND SEALED BY:

M. Fathy 2023.01.11 Abdalla 15:56:06 -05'00'

ON THE DATE ADJACENT TO THE SEAL.

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LIGHTING PLANS

PROFESSIONAL OF RECORD: M. FATHY ABDALLA, P.E. NO. 63914 KISINGER CAMPO & ASSOCIATES CORP. 201 N. FRANKLIN STREET, SUITE 400 TAMPA. FL 33602





ATTENTION IS DIRECTED TO THE FACT THAT THESE PLANS MAY HAVE BEEN ENLARGED IN SIZE BY REPRODUCTION. THIS MUST BE CONSIDERED WHEN OBTAINING SCALED

GOVERNING DESIGN STANDARDS: FLORIDA DEPARTMENT OF TRANSPORTATION. FY 2023-24 DESIGN STANDARDS

eBOOK (DSeB) AND APPLICABLE DESIGN STANDARDS REVISIONS (DSRs) AT THE FOLLOWING WEBSITE:

https://www.fdot.gov/design/standardplans/current/default.shtm

GOVERNING STANDARD SPECIFICATIONS:

FLORIDA DEPARTMENT OF TRANSPORTATION, JULY 2022 STANDARD SPECIFICATIONS FOR ROAD AND BRIDGE CONSTRUCTION AT THE FOLLOWING WEBSITE:

http://www.fdot.gov/programmanagement/Implemented/SpecBooks

CONSTRUCTION	FISCAL	SHEET
CONTRACT NO.	YEAR	NO.
N/A	2023	

LIGHTING GENERAL NOTES

- 1. WHERE FOOTER OR FOUNDATION ARE TO BE INSTALLED BY AUGERING OR DRILLING, SURVEY AND STAKE OR PAINT TO AN ACCURACY OF 0.1' PRIOR TO REQUESTING UTILITY LOCATES. STAKE OR PAINT THE CENTER OF EACH LOCATION AND CLEARLY LABEL WITH STATION, OFFSET, IDENTIFYING STRUCTURE NUMBER, AND DIAMETER OF EXCAVATION IN INCHES.
- 2. WHERE AUGERING OR DRILLING, EXCAVATE THE FIRST 4 FEET BY NON MECHANICAL AND NON DESTRUCTIVE MEANS.
- 3. PROVIDE SHOP DRAWINGS OF THE PHOTOMETRIC CALCULATIONS FOR LUMINAIRES OTHER THAN THE BASIS OF DESIGN SHOWN IN THE PLANS. MEET ALL PHOTOMETRIC REQUIREMENTS IN THE CONTRACT DOCUMENTS AND THE FDOT DESIGN MANUAL.
- 4. THE LOCATIONS OF EXISTING UTILITIES ARE APPROXIMATE, DO NOT COVER ALL SEGMENTS OF THE PROJECT, AND ARE BASED ON LIMITED INVESTIGATION. ADDITIONAL UTILITIES MAY EXIST. CONTRACTOR SHALL VERIFY AND LOCATE ALL UTILITIES IN CONFLICT WITH PROPOSED LIGHT POLES.
- 5. THE CADD SYMBOLS USED TO REPRESENT LIGHT POLES ARE ENLARGED TO ENHANCE PLAN READABILITY AND DO NOT REPRESENT THE ACTUAL SIZE OF THESE ELEMENTS. PLACE THESE ELEMENTS AS SPECIFIED IN THE PLANS WHILE PROVIDING A MINIMUM CLEAR ZONE DISTANCE SHOWN IN THE PLAN

SIGNALIZED INTERSECTION LIGHTING CRITERIA (RECONSTRUCTION)

AVERAGE INITIAL INTENSITY (HORIZONTAL FOOT CANDLES)
AVERAGE INITIAL INTENSITY (VERTICAL FOOT CANDLES)
UNIFORMITY RATION AVG./MIN.
MAX./MIN
VEILING LUMINANCE RATIO
DESIGN WIND SPEED

1.5 - 3.0 FOOT CANDLES 1.2 - 1.5 FOOT CANDLES 4:1 OR LESS 10:1 OR LESS N/A 140 MPH

M. FATHY ABDALLA, P.E. DESCRIPTION DATE PROJECT # 5/2018 P.E. LICENSE NUMBER 63914 6083160 SURVEYED RPH (ISINGER CAMPO & ASSOCIATES CORP 9/2021 SURVEY # N/A DESIGNED 201 N. FRANKLIN STREET SEC./TWN./RGE 28/335/18E DRAWN *SUITE 400* CHECKED TAMPA, FL 33602



GENERAL NOTES

SHEET NO. L-2 PROP. CONV. LIGHT POLE WITH LED LUMINAIRE. THE BASIS OF DESIGN USED WAS: MANUFACTURER: GE, MODEL: EVOLVE ERL2, PHOTOMETRIC CURVE: C5, SINGLE ARM LIGHT POLE, 223 WATT, LED, 240 VOLT, TYPE III DISTRIBUTION, 40' MOUNTING HEIGHT, AND 12' ARM LENGTH. FILE NAME: ERL2_28C53O.ies. SYMBOL INCLUDES LUMINAIRE, ARM, POLE, FOUNDATION, PULL BOX, CONCRETE SLAB, & POLE CABLE DISTRIBUTION SYSTEM. PULL BOX AND PCDS TO BE PAID FOR SEPARATELY.



PROP. CONV. LED LUMINAIRE MOUNTED TO PROP. SIGNAL POLE. THE BASIS OF DESIGN USED WAS: MANUFACTURER: GE, MODEL: EVOLVE ERL2, PHOTOMETRIC CURVE: C5, SINGLE ARM LIGHT POLE, 223 WATT, LED, 240 VOLT, TYPE III DISTRIBUTION, 40' MOUNTING HEIGHT, AND 12' ARM LENGTH. FILE NAME: ERL2_28C530.ies. SYMBOL INCLUDES LUMINAIRE, ARM, PULL BOX, & POLE CABLE DISTRIBUTION SYSTEM. PULL BOX AND PCDS TO BE PAID FOR SEPARATELY. SEE SIGNALIZATION PLANS FOR DETAILS ON SIGNAL POLE.



PROP. CONV. LED LUMINAIRE MOUNTED TO PROP. SIGNAL POLE. THE BASIS OF DESIGN USED WAS: MANUFACTURER: GE, MODEL: EVOLVE ERL2, PHOTOMETRIC CURVE: C5, SINGLE ARM LIGHT POLE, 223 WATT, LED, 240 VOLT, TYPE III DISTRIBUTION, 35' MOUNTING HEIGHT, AND 12' ARM LENGTH. FILE NAME: ERL2_28C530.ies. SYMBOL INCLUDES LUMINAIRE, ARM, PULL BOX, & POLE CABLE DISTRIBUTION SYSTEM. PULL BOX AND PCDS TO BE PAID FOR SEPARATELY. SEE SIGNALIZATION PLANS FOR DETAILS ON SIGNAL POLE.



PROPOSED LOAD CENTER RATED FOR 120V / 240V OPERATION, SINGLE PHASE, 3 WIRE



PULL BOX



2" SCH. 40 PVC CONDUIT, OPEN TRENCH, WITH CONDUCTORS INSIDE (CONDUIT AND CONDUCTOR SIZE SHOWN ON PLAN SHEETS). RUN ONE COPPER BOND CONDUCTOR (XHHW INSULATION) INSIDE CONDUIT WITH OTHER CONDUCTORS.




2" HDPE CONDUIT, DIRECTIONAL BORE, WITH CONDUCTORS INSIDE (CONDUIT AND CONDUCTOR SIZE SHOWN ON PLAN SHEETS). RUN ONE COPPER BOND CONDUCTOR (XHHW INSULATION) INSIDE CONDUIT WITH OTHER CONDUCTORS AND A SPARE CONDUIT. CONDUIT AND TRANSITION COUPLING SHALL BE UL LISTED. EXTEND CONDUIT BEYOND EDGE OF PAVEMENT TO PULL BOXES.

POLE DATA										
POLE NO.	LUMINAIRE NO.	CIRCUIT	₽ OR Q	STATION	OFFSET	ORIENT.*	PAY ITEM			
1	-	A-1	BUFFALO RD.	199+32	56.26' RT.	<i>0°</i>	715-61-342			
2	-	A-1	BUFFALO RD.	199+76	91.06' RT.	<i>0°</i>	715-5-32			
3	1	A-1	BUFFALO RD.	199+65	-65.36' LT.	-40°	715-5-32			
3	2	A-1	BUFFALO RD.	199+65	-65.36' LT.	-140°	715-5-32			
4	_	A-2	BUFFALO RD.	200+92	48.71' RT.	25°	715-5-32			

* ORIENTATION IS MEASURED CLOCKWISE FROM THE AXIS ALONG THE MAST ARM.

		M. FATHY ABDALLA, P.E.						
NUMBER	DESCRIPTION	DATE	PROJECT #	6083160	SURVEYED	RPH		P.E. LICENSE NUMBER 63914 KISINGER CAMPO & ASSOCIATES CC 201 N. FRANKLIN STREET
			SURVEY #	N/A	DESIGNED	NCR	9//0/1	
			SEC./TWN./RGE	28/335/18E	DRAWN	NCR		SUITE 400
			SCALE	1" = 50'	CHECKED		9/2021	TAMPA, FL 33602



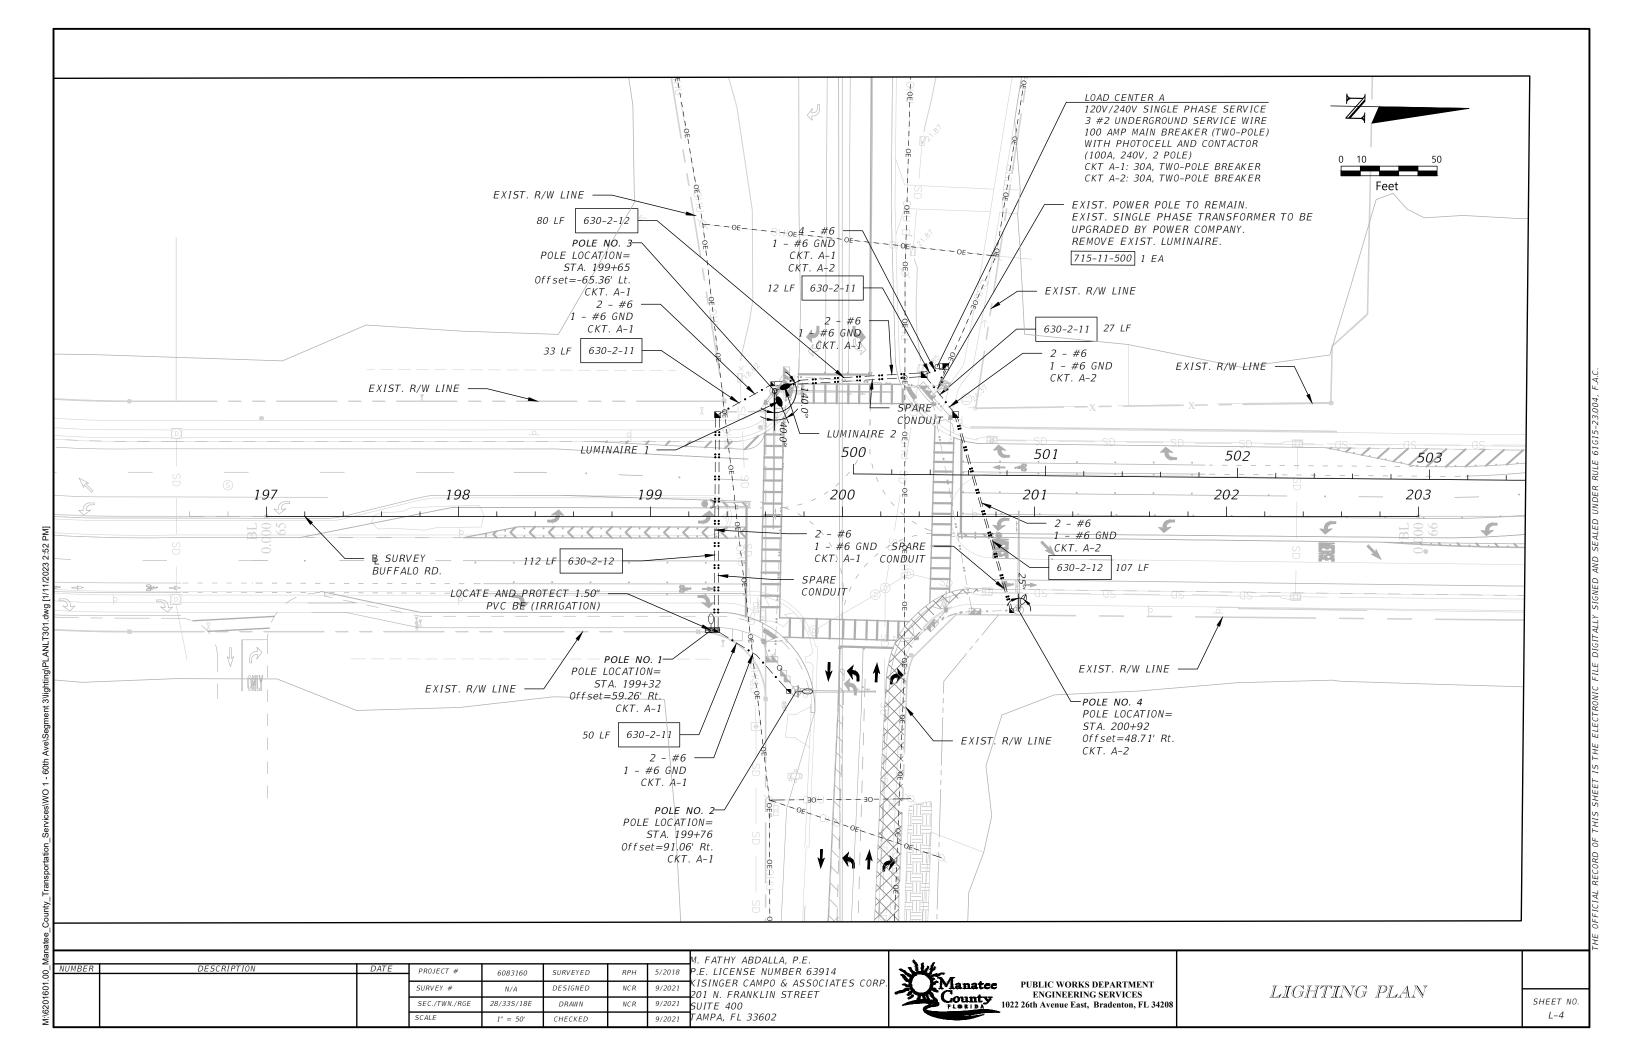


MAINS: 100A MCB VOLTAGE: 120/240 PHASE: 1 - WIRE: 3		SERVICE POINT "A" (LOAD CENTER SCHEDULE)					
CKT NO	KVA	AMPS/PHASE		CIRCUI	1010		
CKT. NO.			AMPS	POLES	LUMINAIRES	LOAD	
A-1	0.89	3.72	30	3	4	ROADWAY LIGHTING SOUTH OF 69TH ST.	
A-2	0.22	0.93	30	1	1	ROADWAY LIGHTING NORTH OF 69TH ST.	
MCB		100A - 2P					
CONNECTED LOAD		1.11 KVA					
TOTAL DEMAND LOAD 4.65 AMP							

SERVICE POINT DIAGRAM

- 1. PRIMARY ELECTRICAL DISTRIBUTION SYSTEM.
- 2. UTILITY POLE MOUNTED TRANSFORMER.
- 3. GROUNDING SYSTEM
- 4. ELECTRICAL SERVICE CONDUCTORS AND CONDUIT.
- 5. KWH METER.

- 6. SURGE PROTECTIVE DEVICE.
- 7. MAIN SERVICE DISCONNECT, ENCLOSED CIRCUIT BREAKER.
- 8. FEEDER CONDUCTORS AND CONDUIT.
- 9. LIGHTING CONTROL CABINET.
- 10. LOAD CENTER.

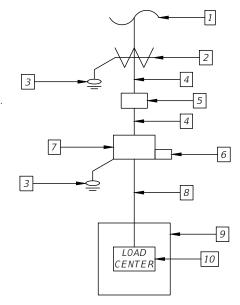

DESCRIPTION PROJECT # 6083160 SURVEYED 5/2018 SURVEY # DESIGNED 9/2021 N/A DRAWN CHECKED

M. FATHY ABDALLA, P.E. P.E. LICENSE NUMBER 63914 (ISINGER CAMPO & ASSOCIATES CORP 201 N. FRANKLIN STREET SUITE 400 TAMPA, FL 33602

