CONSTRUCTION PLANS FOR

END OF SERVICE LIFE FY-18 FORCEMAIN 29A/OLD TAMPA ROAD FM/FM 10M /DESOTO MEMORIAL WATERMAIN

MANATEE COUNTY, FLORIDA

MAY 2019

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FLORIDA

MANATEE COUNTY PROJECTS #5150380, #5150480, #5150580, #6092370

PROJECT TEAM

OWNER:
MANATEE COUNTY
1022 26TH AVE. E.
BRADENTON, FL 34208
CONTACT: ALEJANDRO GONZALEZ, P.E.
941-708-7450 ext. 7338

ENGINEER:

KIMLEY-HORN AND ASSOCIATES, INC. 100 2ND AVENUE SOUTH, SUITE 300S ST. PETERSBURG, FL 33701 CONTACT: W. WADE WOOD, P.E. 727-498-3853 SURVEYOR:

HYATT SURVEY SERVICES, INC. (FM 29A) 11007 BTH AVENUE EAST, BRADENTON, FL 34212 CONTACT: RUSSELL P. HYATT, PSM 941-748-4693

MANATEE COUNTY PROPERTY MANAGEMENT (FM 10M)
DEPARTMENT SURVEY DIVISION
1112 MANATEE AVENUE WEST,
BRADENTON, FL 34205
CONTACT: TODD E. BOYLE, RSM
941-944-4501

FLORIDA DESIGN CONSULTANTS, INC. (DESOTO WM) 3030 STARKEY BOULEVARD NEW PORT RICHEY, FL 34655 CONTACT: JARRD T. PATENAUDE, PSM

ZNS ENGINEERING (OLD TAMPA ROAD FM)
201 5TH AVENUE DRIVE EAST
BRADENTON, FL 34208
CONTACT: JAMES GATCH
941-748-3318

UTILITY CONTACTS:


MANATEE COUNTY UTILITY RECORDS KATHY MCMAHON 4520- 66TH STREET W BRADENTON, FL 34210 941-792-8811 EXT. 5002

FRONTIER COMMUNICATIONS PATTI REID 1701 RINGLING BLVD. SARASOTA, FL 34236 941-906-6711

FLORIDA POWER & LIGHT JOEL BRAY 4215 UP THE GROVE LANE WEST PALM BEACH, FL. 33407 386-586-6403 CHARTER COMMUNICATIONS JIM CRUZAN 5413 S.R. 64 EAST BRADENTON, FL 34208 727-329-2846

TECO PEOPLES GAS JOAN DOMNING 8416 PALM RIVER ROAD TAMPA, FL 33619 813-275-3783

PEACE RIVER ELECTRIC COOPERATIVE CLAY STANPHILL 210 METHENY RD WAUCHULA, FL 33873 863-781-0863

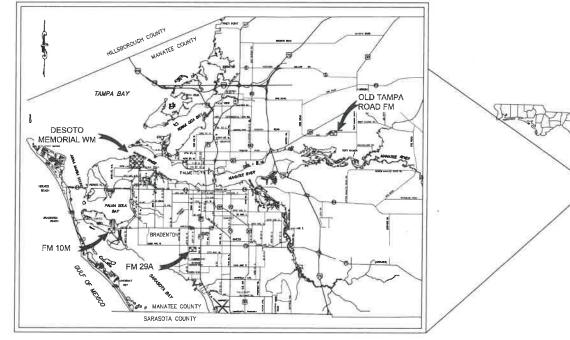

PROJECT VICINITY MAP

100% PLANS



2	GENERAL NOTES
3	FM 29A KEY SHEET
4	FM 29A PLAN & PROFILE
5	FM 29A PLAN & PROFILE
6	OLD TAMPA ROAD KEY SHEET
7	OLD TAMPA ROAD PLAN & PROFILE
8	FM 10M KEY SHEET
9	FM 10M PLAN & PROFILE
10	DESOTO MEMORIAL KEY SHEET
11	DESOTO PLAN & PROFILE
12	DESOTO PLAN & PROFILE
13	DESOTO PLAN & PROFILE
14	DESOTO PLAN & PROFILE
15	CONSTRUCTION DETAILS
16	CONSTRUCTION DETAILS
17	CONSTRUCTION DETAILS
18	CONSTRUCTION DETAILS
19	AERIAL CROSS AGDETAIL

SHEET LIST TABLE

SHEET TITLE

COVER SHEET

SHEET

NUMBER

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DEVISIONS DATE BY

GENERAL

- ALL CONSTRUCTION ACTIVITIES SHALL BE COORDINATED WITH THE PROJECT MANAGEMENT DIVISION.
 THE PROJECT MANAGER IS: ALEX GONZALEZ, P.E. AND CAN BE REACHED AT (941) 708-7450 X7338
- HE CONTRACTOR WANTS A SITE VISIT PRIOR TO BIDDING, THESE SHALL BE ARRANGED THROUGH THE COUNTY'S
- 3. ALL CONSTRUCTION ON THIS PROJECT SHALL BE IN ACCORDANCE WITH THE LATEST EDITION OF MANATEE COUNTY UTILITY AND TRANSPORTATION STANDARDS AND/OR FDOT "STANDARD PLANS FOR ROAD AND BRIDGE CONSTRUCTION" UNLESS OTHERWISE INDICATED ON THE PLANS.
- 4. THE CONTRACTOR SHALL BE RESPONSIBLE FOR MEETING ALL CONDITIONS AND REQUIREMENTS OF ALL PERMITS AND ALL GOVERNING FEDERAL STATE, AND LOCAL AGENCIES. THE CONTRACTOR SHALL OSTAIN AND PAY FOR ALL REQUIRED PERMITS THAT ARE NOT PROVIDED IN THE BID DOCUMENTS, AT NO ADDITIONAL COST. TO THE OWNER.
- 5. THE INFORMATION PROVIDED IN THESE PLANS IS SOLELY TO ASSIST THE CONTRACTOR IN ASSESSING THE NATURE AND EXTENT OF THE CONDITIONS WHICH MAY BE ENCOUNTERED DURING THE COURSE OF WORK, ALL CONTRACTORS ARE DIRECTED, PROOF TO EBIDDING, TO CONDUCT WHATEVER INVESTIGATION THEY MAY DEEM NECESSARY TO ARRIVE AT THEIR OWN CONCLUSIONS REGARDING THE ACTUAL CONDITIONS THAT WILL BE ENCOUNTERED, AND UPON WHICH THEIR BIOS WILL BE BASED.
- 6. THE CONTRACTOR SHALL REVIEW AND VERIFY ALL DIMENSIONS ON THE PLANS AND REVIEW ALL FIELD CONDITIONS THAT MAY AFFECT CONSTRUCTION, SHOULD DISCREPANCIES OCCUR, THE CONTRACTOR SHALL NOTIFY THE ENGINEER TO DETAIN THE ENGINEER'S CLARIFOCATION BEFORE COMMENCING WITH CONSTRUCTION.
- 7. THE CONTRACTOR SHALL NOTIFY SUNSHINE 811 (1-800-432-4770) AT LEAST 2 FULL BUSINESS DAYS PRIOR TO CONSTRUCTION OPERATIONS. THE CONTRACTOR SHALL BE RESPONSIBLE FOR COORDINATING WITH ALL UTILITIES FOR THE POSSIBLE RELOCATION OR THE TEMPORARY MOVEMENT OF ANY EXISTING UTILITIES WHITH THE RIGHTS—OF—WAY, IT IS THE CONTRACTOR'S RESPONSIBILITY TO PROTECT EXISTING UTILITIES FROM DAMAGE. EXPLORATORY EXCAVATION MAY BE REQUIRED.
- 8. NO WORK, EXCEPT FOR EMERGENCY TYPE, SHALL BE PERFORMED AFTER 7:00 PM AND BEFORE 7:00 AM. FOR ADDITIONAL PROJECT RESTRAINTS, REFER TO SECTION 01310 OF THE SPECIFICATIONS.
- 9. THE CONTRACTOR SHALL PROVIDE CERTIFIED RECORD DRAWINGS AS OUTLINED IN THE SPECIFICATIONS. RED-LINE DRAWINGS SHALL BE CURRENT WITH EACH PAY APPLICATION SUBMITTED AND WILL BE CHECKED AS PART OF THE PAY APPLICATION REVIEW PROCESS. PAYMENT WILL NOT BE MADE TO CONTRACTOR WITHOUT APPROVED RED-LINE DRAWINGS. THE MCST CURRENT SET OF RED-LINE DRAWINGS. THE MCST CURRENT SET OF RED-LINE DRAWINGS. THE MCST CURRENT SET OF RED-LINE DRAWINGS SHALL ALSO BE BROUGHT TO EACH MONTHLY PROGRESS
- 10. THE CONTRACTOR SHALL INCLUDE IN HIS BID: BY-PASS PUMPING FACILITIES, PUMPIS, FITTINGS, LABOR, ETC. AS NECESSARY, BASED ON METHOD AND SEQUENCE OF CONSTRUCTION TO COMPLETE ALL WORK WHILE MAINTAINING SERVICE OPERATIONS AT ALL TIMES.
- 11. THE CONTRACTOR SHALL PROVIDE THE OWNER AND ENGINEER WITH A DETAILED CONSTRUCTION PHASING PLAN BASED ON THE CONNECTION SEQUENCING BELOW. EXISTING FORCE MAIN 29A, OLD TAMPA ROAD FORCE MAIN, FORCE MAIN 10M, AND DESCRID MEMORAL, WAITER MAIN SHALL REMAIN IN SERVICE UNIT. LAL CONNECTIONS OTHE PROPOSED FORCE MAIN/WATER MAIN IS CONSTRUCTED.
- 12. ALL PROPOSED WORK SHALL BE COORDINATED WITH MANATEE COUNTY UTILITIES DEPARTMENT AT LEAST TWO WEEKS IN ADVANCE OF PROPOSED CONSTRUCTION.
- 14. UNLESS OTHERWISE INDICATED OR APPROVED, ALL BELOW GROUND PVC PIPE SHALL HAVE PUSH—ON OR MECHANICAL JOINTS, AND ALL ABOVE GROUND PVC PIPE SHALL HAVE FLANGED JOINTS. ALL JOINTS SHALL BE FULLY RESTRAINED PER THE DETAILS IN THESE PLANS.
- 15 SANITARY SEWERS AND FORCE MAINS CROSSING OVER OR LINDER WATER MAINS SHALL BE LAID TO PROVIDE A MINIMUM VERTICAL DISTANCE OF 18" BETWEEN THE INVERT OF THE UPPER PIPE AND THE CROWN OF THE LOWER PIPE. WHERE THIS MINIMUM SEPARATION CANNOT BE MAINTAINED, THE CROSSING SHALL BE ARRANGED SO THAT THE SEWER OR FORCE MAIN PIPE JOINTS ARE EQUIDISTANT FROM THE POINT OF CROSSING WITH NO LESS THAN 10' BETWEEN ANY TWO JOINTS. AS AN ALTERNATIVE, THE SEWER OR FORCE MAIN MAY BE PLACED IN A WATERTIGHT CASING PIPE, CONSISTENT WITH F.A.C. RULL 62-55.514.
- 16. ALL BELOW-GRADE FITTINGS 4-INCHES AND GREATER IN DIAMETER SHALL BE MECHANICAL JOINT DUCTILE IRON WITH PROTECTO 401 LINING FOR THIER INTERIOR SURFACES AND COAL TAR ENAMEL COATING ON EXTERIOR SURFACES, AS NOTED IN SECTION 2615 OF SPECIFICATIONS.
- 17. IT SHALL BE THE CONTRACTORS RESPONSIBILITY TO SECURE PROPERTY FOR STAGING MATERIALS AND EQUIPMENT.
- 18. IT WILL BE THE CONTRACTOR'S RESPONSIBILITY TO ACQUIRE, OR ENTER INTO AGREEMENTS, FOR LANDS FOR LAY DOWN AREAS AND STAGING. THE COUNTY WILL COORDINATE AND ADMSE, TO HELP IDENTIFY POSSIBLE PARCELS. IT IS FINALLY THE CONTRACTOR'S RESPONSIBILITY TO SECURE THE NEEDED AREAS, AND THE COUNTY TAKE NO RESPONSIBILITY FOR DELAYS IN THIS REGARD.
- 19. COORDINATION AND PUBLIC INFORMATION FOR AND WITH AREA RESIDENTS ARE OF THE UTMOST IMPORTANCE. CONTRACTOR WILL INSURE ADHERENCE TO THE COUNTY'S NOISE ORDINANCE, HAZARD AND SAFETY, AND NUISANCE ABATEMENT DIRECTIONS, PLANS, OBJECTIONS AND ORDINANCES. THE ENGINEER WILL HAVE THE FINAL DISCRETION IN THIS REGARD, AS REPRESENTED ONSITE BY THE COUNTY INSPECTOR AND ENGINEER'S STAFF.

SAFETY

- 20. THE CONTRACTOR SHALL BE RESPONSIBLE FOR COMPLIANCE WITH THE FLORIDA TRENCH SAFETY ACT, 90-96, LAWS OF FLORIDA EFFECTIVE OCTOBER 1, 1990 AND THE OCCUPATIONAL SAFETY AND HEALTH ADMINISTRATION EXCAVATION SAFETY SANDARDS, 29 CFR 1926.650, SUBPART P, AS AMENDED, THE CONTRACTOR SHALL INCLUDE IN THE TOTAL BID PRICE ALL COSTS FOR COMPLIANCE WITH THESE REGULATIONS.
- 21. THE CONTRACTOR SHALL USE SHEET PILING, SHEETING, BRACING, ETC., AS REQUIRED IN ALL EXCAVATION AREAS AND CONFORM TO ALL OSHA REQUIREMENTS.
- 22. THE CONTRACTOR SHALL USE ALL NECESSARY SAFETY PRECAUTIONS TO AVOID CONTACT WITH OVERHEAD AND UNDERGROUND UTILITIES, POWER LINES, ETC.
- 23. THESE DRAWINGS DO NOT INCLUDE NECESSARY COMPONENTS FOR CONSTRUCTION SAFETY. THIS EXCLUSION DOES NOT ALLEMATE THE CONTRACTOR FOR PROVIDING A CONTINUOUS SAFE WORKSPACE.

- 24. WHEN A BENTONITE SPILL OR FRACK-OUT OCCURS OR THERE IS A LOSS OF RETURN INDICATING EXCESSIVE SEEPAGE OR LOSS OF DRILLING FUND, DRILLING MUST BE STOPPED UNTIL THE LOCATION OF THE SPILL IS IDENTIFIED, UNDER NO CIRCUMSTANCES WILL DRILLING CONTINUE WHEN A SPILL IS APPARENT.
- 25. ONCE LOCATED, THE BENTONITE SPILL MUST BE ISOLATED AND SEEPAGE INTO ANY NEARBY WATER BODIES WILL BI BLOCKED DEPENDING ON THE DEGREE OF THE SPILL, THE ISOLATED BENTONITE MUST BE REMOVED MANUALLY OR MECHANICALLY AND DISPOSED OF BY APPROPRIATE MEANS OR REUSED.
- 26. THE CONTRACTOR SHALL PROVIDE AND INSTALL ALL NECESSARY STORM WATER, EROSION, AND SEDIMENTATION CONTROL MEASURES IN ACCORDANCE WITH THE FDEP "FLORIDA STORM WATER, EROSION AND SEDIMENTATION CONTROL INSPECTOR'S MANUAL". IT IS THE RESPONSIBILITY OF THE CONTRACTOR TO CONTROL AND PREVENT EROSION AND TRANSPORT OF SEDIMENT TO SURFACE DRAINS AND TO DITCHES DURING CONSTRUCTION.
- 27. STOCKPILES SHALL BE PROTECTED AT ALL TIMES BY ON-SITE DRAINAGE CONTROLS WHICH PREVENT EROSION OF THE STOCKPILED MATERIAL CONTROL OF DUST FROM SUCH STOCKPILES IS REQUIRED, DEPENDING UPON THEIR LOCATION AND THE EXPECTED LENGTH OF TIME THE STOCKPILES WILL BE PRESENT. IN NO CASE SHALL ANY STOCKPILED MATERIAL REMAIN AFTER THIRTY (30) CALENDAR DAYS.
- 28. STORM WATER INLETS IN THE MICHITY OF THE PROJECT SHALL BE PROTECTED BY SEDIMENT TRAPS SUCH AS SECURED HAY BALES, SOD, STONE, ETC., WHICH SHALL BE MAINTAINED AND MODIFIED AS REQUIRED BY CONSTRUCTION PROGRESS, AND WHICH MUST BE APPROVED BY THE ENGINEER BEFORE INSTALLATION. THIS WILL BE MAINTAINED TO PREVENT DEGRADATION OF THE WATERS OF THE COUNTY AND STATE.
- 29. SEDIMENT BASINS AND TRAPS, PERIMETER BERMS, SEDIMENT BARRIERS, VEGETATIVE BUFFERS, AND OTHER MEASURES INTENDED TO TRAP SEDIMENT AND/OR PREVENT THE TRANSPORT OF SEDIMENT ONTO ADJACENT PROPERTIES, OR INTO EXISTING BODIES OF WATER, MUST BE INSTALLED, CONSTRUCTED, OR IN THE CASE OF VEGETATIVE BUFFERS, PROTECTED FROM DISTURBANCE, AS A FIRST STEP IN THE LAND ALTERATION PROCESS, SUCH SYSTEMS SHALL BE FULLY OPERATIVE BEFORE ANY OTHER DISTURBANCE OF THE SITE BEGINS. EARTHEN STRUCTURE INCLUDING BUT NOT LIMITED TO BERMS, EARTH FILTERS, DAMS OR DIKES SHALL BE STABILIZED AND PROTECTED FROM DRAINAGE DAMAGE OR EROSION WITHIN ONE (1) WEEK OF INSTALLATION.
- 30. ALL SWALES, DITCHES, AND CHANNELS LEADING FROM THE SITE SHALL BE PROTECTED FROM SILTATION AND EROSION DURING CONSTRUCTION AND BE SODDED WITHIN THREE (3) DAYS OF EXCAVATION.

- 31. SOIL DISPLACED BY CONSTRUCTION WILL BE REMOVED. EROSION CONTROL SHALL BE IMPLEMENTED IN AREAS WHICH ARE CONSIDERED ENVIRONMENTALLY SENSITIVE. EROSION CONTROL SYSTEMS SHALL BE REQUIRED FOR ALL WORK WITHIN JURISDICTIONAL AREAS. THESE SYSTEMS MAY INCLUDE STAKED HAY BALES, SILT SCREENS, FILTER FABRIC, AND TURBINITY SCREENS.
- 32. ALL EROSION AND POLLUTION CONTROL DEVICES SHALL BE CHECKED REGULARLY, ESPECIALLY AFTER EACH RAINFALL AND SHALL BE CLEANED OUT AND/OR REPAIRED AS REQUIRED.
- 33. THE CONTRACTOR SHALL NOT ENTER UPON OR IN ANY WAY ALTER WETLAND AREAS THAT MAY BE ON OR NEAR THE CONSTRUCTION SITE. ALL WORK IN THE MCINITY OF OPEN WATER AND/OR WETLANDS IS TO BE PERFORMED IN COMPILANCE WITH THE ENVIRONMENTAL REGULATIONS AND/OR PERMITS FOR THE SITE. THE CONTRACTOR WILL BE RESPONSIBLE FOR ANY FINES RESULTING FROM HIS WOLLATION OF ANY REGULATIONS OR PERMIT CONDITIONS.
- 34. CONTRACTOR SHALL PROVIDE PROTECTIVE MATTING, FUEL CONTAINMENT AND ALL OTHER MATERIALS, EQUIPMENT AND LABOR TO PROTECT THE STAGING AREA DURING CONSTRUCTION.
- 35. CONTRACTOR SHALL, PRIOR TO BEGINNING CONSTRUCTION, SUBMIT A "FUELING SPILL PREVENTION PLAN" THAT SHALL CLEARLY INDICATE HOW FUEL SPILLS WILL BE PREVENTED WHEN FUELING BOTH WITHIN AND CUTSIDE OF THE STAGING AREA.

RIGHT-OF-WAY

- 36. ALL CONSTRUCTION ACTIVITIES SHALL BE LIMITED TO WITHIN THE MANATEE COUNTY RIGHT-OF-WAY, DITHER PUBLIC RIGHT-OF-WAYS OR EASEMENTS SHOWN ON THE DRAWINGS.
- 37. THE CONTRACTOR SHALL EMPLOY A LAND SURVEYOR REGISTERED IN THE STATE OF FLORIDA TO REFERENCE AND RESTORE PROPERTY CORNER MONUMENTS, PINS, AND LANDMARKS THAT MAY BE DISTURBED BY CONSTRUCTION AT NO ADDITIONAL COST TO THE OWNER.
- 38. THE CONTRACTOR, PRIOR TO CONSTRUCTION AND RESTRICTING ANY TRAFFIC, MUST OBTAIN ANY REQUIRED RIGHTS—OF—WAY USE PERMITS AND A TRAFFIC CONTROL PLAN. THE CONTRACTOR SHALL OBTAIN ALL REQUIRED PERMITS FROM OTHER GOVERNMENTAL AGENCIES HAVING RELEVANT JURISDICION. ALL MANIFAME AND PROTECT OF TRAFFIC SHALL BE IN ACCORDANCE WITH THE APPLICABLE REQUIREMENTS OF THE CURRENT FLORIDA DEPARTMA OF TRANSPORTATION "MANUAL OF TRAFFIC CONTROL AND SAFE PRACTICES". A TRAFFIC CONTROL PLAN SHALL BE SUPPLIED BY THE CONTRACTOR AT THE PRE-CONSTRUCTION MEETING, PER SPECIFICATIONS 01570.
- 39. THE CONTRACTOR SHALL BE RESPONSIBLE FOR REPLACING ALL DAMAGED STORM WATER STRUCTURES, PIPING, ENTRANCE PIPE AND HEADWALLS WHETHER SHOWN ON THE PLANS OR NOT. THE HEADWALLS SHALL BE REPLACED IN ACCORDANCE WITH FLOAT, STANDARDS, OR THE APPLICABLE JURISDICTION.
- 40. IT IS THE RESPONSIBILITY OF THE CONTRACTOR TO ESTABLISH IN THE FIELD THE RIGHT-OF-WAY LINES, BASE LINES, BENCH MARKS (ELEY.), CENTER LINES, AND STATIONING AS REQUIRED TO CONSTRUCT THIS PROJECT.
- 41. THE CONTRACTOR SHALL COORDINATE THE CUTTING OF DRIVEWAYS WITH THE PROPERTY OWNER PRIOR, ALL DRIVEWAYS MUST BE IN PASSABLE CONDITION AT THE END OF THE WORK DAY AND FULLY RESTORED.
- 42. A RIGHT OF ENTRY AGREEMENT SHALL BE OBTAINED BY THE CONSTRUCTION MANAGER FROM THE PROPERTY OWNER BEFORE ANY DRIVEWAY CONSTRUCTION WORK IS DONE OUTSIDE OF THE RIGHT-OF-WAY OR EASEMENT.

UTILITIES

- 43. LOCATIONS, ELEVATIONS AND DIMENSIONS OF EXISTING UTILITIES, STRUCTURES AND OTHER FEATURES ARE SHOWN TO THE BEST INFORMATION AVAILABLE AT THE TIME OF PREPARATION OF THESE PLANS BUT DO NOT PURPORT TO BE ASSOLUTELY CORRECT. THERE MAY BE OTHER MEMORYMENTS, UTILITIES, ETC. WHICH ARE WITHIN THE PROJECT AREA AND WHICH HAVE NOT BEEN LOCATED OR DEDITIFIED, MAY NOT BE IN THE EXACT LOCATION SHOWN OR RELOCATED SINCE THE PREPARATION OF THESE PLANS. THE CONTRACTOR SHALL VERIFY, PRIOR TO CONSTRUCTION, THE LOCATIONS, ELEVATIONS AND DIMENSIONS OF ALL EXISTING UTILITIES STRUCTURES AND OTHER FEATURES (WHETHER OR NOT SHOWN ON THE PLANS) THE CONTRACTOR SHALL VERIFY, PRIOR TO CONSTRUCTION OF THE STRUCTURES AND OTHER FEATURES (WHETHER OR NOT SHOWN ON THE PLANS) THAT MAY EFFECT HIS WORK. ALL EXISTING UTILITIES TO BE EXTENDED, CROSSED OR CONNECTION POINTS SHALL BE EXPOSED PRIOR TO CONSTRUCTION TO VERIFY LOCATION AND ELEVATION. ANY DISCREPANCIES OR CONFLICTS FOUND SHALL BE BROUGHT TO THE ENGINEER'S ATTENTION FOR RESOLUTION.
- 44. THE CONTRACTOR SHALL PROTECT ALL EXISTING STRUCTURES, WATER AND SEWER LINES, STORM DRAINS, UTILITIES, DRIVEWAYS, SIDEWALKS, SIGNS, MAIL BOXES, FENCES, TREES, LANDSCAPING, AND ANY OTHER IMPROVEMENT OR FACILITY IN THE CONSTRUCTION ACTIVITIES TO EQUAL OR BETTER THAN PRE-CONSTRUCTION CONDITIONS AT NO ADDITIONAL COST TO THE OWNER.
- 45. THE CONTRACTOR SHALL USE APPROPRIATE TECHNIQUES, AS APPROVED, RECOMMENDED OR OFFERED BY FLORID POWER AND LIGHT TO PREVENT UNDERMINING OF POWER POLES DURING CONSTRUCTION. IF HOLDING OF POWER IS RECOMMENDED OR REQUIRED BY THE UTILITY, THE CONTRACTOR SHALL COORDINATE THIS ACTIVITY WITH THE UTILITY AND BEAR ALL RELATED COSTS.
- 46. ANY TEMPORARY SHUTDOWNS FOR MODIFICATIONS OF EXISTING UTILITY SYSTEMS THAT MUST REMAIN IN SERVICE DURING CONSTRUCTIONS SHALL BE KEPT TO A MINIMUM AND SHALL BE COORDINATED WITH AND APPROVED BY THE MANATER COUNTRY CITI
- 47. FOR WORK BEING DONE ON EXISTING SANITARY SEWER LINES, THE CONTRACTOR SHALL BE RESPONSIBLE FOR MAINTAINING THE FLOW OF ALL SEWAGE DURING CONSTRUCTION, WHICH MAY REQUIRE BY-PASS PUMPING AND, PUMPER TRUCKS. THE CONTRACTOR SHALL SUBMIT A DETAILED BY-PASS PUMPING PLAN PER SECTION 02720.
- 48. THE ELEVATIONS OF THE UTILITY SERVICES AND LATERALS HAVE BEEN ASSUMED ON THE BASIS OF TYPICAL ANTICIPATIONS OF THE UTILITY SERVICES AND LATERALS HAVE BEEN ASSUMED ON THE BASIS OF TYPICAL ANTICIPATED SCIL COVERAGE, CONTRACTOR SHALL NOT RELY ON THIS INFORMATION FOR CONSTRUCTION, BUT SHALL BE RESPONDED FOR THE AND THE SUBJECT PARCE MAIN CONTRACTOR SHALL INCLUDE IN THE UNIT COST OF THE SUBJECT PARCE MAIN CONSTRUCTION, THE PROPOSED FORCE MAIN CONSTRUCTION OF WITH THE CONSTRUCTION OF THE PROPOSED FORCE MAIN WATER MAIN. INTERCUPTIONS OF ANY EXISTING UTILITY SERVICES SHALL BE NOTICED TO EFFECTED CUSTOMERS A MINIMUM OF 46 HOURS IN ADVANCE AND SHALL NOT EXCEED 4 HOURS IN DURATION.

- 49. ALL RESTORATION WORK PERFORMED THROUGHOUT THE PROJECT SHALL CONFORM TO EXISTING LINES AND GRADES UNLESS SHOWN OTHERWISE.
- 50. ALL DISTURBED GRASSED AREAS SHALL BE SODDED UNLESS OTHERWISE INDICATED. THE TYPE OF SOD USED TO REPLACE OWNER MAINTAINED AREAS IN RIGHT-OF-WAY SHALL BE COORDINATED WITH THE PROPERTY OWNER.
- 52. ASPHALT DRIVES THAT ARE CUT SHALL BE RESTORED PER SECTION 02513.
- 53. CONCRETE DRIVEWAYS OR SIDEWALKS THAT ARE CUT SHALL BE RESTORED TO MATCH EXISTING ACCORDING TO THE CURRENT EDITIONS OF THE F.D.O.T. SPECIFICATIONS FOR ROAD AND BRIDGE DESIGN, SECTION 522 OF THE F.D.O.T. DESIGN STANDARDS.
- 54. WHENEVER A PERMANENT ROADWAY SURFACE IS NOT REPLACED IMMEDIATELY AFTER BACKFILLING AND COMPACTION OF THE NEMY INSTALLED PIPE LINE IN AREAS WHERE TRAFFIC MUST PASS, THE CONTRACTOR SHALL INSTALL A TEMPORARY SURFACE CONSISTING OF INNE INCHES OF COMPACTED LIME ROCK BASE AND A COAT OF ASPHALT EMULSION. PERMANENT ROADWAY REPAIR SHALL BE PERFORMED A MAXIMUM OF TWENTY-ONE CALENDAR DAYS AFTER THE INITIAL OPEN CUTTURG.
- 55. RESTORATION OF CURBS, DRIVEWAYS, SIDEWALKS, AND PLACEMENT OF SOD SHALL BE COMPLETED WITHIN FORTY-FIVE CALENDAR DAYS OF INITIAL DISTURBANCE, OR TWENTY-ONE CALENDAR DAYS OF SUBSTANTIAL COMPLETION, WHICHEVER OCCURS INIST.
- 56. ALL EXISTING FENCES DISTURBED DURING CONSTRUCTION SHALL BE REPAIRED OR REPLACED AND REINSTALLED BY THE CONTRACTOR AT NO ADDITIONAL COST TO THE OWNER UNLESS SHOWN TO BE REMOVED ON CONSTRUCTION PLANS.
- 57. WHERE CONCRETE REPAIRS ARE NECESSARY AND EXPANSION OR CONTRACTION JOINTS ARE PRESENT, CONTRACTOR SHALL REMOVE AND REPLACE CONCRETE UP TO THE NEXT EXPANSION OR CONTRACTION JOINT.

CONSTRUCTION

- 58. THE EXHAUST SYSTEM OF ALL GASOLINE AND DIESEL ENGINES SHALL BE EQUIPPED WITH MUFFLERS THAT MEET THE THE CAPACUST STORM OF ALL GASQUINE AND DEESE EXPINES SANGLE BE COPPED WITH MEET THE EQUIPMENT MANUFACTURER'S REQUIREMENTS FOR NOISE SUPPRESSION. THE CONTRACTOR SHALL INSTALL NOISE ABAILEMENT BAFFELS POSITIONED TO BREAK LINE—OF—SITE FROM THE NOISE SOURCE TO AFFECTED RESIDENCES, AS APPROVED BY THE DISINGER.
- 59. NO MATERIAL SHALL BE STOCKPILED IN ROADWAYS. ALL DIRT AND DEBRIS SHALL BE REMOVED FROM THE JOB SITE DAILY. ROADS SHALL BE SWEPT DAILY AS PART OF DAILY CLEAN UP. KHA PROJECT

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- 60. THE CONTRACTOR IS TO CONTROL ALL FUGITIVE DUST ORIGINATING ON THIS PROJECT BY WATERING OR OTHER METHODS AS REQUIRED.
- 61. INGRESS AND EGRESS TO ALL THE PROPERTIES IN THE CONSTRUCTION AREA SHALL BE MAINTAINED AT ALL TIMES.
- 62. PRIOR APPROVAL WILL BE REQUIRED FOR REMOVAL OR TRIMMING OF ANY TREE WITHIN THE CONSTRUCTION AREA
- ALL PIPING AND FITTINGS USED ON THIS PROJECT SHALL BE AS NOTED ON THE PLANS AND IN THE CONTRACT DOCUMENT AND SHALL BE INSTALLED TO THE LINES AND GRADES SHOWN ON THE PLANS AND PROFILES.
- 65. ALL PIPE SHALL BE COLOR CODED TO CONFORM TO MANATEE COUNTY STANDARDS.
- ALL FITTINGS FOR PRESSURE CLASS—RATED PIPE SHALL BE RESTRAINED DUCTILE IRON, RESTRAINED LENGTHS OF PIPE SHALL ADHERE TO THE REQUIREMENTS AS SHOWN ON THE DETAIL SHEETS.
- 87. WHERE IT IS NECESSARY TO DEFLECT PIPE EITHER HORIZONTALLY OR VERTICALLY, PIPE DEFLECTION SHALL NOT EXCEED 75% OF THE MANUFACTURER'S MAXIMUM ALLOWABLE RECOMMENDED DEFLECTION.
- 68. ALL ROCKS OR STONES LARGER THAN SIX INCH DIAMETER SHALL BE REMOVED FROM THE BACKFILL MATERIAL. BACKFILL MATERIAL PLACED WITHIN DNE FOOT OF PIPING AND APPURTENANCES SHALL NOT CONTAIN ANY STONES LARGER THAN TWO INCH DIAMETER.
- 69. ONLY MANATEE COUNTY UTILITY OPERATIONS STAFF ARE AUTHORIZED TO OPERATE VALVES AND PUMP STATIONS ON COUNTY OWNED AND MAINTAINED UTILITY SYSTEMS.
- 70. THE CONTRACTOR, PRIOR TO ANY TEMPORARY WATER SHUT-OFFS DURING WATER MAIN TIE-IN. ETC., SHALL NOTIFY 0. THE CONTRACTOR, PRIOR TO ANY TEMPORARY WATER SHUT-OFFS DURING WATER MAIN TE-IN, ETC., SHALL NOTIFY THE AFFECTED RESIDENTS BY POSTING INFORMATIONAL SIGNS IN THE NEIGHBORTHOOD AT LEAST TOO DAYS (48 HRS) PRIOR TO THE WATER SHUT-OFF, REFERENCE SECTION 01580, PARAGRAPH 1.0.3 OF THE SPECIFICATIONS, WHEN FEASIBLE, DOOR HANGERS' SHALL BE DELIVERED TO AFFECTED RESIDENCES AT LEAST TWO DAYS (48 HRS) PRIOR TO WATER SHUT-OFF. FOR LARGE PROJECTS WITH HUNDREDS OF HOMES AFFECTED, THE CONTRACTOR SHALL ALSO MAKE EXTENSIVE USE OF THE MEDIA AND SHALL HAVE PRIOR CONTRACT WITH HOMEOWER'S ASSOCIATIONS AND THE RESPECTIVE CITY'S. WRITTEN NOTIFICATIONS SHALL ALSO BE FAXED TO THE TAMPA TRIBUNE, BRADENTON HEADLY AMI SUN, ISLANDER, SKANSOTA HERALD TRIBUNE, WASOR RADIO, TO THE MEDIA AND THE RESPECTIVE CITY'S. WRITTEN NOTIFICATIONS SHALL ALSO BE FAXED TO THE TAMPA TRIBUNE, BRADENTON HEADLY, WATER MANAGER, HELPLINE, CUSTOMER SERVICE, AND THE MANATEE COUNTY UTILITY OPERATIONS DEPARTMENT.
- ALL TEST POINT PIPING SHALL BE CUT LOOSE FROM THE CORPORATION STOP AND COMPLETELY REMOVED AND DISPOSED OF BY THE CONTRACTOR PRIOR TO FINAL ACCEPTANCE. A CORPORATION STOP PLUG SHALL BE INSTALLED AND THE CORPORATION STOP SHALL REMAIN IN PLACE.
- 72. ALL EXISTING MAINS THAT ARE BEING REPLACED SHALL BE ABANDONED IN PLACE UPON ACCEPTANCE AND ACTIVATION OF THE NEW MAINS. ABANDONED MAINS SHALL BE CUT AND CAPPED. REFER TO SECTION 02064 OF THE SPECIFICATIONS FOR CUIT AND CAPPING ABANDONED PIPE.
- 73. FIELD CONDITIONS MAY NECESSITATE MINOR ALIGNMENT AND GRADE DEVIATION OF THE PROPOSED UTILITIES TO AVOID OBSTACLES, AS ORDERED BY THE ENGINEER.
- 74. THE CONTRACTOR SHALL OBTAIN AUTHORIZATION FROM THE MANATEE COUNTY UTILITIES DEPARTMENT (MCUD) OFFICE OF INDUSTRIAL COMPLIANCE PRIOR TO DEWATERING. COMPLETION OF A CONSTRUCTION DEWATERING AUTHORIZATION TO DISCHARGE APPLICATION IS REQUIRED. FILL OUT FORM AS COMPLETELY AS POSSIBLE AS MISSING INFORMATION DELAYS THE APPROVAL PROCESS.
- 75. THE MOUD OFFICE OF INDUSTRIAL COMPLIANCE WILL DETERMINE WHETHER A LETTER OF APPROVAL, A DISCHARGE AUTHORIZATION. OR A DISCHARGE PERMIT IS REQUIRED.
- 76. FOR SITES SUSPECTED OF CONTAMINATED GROUNDWATER MANATEE COUNTY WILL REQUIRE AN APPLICANT TO DEMONSTRATE THAT THE DISCHARGE MEETS THE MANATEE COUNTY SEWER USE ORDINANCE.
- . IF ANY RECLAIMED OR WATER MAINS INCLUDING SERVICE LINES ARE DAMAGED DURING CONSTRUCTION, THEY SHA BE REPLACED FROM THE VALUE TO THE OTHER POINT OF COMMERCION OUTSIDE OF THE ROADWAY PER MANATEE COUNTY'S STANDARDS. SERVICES SHALL HE REPLACED FROM THE COLD STOP TO THE METER.

- 78. TRAFFIC SHALL BE MAINTAINED IN ACCORDANCE WITH F.D.O.T. STANDARD PLAN INDICES NO. 600, 601, 602 603, 504, 805, AND 860 DEPENDING ON THE OPERATION BEIND PERFORMED.
 FOR ALL TWO-LANE WORK, TWO-WAY, WORK OUTSIDE OF SHOULDER UTILIZE INDEX 102-601.
 FOR ALL TWO-LANE WORK, TWO-WAY, WORK ON SHOULDER UTILIZE INDEX 102-602.
 FOR ALL TWO-LANE WORK, TWO-WAY, WORK WITH IN TRAVEL LANE UTILIZE INDEX 102-603.
 FOR ALL TWO-LANE WORK, TWO-WAY, WORK WITH IN INTERSECTION UTILIZE INDEX 102-604.
 FOR ALL TWO-LANE WORK, TWO-WAY, WORK WITH IN STERSECTION UTILIZE INDEX 102-605.
 FOR PALL TWO-LANE WORK, TWO-WAY, WORK WITH IN STERSECTION UTILIZE INDEX 102-605.
 FOR PEDESTRIAN CONTROL FOR CLOSURE OF SIDEWALK, UTILIZE INDEX 102-660.
- 79. CONTRACTOR TO COORDINATE WITH ED HERNDON (941) 708-4436 AT FDOT FOR ALL WORK DONE ON A STATE
- 80. TO AVOID DISRUPTION DUE TO INCLEMENT WEATHER, THE CONTRACTOR SHOULD PERFORM ANY MILLING AND PAYING OPERATIONS DURING THE SAME WORK PERIOD.
- ALL EXISTING PAVEMENT MARKINGS OUTSIDE THE CONSTRUCTION LIMITS THAT HAVE BEEN ALTERED BECAUSE OF CONSTRUCTION OPERATIONS SHALL BE REPLACED UPON THE COMPLETION OF THE PROJECT AT THE CONTRACTORS EXPENSE.
- 82. LANE CLOSURES SHALL OCCUR BETWEEN 9:00 P.M. AND 5:00 A.M., UNLESS LANE CLOSURE CALCULATIONS ARE PROVIDED AND APPROVED OR APPROVAL IS GRANTED BY THE DISTRICT PERMIT ENGINEER.
- THE CONTRACTOR SHALL SCHEDULE WORK OPERATIONS SO THAT ALL LANES CAN BE RE-OPENED TO TRAFFIC WITHIN A PERIOD OF 24 HOURS IN CASE OF AN EMERGENCY. 83. PEDESTRIANS, BICYCLES, AND WHEELCHAIRS:
- AT THE END OF EACH WORKDAY OR WHENEVER THE WORK ZONE BECOMES INACTIVE, ANY DROP-OFF ADJACENT TO A SIDEWALK SHALL BE BACKFILLED AT A SLOPE NOT TO EXCEED 1:4, OR SHALL BE PROTECTED IN ACCORDANCE WITH STANDARD INDEX FOR
- 84. PEDESTRIAN AND WHEELCHAIR TRAFFIC SHALL BE ACCOMMODATED UTILIZING STANDARD INDEX 680.
- 85. ONE PORTABLE VARIABLE MESSAGE SIGN SHALL BE USED IN ADVANCE OF EACH LANE CLOSURE. THE FOLLOWING ARE SUGGESTED MESSAGES TO USE IN THE APPROPRIATE SITUATIONS:

MESSAGE 1
"RIGHT" OR "CENTER" OR "LEFT"
"LANE" "LANE" "LANE" "CLOSED" "CLOSED" "CLOSED"

- 86. THE CONTRACTOR SHALL BE RESPONSIBLE FOR THE IMMEDIATE REMOVAL OF STORMWATER FROM ROADWAYS UTILIZED FOR TRAFFIC CONTROL IN A MANNER APPROVED BY THE ENGINEER.

- 87. AT THE END OF EACH WORKING DAY'S ACTIVITY, TEMPORARY PAVENENT MARKINGS AND TEMPORARY RPM'S SHALL BE INSTALLED PRIOR TO OPENING THE LANES UP TOR TRAFFIC.

 BB. ALL PAVEMENT MARKINGS, SIGNS, MARKERS, CHANNELLANTON REQUIRED TO PHASE WORKING SHIFT TRAFFIC, SHALL UTILIZE INDICES FOR PLACEMENT.

 89. THE CONTRACTOR SHALL RESTRICT THE OPERATIONS SO THAT THE TIEST LET OF ARBIALT IS A ACED ON THE SAME DAY THAT THE LANES ARE MILLED, BEFORE OPENING THE THAT THE INSTALL DEMPORERY PAVEMENT MARKINGS AFTER THE FIRST LIFT AND PROPE TO CREATING THE CONTRACT OF THE FIRST LIFT AND PROPE TO CREATING THE OFF-PEAK HOURS.

 90. MILLING AND RESURFACING SHALL BE ASSOMPTIONED DURING THE OFF-PEAK HOURS.

- 91. THE CONTRACTOR IS RESPONSIBLE TO RETIME THE TRAFFIC SIGNALS WITHIN THE PROJECT LIMITS (INCLUDING LIMITS OF WORK ZONE TRAFFIC CONTROL) THAT ARE POTENTIALLY AFFECTED DURING VARIOUS PHASES OF CONSTRUCTION. COORDINATE ALL SIGNAL RETIME EFFORTS MUKLINDA GOPALAKRISHINA, P.E., PTDE, COUNTY TRAFFIC ENGINEER, AT 941-749-3500, EXT. 7613.
- 92. CONTRACTOR TO MAINTAIN VEHICLE DETECTION IN OPERATION FOR LANES THAT WILL REMAIN OPEN. CONTRACTOR TO COORDINATE ALL VEHICLE DETECTION ISSUES WITH CLARKE DAYS OF MANATEE COUNTY AT 941-708-7456, EXT. 7272 OR CLARKEDDAYS
- 94. ANY SIGNAL RETIMING REQUIRED FOR THE INTERSECTIONS IMPACTED BY THE PROJECT WILL BE THE RESPONSIBILITY OF THE CONTRACTOR, SIGNAL TIMING MODIFICATIONS TO BE SUBMITTED TO MANATE COUNTY REAFFIC DESIGN, ATTEMTON MR. MUKUNDA, GOPALAKRISHNA FOR REVIEW AND APPROVAL AT LEAST 15 WORKING DAYS BEFORE PROPOSED CHANGES. THIS DOES NOT GOVERN EMERGENCY SITUATIONS, PROTONING THE APPROVAL OF THE DISINDER.
- 95. A DETAILED MAINTENANCE OF TRAFFIC PLANS ARE TO BE SUBMITTED TO MANATEE COUNTY AND THE ENGINEER, BY THE CONTRACTOR, FOR REVIEW AND APPROVAL A MINIMUM OF 21 WORKING DAYS PRIOR TO PROPOSED IMPLEMENTATION.

ABBREVIATIONS

- RESTRAINED JOINT RESTRAINED JOINT
RIGHT-OF-WAY
HORIZONTAL DIRECTIONAL DRILL
REINFORCED CONCRETE PIPE
AIR RELEASE VALVE
HIGH DENSITY POLYETHYLENE
POLYWNYL CHLORIDE
NATURAL GROUND

- STORM DRAIN
- EXISTING
- BURIED TELEPHONE
- UNDERGROUND CONDUIT
- DIRECT BURIED CABLE
- FIBER OPTIC CABLE
- SANITARY SEWER
- FORCE MAIN
- WATER MAIN
- BECLAUM WATER MAIN

KIMLEY HORN LEGEND EX. FORCEMAI PROPOSED FORCEMAIN/ EX. WATERMAIN EX. SANITARY SEWER —ss ------- 22 ----

EX. STORM - M.S. ---- N.S. ---- N.S. ---- N.S. ---EX. BURIED TELEPHONE/FIBER T PT

EX. FIBER OPTIC CABLE EX. DIRECT BURIED CABLE EX. UNDERGROUND CONDUCT

EX. BURIED ELECTRIC EX. GAS

EX. RECLAIM WATER EX. OVERHEAD UTILITIES

PROPOSED SHELL DRIVEWAY REPAIR

PROPOSED SIDEWALK/ CONCRETE DRIVEWAY XXXXXXXXX PROPOSED CURB REPAIR

PROPOSED MILLING AND RESURFACING

EX. ASPHALT DRIVEWAY

EX. CONCRETE DRIVEWAY

EX. SHELL DRIVEWAY

SHEET NUMBER

GENERAL NOTES

100 2ND AVENUE SOUTH, SUITE 300S, ST. PETERSBURG, FL 33701

REVISIONS

DATE

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PHONE: 727-547-3999

WWW.KIMI.EY-HORN.COM CA 00000698

DATE 5/3/2019 SCALE AS SHOW DESIGNED BY WWW DRAWN BY LMB

END OF SERVICE LIFE: FY-18

SAN REMO SHORES WM REPLACEMENT

ANATEF COUNTY

Manatee


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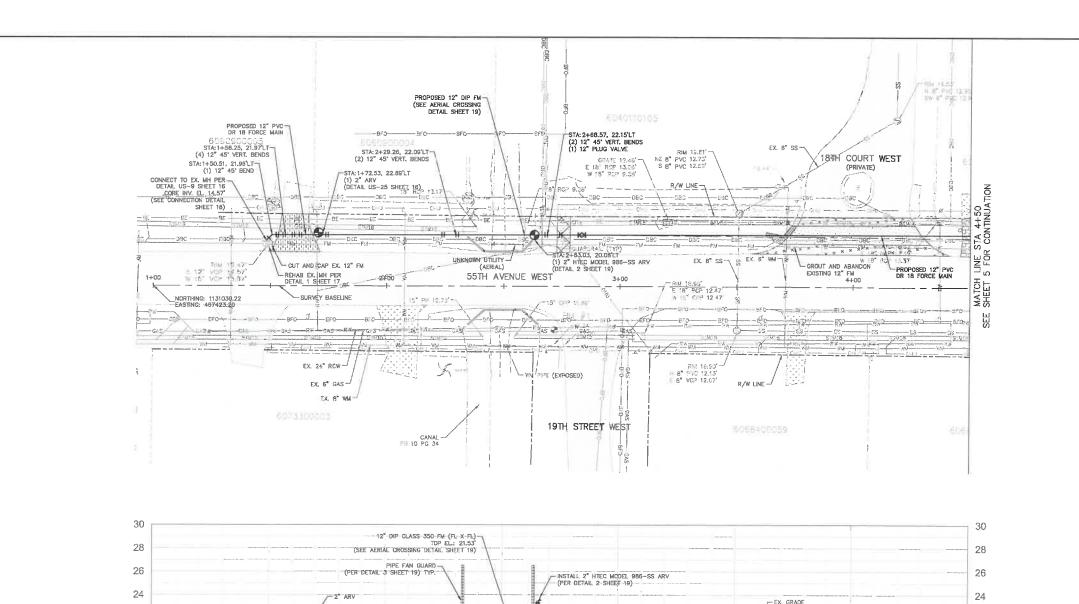
SAN REMO SHORES WM REPLACEMENT

PL DATE CHECKED BY SNR MANATEE COUNTY

TEER WILLIAM

2



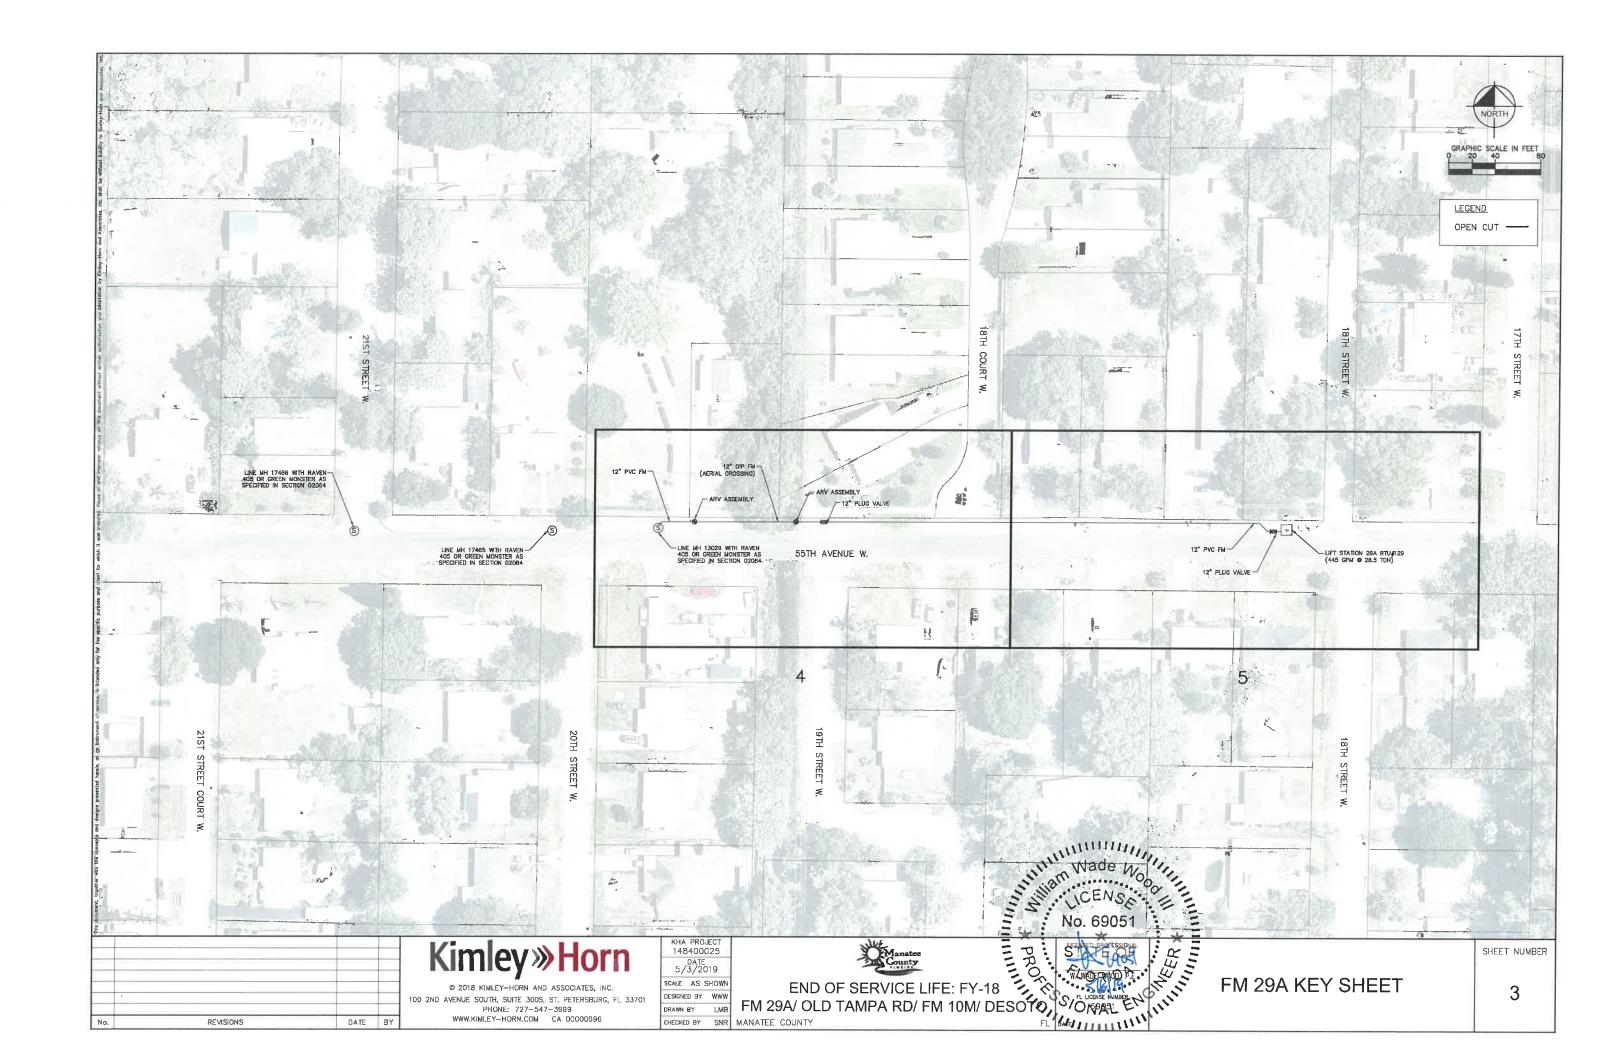

12" 45" DI VERT, BEND (FL)

3+00

-12" DIP CLASS 350 FM (FL K PF

EX. DBC*



LEGEND ASPHALT DRIVEWAY RESTORATION

SIDEWALK/CONCRETE DRIVEWAY RESTORATION

BRICK DRIVEWAY RESTORATION

SHELL DRIVEWAY RESTORATION

FULL ROADWAY RESTORATION

MILLING AND RESURFACING

REMOVE & REPLACE CURB

NOTES:

1. CONTRACTOR TO FOLLOW RESTRAINED LENGTH'S SET IN RESTRAIN LENGTH DETAILS ON SHEET 16 & 17.

+ + +

- 2. CONSTRUCTION DEWATERING SHALL BE CONDUCTED IN ACCORDANCE WITH ALL FEDERAL, STATE, AND LOCAL REQUIREMENTS INCLUDING BUT NOT LIMITED TO CHAPTERS 62-621.300 AND 62-620 OF THE FLORIDA ADMINISTRATIVE CODE (FAC).
- EXISTING FORCE MAIN SHALL BE FLUSH PRIOR TO GROUTING AFTER THE PROPOSED FORCE MAIN HAS BEEN PLACED INTO SERVICE.

*NOTES:
THE ELEVATIONS OF THE UTILITIES MARKED WITH AN ASTERISK (*) HAVE BEEN ASSUMED ON THE BASIS OF TYPICAL ANTICIPATED SOIL COVERAGE. CONTRACTOR SHALL NOT RELY ON THIS INFORMATION FOR CONSTRUCTION, BUT SHALL BE RESPONSIBLE FOR FIELD LOCATIONS (HORIZONTAL AND VERTICAL) OF ALL UTILITIES CROSSING THE PROPOSED FORCE MAIN. CONTRACTOR SHALL INCLUDE IN THE UNIT COST OF THE SUBJECT FORCE MAIN CONSTRUCTION, THE COST OF UTILITY ADJUSTMENTS NECESSARY TO ATTAIN DESIGN MINIMUM SEPARATION FOR UTILITIES ON THE ONLY THE PROPOSED FORCE MAIN. INTERRUPTIONS OF ANY EXISTING UTILITY SERVICES SHALL BE NOTICED TO EFFECTED CUSTOMERS A MINIMUM OF 48 HOURS IN ADVANCE AND SHALL DIT EXCEED 4 HOURS IN ADVANCE AND SHALL DIT EXCEED 4 HOURS IN DURATION.

22

20

18

12 10

Wade W8000 12 69051

No. 600

EX. RW SERVICE*

12° PVC DR 18 FM

EX. 18" STM --

WHERE CONCRETE REPAIRS ARE NECESSARY AND EXPANSION JOINTS ARE PRESENT, CONTRACTOR TO REMOVE AND REPLACE CONCRETE UP TO THE NEXT EXPANSION JOINT, OTHERWISE, REPLACE CONCRETE AS NECESSARY.

GROUNDWATER /

DEWATERING NOTE;
THE PRESENCE OF GROUNDWATER
SHOULD BE ANTICIPATED ON THIS
PROJECT. CONTRACTOR'S BID SHALL
INCLUDE CONSIDERATION FOR THIS
ISSUE WHEN PERFORMING GRADING
OPERATIONS DURING PERIODS OF WET
WEATHER, PROVIDE ADEQUATE
DEWATERING, DRAINAGE AND GROUND
WATER MANAGEMENT TO CONTROL
MOISTURE OF SOILS.



2+00

12" 45" VERT. BENDS

12" 45" DI VERT, BEND (FL) -

FLANGE PIPE SUPPORT UNDER FITTING (PER DETAIL 1 SHEET 19)

EX. 18" STM

12" 45" VERT. BEND (MJ)-

EX. WAL SERVICE: NE

EX. RW SERVICE*

1+50

DATE BY

22

20

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KHA PROJECT 148400025 DATE 5/3/2019 CALE AS SHOW DESIGNED BY WWW

DRAWN BY LMB

2+50




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3+50

SHEET NUMBER


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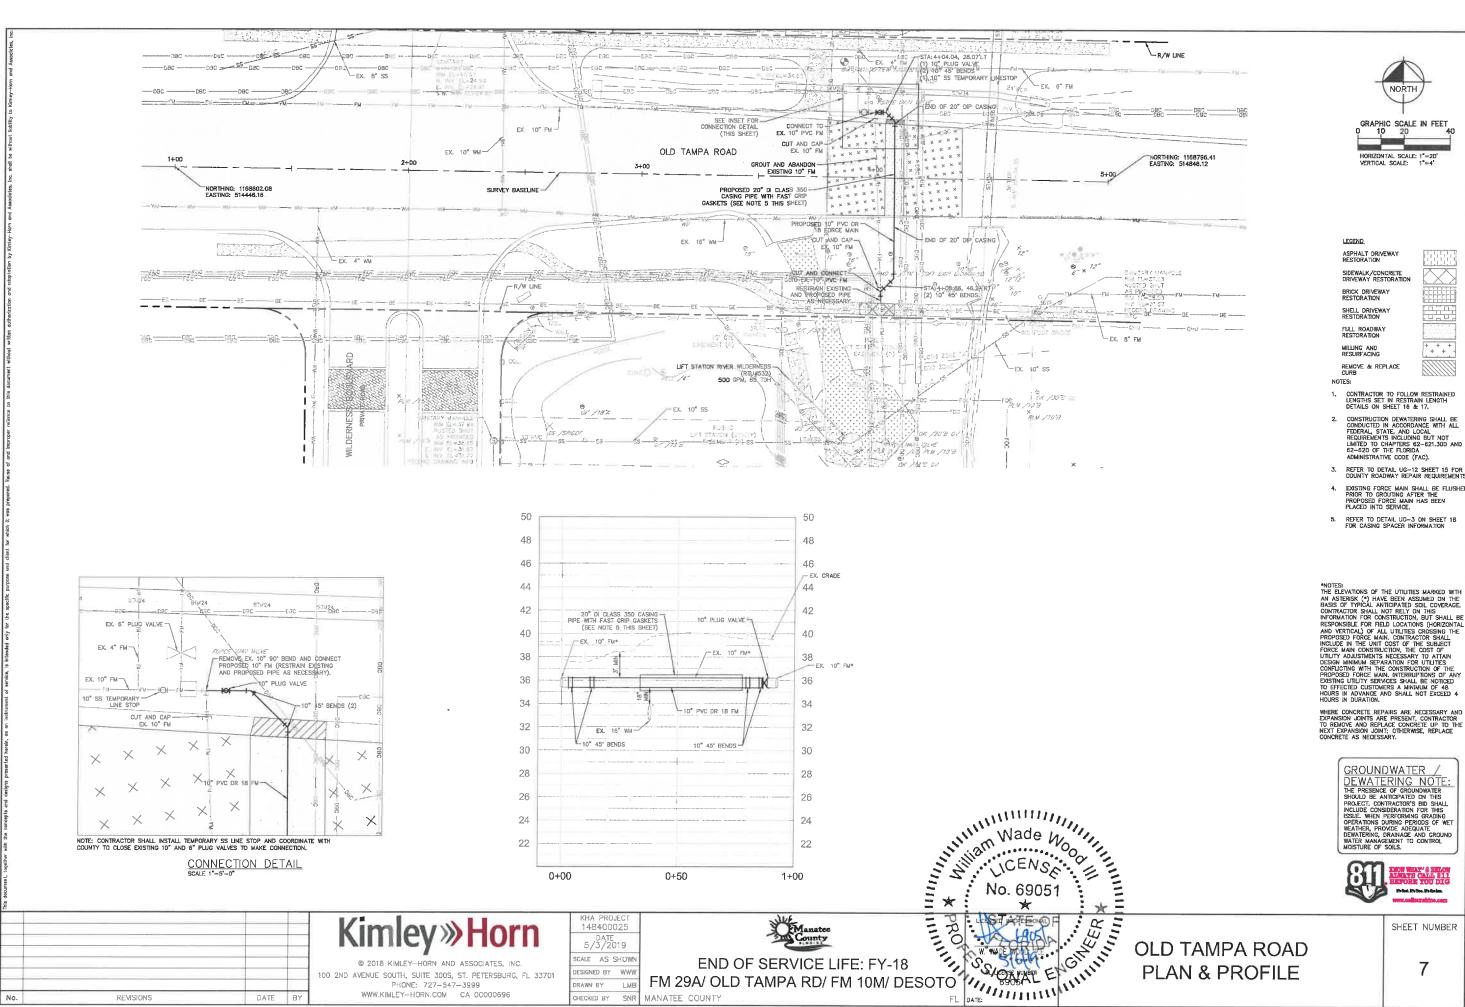


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REVISIONS

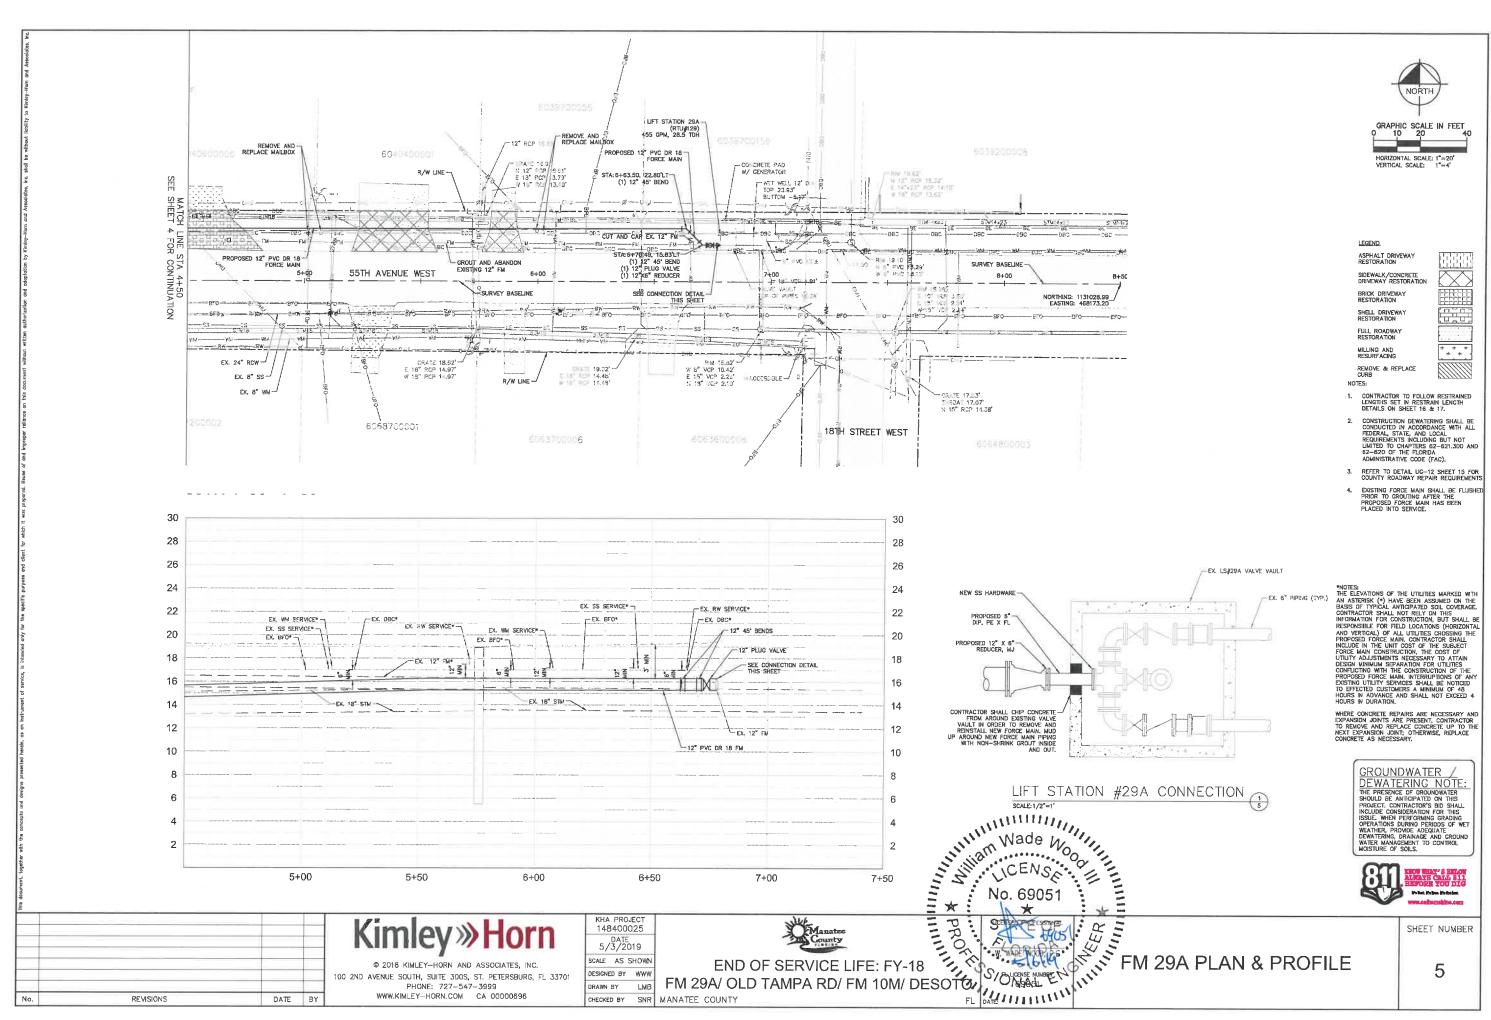DATE BY



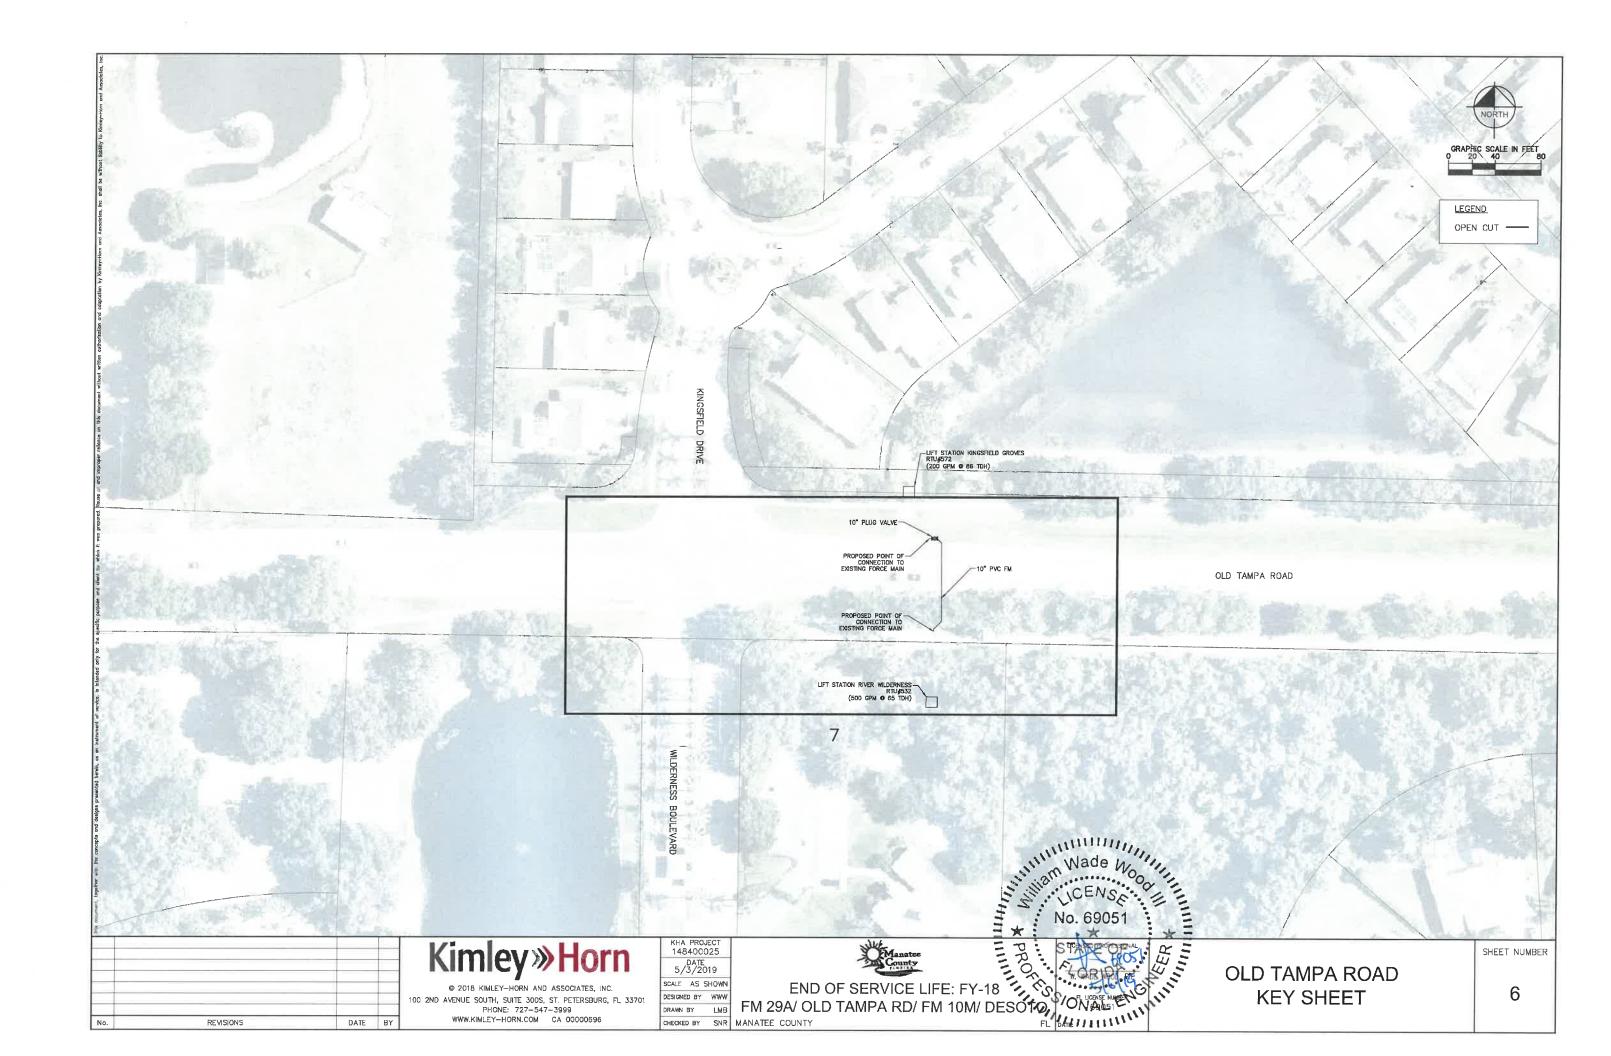



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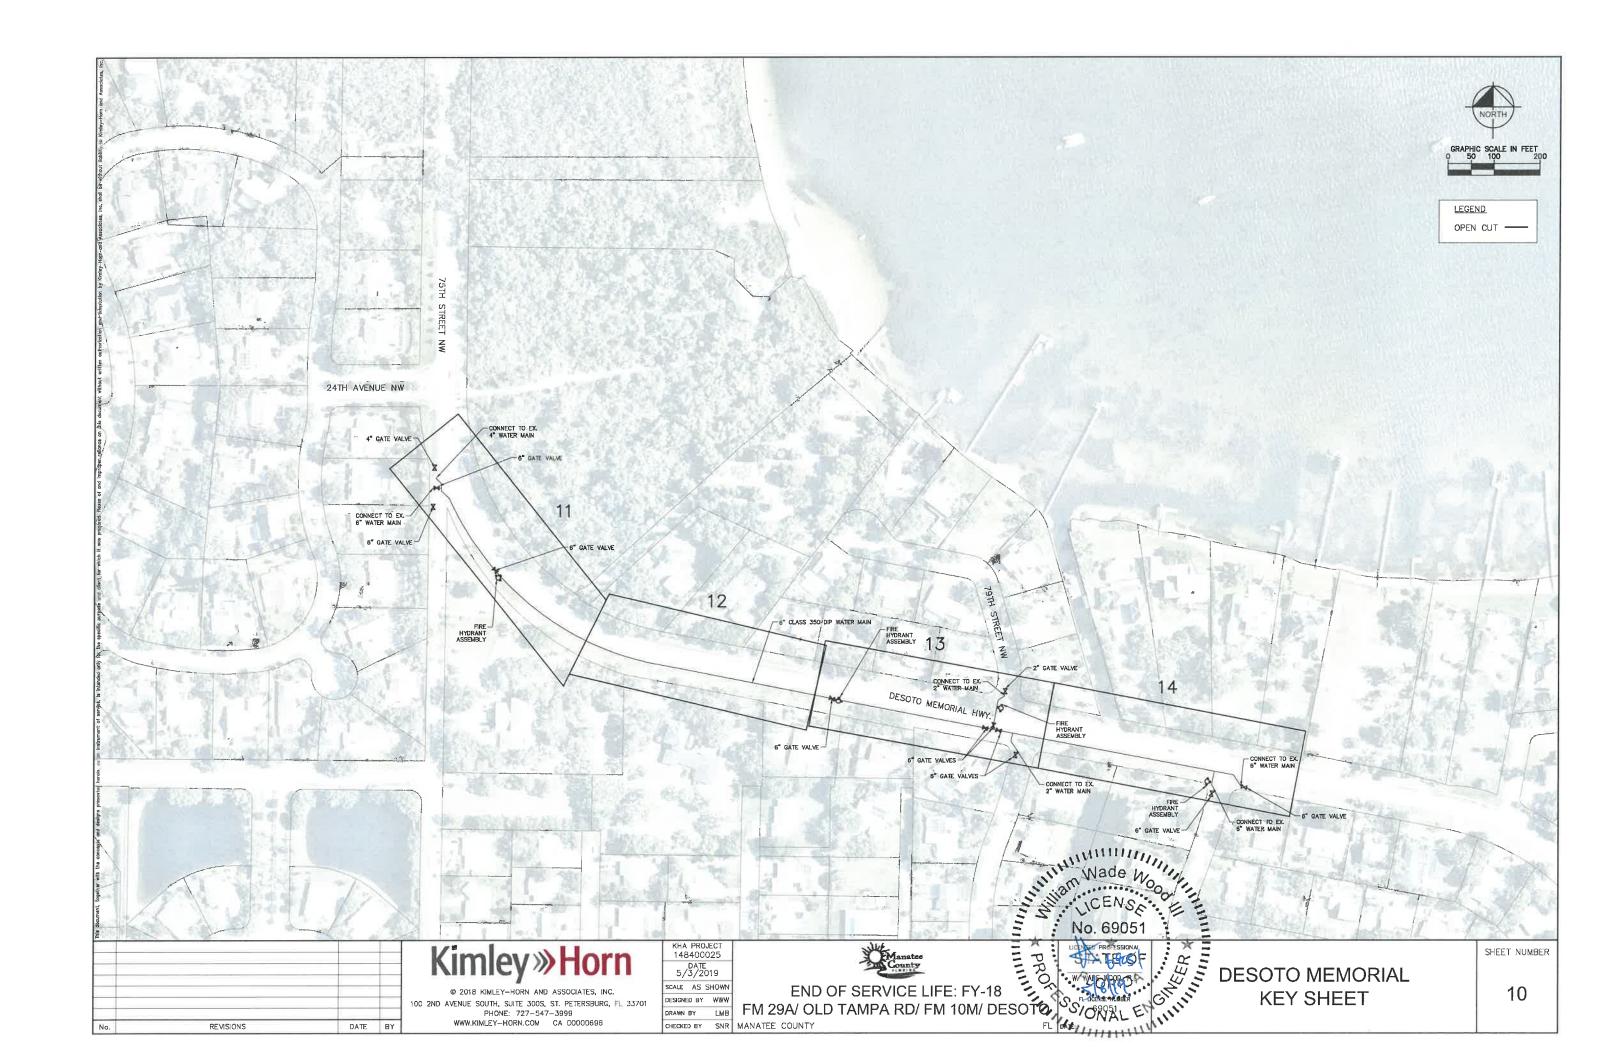
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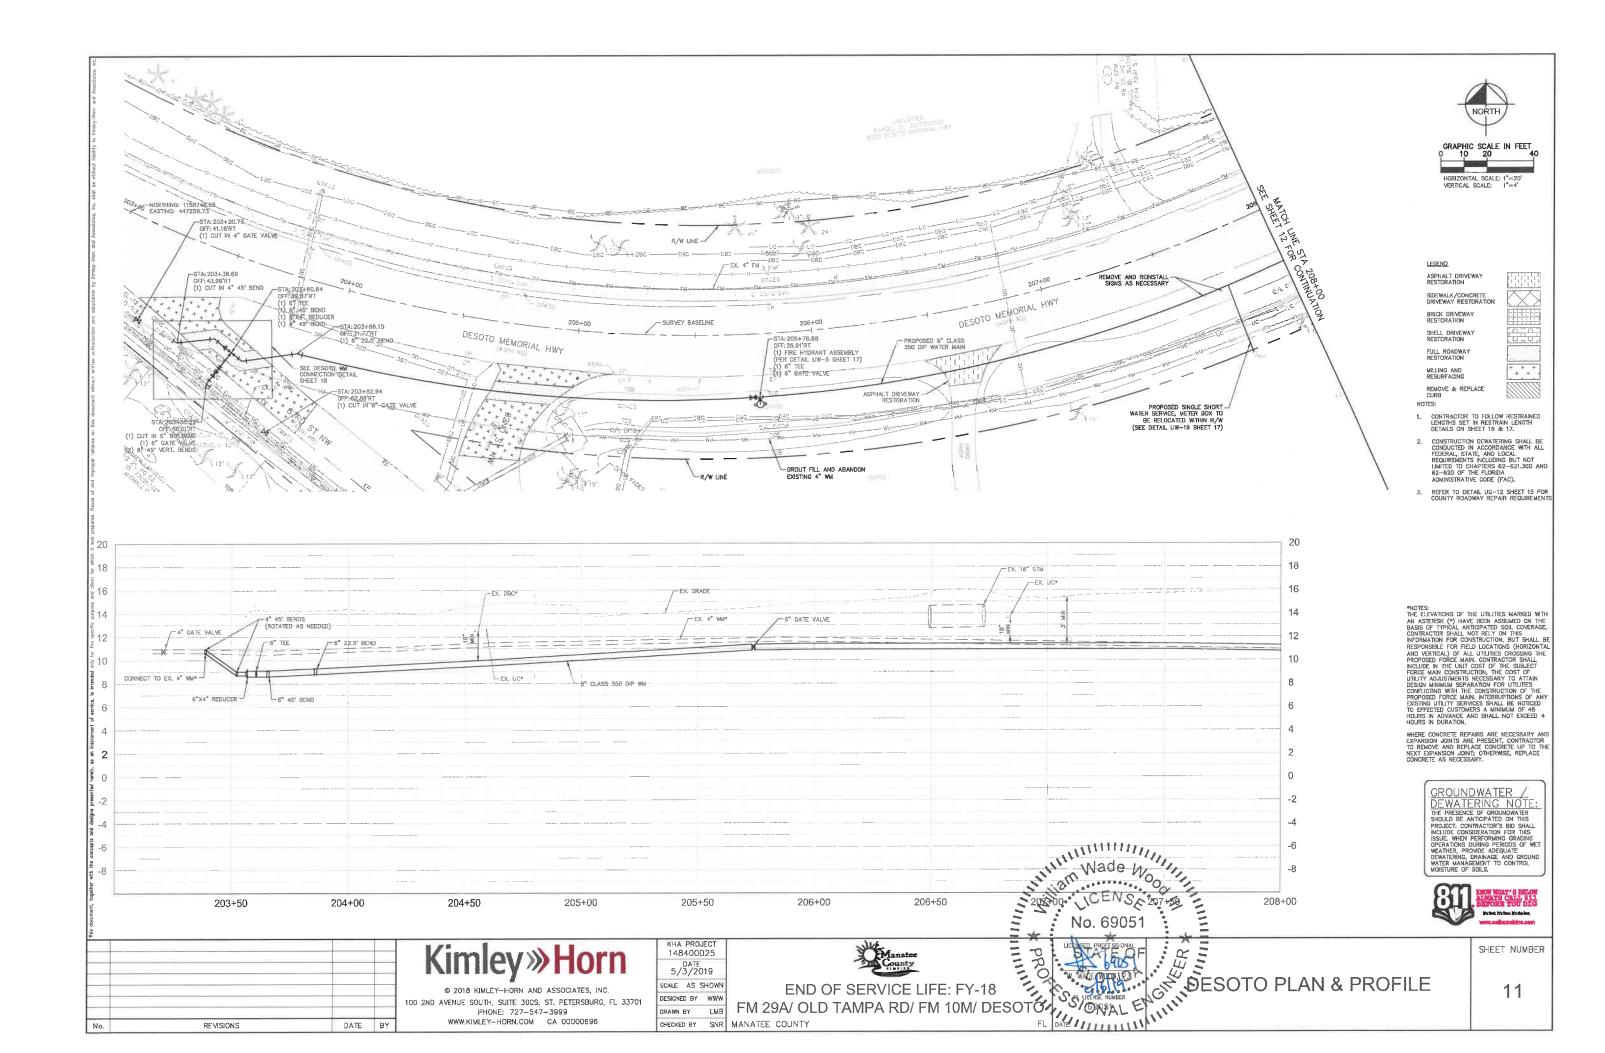
REVISIONS


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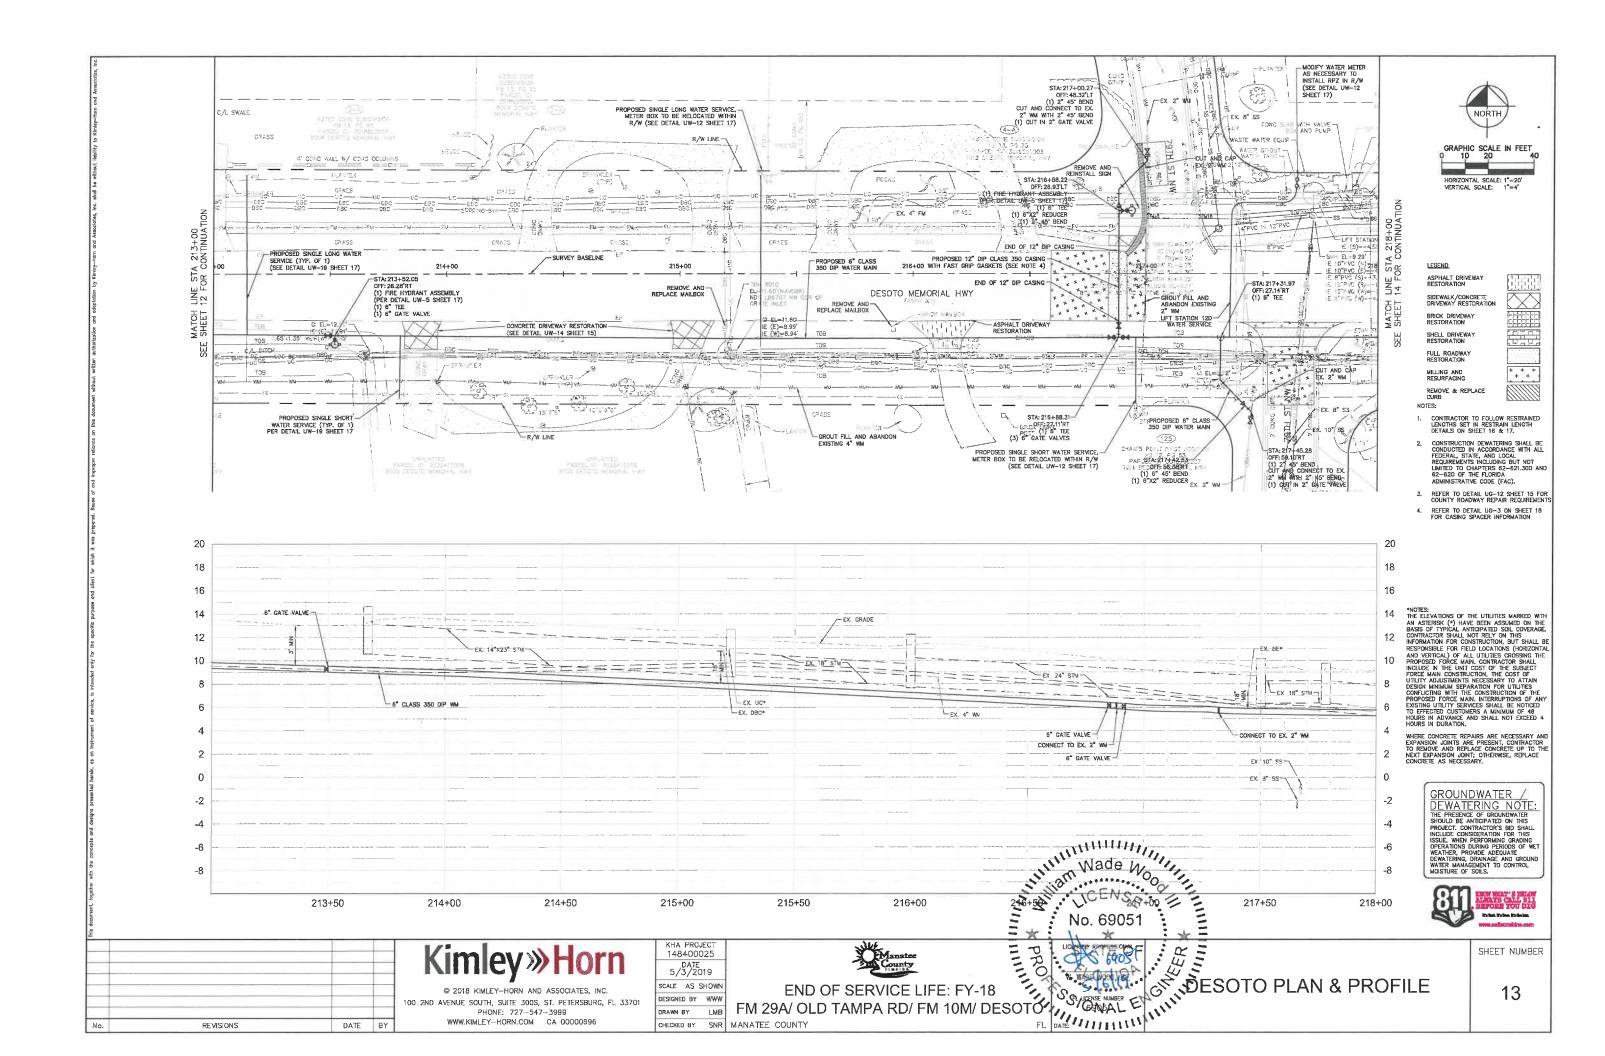








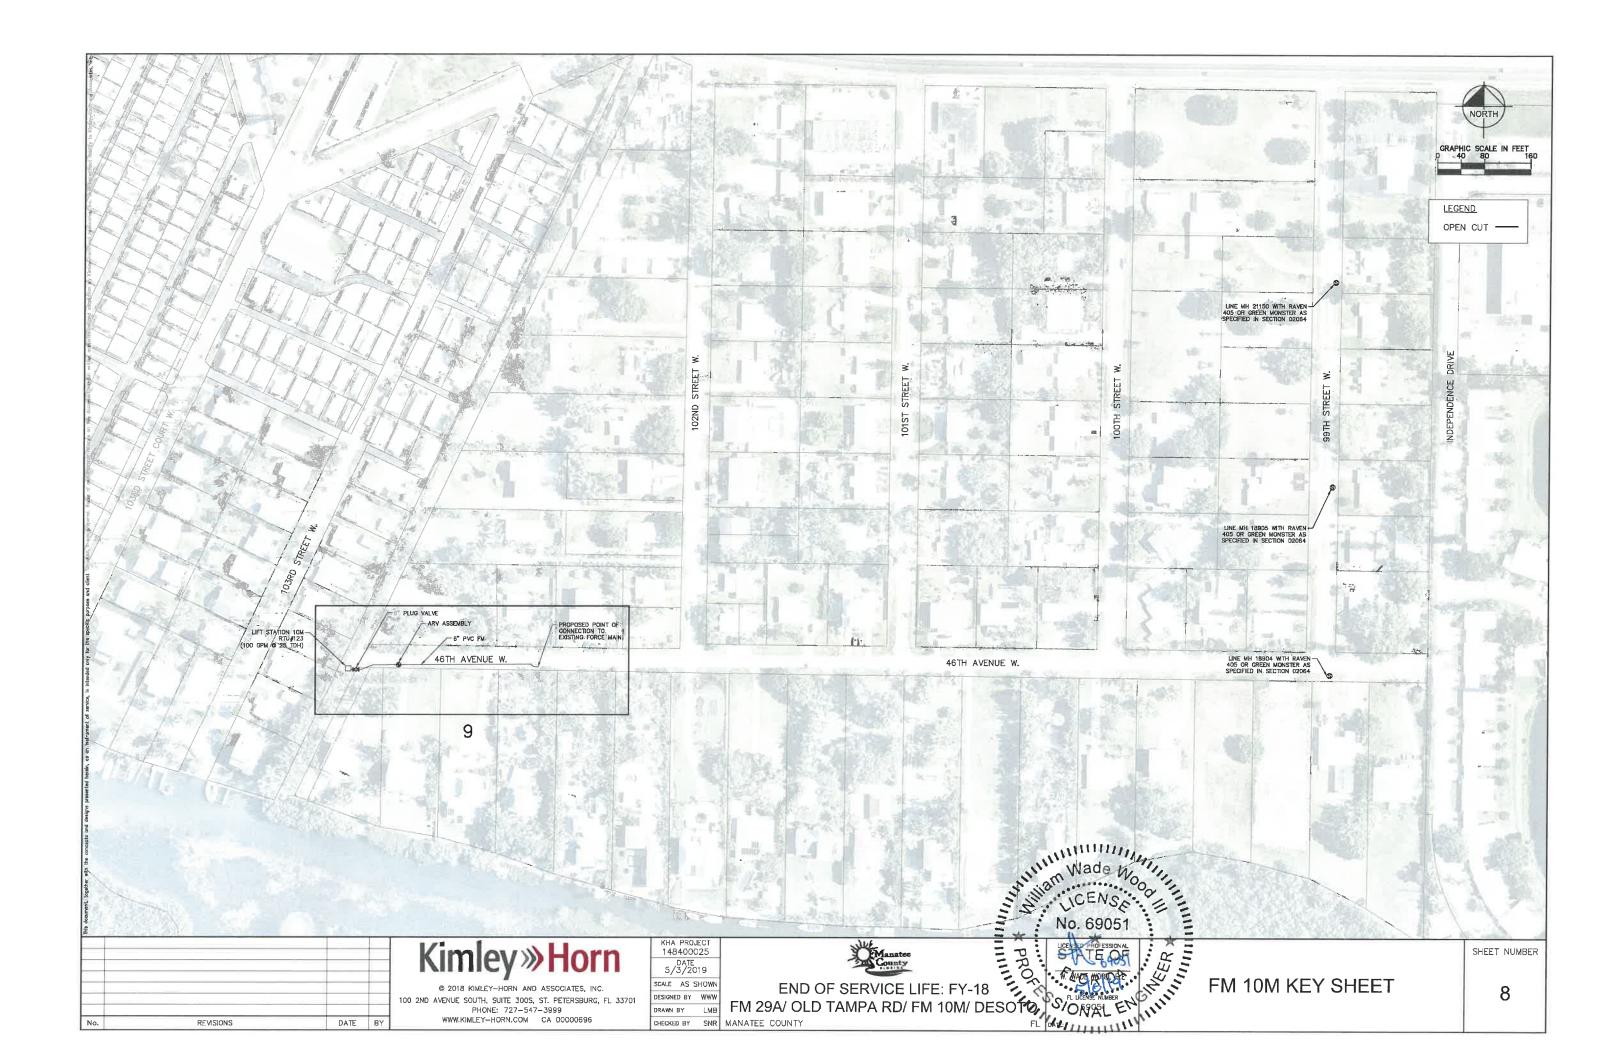


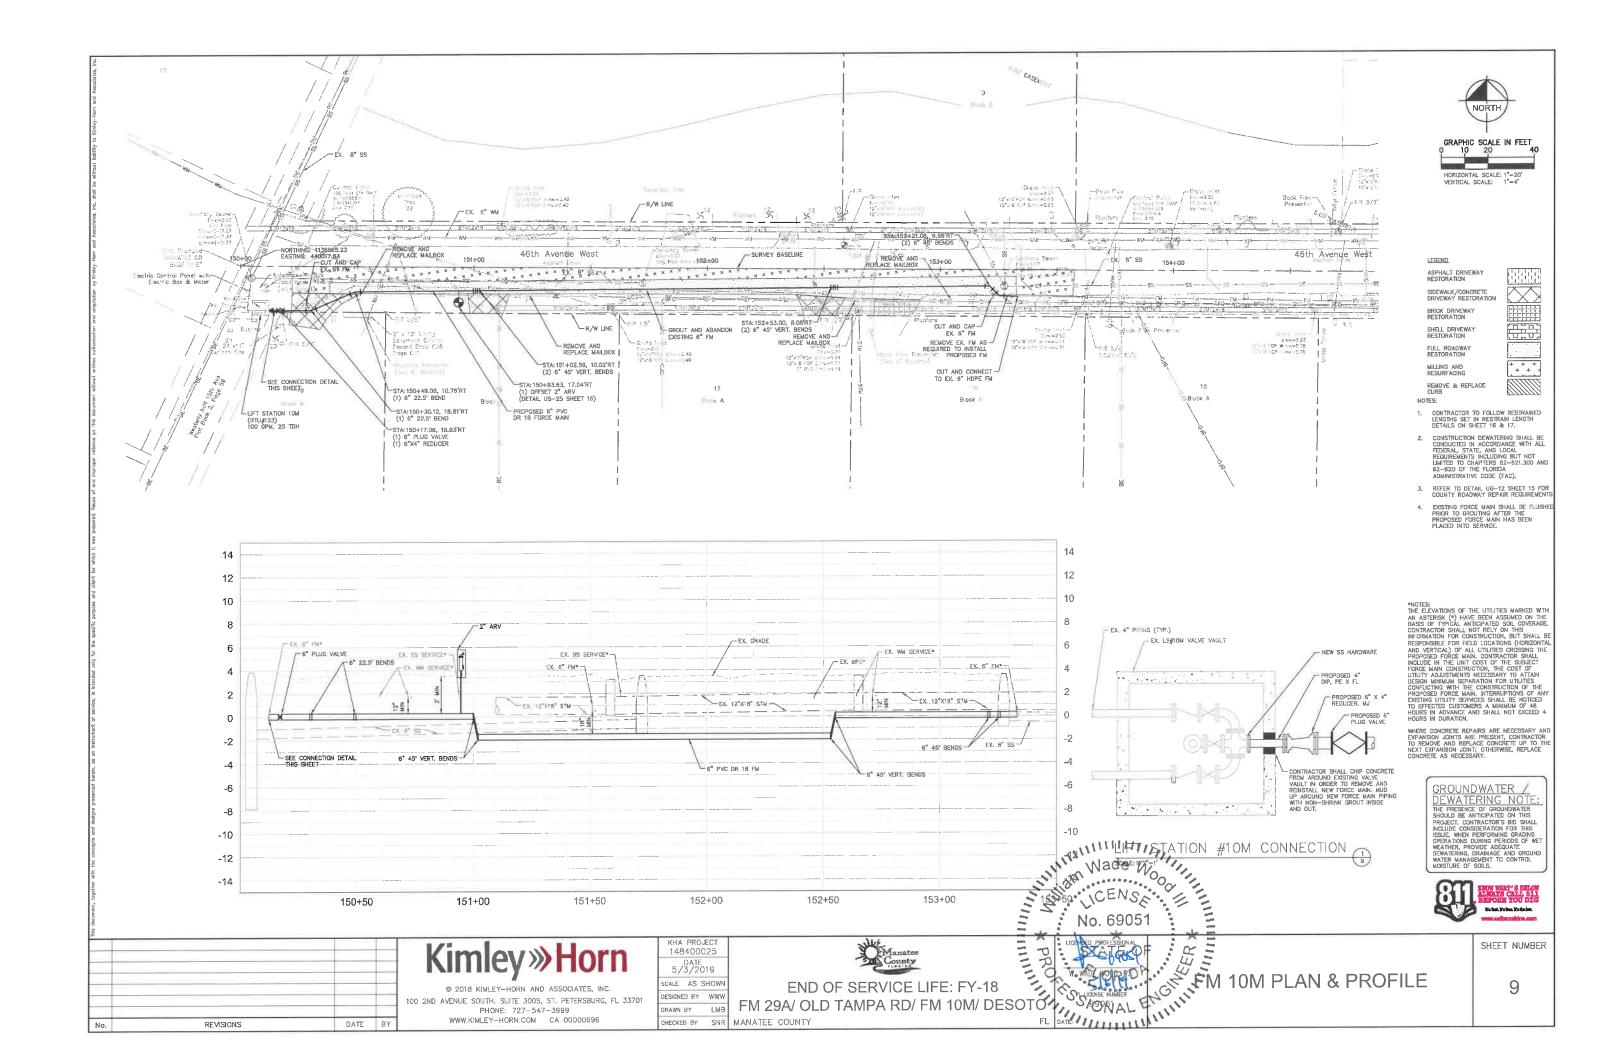


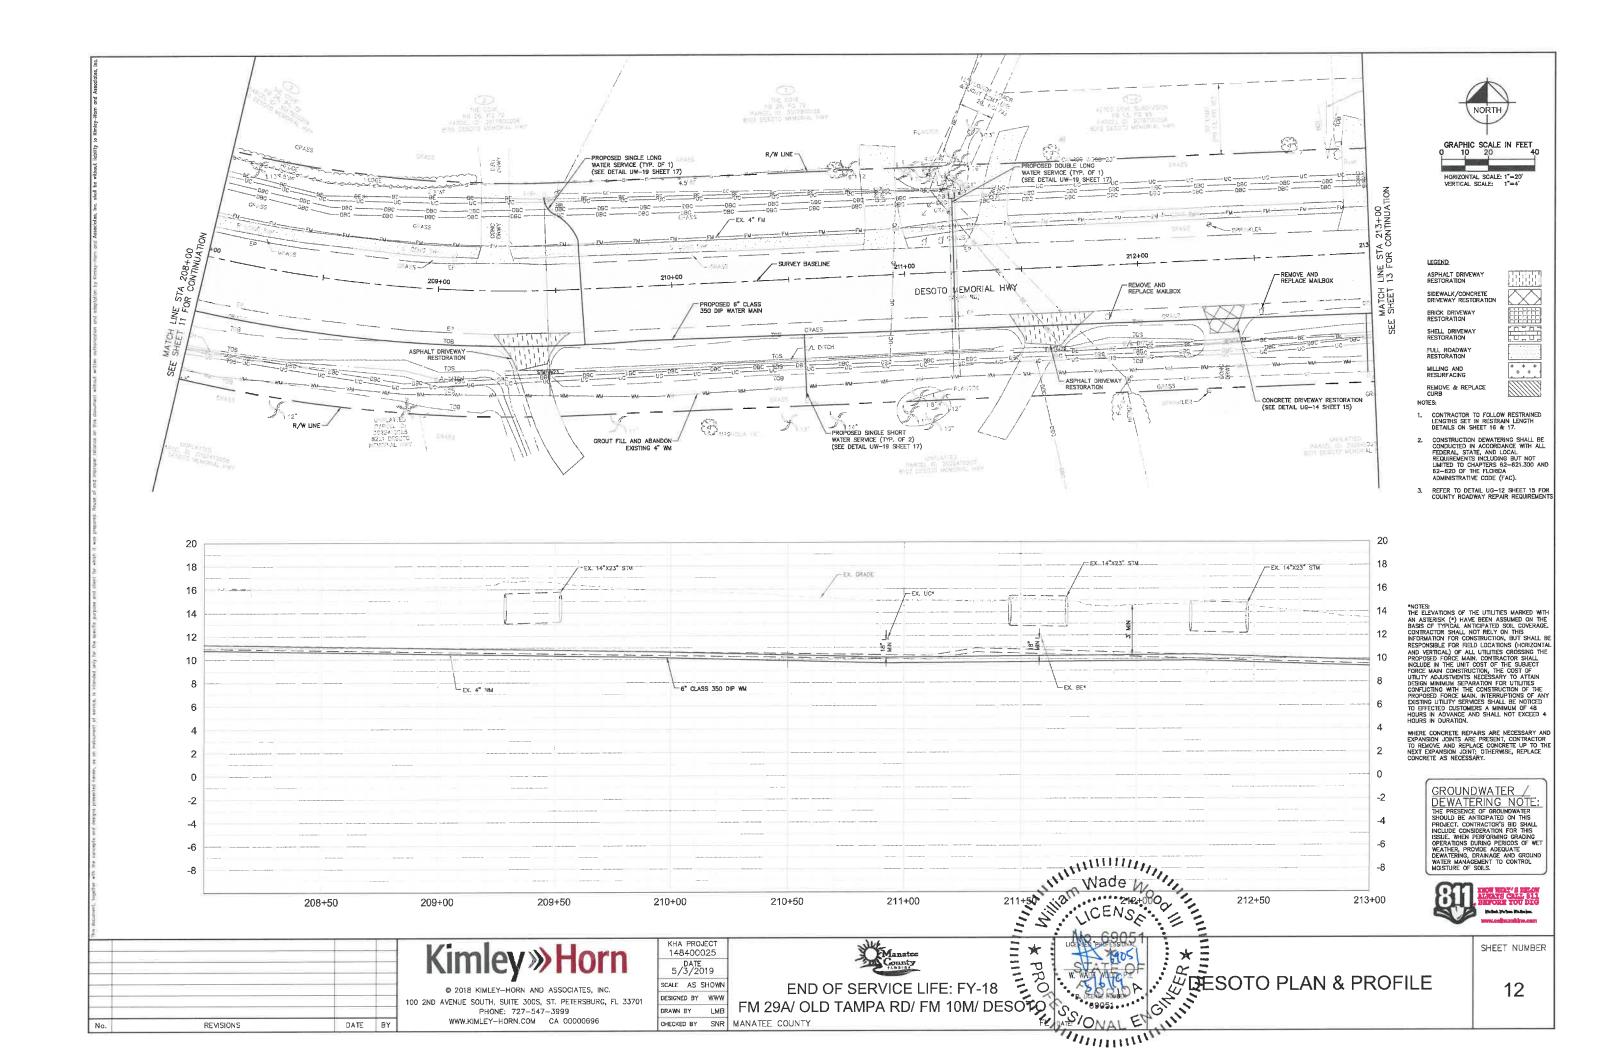

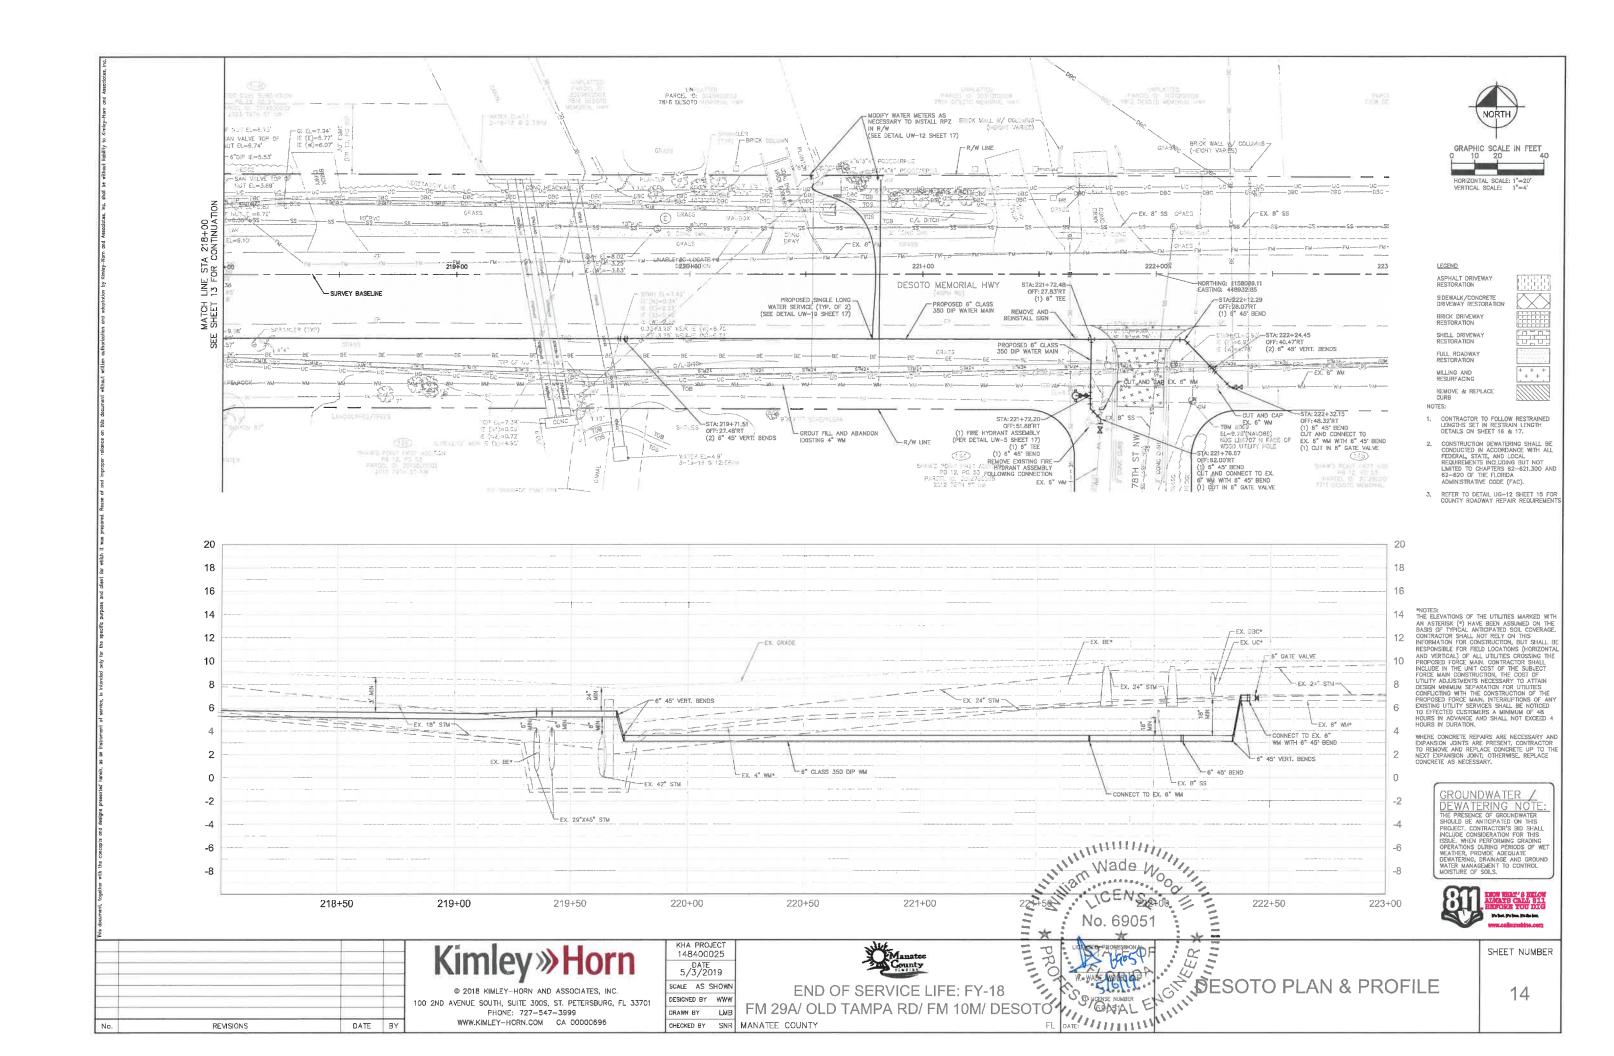

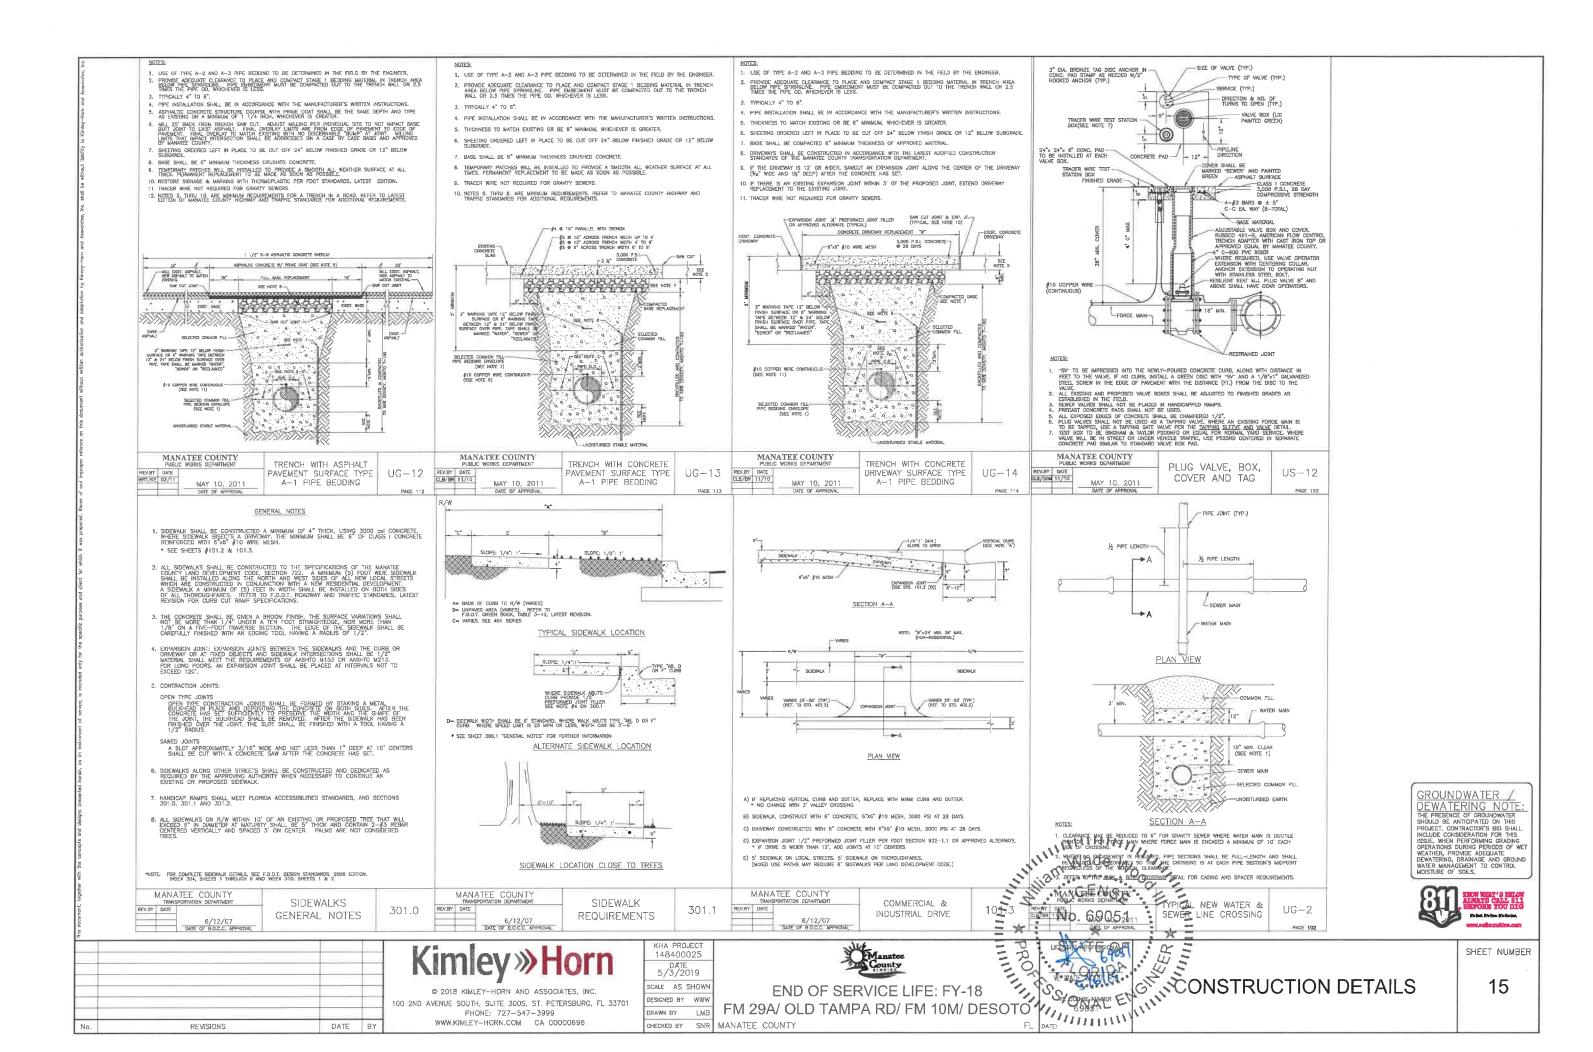

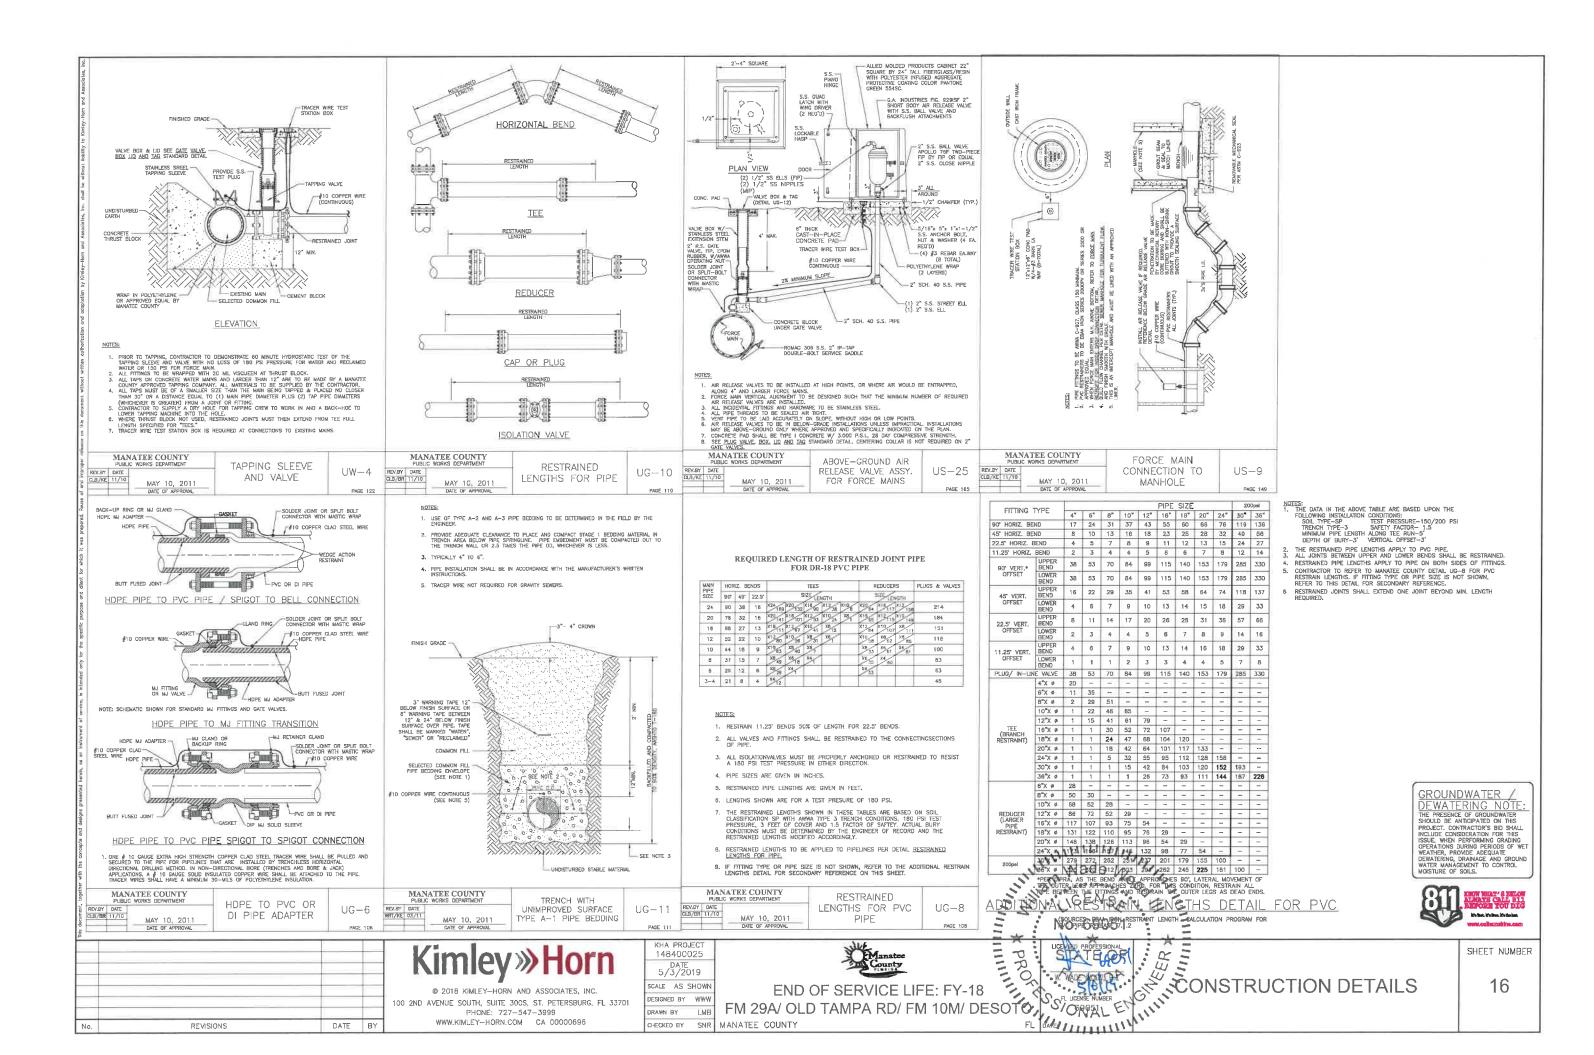

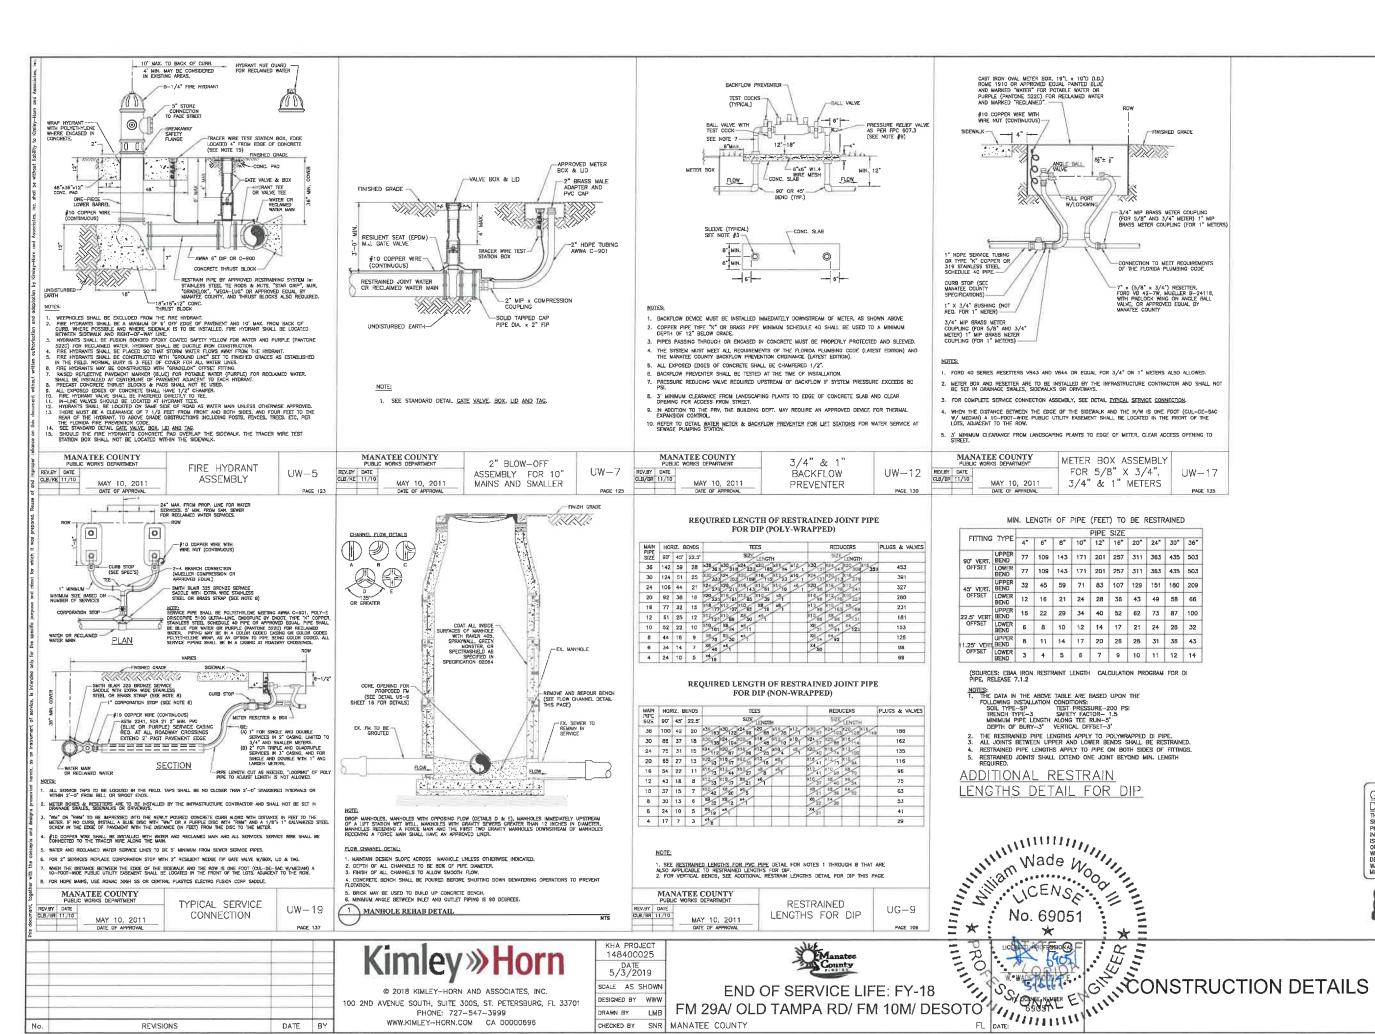


SHEET NUMBER

17

GROUNDWATER


DEWATERING NOTE:
THE PRESENCE OF GROUNDWATER
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INCLUDE CONSIDERATION FOR THIS
ISSUE, WHEN PERFORMING GRADING
OPERATIONS DURING PERIODS OF WET
WEATHER, PROVIDE ADEQUATE
DEWATERING, DRAINAGE AND GROUND
WATER MANAGEMENT TO CONTROL.
MOISTURE OF SOILS.

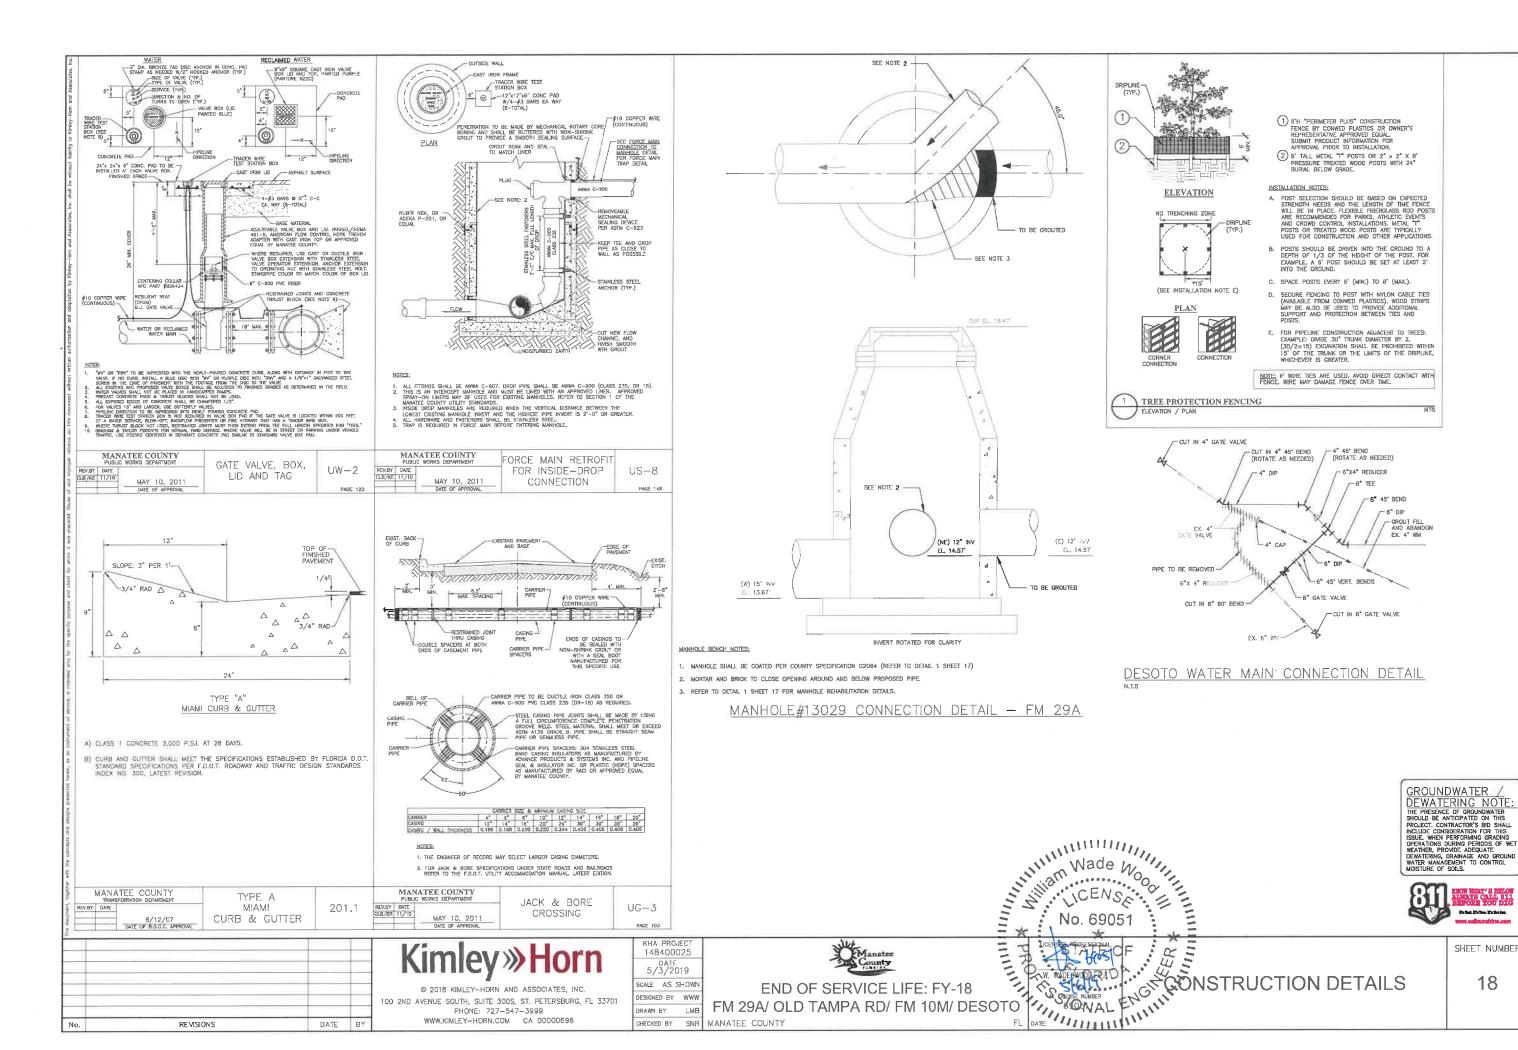



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SHEET NUMBER

CHON WHAT'S BELOW LLOVE CALL, SIII SEFORE YOU DIG



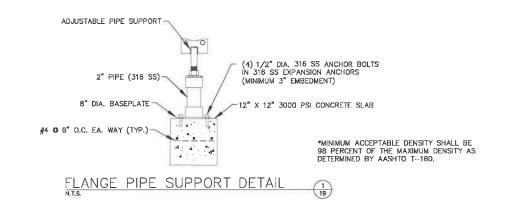


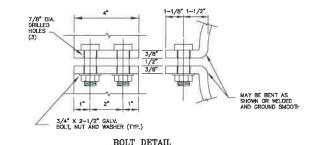

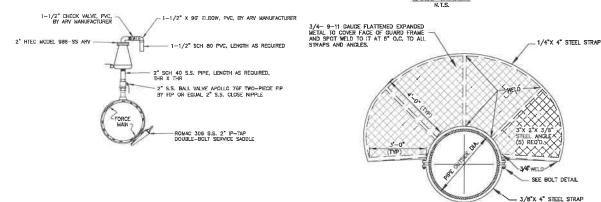ENTIRE GJARD ASSEMBLY TO BE HOT DIPPED GALVANIZED AFTER FABRICATION, PAINTING IS NOT PERMITTED.
 CENTER ANGLES ON 4" STEEL STRAP.

AERIAL CROSSING ARV DETAIL

AERIAL CROSSING PIPE GUARD DETAIL 3

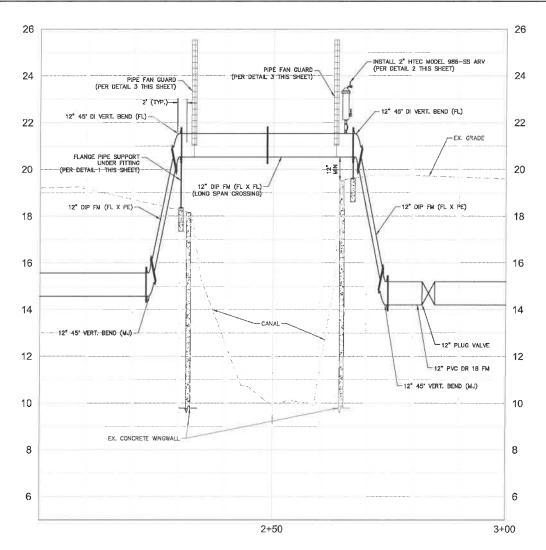

AERIAL CROSSING
HORIZONTAL SCALE: 1"=10'
VERTICAL SCALE: 1"=4'

19

- ALL ABOVEGROUND HARDWARE FOR FLANGE CONNECTIONS SHALL BE STAINLESS STEEL
- 2. ALL JOINTS SHALL BE RESTRAINED PER THE COUNTY STANDARDS
- 3. FLANGE ADAPTERS WILL NOT BE ALLOWED
- CONTRACTOR TO FIELD MEASURE PIPE LENGTHS AND PERFORM UTILITY LOCATES BEFORE ORDERING MATERIALS
- 5. PAINT AND COAT PROPOSED DIP 18" FORCE MAIN AERIAL CROSSINI PER MANATEE COUNTY SPECIFICATIONS SECTION 09900 "PAINTING"
- CONTRACTOR SHALL SUBMIT SHOP DRAWINGS FOR REVIEW AND APPROVAL THAT FOLLOW THE PIPE MANUFACTURER'S RECOMMENDATIONS.

GROUNDWATER

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WEATHER, PROVIDE ADEQUATE
DEWATTERING, DRAINAGE AND GROUND
WATER MANAGEMENT TO CONTROL
MOISTURE OF SOILS. No. 69051



DATE BY

REVISIONS

100 2ND AVENUE SOUTH, SUITE 300S, ST. PETERSBURG, Ft. 33701 PHONE: 727-547-3999 WWW.KIMLEY-HORN.COM CA 00000696

KHA PROJECT 148400025 DATE 5/3/2019 CALE AS SHOWN DRAWN BY LMB



END OF SERVICE LIFE: FY-18
FM 29A/ OLD TAMPA RD/ FM 10M/ DESOTO
MANATEE COUNTY

END OF SERVICE LIFE: FY-18

PS ON AL

PS ON AL CHECKED BY SNR MANATEE COUNTY

SHEET NUMBER

19