CONSTRUCTION PLANS FOR

NORTH COUNTY METAL GRAVITY SEWER PIPE REPLACEMENTS

MANATEE COUNTY, FLORIDA

AUGUST 2023 MANATEE COUNTY PROJECT #402-0021309



PROJECT TEAM:

OWNER:
MANATEE COUNTY
1022 26TH AVE. E.
BRADENTON, FL 34208
CONTACT: ANDRES HIDALGO, P.E.
941-708-7450 EXT. 7392

ENGINEER:
KIMLEY-HORN AND ASSOCIATES, INC.
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941-792-8811

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MANATEE COUNTY UTILITY OPERATIONS KATHY MCMAHON 4422-C 66TH ST. W.

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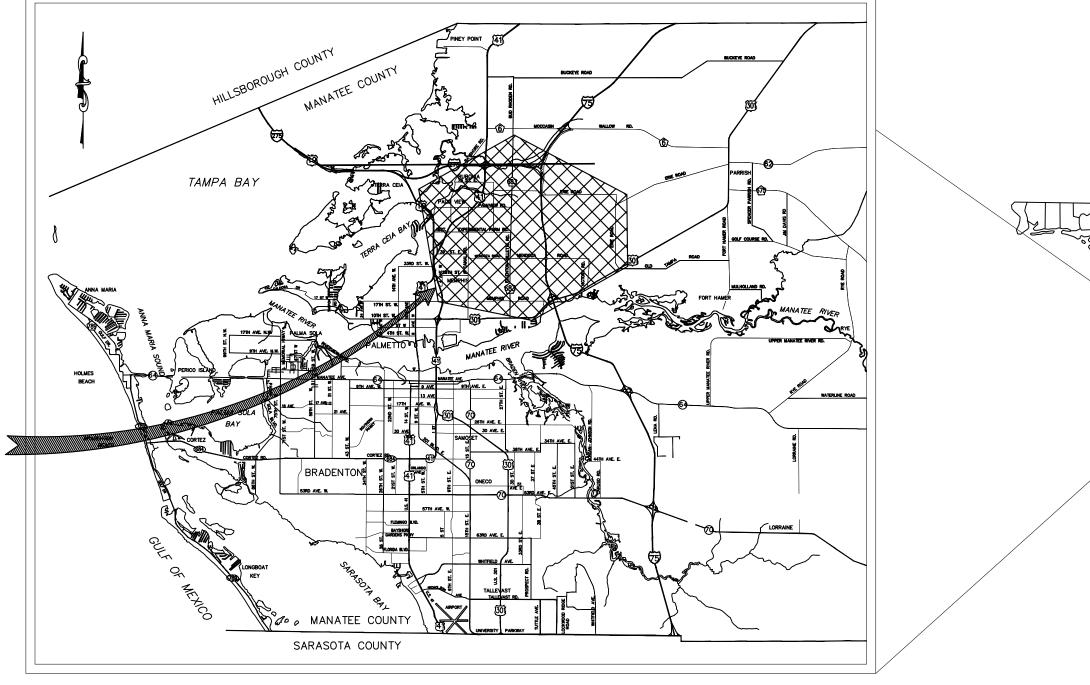
THOMAS ENGINEERING

813-227-9190

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UNITI FIBER LLC CAHRLIE CROFT 107 ST FRANCIS ST, SUITE 1800 MOBILE, AL 36602 251-214-7059 SITE , LOCATION



PROJECT VICINITY MAP

100% DESIGN

PREPARED BY
Kimley » Hort
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WWW.KIMLEY-HORN.COM Registry No. 35106

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SHEET LIST TABLE

SHEET NUMBER

THE SITE CONSTRUCTION STAKEOUT SHALL BE PERFORMED UNDER THE DIRECTION OF A FLORIDA REGISTERED SURVEYOR. AUTOCAD FILES WILL BE FURNISHED TO AID IN THE SITE CONSTRUCTION STAKEOUT. ANY DISCREPANCIES FOUND BETWEEN AUTOCAD FILES AND SITE CONSTRUCTION PLANS SHALL BE BROUGHT TO THE ENGINEER'S ATTENTION FOR CLARIFICATION PRIOR TO THAT STAKEOUT.

SHALL BE	BROUGHT TO THE ENGINEER S	ATTENTION F	UR C	LARIFICATION PRIOR TO THAT STAKEOUT.		DATE
				KIMLEY-HORN AND ASSOCIATES, INC. CONSENT IS	MICHAEL A. SEMAGO, P.E.	AUG 2023 PROJECT NO. 148400106 SHEET NUMBER G-1
No.	REVISIONS	DATE	RY	HEREBY GRANTED SPECIFICALLY TO GOVERNMENTAL AGENCIES TO REPRODUCE THIS DOCUMENT IN COMPLIANCE WITH F.S. CHAPTER 119.	87501 DATE:	0-1

<u>GENERAL</u>

- 1. ALL CONSTRUCTION ACTIVITIES SHALL BE COORDINATED WITH THE PROJECT MANAGEMENT DIVISION. THE PROJECT MANAGER IS: ANDRES HIDALGO, P.E. AND CAN BE REACHED AT (941) 708-7450 X 7392.
- 2. IF THE CONTRACTOR WANTS A SITE VISIT PRIOR TO BIDDING, THESE SHALL BE ARRANGED THROUGH THE COUNTY'S PURCHASING DIVISION.
- 3. ALL CONSTRUCTION ON THIS PROJECT SHALL BE IN ACCORDANCE WITH THE LATEST EDITION OF MANATEE COUNTY PUBLIC WORKS STANDARDS UTILITIES STANDARDS MANUAL AND HIGHWAY & TRAFFIC STANDARDS MANUAL AND/OR FDOT "STANDARD PLANS FOR ROAD AND BRIDGE CONSTRUCTION" UNLESS OTHERWISE INDICATED ON THE PLANS.
- 4. THE CONTRACTOR SHALL BE RESPONSIBLE FOR MEETING ALL CONDITIONS AND REQUIREMENTS OF ALL PERMITS AND ALL GOVERNING FEDERAL, STATE, AND LOCAL AGENCIES. THE CONTRACTOR SHALL OBTAIN AND PAY FOR ALL REQUIRED PERMITS THAT ARE NOT PROVIDED IN THE BID DOCUMENTS, AT NO ADDITIONAL COST TO THE
- 5. THE INFORMATION PROVIDED IN THESE PLANS IS SOLELY TO ASSIST THE CONTRACTOR IN ASSESSING THE NATURE AND EXTENT OF THE CONDITIONS WHICH MAY BE ENCOUNTERED DURING THE COURSE OF WORK. ALL CONTRACTORS ARE DIRECTED, PRIOR TO BIDDING, TO CONDUCT WHATEVER INVESTIGATION THEY MAY DEEM NECESSARY TO ARRIVE AT THEIR OWN CONCLUSIONS REGARDING THE ACTUAL CONDITIONS THAT WILL BE ENCOUNTERED, AND UPON WHICH THEIR BIDS WILL BE BASED.
- 6. THE CONTRACTOR SHALL REVIEW AND VERIFY ALL DIMENSIONS ON THE PLANS AND REVIEW ALL FIELD CONDITIONS THAT MAY AFFECT CONSTRUCTION. SHOULD DISCREPANCIES OCCUR, THE CONTRACTOR SHALL NOTIFY THE ENGINEER TO OBTAIN THE ENGINEER'S CLARIFICATION BEFORE COMMENCING WITH CONSTRUCTION.
- 7. THE CONTRACTOR SHALL NOTIFY SUNSHINE 811 (1-800-432-4770) AT LEAST 2 FULL BUSINESS DAYS PRIOR TO CONSTRUCTION OPERATIONS. THE CONTRACTOR SHALL BE RESPONSIBLE FOR COORDINATING WITH ALL UTILITIES FOR THE POSSIBLE RELOCATION OR THE TEMPORARY MOVEMENT OF ANY EXISTING UTILITIES WITHIN THE RIGHTS-OF-WAY OR UTILITY EASEMENTS. IT IS THE CONTRACTOR'S RESPONSIBILITY TO PROTECT EXISTING UTILITIES FROM DAMAGE. EXPLORATORY EXCAVATION MAY BE REQUIRED PRIOR TO CONNECTION TO EXISTING UTILITIES.
- 8. NO WORK, EXCEPT FOR EMERGENCY TYPE, SHALL BE PERFORMED AFTER 7:00 PM AND BEFORE 7:00 AM. FOR ADDITIONAL PROJECT RESTRAINTS, REFER TO SECTION 01310 OF THE SPECIFICATIONS.
- 9. THE CONTRACTOR SHALL PROVIDE CERTIFIED RECORD DRAWINGS AS OUTLINED IN THE SPECIFICATIONS. RED-LINE DRAWINGS SHALL BE CURRENT WITH EACH PAY APPLICATION SUBMITTED AND WILL BE CHECKED AS PART OF THE PAY APPLICATION REVIEW PROCESS. PAYMENT WILL NOT BE MADE TO CONTRACTOR WITHOUT APPROVED RED-LINE DRAWINGS. THE MOST CURRENT SET OF RED-LINE DRAWINGS SHALL ALSO BE BROUGHT TO EACH MONTHLY PROGRESS MEETING.
- 10. THE CONTRACTOR SHALL INCLUDE IN HIS BID: DEWATERING PUMPING EQUIPMENT, PUMPS, FITTINGS, LABOR, ETC. AS NECESSARY, BASED ON METHOD AND SEQUENCE OF CONSTRUCTION TO COMPLETE ALL WORK WHILE MAINTAINING UTILITY SERVICE OPERATIONS AT ALL TIMES.
- 11. ALL PROPOSED WORK SHALL BE COORDINATED WITH MANATEE COUNTY UTILITIES DEPARTMENT AT LEAST TWO WEEKS IN ADVANCE OF PROPOSED CONSTRUCTION.
- 12. THE CONTRACTOR SHALL FURNISH SHOP DRAWINGS TO THE ENGINEER FOR REVIEW OF ALL PIPE CONNECTIONS, TRANSITIONS, AND SPECIAL APPURTENANCES PRIOR TO FABRICATION OR DELIVERY TO THE JOB SITE.
- 13. UNLESS OTHERWISE INDICATED OR APPROVED, ALL BELOW GROUND PVC PIPE SHALL HAVE PUSH-ON JOINTS. AND ALL ABOVE GROUND DIP PIPE SHALL HAVE FLANGED JOINTS. JOINTS SHALL BE RESTRAINED PER THE DETAILS IN THESE PLANS.
- 14. SANITARY SEWERS AND FORCE MAINS CROSSING OVER OR UNDER WATER MAINS SHALL BE LAID TO PROVIDE A MINIMUM VERTICAL DISTANCE OF 18" BETWEEN THE INVERT OF THE UPPER PIPE AND THE CROWN OF THE LOWER PIPE. WHERE THIS MINIMUM SEPARATION CANNOT BE MAINTAINED. THE CROSSING SHALL BE ARRANGED SO THAT THE SEWER OR FORCE MAIN PIPE JOINTS ARE EQUIDISTANT FROM THE POINT OF CROSSING WITH NO LESS THAN 10' BETWEEN ANY TWO JOINTS. AS AN ALTERNATIVE, THE SEWER OR FORCE MAIN MAY BE PLACED IN A WATERTIGHT CASING PIPE, CONSISTENT WITH F.A.C. RULE 62-555.314.
- 15. ALL BELOW-GRADE FITTINGS 4-INCHES AND GREATER IN DIAMETER SHALL BE MECHANICAL JOINT DUCTILE IRON WITH AN APPROVED LINING FOR THEIR INTERIOR SURFACES AND COAL TAR ENAMEL COATING ON EXTERIOR SURFACES, AS NOTED IN SECTION 02615 OF SPECIFICATIONS.
- 16. IT SHALL BE THE CONTRACTOR'S RESPONSIBILITY TO SECURE PROPERTY FOR STAGING MATERIALS AND
- 17. IT WILL BE THE CONTRACTOR'S RESPONSIBILITY TO ACQUIRE, OR ENTER INTO AGREEMENTS, FOR LANDS FOR LAY DOWN AREAS AND STAGING. THE COUNTY WILL COORDINATE AND ADVISE, TO HELP IDENTIFY POSSIBLE PARCELS. IT IS FINALLY THE CONTRACTOR'S RESPONSIBILITY TO SECURE THE NEEDED AREAS, AND THE COUNTY TAKE NO RESPONSIBILITY FOR DELAYS IN THIS REGARD.
- 18. COORDINATION AND PUBLIC INFORMATION FOR AND WITH AREA RESIDENTS ARE OF THE UTMOST IMPORTANCE. CONTRACTOR WILL INSURE ADHERENCE TO THE COUNTY'S NOISE ORDINANCE, HAZARD AND SAFETY, AND NUISANCE ABATEMENT DIRECTIONS, PLANS, OBJECTIONS AND ORDINANCES. THE ENGINEER WILL HAVE THE FINAL DISCRETION IN THIS REGARD, AS REPRESENTED ONSITE BY THE COUNTY INSPECTOR AND ENGINEER'S STAFF.
- 19. ANY LIFT STATION SHUTDOWN REQUIRED FOR SANITARY SEWER CONNECTIONS WILL NEED TO BE COORDINATED WITH ERIK GIBSON 941-792-8811 EXT. 5377 AT LEAST A WEEK IN ADVANCE.
- 20. COORDINATE ALL WATER MAIN TIE-INS WITH ROBBY PHILLIPS, 941-792-881 EXT. 5149 OR ROBBY.PHILLIPS@MYMANATEE.ORG, PROPOSED WORK INVOLVES WATER MAIN ISOLATIONS WHICH ARE POSSIBLE WITH UPSTREAM AND DOWNSTREAM VALVES. CONTRACTOR SHALL COORDINATE WITH COUNTY OPERATIONS TO ISOLATE WATER MAINS.

- 21. THE CONTRACTOR SHALL BE RESPONSIBLE FOR COMPLIANCE WITH THE FLORIDA TRENCH SAFETY ACT, 90-96, LAWS OF FLORIDA EFFECTIVE OCTOBER 1, 1990 AND THE OCCUPATIONAL SAFETY AND HEALTH ADMINISTRATION EXCAVATION SAFETY STANDARDS, 29 CFR 1926.650, SUBPART P, AS AMENDED. THE CONTRACTOR SHALL
- 22. THE CONTRACTOR SHALL USE SHEET PILING, SHEETING, BRACING, ETC., AS REQUIRED IN ALL EXCAVATION AREAS AND CONFORM TO ALL OSHA REQUIREMENTS.

INCLUDE IN THE TOTAL BID PRICE ALL COSTS FOR COMPLIANCE WITH THESE REGULATIONS.

- 23. THE CONTRACTOR SHALL USE ALL NECESSARY SAFETY PRECAUTIONS TO AVOID CONTACT WITH OVERHEAD AND UNDERGROUND UTILITIES, POWER LINES, ETC.
- 24. THESE DRAWINGS DO NOT INCLUDE NECESSARY COMPONENTS FOR CONSTRUCTION SAFETY. THESE EXCLUSIONS DO NOT RELIEVE THE CONTRACTOR FROM PROVIDING ANY REQUIRED SAFETY EQUIPMENT, SUPPLIES, OR APPARATUS AS NEEDED TO EXECUTE THE WORK EFFECTIVELY AND SAFELY AS OUTLINES IN THE PLANS AND SPECIFICATIONS. THE CONTRACTOR ACCEPTS ANY AND ALL LIABILITY FROM THE CONTRACTOR'S FAILURE TO PROVIDE A SAFE WORK ENVIRONMENT.

ENVIRONMENTAL

- 25. THE CONTRACTOR SHALL PROVIDE AND INSTALL ALL NECESSARY STORM WATER, EROSION, AND SEDIMENTATION CONTROL MEASURES IN ACCORDANCE WITH THE FDEP "FLORIDA STORM WATER, EROSION AND SEDIMENTATION CONTROL INSPECTOR'S MANUAL". IT IS THE RESPONSIBILITY OF THE CONTRACTOR TO CONTROL AND PREVENT EROSION AND TRANSPORT OF SEDIMENT TO SURFACE DRAINS AND TO DITCHES DURING CONSTRUCTION.
- 26. STOCKPILES SHALL BE PROTECTED AT ALL TIMES BY ON-SITE DRAINAGE CONTROLS WHICH PREVENT EROSION OF THE STOCKPILED MATERIAL. CONTROL OF DUST FROM SUCH STOCKPILES IS REQUIRED, DEPENDING UPON THEIR LOCATION AND THE EXPECTED LENGTH OF TIME THE STOCKPILES WILL BE PRESENT. IN NO CASE SHALL ANY STOCKPILED MATERIAL REMAIN AFTER THIRTY (30) CALENDAR DAYS.
- 27. STORM WATER INLETS IN THE VICINITY OF THE PROJECT SHALL BE PROTECTED BY SEDIMENT TRAPS SUCH AS SECURED HAY BALES, SOD, STONE, ETC., WHICH SHALL BE MAINTAINED AND MODIFIED AS REQUIRED BY CONSTRUCTION PROGRESS, AND WHICH MUST BE APPROVED BY THE ENGINEER BEFORE INSTALLATION. THIS WILL BE MAINTAINED TO PREVENT DEGRADATION OF THE WATERS OF THE COUNTY AND STATE.
- 28. SEDIMENT BASINS AND TRAPS, PERIMETER BERMS, SEDIMENT BARRIERS, VEGETATIVE BUFFERS, AND OTHER MEASURES INTENDED TO TRAP SEDIMENT AND/OR PREVENT THE TRANSPORT OF SEDIMENT ONTO ADJACENT PROPERTIES, OR INTO EXISTING BODIES OF WATER, MUST BE INSTALLED, CONSTRUCTED, OR IN THE CASE OF VEGETATIVE BUFFERS, PROTECTED FROM DISTURBANCE, AS A FIRST STEP IN THE LAND ALTERATION PROCESS. SUCH SYSTEMS SHALL BE FULLY OPERATIVE BEFORE ANY OTHER DISTURBANCE OF THE SITE BEGINS. EARTHEN STRUCTURES INCLUDING BUT NOT LIMITED TO BERMS, EARTH FILTERS, DAMS OR DIKES SHALL BE STABILIZED AND PROTECTED FROM DRAINAGE DAMAGE OR EROSION WITHIN ONE (1) WEEK OF INSTALLATION.

DATE BY

- 29. ALL SWALES, DITCHES, AND CHANNELS LEADING FROM THE SITE SHALL BE PROTECTED FROM SILTATION AND EROSION PRIOR TO THE START OF CONSTRUCTION AND MAINTAINED THRU THE CONTRACT TERM. ALL SODDING SHALL BE PERFORMED WITHIN THREE (3) DAYS OF EXCAVATION.
- 30. SOIL DISPLACED BY CONSTRUCTION WILL BE REMOVED. EROSION CONTROL SHALL BE IMPLEMENTED IN AREAS WHICH ARE CONSIDERED ENVIRONMENTALLY SENSITIVE. EROSION CONTROL SYSTEMS SHALL BE REQUIRED FOR ALL WORK WITHIN JURISDICTIONAL AREAS. THESE SYSTEMS MAY INCLUDE STAKED HAY BALES, SILT SCREENS, FILTER FABRIC. AND TURBIDITY SCREENS.
- 31. ALL EROSION AND POLLUTION CONTROL DEVICES SHALL BE CHECKED REGULARLY, ESPECIALLY AFTER EACH RAINFALL AND SHALL BE CLEANED OUT AND/OR REPAIRED AS REQUIRED.
- 32. THE CONTRACTOR SHALL NOT ENTER UPON OR IN ANY WAY ALTER WETLAND AREAS THAT MAY BE ON OR NEAR THE CONSTRUCTION SITE. ALL WORK IN THE VICINITY OF OPEN WATER AND/OR WETLANDS IS TO BE PERFORMED IN COMPLIANCE WITH THE ENVIRONMENTAL REGULATIONS AND/OR PERMITS FOR THE SITE. THE CONTRACTOR WILL BE RESPONSIBLE FOR ANY FINES RESULTING FROM HIS VIOLATION OF ANY REGULATIONS OR PERMIT CONDITIONS
- 33. CONTRACTOR SHALL PROVIDE PROTECTIVE MATTING, FUEL CONTAINMENT AND ALL OTHER MATERIALS, EQUIPMENT AND LABOR TO PROTECT THE STAGING AREA DURING CONSTRUCTION.
- 34. CONTRACTOR SHALL, PRIOR TO BEGINNING CONSTRUCTION, SUBMIT A "FUELING SPILL PREVENTION PLAN" THAT SHALL CLEARLY INDICATE HOW FUEL SPILLS WILL BE PREVENTED WHEN FUELING BOTH WITHIN AND OUTSIDE OF THE STAGING AREA.

<u>RIGHT-OF-WAY</u>

- 35. ALL CONSTRUCTION ACTIVITIES SHALL BE LIMITED TO WITHIN THE MANATEE COUNTY RIGHT-OF-WAY, OTHER PUBLIC RIGHT-OF-WAYS OR EASEMENTS SHOWN ON THE DRAWINGS.
- 36. THE CONTRACTOR SHALL EMPLOY A LAND SURVEYOR REGISTERED IN THE STATE OF FLORIDA TO REFERENCE AND RESTORE PROPERTY CORNER MONUMENTS, PINS, AND LANDMARKS THAT MAY BE DISTURBED BY CONSTRUCTION AT NO ADDITIONAL COST TO THE OWNER.
- 37. THE CONTRACTOR, PRIOR TO CONSTRUCTION AND RESTRICTING ANY TRAFFIC, MUST OBTAIN ANY REQUIRED RIGHTS-OF-WAY USE PERMITS AND A TRAFFIC CONTROL PLAN. THE CONTRACTOR SHALL OBTAIN ALL REQUIRED PERMITS FROM OTHER GOVERNMENTAL AGENCIES HAVING RELEVANT JURISDICTION. ALL MAINTENANCE AND PROTECTION OF TRAFFIC SHALL BE IN ACCORDANCE WITH THE APPLICABLE REQUIREMENTS OF THE CURRENT FLORIDA DEPARTMENT OF TRANSPORTATION "STANDARD PLANS FOR ROAD CONSTRUCTION MAINTENANCE OF TRAFFIC" INDEX 102-600 THROUGH 102-690. A TRAFFIC CONTROL PLAN SHALL BE SUPPLIED BY THE CONTRACTOR AT THE PRE-CONSTRUCTION MEETING, PER SPECIFICATIONS 01570.
- 38. THE CONTRACTOR SHALL BE RESPONSIBLE FOR REPLACING ALL DAMAGED STORM WATER STRUCTURES, PIPING, ENTRANCE PIPE AND HEADWALLS WHETHER SHOWN ON THE PLANS OR NOT. THE HEADWALLS SHALL BE REPLACED IN ACCORDANCE WITH F.D.O.T. STANDARDS, OR THE APPLICABLE JURISDICTION
- 39. IT IS THE RESPONSIBILITY OF THE CONTRACTOR TO ESTABLISH IN THE FIELD THE RIGHT-OF-WAY LINES, BASE LINES, BENCH MARKS (ELEV.), CENTER LINES, AND STATIONING AS REQUIRED TO CONSTRUCT THIS PROJECT.
- 40. THE CONTRACTOR SHALL BE RESPONSIBLE FOR COORDINATING WITH PROPERTY OWNERS PRIOR TO PERFORMING ANY WORK ON THE OWNER'S DRIVEWAY. CONTRACTOR SHALL MAINTAIN SAFE ACCESS TO THE PROPERTY AT ALL TIMES DURING CONSTRUCTION.
- 41. A RIGHT OF ENTRY AGREEMENT SHALL BE OBTAINED BY THE CONSTRUCTION MANAGER FROM THE PROPERTY OWNER BEFORE ANY DRIVEWAY CONSTRUCTION WORK IS DONE OUTSIDE OF THE RIGHT-OF-WAY OR EASEMENT.

- 42. LOCATIONS, ELEVATIONS AND DIMENSIONS OF EXISTING UTILITIES, STRUCTURES AND OTHER FEATURES ARE SHOWN TO THE BEST INFORMATION AVAILABLE AT THE TIME OF PREPARATION OF THESE PLANS BUT DO NOT PURPORT TO BE ABSOLUTELY CORRECT. THERE MAY BE OTHER IMPROVEMENTS, UTILITIES, ETC. WHICH ARE WITHIN THE PROJECT AREA AND WHICH HAVE NOT BEEN LOCATED OR IDENTIFIED, MAY NOT BE IN THE EXACT LOCATION SHOWN OR RELOCATED SINCE THE PREPARATION OF THESE PLANS. THE CONTRACTOR SHALL VERIFY, PRIOR TO CONSTRUCTION, THE LOCATIONS, ELEVATIONS AND DIMENSIONS OF ALL EXISTING UTILITIES STRUCTURES AND OTHER FEATURES (WHETHER OR NOT SHOWN ON THE PLANS) THAT MAY EFFECT HIS WORK ALL EXISTING UTILITIES TO BE EXTENDED, CROSSED OR CONNECTION POINTS SHALL BE EXPOSED PRIOR TO CONSTRUCTION TO VERIFY LOCATION AND ELEVATION. ANY DISCREPANCIES OR CONFLICTS FOUND SHALL BE BROUGHT TO THE ENGINEER'S ATTENTION FOR RESOLUTION.
- 43. THE CONTRACTOR SHALL PROTECT ALL EXISTING STRUCTURES, WATER AND SEWER LINES, STORM DRAINS. UTILITIES, DRIVEWAYS, SIDEWALKS, SIGNS, MAIL BOXES, FENCES, TREES, LANDSCAPING, AND ANY OTHER IMPROVEMENT OR FACILITY IN THE CONSTRUCTION AREA. THE CONTRACTOR SHALL REPAIR AND/OR REPLACE ANY DAMAGED ITEM DUE TO HIS CONSTRUCTION ACTIVITIES TO EQUAL OR BETTER THAN PRE-CONSTRUCTION CONDITIONS AT NO ADDITIONAL COST TO THE OWNER.
- 44. THE CONTRACTOR SHALL USE APPROPRIATE TECHNIQUES, AS APPROVED, RECOMMENDED OR OFFERED BY FLORIDA POWER AND LIGHT TO PREVENT UNDERMINING OF POWER POLES DURING CONSTRUCTION. IF HOLDING OF POWER POLES IS RECOMMENDED OR REQUIRED BY THE UTILITY, THE CONTRACTOR SHALL COORDINATE THIS ACTIVITY WITH THE UTILITY AND BEAR ALL RELATED COSTS.
- 45. ANY TEMPORARY SHUTDOWNS FOR MODIFICATIONS OF EXISTING UTILITY SYSTEMS THAT MUST REMAIN IN SERVICE DURING CONSTRUCTIONS SHALL BE KEPT TO A MINIMUM AND SHALL BE COORDINATED WITH AND APPROVED BY THE MANATEE COUNTY UTILITY OPERATIONS DEPARTMENT IN ACCORDANCE WITH THE CONTRACT DOCUMENTS. IT IS NOTED THAT TEMPORARY SHUTDOWNS MAY BE RESTRICTED TO CERTAIN HOURS AT ANY TIME OF THE DAY OR NIGHT AND WILL BE COMPLETED AT NO ADDITIONAL COST TO THE OWNER.
- 46. THE ELEVATIONS OF THE UTILITY SERVICES AND LATERALS HAVE BEEN ASSUMED ON THE BASIS OF TYPICAL ANTICIPATED SOIL COVERAGE. CONTRACTOR SHALL NOT RELY ON THIS INFORMATION FOR CONSTRUCTION, BUT SHALL BE RESPONSIBLE FOR FIELD LOCATIONS (HORIZONTAL AND VERTICAL) OF ALL UTILITIES CROSSING THE PROPOSED FORCE MAIN. CONTRACTOR SHALL INCLUDE IN THE UNIT COST OF THE SUBJECT FORCE MAIN. CONSTRUCTION, THE COST OF UTILITY ADJUSTMENTS NECESSARY TO ATTAIN DESIGN MINIMUM SEPARATION FOR UTILITIES CONFLICTING WITH THE CONSTRUCTION OF THE PROPOSED FORCE MAIN. INTERRUPTIONS OF ANY EXISTING UTILITY SERVICES SHALL BE NOTICED TO EFFECTED CUSTOMERS A MINIMUM OF 48 HOURS IN ADVANCE AND SHALL NOT EXCEED 4 HOURS IN DURATION.

RESTORATION

- 47. ALL RESTORATION WORK PERFORMED THROUGHOUT THE PROJECT SHALL CONFORM TO EXISTING LINES AND GRADES UNLESS SHOWN OTHERWISE.
- 48. ALL DISTURBED GRASSED AREAS SHALL BE SODDED UNLESS OTHERWISE INDICATED. THE TYPE OF SOD USED TO REPLACE OWNER MAINTAINED AREAS IN RIGHT-OF-WAY SHALL BE COORDINATED WITH THE PROPERTY OWNER.
- 49. ALL CONCRETE THRUST BLOCKS INSTALLED FOR TESTING PURPOSES AND NOT REQUIRED FOR THE OPERATION OF THE PIPELINE SHALL BE REMOVED AND DISPOSED OF BY THE CONTRACTOR, PRIOR TO FINAL ACCEPTANCE, AT NO ADDITIONAL COST TO THE OWNER.

50. ASPHALT DRIVES THAT ARE CUT SHALL BE RESTORED PER SECTION 02513 OF THE SPECIFICATIONS.

- 51. CONCRETE DRIVEWAYS OR SIDEWALKS THAT ARE CUT SHALL BE RESTORED TO MATCH EXISTING PER MANATEE COUNTY PUBLIC WORKS STANDARDS AND ACCORDING TO THE 2023-2024 EDITIONS OF THE F.D.O.T. STANDARD PLANS FOR ROAD CONSTRUCTION CONCRETE SIDEWALK AND DRIVEWAYS INDEX 522-001 THROUGH 522-003.
- 52. WHENEVER A PERMANENT ROADWAY SURFACE IS NOT REPLACED IMMEDIATELY AFTER BACKFILLING AND COMPACTION OF THE NEWLY INSTALLED PIPE LINE IN AREAS WHERE TRAFFIC MUST PASS, THE CONTRACTOR SHALL INSTALL A TEMPORARY SURFACE CONSISTING OF NINE INCHES OF COMPACTED LIME ROCK BASE AND A COAT OF ASPHALT EMULSION. PERMANENT ROADWAY REPAIR SHALL BE PERFORMED A MAXIMUM OF TWENTY-ONE CALENDAR DAYS AFTER THE INITIAL OPEN CUTTING.
- 53. RESTORATION OF CURBS, DRIVEWAYS, SIDEWALKS, AND PLACEMENT OF SOD SHALL BE COMPLETED AS SOON AS THE CONTRACTOR HAS COMPLETED WORK IN THE AREA OF IMPACT. RESTORATION SHALL BE COMPLETED NO MORE THAN 10 DAYS FROM COMPLETION OF CONSTRUCTION IN THE AREA OF IMPACT.
- 54. ALL EXISTING FENCES DISTURBED DURING CONSTRUCTION SHALL BE REPAIRED OR REPLACED AND REINSTALLED BY THE CONTRACTOR AT NO ADDITIONAL COST TO THE OWNER UNLESS SHOWN TO BE REMOVED ON CONSTRUCTION PLANS.
- 55. WHERE CONCRETE REPAIRS ARE NECESSARY AND EXPANSION OR CONTRACTION JOINTS ARE PRESENT, CONTRACTOR SHALL REMOVE AND REPLACE CONCRETE UP TO THE NEXT EXPANSION OR CONTRACTION JOINT. ANY CURB REQUIRING CONCRETE REPAIRS SHALL BE REPLACED AT A MINIMUM OF TEN (10) FEET IN LENGTH.
- 56. ALL SIGNING AND PAVEMENT MARKINGS AFFECTED BY ANY IMPROVEMENTS, ROADWAY RESTORATION, OR MILLING

AND RESURFACING SHALL BE RESTORED BY THE CONTRACTOR.

57. LANDSCAPE REMOVAL AND TREE REMOVAL SHALL BE PERFORMED IN ACCORDANCE WITH THE SITE RESTORATION PAY ITEM IN MEASUREMENT AND PAYMENT SECTION 01150. CONTRACTOR TO RESTORE AFFECTED AREAS TO EXISTING CONDITION MATCHING EXISTING GRADE, MEETING COUNTY COMPACTION REQUIREMENTS. ALL AFFECTED LANDSCAPE AREAS SHALL BE RESTORED TO EXISTING CONDITION. ALL OTHER AREAS SHALL BE SODDED UNLESS OTHERWISE INDICATED.

CONSTRUCTION

- 58. THE EXHAUST SYSTEM OF ALL GASOLINE AND DIESEL ENGINES SHALL BE EQUIPPED WITH MUFFLERS THAT MEET THE EQUIPMENT MANUFACTURER'S REQUIREMENTS FOR NOISE SUPPRESSION. THE CONTRACTOR SHALL INSTALL NOISE ABATEMENT BAFFLES POSITIONED TO BREAK LINE-OF-SITE FROM THE NOISE SOURCE TO AFFECTED RESIDENCES, AS APPROVED BY THE ENGINEER.
- 59. NO MATERIAL SHALL BE STOCKPILED IN ROADWAYS. ALL DIRT AND DEBRIS SHALL BE REMOVED FROM THE JOB SITE DAILY. ROADS SHALL BE SWEPT DAILY AS PART OF DAILY CLEAN UP.
- 60. THE CONTRACTOR IS TO CONTROL ALL FUGITIVE DUST ORIGINATING ON THIS PROJECT BY WATERING OR OTHER METHODS AS REQUIRED.
- 61. INGRESS AND EGRESS TO ALL THE PROPERTIES IN THE CONSTRUCTION AREA SHALL BE MAINTAINED AT ALL
- 62. PRIOR APPROVAL WILL BE REQUIRED FOR REMOVAL OR TRIMMING OF ANY TREE WITHIN THE CONSTRUCTION
- 63. THE CONTRACTOR SHALL PROVIDE ALL DEWATERING EQUIPMENT NECESSARY TO KEEP ALL EXCAVATIONS DRY. DEWATERING IS REQUIRED TO 18" BELOW TRENCH BOTTOM. REFER TO THE PLANS FOR ADDITIONAL DETAILS.
- 64. ALL PIPING AND FITTINGS USED ON THIS PROJECT SHALL BE AS NOTED ON THE PLANS AND IN THE CONTRACT DOCUMENT AND SHALL BE INSTALLED TO THE LINES AND GRADES SHOWN ON THE PLANS AND PROFILES.
- 65. ALL PIPE SHALL BE COLOR CODED TO CONFORM TO MANATEE COUNTY STANDARDS.
- 66. ALL FITTINGS FOR PRESSURE CLASS-RATED PIPE SHALL BE RESTRAINED DUCTILE IRON. FITTINGS AND PIPE JOINTS SHALL BE RESTRAINED PER THE DETAILS IN THE PLANS.
- 67. WHERE IT IS NECESSARY TO DEFLECT PIPE EITHER HORIZONTALLY OR VERTICALLY, PIPE DEFLECTION SHALL NOT EXCEED 75% OF THE MANUFACTURER'S MAXIMUM ALLOWABLE RECOMMENDED DEFLECTION.
- 68. ALL ROCKS OR STONES LARGER THAN SIX INCH DIAMETER SHALL BE REMOVED FROM THE BACKFILL MATERIAL. BACKFILL MATERIAL PLACED WITHIN ONE FOOT OF PIPING AND APPURTENANCES SHALL NOT CONTAIN ANY STONES LARGER THAN TWO INCH DIAMETER.
- 69. ONLY MANATEE COUNTY UTILITY OPERATIONS STAFF ARE AUTHORIZED TO OPERATE VALVES AND PUMP STATIONS ON COUNTY OWNED AND MAINTAINED UTILITY SYSTEMS.
- 70. ALL TEST POINT PIPING SHALL BE CUT LOOSE FROM THE CORPORATION STOP AND COMPLETELY REMOVED AND DISPOSED OF BY THE CONTRACTOR PRIOR TO FINAL ACCEPTANCE. A CORPORATION STOP PLUG SHALL BE INSTALLED AND THE CORPORATION STOP SHALL REMAIN IN PLACE.
- 71. ALL EXISTING MAINS THAT ARE BEING REPLACED SHALL BE ABANDONED IN PLACE UPON ACCEPTANCE AND ACTIVATION OF THE NEW MAINS. ABANDONED MAINS SHALL BE CUT AND CAPPED. REFER TO SECTION 02064 OF THE SPECIFICATIONS FOR CUT AND CAPPING ABANDONED PIPE.
- 72. FIELD CONDITIONS MAY NECESSITATE MINOR ALIGNMENT AND GRADE DEVIATION OF THE PROPOSED UTILITIES TO AVOID OBSTACLES, AS ORDERED BY THE ENGINEER.
- 73. THE CONTRACTOR SHALL OBTAIN AUTHORIZATION FROM THE MANATEE COUNTY UTILITIES DEPARTMENT (MCUD) WASTEWATER COMPLIANCE DIVISION PRIOR TO DEWATERING. COMPLETION OF A CONSTRUCTION DEWATERING AUTHORIZATION TO DISCHARGE APPLICATION IS REQUIRED. FILL OUT FORM AS COMPLETELY AS POSSIBLE AS MISSING INFORMATION DELAYS THE APPROVAL PROCESS.
- 74. THE MCUD WASTEWATER COMPLIANCE DIVISION WILL DETERMINE WHETHER A LETTER OF APPROVAL, A DISCHARGE AUTHORIZATION, OR A DISCHARGE PERMIT IS REQUIRED.
- 75. FOR SITES SUSPECTED OF CONTAMINATED GROUNDWATER MANATEE COUNTY WILL REQUIRE AN APPLICANT TO DEMONSTRATE THAT THE DISCHARGE MEETS THE MANATEE COUNTY SEWER USE ORDINANCE.
- 76. CONTRACTOR SHALL REPLACE ANY DAMAGED VALVE BOXES AND ADJUST THE BOX TO THE FINISHED GRADE. IF ANY RECLAIMED OR WATER MAINS INCLUDING SERVICE LINES ARE DAMAGED DURING CONSTRUCTION, THEY SHALL BE REPLACED FROM THE VALVE TO THE OTHER POINT OF CONNECTION OUTSIDE OF THE ROADWAY PER MANATEE COUNTY'S STANDARDS. SERVICES SHALL BE REPLACED FROM THE CORP STOP TO THE METER.

TRAFFIC CONTROL NOTES

- 76. TRAFFIC SHALL BE MAINTAINED IN ACCORDANCE WITH F.D.O.T. STANDARD PLAN INDICES NO. 102 SERIES DEPENDING ON THE OPERATION BEING PERFORMED. FOR ALL TWO-LANE AND MULTILANE ROADWAY, WORK BEYOND THE SHOULDER UTILIZE INDEX
- 102 601FOR ALL TWO-LANE AND MULTILANE, WORK ON SHOULDER UTILIZE INDEX 102-602. FOR ALL TWO-LANE WORK, TWO-WAY, WORK WITHIN TRAVEL WAY UTILIZE INDEX 102-603. FOR ALL TWO-LANE WORK, TWO-WAY, INTERSECTION WORK UTILIZE INDEX 102-604.
- 77. TO AVOID DISRUPTION DUE TO INCLEMENT WEATHER, THE CONTRACTOR SHOULD PERFORM ANY MILLING AND PAVING OPERATIONS DURING THE SAME WORK PERIOD.
- 78. ALL EXISTING PAVEMENT MARKINGS OUTSIDE THE CONSTRUCTION LIMITS THAT HAVE BEEN ALTERED BECAUSE OF CONSTRUCTION OPERATIONS SHALL BE REPLACED UPON THE COMPLETION OF THE PROJECT AT THE CONTRACTORS EXPENSE.
- 79. PEDESTRIANS, BICYCLES, AND WHEELCHAIRS: AT THE END OF EACH WORKDAY OR WHENEVER THE WORK ZONE BECOMES INACTIVE, ANY DROP-OFF ADJACENT TO A SIDEWALK SHALL BE BACKFILLED AT A SLOPE NOT TO EXCEED 1:4, OR SHALL BE PROTECTED IN ACCORDANCE WITH STANDARD INDEX 102-600.
- 80. PEDESTRIAN AND WHEELCHAIR TRAFFIC SHALL BE ACCOMMODATED UTILIZING STANDARD INDEX 102-660.
- 81. ONE PORTABLE VARIABLE MESSAGE SIGN SHALL BE USED IN ADVANCE OF EACH LANE CLOSURE. THE FOLLOWING ARE SUGGESTED MESSAGES TO USE IN THE APPROPRIATE SITUATIONS:

"RIGHT" OR "CENTER" OR "LEFT" "LANE" "LANE" "LANE" "CLOSED" "CLOSED" "CLOSED"

FOR SIDEWALK CLOSURE, UTILIZE INDEX 102-660.

- 82. THE CONTRACTOR SHALL BE RESPONSIBLE FOR THE IMMEDIATE REMOVAL OF STORMWATER FROM ROADWAYS UTILIZED FOR TRAFFIC CONTROL IN A MANNER APPROVED BY THE ENGINEER.
- 83. AT THE END OF EACH WORKING DAY'S ACTIVITY, TEMPORARY PAVEMENT MARKINGS AND TEMPORARY RPM'S SHALL BE INSTALLED PRIOR TO OPENING THE LANES UP FOR TRAFFIC.
- 84. ALL PAVEMENT MARKINGS, SIGNS, MARKERS, CHANNELIZATION REQUIRED TO PHASE WORK OR SHIFT TRAFFIC, SHALL UTILIZE INDICES FOR PLACEMENT.
- 85. THE CONTRACTOR SHALL RESTRICT THE OPERATIONS SO THAT THE FIRST LIFT OF ASPHALT IS PLACED ON THE SAME DAY THAT THE LANES ARE MILLED, BEFORE OPENING THE LANES TO TRAFFIC. INSTALL TEMPORARY PAVEMENT MARKINGS AFTER THE FIRST LIFT AND PRIOR TO OPENING.
- 86. MILLING AND RESURFACING SHALL BE ACCOMPLISHED DURING THE OFF-PEAK HOURS.

- 87. THE CONTRACTOR IS RESPONSIBLE TO RETIME THE TRAFFIC SIGNALS WITHIN THE PROJECT LIMITS (INCLUDING LIMITS OF WORK ZONE TRAFFIC CONTROL) THAT ARE POTENTIALLY AFFECTED DURING VARIOUS PHASES OF CONSTRUCTION. COORDINATE ALL SIGNAL RETIME EFFORTS WITH MANATEE COUNTY TRAFFIC ENGINEERING, MUKUNDA GOPALAKRISHNA, P.E., PTOE, AT 941-749-3500, EXT. 7813.
- 88. CONTRACTOR TO MAINTAIN VEHICLE DETECTION IN OPERATION FOR LANES THAT WILL REMAIN OPEN. CONTRACTOR TO COORDINATE ALL VEHICLE DETECTION ISSUES WITH MANATEE COUNTY TRAFFIC ENGINEERING,
- VISHAL S. KAKKAD, P.E., PTOE, AT 941-749-3500 EXT 7812 OR VISHAL.KAKKAD@MYMANATEE.ORG 89. MAINTENANCE OF TRAFFIC AND ANY SIGNAL RETIMING WILL BE THE RESPONSIBILITY OF THE CONTRACTOR.
- 90. ANY SIGNAL RETIMING REQUIRED FOR THE INTERSECTIONS IMPACTED BY THE PROJECT WILL BE THE RESPONSIBILITY OF THE CONTRACTOR. SIGNAL TIMING MODIFICATIONS TO BE SUBMITTED TO MANATEE COUNTY TRAFFIC ENGINEERING, ATTENTION, MR. MUKUNDA GOPALAKRISHNA FOR REVIEW AND APPROVAL AT LEAST 15 WORKING DAYS BEFORE PROPOSED CHANGES. THIS DOES NOT GOVERN EMERGENCY SITUATIONS, PENDING THE APPROVAL OF THE ENGINEER.
- 91. A DETAILED MAINTENANCE OF TRAFFIC PLANS ARE TO BE SUBMITTED TO MANATER COUNTY AND THE ENGINEER. BY THE CONTRACTOR, FOR REVIEW AND APPROVAL A MINIMUM OF 21 WORKING DAYS PRIOR TO PROPOSED IMPLEMENTATION.

KIMLEY HORN LEGEND

EX. RECLAIMED WATER	X F	RCW ——	-X RCW-	—X RC	:W ———
EX. FORCE MAIN	X[FM	-X-FM —	——X-F	М ——
EX. POTABLE WATER	X	WT ——	-X WT	X WT	
EX. SANITARY SEWER	———X SS-	X SS	SX :	SS	-X SS
EX. STORM	X-ST-		—X-ST——		X-ST
EX. BURIED TELEPHONE/FIBER	——х вт—	— х вт	x	вт ——	- X BT
EX. BURIED ELECTRIC	—— Х ВЕ —	—— Х ВЕ	:×	BE	- X BE
EX. GAS		—X-GAS—		-X-GAS	
EX. OVERHEAD ELECTRIC	—— X OE —	—— Х ОЕ	x	OE	- X OE
EX. FIBER OPTIC		—X-F0		—X-F0	

<u>ABBREVIATIONS</u>

ARV - AIR RELEASE VALVE BT - BURIED TELEPHONE DIP - DUCTILE IRON PIPE EX. – EXISTING FM - FORCE MAIN LINEAR FEET PVC - POLYVINYL CHLORIDE RJ - RESTRAINED JOINT R/W - RIGHT-OF-WAY RCP - REINFORCED CONCRETE PIPE

RCW - RECLAIMED WATER MAIN

SS - SANITARY SEWER

PLAN CALLOUT LEGEND DETAIL NAME $\langle 7 \rangle$ KEY NOTE (A) KEY TAG SHEET WHERE DETAIL IS SHOWN

200 CENTRAL AVENUE, SUITE 600, ST. PETERSBURG, FL 33701

REVISIONS

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KHA PROJECT 148400106 DATE JUL 2023 SCALE AS SHOW ESIGNED BY MA

drawn by GME

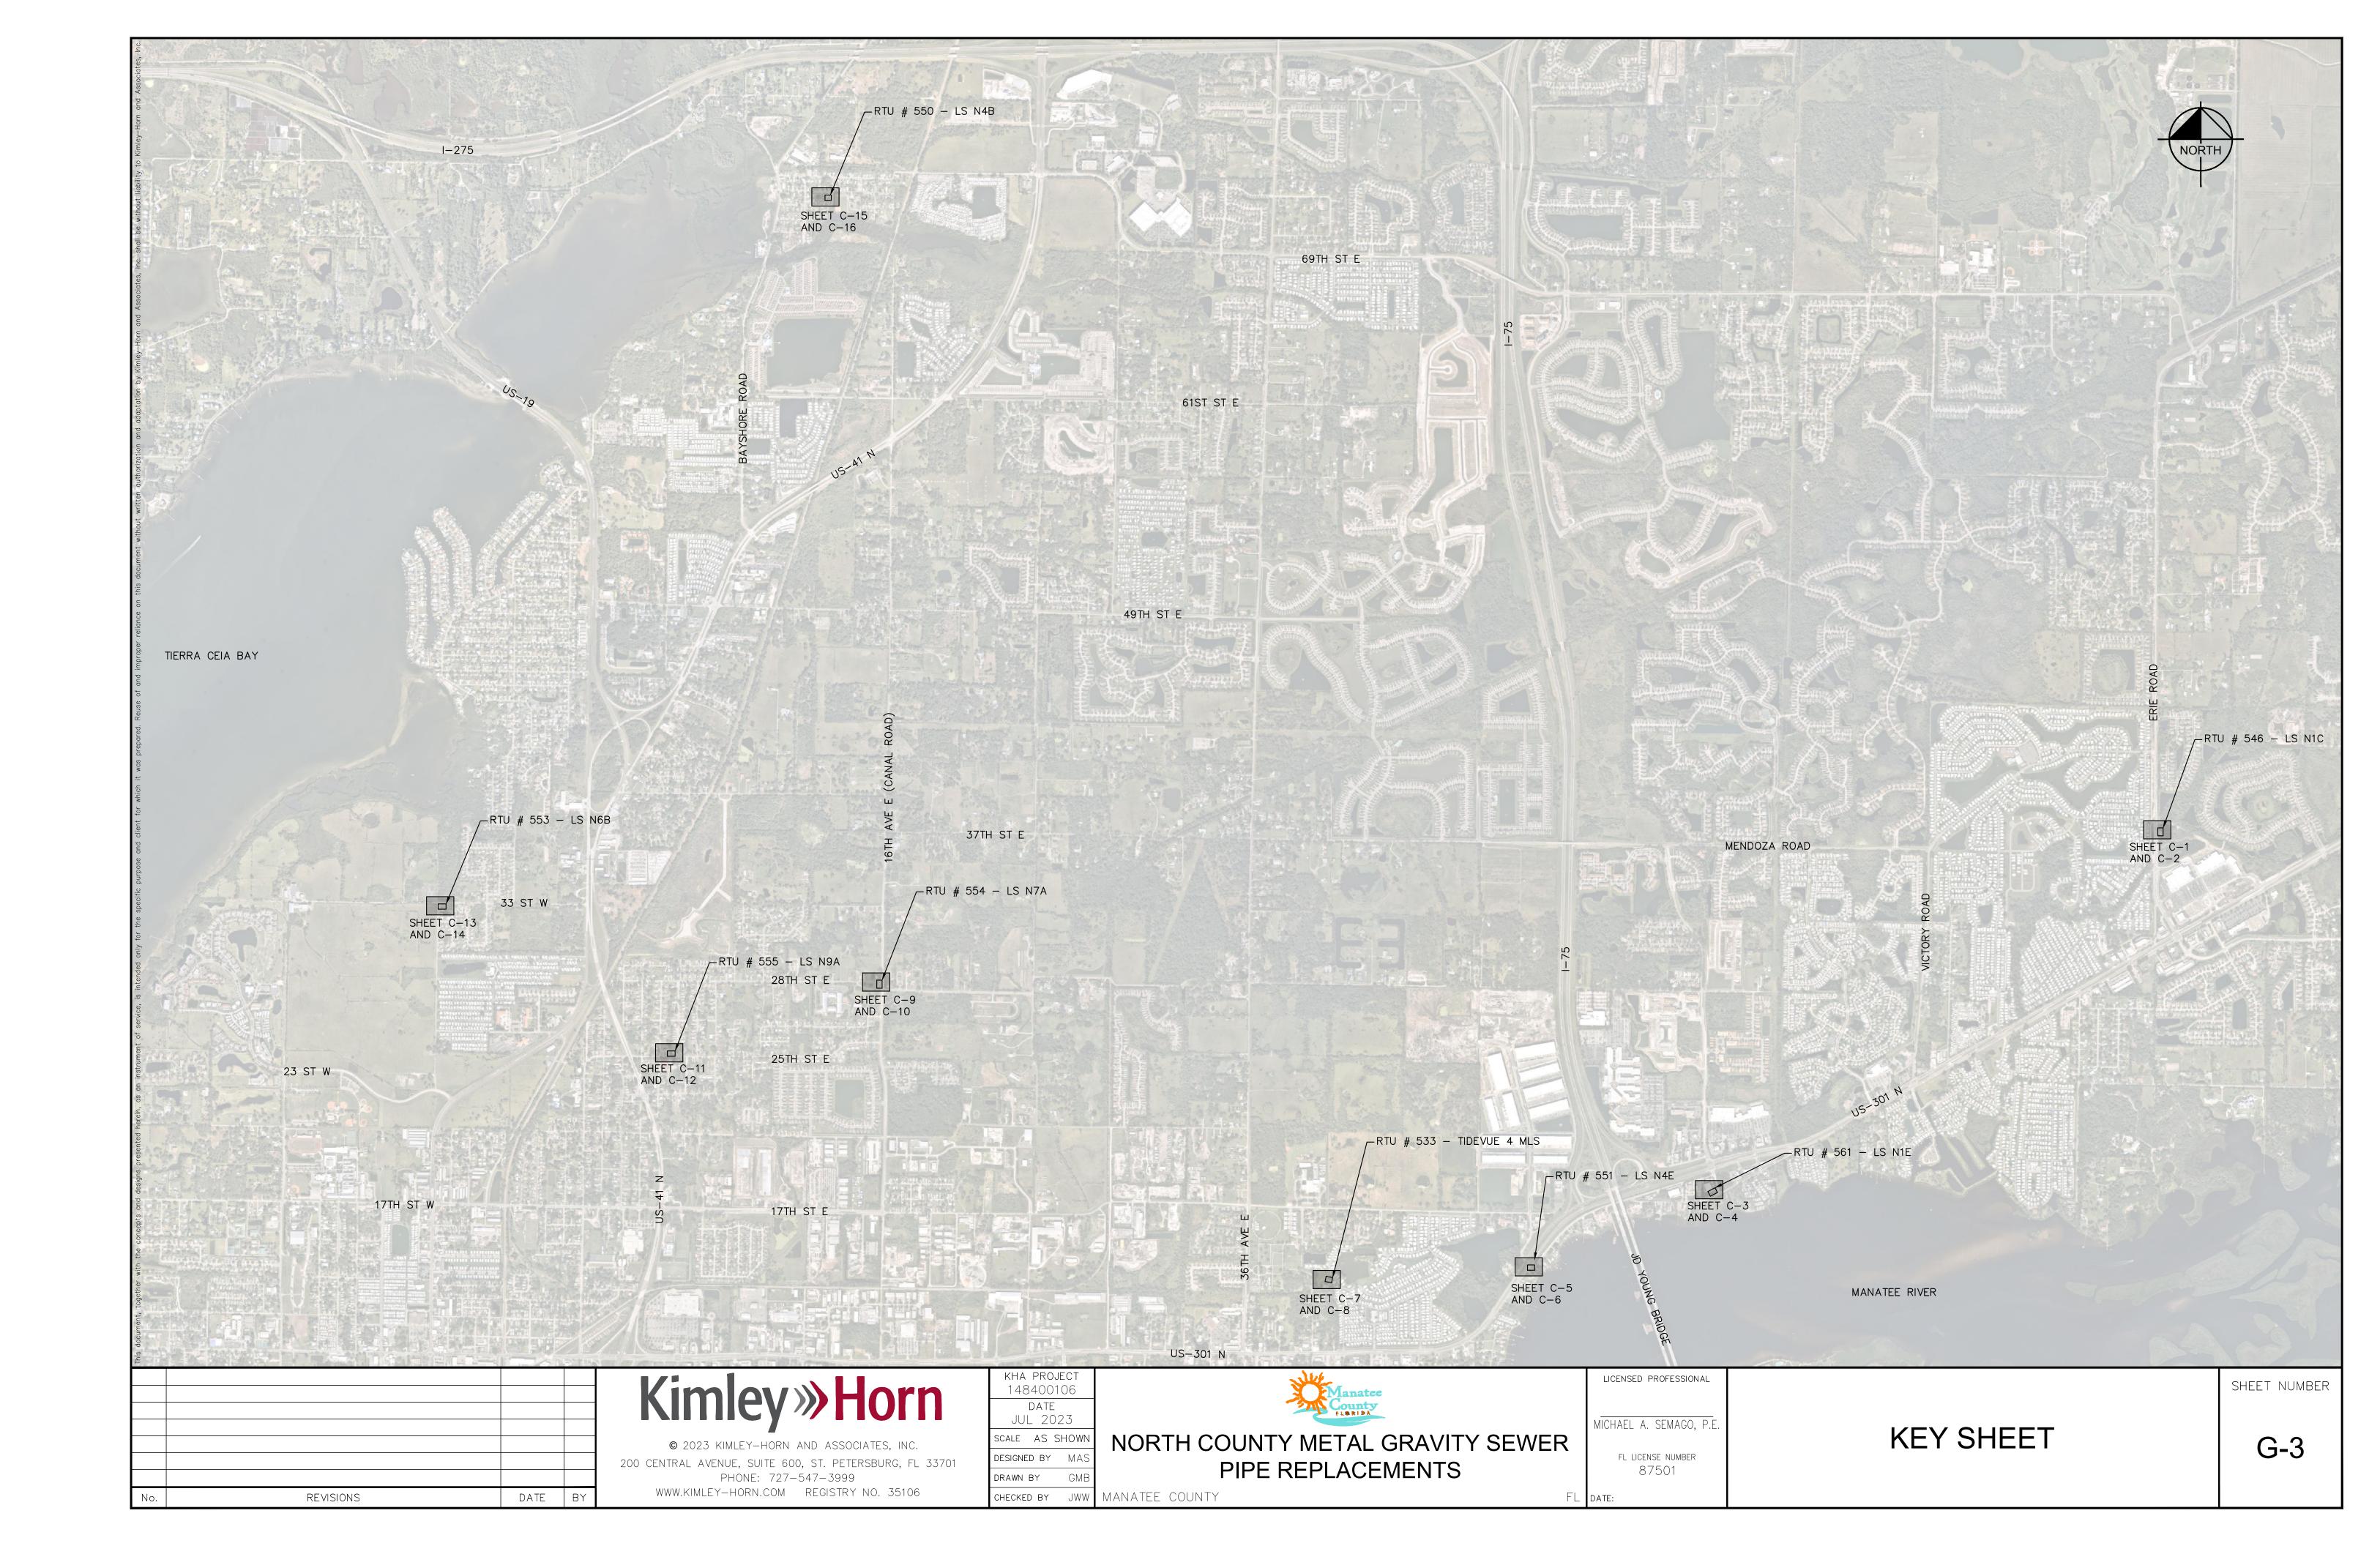
CHECKED BY JWW MANATEE COUNTY

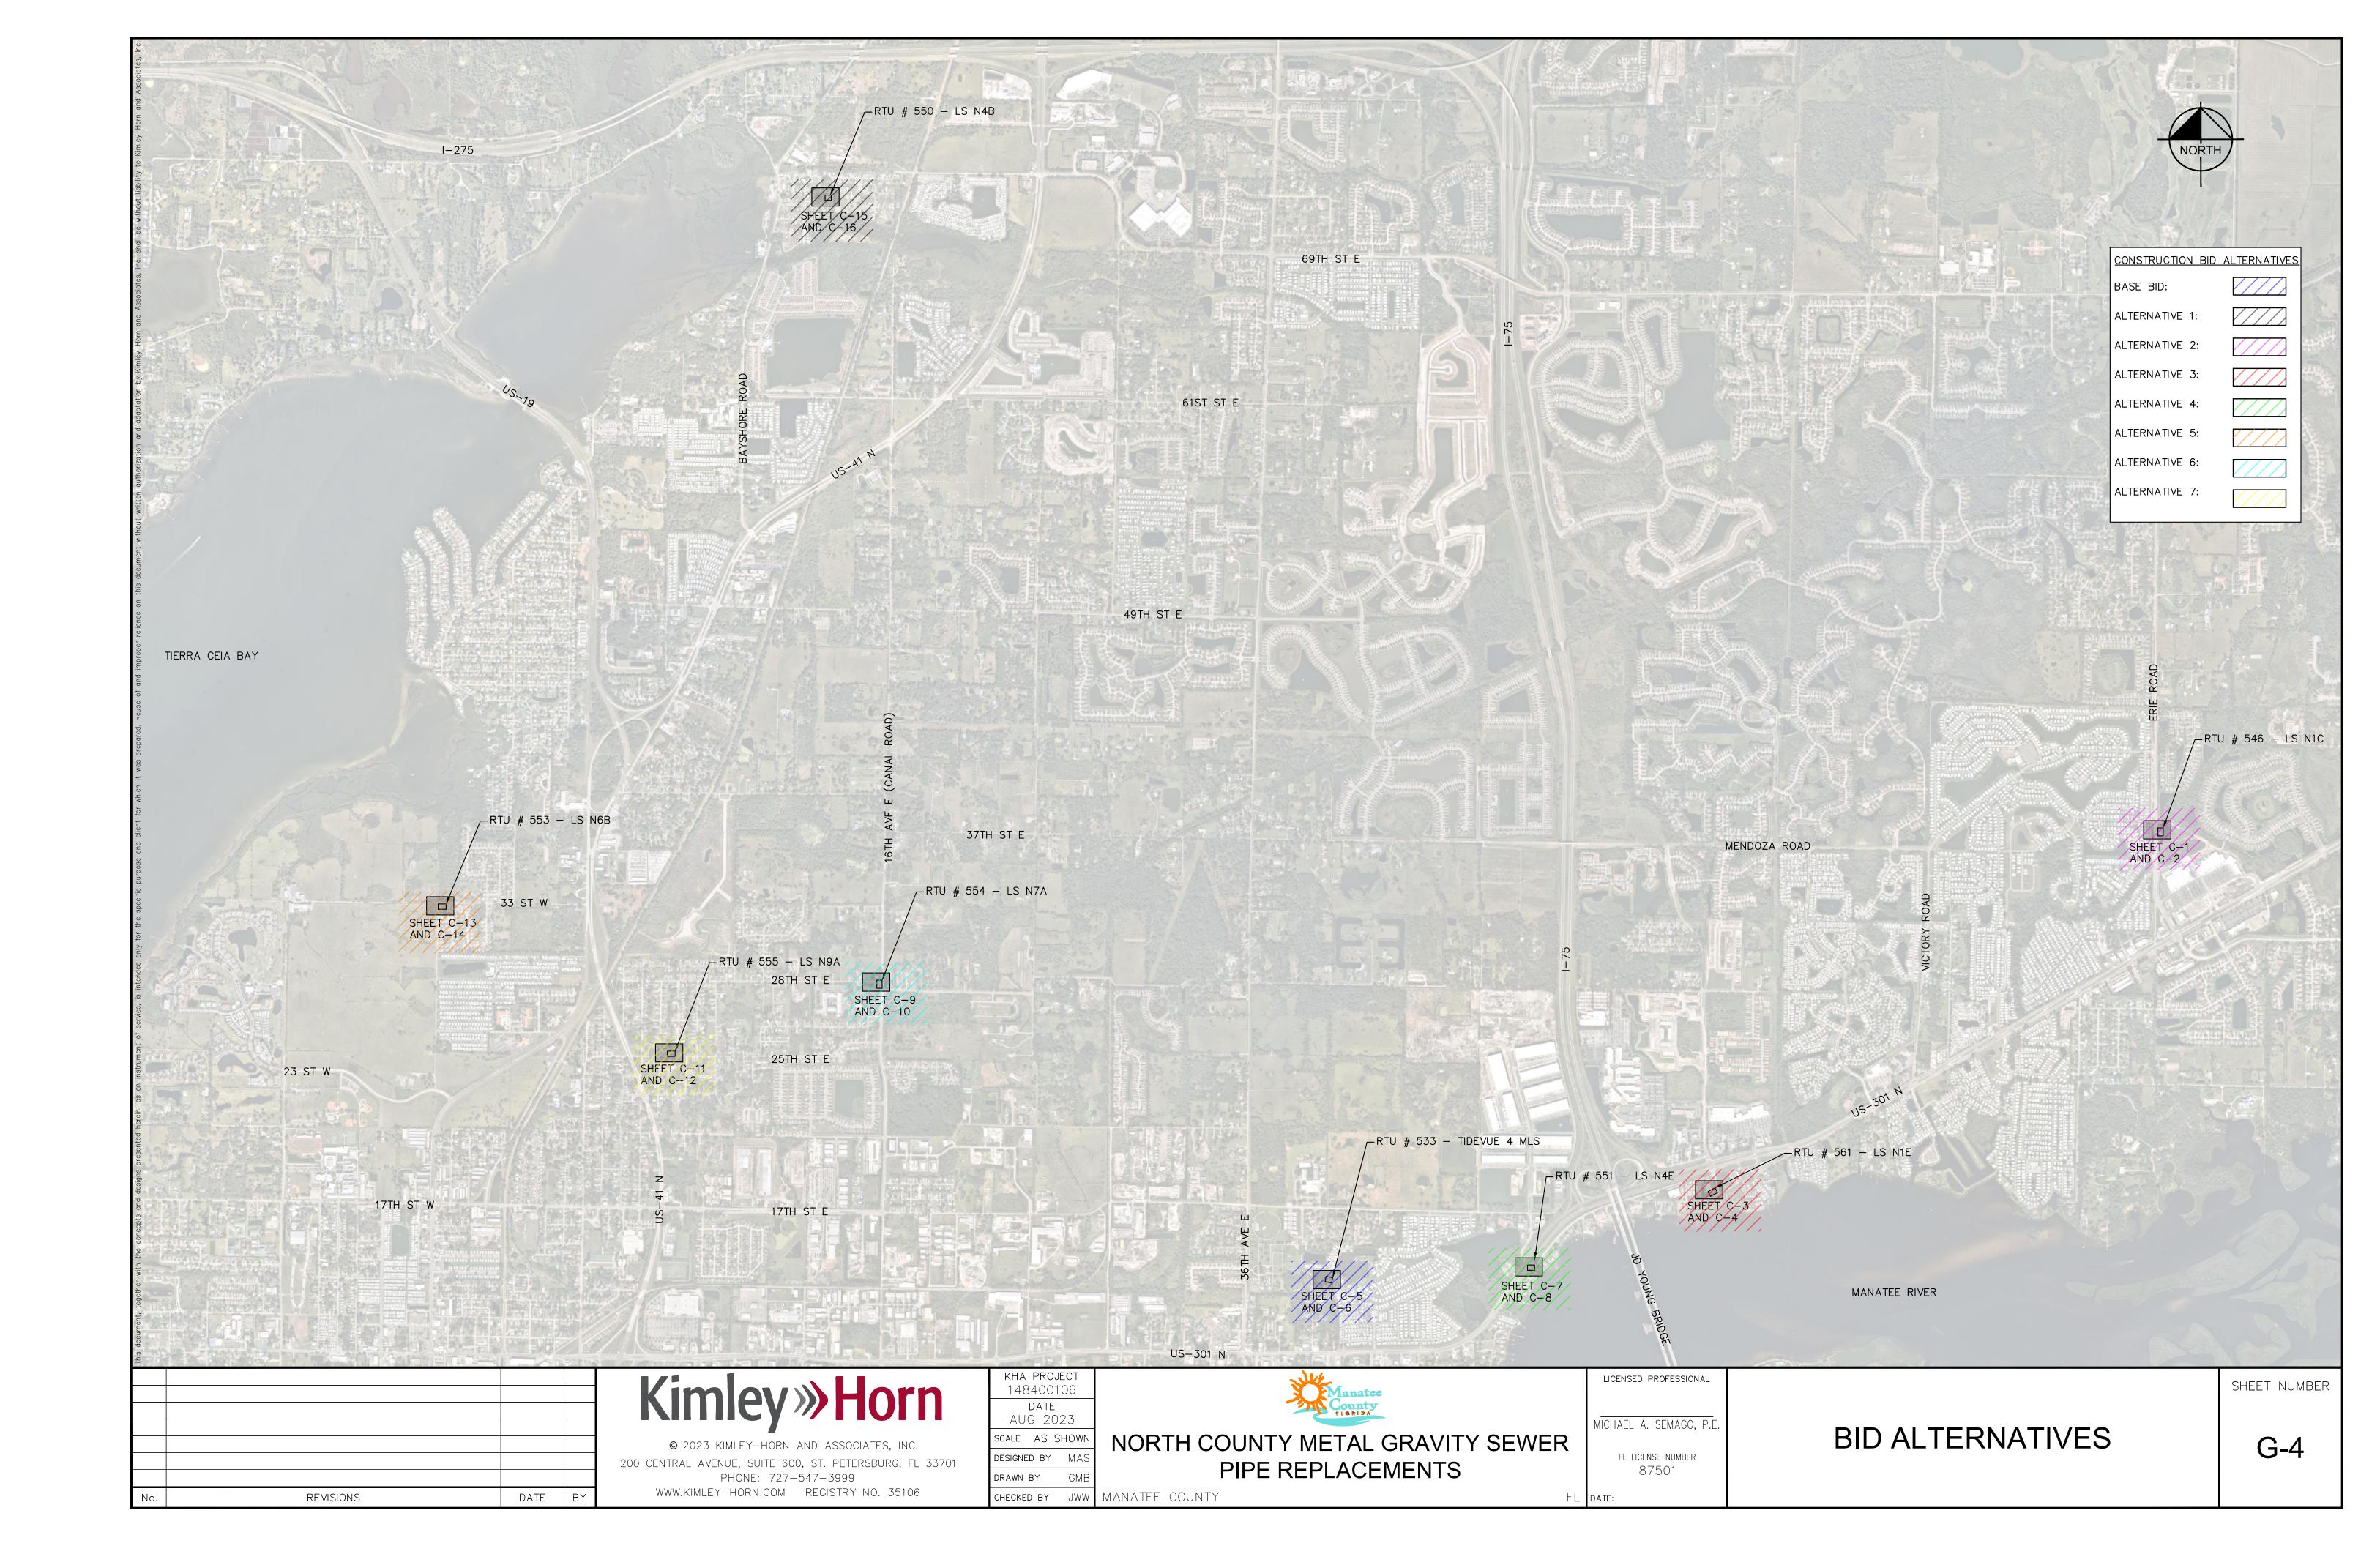
NORTH COUNTY METAL GRAVITY SEWER PIPE REPLACEMENTS

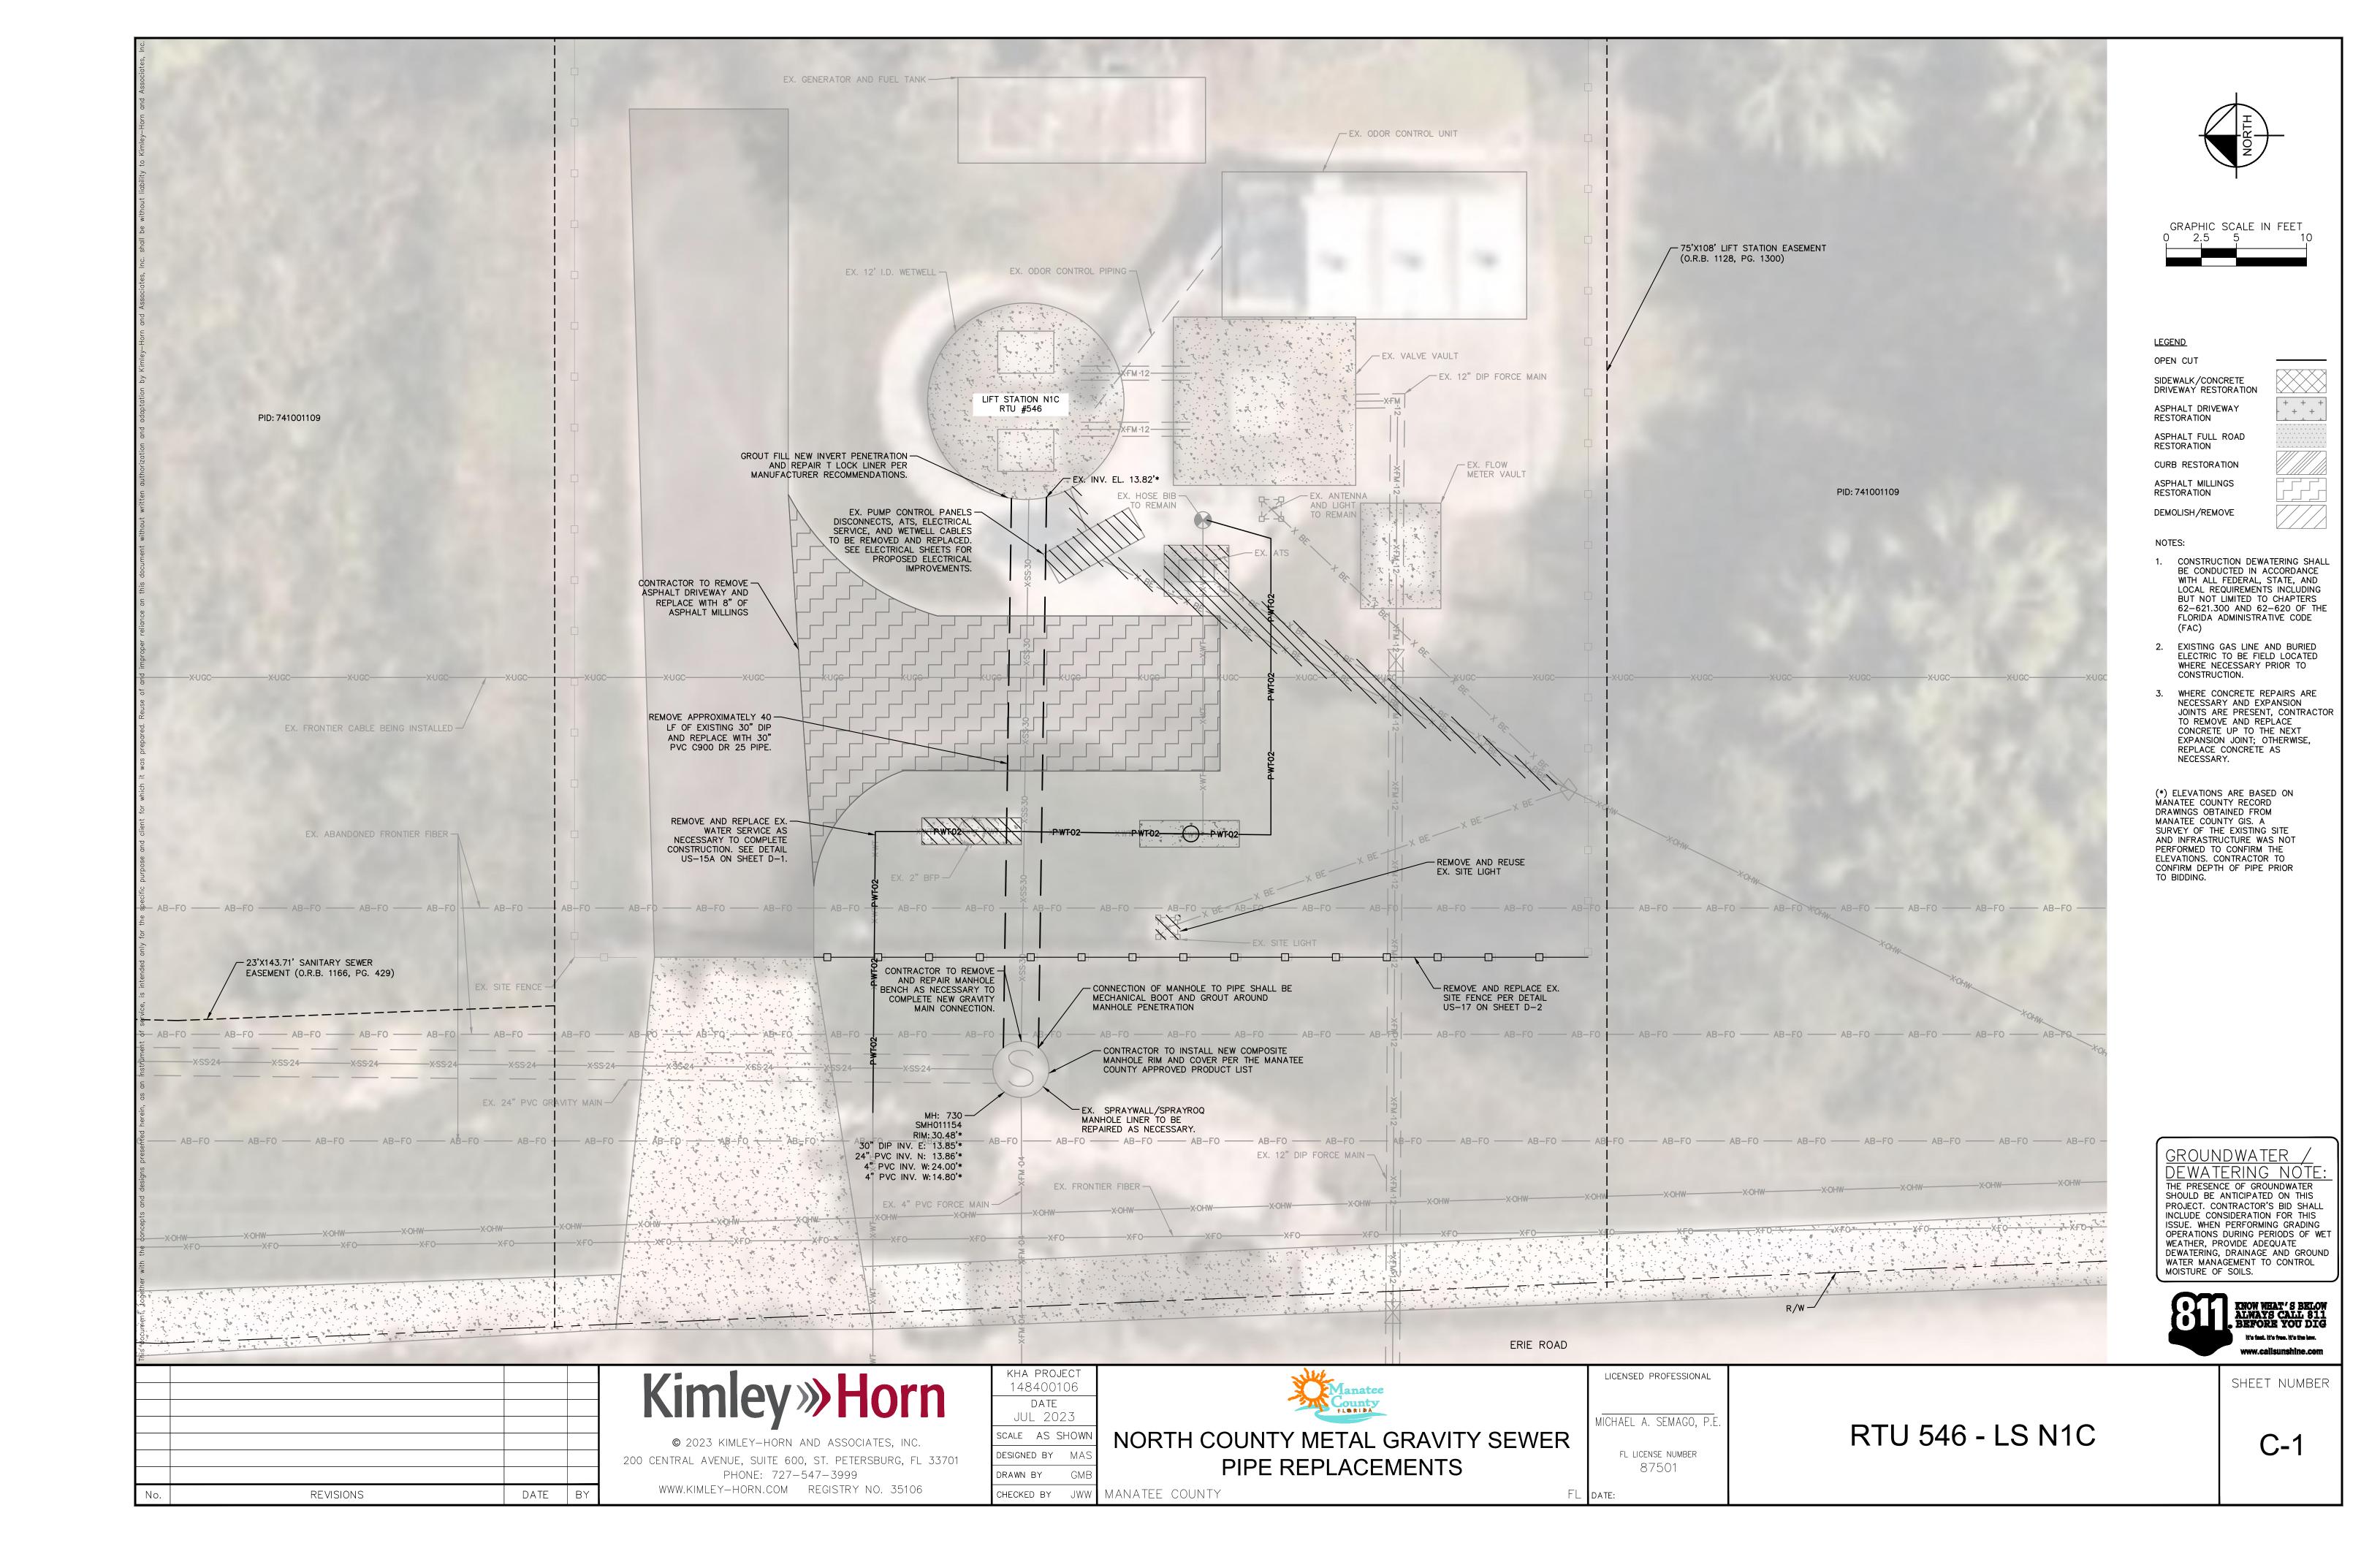
LICENSED PROFESSIONAL MICHAEL A. SEMAGO, P.E FL LICENSE NUMBER 87501

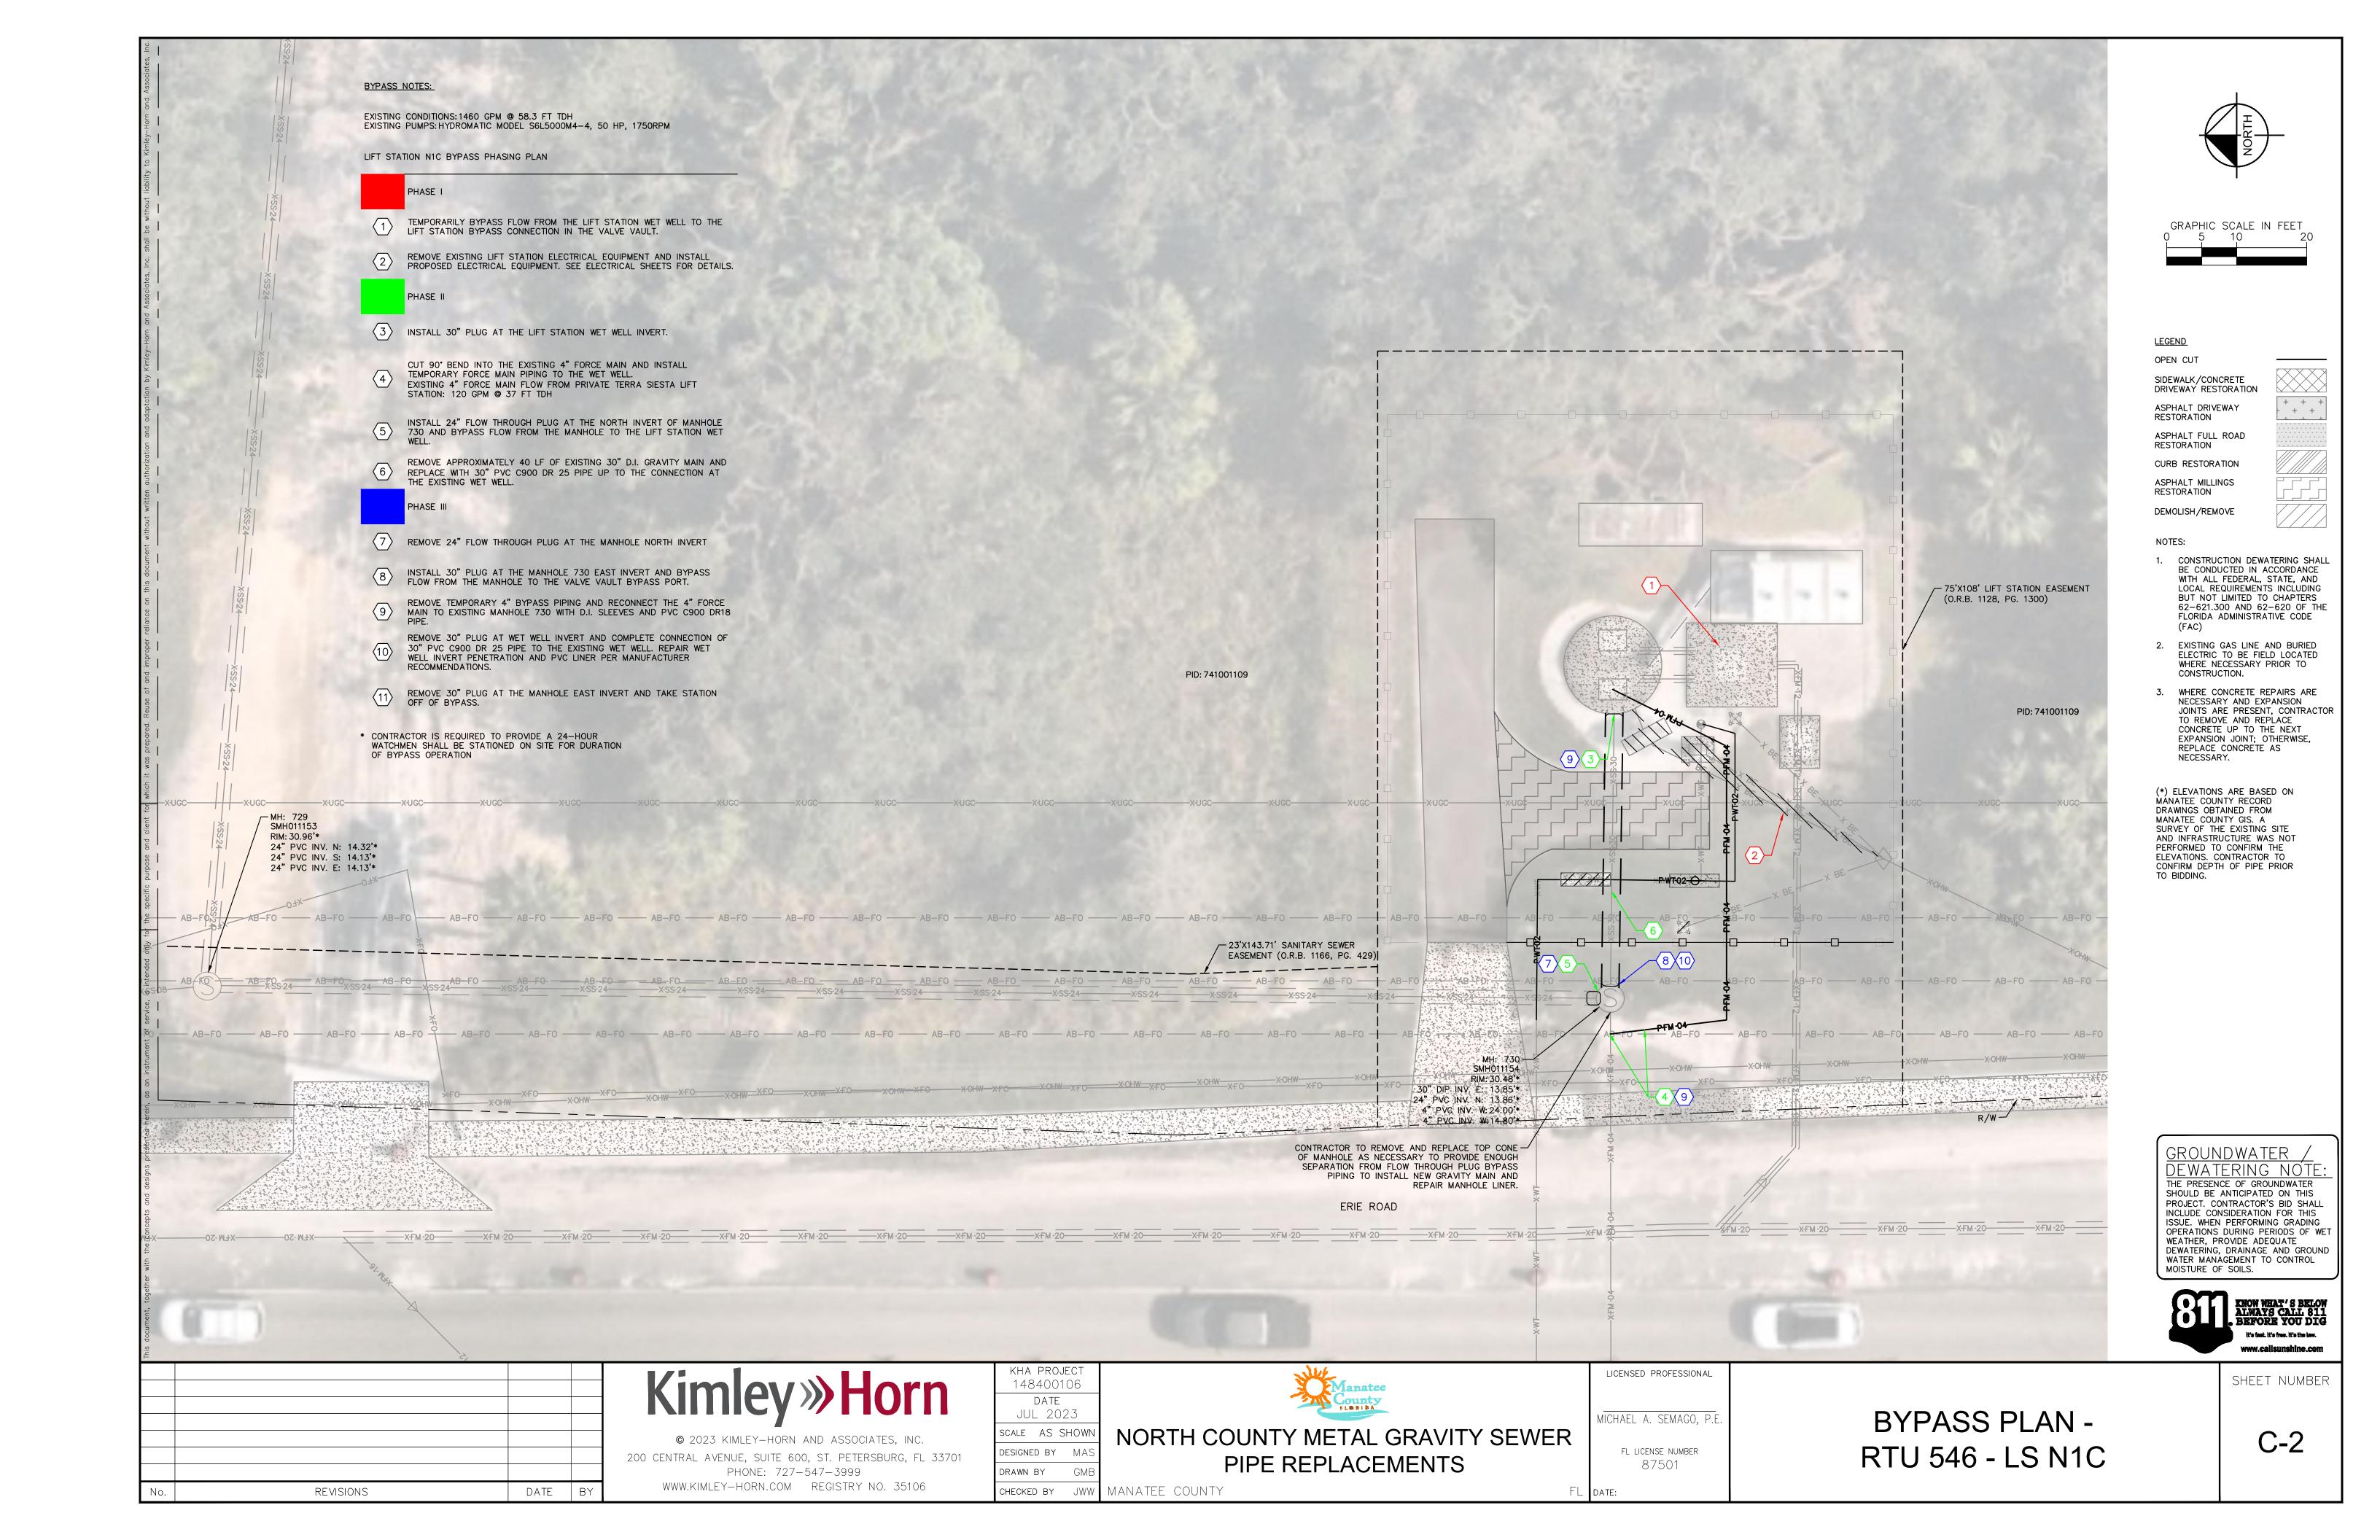
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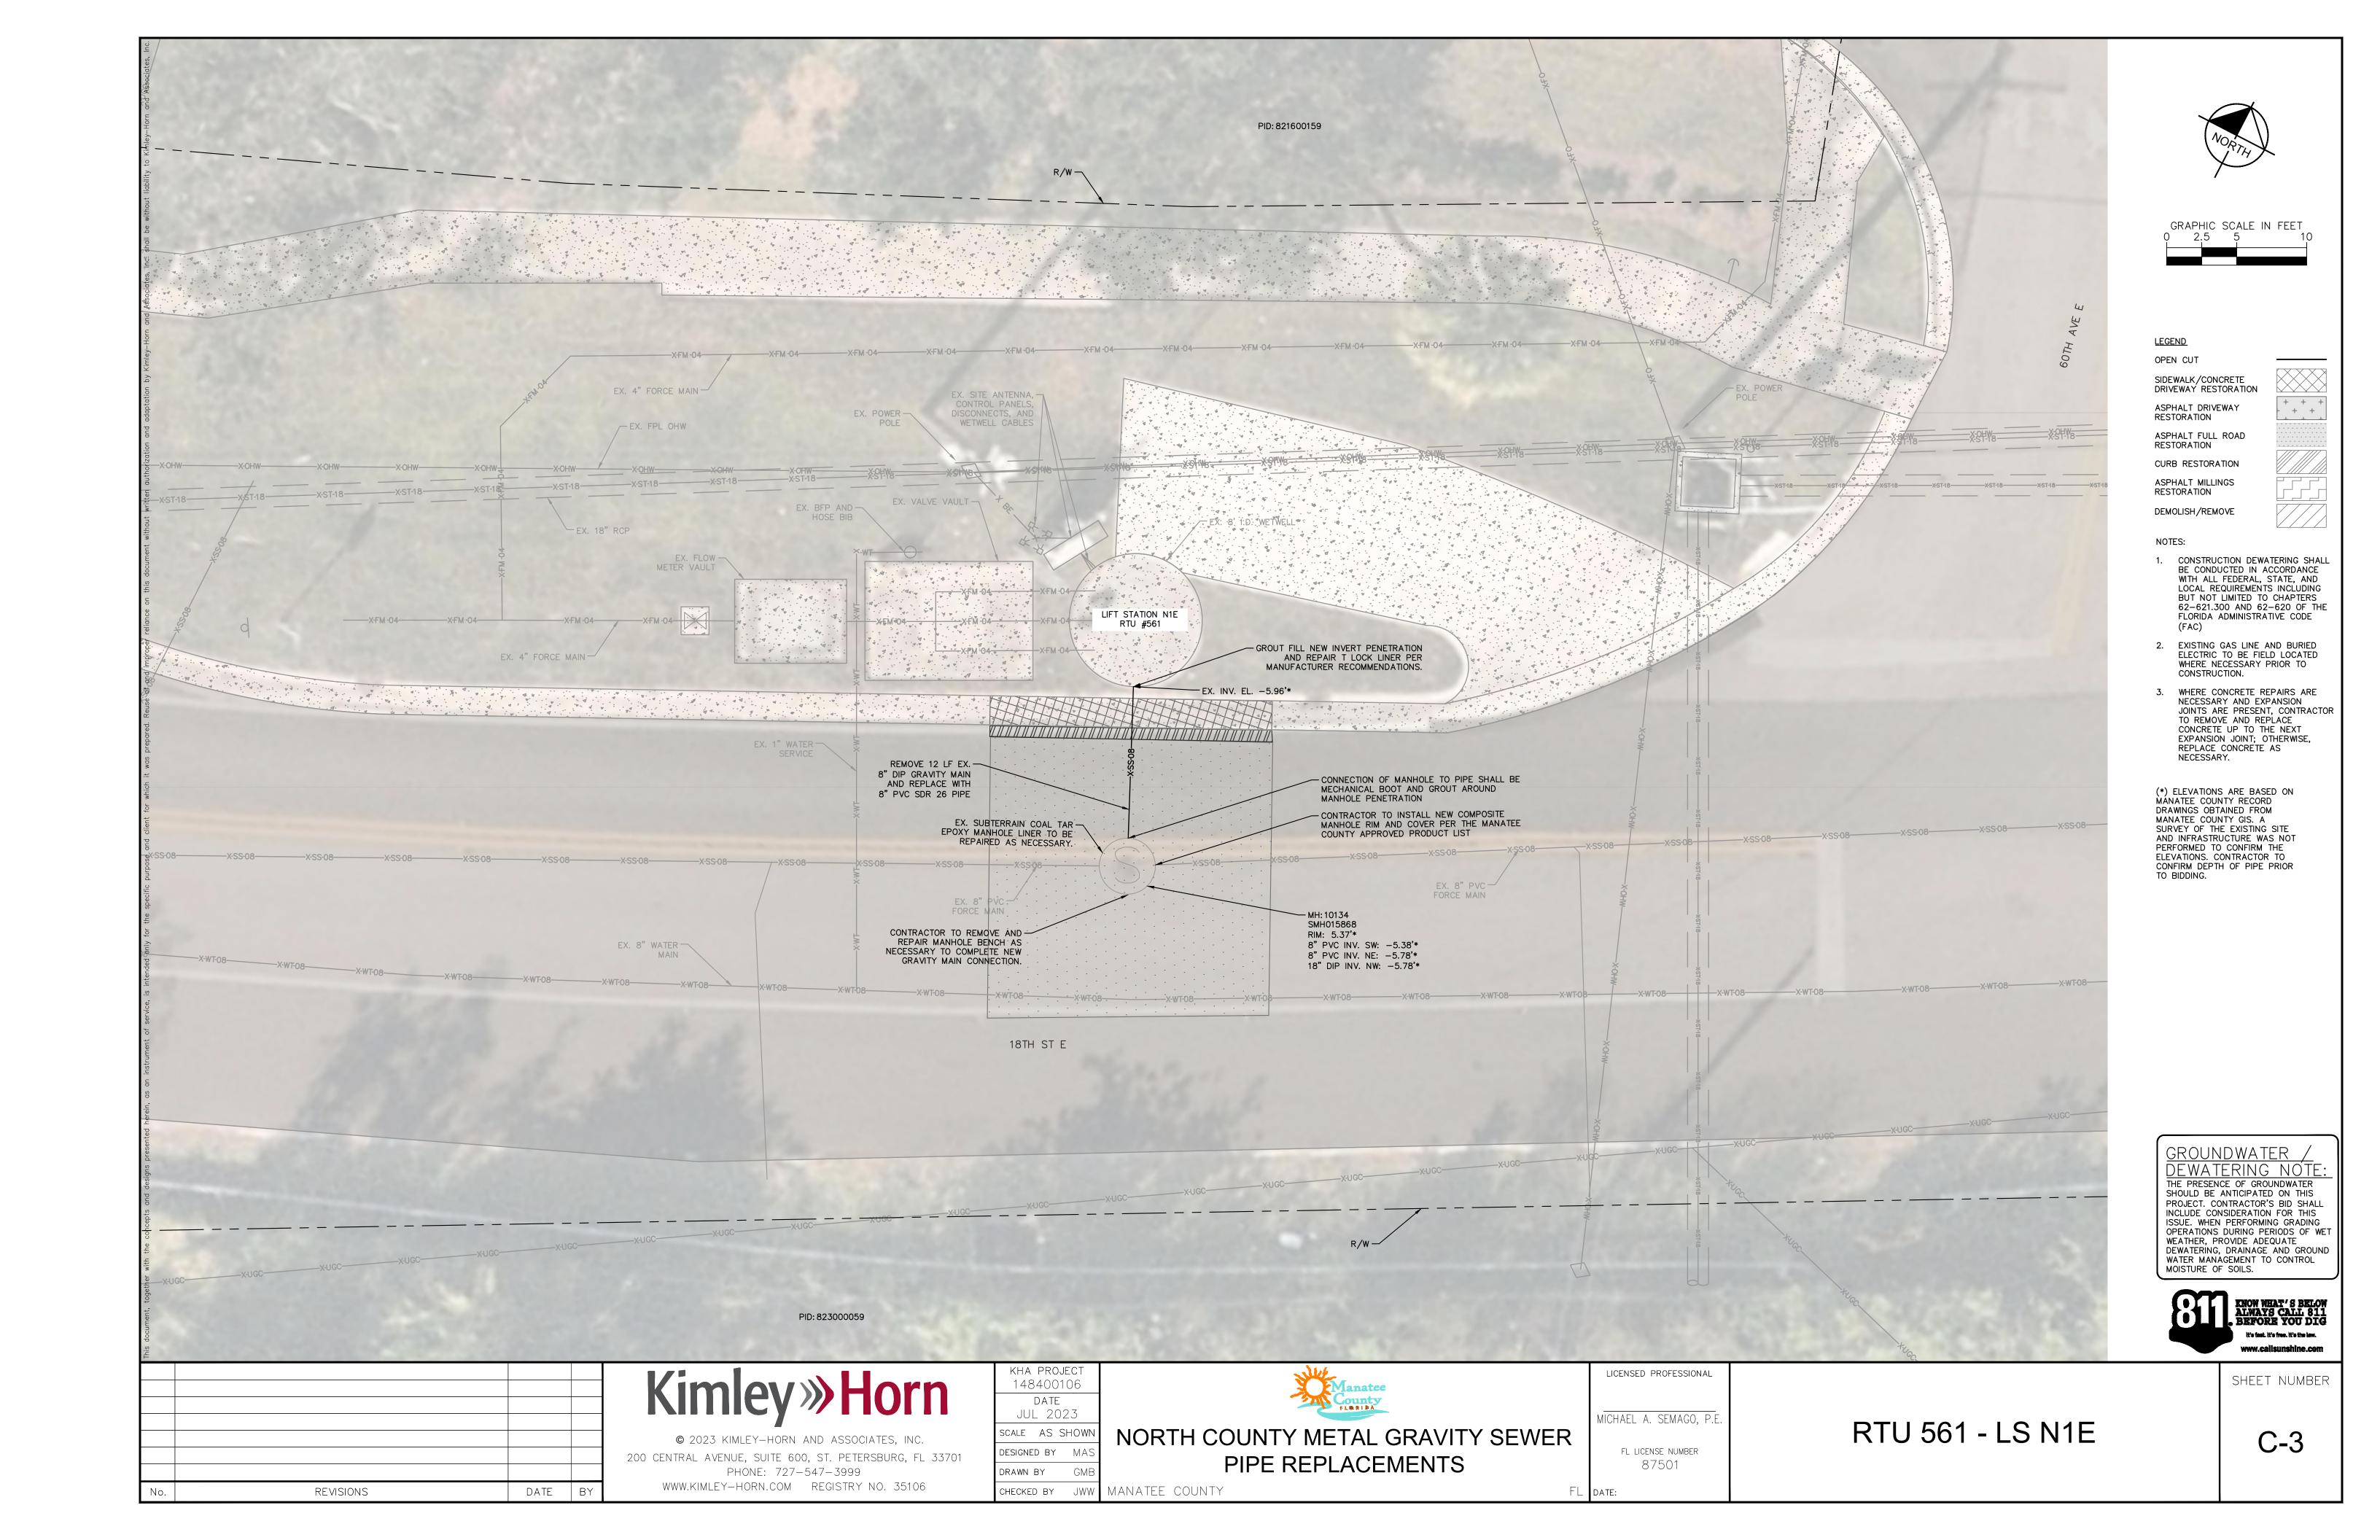
GENERAL NOTES

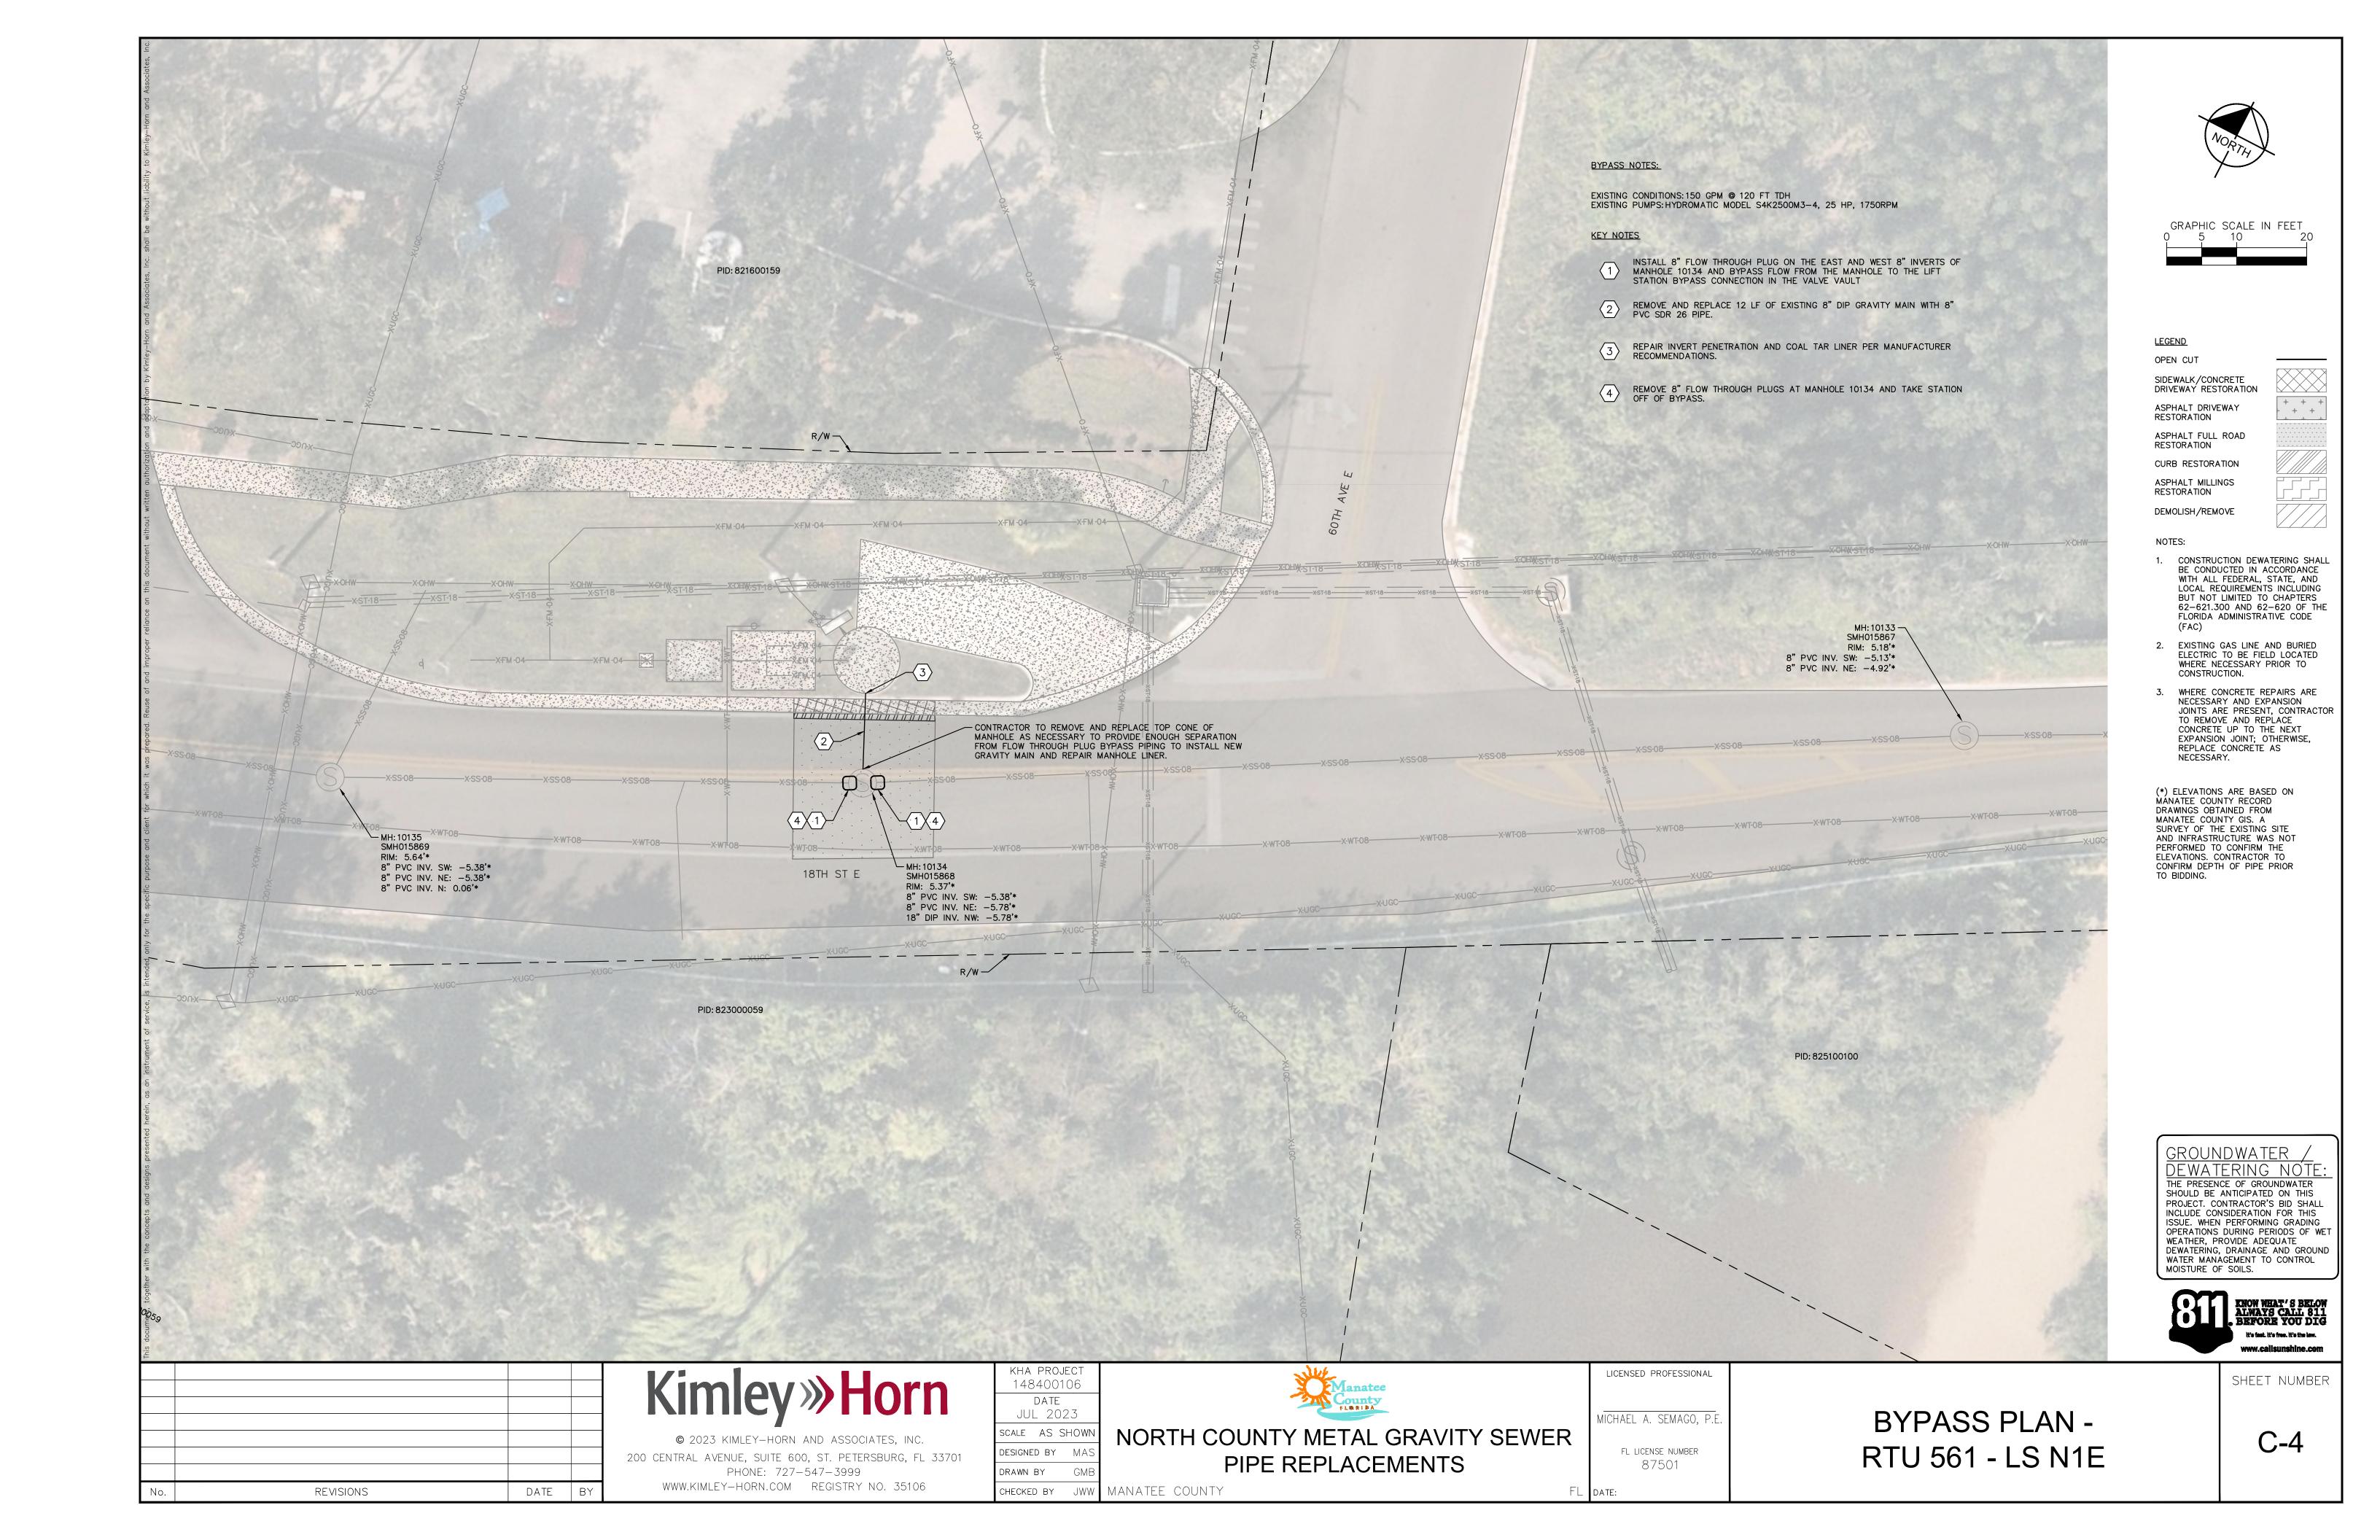


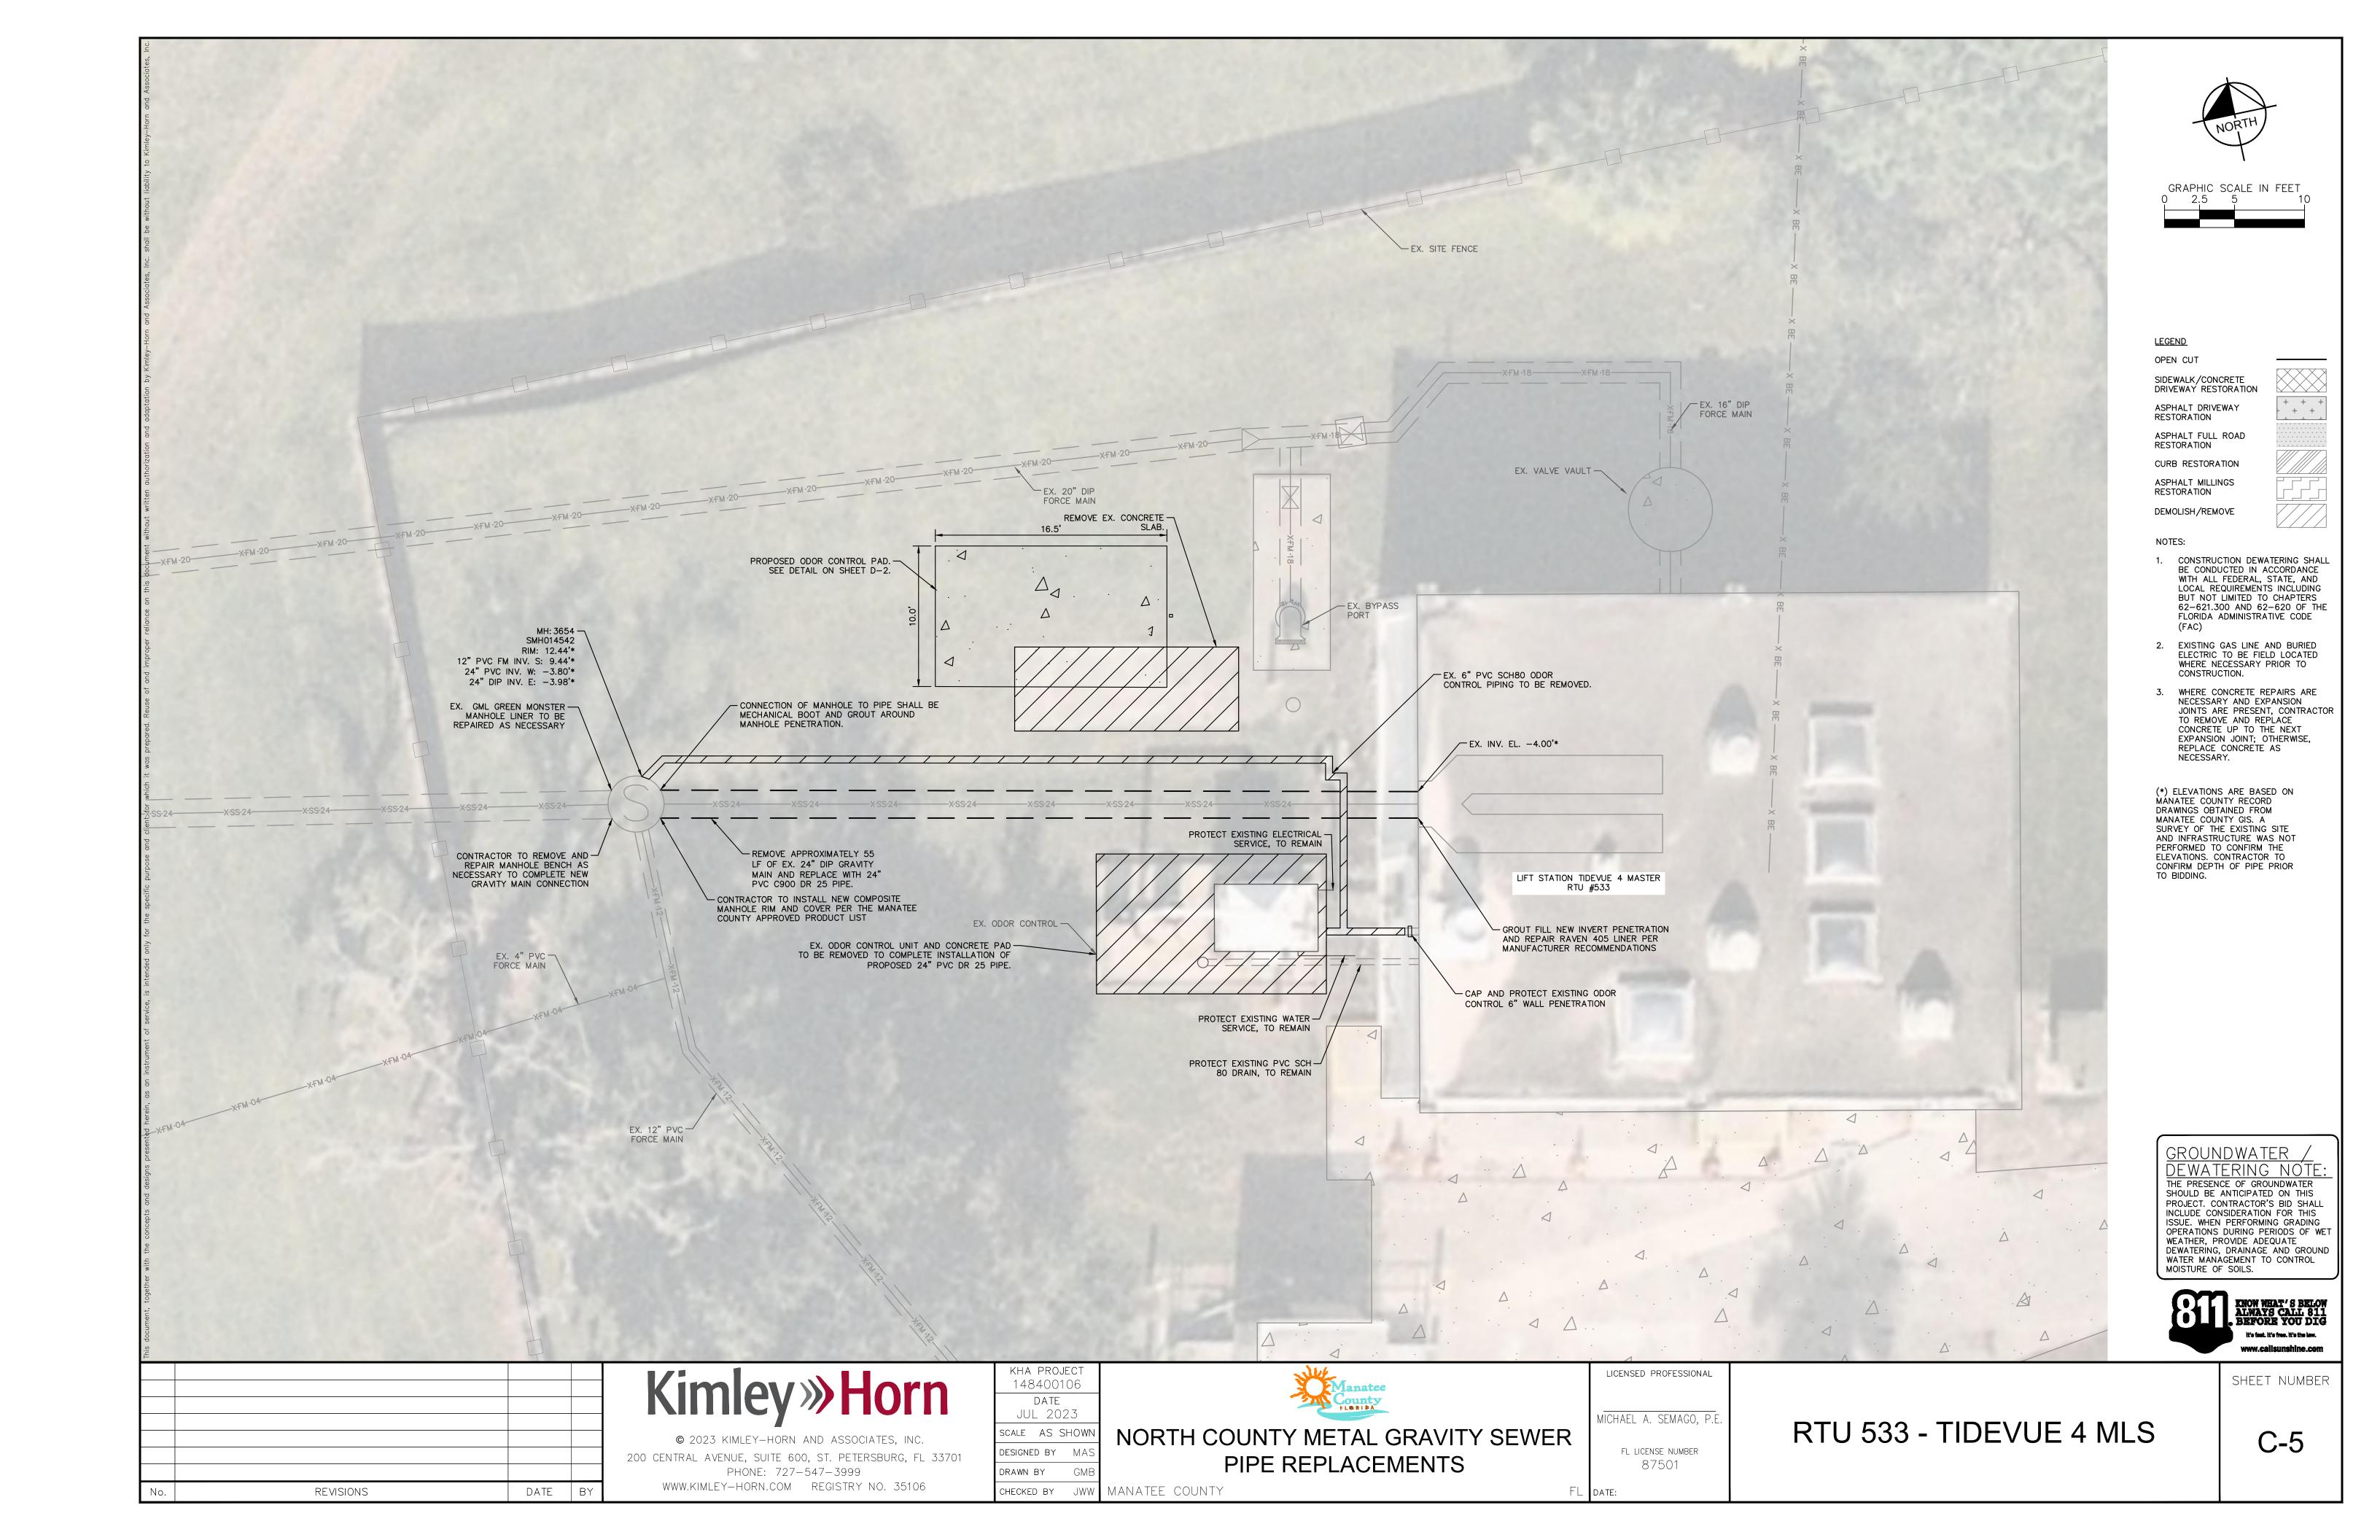


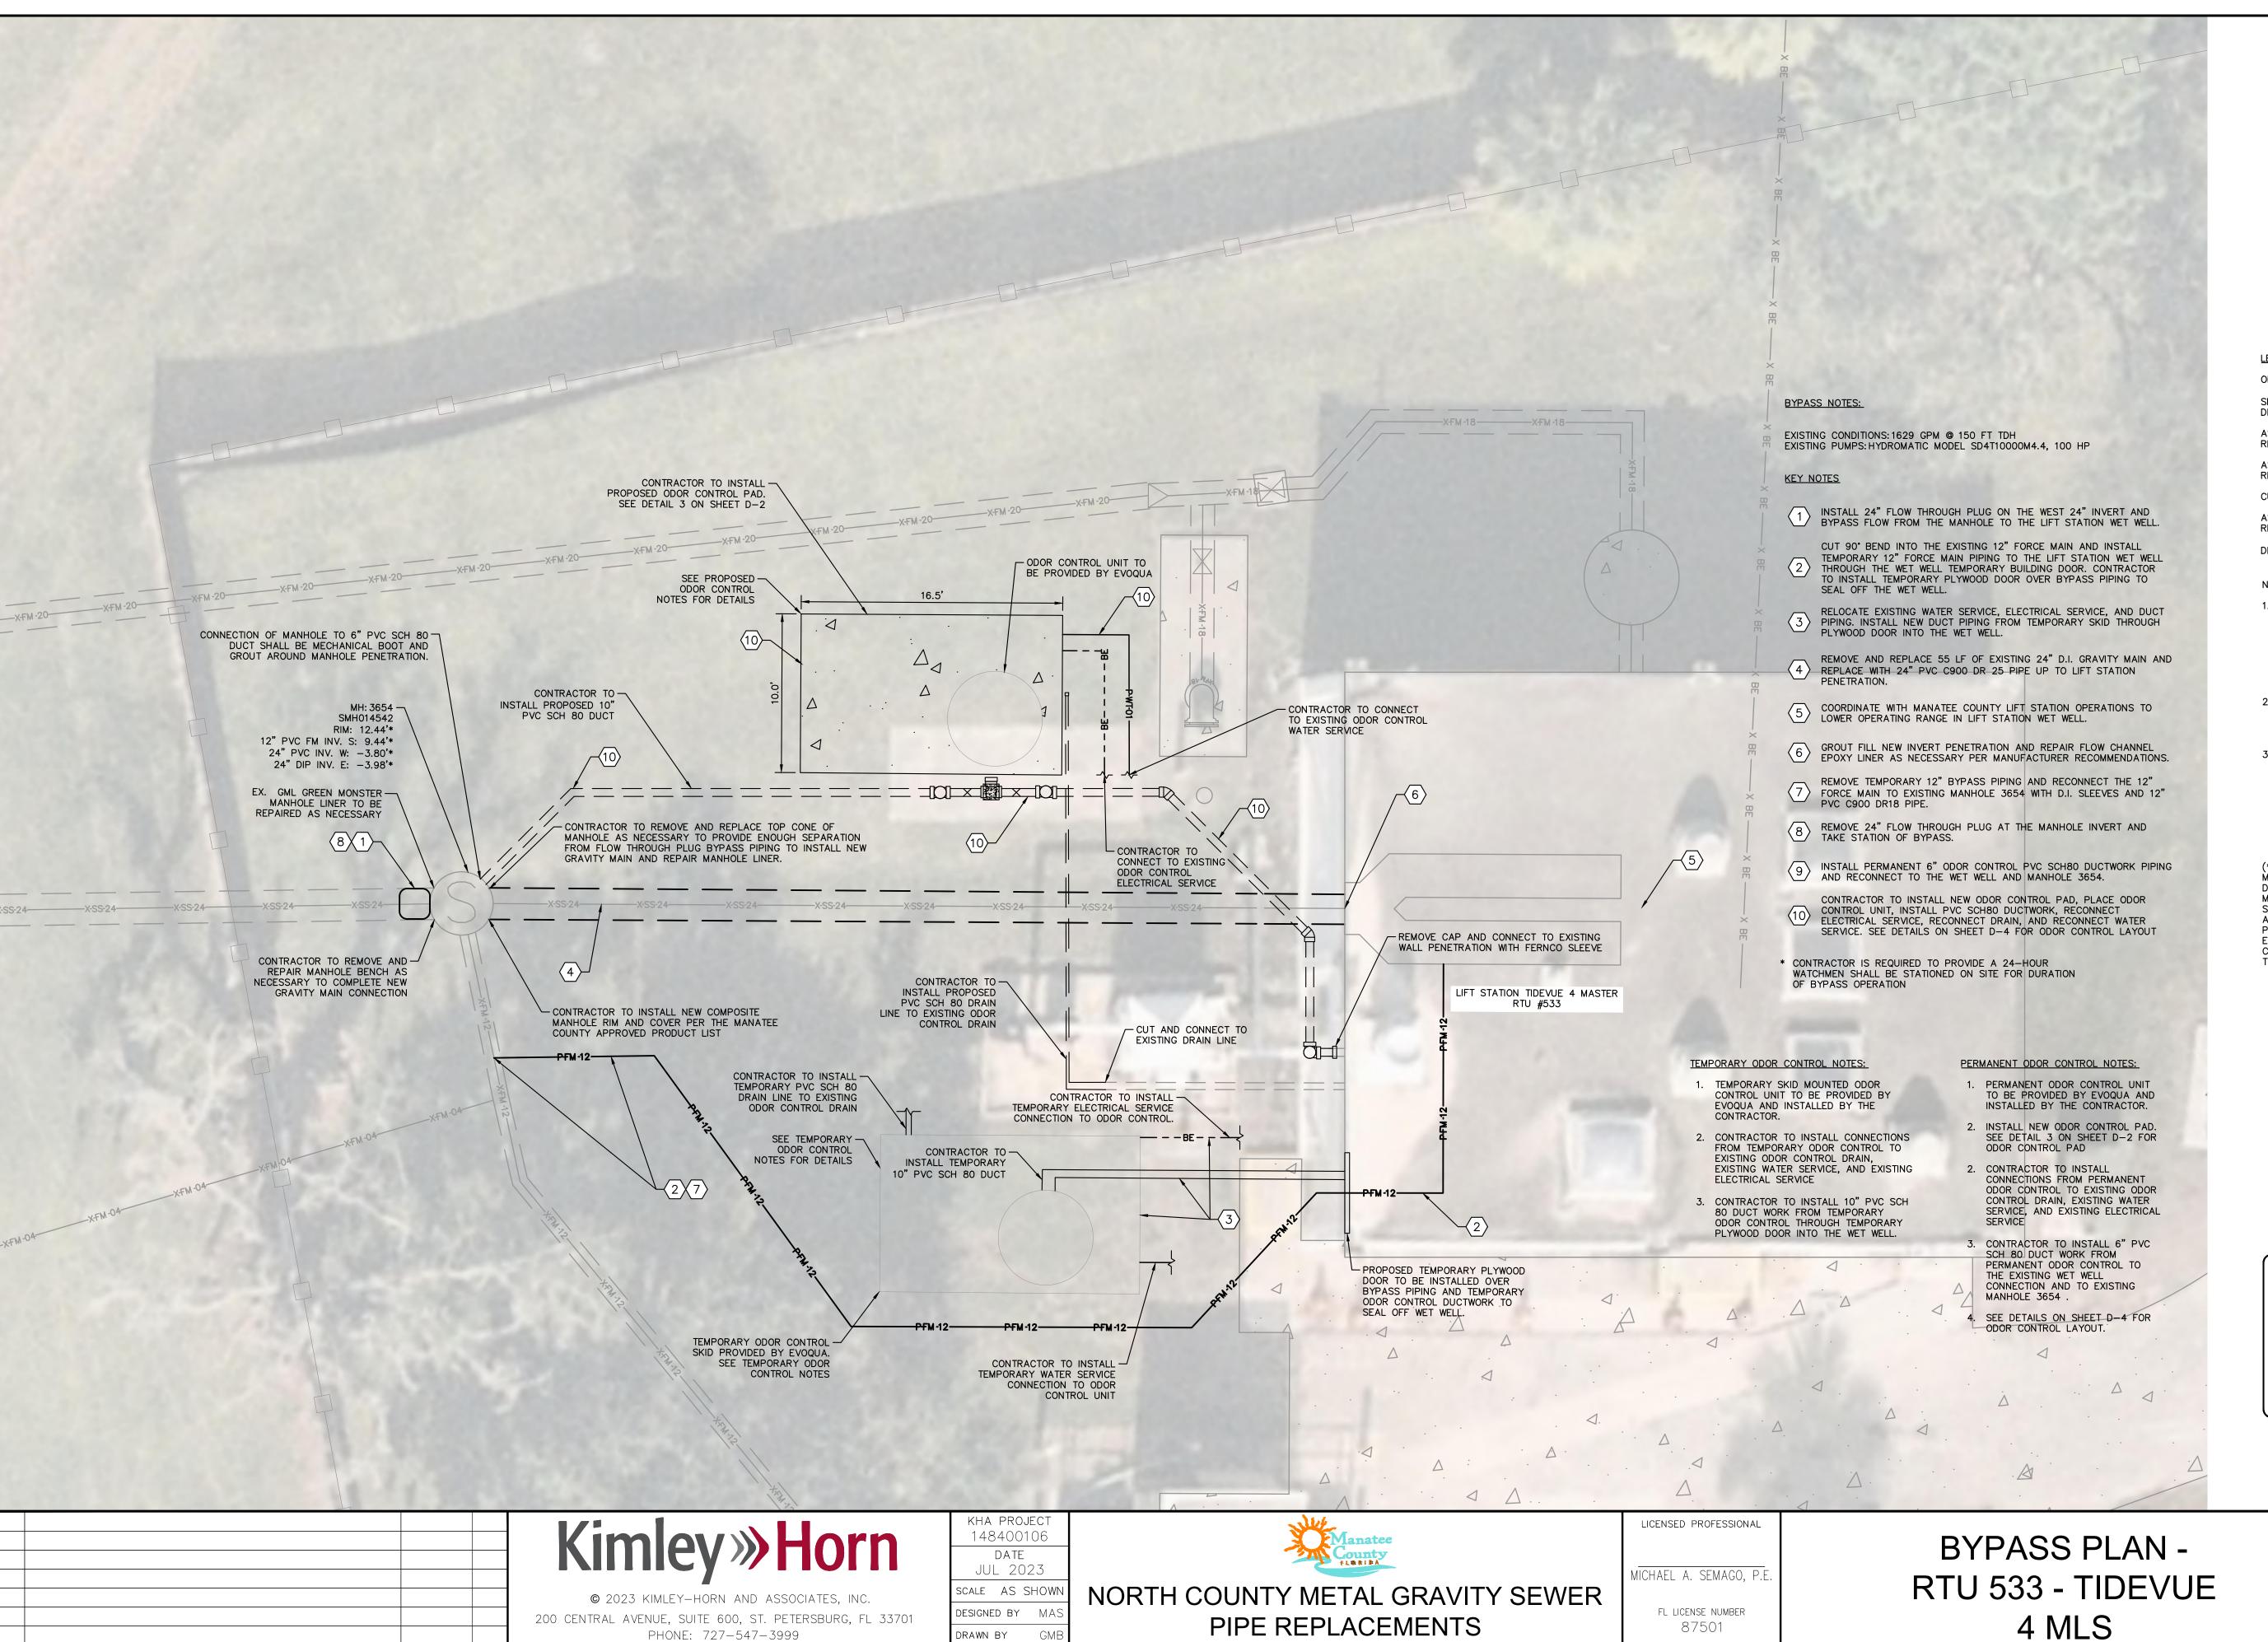












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DATE BY



GRAPHIC SCALE IN FEET
0 2.5 5 1

<u>LEGEND</u>

OPEN CUT

SIDEWALK/CONCRETE DRIVEWAY RESTORATION

ASPHALT DRIVEWAY RESTORATION

ASPHALT FULL ROAD RESTORATION

CURB RESTORATION
ASPHALT MILLINGS

RESTORATION

DEMOLISH/REMOVE

,

ES:

:

- I. CONSTRUCTION DEWATERING SHALL BE CONDUCTED IN ACCORDANCE WITH ALL FEDERAL, STATE, AND LOCAL REQUIREMENTS INCLUDING BUT NOT LIMITED TO CHAPTERS 62-621.300 AND 62-620 OF THE FLORIDA ADMINISTRATIVE CODE
- 2. EXISTING GAS LINE AND BURIED ELECTRIC TO BE FIELD LOCATED WHERE NECESSARY PRIOR TO CONSTRUCTION.
- 3. WHERE CONCRETE REPAIRS ARE NECESSARY AND EXPANSION JOINTS ARE PRESENT, CONTRACTOR TO REMOVE AND REPLACE CONCRETE UP TO THE NEXT EXPANSION JOINT; OTHERWISE, REPLACE CONCRETE AS NECESSARY.

(*) ELEVATIONS ARE BASED ON MANATEE COUNTY RECORD DRAWINGS OBTAINED FROM MANATEE COUNTY GIS. A SURVEY OF THE EXISTING SITE AND INFRASTRUCTURE WAS NOT PERFORMED TO CONFIRM THE ELEVATIONS. CONTRACTOR TO CONFIRM DEPTH OF PIPE PRIOR TO BIDDING.

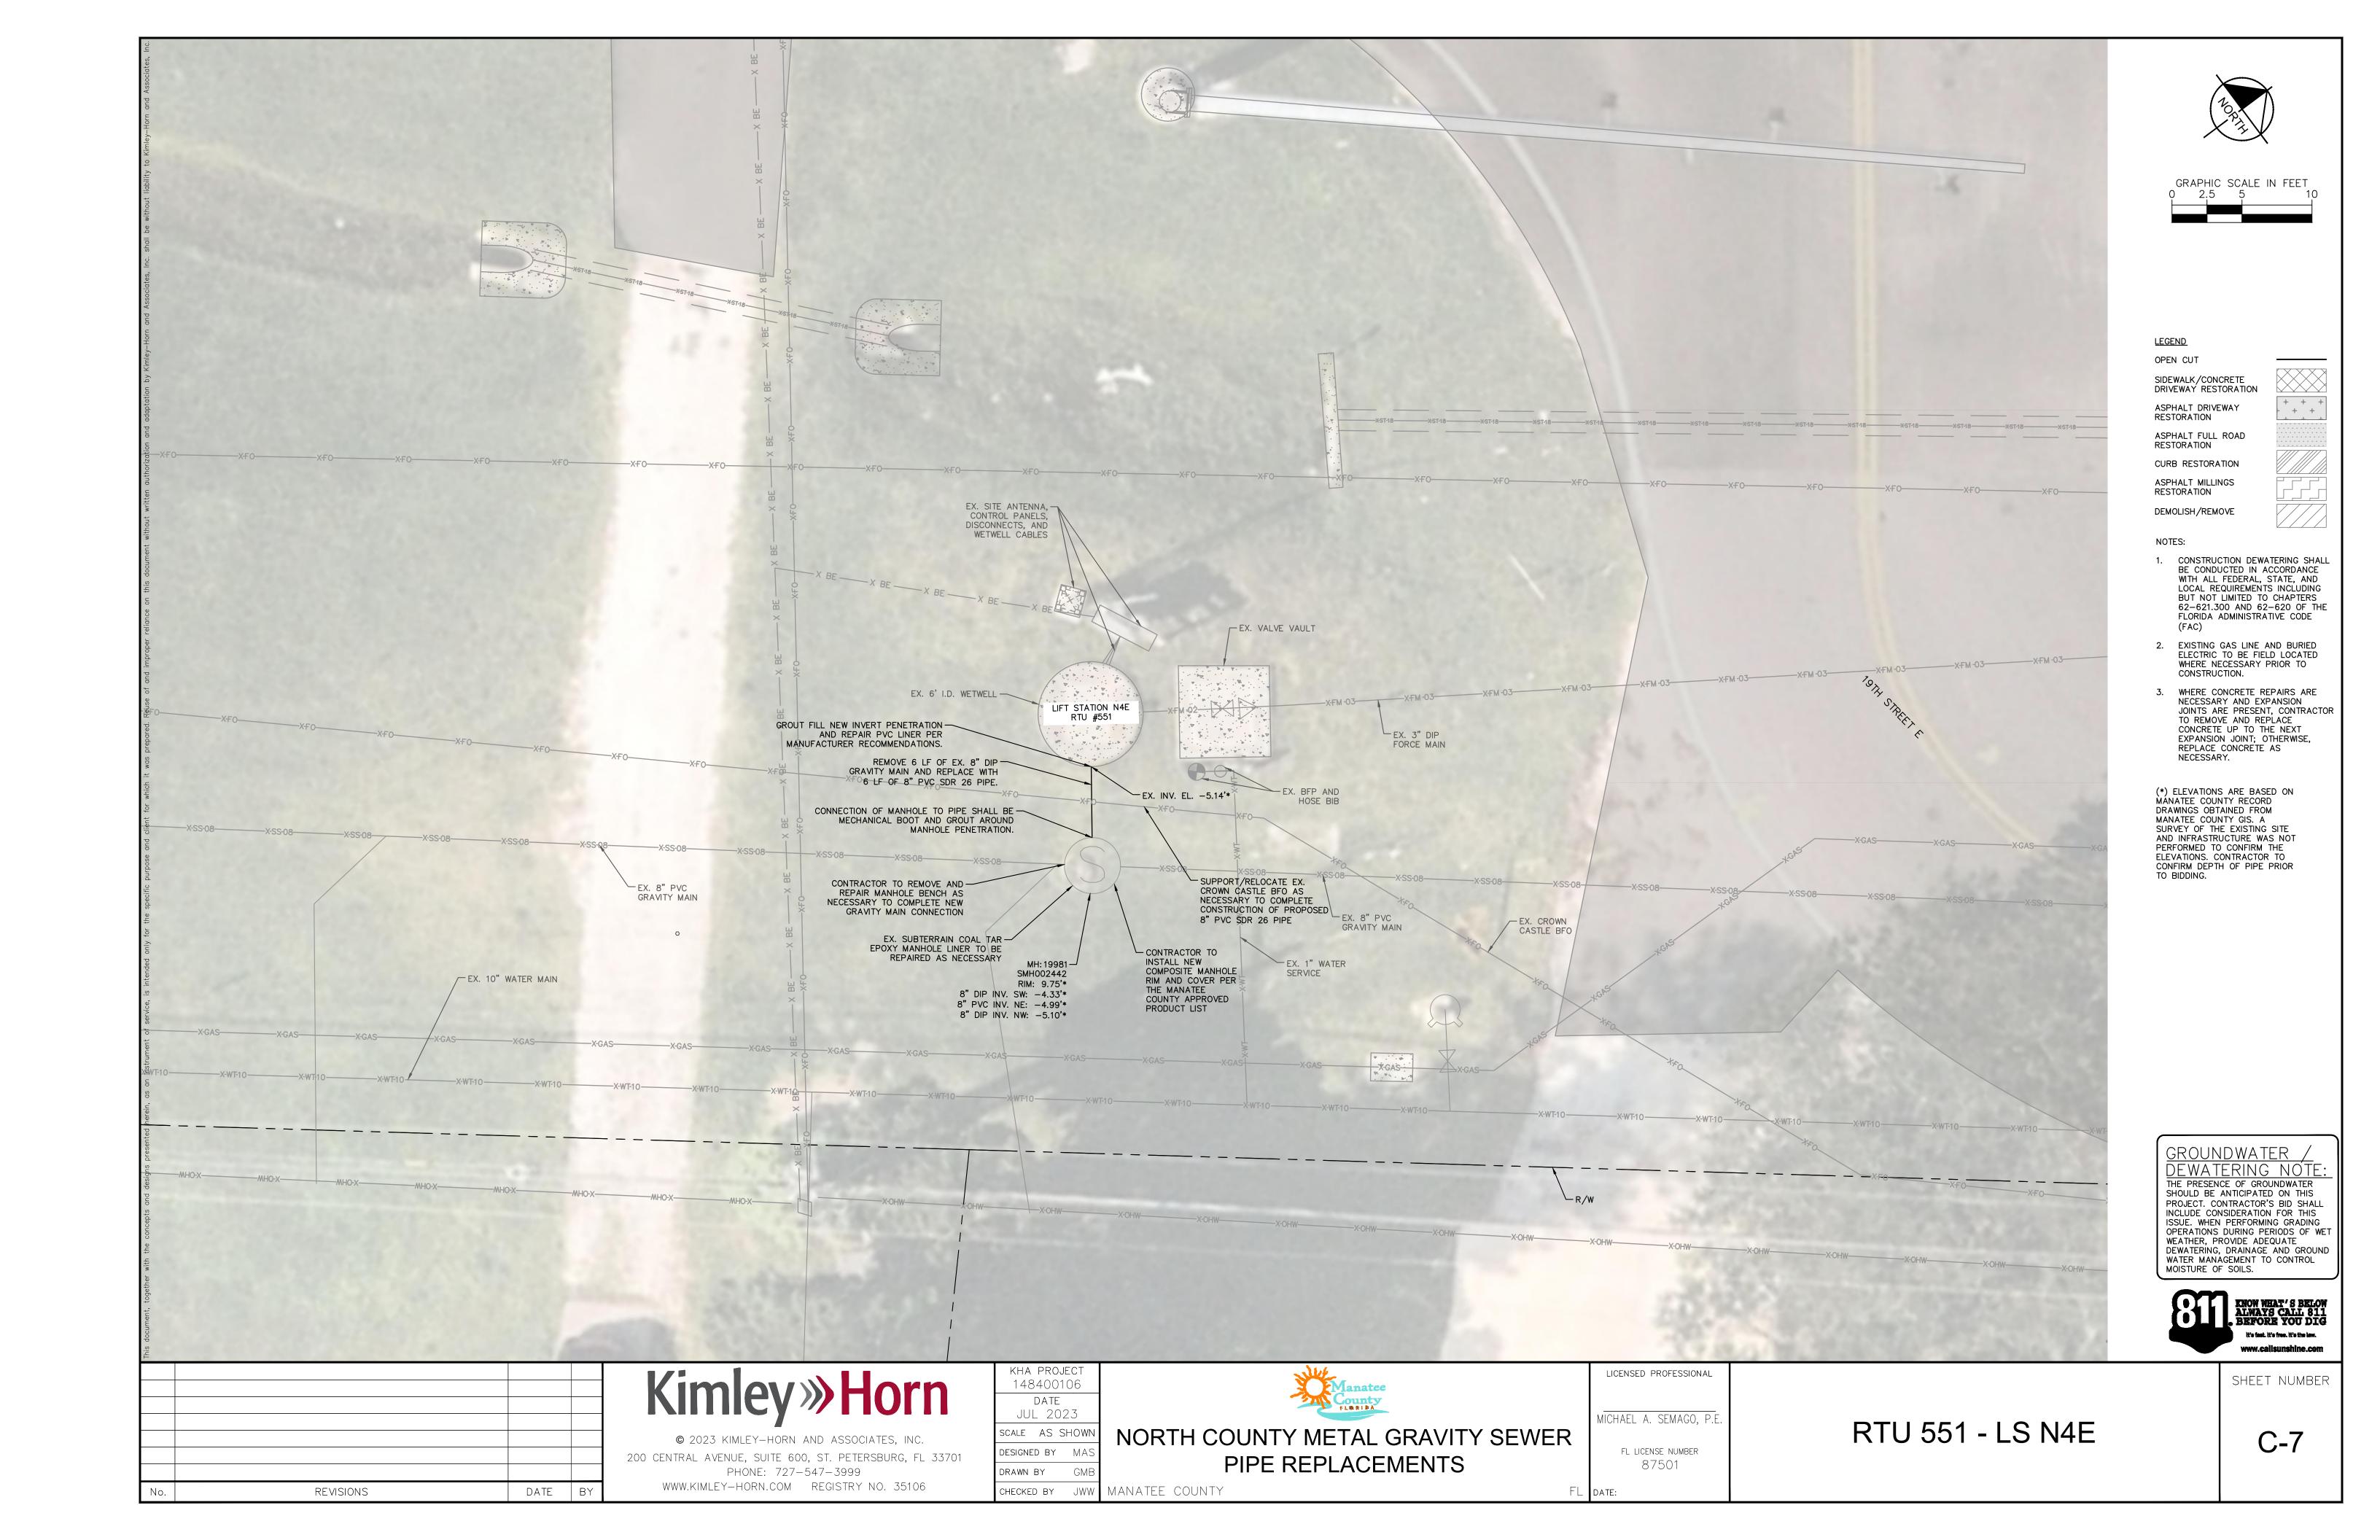
GROUNDWATER / DEWATERING NO

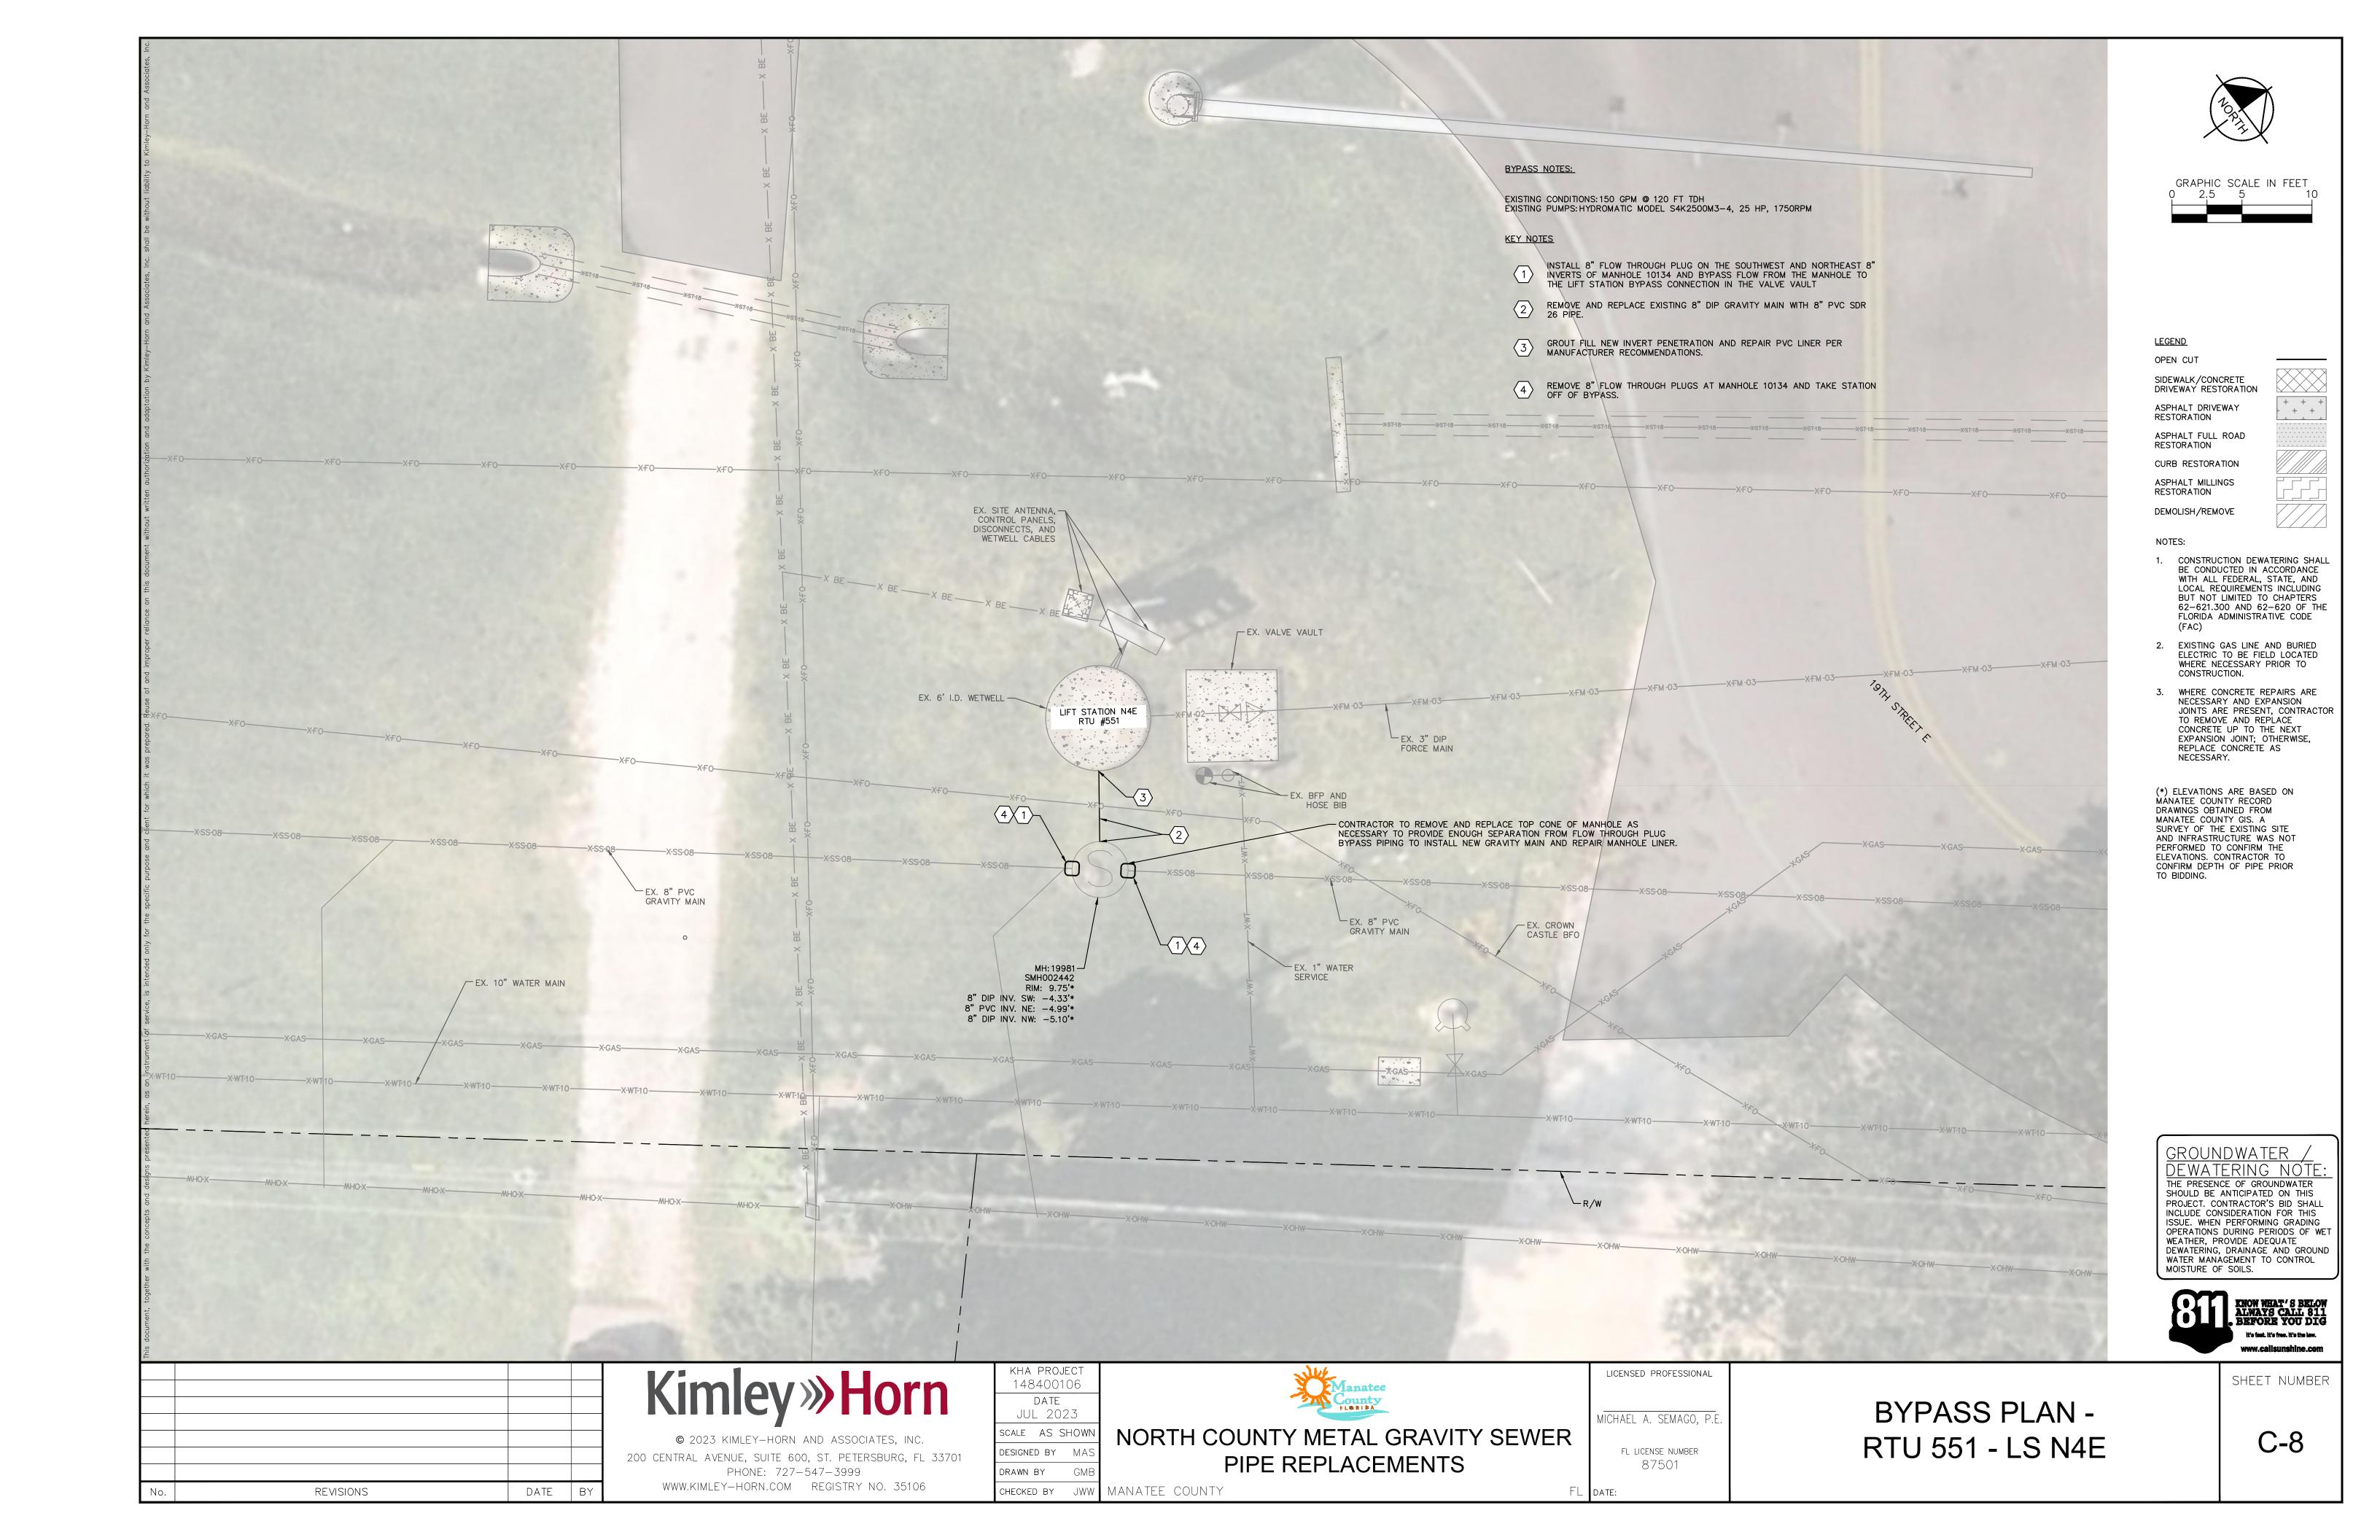
THE PRESENCE OF GROUNDWATER SHOULD BE ANTICIPATED ON THIS PROJECT. CONTRACTOR'S BID SHALL INCLUDE CONSIDERATION FOR THIS ISSUE. WHEN PERFORMING GRADING OPERATIONS DURING PERIODS OF WET WEATHER, PROVIDE ADEQUATE DEWATERING, DRAINAGE AND GROUND WATER MANAGEMENT TO CONTROL MOISTURE OF SOILS.

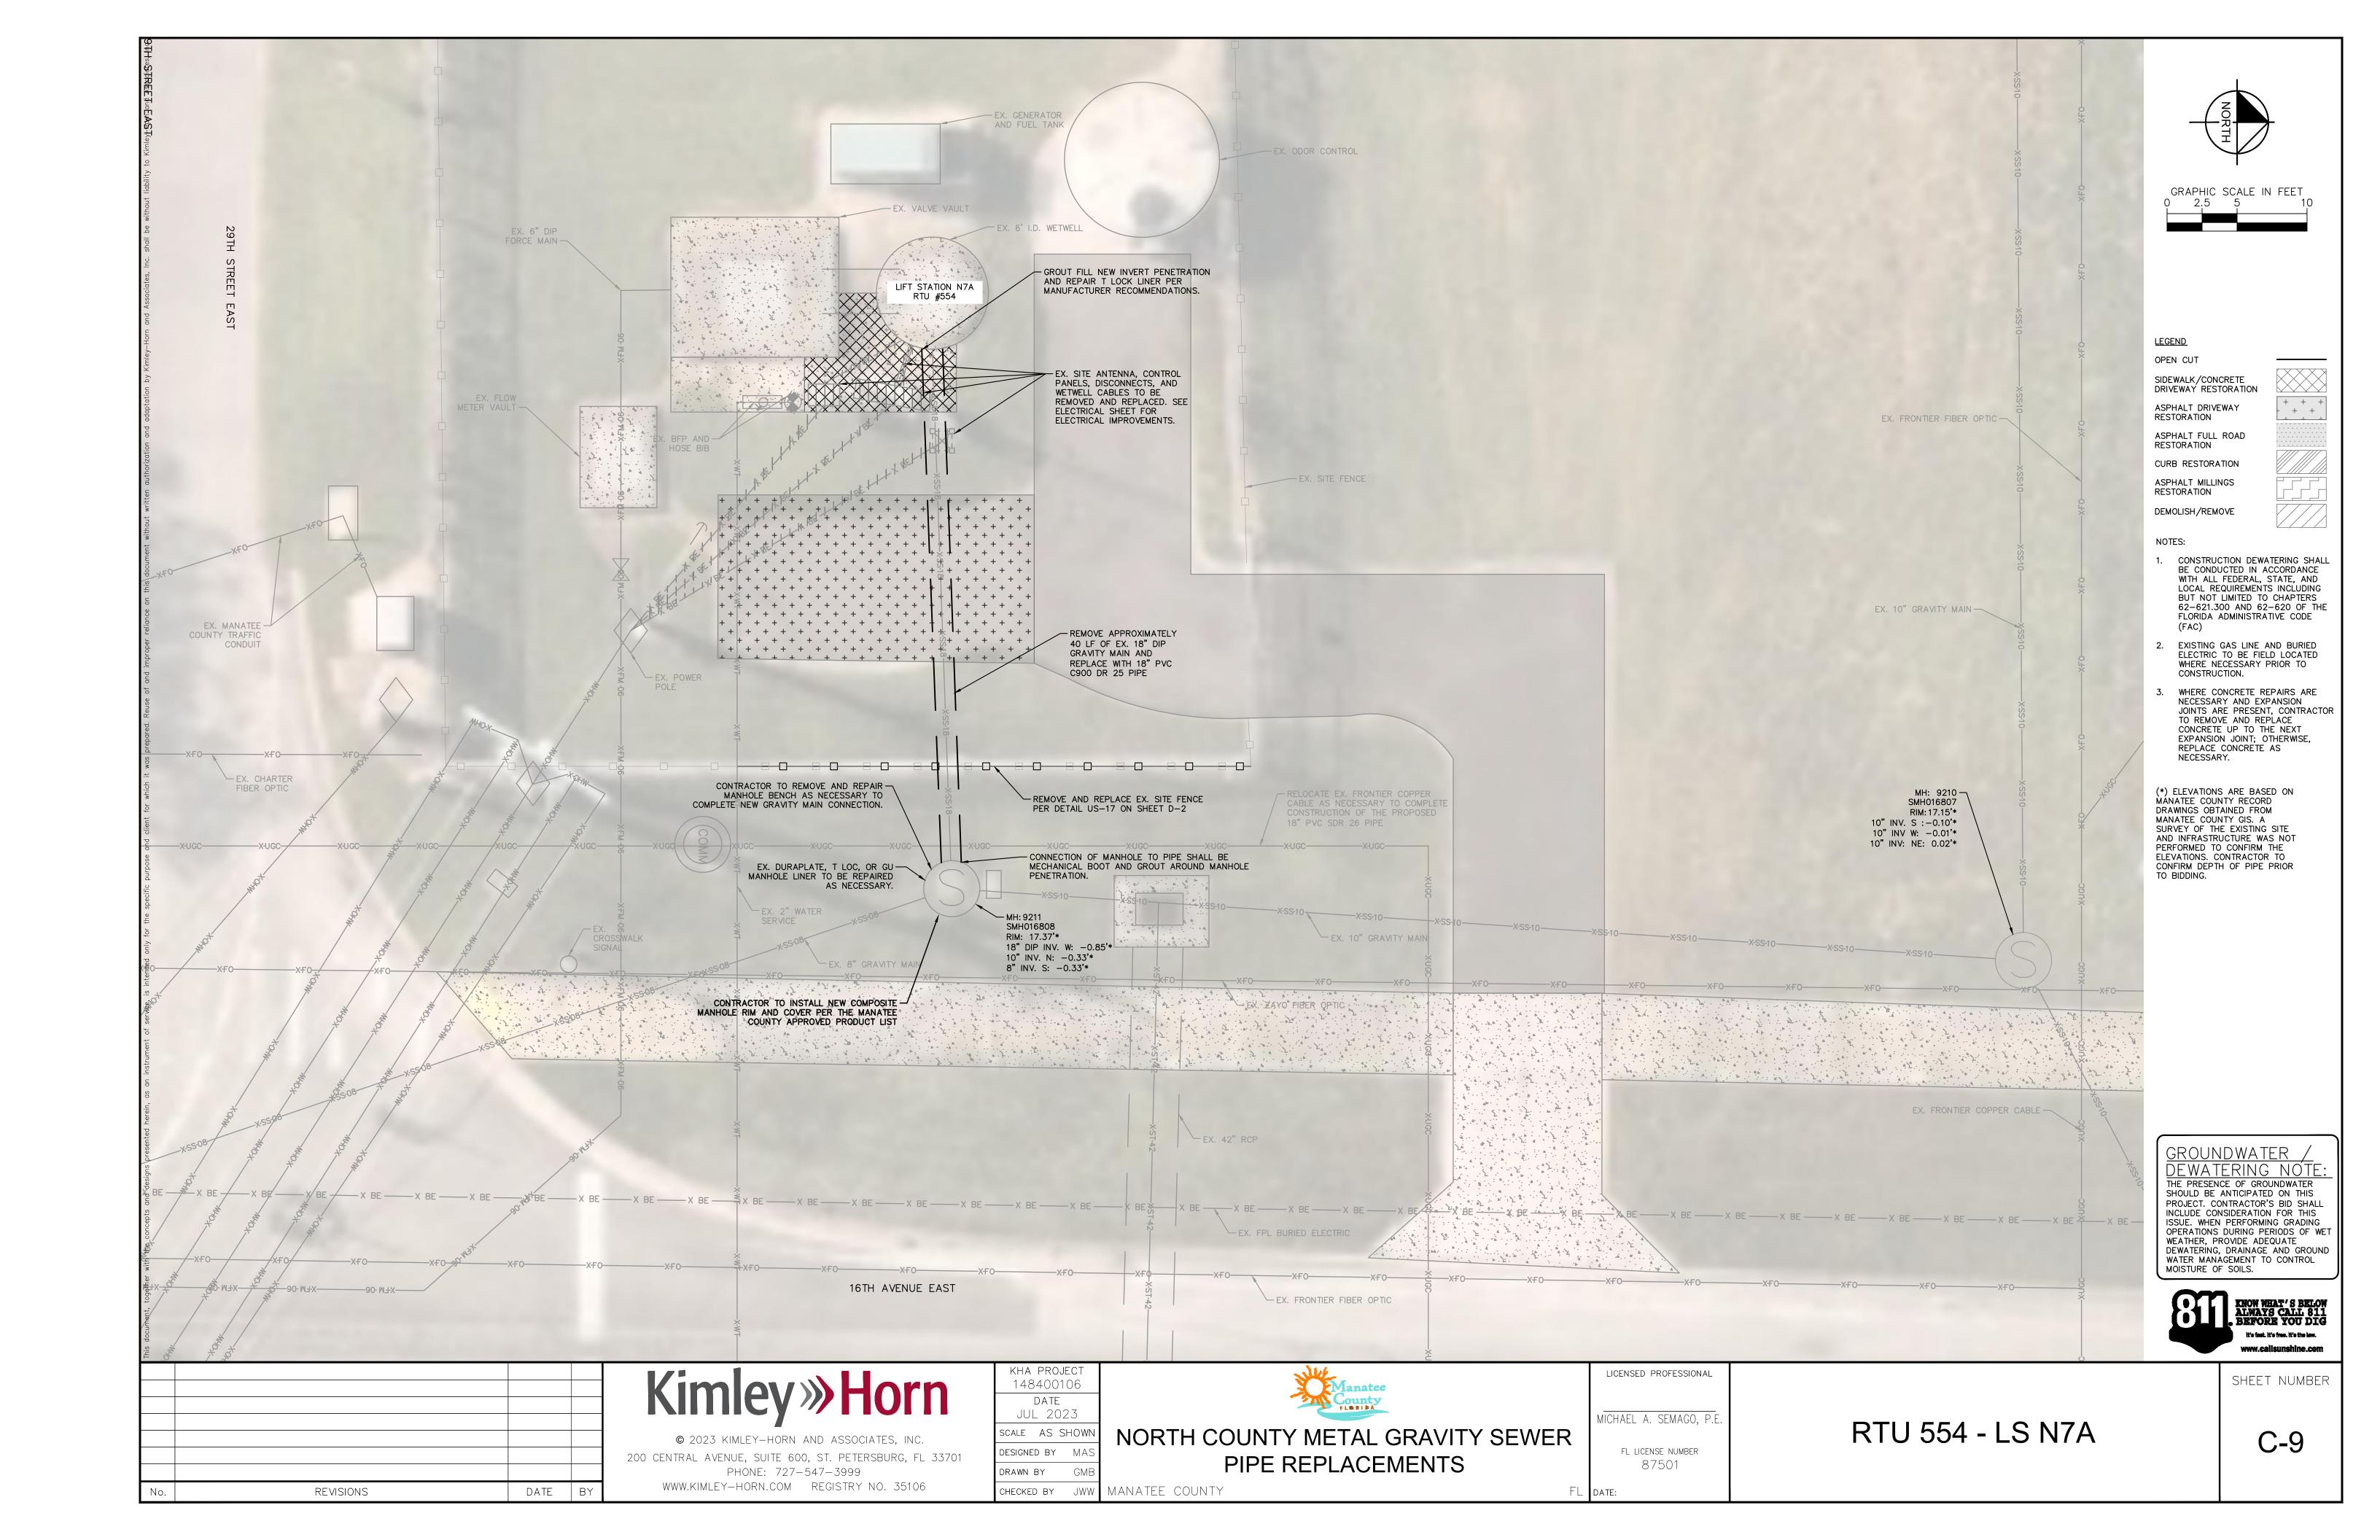


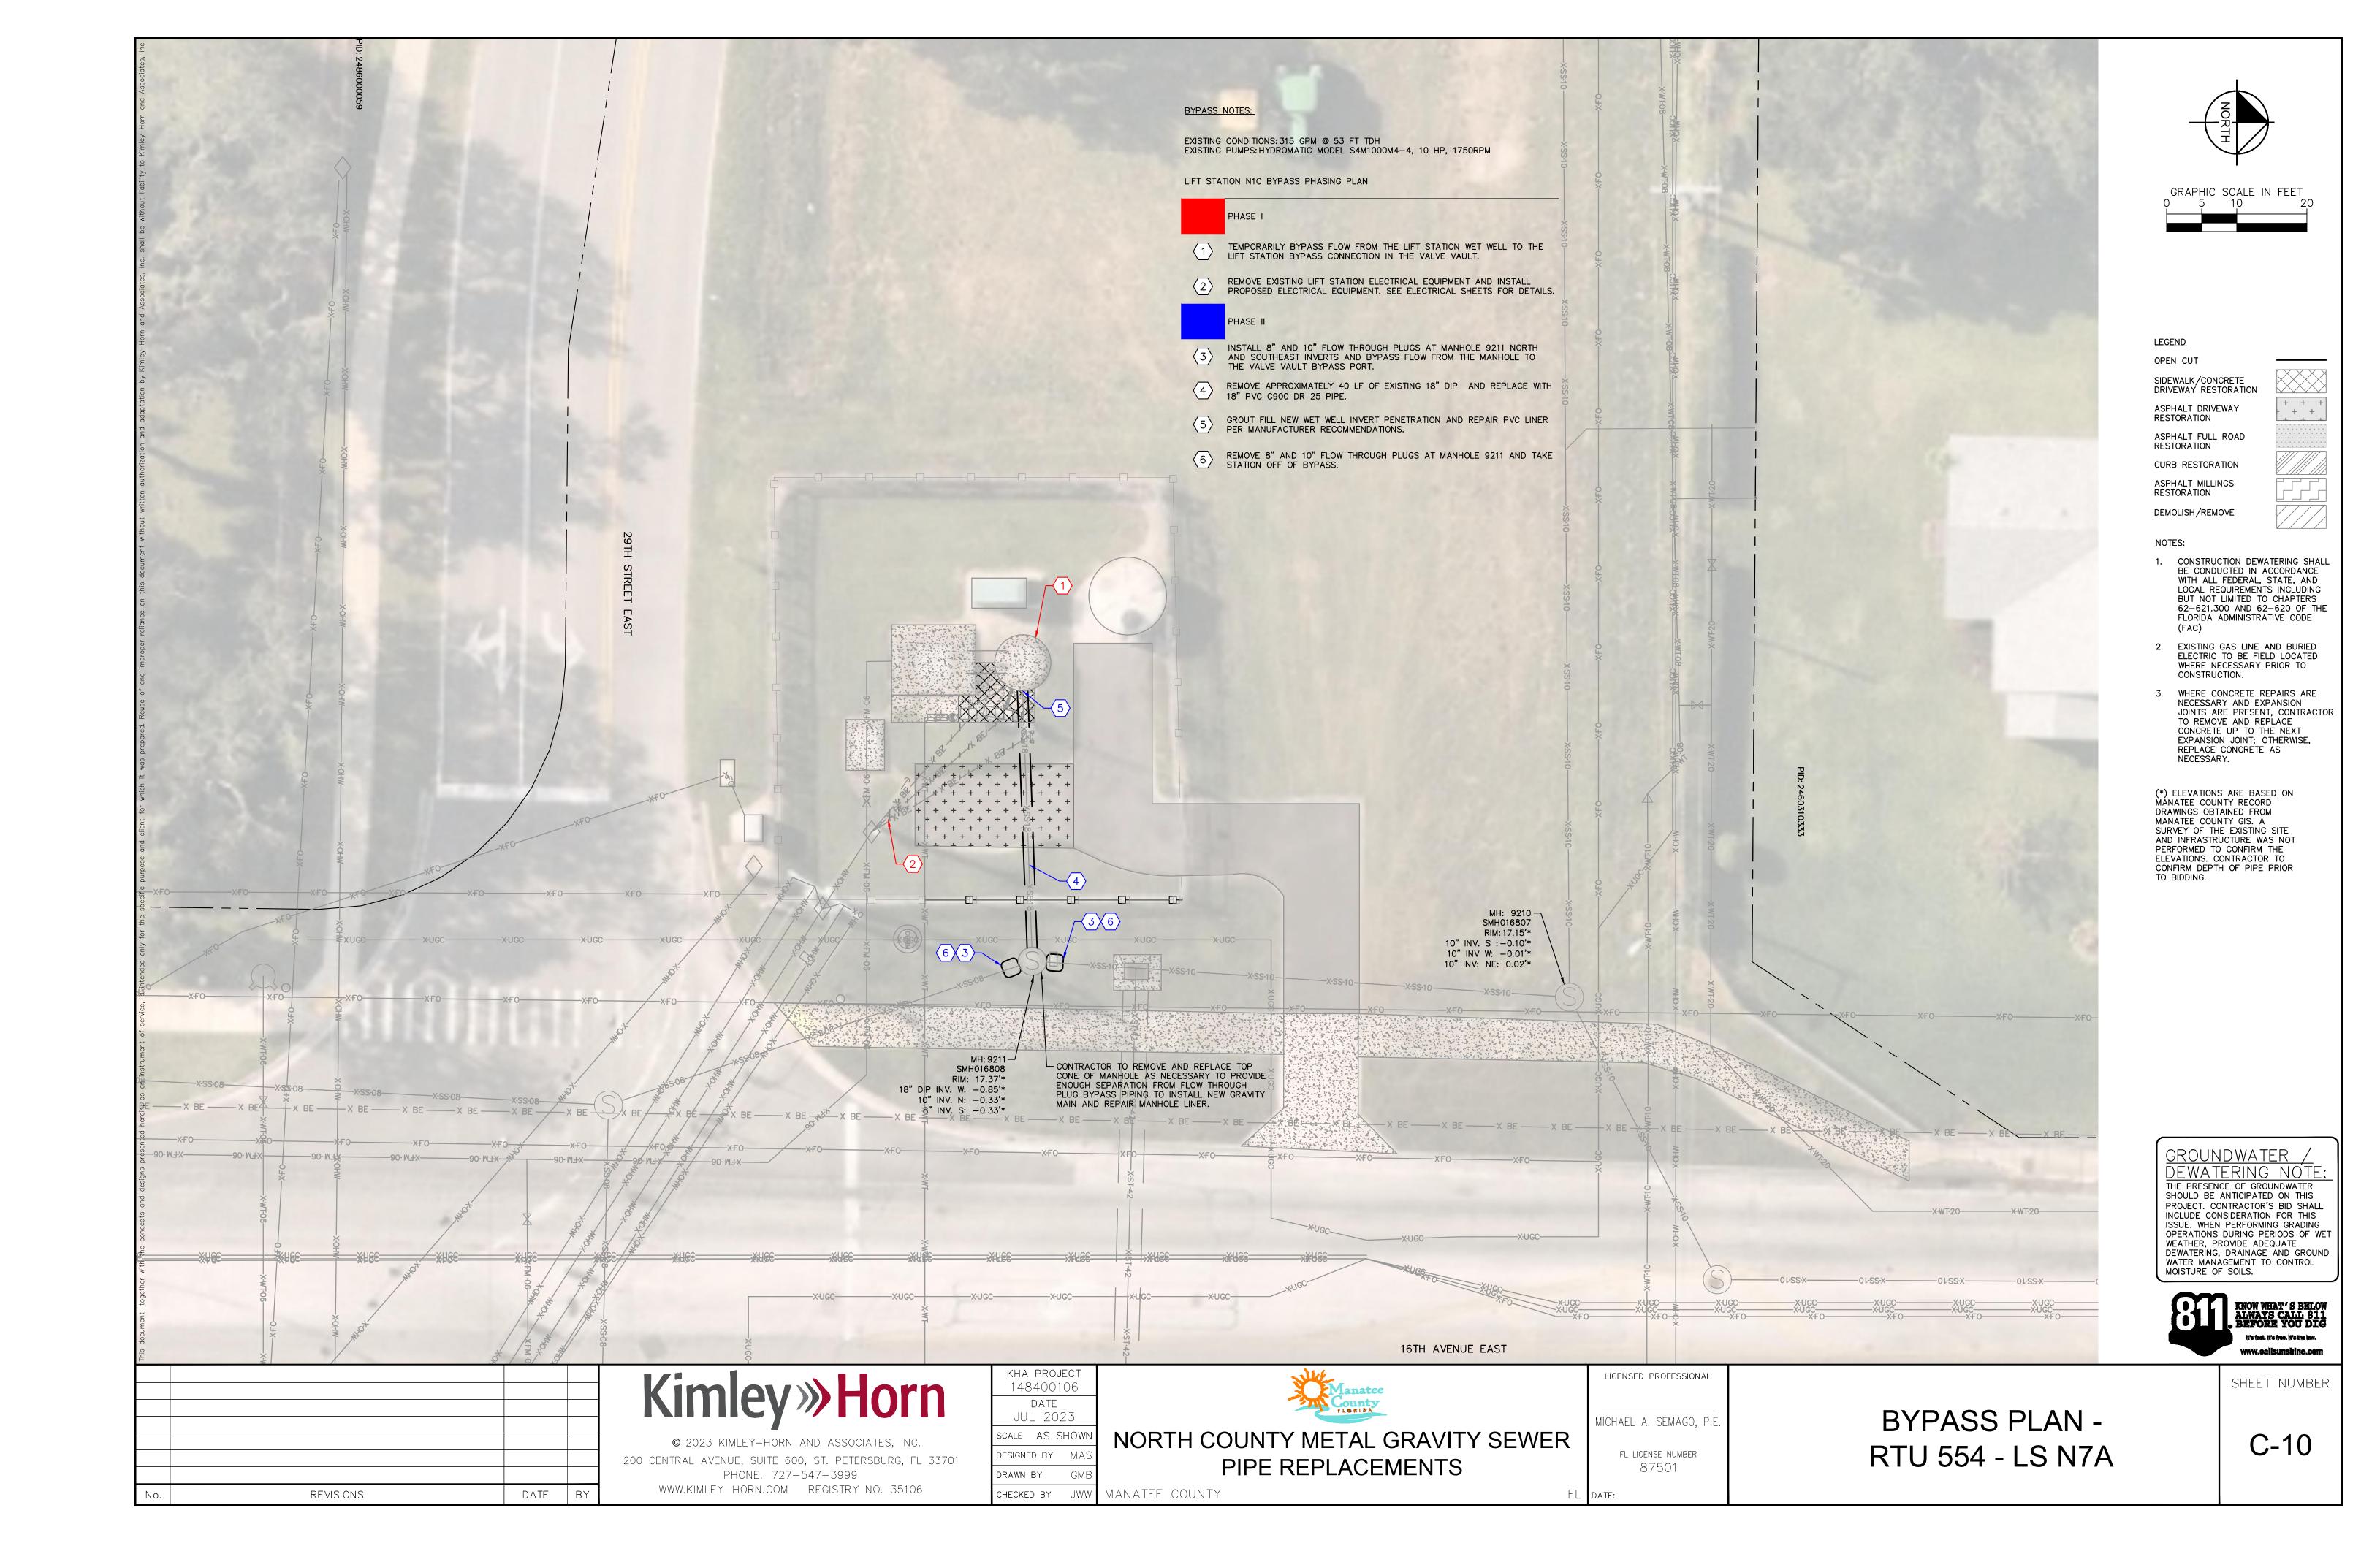
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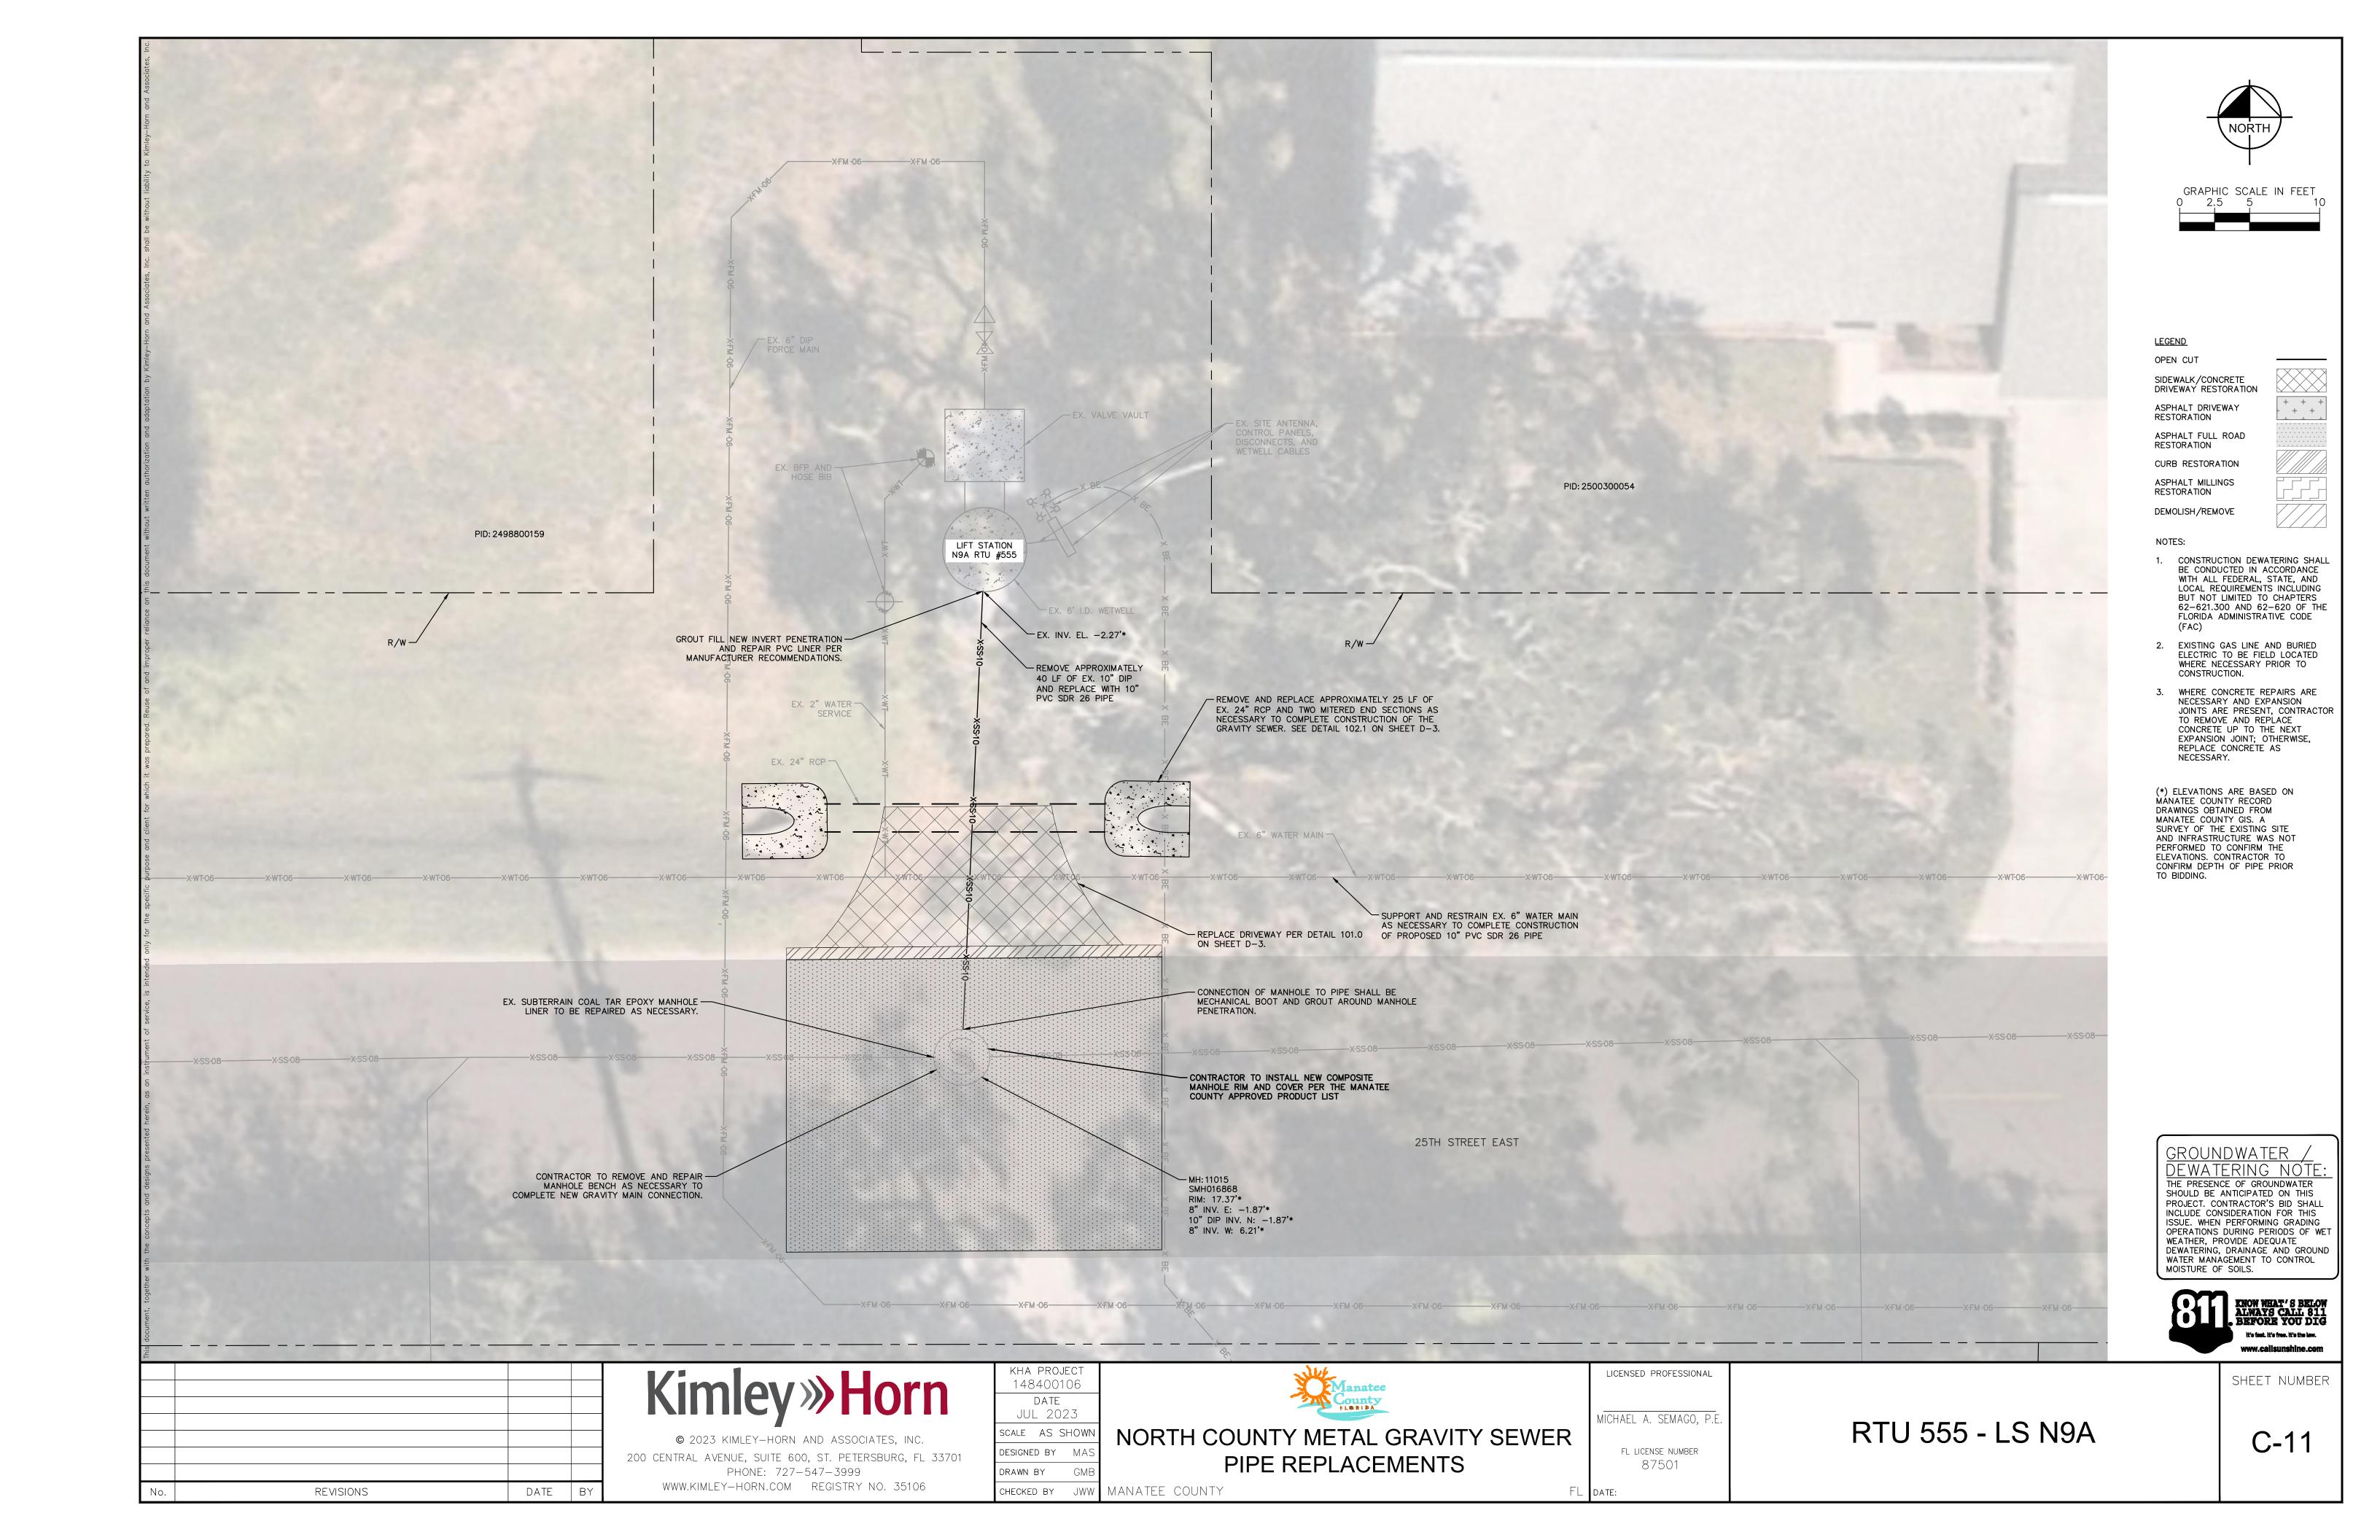
C-6

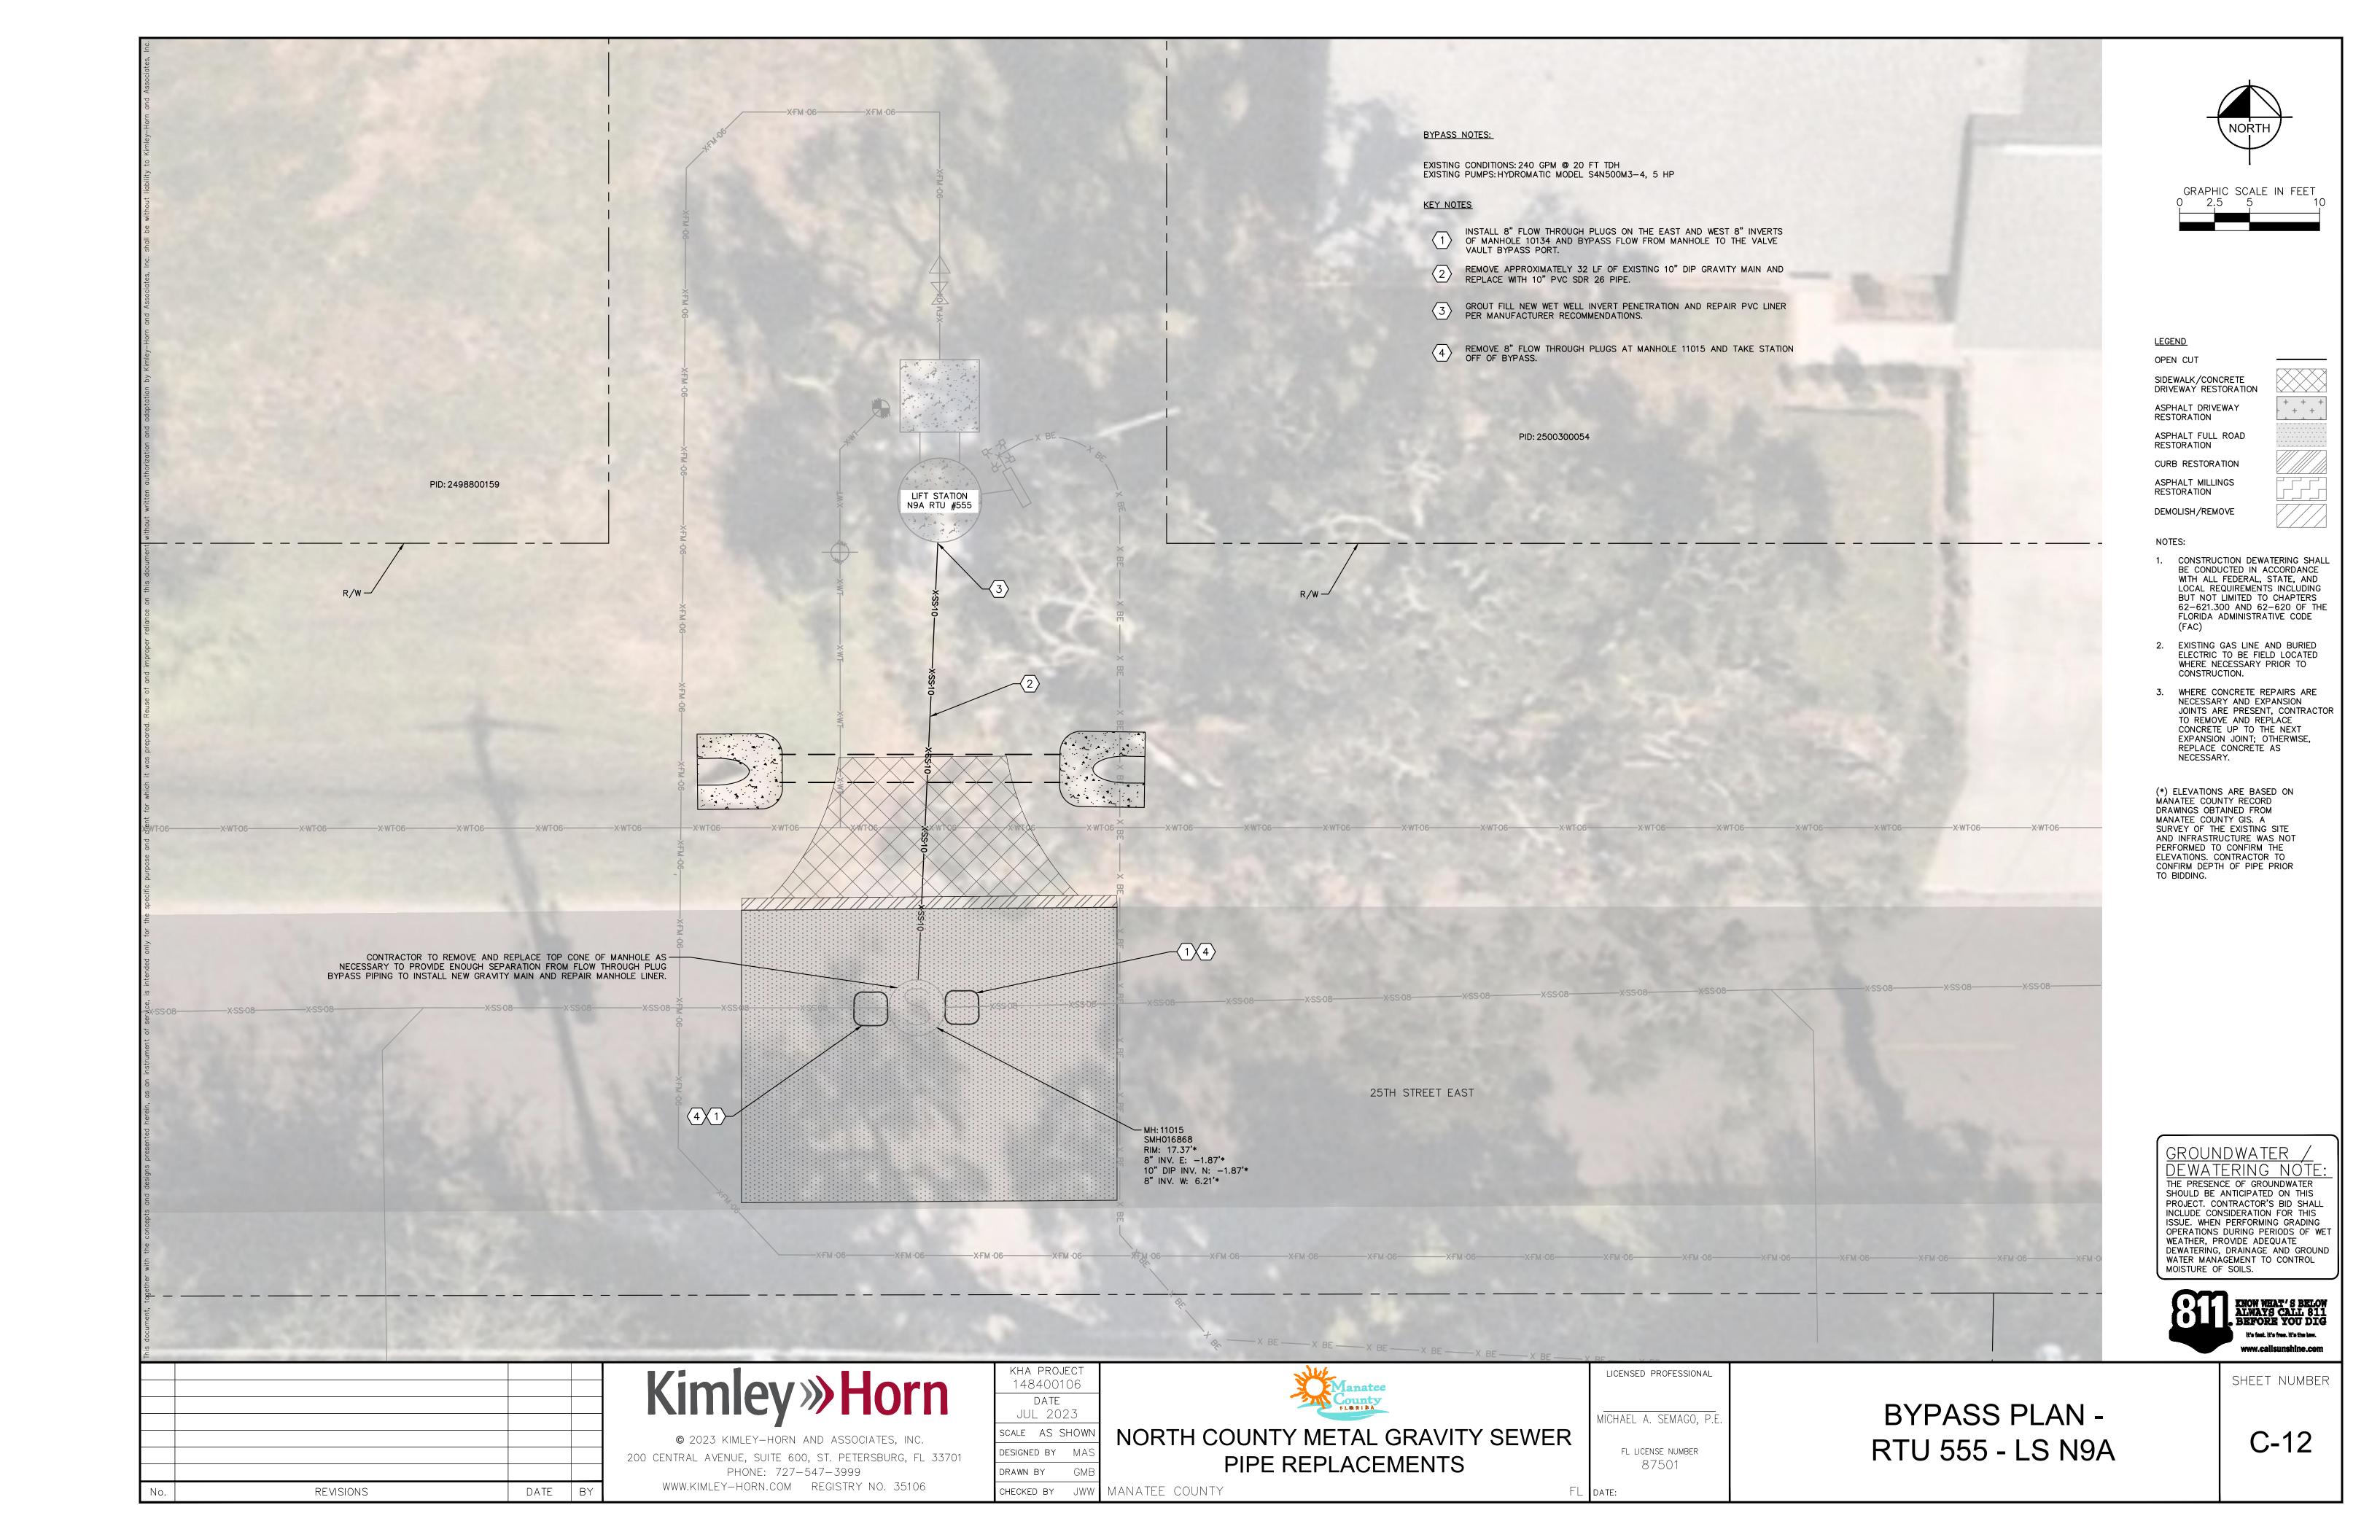


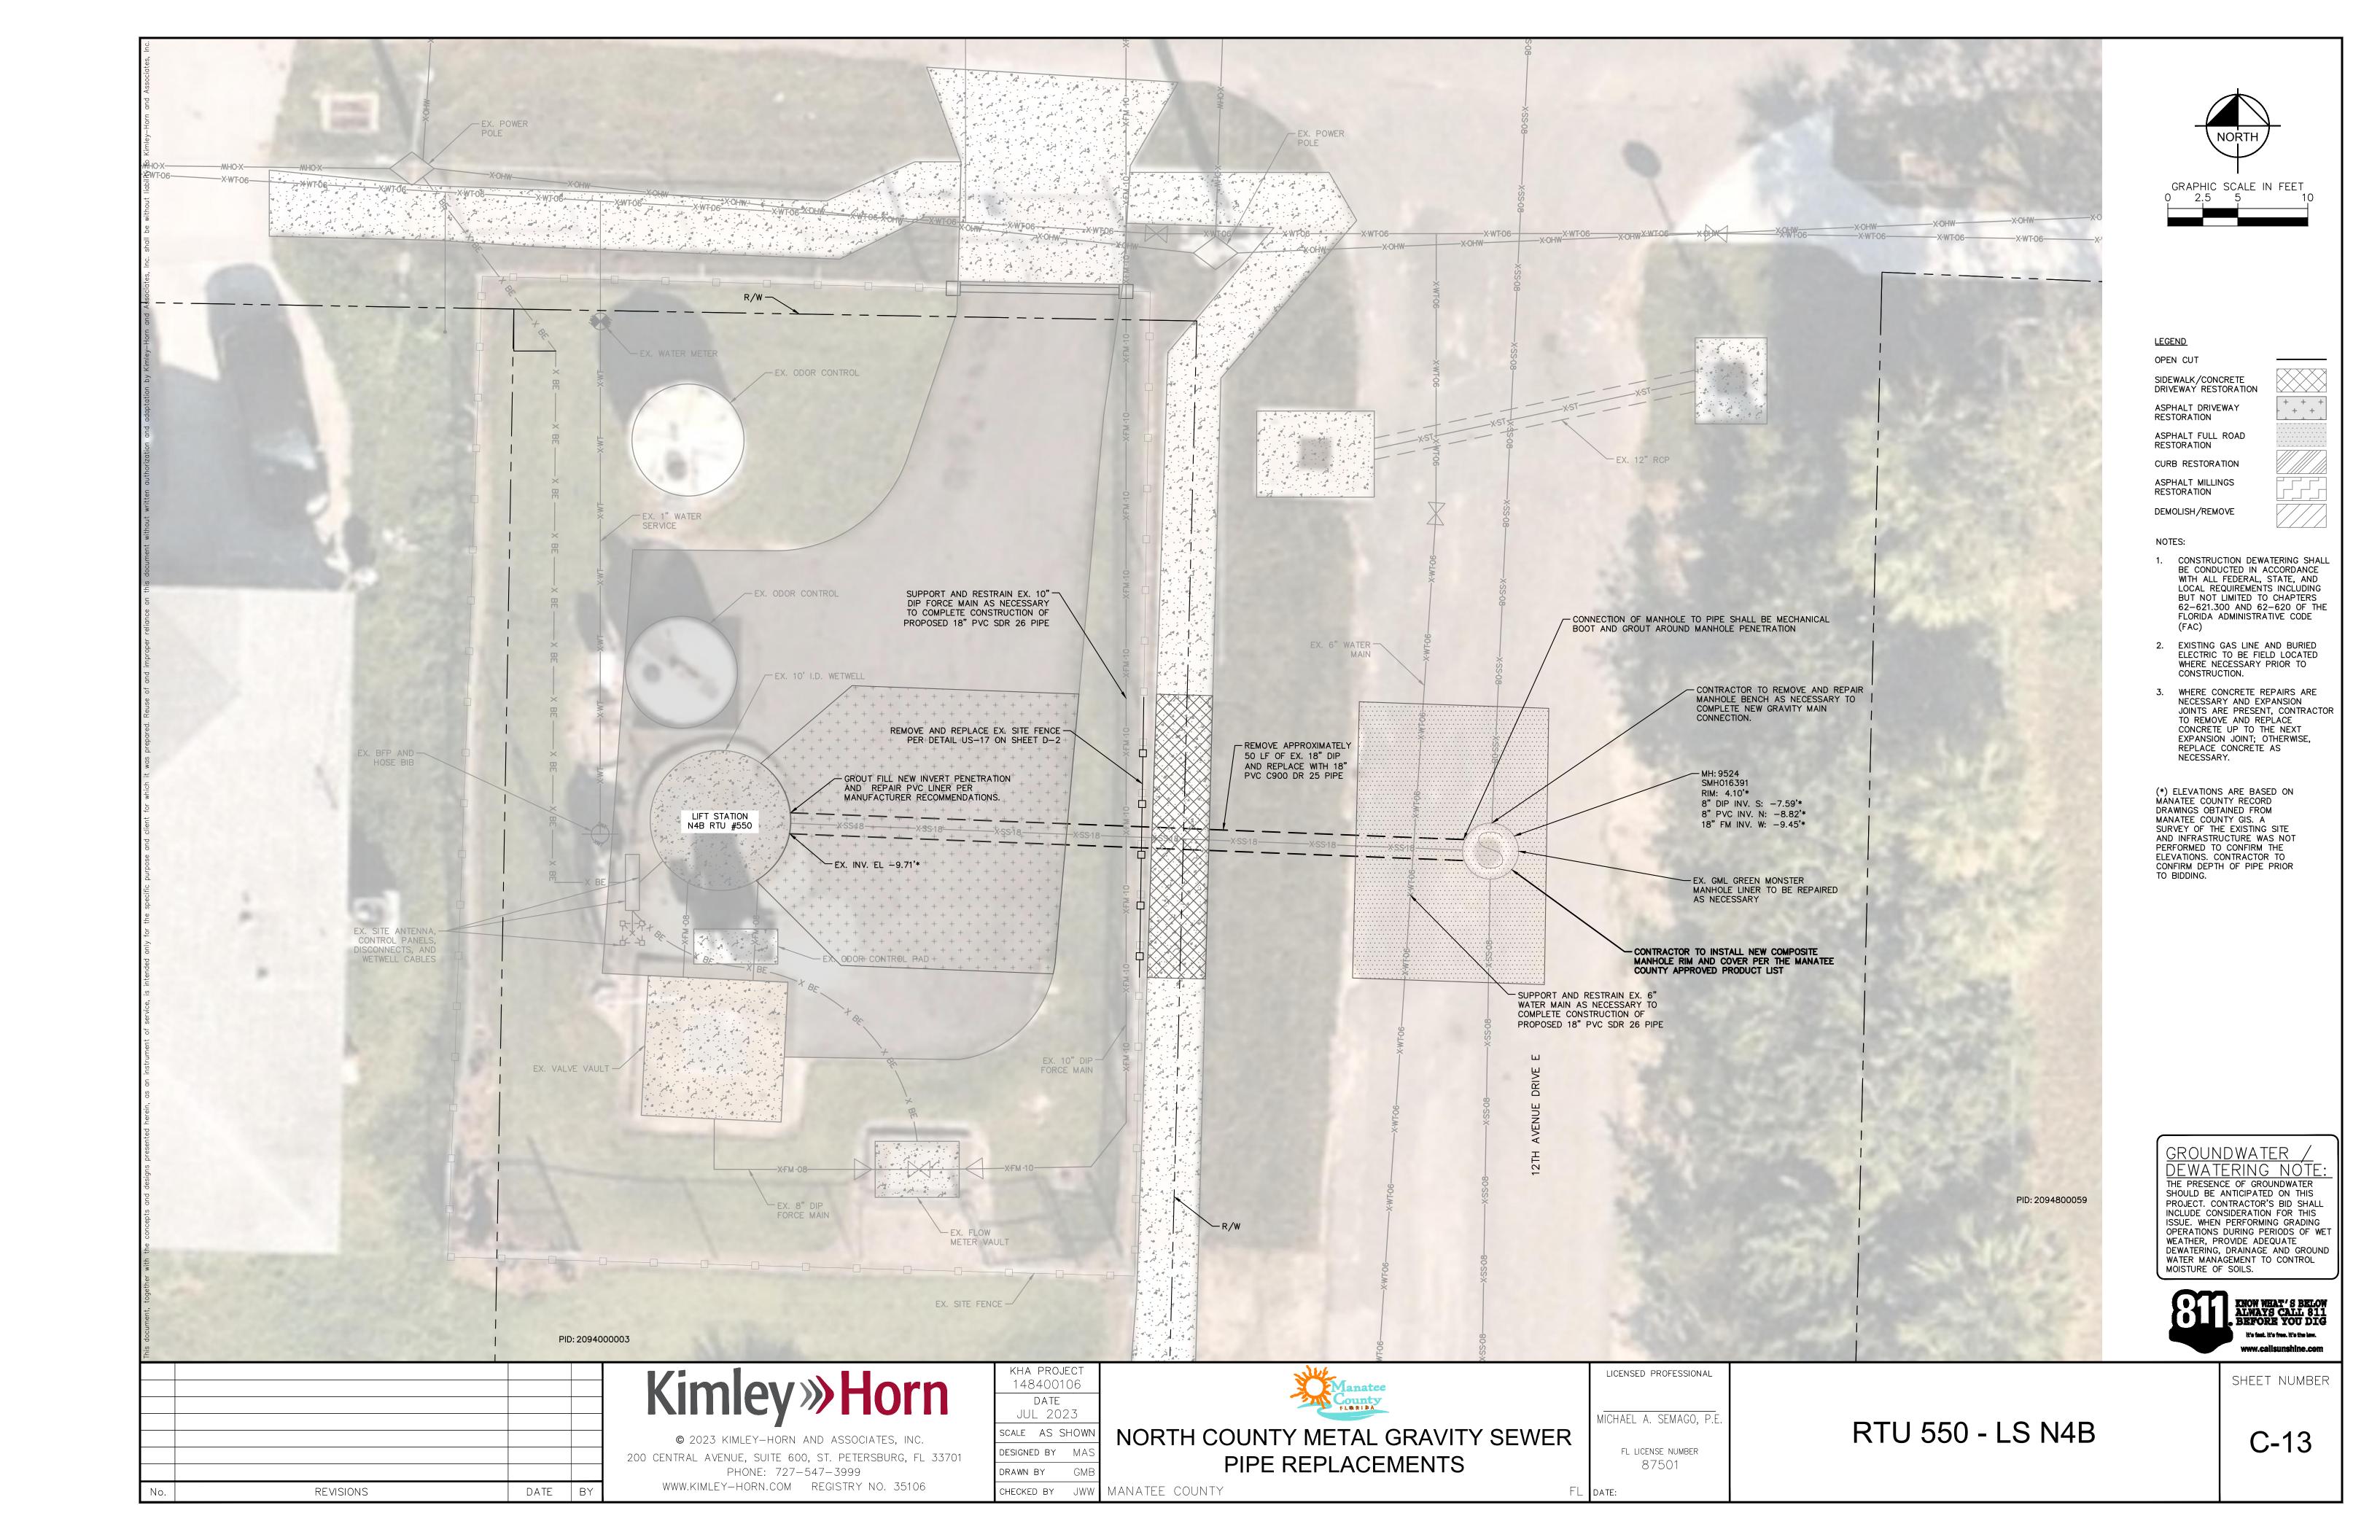


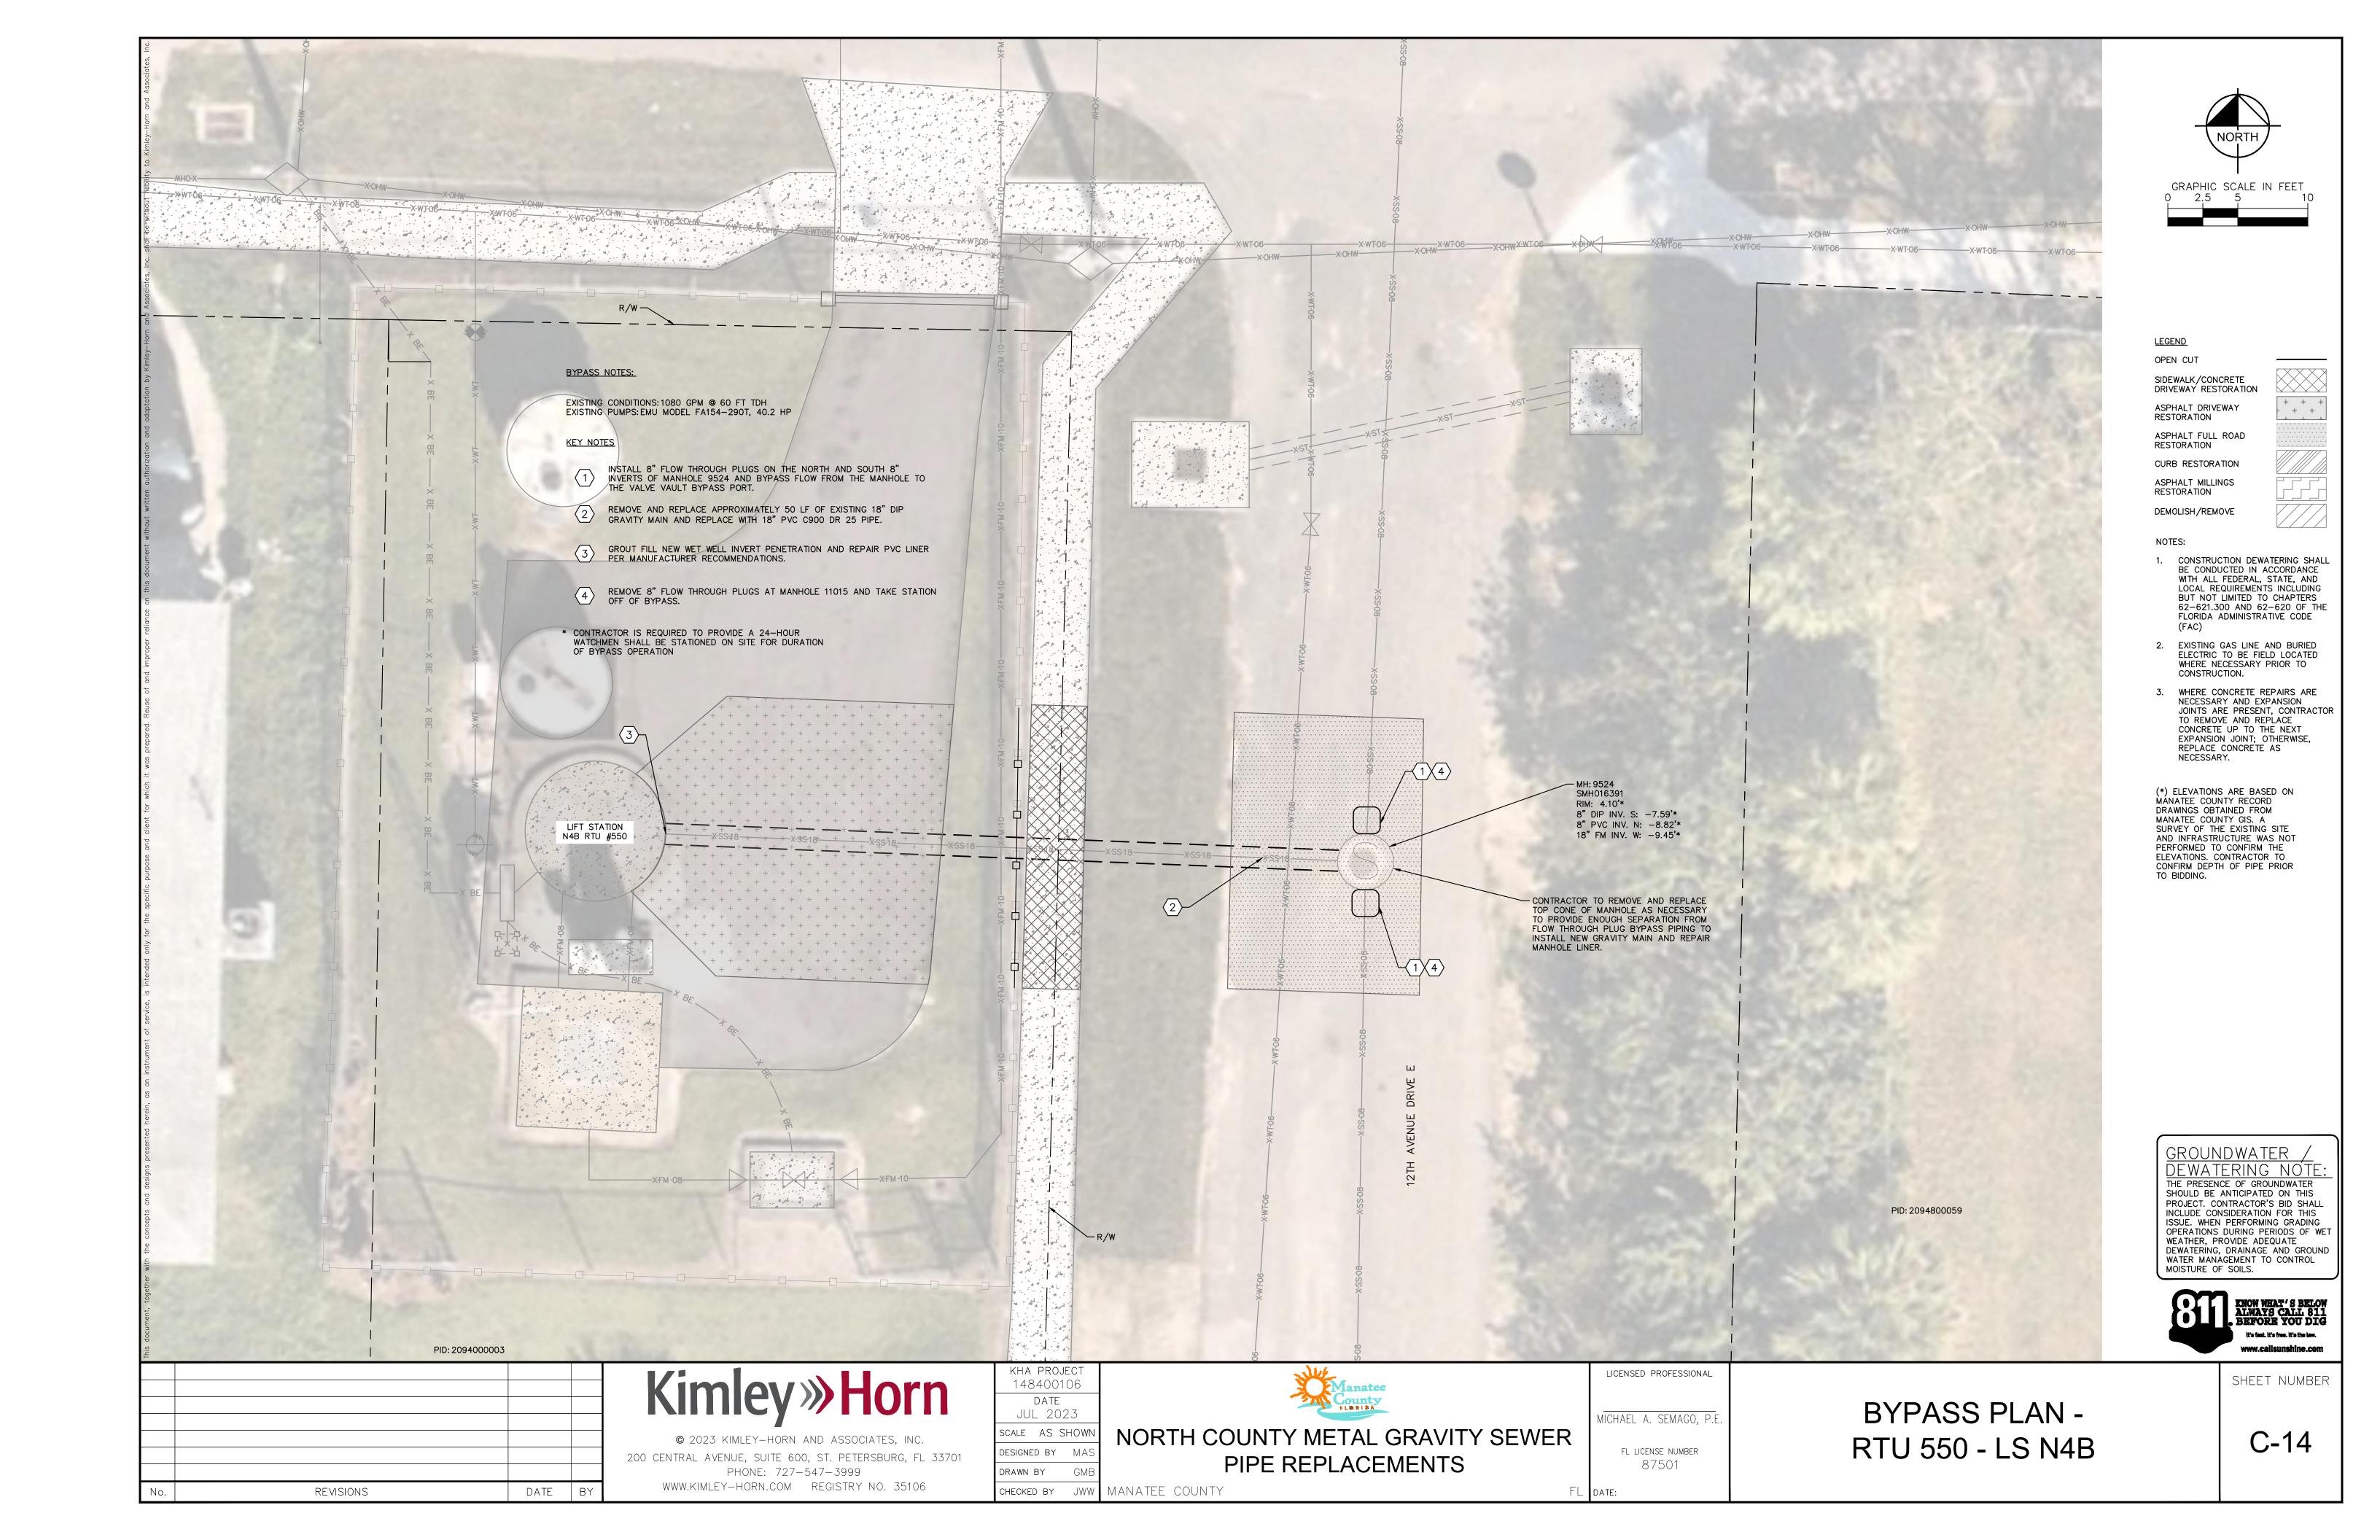


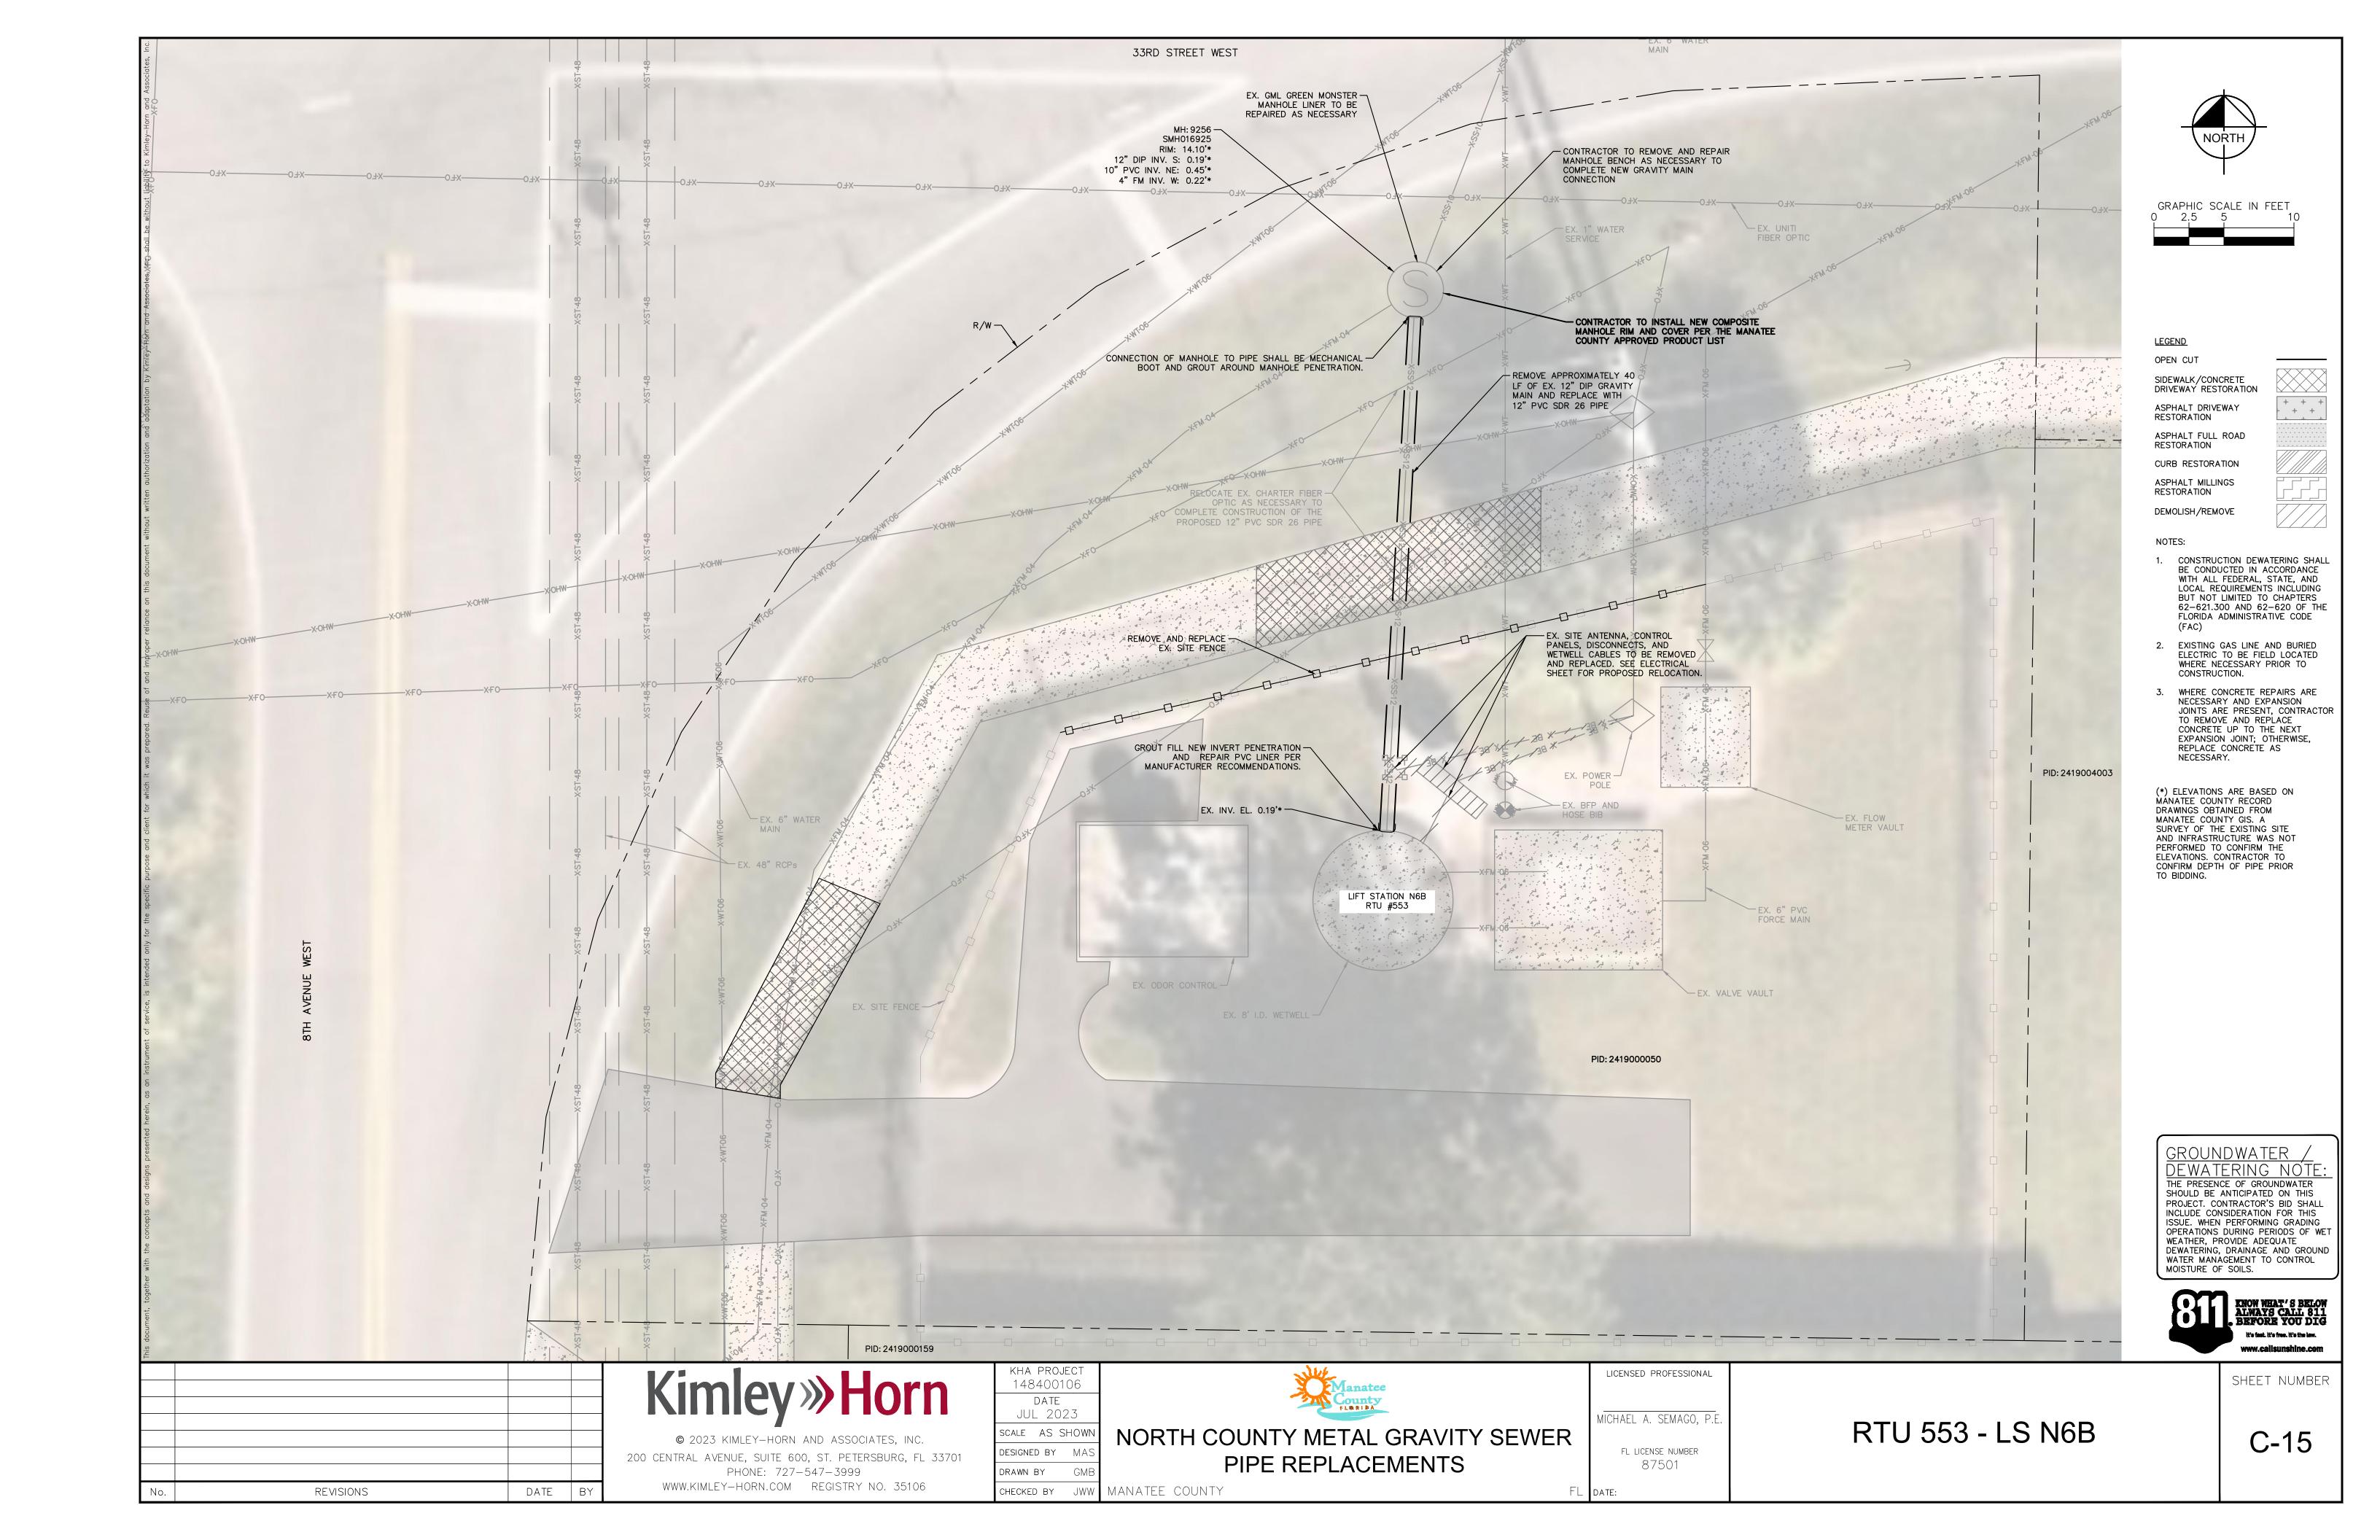


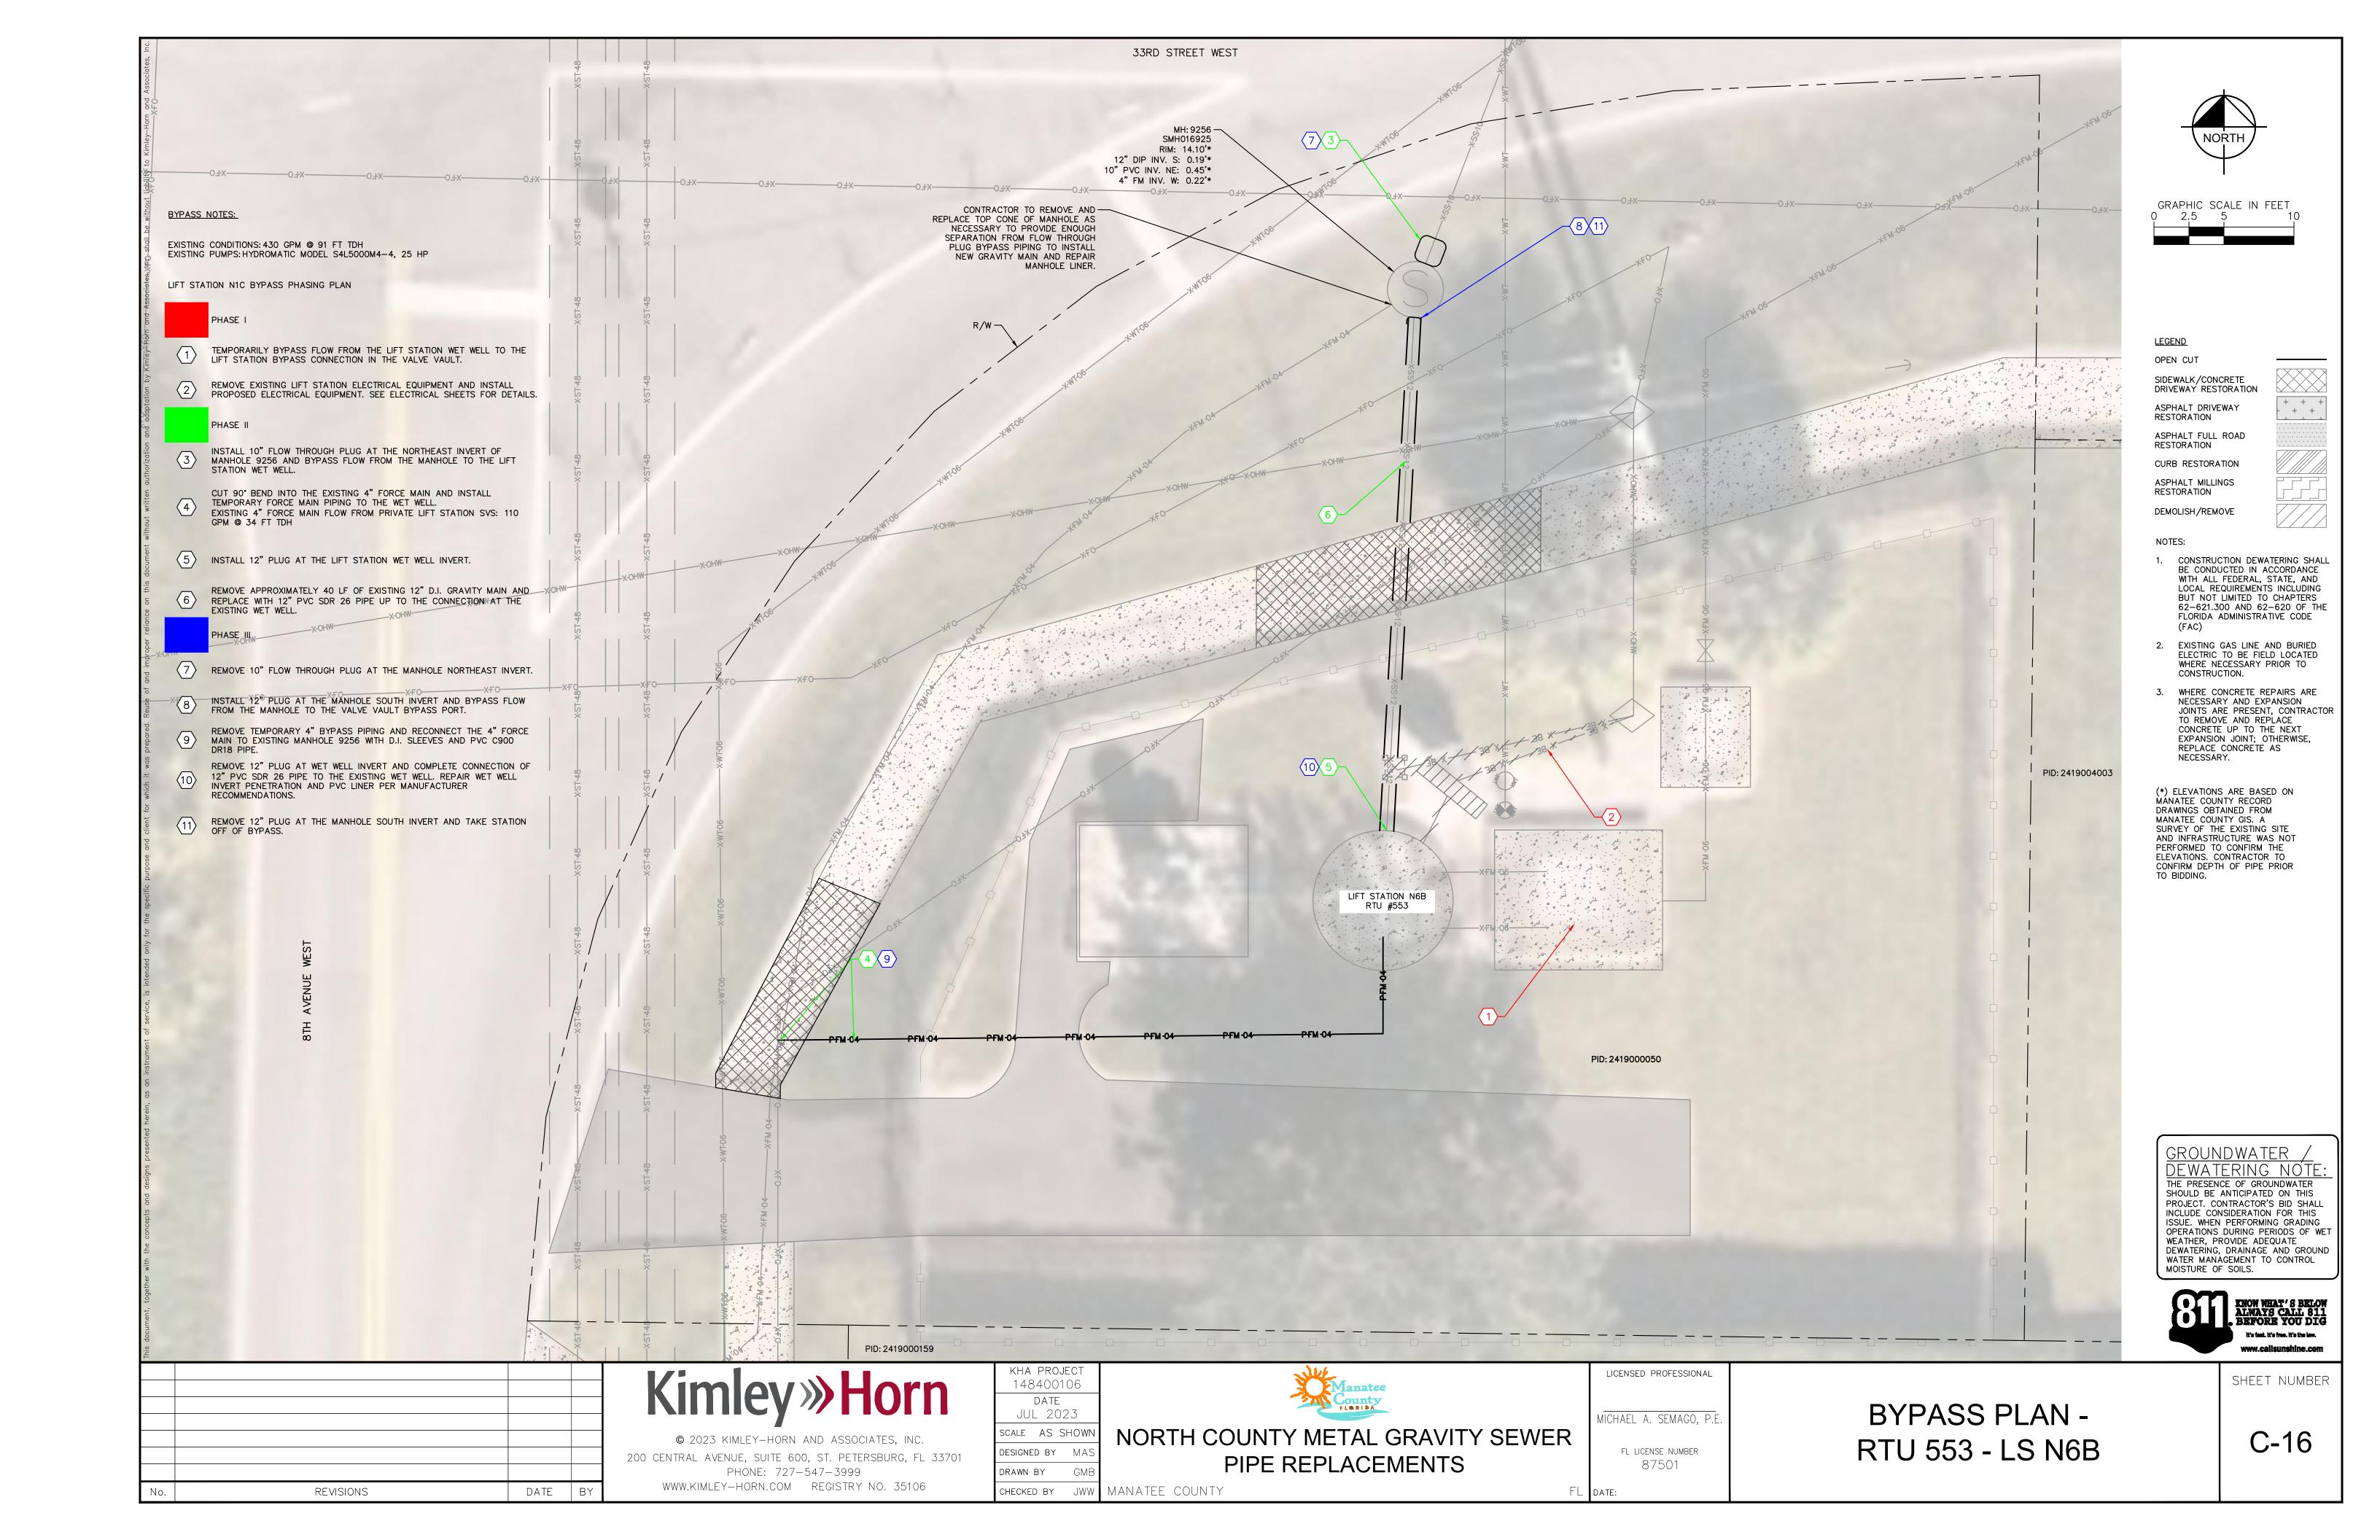


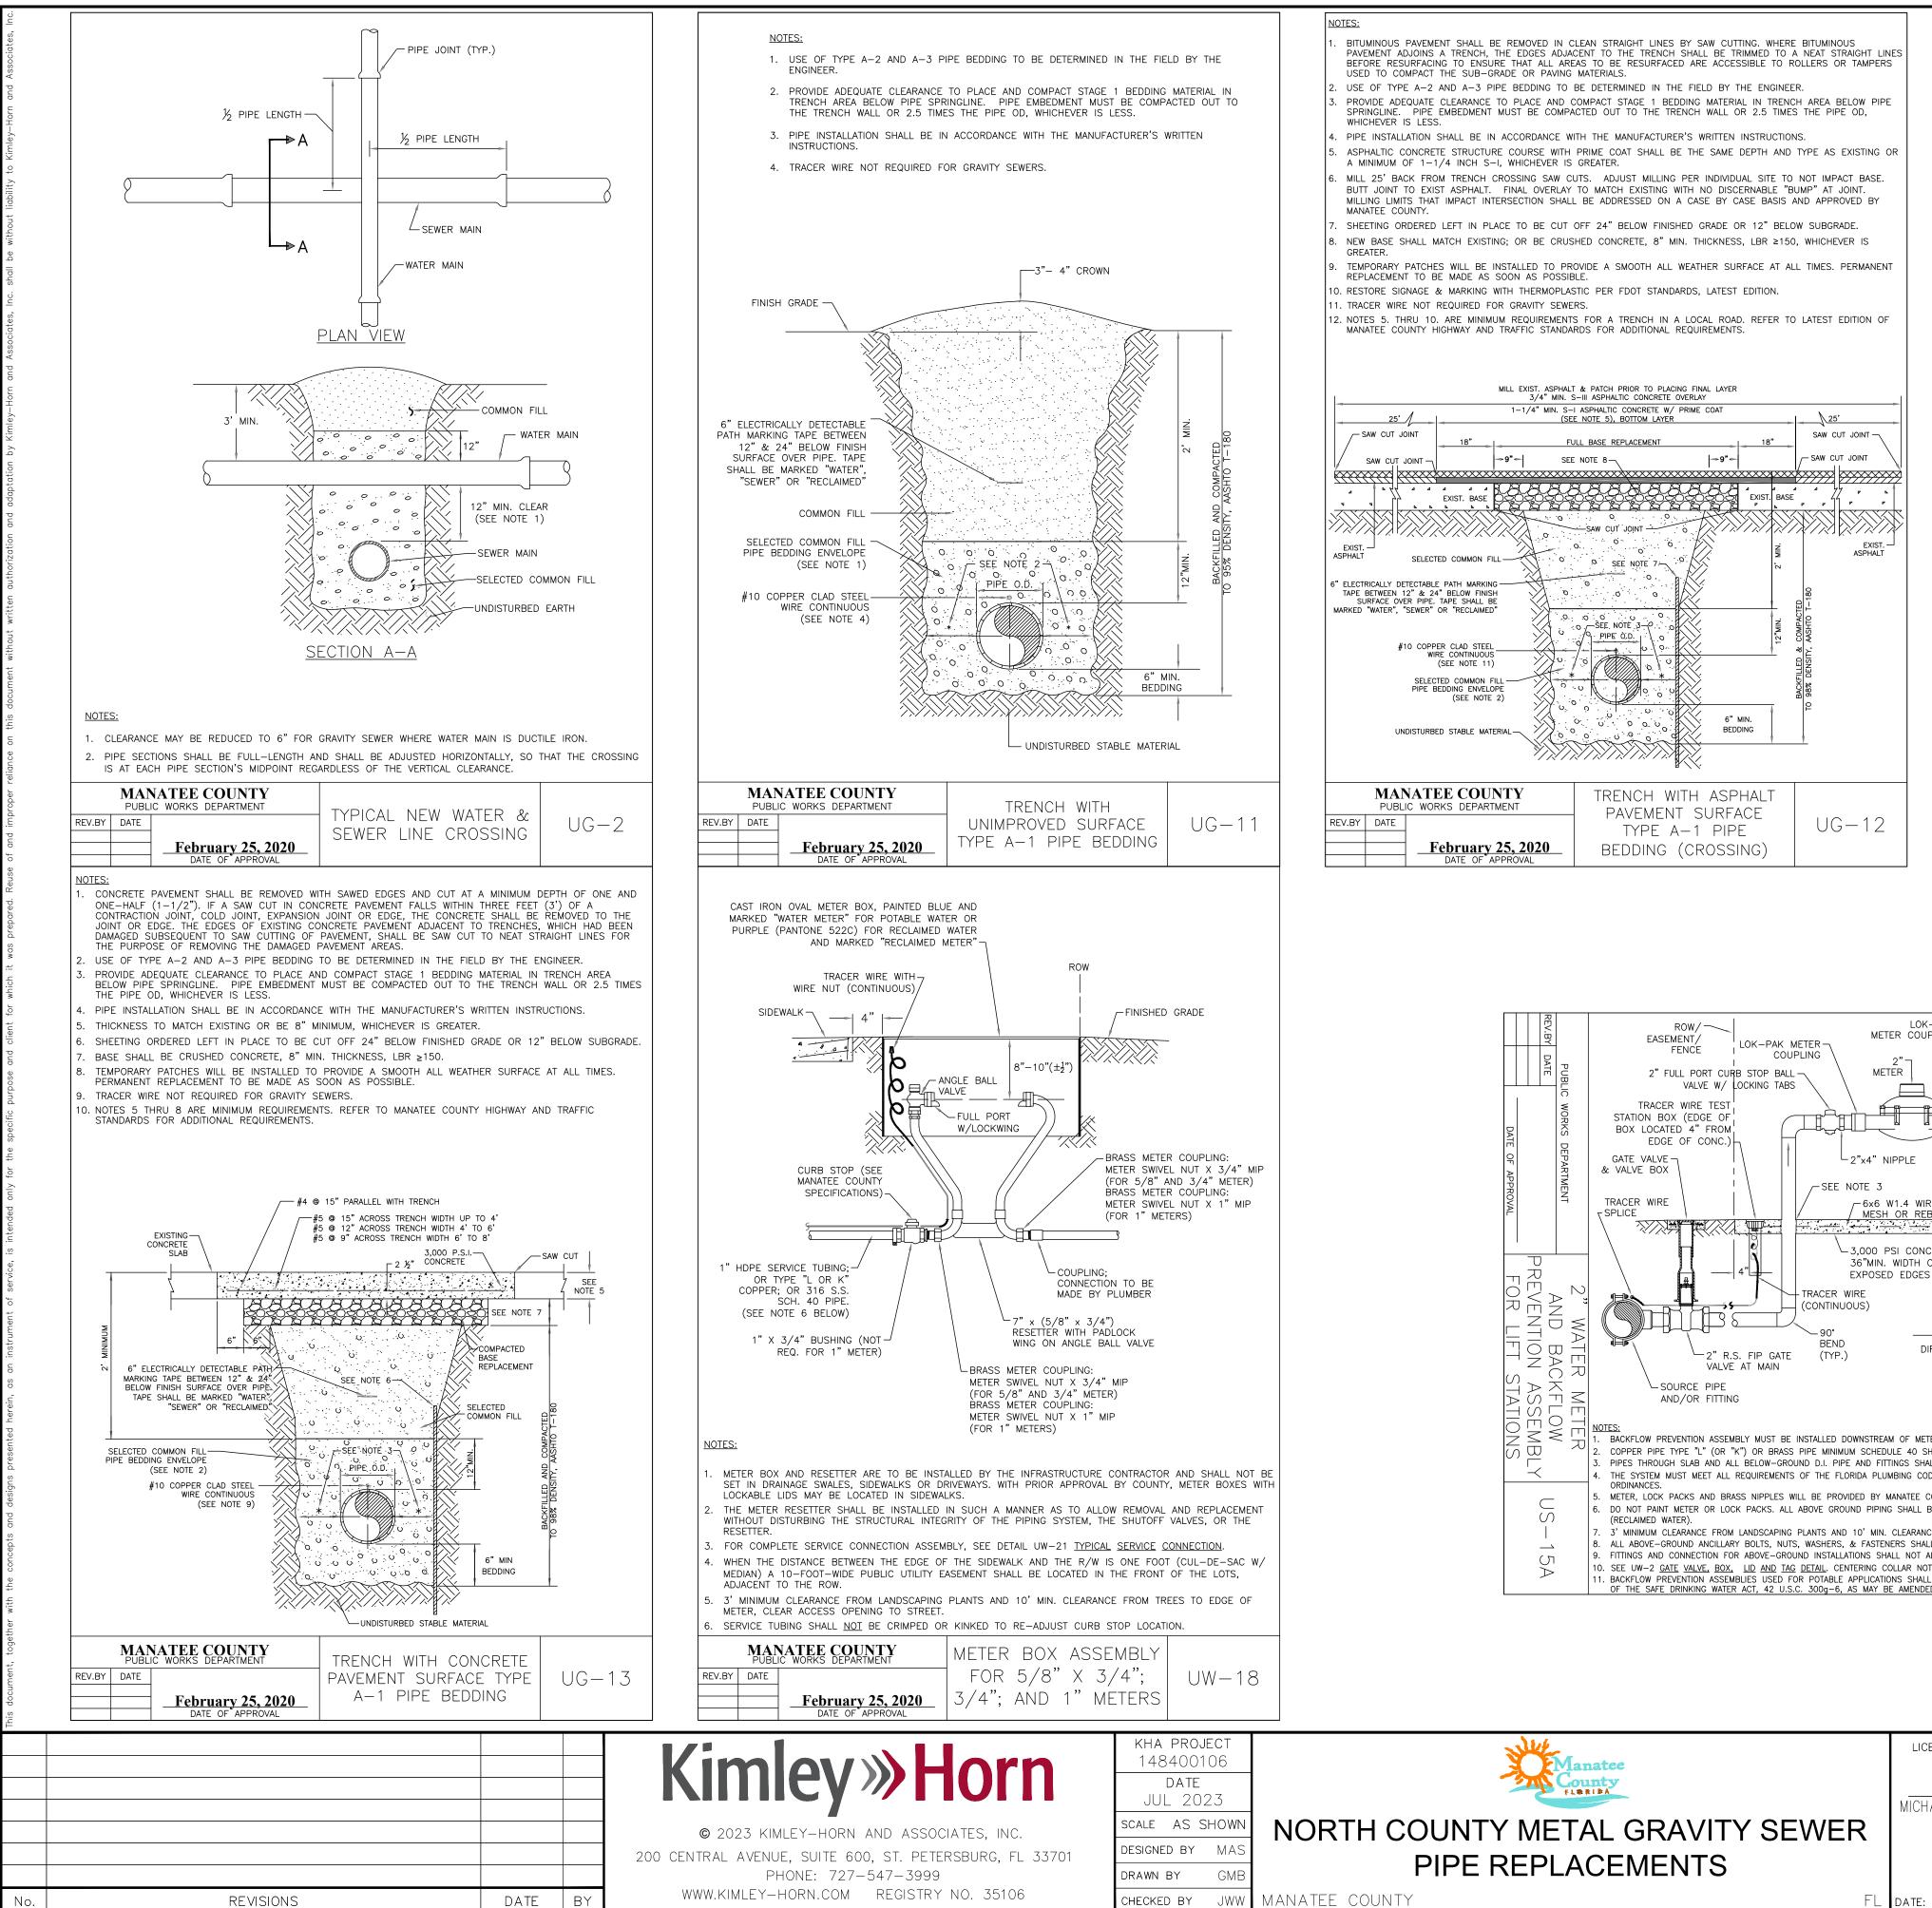


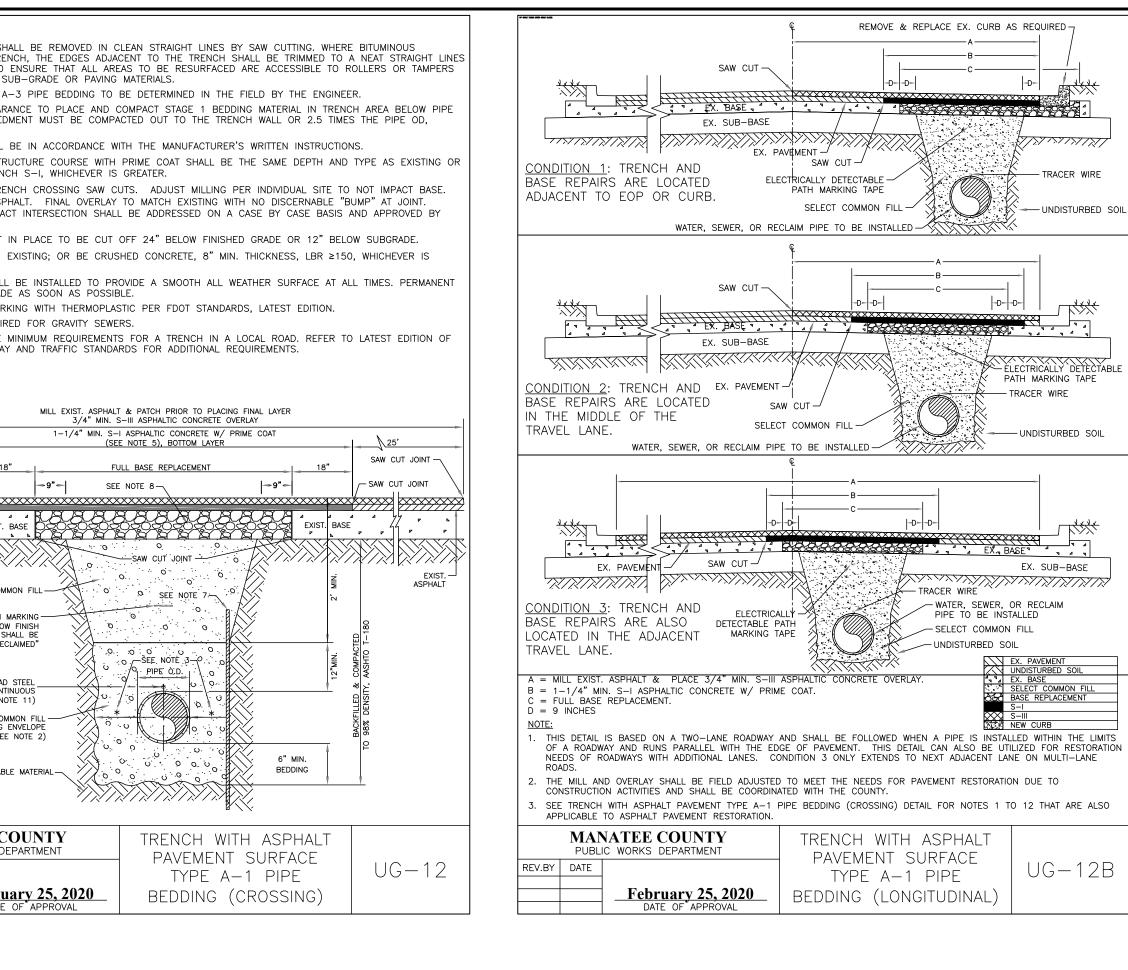


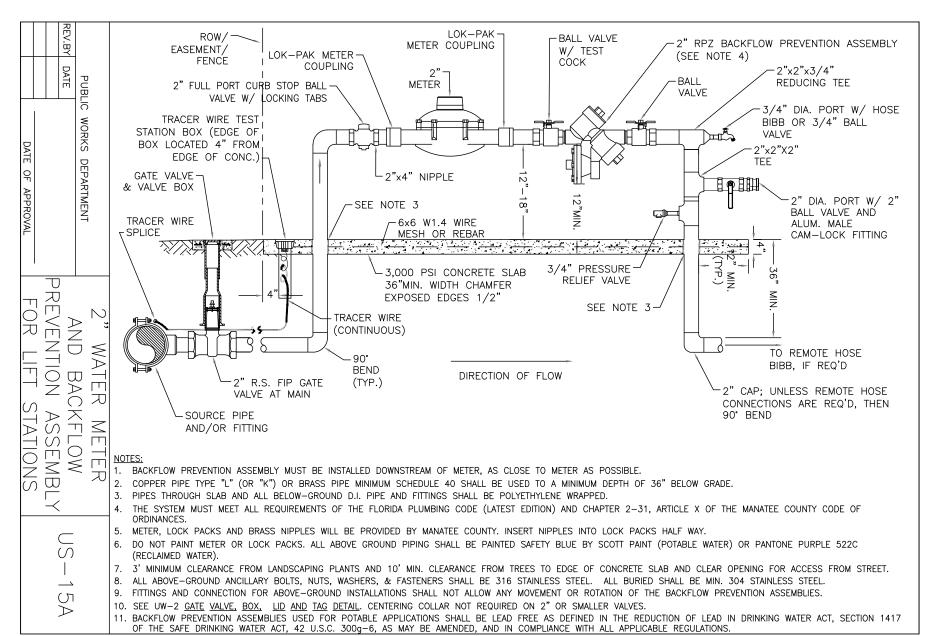








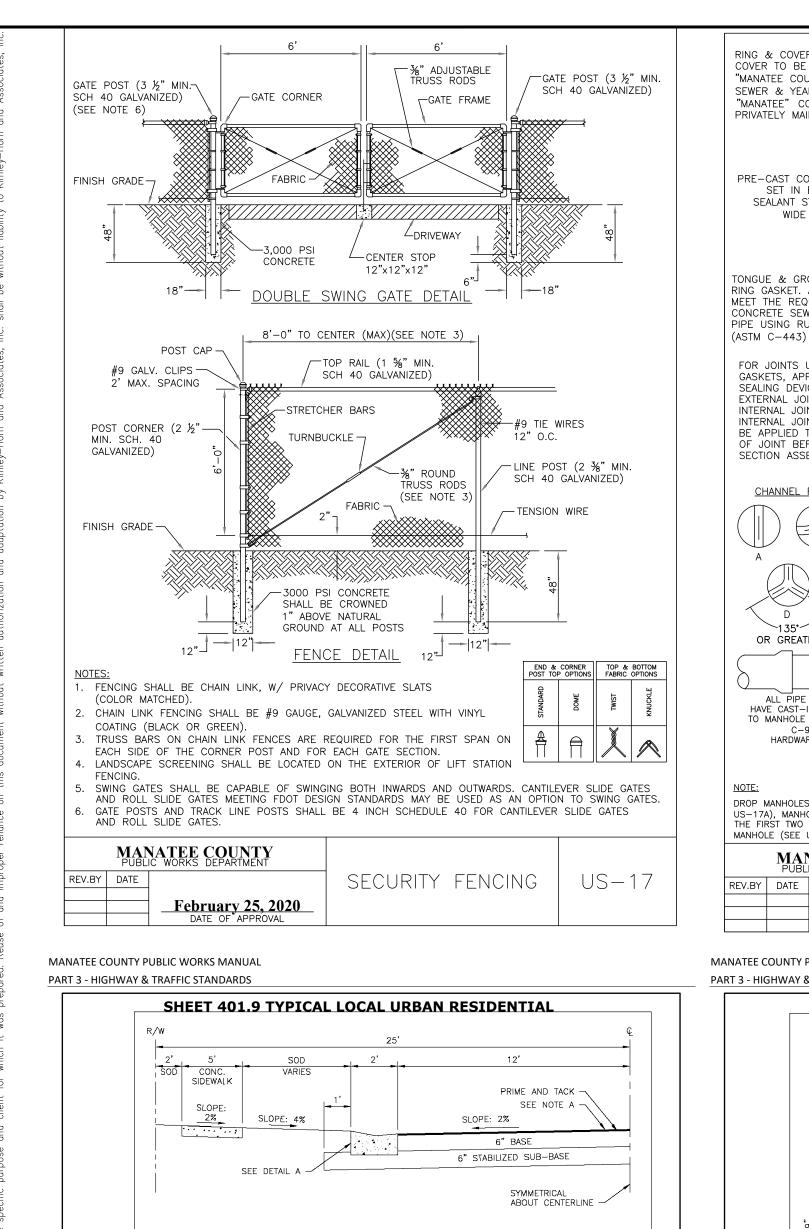


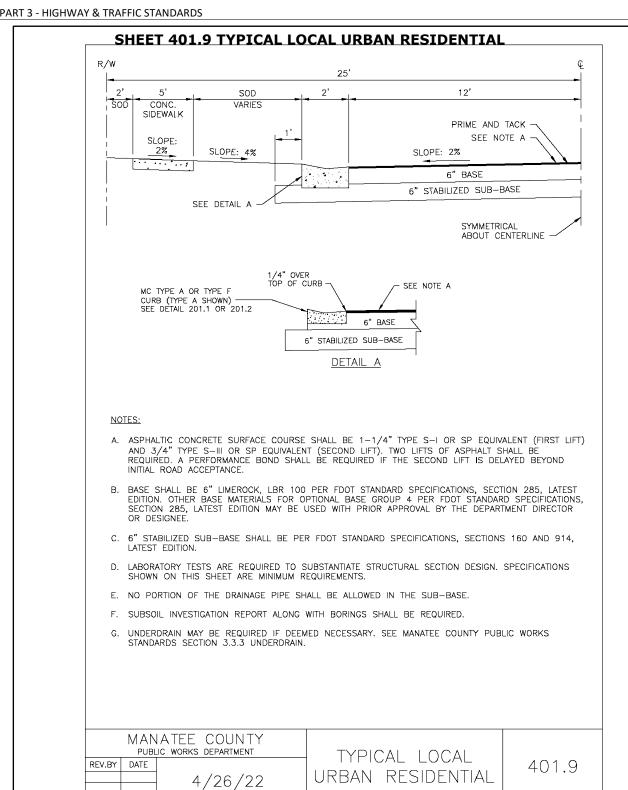


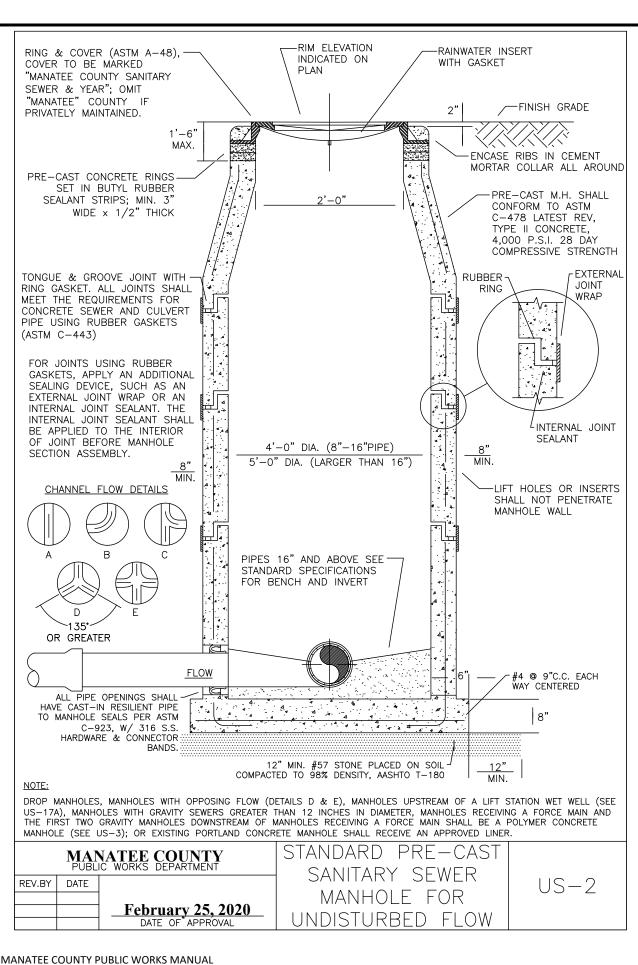
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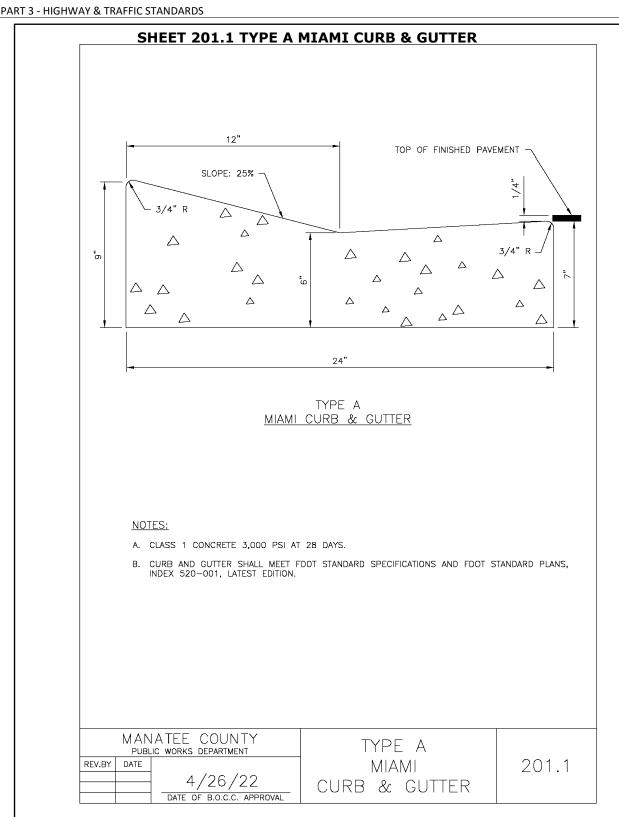
MICHAEL A. SEMAGO, P.I FL LICENSE NUMBER 87501


CIVIL DETAILS












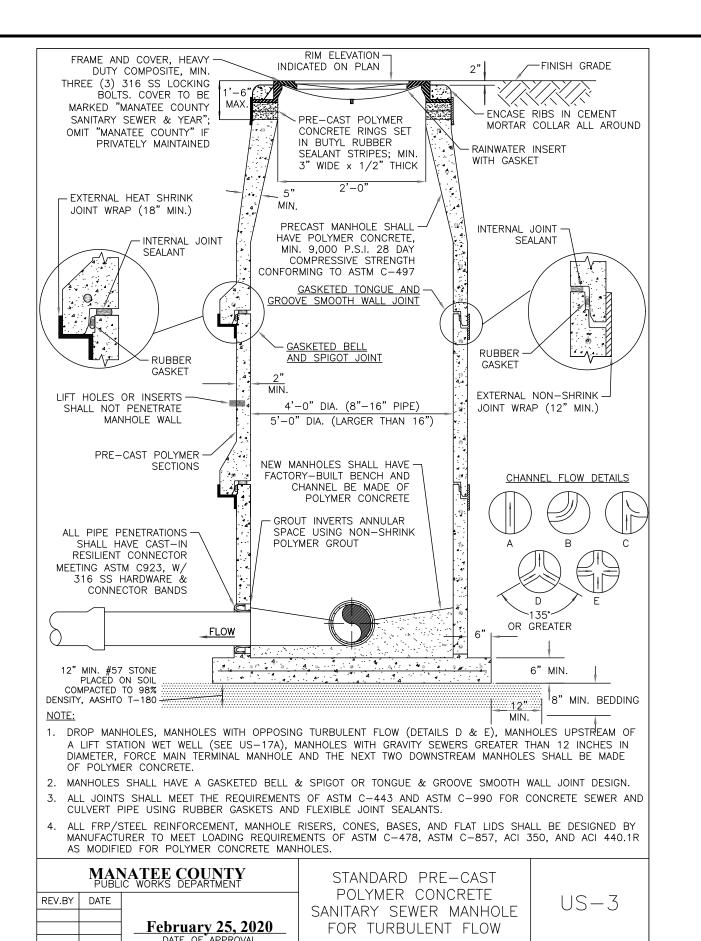



MANATEE COUNTY PUBLIC WORKS MANUAL

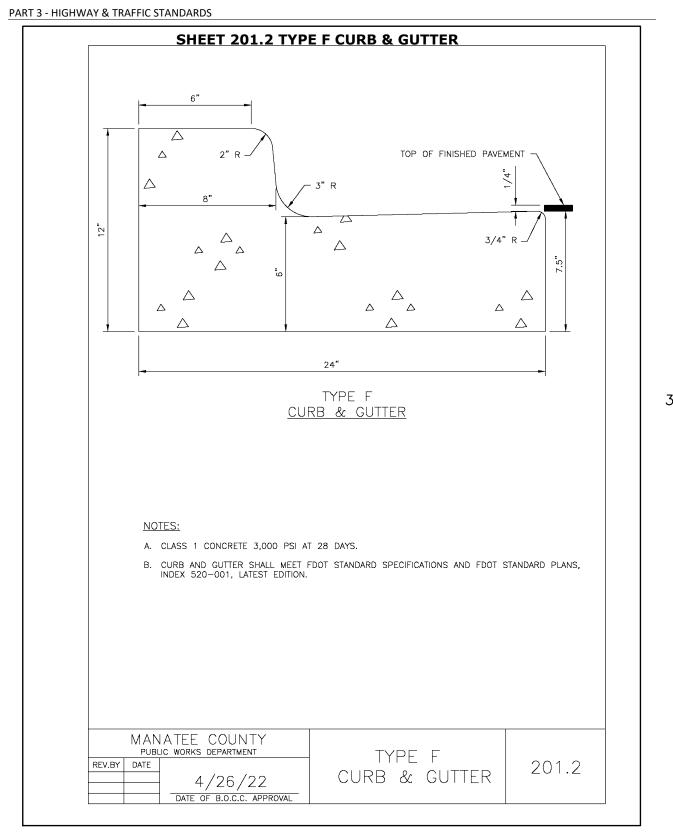

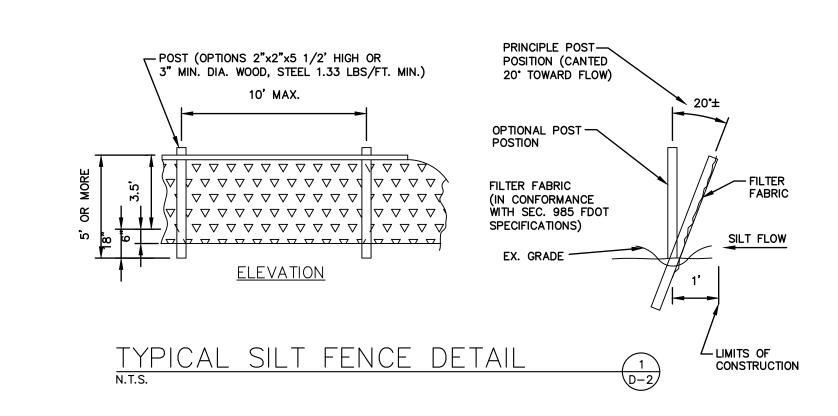

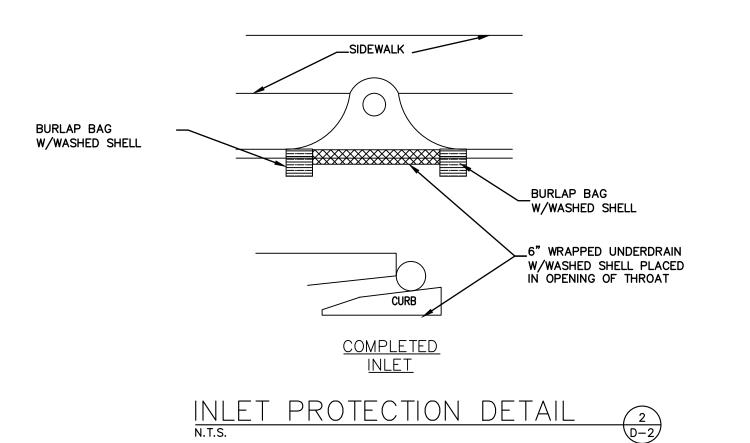

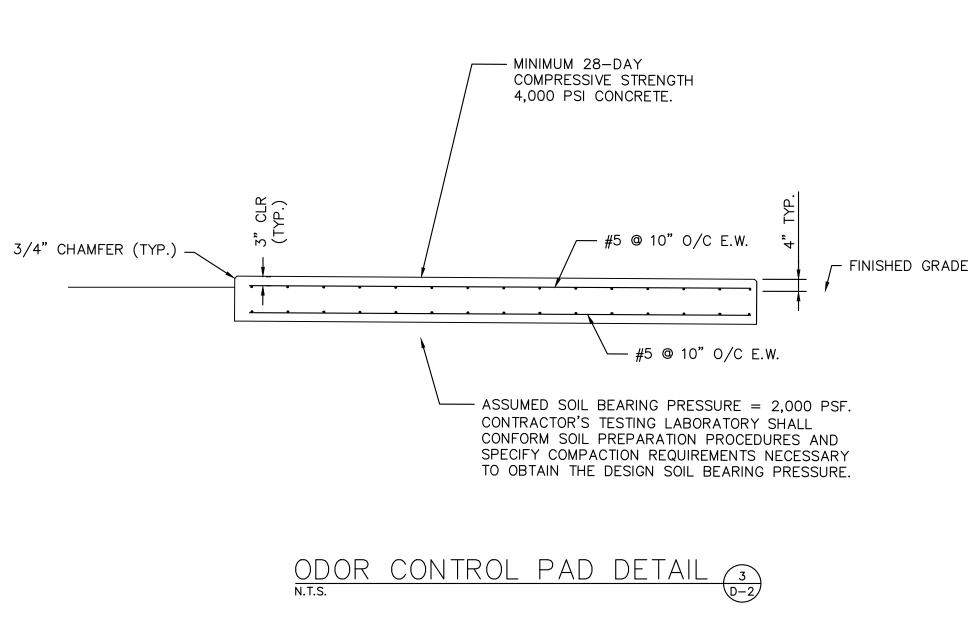

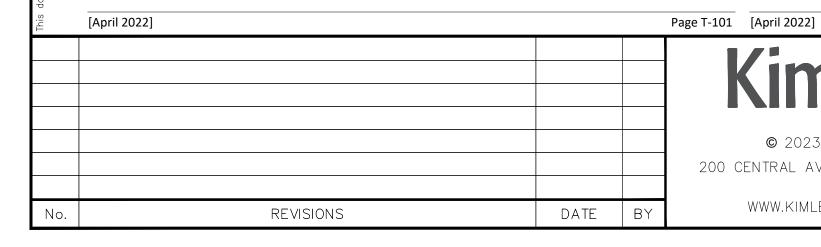

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148400106 DATE JUL 2023 CALE AS SHOWN ESIGNED BY MA drawn by GME

Page T-76 [April 2022]

CHECKED BY JWW MANATEE COUNTY

NORTH COUNTY METAL GRAVITY SEWER PIPE REPLACEMENTS

MICHAEL A. SEMAGO, P.I FL LICENSE NUMBER 87501

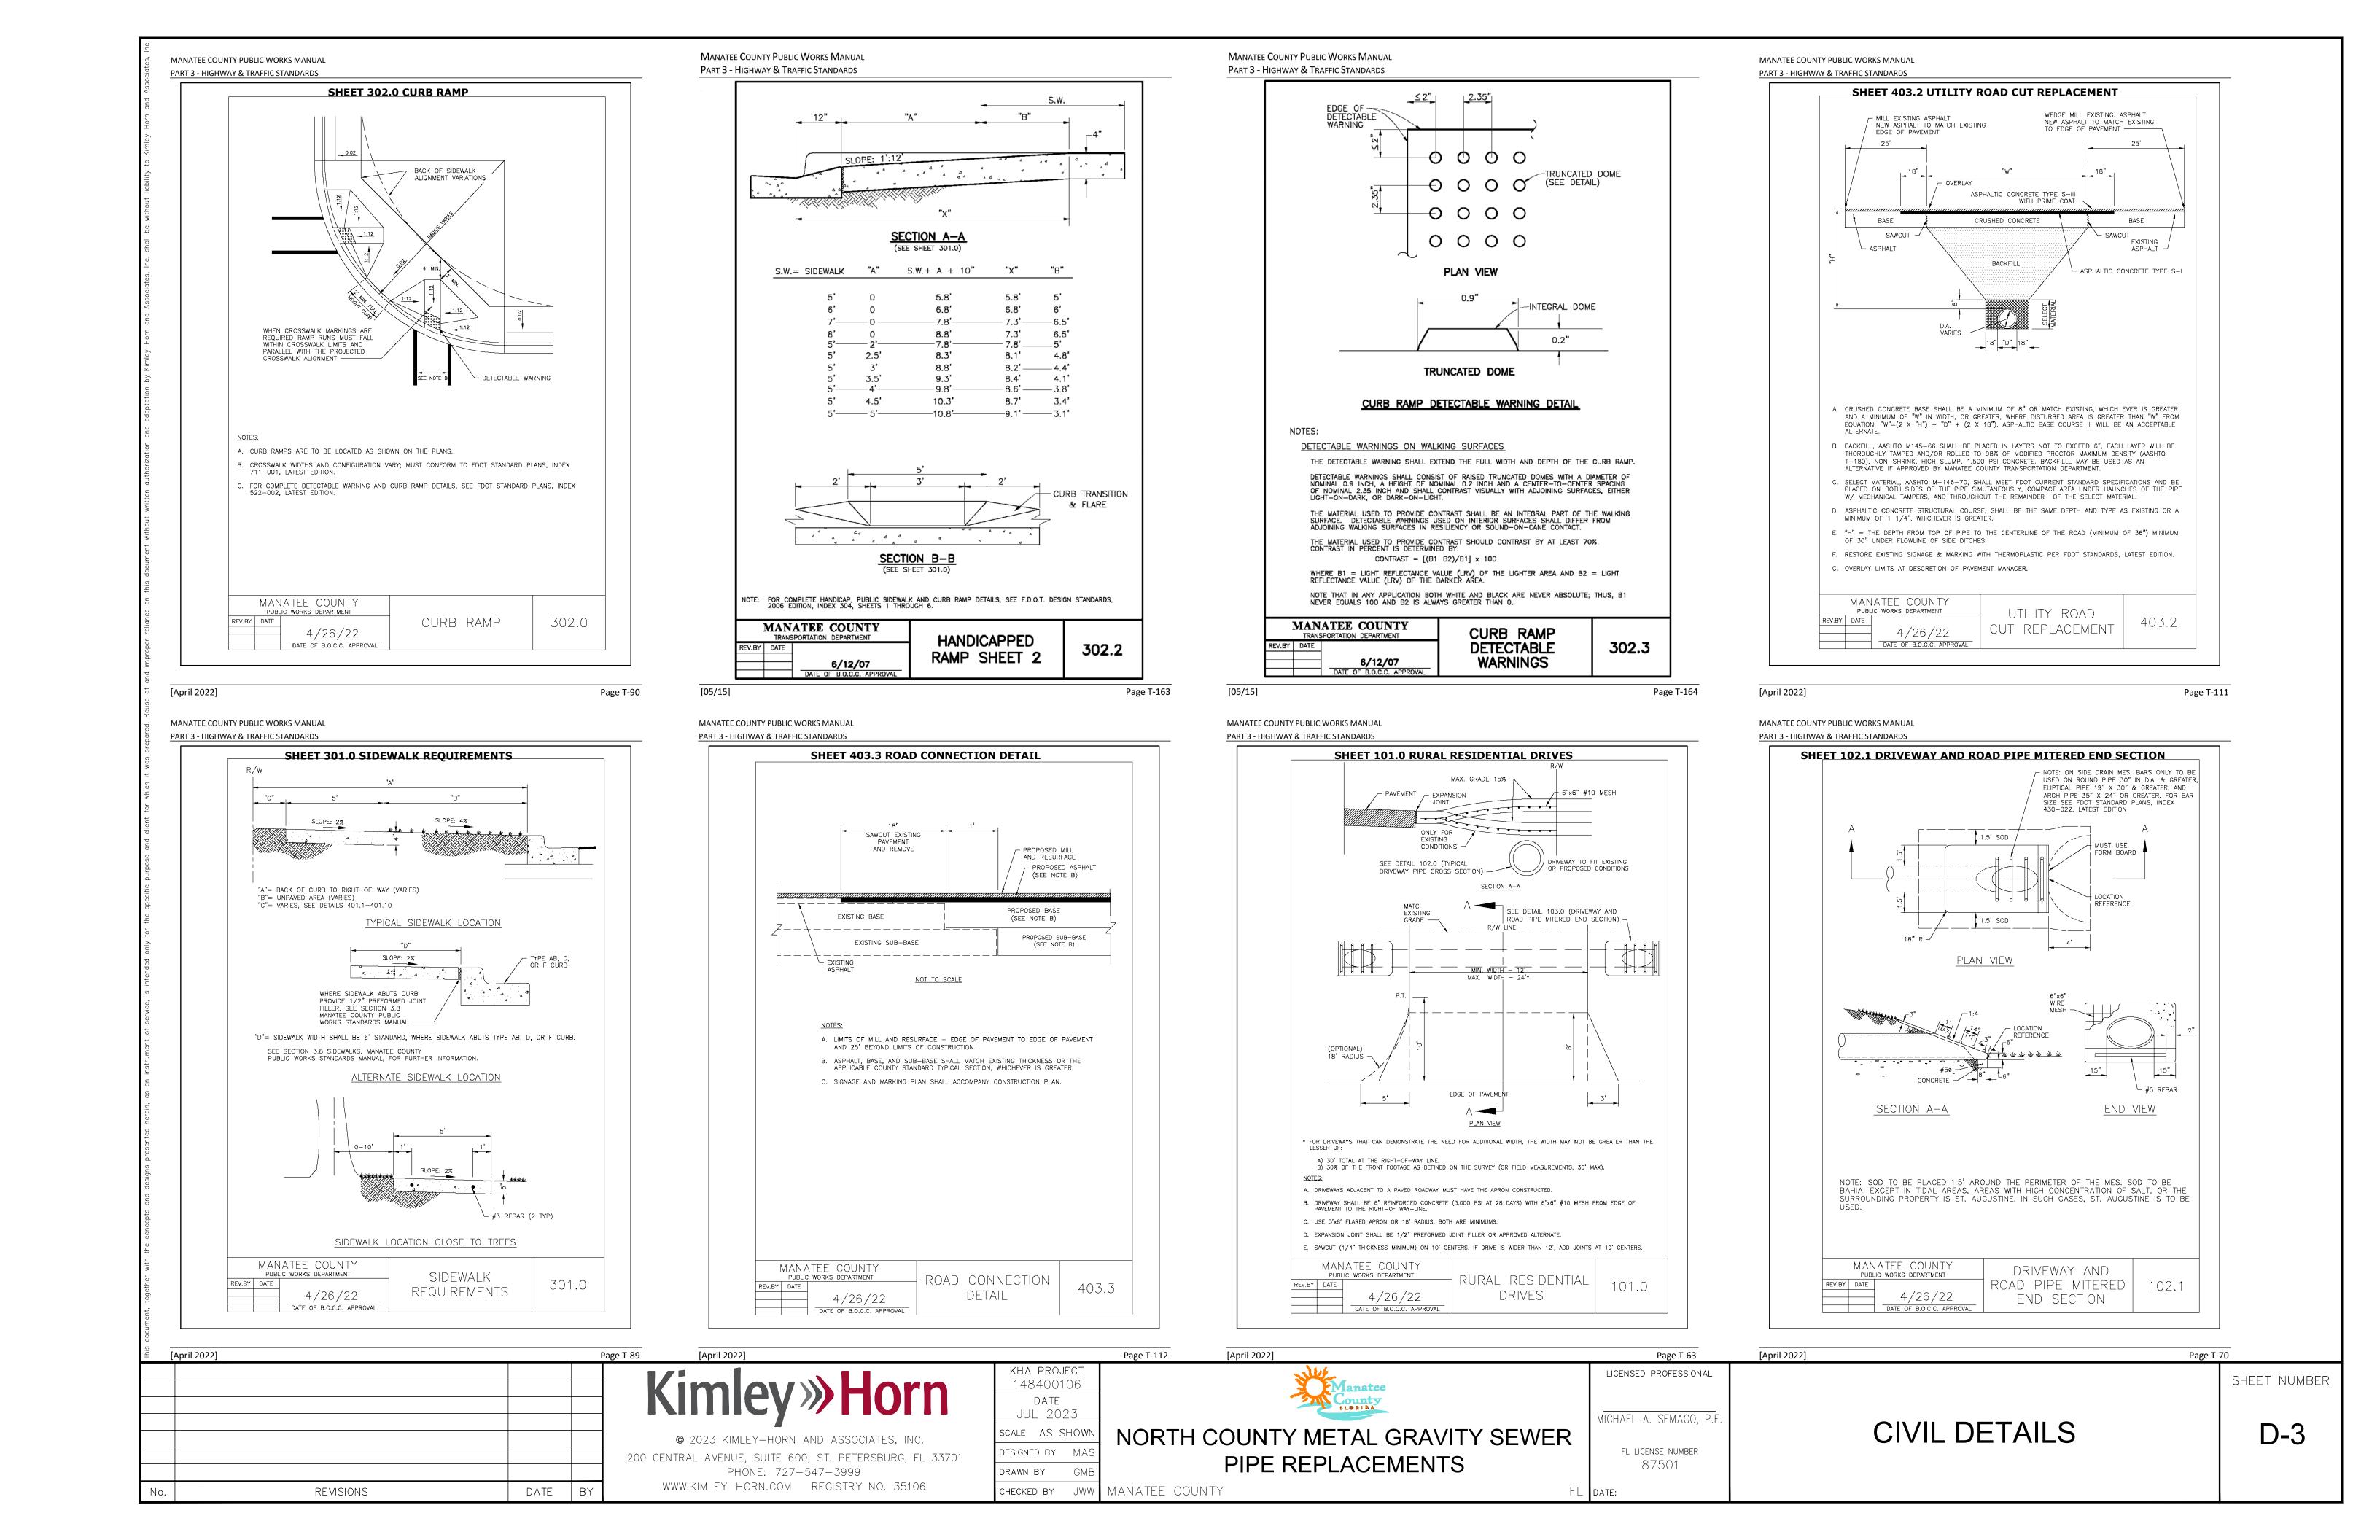
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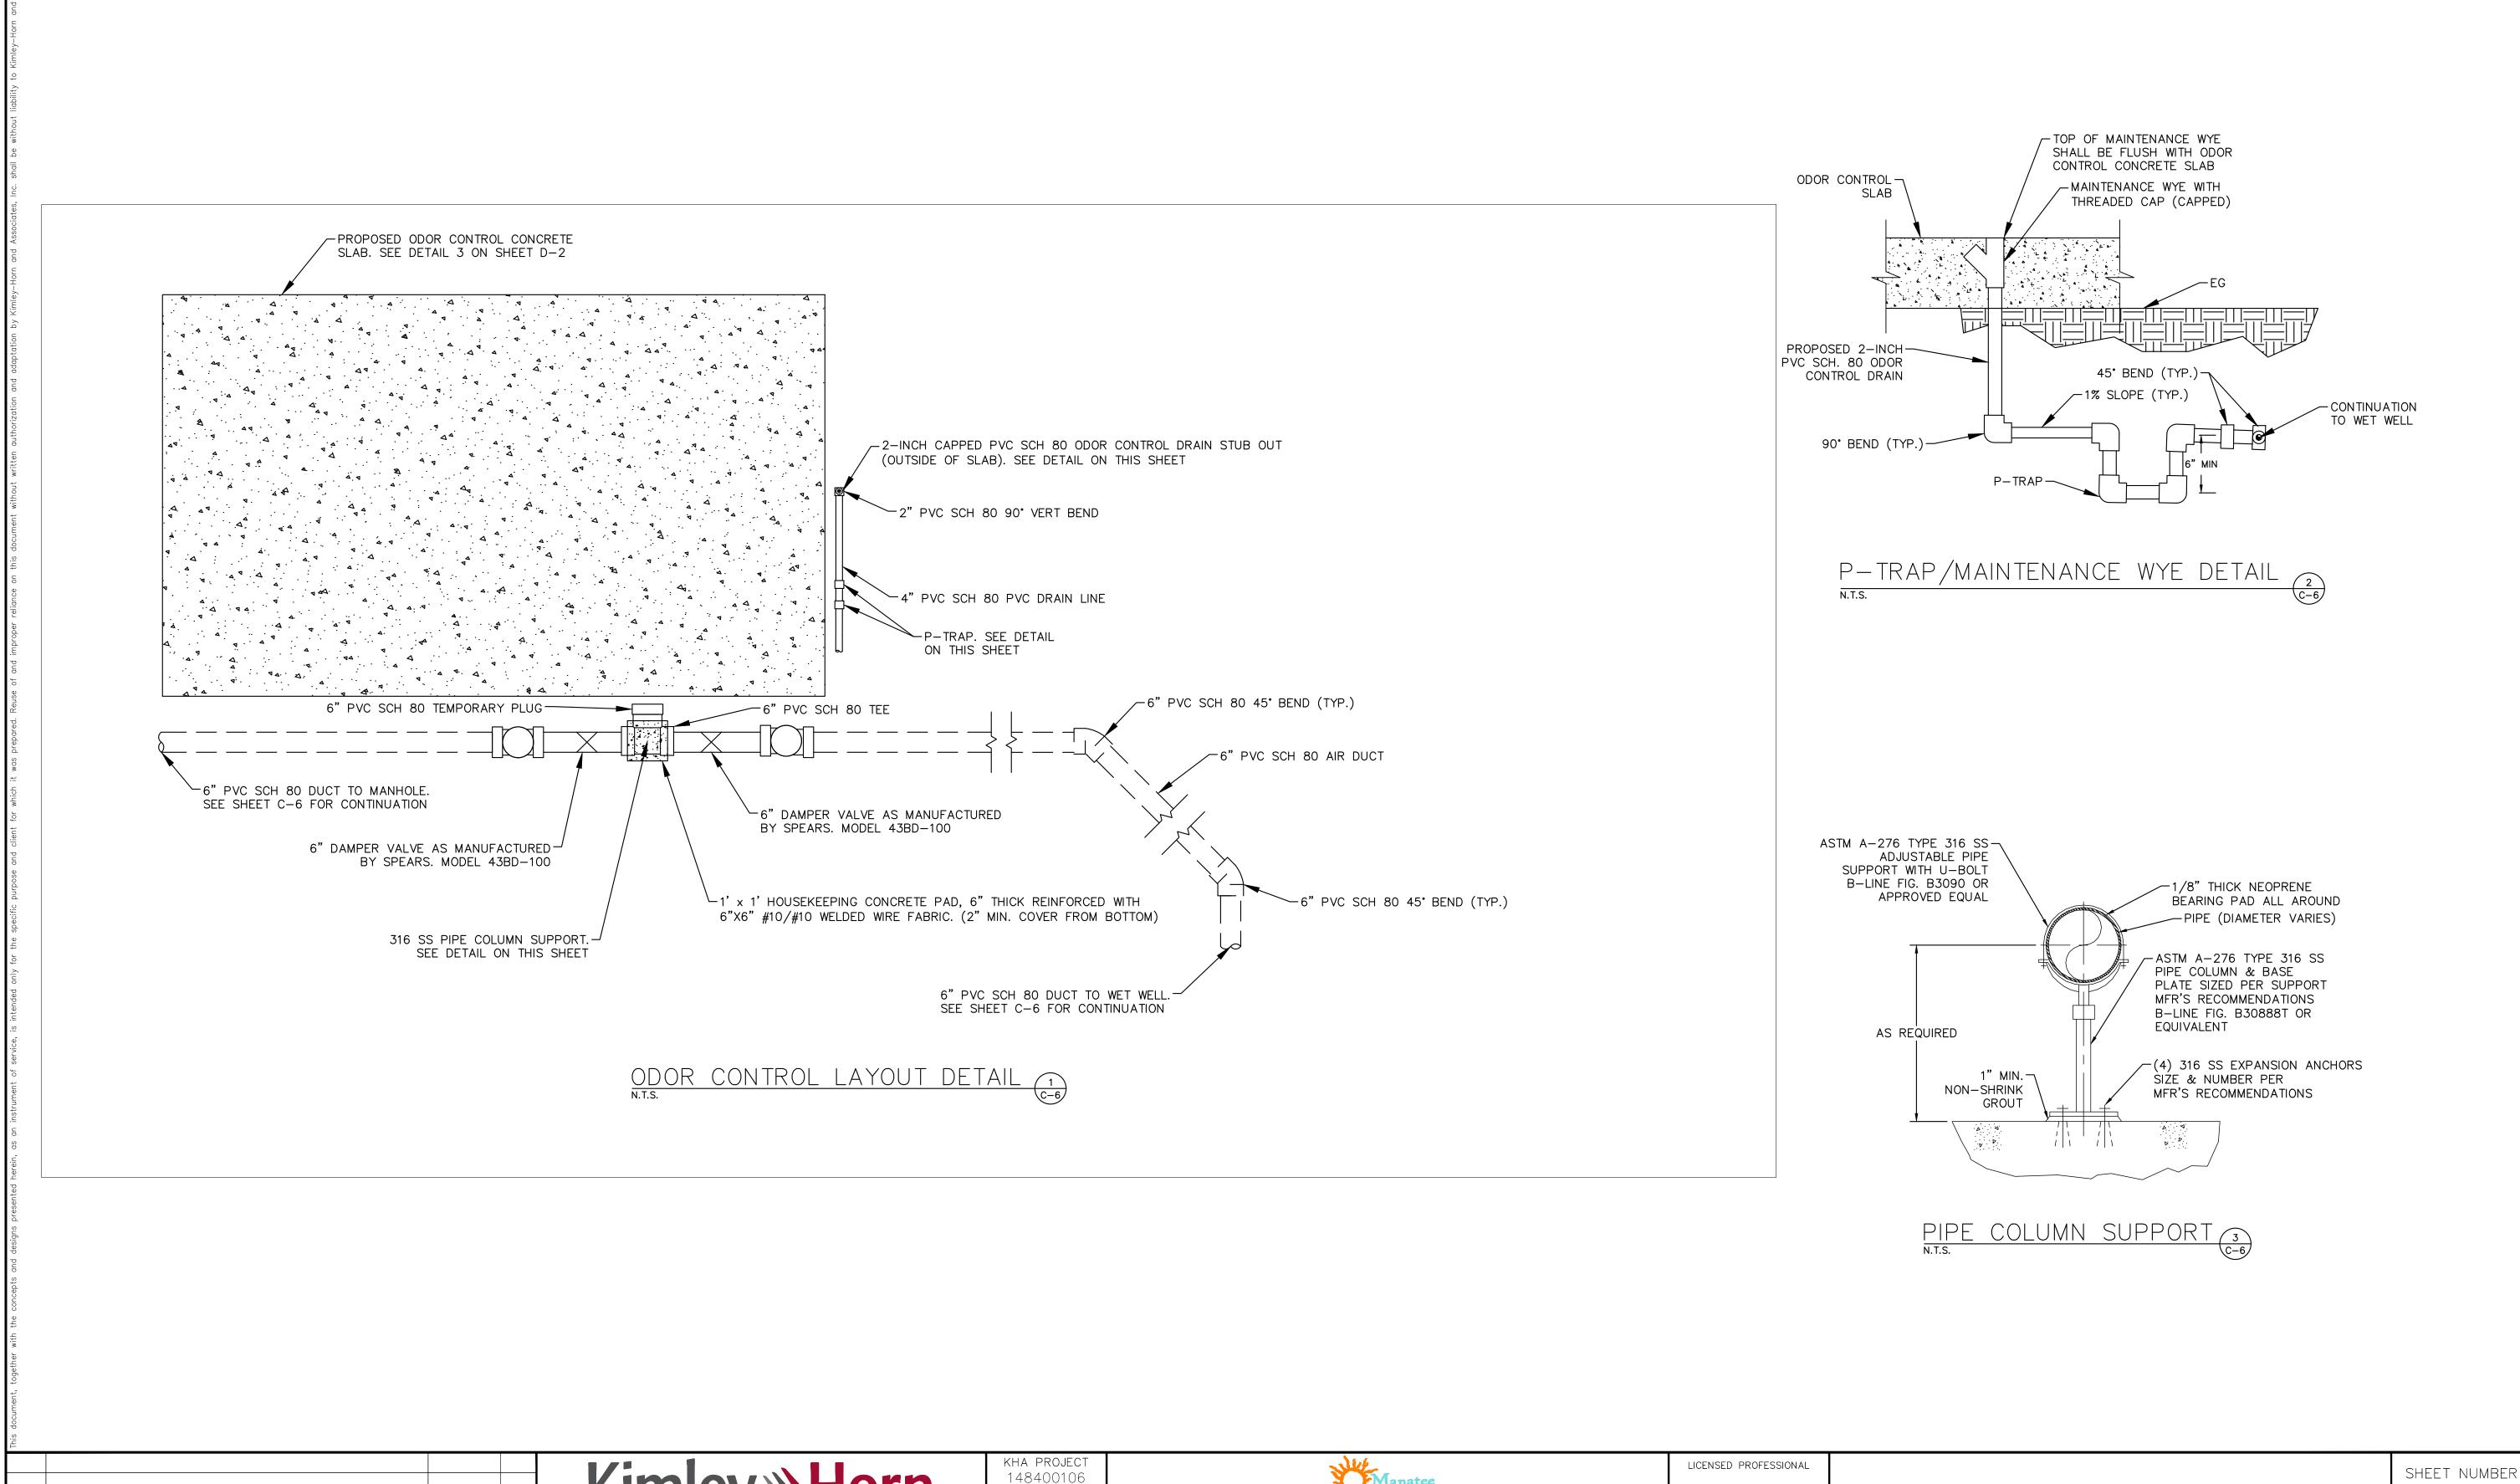
Page T-77

FL DATE:

CIVIL DETAILS

D-2





REVISIONS DATE BY

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PHONE: 727-547-3999

WWW.KIMLEY-HORN.COM REGISTRY NO. 35106

DATE JUL 2023 SCALE AS SHOWN ESIGNED BY MAS 200 CENTRAL AVENUE, SUITE 600, ST. PETERSBURG, FL 33701 DRAWN BY GMB CHECKED BY JWW MANATEE COUNTY

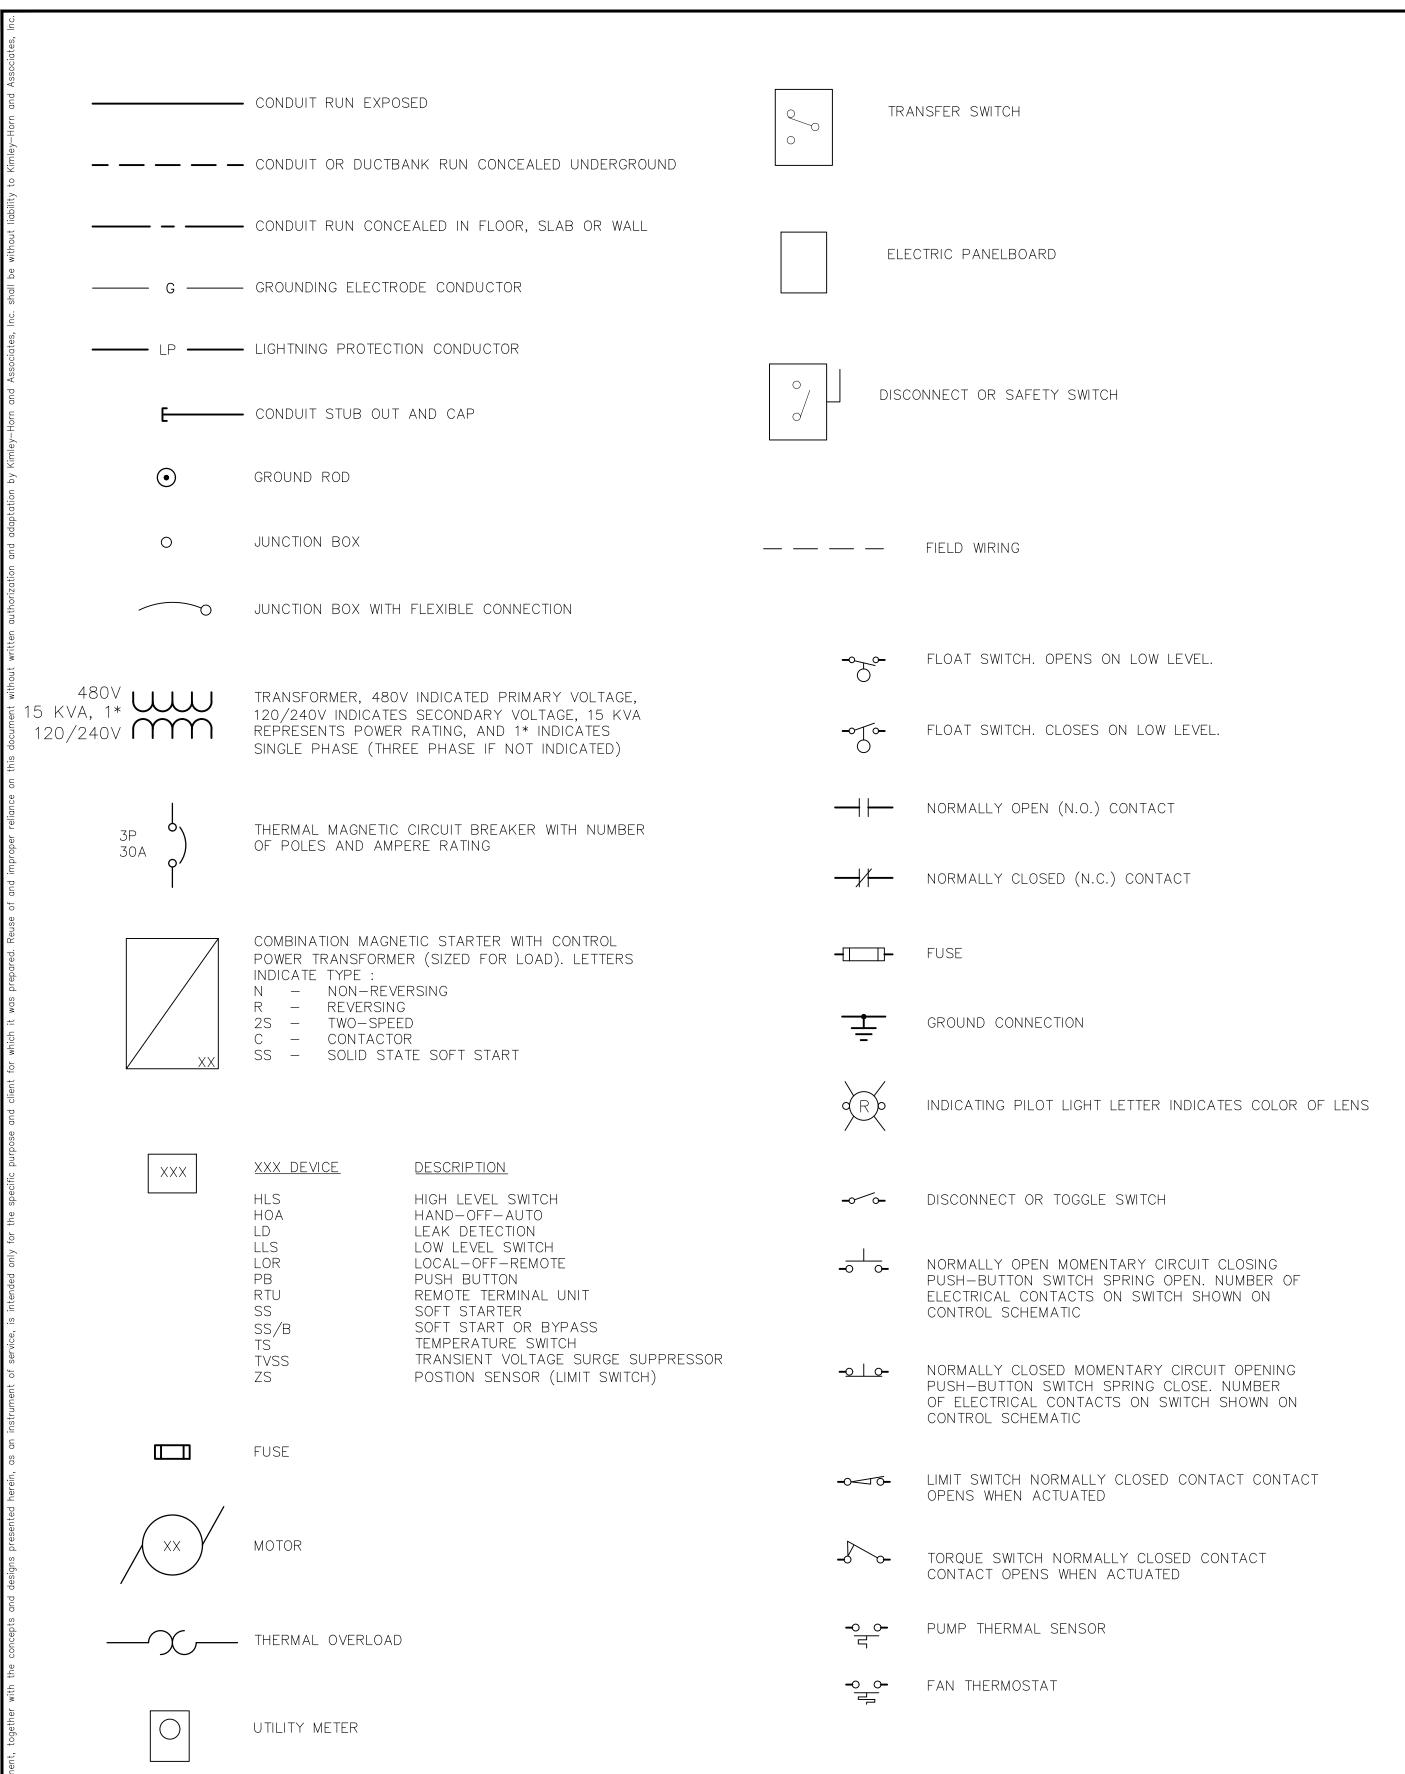
NORTH COUNTY METAL GRAVITY SEWER PIPE REPLACEMENTS

MICHAEL A. SEMAGO, P.E FL LICENSE NUMBER 87501

FL DATE:


CIVIL DETAILS

D-4



SYMBOL	DESCRIPTION	MOUNTING/REMARKS
A	8' LED STRIP LIGHTING FIXTURE (1)	CEILING MOUNT
<u></u>	LED WALLPACK LIGHTING FIXTURE (1)	EXTERIOR WALL
EM	LED EMERGENCY FLOOD LIGHTING FIXTURE (1)	WALL MOUNTED
	LED EXIT SIGN FIXTURE (1)	SURFACE UNIVERSAL MOUNT
\$	SWITCH: SINGLE-POLE OR AS NOTED, 20A, 120/277VAC	TOP 48" AFF OR AS NOTED
\$ ³	SWITCH: THREE-WAY, 20A, 120/277VAC	TOP 48" AFF OR AS NOTED
\$4	SWITCH: 4-WAY, 20A, 120/277VAC	TOP 48" AFF OR AS NOTED
\rightleftharpoons	DUPLEX RECEPTACLE: 20A, 125VAC	TOP 20" AFF OR AS NOTED
-	COUNTER-TOP DUPLEX RECEPTACLE: 20A, 125VAC	TOP 44" AFF OR AS NOTED
 	QUAD RECEPTACLE: 20A, 125VAC	TOP 20" AFF OR AS NOTED
\triangleright	TELEPHONE/DATA OUTLET (2)	TOP 20" AFF OR AS NOTED
	ELECTRIC PANEL	REFER TO PANEL SCHEDULE
	FIRE ALARM PANEL	
4	EQUIPMENT DISCONNECT SWITCH	
0	OUTLET OR JUNCTION BOX	WIRES INDICATED AS FOLLOWS:
CR	CARD READER	TWO WIRES:
DL	MAGNETIC DOOR LOCK	THREE WIRES:
(S)	SMOKE DETECTOR	FOUR WIRES, ETC.
0	JUNCTION BOX WITH FLEXIBLE CONNECTION	NEUTRAL WIRE ISOLATED GR.
	CONDUIT RUN CONCEALED IN CEILING SPACE OR WALL	WIRE
	CONDUIT RUN CONCEALED IN FLOOR OR UNDERGROUND	PROVIDE 2#12 THWN CU. IN 1/2" C. UNLESS OTHERWISE
	CONDUIT RUN EXPOSED	NOTED AND EQUIPMENT GROUND WIRE (NOT
	HOME RUN TO PANEL/CIRCUIT(S) INDICATED	INDICATED) IN ALL POWER AND LIGHTING RACEWAYS.

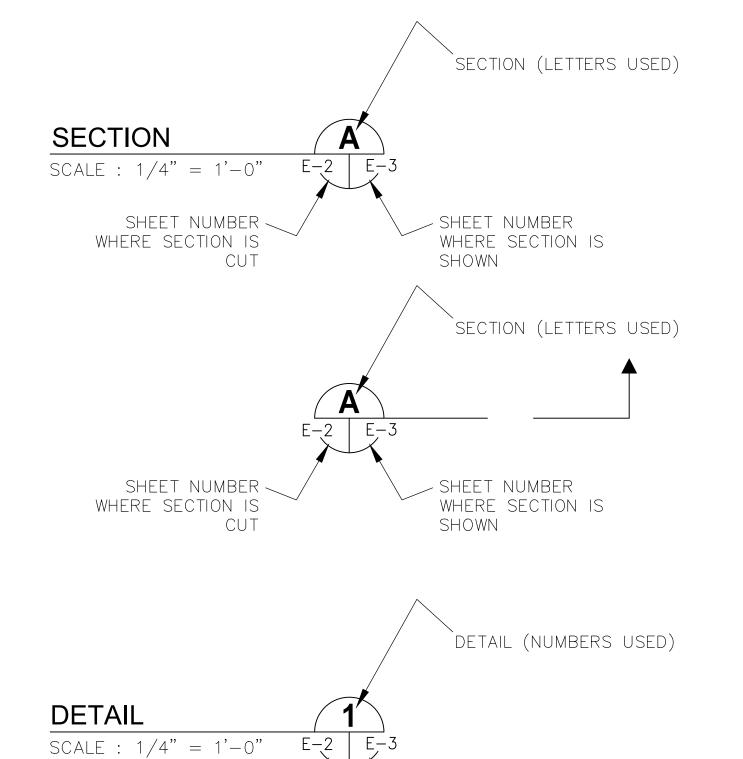
EXAMPLE OF SECTION CUT AND DETAIL



SHEET NUMBER

ENLARGED

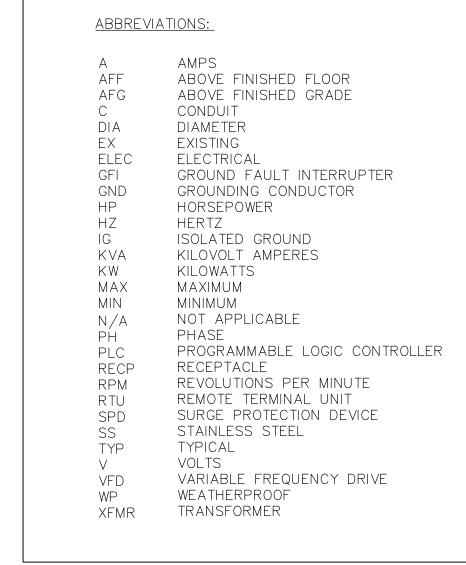WHERE DETAIL IS





No.	REVISIONS	DATE	BY

Kimley» Horn

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PHONE: 727-547-3999
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KHA PROJECT
148400106

DATE
JUN 2023

SCALE AS SHOWN

DESIGNED BY TDT

DRAWN BY JLT

CHECKED BY GLW MANATEE COUNTY

Manatee
County
Flexible
TY METAL GRAVIT

NORTH COUNTY METAL GRAVITY SEWER PIPE REPLACEMENTS

TIMOTHY THOMAS, P.E.

FL LICENSE NUMBER
47079

FL DATE:

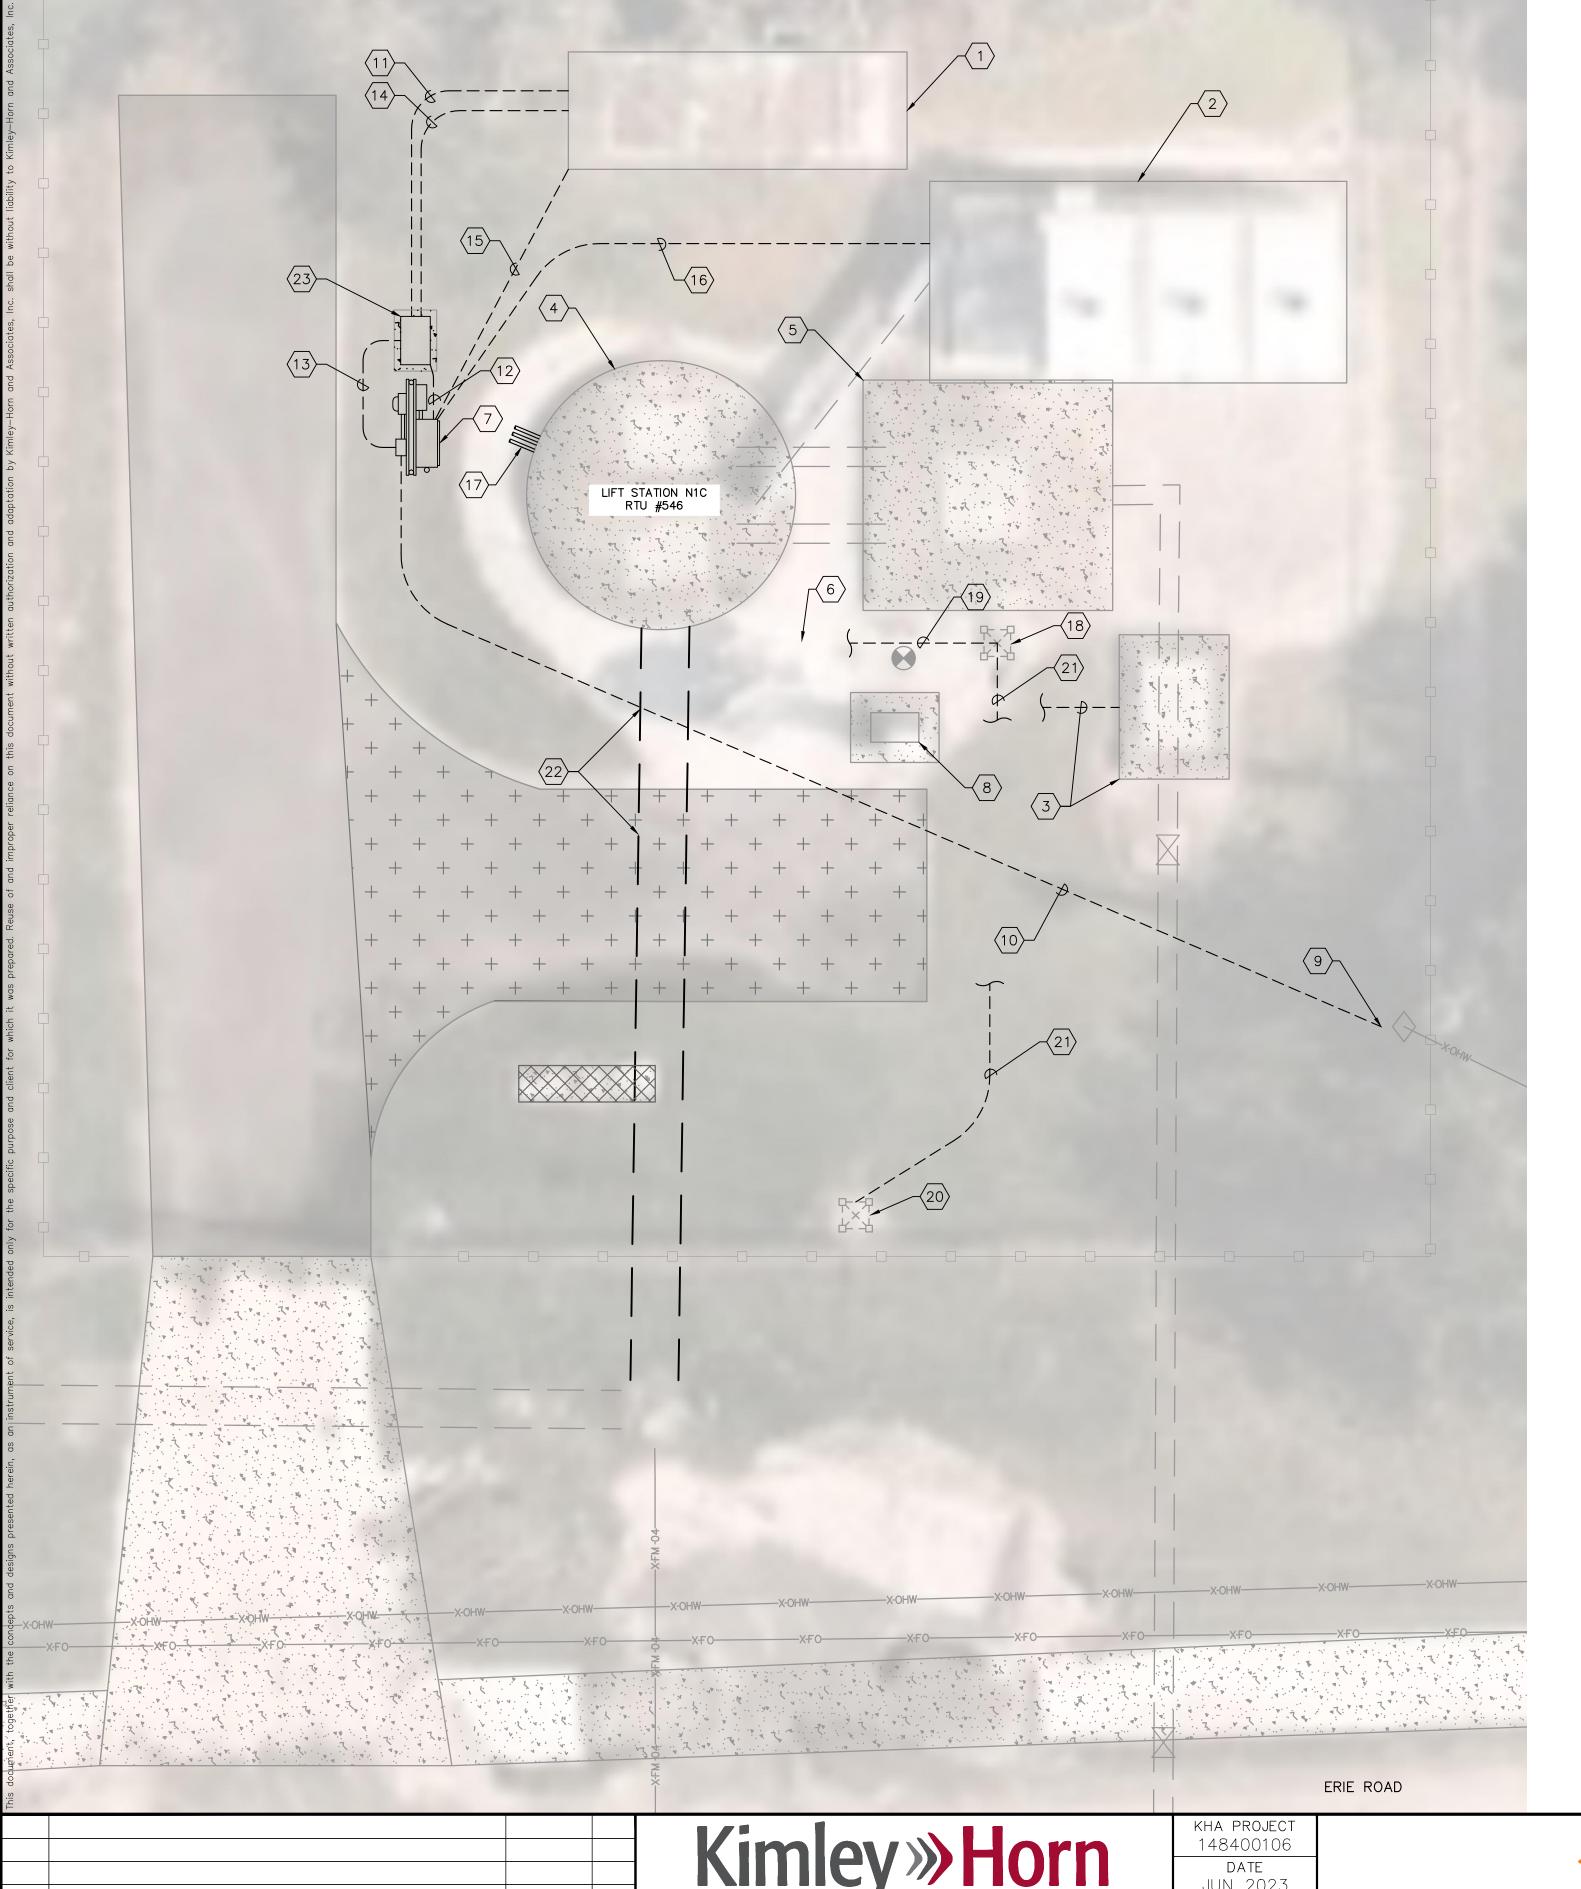
ELECTRICAL LEGEND AND ABBREVIATIONS

SHEET NUMBER

WHERE DETAIL IS

SHOWN

SHEET NUMBER




KEYED NOTES:

- (1) EXISTING GENERATOR AND FUEL TANK TO REMAIN.
- $\langle 2 \rangle$ EXISTING ODOR CONTROL UNIT TO REMAIN.
- EXISTING FLOW METER VAULT TO REMAIN. PROVIDE 2/C-#16 TWISTED SHIELDED CABLE IN 1" CONDUIT FROM FROM METER TRANSMITTER TO PUMP CONTROL PANEL FOR FLOW METER 4-20mA FLOW METER SIGNAL. CONFIRM REQUIREMENTS WITH MANATEE COUNTY.
- $\langle 4 \rangle$ EXISTING 12' I.D. WET WELL.
- 5 EXISTING VALVE VAULT. NO WORK REQUIRED.
- 6 EXISTING PUMP CONTROL PANEL, DISCONNECT, DATA FLOW EQUIPMENT AND WET WELL CABLES TO BE REMOVED AND REPLACED. REFER TO KEYED NOTE #7 FOR NEW EQUIPMENT LOCATION.
- $\langle 7 \rangle$ NEW DISCONNECT, ELECTRIC METER, PUMP CONTROL PANEL, DFS BOX AND JUNCTION BOX. REFER TO SEWAGE LIFT STATION METER & ELECTRIC DETAILS (MANATEE STANDARD US-23) AND SEWAGE LIFT STATION CONTROL PANEL (MANATEE STANDARD US-24) ON SHEET E-8. ALL EQUIPMENT TO BE PROVIDED BY MANATEE COUNTY AND INSTALLED BY THE CONTRACTOR.
- $\langle 8 \rangle$ EXISTING AUTOMATIC TRANSFER SWITCH TO BE REMOVED AND RELOCATED. REFER TO KEYED NOTE #23 FOR PROPOSED LOCATION.
- 9 EXISTING UTILITY DISTRIBUTION POLE TO REMAIN. EXISTING METER TO BE REMOVED. COORDINATE ALL REQUIREMENTS WITH FPL. REFER ALSO TO ONE LINE ON SHEET E-3.
- PROVIDE AND INSTALL 3-3/0 THWN CU + 1-#6 THWN CU GND IN 2" CONDUIT FROM EXISTING UTILITY DISTRIBUTION POLE TO NEW ELECTRIC METER.
- $\langle 11 \rangle$ Provide and install 3-3/0 thwn cu + 1-#6 thwn cu gnd in 2" conduit from automatic transfer SWITCH TO GENERATOR.
- PROVIDE AND INSTALL 3-3/0 THWN CU + 1-#6 THWN CU GND IN 2" CONDUIT FROM AUTOMATIC TRANSFER SWITCH THE PUMP CONTROL PANEL.
- PROVIDE AND INSTALL 3-3/0 THWN CU + 1-#6 THWN CU GND IN 2" CONDUIT FROM SERVICE DISCONNECT TO AUTOMATIC TRANSFER SWITCH.
- PROVIDE AND INSTALL 2-#12 THWN CU + 1-#12 THWN CU GND IN 3/4" CONDUIT FROM AUTOMATIC TRANSFER SWITCH TO THE GENERATOR FOR GENERATOR START CONTROLS.
- PROVIDE AND INSTALL 2-#12 THWN CU + 1-#12 THWN CU GND IN 3/4" CONDUIT FROM PUMP CONTROL PANEL TO THE GENERATOR FOR 120V AC POWER (BATTERY CHARGER AND ANTI-CONDENSATION).
- PROVIDE AND INSTALL 3-#12 + 1-#12 GND IN 3/4" CONDUIT FROM PUMP CONTROL PANEL TO THE EXISTING ODOR CONTROL PANEL.
- $\langle 17 \rangle$ PROVIDE AND INSTALL THREE (3) 2" SCHEDULE 80 PVC CONDUITS FROM WET WELL TO JUNCTION BOX.
- EXISTING SITE LIGHT, DATA FLOW SYSTEM (DFS) ANTENNA AND DFS TOWER TO REMAIN. SITE LIGHT IS MOUNTED ON DFS TOWER.
- 19 PROVIDE AND INSTALL 1" CONDUIT FROM DFS ANTENNA TO PUMP CONTROL PANEL. CONFIRM CONDUIT SIZE WITH DFS. DFS SHALL INSTALL COAXIAL CABLE. ALSO PROVIDE AND INSTALL 2-#12 + 1-#12 GND IN 3/4" CONDUIT FROM PUMP CONTROL PANEL TO EXISTING SITE LIGHTS MOUNTED ON DFS ÄNTENNA. FIELD VERIFY CONDUCTOR COUNT AND VOLTAGE.
- 20 EXISTING SITE LIGHT TO REMAIN.
- PROVIDE AND INSTALL 2-#12 + 1-#12 GND IN 3/4" CONDUIT FROM EXISTING SITE LIGHT ON DFS TOWER IN KEYED NOTE #19 TO EXISTING SITE LIGHT IN KEYED NOTE #20. FIELD VERIFY CONDUCTOR COUNT AND VOLTAGE.
- $\langle 22
 angle$ existing gravity main to be replaced. Refer to civil drawings.
- PROPOSED LOCATION FOR RELOCATED AUTOMATIC TRANSFER SWITCH. FRONT DOOR OF AUTOMATIC TRANSFER SWITCH SHALL FACE SOUTH. PROVIDE NEW CONCRETE SLAB. CONCRETE SLAB TO BE 6" IN DEPTH, WITH 3" OF THE SLAB EXTENDING ABOVEGROUND. CONCRETE PAD SHALL EXTEND OUT FROM AUTOMATIC TRANSFER SWITCH 4" ON

GENERAL NOTES:

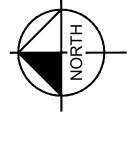- 1. MANATEE COUNTY WILL HAVE FIRST RIGHT OF REFUSAL ON ANY EQUIPMENT THAT IS DEMOLISHED OR
- 2. ROUTING AND DEPTH OF EXISTING CONDUITS IS UNKNOWN.
- 3. CONDUIT ROUTING SHOWN IS DIAGRAMMATICAL.
- 4. NEW CONDUIT TO BE INSTALLED SHALL BE FIELD ROUTED BASED ON EXISTING CONDITIONS.
- 5. WHERE POSSIBLE, EXISTING CONDUIT MAY BE INTERCEPTED AND REROUTED.
- 6. ALL EXISTING CONDUIT TO BE REUSED SHALL BE CLEANED WITH MANDREL PRIOR TO INSTALLING CONDUIT.
- 7. ALL RACEWAY SYSTEMS (NEW CONDUIT AND REUSED CONDUIT) SHALL COMPLY WITH NEC ARTICLE 352.26 OR AS APPLICABLE. PROVIDE AND INSTALL IN GROUND PULL BOXES (QUAZITE PG1324BA18 AND LID OR EQUAL).
- 8. WHERE/IF REQUIRED, IN GROUND PULL BOXES SHALL BE INSTALLED AT LOCATIONS THAT AVOID VEHICULAR
- 9. NOT ALL REQUIRED CONDUITS AND CONDUCTORS SHOWN FOR CLARITY. REFERENCE OTHER SHEETS FOR ADDITIONAL CONDUIT OR CONDUCTORS THAT ARE REQUIRED.







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NORTH COUNTY METAL GRAVITY SEWER PIPE REPLACEMENTS

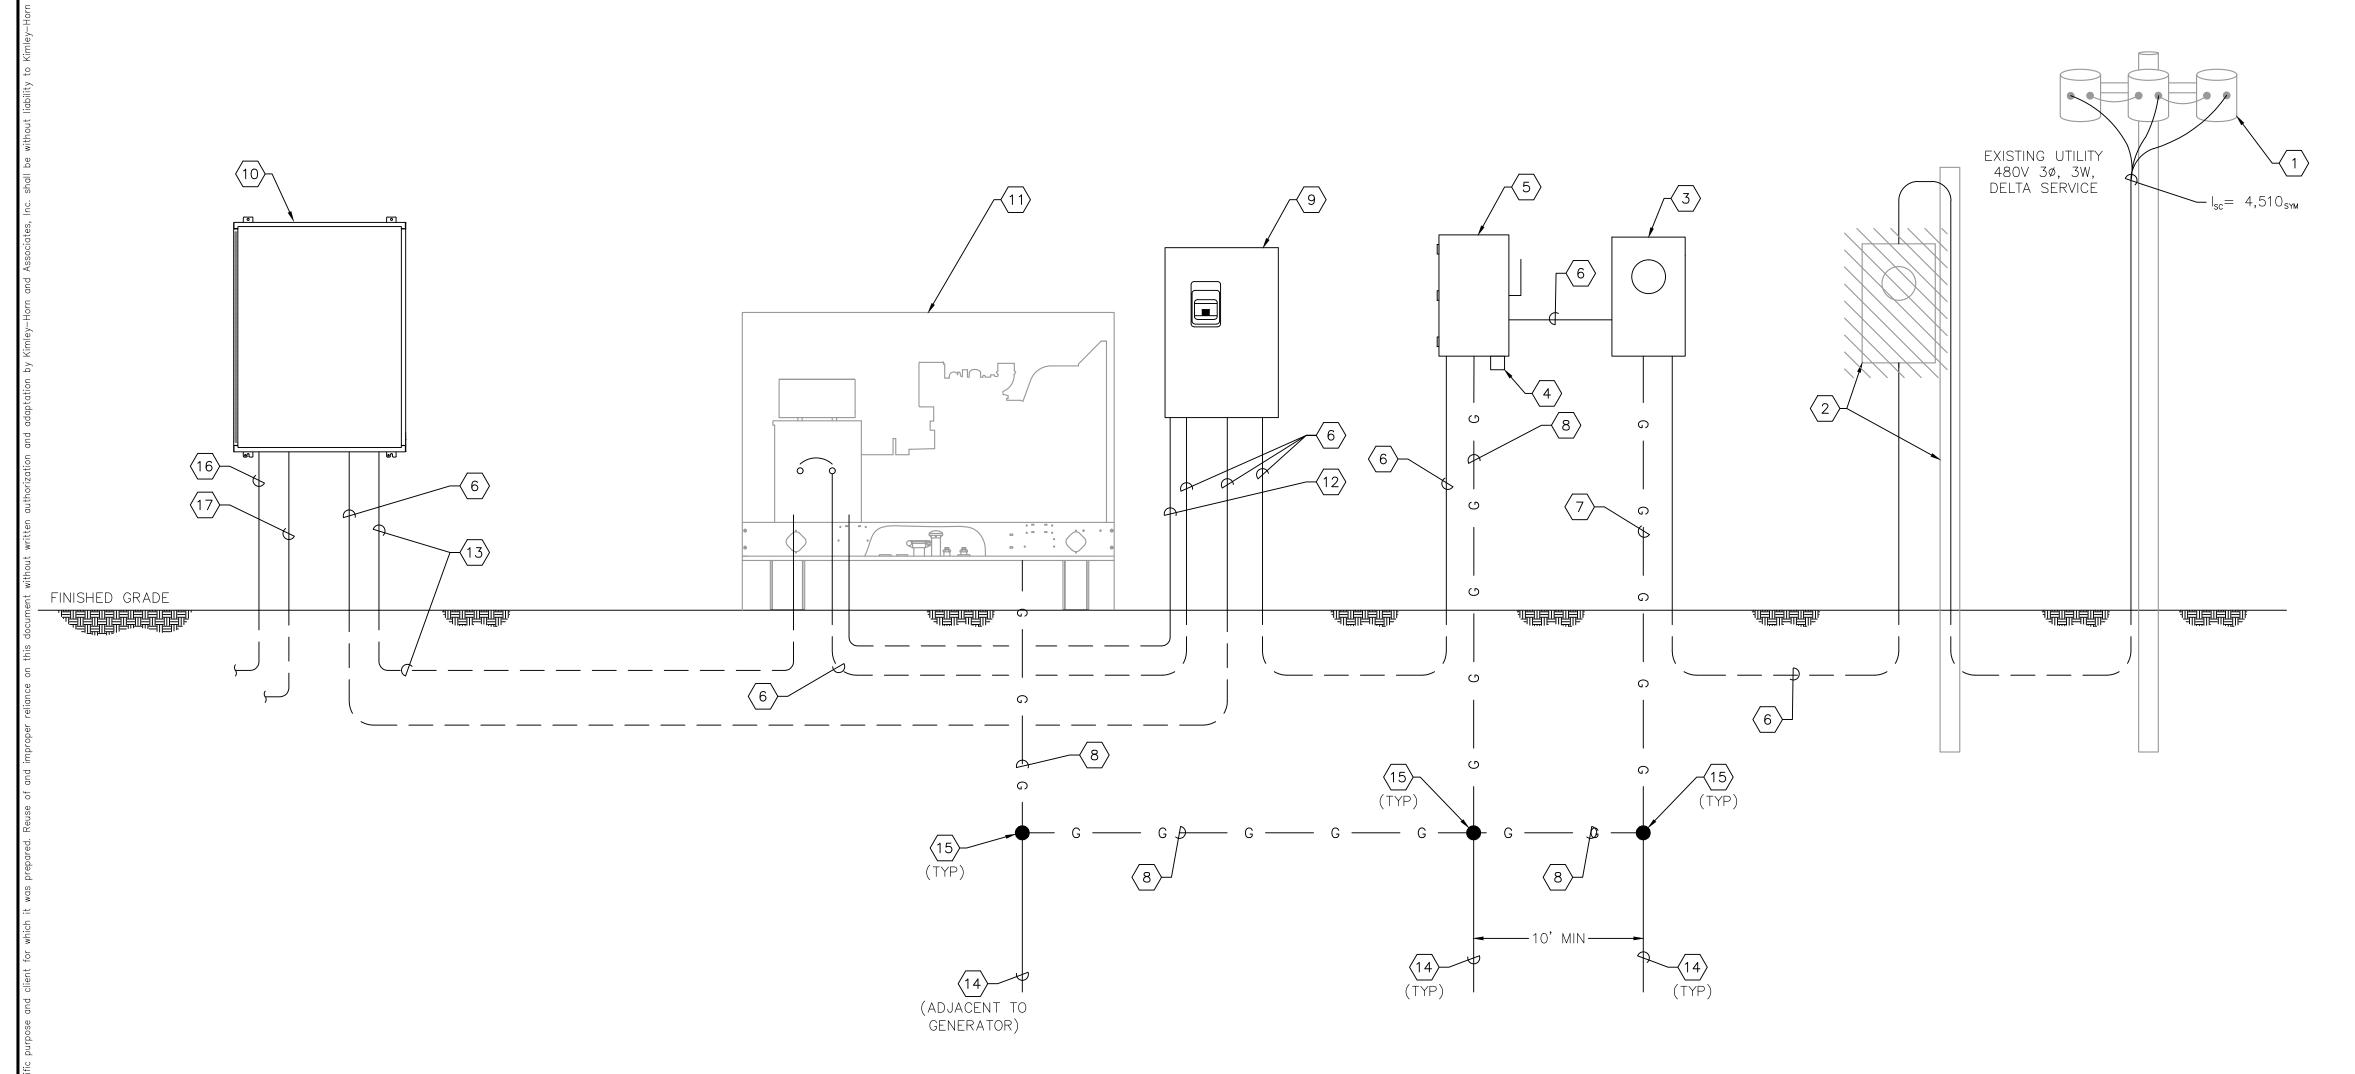
TIMOTHY THOMAS, P.E. FL LICENSE NUMBER

FL DATE:

LICENSED PROFESSIONAL

47079

RTU #546 - LS N1C **ELECTRICAL SITE PLAN** SHEET NUMBER



RTU #546 - LS N1C ONE LINE DIAGRAM

ONE LINE DIAGRAM NOTES:

- (1) EXISTING UTILITY POLE-MOUNTED TRANSFORMERS TO REMAIN. NO WORK REQUIRED.
- EXISTING UTILITY DISTRIBUTION POLE TO REMAIN. EXISTING METER TO BE REMOVED. COORDINATE ALL REQUIREMENTS WITH FPL.
- NEW 200A, 480V, 30 METER SOCKET TO BE PROVIDED BY MANATEE COUNTY AND INSTALLED BY CONTRACTOR. GROUND METER SOCKET PER FPL SPECIFICATIONS. COORDINATE NEW ELECTRICAL SERVICE ENTRANCE REQUIREMENTS WITH FPL.
- $\langle 4 \rangle$ NEW LIGHTNING ARRESTOR TO BE PROVIDED BY MANATEE COUNTY AND INSTALLED BY CONTRACTOR.
- NEW 200A, 600V, 3-POLE FUSED DISCONNECT SWITCH TO BE PROVIDED BY MANATEE COUNTY AND INSTALLED BY CONTRACTOR. DISCONNECT TO BE FUSED AT 200A WITH CLASS RK5 FUSES.
- $\langle 6 \rangle$ PROVIDE AND INSTALL 3-3/0 THWN CU + 1-#6 THWN CU GND IN 2"C.
- $\langle 7 \rangle$ provide and install #8 cu grounding electrode conductor. Verify/coordinate requirements with FPL.
- 8 PROVIDE AND INSTALL #4 CU GROUNDING ELECTRODE CONDUCTOR.
- 9 EXISTING AUTOMATIC TRANSFER SWITCH (ATS) TO BE REUSED, BUT RELOCATED. REFER TO SHEET E-2.

- (10) NEW PUMP CONTROL PANEL TO BE PROVIDED BY MANATEE COUNTY AND INSTALLED BY CONTRACTOR.
- (11) EXISTING GENERATOR TO REMAIN AND BE REUSED.
- PROVIDE AND INSTALL 2-#12+1-#12 GND IN 3/4" CONDUIT FROM AUTOMATIC TRANSFER SWITCH TO THE GENERATOR FOR GENERATOR START CONTROLS.
- PROVIDE AND INSTALL 2-#12 + 1-#12 GND IN 3/4" CONDUIT FROM PUMP CONTROL PANEL TO THE GENERATOR FOR 120V AC POWER (BATTERY CHARGER AND ANTI-CONDENSATION).
- PROVIDE AND INSTALL 5/8" X 10'-0" COPPER CLAD GROUNDING ELECTRODE. ELECTRODES TO BE SPACED A MINIMUM OF 10 FEET APART.
- (15) EXOTHERMIC WELD TO GROUND ROD.
- PROVIDE AND INSTALL 3-#12+1-#12 GND IN 3/4" CONDUIT FROM PUMP CONTROL PANEL TO THE NEW ODOR CONTROL PANEL.
- PROVIDE AND INSTALL 2-#12 + 1-#12 GND IN 3/4" CONDUIT FROM PUMP CONTROL PANEL TO EXISTING SITE LIGHTS. FIELD VERIFY CONDUCTOR COUNT AND VOLTAGE. PROVIDE AND INSTALL 1" CONDUIT FROM PUMP CONTROL PANEL TO EXISTING DFS ANTENNA. COAXIAL CABLE TO BE INSTALLED BY DFS.

LIFT STATION LOAD CALCULATION

MOTORS:

 PUMP NO. 2:
 50.0
 HP, 480 VAC, 3
 Ø, 65.0
 A

 MOTOR SUB-TOTAL
 130.0
 A

PUMP NO. 1: <u>50.0</u> HP, <u>480</u> VAC, <u>3</u> Ø, <u>65.0</u> A

+ 25% OF LARGEST MOTOR

SUB-TOTAL <u>147.0</u> A

<u>17.0</u> A

<u>20.0</u> A

<u>167.0</u> A

AUXILIARY EQUIPMENT

TOTAL MAXIMUM PHASE AMPERES

SERVICE SIZE:

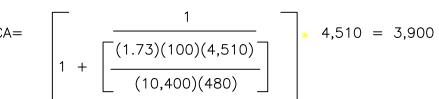
<u>200</u> A, <u>480</u> VAC, <u>3</u> Ø, <u>3</u> – WIRE MINIMUM.

SHORT CIRCUIT CALCULATIONS

AVAILABLE SHORT-CIRCUIT CURRENT AT 480V UTILITY SERVICE IS 13,532 AMPERES.
CONTRACTOR TO CONFIRM WITH THE UTILITY

UTILITY SERVICE: 480V, 3 PH, TRANSFORMER BANK AVAILABLE FAULT CURRENT AT SECONDARY SIDE OF UTILITY'S TRANSFORMER: 4,510 AMP RMS SYM. SERVICE CONDUCTOR LENGTH: 100 FEET

SERVICE CONDUCTOR SIZE: 3/0 THWN CU. FUSE RATING: 200 AMPS ISCA AT LINE SIDE OF SERVICE DISCONNECT:



SHORT CIRCUIT CURRENT AVAILABLE AT LINE SIDE LUGS OF THE FUSED DISCONNECT = 3,900 AMPS RMS.

GENERAL NOTES:

1. NOT ALL REQUIRED CONDUITS AND CONDUCTORS SHOWN FOR CLARITY. REFERENCE OTHER SHEETS FOR ADDITIONAL CONDUIT OR CONDUCTORS THAT ARE REQUIRED.



 No.
 REVISIONS
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 BY

Kimley»Horn

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PHONE: 727-547-3999
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Manatee County

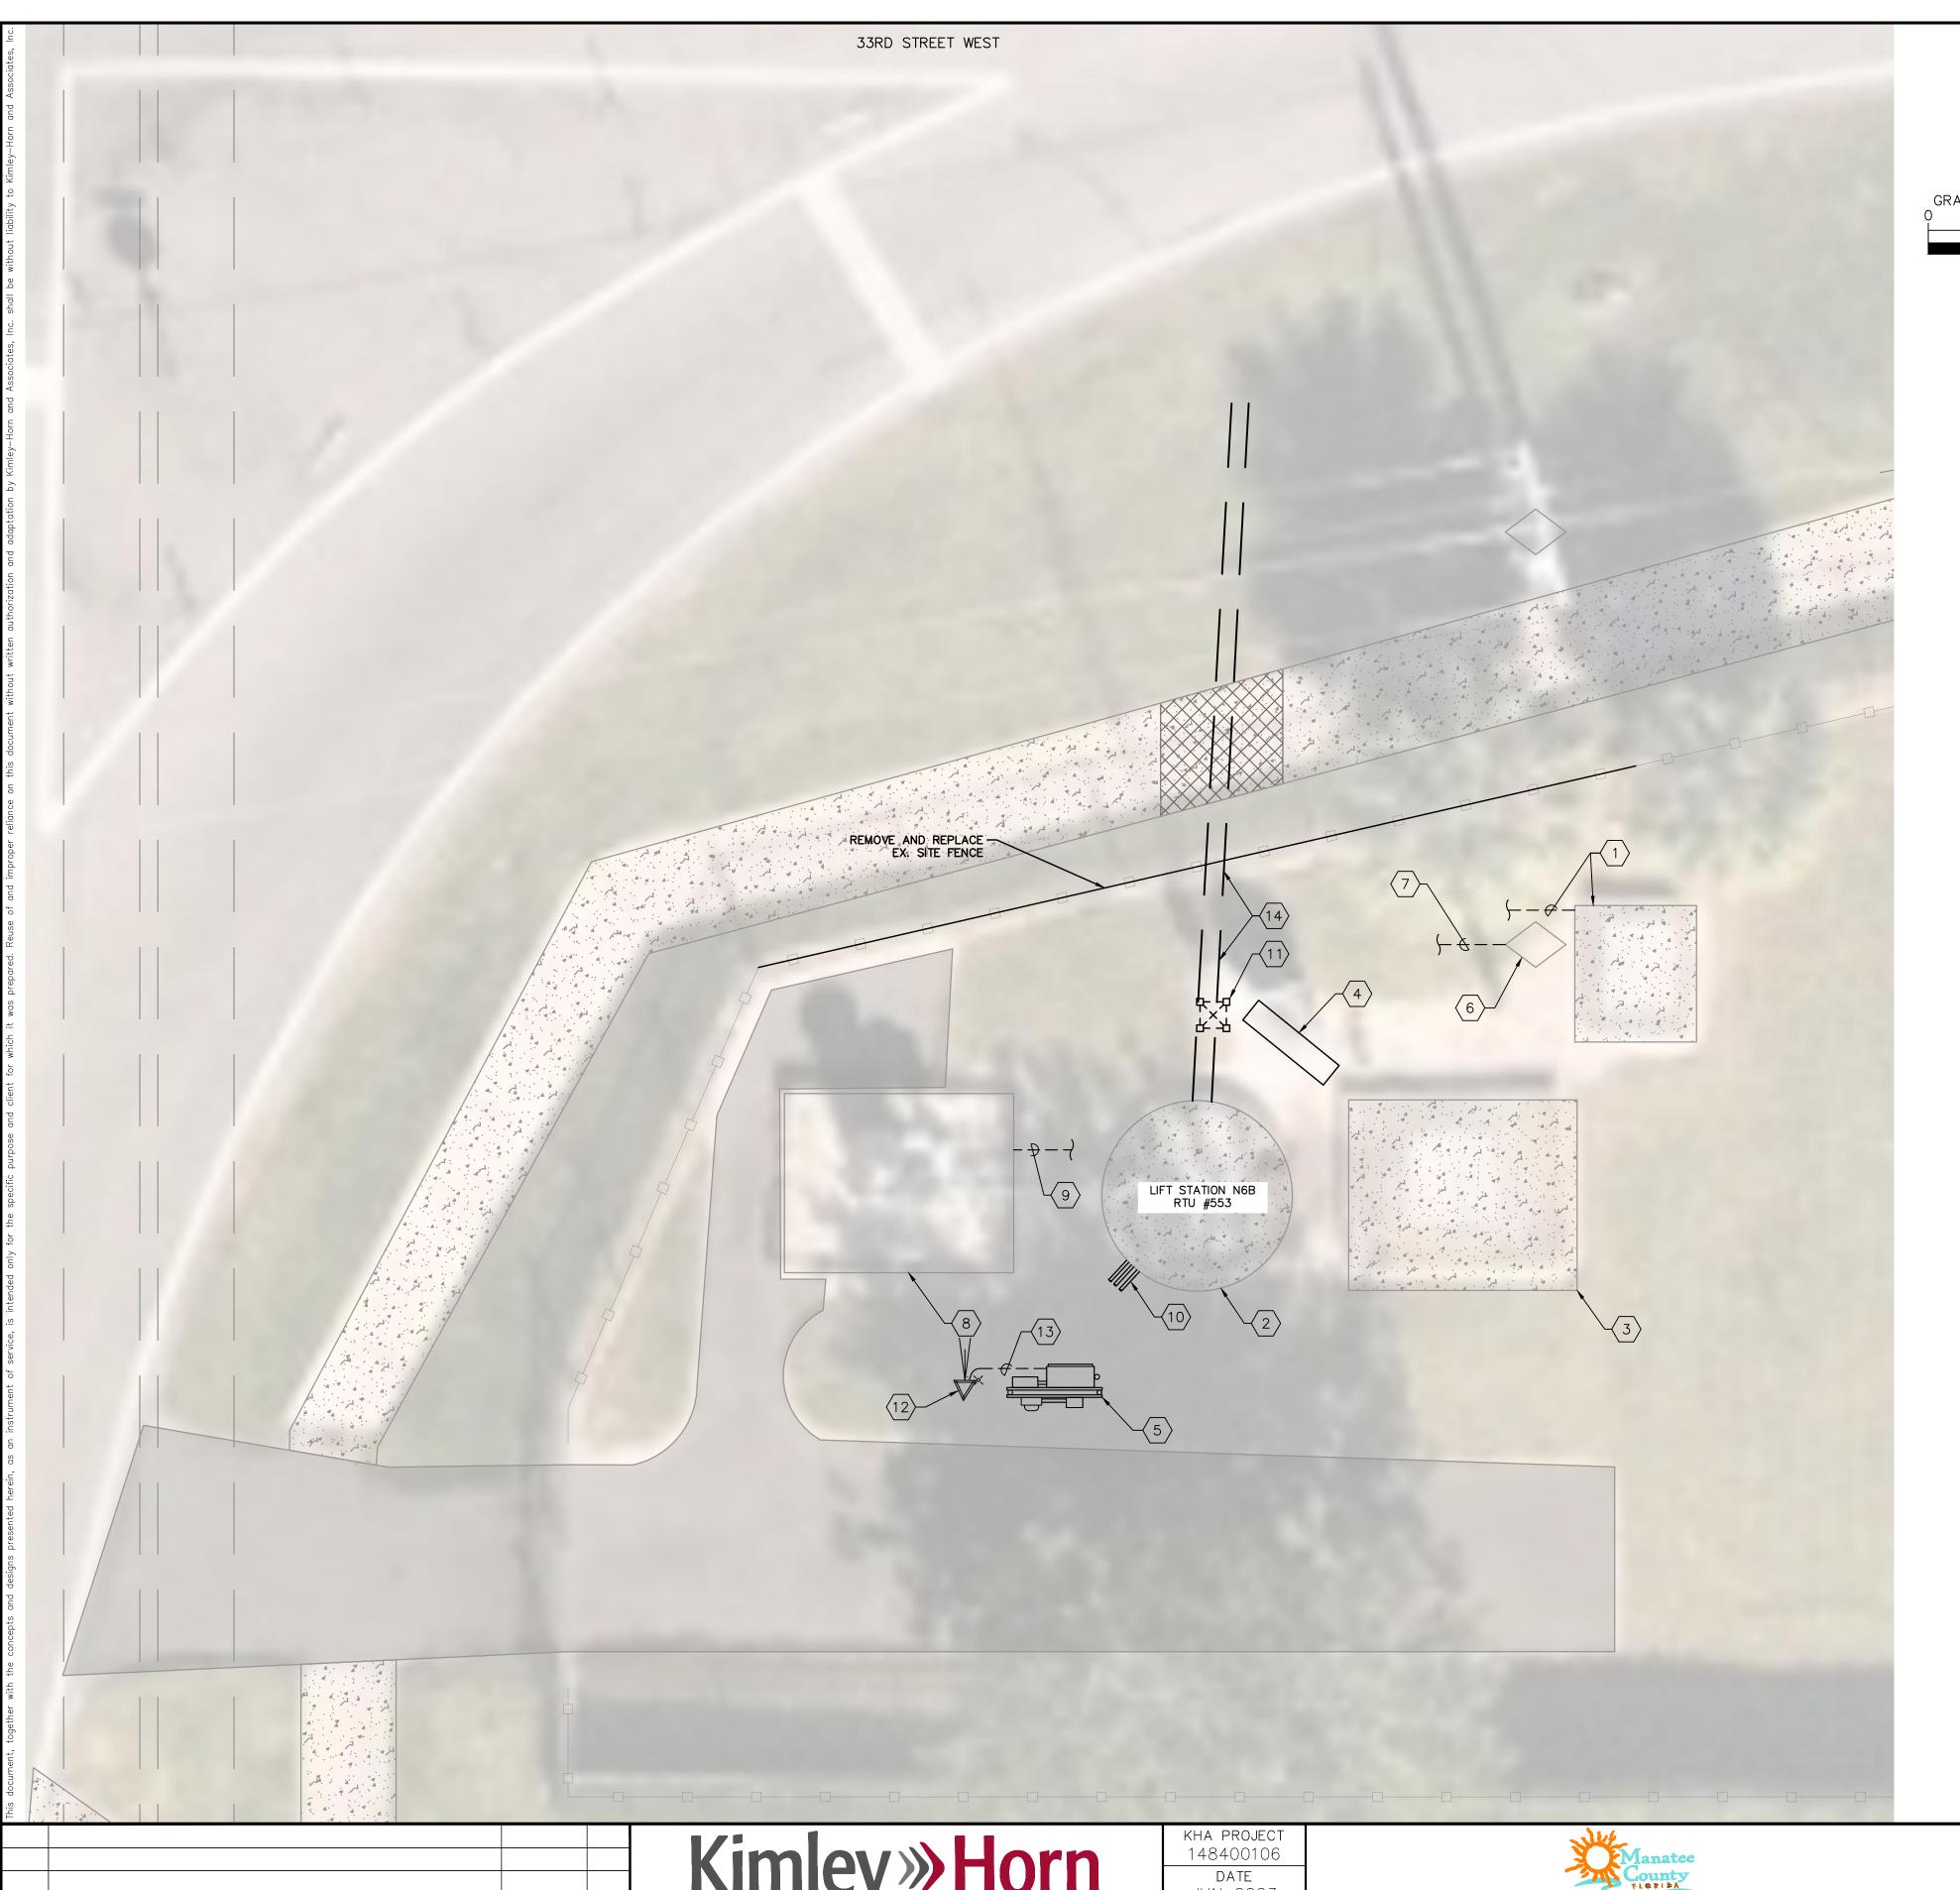
NORTH COUNTY METAL GRAVITY SEWER PIPE REPLACEMENTS

TIMOTHY THOMAS, P.E.

FL LICENSE NUMBER
47079

FL DATE:

RTU #546 - LS N1C ONE LINE DIAGRAM SHEET NUMBER







ONE LINE DIAGRAM NOTES:

- EXISTING FLOW METER VAULT TO REMAIN. PROVIDE 2/C-#16 TWISTED SHIELDED CABLE IN 1" CONDUIT FROM FROM METER TRANSMITTER TO PUMP CONTROL PANEL FOR FLOW METER 4-20mA FLOW METER SIGNAL. CONFIRM REQUIREMENTS WITH MANATEE COUNTY.
- $\langle 2 \rangle$ EXISTING 8' I.D. WET WELL.
- (3) EXISTING VALVE VAULT. NO WORK REQUIRED.
- EXISTING PUMP CONTROL PANEL, DISCONNECT, ELECTRIC METER AND WET WELL CABLES TO BE REMOVED AND REPLACED. REFER TO KEYED NOTE #5 FOR NEW EQUIPMENT LOCATION.
- \langle 5 angle NEW DISCONNECT, ELECTRIC METER, PUMP CONTROL PANEL, DFS BOX AND JUNCTION BOX. REFER TO SEWAGE LIFT STATION METER & ELECTRIC DETAILS (MANATEE STANDARD US-23) AND SEWAGE LIFT STATION CONTROL PANEL (MANATEE STANDARD US-24) ON SHEET E-8. ALL EQUIPMENT TO BE PROVIDED BY MANATEE COUNTY AND INSTALLED BY THE CONTRACTOR.
- 6 EXISTING UTILITY DISTRIBUTION POLE TO REMAIN. COORDINATE ALL REQUIREMENTS WITH FPL. REFER ALSO TO ONE LINE ON SHEET E-5.
- $\langle 7 \rangle$ PROVIDE AND INSTALL 3-1/0 THWN CU + 1-1/0 THWN CU NEUTRAL IN 2" CONDUIT FROM EXISTING UTILITY DISTRIBUTION POLE TO NEW ELECTRIC METER. RÉFER ALSO TO ONE LINE ON SHEET E-5.
- (8) EXISTING ODOR CONTROL UNIT TO REMAIN.
- PROVIDE AND INSTALL 3-#12 + 1-#12 GND IN 3/4" CONDUIT FROM PUMP CONTROL PANEL TO THE EXISTING ODOR CONTROL PANEL.
- $\langle 10 \rangle$ PROVIDE AND INSTALL THREE (3) 2" SCHEDULE 80 PVC CONDUITS FROM WET WELL TO JUNCTION BOX.
- EXISTING DATA FLOW SYSTEMS (DFS) ANTENNA AND TOWER TO BE REMOVED. REFER TO KEYED NOTE #12 FOR NEW DFS EQUIPMENT LOCATION.
- $\langle 12 \rangle$ NEW DFS TOWER, ANTENNA AND AREA LIGHT TO BE PROVIDED BY MANATEE COUNTY AND INSTALLED BY CONTRACTOR. REFER TO SEWAGE LIFT STATION METER & ELECTRIC DETAILS (MANATEE STANDARD US-23) ON
- (13) PROVIDE AND INSTALL 1" CONDUIT FROM DFS ANTENNA TO PUMP CONTROL PANEL. CONFIRM CONDUIT SIZE WITH DFS. DFS SHALL INSTALL COAXIAL CABLE. ALSO PROVIDE AND INSTALL 2-#12 + 1-#12 GND IN 3/4" CONDUIT FROM PUMP CONTROL PANEL TO NEW SITE LIGHT MOUNTED ON DFS ANTENNA.
- $\langle 14 \rangle$ EXISTING GRAVITY MAIN TO BE REPLACED. REFER TO CIVIL DRAWINGS.

GENERAL NOTES:

- 1. MANATEE COUNTY WILL HAVE FIRST RIGHT OF REFUSAL ON ANY EQUIPMENT THAT IS DEMOLISHED OR
- 2. ROUTING AND DEPTH OF EXISTING CONDUITS IS UNKNOWN.
- 3. CONDUIT ROUTING SHOWN IS DIAGRAMMATICAL.
- 4. NEW CONDUIT TO BE INSTALLED SHALL BE FIELD ROUTED BASED ON EXISTING CONDITIONS.
- 5. WHERE POSSIBLE, EXISTING CONDUIT MAY BE INTERCEPTED AND REROUTED.
- 6. ALL EXISTING CONDUIT TO BE REUSED SHALL BE CLEANED WITH MANDREL PRIOR TO INSTALLING CONDUIT.
- 7. ALL RACEWAY SYSTEMS (NEW CONDUIT AND REUSED CONDUIT) SHALL COMPLY WITH NEC ARTICLE 352.26 OR AS APPLICABLE. PROVIDE AND INSTALL IN GROUND PULL BOXES (QUAZITE PG1324BA18 AND LID OR EQUAL).
- 8. WHERE/IF REQUIRED, IN GROUND PULL BOXES SHALL BE INSTALLED AT LOCATIONS THAT AVOID VEHICULAR TRAFFIĆ.
- 9. NOT ALL REQUIRED CONDUITS AND CONDUCTORS SHOWN FOR CLARITY. REFERENCE OTHER SHEETS FOR ADDITIONAL CONDUIT OR CONDUCTORS THAT ARE REQUIRED.



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NORTH COUNTY METAL GRAVITY SEWER PIPE REPLACEMENTS

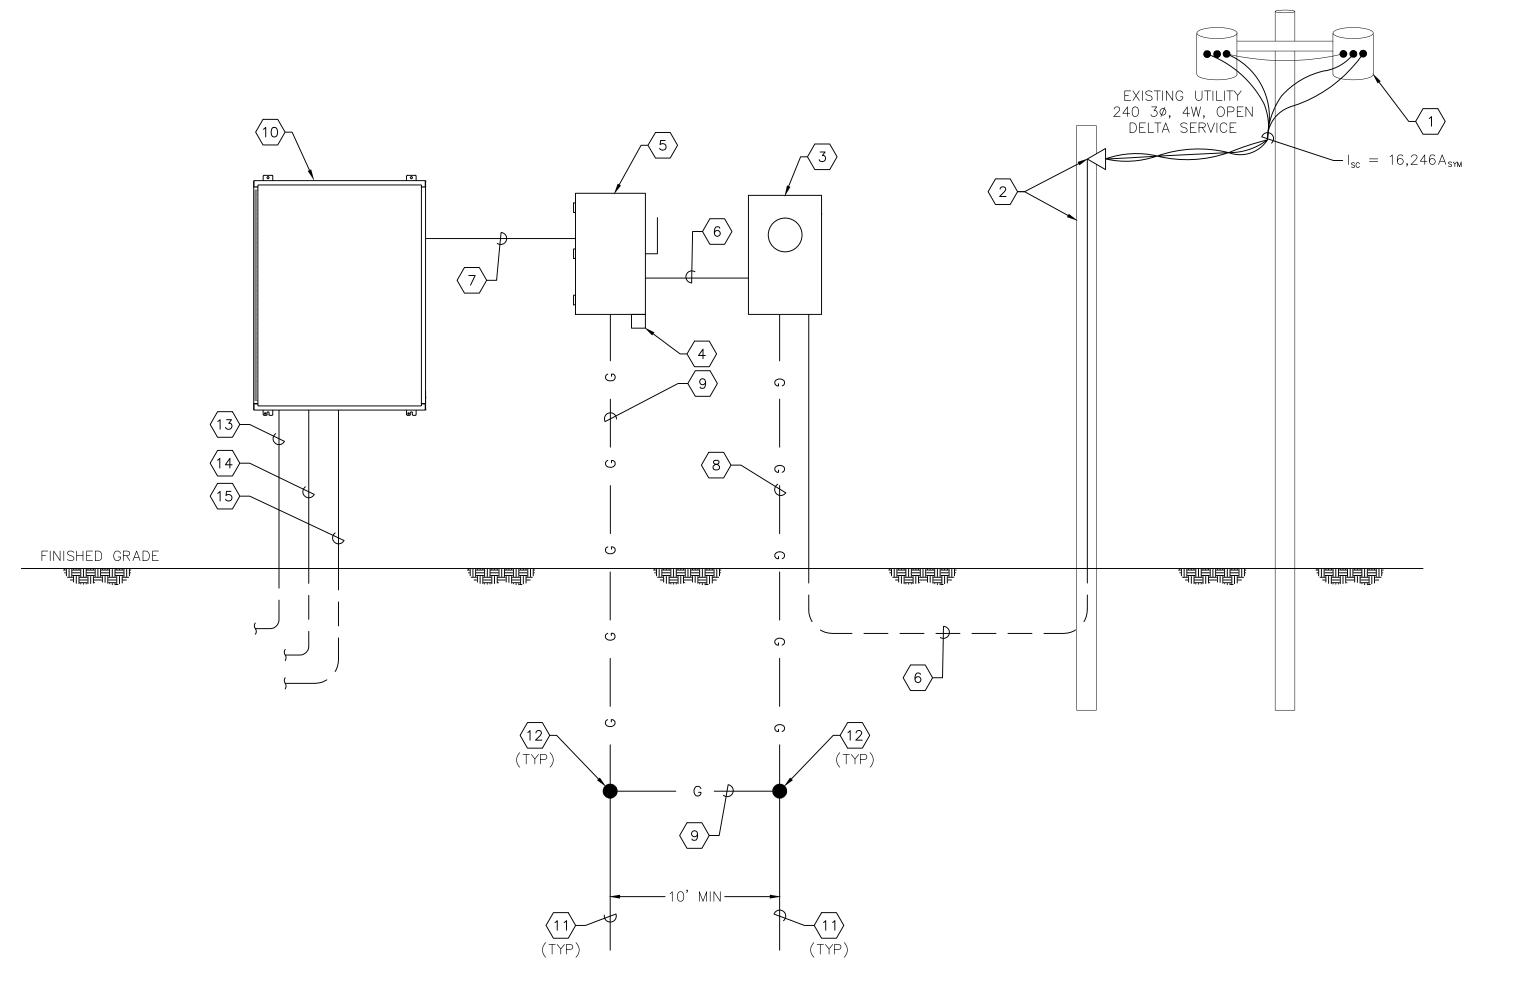
TIMOTHY THOMAS, P.E.

LICENSED PROFESSIONAL

FL LICENSE NUMBER 47079

FL DATE:

RTU #553 - LS N6B **ELECTRICAL SITE PLAN** SHEET NUMBER



RTU #553 - LS N6B ONE LINE DIAGRAM

ONE LINE DIAGRAM NOTES:

- EXISTING UTILITY POLE-MOUNTED TRANSFORMERS TO REMAIN. NO WORK REQUIRED.
- $\langle 2 \rangle$ EXISTING UTILITY DISTRIBUTION POLE WITH WEATHERHEAD TO REMAIN. COORDINATE ALL REQUIREMENTS WITH FPL.
- NEW 200A, 240V, 3Ø, METER SOCKET TO BE PROVIDED BY MANATEE COUNTY AND INSTALLED BY CONTRACTOR. GROUND METER SOCKET PER FPL SPECIFICATIONS. COORDINATE NEW ELECTRICAL SERVICE ENTRANCE REQUIREMENTS WITH FPL.
- 4 PROVIDE AND INSTALL LIGHTNING ARRESTOR.
- NEW 200A, 240V, 3-POLE FUSED DISCONNECT SWITCH TO BE PROVIDED BY MANATEE COUNTY AND INSTALLED BY CONTRACTOR. FUSE SWITCH AT 150 AMPERES WITH CLASS RK5 FUSES.
- 6 PROVIDE AND INSTALL 3-1/0 THWN CU + 1-1/0 THWN CU NEUTRAL IN 2"C.
- 7 PROVIDE AND INSTALL 3-1/0 THWN CU + 1-1/0 THWN CU NEUTRAL + 1-#6 THWN CU GND IN 2"C.
- 8 PROVIDE AND INSTALL #8 CU GROUNDING ELECTRODE CONDUCTOR. VERIFY/COORDINATE REQUIREMENTS WITH FPL.

- 9 PROVIDE AND INSTALL #4 CU GROUNDING ELECTRODE CONDUCTOR.
- (10) NEW PUMP CONTROL PANEL TO BE PROVIDED BY MANATEE COUNTY AND INSTALLED BY CONTRACTOR.
- PROVIDE AND INSTALL 5/8" X 10'-0" COPPER CLAD GROUNDING ELECTRODE. ELECTRODES TO BE SPACED A MINIMUM OF 10 FEET APART.
- (12) EXOTHERMIC WELD TO GROUND ROD.
- PROVIDE AND INSTALL 3-#12 + 1-#12 GND IN 3/4" CONDUIT FROM PUMP CONTROL PANEL TO THE NEW ODOR CONTROL PANEL.
- PROVIDE AND INSTALL 2-#12 + 1-#12 GND IN 3/4" CONDUIT FROM PUMP CONTROL PANEL TO NEW SITE LIGHT ON DFS TOWER.
- PROVIDE AND INSTALL 1" CONDUIT FROM PUMP CONTROL PANEL TO NEW DFS ANTENNA. COAXIAL CABLE WILL BE INSTALLED BY DFS.

LIFT STATION LOAD CALCULATION

MOTORS:

MOTOR SUB-TOTAL <u>68.0</u> A

PUMP NO. 1: <u>25.0</u> HP, <u>240</u> VAC, <u>3</u> Ø, <u>34.0</u> A

PUMP NO. 2: <u>25.0</u> HP, <u>240</u> VAC, <u>3</u> Ø, <u>34.0</u> A

+ 25% OF LARGEST MOTOR <u>8.5</u> A

SUB-TOTAL <u>76.5</u> A

<u>20.0</u> A

AUXILIARY EQUIPMENT

TOTAL MAXIMUM PHASE AMPERES 96.5 A

SERVICE SIZE:

<u>150</u> A, <u>240</u> VAC, <u>3</u> Ø, <u>4</u> - WIRE MINIMUM.

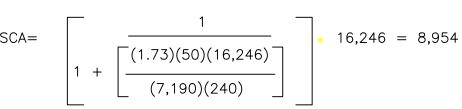
SHORT CIRCUIT CALCULATIONS

AVAILABLE SHORT—CIRCUIT CURRENT AT 240V UTILITY SERVICE IS 16,246 AMPERES.

CONTRACTOR TO CONFIRM WITH THE UTILITY

ISCA AT LINE SIDE OF SERVICE DISCONNECT:

UTILITY SERVICE: 240V, 3 PH, TRANSFORMER BANK AVAILABLE FAULT CURRENT AT SECONDARY SIDE OF UTILITY'S TRANSFORMER: 16,246 AMP RMS SYM. SERVICE CONDUCTOR LENGTH: 50 FEET SERVICE CONDUCTOR SIZE: 1/0 THWN CU.



SHORT CIRCUIT CURRENT AVAILABLE AT LINE SIDE LUGS OF THE FUSED DISCONNECT = 8,954 AMPS RMS.

GENERAL NOTES:

FUSE RATING: 150 AMPS

1. NOT ALL REQUIRED CONDUITS AND CONDUCTORS SHOWN FOR CLARITY. REFERENCE OTHER SHEETS FOR ADDITIONAL CONDUIT OR CONDUCTORS THAT ARE REQUIRED.



No. REVISIONS DATE BY

Kimley» Horn

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PHONE: 727-547-3999
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148400106

DATE
JUN 2023

SCALE AS SHOWN

DESIGNED BY TDT

CHECKED BY GLW MANATEE COUNTY

DRAWN BY

Manatee County

NORTH COUNTY METAL GRAVITY SEWER
PIPE REPLACEMENTS

TIMOTHY THOMAS, P.E.

FL LICENSE NUMBER
47079

FL DATE:

RTU #553 - LS N6B ONE LINE DIAGRAM SHEET NUMBER



ONE LINE DIAGRAM NOTES:

- (1) EXISTING GENERATOR TO REMAIN.
- (2) EXISTING ODOR CONTROL UNIT TO REMAIN.
- EXISTING FLOW METER VAULT TO REMAIN. PROVIDE 2/C-#16 TWISTED SHIELDED CABLE IN 1" CONDUIT FROM FROM METER TRANSMITTER TO PUMP CONTROL PANEL FOR FLOW METER 4-20mA FLOW METER SIGNAL. CONFIRM REQUIREMENTS WITH MANATEE COUNTY.
- (4) EXISTING 6' I.D. WET WELL.
- 5 EXISTING VALVE VAULT. NO WORK REQUIRED.
- 6 EXISTING PUMP CONTROL PANEL, DISCONNECT, DATA FLOW EQUIPMENT AND WET WELL CABLES TO BE REMOVED AND REPLACED. REFER TO KEYED NOTE #8 FOR NEW EQUIPMENT LOCATION.
- $\langle 7 \rangle$ existing data flow systems (DFS) tower, antenna and area light to be removed.
- (8) NEW ELECTRICAL SERVICE PUMP CONTROL PANEL. REFER TO SEWAGE LIFT STATION METER & ELECTRIC DETAILS (MANATEE STANDARD US-23) AND SEWAGE LIFT STATION CONTROL PANEL (MANATEE STANDARD US-24) ON SHEET E-8. ALL EQUIPMENT TO BE PROVIDED BY MANATEE COUNTY AND INSTALLED BY THE CONTRACTOR.
- 9 NEW DFS TOWER, ANTENNA AND AREA LIGHT TO BE PROVIDED BY MANATEE COUNTY AND INSTALLED BY CONTRACTOR. REFER TO SEWAGE LIFT STATION METER & ELECTRIC DETAILS (MANATEE STANDARD US-23) ON
- EXISTING AUTOMATIC TRANSFER SWITCH TO BE REUSED AFTER RELOCATION. AUTOMATIC TRANSFER SWITCH TO BE RELOCATED TO NEW RACK. REFER TO KEYED NOTE #22 FOR PROPOSED LOCATION.
- EXISTING UTILITY DISTRIBUTION POLE TO REMAIN. EXISTING METER TO BE REMOVED. COORDINATE ALL REQUIREMENTS WITH FPL. REFER ALSO TO ONE LINE ON SHEET E-7.
- PROVIDE AND INSTALL 3-#3 THWN CU + 1-#8 THWN CU GND IN 1-1/2" CONDUIT FROM EXISTING UTILITY DISTRIBUTION POLE TO NEW ELECTRIC METER."
- PROVIDE AND INSTALL 3-#3 THWN CU + 1-#8 THWN CU GND IN 1-1/2" CONDUIT FROM AUTOMATIC TRANSFER SWITCH TO GENERATOR.
- PROVIDE AND INSTALL 3-#3 THWN CU + 1-#8 THWN CU GND IN 1-1/2" CONDUIT FROM AUTOMATIC TRANSFER SWITCH THE PUMP CONTRÖL PANEL.
- PROVIDE AND INSTALL 3-#3 THWN CU + 1-#8 THWN CU GND IN 1-1/2" CONDUIT FROM SERVICE DISCONNECT TO AUTOMATIC TRANSFER SWITCH.
- PROVIDE AND INSTALL 2-#12 THWN CU + 1-#12 THWN CU GND IN 3/4" CONDUIT FROM AUTOMATIC TRANSFER SWITCH TO THE GENERATOR FOR GENERATOR START CONTROLS.
- PROVIDE AND INSTALL 2-#12 THWN CU + 1-#12 THWN CU GND IN 3/4" CONDUIT FROM PUMP CONTROL PANEL TO THE GENERATOR FOR 120V AC POWER (BATTERY CHARGER AND ANTI-CONDENSATION).
- PROVIDE AND INSTALL 3-#12 + 1-#12 GND IN 3/4" CONDUIT FROM PUMP CONTROL PANEL TO THE NEW ODOR
- PROVIDE AND INSTALL THREE (3) 2" SCHEDULE 80 PVC CONDUITS FROM WET WELL TO JUNCTION BOX.
- PROVIDE AND INSTALL 1" CONDUIT FROM DFS ANTENNA TO PUMP CONTROL PANEL. CONFIRM CONDUIT SIZE WITH DFS. DFS SHALL INSTALL COAXIAL CABLE. ALSO PROVIDE AND INSTALL 2-#12 + 1-#12 GND IN 3/4" CONDUIT FROM PUMP CONTROL PANEL TO NEW SITE LIGHT MOUNTED ON DFS ANTENNA.
- (21) EXISTING GRAVITY MAIN TO BE REPLACED. REFER TO CIVIL DRAWINGS.
- PROPOSED LOCATION FOR RELOCATED AUTOMATIC TRANSFER SWITCH. RELOCATED AUTOMATIC TRANSFER SWITCH SHALL BE INSTALLED ON NEW RACK. REFER TO SHEET E-13 FOR RACK ELEVATION DETAIL.

GENERAL NOTES:

- 1. MANATEE COUNTY WILL HAVE FIRST RIGHT OF REFUSAL ON ANY EQUIPMENT THAT IS DEMOLISHED OR
- 2. ROUTING AND DEPTH OF EXISTING CONDUITS IS UNKNOWN.
- 3. CONDUIT ROUTING SHOWN IS DIAGRAMMATICAL
- 4. NEW CONDUIT TO BE INSTALLED SHALL BE FIELD ROUTED BASED ON EXISTING CONDITIONS.
- 5. WHERE POSSIBLE, EXISTING CONDUIT MAY BE INTERCEPTED AND REROUTED.
- 6. ALL EXISTING CONDUIT TO BE REUSED SHALL BE CLEANED WITH MANDREL PRIOR TO INSTALLING CONDUIT.
- 7. ALL RACEWAY SYSTEMS (NEW CONDUIT AND REUSED CONDUIT) SHALL COMPLY WITH NEC ARTICLE 352.26 OR AS APPLICABLE. PROVIDE AND INSTALL IN GROUND PULL BOXES (QUAZITE PG1324BA18 AND LID OR EQUAL).
- 8. WHERE/IF REQUIRED, IN GROUND PULL BOXES SHALL BE INSTALLED AT LOCATIONS THAT AVOID VEHICULAR
- 9. NOT ALL REQUIRED CONDUITS AND CONDUCTORS SHOWN FOR CLARITY. REFERENCE OTHER SHEETS FOR ADDITIONAL CONDUIT OR CONDUCTORS THAT ARE REQUIRED.



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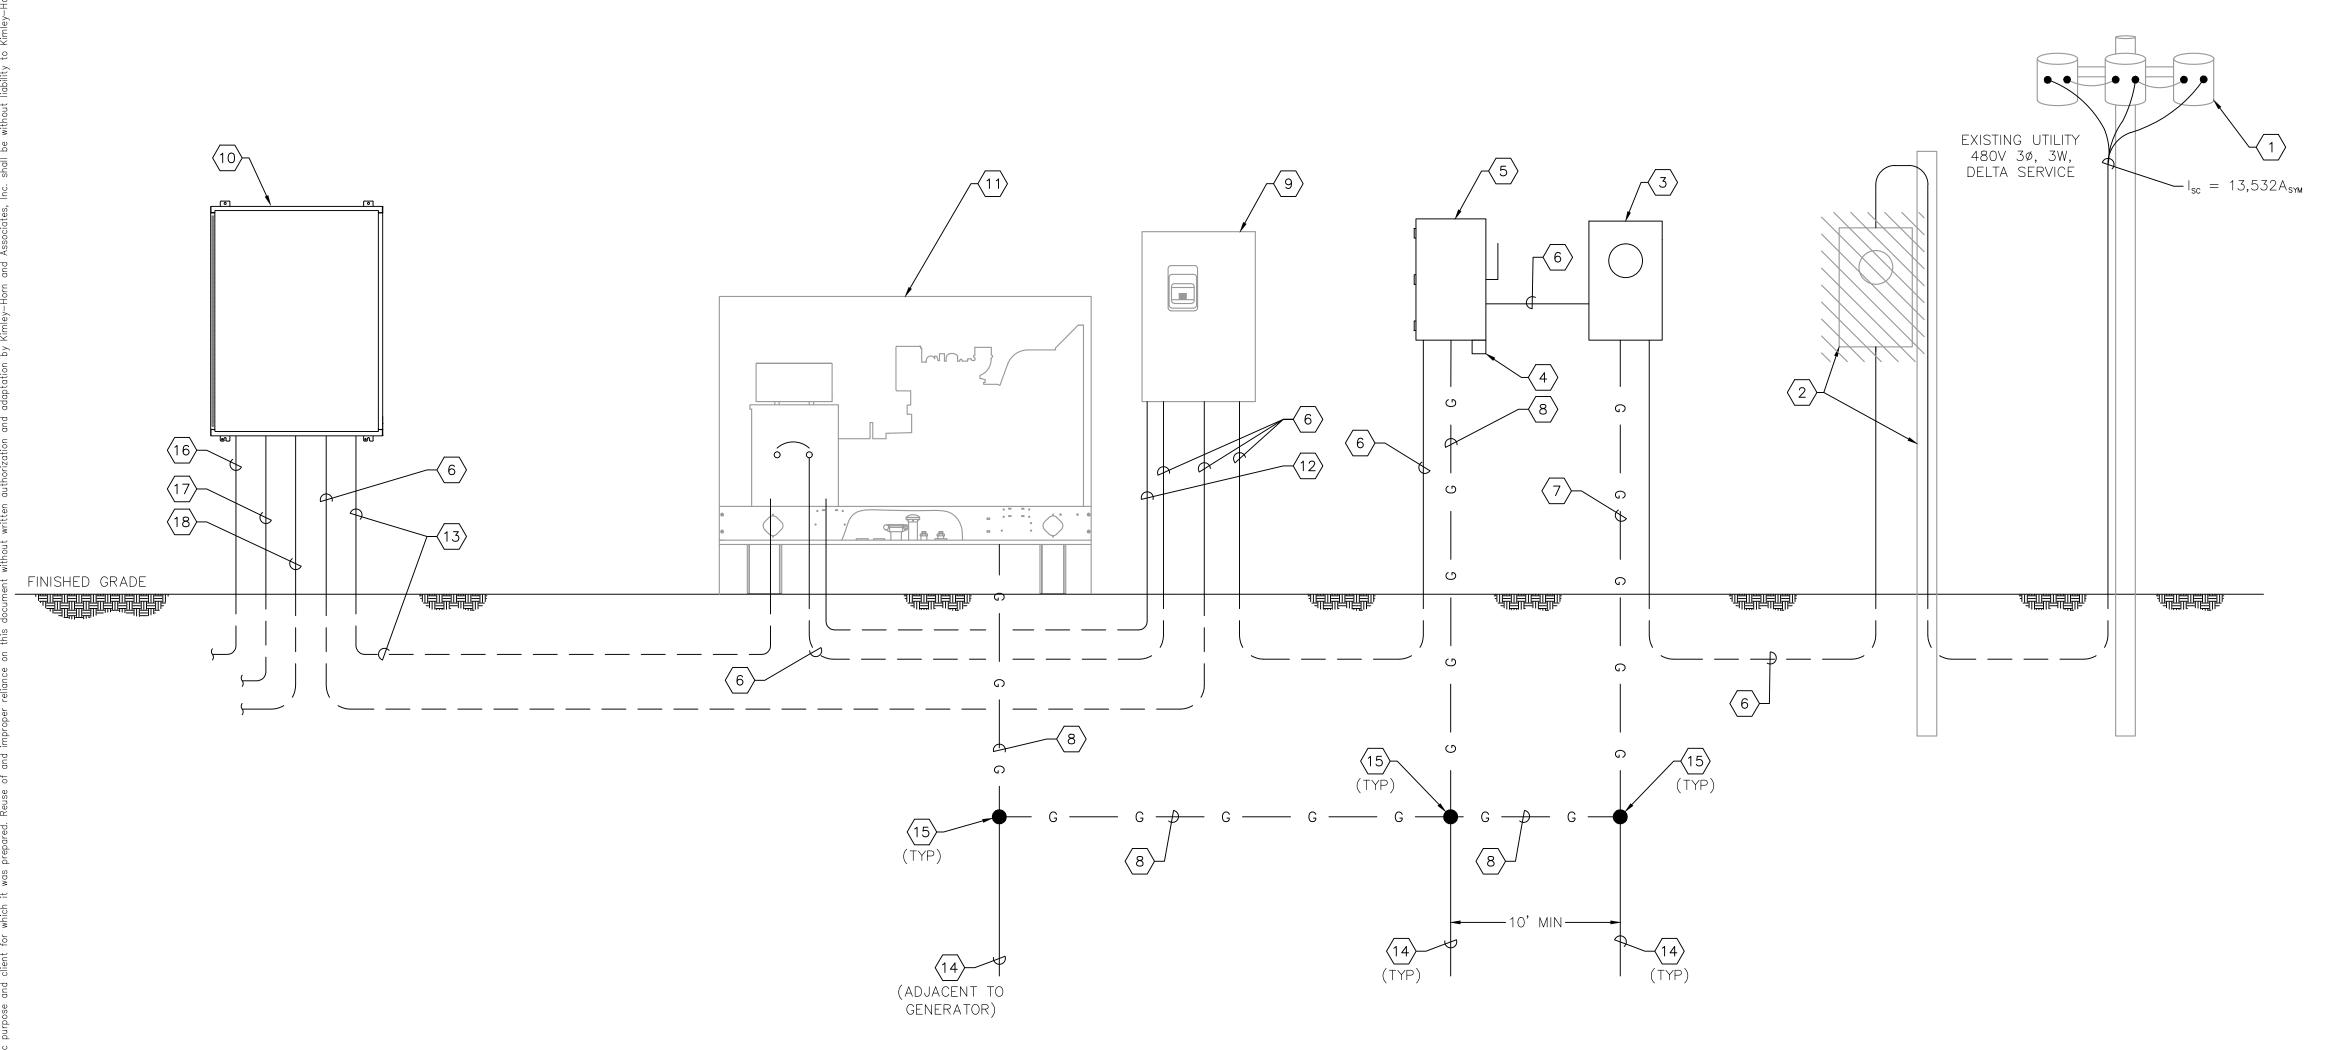
TIMOTHY THOMAS, P.E. FL LICENSE NUMBER

47079

FL DATE:

LICENSED PROFESSIONAL

RTU #554 - LS N7A ELECTRICAL SITE PLAN SHEET NUMBER



RTU #554 - LS N7A ONE LINE DIAGRAM

ONE LINE DIAGRAM NOTES:

- (1) EXISTING UTILITY POLE-MOUNTED TRANSFORMERS TO REMAIN. NO WORK REQUIRED.
- EXISTING UTILITY DISTRIBUTION POLE TO REMAIN. EXISTING METER TO BE REMOVED. COORDINATE ALL REQUIREMENTS WITH FPL.
- NEW 100A, 480V, 3Ø, METER SOCKET TO BE PROVIDED BY MANATEE COUNTY AND INSTALLED BY CONTRACTOR. GROUND METER SOCKET PER FPL SPECIFICATIONS. COORDINATE NEW ELECTRICAL SERVICE ENTRANCE REQUIREMENTS WITH FPL.
- (4) NEW LIGHTNING ARRESTOR TO BE PROVIDED BY MANATEE COUNTY AND INSTALLED BY CONTRACTOR.
- NEW 100A, 600V, 3-POLE FUSED DISCONNECT SWITCH TO BE PROVIDED BY MANATEE COUNTY AND INSTALLED BY CONTRACTOR. FUSE SWITCH AT 100 AMPERES WITH CLASS RK5 FUSES.
- $\langle 6 \rangle$ PROVIDE AND INSTALL 3-#3 THWN CU + 1-#8 THWN CU GND IN 1-1/2" CONDUIT.
- $\overline{\langle 7 \rangle}$ provide and install #8 cu grounding electrode conductor. Verify/coordinate requirements with fpl.
- 8 PROVIDE AND INSTALL #4 CU GROUNDING ELECTRODE CONDUCTOR.
- 9 EXISTING AUTOMATIC TRANSFER SWITCH TO REUSED, BUT RELOCATED TO NEW EQUIPMENT RACK. REFER TO SHEET E-6.
- $\langle 10 \rangle$ Existing automatic transfer switch (ats) to be reused, but relocated. Refer to sheet E-6.

- (11) EXISTING GENERATOR TO REMAIN.
- PROVIDE AND INSTALL 2-#12 + 1-#12 GND IN 3/4" CONDUIT FROM AUTOMATIC TRANSFER SWITCH TO THE GENERATOR FOR GENERATOR START CONTROLS.
- PROVIDE AND INSTALL 2-#12 + 1-#12 GND IN 3/4" CONDUIT FROM PUMP CONTROL PANEL TO THE GENERATOR FOR 120V AC POWER (BATTERY CHARGER AND ANTI-CONDENSATION).
- PROVIDE AND INSTALL 5/8" X 10'-0" COPPER CLAD GROUNDING ELECTRODE. ELECTRODES TO BE SPACED A MINIMUM OF 10 FEET APART.
- $\langle 15 \rangle$ EXOTHERMIC WELD TO GROUND ROD.
- PROVIDE AND INSTALL 3-#12+1-#12 GND IN 3/4" CONDUIT FROM PUMP CONTROL PANEL TO THE NEW ODOR CONTROL PANEL.
- PROVIDE AND INSTALL 2-#12 + 1-#12 GND IN 3/4" CONDUIT FROM PUMP CONTROL PANEL TO NEW SITE LIGHT ON DFS TOWER.
- PROVIDE AND INSTALL 1" CONDUIT FROM PUMP CONTROL PANEL TO NEW DFS ANTENNA. COAXIAL CABLE WILL BE INSTALLED BY DFS.

LIFT STATION LOAD CALCULATION

MOTORS:

 PUMP NO. 1:
 10.0 HP, 480 VAC, 3 Ø, 14.0 A

 PUMP NO. 2:
 10.0 HP, 480 VAC, 3 Ø, 14.0 A

 MOTOR SUB-TOTAL
 28.0 A

<u>20.0</u> A

<u>51.5</u> A

AUXILIARY EQUIPMENT

TOTAL MAXIMUM PHASE AMPERES

SERVICE SIZE:

<u>100</u> A, <u>480</u> VAC, <u>3</u> Ø, <u>3</u> – WIRE MINIMUM.

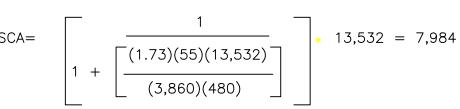
SHORT CIRCUIT CALCULATIONS

AVAILABLE SHORT—CIRCUIT CURRENT AT 480V UTILITY SERVICE IS 13,532 AMPERES.

CONTRACTOR TO CONFIRM WITH THE UTILITY

ISCA AT LINE SIDE OF SERVICE DISCONNECT:

UTILITY SERVICE: 480V, 3 PH, TRANSFORMER BANK AVAILABLE FAULT CURRENT AT SECONDARY SIDE OF UTILITY'S TRANSFORMER: 13,532 AMP RMS SYM. SERVICE CONDUCTOR LENGTH: 55 FEET SERVICE CONDUCTOR SIZE: #3 AWG CU.



SHORT CIRCUIT CURRENT AVAILABLE AT LINE SIDE LUGS OF THE FUSED DISCONNECT = 7,984 AMPS RMS.

GENERAL NOTES:

FUSE RATING: 100 AMPS

 NOT ALL REQUIRED CONDUITS AND CONDUCTORS SHOWN FOR CLARITY. REFERENCE OTHER SHEETS FOR ADDITIONAL CONDUIT OR CONDUCTORS THAT ARE REQUIRED.



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 REVISIONS
 DATE
 BY

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PHONE: 727-547-3999
WWW.KIMLEY-HORN.COM REGISTRY NO. 35106

KHA PROJECT
148400106

DATE
JUN 2023

SCALE AS SHOWN

DESIGNED BY TDT

CHECKED BY GLW MANATEE COUNTY

DRAWN BY

Manatee County

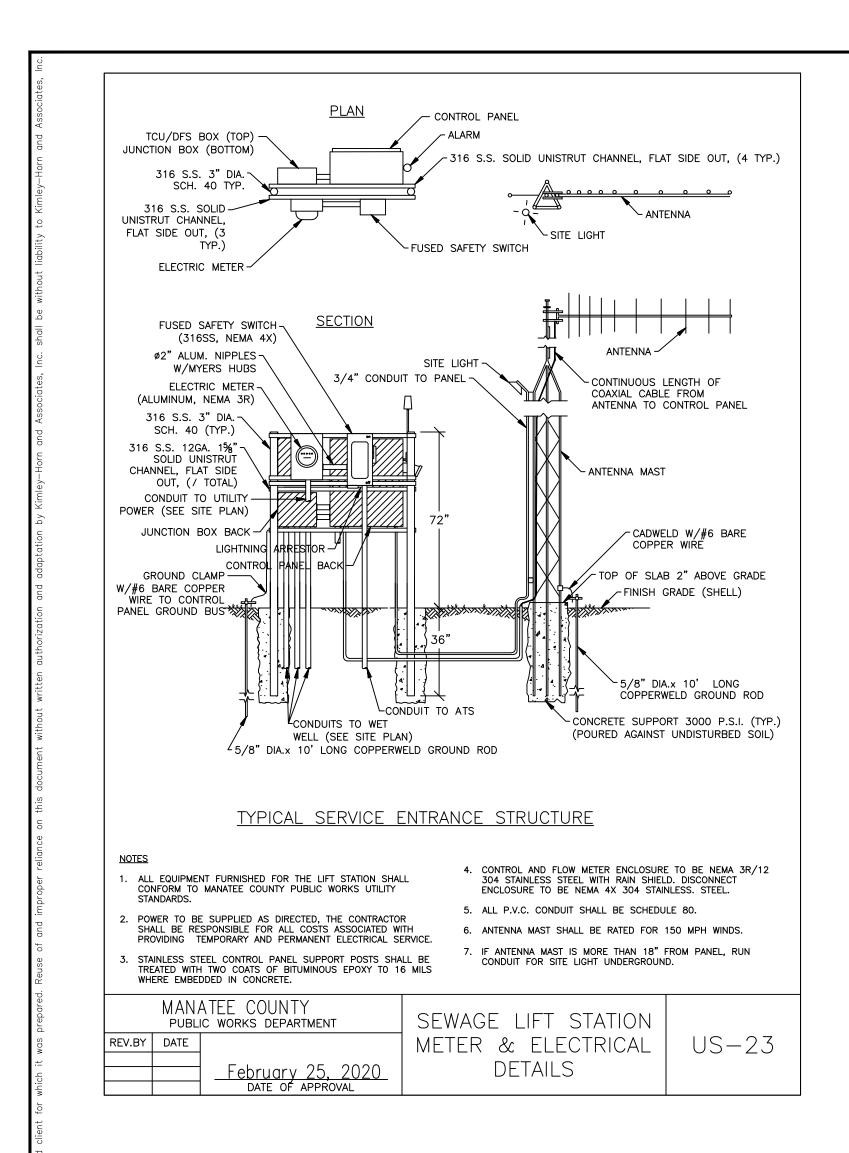
NORTH COUNTY METAL GRAVITY SEWER PIPE REPLACEMENTS

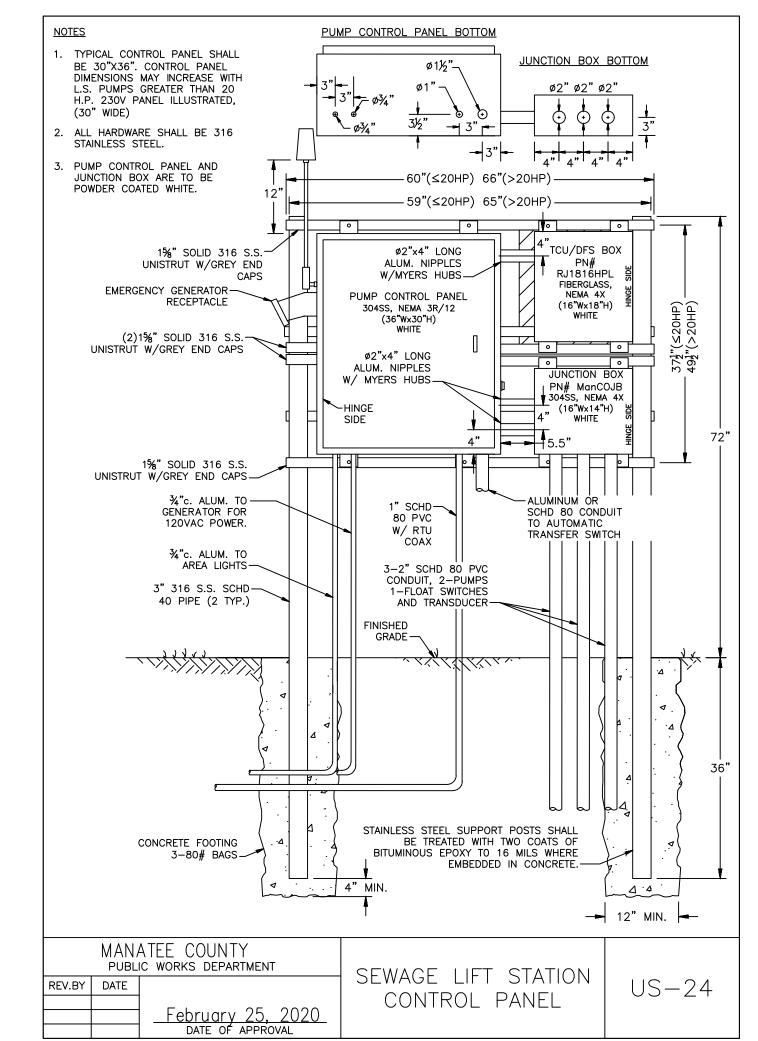
TIMOTHY THOMAS, P.E.

FL LICENSE NUMBER
47079

FL DATE:

RTU #554 - LS N7A ONE LINE DIAGRAM SHEET NUMBER







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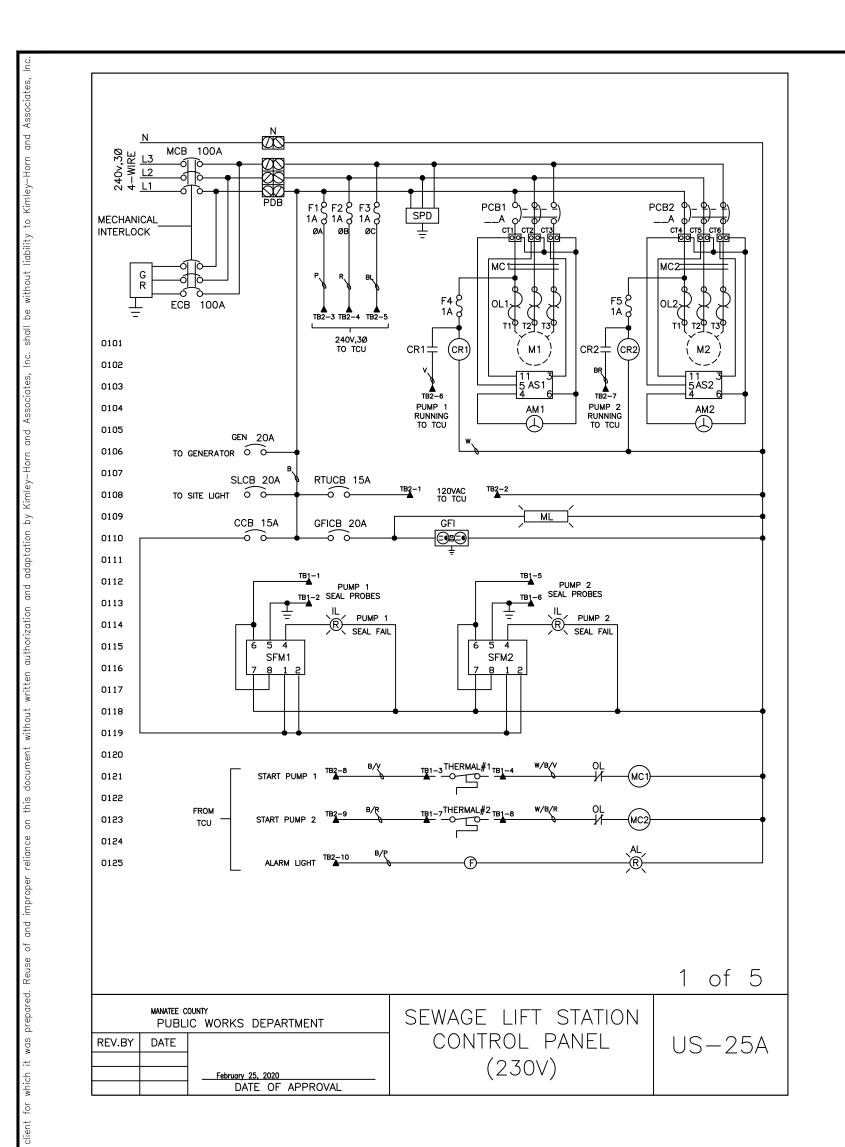
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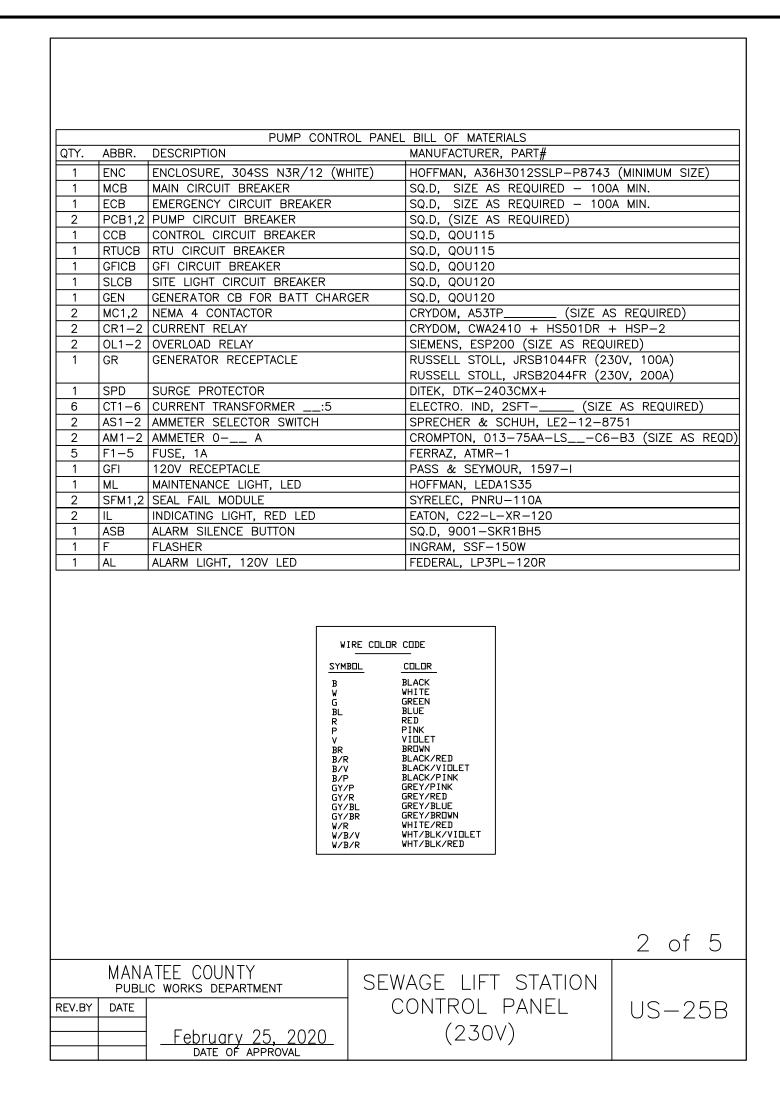
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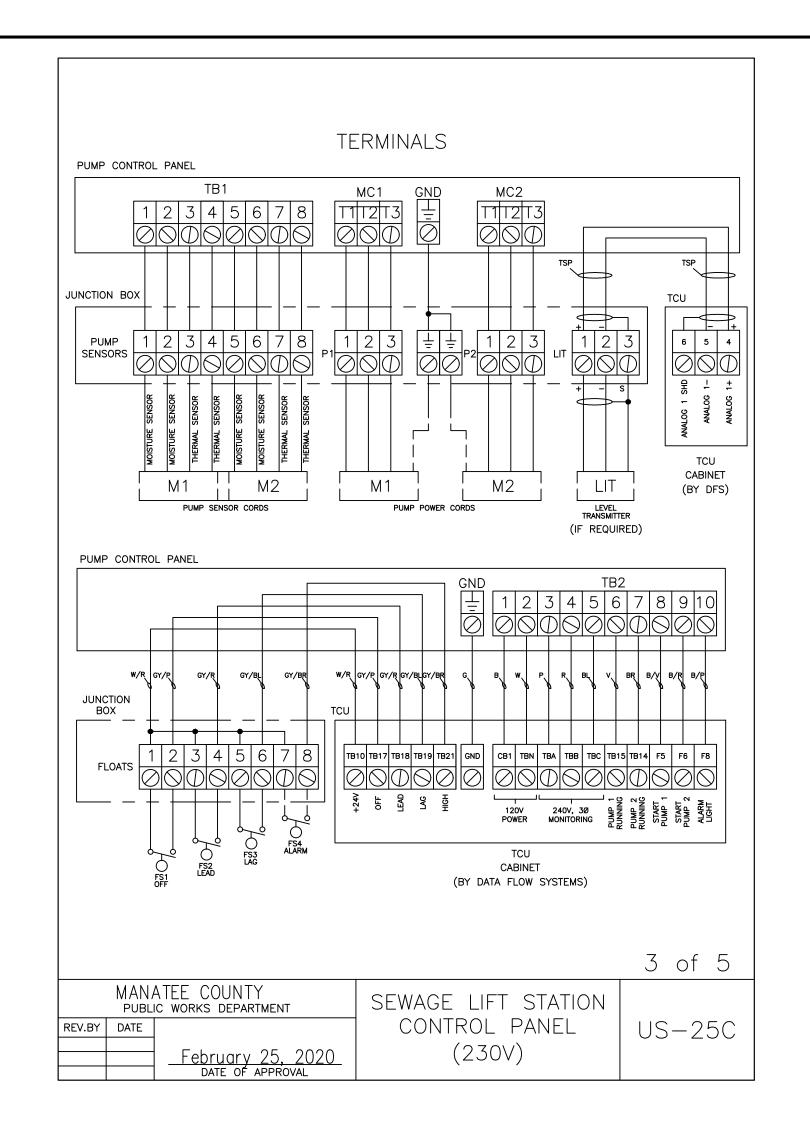
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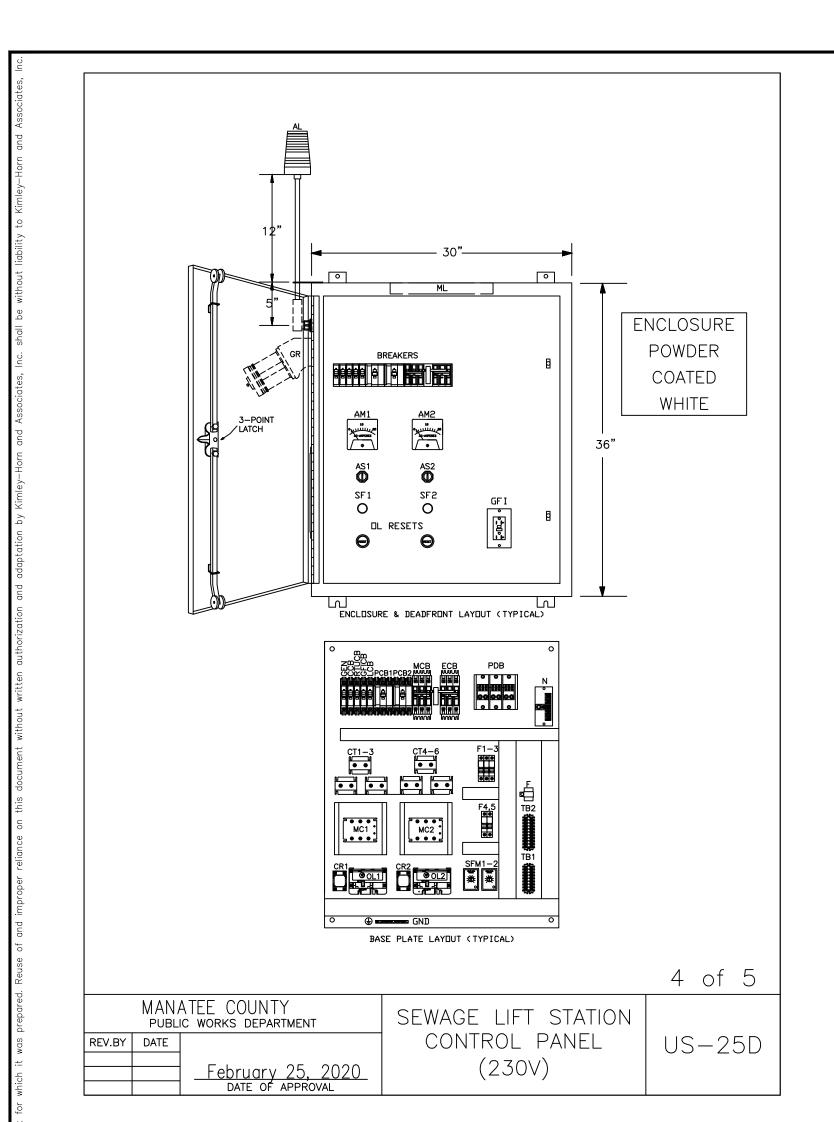
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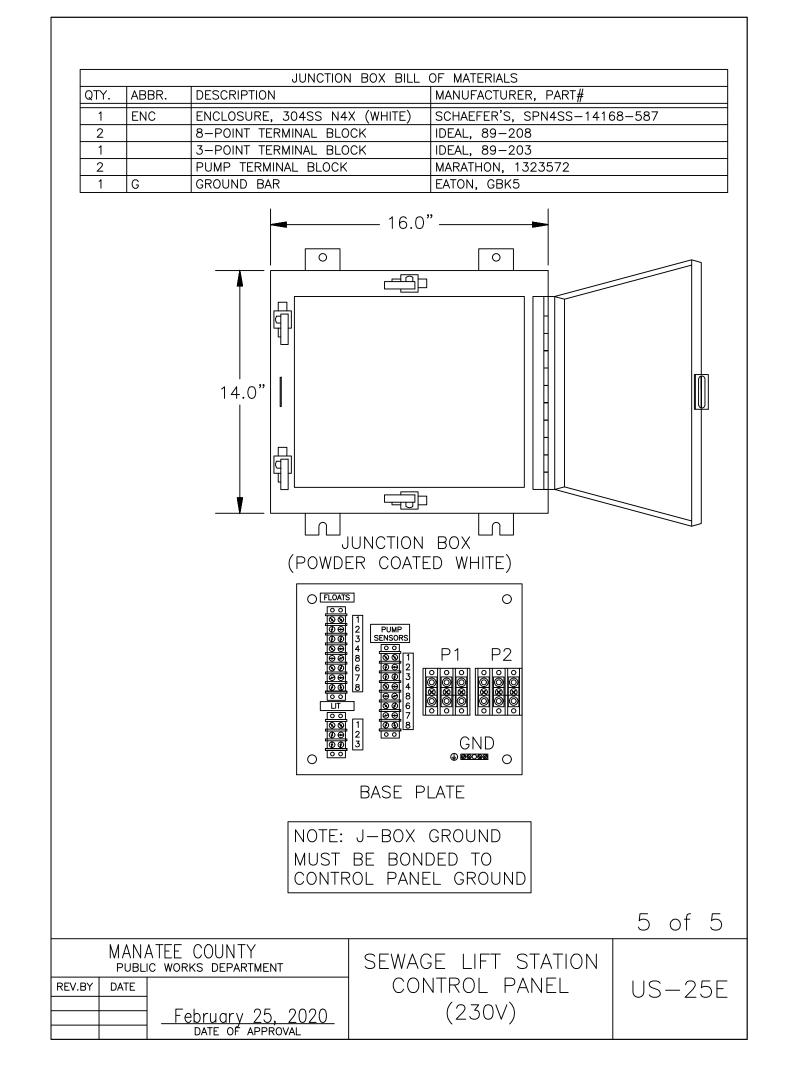
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STANDARD ELECTRICAL DETAILS
230V LIFT STATIONS

SHEET NUMBER





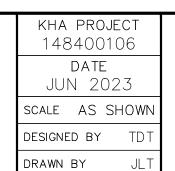


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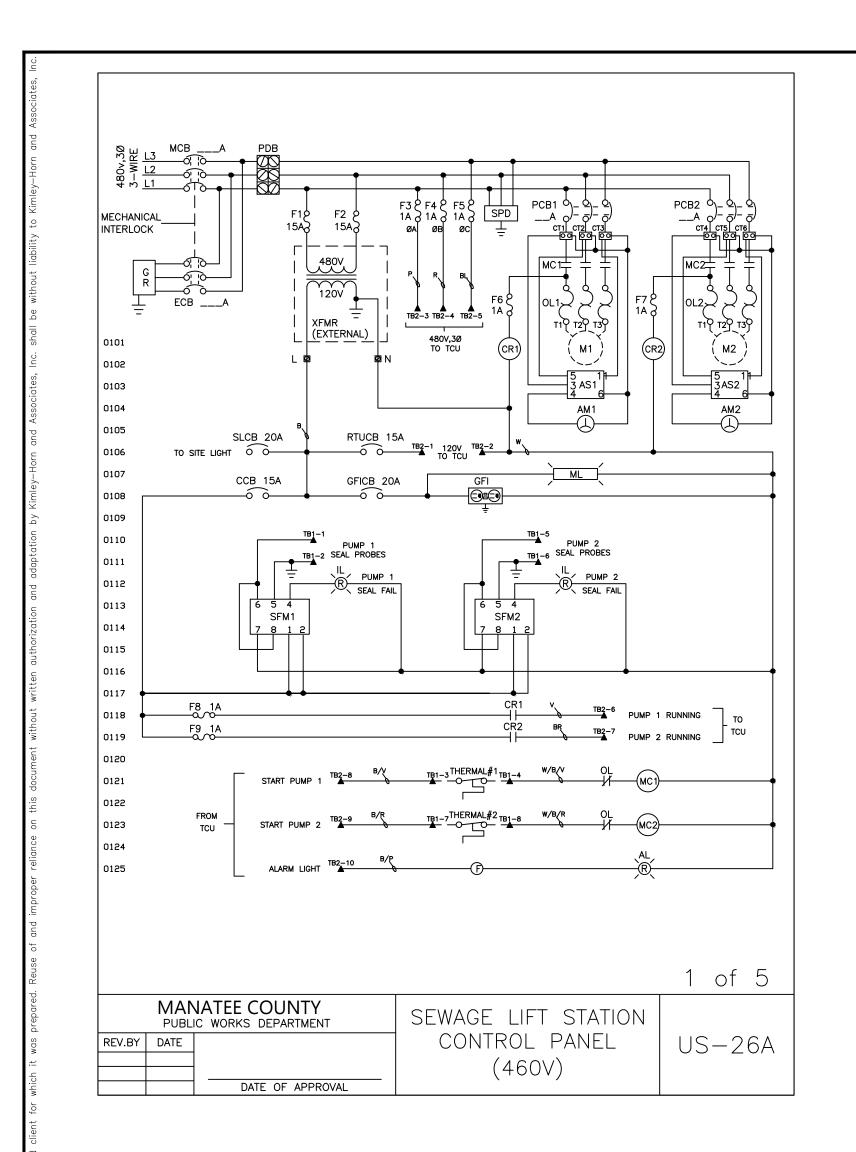
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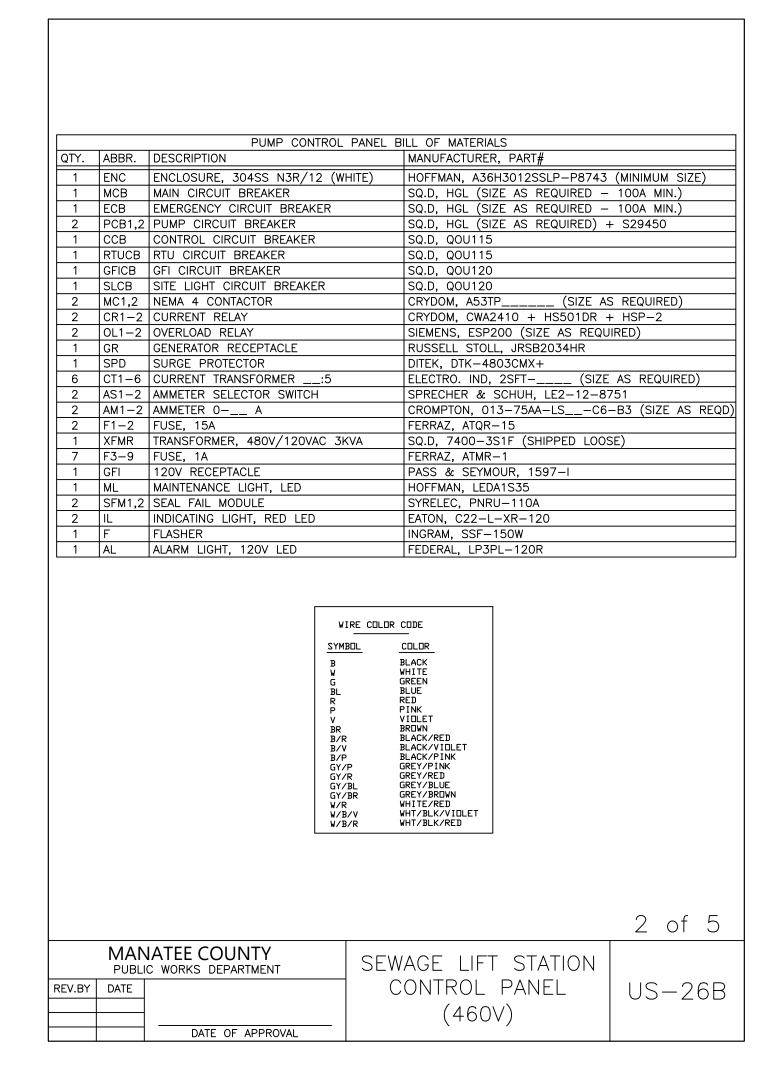
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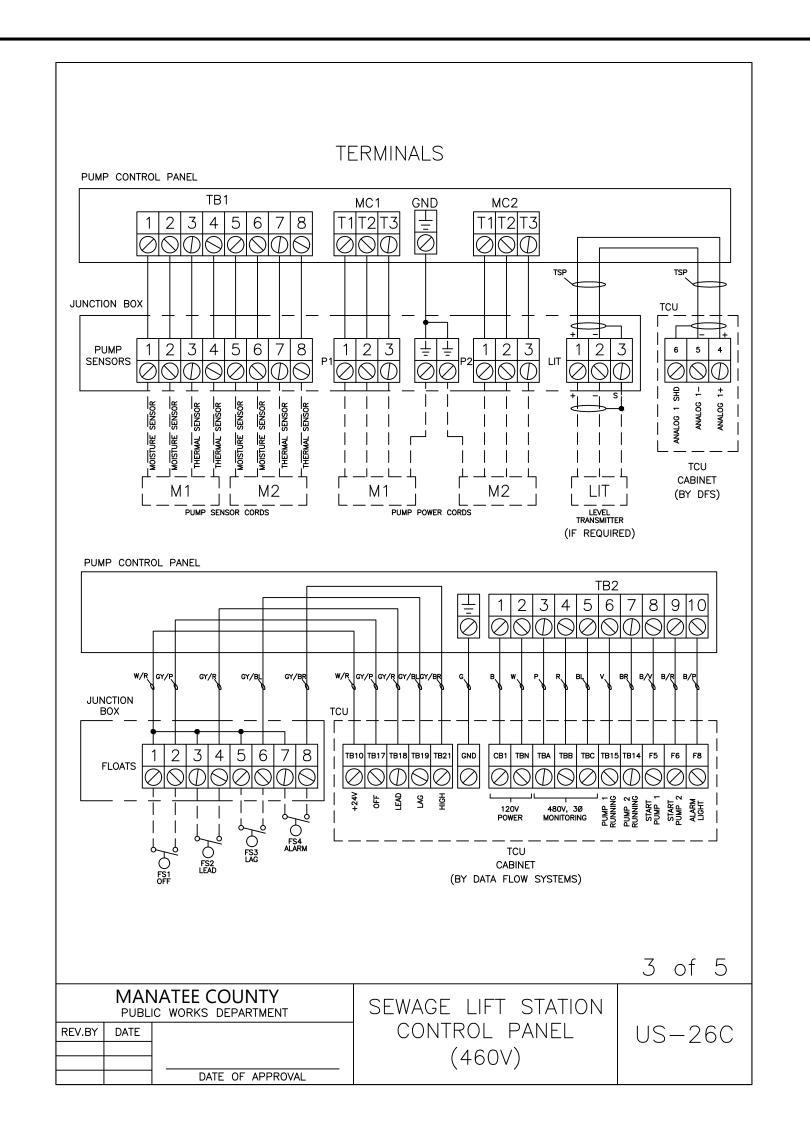
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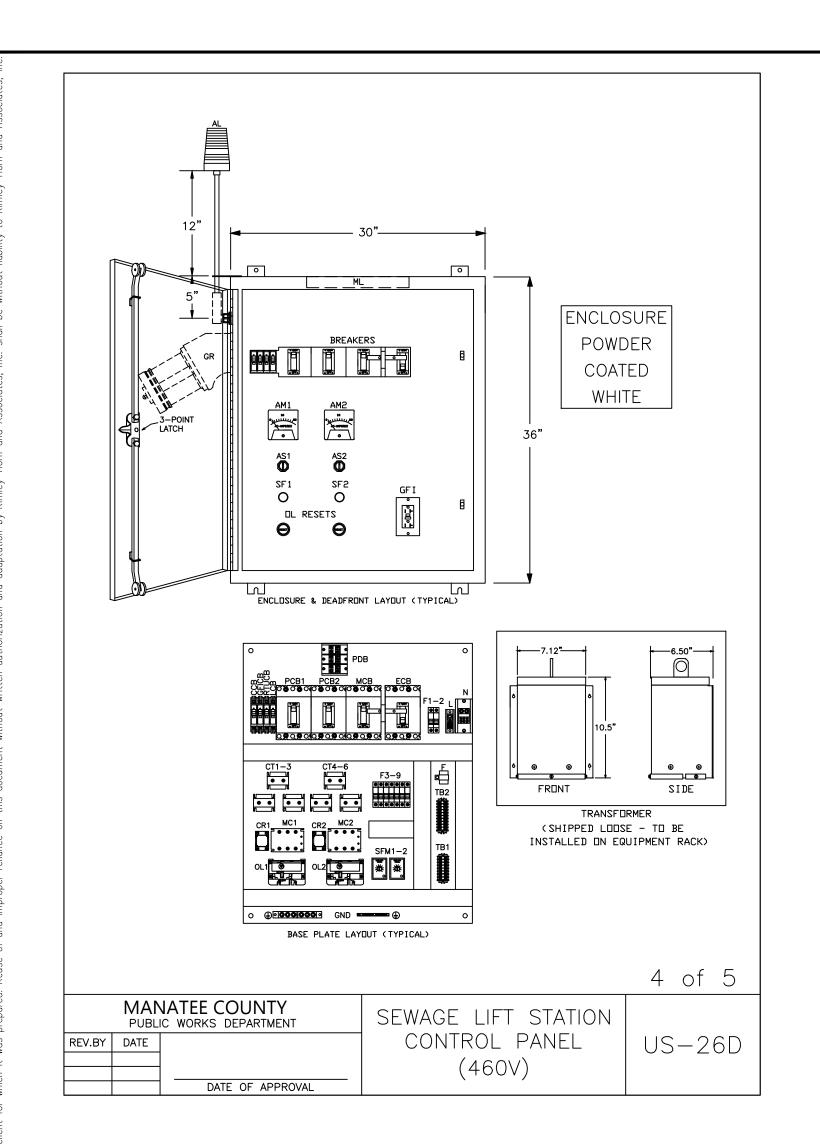
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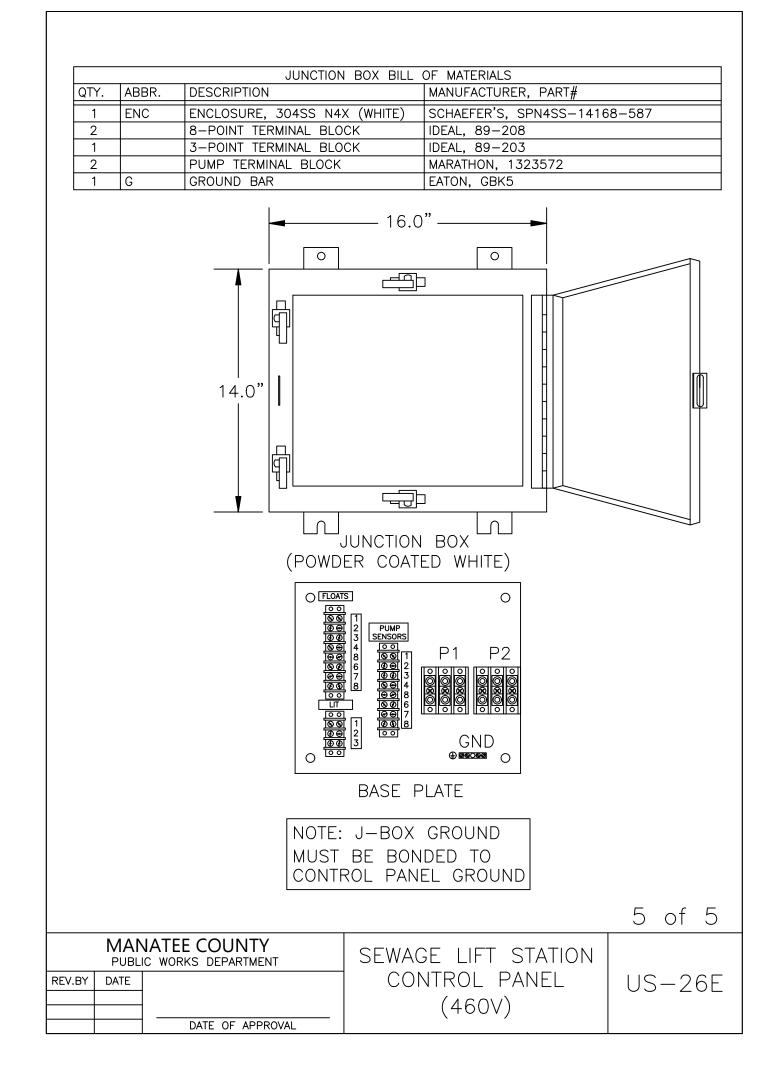
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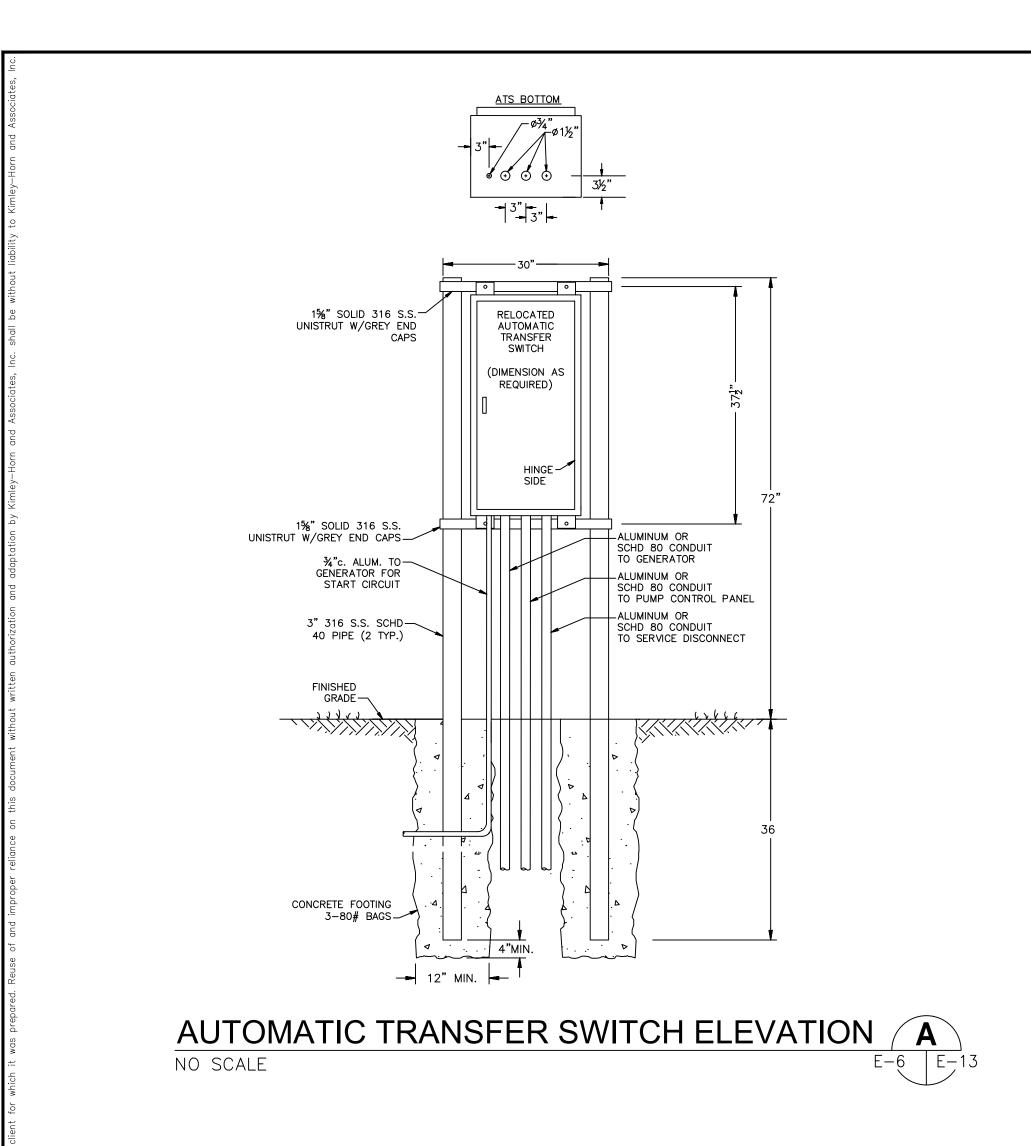
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777 S. Harbour Island Blvd, STE 350, TAMPA, FL 33602 813.227.9190 Certificate of Authorization No. 00031028

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LICENSED PROFESSIONAL TIMOTHY THOMAS, P.E. FL LICENSE NUMBER 47079

FL DATE:

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