SCOPE OF WORK

THE SCOPE OF WORK SHALL BE AS OUTLINED IN THE DRAWINGS AND SPECIFICATIONS. IN SUMMARY, IT SHALL INCLUDE BUT NOT BE LIMITED TO THE FOLLOWING:

EXTENSION OF CHILLED WATER PIPING SERVICE FROM THE JUDICIAL CENTER (ADJACENT BUILDING) INTO THE HISTORIC COURTHOUSE WITHOUT CHILLED WATER SERVICE INTERRUPTION TO THE HISTORIC COURTHOUSE.

INTEGRATION OF CONTROLS AND SEQUENCING OF CHILLED WATER DISTRIBUTION.

TESTING, ADJUSTING AND BALANCING TO ACHIEVE CHILLED WATER FLOWS AS INDICATED.

UPON ESTABLISHING CHILLED WATER SERVICE TO THE HISTORIC COURTHOUSE, DEMOLITION OF EXISTING CHILLERS AND COOLING TOWER AND ASSOCIATED APPURTENANCES ON THE ROOF/PENTHOUSE OF THE HISTORIC COURTHOUSE.

COOLING FOR SERVER ROOM SHALL BE ESTABLISHED PRIOR TO ANY DEMOLITION WORK IN THE CHILLER PLANT. ADDITIONALLY, TEMPORARY COOLING 24/7 SHALL BE REQUIRED FOR THE SERVER ROOMS. COORDINATE WITH OWNER.

L REQ	UIRED SUBMITTALS
PRIOR TO COMMENCEMENT OF	THE WORK SURMITTALS
SHALL BE REQUIRED FOR THE	WORK, INCLUDING BUT NOT
LIMITED TO THE FOLLOWING:	
ITEM	TITLE
230500	COMMON WORK RESULTS FOR HVAC
230523	GENERAL DUTY VALVES FOR HVAC PIPING
230529	HANGERS AND SUPPORTS FOR PIPING AND EQUIPMENT
230553	IDENTIFICATION FOR PIPING AND EQUIPMENT
230700	HVAC INSULATION
232113	HYDRONIC PIPING
232123	HYDRONIC PUMPS
235700	HEAT EXCHANGER
260519	LOW VOLTAGE ELECTRICAL POWER CONDUCTORS AND CABLES
260528	GROUNDING AND BONDING FOR ELECTRICAL SYSTEMS
260529	HANGERS AND SUPPORTS FOR ELECTRICAL SYSTEMS
260533	RACEWAY AND BOXES FOR ELECTRICAL SYSTEMS
260553	IDENTIFICATION FOR ELECTRICAL SYSTEMS
262816	ENCLOSED SWITCHES AND CIRCUIT BREAKERS
_	ARCHITECTURAL ELEMENTS AND WATERPROOFING
-	PROJECT SCHEDULE (WITHIN 10 DAYS OF NTP)
-	SHOP DRAWING SCHEDULE (WITHIN 30 DAYS OF NTP)
-	HVAC CONTROLS
-	SHOP DRAWINGS
-	TESTING ADJUSTING AND BALANCING

	INDEX
SHEET NUMBER	TITLE
COVER	COVER SHEET
A-1	ARCHITECTURAL PARTIAL PLANS
A-2	WATERPROOFING DETAILS
MD-1	MECHANICAL ROOFTOP PENTHOUSE DEMOLITION PLAN
M-0	MECHANICAL LEGEND
M-0.1	MECHANICAL FIRST FLOOR SERVER ROOM PLAN
M-1	MECHANICAL FIRST FLOOR PLAN
M-2	MECHANICAL SECOND FLOOR PLAN
M-3	MECHANICAL THIRD FLOOR PLAN
M-4	MECHANICAL FOURTH FLOOR PLAN
M-5	MECHANICAL ROOFTOP PENTHOUSE PLAN
M-6	MECHANICAL DETAILS
M-7	MECHANICAL FLOW DIAGRAM
M-8	MECHANICAL SCHEDULES AND CONTROLS
E-1	ELECTRICAL BASEMENT POWER PLAN
E-2	ELECTRICAL PARTIAL POWER PLANS
E-3	ELECTRICAL PARTIAL RISER
BOOK	PROJECT SPECIFICATIONS

BUILDING CODE ANALYSIS

EXISTING BLDG	AREA OF EXISTING B	LDG AREA OF RENO	DVATION
BASMENT FLOOR	22,83ر 5Q.FT.	1ر	SQ.FT.
ist FLOOR	22,83ر 5Q.FT.	1ر	SQ.FT.
2nd FLOOR	22,83ر 5Q.FT.	1ر	SQ.FT.
3rd FLOOR	2 <i>0,</i> 285± 5Q.FT.	26±	SQ.FT.
ROOF/PENTHOUSE	2 <i>0,28</i> 5± 5Q.FT.	555±	SQ.FT.
TOTAL BLDG	109,060± 5Q.FT.	611±	SQ.FT.

C-1/UCBE

ZONING: HISTORICAL DISTRICT REQUIRED SETBACKS TO PROPERTY LINES: (F) N/A (R) N/A (LS) N/A (RS) N/A SQ.FT. CLASSIFICATION OF BUILDING BY OCCUPANCY: BUSINESS
CLASSIFICATION OF BUILDING BY CONSTRUCTION TYPE: III-B LEVEL 2 ALTERATION

SPRINKLERED: YES_XXXX _____ THRESHOLD BUILDING: YES____ NO_XXXX FLOOD ZONE: X/O/N 0327 C/100 BFE: _ - - -

YEAR AND CODE IN EFFECT BY BUILDING DEPT: 2007 FLORIDA BUILDING CODE
2007 EXISTING BUILDING FLORIDA BUILDING CODE
2007 FBC AND MECHANICAL & PLUMBING W/09 REVISIONS

BUILDING HEIGHT & AREA / AREA MODIFICATION (TABLE 503)

FIRE RESISTANCE RATING OF BUILDING COMPONENTS AND PERCENTAGE OF OPENINGS (TABLES 601 AND 602)

HORIZONTAL SEPARATION FROM PROPERTY LINES AND/OR BUILDINGS:(F)_30'± (R)_30'± (RS)_30'± FEET STRUCTURAL FRAME (INCLUDING COLUMNS, GIRDERS AND TRUSSES): __0_____ HR.

EXTERIOR BEARING WALL RATING REQUIREMENTS: _______ 0____ HR.

EXTERIOR NON-BEARING WALL RATING REQUIREMENTS: ______ 0____ HR.

INTERIOR BEARING WALL RATING REQUIREMENTS: ______ 0____ HR.

INTERIOR NON- BEARING WALL RATING REQUIREMENTS: ______ 0____ HR.

FLOOR CONSTRUCTION (INCLUDING SUPPORTING BEAMS AND JOISTS): ____ 0____ HR.


ROOF CONSTRUCTION (INCLUDING SUPPORTING BEAMS AND JOISTS): ___ 0_____ HR.

EXIT ACCESS ENCLOSURES/CORRIDORS: ____ 0____ HR. EXIT ENCLOSURES/STAIRS: _____ 2_____ HR.

DESIGN LOADS AND STRESSES

ROOF: LIVE LOAD: _20 PSF __ PIPE DEAD LOAD: _100 PLF ___ ROOF SLOPE: _FLAT FLOOR LIVE LOAD: _50 __ CORRIDORS LIVE LOAD: _80 __ BALCONY AND DECK LIVE LOAD: _100 __ WIND LOAD: VELOCITY: _130 __ MPH WIND PRESSURE: ___ 31 __ PSF __ WIND EXPOSURE CATEGORY: ___ B __ IMPORTANCE FACTOR: _1.0 __ ENCLOSURE CLASSIFICATION (OPEN, ENCLOSED): _ENCLOSED __ INTERNAL PRESSURE COEFFICIENT: __0.18± __ COMPONENTS & CLADDING, DESIGN WIND PRESSURE: ___ 45 __ PSF SOIL BEARING CAPACITY: _N/A _PSF __ NOTE: SOILS ANALYSIS IS NOT REQUIRED.

MAXIMUM ALLOWABLE TRAVEL DISTANCE WITHIN ROOMS OR SPACES ALONG ROUTES OF EXIT ACCESS (1015.1) 300' BUSINESS OCCUPANCY W/ SPRINKLER SYSTEM_

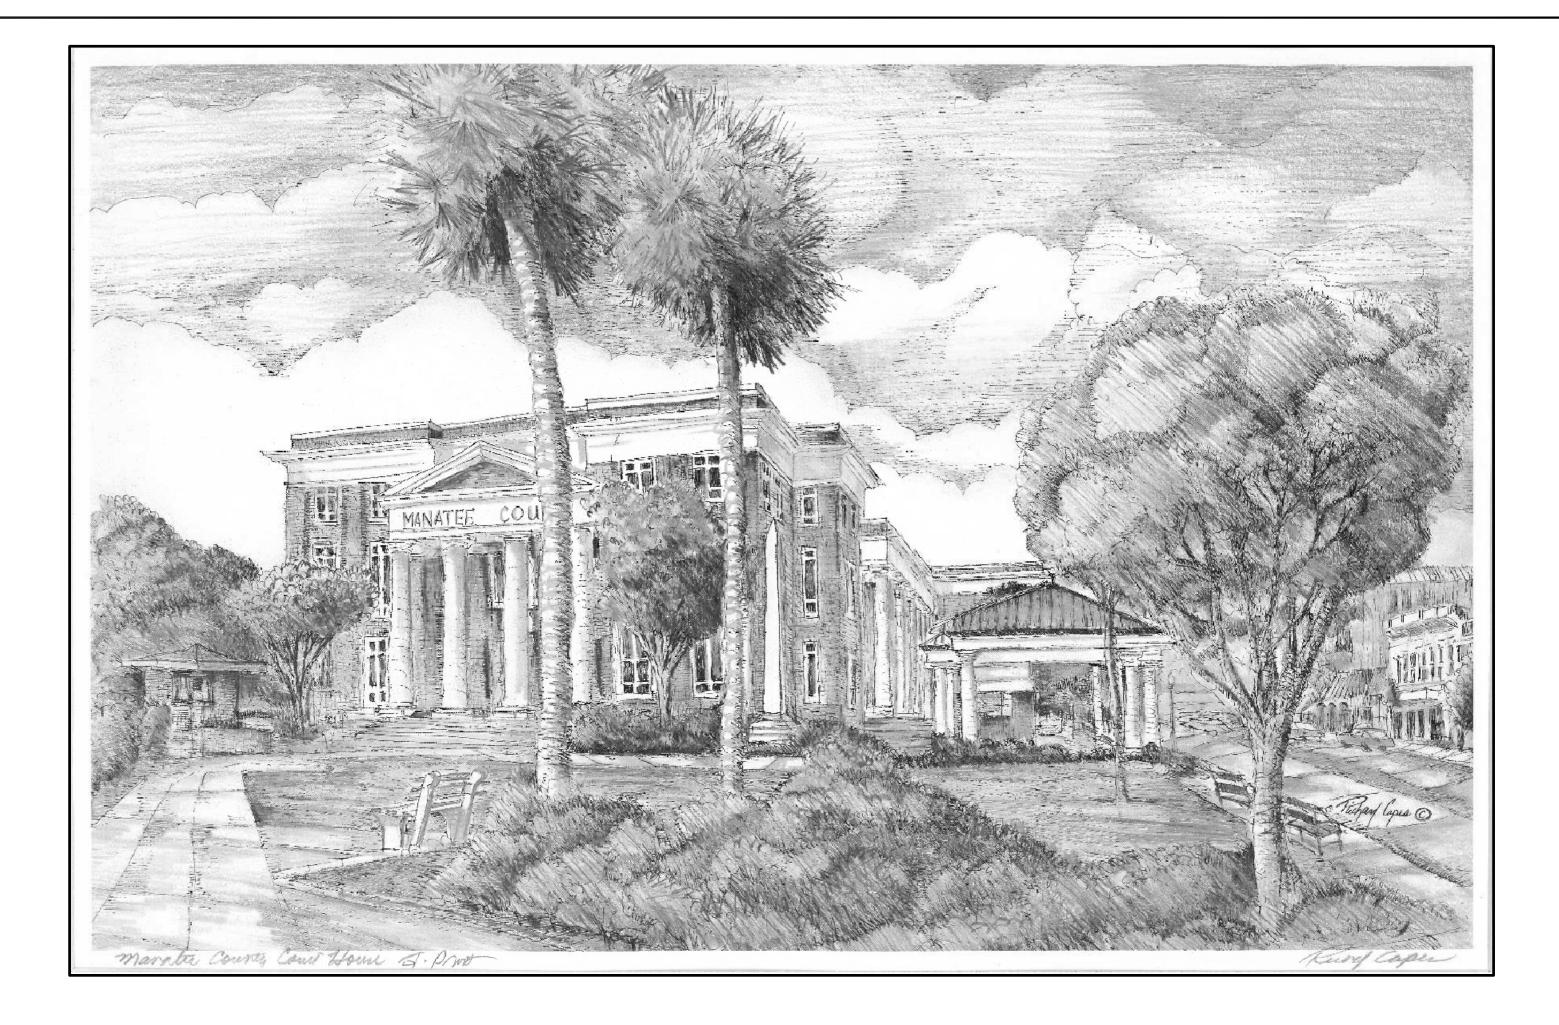

MANATEE COUNTY HISTORIC COURTHOUSE CHILLED WATER PIPING EXTENSION

MANATEE COUNTY GOVERNMENT PROPERTY MANAGEMENT DEPARTMENT FRANK MONHART, PROJECT MANAGER 941-742-5844

PLANS AND SPECIFICATIONS PREPARED BY: FORNEY ENGINEERING, INC.

PHASING PLAN

IT IS THE INTENT OF THE DRAWINGS AND SPECIFICATIONS TO LIMIT INTERRUPTION TO THE OWNER DURING THE DEMOLITION/CONSTRUCTION OF THE PROJEC	. THE CONTRACTOR MAY DEVELOP AN
ALTERNATE PHASING PLAN PROVIDED THE INTENT OF LIMITED INTERRUPTION IS MET.	

ALL WORK IN THE OCCUPIED SPACES SHALL OCCUR ON NIGHTS AND WEEKENDS. THE CONTRACTOR SHALL PROVIDE A DUST TIGHT BARRIER FOR ALL WORK IN OCCUPIED SPACES.

THE FIRST PHASE OF THE PROJECT SHALL CONSIST OF INSTALLATION OF THE SPLIT SYSTEM IN THE FIRST FLOOR SERVER ROOM AS SHOWN ON DRAWINGS. COOLING FOR SERVER ROOM S

THE FIRST PHASE OF THE PROJECT SHALL CONSIST OF INSTALLATION OF THE SPLIT SYSTEM IN THE FIRST FLOOR SERVER ROOM AS SHOWN ON DRAWINGS. COOLING FOR SERVER ROOM SHALL BE ESTABLISHED PRIOR TO ANY DEMOLITION WORK IN THE CHILLER PLANT. ADDITIONALLY, TEMPORARY COOLING 24/7 SHALL BE REQUIRED FOR THE COMPUTER ROOMS IN THE BUILDING. COORDINATE WITH OWNER.

THE SECOND PHASE OF THE PROJECT SHALL CONSIST OF ROUTING CHILLED WATER PIPING INTO THE BASEMENT OF THE HISTORIC COURTHOUSE. ELECTRICAL CONDUIT SHALL BE ROUTED ALONG WITH THE CHILLED WATER PIPING IN THE TRENCH. THE WORK ON THE EXTERIOR OF THE BUILDING SHALL OCCUR AS QUICKLY AS POSSIBLE SO THAT PEDESTRIAN TRAFFIC MAY BE RESTORED IN THE COURTYARD.


THE THIRD PHASE OF THE PROJECT SHALL INCLUDE ESTABLISHING CHILLED WATER PIPING SERVICE TO THE COURTHOUSE. THIS INCLUDES THE ROUTING OF THE NEW PIPING IN THE HISTORIC COURTHOUSE, SELECTIVE DEMOLITION OF EXISTING PIPING AND EQUIPMENT, AND THE CONNECTION OF THE NEW PIPING TO THE HEAT EXCHANGER IN THE PENTHOUSE AND CONTROLS WORK ASSOCIATED WITH ESTABLISHING CHILLED WATER SERVICE TO THE HISTORIC COURTHOUSE (INSTALLATION OF COURTHOUSE DP, CONTROL VALVES AT TIE-IN AND ADDITIONAL PROGRAMMING FOR THE SCP'S IN THE JUDICIAL CENTER. WORK IN THE OCCUPIED SPACES AS WELL AS PLANT SHUTDOWN SHALL OCCUR AFTER-HOURS.

THE FOURTH PHASE SHALL CONSIST OF REMOVAL OF EXISTING PUMPS AND INSTALLATION OF THE NEW CHILLED WATER PUMPS IN THE HISTORIC COURTHOUSE AND ASSOCIATED CONTROL WORK.

THE FINAL PHASE SHALL CONSIST OF THE REMOVAL OF REMAINING EXISTING EQUIPMENT SHOWN TO BE DEMOLISHED.

ERING, INC.
SULTING ENGINEERS
N, FL. 34208 C.O.A. #40

ANICAL & ELECTRICA

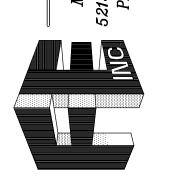

MANATEE COUNTY STORIC COURTHOUSE ILLED WATER PIPING

TO THE BEST OF MY KNOWLEDGE, SAID PLANS AND SPECIFICATIONS COMPLY WITH ALL APPLICABLE BUILDING CODES.

GERARD L. ABRAMS P.E. 47786

S E A L


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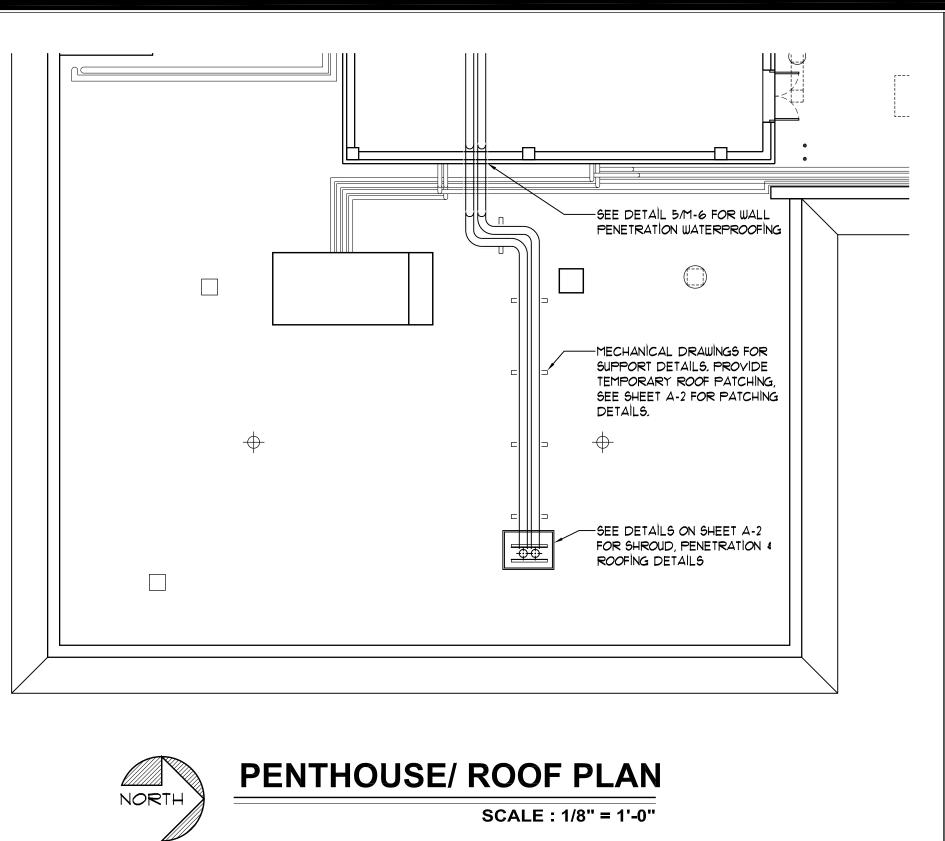
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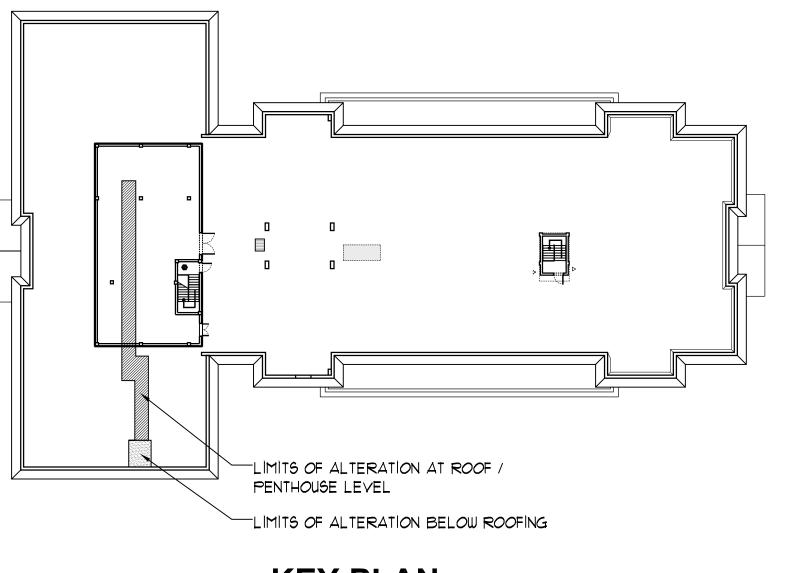
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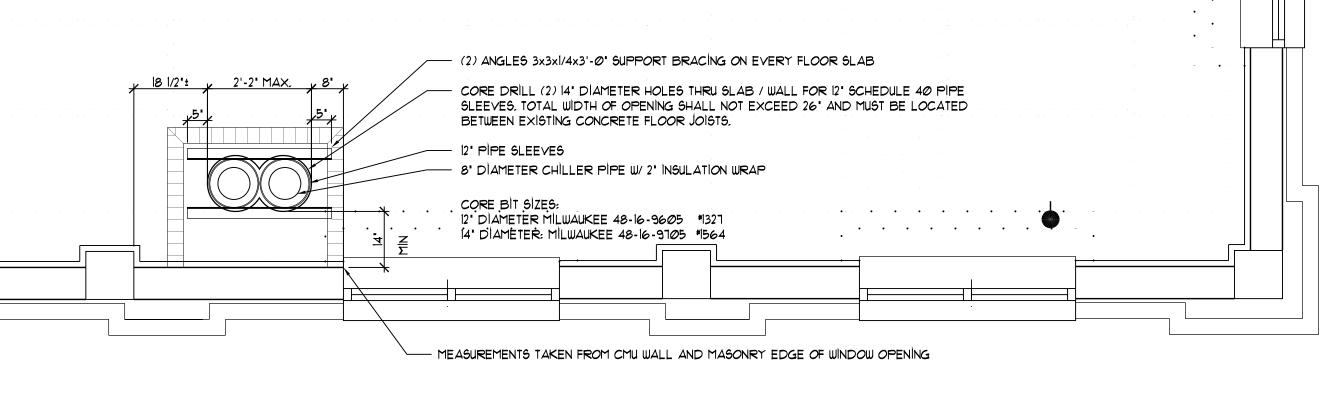






KEY PLAN


SCALE: 1/16" = 1'-0"

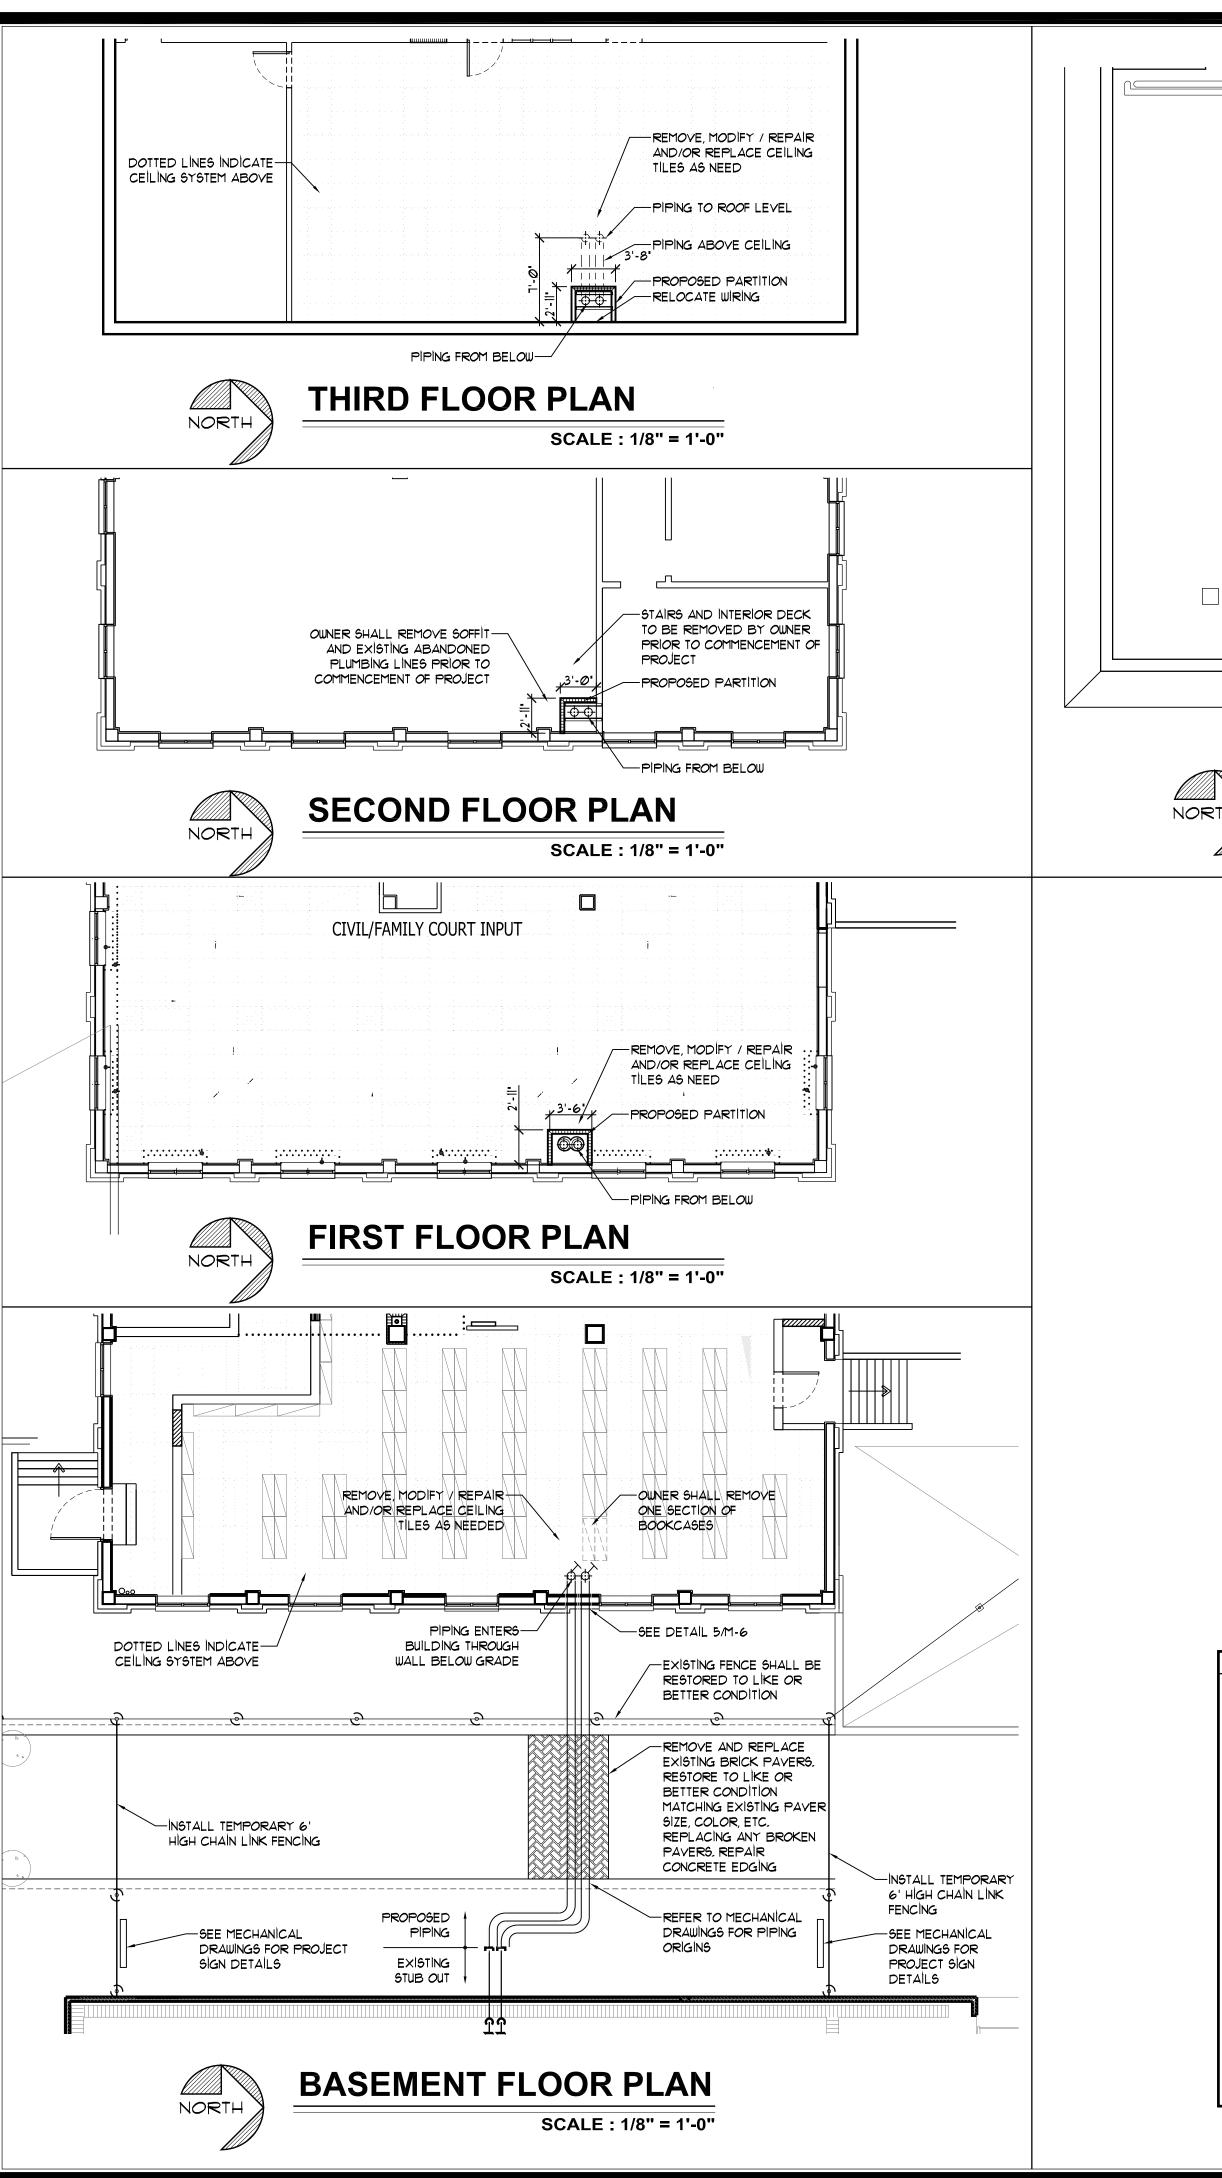

NORTH

TYPICAL FLOOR / FLOOR PENETRATION LOCATION

SCALE: 1/2" = 1'-0" GENERAL NOTES: 1. CENTER LINE FOR CHILLER PIPING SHALL ALIGN VERTICAL FROM BASEMENT LEVEL THRU 3RD FLOOR AND BE OFFSET ABOVE 3RD FLOOR CEILING.

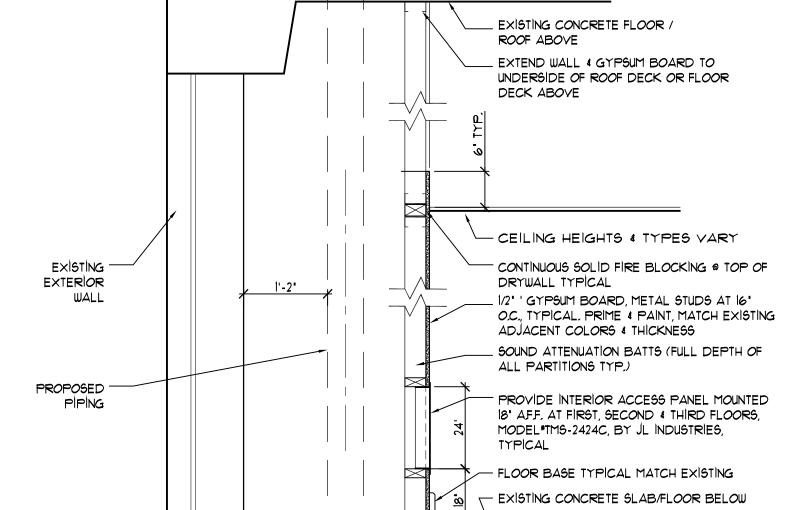

TYPICAL INTERIOR PARTITION

SCALE: 3/4" = 1'-0"

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COURTHOUSE PERSONNEL PRIOR TO COMMENCING CONSTRUCTION.

WALL LEGEND

EXISTING EXTERIOR WALL TO REMAIN

EXISTING INTERIOR WALL TO REMAIN

AS PART OF THE DEMOLÍTION PROCESS, ALL AREAS IN WHICH DEMOLÍTION IS TAKING PLACE IS TO

OFF AND THE DUCT WORK SEALED TO PREVENT ANY DUST OR DEBRIS FROM ENTERING THE SYSTEM

ELECTRICAL: REMOVE / RELOCATE ANY ELECTRICAL / DATA OUTLETS IN ALL WALLS 4

CEILING: EXISTING CEILING MOUNTED DEVICES (I.E. FIRE ALARM, DIFFUSERS, LIGHT FIXTURES,

ENERGY MANAGEMENT CONTROL SYSTEMS) ARE TO REMAIN, PROVIDE TEMPORARY SUPPORT

ARE REMOVED, ALL TROFFER FLUORESCENT FIXTURES SHALL HAVE TWO SUPPORTING WIRES

FIRE PROTECTION: THE EXISTING FIRE SPRINKLER SYSTEM SHALL REMAIN INTACT & FULLY

WARNING: EXTREME CARE SHALL BE EXERCISED WHILE REMOVING ADJACENT CEILING

COUNTY EMPLOYEES SHALL BE OCCUPYING THE FIRST & THIRD FLOORS

DURING NORMAL COUNTY WORK HOURS, COORDINATE WITH HISTORIC

ACTIVATED. CONTRACTOR SHALL LOCATE FIRE SPRINKLER EMERGENCY SHUT-OFF VALVE(S)

SYSTEM(S) FROM AROUND FIRE SPRINKLER HEADS TO ENSURE THAT THEY ARE NOT

BY STEEL WIRE CAPABLE OF SUPPORTING THE DEVICES FULL WEIGHT AFTER CEILING SYSTEMS

PHONE, ELECTRICAL RECEPTACLES, EMERGENCY LIGHT UNITS, EXIT SIGNS, SPEAKERS 4

BE ISOLATED FROM THE BUILDING'S AIR CONDITIONING SYSTEM AND THE SPACE IS TO BE ISOLATED AND UNDER NEGATIVE PRESSURE WITH RESPECT TO THE MAIN BUILDING, THE CONTRACTOR SHALL PROVIDE A DEMOLÍTION PROTOCOL TO THE ARCHITECT FOR REVIEW PRIOR TO COMMENCING CONSTRUCTION, THE AIR CONDITIONING SYSTEM IN THE AREA BEING DEMOLISHED IS TO BE TURNED

TYPICAL METAL FRAME INTERIOR PARTÍTION TO BOTTOM OF DECK


DEMOLITION / CONSTRUCTION NOTES:


PARTITIONS TO BE REMOVED, TYPICAL.


LOCATED ON OPPOSITE CORNERS.


PRIOR TO COMMENCING DEMOLITION


OPERATIONAL,

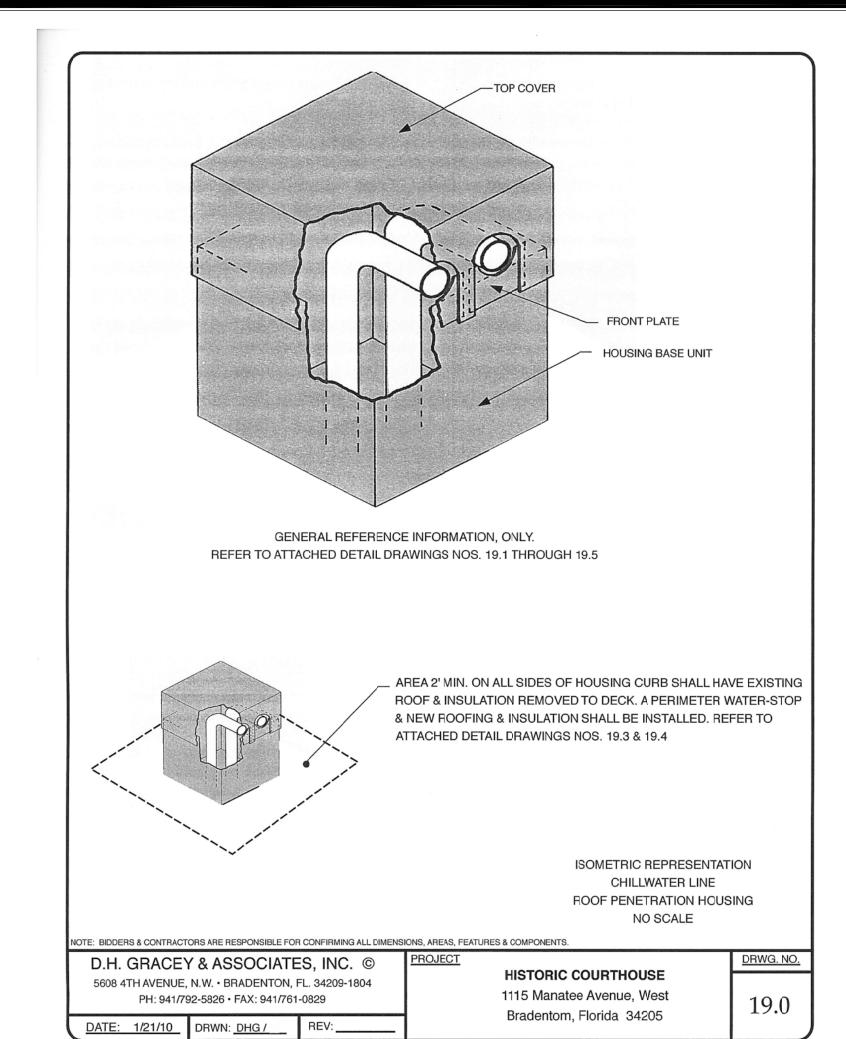


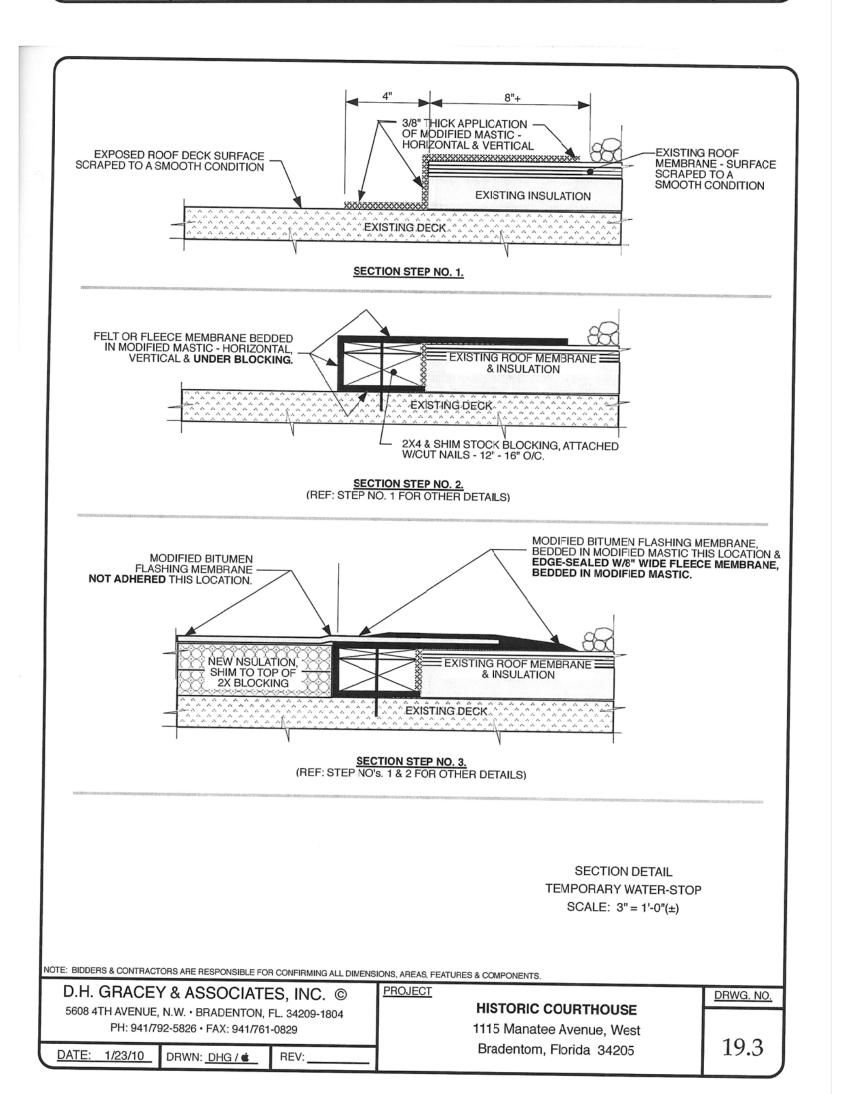

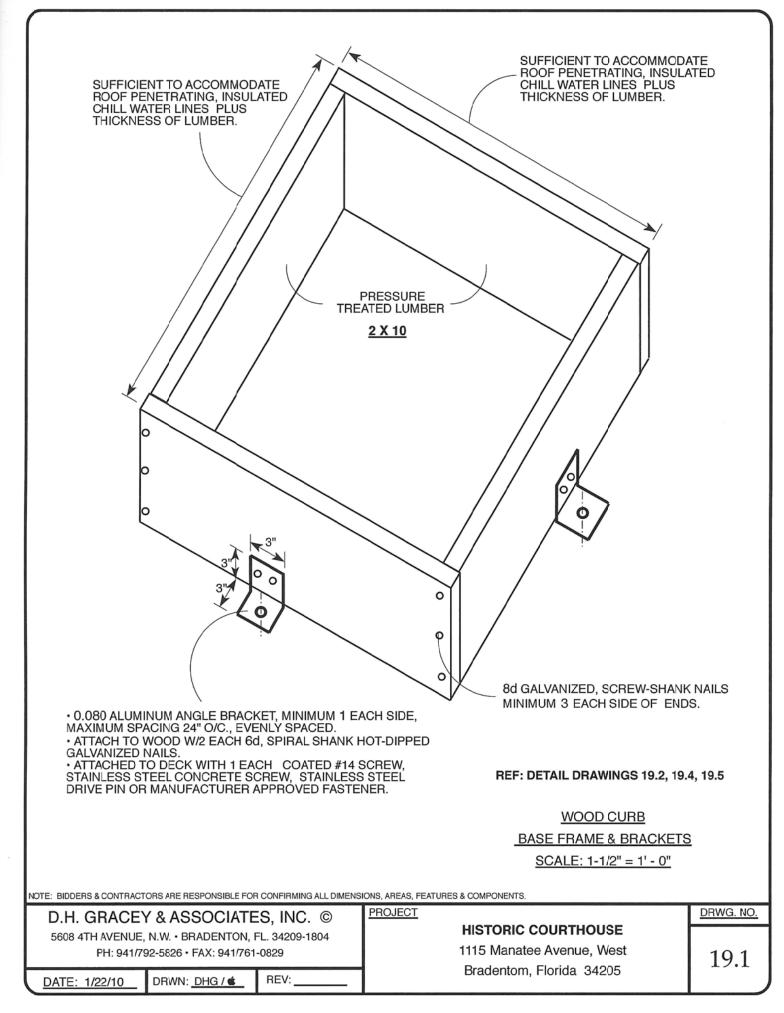

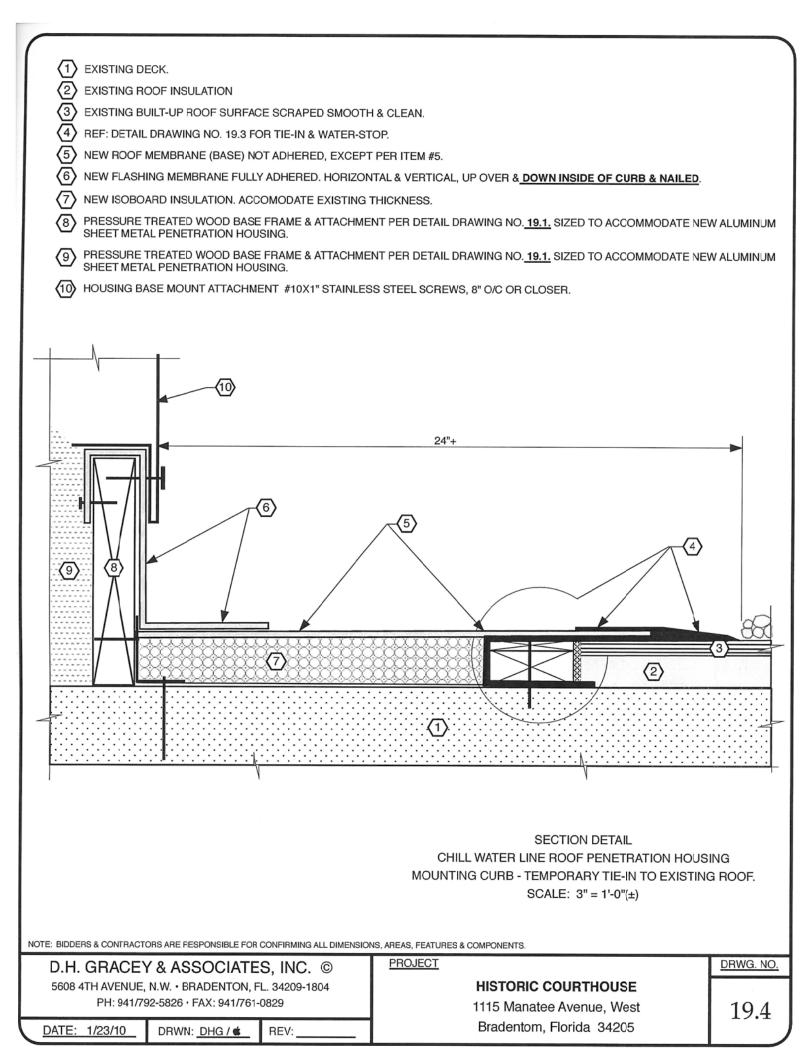

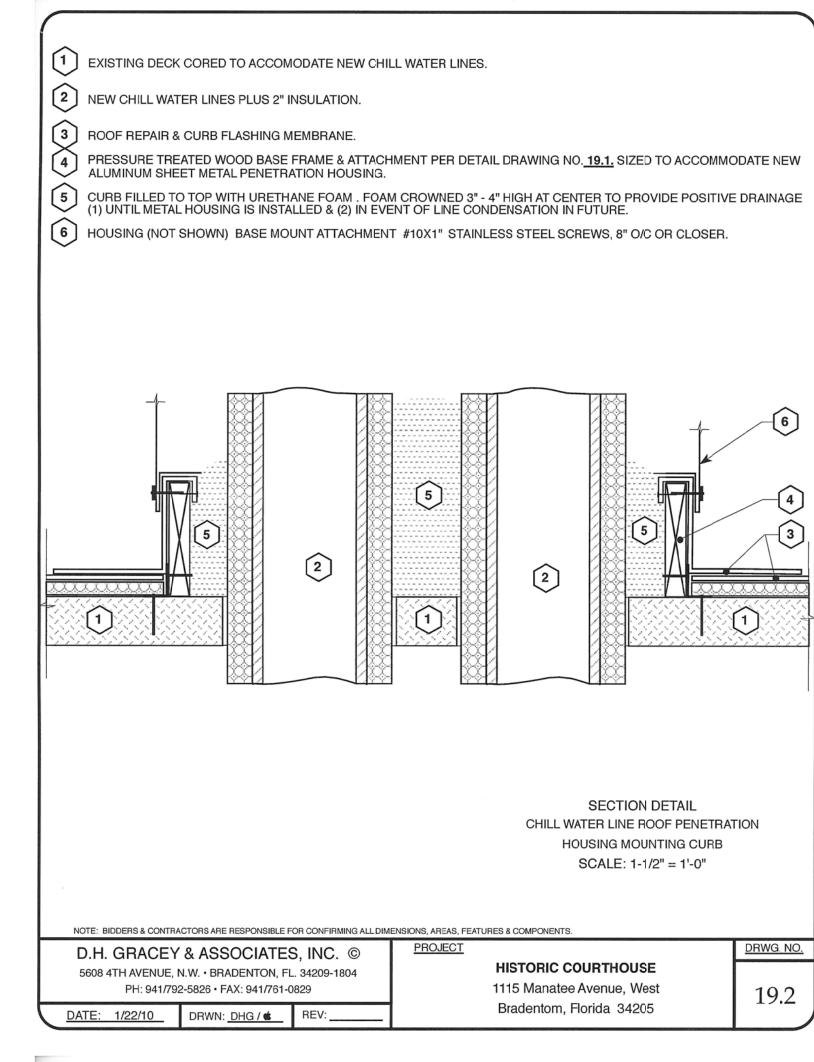


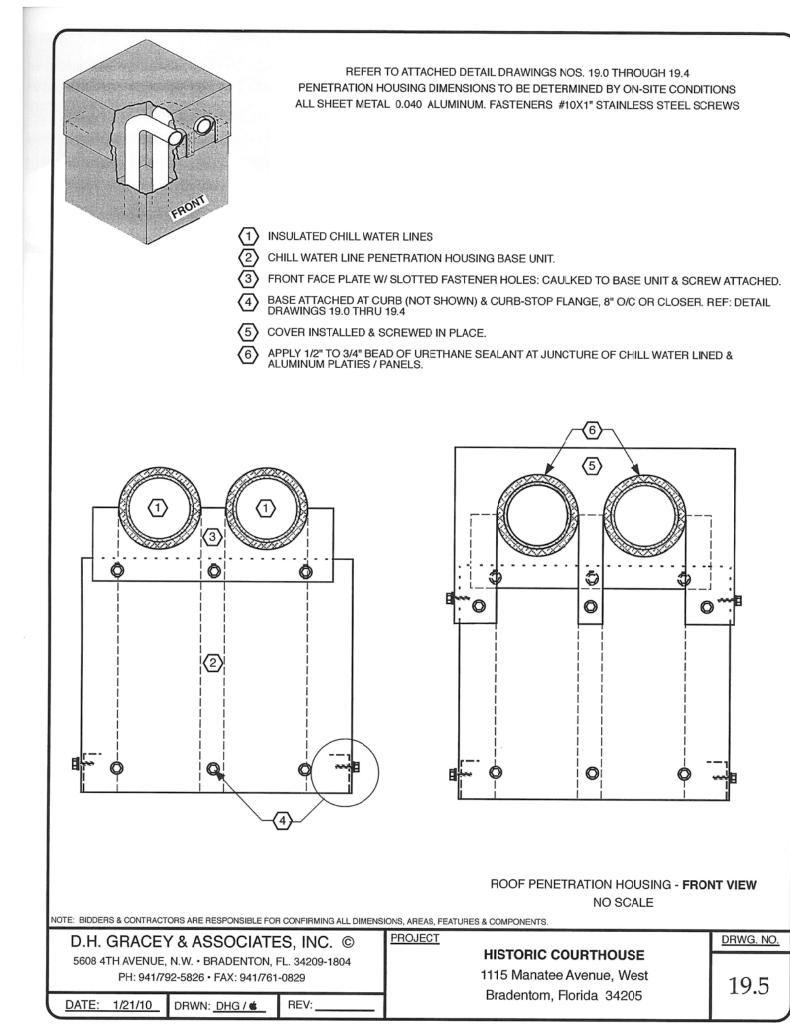



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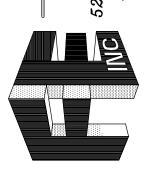


FLOOR DRAIN

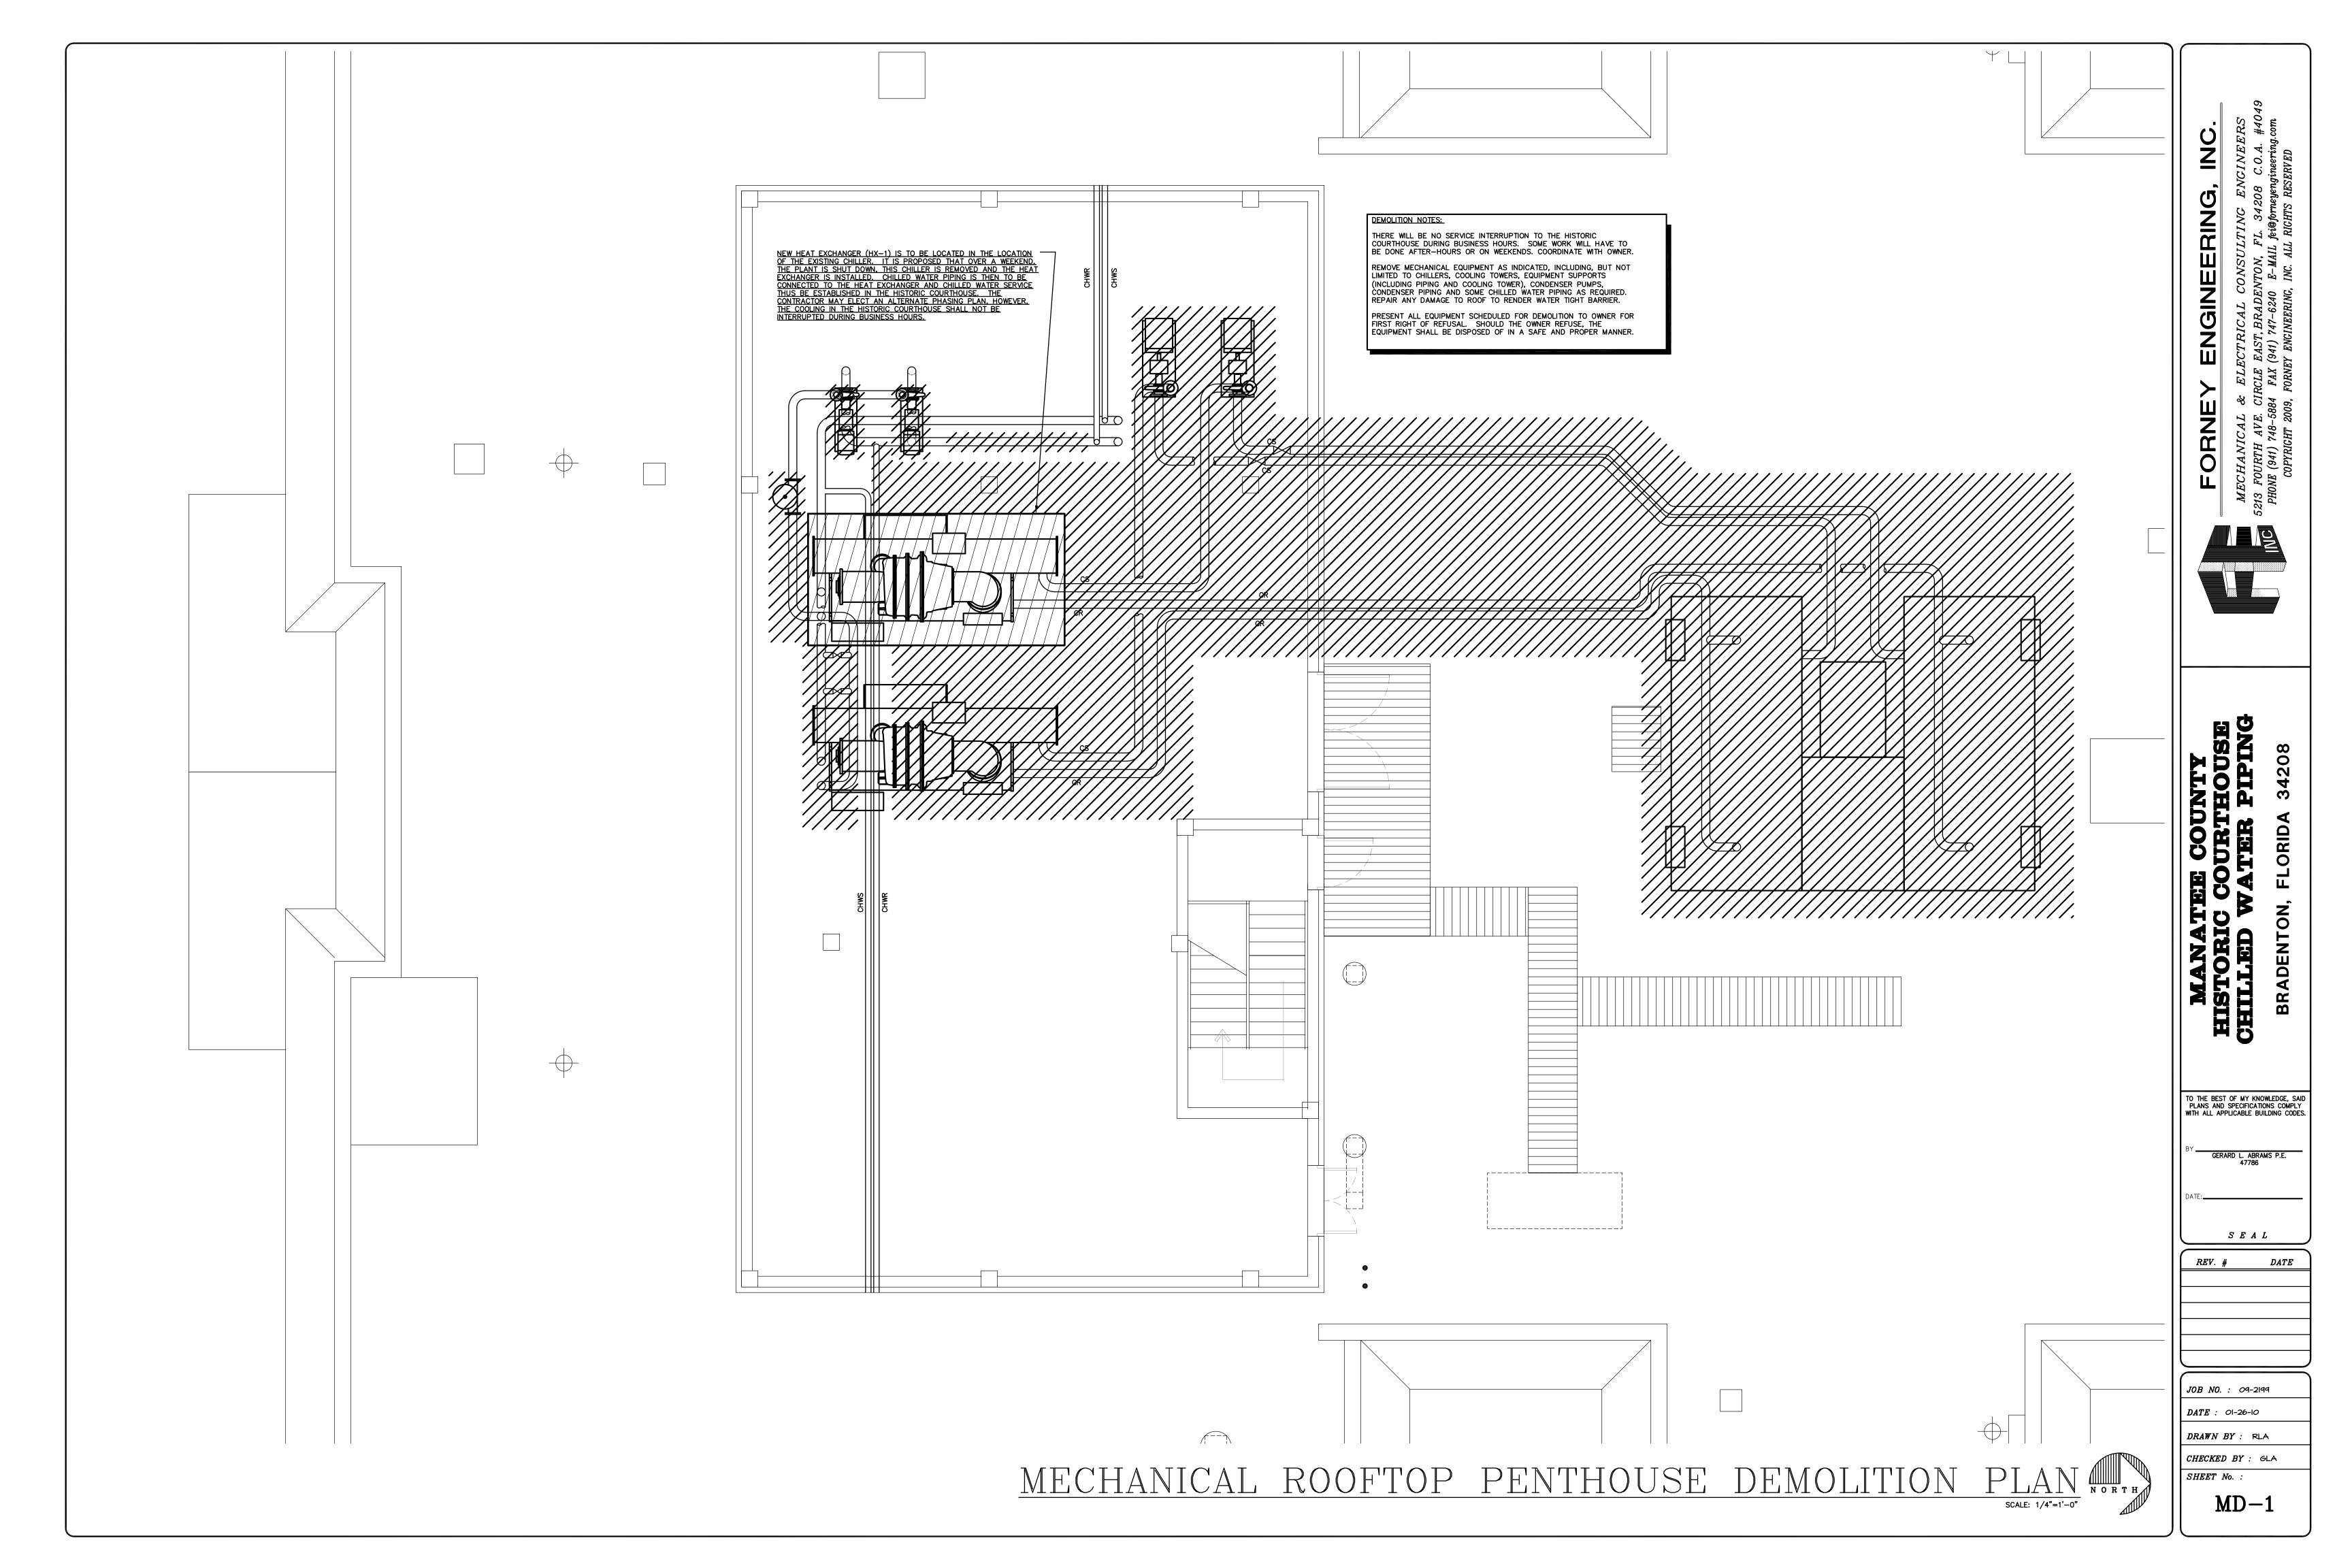HP HORSE POWER

ELECTRICAL CONSULTING ENGINEER
RCLE EAST, BRADENTON, FL. 34208 C.O.A. #

MECHANICAL & ELECTRIC 5213 FOURTH AVE. CIRCLE EAST, B



MANATEE COUNTY HISTORIC COURTHOUSE CHILLED WATER PIPING

TO THE BEST OF MY KNOWLEDGE, SAI PLANS AND SPECIFICATIONS COMPLY WITH ALL APPLICABLE BUILDING CODE:

GERARD L. ABRAMS P.E. 47786

S E A L

REV. # DATE

JOB NO. : 09-2199


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M-O



SERVER ROOM AIR HANDLING UNIT LOCATION

SCALE: 1/4" = 1'

MECHANICAL FIRST FLOOR SERVER ROOM PLANS

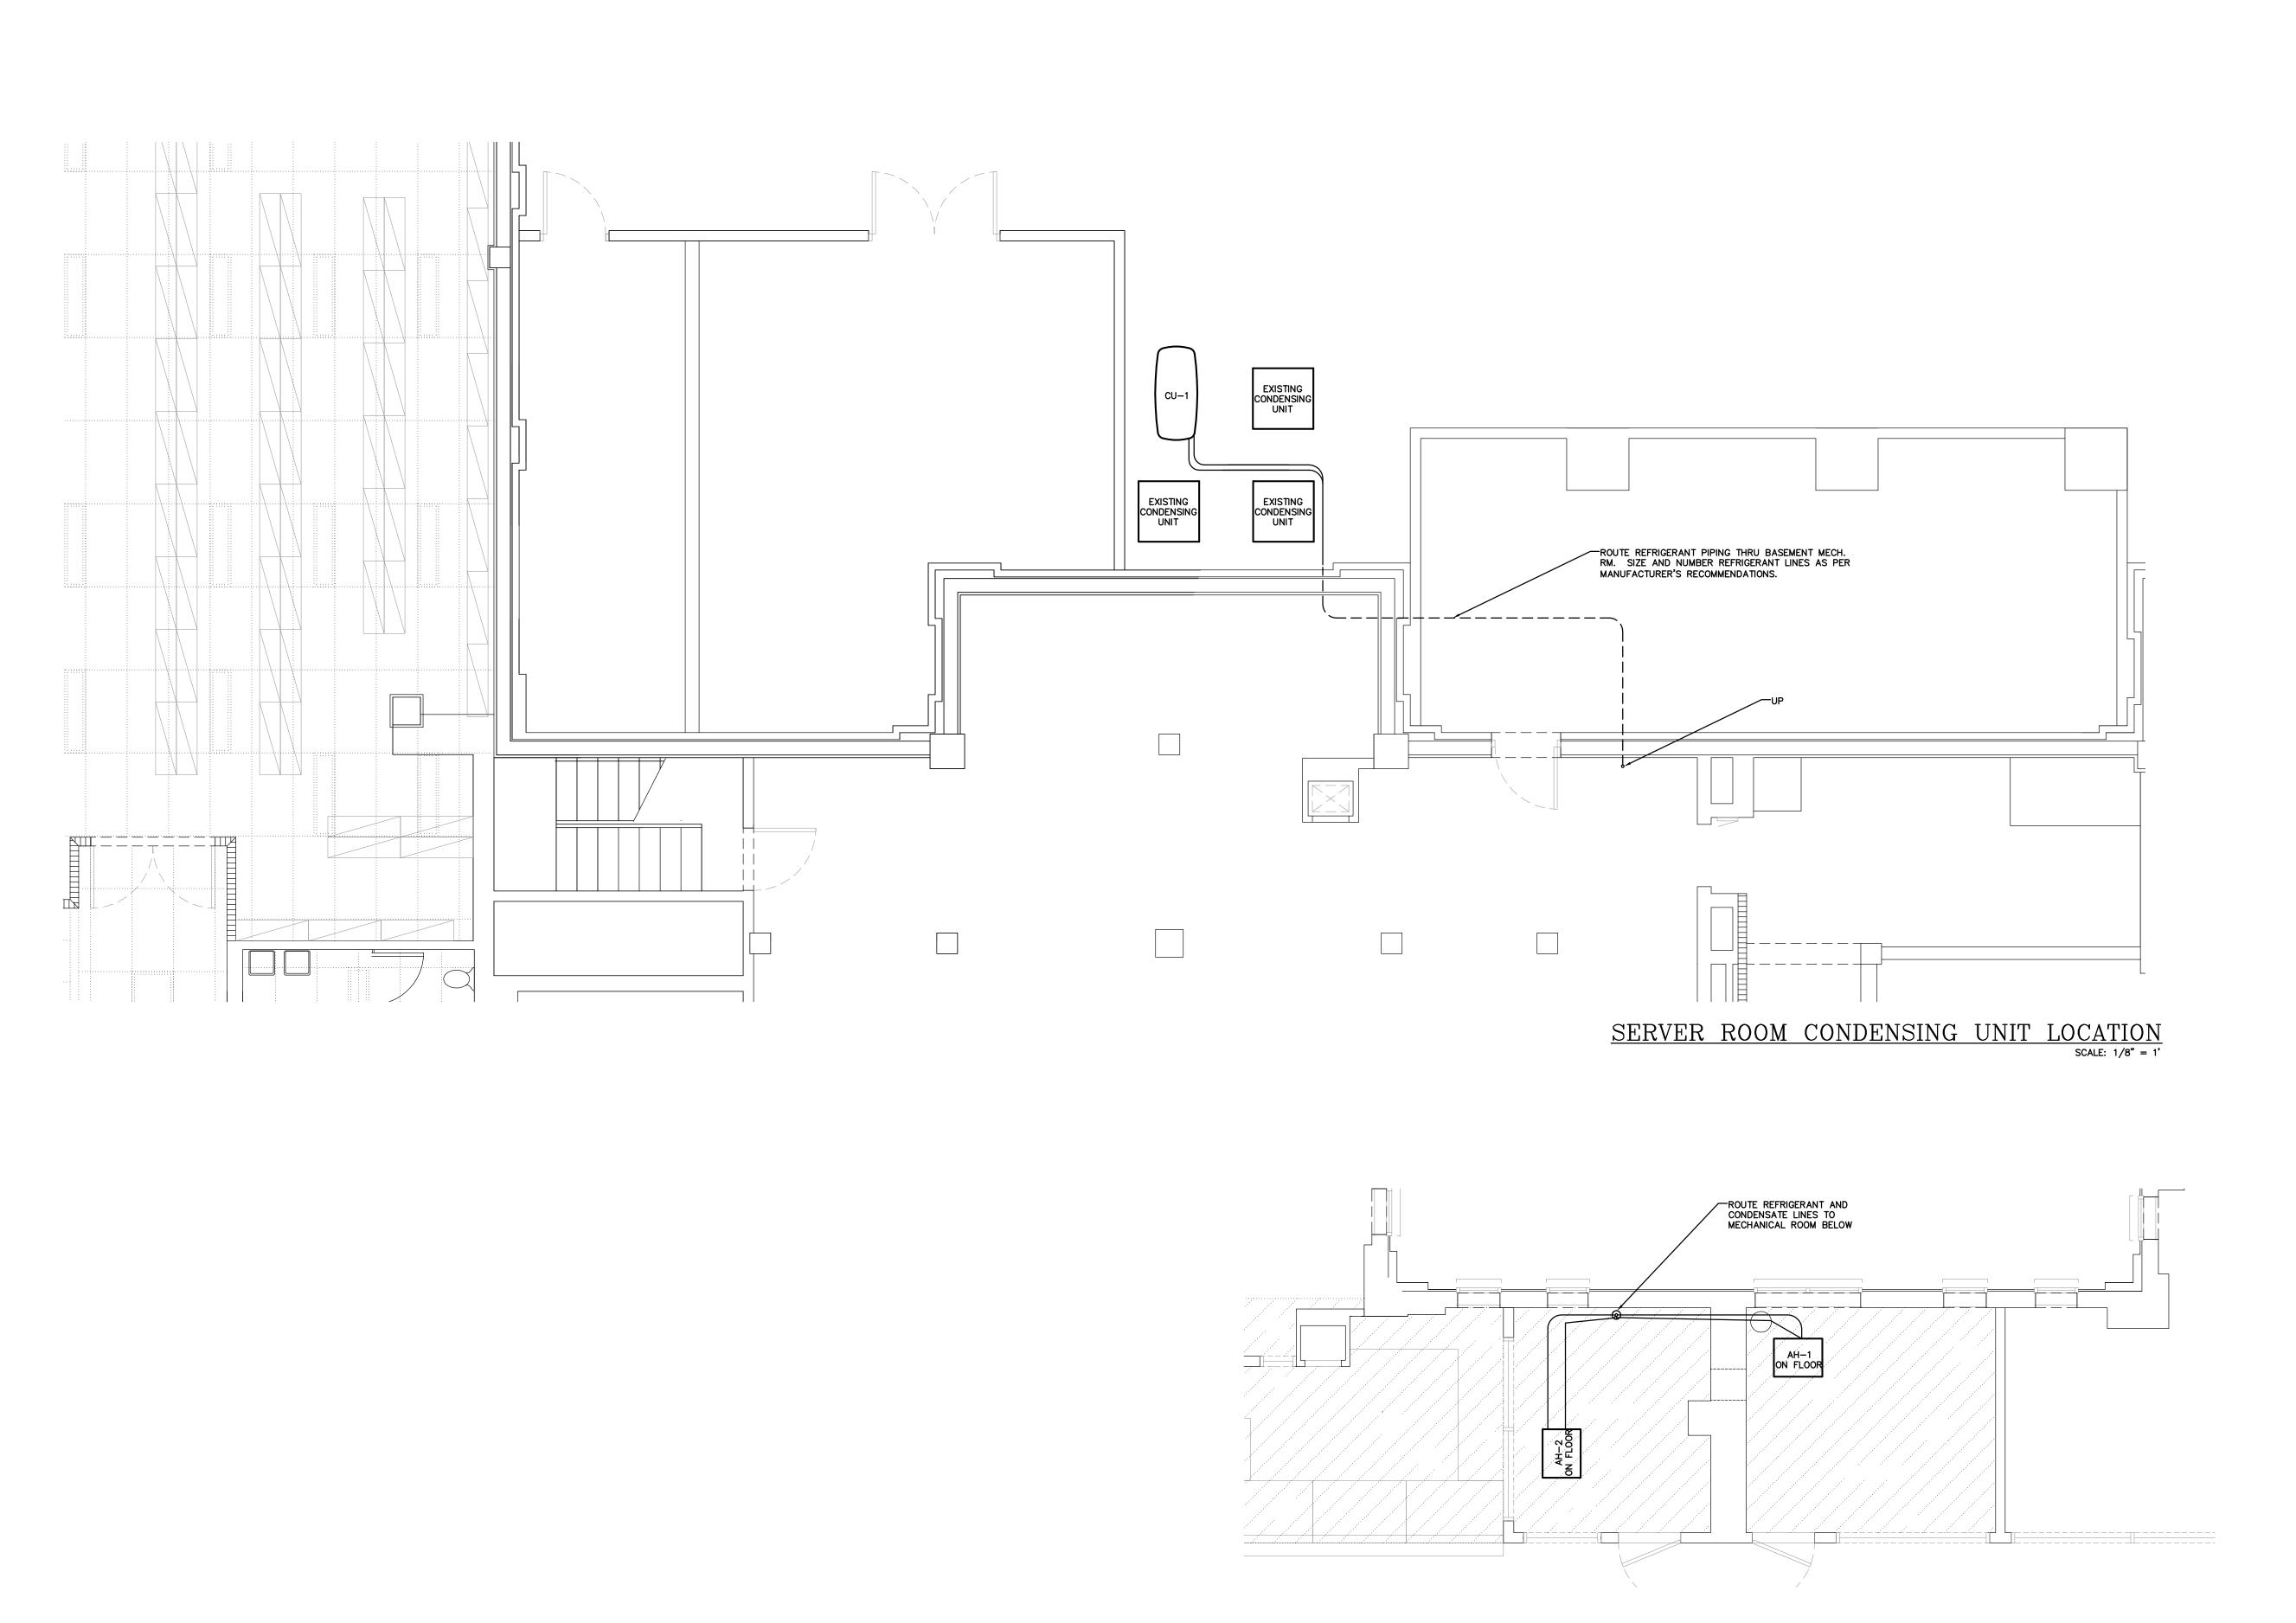NEY ENGINEERING, INC.

'AL & ELECTRICAL CONSULTING ENGINEER.

IVE. CIRCLE EAST, BRADENTON, FL. 34208 C.O.A. #4

18-5884 FAX (941) 747-6240 E-WAII. fri@firmenemainegening.com

M Ph

MANATEE COUNTY
ISTORIC COURTHOUSE
HILLED WATER PIPING

TO THE BEST OF MY KNOWLEDGE, SAID PLANS AND SPECIFICATIONS COMPLY WITH ALL APPLICABLE BUILDING CODES.

GERARD L. ABRAMS P.E. 47786

S E A L

REV. # DATE

REV. # DAT


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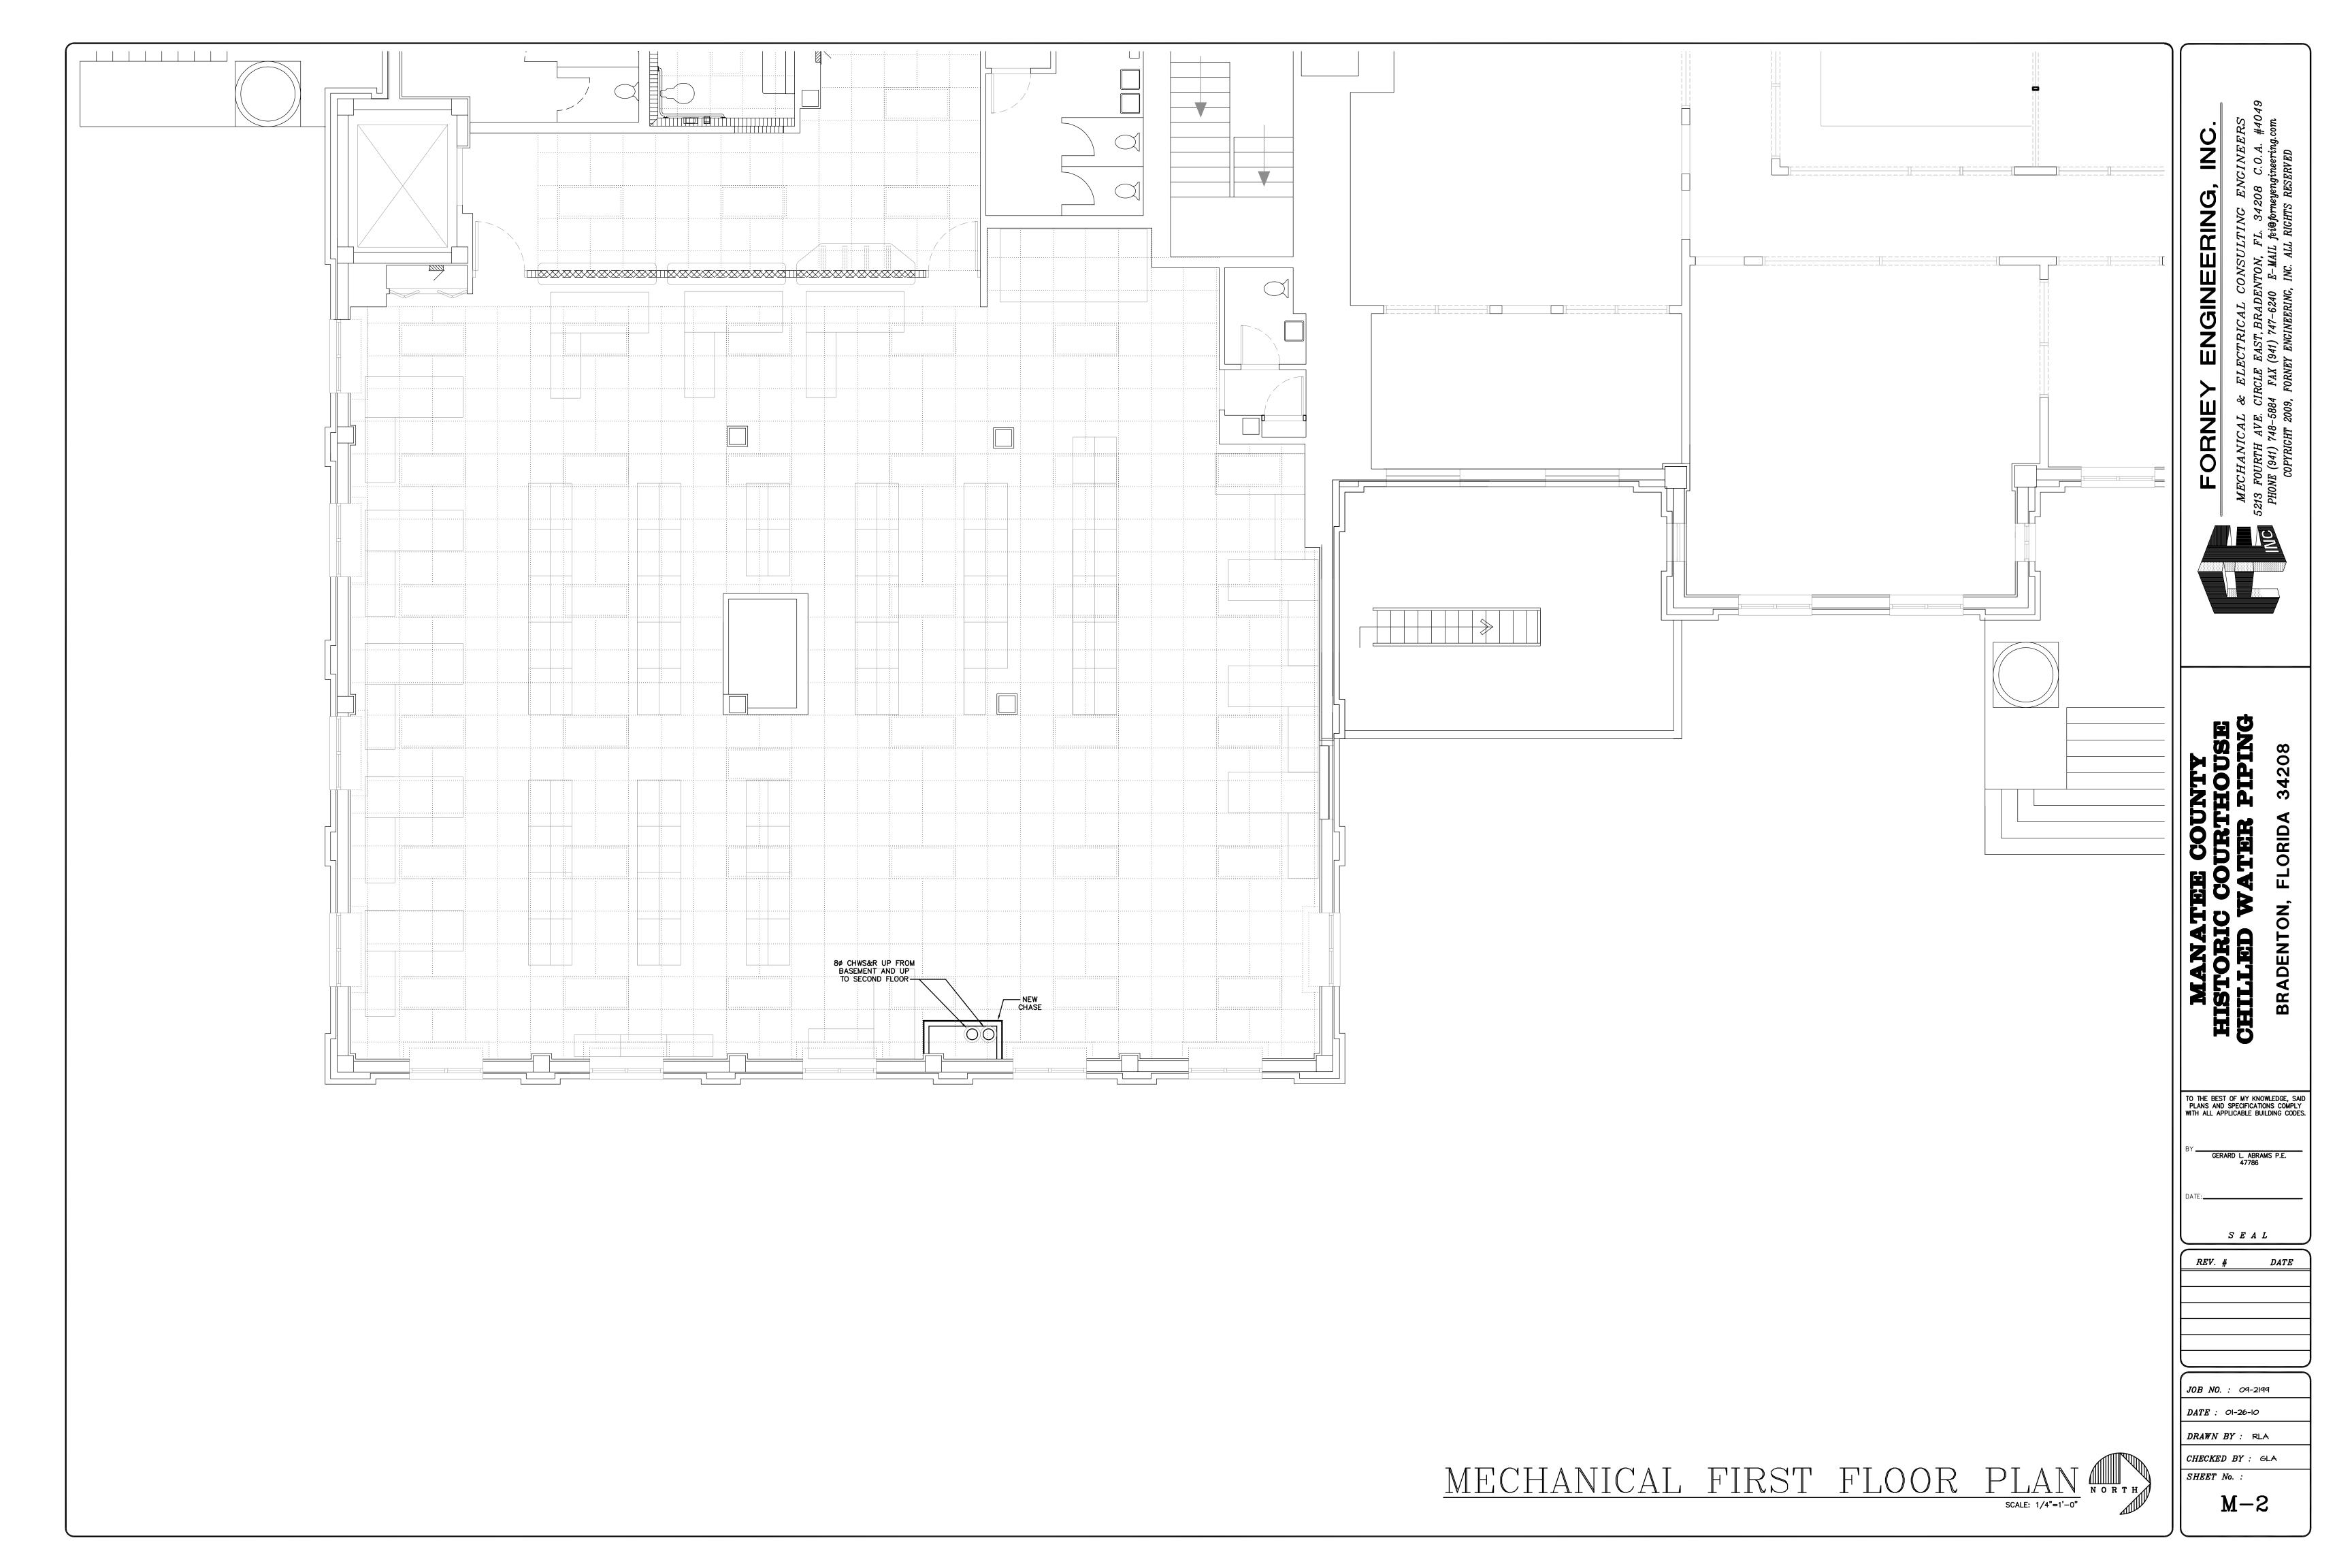
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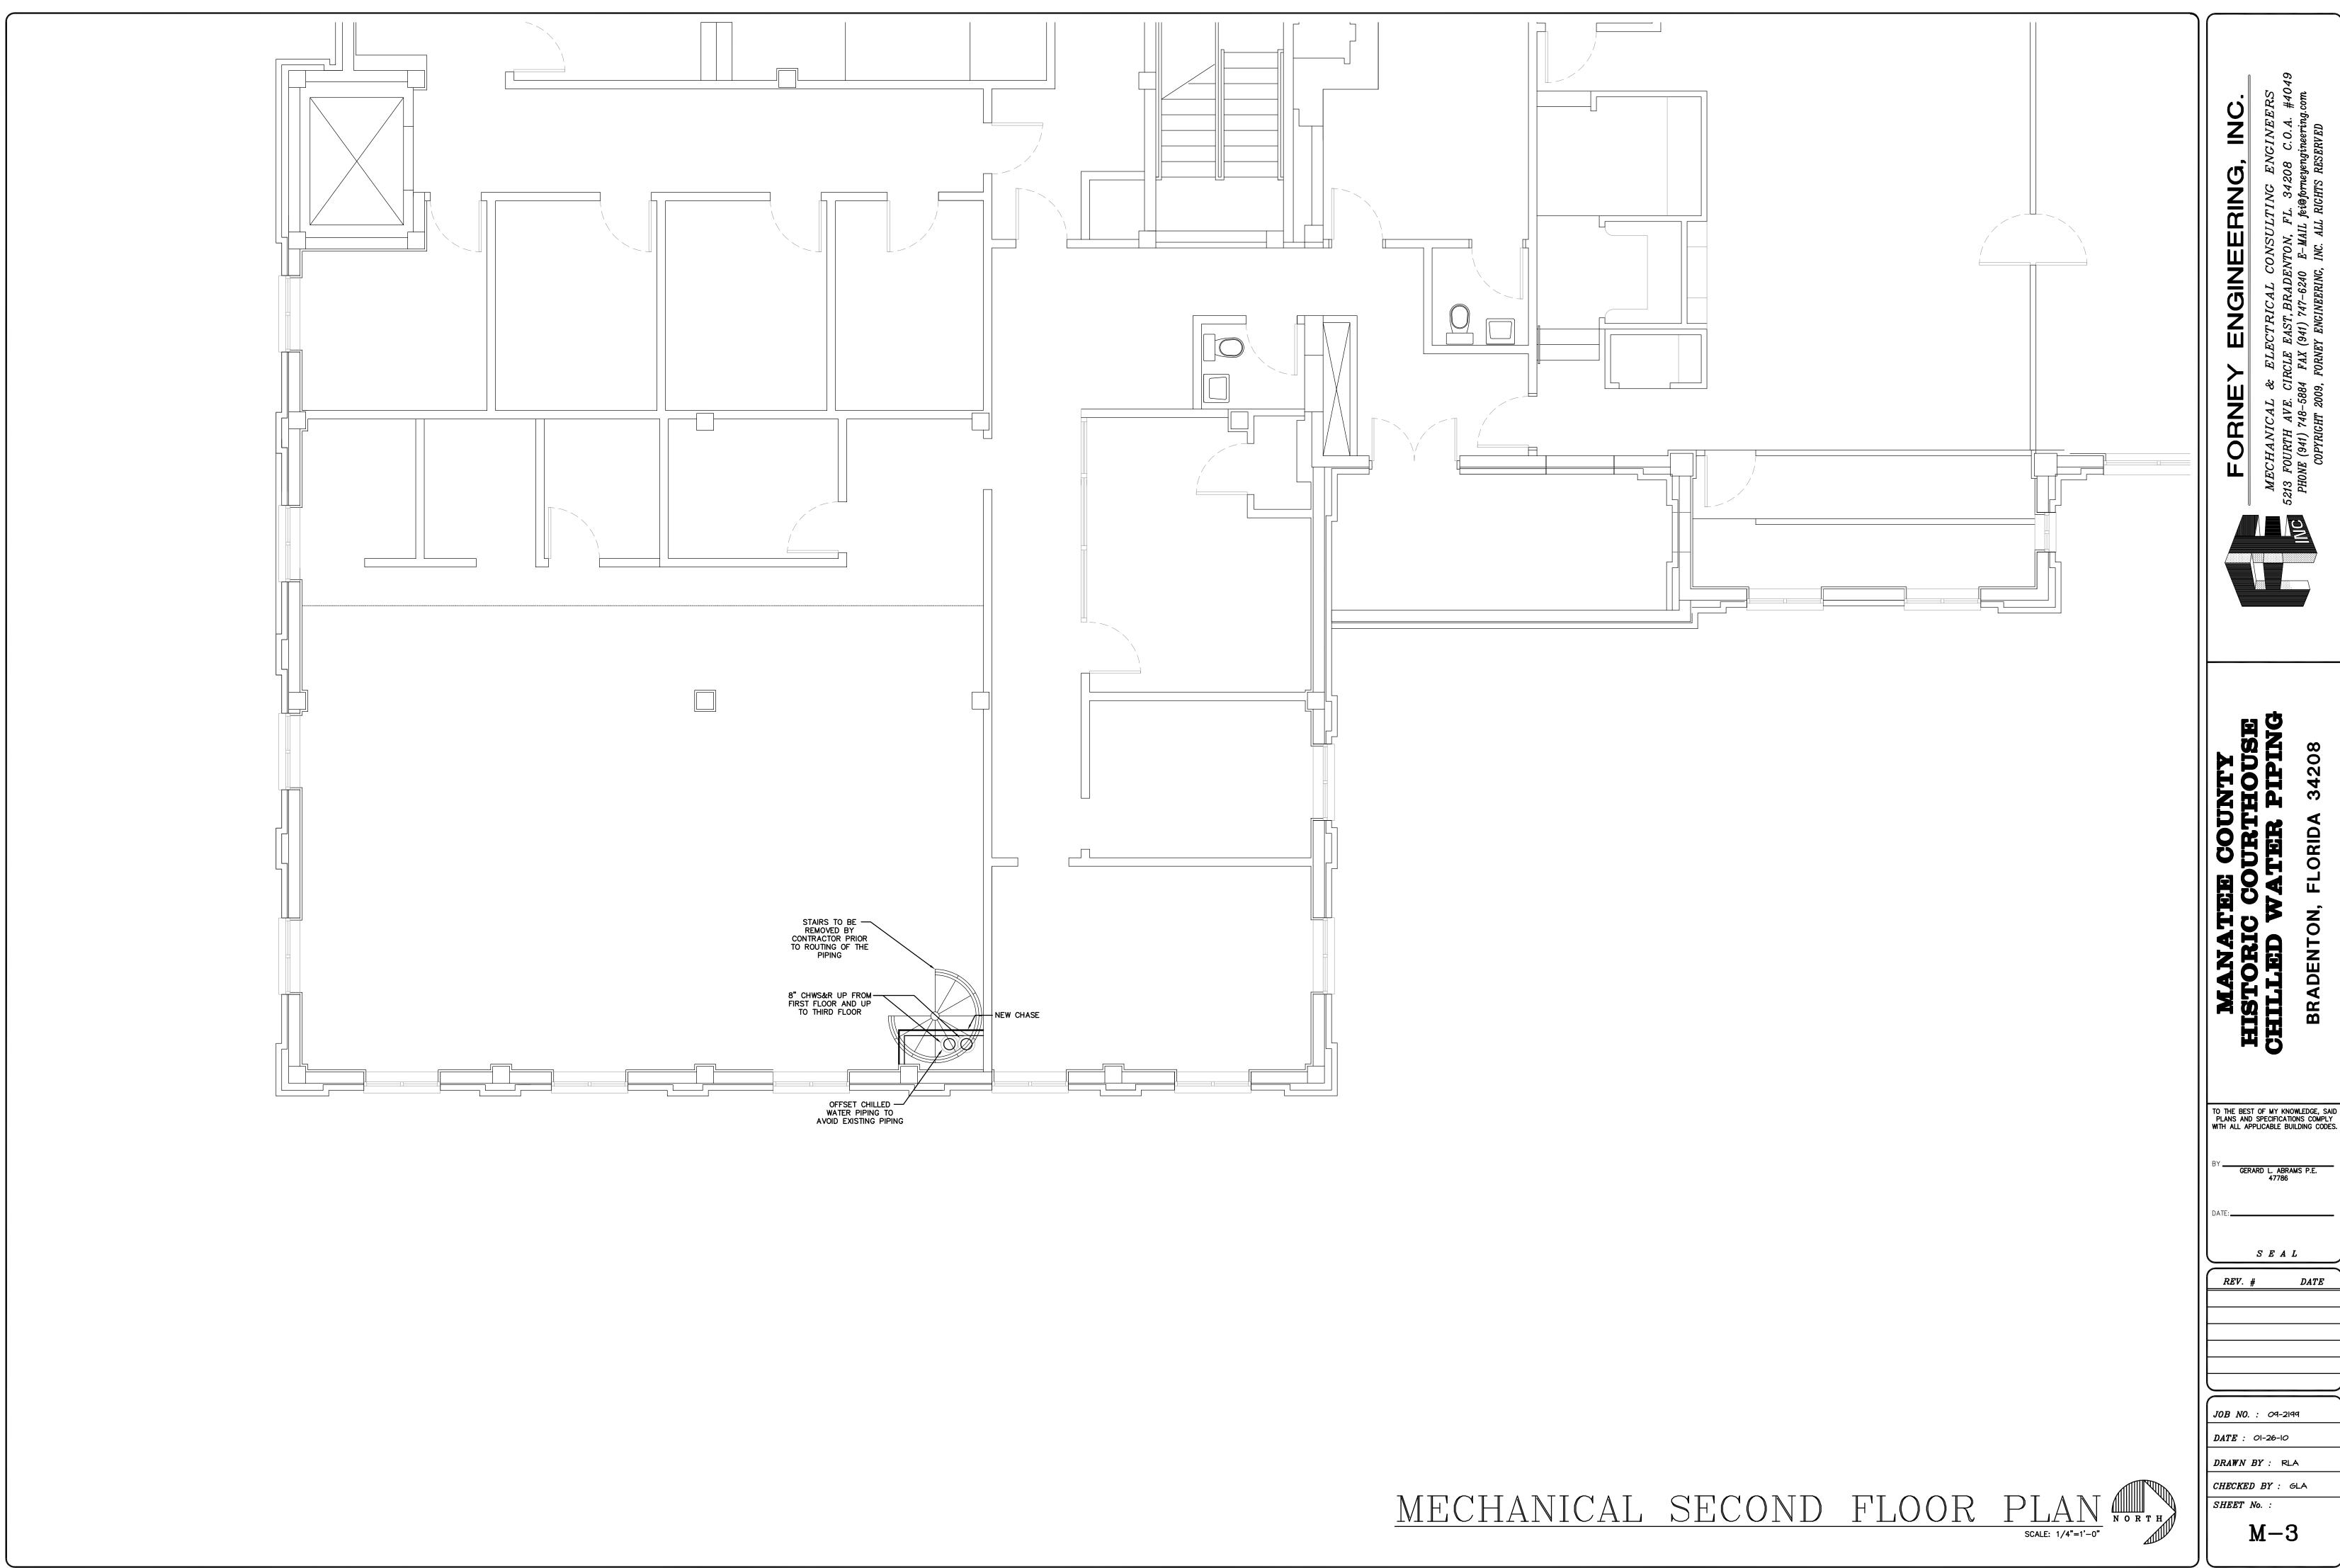
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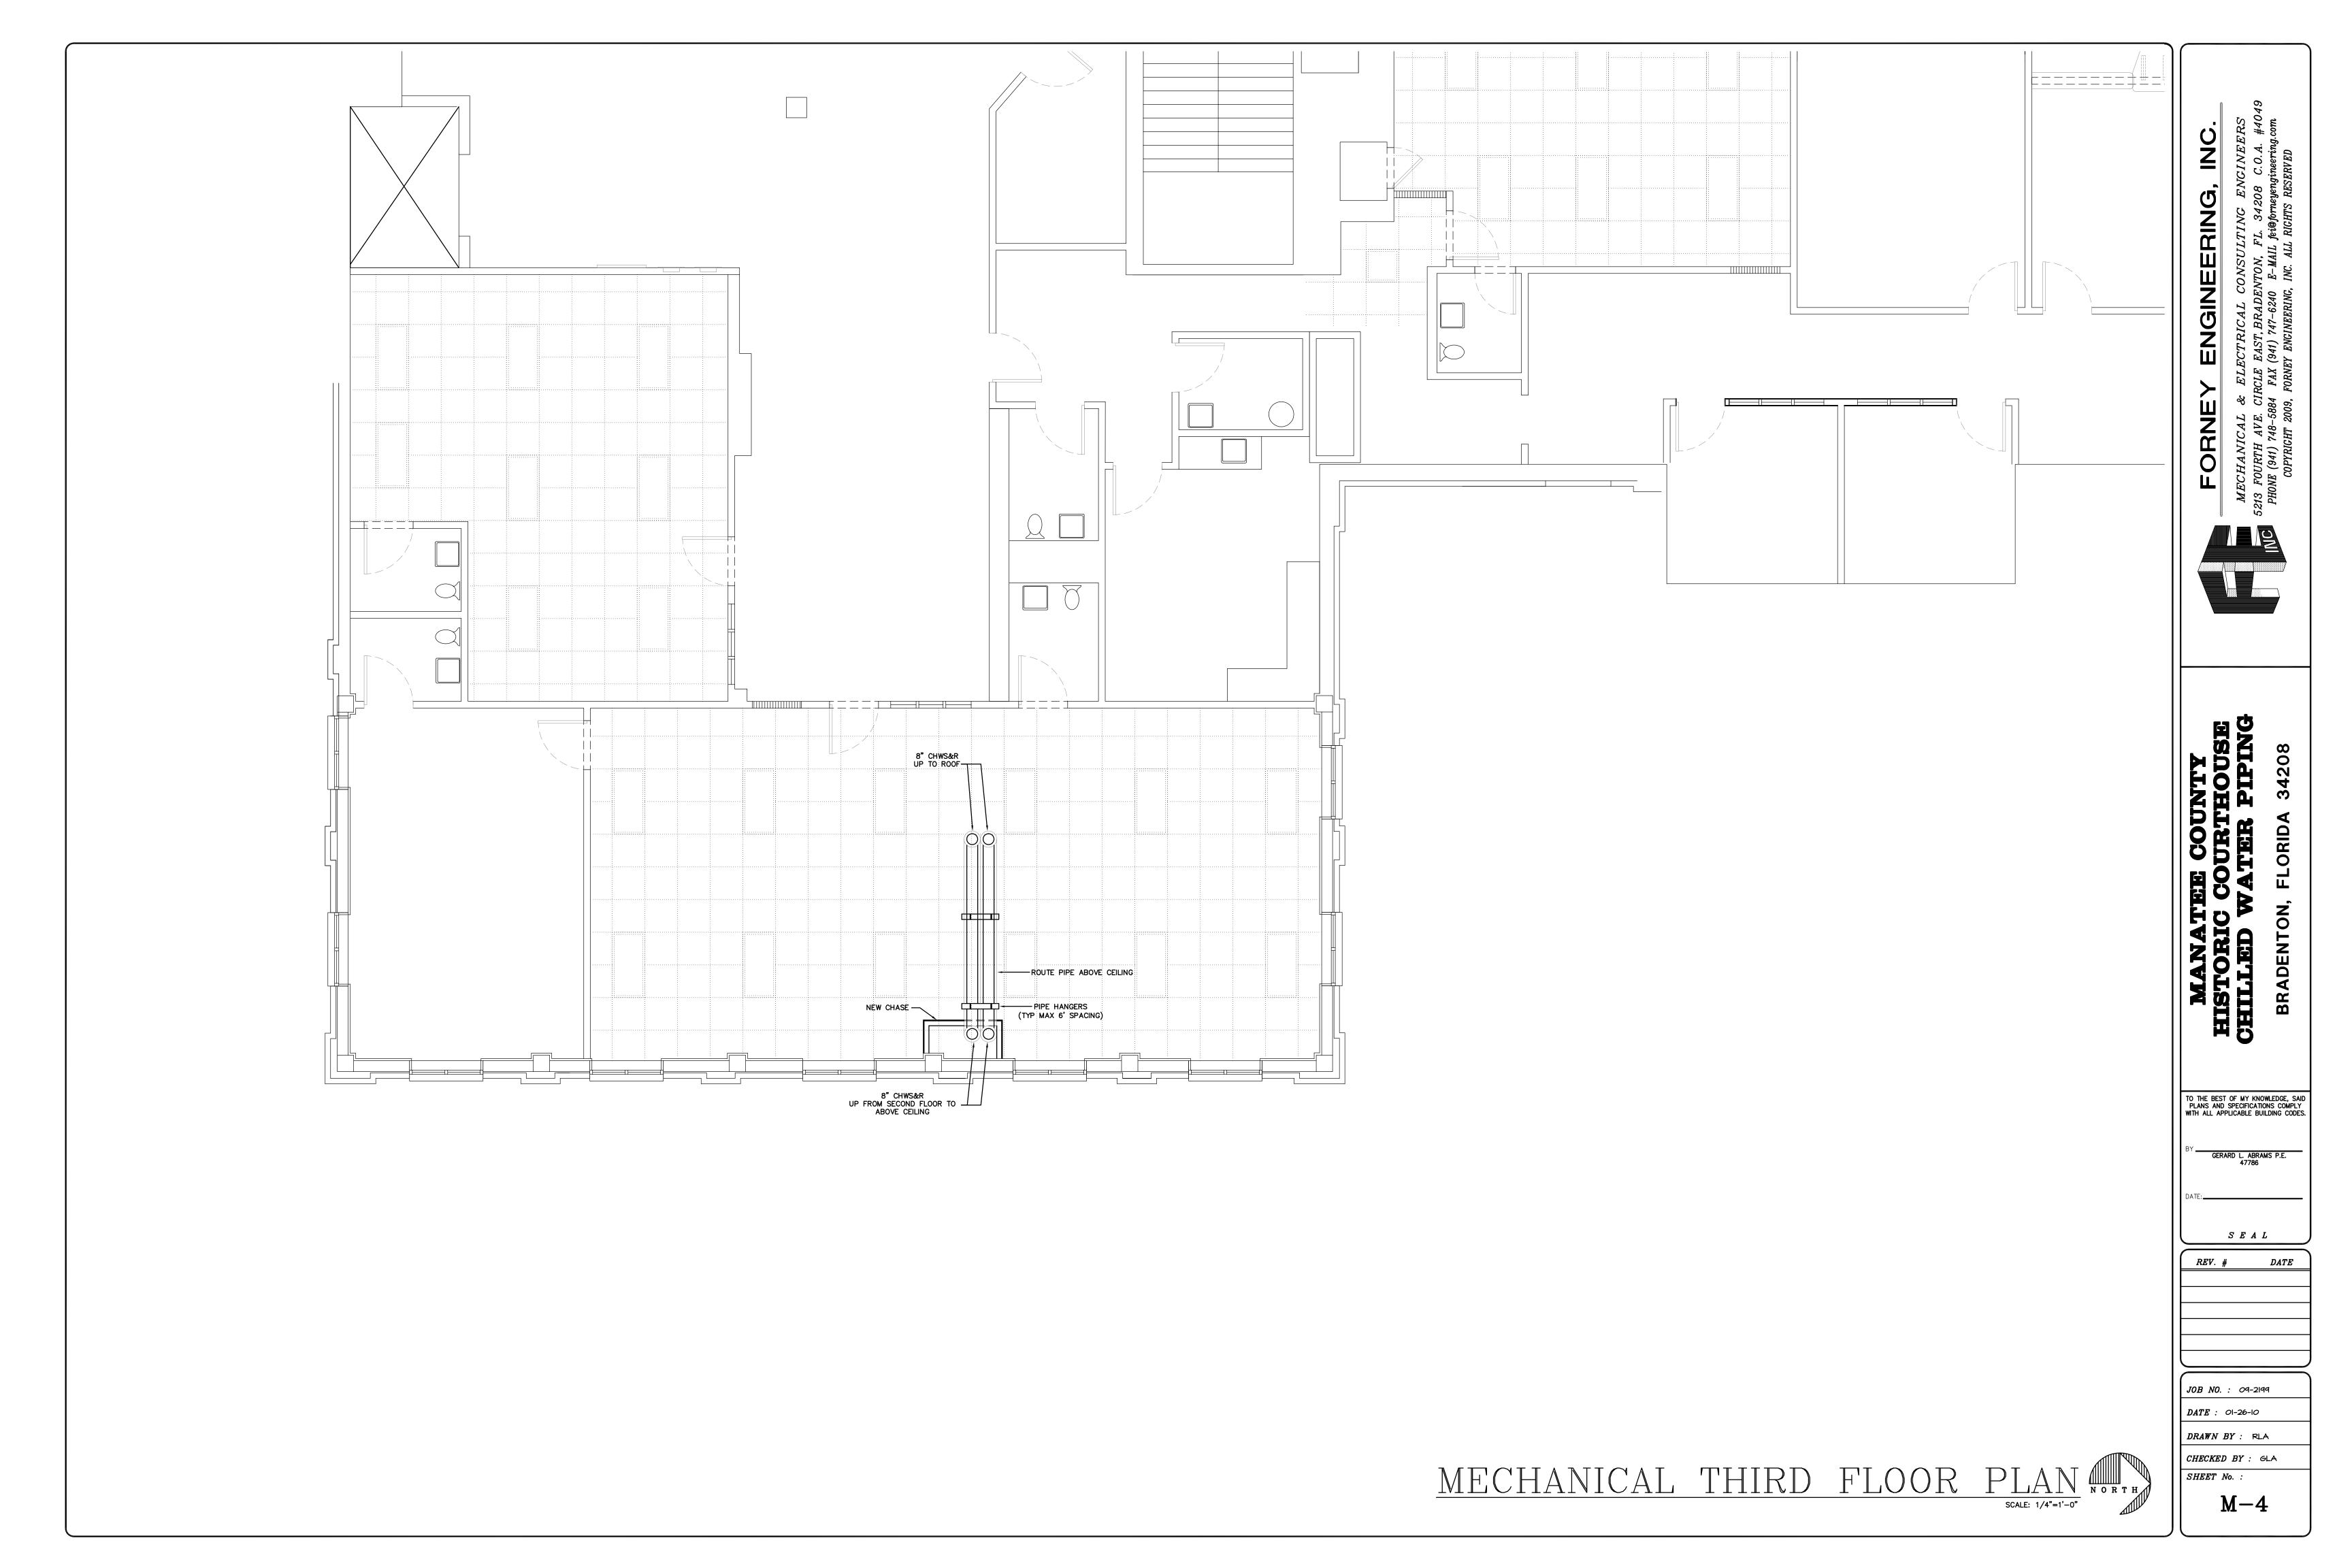






S E A L

DATE

CHECKED BY : GLA

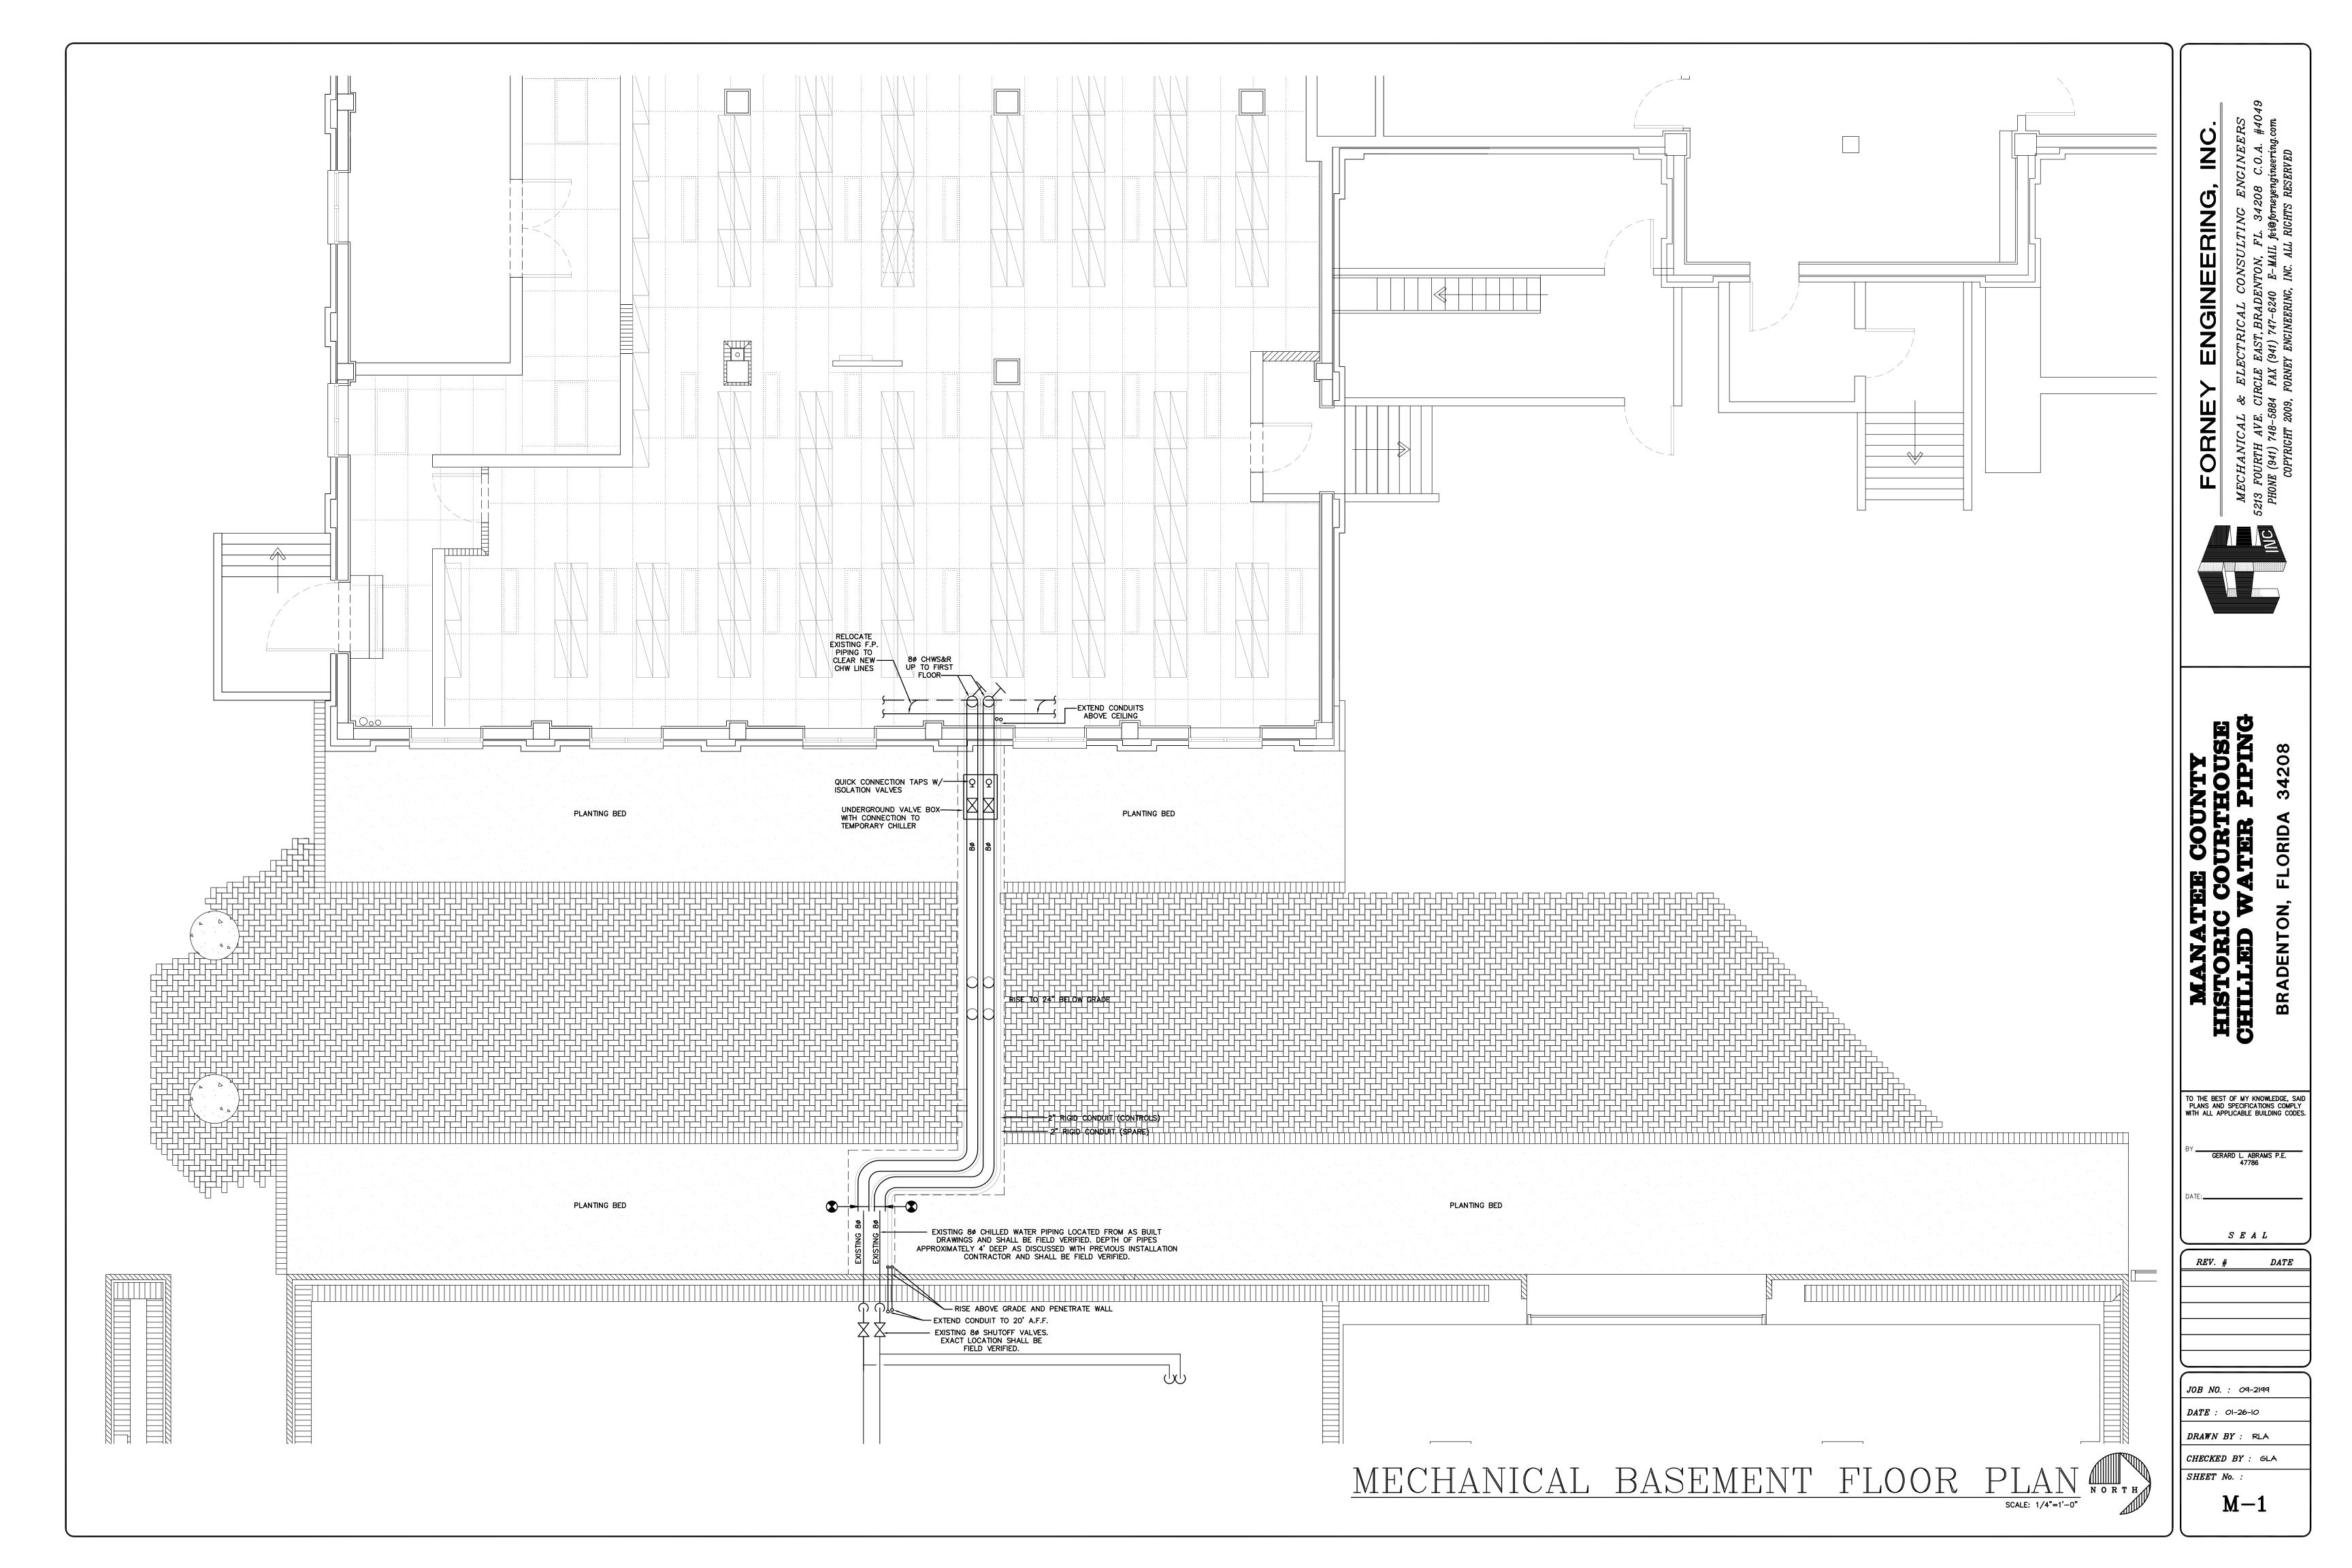

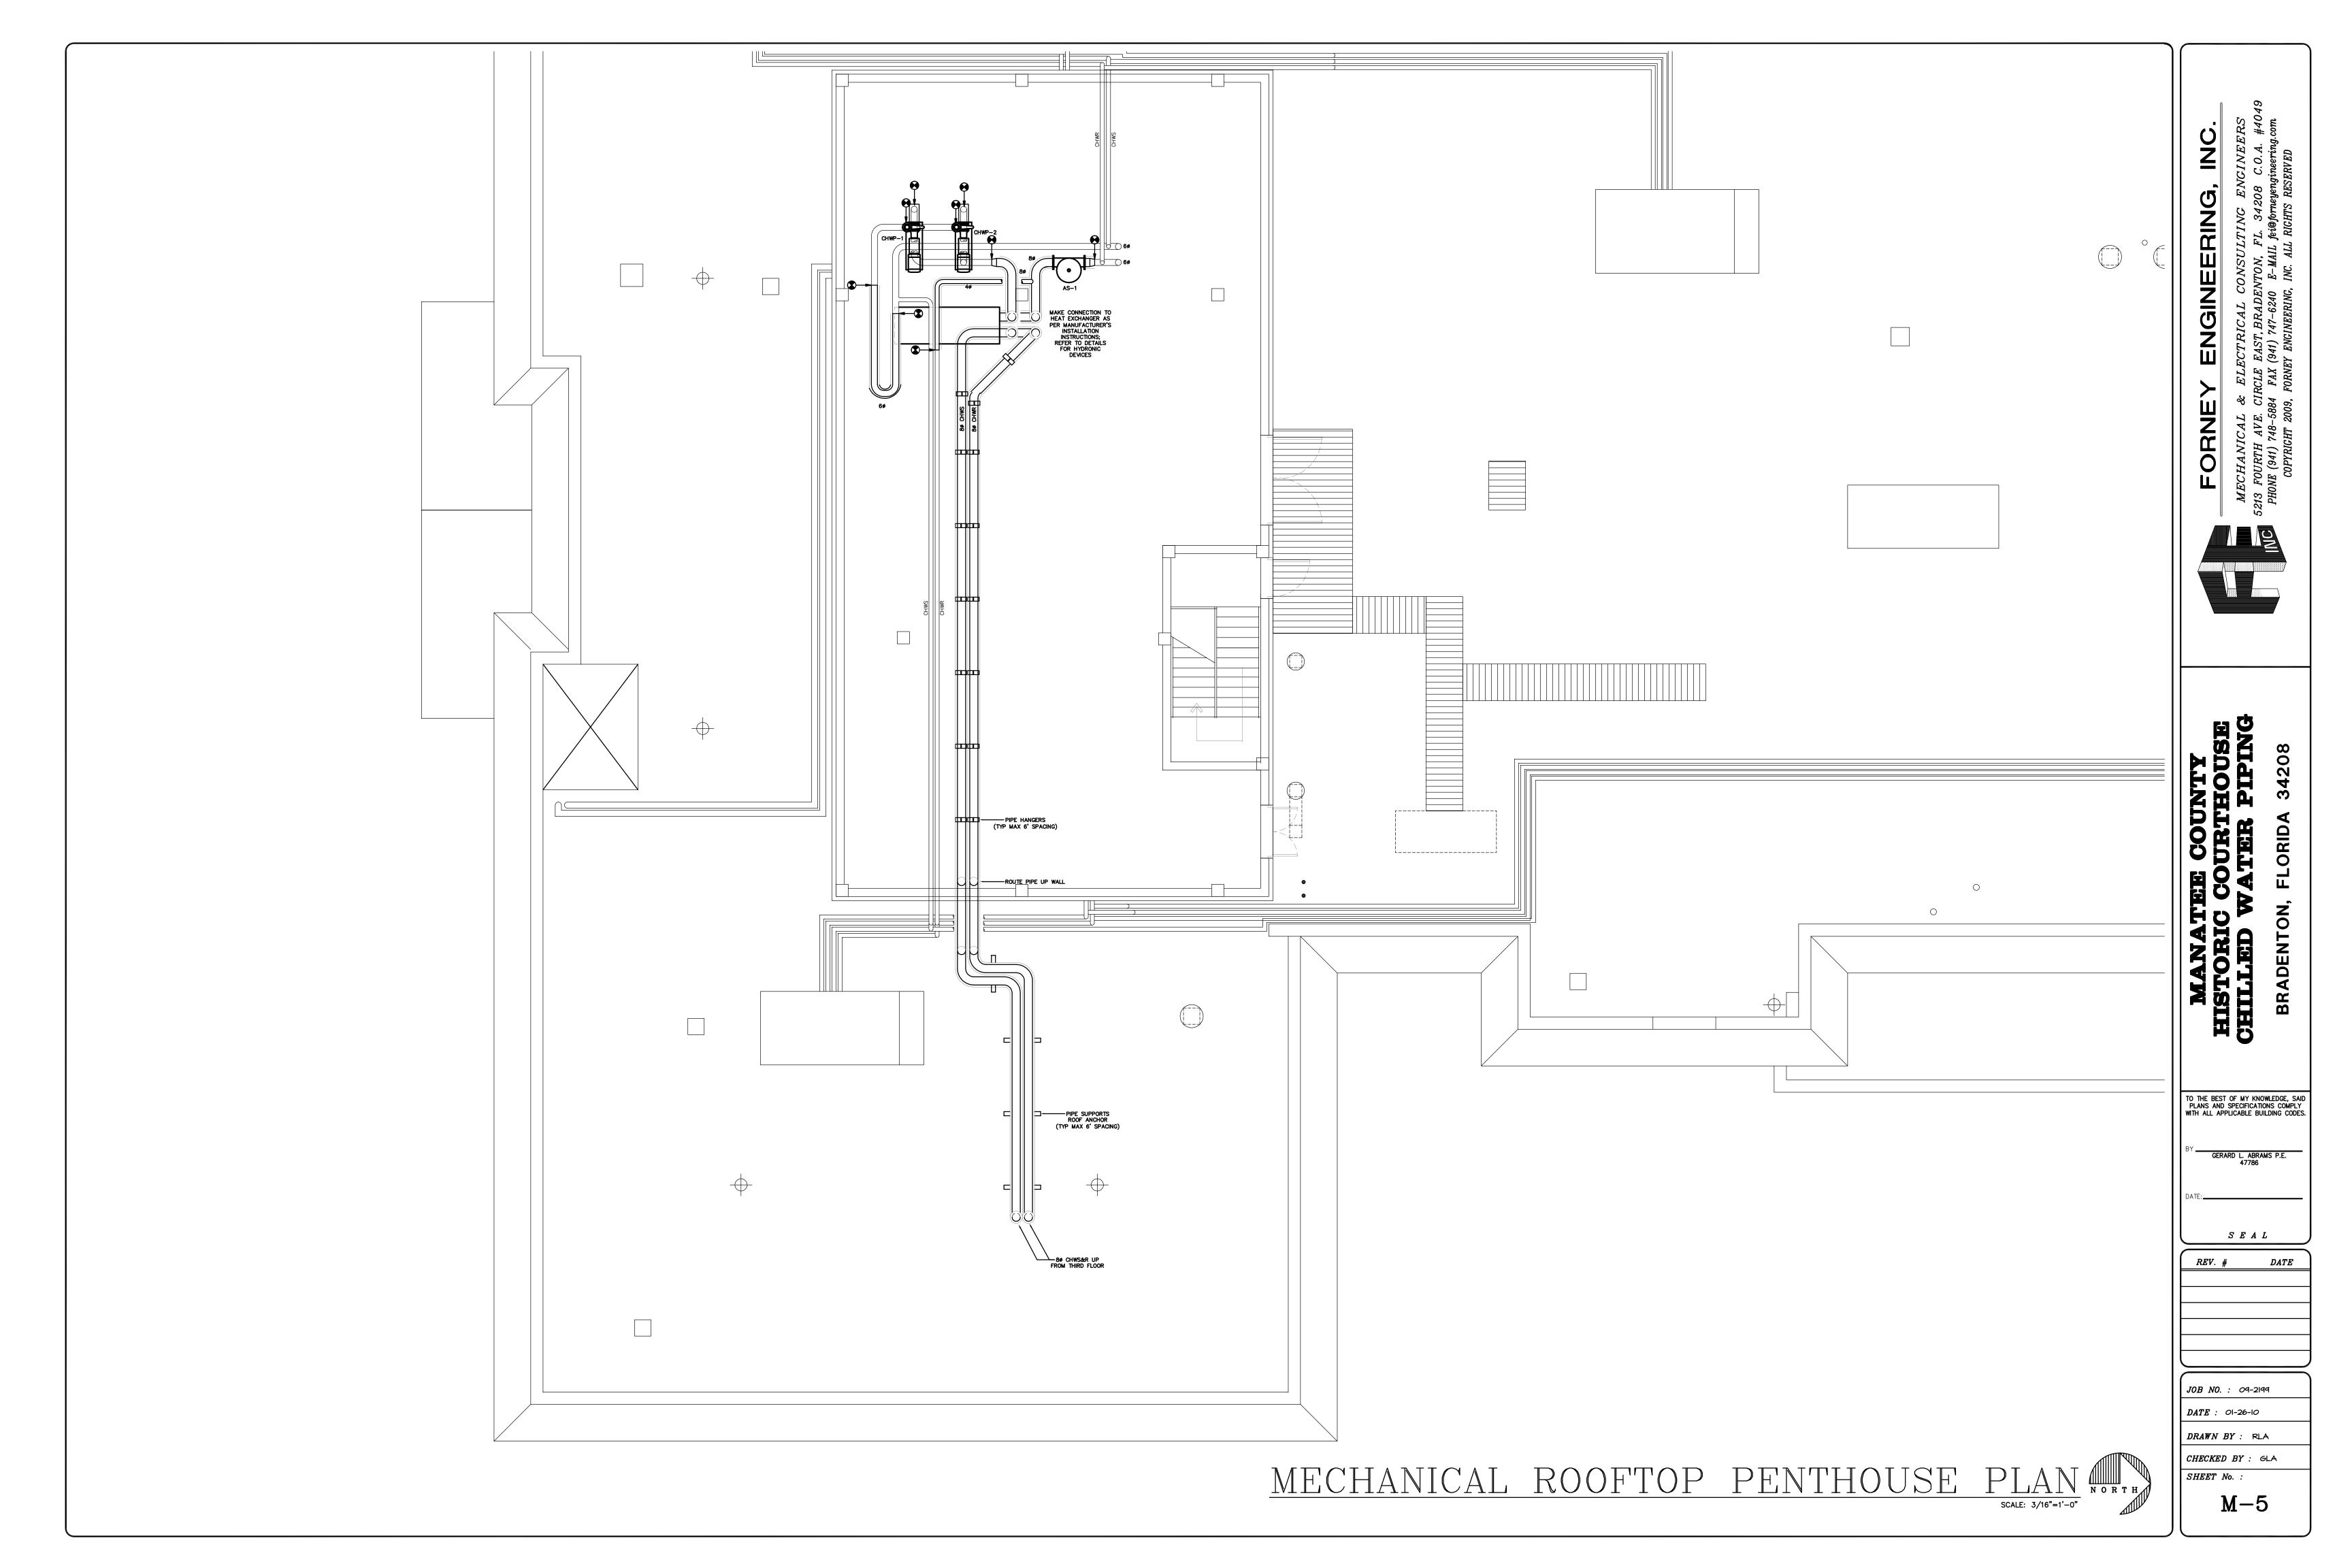

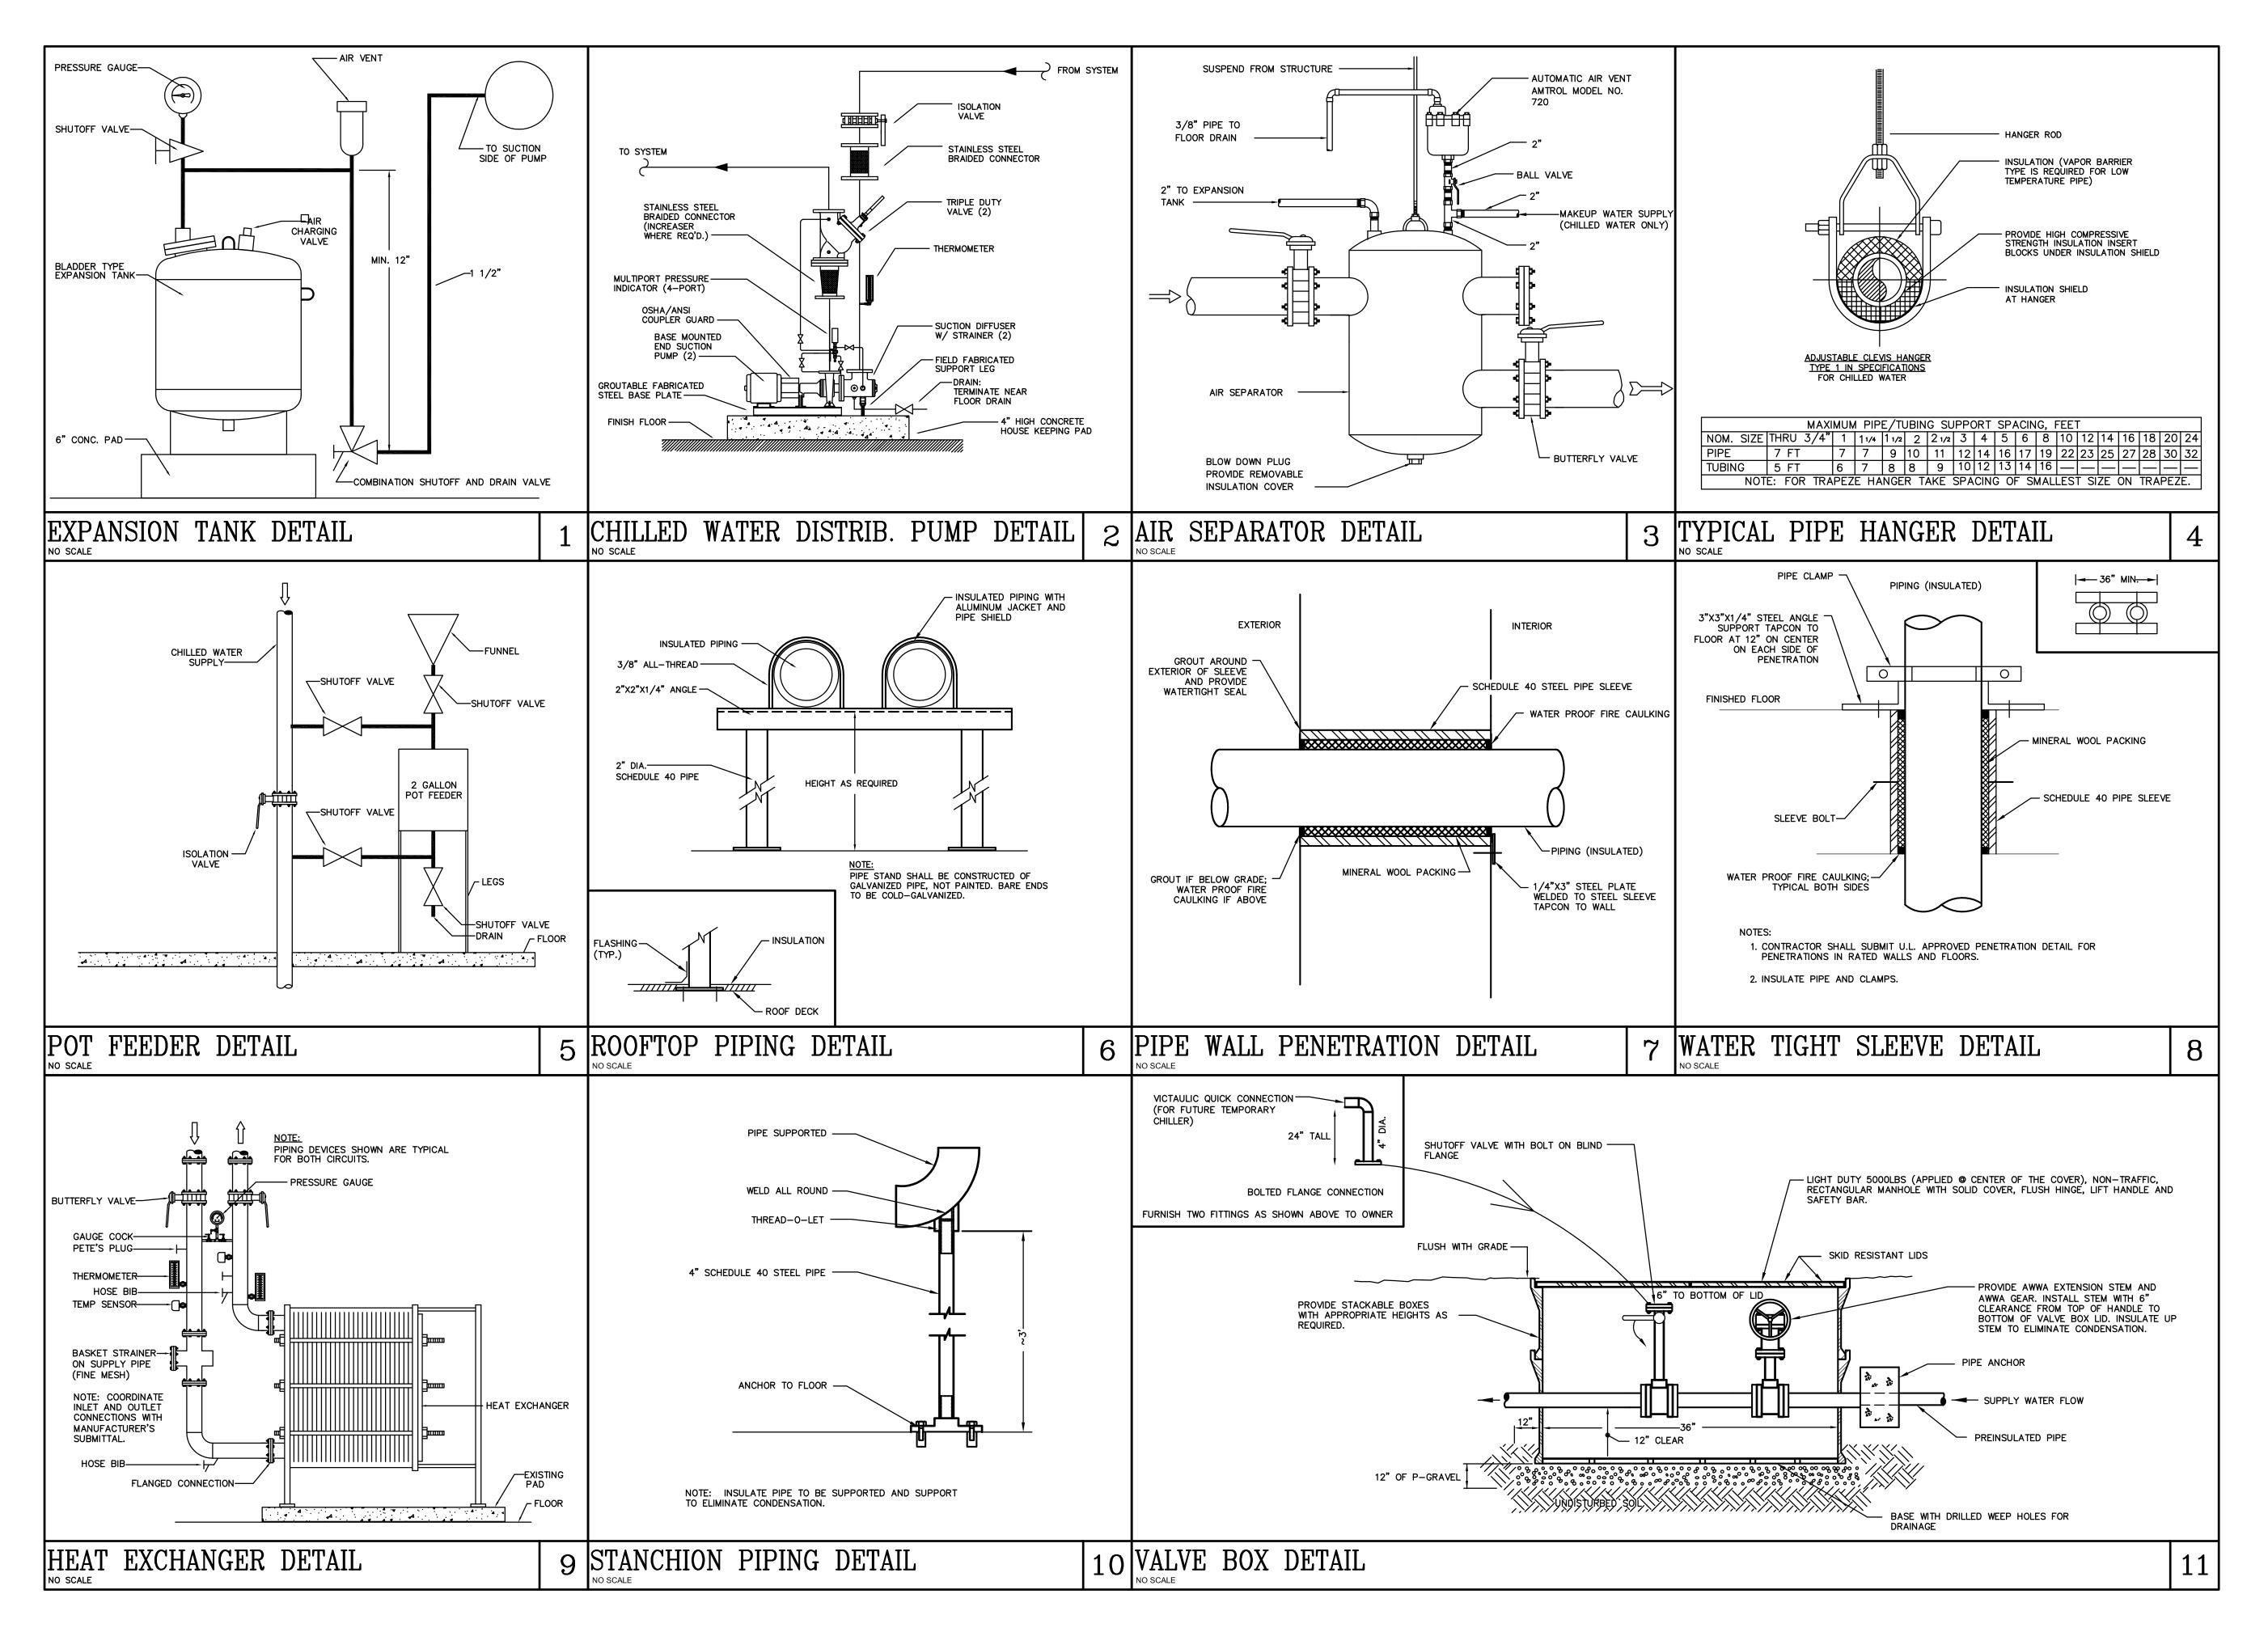

MECHANICAL DETAILS

TO THE BEST OF MY KNOWLEDGE, SAID PLANS AND SPECIFICATIONS COMPLY WITH ALL APPLICABLE BUILDING CODES.

BRADENTON,

GERARD L. ABRAMS P.E. 47786

S E A LREV. #


DATE

JOB NO. : 09-2199

DATE : 01-26-10 DRAWN BY : RLA

CHECKED BY : GLA SHEET No. :

M-6

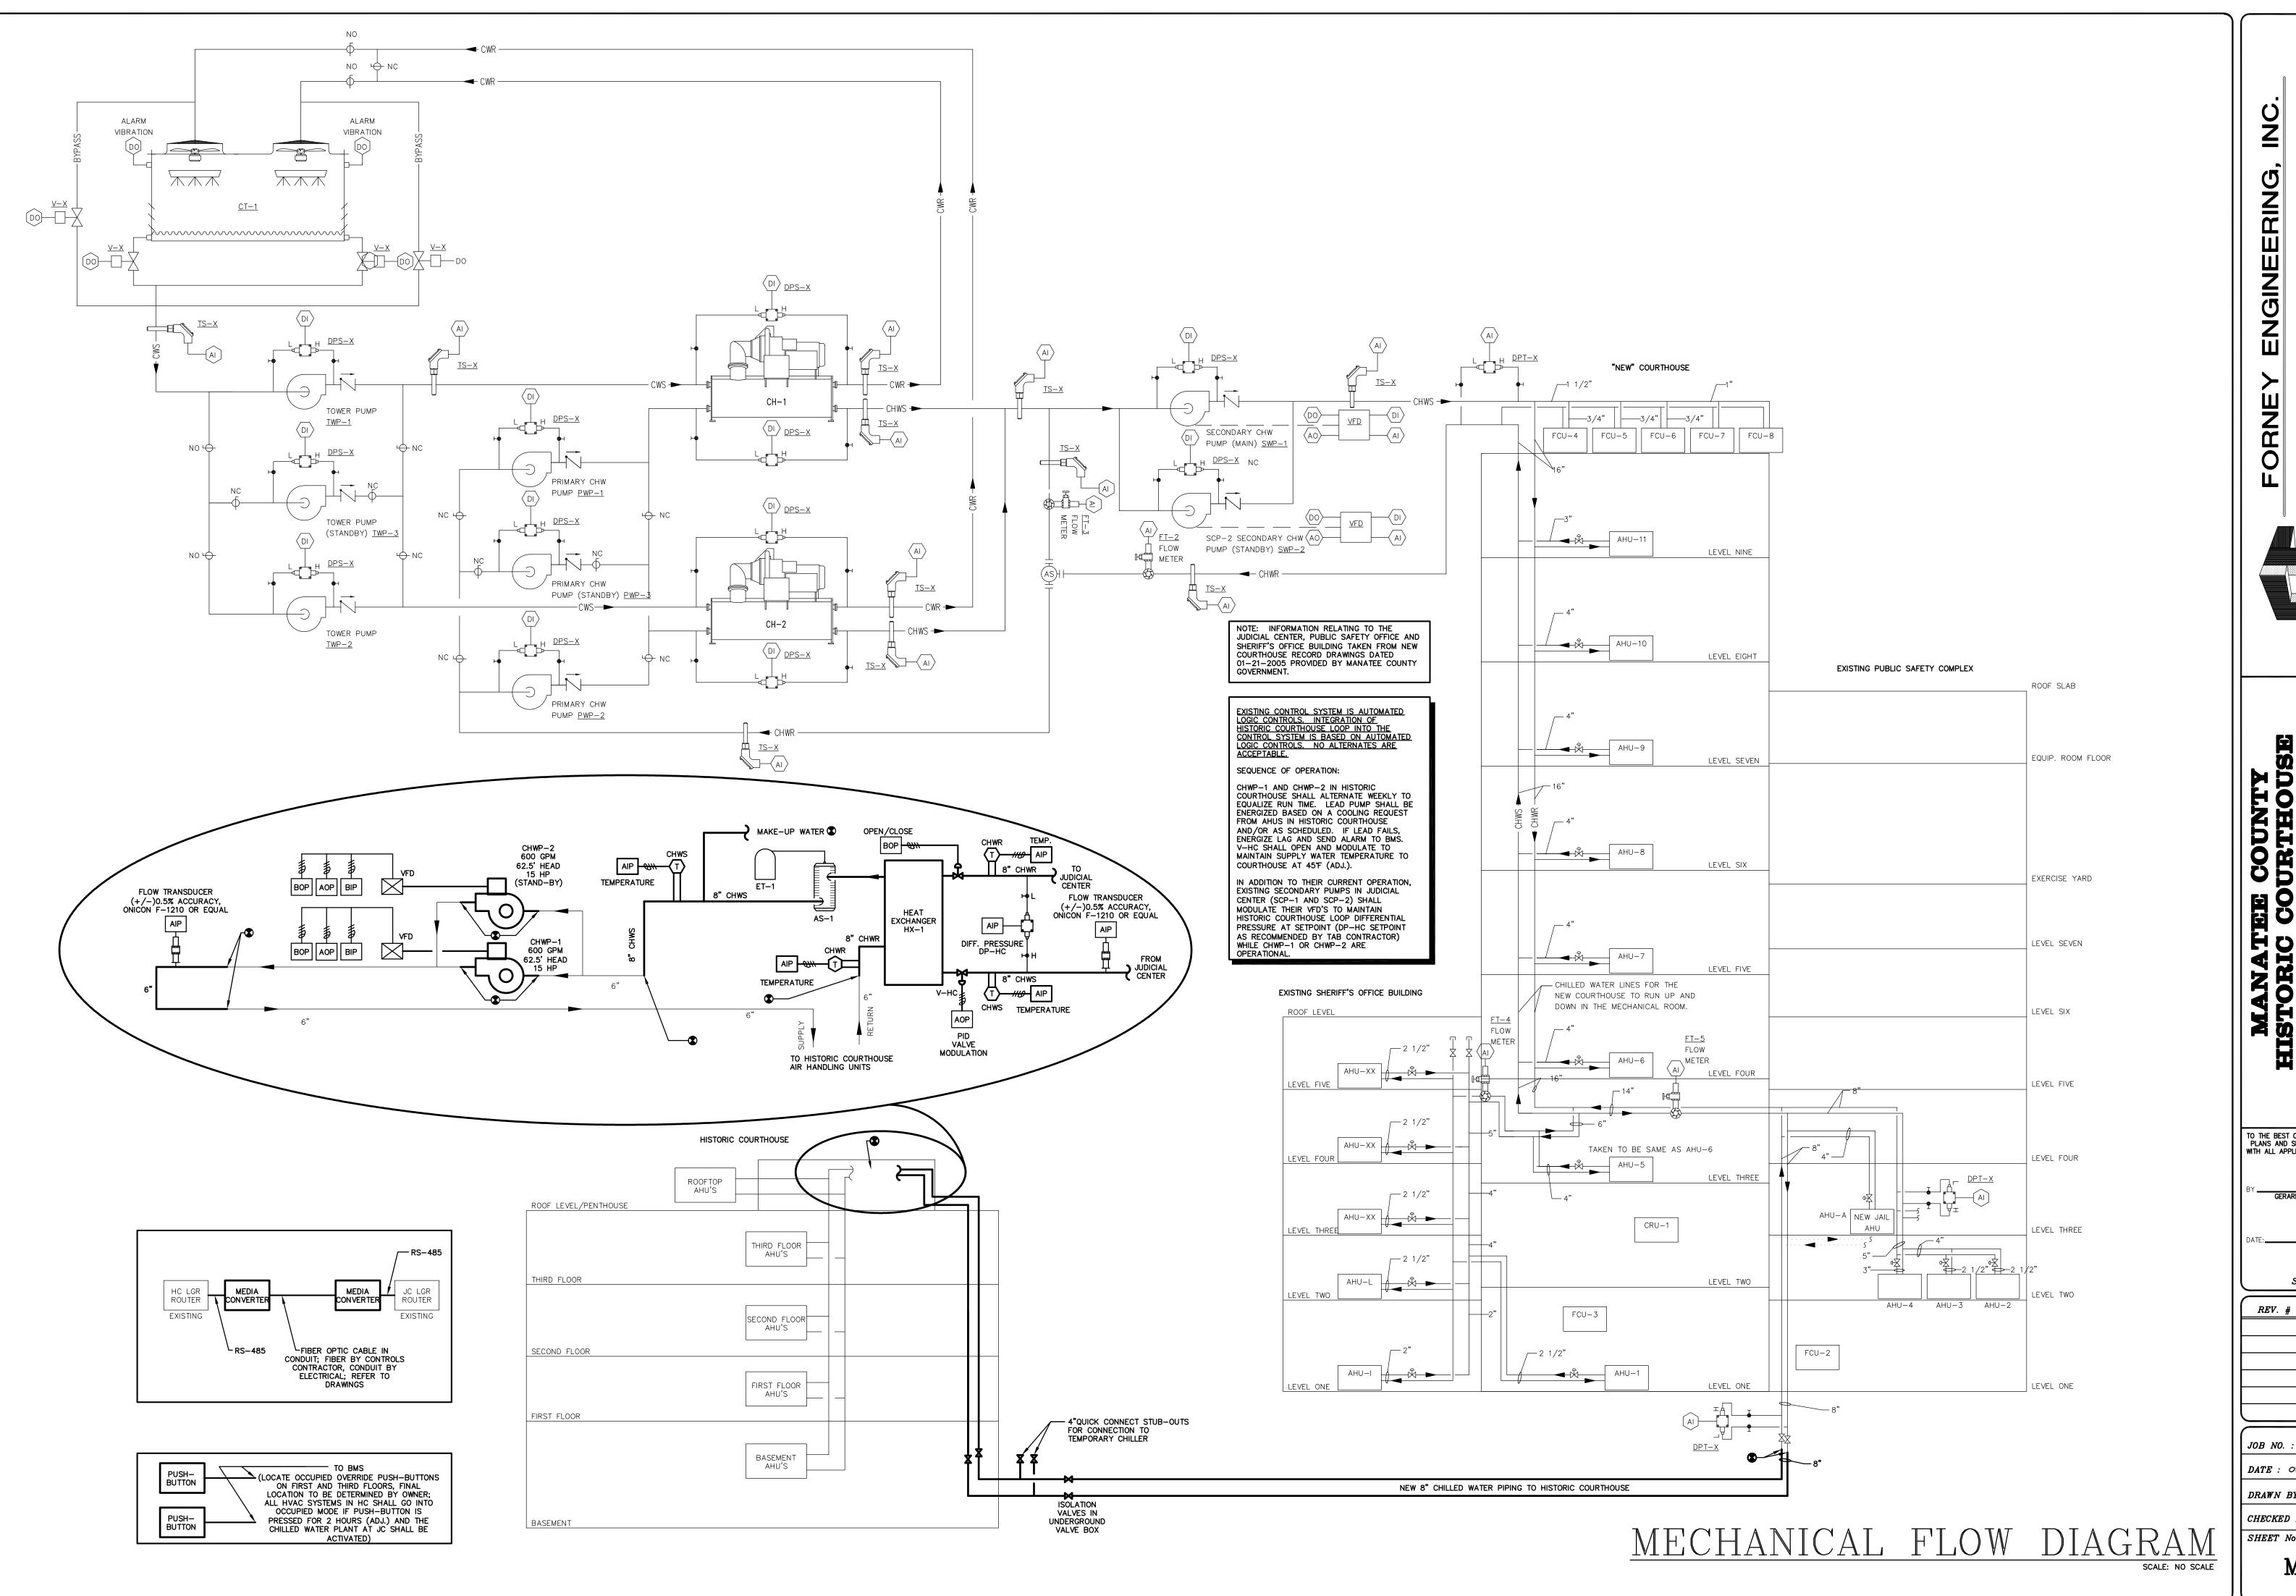

MANATEE COUNTY HISTORIC COURTHOUSE CHILLED WATER PIPING

34208 FLORIDA BRADENTON,

TO THE BEST OF MY KNOWLEDGE, SAID PLANS AND SPECIFICATIONS COMPLY WITH ALL APPLICABLE BUILDING CODES.


GERARD L. ABRAMS P.E. 47786

S E A LDATE

JOB NO. : 09-2199 DATE : 01-26-10

DRAWN BY : RLA CHECKED BY : GLA

SHEET No. : M-7

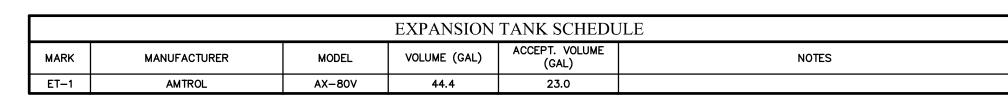

	POT FEEDER SCHEDULE								
MARK	MANUFACTURER	NOTES							
PF-1	B & G	FA-700	2.0						

	AIR SEPARATOR SCHEDULE									
MARK	MANUFACTURER	MODEL	GPM	NOTES						
AS-1	AMTROL	AS-6	575	UNIT SHALL HAVE STAINLESS STEEL STRAINER WITH 3/16" PERFORATIONS						

PU	JMP SCHEDULE			
MARK	CHWP-1	CHWP-2		
SERVICE	CHILLED WATER	CHILLED WATER		
MANUFACTURER	BELL & GOSSETT	BELL & GOSSETT		
SERIES	1510	1510		
FLOW RATE	600	600		
TOTAL HEAD	62.5	62.5		
ELECTRICAL (V/PH/HZ)	480/3/60	480/3/60		
MOTOR (HP)	15	15		
MOTOR SPEED (RPM)	1750	1750		
PUMP STYLE	END SUCTION-BASE	END SUCTION-BASE		
PUMP SIZE	4BC	4BC		
SUCTION SIZE	5"	5"		
DISCHARGE SIZE	4"	4"		
IMPELLER SIZE	9.25"	9.25"		
MIN. EFFICIENCY (%)	82.7	82.7		

VARIABLE FREQUENCY DRIVE SCHEDULE							
MARK	VFD-CHWP1	VFD-CHWP2					
MANUFACTURER	ABB	ABB					
MODEL	ACH550	ACH550					
SERVING	CHWP-1	CHWP-2					
HORSEPOWER	15	15					
ELECTRICAL	480/3/60	480/3/60					
RATED INPUT/OUTPUT AMPS (A)	23.0	23.0					
. PROVIDE WITH BY-PASS WITH CIRCUIT BREAKER DISCONN	ECT. BYPASS SHALL BE	CAPABLE OF					

- PROVIDE WITH BY-PASS WITH CIRCUIT BROPERATING UNIT WITH DRIVE REMOVED.
 PROVIDE WITH 5% INPUT LINE REACTOR.
 PROVIDE WITH 2-YEAR WARRANTY.
 PROVIDE REGISTERED START-UP.
 PROVIDE WITH NEMA 12 ENCLOSURE.
- 6. ALL VFD'S SHALL BE BY SAME MANUFACTURER.
 7. ALL VFD'S SHALL HAVE BACNET COMMUNICATION.

NOTES:

1. CHILLED WATER PUMPS SHALL HAVE VARIABLE FREQUENCY DRIVES FOR BALANCING PURPOSES.

2. MOTORS SHALL BE PREMIUM TYPE EQUAL TO BALDOR SUPER "E" AND SHALL HAVE CLASS "F" INSULATION..

3. PROVIDE WITH FACTORY INSTALLED DRIP PAN WITH 1" DRAIN CONNECTION.

4. ALL PUMP SELECTIONS' FLOW AT BEST EFFICIENCY POINT SHALL BE WITHIN +/-10% OF DESIGN FLOWS SCHEDULED.

5. APPLY 2 COATS OF RUST PREVENTATIVE ENAMEL PAINT ON CASING AND DRAIN PAN. PAINT COLOR TO BE RED.


6. CHILLED WATER CASINGS ARE NOT TO BE INSULATED.

SPLIT SYSTEM AC SC	CHEDULE	
MARK	AH-1	AH-2
TOTAL CAPACITY (BTUH)	54,000	54,000
SENSIBLE CAPACITY (BTUH)	54,000	54,000
LATENT CAPACITY (BTUH)	0	0
TOTAL AIR (CFM)	1570	1570
OUTSIDE AIR (CFM)	_	_
ENTERING AIR ARI 210/240 (DB/WB)	75/63	75/63
EXTERNAL STATIC PRESS. (IN. W.C.)	0.5	0.5
BLOWER MOTOR (KW)	0.41	0.41
HEATING CAPACITY (BTUH)	60,000	60,000
MCA / MOP	3.53/15	3.53/15
ELECTRICAL SERVICE (V/PH/HZ)	208/1/60	208/1/60
FILTER (TYPE)	1" PLEATED	1" PLEATED
WEIGHT (LBS)	170	170
BLOWER MODEL NO.	PVFY-P54E00A	PVFY-P54E00A
MARK	cu	I–1
OUTDOOR TEMP ARI 210/240 (DEG F)	9	5
COND. ELECTRICAL (V/PH/HZ)	208/	3/60
MCA / MOP	41,	/50
MIN SEER/EER	> 1	5.0
COMPRESSOR TYPE	INVERTER	SCROLL
COND. UNIT MODEL NO.	PUHY-P12	2OTHMU—A
MANUFACTURER	MITSU	JBISHI
REFRIGERANT PIPING	DIAGRAM	
3/8" & 7/8" CU-1 3/8" & 5/8" AH-	3/8" & 5/8" -1 AH-	-2
1. SIZE AND NUMBER REFRIGERANT LINES AS PER M	ANUFACTURER'S REC	COMMENDATIONS
2. ACCEPTABLE MANUFACTURERS ARE: MITSUBISHI, L		OMMENDA HONS.

HEAT EXCHANG	ER SCHEDUL	E			
ITEM NO.		ŀ	HX—1		
SERVICE		CHILLED WATE	R/CHILLED WATER		
TYPE		PLATE AND FRAME			
PERFORMANCE		HOT SIDE	COLD SIDE		
FLOW RATE	GPM	1000	620		
INLET TEMP.	*F	55	44		
OUTLET TEMP.	۴	45	54		
MAX. PRESSURE DROP	PSI	10	10		
TOTAL HEAT EXCH.	MBH	5,017.0			
U-VALUE	BTU/H*SQ FT**F)		-		
TRANSFER AREA	SQ. FT.	2	,078		
LMTD	" F	:	2.00		
FLUID TYPE		WATER	WATER		
PLATE MATERIAL		Al	SI304		
GASKET MATERIAL		NITRILE			
CONN. MATERIAL		STUDDED PORT			
CONN. SIZE INLET	IN.	6 6			
CONN. SIZE OUTLET	IN.	6	6		
DESIGN/TEST PRESS.	PSIG	150/195			
DESIGN TEMPERATURE	* F	257			
ASME RATED			YES		
TOTAL WEIGHT	LBS.	5	5240		
NO. PLATES	QTY.		286		
PASS ARRANGEMENT		1X15	3, 1X154		
PLATE MAX			300		
FLOW DIRECTION		со	UNTER		
MANUFACTURER		BELL &	c GOSSETT		
MODEL			P62		

NOTES: 1. PROVIDE EXTERNAL INSULATION ON HEAT EXCHANGER AND STAINLESS STEEL COVER.

MECHANICAL SCHEDULES

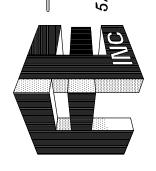

TO THE BEST OF MY KNOWLEDGE, SAID PLANS AND SPECIFICATIONS COMPLY WITH ALL APPLICABLE BUILDING CODES.

BRADENTON,

S E A L


REV. #

JOB NO. : 09-2199 DATE : 01-26-10

DRAWN BY : RLA CHECKED BY : GLA

M-8

SHEET No. :

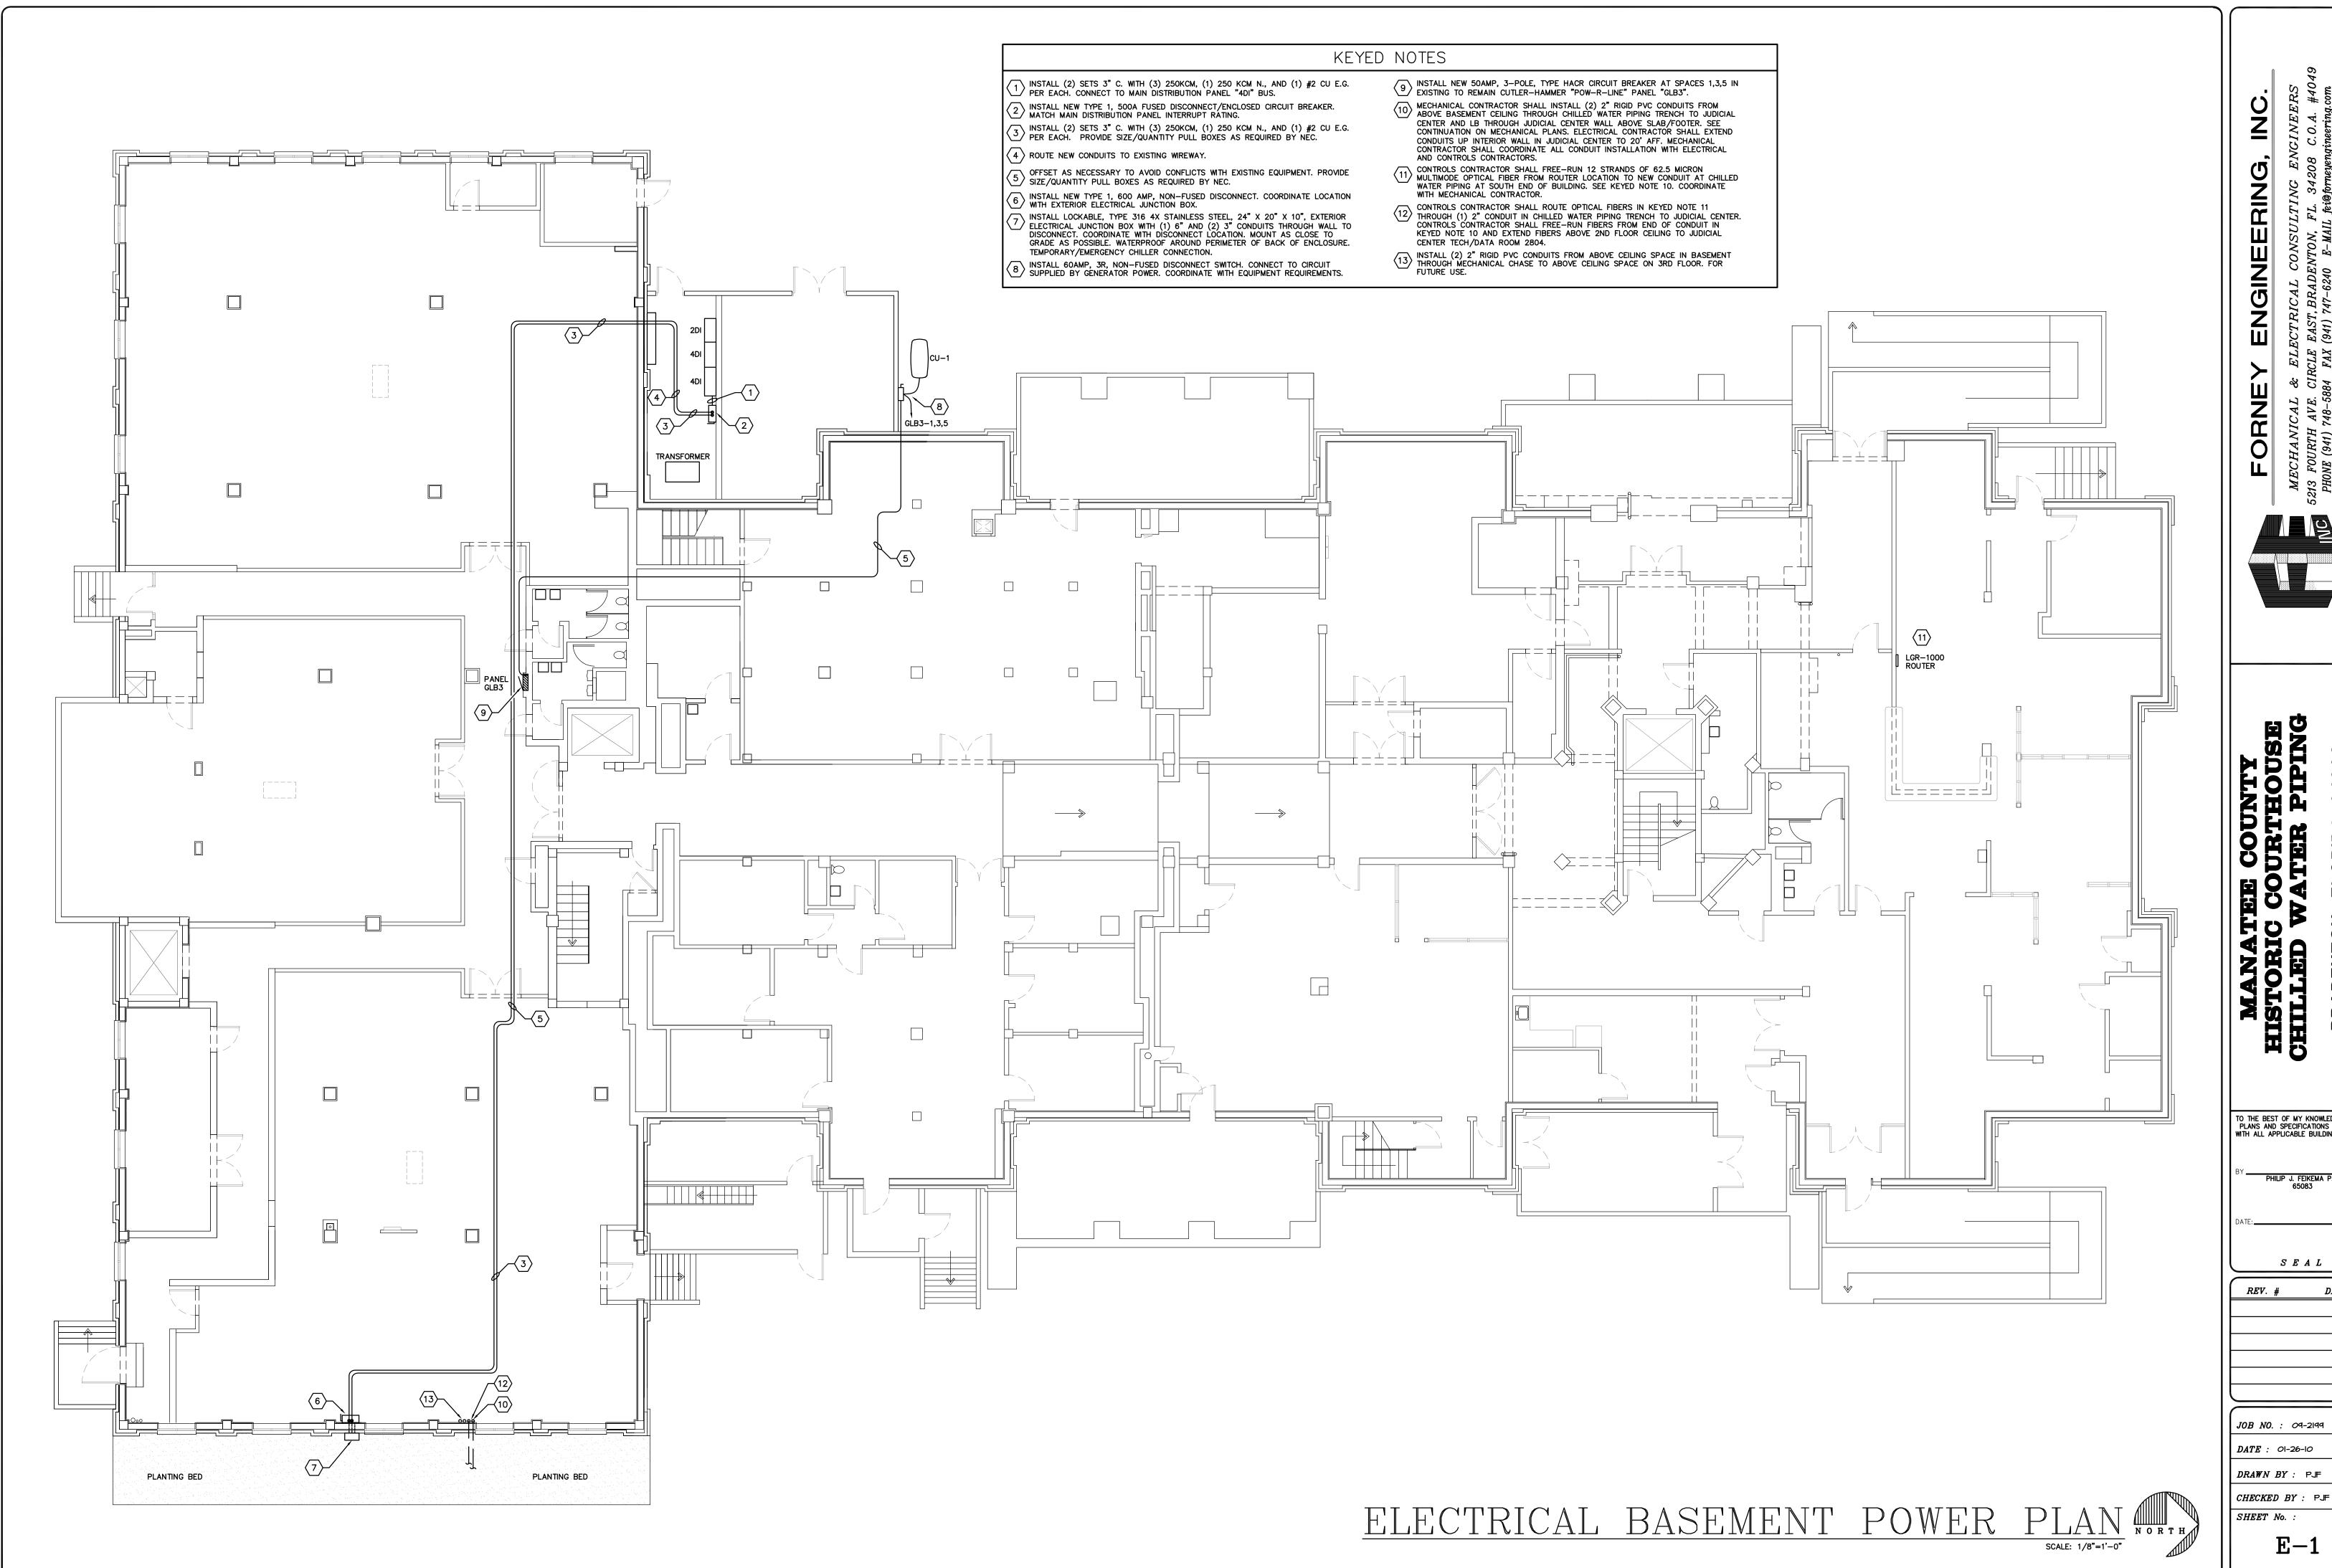

TO THE BEST OF MY KNOWLEDGE, SAID PLANS AND SPECIFICATIONS COMPLY WITH ALL APPLICABLE BUILDING CODES.

S E A L



KEYED NOTES


- 30AMP, TYPE 1, NON-FUSED DISCONNECT SWITCH. CONNECT TO CIRCUIT SUPPLIED BY GENERATOR POWER. COORDINATE WITH EQUIPMENT REQUIREMENTS. COORDINATE LOCATION WITH EXISTING EQUIPMENT.
- 30AMP, TYPE 1, NON-FUSED DISCONNECT SWITCH. CONNECT TO CIRCUIT SUPPLIED BY GENERATOR POWER. COORDINATE WITH EQUIPMENT REQUIREMENTS. COORDINATE LOCATION WITH EXISTING EQUIPMENT AND WINDOWS.
- PROVIDE NEW 15 AMP, 2-POLE, TYPE HACR CIRCUIT BREAKER AT SPACES 16,18 IN EXISTING TO REMAIN SIEMENS "P1" PANEL "GL16".
- RELOCATE EXISTING QUAD RECEPTACLE TO NEW LOCATION AS SHOWN. PULL BACK CONDUCTORS TO JUNCTION BOX ABOVE CEILING. EXTEND CONDUCTORS/CONDUIT
- FROM JUNCTION BOX TO NEW LOCATION. 5 RELOCATE DATA OUTLET TO NEW LOCATION AS SHOWN. PULL BACK CABLE TO JUNCTION BOX ABOVE CEILING. EXTEND CABLE FROM JUNCTION BOX TO NEW
- 6 INSTALL (2) 2" RIGID PVC CONDUITS FROM ABOVE CEILING SPACE IN BASEMENT THROUGH MECHANICAL CHASE TO ABOVE CEILING SPACE ON 3RD FLOOR. FOR FUTURE USE.


GENERAL NOTES


MOV: EXISTING DEVICE TO BE RE-LOCATED


SYMBOL LEGEND

- 20 AMP DOUBLE DUPLEX (QUAD) RECEPTACLE WITH COMMON COVER PLATE, RECESS MOUNT 18" AFF TO CENTER OF BACKBOX.
- COMMUNICATIONS OUTLET, RECESS MOUNT 18"AFF TO CENTER OF BACKBOX U.N.O.. PROVIDE 2-GANG BACKBOX WITH SINGLE GANG OPENING AND (1) 3/4" CONDUIT WITH BACKBOX AND PULL STRING STUBBED INTO ACCESSIBLE CEILING SPACE ABOVE BACKBOX.

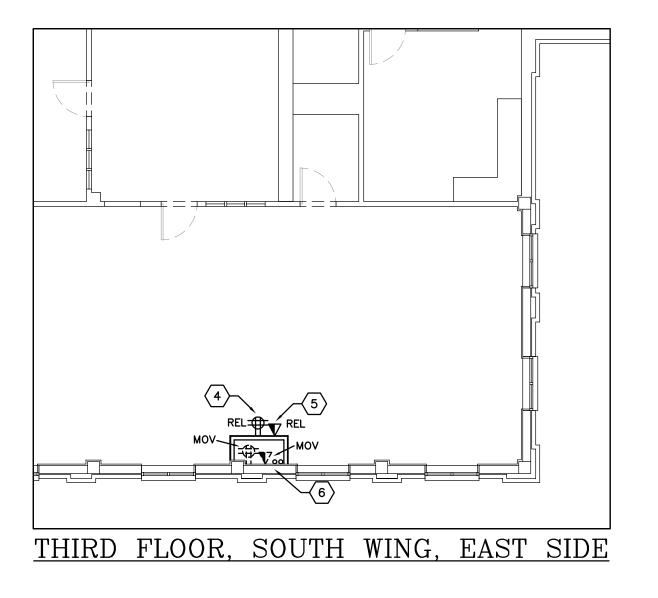

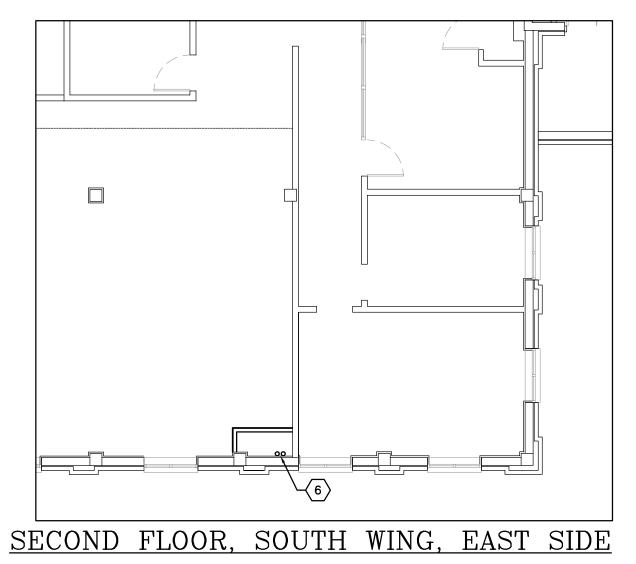

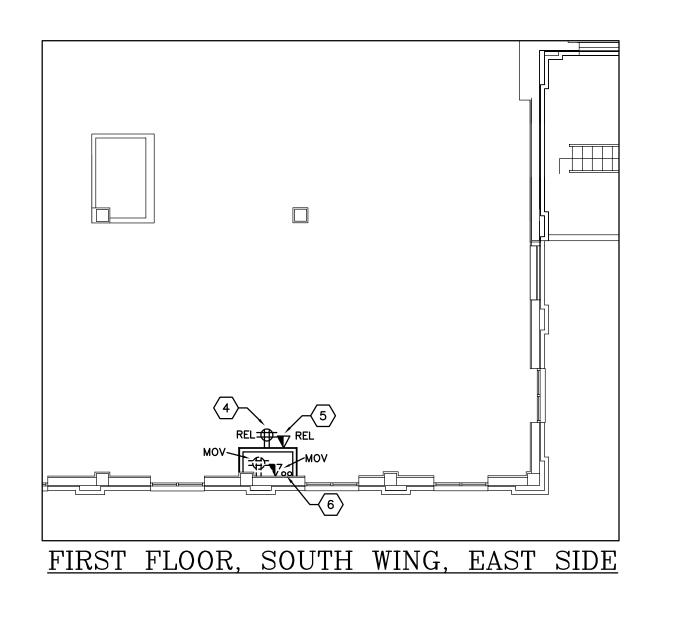

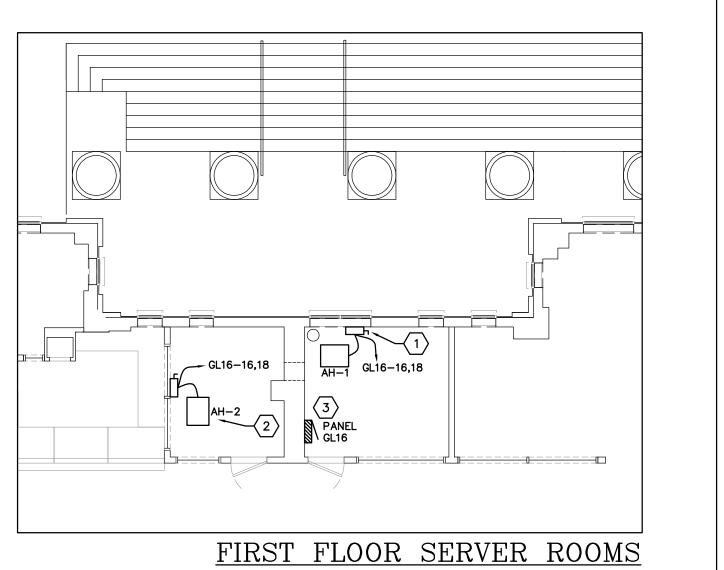

ELECTRICAL POWER PARTIAL FLOOR PLANS

TO THE BEST OF MY KNOWLEDGE, SAID PLANS AND SPECIFICATIONS COMPLY WITH ALL APPLICABLE BUILDING CODES.

PHILIP J. FEIKEMA P.E. 65083

S E A LREV. # DATE

JOB NO. : 09-2199


DATE : 01-26-10 DRAWN BY : PJF

CHECKED BY : PJF SHEET No. :

						ASEME		
3ø-4W	MAINS RA	TING:	1	00	AM	IPS MAIN	CB TRIF	PRATING: - AMF
	COPPE	₹					NTERRUPT	ING RATING: AIC
	BUS	•					(ENCLOSURE:
CB SIZE	LOAD VA	CKT#			CKT#	LOAD VA	CB SIZE	SERVES
50	3735	1	•		2	108	50	PANEL GA
	3735	3		•	4	1032		
	3735	5		•	6	36		
_	_	7	•	Ш	8	_	_	SPACE
_		9	Ш	•	10	_	_	SPACE
_	_	11	Ш	•	12	_	-	SPACE
20	96	13	•	Ш	14	0.0	20	UNMARKED
20	192	15	Ш	•	16	0.0	20	UNMARKED
20		17	Ш	4	18	_	20	SPARE
20	_	19	•	Ц	20	-	20	SPARE
20	_	21	Ш		22	-	20	SPARE
20	0.0	23	Ш	4	24	_	20	SPARE
20		25	•	Ш	26	_	20	SPARE
20	0.0	27	Ш		28	84	20	LIGHTS
20	108	29	Ш		30	_	20	SPARE
20	72	31	•	Ц	32	228	20	LIGHTS
20	108	33	Ш	•	34	0.0	20	RECEPTS
20	204	35	Ш		36	0.0	20	RECEPTS
15	192	37	•	Ц	38	0.0	20	UNMARKED
	132	39	Ш	(40	0.0		
	132	41	Ш		42	0.0		
	50 	BUS CB SIZE LOAD VA 50 3735 3735 3735 20 96 20 192 20 - 20 - 20 - 20 - 20 0.0 20 - 20 108 20 72 20 108 20 72 20 108 20 204 15 192	CB SIZE LOAD VA CKT# 50 3735 1 3735 3 - - 7 - - 9 - - 11 20 96 13 20 192 15 20 - 17 20 - 21 20 - 21 20 - 25 20 0.0 27 20 108 29 20 72 31 20 108 33 20 204 35 15 192 37 132 39 132 41	BUS CB SIZE LOAD VA CKT# 50 3735 1 3735 5 7 - 9 11 20 96 13 20 192 15 20 - 17 20 - 19 20 - 21 20 0.0 23 20 - 25 20 0.0 27 20 108 29 20 72 31 20 108 33 20 204 35 15 192 37 132 39	BUS CB SIZE LOAD VA CKT# 50 3735 1 3735 3 3735 5	BUS CB SIZE LOAD VA CKT# 50 3735 1 2 3735 3 4 3735 5 6 - 7 8 - 7 8 - 9 10 - 11 1 12 20 96 13 14 20 192 15 16 20 - 17 1 18 20 - 19 0 20 20 - 21 0 20 20 - 21 0 22 20 0.0 23 0 24 20 - 25 0 26 20 0.0 27 0 28 20 108 29 0 30 20 72 31 0 32 20 108 33 0 34 20 204 35 15 15 192 37 0 38 132 39 0 40 132 41 0 42	CB SIZE LOAD VA CKT# CKT# LOAD VA 50	CB SIZE LOAD VA CKT# CKT# LOAD VA CB SIZE

	i					_					
VOLTAGE: 208/120	V 1P/3W	MAINS RA	ATING:	1:	25	AM	PS MAIN	CB TRIF	P RATING:	-	AMPS
SURFACE MCE	В	COPPE	R				ı İ	NTERRUPT	NG RATING:	22000	AIC
FLUSH MLO		BUS							ENCLOSURE:	NEMA 1	
SERVES	CB SIZE	LOAD VA	CKT#			CKT#	LOAD VA	CB SIZE	SERVES		
RECEPT	30	1200	1			2	1200	30	RECEPT		
RECEPT	30	1200	3			4	1200	30	RECEPT		
RECEPT	30	1200	5			6	1200	30	RECEPT		
RECEPT	30	1200	7			8	1200	20	RECEPT		
RECEPT	30	1200	9			10	1200	30	RECEPT		
RECEPT	20	1200	11			12	1200	30	RECEPT		
		1200	13			14	1200				
RECEPT	20	1200	15			16	590	15	AH-1, Al	I-2	
		1200	17			18	590		NEW	_	
	CONNECTED	20.4	KVA	Ā	Гв	ES	T. DEMAND:	20.4	KVA		

PANEL SCHEDULES
NO SCALE

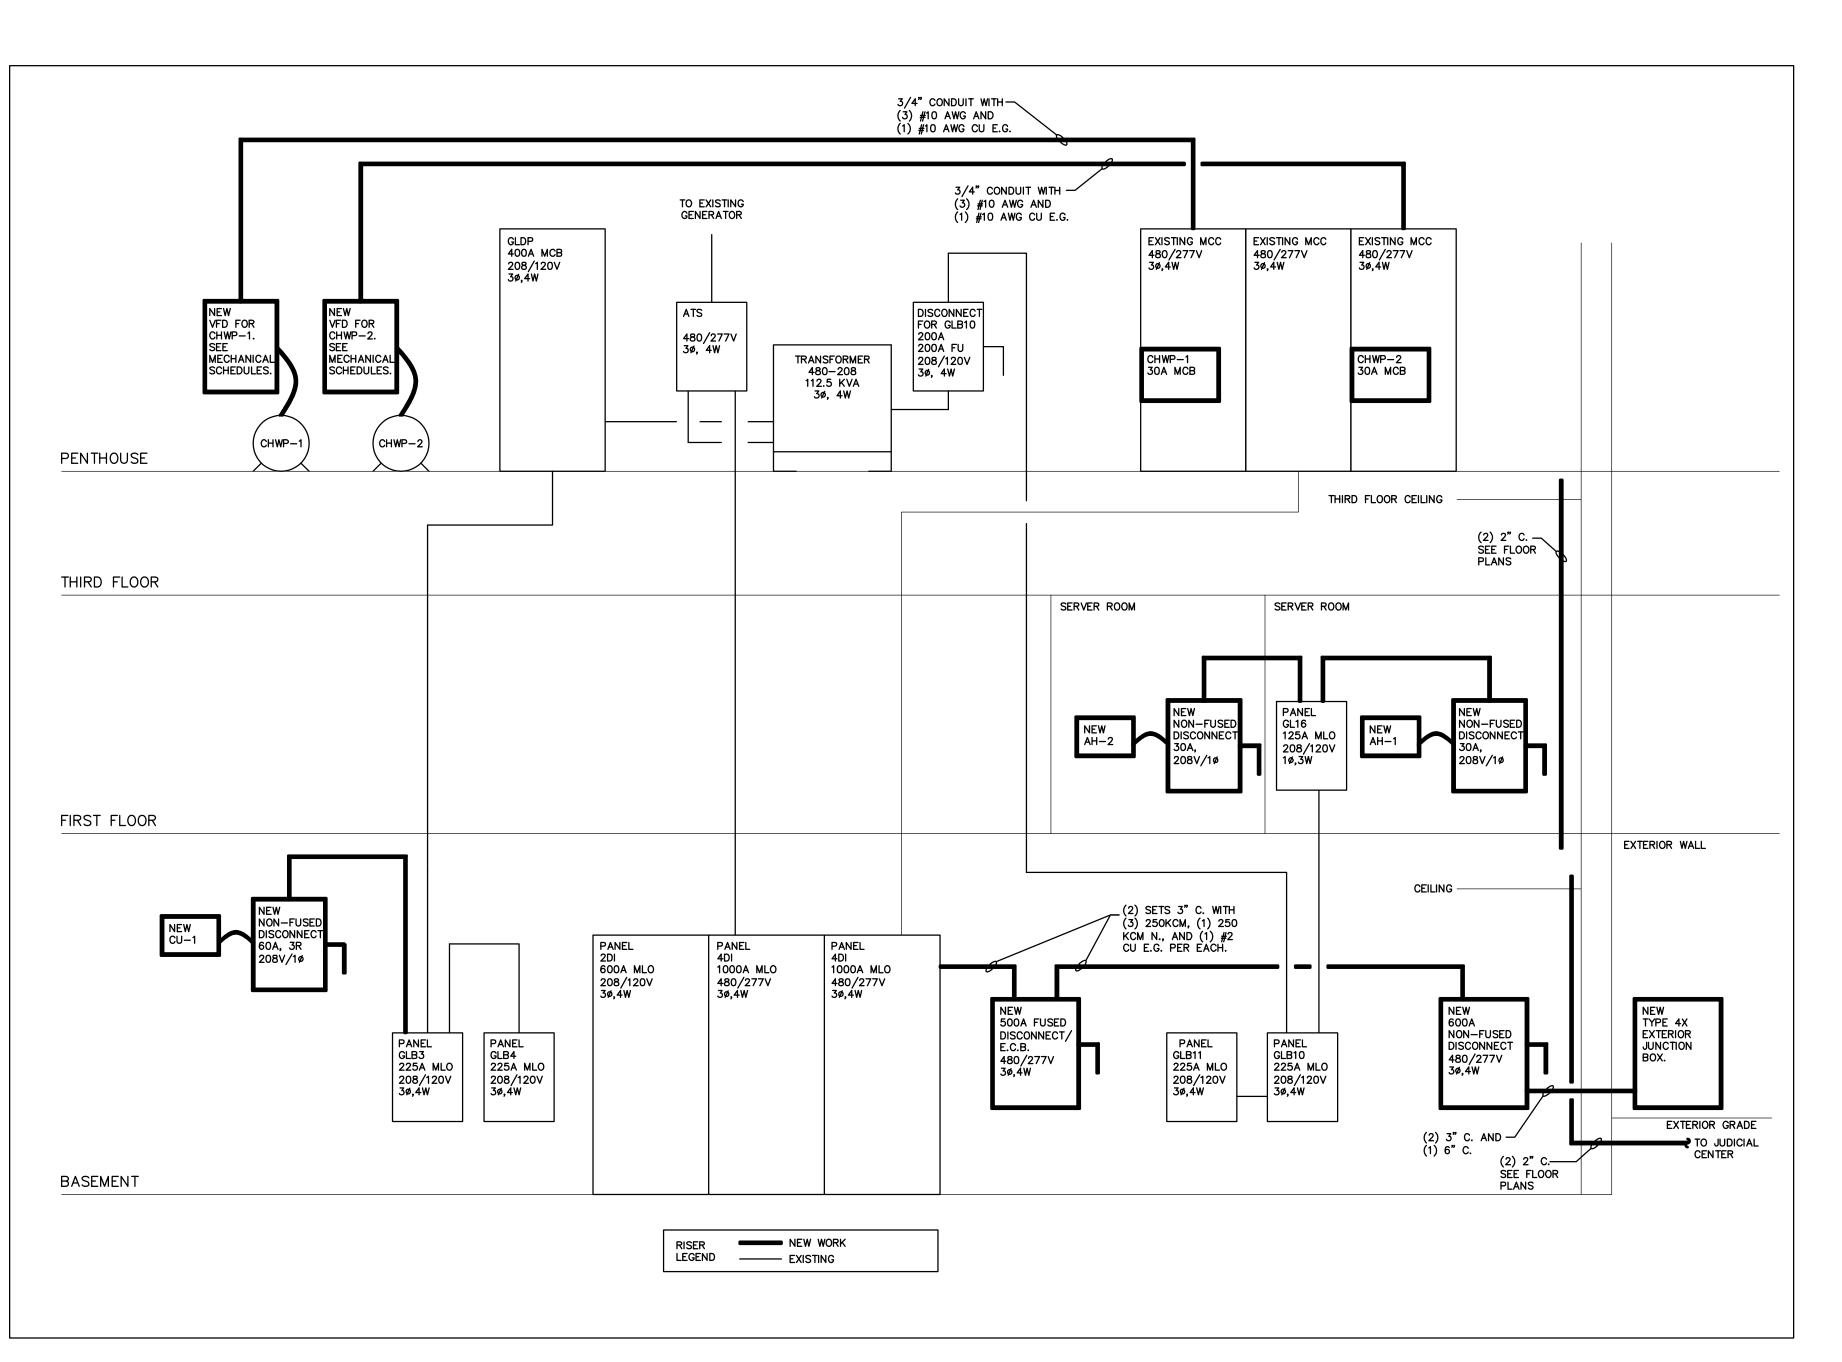

PARTIAL ELECTRICAL RISER

EY ENGINEERING, INC.

C. & ELECTRICAL CONSULTING ENGINEERS

C. CIRCLE EAST, BRADENTON, FL. 34208 C.O.A. #40.

5884 FAX (941) 747-6240 E-MAIL fei@forneyengineering.com

MANATEE COUNTY
ISTORIC COURTHOUSE
HILLED WATER PIPING
BRADENTON, FLORIDA 34208

TO THE BEST OF MY KNOWLEDGE, SAID PLANS AND SPECIFICATIONS COMPLY WITH ALL APPLICABLE BUILDING CODES.

PHILIP J. FEIKEMA P.E. 65083

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CHECKED BY : PJF

SHEET No. :

E-3