CONSTRUCTION PLANS

FOR

END OF SERVICE LIFE FORCE MAIN REPLACEMENT PACKAGE A: FM 28A/ PORT MANATEE / ORLANDO AVENUE

MANATEE COUNTY, FLORIDA

SEPTEMBER 2018

MANATEE COUNTY PROJECTS #6089380, #6089880, #6089780

Manatee

Lounty FLORIDA



MANATEE COUNTY 1022 26TH AVE. E. BRADENTON, FL 34208 CONTACT: MICHAEL STURM, P.E. 941-708-7450 ext. 7332

KIMLEY-HORN AND ASSOCIATES, INC. 655 NORTH FRANKLIN STREET, SUITE 150 TAMPA, FL 33602 CONTACT: W. WADE WOOD, P.E. 813-635-5583

FLORIDA DESIGN CONSULTANTS, INC., 3030 STARKEY BOULEVARD, NEW PORT RICHEY, FLORIDA 34655 CONTACT: JARED T. PATENAUDE, PSM 800-532-1047

TERRACON CONSULTANTS, INC. 8260 VICO COURT, UNIT B SARASOTA, FLORIDA 34240 CONTACT: JIMMY M. JACKSON, P.E. 941-256-0510

UTILITY CONTACTS:

FLORIDA POWER & LIGHT GREG COKER 1253 12TH AVE. EAST PALMETTO, FL 34221 941-723-4430

FRONTIER COMMUNICATIONS 1701 RINGLING BLVD. SARASOTA, FL 34236 941-906-6711

CHARTER COMMUNICATIONS JIM CRUZAN 5413 S.R. 64 EAST, BRADENTON, FL 34208 727-329-2846

TRANSMONTAIGNE 941-722-7727 EXT. 6173


MANATEE COUNTY UTILITY RECORDS 4520- 66TH STREET W BRADENTON, FL 34210 941-792-8811 EXT. 5002

DANNY SHANAHAN 8261 VICO CT. SARASOTA, FL 34240 941-342-4006

MANATEE COUNTY PORT AUTHORITY GEORGE ISIMINGER 300 TAMPA BAY WAY

GULFSTREAM NATURAL GAS FRED DELOACH 4610 BUCKEYE ROAD PALMETTO, FL 34221 941-723-7108

9250 W FLAGLER ST. MIAMI, FL 33174 305-552-2931

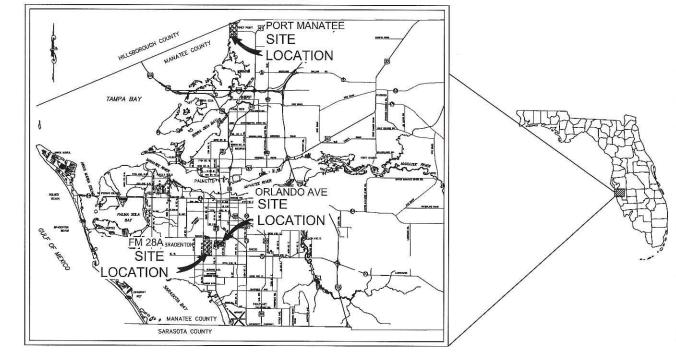

PROJECT VICINITY MAP

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SHEET NUMBER	SHEET TITLE
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2	GENERAL NOTES
3	SURVEY AND SUE NOTES
4	FORCE MAIN 28A KEY SHEET
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8	PLAN AND PROFILE 57TH AVENUE
9	PLAN AND PROFILE 24TH STREET (N)
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11	PORT MANATEE FORCE MAIN KEY SHEET
12-13	PLAN AND PROFILE REGAL CRUISE WAY
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SHEET LIST TABLE

PREPARED BY

FILES AND SITE CONSTRUCTION PLAN

GENERAL

- ALL CONSTRUCTION ACTIVITIES SHALL BE COORDINATED WITH THE PROJECT MANAGEMENT DIVISION.
 THE PROJECT MANAGER IS: MICHAEL STURM, P.E. AND CAN BE REACHED AT (941) 708-7450 X7332
- 3. ALL CONSTRUCTION ON THIS PROJECT SHALL BE IN ACCORDANCE WITH THE LATEST EDITION OF MANATEE COUNTY UTILITY AND TRANSPORTATION STANDARDS AND/OR FDOT "STANDARD SPECIFICATIONS FOR ROAD AND BRIDGE CONSTRUCTION" UNLESS OTHERWISE INDICATED ON THE PLANS.
- 4. THE CONTRACTOR SHALL BE RESPONSIBLE FOR MEETING ALL CONDITIONS AND REQUIREMENTS OF ALL PERMITS AND ALL GOVERNING FEDERAL, STATE, AND LOCAL AGENCIES. THE CONTRACTOR SHALL GOTAIN AND PAY FOR ALL REQUIRED PERMITS THAT ARE NOT PROVIDED IN THE BIID DOCUMENTS, AT NO ADDITIONAL COST TO THE OWNER.
- 5. THE INFORMATION PROVIDED IN THESE PLANS IS SOLELY TO ASSIST THE CONTROL IN ASSESSING THE NATURE AND EXTENT OF THE CONDITIONS WHICH MAY BE ENCOUNTERED DURING THE COURSE OF WORK. ALL CONTRACTORS ARE DIRECTED, PRIOR TO BIDDING, TO CONDUCT WHATEVER INVESTIGATION THEY MAY DEEM NECESSARY TO ARRIVE AT THEIR OWN CONCLUSIONS REGARDING THE ACTUAL CONDITIONS THAT WILL BE ENCOUNTERED, AND UPON WHICH THEIR BIDS WILL BE BASED.
- 6. THE CONTRACTOR SHALL REVIEW AND VERIFY ALL DIMENSIONS ON THE PLANS AND REVIEW ALL FIELD CONDITIONS THAT MAY AFFECT CONSTRUCTION. SHOULD DISCREPANCIES OCCUR, THE CONTRACTOR SHALL NOTIFY THE ENGINEER TO OBTAIN THE ENGINEER'S CLARIFOATION BEFORE COMMENCING WITH CONSTRUCTION.
- THE CONTRACTOR SHALL NOTIFY SUNSHINE 811 (1-800-432-4770) AT LEAST 2 FULL BUSINESS DAYS PRIOR TO CONSTRUCTION OPERATIONS, THE CONTRACTOR SHALL BE RESPONSIBLE FOR COORDINATING WITH ALL UTILITIES FOR THE POSSIBLE RELOCATION OR THE TEMPORARY MOVEMENT OF ANY EXISTING UTILITIES WITHIN THE RIGHTS-OF-WAY. IT IS THE CONTRACTOR'S RESPONSIBILITY TO PROTECT EXISTING UTILITIES FROM DAMAGE, EXPLORATORY EXCAVATION MAY BE REQUIRED PRIOR TO CONNECTION TO EXISTING UTILITIES FROM DAMAGE, EXPLORATORY EXCAVATION MAY BE REQUIRED
- NO WORK, EXCEPT FOR EMERGENCY TYPE, SHALL BE PERFORMED AFTER 7:00 PM AND BEFORE 7:00 AM. FOR ADDITIONAL PROJECT RESTRAINTS, REFER TO SECTION 01310 OF THE SPECIFICATIONS.
- THE CONTRACTOR SHALL PROVIDE CERTIFIED RECORD DRAWINGS AS OUTLINED IN THE SPECIFICATIONS. RED-LINE DRAWINGS SHALL BE CURRENT WITH EACH PAY APPLICATION SUBMITTED AND MILL BE CHECKED AS PART OF THE PAY APPLICATION REVIEW PROCESS. PAYMENT MILL NOT BE MADE TO CONTRACTOR WITHOUT PROVED RED-LINE DRAWINGS. THE MOST CURRENT SET OF RED-LINE DRAWINGS SHALL ALSO BE BROUGHT TO EACH MONTHLY PROGRESS
- D. THE CONTRACTOR SHALL INCLUDE IN HIS BID: BY-PASS PUMPING FACILITIES, PUMPS, FITTINGS, LABOR, ETC. AS NECESSARY, BASED ON METHOD AND SEQUENCE OF CONSTRUCTION TO COMPLETE ALL WORK WHILE MAINTAINING SEWER SERVICE OPERATIONS AT ALL THIES.
- 11. THE CONTRACTOR SHALL PROVIDE THE OWNER AND ENGINEER WITH A DETAILED CONSTRUCTION PHASING PLAN BASED ON THE CONNECTION SEQUENCING BELOVE, EMSTING FORCE MAIN 28A, PORT MANAIGE, AND ORLANDO AVENUE SHALL REMAIN IN SERVICE UNITL ALL CONNECTIONS TO THE PROPOSED FORCE MAIN ARE CONSTRUCTED.
- ALL PROPOSED WORK SHALL BE COORDINATED WITH MANATEE COUNTY UTILITIES DEPARTMENT AT LEAST TWO WEEKS IN ADVANCE OF PROPOSED CONSTRUCTION.
- 13. THE CONTRACTOR SHALL FURNISH SHOP DRAWINGS TO THE ENGINEER FOR REVIEW OF ALL PIPE CONNECTIONS, TRANSITIONS, AND SPECIAL APPURTENANCES PRIOR TO FABRICATION OR DELIVERY TO THE JOB SITE.
- 14. UNLESS OTHERWISE INDICATED OR APPROVED, ALL BELOW GROUND PVC PIPE SHALL HAVE PUSH—ON OR MECHANICAL JOINTS, AND ALL ABOVE GROUND PVC PIPE SHALL HAVE FLANGED JOINTS. ALL JOINTS SHALL BE FULLY RESTRAINED PER THE DETAILS IN THESE PLANS.
- 15. SANITARY SEWERS AND FORCEMAINS CROSSING OVER OR UNDER WATER MAINS SHALL BE LAID TO PROVIDE A MINIMUM VERTICAL DISTANCE OF 18" BETWEEN THE INVERT OF THE UPPER PIPE AND THE CROWN OF THE LOWER PIPE. WHERE THIS MINIMUM SEPARATION CANNOT BE MAINTAINED, THE CROSSING SHALL BE ARRANGED SO THAT THE SEWER OR FORCE MAIN PIPE JOINTS ARE EQUIDISTANT FROM THE POINT OF CROSSING WITH NO LESS THAN 10' BETWEEN ANY TWO JOINTS. AS AN ALTERNATIVE, THE SEWER OR FORCE MAIN MAY BE PLACED IN A WATERTIGHT CASING PIPE, CONSISTENT WITH F.A.C. RULE 82-555.314.
- 16. ALL BELOW-GRADE FITTINGS 4—INCHES AND GREATER IN DIAMETER SHALL BE MECHANICAL JOINT DUCTILE IRON WITH PROTECTO 401 LINING FOR THEIR INTERIOR SURFACES AND COAL TAR ENAMEL COATING ON EXTERIOR SURFACES, AS NOTED IN SECTION 2015 OF SPICIFICATIONS.
- 18. IT WILL BE THE CONTRACTOR'S RESPONSIBILITY TO ACQUIRE, OR ENTER INTO AGREEMENTS, FOR LANDS FOR LAY DOWN AREAS AND STAGING. THE COUNTY WILL COORDINATE AND ADMSE, TO HELP IDENTIFY POSSIBLE PARCELS. IT IS FINALLY THE CONTRACTOR'S RESPONSIBILITY TO SECURE THE NEEDED AREAS, AND THE COUNTY TAKE NO RESPONSIBILITY FOR DELAYS IN THIS REGARD.
- 19. COORDINATION AND PUBLIC INFORMATION FOR AND WITH AREA RESIDENTS ARE OF THE UTMOST IMPORTANCE. CONTRACTOR WILL INSURE ADHERENCE TO THE COUNTY'S NOISE ORDINANCE, HAZARD AND SAFETY, AND NUISANCE ABATEMENT DIRECTIONS, PLANS, OBJECTIONS AND ORDINANCES. THE PRINGERER WILL HAVE THE FINAL DISCRETION IN THIS RECORD, AS REPRESENTED ONSITE BY THE COUNTY INSPECTOR AND ENGINEER'S STAFF.

- 20. THE CONTRACTOR SHALL BE RESPONSIBLE FOR COMPLIANCE WITH THE FLORIDA TRENCH SAFETY ACT, 90-96, LAWS OF FLORIDA EFFECTIVE OCTOBER 1, 1990 AND THE OCCUPATIONAL SAFETY AND HEALTH ADMINISTRATION EXCAVATION SAFETY STANDARDS, 29 CPR 1926.650, SUBPART P, AS AMENDED THE CONTRACTOR SHALL INCLUDE IN THE TOTAL BID PRICE ALL COSTS FOR COMPLIANCE WITH THESE REGULATIONS.
- 21. THE CONTRACTOR SHALL USE SHEET PILING, SHEETING, BRACING, ETC., AS REQUIRED IN ALL EXCAVATION AREAS AND CONFORM TO ALL OSHA REQUIREMENTS.
- 22. THE CONTRACTOR SHALL USE ALL NECESSARY SAFETY PRECAUTIONS TO AVOID CONTACT WITH OVERHEAD AND UNDERGROUND UTILITIES, POWER LINES, ETC.
- 23. THESE DRAWINGS DO NOT INCLUDE NECESSARY COMPONENTS FOR CONSTRUCTION SAFETY. THIS EXCLUSION DOES NOT ALLEVIATE THE CONTRACTOR FOR PROVIDING A CONTINUOUS SAFE WORKSPACE.

- 24. WHEN A BENTONITE SPILL OF FRACK-OUT OCCURS OR THERE IS A LOSS OF RETURN INDICATING EXCESSIVE SEEPAGE OR LOSS OF ORILLING FILLING MUST BE STOPPED UNTIL THE LOCATION OF THE SPILL IS IDENTIFIED. UNDER NO CIRCUMSTANCES WILL DRILLING CONTINUE WHEN A SPILL IS APPARENT.
- 25. ONCE LOCATED, THE BENTONITE SPILL MUST BE ISOLATED AND SEEPAGE INTO ANY NEARBY WATER BODIES WILL BE BLOCKED DEPOINING ON THE DEGREE OF THE SPILL, THE ISOLATED BENTONITE MUST BE REMOVED MANUALLY OR MECHANICALLY AND DISPOSED OF BY APPROPRIATE MEANS OR REUSED.
- 26. THE CONTRACTOR SHALL PROVIDE AND INSTALL ALL NECESSARY STORM WATER, EROSION, AND SEDIMENTATION CONTROL MEASURES IN ACCORDANCE WITH THE FDEP "FLORIDA STORM WATER, EROSION AND SEDIMENTATION CONTROL INSPECTOR'S MANUAL". IT IS THE RESPONSIBILITY OF THE CONTRACTOR TO CONTROL AND PREVENT EROSION AND TRANSPORT OF SEDIMENT TO SURFACE DRAINS AND TO DITCHES DURING CONSTRUCTION.
- 27. STOCKPILES SHALL BE PROTECTED AT ALL TIMES BY ON-SITE DRAINAGE CONTROLS WHICH PREVENT EROSION OF THE STOCKPILED MATERIAL. CONTROL, OF DUST FROM SUCH STOCKPILES IS REQUIRED, DEPENDING UPON THEIR LOCATION AND THE EXPECTED LENGTH OF TIME THE STOCKPILES WILL BE PRESENT. IN NO CASE SHALL ANY STOCKPILED MATERIAL REMAIN AFTER THIRTY (30) CALENDAR DAYS.
- 28. STORM WATER INLETS IN THE VICINITY OF THE PROJECT SHALL BE PROTECTED BY SEDIMENT TRAPS SUCH AS SECURED HAY BALES, SOO, STONE, ETC., WHICH SHALL BE MAINTAINED AND MODIFIED AS REQUIRED BY CONSTRUCTION PROGRESS, AND WHICH MUST BE APPROVED BY THE ENGINEER BEFORE INSTALLATION. THIS WILL BE MAINTAINED TO PREVENT DEGRADATION OF THE WATERS OF THE COUNTY AND STATE.
- 29. SEDIMENT BASINS AND TRAPS, PERIMETER BERNS, SEDIMENT BARRIERS, VEGETATIVE BUFFERS, AND OTHER MEASURES INTENDED TO TRAP SEDIMENT AND/OR PREVENT THE TRANSPORT OF SEDIMENT ONTO ADJACENT PROPERTIES, OR INTO EXISTING BODIES OF WATER, MUST BE INSTALLED, CONSTRUCTED, OR IN THE CASE OF VEGETATIVE BUFFERS, PROTECTED FROM DISTURBANCE, AS A FIRST SITE IN THE LAND ALTERATION PROCESS. SUCH SYSTEMS SHALL BE FILLY OPERATIVE BEFORE ANY OTHER DISTURBANCE OF THE SITE BEGINS. EARTHEN STRUCTES INCLUDING BUT NOT LIMITED TO BERMS, EARTH FILTERS, DAMS OR DIKES SHALL BE STABILIZED AND PROTECTED FROM DRAINAGE DAMAGE OR EROSION WITHIN ONE (1) WEEK OF INSTALLATION.
- 30. ALL SWALES, DITCHES, AND CHANNELS LEADING FROM THE SITE SHALL BE PROTECTED FROM SILTATION AND BE SODDED WITHIN THREE (3) DAYS OF EXCAVATION.

DATE BY

REVISIONS

- 31. SOIL DISPLACED BY CONSTRUCTION WILL BE REMOVED. EROSION CONTROL SHALL BE IMPLEMENTED IN AREAS WHICH ARE CONSIDERED ENVIRONMENTALLY SENSITIVE. EROSION CONTROL SYSTEMS SHALL BE REQUIRED FOR ALL WORK WITHIN JURISDICTIONAL AREAS. THESE SYSTEMS MAY INCLUDE STAKED HAY BALES, SILT SCREENS, FILTER FABRIC, AND TURBIDITY SCREENS.
- 32. ALL EROSION AND POLLUTION CONTROL DEVICES SHALL BE CHECKED REGULARLY, ESPECIALLY AFTER EACH RAINFALL AND SHALL BE CLEANED OUT AND/OR REPAIRED AS REQUIRED.
- 33. THE CONTRACTOR SHALL NOT ENTER UPON OR IN ANY WAY ALTER WETLAND AREAS THAT MAY BE ON OR NEAR THE CONSTRUCTION SITE. ALL WORK IN THE VICINITY OF OPEN WATER AND/OR WETLANDS IS TO BE PERFORMED IN COMPLIANCE WITH THE ENTRONMENTAL REGULATIONS AND/OR PERMITS FOR THE SITE. THE CONTRACTOR WILL BE RESPONSIBLE FOR ANY FINES RESULTING FROM HIS WOLATION OF ANY REGULATIONS OR PERMIT CONDITIONS.
- 34. CONTRACTOR SHALL PROVIDE PROTECTIVE MATTING, FUEL CONTAINMENT AND ALL OTHER MATERIALS, EQUIPMENT AND LABOR TO PROTECT THE STAGING AREA DURING CONSTRUCTION.
- 35. CONTRACTOR TO COORDINATE WITH PSI REPRESENTATIVES, MICHAEL ROTHENBURG (813.917.0403) AND BEN MARSHALL (813.520.8275) DURING PORT MANATEE AND ORLANDO AVENUE CONSTRUCTION, FOR CONTAMINATED SOIL AND GROUNDWATER.
- 37. ALL PORT MANATEE CONTAMINATED SOIL AND GROUNDWATER CREATED BY DEWATERING WILL HAVE TO BE TREATED AND IF CONTAMINATED SOIL OR GROUNDWATER IS ENCOUNTERED AT ORLANDO AVENUE, CONTRACTOR TO COORDINATE WITH PSI REPRESENTATIVES.
- 38. CONTRACTOR SHALL BE AWARE THAT HIGH LEVELS OF HYDROGEN SULFIDE WERE FOUND AT THE NORTH END OF THE PORT MANATEE PROJECT LIMITS.

- 39. ALL CONSTRUCTION ACTIVITIES SHALL BE LIMITED TO WITHIN THE MANATEE COUNTY RIGHT-OF-WAY, OTHER PUBLIC RIGHT-OF-WAYS OR EASEMENTS SHOWN ON THE DRAWINGS.
- 41. THE CONTRACTOR, PRIOR TO CONSTRUCTION AND RESTRICTING ANY TRAFFIC, MUST OBTAIN ANY REQUIRED RIGHTS—OF—WAY USE PERMITS AND A TRAFFIC CONTROL PLAN. THE CONTRACTOR SHALL OBTAIN ALL REQUIRED PERMITS FROM OTHER GOVERNMENTAL AGENCIES HAVING RELEVANT JURISDICTION. ALL MAINTEANCE AND PROTECT OF TRAFFIC SHALL BE IN ACCORDANCE WITH THE APPLICABLE REQUIREMENTS OF THE CURRENT FLORIDA DEPARTM OF TRANSPORTATION "MANUAL OF TRAFFIC CONTROL AND SAFE PRACTICES". A TRAFFIC CONTROL LAN SHALL BE SUPPLIED BY THE CONTRACTOR AT THE PRE—CONSTRUCTION MEETING, PER SPECIFICATIONS 01570.
- 42. THE CONTRACTOR SHALL BE RESPONSIBLE FOR REPLACING ALL DAMAGED STORM WATER STRUCTURES, PIPING, ENTRANCE PIPE AND HEADWALLS WHETHER SHOWN ON THE PLANS OR NOT. THE HEADWALLS SHALL BE REPLACED IN ACCORDANCE WITH FLO.O.T. STANDARDS, OR THE APPLICABLE JURISDICTION.
- 43. IT IS THE RESPONSIBILITY OF THE CONTRACTOR TO ESTABLISH IN THE FIELD THE RIGHT-OF-WAY LINES, BASE LINES, BENCH MARKS (ELEV.), CENTER LINES, AND STATIONING AS REQUIRED TO CONSTRUCT THIS PROJECT.
- 44. THE CONTRACTOR SHALL COORDINATE THE CUTTING OF DRIVEWAYS WITH THE PROPERTY OWNER PRIOR. ALL DRIVEWAYS MUST BE IN PASSABLE CONDITION AT THE END OF THE WORK DAY AND FULLY RESTORED.
- 45. A RIGHT OF ENTRY AGREEMENT SHALL BE OBTAINED BY THE CONSTRUCTION MANAGER FROM THE PROPERTY OWNER BEFORE ANY DRIVEWAY CONSTRUCTION WORK IS DONE OUTSIDE OF THE RIGHT-OF-WAY OR EASEMENT.

UTILITIES

- 48. LOCATIONS, ELEVATIONS AND DIMENSIONS OF EXISTING UTILITIES, STRUCTURES AND OTHER FEATURES ARE SHOWN TO THE BEST INFORMATION AVAILABLE AT THE TIME OF PREPARATION OF THESE PLANS BUT DO NOT PURPORT TO BE ABSOLUTELY CORRECT. THERE MAY BE OTHER IMPROVEMENTS, UTILITIES, ETC. WHICH ARE WITHIN THE PROJECT AREA AND WHICH HAVE NOT BEEN LOCATED OR IDENTRIED, MAY NOT BE IN THE EXACT LOCATION SHOWN OR RELOCATED SINCE THE PREPARATION OF THESE PLANS. THE CONTRACTOR SHALL VERIFY, PRIOR TO CONSTRUCTION, THE LOCATIONS, ELEVATIONS AND DIMENSIONS OF ALL EXISTING UTILITIES STRUCTURES AND OTHER FEATURES (WHETHER OR NOT SHOWN ON THE PLANS) THAT MAY EFFECT HIS WORK, ALL EXISTING UTILITIES TO BE EXTENDED, CROSSED OR CONNECTION POINTS SHALL BE EXPOSED PRIOR TO CONSTRUCTION TO VERIFY LOCATION ADLEVATION, ANY DISCREPANCIES OR CONFLICTS FOUND SHALL BE BROUGHT TO THE ENGINEER'S ATTENTION FOR RESOLUTION.
- 47. THE CONTRACTOR SHALL PROTECT ALL EXISTING STRUCTURES, WATER AND SEWER LINES, STORM DRAINS, UTILITIES, DRIVEWAYS, SIDEWALKS, STORM, MAIL BOXES, FENCES, TREES, LANDSCAPING, AND ANY OTHER IMPROVEMENT OR FACILITY IN THE CONSTRUCTION AREA. THE CONTRACTOR SHALL REPAIR AND/OR REPLACE ANY DAMAGED ITEM DUE TO HIS CONSTRUCTION ACTIVITIES TO EQUAL OR BETTER THAN PRE-CONSTRUCTION CONDITIONS AT NO ADDITIONAL COST TO THE OWNER.
- 48. THE CONTRACTOR SHALL USE APPROPRIATE TECHNIQUES, AS APPROVED, RECOMMENDED OR OFFERED BY FLORIDA POWER AND LIGHT TO PREVENT UNDERMINING OF POWER POLES DURING CONSTRUCTION. IF HOLDING OF POWER POLES IS RECOMMENDED OR REQUIRED BY THE UTILITY. THE CONTRACTOR SHALL COORDINATE THIS ACTIVITY WITH THE CONTRACTOR SHALL COORDINATE THIS ACTIVITY WITH THE
- 49. ANY TEMPORARY SHUTDOWNS FOR MODIFICATIONS OF EXISTING UTILITY SYSTEMS THAT MUST REMAIN IN SERVICE DURING CONSTRUCTIONS SHALL BE KEPT TO A MINIMUM AND SHALL BE COORDINATED WITH AND APPROVED BY THE MANATE COUNTY UTILITY OPERATIONS DEPARTMENT IN ACCORDANCE WITH THE CONTRACT DOCUMENTS. IT IS NOTED THAT TEMPORARY SHUTDOWNS MAY BE RESTRICTED TO CERTAIN HOURS AT ANY TIME OF THE DAY OR NIGHT AND WILL BE COMPLETED AT NO ADDITIONAL COST TO THE OWNER.
- 50. FOR WORK BEING DONE ON EXISTING SANITARY SEWER LINES, THE CONTRACTOR SHALL BE RESPONSIBLE FOR MAINTAINING THE FLOW OF ALL SEWAGE DURING CONSTRUCTION, WHICH MAY REQUIRE BY-PASS PUMPING AND/OR PUMPER TRUCKS. THE CONTRACTOR SHALL SUBMIT A DETAILED BY-PASS PUMPING PLAN PER SECTION 02720.
- 51, THE ELEVATIONS OF THE UTILITY SERVICES AND LATERALS HAVE BEEN ASSUMED ON THE BASIS OF TYPICAL ANTICIPATED SOIL COVERAGE, CONTRACTOR SHALL NOT RELY ON THIS INFORMATION FOR CONSTRUCTION, BUT SHALL BE RESPONSIBLE FOR FIELD LOCATIONS (HORIZONTAL AND VERTICAL) OF ALL UTILITIES CROSSING THE PROPOSED FORCE MAIN. CONTRACTOR SHALL INCLUDE IN THE UNIT COST OF THE SUBJECT FORCE MAIN CONSTRUCTION, THE COST OF UTILITY ADJUSTMENTS NECESSARY TO ATTAIN DESIGN MINIMUM SEPARATION FOR UTILITIES CONFLICTING WITH THE CONSTRUCTION OF THE PROPOSED FORCE MAIN. INTERRUPTIONS OF ANY EXISTING UTILITY SERVICES SHALL BE NOTICED TO EFFECTED CUSTOMERS A MINIMUM OF 48 HOURS IN ADVANCE AND SHALL NOT EXCEED 4 HOURS IN DURATION.

RESTORATION

- 52. ALL RESTORATION WORK PERFORMED THROUGHOUT THE PROJECT SHALL CONFORM TO EXISTING LINES AND GRADES UNLESS SHOWN OTHERMSE.
- 54. ALL CONCRETE THRUST BLOCKS INSTALLED FOR TESTING PURPOSES AND NOT REQUIRED FOR THE OPERATION OF THE PIPELINE SHALL BE REMOVED AND DISPOSED OF BY THE CONTRACTOR, PRIOR TO FINAL ACCEPTANCE, AT NO ADDITIONAL COST TO THE OWNER.
- 56. CONCRETE DRIVEWAYS OR SIDEWALKS THAT ARE CUT SHALL BE RESTORED TO MATCH EXISTING ACCORDING TO THE CURRENT EDITIONS OF THE F.J.O.T. SPECIFICATIONS FOR ROAD AND BRIDGE DESIGN, SECTION 522, AND SECTION 310 OF THE F.J.O.T. DESIGN STANDARDS.
- 57. WHENEVER A PERMANENT ROADWAY SURFACE IS NOT REPLACED IMMEDIATELY AFTER BACKFILLING AND COMPACTION OF THE NEWLY INSTALLED PIPE LINE IN AREAS WHERE TRAFFIC MUST PASS, THE CONTRACTOR SHALL INSTALL A TEMPORARY SURFACE CONSISTING OF NINE INCHES OF COMPACTED LINE ROCK BASE AND A COAT OF ASPHALT EMULSION, PERMANENT ROADWAY REPAIR SHALL BE PERFORMED A MAXIMUM OF TWENTY—ONE CALENDAR DAYS AFTER THE INITIAL OPEN CUTTING.
- 58. RESTORATION OF CURBS, DRIVEWAYS, SIDEWALKS, AND PLACEMENT OF SOD SHALL BE COMPLETED WITHIN FORTY—FIVE CALENDAR DAYS OF INITIAL DISTURBANCE, OR TWENTY—ONE CALENDAR DAYS OF SUBSTANTIAL COMPLETION, WHICHEVER OCCURS FIRST.
- 59. ALL EXISTING FENCES DISTURBED DURING CONSTRUCTION SHALL BE REPAIRED OR REPLACED AND REINSTALLED BY PLANS.


 PLANS.
- 60. WHERE CONCRETE REPAIRS ARE NECESSARY AND EXPANSION OR CONTRACTION JOINTS ARE PRESENT, CONTRACTOR SHALL REMOVE AND REPLACE CONCRETE UP TO THE NEXT EXPANSION OR CONTRACTION JOINT.

- 61. THE EXHAUST SYSTEM OF ALL GASOLINE AND DIESEL ENGINES SHALL BE EQUIPPED WITH MUFFLERS THAT MEET THE EQUIPMENT MANUFACTURER'S REQUIREMENTS FOR NOISE SUPPRESSION. THE CONTRACTOR SHALL INSTALL NOISE ABATEMENT BAFTLES POSITIONED TO BREAK LINE-OF-SITE FROM THE NOISE SOURCE TO AFFECTED RESIDENCES, AS APPROVED BY THE ENGINEER.
- 62. NO MATERIAL SHALL BE STOCKPILED IN ROADWAYS. ALL DIRT AND DEBRIS SHALL BE REMOVED FROM THE JOB SITE DAILY. ROADS SHALL BE SWEPT DAILY AS PART OF DAILY CLEAN UP.
- 63. THE CONTRACTOR IS TO CONTROL ALL FUGITIVE DUST ORIGINATING ON THIS PROJECT BY WATERING OR OTHER METHODS AS REQUIRED.
- 64, INGRESS AND EGRESS TO ALL THE PROPERTIES IN THE CONSTRUCTION AREA SHALL BE MAINTAINED AT ALL TIMES.
- 66, THE CONTRACTOR SHALL PROVIDE ALL DEWATERING EQUIPMENT NECESSARY TO KEEP ALL EXCAVATIONS DRY. DEWATERING IS REQUIRED TO 18" BELOW TRENCH BOTTOM.
- 67. ALL PIPING AND FITTINGS USED ON THIS PROJECT SHALL BE AS NOTED ON THE PLANS AND IN THE CON DOCUMENT AND SHALL BE INSTALLED TO THE LINES AND GRADES SHOWN ON THE PLANS AND PROFILES.
- 68. ALL PIPE SHALL BE COLOR CODED TO CONFORM TO MANATEE COUNTY STANDARDS.
- 69. ALL FITTINGS FOR PRESSURE CLASS—RATED PIPE SHALL BE RESTRAINED DUCTILE IRON. RESTRAINED LENGTHS OF PIPE SHALL ADHERE TO THE REQUIREMENTS AS SHOWN ON THE DETAIL SHEETS.
- 70. WHERE IT IS NECESSARY TO DEFLECT PIPE EITHER HORIZONTALLY OR VERTICALLY, PIPE DEFLECTION SHALL NOT EXCEED 75% OF THE MANUFACTURER'S MAXIMUM ALLOWABLE RECOMMENDED DEFLECTION.
- . ALL ROCKS OR STONES LARGER THAN SIX INCH DIAMETER SHALL BE REMOVED FROM THE BACKFILL MATERIAL. BACKFILL MATERIAL BACKFILL MATERIAL BACKFILL MATERIAL PLACED WITHIN ONE FOOT OF PIPING AND APPURTENANCES SHALL NOT CONTAIN ANY STONES LARGER THAN TWO INCH DIAMETER.
- 72. ONLY MANATEE COUNTY UTILITY OPERATIONS STAFF ARE AUTHORIZED TO OPERATE VALVES AND PUMP STATIONS ON COUNTY OWNED AND MAINTAINED UTILITY SYSTEMS.
- 3. THE CONTRACTOR, PRIOR TO ANY TEMPORARY WATER SHUT-OFFS DURING WATER MAIN TIE-IN, ETC., SHALL NOTIFY THE AFFECTED RESIDENTS BY POSTING INFORMATIONAL SIGNS IN THE NEIGHBORHOOD AT LEAST TWO DAYS (48 HRS) PRIOR TO THE WATER SHUT-OFF. REFERENCE SECTION OISSO, PARAGRAPH 1.03 OF THE SPECIFICATIONS. WHEN FEASIBLE, DOOR HANGERS' SHALL BE DELIVERED TO AFFECTED RESIDENCES AT LEAST TWO DAYS (48 HRS) PRIOR TO WATER SHUT-OFF. FOR LARGE PROJECTS WITH HUNDREDS OF HOMES AFFECTED, THE CONTRACTOR SHALL ALSO MAKE EXTENSIVE USE OF THE MEDIA AND SHALL HAVE PRIOR CONTACT WITH HOMEOWNER'S ASCOCIATIONS AND THE RESPECTIVE. CITY'S. WRITTEN NOTIFICATIONS SHALL ALSO BE FAXED TO THE TAMPA TRIBUNE, BRADENTON HERALD, AMI SUN, ISLANDER, SARASOTA HERALD TRIBUNE, WASDR RADIO THE TAMPA TRIBUNE, BY REPROPAY COMMUNITY CENTERS, INSPECTIONS, WATER TREATMENT PLANT, WATER MANAGER, HELPLINE, CUSTOMER SERVICE, AND THE MANATEE COUNTY UTILITY OFFRATIONS DEPARTMENT.
- 74. ALL TEST POINT PIPING SHALL BE CUT LOOSE FROM THE CORPORATION STOP AND COMPLETELY REMOVED AND DISPOSED OF BY THE CONTRACTOR PRIOR TO FINAL ACCEPTANCE. A CORPORATION STOP PLUG SHALL BE INSTALLED AND THE CORPORATION STOP SHALL REMAIN IN PLACE.
- 75. ALL EXISTING MAINS THAT ARE BEING REPLACED SHALL BE ABANDONED IN PLACE UPON ACCEPTANCE AND ACTIVATION OF THE NEW MAINS. ABANDONED MAINS SHALL BE CUT AND CAPPED. REFER TO SECTION 02064 OF THE SPECIFICATIONS FOR CUT AND CAPPING ABANDONED PIPE.
- 76. FIELD CONDITIONS MAY NECESSITATE MINOR ALIGNMENT AND GRADE DEVIATION OF THE PROPOSED UTILITIES TO AVOID OBSTACLES, AS ORDERED BY THE ENGINEER.
- 77. THE CONTRACTOR SHALL OBTAIN AUTHORIZATION FROM THE MANATEE COUNTY UTILITIES DEPARTMENT (MCUD) OFFICE OF INDUSTRIAL COMPILANCE PRIOR TO DEWATERING, COMPLETION OF A CONSTRUCTION DEWATERING AUTHORIZATION TO DISCHARGE APPLICATION IS REQUIRED. FILL OUT FORM AS COMPLETELY AS POSSIBLE AS MISSING INFORMATION DELAYS THE APPROVAL PROCESS.
- 78, THE MCUD OFFICE OF INDUSTRIAL COMPLIANCE WILL DETERMINE WHETHER A LETTER OF APPROVAL, A DISCHARGE AUTHORIZATION, OR A DISCHARGE PERMIT IS REQUIRED.
- IF ANY RECLAIMED OR WATER MAINS INCLUDING SERVICE LINES ARE DAMAGED DURING CONSTRUCTION, THEY SHALL BE REPLACED FROM THE VALVE TO THE OTHER POINT OF CONNECTION OUTSIDE OF THE ROADWAY FER MANATED COUNTY'S STANDARDS. SERVICES SHALL BE REPLACED FROM THE COLD STOP TO THE METER.

- TRAFFIC SHALL BE MAINTAINED IN ACCORDANCE WITH F.D.O.T. DESIGN STANDARDS INDICES NO. 600, 603, 605, 611, 612, 613, 616, AND 660 DEPENDING ON THE OPERATION BEING PERFORMED.

 FOR ALL TWO-LANE WORK, TWO-WAY, WORK WITHIN TRAVEL LANE UTILIZE INDEX 603, FOR ALL TWO-LANE WORK, TWO-WAY, WORK NEAR INTERSECTION UTILIZE INDEX 605.

- FOR ALL MULTILANE WORK OUTSIDE SHOULDER UTILIZE INDEX NO. 611.
- FOR ALL MULTILANE WORK ON SHOULDER UTILIZE INDEX NO. 612.
 FOR ALL MULTILANE WORK WITHIN TRAYEL WAY MEDIAN OR OUTSIDE LANE UTILIZE INDEX NO. 613.
 FOR ALL MULTILANE WORK NEAR INTERSECTION MEDIAN OR OUTSIDE LANE UTILIZE INDEX NO. 616.
 FOR PEDESTRIAN CONTROL FOR CLOSURE OF SIDEWALK, UTILIZE FOOT INDEX NO. 660.
- CONTRACTOR TO COORDINATE WITH ED HERNDON (941) 708-4436 AT FDOT FOR ALL WORK DONE ON A STATE FACILITY.
- 83. TO AVOID DISRUPTION DUE TO INCLEMENT WEATHER, THE CONTRACTOR SHOULD PERFORM ANY MILLING AND PAVING OPERATIONS DURING THE SAME WORK PERIOD.
- 85. LANE CLOSURES SHALL OCCUR BETWEEN 9:00 P.M. AND 5:00 A.M., UNLESS LANE CLOSURE CALCULATIONS ARE PROVIDED AND APPROVED OR APPROVAL IS GRANTED BY THE DISTRICT PERMIT ENGINEER.
- AT THE END OF EACH WORKDAY OR WHENEVER THE WORK ZONE BECOMES INACTIVE, ANY DROP-OFF ADJACENT TO SIDEWALK SHALL BE BACKFILLED AT A SLOPE NOT TO EXCEED 1:4, OR SHALL BE PROTECTED IN ACCORDANCE WITH STANDARD INDEX 600.
- 87. PEDESTRIAN AND WHEELCHAIR TRAFFIC SHALL BE ACCOMMODATED UTILIZING STANDARD INDEX 660.
- 88. ONE PORTABLE VARIABLE MESSAGE SIGN SHALL BE USED IN ADVANCE OF EACH LANE CLOSURE. THE FOLLOWING ARE SUGGESTED MESSAGES TO USE IN THE APPROPRIATE SITUATIONS:

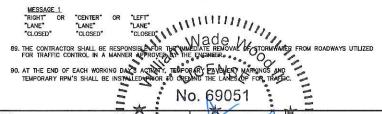

STATE OF PROFESSIONAL

FL LICENSE NUMBER

A D RAP PRODE

ALL PAVEMENT MARKINGS, SIGNS, MARKERS, CHANNELIZATION REQUIRED TO PHASE WORK OR SHIFT TRAFFIC, SHALL UTILIZE INDICES FOR PLACEMENT.

THE CONTRACTOR SHALL RESTRICT THE OPERATIONS SO THAT THE FIRST LIFT OF ASPHALT IS PLACED ON THE SAME DAY THAT THE LANES ARE MILLED, BEFORE OPENING THE LANES TO TRAFFIC. INSTALL TEMPORARY PAVEMENT MARKINGS AFTER THE FIRST LIFT AND PRIOR TO OPENING.

- 93. MILLING AND RESURFACING SHALL BE ACCOMPLISHED DURING THE OFF-PEAK HOURS.
- 94. THE CONTRACTOR IS RESPONSIBLE TO RETIME THE TRAFFIC SIGNALS WITHIN THE PROJECT LIMITS (INCLUDING LIMITS OF WORK ZONE TRAFFIC CONTROL) THAT ARE POTENTIALLY AFFECTED DURING VARIOUS PHASES OF CONSTRUCTION, COORDINATE ALL SIGNAL RETIME EFFORTS MUKUNDA GOPALAKRISHNA, P.E., PTOE, COUNTY TRAFFIC ENGINEER, AT 941–749–3500, EXT. 7813.
- 95, CONTRACTOR TO MAINTAIN VEHICLE DETECTION IN OPERATION FOR LANES THAT WILL REMAIN OPEN. CONTRACTOR TO COORDINATE ALL VEHICLE DETECTION ISSUES WITH CLARKE DAMS OF MANATE COUNTY AT 941-708-7450, EXT. 7272 OR CLARKE,DAMS
- 96. MAINTENANCE OF TRAFFIC AND ANY SIGNAL RETIMING WILL BE THE RESPONSIBILITY OF THE CONTRACTOR.
- 97. ANY SIGNAL RETIMING REQUIRED FOR THE INTERSECTIONS IMPACTED BY THE PROJECT WILL BE THE RESPONSIBILITY OF THE CONTRACTOR. SIGNAL TIMING MODIFICATIONS TO BE SUBMITTED TO MANATAE COUNTY INAFFIC DESIGN, ATTENTION MR. MUKUNDA GOPALAKRISHNA FOR REVIEW AND APPROVAL AT LEAST 15 WORKING DAYS BEFORE PROPOSED CHANKES. THIS DIES NOT GOVERN DEMERGENCY STUATIONS, PEDIDING THE APPROVAL OF THE ENGINEER.
- 98. A DETAILED MAINTENANCE OF TRAFFIC PLANS ARE TO BE SUBMITTED TO MANATEE COUNT AND THE ENGINEER, BY THE CONTRACTOR, FOR REVIEW AND APPROVAL A MINIMUM OF 21 WORKING DAYS PRIOR TO PROPOSED IMPLEMENTATION.

ABBREV

Ļ	ATIONS			
		ST	32	STORM DRAIN
	RESTRAINED JOINT	EX.	-	EXISTING
	RIGHT-OF-WAY	BT	-	BURIED TELEPHONE
	HORIZONTAL DIRECTIONAL DRILL	UC	-	UNDERGROUND CONDUIT
	REINFORCED CONCRETE PIPE	DBC	-	DIRECT BURIED CABLE
	AIR RELEASE VALVE	FOC	-	FIBER OPTIC CABLE
	HIGH DENSITY POLYETHYLENE	SS	2	SANITARY SEWER
	POLYVNYL CHLORIDE	FM	-	FORCE MAIN
	NATURAL GROUND	WM	-	WATER MAIN
MATORAL GROOM	MATORIAL GROOMD	RW	_	RECLAIM WATER MAIN
		ECP	_	ELLIPTICAL CONCRETE PIPE

KIMLEY HORN LEGEND EX. FORCEMAIN PROPOSED FORCEMAIN/ WATERMAIN

EX. WATERMAIN ABANDONED WATERMAIN EX. SANITARY SEWER

EX. BURIED TELEPHONE/FIBER EX. FIBER OPTIC CABLE EX. DIRECT BURIED CABLE

EX. OIL EX. BURIED ELECTRIC

EX. GAS EX. OVERHEAD UTILITIES

EX. BURIED TV

PROPOSED FULL ROADWAY RESTORATION PROPOSED SIDEWALK/ DRIVEWAY REPAIR

PROPOSED CURB REPAIR PROPOSED MILLING AND RESURFACING +++++++++++++++++

EX. CONCRETE DRIVEWAY

EX. ASPHALT DRIVEWAY EX. BRICK DRIVEWAY

EX. INFILTRATION TRENCH

EX. GRAVEL/STONE

Kimley» Horn

655 NORTH FRANKLIN STREET, SUITE 150, TAMPA, FL 33602

PHONE: 813-620-1460 WWW.KIMLEY-HORN.COM CA 00000696

KHA PROJECT 148400016 9/11/2018 SCALE AS SHOWN DESIGNED BY WWW

DRAWN BY IMB

CHECKED BY WEW MANATEE COUNTY

END OF SERVICE LIFE - PACKAGE AS FM 28A/ PORT MANATEE/ ORLANDO AVE.

GENERAL NOTES

FM 28A TEST HOLE DATA (OMNI COMMUNICATIONS REPORT, JOB #33-17-062) TEST HOLE UTILITY GROUND EL (FEET) TOP OF PIPE (FEET) FIELD MARKING NOTES PER OMNI REPORT 4" PVC MULTI-DUCT TH-01 FOUND HUB AT GROUND LEVEL, NO LATH ONE CONDUIT WAS BROKEN COMMUNICATION

NOTE: SUBSURFACE UTILITY ENGINEERING DATA PROVIDED BY OMNI COMMUNICATIONS, LLC, DATED DECEMBER 14, 2017.

	(OMNI	PORT MANATEE TEST H COMMUNICATIONS REPORT, JOB #33-		3-17-061)	
TEST HOLE	UTILITY	FIELD MARKING	GROUND EL (FEET)	TOP OF PIPE (FEET)	NOTES PER OMNI REPORT
TH-01	30" OIL LINE	FOUND NAIL AND DISK MARKED TH-1	8.50	N/A	NO UTILITY DETECTED
TH-02	16" STEEL OIL LINE	FOUND NAIL AND DISK MARKED TH-2 C-3.10	8.71	5.61	UTILITY TYPE UNABLE TO BE VERIFIED, POSSIBLE OIL LINE
TH-03	6" STEEL UNKNOWN UTILITY	FOUND NAIL AND DISK MARKED TH-3 C-3.49	8.43	4.94	UTILITY TYPE UNABLE TO BE VERIFIED, RUSTY POOR CONDITION
TH-04	5' CONC CAP ON OIL LINE	FOUND NAIL AND DISK MARKED TH-4	8.49	1.09	FOUND TOP OF CONC CAP ON OILLINE
TH05	14" STEEL OIL LINE	FOUND HUB AT GROUND LEVEL W/ LATH MARKED TH-5 14" STEEL UNK C-5.54	6.70	1.16	UTILITY TYPE UNABLE TO BE VERIFIED, POSSIBLE OIL LINE
TH-06	OIL/GAS LINE	FOUND NAIL AND DISK MARKED TH-6	8.63	N/A	VAC AND PROBED SOUTH SIDE O 16" UNK. POSSIBLE OIL AND GA NO LINES FOUND BESIDE OR BELOW.
TH-07	OIL/GAS LINE	FOUND NAIL AND DISK MARKED TH-7	8.71	N/A	VAC AND PROBED NORTH SIDE O 16" UNK. POSSIBLE OIL AND GA NO OTHER LINES BESIDE OR BELOW.
TH-08	18" STEEL OIL LINE	FOUND NAIL WITH PINK FLAGGING AND OMNI DESCRIPTION PINK PAINT	8.40	5.60	FOUND 18" STEEL OIL LINE
TH-09	STEEL OIL LINE (SIZE UNKNOWN)	FOUND NAIL WITH PINK FLAGGING AND OMNI DESCRIPTION PINK PAINT	8.39	0.13	NOT ABLE TO VERIFY SIZE OF STEEL OIL LINE DUE TO WATER AND CAVE INS

NOTE: SUBSURFACE UTILITY ENGINEERING DATA PROVIDED BY OMNI COMMUNICATIONS, LLC, DATED DECEMBER 18, 2017.

		ORLANDO AVE (OMNI COMMUNICATIONS REPORT,	. TEST HOLE D JOB #33-17-02		53)
TEST HOLE	עדטוויט	FIELD MARKING	GROUND EL (FEET)	TOP OF PIPE (FEET)	NOTES PER OMNI REPORT
TH-01	2" PE GAS LINE	X-CUT W/ "C-1.55" MARKED ON CONC SWK FOR LOCATION	15.70	14.15	FOUND 2" PE GAS LINE
TH-02	4" PVC/STEEL WATERLINE	FOUND NAIL IN ASPH MARKED TH2, NO CUT POSTED	14.64	12.72	FOUND 4" PVC TO METAL WATERLINE
TH-03	6" ACP WATERLINE	FOUND HUB AT GROUND LEVEL W/ LATH MARKED "BH TH3 6" ACP WL C-1.54"	16.10	14.57	FOUND 6" ACP WATERLINE
TH-04	1" PE GAS LINE	FOUND HUB AT GROUND LEVEL W/ LATH MARKED "BH TH4 1" PE GAS C-1.20"	16.10	14.90	FOUND 1" PE GAS HAS YELLOW TRACE WIRE WITH IT
TH-05	2" PE GAS LINE	FOUND HUB AT GROUND LEVEL W/ LATH MARKED "BH TH5 2" PE GAS C-1.85"	15.70	13.85	FOUND 2" PE GAS
TH-06	2" PE GAS LINE	FOUND HUB AT GROUND LEVEL W/ LATH MARKED "BH TH6 2" PE GAS C-1.83"	15.60	13.77	FOUND 2" PE GAS LINE
TH-07	8" PVC WATERLINE	FOUND HUB AT GROUND LEVEL MARKED "BH TH7 8" WL PVC C-3.60"	16.00	12.40	FOUND 8" PVC WATERLINE
TH-08	WATERLINE	NOT FOUND OR MARKED IN FIELD BY OMNI	15.70	N/A	VAC AND PROBED BOTH SIDES OF WM 1-CALL MARKS (NOT FOUND). GPR NOT DETECTING — BAD GRID CONDITIONS. SHELL, HARD LAYERS. WILL TAKE VAC SOMETIME TO LOCATE
TH09	10" DIP FORCEMAIN	FOUND HUB AT GROUND LEVEL W/ LATH MARKED "BH TH9 10" DIP FM C-4.67"	15.60	10.93	FOUND 10" DIP FORCEMAIN
TH-10	2" PE GAS LINE	FOUND HUB AT GROUND LEVEL W/ LATH MARKED "BH TH10 2" PE GAS C-3.53"	15.60	12.07	FOUND 2" PE GAS
TH-11	10" DIP FORCEMAIN	FOUND NAIL IN ASPHALT	15.98	12.06	NO NOTES
TH-12	1-1/2" PE FIBER OPTIC CABLE	FOUND NAIL IN ASPHALT	15.87	13.17	NO NOTES
TH-13	10" DIP FORCEMAIN	FOUND NAIL IN ASPHALT	15.06	12.58	NO NOTES
TH-14	4" PVC WATERLINE	FOUND HUB AT GROUND LEVEL	15.74	14.20	NO NOTES
TH-15	WATERLINE	FOUND HUB AT GROUND LEVEL WITH LATH THAT INDICATED VAC TO 5' AND LANCED TO 10'. NO UTILITY FOUND.	16.31	N/A	NO DETECTION ON WATER LINE 810-GPR RD. CALL MARK LEONARD. 1 CALL MARKS NOT FOUND

NOTE: SUBSURFACE UTILITY ENGINEERING DATA PROVIDED BY OMNI COMMUNICATIONS, LLC, DATED DECEMBER 13, 2017.

DATE BY

REVISIONS

SURVEY NOTES

FM 28A SITE CONTROL						
DESIGNATION	NORTHING	EASTING	ELEVATION (FEET)			
BM-1	1129721.35	466405.00	18.14			
BM-2	1129715.77	467401.42	18.33			

THE FOLLOWING NOS VERTICAL CONTROL MONUMENT WAS RECOVERED AND UTILIZED FOR THE ELEVATIONS SHOWN HEREIN: "COB 1049" NAVD 1988 ELEVATION 23.94' A VALUE OF (+0.98') SHOULD BE APPLIED TO ALL ELEVATIONS FOR A CONVERSION TO NGVD 1929.

PORT MANATEE FM SITE CONTROL					
DESIGNATION	NORTHING	EASTING	ELEVATION (FEET)		
BM-1	1199967.34	475749.05	8.83		
BM-2	1200449.83	475838.48	7.11		

THE FOLLOWING NGS VERTICAL CONTROL MONUMENT WAS RECOVERED AND UTILIZED FOR THE ELEVATIONS SHOWN HEREIN: "COB 1049" NAVD 1988 ELEVATION 23.94' A VALUE OF (+0.98') SHOULD BE APPLIED TO ALL ELEVATIONS FOR A CONVERSION TO NGVD 1929.

DESIGNATION	NORTHING	EASTING	ELEVATION (FEET
BM-1	1136195.59	470368.61	16.35
BM-2	1136241.69	471733.45	16.13
BM-3	1136940.38	471979.23	15.63
BM-4	1136940.39	471979.21	15.62
BM-5	1137137.43	471941.22	17.12

THE FOLLOWING NGS VERTICAL CONTROL MONUMENT WAS RECOVERED AND UTILIZED FOR THE ELEVATIONS SHOWN HEREIN: "COB 1049" NAVD 1988 ELEVATION 23.94' A VALUE OF (+0.98") SHOULD BE APPLIED TO ALL ELEVATIONS FOR A CONVERSION TO NGVD 1929.

SURVEY LEGEND

	_					
ВМ	•	BENCH MARK	Q	BUSH		ABBREVIATIONS
CM	•	CONCRETE MONUMENT	9 8	TREE		
IP.	٥	IRON PIPE	₹	DAK TREE	R/W	RIGHT OF WAY
IR	•	IRON ROD	7	PALM TREE	CONC	CONCRETE
HUB	^	HUB	7	PINE TREE	ASPH	ASPHALT
N&D	•	NAIL & DISK	7H−1	TEST HOLE	DRWY	DRIVEWAY
K2288		ELEVATION	₽ B−1	BORE HOLE	SWK	SIDEWALK
\leq	2	PARCEL ID NO.	Ψ		EP	EDGE OF PAVEMEN
\subseteq)	PARCEL ID NO.	ann	EDGE OF VEGETATION	BOC	BACK OF CURB
\subset)	LOT NO.		- CHAIN LINK FENCE		
GW	←	GUY WIRE		- WOOD FENCE		
PP	ø	POWER POLE	xx	- BARBED WIRE FENCE		
LP	*	LIGHT POLE		- RAIL ROAD TRACKS		
MB	ď	MAIL BOX		- EDGE OF CONCRETE		
SN	þ	SIGN		-EDGE OF ROAD		
REF	9	REFLECTOR		TOE OF SLOPE		
SPRK		SPRINKLER		- TOP OF BANK		
GM	©	GAS MARKER		- PROPERTY LINE		
BFP	-0-	BACKFLOW PREVENTER		RIGHT OF WAY		
BO	040	BLOW OFF VALVE				
FH	·Q·	FIRE HYDRANT				
W	M	WATER VALVE				
ARV	(4)	AIR RELEASE VALVE				
WM		WATER METER				
SMH	(S)	SANITARY SEWER MANHOLE				
co	ō	SANITARY SEWER CLEAN OUT				
SB#	•	SOIL BORING LOCATION				
TEL	ŒD	TELEPHONE SERVICE BOX				
UB	u	UTILITY BOX				
@)	UTILITY RISER				
-	•	FLOW DIRECTION				
GI		GRATE INLET				
0	3), , '	MITTER THE SERVICE MANHOLE /				
1	11,	Wade W	"11,			

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KHA PROJECT 148400016 DATE 9/11/2018 SCALE AS SHOWN DESIGNED BY WWW


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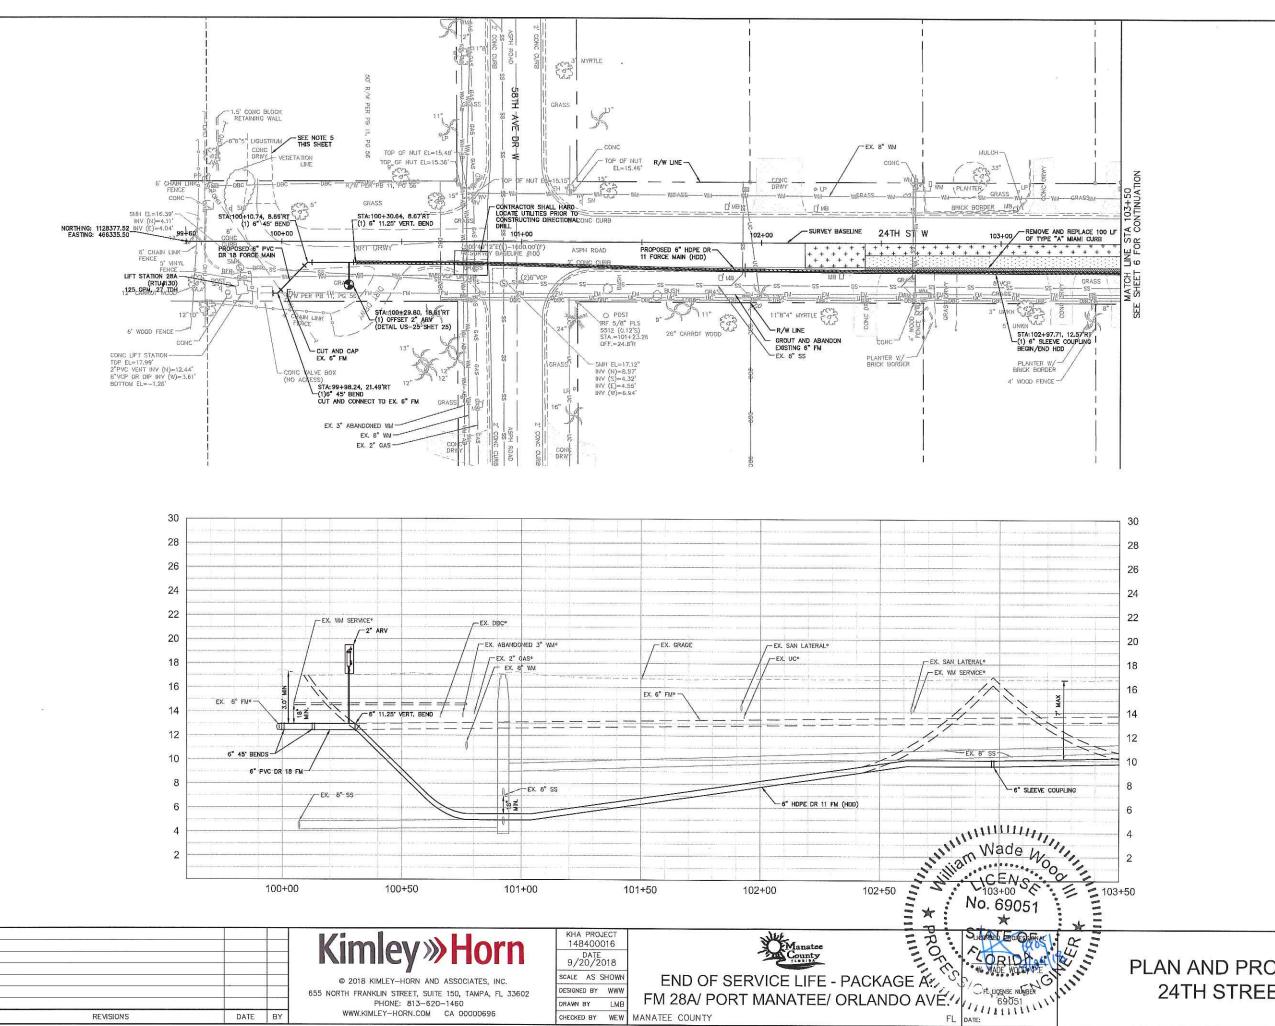
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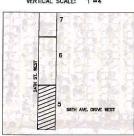
END OF SERVICE LIFE - PACKAGE A: FM 28A/ PORT MANATEE/ ORLANDO ÁVE. SHEET NUMBER

SURVEY AND SUE NOTES





CHECKED BY WEW MANATEE COUNTY

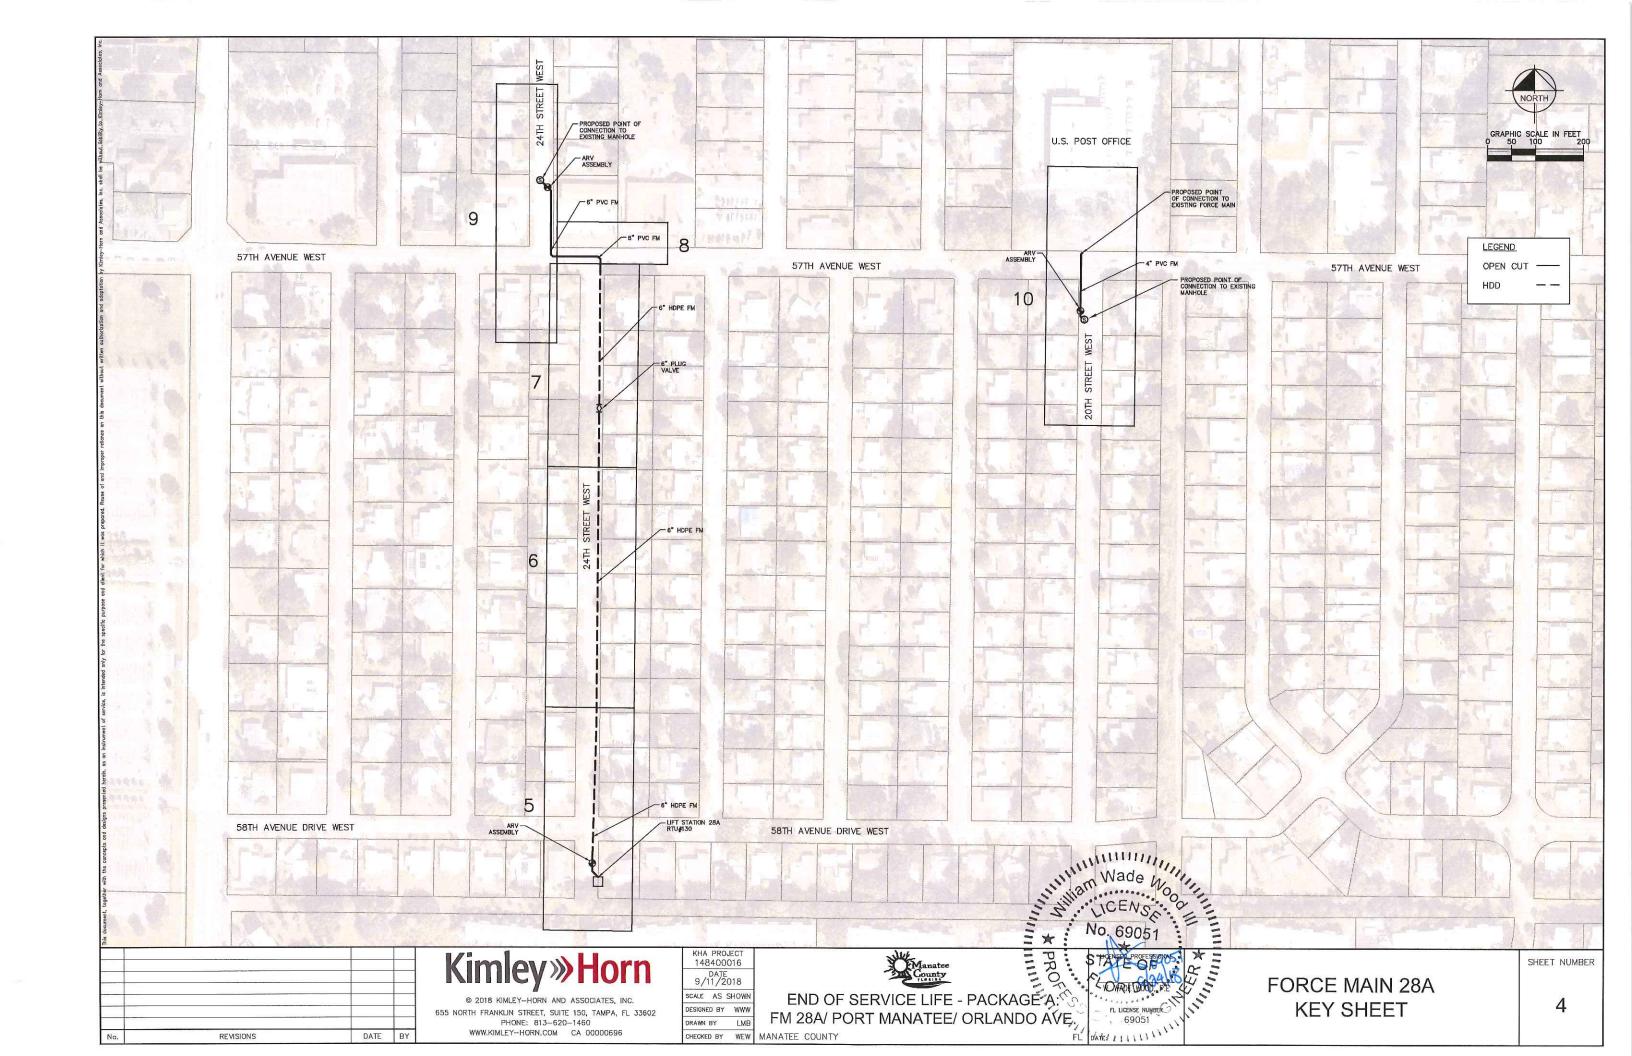

SIDEWALK/DRIVEWAY RESTORATION

- CONSTRUCTION DEWATERING SHALL BE CONDUCTED IN ACCORDANCE WITH ALL FEDERAL, STATE, AND LOCAL REQUIREMENTS INCLUDING BUT NOT LIMITED TO CHAPTERS 62—621.300 AND 62—620 OF THE FLORIDA ADMINISTRATIVE CODE (FAC).
- 4. EXISTING FORCE MAIN SHALL BE FLUSHED PRIOR TO GROUTING AFTER THE PROPOSED FORCE MAIN HAS BEEN PLACED INTO SERVICE.
 5. CONTRACTOR SHALL PROVIDE ACCESS TO THE RESIDENTIAL DRIVEWAYS DURING CONSTRUCTION.

*NOTES:
THE ELEVATIONS OF THE UTILITIES MARKED WITH AN ASTERISK (*) HAVE BEEN ASSUMED ON THE BASIS OF TYPICAL ANTIGIPATED SOIL COVERAGE. CONTRACTOR SHALL NOT RELY ON THIS INFORMATION FOR CONSTRUCTION, BUT SHALL BE RESPONSIBLE FOR FIELD LOCATIONS (HORIZONTAL AND VERTICAL) OF ALL UTILITIES CROSSING THE PROPOSED FORCE MAIN. CONTRACTOR SHALL INCLUDE IN THE UNIT COST OF THE SUBJECT FORCE MAIN CONSTRUCTION, THE COST OF UTILITY ADJUSTMENTS NECESSARY TO ATTAIN DESIGN MINIMUM SEPARATION FOR UTILITIES CONFLICTING WITH THE CONSTRUCTION OF THE PROPOSED FORCE MAIN. INTERRUPTIONS OF ANY EXISTING UTILITY SERVICES SHALL BE NOTICED TO EFFECTED CUSTOMERS A MINIMUM OF 48 HOURS IN ADVANCE AND SHALL NOT EXCRED A HOURS IN DURATION.

WHERE CONCRETE REPAIRS ARE NECESSARY AND EXPANSION JOINTS ARE PRESENT, CONTRACTOR TO REMOVE AND REPLACE CONCRETE UP TO THE NEXT EXPANSION JOINT; OTHERWISE, REPLACE CONCRETE AS NECESSARY.

GROUNDWATER DEWATERING NOTE:
THE PRESENCE OF GROUNDWATER
SHOULD BE ANTICIPATED ON THIS
PROJECT. CONTRACTOR'S BID SHALL
INCLUDE CONSIDERATION FOR THIS
ISSUE, WHEN PERFORMING GRADING
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MOISTURE OF SOILS.




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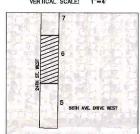
REVISIONS

DATE BY

PLAN AND PROFILE 24TH STREET

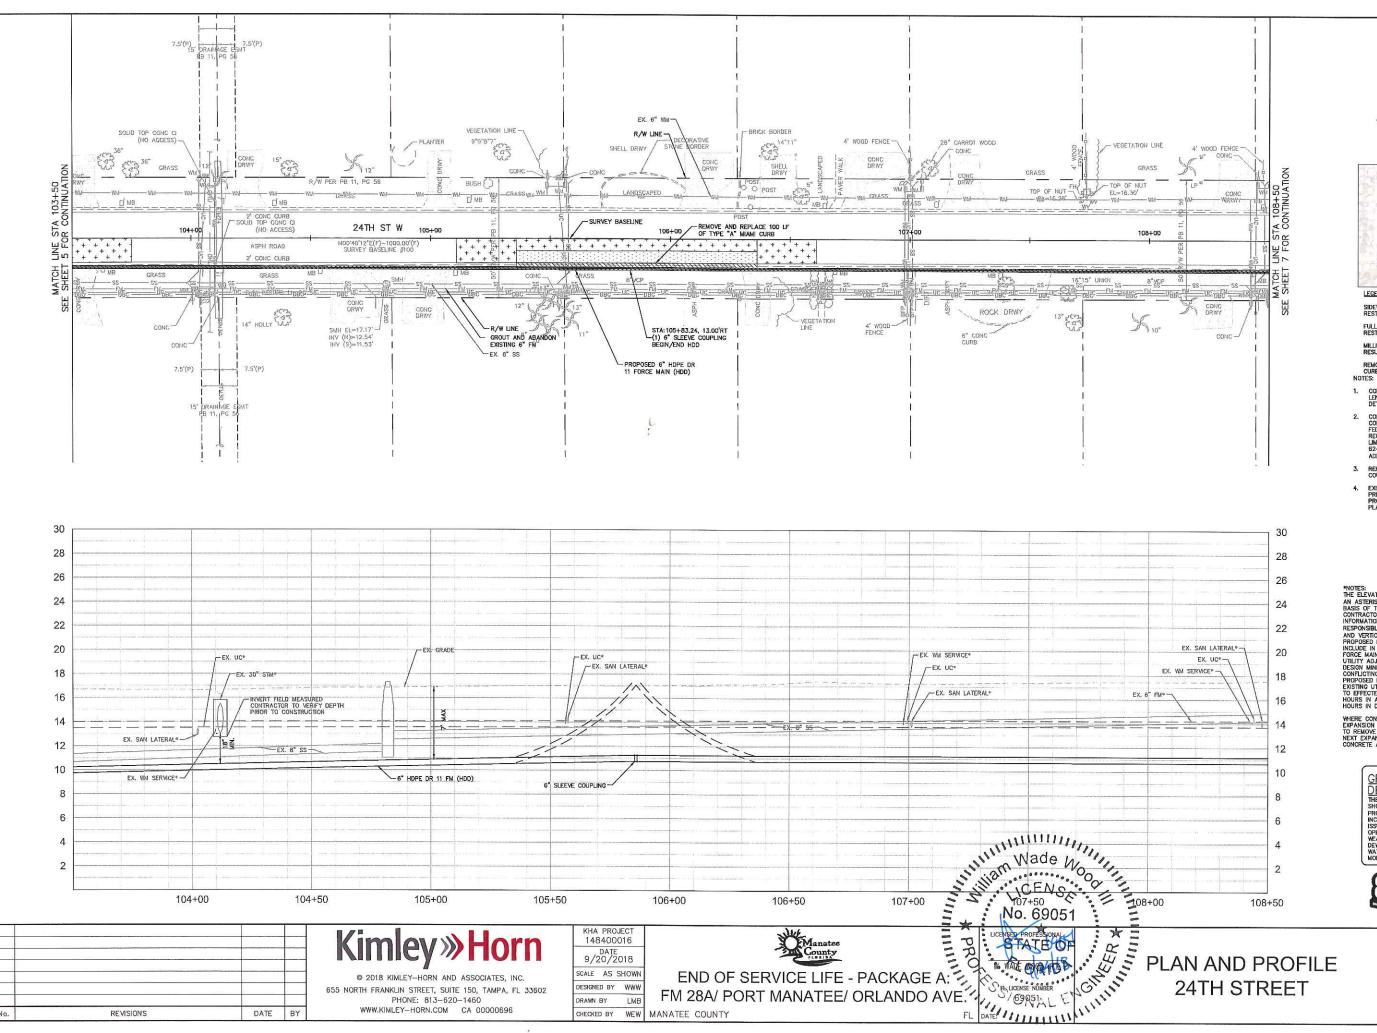

HORIZONTAL SCALE: 1"=2" VERTICAL SCALE: 1"=4"



MILLING AND RESURFACING

REMOVE & REPLACE CURB NOTES:

- CONSTRUCTION DEWATERING SHALL BE CONDUCTED IN ACCORDANCE WITH ALL FEDERAL, STATE, AND LOCAL REQUIREMENTS INCLUDING BUT NOT LIMITED TO CHAPTERS 62—621.300 AND 62—620 OF THE FLORION ADMINISTRATIVE CODE (FAC),

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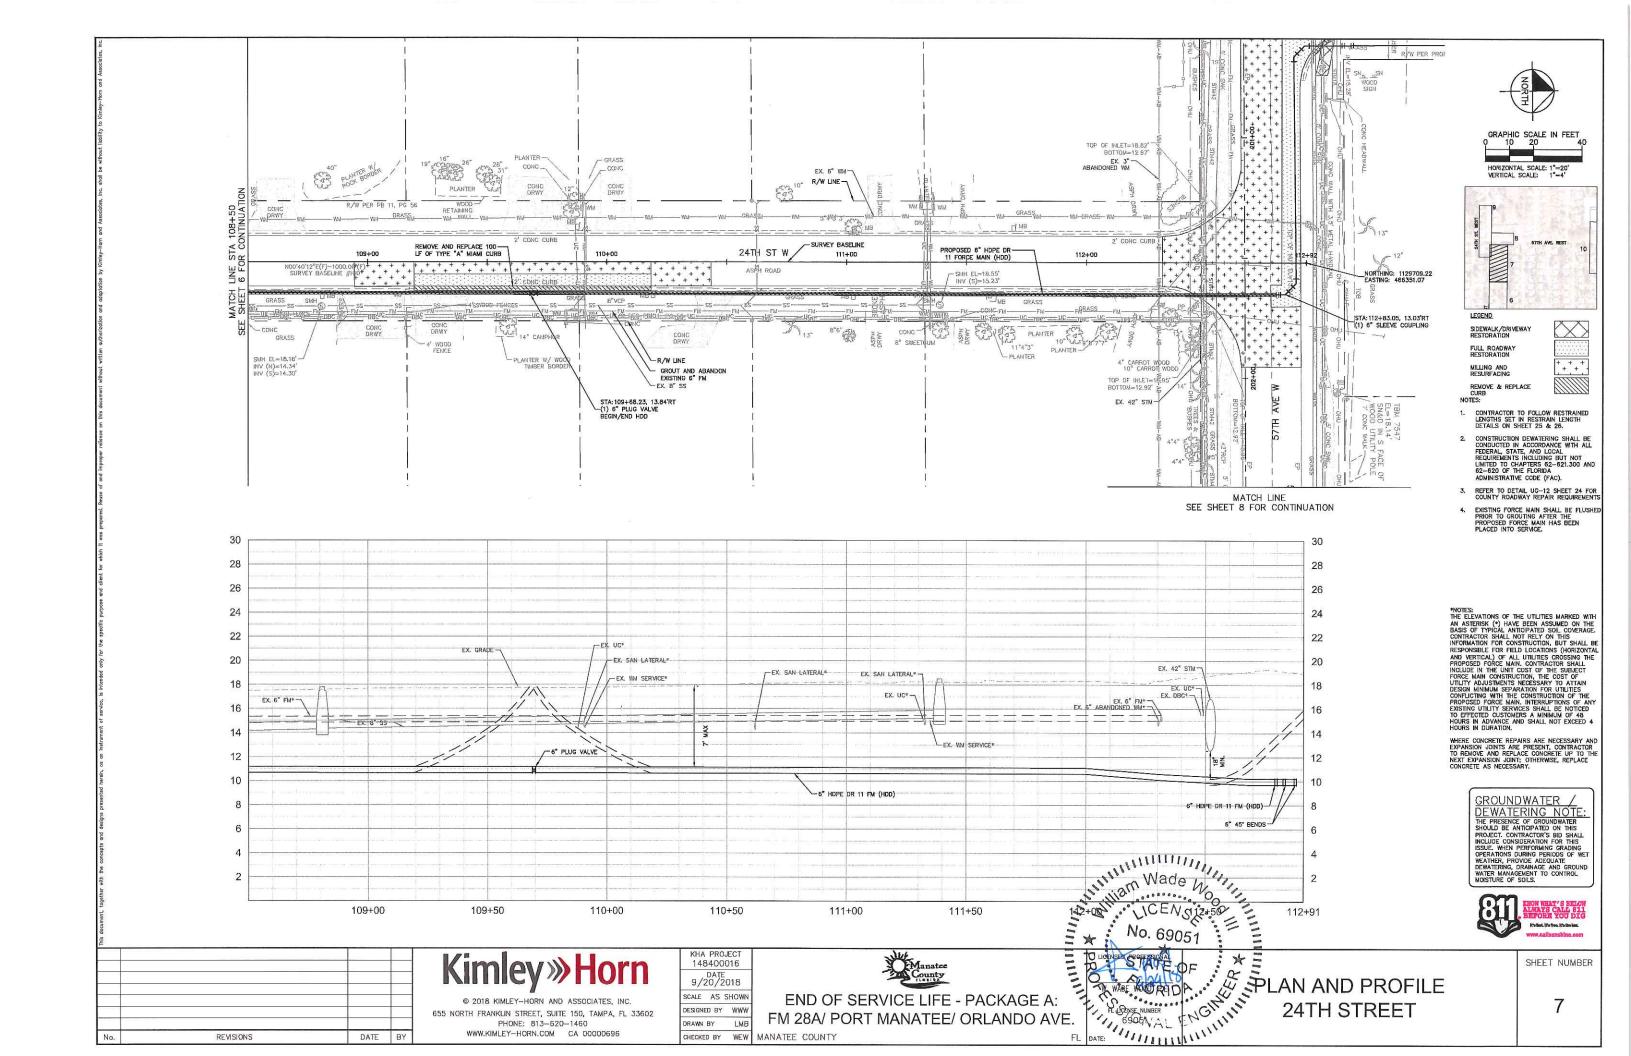
WHERE CONCRETE REPAIRS ARE NECESSARY AND EXPANSION JOINTS ARE PRESENT, CONTRACTOR TO REMOVE AND REPLACE CONCRETE UP TO THE NEXT EXPANSION JOINT, OTHERWISE, REPLACE CONCRETE AS NECESSARY.


GROUNDWATER


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WEATHER, PROVIDE ADEQUATE
DEWATERING, DRAINAGE AND GROUND
WATER MANAGEMENT TO CONTROL
MOISTURE OF SOILS.



SHEET NUMBER



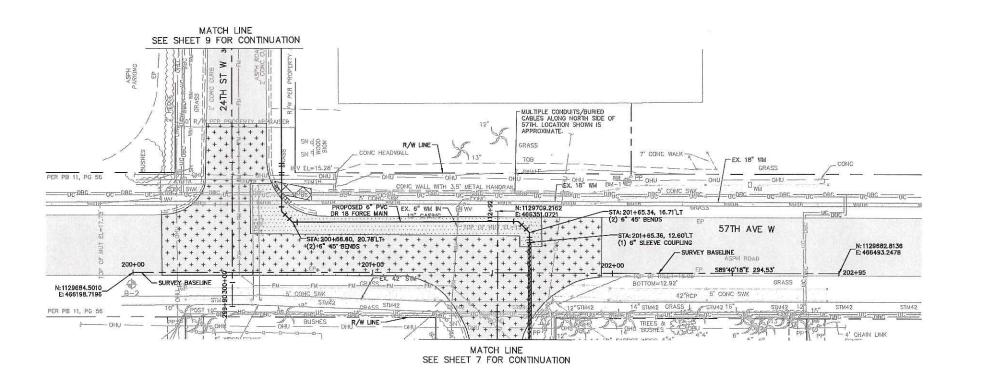

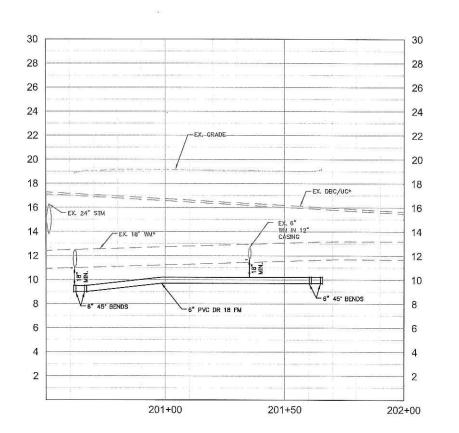

No. 69051 PLAN AND PROFILE

VE.

57TH AVENUE

LEGEND

SIDEWALK/DRIVEWAY RESTORATION

REMOVE & REPLACE CURB

- CONSTRUCTION DEWATERING SHALL BE CONDUCTED IN ACCORDANCE WITH ALL FEDERAL, STATE, AND LOCAL REQUIREMENTS INCLUDING BUT NOT LIMITED TO CHAPTERS 62—621.300 AND 62—620 OF THE FLORIDA
- REFER TO DETAIL UG-12 SHEET 24 FOR COUNTY ROADWAY REPAIR REQUIREMENTS
- EXISTING FORCE MAIN SHALL BE FLUSHED PRIOR TO GROUTING AFTER THE PROPOSED FORCE MAIN HAS BEEN PLACED INTO SERVICE.

THE ELEVATIONS OF THE UTILITIES MARKED WITH AM ASTERISK (*) HAVE BEEN ASSUMED ON THE BASIS OF TYPICAL ANTICIPATED SOIL COVERAGE, CONTRACTOR SHALL NOT RELY ON THIS INFORMATION FOR CONSTRUCTION, BUT SHALL BE RESPONSIBLE FOR FIELD LOCATIONS (HORIZONTAL AND VERTICAL) OF ALL UTILITIES CROSSING THE PROPOSED FORCE MAIN. CONTRACTOR SHALL INCLUDE IN THE UNIT COST OF THE SUBJECT FORCE MAIN CONSTRUCTION, THE COST OF UTILITY ADJUSTMENTS NECESSARY TO ATTAIN DESIGN MINIMUM SEPARATION FOR UTILITIES CONFLICTING WITH THE CONSTRUCTION OF THE PROPOSED FORCE MAIN. INTERRUPTIONS OF ANY EXISTING UTILITY SERVICES SHALL BE NOTICED TO EFFECTED CUSTOMERS A MINIMUM OF 48 HOURS IN ADVANCE AND SHALL NOT EXCEED 4 HOURS IN DURATTON.

WHERE CONCRETE REPAIRS ARE NECESSARY AND EXPANSION JOINTS ARE PRESENT, CONTRACTOR TO REMOVE AND REPLACE CONCRETE UP TO THE NEXT EXPANSION JOINT; OTHERWISE, REPLACE CONCRETE AS NECESSARY.

GROUNDWATER / DEWATERING NOTE: DE WATERING NOTE:
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MOISTURE OF SOILS.



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DATE BY


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CHECKED BY WEW MANATEE COUNTY

SHEET NUMBER



148400016

DATE 9/11/2018

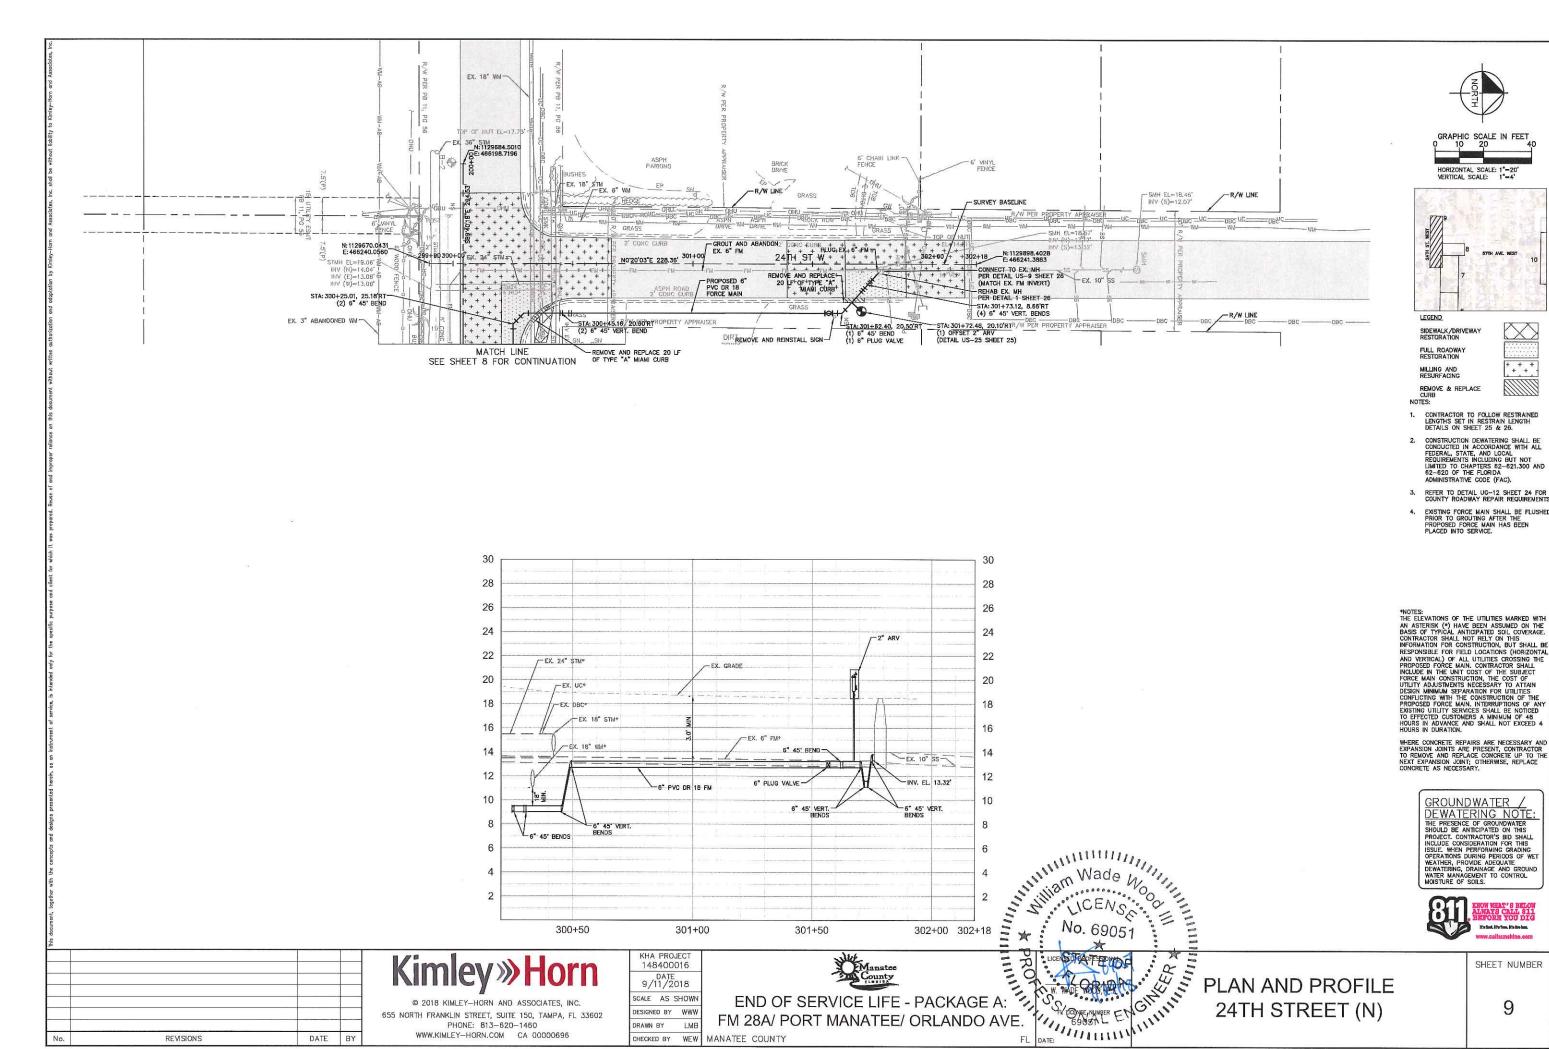SCALE AS SHOWN

DESIGNED BY WWW

CHECKED BY WEW MANATEE COUNTY

DRAWN BY

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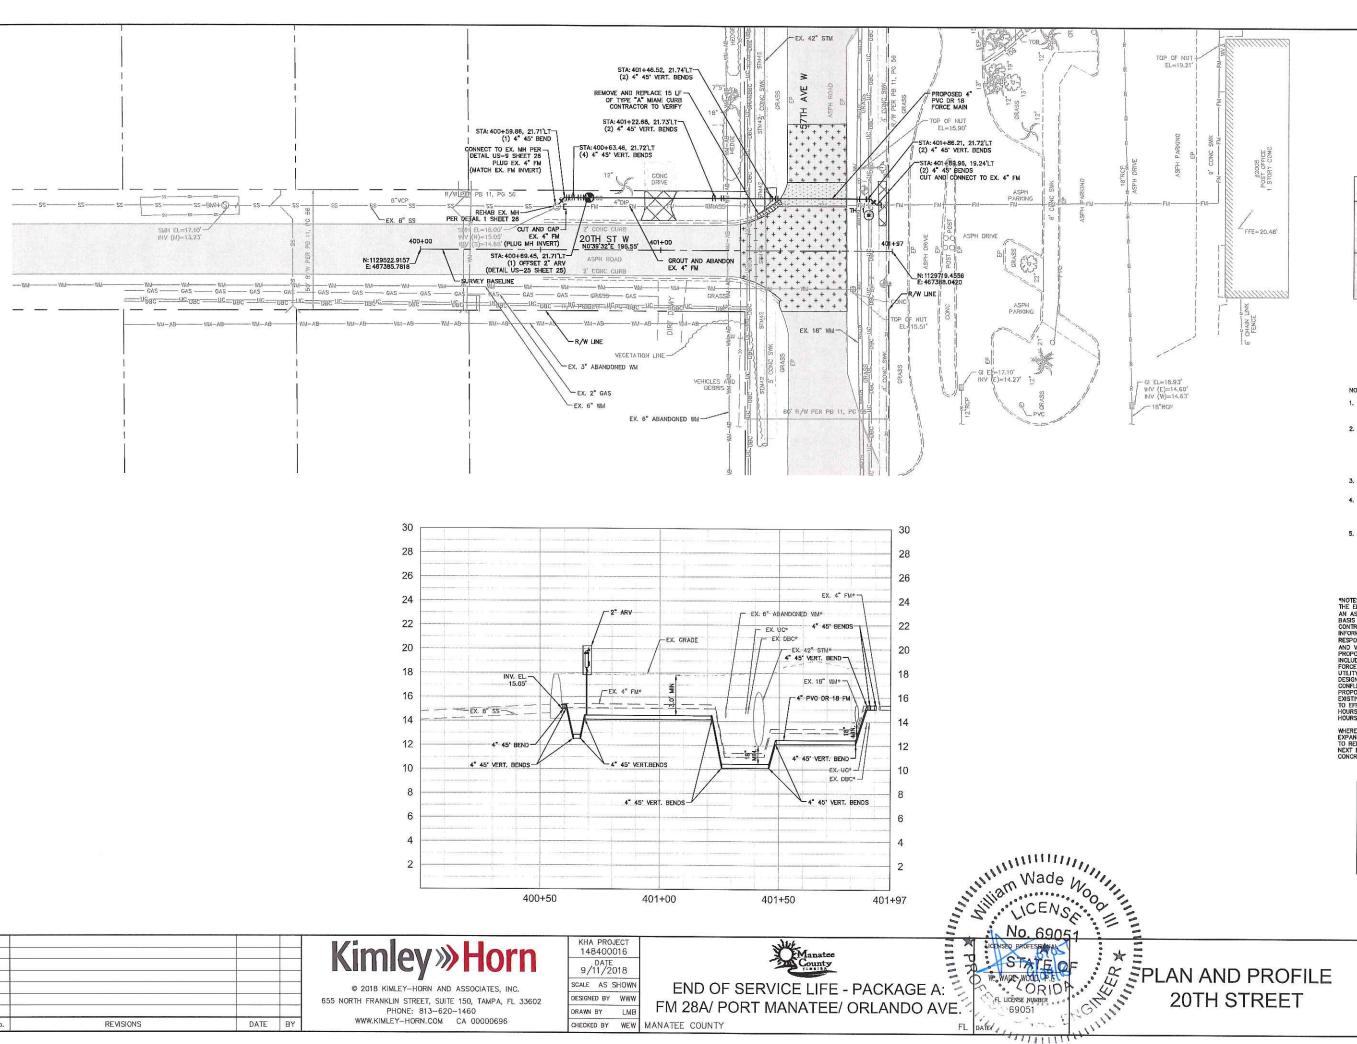
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FM 28A/ PORT MANATEE/ ORLANDO AVE.


SHEET NUMBER PLAN AND PROFILE

24TH STREET (N)



CHECKED BY WEW MANATEE COUNTY

HORIZONTAL SCALE: 1"=20" VERTICAL SCALE: 1"=4"

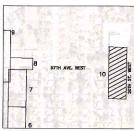

+ + +

SIDEWALK/DRIVEWAY RESTORATION

MILLING AND RESURFACING REMOVE & REPLACE CURB NOTES:

- CONSTRUCTION DEWATERING SHALL BE CONDUCTED IN ACCORDANCE WITH ALL FEDERAL, STATE, AND LOCAL REQUIREMENTS INCLUDING BUT NOT LIMITED TO CHAPTERS 82-621.300 AND 62-620 OF THE FLORING ADMINISTRATIVE CODE (FAC),
- EXISTING FORCE MAIN SHALL BE FLUSHE PRIOR TO GROUTING AFTER THE PROPOSED FORCE MAIN HAS BEEN PLACED INTO SERVICE.
- CONTRACTOR SHALL NOT WORK ON POST OFFICE PROPERTY, AS THIS IS FEDERAL PROPERTY.

*NOTES:
THE ELEVATIONS OF THE UTILITIES MARKED WITH
AN ASTERISK (*) HAVE BEEN ASSUMED ON THE
BASIS OF TYPICAL ANTICIPATED SOIL COVERAGE,
CONTRACTION SHALL NOT RELY ON THIS
INFORMATION FOR CONSTRUCTION, BUT SHALL BE
RESPONSIBLE FOR FIELD LOCATIONS (HORIZONTAL
AND VERTICAL) YOF ALL UTILITIES (ROSSING THE RESPONSIBLE FOR FIELD LOCATIONS (HORIZONTAL AND VERTICAL) OF ALL UTILITIES CROSSING THE PROPOSED FORCE MAIN. CONTRACTOR SHALL INCLUDE IN THE UNIT COST OF THE SUBJECT FORCE MAIN CONSTRUCTION, THE COST OF UTILITY ADJUSTMENTS NECESSARY TO ATTAIN DESIGN MINIMUM SEPARATION FOR UTILITIES CONFLICTING WITH THE CONSTRUCTION OF THE PROPOSED FORCE MAIN. INTERRUPTIONS OF ANY EXISTING UTILITY SERVICES SHALL BE NOTICED TO EFFECTED CUSTOMERS A MINIMUM OF 48 HOURS IN ADVANCE AND SHALL NOT EXCEED 4 HOURS IN DURATION.

WHERE CONCRETE REPAIRS ARE NECESSARY AND EXPANSION JOINTS ARE PRESENT, CONTRACTOR TO REMOVE AND REPLACE CONCRETE UP TO THE NEXT EXPANSION JOINT; OTHERWISE, REPLACE CONCRETE AS NECESSARY.

GROUNDWATER /
DEWATERING NOTE:
THE PRESENCE OF GROUNDWATER
SHOULD BE ANTICIPATED ON THIS
PROJECT. CONTRACTOR'S BID SHALL
INCLUBE CONSIDERATION FOR THIS
ISSIE WHEN DEPERPAINING GRAINING.

INCLUDE CONSIDERATION FOR THIS ISSUE. WHEN PERFORMING GRADING OPERATIONS DURING PERIODS OF WET WEATHER, PROVIDE ADEQUATE DEWATTERING, DRAINAGE AND GROUND WATER MANAGEMENT TO CONTROL MOISTURE OF SOILS.




PHONE: 813-620-1460 WWW.KIMLEY-HORN.COM CA 00000696


REVISIONS


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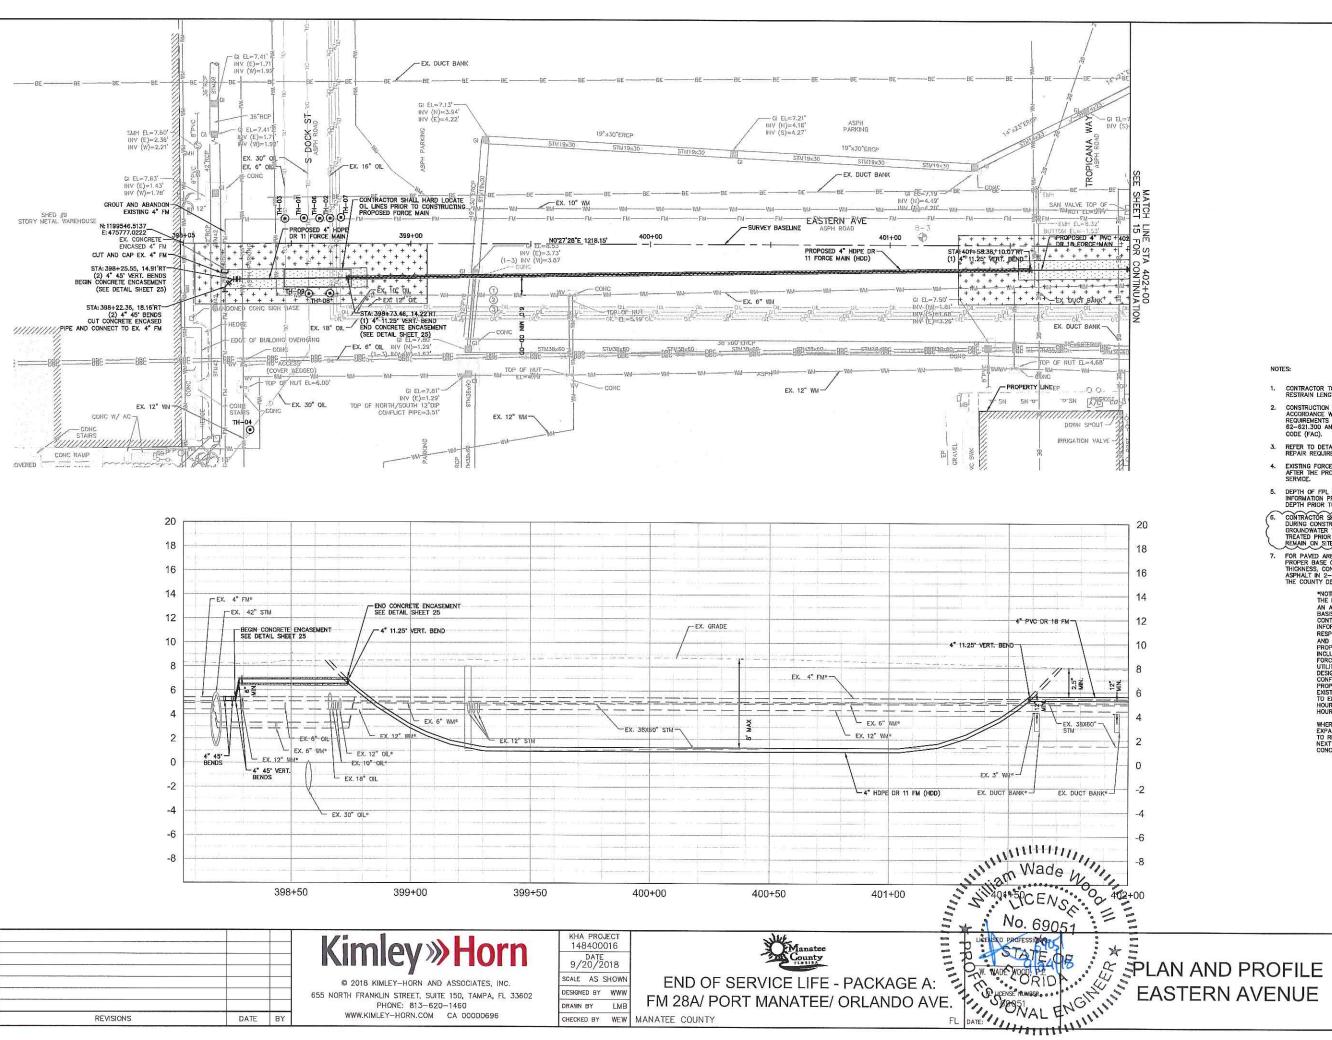
FM 28A/ PORT MANATEE/ ORLANDO AVE.

SHEET NUMBER




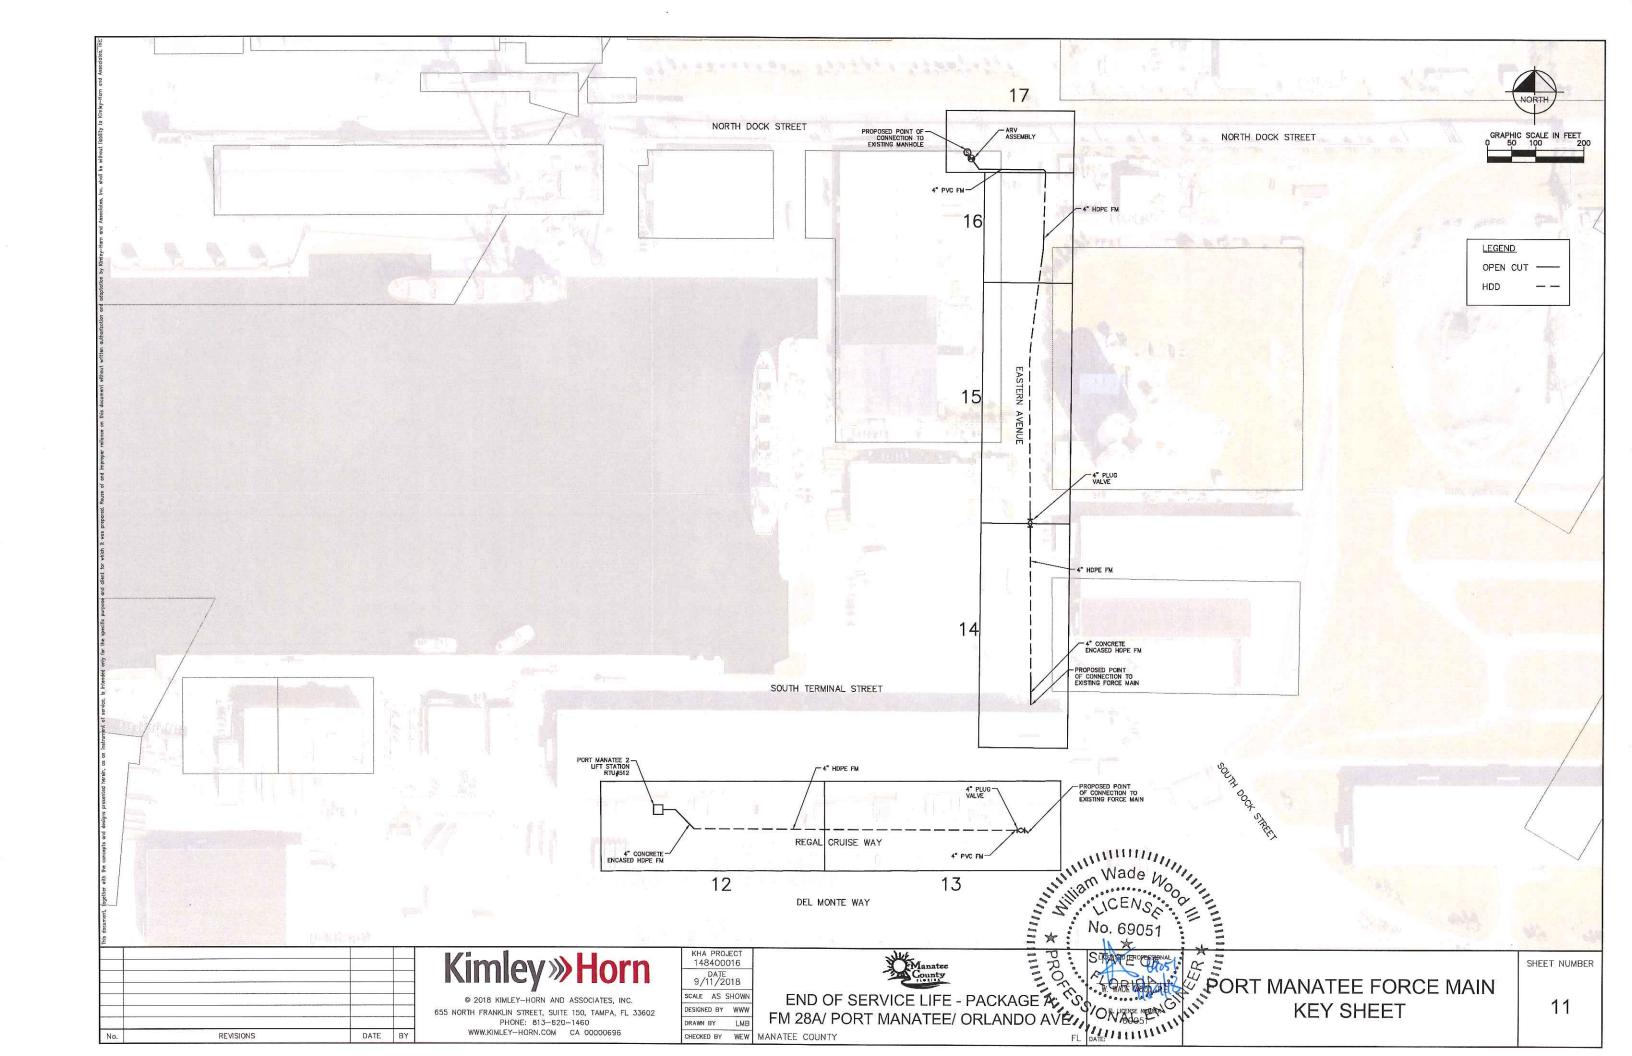

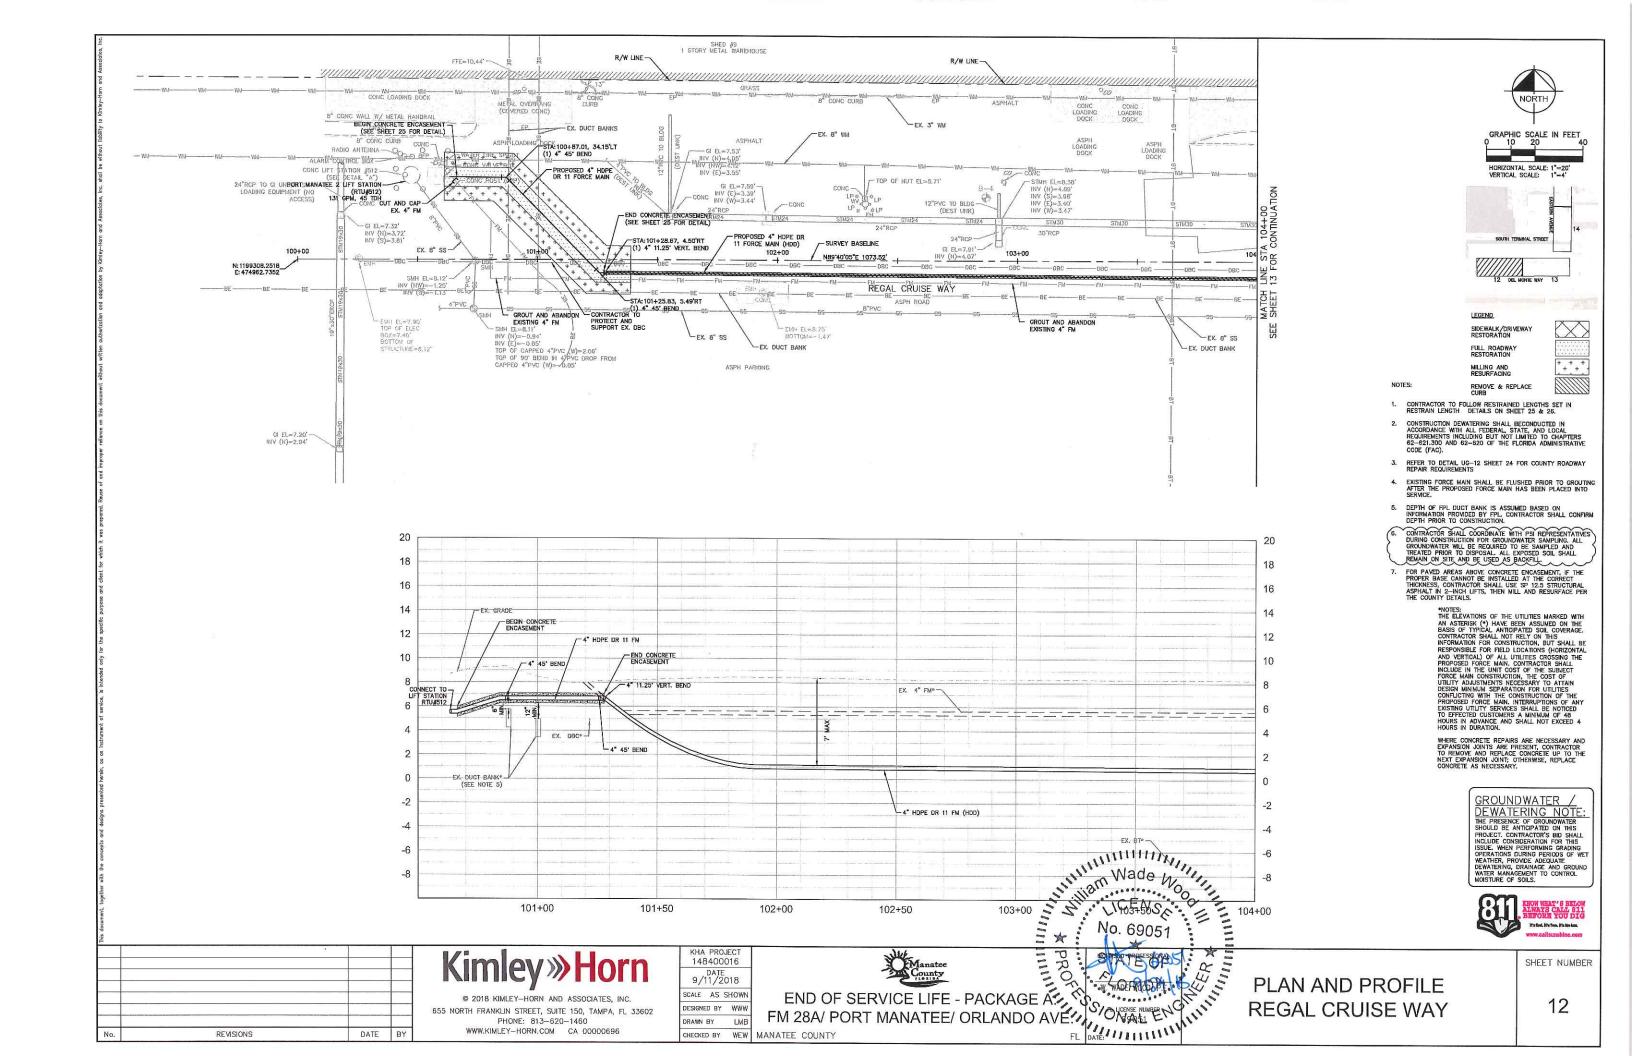

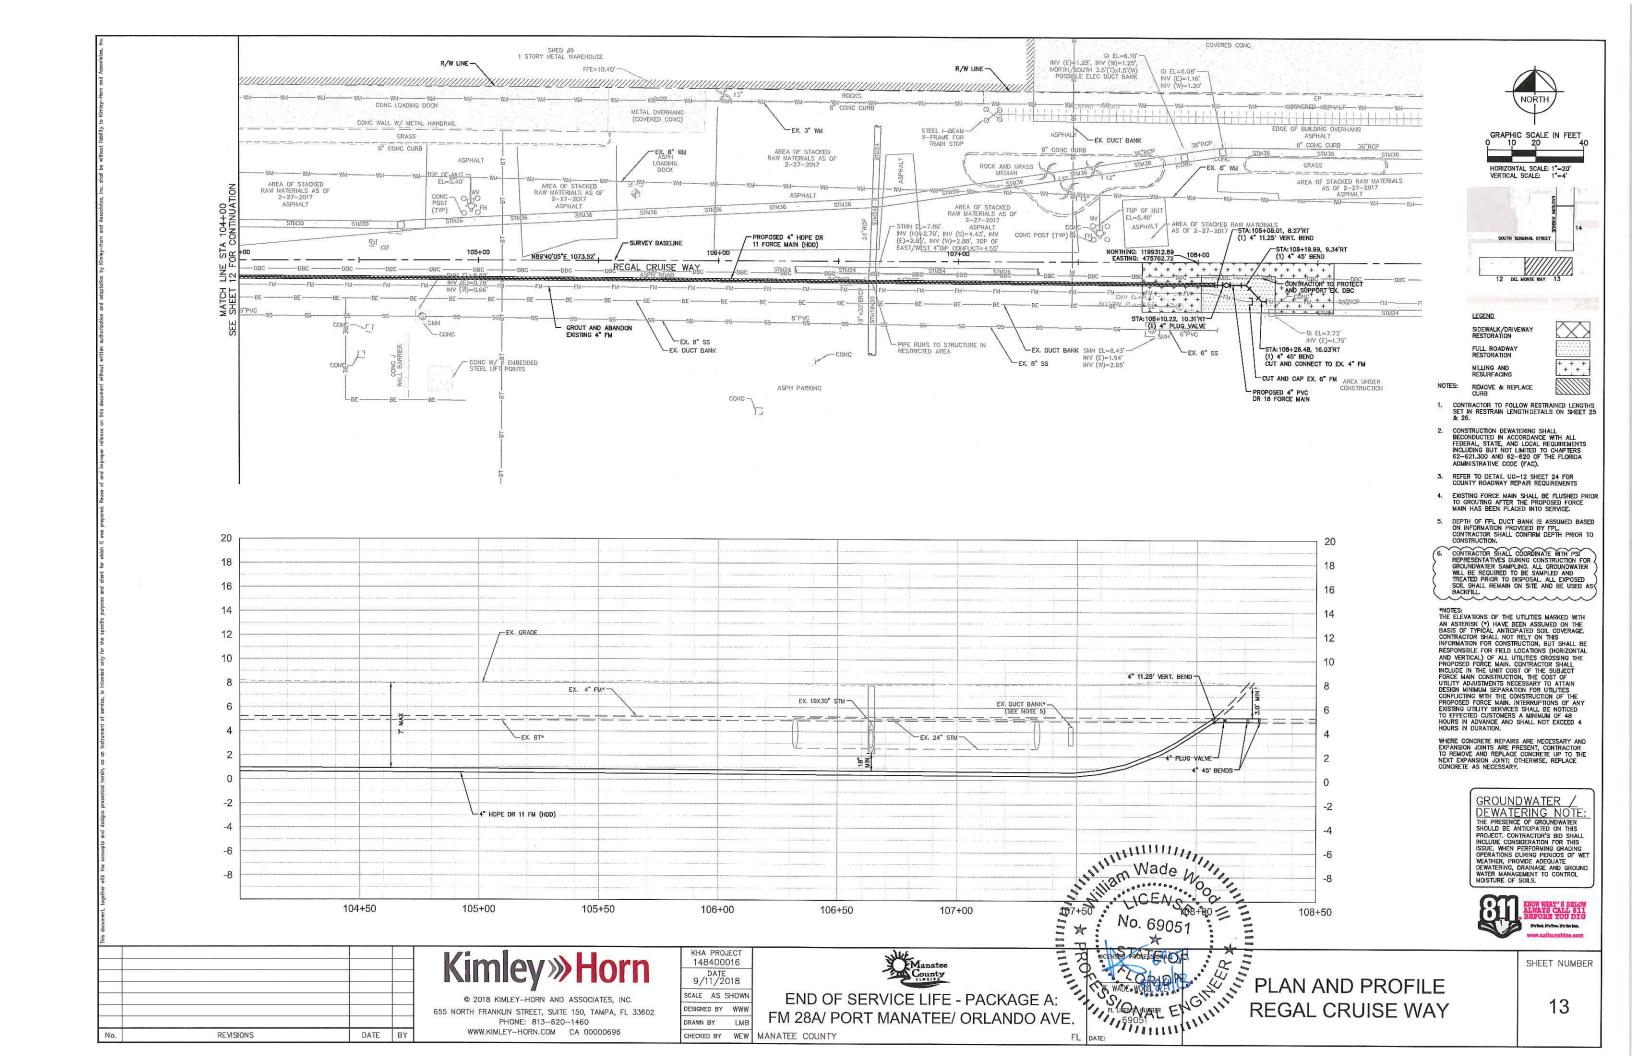

HORIZONTAL SCALE: 1"=20"

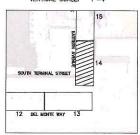

+ +

LEGEND

SIDEWALK/DRIVEWAY RESTORATION

FULL ROADWA'
RESTORATION

REMOVE & REPLACE CURB

- CONTRACTOR TO FOLLOW RESTRAINED LENGTHS SET IN RESTRAIN LENGTH DETAILS ON SHEET 25 & 26.
- CONSTRUCTION DEWATERING SHALL BECONDUCTED IN ACCORDANCE WITH ALL FEDERAL, STATE, AND LOCAL REQUIREMENTS INCLUDING BUT NOT LIMITED TO CHAPTERS 62-521,300 AND 62-620 OF THE FLORIDA ADMINISTRATIVE CODE CENT.
- REFER TO DETAIL UG-12 SHEET 24 FOR COUNTY ROADWAY REPAIR REQUIREMENTS
- DEPTH OF FPL DUCT BANK IS ASSUMED BASED ON INFORMATION PROVIDED BY FPL CONTRACTOR SHALL CONFIRM DEPTH PRIOR TO CONSTRUCTION.
- CONTRACTOR SHALL COORDINATE WITH PSI REPRESENTATIVES DURING CONSTRUCTION FOR GROUNDWATER SAMPLING. ALL GROUNDWATER WITH SEAMPLE AND TREATED PRIOR TO DISPOSAL ALL EXPOSED SOIL SHALL REMAIN ON SITE AND BE USED AS BACKFILL.
- FOR PAVED AREAS ABOVE CONCRETE ENCASEMENT, IF THE PROPER BASE CANNOT BE INSTALLED AT THE CORRECT THICKNESS, CONTRACTOR SHALL USE SP 12.5 STRUCTURAL ASPHALT IN 2-INCH LIFTS, THEN MILL AND RESURFACE PER THE COUNTY DETAILS.

INTY DETAILS.

*NOTES:

*NOTES

WHERE CONCRETE REPAIRS ARE NECESSARY AND EXPANSION JOINTS ARE PRESENT, CONTRACTOR TO REMOVE AND REPLACE CONCRETE UP TO THE NEXT EXPANSION JOINT, OTHERWISE, REPLACE CONCRETE AS NECESSARY.


GROUNDWATER


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WATER MANAGEMENT TO CONTROL
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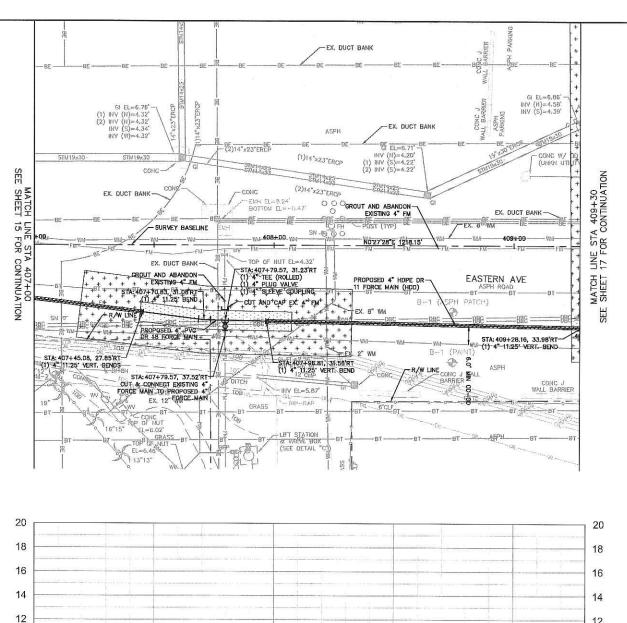



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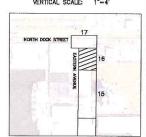






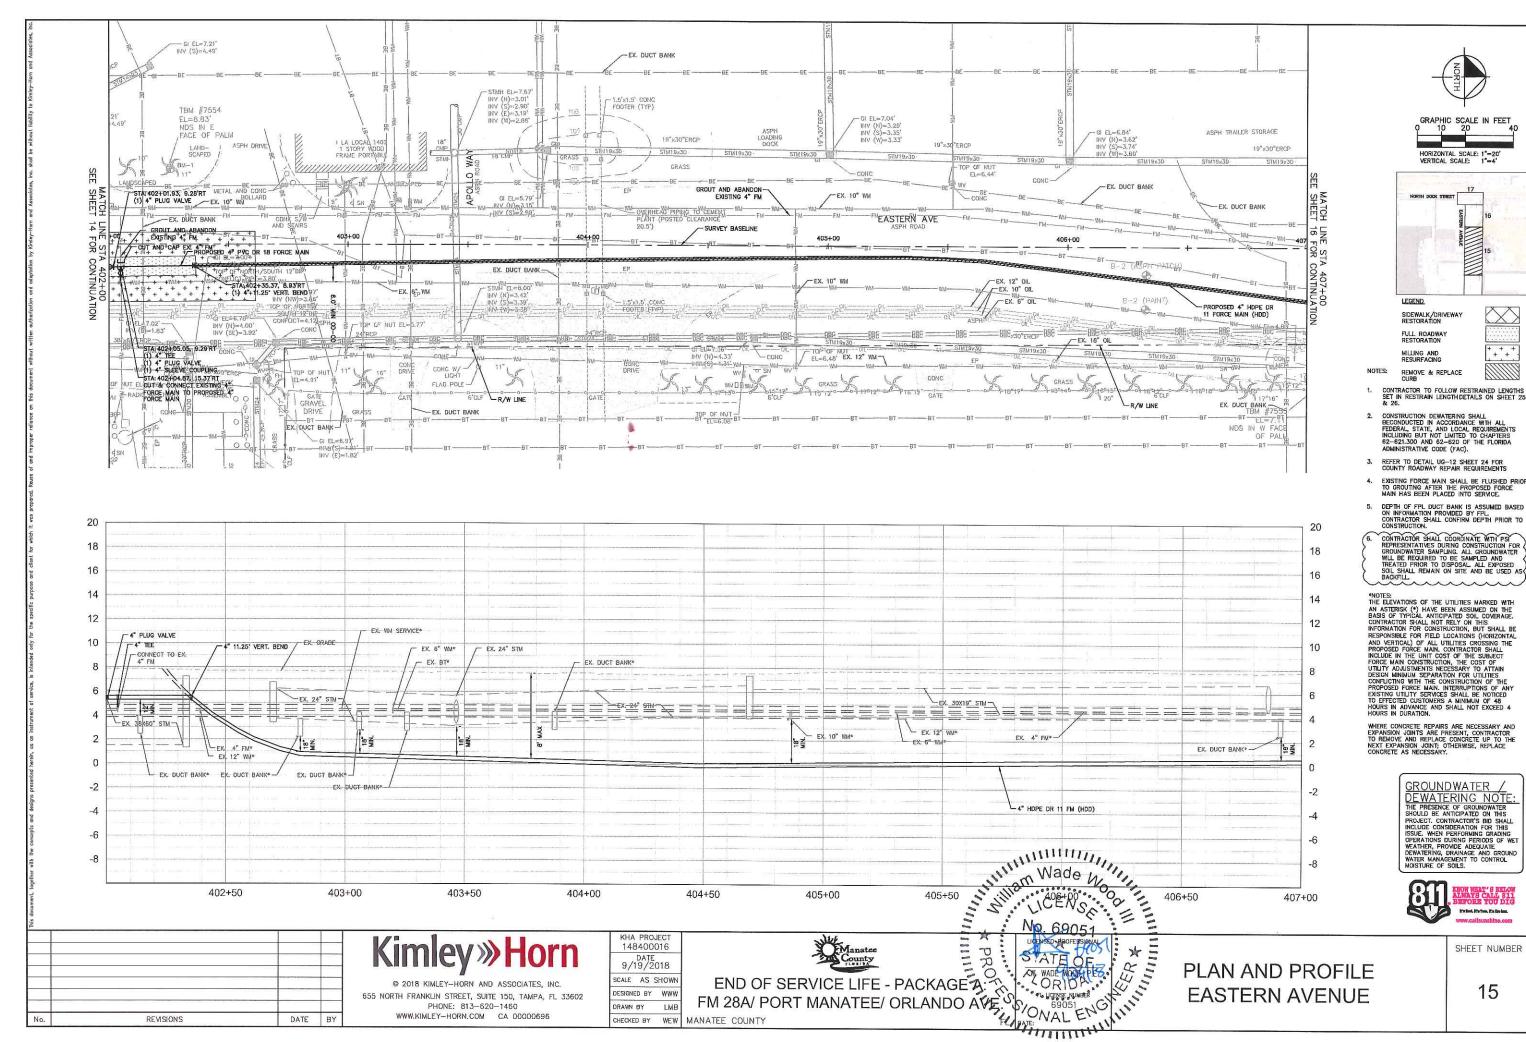

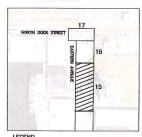

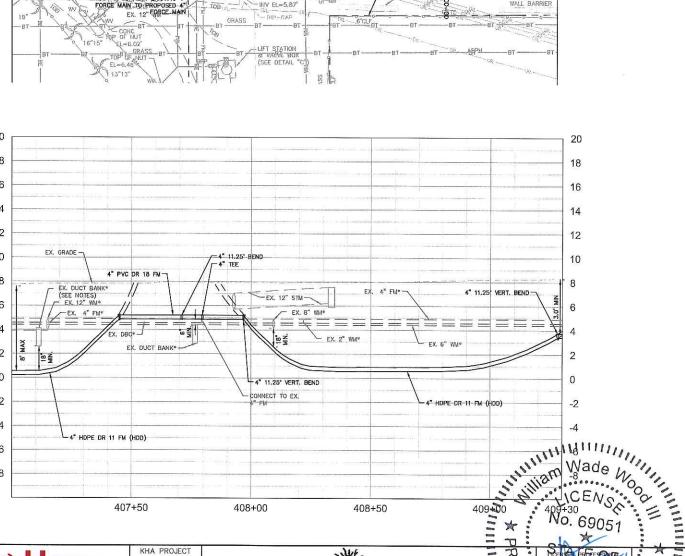

MILLING AND RESURFACING

REMOVE & REPLACE CURB

- 2. CONSTRUCTION DEWATERING SHALL BECONDUCTED IN ACCORDANCE WITH ALL FEDERAL, STATE, AND LOCAL REQUIREMENTS INCLUDING BUT NOT LIMITED TO CHAPTERS 82-82.300 AND 82-820 OF THE FLORIDA ADMINISTRATIVE CODE (FAC).

CONTRACTOR SHALL COORDINATE WITH PSI
REPRESENTATIVES DURING CONSTRUCTION FOR
REQUINIDATE SAMPLING, ALL GROUNOWATER
WILL BE REQUIRED TO BE SAMPLED AND
TREATED PRIOR TO DISPOSAL. ALL EXPOSED
SOIL SHALL REMAIN ON SITE AND BE USED AS
BACKFILL.

NOTES:
NO

WHERE CONCRETE REPAIRS ARE NECESSARY AND EXPANSION JOINTS ARE PRESENT, CONTRACTOR TO REMOVE AND REPLACE CONCRETE UP TO THE NEXT EXPANSION JOINT; OTHERWISE, REPLACE CONCRETE AS NECESSARY.

GROUNDWATER / DEWATERING NOTE: THE PRESENCE OF GROUNDWATER SHOULD BE ANTICIPATED ON THIS SHOULD BE ANTICIPATED ON THIS PROJECT. CONTRACTOR'S BIO SHALL INCLUDE CONSIDERATION FOR THIS ISSUE. WHEN PERFORMING GRADING OPERATIONS DURING PERIODS OF WET WEATHER, PROVIDE ADEQUATE DEWATERING, DRAINAGE AND GROUND WATER MANAGEMENT TO CONTROL MOISTURE OF SOILS.



655 NORTH FRANKLIN STREET, SUITE 150, TAMPA, FL 33602

KHA PROJECT 148400016 DATE 9/19/2018 SCALE AS SHOWN DESIGNED BY WWW DRAWN BY LMB

CHECKED BY WEW MANATEE COUNTY

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END OF SERVICE LIFE - PACKAGE A:

FM 28A/ PORT MANATEE/ ORLANDO AVE.


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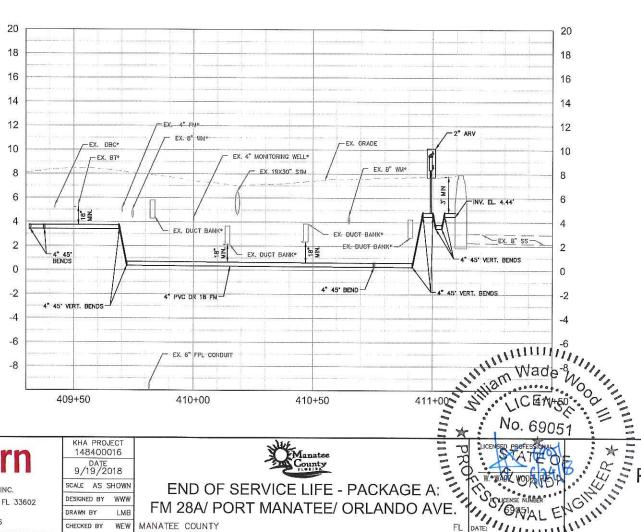
CONTRACTOR OF THE PROTESTATION OF THE PROTEST

PLAN AND PROFILE **EASTERN AVENUE**


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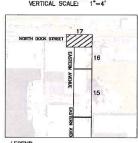


HIGH LEVELS OF HYDROGEN SULFIDE WERE DETECTED IN THIS GENERAL AREA. CONTRACTOR SHALL TAKE CAUTION WHEN EXCAVATING IN THIS AREA



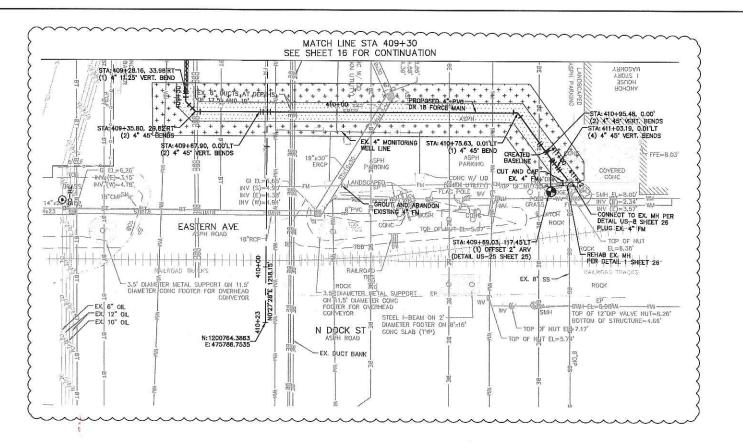



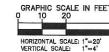

LEGEND

SIDEWALK/DRIVEWAY RESTORATION

REMOVE & REPLACE CURB CONTRACTOR TO FOLLOW RESTRAINED LENGTHS SET IN RESTRAIN LENGTH DETAILS ON SHEET 25 & 26.

+ + +

- 2. CONSTRUCTION DEWATERING SHALL BECONDUCTED IN ACCORDANCE WITH ALL FEDERAL, STATE, AND LOCAL REQUIREMENTS INCLUDING BUT NOT LIMITED TO CHAPTERS 62-621.300 AND 82-620 OF THE FLORIDA ADMINISTRATIVE CODE (FAC).
- EXISTING FORCE MAIN SHALL BE FLUSHED PRIOF TO GROUTING AFTER THE PROPOSED FORCE MAIN HAS BEEN PLACED INTO SERVICE.
- DEPTH OF FPL DUCT BANK IS ASSUMED BASED ON INFORMATION PROVIDED BY FPL CONTRACTOR SHALL CONFIRM DEPTH PRIOR TO CONSTRUCTION.

CONTRACTOR SHALL COORDINATE WITH PSI REPRESENTATIVES DURING CONSTRUCTION FOR GROUNDWATER SAMPLING. ALL ROUNDWATER MILL BER REQUIRED TO BE SLAMPLED AND TREATED PRIOR TO DISPUSAL ALL EXPOSED TOOL SHALL REMAIN ON SITE AND BE USED AS BACKFILL

*NOTES:
THE ELEVATIONS OF THE UTILITIES MARKED WITH
AM ASTERISK (*) HAVE BEEN ASSUMED ON THE
BASIS OF TYPICAL ANTIOPATED SOIL COVERAGE.
CONTRACTOR SHALL NOT RELY ON THIS
INFORMATION FOR CONSTRUCTION, BUT SHALL BE
RESPONSIBLE FOR FIELD LOCATIONS (HORIZONTAL
AND VERTICAL) OF ALL UTILITIES CROSSING THE
PROPOSED FORCE MAIN. CONTRACTOR SHALL
INCLUDE IN THE UNIT COST OF THE SUBJECT
FORCE MAIN CONSTRUCTION, THE COST OF
UTILITY ADJUSTMENTS NECESSARY TO ATTAIN
DESIGN MINIMUM SEPARATION FOR UTILITIES
CONFLICTING WITH THE CONSTRUCTION OF THE
PROPOSED FORCE MAIN. INTERRUPTIONS OF ANY
EXISTING UTILITY SEPARCES SHALL BE NOTICED
TO EFFECTED CUSTOMERS A MINIMUM OF 48
HOURS IN ADVANCE AND SHALL NOT EXCEED 4
HOURS IN DURATION.

WHERE CONCRETE REPAIRS ARE NECESSARY AND EXPANSION JOINTS ARE PRESENT, CONTRACTOR TO REMOVE AND REPLACE CONCRETE UP TO THE NEXT EXPANSION JOINT, OTHERWISE, REPLACE CONCRETE AS NECESSARY.

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DATE BY REVISIONS

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KHA PROJECT 148400016 DATE 9/19/2018 SCALE AS SHOWN DESIGNED BY WWW DRAWN BY



END OF SERVICE LIFE - PACKAGE A: FM 28A/ PORT MANATEE/ ORLANDO AVE. CHECKED BY WEW MANATEE COUNTY


PLAN AND PROFILE


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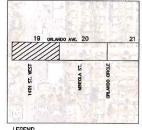
PLAN AND PROFILE


EASTERN AVENUE


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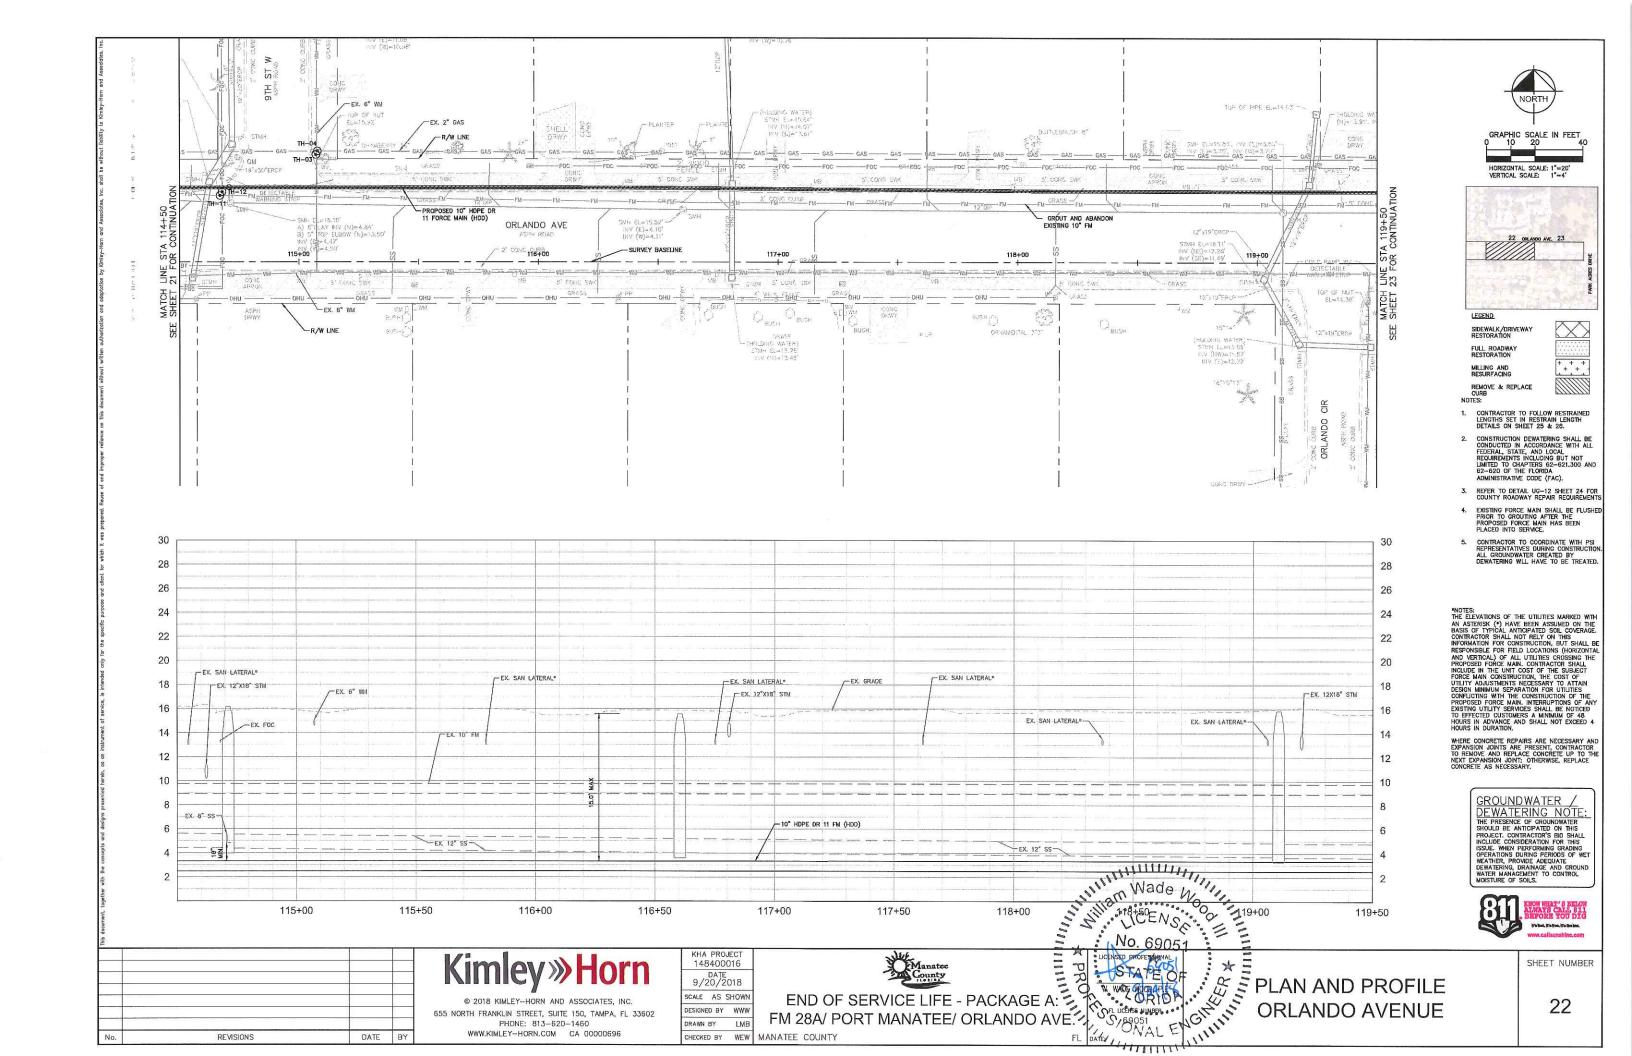





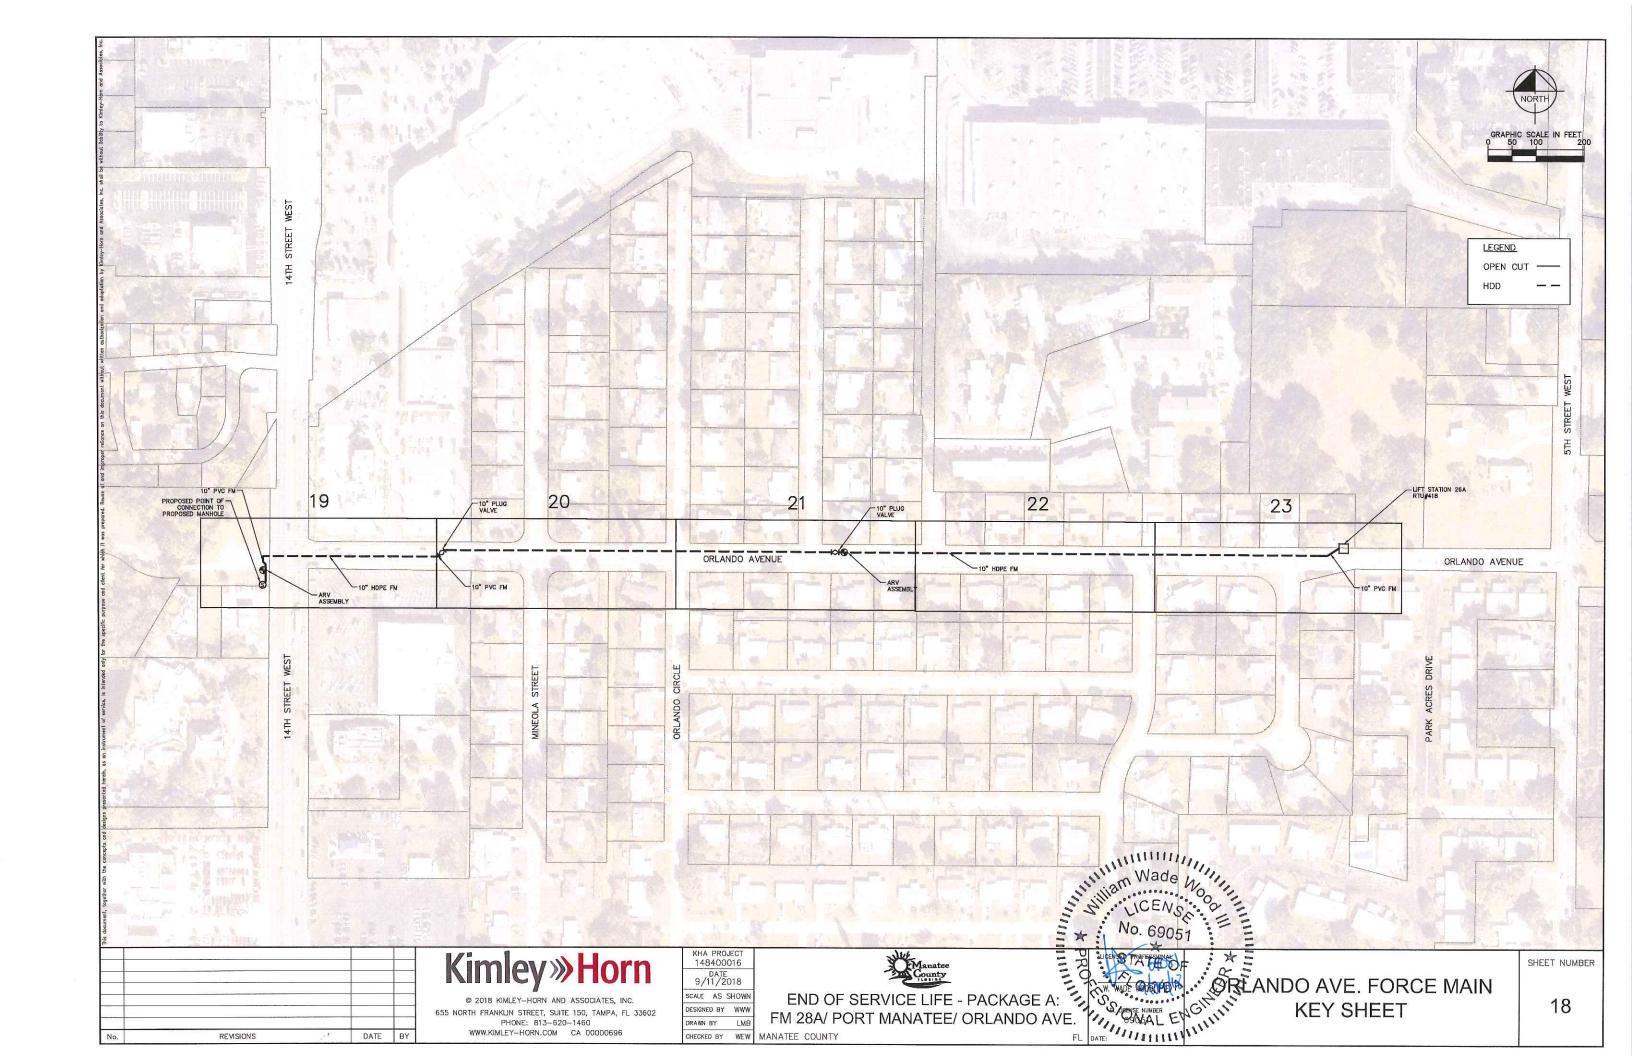


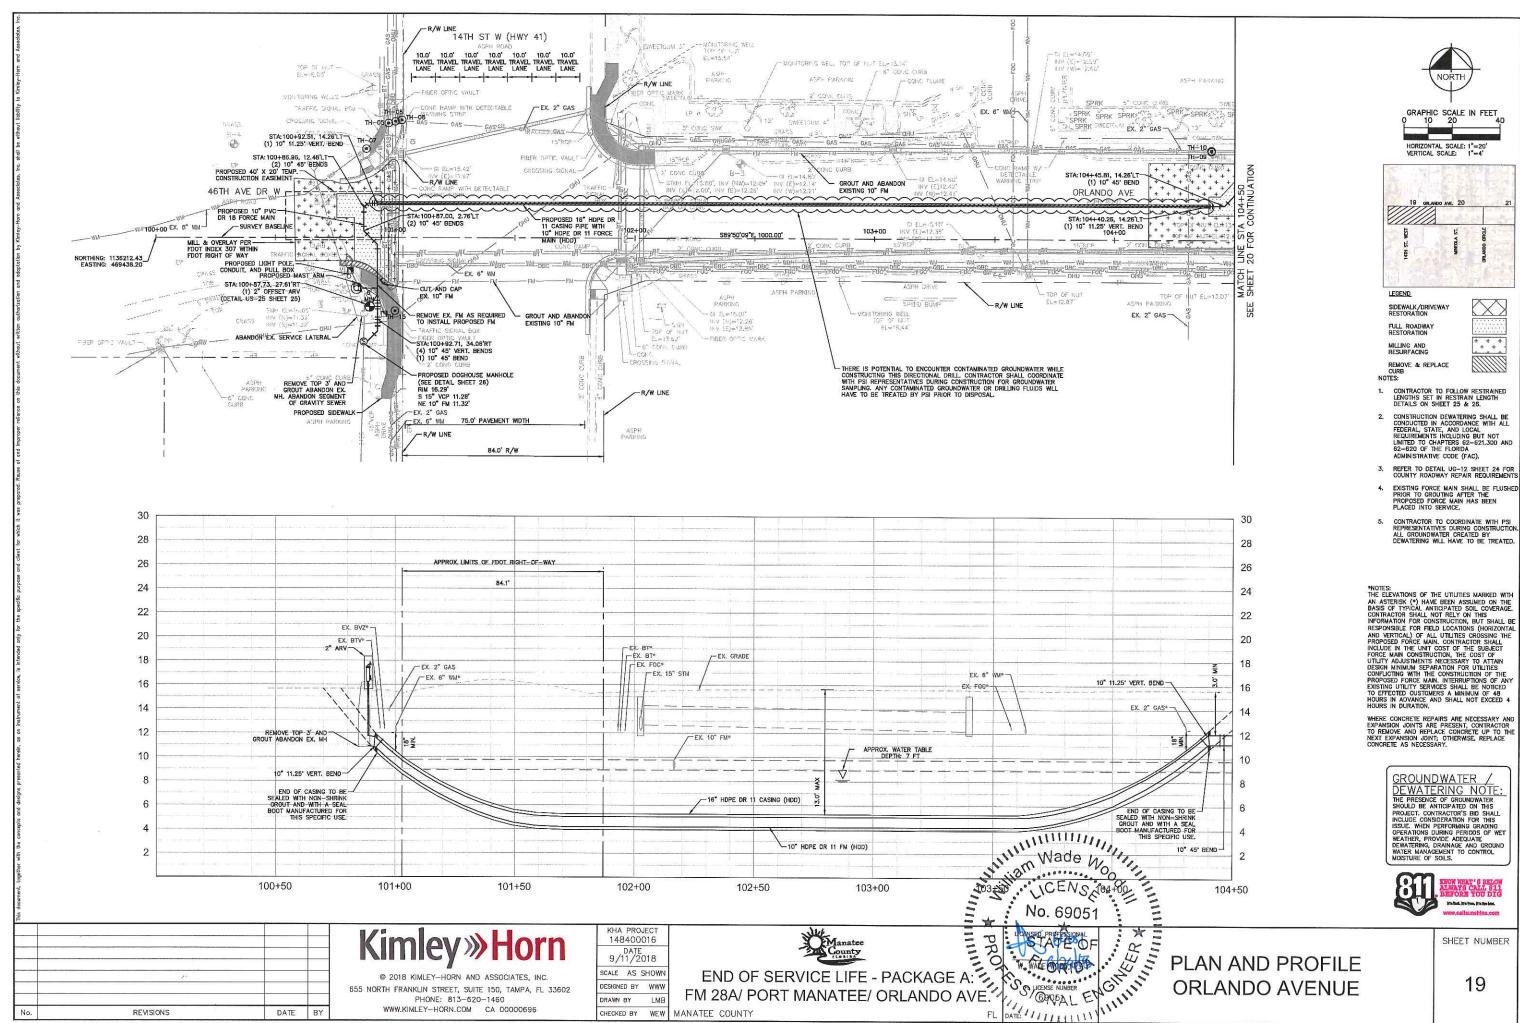

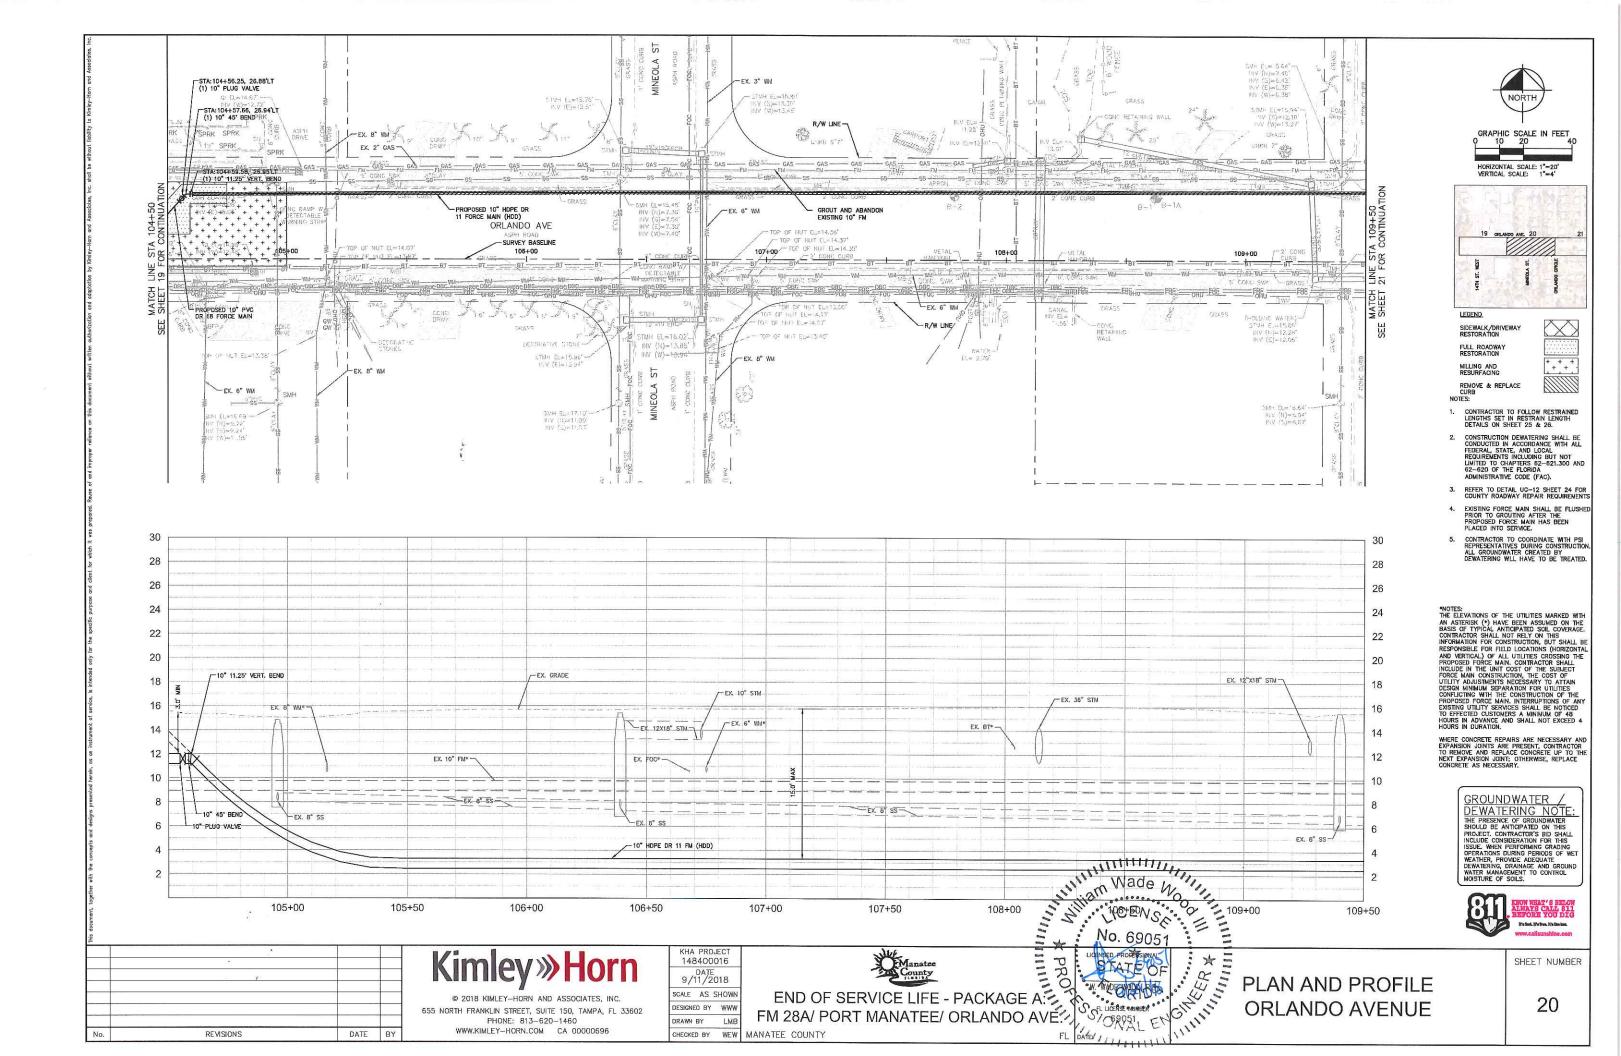

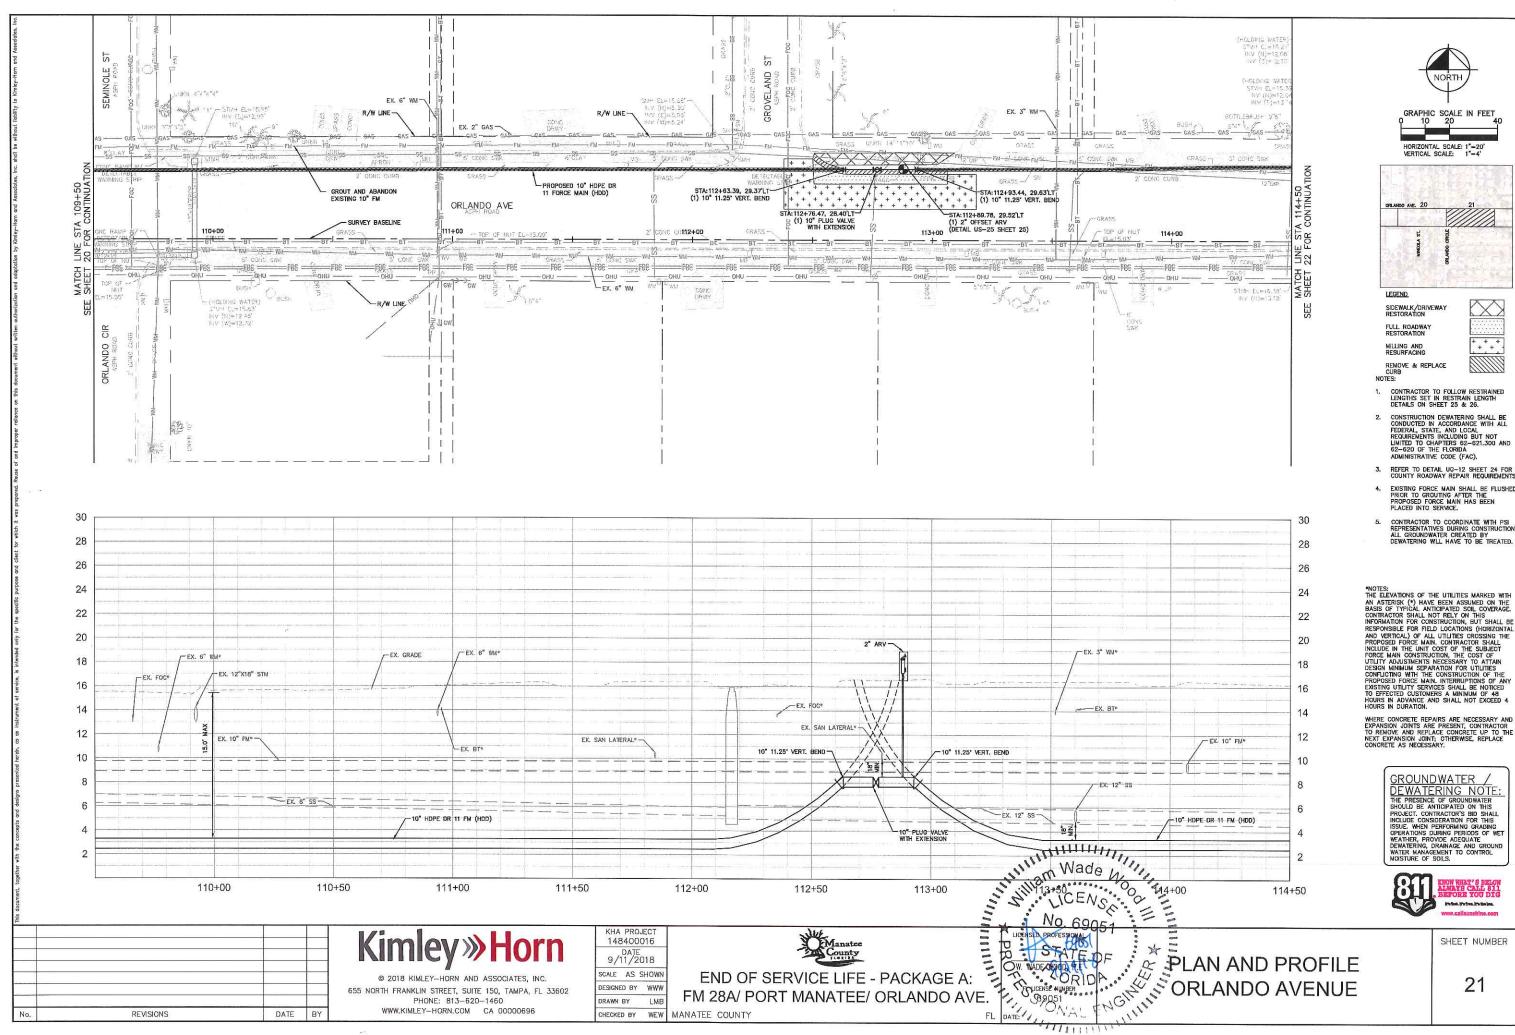


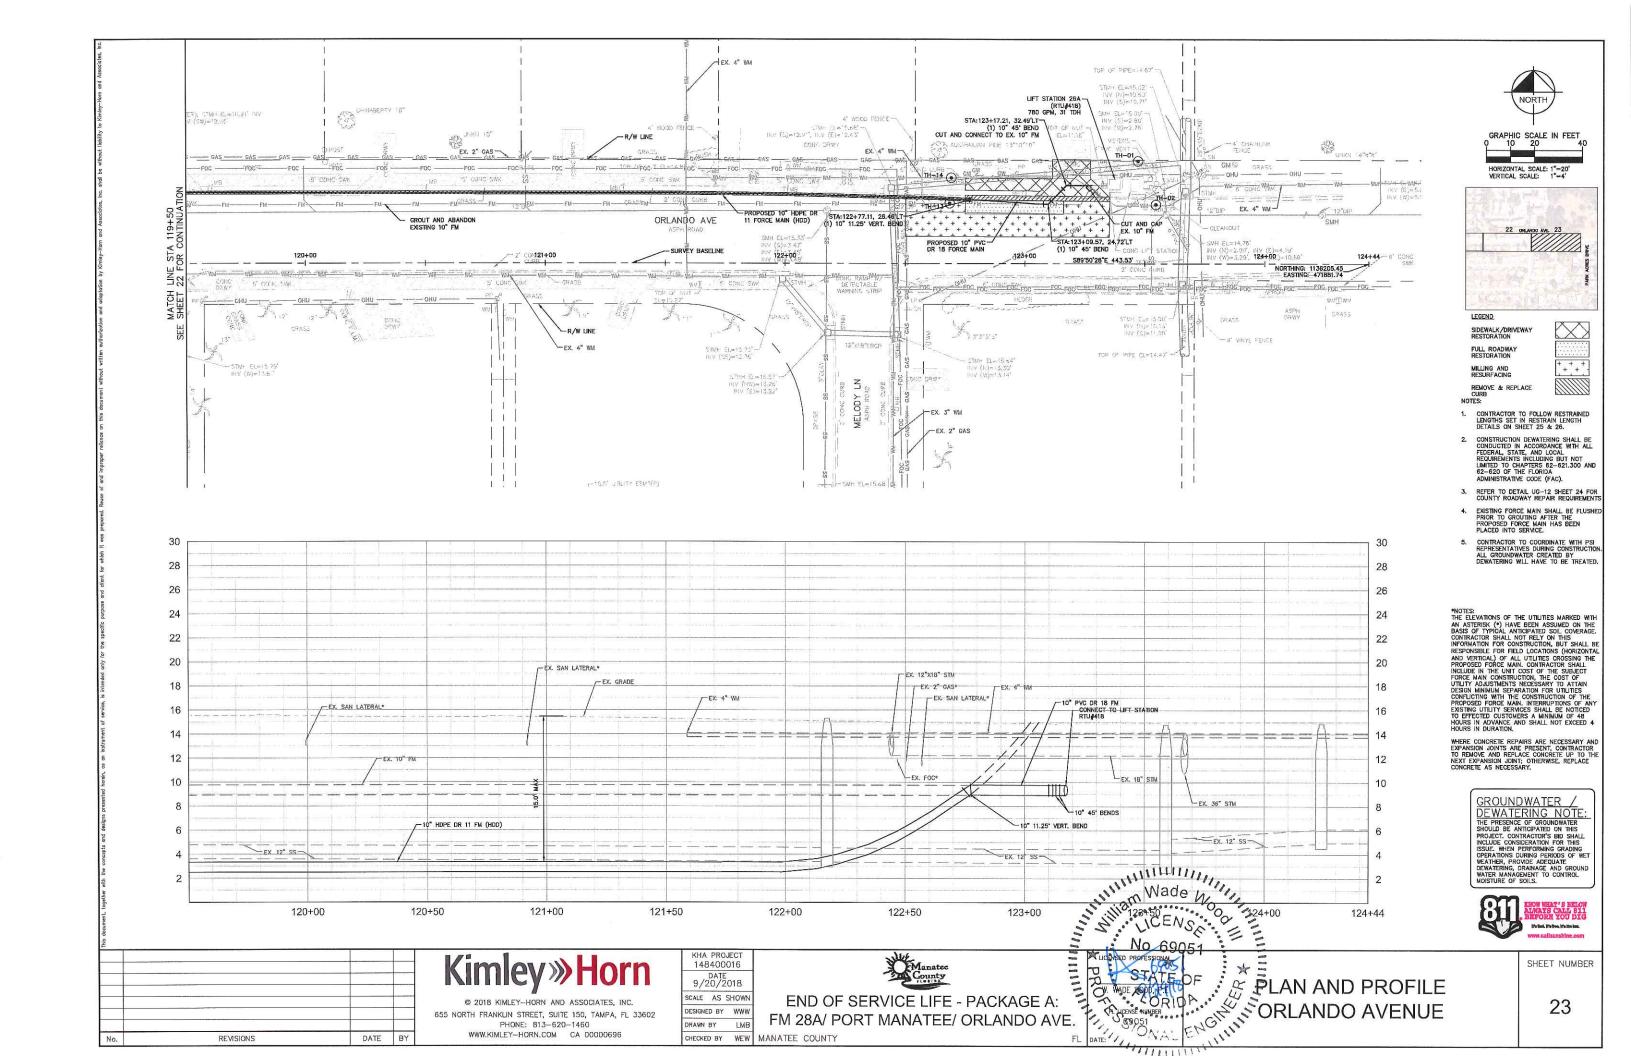

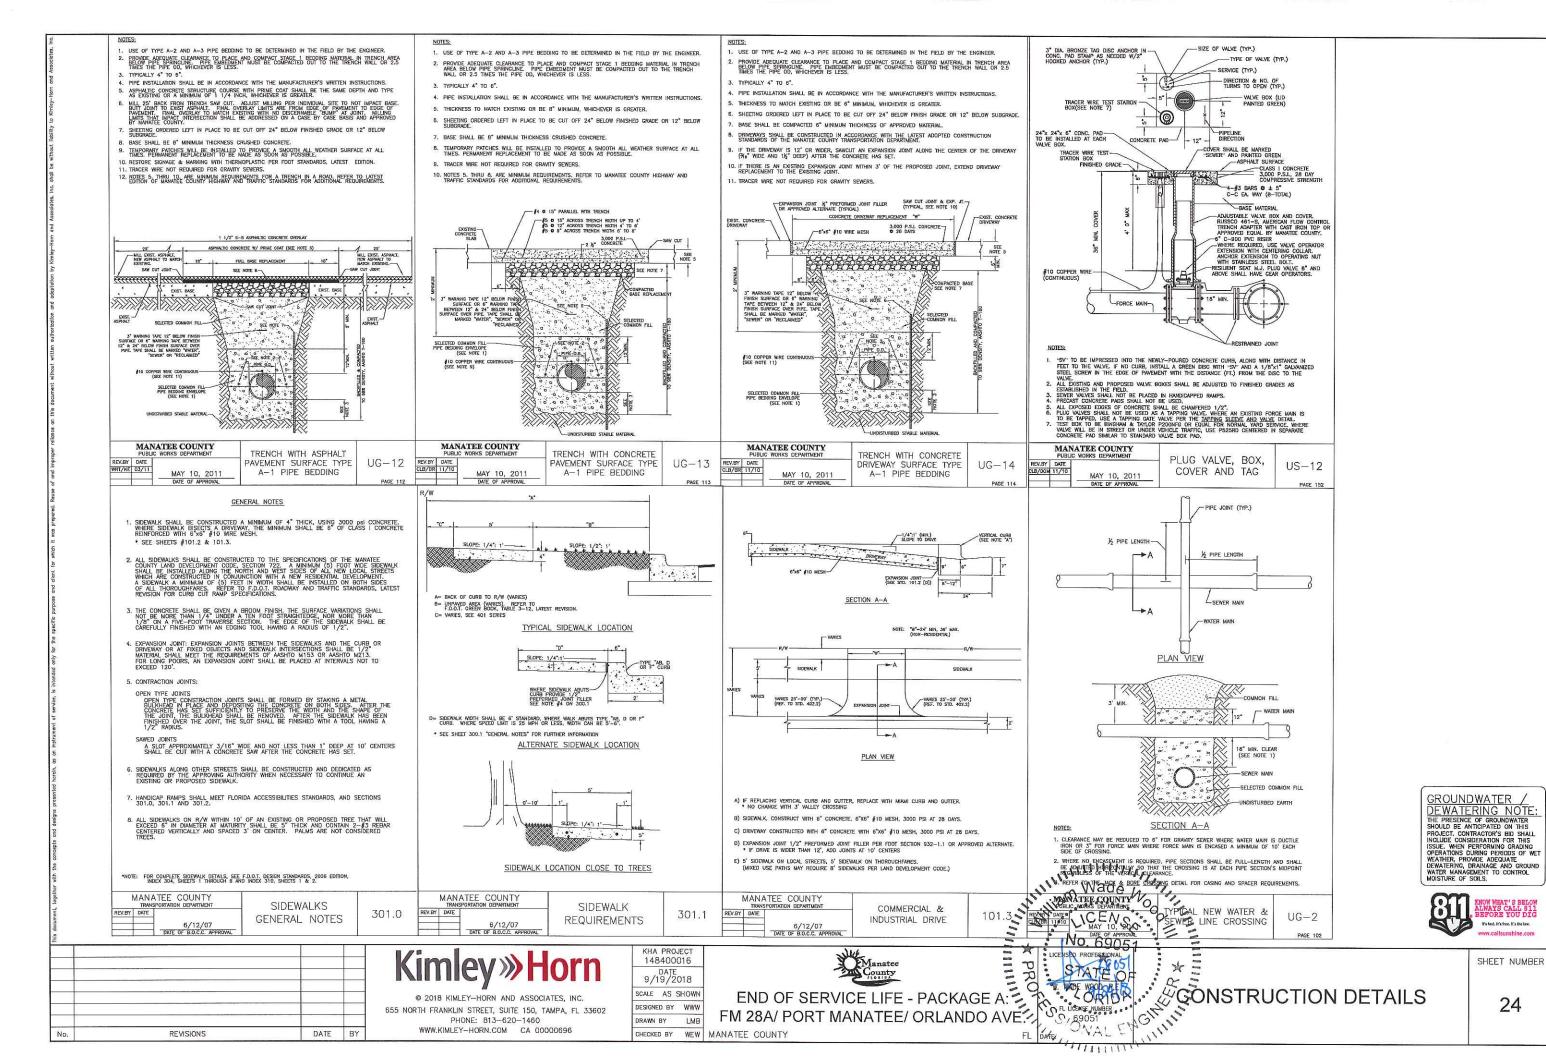

SHEET NUMBER

It's fast. It's free, It's the law.

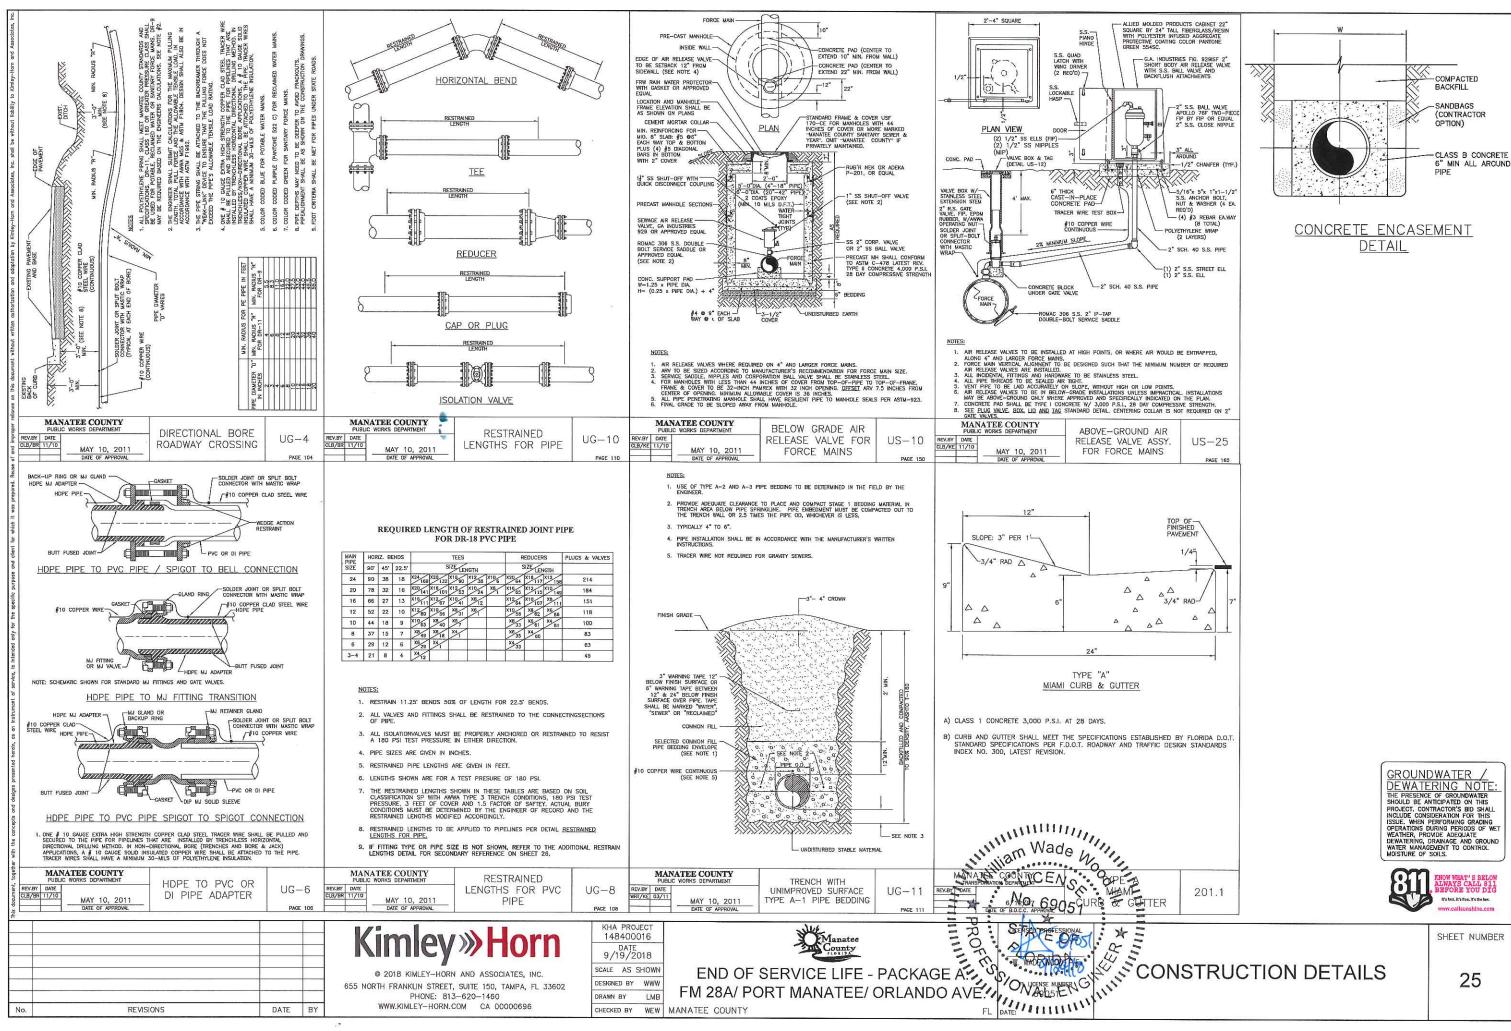


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DATE BY DRAWN BY LMB

CHECKED BY WEW MANATEE COUNTY



MANATEE COUNTY FORCE MAIN RETROFIT FOR INSIDE-DROP US-8 CONNECTION


> 36"X \$\psi\$ 325 320 312 303 291 262 245 225 181 100 -*PER DIPRA, AS THE BEND ANGLE APPROACHES 90', LATERAL MOVEMENT OF THE OUTER LEGS APPROACHES ZERO, FOR THIS CONDITION, RESTRAIN ALL PIPE BETWEEN THE FITTINGS AND RESTRAIN THE OUTER LEGS AS DEAD ENDS.
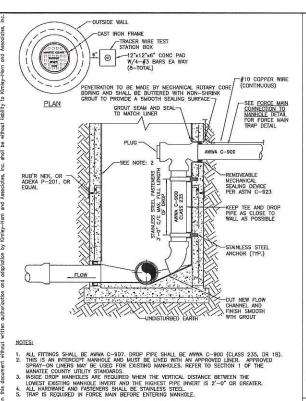
> > DATE

ADDITIONAL RESTRAIN LENGTHS DETAIL FOR PVC


REVISIONS

20"X ø 146 138 126 113 96 54 29 24"X \$\notin 173 166 157 146 132 98 77 54 -30"X \$\notin 279 272 262 251 237 201 179 155 100

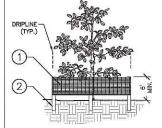

6'H "PERIMETER PLUS" CONSTRUCTION
FENCE BY CONWED PLASTICS OR OWNER'S
REPRESENTATIVE APPROVED EQUAL.
SUBMIT PRODUCT INFORMATION FOR
APPROVAL PRIOR TO INSTALLATION. (2) B' TALL METAL "1" POSTS OR 2" x 2" X 8'
PRESSURE TREATED WOOD POSTS WITH 24"
BURIAL BELOW GRADE.

INSTALLATION NOTES: ELEVATION

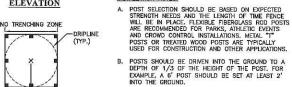

B, POSTS SHOULD BE DRIVEN INTO THE GROUND TO A DEPTH OF 1/3 OF THE HEIGHT OF THE POST, FOR EXAMPLE, A 6' POST SHOULD BE SET AT LEAST 2' INTO THE GROUND.

- C. SPACE POSTS EVERY 6' (MIN.) TO B' (MAX.).
- D. SECURE FENCING TO POST WITH NYLON CABLE TIES (AVAILABLE FROM CONWED PLASTICS), WOOD STRIPS MAY BE ALSO BE USED TO PROVIDE ADDITIONAL SUPPORT AND PROTECTION BETWEEN TIES AND POSTS.
- FOR PIPEUNE CONSTRUCTION ADJACENT TO TREES: EXAMPLE: DIVIDE 30" TRUNK DIAMETER BY 2. (30/2=15) EXCAVATION SHALL BE PROHIBITED WITHIN 15' OF THE TRUNK OR THE LIMITS OF THE DRIPLINE, WHICHEVER IS GREATER.


NOTE: IF WIRE TIES ARE USED, AVOID DIRECT CONTACT WITH FENCE. WIRE MAY DAMAGE FENCE OVER TIME.



(SEE INSTALLATION NOTE E)

誰

PLAN

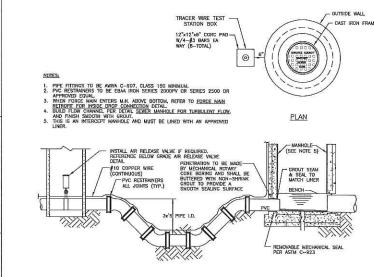

(SOURCES: EBAA IRON RESTRAINT LENGTH CALCULATION PROGRAM FOR PVC PIPE, RELEASE 7.1.2

NOTES:

1. THE DATA IN THE ABOVE TABLE ARE BASED UPON THE FOLLOWING INSTALLATION CONDITIONS:
SOIL TYPE-SP
TIRENOT TYPE-3
SAFETY FACTOR-1.5
MINIMUM PIPE LENGTH ALONG TEE RUN-5'
DEPTH OF BURY-3' VERTICAL OFFSET-3'

- DEPTH OF BURY-3' VENTICAL OFFSET-3'
 THE RESTRAINED PIPE LENGTHS APPLY TO PVC PIPE.
 ALL JOINTS BETWEEN UPPER AND LOWER BENDS SHALL BE RESTRAINED.
 RESTRAINED PIPE LENGTHS APPLY TO PIPE ON BOTH SIDES OF FITTINGS.
 CONTRACTOR TO REFER TO MANATEE COUNTY DETAIL US—B FOR PVC
 RESTRAIN LENGTHS. IF ITTING TYPE OR PIPE SIZE IS NOT SHOWN,
 REFER TO THIS DETAIL FOR SECONDARY REFERENCE.
- RESTRAINED JOINTS SHALL EXTEND ONE JOINT BEYOND MIN. LENGTH REQUIRED.

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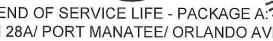


LMB

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DRAWN BY





END OF SERVICE LIFE - PACKAGE A:

FM 28A/ PORT MANATEE/ ORLANDO AVE.

MANATEE COUNTY

WAD COUNTY

WAD COUNTY

WAD COUNTY

OF DATE:

JURIS HOUSE NUMBER

OF D

DOGHOUSE MANHOLE NOTES: SEE NOTE 4 TOP EL. 16.29' SEE NOTE 4 (NE) 10" INV EL. 11.28'

DOGHOUSE MANHOLE DETAIL - ORLANDO AVE.

1. REFER TO DETAIL US-9 FOR FORCE MAIN CONNECTION

- FINISH GRADE

1/1/1/1/

-EX. MANHOLE

-REMOVE AND REPOUR BENCH (SEE FLOW CHANNEL DETAIL THIS PAGE)

No. 69051

FLOW

- 2. MANHOLE SHALL BE COATED PER COUNTY SPECIFICATION 02064.
- 3. OPENING IN PRECAST MANHOLES ARE TO BE 4" MINIMUM TO 8" MAXIMUM LARGER THAN THE OUTSIDE DIAMETER FOR THE EXISTING PIPE.
- 4. MORTAR AND BRICK TO CLOSE OPENING AROUND AND BELOW EXISTING PIPE.
- 5. CONTRACTOR SHALL PLUG AND GROUT INVERT TO BE ABANDONED.

GROUNDWATER / DEWATERING NOTE: DE WALEKTING NOTE:
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MOISTURE OF SOILS,

- SEE NOTE 4



SHEET NUMBER

26

CHANNEL FLOW DETAILS

ACES OF MANHOLI WITH RAVEN 405 SPRAYWALL, GREEN MONSTER, OF SPECTRASHIELD AS

SPECIFIED II SPECIFICATION 02064

(SEE DETAIL US-9 FOR DETAILS)

DROP MANHOLES, MANHOLES WITH OPPOSING FLOW (DETAILS D & E), MANHOLES IMMEDIATELY UPSTREAM OF A LIFT STATION WET WELL, MANHOLES WITH GRAVITY SEWERS GREATER THAN 12 INCHES IN DIAMETER, MANHOLES RECEIVING A FORCE MAIN AND THE FIRST TWO GRAVITY MANHOLES DOWNSTREAM OF MANHOLES RECEIVING A FORCE MAIN SHALL HAVE AN APPROVED LINER.

CONCRETE BENCH SHALL BE POURED BEFORE SHUTTING DOWN DEWATERING OPERATIONS TO PREVENT FLOTATION.

FLOW

MAINTAIN DESIGN SLOPE ACROSS MANHOLE UNLESS OTHERWISE INDICATED.
 DEPTH OF ALL CHANNELS TO BE 80% OF PIPE DIAMETER.
 FINISH OF ALL CHANNELS TO ALLOW SMOOTH FLOW.

6. MINIMUM ANGLE BETWEEN INLET AND OUTLET PIPING IS 90 DEGREES.

5. BRICK MAY BE USED TO BUILD UP CONCRETE BENCH

1 MANHOLE REHAB DETAIL

NOTE:

FLOW CHANNEL DETAIL: