FINAL SITE PLAN / CONSTRUCTION PLANS FOR

BLACKSTONE PARK EXPANSION

PART OF SECTION 11, TOWNSHIP 34 SOUTH, RANGE 17 EAST, CITY OF PALMETTO MANATEE COUNTY, FLORIDA

- TOTAL PROPERTY BOUNDARY AREA: 31.09± AC
- 2. TOTAL SWFWMD ERP PROJECT AREA = $9.92\pm$ AC
- BOUNDARY DATA SHOWN IS FOR INFORMATIONAL PURPOSES ONLY AND DOES NOT CONSTITUTE A

NOTES


- 4. THE PROJECT WILL CONSIST OF A PUBLIC RECREATIONAL/PARK FACILITY.
- . PRESENT ZONING IS PUBLIC (P). THE EXISTING LAND USE IS VACANT/RECREATIONAL
- PROJECT IS 100% OPEN SPACE/RECREATIONAL.
- THERE ARE NO WETLANDS OR OTHER SURFACE WATERS LOCATED WITHIN THE PROJECT AREA
- PROJECT IS LOCATED WITHIN FLOOD ZONE B AS PER LATEST FEMA FIRM. COMM. PANEL NO 120153/0187B, REVISED (EFFECTIVE 3/15/84).
- 10. DRAINAGE AND UTILITY EASEMENTS WILL BE PROVIDED AS REQUIRED BY THE CITY OF PALMETTO

- 13. THE STORMWATER MANAGEMENT SYSTEM FOR THIS DEVELOPMENT WILL BE MAINTAINED BY MANATEI
- 15. TOPOGRAPHY IS COMPILED FROM FIELD INFORMATION OBTAINED BY ZOLLER, NAJJAR, & SHROYER, L.C. ALL
- PROPOSED ADDITIONAL GROSS FLOOR AREA RATIO 2,030 S.F./1,354,193 S.F. = 0.001
- 17. ALL COMMON IMPROVEMENTS AND OPEN SPACE WITHIN THE SITE WILL BE MAINTAINED BY MANATEE
- 18. THE STORMWATER MANAGEMENT SYSTEM HAS BEEN DESIGNED IN ACCORDANCE WITH CHAPTER 62-343 F.A.C. REQUIREMENTS.
- MAXIMUM SEATING CAPACITY OF BLEACHERS = 50 SEATS (ESTIMATED) TOTAL NUMBER OF BLEACHERS MAXIMUM SEATING CAPACITY PROPOSED PARKING SPACES REQUIRED
 - - = 6 (2 BLEACHERS PER BALL FIELD)
 - = 1 PARKING SPACE PER 3 SEATS FOR PUBLIC ASSEMBLY = 100 PARKING SPACES REQUIRED
- = 150 PARKING SPACES (INCLUDES 6 HANDICAP SPACES)
- 20. ALL SEDIMENT AND EROSION CONTROL DEVICES SHALL BE IN PLACE PRIOR TO CONSTRUCTION ACTIVITIES. 21. ALL EXISTING FEATURES ARE LABELED AS EXISTING ON THE SITE PLAN SHEETS. ALL OTHER FEATURES NOT
- 22. ALL PROPOSED SETBACKS AND BUFFERS ARE SHOWN ON THE SITE PLAN.
- 23. ALL TRAFFIC CONTROL SIGNAGE AND PAVEMENT MARKINGS, SHALL CONFORM TO FDOT AND MUTCD
- 24. SOLID WASTE WILL BE STORED IN A DUMPSTER ENCLOSURE ON-SITE AND COLLECTED BY THE CITY OF


A PROJECT BY

MANATEE BOARD OF COUNTY COMMISSIONERS

1112 MANATEE AVENUE, SUITE 803 BRADENTON, FLORIDA 34205 PHONE: (941) 748-4501

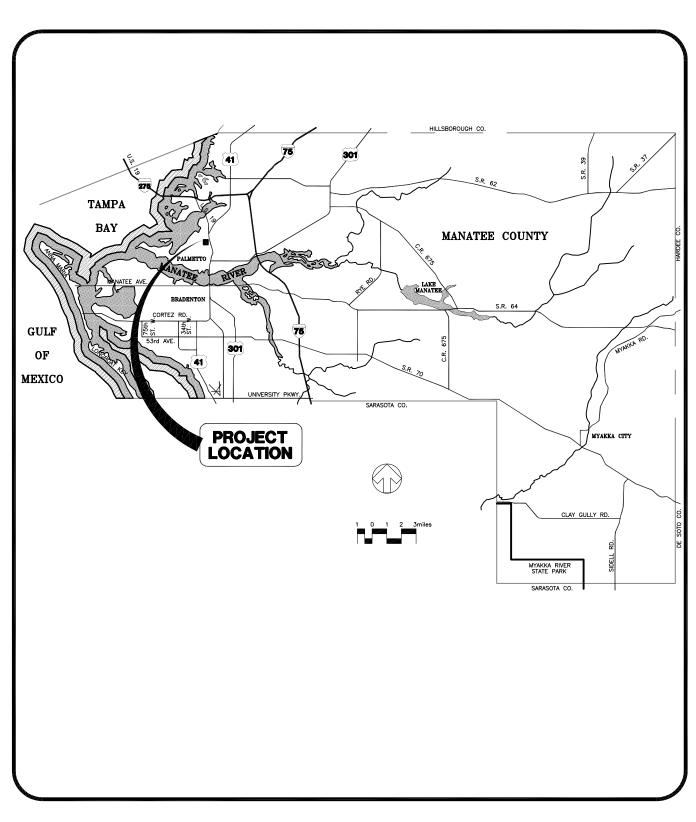

LOCATION MAP

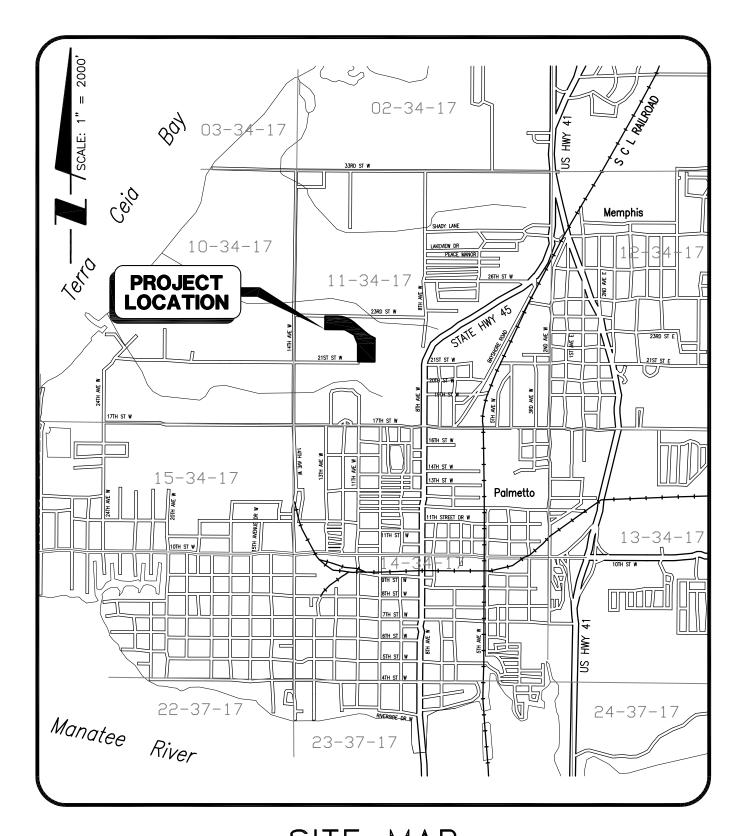

SITE MAP

BEFORE YOU DIG! CALL SUNSHINE STATE ONE CALL OF FLORIDA



6900 Professional Parkway East, Sarasota, FL 34240 *Phone* 941-907-6900 • *Fax* 941-907-6910 Certificate of Authorization #43 • FL Lic. # LC-C000170 • www.stantec.com


INDEX TO SHEETS


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////	COVER SHE	ΞT					
/2//	AERIAL LOCATION MAP						
//3//	MASTER SITE PLAN AND KEY SHEET						
4/	SITE PLAN	– NOR	TH				
//5//	SITE PLAN	– SOU	TH				
//6//	PAVING AND	DRAIN	IAGE PLAN – NORTH				
	PAVING AND	DRAIN	IAGE PLAN - SOUTH				
//8//	DRY RETENT	TON AF	REA PLAN				
//9//	TYPICAL SEC	CTIONS	AND CONSTRUCTION DETAIL	.S			
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17	BALL FIELD	FENCIN	NG, NETTING, AND BATTING	CAGE	DETAILS		
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1 OF 1	CONCRETE /	AND PA	VER SURFACING PLAN AND	DETA	AILS		
LP-401	LANDSCAPE	MATER	IALS / SURFACES PLAN				
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DRO	DRC Member OK Signature Date					9	
Dep	Deputy Director of Operations						
(City Planner						
· ·	Fire Marshall						
(City Engineer						
DR	DRC Coordinator						
	Stipulations		Yes				
			No				


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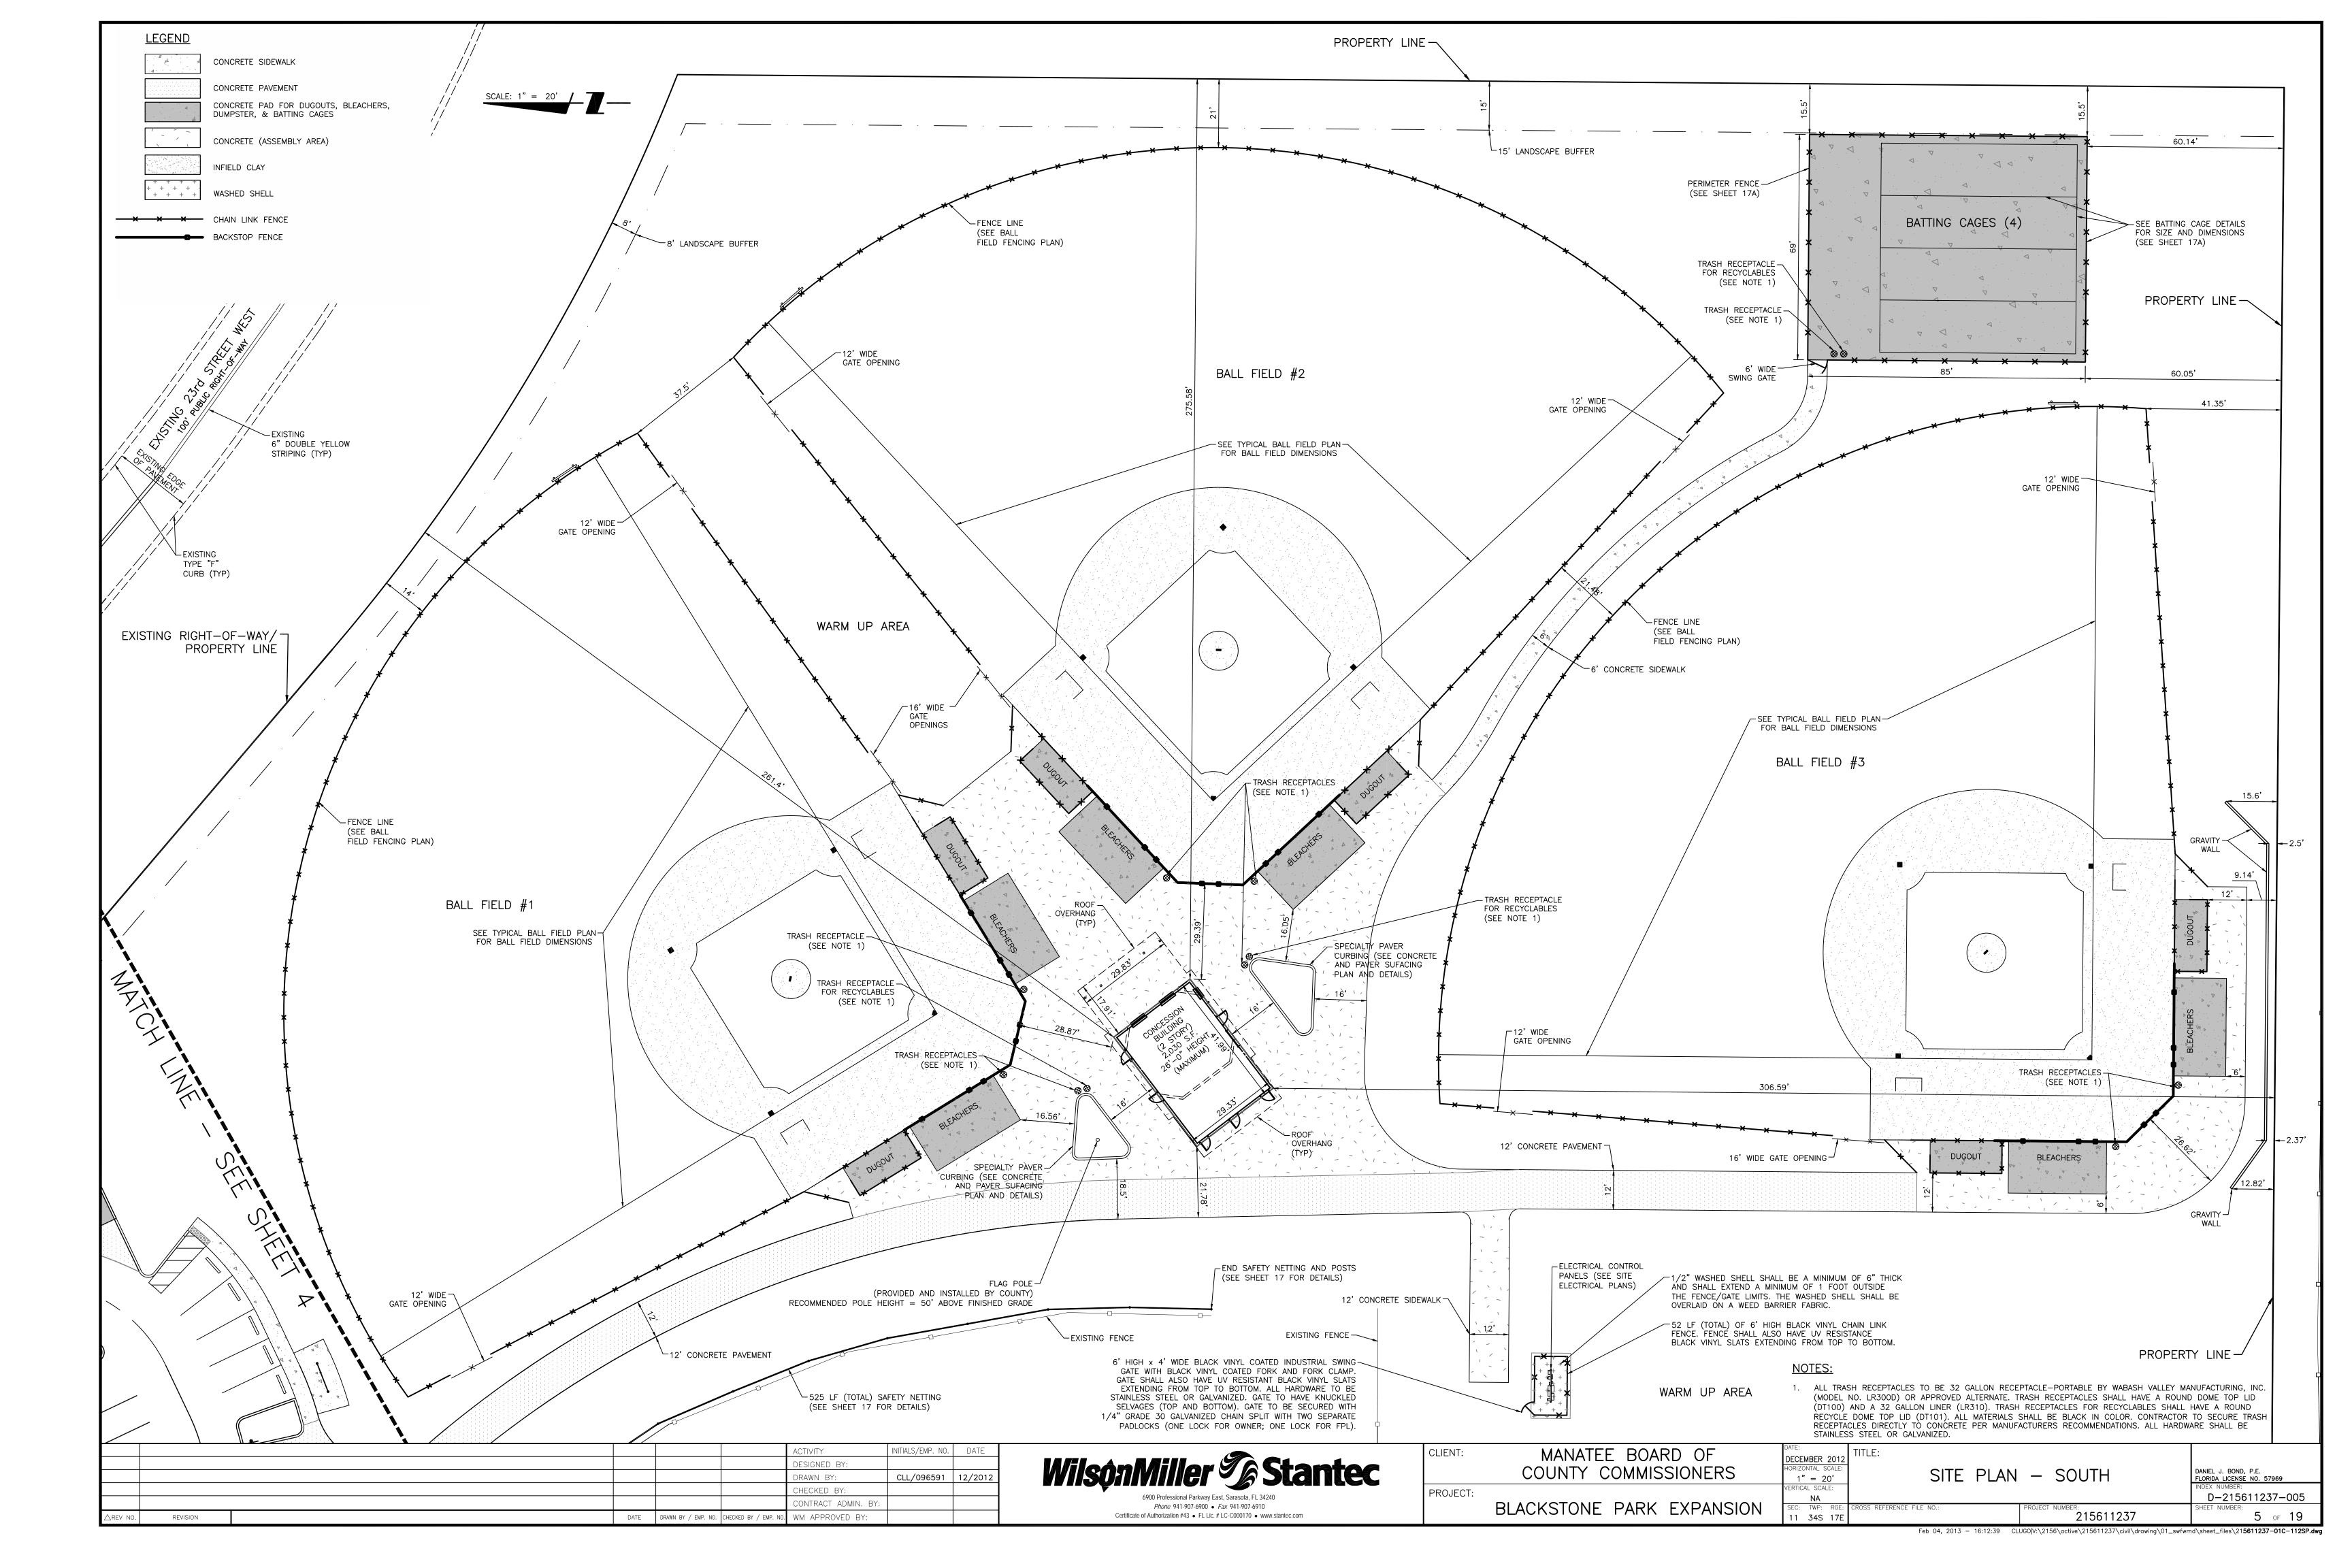
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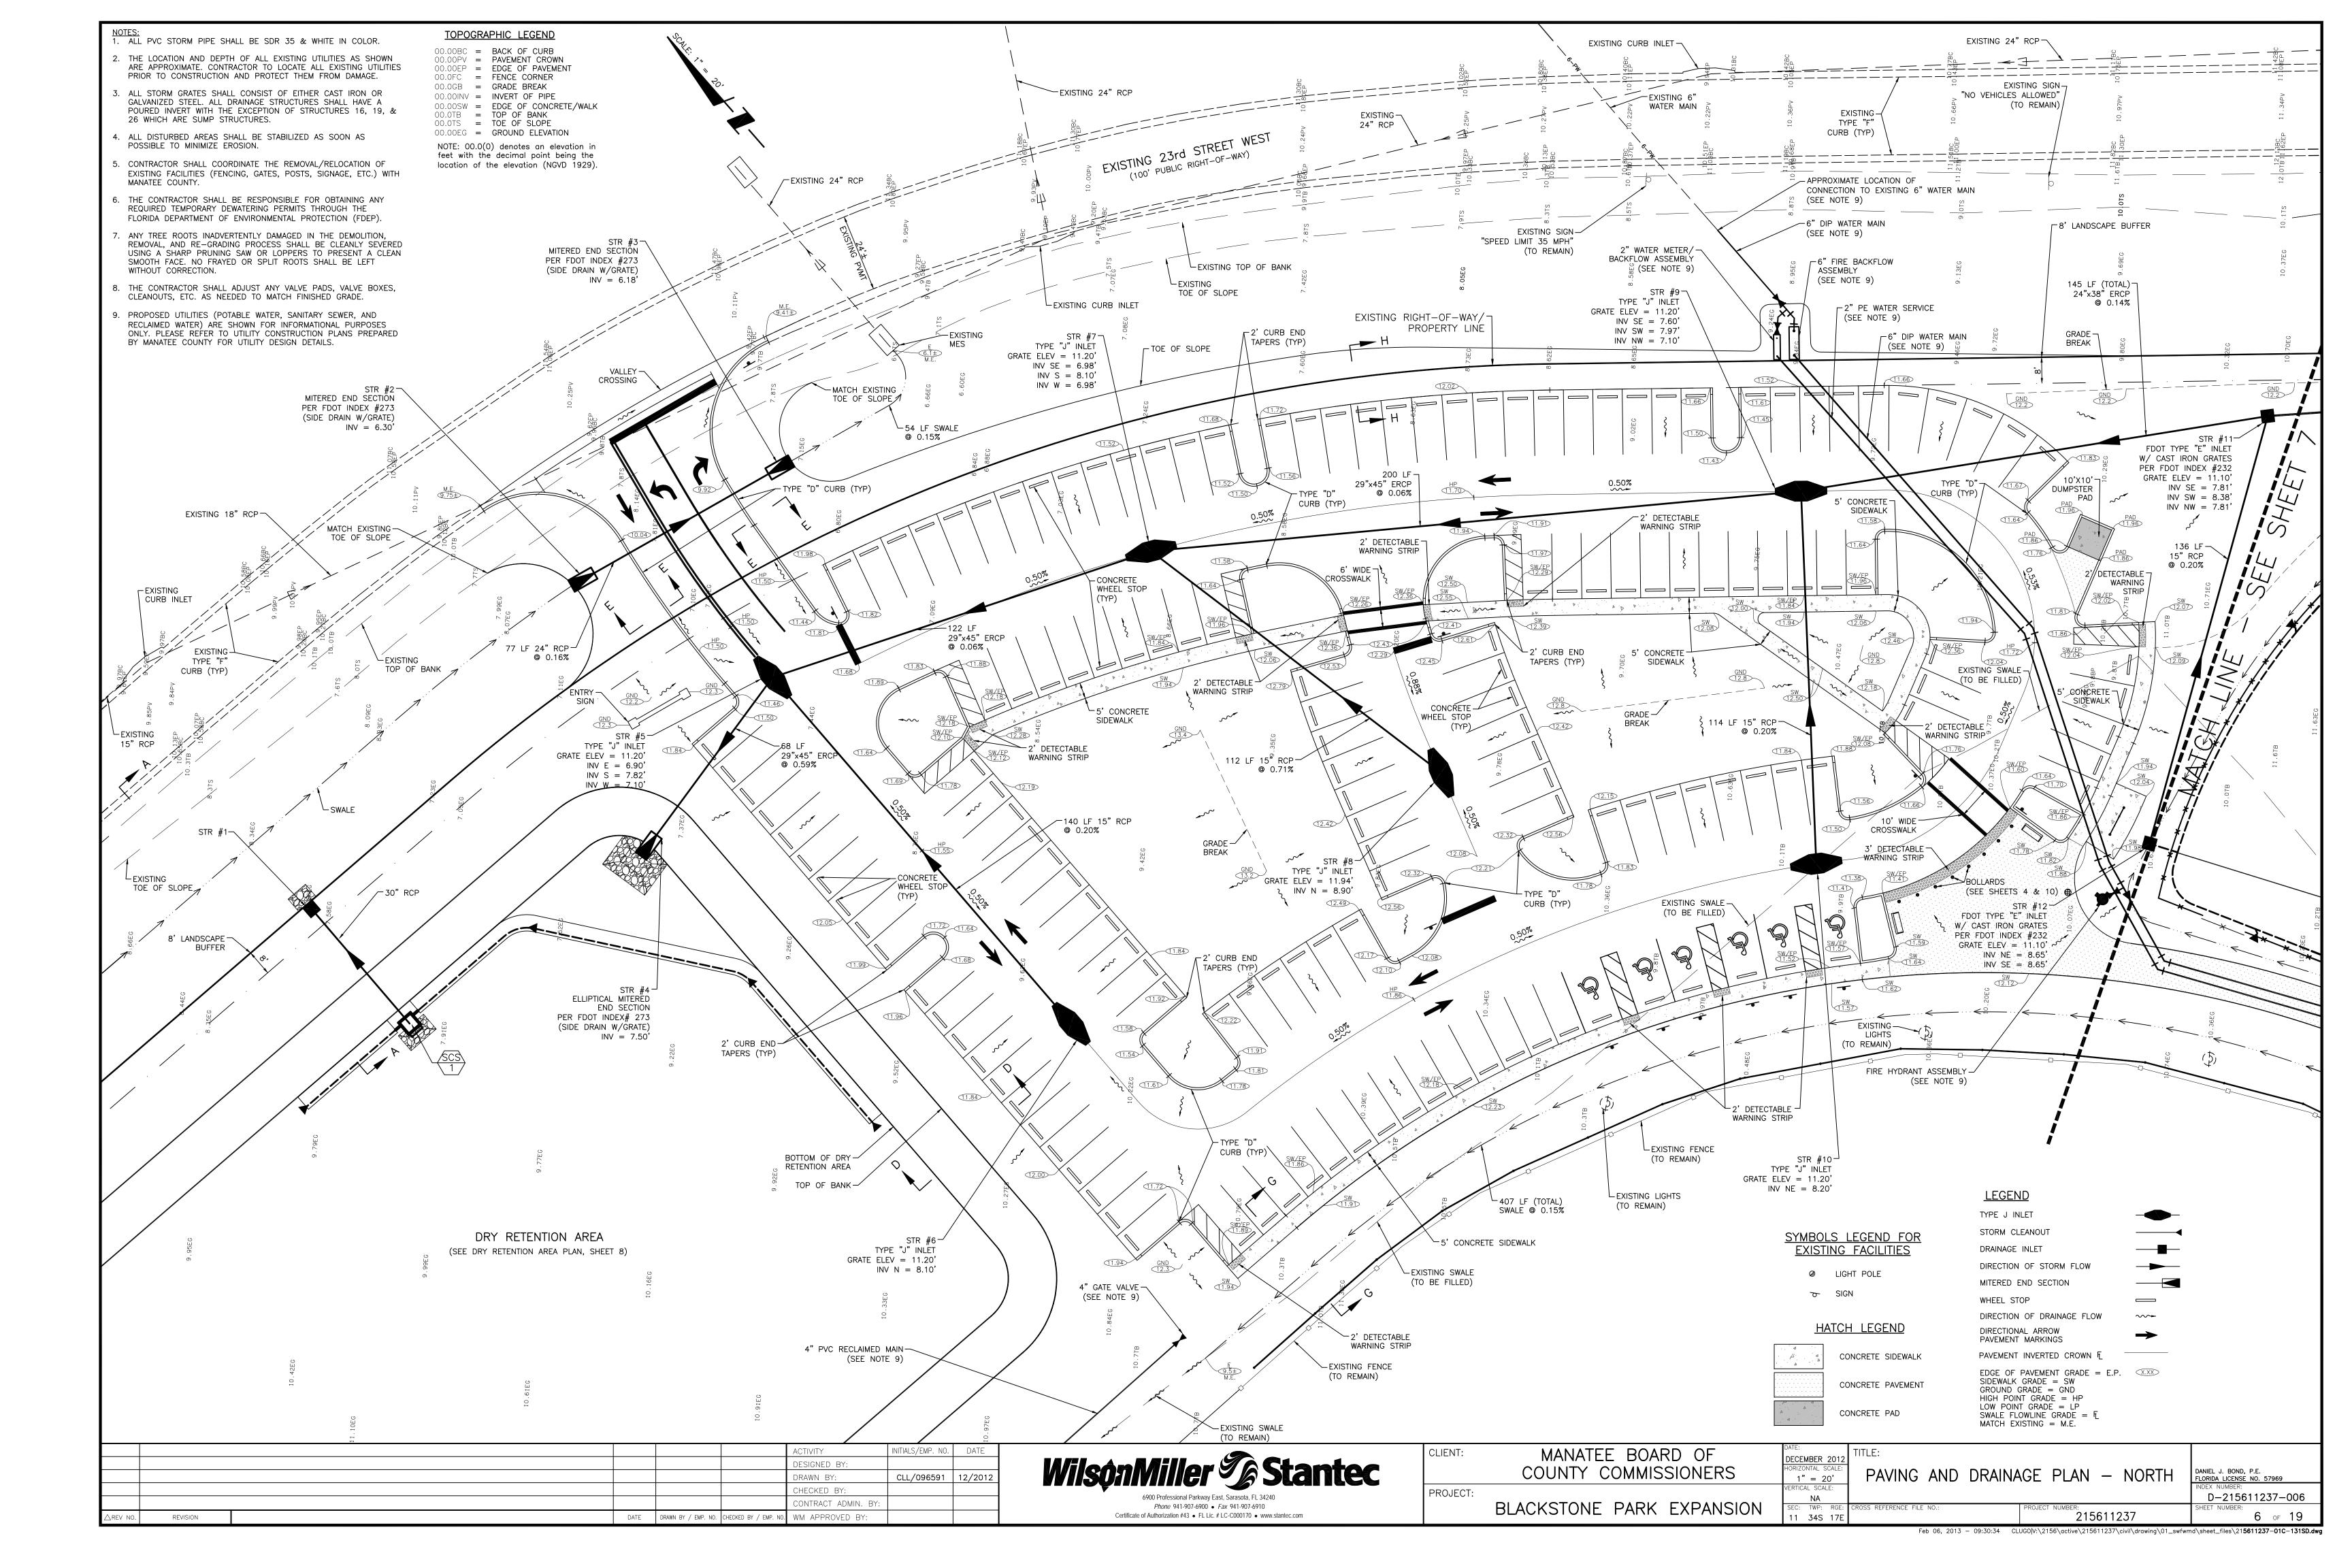
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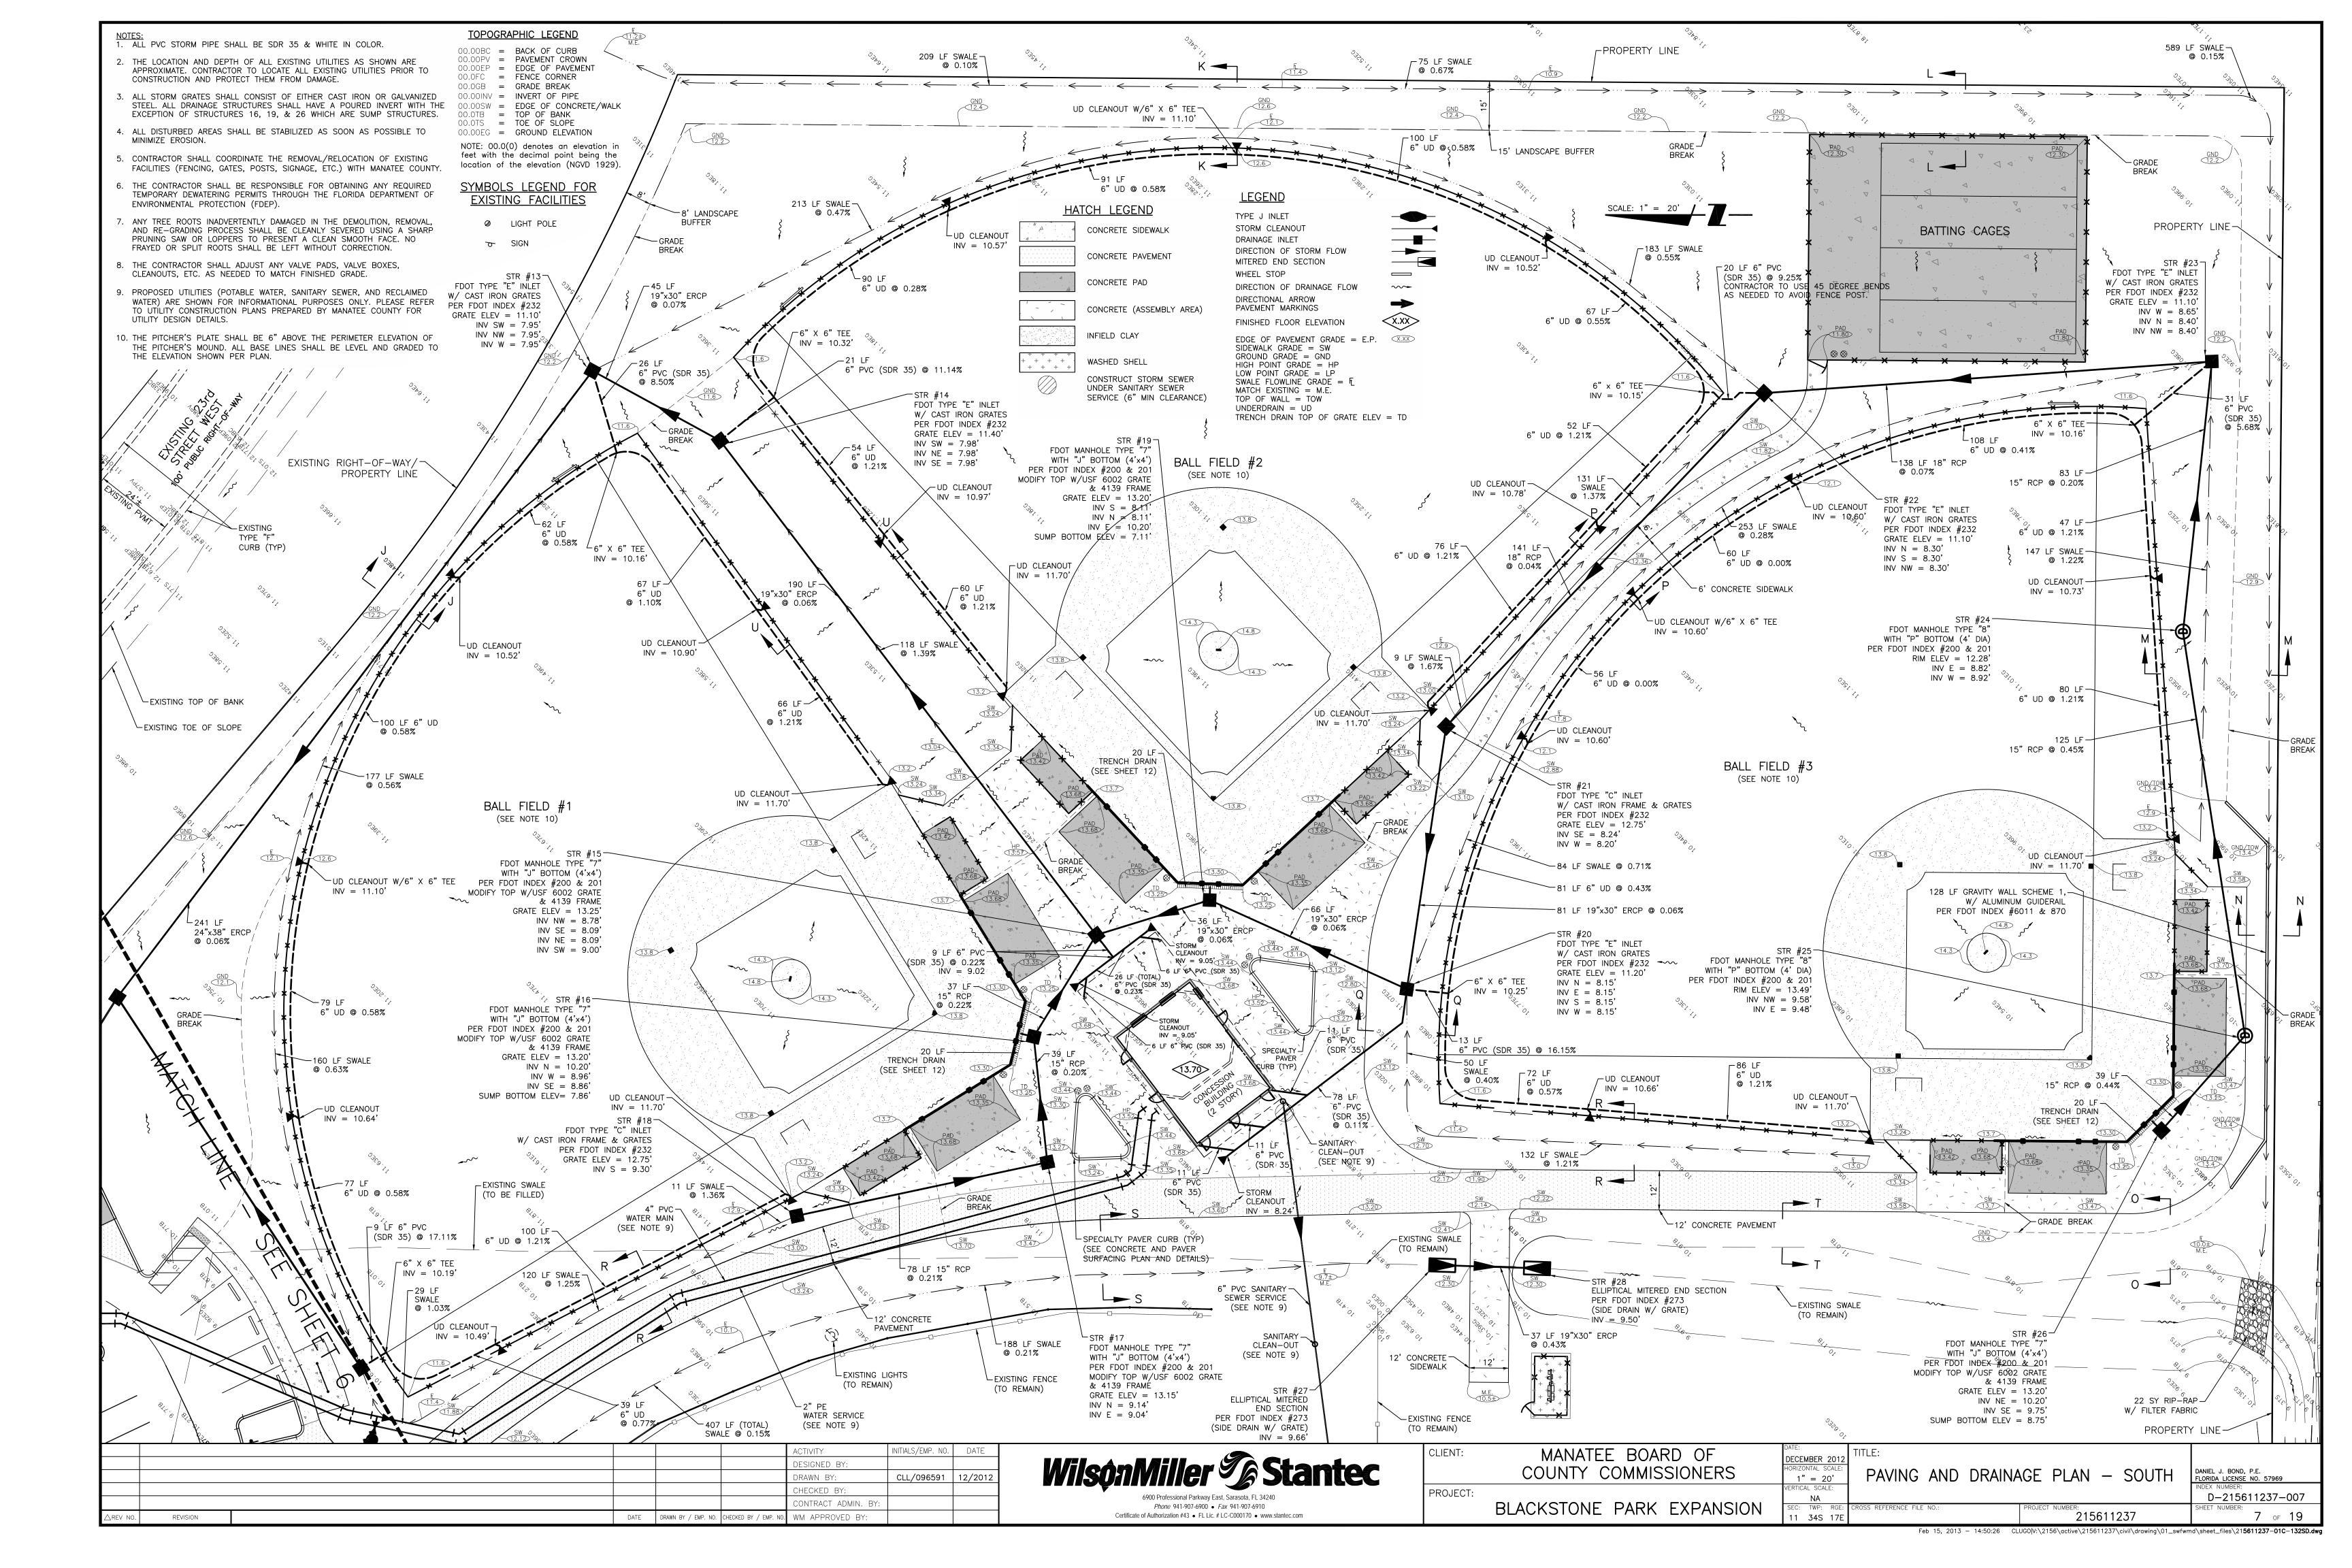







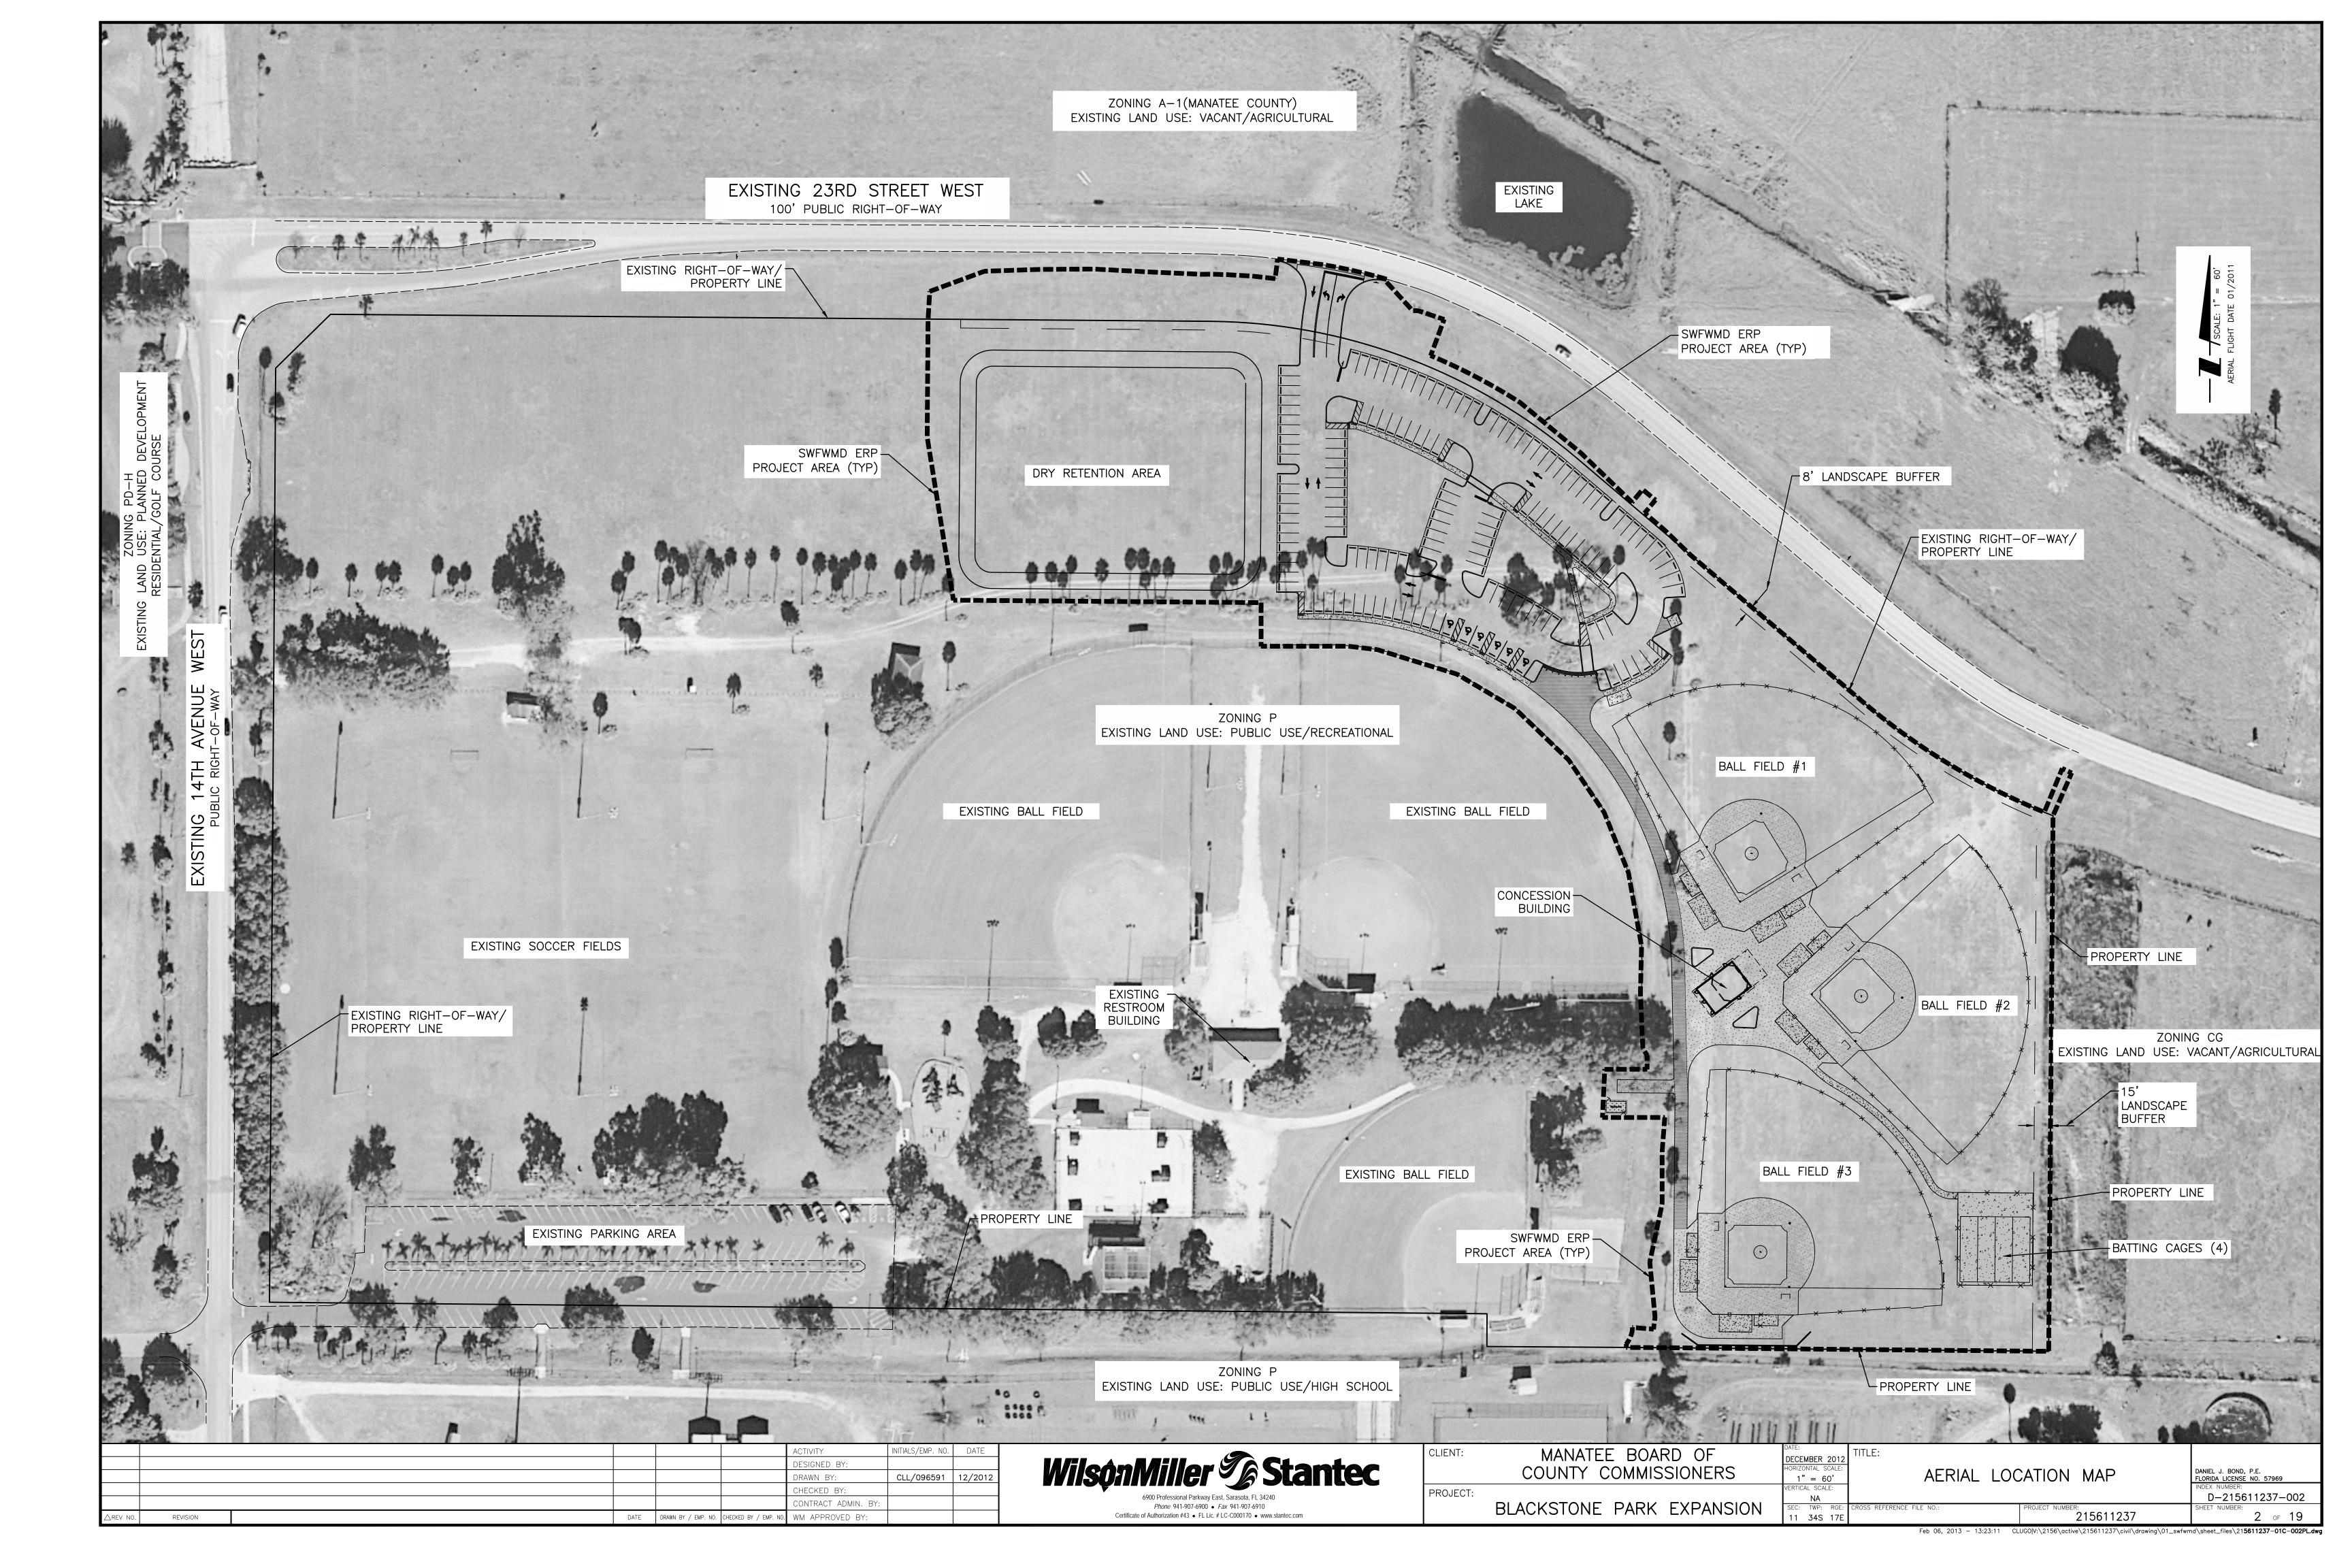

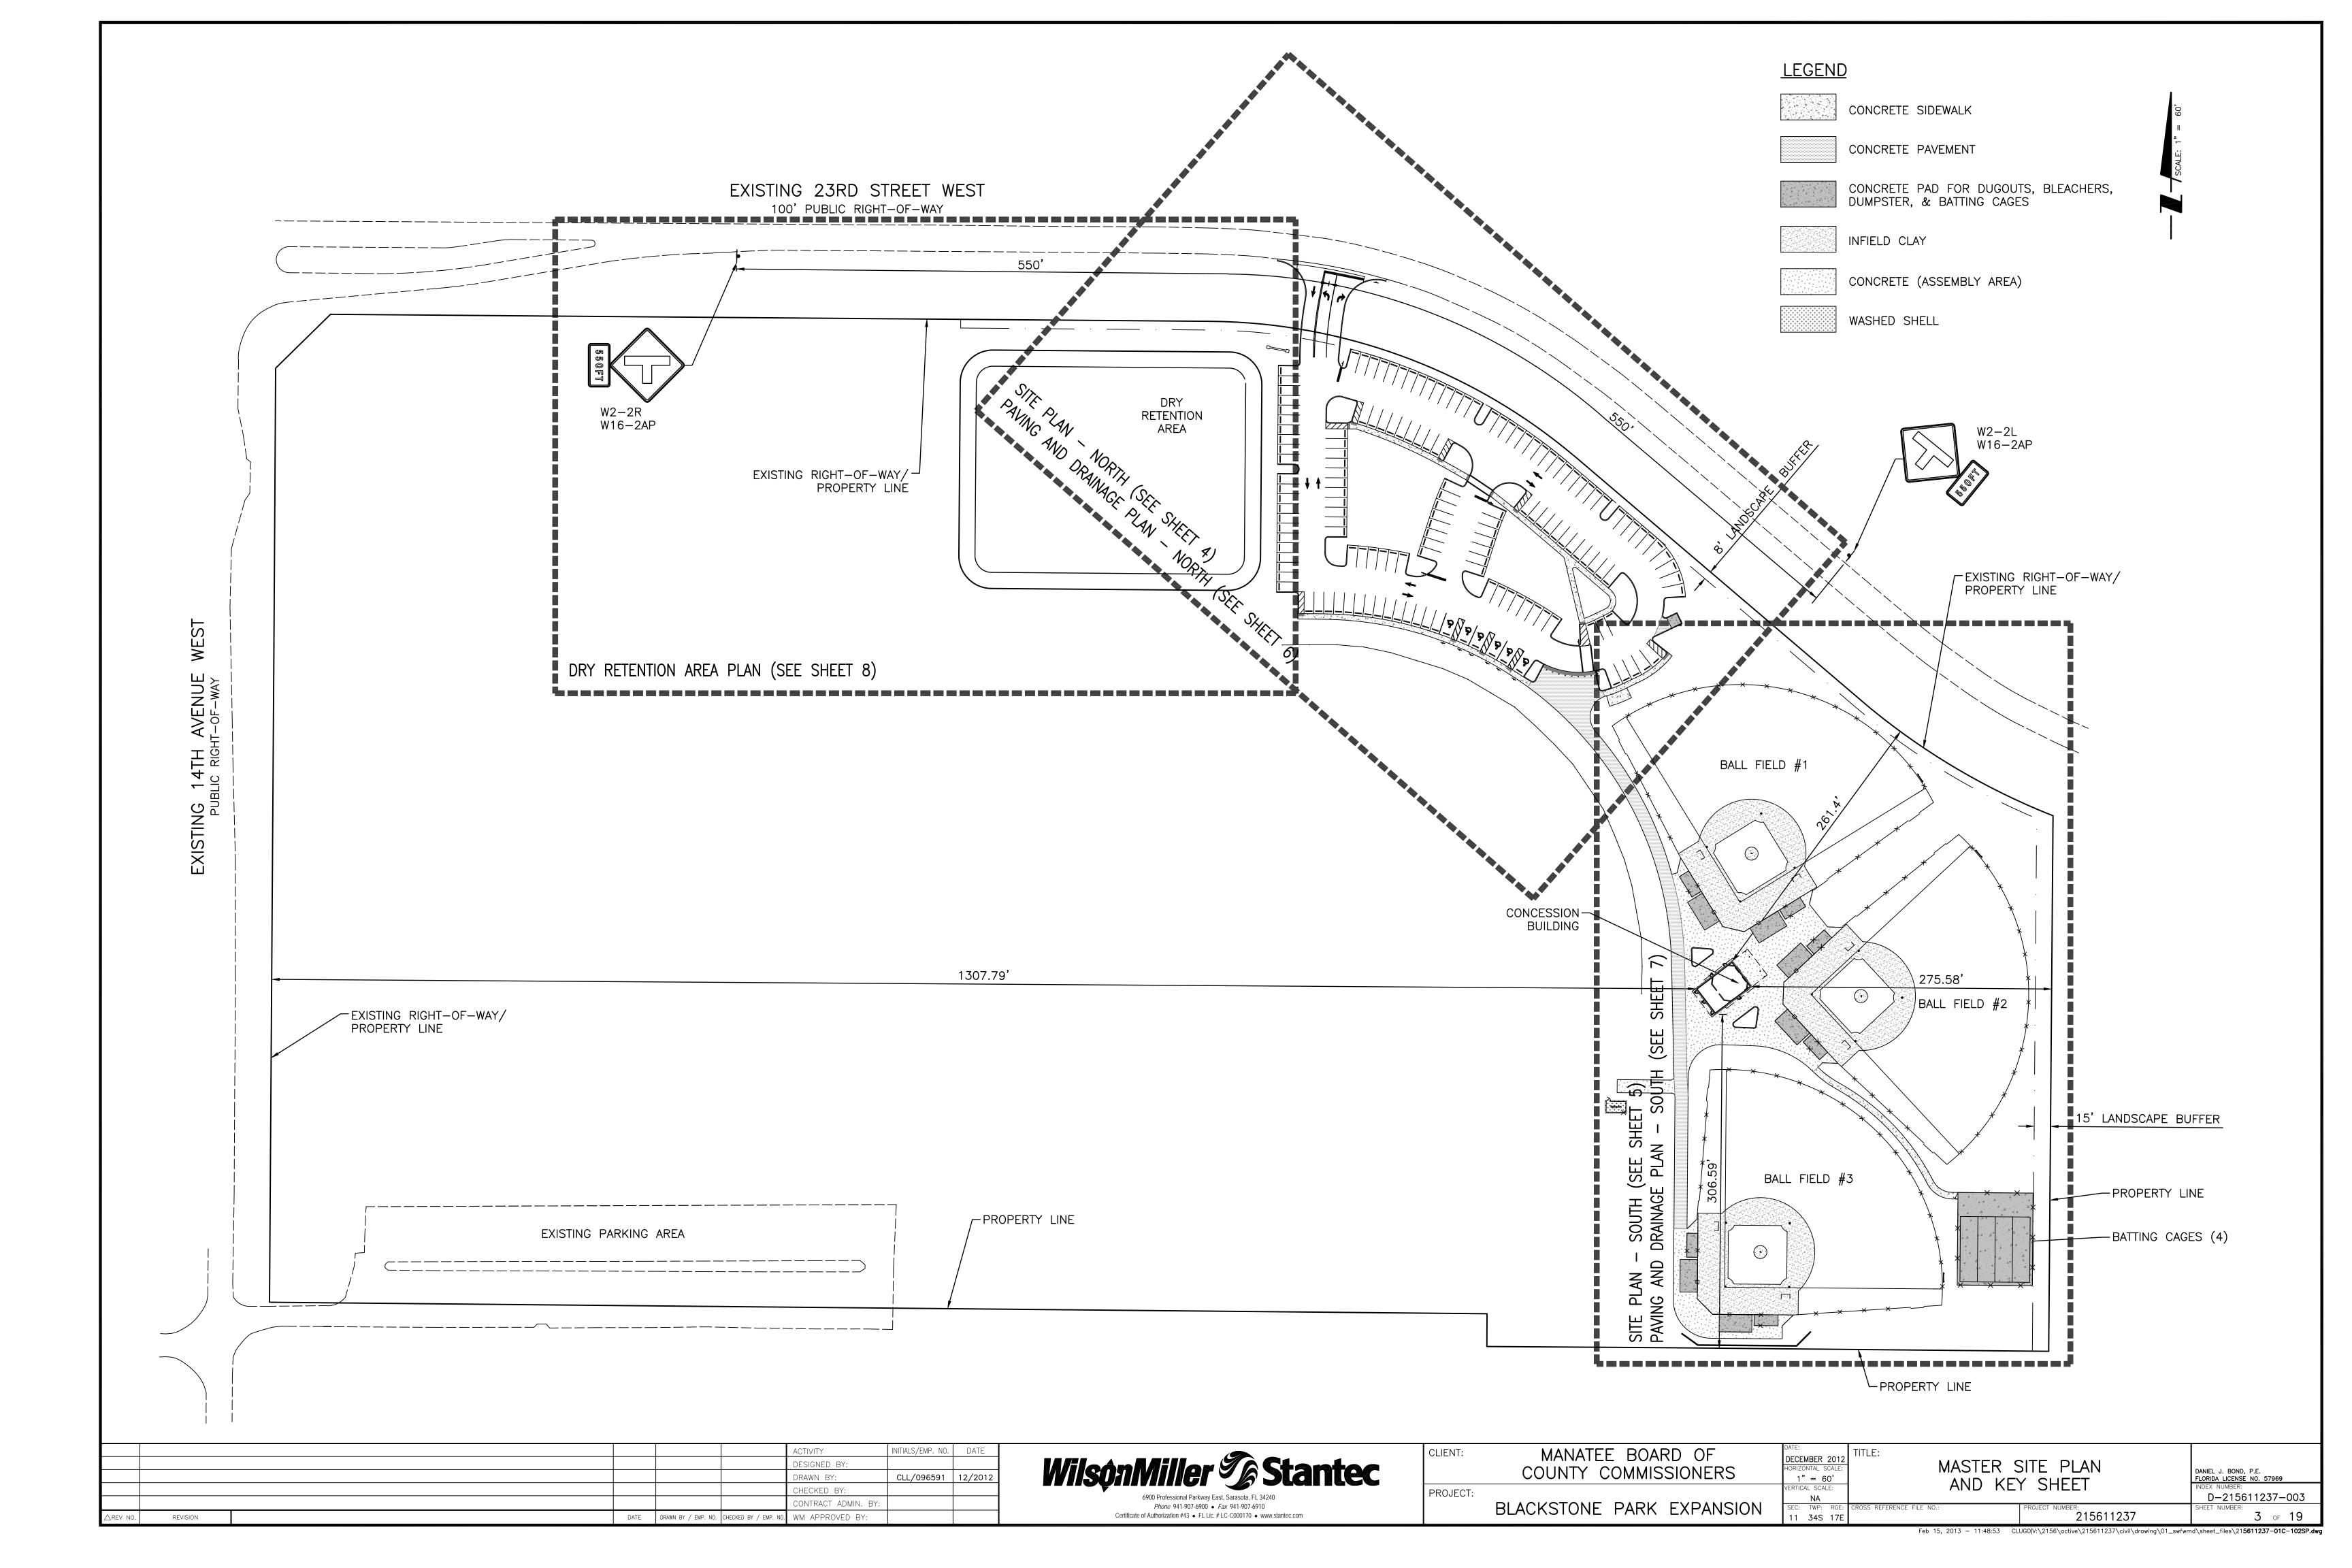


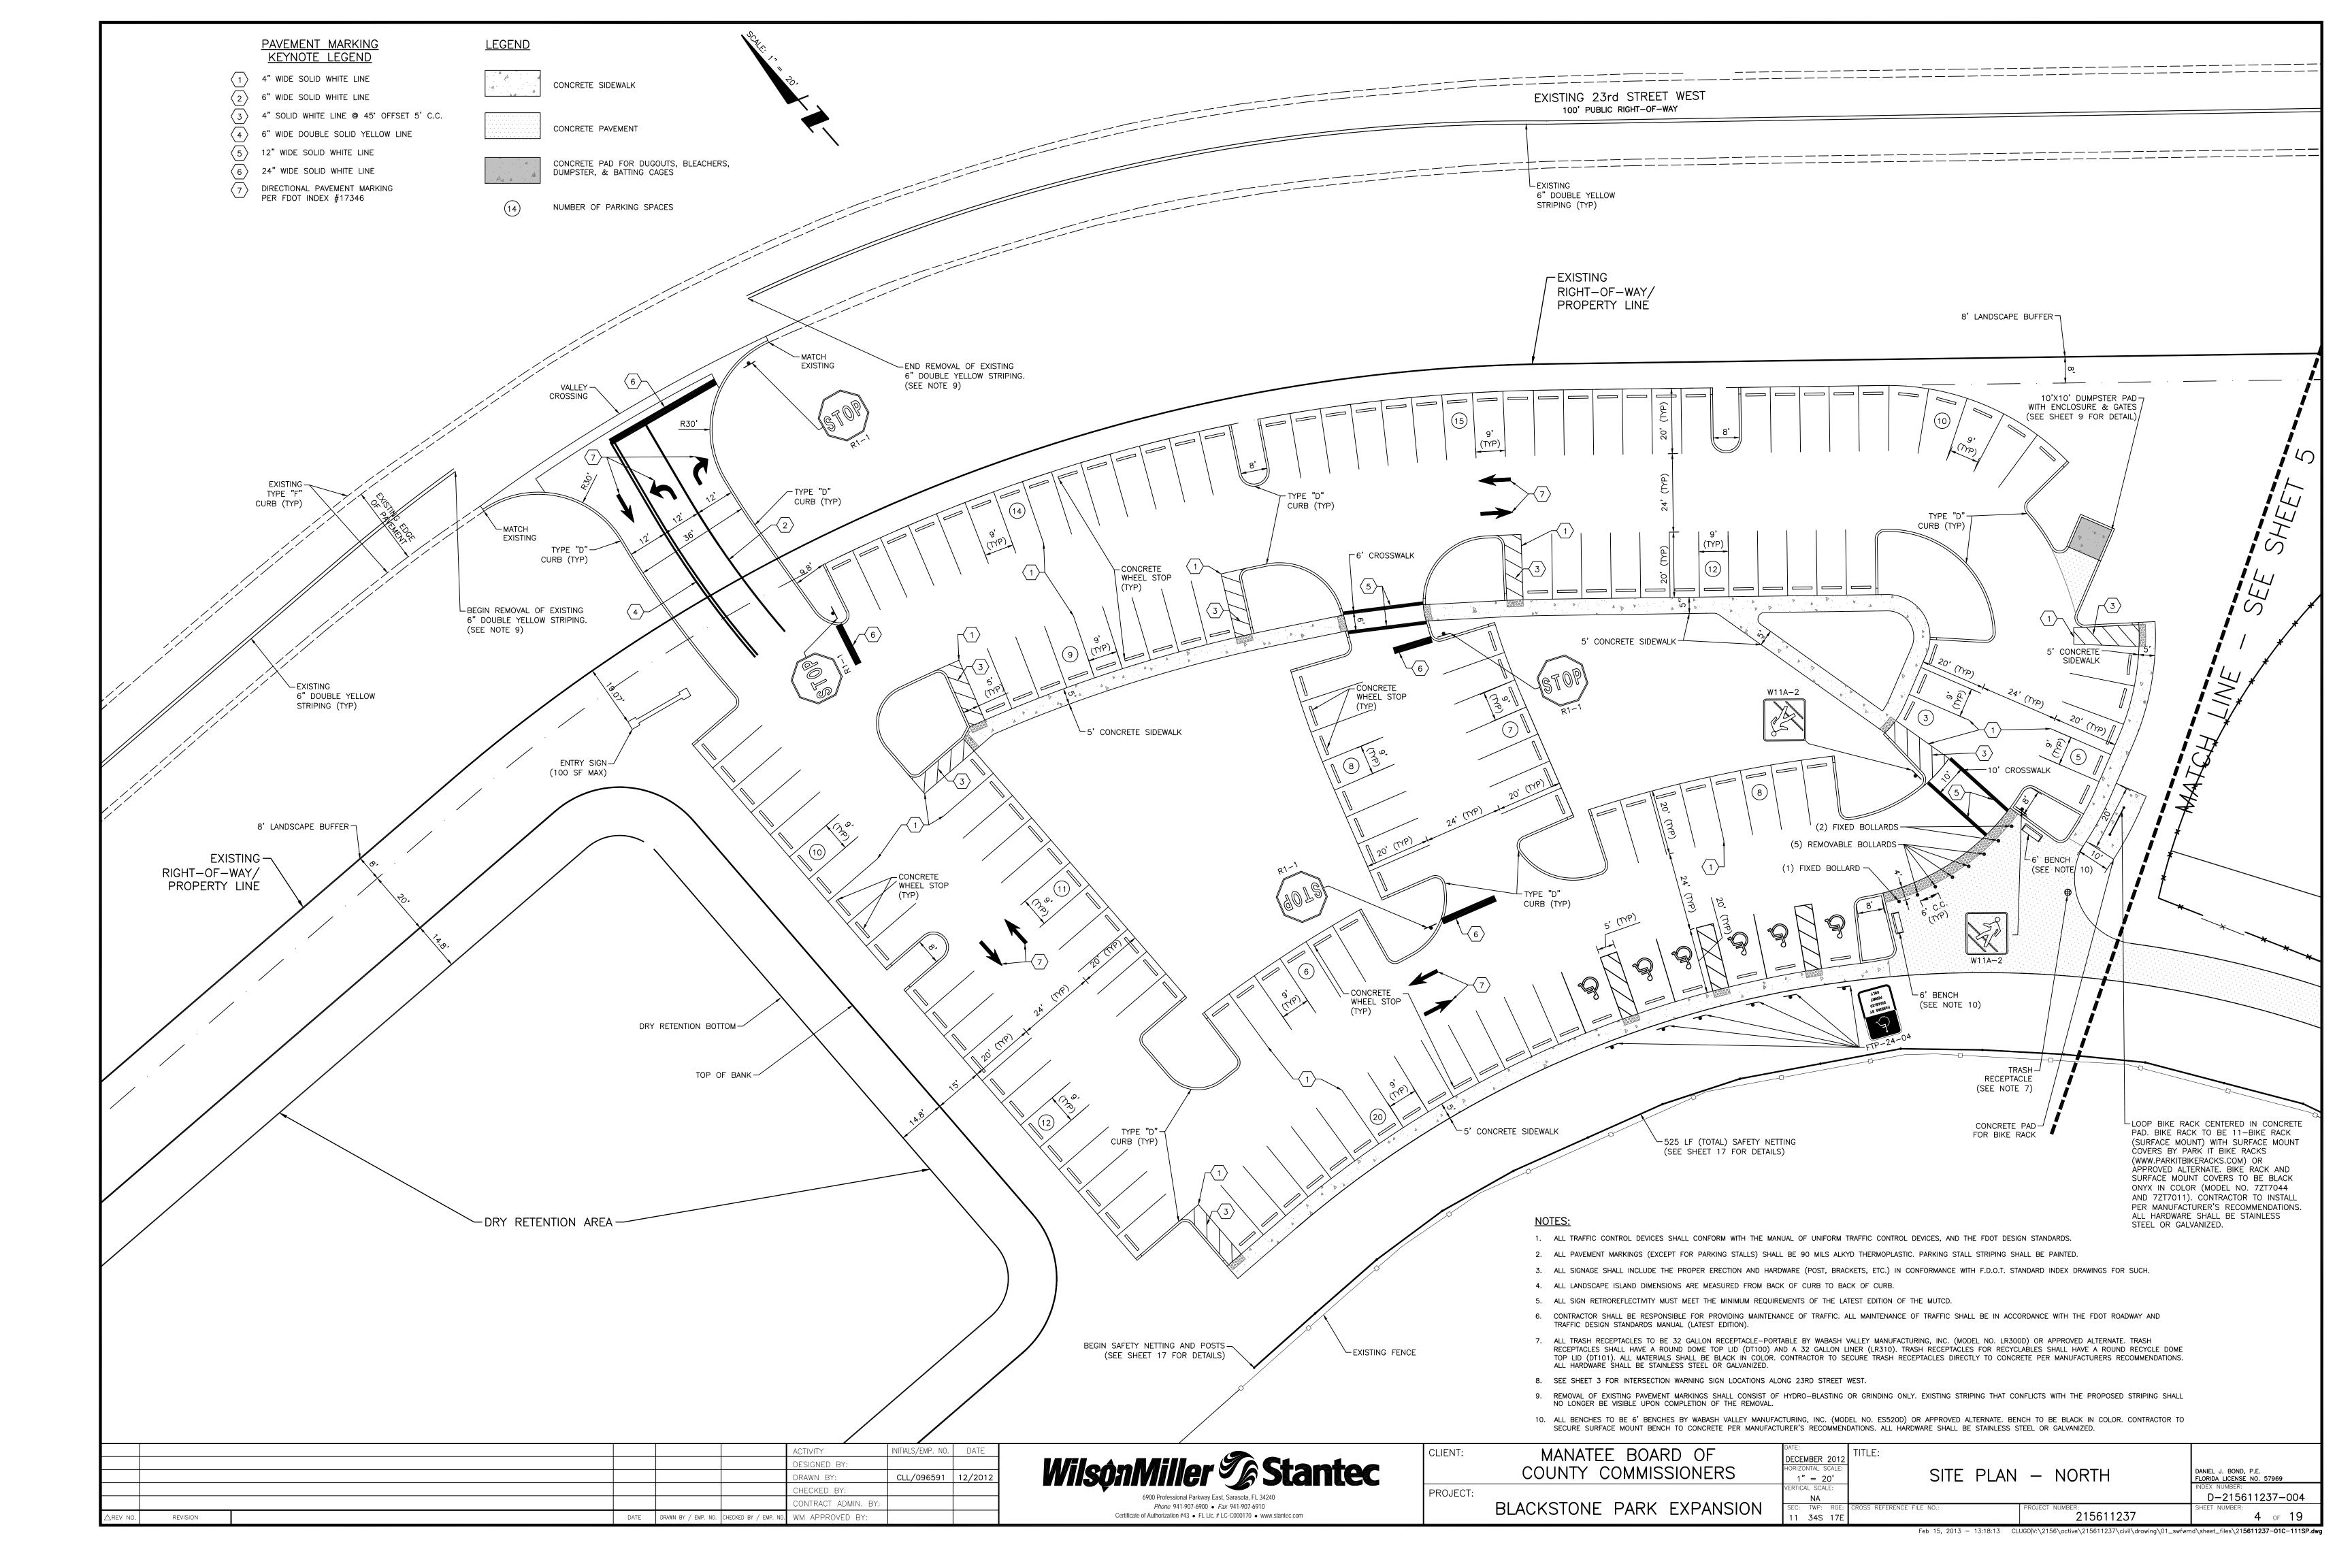


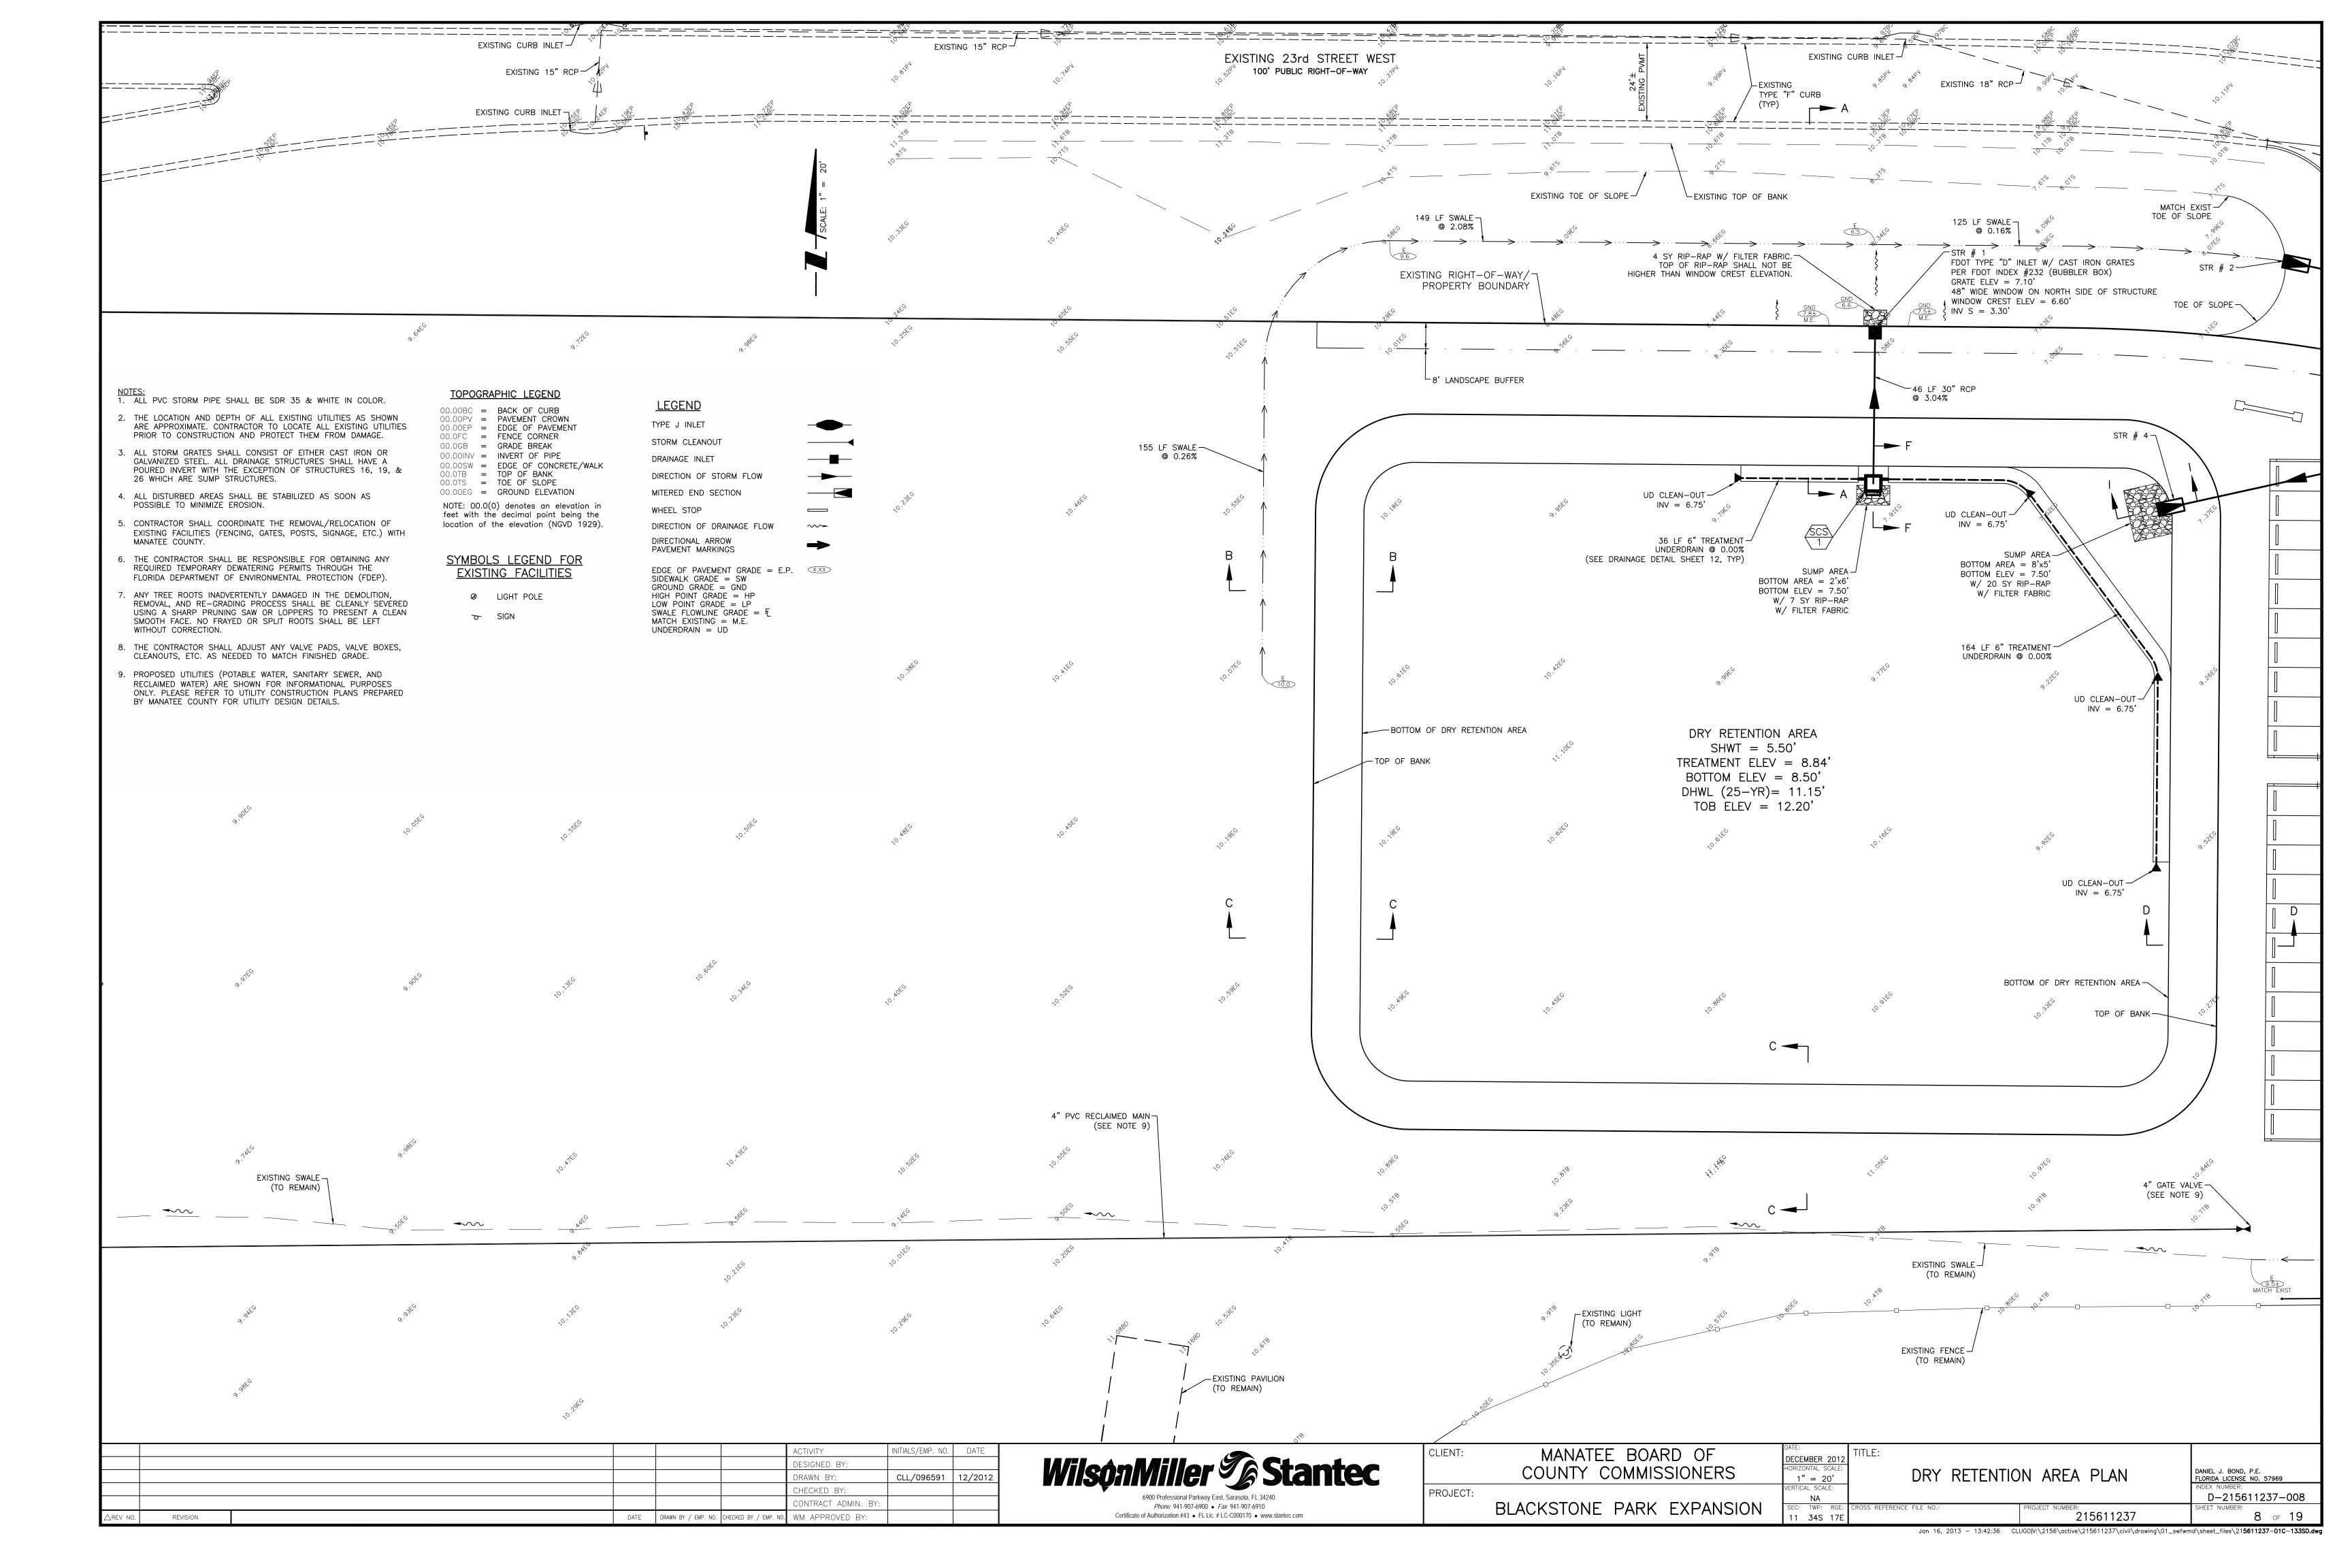



ENTRY SIGN PHOTO EXAMPLE ENTRY SIGN REFERENCE EXAMPLE LOCATED AT TOM BENNETT PARK ADDRESS: 400 CYPRESS CREEK BOULEVARD, BRADENTON, FL. 34208. SIGN BY LCM GROUP SERVICES, LLC.

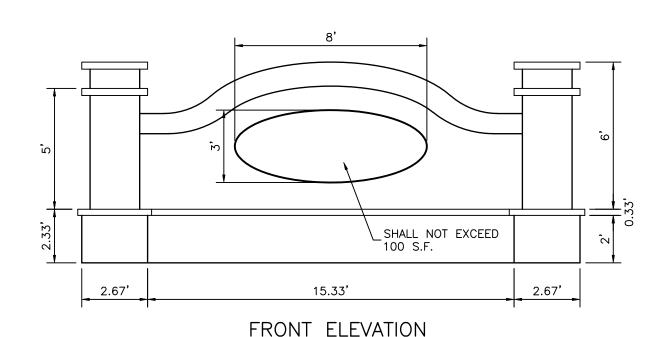

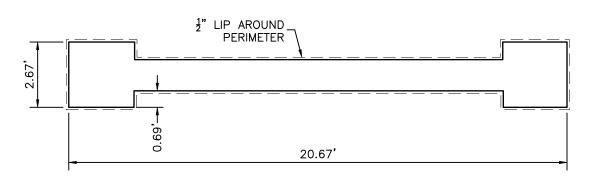


PLAN VIEW

ENTRY SIGN DETAILS ARE SHOWN FOR INFORMATIONAL PURPOSES ONLY AND ARE PROVIDED FOR BASIS OF BID ONLY. CONTRACTOR SHALL PROVIDE FINAL DESIGN/SHOP DRAWINGS FOR ENTRY SIGN, INCLUDING SIGNED AND SEALED STRUCTURAL PLANS.

- 2. CONTRACTOR SHALL BE RESPONSIBLE FOR ALL PERMITTING RELATED TO THE ENTRY SIGN AS REQUIRED BY THE CITY OF PALMETTO, INCLUDING ANY APPLICABLE PERMIT FEES.
- 3. ENTRY SIGN FOR BLACKSTONE PARK SHALL MATCH ALL MATERIALS, FINISHES, COLORS, AND DIMENSIONS AS THE TOM BENNETT PARK SIGN. PARK NAME SHALL READ "BLACKSTONE PARK" INSTEAD OF "TOM BENNETT PARK"


ENTRY SIGN SCHEMATIC DETAIL

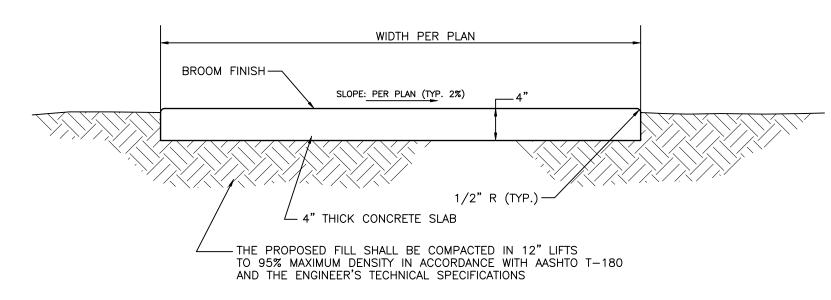


SIDEWALK NOTES:

- 1. CONCRETE SHALL HAVE A COMPRESSIVE STRENGTH OF 3000 P.S.I. IN 28 DAYS UNLESS OTHERWISE NOTED.
- 2. SEE CONCRETE AND PAVER SURFACING PLAN FOR CONTROL JOINT AND EXPANSION JOINT LOCATIONS AND DETAILS. MINIMUM SAW CUT DEPTH SHALL BE 1.5".
- 3. ALL SIDEWALKS AND SIDEWALK CROSSINGS SHALL BE CONSTRUCTED IN ACCORDANCE WITH THE AMERICANS WITH DISABILITIES ACT (ADA).

TYPICAL CONCRETE SIDEWALK DETAIL

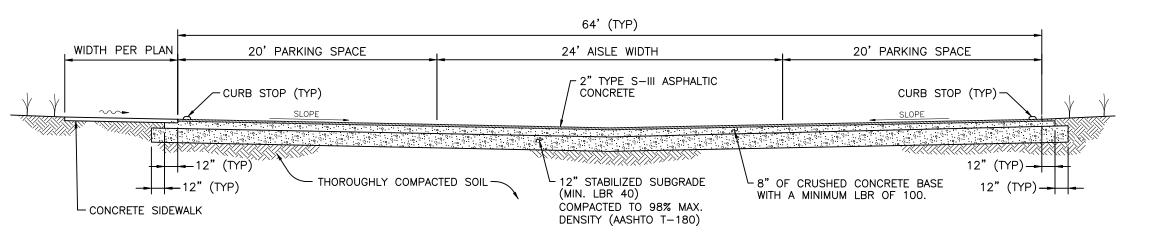

TYPICAL FLEXIBLE PAVEMENT SECTION

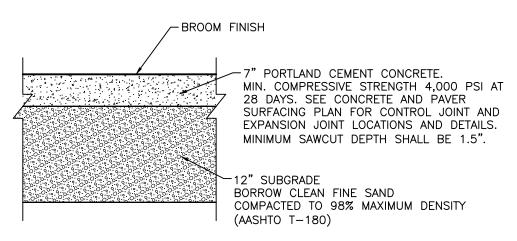

1. SUBGRADE SOILS SHOULD BE DENSIFIED TO AT LEAST 98% OF MODIFIED PROCTOR TEST MAXIMUM DRY DENSITY (ASTM D1557, AASHTO T-180) TO A DEPTH OF AT LEAST 1 FEET PRIOR TO PLACEMENT OF CONCRETE. 2. THE SURFACE OF THE SUBGRADE SOILS SHOULD BE SMOOTH, AND ANY DISTURBANCES OR

- WHEEL RUTTING CORRECTED PRIOR TO PLACEMENT OF CONCRETE. 3. THE SUBGRADE SOILS SHOULD BE MOISTENED PRIOR TO PLACEMENT OF CONCRETE. 4. CONCRETE PAVEMENT THICKNESS SHOULD BE UNIFORM THROUGHOUT.
- 5. SEE SITE PLAN FOR CONCRETE PAVEMENT LOCATIONS. 6. ALL CONCRETE AREAS SHALL NOT EXCEED 2% CROSS SLOPE IN ACCORDANCE WITH THE AMERICAN WITH DISABILITIES ACT (ADA).
- 7. ALL EDGES SHALL HAVE A 0.5" RADIUS. 8. THE RIGID PAVEMENT SHALL BE DOWELED IN ACCORDANCE WITH FDOT STANDARD INDEX #305.

CONCRETE

10' X 10' CONCRET

10'-0"

DUMPSTER

AS REQUIRED TO ENCLOSE 10'x10' DUMPSTER PAD

7/8"x6" TONGUE & GROOVE

OPAQUE PICKETS WITH-

LOCKING MECHANISM

1-1/2"x5-1/2"

POCKET RAIL (TYP)

FINISH GRADE WWW WW


7/8"x6" TONGUE & GROOVE

OPAQUE PICKETS WITH

LOCKING MECHANISM

\PAVEMENT/


PORTLAND CEMENT CONCRETE RIGID PAVEMENT SECTION

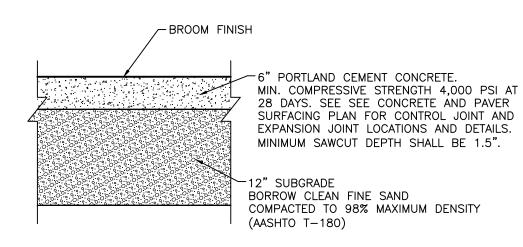


1. SUBGRADE SOILS SHOULD BE DENSIFIED TO AT LEAST 98% OF MODIFIED PROCTOR TEST MAXIMUM DRY DENSITY (ASTM D1557, AASHTO T-180) TO A DEPTH OF AT LEAST 1 FEET PRIOR TO PLACEMENT OF CONCRETE

- 2. THE SURFACE OF THE SUBGRADE SOILS SHOULD BE SMOOTH, AND ANY DISTURBANCES OR WHEEL RUTTING CORRECTED PRIOR TO PLACEMENT OF CONCRETE. . THE SUBGRADE SOILS SHOULD BE MOISTENED PRIOR TO PLACEMENT OF CONCRETE.
- . CONCRETE THICKNESS SHOULD BE UNIFORM THROUGHOUT.
- 5. SEE SITE PLAN FOR CONCRETE (ASSEMBLY AREA) LOCATIONS. 6. ALL CONCRETE AREAS SHALL NOT EXCEED 2% CROSS SLOPE IN ACCORDANCE WITH THE
- AMERICAN WITH DISABILITIES ACT (ADA). 7. ALL EDGES SHALL HAVE A 0.5" RADIUS.

TYPICAL CONCRETE SECTION FOR ASSEMBLY AREAS

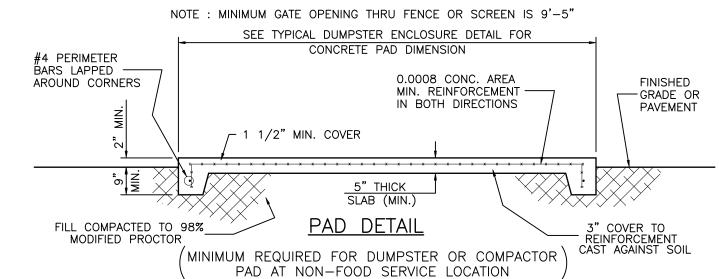

MIN. CONC. STRENGTH f'c= 3000 P.S.I. MIN. REINFORCEMENT STRENGTH fy= 60,000 P.S.I.

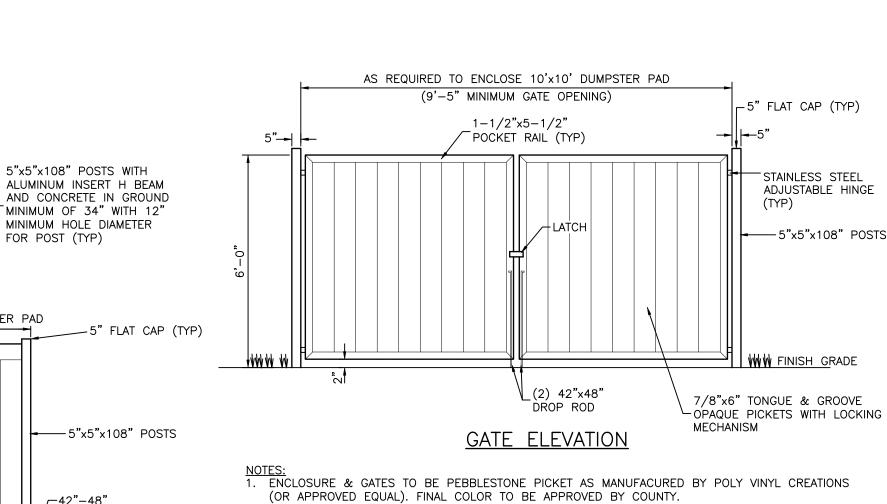

(OR APPROVED EQUAL). FINAL COLOR TO BE APPROVED BY COUNTY.

- 2. CONTRACTOR TO SUBMIT TO THE COUNTY/ENGINEER SHOP DRAWINGS AND SIGNED & SEALED WINDLOAD CALCULATIONS MEETING BUILDING CODE REQUIREMENTS.
- 3. CONTRACTOR SHALL INCLUDE ANY BUILDING PERMITTING REQUIRED FOR DUMPSTER PAD,
- ENCLOSURE, & GATES IN THEIR BID PRICE.
- 4. ALL GATE POSTS TO BE 5"x5"x108" WITH ALUMINUM INSERT H BEAM AND CONCRETE IN GROUND MINIMUM OF 34" WITH 12" DIAMETER HOLE. CONCRETE TO BE FILLED UP TO FINISHED GRADE.
- FLUSH W/GRADE FOR DROP FOR HARDWARE: PADLOCKABLE DROP ROD, LOCK LATCH DELUXE WITH 6 PIN KEY SYSTEM AND STAINLESS STEEL ADJUSTABLE HINGES.

TYPICAL DUMPSTER ENCLOSURE DETAIL

(2) GAL. STEEL SLEEVES

ROD ANCHORING (TYP)

					ACTIVITY	INITIALS/EMP. NO.	DATE
					DESIGNED BY:		
					DRAWN BY:	CLL/096591	12/2012
					CHECKED BY:		
					CONTRACT ADMIN. BY:		
△REV NO.	REVISION	DATE	DRAWN BY / EMP. NO.	CHECKED BY / EMP. NO.	WM APPROVED BY:		

Phone 941-907-6900 • Fax 941-907-6910

DROP ROD

/—1/2" EX. JT.

CONCRETE

PAVFMFNT

GAL. STEEL SLEEVES

FLUSH W/GRADE FOR DROP ROD ANCHORING (TYP)

OPAQUE VINYL GATE

MANATEE BOARD OF CLIENT: COUNTY COMMISSIONERS

ECEMBER 2 AS SHOWN

DANIEL J. BOND, P.E. FLORIDA LICENSE NO. 57969

CONTRACTOR IS RESPONSIBLE FOR ALL COSTS ASSOCIATED WITH TESTING.

TYPICAL SECTIONS AND

GENERAL SITE CONSTRUCTION NOTES:

PRIOR APPROVAL BY THE ENGINEER.

TO ALLOW FOR SOD THICKNESS.

REQUIRED TO REMOVE SAID TREE(S).

1. THERE SHALL BE NO CHANGE OR DEVIATION FROM THESE PLANS WITHOUT

2. ALL CLEARING AND GRUBBING DEBRIS TO BE BURNED OR REMOVED FROM

FINISH EARTHWORK GRADING SHALL BE 0.2 FEET BELOW ELEVATIONS SHOWN

4. SODDING INCLUDES MAINTAINING SLOPES AND SOD UNTIL COMPLETION AND

COMES LAST. UNTIL THEN, ALL EROSION, SILTATION, AND MAINTENANCE OF GRADES AND GRASS IS THE RESPONSIBILITY OF THE CONTRACTOR.

5. CERTAIN TREES ARE DESIGNATED BY THE OWNER TO BE SAVED AND

ACCEPTANCE OF TOTAL PROJECT OR GROWTH IS ESTABLISHED, WHICHEVER

PROTECTED BY THE CONTRACTOR. IT IS ASSUMED THESE TREES ARE HEALTHY AND ARE EXPECTED TO BE PART OF THE LANDSCAPE DEVELOPMENT. THEREFORE, IF ANY TREE(S) ARE DAMAGED BY CONSTRUCTION OPERATIONS OR BY OTHER MEANS (EXCLUDING LIGHTNING, WINDSTORM AND OTHER ACTS

OF GOD) AND PERISHES WITHIN THE CONSTRUCTION PERIOD, IT SHALL BE THE

RESPONSIBILITY OF THE CONTRACTOR TO REMOVE AND DISPOSE OF THOSE TREES. CITY OF PALMETTO APPROVAL IS REQUIRED PRIOR TO REMOVAL OF ANY TREES DESIGNATED TO REMAIN. NO ADDITIONAL COMPENSATION SHALL BF MADE BY THE OWNER FOR THE LABOR, MATERIAL, OR MACHINERY

6. WHERE EXCAVATIONS ARE IN CLOSE PROXIMITY OF TREES, THE CONTRACTOR

WITHIN THE DRIP LINE OF TREES TO REMAIN AND BE PRESERVED. IT SHALL BE THE RESPONSIBILITY OF THE CONTRACTOR TO INFORM ALL OF HIS EMPLOYEES

8. NOTIFY "SUNSHINE STATE ONE CALL (1-800-432-4770), MANATEE COUNTY PUBLIC WORKS

DEPARTMENT, CITY OF PALMETTO PUBLIC WORKS DEPARTMENT, FLORIDA POWER & LIGHT, VERIZON AND ANY OTHER UTILITIES (GAS COMPANIES, CABLE TV, ETC.) PRIOR TO

SHALL USE EXTREME CARE IN NOT DAMAGING THE ROOT SYSTEM. NO

AND SUBCONTRACTORS OF THIS REQUIREMENT AND TO ENFORCE SAME.

7. LAY SOD AROUND ALL INLETS, MITERED ENDWALLS, HEADWALLS, SWALES, LAKE SLOPES, ADJACENT TO EDGE OF PAVEMENT AND ADJACENT TO BACK OF CURB

CONSTRUCTION AND PRIOR TO ANY CONNECTION TO EXISTING UTILITIES. IT IS

9. ALL UTILITY LINES, STORM DRAIN LINES AND ACCESSORIES SUCH AS, BUT NOT

LIMITED TO, MANHOLES, CLEANOUTS, SEWER AND WATER SERVICES, VALVES,

LOCATIONS SHOWN ON PLANS UNLESS OTHERWISE DIRECTED BY THE ENGINEER.

10. CLEARING, GRUBBING, STRIPPING, AND COMPACTION SHALL BE INSPECTED BY THE

FIRE HYDRANTS AND INLETS SHALL BE CONSTRUCTED TO ALIGNMENT AND

ENGINEER OR HIS DULY APPOINTED REPRESENTATIVE PRIOR TO FILLING.

SILT BARRIERS SHALL BE CONSTRUCTED IN

WETLAND/BUFFER.

PERMIT FOR THE PROJECT ON SITE.

HAVE ALL JOINTS WRAPPED.

CITY OF PALMETTO.

23. LANDSCAPE SOIL

COLLECT WATER.

11. PRIOR TO THE START OF CONSTRUCTION ACTIVITIES, PRESERVE AREAS WITHIN

AND ADJOINING THE AREA OF CONSTRUCTION ACTIVITY SHALL BE PROTECTED BY ERECTION OF TREE PROTECTION BARRICADES AND/OR SILT BARRIERS.

ACCORDANCE WITH THE BEST MANAGEMENT PRACTICES DETAIL DRAWING. THE

THE APPROVAL OF SWFWMD & THE CITY OF PALMETTO. THE CONTRACTOR SHALL NOTIFY THE ENGINEER & THE CITY OF PALMETTO WHEN PRESERVE AREA BARRICADES AND BARRIERS ARE IN PLACE. THE CONTRACTOR IS RESPONSIBLE TO

OBTAIN ANY REQUIRED TREE REMOVAL PERMIT FROM THE CITY OF PALMETTO.

SWALE SHALL BE STAKED PRIOR TO ANY CONSTRUCTION WITHIN THE LAKES OR WETLAND/BUFFERS. APPROVAL FROM THE ENGINEER, AND THE OWNER IS REQUIRED

BEFORE EQUIPMENT CAN BE USED WITHIN THE LAKE OR WETLAND/BUFFER. THE

12. ALL LIMITS OF CONSTRUCTION FOR THE OUTFALL PIPE/STRUCTURE/SPREADER

ENGINEER SHALL BE ON SITE DURING CONSTRUCTION WITHIN THE LAKE OR

13. LOCATION OF ALL STORM STRUCTURES (WEIR, MITERED END, CONTROL STRUCTURE,

ENGINEER OR HIS REPRESENTATIVE AFTER SURVEY STAKE OUT AND PRIOR TO

GRATE INLET, ETC.) ADJACENT TO A WETLAND SHALL BE APPROVED BY THE

14. FILLING, EXCAVATING OR REMOVAL OF NATIVE VEGETATION SHALL BE PROHIBITED IN THE PRESERVATION AREA, UNLESS APPROVED BY THE CITY OF PALMETTO.

16. ALL CONCRETE PIPE SHALL HAVE A FILTER FABRIC JACKET MINIMUM 12" EACH

AREAS TO CONTROL BOTH SIGNIFICANT WIND EROSION AND FUGITIVE DUST.

THE COST OF VALVE RELOCATION IS THE CONTRACTOR'S RESPONSIBILITY.

SHEET SHALL ALSO APPLY TO FORCE MAIN, IRRIGATION & WATER MAINS.

ALSO APPLY TO FORCE MAIN, IRRIGATION & WATER MAINS.

TOP OF SURROUNDING PAVEMENT EDGES.

MM, AND 6.0-8.0% CLAY.

MAXIMUM OF 6.0%.

• PH SHALL BE 5.5-7.0

AREAS OF PROPOSED LANDSCAPING AS FOLLOWS:

SIDE OF JOINT WITH MINIMUM 24" OVERLAP AT SEAM PER FDOT INDEX #280 & #199

17. CONTRACTOR SHALL SPRINKLE OR OTHERWISE APPLY WATER TO AFFECTED CONSTRUCTION

18. CONTRACTOR SHALL CONSTRUCT ALL VALVES SO THAT NO VALVE BOXES ARE LOCATED IN

19. THRUST BLOCKS AND JOINT RESTRAINTS DETAILS ON THE WATER DISTRIBUTION DETAILS

20. TRENCH DETAILS ON THE WASTEWATER COLLECTION CONSTRUCTION DETAILS SHEET SHALL

REQUIREMENTS OF THE SWFWMD ERP INFORMATION MANUAL, LATEST EDITION AND THE

LANDSCAPE SOIL SHALL BE NATURAL, FERTILE, AGRICULTURAL SOIL CAPABLE OF SUSTAINING

UNLESS OTHERWISE NOTED, SMOOTH ALL PREPARED LANDSCAPE SOIL TO 3 INCHES BELOW

FINISH GRADE ALL LANDSCAPE SOIL AREAS TO A SMOOTH, EVEN SURFACE ASSURING POSITIVE DRAINAGE AWAY FROM ALL STRUCTURES AND ANY ELIMINATE ANY LOW AREAS WHICH MAY

SOIL SHALL MEET THE CLASSIFICATION OF COARSE LOAMY SAND TO A DEPTH OF 36" IN ALL

• SAND CONTENT AFTER MIXING SHALL BE A MINIMUM OF 85% SAND HAVING A PARTICLE SIZE OF 0.05-2.00 MM (A MINIMUM OF 25% OF WHICH SHALL BE CLASSIFIED AS

COARSE SAND HAVING A PARTICLE SIZE OF 0.5-1.0 MM AND A MAXIMUM OF 50% OF

ANY OTHER SAND GRADE), 4.0-5.0% SILT HAVING A PARTICLE SIZE OF 0.002-0.05

• ORGANIC MATTER CONTENT OF THE SOIL LAYER SHALL BE A MINIMUM OF 3.0% AND

THE CONTRACTOR SHALL TEST THE PROPOSED SOIL MIXTURE PRIOR TO PLACEMENT OF FILL

UPON COMPLETION OF SITE GRADING, THE CONTRACTOR SHALL SUBMIT LABORATORY TESTS

FROM A MINIMUM OF 8 LOCATIONS AS DETERMINED BY THE ENGINEER/LANDSCAPE ARCHITECT.

TO ENSURE THAT THE ABOVE REFERENCED LANDSCAPE SOIL SPECIFICATIONS ARE MET.

VIGOROUS PLANT GROWTH. IT SHALL BE OF UNIFORM COMPOSITION THROUGHOUT. IT SHALL

22. CONTRACTOR SHALL PROVIDE TRAFFIC CONTROL DURING CONSTRUCTION IN ACCORDANCE WITH THE FEDERAL HIGHWAY ADMINISTRATION MANUAL OF UNIFORM TRAFFIC CONTROL

DEVICES MILLENNIUM EDITION AND THE FLORIDA DEPARTMENT OF TRANSPORTATION DESIGN STANDARDS, 2006, TRAFFIC CONTROL THROUGH WORK ZONES, SERIES

BE FREE OF STONES, LUMPS, ROOTS, STICKS AND OTHER EXTRANEOUS MATTER.

21. THE CONTRACTOR SHALL PROVIDE RECORD DRAWINGS THAT MEET OR EXCEED THE

HANDICAP RAMPS AND/OR CURBING. IF VALVES ARE FOUND TO BE IN THESE LOCATIONS,

& ALL APPLICABLE CITY REQUIREMENTS. IN ADDITION, ALL ELLIPTICAL PÏPE SHALL

15. THE CONTRACTOR SHALL ADHERE TO AND HAVE A COPY OF THE SWFWMD

ENGINEER SHALL DETERMINE THE EXTENT AND TYPE OF PROTECTIVE MEASURES TO BE CONSTRUCTED FOR THE PROTECTION OF PRESERVE AREAS SUBJECT TO

THE CONTRACTORS RESPONSIBILITY TO PROTECT EXISTING UTILITIES FROM DAMAGE.

EQUIPMENT, SUPPLIES, OR VEHICLES SHALL BE STORED OR PARKED

AS SHOWN IN DETAILS OR AS DIRECTED BY THE ENGINEER.


TO BE OBTAINED BY THE CONTRACTOR IF BURNING IS TO OCCUR. 3. ALL PROPOSED GROUND ELEVATIONS ARE FINISHED SOD ELEVATIONS.

SITE AND IS PART OF CLEARING AND GRUBBING ITEM. A BURN PERMIT IS REQUIRED

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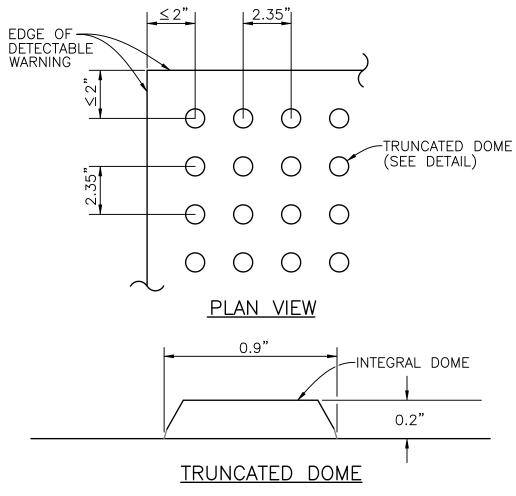
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CONSTRUCTION DETAILS RTICAL SCALE PROJECT: AS SHOWN BLACKSTONE PARK EXPANSION Certificate of Authorization #43 • FL Lic. # LC-C000170 • www.stantec.com 34S 17E



- 1. BOLLARDS TO BE 8" CARBON STEEL (SCH 80) SECURITY BOLLARDS AS MANUFACTURED BY CAL PIPE SECURITY BOLLARDS (IBP08080) OR APPROVED ALTERNATE. ALL BOLLARD TOPS SHALL HAVE A DOME CAP STYLE AND SHALL HAVE A BLACK POWDERCOAT FINISH. THE CONTRACTOR SHALL PROVIDE A COLOR SAMPLE (WITH THE SHOP DRAWINGS) TO THE ENGINEER AND COUNTY FOR REVIEW/APPROVAL PRIOR TO FABRICATION.
- 2. ALL BOLLARDS AND FOOTINGS SHALL BE INSTALLED/CONSTRUCTED PER MANUFACTURER'S SPECIFICATIONS. LOCKS FOR REMOVABLE BOLLARDS TO BE PROVIDED BY THE COUNTY.
- 3. ALL HINGING LIDS FOR THE REMOVABLE BOLLARDS SHALL BE POSITIONED TO OPEN DIRECTLY AWAY FROM THE PARKING LOT DRIVE AISLE.
- 4. EMBEDMENT SLEEVE AND HINGING LID TO BE PROVIDED FOR REMOVABLE BOLLARDS ONLY. PLEASE SEE SHEET 4 FOR THE SPECIFIC LOCATIONS OF THE REMOVABLE BOLLARDS AND FIXED BOLLARDS.

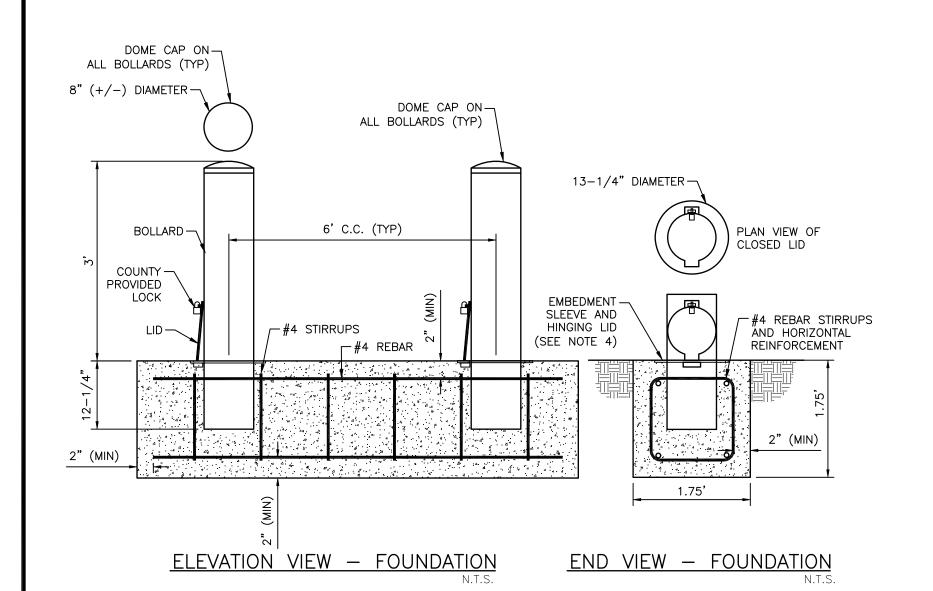BOLLARD DETAIL



CURB RAMP DETECTABLE WARNING DETAIL

NOTES: DETECTABLE WARNINGS ON WALKING SURFACES

ALL DETECTABLE WARNINGS SURFACES/TRUNCATED DOMES SHALL BE VANGUARD ADA SYSTEMS (QPL S527-0015) OR APPROVED ALTERNATE. THE ENTIRE DETECTABLE WARNING SURFACE SHALL BE SEAMLÉSS AND BLACK IN COLOR.

THE DETECTABLE WARNING SHALL EXTEND THE FULL WIDTH AND DEPTH OF THE CURB RAMP.

DETECTABLE WARNINGS SHALL CONSIST OF RAISED TRUNCATED DOMES WITH A DIAMETER OF NOMINAL 0.9 INCH, A HEIGHT OF NOMINAL 0.2 INCH AND A CENTER-TO-CENTER SPACING OF NOMINAL 2.35 INCH AND SHALL CONTRAST VISUALLY WITH ADJOINING SURFACES, EITHER LIGHT-ON-DARK, OR DARK-ON-LIGHT.

THE MATERIAL USED TO PROVIDE CONTRAST SHALL BE AN INTEGRAL PART OF THE WALKING SURFACE. DETECTABLE WARNINGS USED ON INTERIOR SURFACES SHALL DIFFER FROM ADJOINING WALKING SURFACES IN RESILIENCY OR SOUND-ON-CANE CONTACT.


THE MATERIAL USED TO PROVIDE CONTRAST SHOULD CONTRAST BY AT LEAST 70%. CONTRAST IN PERCENT IS DETERMINED BY: $CONTRAST = [(B1-B2)/B1] \times 100$

WHERE B1 = LIGHT REFLECTANCE VALUE (LRV) OF THE LIGHTER AREA AND B2 = LIGHT REFLECTANCE VALUE (LRV) OF THE DARKER AREA.


NOTE THAT IN ANY APPLICATION BOTH WHITE AND BLACK ARE NEVER ABSOLUTE; THUS, B1


NEVER EQUALS 100 AND B2 IS ALWAYS GREATER THAN 0.

CURB RAMP DETECTABLE WARNINGS

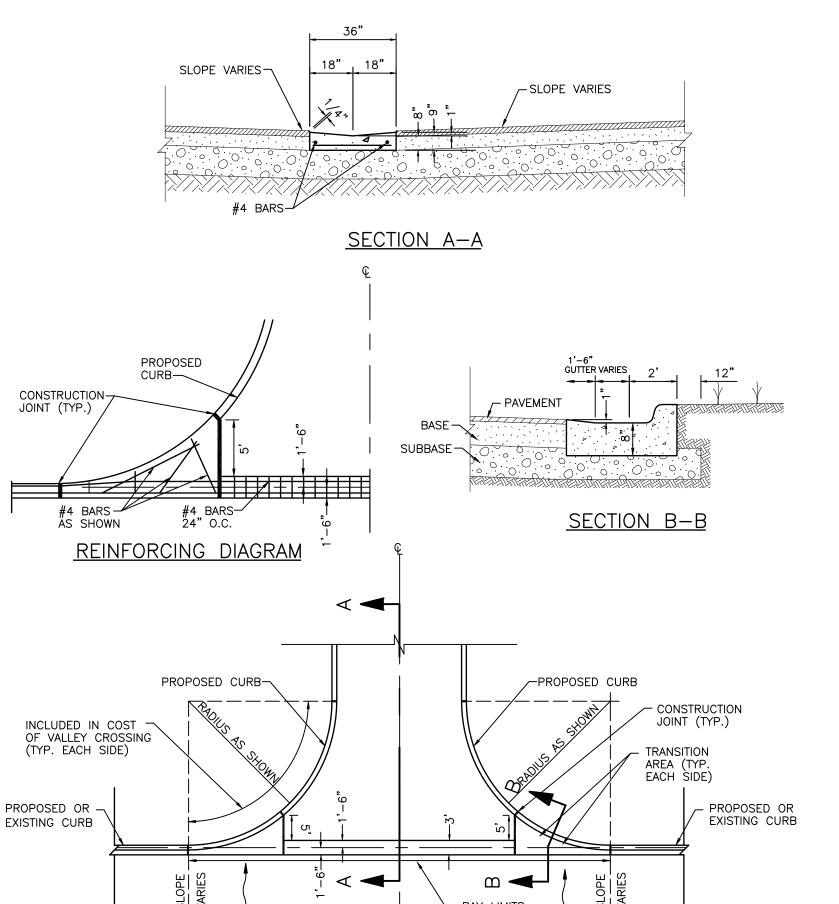

VALLEY CROSSING DETAIL

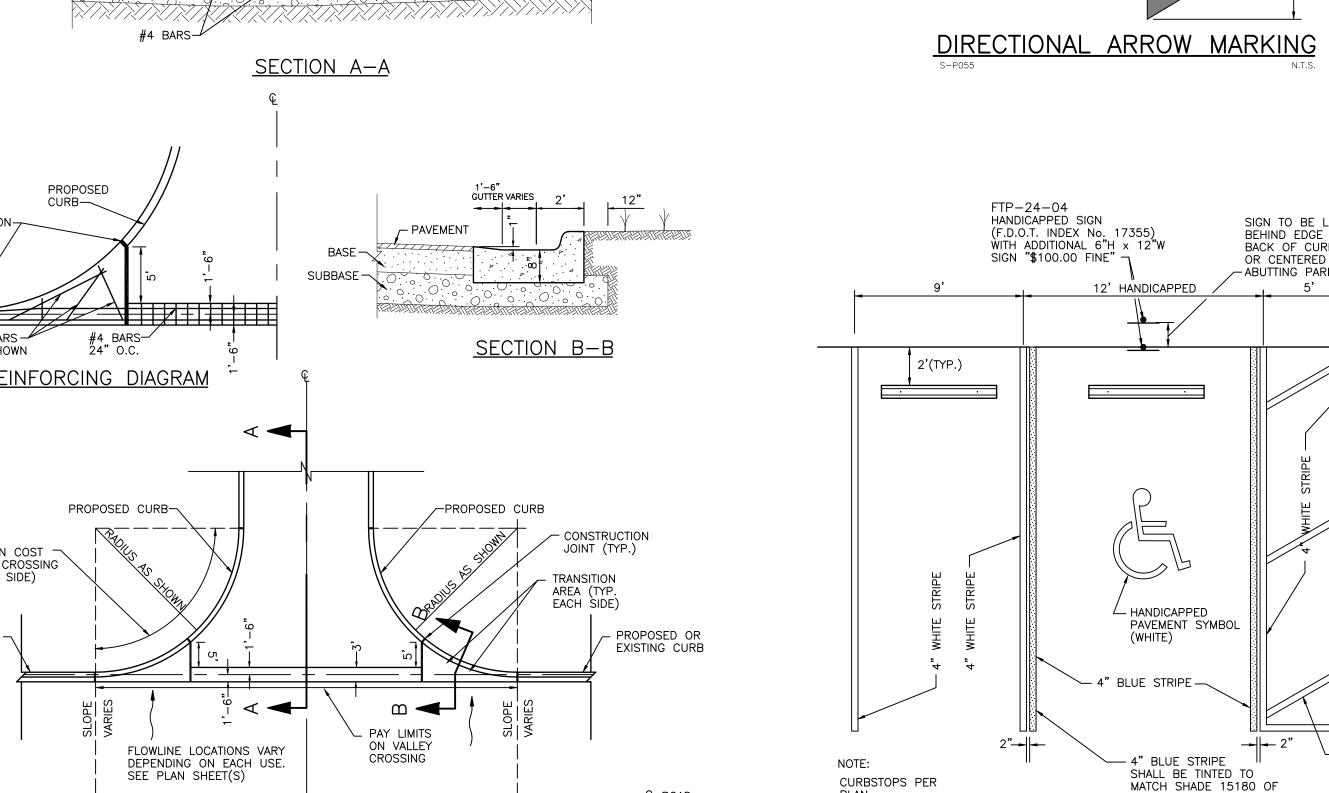

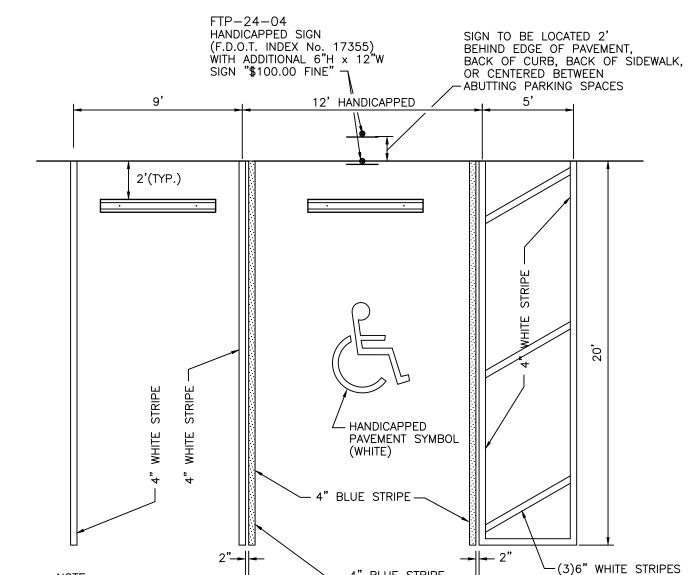

NOTE:
ARROW TO BE PAINTED WHITE AND IN ACCORDANCE
WITH FDOT SECTION 710 — PAINTING TRAFFIC

2'-6"

STRIPES AND MARKINGS




(TYPICAL)


FEDERAL STANDARD 595a


ÈQUALLY SPACED

TYPICAL STOP SIGN DETAIL

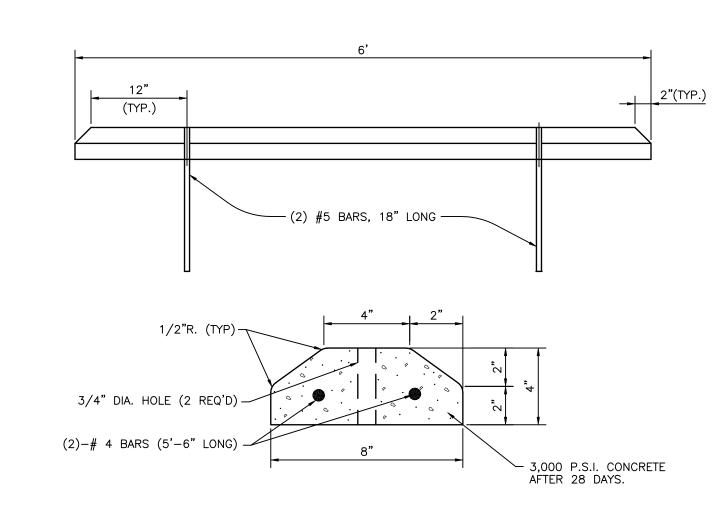


PRECAST CONCRETE WHEEL STOP

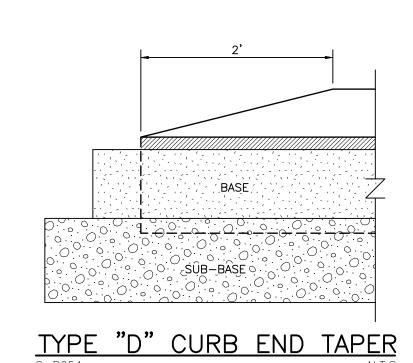


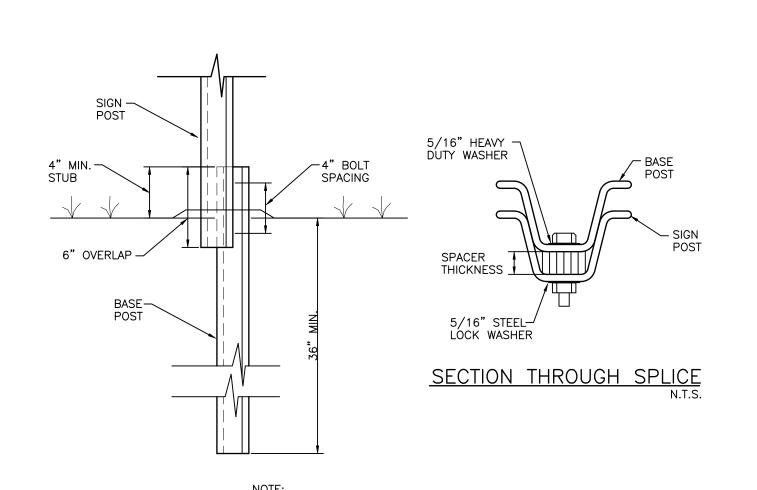

NOTE: ALL MATERIALS AS PER F.D.O.T. SPECIFICATIONS, INDEX NO. 11865, AND ALL APPLICABLE CITY REQUIREMENTS. SIGN POST BREAKAWAY DETAIL

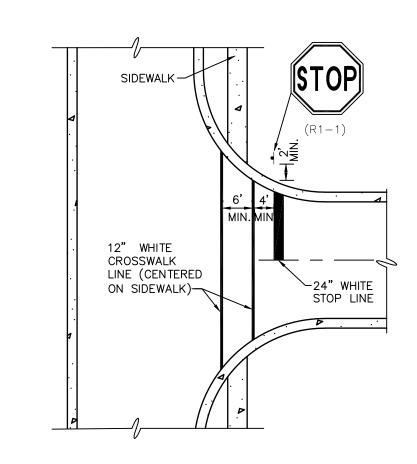


STOP SIGN, STOP LINE AND CROSSWALK LOCATION DETAIL S-P037 (09/07/04)

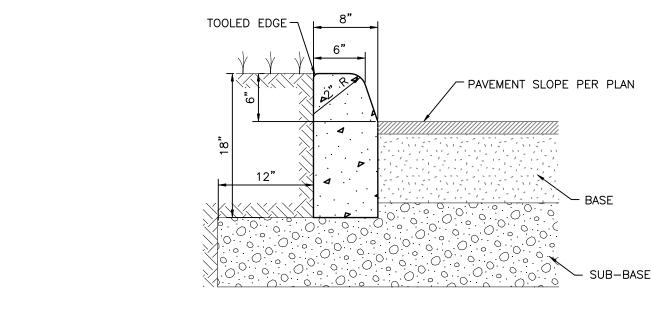


CURB NOTES: 1) CONCRETE SHALL HAVE A COMPRESSIVE STRENGTH OF 3,000 P.S.I. IN 28 DAYS UNLESS OTHERWISE NOTÉD. 2) AN EXPANSION JOINT WILL BE PLACED AT THE END OF ALL RETURNS AT INTERVALS NOT TO EXCEED 50'. CONTRACTION JOINTS AT A MAXIMUM SPACING OF 10' SHALL BE SAW CUT AT DEPTH PER FDOT INDEX NO. 300 3) EXPANSION JOINTS SHALL BE CONSTRUCTED WITH 1/2" BITUMINOUS IMPREGNATED EXPANSION JOINT MATERIAL.


	DESIGNED BY: DRAWN BY: CL	./096591 12/2012	<i>WilsonMiller Se Stantec</i>	CLIENT: MANATEE BOARD OF COUNTY COMMISSIONERS	DECEMBER 2012 HORIZONTAL SCALE: AS SHOWN	PAVING DETAILS	DANIEL J. BOND, P.E. FLORIDA LICENSE NO. 57969
	CHECKED BY:		6000 Professional Parkway Fact Sarasota FL 3/1/10	PROJECT:	VERTICAL SCALE:		D-215611237-010
	CONTRACT ADMIN. BY:		Phone 941-907-6900	BLACKSTONE PARK EXPANSION	SEC: TWP: RGE: CROSS REFERENCE FILE NO.:	PROJECT NUMBER:	SHEET NUMBER:
△REV NO.	REVISION DATE DRAWN BY / EMP. NO. CHECKED BY / EMP. NO. WM APPROVED BY:		Certificate of Authorization #43 ◆ FL Lic. # LC-C000170 ◆ www.stantec.com	DLACKSTONE FAIR EXPANSION	11 34S 17E	215611237	10 of 19
<u> </u>					Jan 10,	2013 - 10:47:44 CLUGO V:\2156\active\215611237\civil\drawing\01_swfw	md\sheet_files\215611237-01C-501PD.dwg

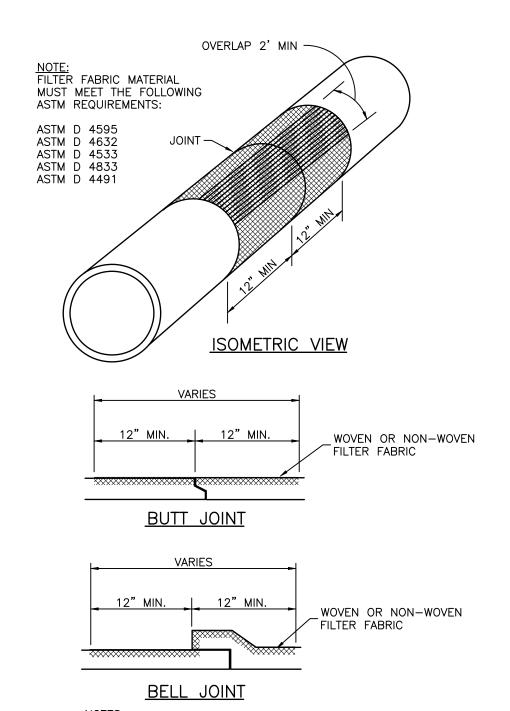

- 1. CENTER FILTER FABRIC ON PIPE JOINT.
- 2. FILTER FABRIC TO OVERLAP A MIN. OF ONE FOOT.
- 3. PRICE OF FILTER FABRIC JACKET TO BE INCLUDED IN PRICE OF PIPE.
- 4. FILTER FABRIC WRAP SHALL ALSO BE PLACED ON THE GROUTED PIPE TO STRUCTURE JOINT PER FDOT INDEX 201


FILTER FABRIC JACKET

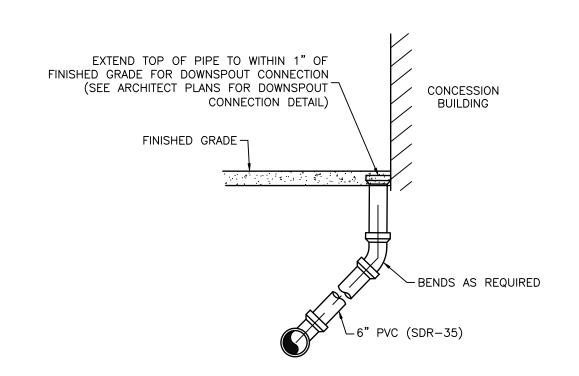


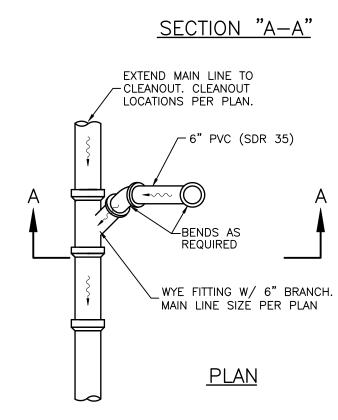


1. CONTRACTOR TO CONFIRM FINAL DOWNSPOUT LOCATIONS PER ARCHITECT'S PLANS. CONTRACTOR TO ADJUST PIPING AS NEEDED TO AVOID BUILDING FOOTER. THE ELBOW PIPE CONNECTOR SHALL BE ABOVE FINISHED GRADE TO ALLOW FOR MAINTENANCE ACCESS TO ROOF DRAIN SERVICE BELOW CONCRETE SLAB.

TYPICAL ROOF DRAIN SERVICE DETAIL

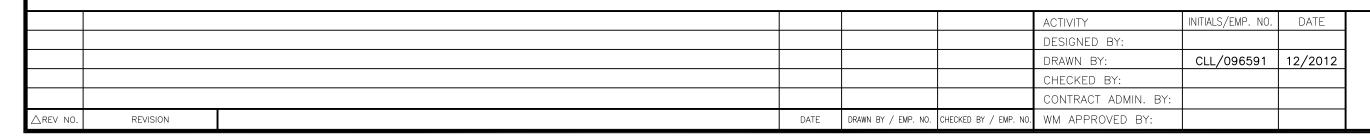

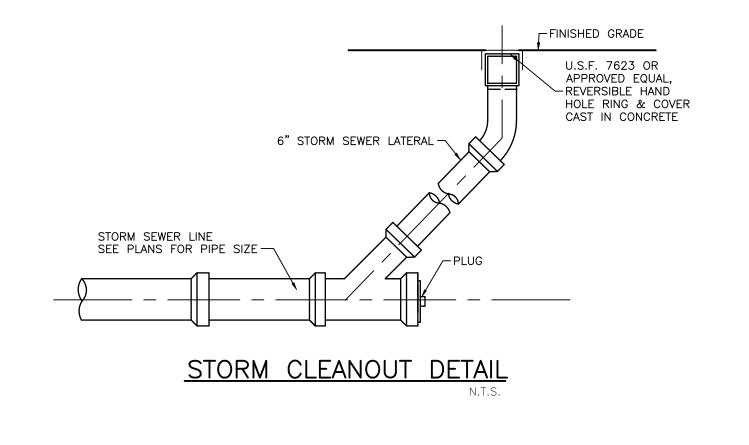

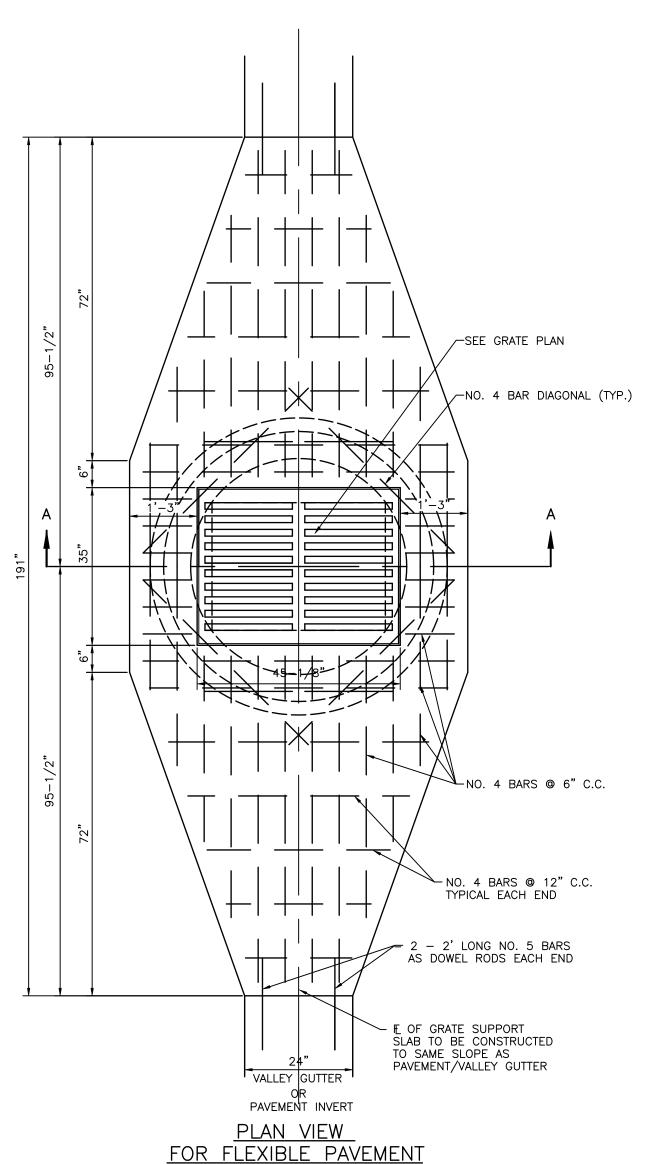


NOTES:


- 1. MATERIAL; GRATE-CAST IRON, FIELD APPLY ONE COAT OF ASPHALTIC PAINT. FRAME-STEEL, FIELD APPLY ONE COAT OF ASPHALTIC PAINT.
- 2. SEE DRAINAGE PLANS AND/OR STORMPIPING PLANS FOR PIPE SIZES, FLOWLINES AND DIRECTION. SEE UNDERDRAIN PLANS AND/OR DRAINAGE PLANS FOR UNDERDRAIN SIZES, FLOWLINES AND DIRECTION.

WITH INVERTED CROWN

3. CONCRETE TEST CYLINDERS (3 MIN) SHALL BE TAKEN FOR EACH DAYS POUR OR EACH 50 YARDS WHICH EVER IS GREATER

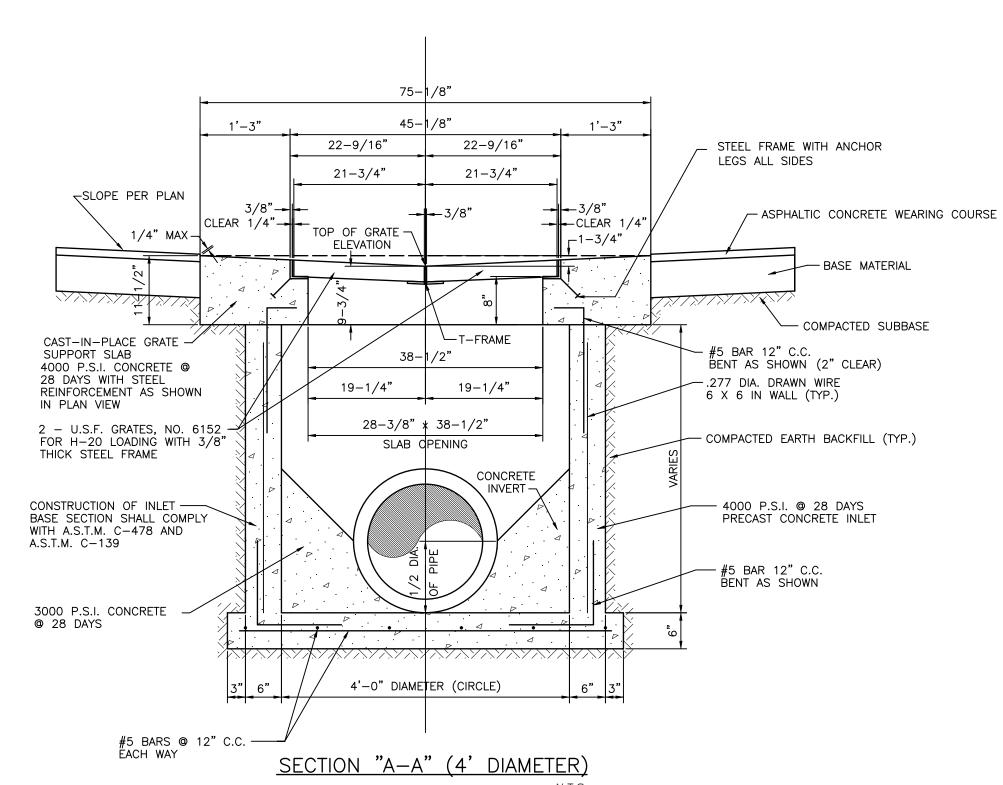

OVERSIZED INLET NOTE: INLETS FOR PIPE LARGER THAN 30" CIRCULAR OR 19" x 30" OVAL SHALL BE CONSTRUCTED AS PER FDOT INDEX #200 ALTERNATE "B". TOP SLAB OF THE FDOT BOX SHALL HAVE A 30" x 40" OPENING. GRATE SUPPORT SHALL BE CONSTRUCTED ABOVE & CENTERED ON THE FDOT INLET BOX AS SHOWN IN THE PLAN VIEW AND SECTION A-A. CONTRACTOR SHALL SUBMIT SHOP DRAWINGS TO ENGINEER FOR APPROVAL. THERE SHALL BE 1/2" OF MORTAR BETWEEN THE GRATE SUPPORT SLAB AND THE TOP SLAB OF THE FDOT INLET BOX.

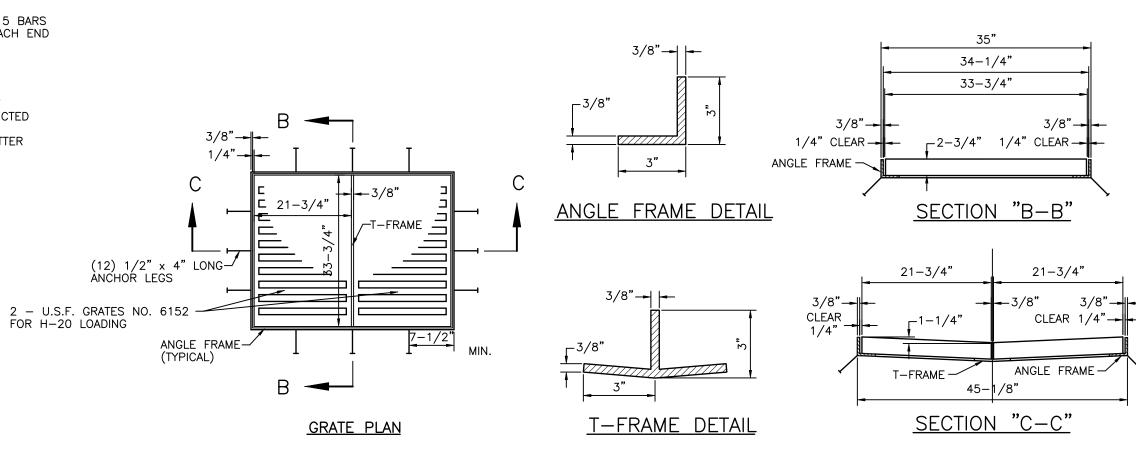

TYPE "J" INLET S-D001(11/18/01) N.T.S.

DECEMBER 2

AS SHOWN

AS SHOWN

1 34S 17E


MANATEE BOARD OF CLIENT: COUNTY COMMISSIONERS PROJECT: BLACKSTONE PARK EXPANSION

DANIEL J. BOND, P.E. FLORIDA LICENSE NO. 57969 DRAINAGE DETAILS D-215611237-011 215611237 11 of 19


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CLEANOUT DETAIL FOR SINGLE UNDERDRAIN FILTER SYSTEM



TYPICAL CONNECTION FOR UNDERDRAIN TO STRUCTURE

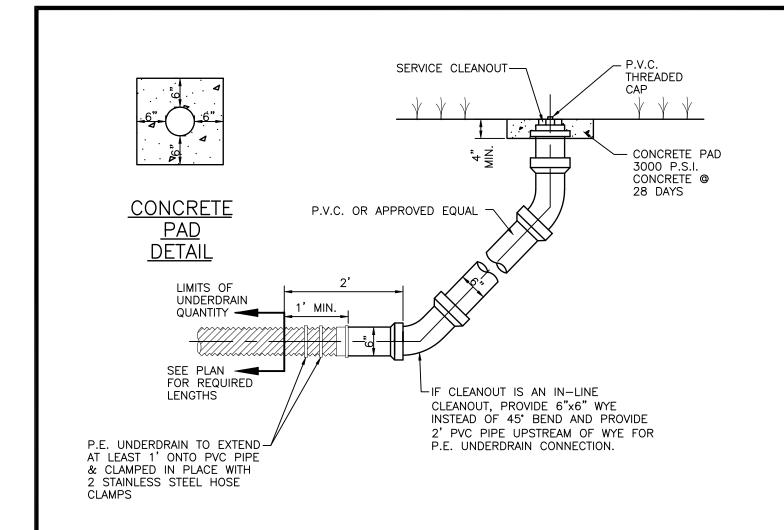30 MIL POLYETHYLENE

GROUNDWATER BARRIER OR

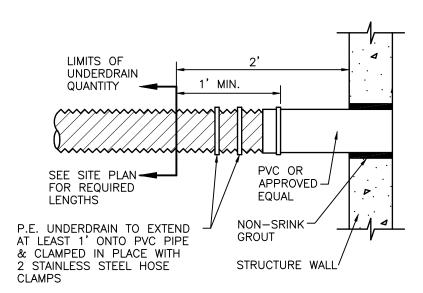APPROVED EQUAL. SEAMS-WELDED SO AS NOT TO

ALLOW WATER LEAKAGE.


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6" POLYETHYLENE

(INV = 6.75 FT-NGVD)

**UNDERDRAIN NOTES:** 

UNDERDRAIN-

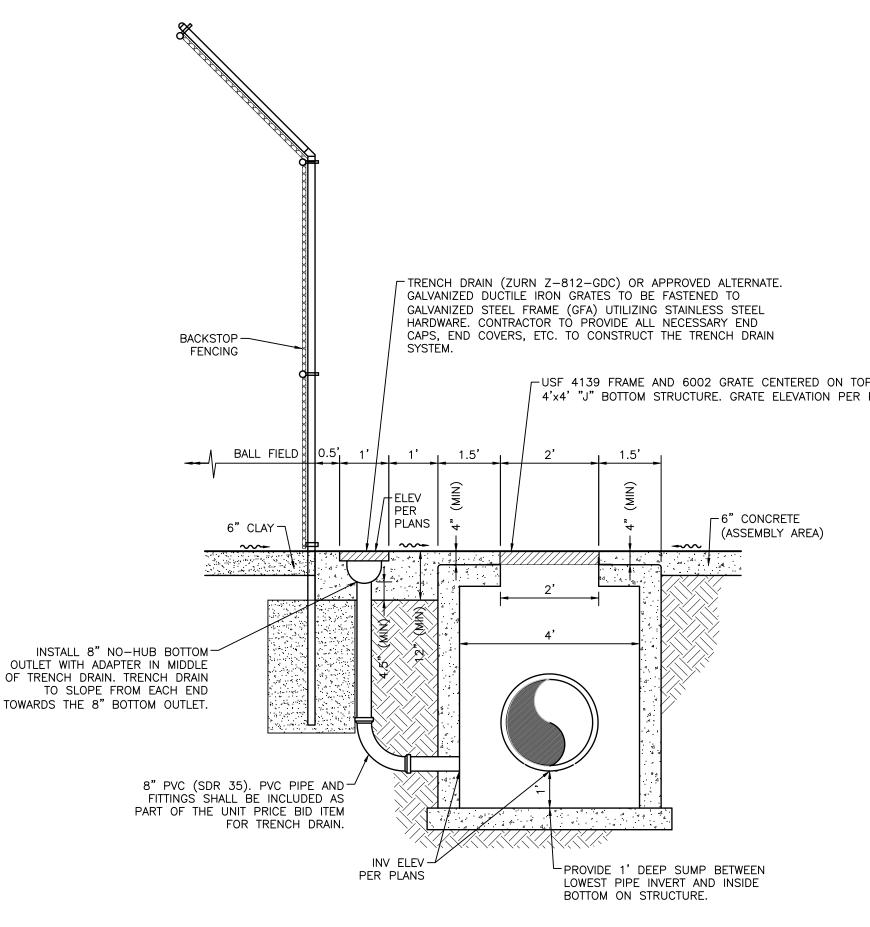

1. ALL CONCRETE SHALL HAVE A COMPRESSIVE STRENGTH OF 4,000 PSI AT 28 DAYS TYPICAL TRENCH DRAIN DETAIL BEHIND BACKSTOP

TYPE "A"

AGGREGATE

-USF 4139 FRAME AND 6002 GRATE CENTERED ON TOP OF 4'x4' "J" BOTTOM STRUCTURE. GRATE ELEVATION PER PLAN.

INSTALLED FILTER SOCK TO EXTEND AT LEAST 1' ONTO PVC PIPE & CLAMPED IN PLACE WITH 2 STAINLESS STEEL HOSE CLAMPS.

LIMITS OF

QUANTITY -

SEE PLAN

P.E. UNDERDRAIN WITH FACTORY

UNDERDRAIN

FOR REQUIRED

LENGTHS

BALL FIELD I → BALL FIELD FENCING -PVC THREADED CAP SEE TYPICAL SECTION-FOR BALL FIELD TURF - x -- x -- x -- x -- x --UNDERDRAIN CONCRETE PAD QUANTITY 3,000 PSI CONCRETE @ 28 DAYS SEE PLAN FOR REQUIRED LENGTHS P.E. UNDERDRAIN WITH FACTORY 6" PE UNDERDRAIN WITH-INSTALLED FILTER SOCK TO EXTEND FACTORY INSTALLED FILTER SOCK AT LEAST 1' ONTO PVC PIPE & (INV ELEV PER PLAN). PROVIDE CLAMPED IN PLACE WITH 2 6" X 6" WYE OR 6" X 6" TEE STAINLESS STEEL HOSE CLAMPS. WHERE CLEANOUT LOCATIONS ARE SHOWN PER PLAN (SEE NOTE 3) PROFILE VIEW


-CONCRETE PAD

- 1. UNDERDRAIN SHALL BE SLOTTED POLYETHYLENE CORRUGATED PIPE PER ASTM F-405-77 OR AASHTO M-252 HAVING A MINIMUM SLOTTED AREA OF 1 SQ.IN./FT OF PIPE MANUFACTURED BY ADS (OR APPROVED ALTERNATE).
- 2. CONTRACTOR TO FIELD ADJUST CLEANOUT LOCATIONS AS NEEDED TO AVOID FENCE
- 3. 6" X 6" WYE TO BE REPLACED WITH 6" X 6" TEE (TWO WAY CLEANOUT STYLE) ONLY WHERE SPECIFICALLY CALLED FOR ON THE PLANS.

ANGLE FRAME DETAIL

## BALL FIELD UNDERDRAIN/UNDERDRAIN CLEANOUT DETAIL

41 1/4"

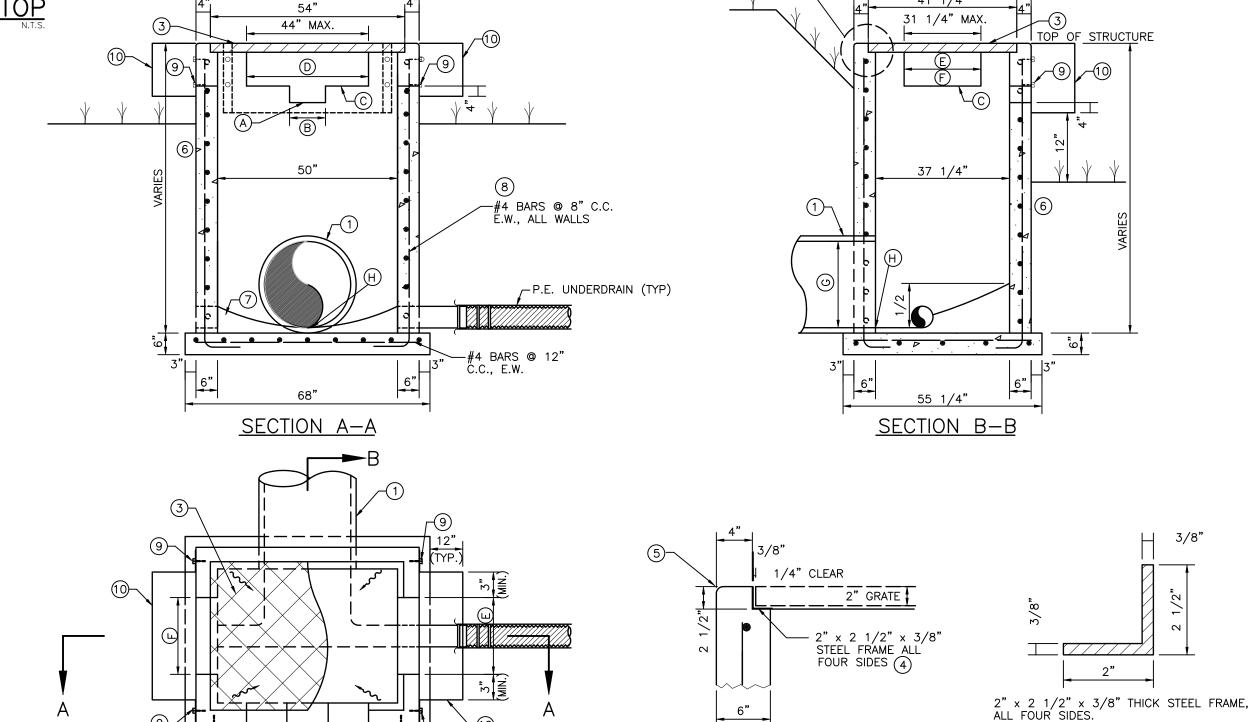

-FENCE POST

(SEE NOTE 2)

—— × — × — × — ×

(SEE NOTE 3)

6" PVC (SDR 35)-

PLAN VIEW

- 1) SEE STORM PIPING PLAN DRAWINGS FOR PIPE SIZE, ALIGNMENT, FLOWLINE AND GRATE ELEVATIONS
- 2 BENCH MARK REQUIRED TO BE SET ON STRUCTURE AFTER CONSTRUCTION IS COMPLETE. ELEVATION TO BE NOTED IN RECORD DRAWINGS.
- (3) U.S.F. GRATE NO. 6615 (STEEL  $40^{\circ} \times 52 \ 11/16^{\circ} \times 2^{\circ}$ )
- FRAME & GRATE SHALL BE OF STEEL CONSTRUCTION COATED WITH 2 APPLICATIONS OF BLACK ENAMEL, 4.0 MILS DRY FILM THICKNESS EACH COAT, 8 MILS TOTAL. COATING SHALL MEET OR EXCEED FDOT SPECIFICATION 971-8. CONTRACTOR SHALL APPLY ONE FIELD COAT TO ANY BARE AREAS AS DETERMINED BY ENGINEER.
- (5) 3/4" CHAMFER ALL EXPOSED EDGES.
- 6 3000 PSI CONCRETE @ 28 DAYS SHALL BE USED THROUGHOUT.
- 7) POURED CONCRETE INVERT AFTER INLET AND PIPE PLACED IN GROUND, 3000 PSI @ 28 DAYS.
- (8) REINFORCING STEEL SHALL BE INTERMEDIATE GRADE BILLET WITH DEFORMATIONS CONFORMING TO ASTM A-615-76A. ALL STEEL SHALL BE 1 1/2" CLEAR UNLESS OTHERWISE NOTED.
- 3/8" DIAMETER STAINLESS STEEL EXPANSION ANCHORS, 3" LONG MINIMUM WITH STAINLESS STEEL WASHERS AND NUTS. IF HEIGHT OF SKIMMER IS 12" OR LESS, 2 EACH SIDE REQUIRED. IF SKIMMER IS OVER 12" HEIGHT, SPACE BOLTS ONE FOR EACH 6" C.C. MAXIMUM SPACING EACH SIDE OF
- (10) 3/16" THICK STAINLESS STEEL, 1/4" THICK ALUMINUM OR 3/16" "GLASKIMER" HSS-HIGH STRENGTH COMPOSITE SHEET SKIMMER PLATE WITH OPEN TOP AND BOTTOM. SKIMMER TO EXTEND 4"

BY ENGINEER OR HIS REPRESENTATIVE.

- BELOW NOTCH ELEVATION. STAKEOUT POINT TO BE CENTER OF STRUCTURE. FIELD LOCATION TO FIT LAKE BANK OR FILL SLOPE MAY BE NECESSARY. LOCATION TO BE REVIEWED
- (12) PROVIDE MINIMUM 6" CLEARANCE UNDER SKIMMER.

|                     | <u>PLAI</u>                           | <u> </u>                         |                                       |                                |                                     | DAT                             | A TABLE                         |                                 |                                          |                           |                                                                       |
|---------------------|---------------------------------------|----------------------------------|---------------------------------------|--------------------------------|-------------------------------------|---------------------------------|---------------------------------|---------------------------------|------------------------------------------|---------------------------|-----------------------------------------------------------------------|
| STRUCTURE<br>NUMBER | NORMAL<br>WATER<br>LEVEL<br>(FT-NGVD) | TOP<br>GRATE<br>EL.<br>(FT-NGVD) | A<br>FL. EL. OF<br>NOTCH<br>(FT-NGVD) | B<br>WIDTH OF<br>NOTCH<br>(FT) | C<br>FL. EL.<br>WINDOW<br>(FT-NGVD) | ©<br>WIDTH OF<br>WINDOW<br>(FT) | E<br>WIDTH OF<br>WINDOW<br>(FT) | F<br>WIDTH OF<br>WINDOW<br>(FT) | G<br>DIAMETER OF<br>OUTFALL PIPE<br>(IN) | H) PIPE FL. EL. (FT-NGVD) | SPECIAL REMARKS                                                       |
| SCS-1               | N/A                                   | 11.40                            | N/A                                   | N/A                            | 8.84                                | 0.36                            | N/A                             | N/A                             | 30                                       | 4.70                      | SKIMMER REQUIRED ALL WINDOWS UNDERDRAIN REQUIRED (INV = 6.75 FT-NGVD) |
|                     |                                       |                                  |                                       | <u>TY</u> F                    | PE "G" (                            | CONTRO                          | L STRU                          | CTURE                           |                                          |                           |                                                                       |

DETAIL "A"

### TYPICAL SHALLOW BOTTOM TREATMENT UNDERDRAIN

2'MIN

AGGREGATE

TYPE "A" AGGREGATE: FILTER AGGREGATE FOR UNDERDRAINS SHALL CONSIST OF WASHED MATERIAL MEETING FDOT ROAD & BRIDGE SPECIFICATIONS FOR SILICA SAND & QUARTZ GRAVEL CONTAINING LESS

TYPE "B" AGGREGATE: 3/4" TO 1" STONE, RIVER GRAVEL OR EQUAL (NO LIMEROCK, MARL, OR SIMILAR MATERIAL).

FILTER FABRIC: FILTER FABRIC SHALL BE WOVEN GEOTEXTILE, AMOCO 1198 SYNTHETIC INDUSTRIES EROSION 1

UNDERDRAIN: THE UNDERDRAIN SHALL BE SLOTTED POLYETHYLENE CORRUGATED PIPE A.S.T.M F-405-77 OR

OF THE AGGREGATE SHALL BE MINIMUM OF 8 FT/HR.

THAN 1% (BY WEIGHT) OF SILT, CLAY AND ORGANIC MATTER. SAID MATERIAL SHALL HAVE

MILLIMETER AND SIEVE ANALYSIS (IN PERCENT OF TOTAL WEIGHT PASSING) AS FOLLOWS:

3/8" = 95 - 100%

 $\dot{NO}$ . 4 = 95 - 100%

NO. 8 = 85 - 100%

NO. 16 = 65 - 97%NO. 30 = 25 - 70%NO. 50 = 5 - 35%

NO. 200 = MAX. 1%THE AGGREGATE SHALL BE FREE OF ORGANIC MATTER AND OTHER DELETERIOUS MATERIALS.

WASHED SHELL & LIMEROCK SHALL NOT BE USED FOR FILTER AGGREGATE. PERMEABILITY

A.A.S.H.T.O. M-252 HAVING A MINIMUM SLOTTED AREA OF 1 SQ. IN./FT. OF PIPE MANUFACTURED BY A.D.S. OR HANCOR. NO FACTORY INSTALLED SOCK SHALL BE INSTALLED WITH THIS UNDERDAIN.

PERFORMED BY AN INDEPENDENT TESTING LABORATORY PRIOR TO DELIVERY OF THE FILTER AGGREGATE MATERIAL ON SITE. FAILURE TO MEET THE SPECIFIED PERMEABILITY OR SIEVE ANALYSIS WILL BE CAUSE FOR REJECTION OF THE MATERIAL. THE CONTRACTOR SHALL ALSO PROVIDE THE ENGINEER WITH SIEVE ANALYSIS & PERCOLATION TEST RESULTS OF THE FILTER AGGREGATE RECEIVED AT THE SITE PRIOR TO IT BEING PUT IN PLACE. THIS TEST SHALL BE PERFORMED BY AN INDEPENDENT TESTING LABORATORY.

TESTING: THE CONTRACTOR SHALL PROVIDE THE ENGINEER WITH SIEVE ANALYSIS & PERCOLATION TEST RESULTS

UNIFORMITY COEFFICIENT OF 1.5 OR GREATER, AN EFFECTIVE GRAIN SIZE OF 0.20 - 0.55

2'MIN

30 MIL POLYETHYLENE GROUNDWATER

SEAMS WELDED SO AS NOT TO ALLOW

BARRIER OR APPROVED EQUAL.

WATER LEAKAGE.

TYPE "B"

AGGREGATE

|          |          |      |                     |                       | ACTIVITY            | INITIALS/EMP. NO. | DATE    |
|----------|----------|------|---------------------|-----------------------|---------------------|-------------------|---------|
|          |          |      |                     |                       | DESIGNED BY:        |                   |         |
|          |          |      |                     |                       | DRAWN BY:           | CLL/096591        | 12/2012 |
|          |          |      |                     |                       | CHECKED BY:         |                   |         |
|          |          |      |                     |                       | CONTRACT ADMIN. BY: |                   |         |
| △REV NO. | REVISION | DATE | DRAWN BY / EMP. NO. | CHECKED BY / EMP. NO. | WM APPROVED BY:     |                   |         |

OR APPROVED EQUAL.


WilsonMiller S Stantec Phone 941-907-6900 • Fax 941-907-6910


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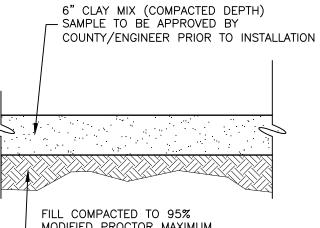
| ENT:   | MANATEE BOARD OF           | DATE: DECEMBER 2012         | TITLE:     |
|--------|----------------------------|-----------------------------|------------|
|        | COUNTY COMMISSIONERS       | HORIZONTAL SCALE:  AS SHOWN |            |
| OJECT: |                            | VERTICAL SCALE:             |            |
| OULC1. |                            | AS SHOWN                    |            |
|        | BLACKSTONE PARK EXPANSION  | SEC: TWP: RGE:              | CROSS REFE |
|        | DE TOTOTOTE TANKE EATAMONT | 11 34S 17E                  |            |
|        |                            |                             |            |

DRAINAGE DETAILS DANIEL J. BOND, P.E. FLORIDA LICENSE NO. 57969 D-215611237-012 215611237 12 of 19

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FILL COMPACTED TO 95%

— MODIFIED PROCTOR MAXIMUM DRY DENSITY (AASHTO T-180)

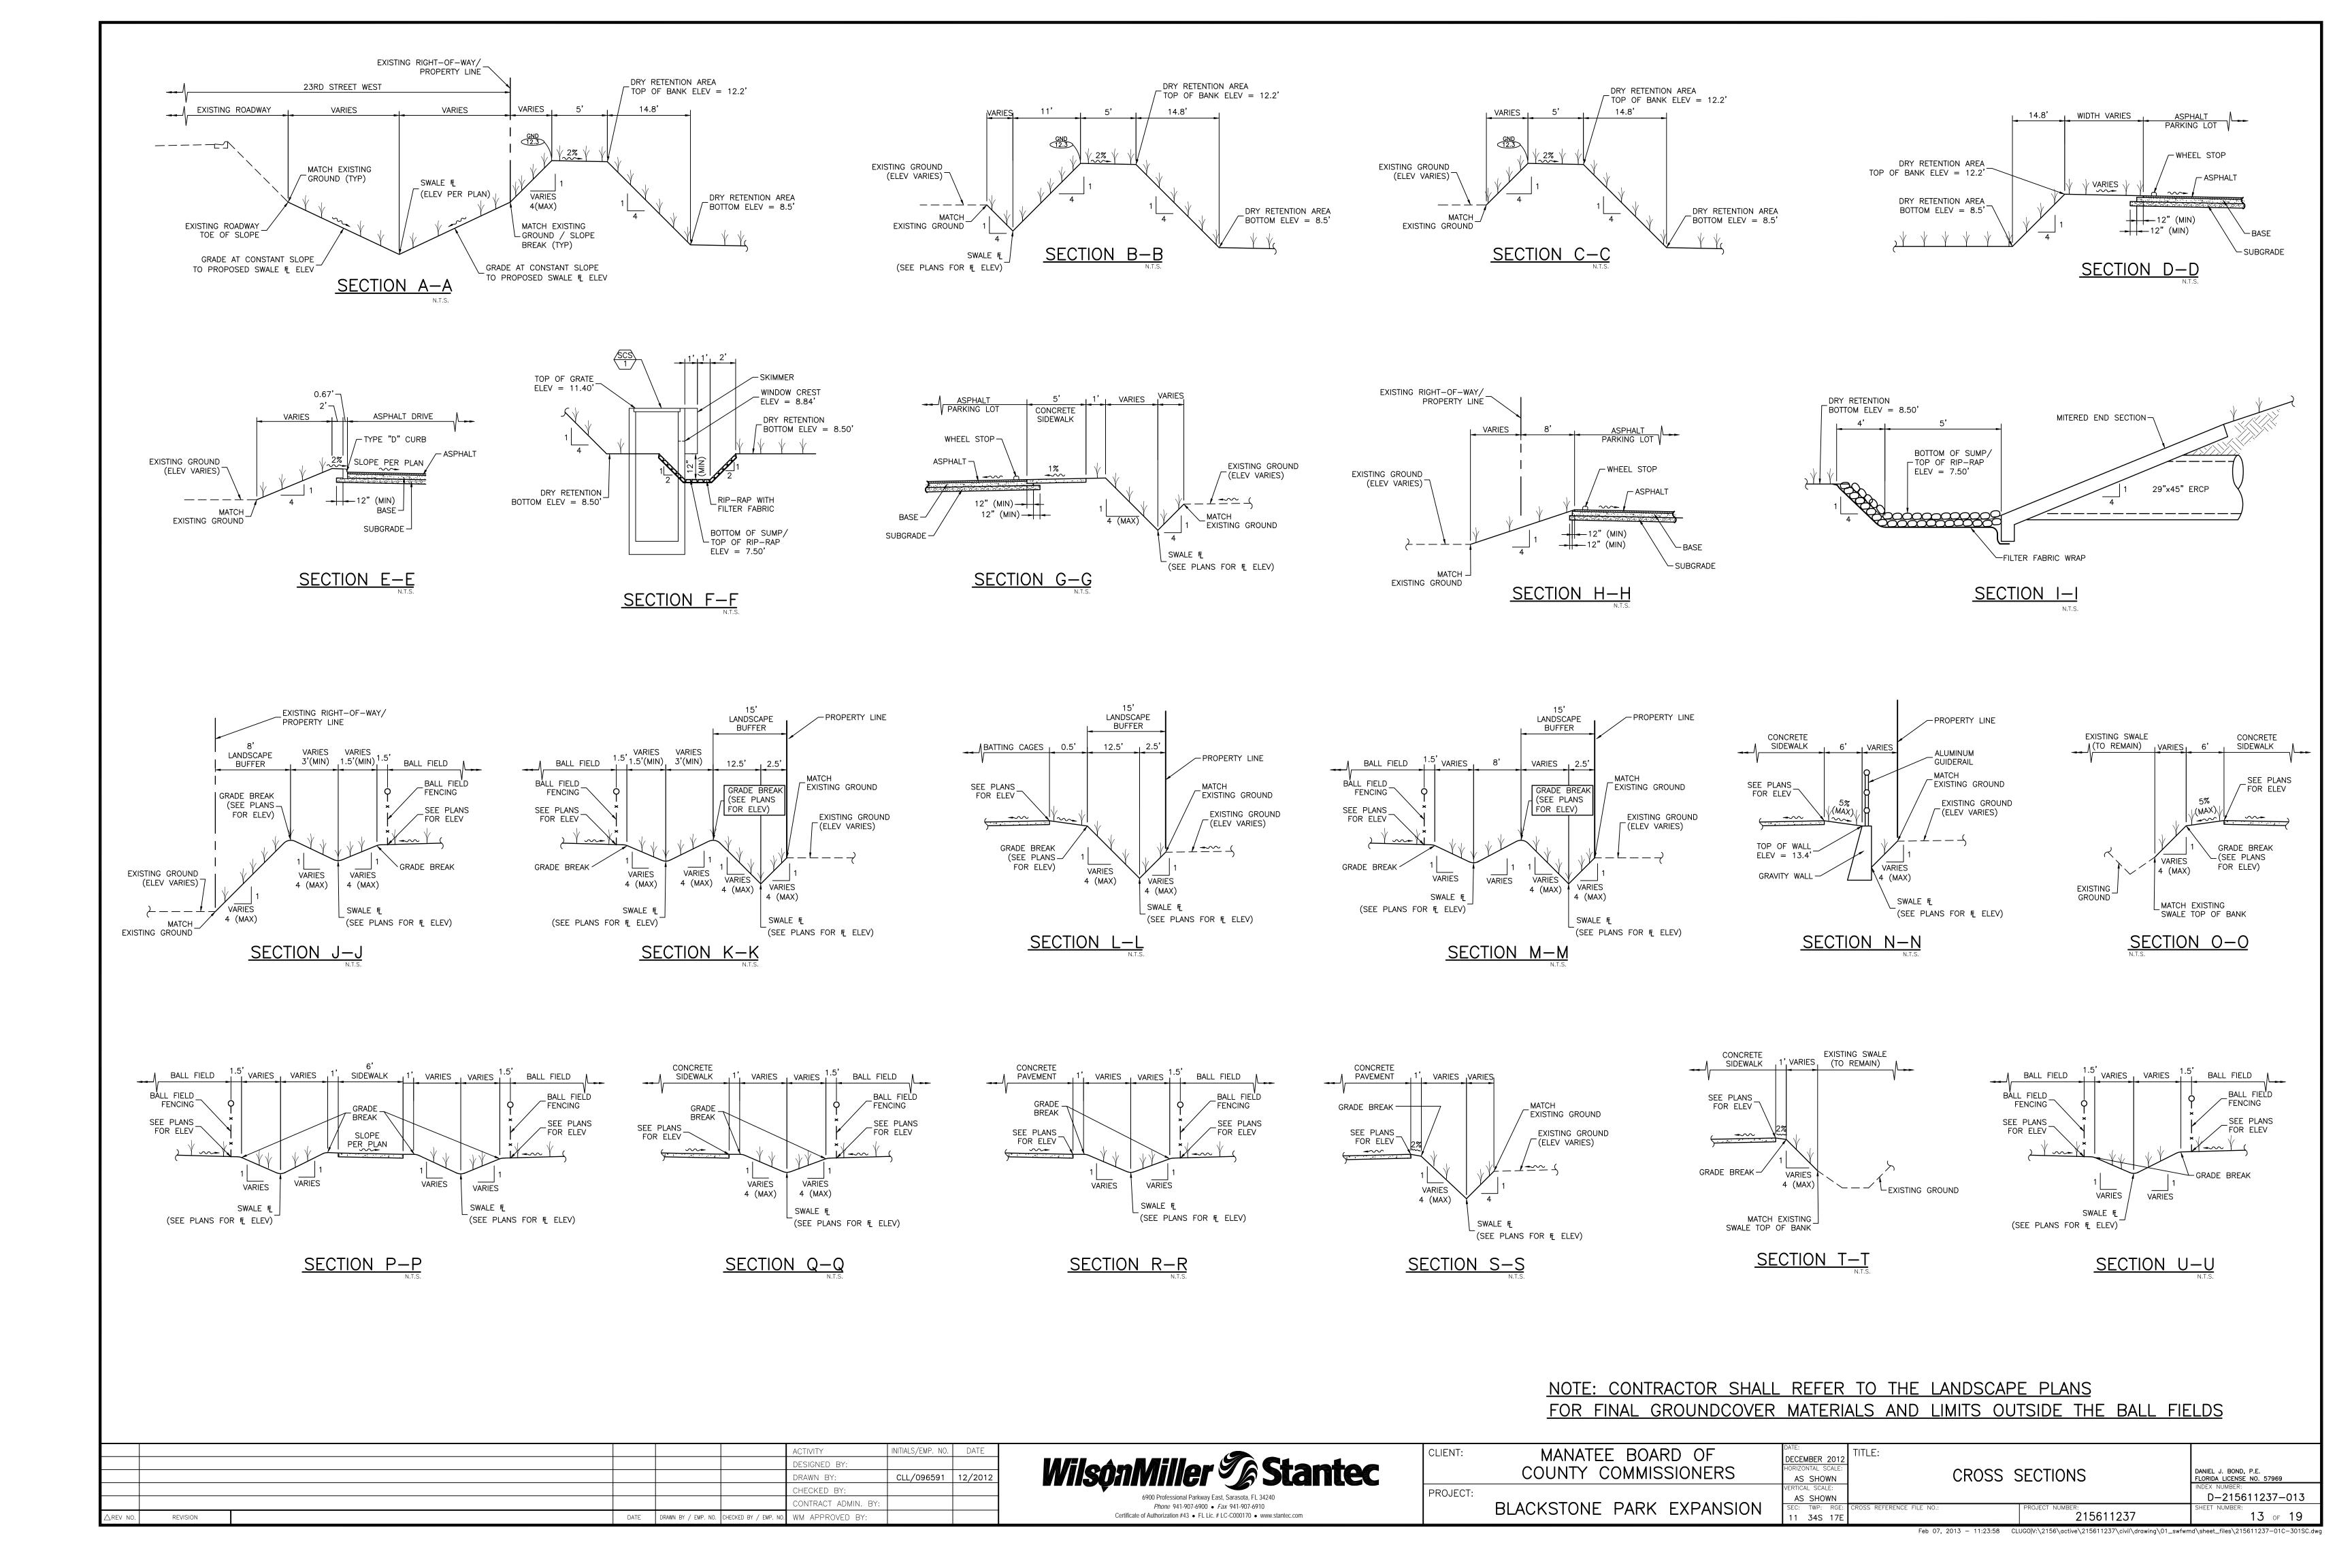
NOTE: CLAY TO BE ROLLED.
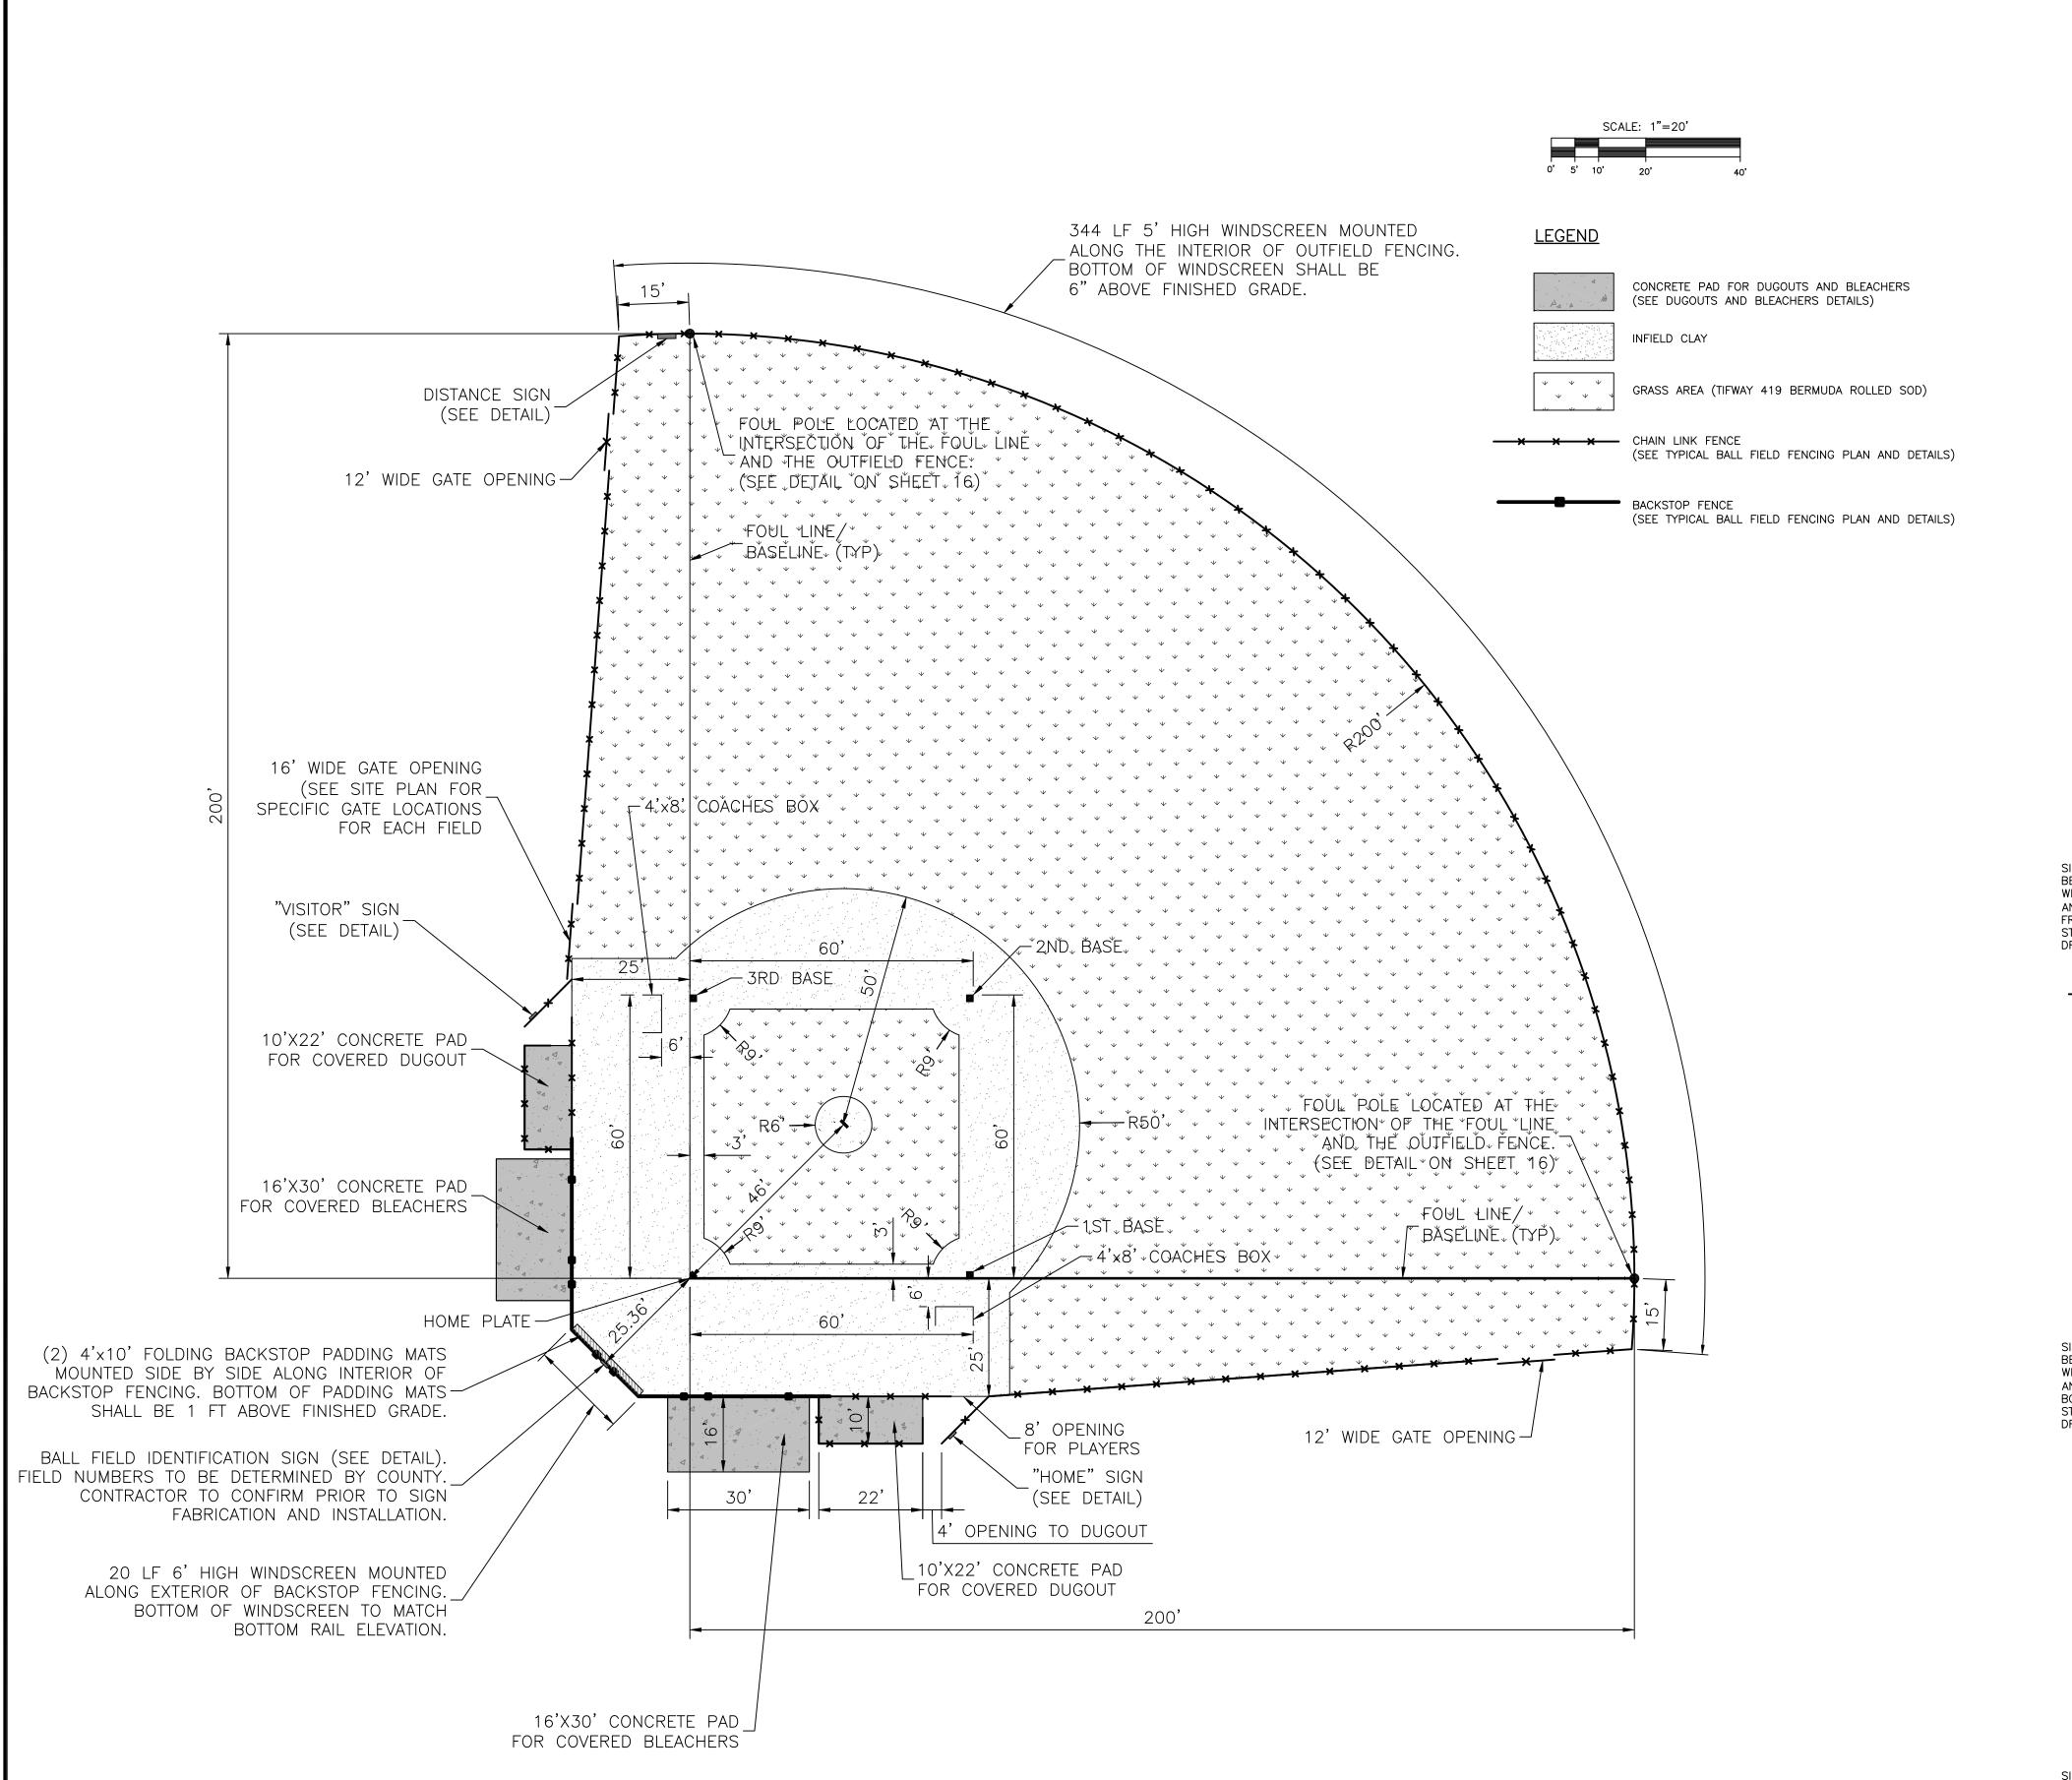
#### **CLAY SECTION**

1. CLAY COMPOSITION SHALL BE NO LESS THAN 80% CLAY/20% SAND, MIX AS SUPPLIED BY TURBO LINK INTERNATIONAL INC. OR APPROVED ALTERNATE. BALL FIELD CLAY SHALL BE WELL GRADED CLAYEY SAND ("SC") WITH BETWEEN 17.5% AND 22.5% OF MATERIAL PASSING A #200 SIEVE. NO MATERIAL TO BE RETAINED ON A #10 SIEVE. SUBMIT 2 GALLON SAMPLE AND SIEVE ANALYSIS (ASTM C136 AND D422) FROM AN INDEPENDENT TESTING COMPANY TO ENGINEER FOR APPROVAL PRIOR TO ORDERING MATERIAL.


2. MATERIALS AND INSTALLATION PROCEDURES SHALL BE SUBJECT TO

- ENGINEERS REVIEW AND APPROVAL PRIOR TO COMMENCEMENT.
- 3. GRADING SHALL BE AS PER PAVING AND DRAINAGE PLAN.

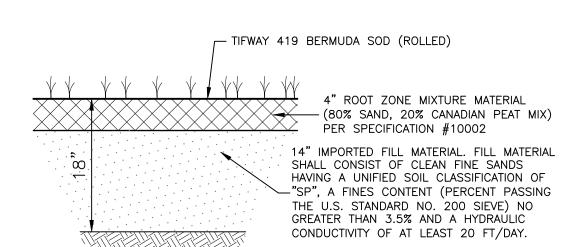

#### TYPICAL SECTION FOR BALL FIELD TURF

- 1. THE CONTRACTOR SHALL PROVIDE THE ENGINEER WITH SIEVE ANALYSIS, UNIFIED SOIL CLASSIFICATION, AND PERCOLATION TEST RESULTS PERFORMED BY AN INDEPENDENT TESTING LABORATORY PRIOR TO THE ONSITE DELIVERY OF THE 14" IMPORTED FILL MATERIAL UNDERNEATH THE BALL FIELD TURF. FAILURE TO MEET THE SPECIFIED HYDRAULIC CONDUCTIVITY, SOIL CLASSIFICATION, OR SIEVE ANALYSIS WILL BE CAUSE FOR REJECTION OF THE MATERIAL. THE FREQUENCY OF TESTING SHALL BE A MINIMUM OF 1 TEST REPORT FOR EVERY 450 CY OF FILL MATERIAL TO BE BROUGHT TO THE SITE.
- 2. PRIOR TO INSTALLATION OF THE BALL FIELD SOD, THE CONTRACTOR SHALL PROVIDE THE ENGINEER WITH SIEVE ANALYSIS, UNIFIED SOIL CLASSIFICATION, AND PERCOLATION TEST RESULTS PERFORMED BY AN INDEPENDENT TESTING LABORATORY OF THE IN-PLACE 14" IMPORTED FILL MATERIAL. FAILURE TO MEET THE SPECIFIED HYDRAULIC CONDUCTIVITY, SOIL CLASSIFICATION, OR SIEVE ANALYSIS WILL BE CAUSE FOR REJECTION OF THE MATERIAL. THE FREQUENCY OF TESTING SHALL BE A MINIMUM OF 5 TEST REPORTS FOR EACH

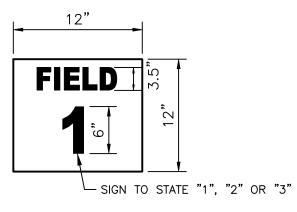


SIGN MATERIAL SHALL BE ALUMINUM. LETTERS AND BACKGROUND SHALL BE OF A REFLECTIVE MATERIAL. LETTERS ARE TO BE DARK GREEN ON A WHITE BACKGROUND. SIGNS SHALL BE MOUNTED ON FENCE WITH BOLTS AND BACK PLATES (EACH CORNER). MOUNTING HEIGHT SHALL BE 11' FROM BOTTOM OF SIGN TO FINISHED GRADE. ALL HARDWARE SHALL BE STAINLESS STEEL OR GALVANIZED. CONTRACTOR TO SUBMIT SHOP DRAWINGS OF SIGN FOR REVIEW AND APPROVAL PRIOR TO FABRICATION.

BALL FIELD IDENTIFICATION SIGN DETAIL


#### **SPECIFICATIONS:**

- 1. PITCHER'S PLATE: JAYPRO SPORTS LITTLE LEAGUE PROFESSIONAL PITCHING RUBBER (6"X18"), PR-618 (OR APPROVED ALTERNATE)
- 2. HOME PLATE: ROGERS ONE TIME HOME PLATE, RHP-1 (OR APPROVED ALTERNATE)
- 3. BASES: ROGERS BREAK AWAY BASE SET YOUTH, RBBS-Y (OR APPROVED ALTERNATE)
- 4. BACKSTOP PADDING: BSN SPORTS FOLDING BACKSTOP PADDING MATS 4'x10'(EACH), 1150964 - ROYAL BLUE IN COLOR (OR APPROVED ALTERNATE). PADDING SHALL BE MOUNTED TO BACKSTOP ALONG TOP, BOTTOM, AND SIDES UTILIZING STAINLESS STEEL OR GALVANIZED S-HOOKS IN ACCORDANCE WITH MANUFACTURER RECOMMENDATIONS.
- 5. WINDSCREENS: BSN SPORTS POLYESTER OUTFIELD WINDSCREENS, 5' HIGH (1158670) OR 6' HIGH (1170610) AS SPECIFIED PER PLAN - ROYAL BLUE IN COLOR (OR APPROVED ALTERNATE). WINDSCREEN SHALL BE MOUNTED TO FENCING USING 7" SELF-LOCK TIE WRAPS (MTTWRAPS) EVERY 12" TO 18" PER MANUFACTURER RECOMMENDATIONS.

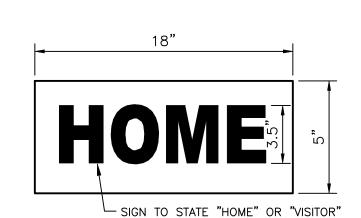


SIGN MATERIAL SHALL BE ALUMINUM. LETTERS AND BACKGROUND SHALL BE OF A REFLECTIVE MATERIAL. LETTERS ARE TO BE DARK GREEN ON A WHITE BACKGROUND. SIGNS SHALL BE MOUNTED ON FENCE WITH BOLTS AND BACK PLATES (EACH CORNER). MOUNTING HEIGHT SHALL BE 5' FROM BOTTOM OF SIGN TO FINISHED GRADE. ALL HARDWARE SHALL BE STAINLESS STEEL OR GALVANIZED. CONTRACTOR TO SUBMIT SHOP DRAWINGS OF SIGN FOR REVIEW AND APPROVAL PRIOR TO FABRICATION.

## HOME/VISITOR SIGN DETAIL

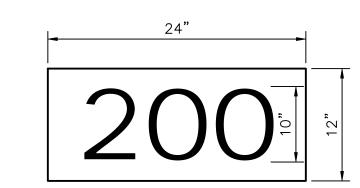

SIGN MATERIAL SHALL BE ALUMINUM. LETTERS AND BACKGROUND SHALL BE OF A REFLECTIVE MATERIAL. LETTERS ARE TO BE WHITE ON A DARK GREEN BACKGROUND. DISTANCES FOR SIGNS ARE AS SHOWN (ONE SIGN PER FIELD). SIGNS SHALL BE MOUNTED ON FENCE WITH BOLTS AND BACK PLATES (EACH CORNER). MOUNTING HEIGHT SHALL BE 4' FROM TOP OF SIGN TO FINISHED GRADE. ALL HARDWARE SHALL BE STAINLESS STEEL OR GALVANIZED. CONTRACTOR TO SUBMIT SHOP DRAWINGS OF SIGN FOR REVIEW AND APPROVAL PRIOR TO FABRICATION.

DISTANCE SIGN DETAIL

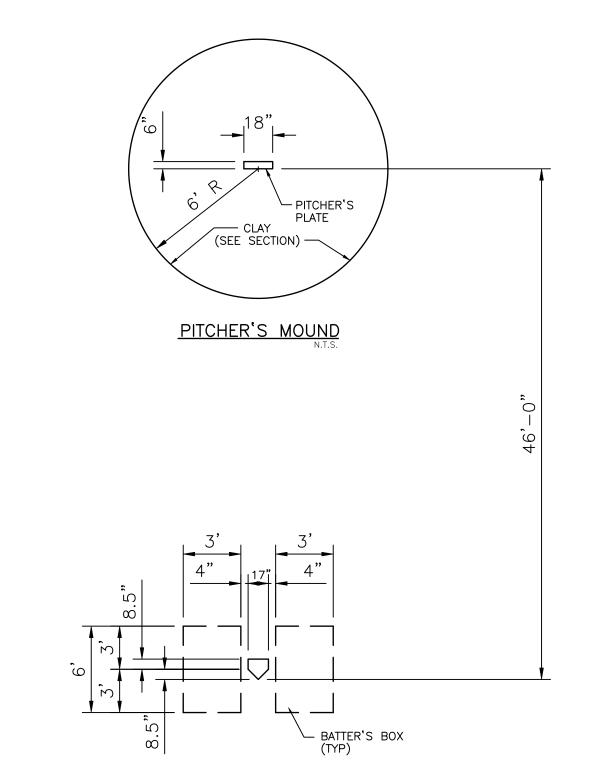

#### HOME PLATE

HOME PLATE / PITCHER'S MOUND DETAIL

|          |          |      |                     |                       | ACTIVITY            | INITIALS/EMP. NO. | DATE  |
|----------|----------|------|---------------------|-----------------------|---------------------|-------------------|-------|
|          |          |      |                     |                       | DESIGNED BY:        |                   |       |
|          |          |      |                     |                       | DRAWN BY:           | CLL/096591        | 12/20 |
|          |          |      |                     |                       | CHECKED BY:         |                   |       |
|          |          |      |                     |                       | CONTRACT ADMIN. BY: |                   |       |
| △REV NO. | REVISION | DATE | DRAWN BY / EMP. NO. | CHECKED BY / EMP. NO. | WM APPROVED BY:     |                   |       |

| Wilse | nMiller Stantec                                    |
|-------|----------------------------------------------------|
| •     | 6900 Professional Parkway East, Sarasota, FL 34240 |
|       | Phone 941-907-6900 • Fax 941-907-6910              |

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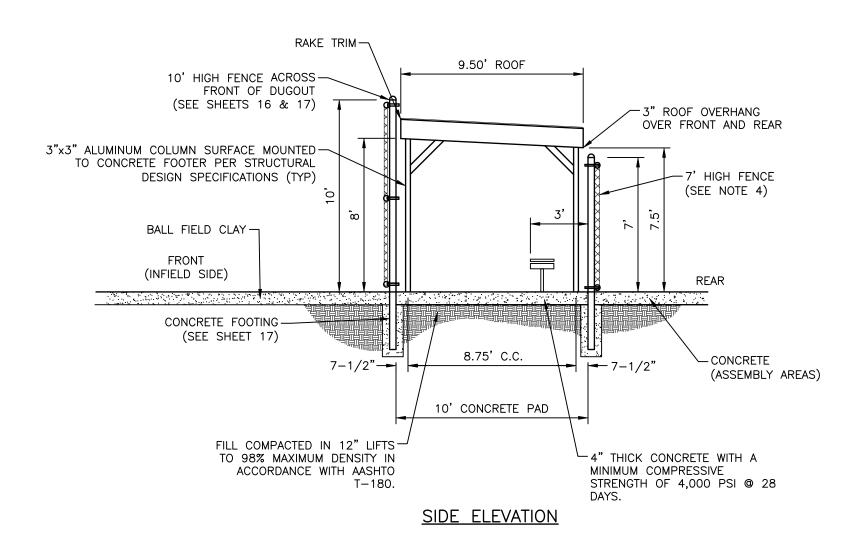
| CLIENT:  | MANATEE BOARD OF          | DATE             |
|----------|---------------------------|------------------|
|          | COUNTY COMMISSIONERS      | HOR              |
| PROJECT: |                           | VERT<br>F<br>SEC |
|          | BLACKSTONE PARK EXPANSION | SEC              |


| DATE:  DECEMBER 2012  HORIZONTAL SCALE:  AS SHOWN  VERTICAL SCALE: | TYPICAL BALL              | FIELD          |
|--------------------------------------------------------------------|---------------------------|----------------|
| AS SHOWN                                                           |                           |                |
| SEC: TWP: RGE:                                                     | CROSS REFERENCE FILE NO.: | PROJECT NUMBER |


11 34S 17E

| BALL | FIELD PLAN                | DANIEL J. BOND, P.E.<br>FLORIDA LICENSE NO. 57969 |
|------|---------------------------|---------------------------------------------------|
|      |                           | INDEX NUMBER:                                     |
|      |                           | D-215611237-014                                   |
|      | PROJECT NUMBER: 215611237 | SHEET NUMBER: 14 OF 19                            |

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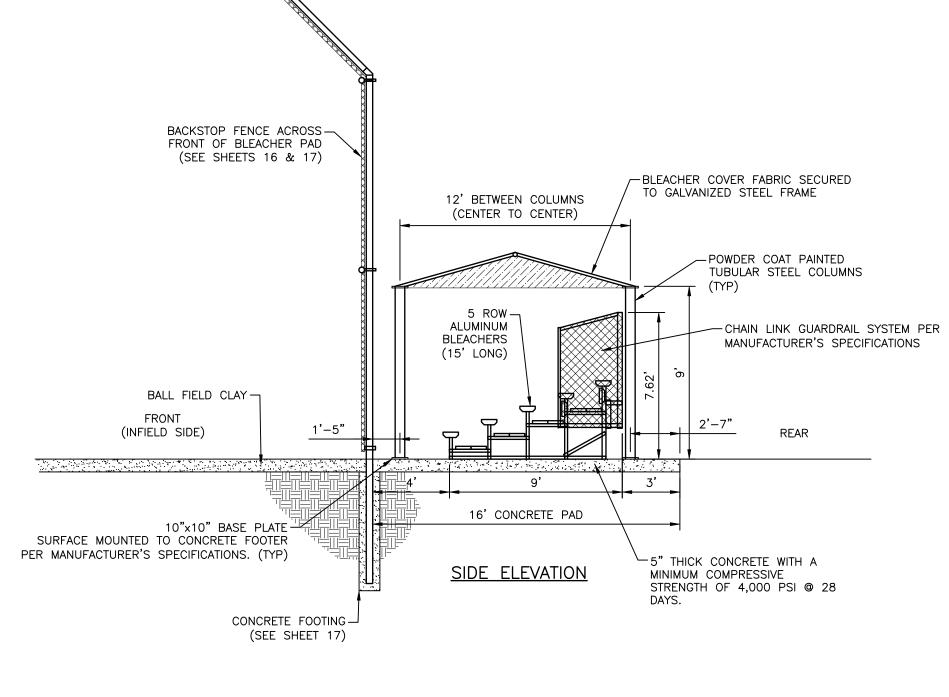



#### NOTES:

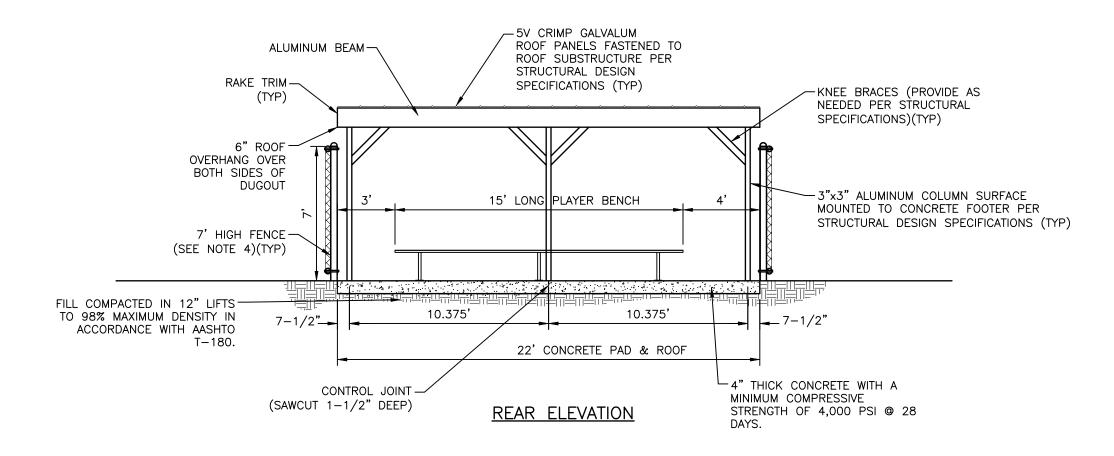
- 1. DUGOUT CANOPY DETAILS ARE PROVIDED FOR INFORMATIONAL PURPOSES ONLY FOR BASIS OF BID. DUGOUT CANOPIES TO CONSIST OF LIGHT ALUMINUM MATERIALS SIMILAR TO A CARPORT/CANOPY STRUCTURE AS MANUFACTURED BY ELLENTON ROOF AND ALUMINUM, INC. (OR APPROVED ALTERNATE). ALL MATERIALS SHALL BE IN WHITE COLOR. CONTRACTOR IS RESPONSIBLE TO PROVIDE SIGNED AND SEALED STRUCTURAL DRAWINGS/DESIGN CALCULATIONS FOR THE CANOPY STRUCTURES AND SHALL INCLUDE PERMITTING THROUGH THE CITY OF PALMETTO (IF REQUIRED). CONTRACTOR TO CONFIRM FOOTING REQUIREMENTS FOR THE DUGOUT CANOPY COLUMNS PRIOR TO POURING THE CONCRETE PAD.
- 2. ALL HARDWARE SHALL BE STAINLESS STEEL OR GALVANIZED.
- 3. REFER TO SHEET 5 FOR DUGOUT PAD LOCATIONS (6 TOTAL).
- 4. CONTRACTOR TO INSTALL 6' HIGH WINDSCREEN MOUNTED ALONG THE EXTERIOR OF THE 7' HIGH DUGOUT FENCING (37 LF TOTAL PER DUGOUT). BOTTOM OF WINDSCREEN SHALL BE 6" ABOVE FINISH GRADE.
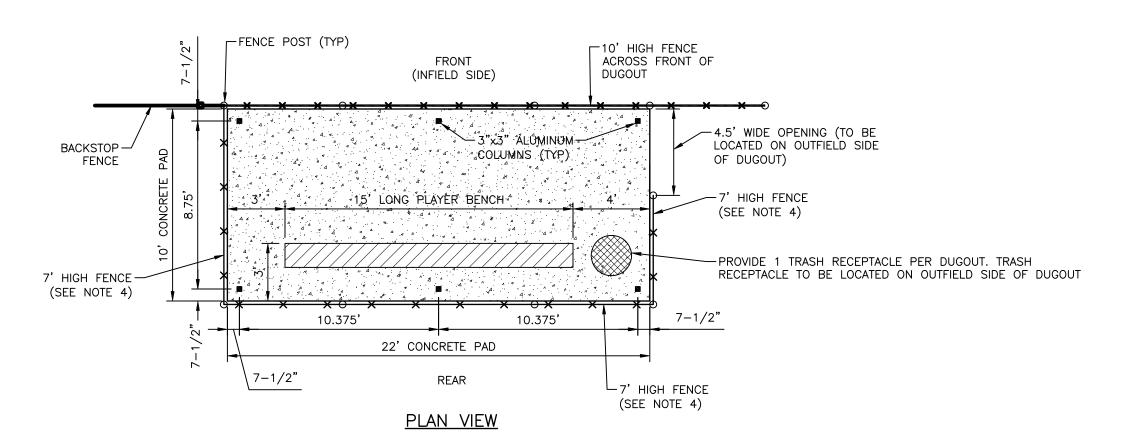
#### **SPECIFICATIONS:**

- 1. WINDSCREENS: BSN SPORTS POLYESTER OUTFIELD WINDSCREEN (1170610)- ROYAL BLUE IN COLOR (OR APPROVED ALTERNATE). WINDSCREEN SHALL BE MOUNTED TO FENCING USING 7" SELF-LOCK TIE WRAPS (MTTWRAPS) EVERY 12" TO 18" PER MANUFACTURER'S RECOMMENDATIONS.
- 2. ALL TRASH RECEPTACLES TO BE 32 GALLON RECEPTACLE-PORTABLE BY WABASH VALLEY MANUFACTURING, INC. (LR300D) OR APPROVED ALTERNATE. TRASH RECEPTACLES SHALL HAVE A ROUND DOME TOP LID (DT100) AND A 32 GALLON LINER (LR310). ALL MATERIALS SHALL BE BLACK IN COLOR. CONTRACTOR TO SECURE TRASH RECEPTACLES DIRECTLY TO CONCRETE PER MANUFACTURER'S RECOMMENDATIONS. ALL HARDWARE SHALL BE STAINLESS STEEL OR GALVANIZED.
- 3. PLAYER BENCH: 15' PLAYER BENCH WITHOUT BACK SURFACE MOUNT BY WABASH VALLEY MANUFACTURING, INC. (SG443D) OR APPROVED EQUAL. BENCH SHALL HAVE SMALL MOUNTING PLATE COVERS (SC203). ALL MATERIALS SHALL BE BLACK IN COLOR. CONTRACTOR TO SECURE SURFACE MOUNT BENCH TÒ CONCRETE PER MANUFACTURER'S RECOMMENDATIONS. ALL HARDWARE TO BE STAINLESS STEEL OR GALVANIZED.



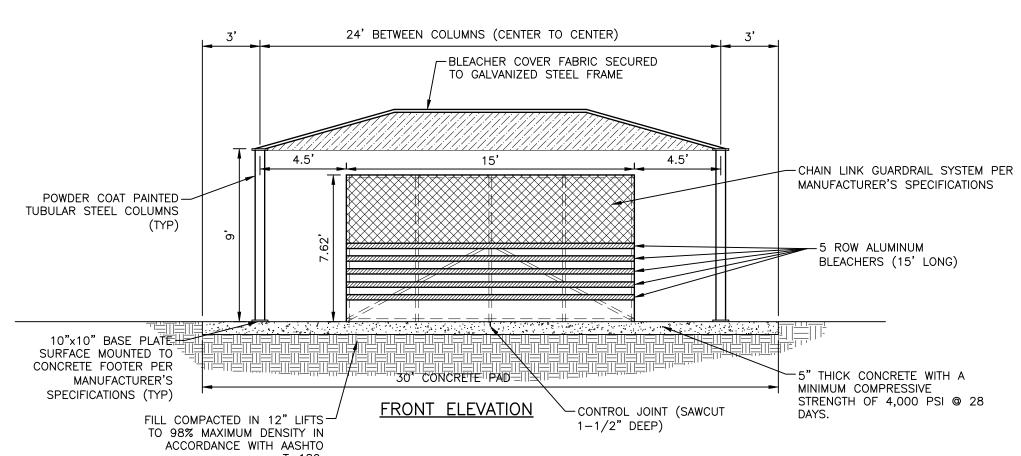

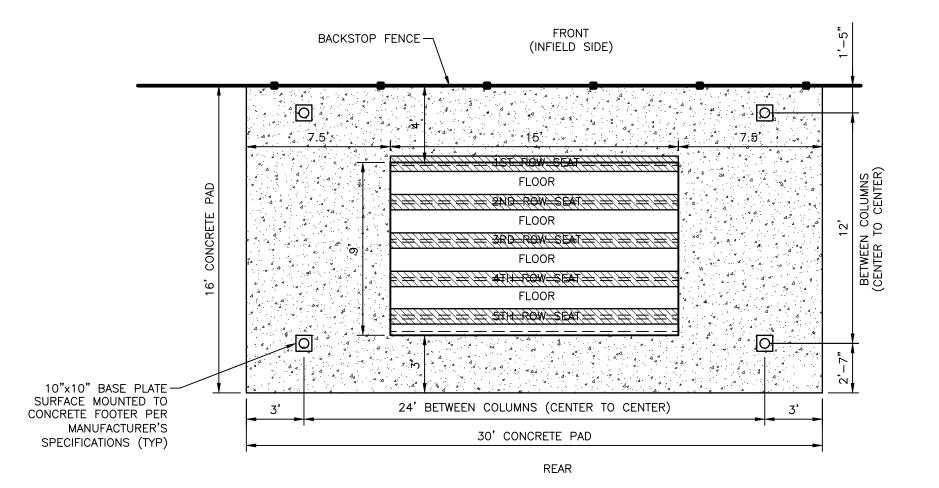

#### PLAN VIEW


- 1. INSTALL ALL ITEMS PER MANUFACTURER'S SPECIFICATIONS. CONTRACTOR IS RESPONSIBLE TO PROVIDE SIGNED AND SEALED ENGINEERING DRAWINGS/DESIGN CALCULATIONS FOR THE BLEACHER COVERS AND SHALL INCLUDE PERMITTING THROUGH THE CITY OF PALMETTO (IF REQUIRED). CONTRACTOR TO CONFIRM FOOTING REQUIREMENTS FOR THE BLEACHER COVER COLUMNS PRIOR TO POURING THE CONCRETE PAD.
- 2. ALL HARDWARE SHALL BE STAINLESS STEEL OR GALVANIZED.
- 3. REFER TO SHEET 5 FOR BLEACHER PAD LOCATIONS (6 TOTAL).

#### **SPECIFICATIONS:**

- 1. BLEACHERS (50 SEAT CAPACITY): BSN SPORTS 5 ROW 15' PREFERED BLEACHER (NB0515P) OR APPROVED ALTERNATE. BLEACHER TO HAVE DOUBLE FOOT PLANKS AND A RISER BOARD ON ALL ROWS, A CHAIN LINK GUARDRAIL SYSTEM, AND SAFETY END CAPS ON ALL ROWS.
- 2. BLEACHER COVER: 12' WIDE BY 24' LONG BLEACHER COVER BY APOLLO SUNGUARD SYSTEMS, INC. OR APPROVED ALTERNATE. FABRIC COLOR SHALL BE ROYAL BLUE WITH GALVANIZED FRAME. COLUMNS TO BE BLACK POWDER COAT PAINTED TUBULAR STEEL. COLUMNS SHALL BE SURFACE MOUNTED IN ACCORDANCE WITH MANUFACTURER'S SPECIFICATIONS (SEE NOTE 1).

|                     |                                            | ACTIVITY        | INITIALS/EMP. NO | . DATE  |                                                                                                                 | CLIENT:  | MANATEE BOARD OF          | DATE: TITLE:                             |                           |                           |
|---------------------|--------------------------------------------|-----------------|------------------|---------|-----------------------------------------------------------------------------------------------------------------|----------|---------------------------|------------------------------------------|---------------------------|---------------------------|
|                     |                                            | DESIGNED BY:    |                  |         | <i>WilsonMiller S</i> Stantec                                                                                   |          |                           | DECEMBER 2012 HORIZONTAL SCALE:          | T AND DIEACHED DETAILS    | DANIEL J. BOND. P.E.      |
|                     |                                            | DRAWN BY:       | CLL/096591       | 12/2012 | Wiisuminer & Stainted                                                                                           |          | COUNTY COMMISSIONERS      | AS SHOWN DUGOU                           | T AND BLEACHER DETAILS    | FLORIDA LICENSE NO. 57969 |
|                     |                                            | CHECKED BY:     |                  |         | 6900 Professional Parkway East, Sarasota, FL 34240                                                              | PROJECT: |                           | AS SHOWN                                 |                           | D-215611237-015           |
| A REV. NO. REVISION | DATE DRAWN RY / FMP NO CHECKED RY / FMP NO | WM APPROVED BY: | :                |         | Phone 941-907-6900 • Fax 941-907-6910 Certificate of Authorization #43 • FL Lic. # LC-C000170 • www.stantec.com |          | BLACKSTONE PARK EXPANSION | SEC: TWP: RGE: CROSS REFERENCE FILE NO.: | PROJECT NUMBER: 215611237 | SHEET NUMBER:             |

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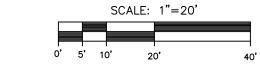

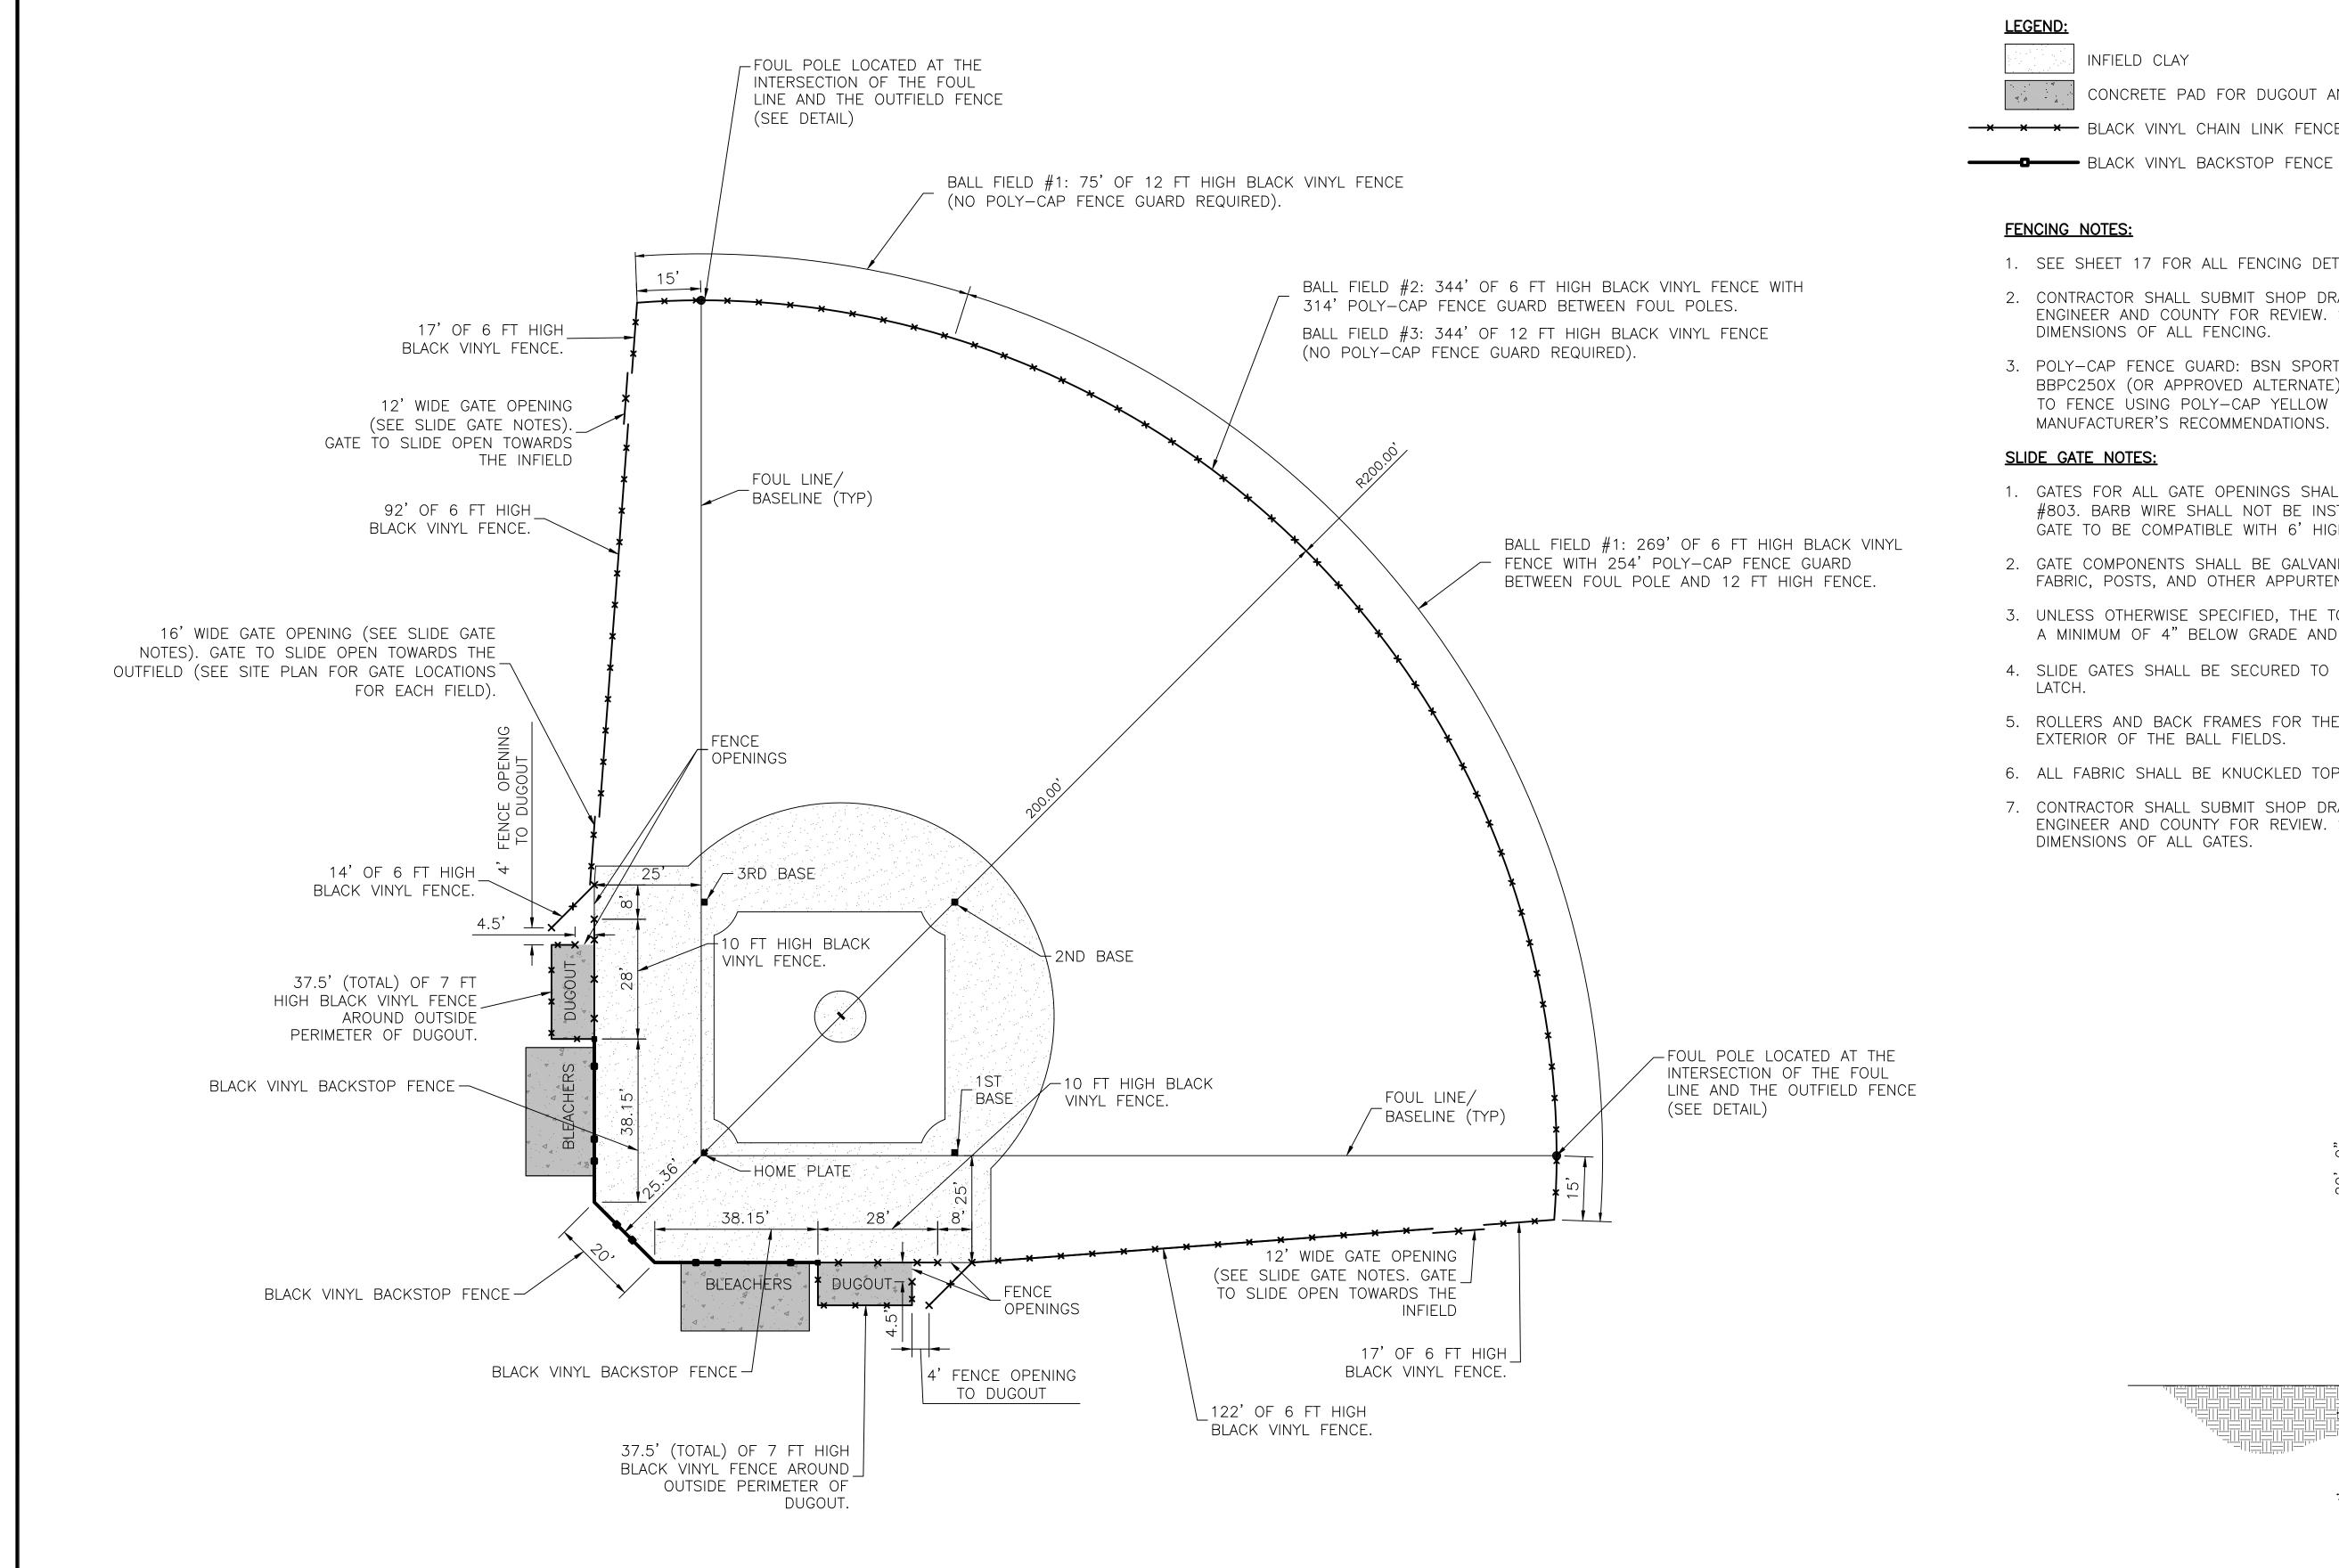
#### **LEGEND:**

INFIELD CLAY



CONCRETE PAD FOR DUGOUT AND BLEACHERS




-X X BLACK VINYL CHAIN LINK FENCE

#### **FENCING NOTES:**

- 1. SEE SHEET 17 FOR ALL FENCING DETAILS.
- 2. CONTRACTOR SHALL SUBMIT SHOP DRAWINGS OF ALL FENCING COMPONENTS TO THE ENGINEER AND COUNTY FOR REVIEW. SHOP DRAWINGS TO INCLUDE SIZE AND DIMENSIONS OF ALL FENCING.
- 3. POLY-CAP FENCE GUARD: BSN SPORTS POLY-CAP FENCE GUARD YELLOW, BBPC250X (OR APPROVED ALTERNATE). POLY-CAP FENCE GUARD SHALL BE SECURED TO FENCE USING POLY-CAP YELLOW 18" TIE WRAPS (BBPCTIES) EVERY 3' PER MANUFACTURER'S RECOMMENDATIONS.

#### **SLIDE GATE NOTES:**

- 1. GATES FOR ALL GATE OPENINGS SHALL BE CANTILEVER SLIDE GATES PER FDOT INDEX #803. BARB WIRE SHALL NOT BE INSTALLED AS PART OF THE GATE. HEIGHT OF THE GATE TO BE COMPATIBLE WITH 6' HIGH FENCE.
- 2. GATE COMPONENTS SHALL BE GALVANIZED AND BLACK VINYL COATED INCLUDING ALL FABRIC, POSTS, AND OTHER APPURTENANCES.
- 3. UNLESS OTHERWISE SPECIFIED, THE TOP OF ALL CONCRETE FOOTINGS SHALL BE SET A MINIMUM OF 4" BELOW GRADE AND SHALL NOT BE EXPOSED TO THE SURFACE.
- 4. SLIDE GATES SHALL BE SECURED TO FENCE END POSTS UTILIZING AN OFFSET LOK'N LATCH.
- 5. ROLLERS AND BACK FRAMES FOR THE SLIDE GATES SHALL BE LOCATED ON THE EXTERIOR OF THE BALL FIELDS.
- 6. ALL FABRIC SHALL BE KNUCKLED TOP AND BOTTOM SELVAGES.
- 7. CONTRACTOR SHALL SUBMIT SHOP DRAWINGS OF ALL GATE COMPONENTS TO THE ENGINEER AND COUNTY FOR REVIEW. SHOP DRAWINGS TO INCLUDE SIZE AND DIMENSIONS OF ALL GATES.

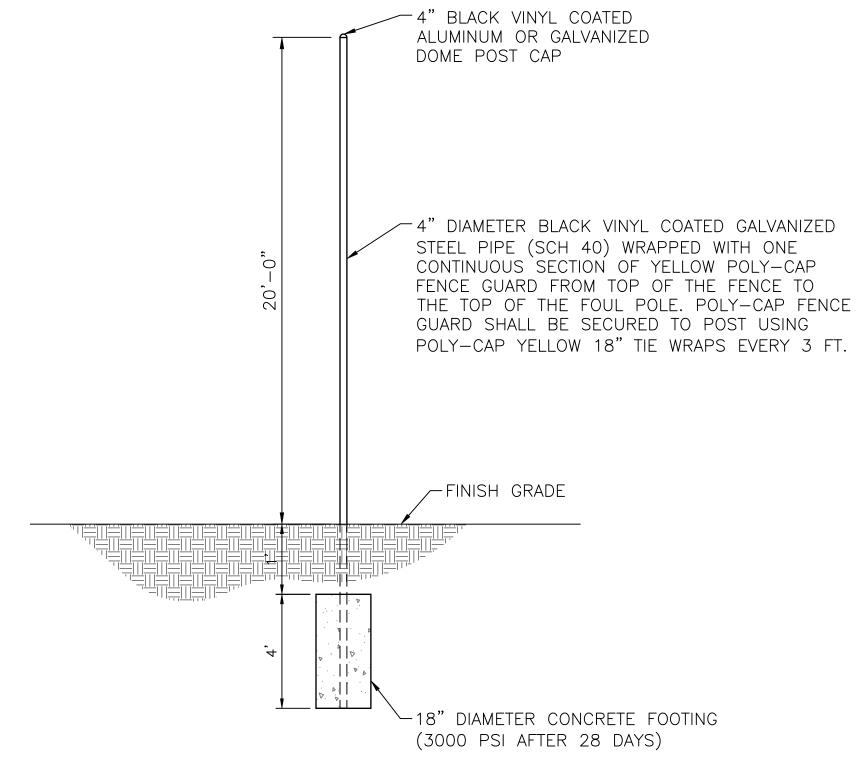

#### NOTES:

1. FOUL POLE SHALL BE INCLUDED AS ONE OF THE OUTFIELD FENCE POSTS. CONTRACTOR TO ADJUST FENCE POST SPACING ACCORDINGLY.

FOUL POLE DETAIL


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|          |          |      |                     |                       | DESIGNED BY:        |                   |         |
|          |          |      |                     |                       | DRAWN BY:           | CLL/096591        | 12/2012 |
|          |          |      |                     |                       | CHECKED BY:         |                   |         |
|          |          |      |                     |                       | CONTRACT ADMIN. BY: |                   |         |
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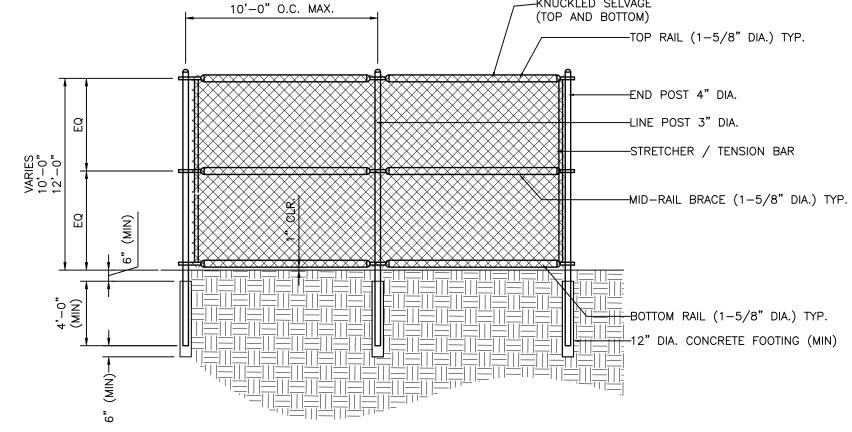
| WilsonMiller S Stantec                                                    |
|---------------------------------------------------------------------------|
| 6900 Professional Parkway East, Sarasota, FL 34240                        |
| Phone 941-907-6900 ◆ Fax 941-907-6910                                     |
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| CLIENT:  | MANATEE BOARD OF           | DECEMBER 201:<br>HORIZONTAL SCALE<br>AS SHOWN |
|----------|----------------------------|-----------------------------------------------|
| PROJECT: |                            | VERTICAL SCALE:                               |
|          | BLACKSTONE PARK EXPANSION  | AS SHOWN SEC: TWP: RGE                        |
|          | DEADINGTONE TAKE EXTANSION | 11 34S 17E                                    |

| :             | TITLE:                     |                 |                           |
|---------------|----------------------------|-----------------|---------------------------|
| EMBER 2012    | 11166.                     |                 |                           |
| ZONTAL SCALE: | ראון דודור נ               |                 | DANIEL J. BOND, P.E.      |
| S SHOWN       | BALL FIELD F               | FENCING PLAN    | FLORIDA LICENSE NO. 57969 |
| ICAL SCALE:   |                            |                 | INDEX NUMBER:             |
| S SHOWN       |                            |                 | D-215611237-016           |
| : TWP: RGE:   | CROSS REFERENCE FILE NO .: | PROJECT NUMBER: | SHEET NUMBER:             |
| 34S 17E       |                            | 215611237       | 16 of 19                  |

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## 10 FOOT AND 12 FOOT FENCE DETAIL

#### GENERAL FENCING NOTES:

- 1. ALL FENCE POSTS AND RAILS SHALL BE LOCATED ON THE EXTERIOR SIDE OF THE FABRIC IN RELATION TO THE BALL
- 2. ALL FENCE FABRIC SHALL BE #9 GAUGE WIRE IN TWO INCH DIAMOND MESH PATTERN WITH KNUCKED SELVAGES (TOP AND BOTTOM).

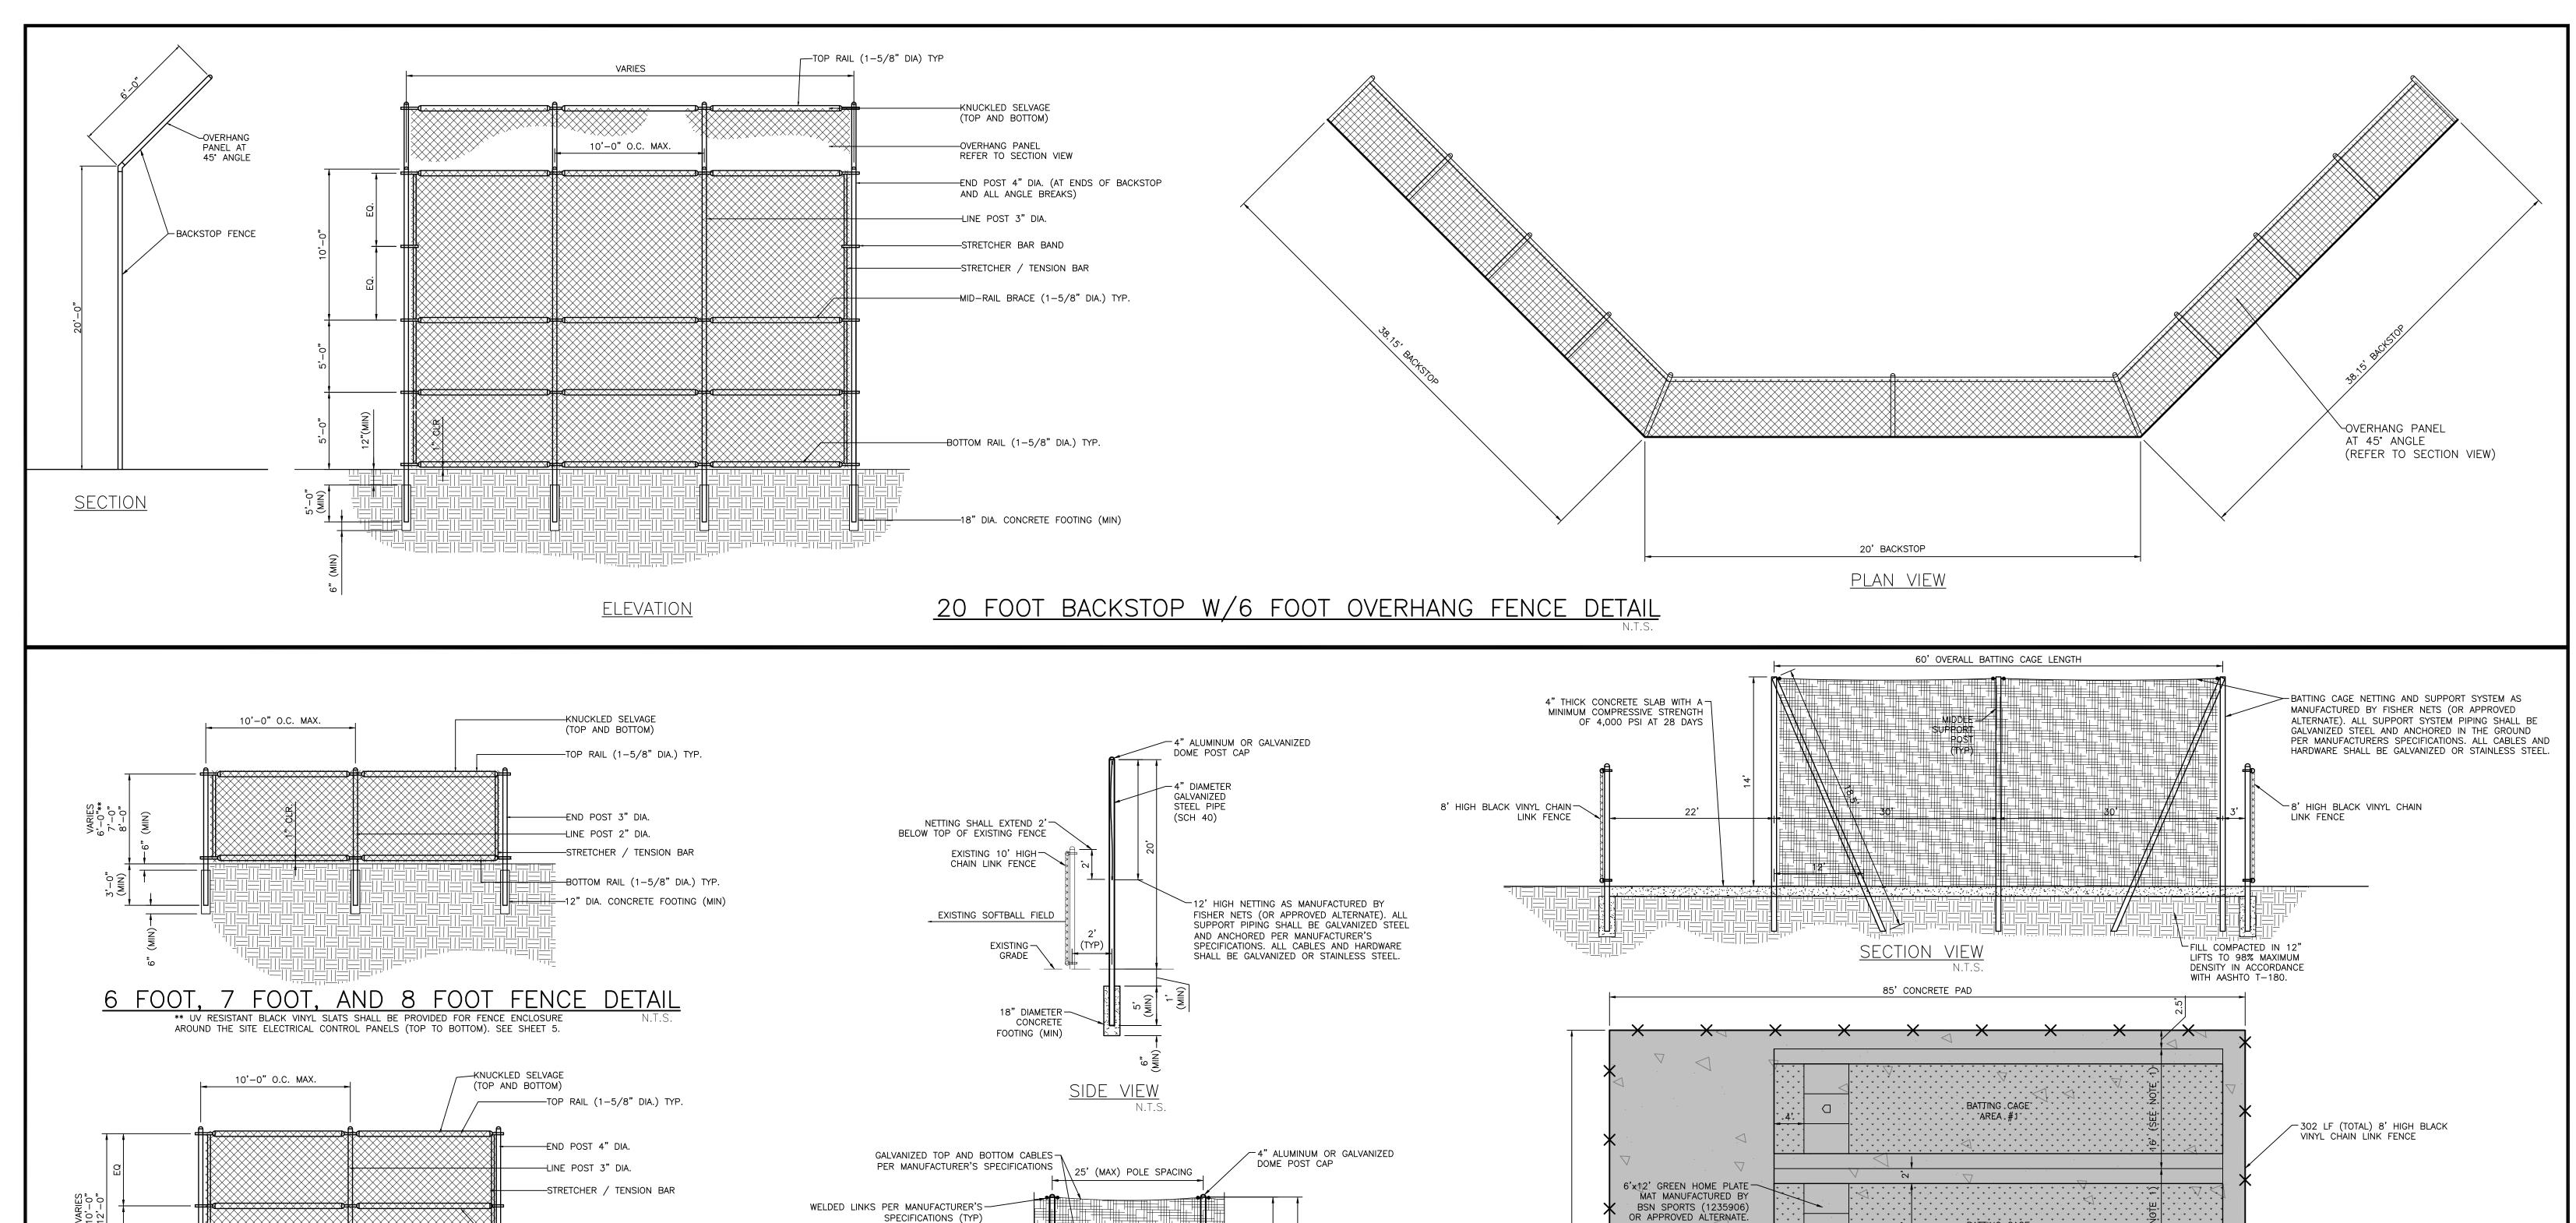12' HIGH NETTING AS MANUFACTURED BY FISHER NETS (OR APPROVED ALTERNATE). ALL SUPPORT PIPING

SHALL BE GALVANIZED STEÉL AND ANCHORED PER

MANUFACTURER'S SPECIFICATIONS. ALL CABLES AND HARDWARE SHALL BE GALVANIZED OR STAINLESS STEEL.

EXISTING GRADE -

- 3. ALL FENCE AND GATE MATERIALS SHALL BE HOT-DIP GALVANIZED AFTER FABRICATION. FABRIC, POSTS, AND ALL OTHER APPURTENANCES SHALL HAVE A MINIMUM ZINC COATING OF 1.2 OUNCES PER SQUARE FOOT OF SURFACE, AND FUSED AND BONDED WITH BLACK VINYL MEETING THE REQUIREMENTS OF ASTM F668-11, CLASS 1. FABRIC TO BE SECURED TO LINE POST WITH #6 GAUGE ALUMINUM TIE WIRES.
- 4. CONCRETE FOR ALL FENCE POST FOOTINGS SHALL HAVE A MINIMUM COMPRESSIVE STRENGTH OF 3,000 PSI AT 28 DAYS.
- 5. CONTRACTOR SHALL SUBMIT SHOP DRAWINGS FOR ALL FENCE/GATE MATERIALS TO ENGINEER AND COUNTY FOR REVIEW.
  6. REFER TO SHEET 16 FOR FENCING LAYOUT AND DIMENSIONS.

| National | National



SAFETY NETTING DETAIL

NETTING SHALL EXTEND 2'

-WELDED LINKS PER

SPECIFICATIONS (TYP)

-4" DIAMETER GALVANIZED STEEL PIPE (SCH 40)

8' HIGH X 6' WIDE BLACK VINYL COATED -

INDUSTRIAL SWING GATE WITH BLACK VINYL COATED FORK AND FORK CLAMP. ALL HARDWARE

HAVE KNUCKLED SELVAGES (TOP AND BOTTOM).

TO BE STAINLESS STEEL OR GALVANIZED. GATE TO

MANUFACTURER'S

BELOW TOP OF EXISTING FENCE

| CLIENT:  | MANATEE BOARD OF          | DATE: DECEMBER 2012 |
|----------|---------------------------|---------------------|
|          | 111/11/11/EE BO/11/B O1   | DECEMBER 2012       |
|          |                           | HORIZONTAL SCALE:   |
|          | COUNTY COMMISSIONERS      | 1" = 30'            |
| חחס ורסד |                           | VERTICAL SCALE:     |
| PROJECT: |                           | NA                  |
|          | BLACKSTONE PARK EXPANSION | SEC: TWP: RGE:      |
|          | BEACKSTONE TAKK EXTANSION | 11 3/5 175          |

PROVIDE 1 MAT FOR

EACH BATTING CAGE.

TRASH RECEPTACLE 7

RECEPTACLE

| DATE:  DECEMBER 2012  HORIZONTAL SCALE:  1" = 30'  VERTICAL SCALE:  NA | BALL FIELD FENC<br>AND BATTING CA | •             | DANIEL J. BOND, P.E. FLORIDA LICENSE NO. 57969 INDEX NUMBER: D-215611237-017 |
|------------------------------------------------------------------------|-----------------------------------|---------------|------------------------------------------------------------------------------|
| SEC: TWP: RGE:                                                         | CROSS REFERENCE FILE NO.: PRO     | DJECT NUMBER: | SHEET NUMBER:                                                                |
| 11 34S 17E                                                             |                                   | 215611237     | 17 of 19                                                                     |

\* BĂŢŤŀŇĠ \*CĂĠĔ

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, "AREA" ,#4°

BATTING CAGE DETAILS

BETWEEN CAGES.

TURF EVOLUTIONS 12' x 60' TRUGRASS LUXURY
SPRING INDOOR/OUTDOOR GREEN ARTIFICIAL TURF
(MODEL #TGLLR) OR APPROVED ALTERNATE. CENTER

ÀRTIFICIAL TURF IN EACH BATTING CAGE AND ADHERE TO CONCRETE USING MANUFACTURER RECOMMENDED

INDOOR/OUTDOOR CARPET GLUE. PROVIDE ALUMINUM

TRIM AROUND ALL EDGE OF TURF AND SECURE TO

NAILS PER MANUFACTURER'S RECOMMENDATIONS.

1. THE BATTING CAGE NETTING SHALL BE A MINIMUM

2. THE CONCRETE PAD FOR THE BATTING CAGES

OF 1-1/2" DEEP EVERY 10' C.C.E.W.

WIDTH OF 15' FOR EACH BATTING CAGE. BATTING

CAGE FRAMING SYSTEM TO BE SPACED AT 16' C.C.

SHALL HAVE CONTROL JOINTS SAWCUT A MINIMUM

CONCRETE WITH STAINLESS STEEL/GALVANIZED SCREW

