
2017 PHASE III GCCS EXPANSION STAGE III - LENA ROAD LANDFILL MANATEE COUNTY, FLORIDA

RFP# 11-2064 FL



MANATEE COUNTY UTILITIES DEPARTMENT 3333 LENA ROAD BRADENTON, FLORIDA

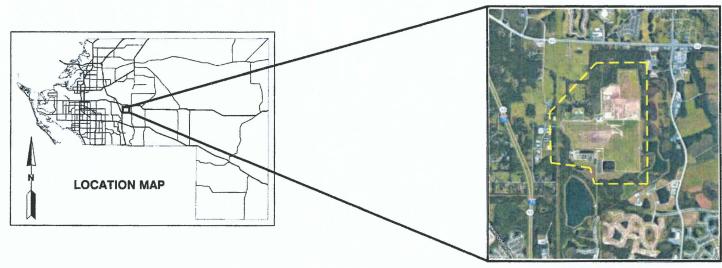

SITE LOCATION

SCS ENGINEERS
STEARNS, CONRAD AND SCHMIDT
CONSULTING ENGINEERS

4041 PARK OAKS BLVD., SUITE 100 TAMPA, FLORIDA 33610 PH NO. (813) 621-0080 FAX NO. (813) 623-6757 WWW.SCSENGINEERS.COM



DRAWING NO. DRAWING TITLE

1 - COVER SHEET

2 - GENERAL NOTES AND SYMBOLS 3 - EXISTING OVERALL SITE PLAN

4 - EXISTING STAGE III SITE PLAN

5 - PROPOSED SITE PLAN

6 - DETAILS - 1

- DETAILS - 2

8 - DETAILS - 3

9 - DETAILS - 4

10 - DETAILS - 5

11 - DETAILS - 6

12 - DETAILS - 7



WHEN DRAWINGS ARE REDUCED IN SIZE FROM ORIGINAL 24"X36", SCALING WILL NOT BE ACCURATE

BID DRAWINGS

DATE: 05/05/2017

2 WEEKS PRIOR TO INITIATING WORK, THE CONTRACTOR WILL SUBMIT FOR APPROVAL A SCHEDULE TO THE ENGINEER FOR COMPLETION OF

2. ALL CONSTRUCTION ACTIVITIES PERFORMED ON THE LANDFILL WILL BE COMPLETED IN ACCORDANCE WITH THE CURRENT AIR AND SOLID

EROSION AND SEDIMENT CONTROL:

1. ALL PRACTICABLE AND NECESSARY EFFORT SHALL BE TAKEN DURING CONSTRUCTION TO CONTROL AND PREVENT EROSION AND TRANSPORT OF SEDIMENT MATERIAL TO INLETS, SURFACE DRAINS, WETLANDS AND DETENTION AREAS. THE CONTRACTOR SHALL BE RESPONSIBLE FOR ALL RESTORATION EFFORTS THAT MAY BE REQUIRED.

2. CONSTRUCTION OPERATIONS SHALL BE CARRIED OUT IN SUCH A MANNER THAT EROSION AND AIR AND WATER POLLUTION WILL BE MINIMIZED. STATE AND LOCAL LAWS SHALL BE COMPLIED WITH AT ALL TIMES.

ALL TIMES.

PROVIDE ALL DISTURBED AREAS WITHIN THE LIMITS OF THE WORK WITH TEMPORARY SOIL EROSION CONTROL AND SEDIMENT CONTROL, UTILIZING EARTH DAMS & PONDS, GRADE TO DRAIN SWALES, SETTLING BASINS, SILT FENCES, STONE FILTERS, HAY BALE FILTERS, ETC., TREATING ALL SOIL SURFACES WITH SEEDED TOPSOIL AND/OR

SOD AFTER GRADING. SEE GENERAL NOTES NO. 15.
EROSION AND SEDIMENT CONTROL WILL BE INSTALLED PRIOR TO
CONSTRUCTION, AS NECESSARY, TO PREVENT SEDIMENTATION AND DAMAGE TO ADJACENT AREAS AND AS DIRECTED BY THE COUNTY'S REPRESENTATIVE AND SHALL BE MAINTAINED UNTIL PERMANENT

GROUND COVER IS ESTABLISHED.

CONTRACTOR WILL INSPECT AND REPAIR, AS NECESSARY, ANY
EROSION AND SEDIMENT CONTROL DAILY AND FOLLOWING EACH RAIN.

EROSION AND SEDIMENT CONTROL DAILY AND FOLLOWING EACH RAIN.

6. CONTRACTOR IS RESPONSIBLE FOR MONITORING DOWNSTREAM
CONDITIONS THROUGHOUT THE CONSTRUCTION PERIOD AND CLEARING
ANY DEBRIS AND SEDIMENT RESULTING FROM CONSTRUCTION.

7. CONTRACTOR SHALL ENSURE THE MINIMUM AMOUNT OF BARE SOIL
EXPOSED AT ONE TIME AND INSTALL SOIL EROSION CONTROL FENCES
AS SHOWN AND IN SUCH A MANNER AS TO CAPTURE AND FILTER
SURFACE WATER DURING CONSTRUCTION.

8. EROSION CONTROL FENCING MUST MEET THE REQUIREMENT OF THE
DEPARTMENT OF TRANSPORTATION, STATE OF FLORIDA STANDARD
SPECIFICATIONS. EROSION CONTROL MEASURES WILL BE MAINTAINED
AT ALL TIMES.

AT ALL TIMES.

9. ALL DISTURBED AREAS WITHIN THE LIMITS OF CONSTRUCTION SHALL RECEIVE VEGETATIVE TREATMENT AFTER FINAL GRADING IN ACCORDANCE WITH THESE PLANS AND SPECIFICATIONS. DISTURBED AREAS NOT SPECIFICALLY DESIGNATED WITH A VEGETATIVE COVER SHALL BE SODDED UNLESS OTHERWISE DIRECTED. SEE GENERAL

EARTHWORK:

1. SURVEY BENCHMARKS, MONUMENTS AND OTHER REFERENCE POINTS WILL BE PROTECTED FROM DAMAGE AND DISPLACEMENT. IF DISTURBED OR DESTROYED, THEY WILL BE REPLACED AT THE CONTRACTOR'S EXPENSE.

2. CONTRACTOR SHALL KEEP DIRT, DUST, NOISE AND OTHER

OBJECTIONABLE NUISANCES TO A MINIMUM.

UTILITIES

1. THERE MAY BE UTILITIES NOT SHOWN ON THESE PLANS. THE ENGINEER ASSUMES NO RESPONSIBILITY FOR LOCATIONS SHOWN AND IT SHALL BE THE RESPONSIBILITY OF THE CONTRACTOR TO VERIFY THE LOCATIONS OF ALL UTILITIES WITHIN THE LIMITS OF THE WORK PRIOR TO CONSTRUCTION. COUNTY WILL ASSIST WITH UTILITY LOCATES. SUNSHINE 811 UTILITY LOCATORS WILL NOT PROVIDE UTILITY LOCATES ON SITE BECAUSE SITE IS CONSIDERED PRIVATE PROPERTY.

2. IT SHALL BE THE RESPONSIBILITY OF THE CONTRACTOR TO PROTECT ALL EXISTING UTILITIES, PAVEMENT OR OTHER IMPROVEMENTS. ANY DAMAGE TO EXISTING UTILITIES AND/OR PAVED/STREETS CAUSED BY CONSTRUCTION OPERATIONS SHALL BE REPAIRED AT THE

CONTRACTOR'S EXPENSE.

CONTRACTOR'S EXPENSE.
UNDERGROUND FACILITIES WHETHER INDICATED OR NOT, WILL BE
LOCATED AND FLAGGED BY THE UTILITIES AT THE REQUEST OF THE
CONTRACTOR NO EXCAVATION WILL BE PERMITTED IN THE AREA
UNTIL ALL SUCH UNDERGROUND UTILITIES HAVE BEEN LOCATED AND
IDENTIFIED TO THE SATISFACTION OF ALL PARTIES AND THEN ONLY
WITH EXTREME CARE TO AVOID ANY POSSIBILITY OF DAMAGE TO THE

4. THE CONTRACTOR SHALL KEEP ALL WATER, GAS AND EXISTING SEWER LINES (AND THEIR APPURTENANCES) FREE OF DEBRIS AND OPERABLE AT ALL TIMES DURING CONSTRUCTION.

GENERAL NOTES:

1. THE CONTRACTOR IS ADVISED THAT NO ACTIVITIES MAY INTERFERE, DISRUPT, BLOCK, OR OTHERWISE CONFLICT WITH LANDFILL OPERATIONS. IF CONFLICTS ARE ANTICIPATED THEY SHALL BE

OPERATIONS. IF CONFLICTS ARE ANTICIPATED THEY SHALL BE COORDINATED AND APPROVED BY THE COUNTY AND ENGINEER PRIOR TO DISRUPTION.

PROJECT SITE IS A SOLID WASTE LANDFILL, AS SUCH, CONDITIONS ARE SUBJECT TO CHANGE WITH TIME, CONTROLS, IN PARTICULAR VERTICAL CONTROL, SHOULD BE EXPECTED (AND ANTICIPATED) TO VARY FROM THOSE SHOWN ON THESE DRAWINGS DUE TO ONGOING SUBSIDENCE RESULTING FROM REFUSE DECOMPOSITION. RELATIVE ELEVATION DIFFERENCES IN EXISTING AND PROPOSED ELEVATIONS ELEVATION DIFFERENCES IN EXISTING AND PROPOSED ELEVATIONS SHOWN ON THE DRAWINGS SHALL BE ADJUSTED ACCORDINGLY. LOCATION OF STRUCTURES SHALL BE PLACED IN ACCORDANCE WITH HORIZONTAL CONTROLS. VERTICAL PLACEMENT OF STRUCTURES SHALL BE IN ACCORDANCE WITH CONSTRUCTION DOCUMENTS, OR AS APPROVED BY THE ENGINEER.

ANY AND ALL FINES IMPOSED ON THE COUNTY BY ANY REGULATORY AGENCY DUE TO ACTION OF THE CONTRACTOR SHALL BE PAID BY THE CONTRACTOR.

THE CONTRACTOR.

INSPECTION: EXAMINE AREAS FOR CONDITIONS UNDER WHICH WORK IS TO BE PERFORMED. REPORT IN WRITING TO COUNTY'S REPRESENTATIVE ALL CONDITIONS CONTRARY TO THOSE SHOWN ON THE DRAWINGS OR SPECIFIED HEREIN AND ALL OTHER CONDITIONS THAT WILL AFFECT SATISFACTORY EXECUTION OF WORK. DO NOT PROCEED WITH WORK UNTIL UNSATISFACTORY CONDITIONS HAVE BEEN CORRECTED. STARTING WORK CONSTITUTES ACCEPTANCE OF THE CONDITIONS UNDER WHICH WORK IS TO BE PERFORMED. AFTER SUCH ACCEPTANCE, THE CONTRACTOR SHALL AT CONTRACTORS EXPENSE BE RESPONSIBLE FOR CORRECTING ALL UNSATISFACTORY AND DEFECTIVE WORK RESULTING FROM SUCH UNSATISFACTORY CONDITIONS. CONDITIONS

MANNER.

THE CONTRACTOR SHALL OBTAIN AND PAY FOR ALL NECESSARY LICENSES AND PERMITS ASSOCIATED WITH THE CONSTRUCTION OF THIS PROJECT UNLESS NOTIFIED OTHERWISE IN WRITING BY THE

LOCATIONS

MANATEE COUNTY REQUIREMENTS.

14. ALL WORK PERFORMED SHALL COMPLY WITH ALL APPLICABLE REGULATIONS AND ORDINANCES. THE CONTRACTOR SHALL BE

REGULATIONS AND ORDINANCES. THE CONTRACTOR SHALL BE RESPONSIBLE FOR PENALTIES/FINES LEVIED DUE TO WORK THAT IS NOT IN ACCORDANCE WITH PERMIT CONDITIONS.

15. ALL AREAS OF EXPOSED EARTH RESULTING FROM CONSTRUCTION ACTIVITIES SHALL BE SODDED OR SEEDED AS PER PROJECT SPECIFICATIONS. ALL AREAS OF DISTURBED EARTH ON SIDE SLOPES SHALL BE SODDED ACCORDING TO PROJECT SPECIFICATIONS. ALL OF THE TOP DECK OF STAGE III SHALL BE SEEDED ACCORDING TO PROJECT SPECIFICATIONS.

16. PROTECT BY WHATEVER MEANS REQUIRED ALL FENCES, SIGNS, STRUCTURES, DRIVES, SIDEWALKS, STREETS, BUSHES, TREES, ETC. WHICH ARE NOT DESIGNATED FOR REMOVAL, OR ARE OUTSIDE THE LIMITS OF CONSTRUCTION.

LEGEND

PROPOSED LFG EXTRACTION WELL

PROPOSED LFG HEADER/LATERAL

PROPOSED VALVE

GW-377 4

• PROPOSED VACUUM ACCESS RISER

PROPOSED COVER

5. ALL WORK SHALL BE PERFORMED IN A QUALITY WORKMANLIKE

DEVIATIONS FROM THESE PLANS AND SPECIFICATIONS WITHOUT PRIOR WRITTEN CONSENT OF THE ENGINEER OR COUNTY MAY CAUSE THE WORK TO BE UNACCEPTABLE AND WILL BE ADJUSTED OR REPAIRED AT THE CONTRACTOR'S EXPENSE.

OWNER.
ALL WORK SHALL HAVE A ONE YEAR WARRANTY, ONE YEAR
WARRANTY WILL BECOME EFFECTIVE WHEN THE PROJECT IS
SUBSTANTIALLY COMPLETE, AS DETERMINED BY THE ENGINEER.
ACTUAL DIMENSIONS AND LOCATIONS MAY VARY BASED ON FIELD

10. TERMS "COUNTY'S REPRESENTATIVE" AND "ENGINEER" ARE

INTERCHANGEABLE.

INTERCHANGEABLE.

11. THE DISPOSAL OF ALL DEBRIS RESULTING FROM CONSTRUCTION ACTIVITIES AND EXCESS EARTHWORK MATERIALS SHALL BE THE RESPONSIBILITY OF THE CONTRACTOR. APPROVAL OF DISPOSAL SITE SHALL BE OBTAINED FROM THE COUNTY PRIOR TO DISPOSAL AT THE WORKING FACE. ALL EXCESS MATERIAL IS THE PROPERTY OF THE COUNTY.

12. THE CONSTRUCTION LENGTHS INDICATED IN THESE PLANS ARE APPROXIMATE. ACTUAL LIMITS MAY BE SET IN THE FIELD AS DIRECTED BY THE ENGINEER.

13. THE CONTRACTOR SHALL FURNISH AND MAINTAIN ALL NECESSARY BARRICADES, WARNING SIGNS, LIGHTS AND FLAGMEN AS PER

LIMITS OF CONSTRUCTION.

17. 5% SLOPE FOR ALL PROPOSED PIPING UNLESS APPROVED BY

ABBREVIATIONS

LINEAR FEET EXISTING EXIST.

SCHEDULE SCH. TYPICAL TYP. DIAMETER CONC CONCRETE

> MAX. MAXIMUM HDPE HIGH DENSITY POLYETHYLENE

> > NUMBER

REINFORCED CONCRETE PIPE

SHEET NUMBER WHERE

DETAIL IS SHOWN

EXISTING LFG HEADER/LATERAL EXISTING MANHOLE

EXISTING LFG EXTRACTION WELL

PROPOSED ROAD CROSSING

EXISTING LEACHATE COLLECTION PIPE

EXISTING COVER

EXISTING VALVE

SECTION AND DETAIL DESIGNATION EXISTING WASTE

> INDICATES SECTION. IUMBER INDICATES DETAIL NUMBER

SHEET NUMBER WHERE REFERENCE IS SHOWN

MANATEE COUNTY SOLID WASTE DIVISION

§ 00000

EXPANSION

PHASE

2017


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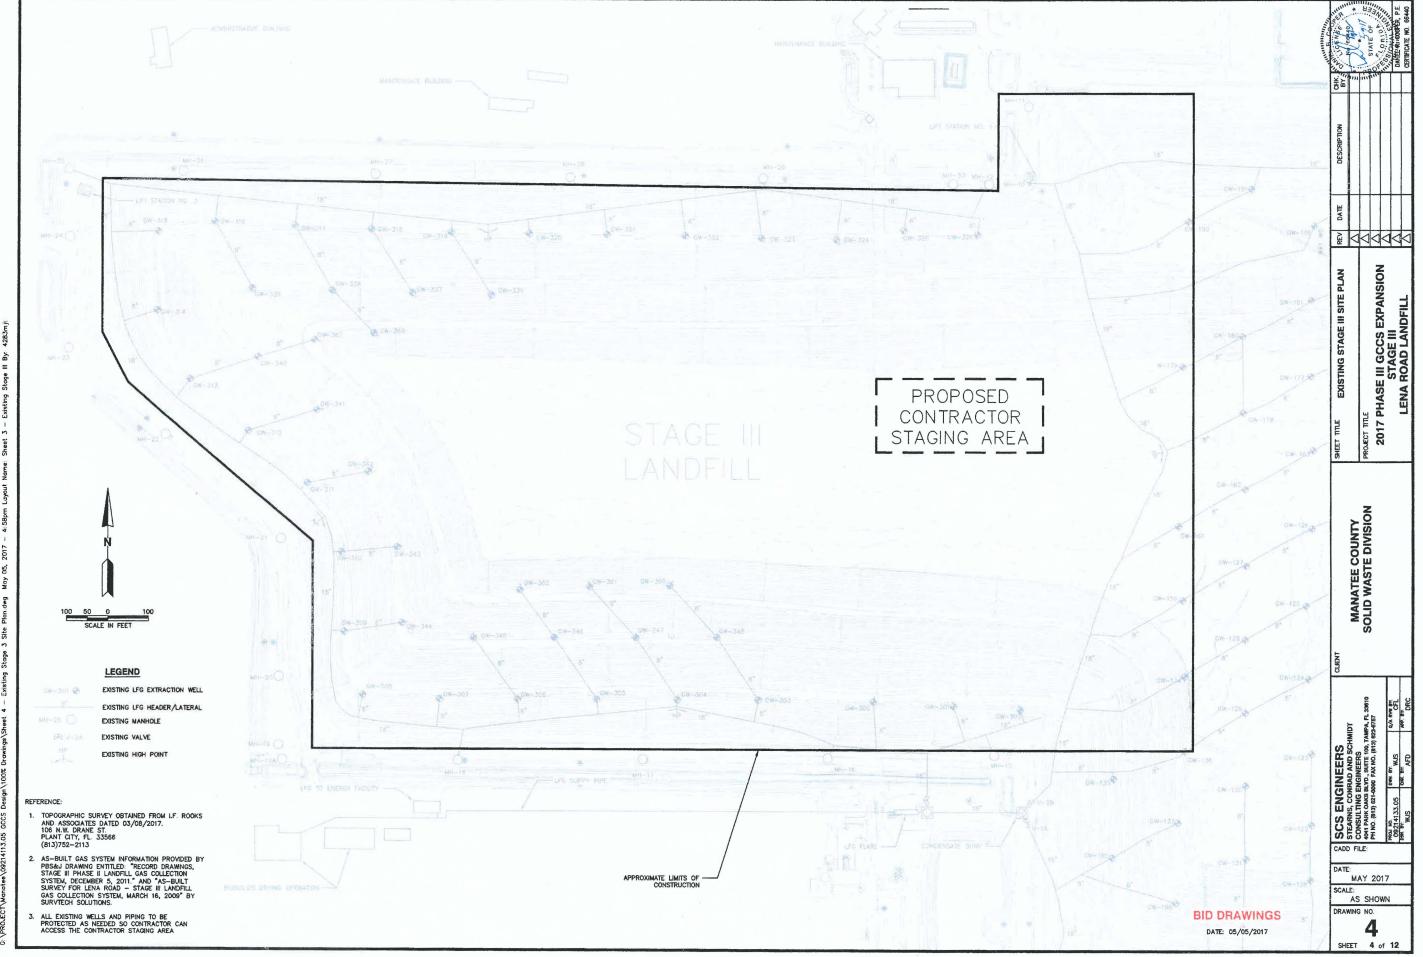
MAY 2017


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SHEET 2 of 12

BID DRAWINGS DATE: 05/05/2017






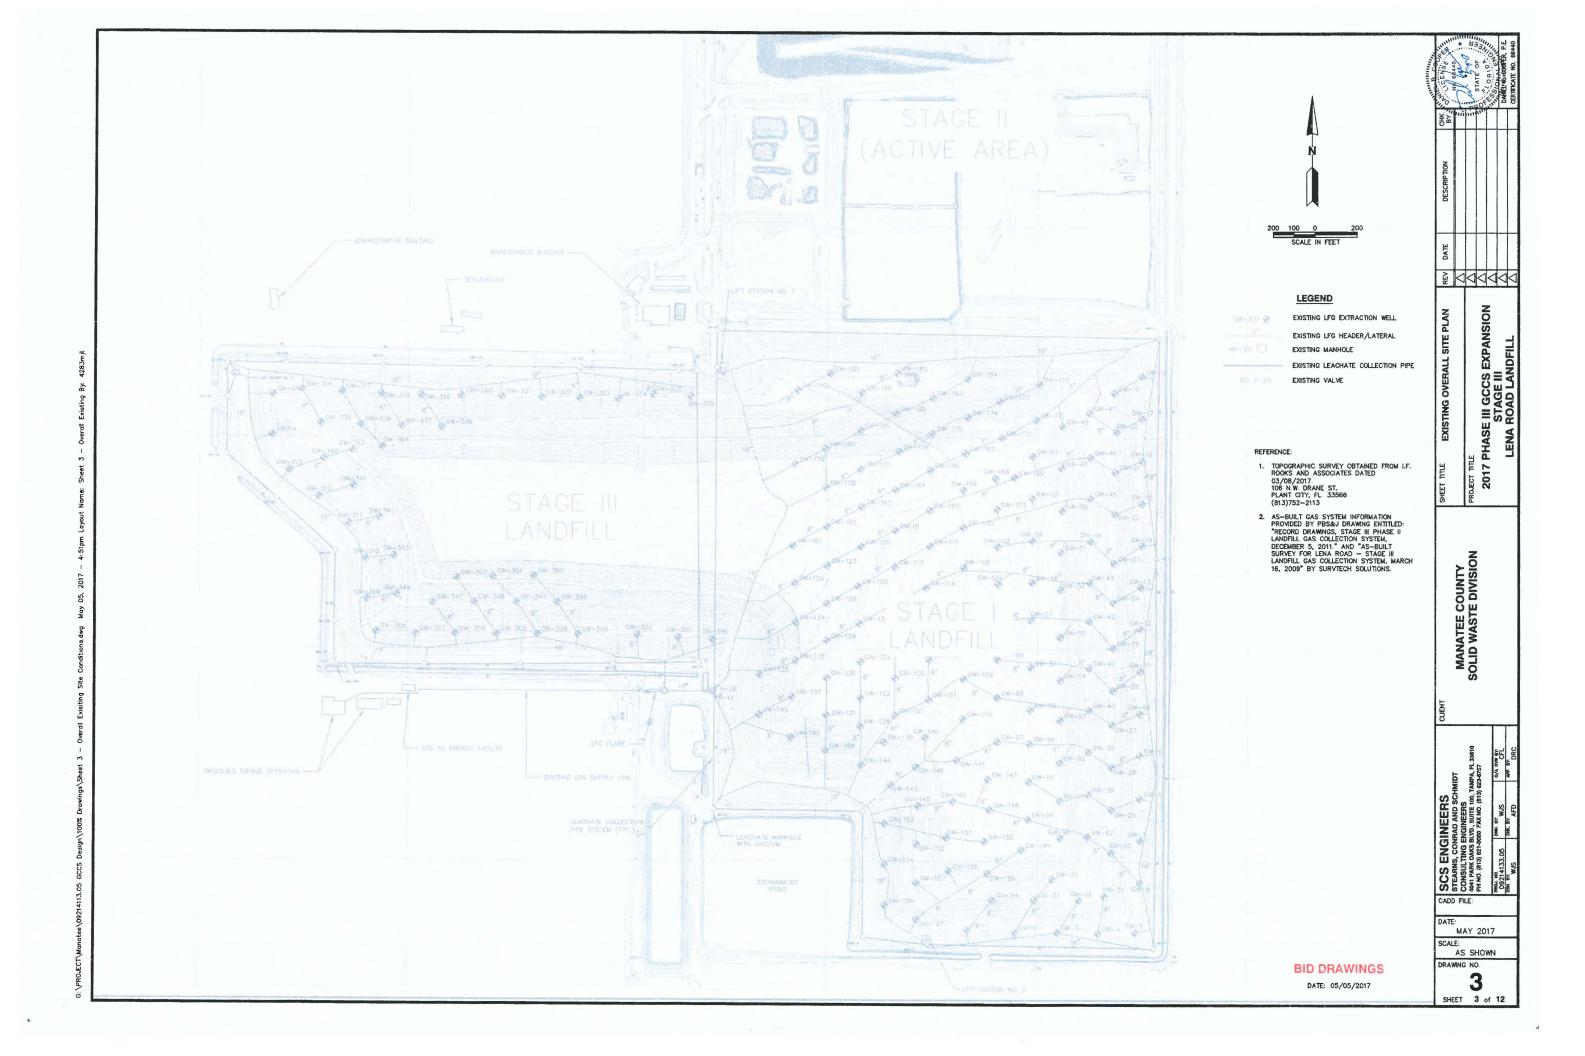

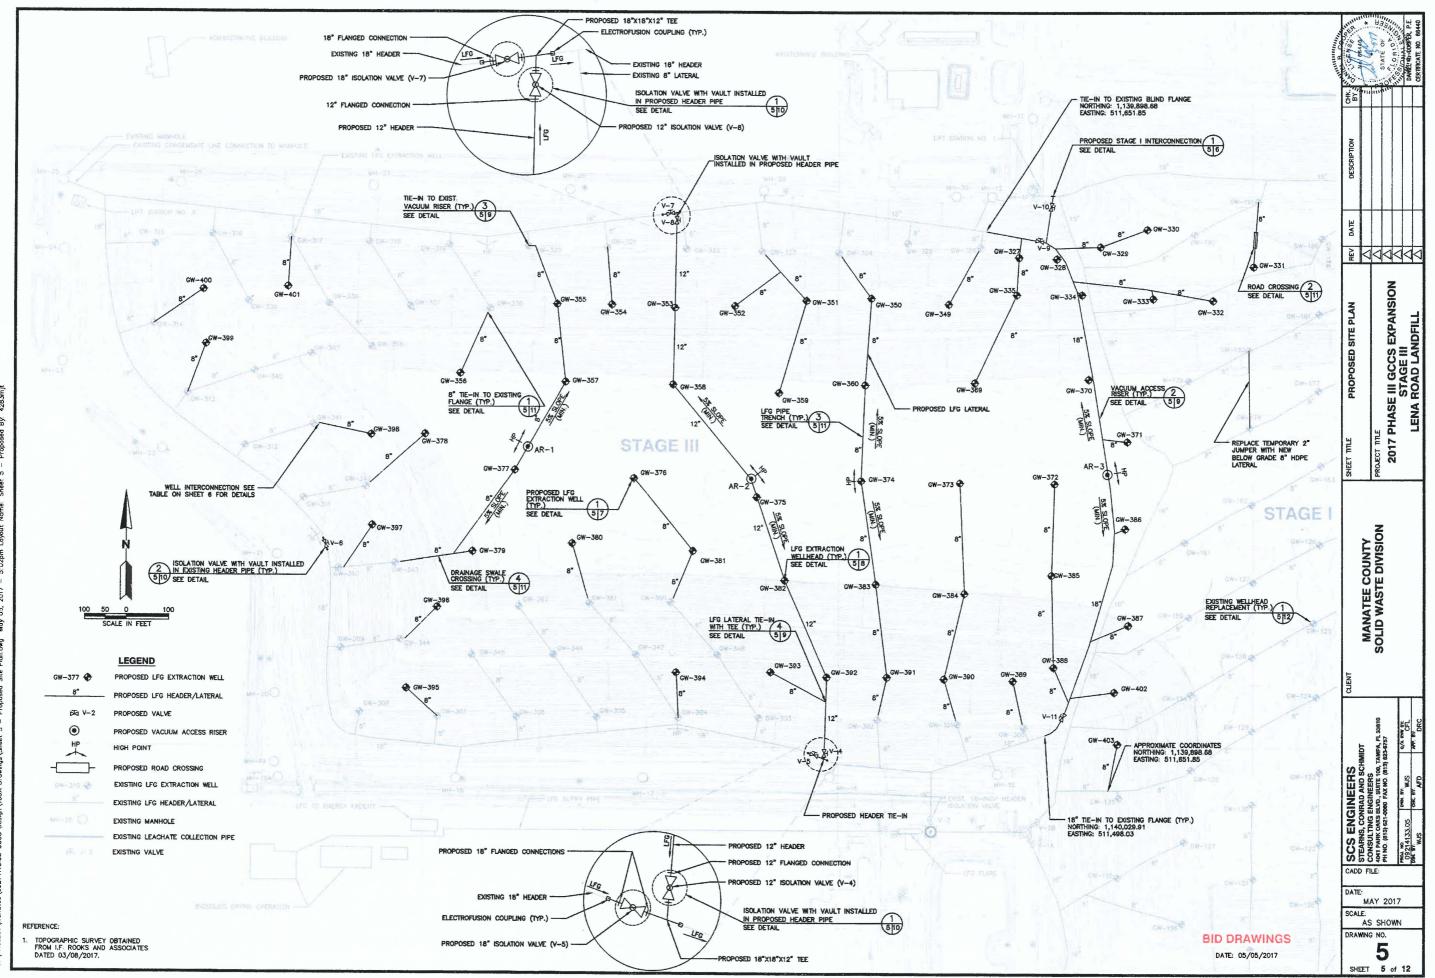TVMontries/092/411106 GCCS Design 100 December 5 Decemb

WELL INTERCONNECTION SCHEDULE

Veli ID	Type of Connection to Existing GCCS	Existing Well Tie-In Location
327	new 8" lateral to new 18" header	
328	new 8" lateral to new 18" header	
329	new 8" lateral to new 18" header	
330	new 8" lateral to new 18" header	
331	new 8" lateral to vacuum riser	GW-191
332	new 8" lateral	
333	new 8" lateral	
334	new 8" lateral to new 18" header	
335	new 8" lateral	
349	new 8" lateral to buried blind flange	GW-326
350	new 8" lateral to buried blind flange	GW-324
351	new 8" lateral to buried blind flange	GW-323
352	new 8" lateral to new 8" lateral	
353	on new 12" header	
354	new 8" lateral to existing vacuum riser	GW-321
355	new 8" lateral to existing vacuum riser	GW-320
356	new 8" lateral to buried blind flange	GW-336
357	new 8" lateral to new 8" lateral	
358	on new 12" header	
359	new 8" lateral to new 8" lateral	
360	new 8" lateral to new 8" lateral	
369	new 8" lateral to new 8" lateral	
370	new 8" lateral to new 18" header	
371	new 8" lateral to new 18" header	
372	new 8" lateral to new 8" lateral	
373	new 8" lateral to new 8" lateral	
374	new 8" lateral to new 8" lateral	
375	on new 12" header	
376	new 8" lateral to new 8" lateral	
377	new 8" lateral to new 8" lateral	
378	new 8" lateral to buried blind flange	GW-342
379	new 8" lateral to buried blind flange	GW-343
380	new 8" lateral to buried blind flange	GW-361
381	new 8" lateral to buried blind flange	GW-360
382	on new 12" header	
383	new 8" lateral to new 8" lateral	
384	new 8" lateral to new 8" lateral	
385	new 8" lateral to new 8" lateral	
386	new 8" lateral to new 18" header	
387	new 8" lateral to new 18" header	
388	new 8" lateral to new 18" header	
389	new 8" lateral to buried blind flange	GW-300
390	new 8" lateral to buried blind flange	GW-301
391	new 8" lateral to buried blind flange	GW-302
392	on new 12" header	
393	new 8" lateral to new 12" header	
394	new 8" lateral to existing vacuum riser	GW-304
395	new 8" lateral to existing vacuum riser	GW-307
396	new 8" lateral to buried blind flange	GW-344
397	new 8" lateral to existing vacuum riser	GW-310
398	new 8" lateral to buried blind flange	GW-341
399	new 8" lateral to existing vacuum riser	GW-313
400	new 8" lateral to existing vacuum riser	GW-314
401	new 8" lateral to existing vacuum riser	GW-317
402	new 8" lateral to new 18" header	
403	new 8" lateral to existing vacuum riser	GW-135

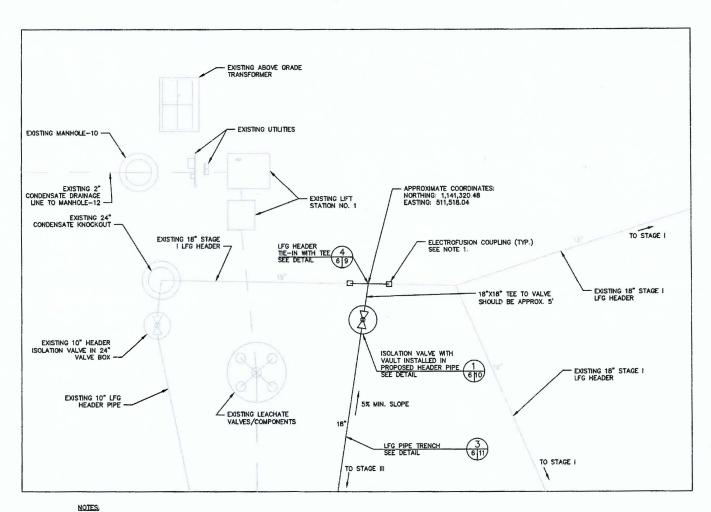

1. ELECTROFUSION COUPLINGS TO BE INSTALLED DIRECTLY TO 18-INCH TEE FITTING TO MINIMIZE EXCAVATION, DRAWING SHOWN ILLUSTRATES CONNECTIONS AND IS NOT TO SCALE.

PROPOSED STAGE I INTERCONNECTION DETAIL 1 NOT TO SCALE 5 6

BID DRAWINGS

DATE: 05/05/2017

PROJECT/Manatee\09214113.05 GCCS Design\100% Drawings\Details.dwg May 05, 2017 — 4:35pm Layout Name: Sheet 6 By. 4283


WELL SCHEDULE

Well ID	Nonhing	Easting	Approx. Ground Surface	Approx. Base Grade Elevation	Well Dopth	Slotted Pipe Length	Salid Fipe Length Below Grade	Solid Pipe Longth Above Grade	Total Solid Pipe Length	Thickness of Grave Pack
			(ft)	(ft)	(ft)	(ft)	(ft)	(ft)	(ft)	(ff)
GW - 327	1141171.95	511436.39	63	35	28	12	1.5	3	18	15
GW - 328	1141168.36	511527.83	63	35	28	12	15	3	18	15
GW - 329	1141197.35	511633.07	64	35	29	13	15	3	18	16
GW - 320	1141239.07	511746.05	77	35	42	26	15	3	18	29
GW - 331	1141150.18	512002.24	77	35	42	26	15	3	18	29
GW - 332	1141069.00	511904.00	84	35	49	33	15	3	18	36
GW - 333	1141073.61	511760.00	82	35	47	31.	15	3	18	34
GW - 334	1141082.43	511588.79	78	35	43	27	15	3	18	30
GW - 335	1141082.58	511431.15	79	35	44	28	15	3	18	31
GW - 349	1141059.37	511266.50	83	35	48	32	15	3	18	35
GW - 350	1141073.58	511078.77	80	35	45	29	15	3	18	32
GW - 351	1141067.69	510924.28	80	35	45	29	15	3	18	32
GW - 352	1141054.61	510751,87	80	35	45	29	15	3	18	32
GW - 353	1141049.86	510605.76	80	35	45	29	15	3	18	32
GW - 354	1141057.09	510454.14	80	35	45	29	15	3	18	32
GW - 355	1141057.71	510322.29	79	35	44	28	15	3	18	31
GW - 356	1140891.32	510089.19	111	35	76	55	20	3	23	58
GW - 357	1140871.15	510343.27	111	35	76	55	20	3	23	58
GW - 358	1140866.12	510601.59	312	35	77	56	20	3	23	59
GW - 359	1140846.68	510858.95	112	35	77	56	20	3	23	59
GW - 360	1140865.34	\$11063.83	115	35	80	59	20	3	23	62
GW - 369	1140871.19	511330.05	116	35	81	60	20	3	23	63
GW - 370	1140879,48	511604,83	115	35	80	59	20	3	23	62
GW - 371	1140730.85	511697.78	116	35	81	60	20	3	23	63
GW - 372	1140629.42	511522,25	116	35	81	60	20	3	23	63
GW - 373	1140631.21	511293.82	116	35	81	60	20	3	23	63
GW - 374	1140636.06	511054.52	116	35	81	60	20	3	23	63
GW - 375	1140596.44	510805.66	115	35	80	59	20	3	23	62
GW - 376	1140641.30	510508,44	115	35	80	59	20	3	23	62
GW - 377	1140660.50	510221.57	114	35	79	58	20	3	23	61
GW - 378	1140746.06	510005.12	113	35	78	57	20	3	23	60
GW - 379	1140465.56	510120.31	111	35	76	55	20	3	23	58
GW - 380	1140485.14	510360.26	112	35	77	56	20	3	23	59
GW - 381	1140467.88	510650.31	113	35	78	57	20	3	23	60
GW - 382	1140398.80	510872.97	114	35	79	58	20	3	23	61
GW - 383	1140389.52	511089.90	114	35	79	58	20	3	23	61
GW - 384	1140368.16	511305.05	114	35	79	58	20	3	23	61
GW - 385	1140411.84	511514.77	112	35	77	56	20	3	23	59
GW - 386	1140522.49	511692.38	115	35	80	59	20	3	23	62
GW - 387	1140292.59	511699.77	113	35	78	57	20	3	23	60
GW - 388	1140192.28	511519.63	80	35	45	29	15	3	18	32
GW - 389	1140159.63	511421.91	74	35	39	23	15	3	18	26
GW - 390	1140163.69	511255.27	73	35	38	22	15	3	18	25
GW - 391	1140167.52	511116.74	73	35	38	22	15	3	18	25
GW - 392	1140167.69	510973.40	73	35	38	22	15	3	18	25
GW - 393	1140179.52	510840.00	74	35	39	23	15	3	18	26
GW - 394	1140176.37	510610.32	73	35	38	22	15	3	18	25
GW - 395	1140138.55	509961.83	64	35	29	13	15	3	18	16
GW - 396	1140332.47	510035.47	93	35	58	37	20	3	23	40
GW - 397	1140527.26	509877.98	76	35	41	25	15	3	18	28
GW - 398	1140744.71	509874.81	93	35	58	37	20	3	23	40
GW - 399	1140960.58	509474.39	74	35	39	23	15	3	18	26
GW - 400	1141091.56	509468.10	75	35	40	24	15	3	18	27
GW - 401	1141099.12	509673.72	75	35	40	24	15	3	18	27
GW - 402 GW - 403	1140133.07	511666.38 511673.70	79	35	38	28	15	3	18	31

NOTES

- 1. CONTRACTOR SHALL SURVEY THE PROPOSED WELL LOCATIONS AND PROVIDE THE EXISTING GROUND SURFACE ELEVATION AT EACH LOCATION TO THE ENGINEER PRIOR TO THE COMMENCEMENT OF WELL DRILLING.
- 2 ENGINEER SHALL ADJUST WELL SCHEDULE AS NECESSARY BASED ON THE PRE-CONSTRUCTION SURVEY.
- 3. ALL SIGNATURES REQUIRED ON THE FINAL WELL SCHEDULE PRIOR TO COMMENCEMENT OF DRILLING.

CQA INSPECTOR	DATE	DRILLER	DATE
ENGINEER	DATE	COUNTY REPRESENTATIVE	DATE

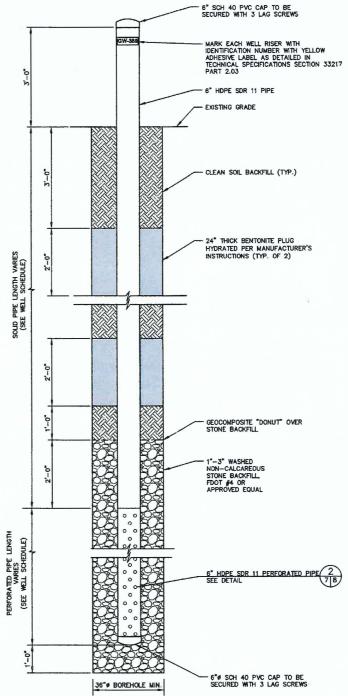

NOTES:

- 1. PVC CAP TO BE SCREWED TO NEW WELL UNTIL WELL CAN BE CONNECTED TO VACUUM.
- 2. BENTONITE TO BE HYDRATED AS IT IS ADDED TO BORING.
- 3. GEOCOMPOSITE RING TO BE INSTALLED OVER GRAVEL AND TAMPERED IN PLACE BEFORE BACKFILLING.



BID DRAWINGS

117

<u>\$</u> 44444

PROJECT TITE
2017 PHASE III GCCS EXPANSION
STAGE III
LENA ROAD LANDFILL

MANATEE COUNTY SOLID WASTE DIVISION

SCS ENGINEERS
STEARNS, CONTAINED AND SCHMIDT
CONSULTING ENGINEERS
R 4001 PARK CAUSE RVD., SUITE 100, TAMPA, FL. 3810
PH NO. (813) 627-0000 FAX NO. (813) 623-6737

CADD FILE: DETAILS DATE:


MAY 2017
SCALE:
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SHEET 7 of 12

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DATE: 05/05/2017


PLAN VIEW



LFG EXTRACTION WELLHEAD DETAIL

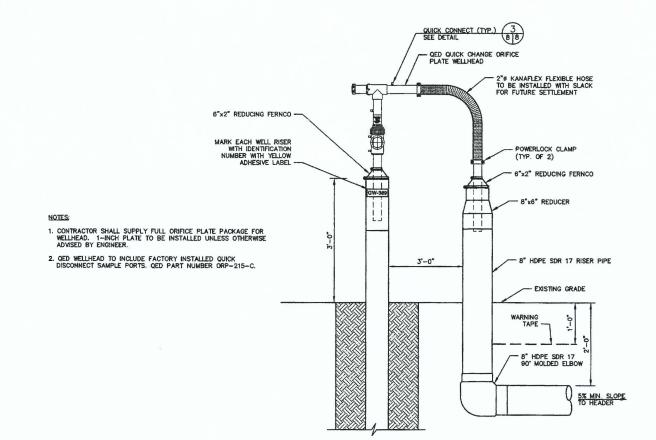NOT TO SCALE


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58

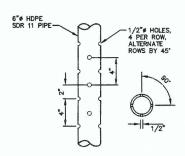

NOTES

- 1. PERFORATIONS SHALL BE SPACED 90* APART HORIZONTALLY.
- PERFORATIONS SHALL BE SPACED 4" APART VERTICALLY.
- 3. 90' AND 270' ROWS SHALL BE STAGGERED 2" BELOW 0' AND 180' ROWS.



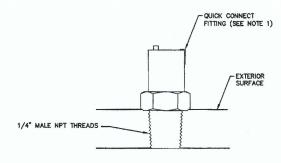

NOTES:

 PART NUMBER EW-06359-72 BY COLE-PARMER, INC. OR APPROVED EQUIVALENT.

QUICK CONNECT DETAIL 3 NOT TO SCALE 89.10.12


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DATE: 05/05/2017


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	DESCRIPTION CI						
	DATE						
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	DETAILS - 3			MOIST STORE HE COOK EXPANSION	TASE III GCCS EAFAINSION	O AGE III	LENA ROAD LANDFILL
	SHEET TITLE		PROJECT TITLE	2011	2017		
	MANATEE COUNTY SOLID WASTE DIVISION						
	DATE SCAL DRAW	W CONSTITUTION SCHMIDS	ΑY	20	17	09214133.05 WJS	WAS DRC ONE AFD APP BRC
	DRAV		SS	3 8	WN of	12	

Manatee (99214113.05 GCCS Design/100% Drowings/Details.dwg May 05, 2017 - 5:10pm Layout Name: Sheet 8 By: 4283mjt

DUMMING

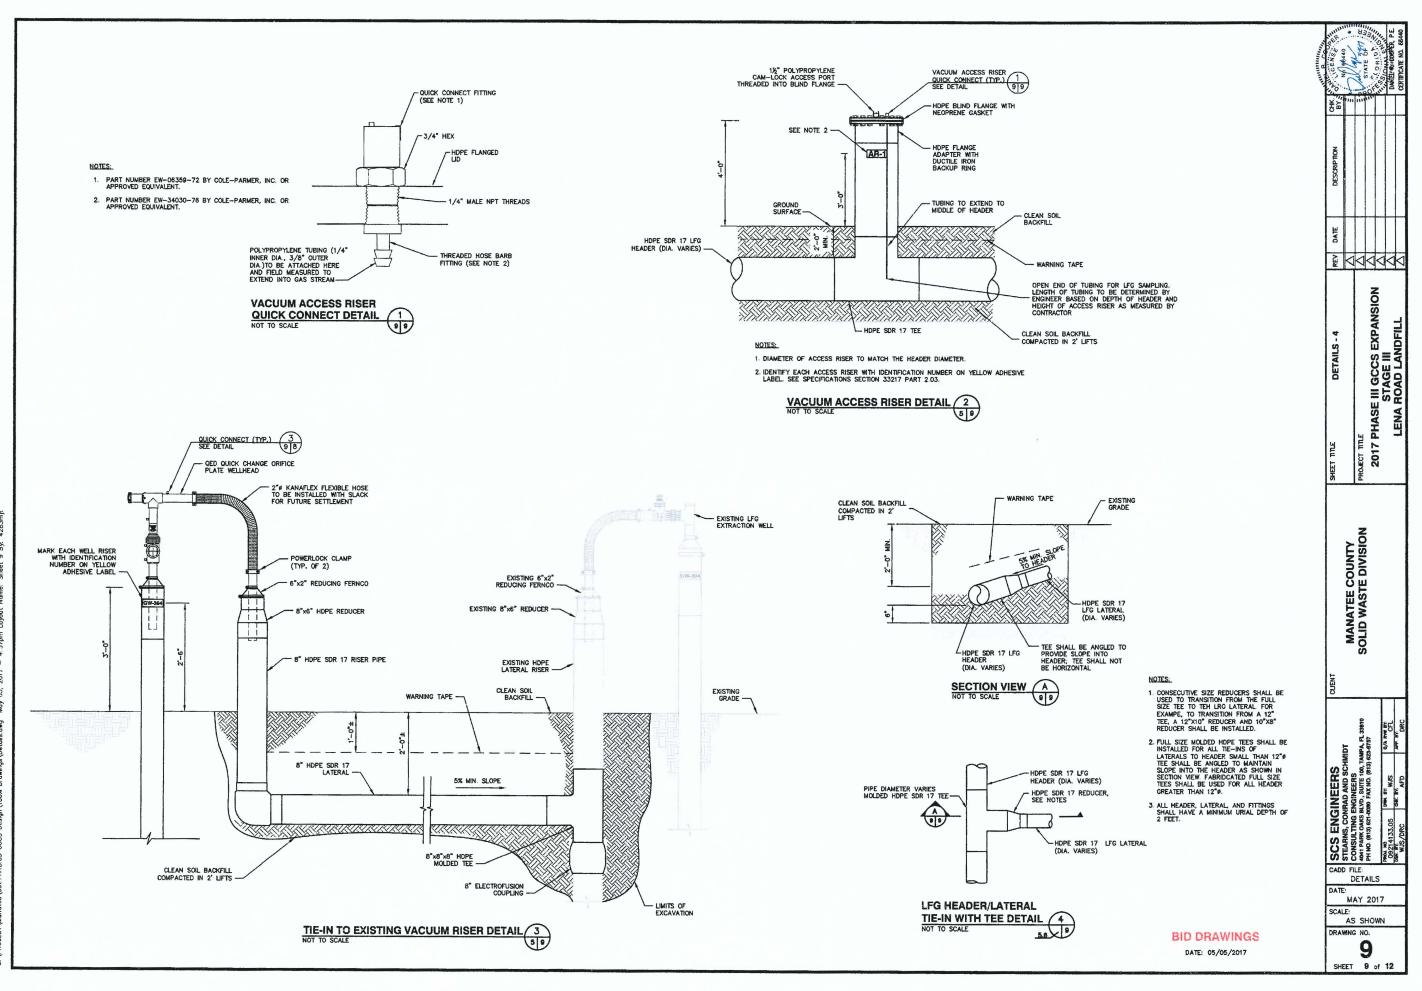

CTAMondae Not 11 To Torce Desired And Desired Assessment Desired Assessment A

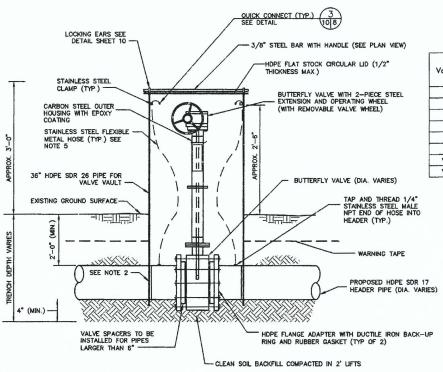


- THOROUGHLY COAT ENTIRE SURFACE OF BOLTS, WASHERS, NUTS AND BACKUP RINGS WITH POLYCOAT RUBBERIZED PRIMER, OR EQUAL, AFTER TIGHTENING BOLTS.
- 2. CUT OUT ARCH FOR PIPE (DIA. OF PIPE VARIES).
- 3. TOP OF VALVE STEM TO BE APPROXIMATELY 6" BELOW VAULT LID.
- 4. FOR VALVE IDENTIFICATION, AN ADHESIVE YELLOW LABEL MUST BE AFFIXED TO THE EXTERIOR OF VALVE VALUE IN A VISIBLE AREA, LABEL TO INCLUDE "LENA ROAD LANDFILL" AND VALVE NUMBER. SEE VALVE SCHEDULE ON SHEET 10.
- 5. SWAGELOK STAINLESS STEEL FLEXIBLE METAL HOSE, PART NO. SS-FM4PMFPF4 (LENGTH VARIES).

ISOLATION VALVE WITH VAULT INSTALLED IN PROPOSED HEADER PIPE DETAIL NOT TO SCALE

VALVE SCHEDULE

Valve ID	Diameter (inches)	Installed in Existing or New Pipe	Northing	Easting
V-4	12	New	1,139,986.34	510,967.56
V-5	18	Existing	1,139,981.92	510,943.62
V-6	18	Existing	1,140,481.05	509,764.82
V-7	18	Existing	1,141,275.94	510,593.93
V-8	12	New	1,141,259.78	510,608.89
V-9	18	New	1,141,210.98	511,485.59
V-10	18	New	1,141,294.41	511,514.04
V-11	18	New	1,140,077.72	511,544.24

PLAN VIEW

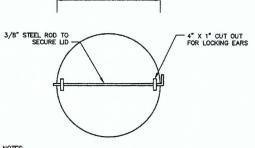

1. 4" X 1" CUTOUT ON 1/4" FLATSTOCK LID FOR LOCKING EARS TO FIT INTO.

STAINLESS STEEL CLAMP (TYP.)

36" HDPE SDR 26 PIPE FOR VALVE VAULT

EXISTING GROUND SURFACE-

STAINLESS STEEL FLEXIBLE METAL HOSE (TYP.) SEE NOTE 5

THOROUGHLY COAT ENTIRE SURFACE OF BOLTS, WASHERS, NUTS AND BACKUP RINGS WITH POLYCOAT RUBBERIZED PRIMER, OR EQUAL, AFTER TIGHTENING BOLTS.

QUICK CONNECT (TYP.) 3
SEE DETAIL 10 8

-3/8" STEEL BAR WITH HANDLE (SEE PLAN VIEW)

HDPE FLAT STOCK CIRCULAR LID (1/2" THICKNESS MAX.)

BUTTERFLY VALVE WITH 2-PIECE STEEL EXTENSION AND OPERATING WHEEL (WITH REMOVABLE VALVE WHEEL)

TAP AND THREAD 1/4" STAINLESS STEEL MALE NPT END OF HOSE INTO

EXISTING 18" HDPE HEADER PIPE

18" HDPE ELECTROFUSION


HEADER (TYP.)


-HDPE FLANGE ADAPTER WITH DUCTILE IRON BACK-UP RING AND RUBBER GASKET (TYP. OF 2)

CLEAN SOIL BACKFILL COMPACTED IN 2' LIFTS

- 2. CUT OUT ARCH FOR PIPE (DIA. OF PIPE VARIES).
- 3. TOP OF VALVE STEM TO BE APPROXIMATELY 6" BELOW VAULT LID.
- 4. FOR VALVE IDENTIFICATION, AN ADHESIVE YELLOW LABEL MUST BE AFFIXED TO THE EXTERIOR OF VALVE VAULT IN A VISIBLE AREA. LABEL TO INCLUDE "LENA ROAD LANDFILL" AND VALVE NUMBER. SEE VALVE SCHEDULE ON SHEET 10.
- 5. SWAGELOK STAINLESS STEEL FLEXIBLE METAL HOSE, PART NO. SS-FM4PMFPF4 (LENGTH VARIES).

ISOLATION VALVE WITH VAULT INSTALLED IN EXISTING HEADER PIPE DETAIL

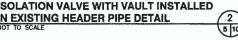

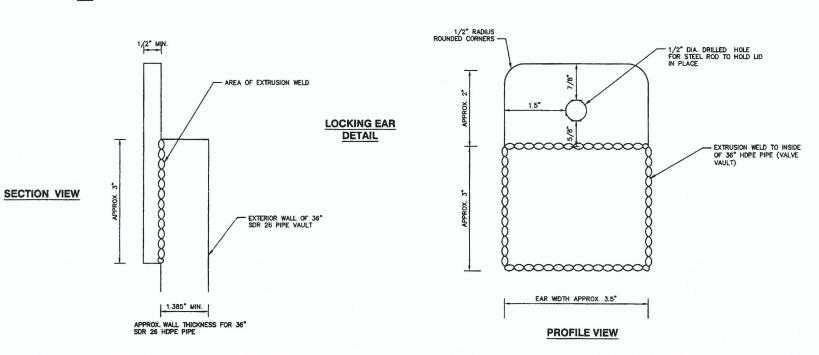



BID DRAWINGS

DATE: 05/05/2017

\$ 000000 **EXPANSION** 2017 PHASE III GCCS E STAGE III LENA ROAD LANC MANATEE COUNTY SOLID WASTE DIVISION SENGINEERS
THIS, CONRAD AND SCHMIDT
LITING ENGINEERS
RIX CAKS BLYD, SUITE 100, TAMPA, PL. 29
(813) 621-0000 FAX NO. (813) 623-6757 SCS STEARNS CONSUL CADD FILE: DETAILS MAY 2017 AS SHOWN DRAWING NO.

SHEET 10 of 12

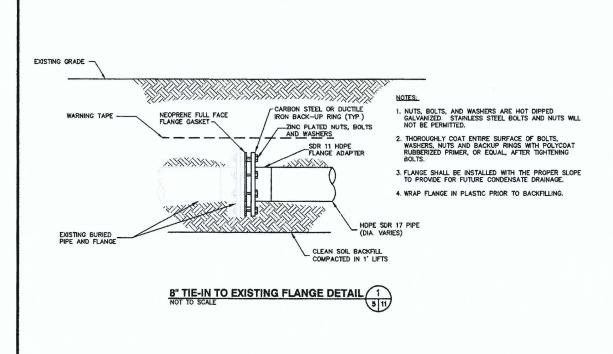


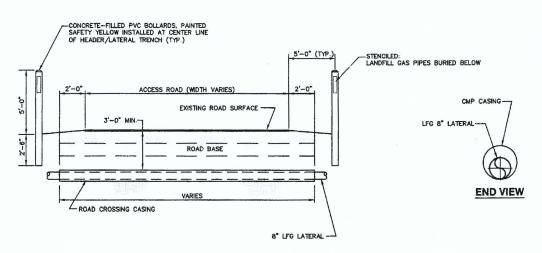

NOTES:

- 1. CONTRACTOR SHALL RESTORE ROAD TO MATCH ORIGINAL CONDITIONS.
- 2. CONTRACTOR SHALL INSTALL 2 BOLLARDS, ONE AT EACH END OF THE CMP CASING. BOLLARDS SHALL BE CONCRETE—FILLED PVC PIPE BOLLARDS $6^*\theta \times 5^*-0^*$ TALL. BOLLARDS SHALL BE PAINTED SAFETY YELLOW AND LABELED "LANDFILL GAS PIPES BURIED BELOW".




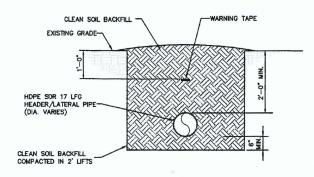

NOTES:

- WARNING TAPE SHALL BE MIN. 3" WIDE AND IMPRINTED WITH "CAUTION GAS LINE BURIED BELOW."
- ALL HEADER AND LATERAL PIPING SHALL BE INSTALLED AT 5% MIN. SLOPE UNLESS APPROVED IN ADVANCE BY THE ENGINEER.

LFG PIPE TRENCH DETAIL 3 NOT TO SCALE 11

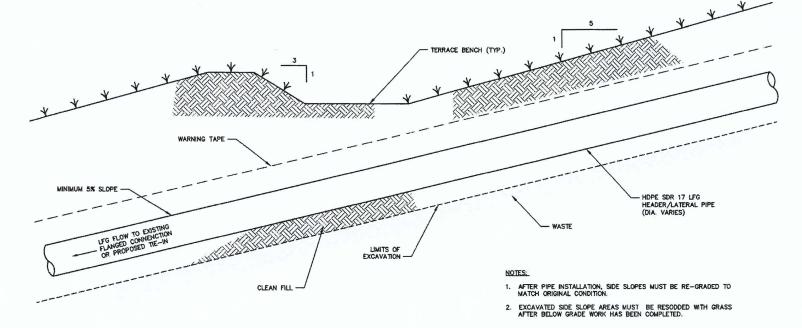

DRAINAGE SWALE CROSSING DETAIL 4
(TYP.) NOT TO SCALE 5 11

BID DRAWINGS

DATE: 05/05/2017

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SCS ENGINEERS
CONSULTING ENGIN


EXPANSION

GCCS AGE III AD LAN

2017 PHASE III G STA I ENA ROA

MANATEE COUNTY SOLID WASTE DIVISION

DETAILS

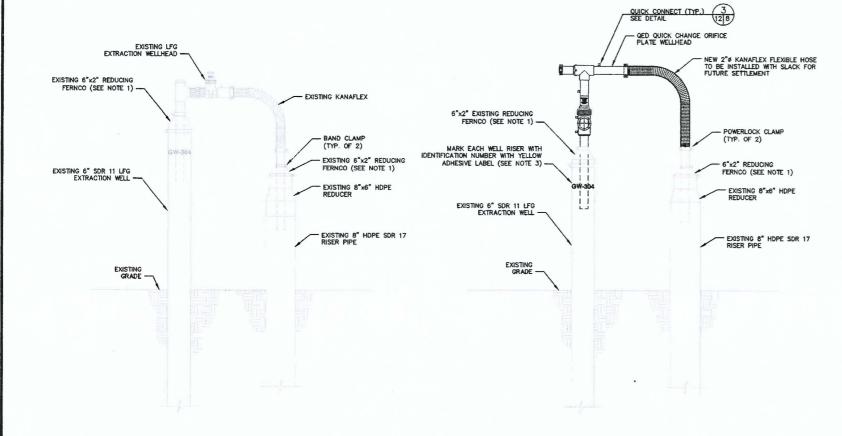

NOTES:

- NEW KANAFLEX, QED WELLHEAD, AND CONNECTION FITTINGS TO BE INSTALLED BY CONTRACTOR ON ALL PREVIOUSLY EXISTING LFG WELLS AS NOTED IN THE EXISTING WELL TABLE ON THIS SHEET. REPLACE EXISTING FERRON REDUCERS AND INSTALL NEW FERROC REDUCERS AS NEEDED.
- 2. 6° HDPE WELL STICKUP TO BE CLEANLY CUT AS NEEDED.
- CONTRACTOR IS RESPONSIBLE FOR REPLACING THE YELLOW WELL IDENTIFICATION STICKERS IF THAT SECTION OF WELL RISER IS REMOVED FOR NEW WELLHEAD INSTALLATION. SEE SPECIFICATION SECTION 33217 PART 2.03.



EXISTING WELLS TO RECEIVE NEW WELLHEADS

	WELL ID	- STAGE I	
GW- 1	GW- 42	GW- 110	GW- 152
GW- 2	GW- 43	GW- 111	GW- 153
GW- 3	GW- 44	GW- 112	GW- 154
GW- 4	GW- 45	GW- 113	GW- 155
GW- 5	GW- 46	GW- 114	GW- 156
GW- 6	GW- 47	GW- 115	GW- 157
GW- 7	GW- 48	GW- 116	GW- 158
GW- 8	GW- 49	GW- 117	GW- 159
GW- 9	GW- 50	GW- 118	GW- 161
GW- 10	GW- 51	GW- 119	GW- 162
GW- 11	GW- 52	GW- 120	GW- 163
GW- 12	GW- 53	GW- 121	GW- 164
GW- 13	GW- 54	GW- 122	GW- 165
GW- 14	GW- 55	GW- 123	GW- 166
GW- 15	GW- 56	GW- 124	GW- 167
GW- 16	GW- 57	GW- 125	GW- 168
GW- 17	GW- 58	GW- 126	GW- 169
GW- 18	GW- 59	GW- 127	GW- 170
GW- 19	GW- 60	GW- 128	GW- 171
GW- 20	GW- 61	GW- 129	GW- 172
GW- 21	GW- 90	GW- 130	GW- 173
GW- 22	GW- 91	GW- 131	GW- 174
GW- 23	GW- 92	GW- 134	GW- 175
GW- 24	GW- 93	GW- 135	GW- 176
GW- 25	GW- 94	GW- 136	GW- 177
GW- 26	GW- 95	GW- 137	GW- 178
GW- 27	GW- 96	GW- 138	GW- 179
GW- 28	GW- 97	GW- 139	GW- 180
GW- 29	GW- 98	GW- 140	GW- 181
GW- 30	GW- 99	GW- 141	GW- 182
GW- 31	GW- 100	GW- 142	GW- 183
GW- 32	GW- 101	GW- 143	GW- 184
GW- 33	GW- 102	GW- 144	GW- 185
GW- 34	GW- 103	GW- 145	GW- 186
GW- 35	GW- 104	GW- 146	GW- 190
GW- 37	GW- 105	GW- 147	GW- 191
GW- 38	GW- 106	GW- 148	GW- 195
GW- 39	GW- 107	GW- 149	GW- 196
GW- 40	GW- 108	GW- 150	GW- 197
GW- 41	GW- 109	GW- 151	GW- 198

METT ID -	STAGE III
GW- 300	GW- 323
GW- 301	GW- 324
GW- 302	GW- 325
GW- 303	GW- 326
GW- 304	GW- 336
GW- 305	GW- 337
GW- 306	GW- 338
GW- 307	GW- 339
GW- 308	GW- 340
GW- 309	GW- 341
GW- 310	GW- 342
GW- 311	GW- 343
GW- 312	GW- 344
GW- 313	GW- 345
GW- 314	GW- 346
GW- 315	GW- 347
GW- 316	GW- 348
GW- 317	GW- 360
GW- 318	GW- 361
GW- 319	GW- 362
GW- 320	GW- 367
GW- 321	GW- 368
GW- 322	

TOTAL: 45

TOTAL: 160

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500	-			~	7 4	23.2	~~	٠.

DATE: 05/05/2017

§ 00000 PROJECT THE 2017 PHASE III GCCS EXPANSION STAGE III LENA ROAD LANDFILL MANATEE COUNTY SOLID WASTE DIVISION SCS ENGINEERS
STEARNS, CONRAD AND SCHMIDT
OONSULTING REGISTERS
HO. (813) 821-0000 FAX HO. (813) 823-6757
PH NO. (813) 821-0000 FAX HO. (813) 823-6757
OSS 113,000 FW W.S. ON W CADD FILE: DETAILS MAY 2017 SCALE: AS SHOWN DRAWING NO. 12 SHEET 12 of 12