CONSTRUCTION PLANS

FOR

END OF SERVICE LIFE FORCE MAIN REPLACEMENT PACKAGE B: FM 8/ FM 15/ FM 1

MANATEE COUNTY, FLORIDA

SEPTEMBER 2018

MANATEE COUNTY PROJECTS #6089580, #6089680, #6089480

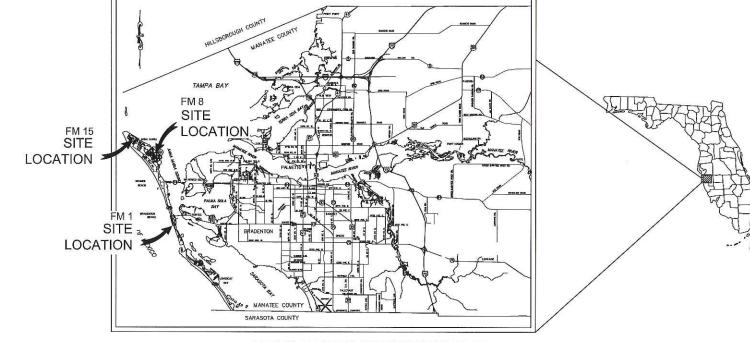
Manatee

PROJECT TEAM:

OWNER: MANATEE COUNTY 1022 26TH AVE. E. BRADENTON, FL 34208 CONTACT: MICHAEL STURM, P.E. 941-708-7450 ext. 7332

ENGINEER: KIMLEY-HORN AND ASSOCIATES, INC. 655 NORTH FRANKLIN STREET, SUITE 150 TAMPA, FL 33602 CONTACT: W. WADE WOOD, P.E. 813-635-5583 SURVEYOR: HYATT SURVEY SERVICES INC., 11007 8TH AVENUE EAST BRADENTON, FLORIDA 34212 CONTACT: JOHN MATTHEWS 941-748-4693

GEOTECH:
ARDAMAN & ASSOCIATES, INC.
78 SARASOTA CENTER BOULEVARD
SARASOTA, FLORIDA 34240
CONTACT: JERRY H. KUEHN, P.E.



SHEET LIST TABLE SHEET SHEET TITLE NUMBER **COVER SHEET** 2 **GENERAL NOTES** SURVEY AND SUE NOTES FORCE MAIN 8 KEY SHEET 5-7 PLAN AND PROFILE MARINA DRIVE FORCE MAIN 15 KEY SHEET 9-12 PLAN AND PROFILE NORTH BAY BLVD. 13 FORCE MAIN 1 KEY SHEET 14 PLAN AND PROFILE 6TH STREET 15 PLAN AND PROFILE GULF DRIVE 16 PLAN AND PROFILE 5TH STREET 17-18 PLAN AND PROFILE BAY DRIVE 19-20 PLAN AND PROFILE CHURCH AVENUE CONSTRUCTION DETAILS

UTILITY CONTACTS:

FLORIDA POWER & LIGHT GREG COKER 1253 12TH AVE. EAST PALMETTO, FL 34221 941-723-4430

FRONTIER COMMUNICATIONS PATTI REID 1701 RINGLING BLVD. SARASOTA, FL 34236 941-906-6711

CHARTER COMMUNICATIONS JIM CRUZAN 5413 S.R. 64 EAST, BRADENTON, FL 34208 727-329-2846 MANATEE COUNTY UTILITY RECORDS KATHY MCMAHON 4520- 66TH STREET W BRADENTON, FL 34210 941-792-8811 EXT. 5002

TECO PEOPLES GAS DANNY SHANAHAN 8261 VICO CT. SARASOTA, FL 34240 941–342–4006 PROJECT VICINITY MAP

PREPARED BY
Kimley»Horn

THE STIE CONSTRUCTION STAKEOUT STALL THE PERPENDING CUITDER HE DIRECT A FLORIDA REGISTERED SUBJECTIVE AUTOCAD FILES WILL BE FURNISHED TO THE SITE CONSTRUCTION FUNDS SHARL HE BROUGHT TO THE ENGINEER ATTENTION FOR CLARIFICATION FROM TO THAT STAKEOUT.

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GENERAL

- ALL CONSTRUCTION ACTIVITIES SHALL BE COORDINATED WITH THE PROJECT MANAGEMENT DIVISION.
 THE PROJECT MANAGER IS: MICHAEL STURM, P.E. AND CAN BE REACHED AT (941) 708-7450 X7332
- IF THE CONTRACTOR WANTS A SITE VISIT PRIOR TO BIDDING, THESE SHALL BE ARRANGED THROUGH THE COUNTY'S PURCHASING DIVISION.
- ALL CONSTRUCTION ON THIS PROJECT SHALL BE IN ACCORDANCE WITH THE LATEST EDITION OF MANATEE COUNTY UTILITY AND TRANSPORTATION STANDARDS AND/OR FDOT "STANDARD SPECIFICATIONS FOR ROAD AND BRIDGE
- 4. THE CONTRACTOR SHALL BE RESPONSIBLE FOR MEETING ALL CONDITIONS AND REQUIREMENTS OF ALL PERMITS AND ALL GOVERNING FEDERAL, STATE, AND LOCAL AGENCIES. THE CONTRACTOR SHALL OBTAIN AND PAY FOR ALL REQUIRED PERMITS THAT ARE NOT PROVIDED IN THE BID DOCUMENTS, AT NO ADDITIONAL COST TO THE OWNER.
- 5. THE INFORMATION PROVIDED IN THESE PLANS IS SOLELY TO ASSIST THE CONTRACTOR IN ASSESSING THE OWNER.

 AND EXTENT OF THE CONDITIONS WHICH MAY BE ENCOUNTERED DURING THE COURSE OF WORK. ALL CONTRACTORS
 ARE DIRECTED, PRIOR TO BIDDING, TO CONDUCT WHATEVER INVESTIGATION THEY MAY DEEM NECESSARY TO ARRIVE
 AT THEIR OWN CONCLUSIONS REGARDING THE ACTUAL CONDITIONS THAT WILL BE ENCOUNTERED, AND UPON WHICH
 THEIR BIDS WILL BE BASED.
- 6. THE CONTRACTOR SHALL REVIEW AND VERIFY ALL DIMENSIONS ON THE PLANS AND REVIEW ALL FIELD CONDITIONS THAT MAY AFFECT CONSTRUCTION. SHOULD DISCREPANCIES OCCUR, THE CONTRACTOR SHALL NOTIFY THE ENGINEER TO OBTAIN THE ENGINEER'S CLARIFICATION BEFORE COMMENCING WITH CONSTRUCTION.
- 7. THE CONTRACTOR SHALL NOTIFY SUNSHINE BI1 (1-800-432-4770) AT LEAST 2 FULL BUSINESS DAYS PRIOR TO CONSTRUCTION OPERATIONS, THE CONTRACTOR SHALL BE RESPONSIBLE FOR COORDINATING WITH ALL UTILITIES FOR THE POSSIBLE RELOCATION OR THE TEMPORARY MOVEMENT OF ANY EXISTING UTILITIES WITHIN THE RIGHTS-OF-WAY. IT IS THE CONTRACTOR'S RESPONSIBILITY TO PROTECT EXISTING UTILITIES FROM DAMAGE. EXPLORATORY EXCAVATION MAY BE REQUIRED PRIOR TO CONNECTION TO EXISTING UTILITIES.
- NO WORK, EXCEPT FOR EMERGENCY TYPE, SHALL BE PERFORMED AFTER 7:00 PM AND BEFORE 7:00 AM. FOR ADDITIONAL PROJECT RESTRAINTS, REFER TO SECTION 01310 OF THE SPECIFICATIONS.
- 9. THE CONTRACTOR SHALL PROVIDE CERTIFIED RECORD DRAWINGS AS OUTLINED IN THE SPECIFICATIONS. RED-LINE DRAWINGS SHALL BE CURRENT WITH EACH PAY APPLICATION SUBMITTED AND WILL BE CHECKED AS PART OF THE PAY APPLICATION REVIEW PROCESS. PAYMENT WILL NOT BE MADE TO CONTRACTOR WITHOUT APPROVED RED-LINE DRAWINGS. THE MOST CURRENT SET OF RED-LINE DRAWINGS. THE MOST CURRENT SET OF RED-LINE DRAWINGS SHALL ALSO BE BROUGHT TO EACH MONTHLY PROGRESS MEETING.
- 11. THE CONTRACTOR SHALL PROVIDE THE OWNER AND ENGINEER WITH A DETAILED CONSTRUCTION PHASING PLAN BASED ON THE CONNECTION SEQUENCING BELOW. EMISTING FORCE MAIN 8, FORCE MAIN 15, AND FORCE MAIN 1 SHALL REMAIN IN SERVICE UNTIL ALL CONNECTIONS TO THE PROPOSED FORCE MAIN ANE CONSTRUCTED.
- 12. ALL PROPOSED WORK SHALL BE COORDINATED WITH MANATEE COUNTY UTILITIES DEPARTMENT AT LEAST TWO WEEKS IN ADVANCE OF PROPOSED CONSTRUCTION.
- 13. THE CONTRACTOR SHALL FURNISH SHOP DRAWINGS TO THE ENGINEER FOR REVIEW OF ALL PIPE CONNECTIONS, TRANSITIONS, AND SPECIAL APPURTENANCES PRIOR TO FABRICATION OR DELIVERY TO THE JOB SITE.
- 14. UNLESS OTHERWISE INDICATED OR APPROVED, ALL BELOW GROUND DUCTILE IRON PIPE SHALL HAVE PUSH—ON OR MECHANICAL JOINTS, AND ALL ABOVE GROUND DUCTILE IRON PIPE SHALL HAVE FLANGED JOINTS. ALL JOINTS SHALL BE FULLY RESTRAINED PER THE DETAILS IN THESE PLANS.
- 15. SANITARY SEWERS AND FORCEMAINS CROSSING OVER OR UNDER WATER MAINS SHALL BE LAID TO PROVIDE A MINIMUM VERTICAL DISTANCE OF 18" BETWEEN THE INVERT OF THE UPPER PIPE AND THE CROWN OF THE LOWER PIPE. WHERE THIS MINIMUM SEPARATION CANNOT BE MAINTAINED, THE CROSSING SHALL BE ARRANGED SO THAT THE SEWER OR FORCE MAIN PIPE JOINTS ARE EQUIDISTANT FROM THE POINT OF CROSSING WITH NO LESS THAN 10' BETWEEN ANY TWO JOINTS. AS AN ALTERNATIVE, THE SEWER OR FORCE MAIN MAY BE PLACED IN A WATERTIGHT CASING PIPE, CONSISTENT WITH F.A.C. RULE 82-555.314.
- 16. ALL BELOW-GRADE FITTINGS 4—INCHES AND GREATER IN DIAMETER SHALL BE MECHANICAL JOINT DUCTILE IRON WITH PROTECTO 401 LIMING FOR THEIR INTERIOR SURFACES AND COAL TAR ENAMEL COATING ON EXTERIOR SURFACES, AS NOTED IN SECTION 02815 OF SPECIFICATIONS.
- 17. IT SHALL BE THE CONTRACTORS RESPONSIBILITY TO SECURE PROPERTY FOR STAGING MATERIALS AND EQUIPMENT.
- 18. IT WILL BE THE CONTRACTOR'S RESPONSIBILITY TO ACQUIRE, OR ENTER INTO AGREEMENTS, FOR LANDS FOR LAY DOWN AREAS AND STAGING. THE COUNTY WILL COORDINATE AND ADMSE, TO HELP IDENTIFY POSSIBLE PARCELS, IT IS FINALLY THE CONTRACTOR'S RESPONSIBILITY TO SECURE THE NEEDED AREAS, AND THE COUNTY TAKE NO RESPONSIBILITY FOR DELAYS IN THIS REGARD.
- 19. COORDINATION AND PUBLIC INFORMATION FOR AND WITH AREA RESIDENTS ARE OF THE UTMOST IMPORTANCE. CONTRACTOR WILL INSURE ADHERENCE TO THE COUNTY'S NOISE ORDINANCE, HAZARD AND SAFETY, AND NUISANCE ABATEMENT DIRECTIONS, PLANS, OBSECTIONS AND ORDINANCES. THE ENGINEER WILL HAVE THE FINAL DISCRETION IN THIS REGARD, AS REPRESENTED ONSITE BY THE COUNTY INSPECTOR AND ENGINEER'S STAFF.

- 20. THE CONTRACTOR SHALL BE RESPONSIBLE FOR COMPLIANCE WITH THE FLORIDA TRENCH SAFETY ACT, 90-96, LAWS OF FLORIDA EFFECTIVE OCTOBER 1, 1990 AND THE OCCUPATIONAL SAFETY AND HEALTH ADMINISTRATION EXCAVATION SAFETY SANDARDS, 29 CFR 1926-650, SUBPART P, AS AMENDED. THE CONTRACTOR SHALL INCLUDE IN THE TOTAL BID PRICE ALL COSTS FOR COMPLIANCE WITH THESE REGULATIONS.
- THE CONTRACTOR SHALL USE SHEET PILING, SHEETING, BRACING, ETC., AS REQUIRED IN ALL EXCAVATION AREAS AND CONFORM TO ALL OSHA REQUIREMENTS.
- 22. THE CONTRACTOR SHALL USE ALL NECESSARY SAFETY PRECAUTIONS TO AVOID CONTACT WITH OVERHEAD AND UNDERGROUND UTILITIES, POWER LINES, ETC.
- 23. THESE DRAWINGS DO NOT INCLUDE NECESSARY COMPONENTS FOR CONSTRUCTION SAFETY. THIS EXCLUSION DOES NOT ALLEMATE THE CONTRACTOR FOR PROVIDING A CONTINUOUS SAFE WORKSPACE.

- 24. WHEN A BENTONITE SPILL OF FRACK-OUT OCCURS OR THERE IS A LOSS OF RETURN INDICATING EXCESSIVE SEEPAGE OR LOSS OF ORILLING FLUID, DRILLING MUST BE STOPPED UNTIL THE LOCATION OF THE SPILL IS IDENTIFIED. UNDER NO CIRCUMSTANCES WILL DRILLING CONTINUE WHEN A SPILL IS APPARENT.
- 25. ONCE LOCATED, THE BENTONITE SPILL MUST BE ISOLATED AND SEEPAGE INTO ANY NEARBY WATER BODIES WILL BE BLOCKED DEPENDING ON THE DEGREE OF THE SPILL, THE ISOLATED BENTONITE MUST BE REMOVED MANUALLY OR MCCHANICALLY AND DISPOSED OF BY APPROPRIATE MEANS OR REUSED.
- 26. THE CONTRACTOR SHALL PROVIDE AND INSTALL ALL NECESSARY STORM WATER, EROSION, AND SEDIMENTATION CONTROL. MEASURES IN ACCORDANCE WITH THE FDEP "FLORIDA STORM WATER, EROSION AND SEDIMENTATION CONTROL INSPECTOR'S MANUAL". IT IS THE RESPONSIBILITY OF THE CONTROLOR TO CONTROL AND PREVENT EROSION AND TRANSPORT OF SEDIMENT TO SURFACE DRAINS AND TO DITCHES DURING CONSTRUCTION.
- 27. STOCKPILES SHALL BE PROTECTED AT ALL TIMES BY ON-SITE DRAINAGE CONTROLS WHICH PREVENT EROSION OF THE STOCKPILED MATERIAL, CONTROL OF DUST FROM SUCK STOCKPILES IS REQUIRED, DEPENDING UPON THEIR LOCATION AND THE EXPECTED LENGTH OF TIME THE STOCKPILES WILL BE PRESENT. IN NO CASE SHALL MY STOCKPILED MATERIAL REMAIN AFTER THIRTY (30) CALENDAR DAYS.
- 28. STORM WATER INLETS IN THE VICINITY OF THE PROJECT SHALL BE PROTECTED BY SEDIMENT TRAPS SUCH AS SECURED HAY BALES, SOO, STONE, ETC., WHICH SHALL BE MAINTAINED AND MODIFIED AS REQUIRED BY CONSTRUCTION PROGRESS, AND WHICH MUST BE APPROVED BY THE ENGINEER BEFORE INSTALLATION. THIS WILL BE MAINTAINED TO PREVENT DEGRADATION OF THE WATERS OF THE COUNTY AND STATE.
- 29. SEDIMENT BASINS AND TRAPS, PERIMETER BERNS, SEDIMENT BARRIERS, VEGETATIVE BUFFERS, AND OTHER MEASURES INTENDED TO TRAP SEDIMENT AND/OR PREVENT THE TRANSPORT OF SEDIMENT CONTO AJACENT PROPERTIES, OR INTO EXISTING BODIES OF WATER, MUST SE INSTALLED, CONSTRUCTED, OR IN THE CASE OF VEGETATIVE BUFFERS, PROTECTED FROM DISTURBANCE, AS A FIRST STEP IN THE LAND ALTERATION PROCESS. SUCH SYSTEMS SHALL BE FULLY OPERATIVE BEFORE ANY OTHER DISTURBANCE OF THE SITE BEGINS. EARTHEN STRUCTES INCLIDING BUT NOT LIMITED TO BERNS, EARTH FILTERS, DAMS OR DIKES SHALL BE STABILIZED AND PROTECTED FROM DRAINAGE DAMAGE OF FRESSION WITHIN ONE (") WHEN OR INSTALL AIRON. DAMAGE OR EROSION WITHIN ONE (1) WEEK OF INSTALLATION.
- ALL SWALES, DITCHES, AND CHANNELS LEADING FROM THE SITE SHALL BE PROTECTED FROM SILTATION AND EROSION DURING CONSTRUCTION AND BE SODDED WITHIN THREE (3) DAYS OF EXCAVATION.

REVISIONS

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- 32. SOIL DISPLACED BY CONSTRUCTION WILL BE REMOVED. EROSION CONTROL SHALL BE IMPLEMENTED IN AREAS WHICH ARE CONSIDERED ENVIRONMENTALLY SENSITIVE. EROSION CONTROL SYSTEMS SHALL BE REQUIRED FOR ALL WORK WITHIN JURISDICTIONAL AREAS. THESE SYSTEMS MAY INCLUDE STAKED HAY BALES, SILT SCREENS, FILTER FABRIC, AND TURBIDITY SCREENS.
- 33. THE CONTRACTOR SHALL NOT ENTER UPON OR IN ANY WAY ALTER WEILAND AREAS THAT MAY BE ON OR NEAR THE CONSTRUCTION SITE. ALL WORK IN THE VICINITY OF OPEN WATER AND/OR WEILANDS IS TO BE PERFORMED IN COMPLIANCE WITH THE ENVIRONMENTAL REGULATIONS AND/OR PERMITS FOR THE SITE. THE CONTRACTOR WILL BE RESPONSIBLE FOR ANY FINES RESULTING FROM HIS WOLATION OF ANY REGULATIONS OR PERMIT CONDITIONS.
- 34. CONTRACTOR SHALL PROVIDE PROTECTIVE MATTING, FUEL CONTAINMENT AND ALL OTHER MATERIALS, EQUIPMENT AND LABOR TO PROTECT THE STAGING AREA DURING CONSTRUCTION.
- 35. CONTRACTOR SHALL, PRIOR TO BEGINNING CONSTRUCTION, SUBMIT A "FUELING SPILL PREVENTION PLAN" THAT SHALL CLEARLY INDICATE HOW FUEL SPILLS WILL BE PREVENTED WHEN FUELING BOTH WITHIN AND OUTSIDE OF THE STAGING AREA.

RIGHT-OF-WAY

- 36. ALL CONSTRUCTION ACTIVITIES SHALL BE LIMITED TO WITHIN THE MANATEE COUNTY RIGHT-OF-WAY, OTHER PUBLIC RIGHT-OF-WAYS OR EASEMENTS SHOWN ON THE DRAWINGS.
- 38. THE CONTRACTOR, PRIOR TO CONSTRUCTION AND RESTRICTING ANY TRAFFIC, MUST OBTAIN ANY REQUIRED RIGHTS—OF—WAY USE PERMITS AND A TRAFFIC CONTROL PLAN. THE CONTRACTOR SHALL OBTAIN ALL REQUIRED PERMITS FROM OTHER GOVERNMENTAL AGENCIES HAVING RELEVANT JURISDICTION. ALL MAINTANCE AND PROTECTION OF TRAFFIC ADALL BE IN ACCORDANCE WITH THE APPLICABLE REQUIREMENTS OF THE CURRENT FLORIDA DEPARTMENT OF TRANSPORTATION, "MANUAL OF TRAFFIC CONTROL AND SAFE PRACTICES". A TRAFFIC CONTROL PLAN SHALL BE SUPPLIED BY THE CONTRACTOR AT THE PRE—CONSTRUCTION MEETING, PER SPECIFICATIONS 01570.
- 39. THE CONTRACTOR SHALL BE RESPONSIBLE FOR REPLACING ALL DAMAGED STORM WATER STRUCTURES, PIPING, ENTRANCE PIE AND HEADWALLS WHETHER SHOWN ON THE PLANS OR NOT. THE HEADWALLS SHALL BE REPLACED IN ACCORDANCE WITH F.O.O.T. STRANGARDS, OR THE APPLICABLE JURISDICTION.
- 40. IT IS THE RESPONSIBILITY OF THE CONTRACTOR TO ESTABLISH IN THE FIELD THE RIGHT—OF—WAY LINES, BASE LINES, BENCH MARKS (ELEV.), CENTER LINES, AND STATIONING AS REQUIRED TO CONSTRUCT THIS PROJECT.
- 41. THE CONTRACTOR SHALL COORDINATE THE CUTTING OF DRIVEWAYS WITH THE PROPERTY OWNER PRIOR. ALL DRIVEWAYS MUST BE IN PASSABLE CONDITION AT THE END OF THE WORK DAY AND FULLY RESTORED.

- 43. LOCATIONS, ELEVATIONS AND DIMENSIONS OF EXISTING UTILITIES, STRUCTURES AND OTHER FEATURES ARE SHOWN TO THE BEST INFORMATION AVAILABLE AT THE TIME OF PREPARATION OF THESE PLANS BUT DO NOT PURPORT TO BE ARSOLUTELY CORRECT. THERE MAY BE OTHER IMPROVEMENTS, UTILITIES, ETC. WHICH ARE WITHIN THE PROJECT AREA AND WHICH HAVE NOT BEEN LOCATED OR IDENTIFIED, MAY NOT BE IN THE EXACT LOCATION SHOWN OR RELOCATED SINCE THE PREPARATION OF THESE PLANS. THE CONTRACTOR SHALL VERIFY, PRIOR TO CONSTRUCTION, THE LOCATIONS, ELEVATIONS AND DIMENSIONS OF ALL EXISTING UTILITIES STRUCTURES AND OTHER PRATURES (WHETHER OR NOT SHOWN ON THE PLANS) THAT MAY EFFECT HIS WORK. ALL EXISTING UTILITIES TO BE EXTENDED, CROSSED OR CONNECTION POINTS SHALL BE EXPOSED PRIOR TO CONSTRUCTION TO VERIFY LOCATION AND ELEVATION. AND
- 44. THE CONTRACTOR SHALL PROTECT ALL EXISTING STRUCTURES, WATER AND SEWER LINES, STORM DRAINS, UTILITIES, DRIVEWAYS, SIDEMALKS, SIGNS, MAIL BOXES, FENCES, TREES, LANDSCAPING, AND ANY OTHER IMPROVEMENT OR FACILITY IN THE CONSTRUCTION ACTIVITIES TO EQUAL OR BETTER THAN PRE—CONSTRUCTION CONDITIONS AT NO ADDITIONAL COST TO THE CAMER
- 45. THE CONTRACTOR SHALL USE APPROPRIATE TECHNIQUES, AS APPROVED, RECOMMENDED OR OFFERED BY FLORIDA POWER AND LIGHT TO PREVENT UNDERMINING OF POWER POLES DURING CONSTRUCTION. IF HOLDING OF POWER POLES IS RECOMMENDED OR REQUIRED BY THE UTILITY, THE CONTRACTOR SHALL COORDINATE THIS ACTIVITY WITH THE UTILITY AND BEAR ALL RELATED COSTS.
- 46. ANY TEMPORARY SHUTDOWNS FOR MODIFICATIONS OF EXISTING UTILITY SYSTEMS THAT MUST REMAIN IN SERVICE DURING CONSTRUCTIONS SHALL BE KEPT TO A MINIMUM AND SHALL BE COORDINATED WITH AND APPROVED BY THE MANATEE COUNTY UTILITY OPERATIONS EPPARTMENT IN ACCORDANCE WITH THE CONTRACT DOCUMENTS. IT IS NOTED THAT TEMPORARY SHUTDOWNS MAY BE RESTRICTED TO CERTAIN HOURS AT ANY TIME OF THE DAY OR NIGHT AND WILL BE COMPLETED AT NO ADDITIONAL COST TO THE OWNER.
- 47. FOR WORK BEING DONE ON EXISTING SANITARY SEWER LINES, THE CONTRACTOR SHALL BE RESPONSIBLE FOR MAINTAINING THE FLOW OF ALL SEWAGE DURING CONSTRUCTION, WHICH MAY REQUIRE BY-PASS PUMPING AND/OR PUMPER TRUCKS. THE CONTRACTOR SHALL SUBMIT A DETAILED WF-PASS PUMPING PLAN PER SECTION D2720.
- 48. THE ELEVATIONS OF THE UTILITY SERVICES AND LATERALS HAVE BEEN ASSUMED ON THE BASIS OF TYPICAL ANTICIPATED SOIL COVERAGE. CONTRACTOR SHALL NOT RELY ON THIS INFORMATION FOR CONSTRUCTION, BUT SHALL BE RESPONSIBLE FOR FELD LOCATIONS (HORIZONTAL AND VERTICAL) OF ALL UTILITIES CROSSING THE PROPOSED FORCE MAIN. CONTRACTOR SHALL INCLUDE IN THE UNIT COST OF THE SUBJECT FORCE MAIN CONTRUCTION, THE COST OF ITILITY ADJUSTMENTS NECESSARY TO ATTAIN DESIGN MINIMUM SEPARATION FOR UTILITIES CONFLICTING WITH THE CONSTRUCTION OF THE PROPOSED FORCE MAIN. INTERRUPTIONS OF ANY EASTING UTILITY SERVICES SHALL BE NOTICED TO EFFECTED CUSTOMERS A MINIMUM OF 48 HOURS IN ADVANCE AND SHALL NOT EXCEED 4 HOURS IN DURATION.

- 49. ALL RESTORATION WORK PERFORMED THROUGHOUT THE PROJECT SHALL CONFORM TO EXISTING LINES AND GRADES UNLESS SHOWN OTHERWISE.
- 50. ALL DISTURBED GRASSED AREAS SHALL BE SODDED UNLESS OTHERWISE INDICATED, THE TYPE OF SOD USED TO REPLACE OWNER MAINTAINED AREAS IN RIGHT-OF-WAY SHALL BE COORDINATED WITH THE PROPERTY OWNER.
- 51. ALL CONCRETE THRUST BLOCKS INSTALLED FOR TESTING PURPOSES AND NOT REQUIRED FOR THE OPERATION OF THE PIPELINE SHALL BE REMOVED AND DISPOSED OF BY THE CONTRACTOR, PRIOR TO FINAL ACCEPTANCE, AT NO ADDITIONAL COST TO THE OWNER.
- 52. ASPHALT DRIVES THAT ARE CUT SHALL BE RESTORED PER SECTION 02513.
- 53. CONCRETE DRIVEWAYS OR SIDEWALKS THAT ARE CUT SHALL BE RESTORED TO MATCH EXISTING ACCORDING TO THE CURRENT EDITIONS OF THE F.D.O.T. SPECIFICATIONS FOR ROAD AND BRIDGE DESIGN, SECTION 522, AND SECTION 310 OF THE F.D.O.T. DESIGN STANDARDS.
- 54. WHENEVER A PERMANENT ROADWAY SURFACE IS NOT REPLACED IMMEDIATELY AFTER BACKFILLING AND COMPACTION OF THE NEMLY INSTALLED PIPE LINE IN AREAS WHERE TRAFFIC MUST PASS, THE CONTRACTOR SHALL INSTALL A TEMPORARY SURFACE CONSISTING OF INIE INCHES OF COMPACTED LIME ROCK BASE AND A COAT OF ASPHALT EMULSION. PERMANENT ROADWAY REPAIR SHALL BE PERFORMED A MAXIMUM OF TWENTY-ONE CALENDAR DAYS AFTER THE INITIAL OPEN CUTTING.
- 55. RESTORATION OF CURBS, DRIVEWAYS, SIDEWALKS, AND PLACEMENT OF SOD SHALL BE COMPLETED WITHIN FORTY—FIVE CALENDAR DAYS OF INITIAL DISTURBANCE, OR TWENTY—ONE CALENDAR DAYS OF SUBSTANTIAL COMPLETION, WHICHEVER OCCURS FIRST.
- 57. WHERE CONCRETE REPAIRS ARE NECESSARY AND EXPANSION OR CONTRACTION JOINTS ARE PRESENT, CONTRACTOR SHALL REMOVE AND REPLACE CONCRETE UP TO THE NEXT EXPANSION OR CONTRACTION JOINT.

- 58. THE EXHAUST SYSTEM OF ALL GASOLINE AND DIESEL ENGINES SHALL BE EQUIPPED WITH MUFFLERS THAT MEET THE EQUIPMENT MANUFACTURER'S REQUIREMENTS FOR NOISE SUPPRESSION. THE CONTRACTOR SHALL INSTALL INSTALL NOISE ABATEMENT BAFFLES POSITIONED TO BREAK LINE-OF-SITE FROM THE NOISE SOURCE TO AFFECTED RESIDENCES, AS APPROVED BY THE ENGINEER.
- 59. NO MATERIAL SHALL BE STOCKPILED IN ROADWAYS. ALL DIRT AND DEBRIS SHALL BE REMOVED FROM THE JOB SITE DAILY. ROADS SHALL BE SWEPT DAILY AS PART OF DAILY CLEAN UP.
- 60. THE CONTRACTOR IS TO CONTROL ALL FUGITIVE DUST ORIGINATING ON THIS PROJECT BY WATERING OR OTHER METHODS AS REQUIRED.

- DEWATERING IS REQUIRED TO 18" BELOW TRENCH BOTTOM.
- 64. ALL PIPING AND FITTINGS USED ON THIS PROJECT SHALL BE AS NOTED ON THE PLANS AND IN THE CONTRACT DOCUMENT AND SHALL BE INSTALLED TO THE LINES AND GRADES SHOWN ON THE PLANS AND PROFILES.
- 65. ALL PIPE SHALL BE COLOR CODED TO CONFORM TO MANATEE COUNTY STANDARDS
- , all fittings for pressure class—rated pipe shall be restrained ductile iron, restrained lengths of pipe shall adhere to the requirements as shown on the detail sheets.
- 67. WHERE IT IS NECESSARY TO DEFLECT PIPE EITHER HORIZONTALLY OR VERTICALLY, PIPE DEFLECTION SHALL NOT EXCEED 75% OF THE MANUFACTURER'S MAXIMUM ALLOWABLE RECOMMENDED DEFLECTION.
- 68. ALL ROCKS OR STONES LARGER THAN SIX INCH DIAMETER SHALL BE REMOVED FROM THE BACKFILL MATERIAL BACKFILL MATERIAL PLACED WITHIN ONE FOOT OF PIPING AND APPURTENANCES SHALL NOT CONTAIN ANY STONES LARGER THAN TWO INCH DIAMETERS.
- 69. ONLY MANATEE COUNTY UTILITY OPERATIONS STAFF ARE AUTHORIZED TO OPERATE VALVES AND PUMP STATIONS OF COUNTY OWNED AND MAINTAINED UTILITY SYSTEMS.
- 70. THE CONTRACTOR, PRIOR TO ANY TEMPORARY WATER SHUT-OFFS DURING WATER MAIN TIE-IN, ETC., SHALL NOTIFY THE AFFECTED RESIDENTS BY POSTING INFORMATIONAL SIGNS IN THE NEIGHBORHOOD AT LEAST TWO DAYS (48 HRS) PRIOR TO THE WATER SHUT-OFF. REFERENCE SECTION 01580, PARAGRAPH 1.03 OF THE SPECIFICATIONS. WHEN FEASIBLE, 'DOOR HANGERS' SHALL BE DELIVERED TO AFFECTED RESIDENCES AT LEAST TWO DAYS (48 HRS) PRIOR TO WATER SHUT-OFF. FOR LARGE PROJECTS WITH HUNDRIEDS OF HOMES AFFECTED, THE CONTRACTOR SHALL ALSO TO WATER SHOT LEFF. FOR CARGE PROJECTS WITH HOURIEUS OF HOMES AFFECTED, HE CONTRACTOR SHALL ALSO
 MAKE EXTENSIVE USE OF THE MEDIA AND SHALL HAVE PRIOR CONTACT WITH HOMEOWNER'S ASSOCIATIONS AND THE
 RESPECTIVE CITY'S. WRITTEN NOTHICATIONS SHALL ALSO BE FAXED TO THE TAMPA TRIBUNE, BRADENTON HERALD,
 AMI SUN, ISLANDER, SARASOTA HERALD TRIBUNE, WAS RADIO RADIO, EMERGENCY COMMUNITY CONTENS, INSPECTIONS,
 WATER TREATMENT PLANT, WATER MANAGER, HELPLINE, CUSTOMER SERVICE, AND THE MANATEE COUNTY UTILITY
 OFERATIONS DEPARTMENT.
- ALL EXISTING MAINS THAT ARE BEING REPLACED SHALL BE ABANDONED IN PLACE UPON ACCEPTANCE AND ACTIVATION OF THE NEW MAINS. ABANDONED MAINS SHALL BE CUT AND CAPPED, REFER TO SECTION 02064 OF THE SPECIFICATIONS FOR CUT AND CAPPING ABANDONED PIPE.
- 73. FIELD CONDITIONS MAY NECESSITATE MINOR ALIGNMENT AND GRADE DEVIATION OF THE PROPOSED UTILITIES TO AVOID OBSTACLES, AS ORDERED BY THE ENGINEER.
- 74. THE CONTRACTOR SHALL OBTAIN AUTHORIZATION FROM THE MANATEE COUNTY UTILITIES DEPARTMENT (MCUD) OFFICE OF INDUSTRIAL COMPLIANCE PRIOR TO DEWATERING. COMPLETION OF A CONSTRUCTION DEWATERING AUTHORIZATION TO DISCHARGE APPLICATION IS REQUIRED, FILL OUT FORM AS COMPLETELY AS POSSIBLE AS MISSING INFORMATION DELAYS THE APPROVAL PROCESS.
- 75. THE MCUD OFFICE OF INDUSTRIAL COMPLIANCE WILL DETERMINE WHETHER A LETTER OF APPROVAL, A DISCHARGE AUTHORIZATION, OR A DISCHARGE PERMIT IS REQUIRED.
- 76. FOR SITES SUSPECTED OF CONTAMINATED GROUNDWATER MANATEE COUNTY WILL REQUIRE AN APPLICANT TO DEMONSTRATE THAT THE DISCHARGE MEETS THE MANATEE COUNTY SEWER USE ORDINANCE.
- 77. IF ANY RECLAIMED OR WATER MAINS INCLUDING SERVICE LINES ARE DAMAGED DURING CONSTRUCTION, THEY SHALL BE REPLACED FROM THE VALUE TO THE OTHER POINT OF CONNECTION OUTSIDE OF THE ROADWAY PER MANATEE COUNTY'S STANDARDS. SERVICES SHALL BE REPLACED FROM THE COLD STOP TO THE METER.

- . TRAFFIC SHALL BE MAINTAINED IN ACCORDANCE WITH F.D.O.T. DESIGN STANDARDS INDICES NO. 600, 603, 605, 611, 612, 613, 616, AND 660 DEPENDING ON THE OPERATION BEING PERFORMED. FOR ALL TWO-LANE WORK, TWO-WAY, WORK WITHIN TRAVEL LANE UTILIZE INDEX 603. FOR ALL TWO-LANE WORK, TWO-WAY, WORK NEAR INTERSECTION UTILIZE INDEX 605, FOR ALL MULTILANE WORK OUTSIDE SHOULDER UTILIZE INDEX NO. 611.

- FOR ALL MULTILANE WORK ON SHOULDER UTILIZE INDEX NO. 612.
 FOR ALL MULTILANE WORK WITHIN TRAYEL WAY MEDIAN OR OUTSIDE LANE UTILIZE INDEX NO. 613.
 FOR ALL MULTILANE WORK NEAR INTERSECTION MEDIAN OR OUTSIDE LANE UTILIZE INDEX NO. 616.
 FOR PEDESTRIAN CONTROL FOR CLOSURE OF SIDEWALK, UTILIZE FOOT INDEX NO. 660.
- 79. CONTRACTOR TO COORDINATE WITH ED HERNDON (941) 708-4436 AT FDOT FOR ALL WORK DONE ON A STATE FACILITY.
- 80. TO AVOID DISRUPTION DUE TO INCLEMENT WEATHER, THE CONTRACTOR SHOULD PERFORM ANY MILLING AND PAYING OPERATIONS DURING THE SAME WORK PERIOD.
- ALL EXISTING PAVEMENT MARKINGS OUTSIDE THE CONSTRUCTION LIMITS THAT HAVE BEEN ALTERED BECAUSE OF CONSTRUCTION OPERATIONS SHALL BE REPLACED UPON THE COMPLETION OF THE PROJECT AT THE CONTRACTORS EXPENSE.
- 82. LANE CLOSURES SHALL OCCUR BETWEEN 9:00 P.M. AND 5:00 A.M., UNLESS LANE CLOSURE CALCULATIONS ARE PROVIDED AND APPROVED OR APPROVAL IS GRANTED BY THE DISTRICT PERMIT ENGINEER.
- THE CONTRACTOR SHALL SCHEDULE WORK OPERATIONS SO THAT ALL LANES CAN BE RE-OPENED TO TRAFFIC WITHIN A PERIOD OF 24 HOURS IN CASE OF AN EMERGENCY.
- 83. PEDESTRIANS, BICYCLES, AND WHEELCHAIRS:
 AT THE END OF EACH WORKDAY OR WHENEVER THE WORK ZONE BECOMES INACTIVE, ANY DROP-OFF ADJACENT TO A SIDEWALK SHALL BE BACKFILLED AT A SLOPE NOT TO EXCEED 1:4, OR SHALL BE PROTECTED IN ACCORDANCE WITH STREAM INDEX 600.
- 84. PEDESTRIAN AND WHEELCHAIR TRAFFIC SHALL BE ACCOMMODATED UTILIZING STANDARD INDEX 650.
- 85. ONE PORTABLE VARIABLE MESSAGE SIGN SHALL BE USED IN ADVANCE OF EACH LANE CLOSURE, THE FOLLOWING ARE SUGGESTED MESSAGES TO USE IN THE APPROPRIATE SITUATIONS:

"RIGHT" OR "CENTER" OR "LEFT"
"LANE" "LANE" "LANE" "CLOSED" "CLOSED"

- 86. THE CONTRACTOR SHALL BE RESPONSIBLE FOR THE IMMEDIATE REMOVAL OF STORMWATER FROM ROADWAYS UTILIZED FOR TRAFFIC CONTROL IN A MANNER APPROVED BY THE ENGINEER.
- 87. AT THE END OF EACH WORKING DAY'S ACTIVITY, TEMPORARY PAVEMENT MARKINGS AND TEMPORARY RPM'S SHALL BE INSTALLED PRIOR TO OPENING THE LANES UP FOR TRAFFIC.
- 88. ALL PAVEMENT MARKINGS, SIGNS, MARKERS, CHANNELIZATION REQUIRED TO PHASE WORK OR SHIFT TRAFFIC, SHALL UTILIZE INDICES FOR PLACEMENT.

- 89. THE CONTRACTOR SHALL RESTRICT THE OPERATIONS SO THAT THE HIRST LIFT OF ASHALT IS PLACED ON THE SAME DAY THAT THE LANES ARE MILLED, BEFORE OPENING THE LANES TO TRAFFIC, INSTALL TEMPORARY PAVEMENT MARKINGS AFTER THE FIRST LIFT AND PRIOR TO OPENING. THE OFFICE HOURS.

 90. MILLING AND RESURFACING SHALL BE ACCOMPLISHED DURING THE OFFICE HOURS.

 91. THE CONTRACTOR IS RESPONSIBLE TO RETIME THAT C SIGNALS WITHIN A PLEASURED CHARGE CONTROL.) THAT ARTS POTENDALLY SAFECTED DURING VARIOUS PHASES OF CONSTRUCTION. COORDINATE ALL SIGNAL RETIME EFFORTS MUKUNDASCOPALAKRISHNA, P.E., PTOE, SOUNTY-TRAFFIC ENGINEER, AT 941–749–3500, EXT. 7813.

- 92. CONTRACTOR TO MAINTAIN VEHICLE DETECTION IN OPERATION FOR LANES THAT WILL REMAIN OPEN. CONTRACTOR TO COORDINATE ALL VEHICLE DETECTION ISSUES WITH CLARKE DAMS OF MANATE COUNTY AT 941-708-7450, EXT. 7272 OR CLARKE.DAVISOM/MANATEE.CRG
- 93. MAINTENANCE OF TRAFFIC AND ANY SIGNAL RETIMING WILL BE THE RESPONSIBILITY OF THE CONTRACTOR.
- 94. ANY SIGNAL RETIMING REQUIRED FOR THE INTERSECTIONS IMPACTED BY THE PROJECT WILL BE THE RESPONSIBILITY OF THE CONTRACTOR. SIGNAL TIMING MODIFICATIONS TO BE SUBMITTED TO MANATIE COUNTY TRAFFIC DESIGN, ATTENTION MR. MUKUNDA GOPALAKRISHNA FOR REVIEW AND APPROVAL AT LEAST 15 WORKING DATS BEFORE PROPOSED CHANGES. THIS DOES NOT GOVERN BEREGREVS TUTATIONS, PEDIDING THE APPROVAL OF THE ENGINEER.
- 95. A DETAILED MAINTENANCE OF TRAFFIC PLANS ARE TO BE SUBMITTED TO MANATEE COUNTY AND THE ENCINEER, BY THE CONTRACTOR, FOR REVIEW AND APPROVAL A MINIMUM OF 21 WORKING DAYS PRIOR TO PROPOSED IMPLEMENTATION.

ALL WORK PERFORMED WITHIN THE FDOT R/W SHALL CONFORM TO:

- FDOT STANDARD SPECIFICATION FOR ROAD AND BRIDGE CONSTRUCTION (2016) (A.K.A. STANDARD SPECS).
 FDOT DESIGN STANDARDS FOR DESIGN, CONSTRUCTION, MAINTENANCE AND
- OPERATIONS ON THE STATE HIGHWAY SYSTEM, 2016, (A.K.A. STANDARD INDEX). COMPLIANCE WITH ALL APPLICABLE INDICES IS REQUIRED.
- FLORIDA DEPARTMENT OF TRANSPORTATION ROADWAY PLANS PREPARATION MANUAL, VOLUME 1, CHAPTERS 2 AND 25. (REVISED 2013).
- FLORIDA DEPARTMENT OF TRANSPORTATION FLEXIBLE PAVEMENT DESIGN MANUAL FOR NEW CONSTRUCTION AND PAVEMENT REHABILITATION, JANUARY
- ALL TRAFFIC STRIPES AND MARKINGS ARE TO BE LEAD FREE, NON-SOLVENT BASED THERMOPLASTIC. THE PERMITTEE SHALL FURNISH THE DEPARTMENT WITH THE MANUFACTURER'S CERTIFICATION THAT THE THERMOPLASTIC IS LEAD FREE:
- 'LEAD FREE'.

 LANE CLOSURE MAY NEED TO BE ALTERED DEPENDING ON THE AREA THE WORK IS TAKING PLACE.

 THE FOLLOWING ASPHALT REPAIRS WITHIN FDOT R/W SHOULD BE AS FOLLOWS: COMPACTED AND DENSITY TESTED SOIL IN 8 INCH LIFTS WITH A DOX DENSITY UP TO A DEPTH OF 10 INCHES, THEN PLACE 10 INCHES OF SP 12.5 STRUCTURAL ASPHALT IN 2 INCH LIFTS, AND THEM MILL THE WIDT OF THE NORTHISOLUM AND SOUTHBOUND LARE TO A DEPTH OF 1.5 INCHES AND RESURFACE WITH 1.5 INCHES OF FC 12.5 FIRCTION COURSE.

BT — BURIED TELEPHONE UC — UNDERGROUND CONDUIT DBC — DIRECT BURIED CABLE FOC — FIBER OPIC CABLE SS — SANITARY SEWER FM — FORCE MAIN WM — WATER MAIN RW — RECLAIM WATER MAIN RW — RECLAIM WATER MAIN FCP — ELIPTICAL CONCRETE PIPE A — ASPHALT NG — NATURAL GROUND G — GRAVEL S — SHELL ABBREVIATIONS RJ - RESTRAINED JOINT RJ — RESTRAINED JOINT R/W = RIGHT-OF-WAY HDD — HORIZOTAL DIRECTIONAL DRILL RCP — REINFORCED CONCRETE PIPE ARV — AIR RELEASE VALVE HDPE — HIGH DENSITY POLYETHYLENE PVC — POLYMYNL CHLORIDE ST — STORM DRAIN EX — EXISTING SHELLCONCRETE KIMLEY HORN LEGEND

PROPOSED FORCEMAIN/ WATERMAIN

EX. FORCEMAIN EX. WATERMAIN ABANDONED WATERMAIN EX. SANITARY SEWER

EX. STORM EX. BURIED TELEPHONE

EX. FIBER OPTIC CABLE

EX. BURIED ELECTRIC

EX. OVERHEAD UTILITIES

PROPOSED FULL ROADWAY RESTORATION

PROPOSED SIDEWALK/ DRIVEWAY REPAIR PROPOSED CURB REPAIR

PROPOSED MILLING AND RESURFACING

EX. CONCRETE DRIVEWAY

EX. ASPHALT DRIVEWAY EX. BRICK DRIVEWAY

EX. INFILTRATION TRENCH

SHEET NUMBER

GENERAL NOTES

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655 NORTH FRANKLIN STREET, SUITE 150, TAMPA, FL 33602

PHONE: 813-620-1460

WWW.KIMLEY-HORN.COM CA 00000696

KHA PROJECT 148400016 DATE 9/10/2018 SCALE AS SHOW DESIGNED BY WWV DRAWN BY

END OF SERVICE LIFE PACKAGE B: FM 8/ FM 15/ FM1 CHECKED BY WEW MANATEE COUNTY

HILL SEER W. WAD MOUNT ...

	FM 8 TEST H (ECHEZABAL & AS		
TEST HOLE	UTILITY	SURFACE TYPE	DEPTH TO TOP OF PIPE (FEET)
TH-20	1.25" DBC BY FRONTIER	NG	1.48
TH-21	2" DBC BY FRONTIER	NG	2.91

NOTE: SUBSURFACE UTILITY ENGINEERING DATA PROVIDED BY ECHEZABAL & ASSOCIATES, INC. DATED DECEMBER 14, 2017.

	FM 1 TEST HO (ECHEZABAL & ASSO			
TEST HOLE	UTILITY	SURFACE TYPE	DEPTH TO TOP OF PIPE (FEET)	
TH-01	16" DIP WM COBB	A	2.80	
TH-02	16" DIP WM COBB	A	3.63	
TH-03	4" PVC BT FRONTIER	NG	2.25	
TH-04	2" STL WM COBB	A	2.96	
TH-05	4" POLY GAS TECO	NG	4.74	
TH-06 6" DIP WM COBB		A	3.37	
TH-07	4" POLY GAS TECO PEOPLES	G	3.75	
TH-08	4" POLY GAS TECO PEOPLES GAS	A	3.53	
TH-09	6" DIP SAN FM MANATEE CO.	A	2.98	
TH-10	4" POLY GAS TECO PEOPLES GAS	A	6.44	
TH-11	6" DIP SAN FM MANATEE CO.	A	4.68	
TH-12	5/8" DBC TELECOM FRONTIER	NG	2.76	
TH-13	5/8" DBC TELECOM FRONTIER	NG	2.24	
TH-14	5/8" DBC TELECOM FRONTIER	S	2.09	
TH-15	5/8" DBC TELECOM FRONTIER	5	1.87	
TH-16	6" WM PLASTIC FG MANATEE	A	2.81	
TH-17	6" DIP WM MANATEE CO.	G	2.69	
TH-18	1.5" POLY GAS TECO PEOPLES	A	2.42	
TH-19	6" AC WM MANATEE CO.	A	3.04	
TH-22	8" PVC WM MANATEE CO.	NG	3.87	
TH-23	(2) 1.5" POLY BT FRONTIER	C/NG	2.82	
TH-24	6" DIP SAN FM MANATEE CO.	A	3.13	
TH-25	6" PLASTIC WM MANATEE CO.	A	2.45	
TH-25	6" AC WM MANATEE CO	A	2.80	

NOTE: SUBSURFACE UTILITY ENGINEERING DATA PROVIDED BY ECHEZABAL & ASSOCIATES, INC, DATED DECEMBER 20, 2017.

SURVEY NOTES

		FM 8 SITE CONTROL		
DESIGNATION	NORTHING	EASTING	ELEVATION (FEET)	DESCRIPTION
BM-5	1158412.28	422205.42	2.29	IRS (LB 7203
BM -6	1157884.45	423039.92	2.02	ND (LB 6690)
BM-5491	1158013.94	422875.43	2.21	IRS (LB 7203

THE FOLLOWING NGS VERTICAL CONTROL MONUMENT WAS RECOVERED AND UTILIZED FOR THE ELEVATIONS INDICATED HEREIN: "GIS 100" PID AG9205 NAVD 1988 ELEVATION 2.56"

		FM 15 SITE CONTROL		
DESIGNATION	NORTHING	EASTING	ELEVATION (FEET)	DESCRIPTION
BM-3	1163831.60	418465,69	2.85	IRC (LB 7203)
BM-4	1164339.33	417562.66	2.50	IRC (LB 7203)

THE FOLLOWING NGS VERTICAL CONTROL MONUMENT WAS RECOVERED AND UTILIZED FOR THE ELEVATIONS INDICATED HEREIN: "S 254" PID AG5205 NAVD 1988 ELEVATION 11.10'

DESIGNATION	NORTHING	EASTING	ELEVATION (FEET)	DESCRIPTION
BM-25	1140044.78	429897.37	13.10	ND (LB 7203)
BM-26	1139417.03	430101.25	2.98	ND (LB 7203)
BM-28	1139020.71	430301.98	4.16	IRC (LB 7203)
BM-29	1138735.27	430265.02	2.65	IRC (LB 7203)
BM-30	1138260.89	430188.95	2.53	IRC (LB 7203)
BM-31	1138171.81	429824.07	4.99	ND (LB 7203)
BM-32	1137959.74	429955.51	5.01	IRC (LB 7203)

THE FOLLOWING NGS VERTICAL CONTROL MONUMENT WAS RECOVERED AND UTILIZED FOR THE ELEVATIONS INDICATED HEREIN: "GIS 100" PID AG9205 NAVD 1988 ELEVATION 2.56"

- LEGEND

 SITE CONTROL POINT

 IRON PIPE FOUND

 IRON ROD FOUND

 CRORETE MONUMENT FOUND

 PP.S. SIGN

 OWOOD UTILITY POLE

 CONCRETE UTILITY POLE

 WATER METER

 WATER VALVE

 SANITARY MANHOLE

 FIRE HYDRANT

 BACKFLOW PREVENTER
- → BACKFLOW PREVENTER
 □ UTILITY BOX
 □ UTILITY RISER
- © ELECTRIC SERVICE BOX
 © TELEPHONE SERVICE BOX
- R/W RIGHT-OF WAY
- IRC IRON ROD W/ CAP * PINE
- TREE
- TH-1 TEST HOLE ₩ B-1 BORE HOLE

No. 69051 No. 69051

SURVEY AND SUE NOTES

SHEET NUMBER

3

KHA PROJECT 148400016 DATE 9/10/2018 SCALE AS SHOWN DESIGNED BY WWW DRAWN BY LMB

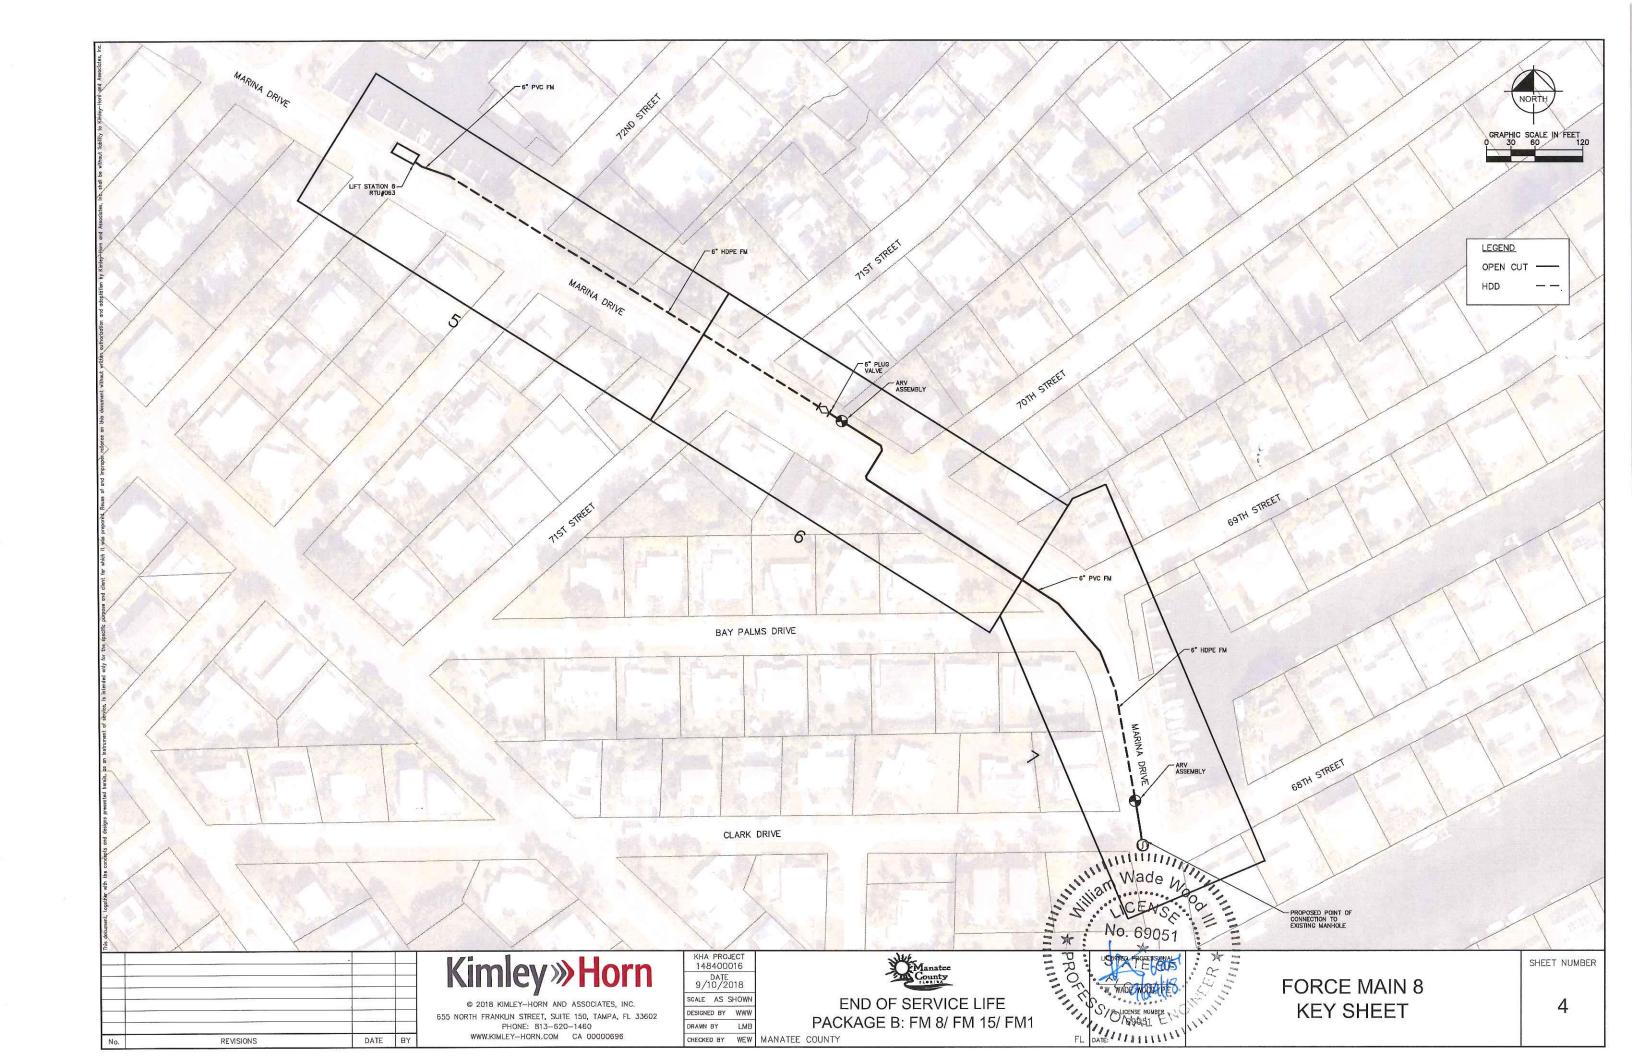
END OF SERVICE LIFE PACKAGE B: FM 8/ FM 15/ FM1

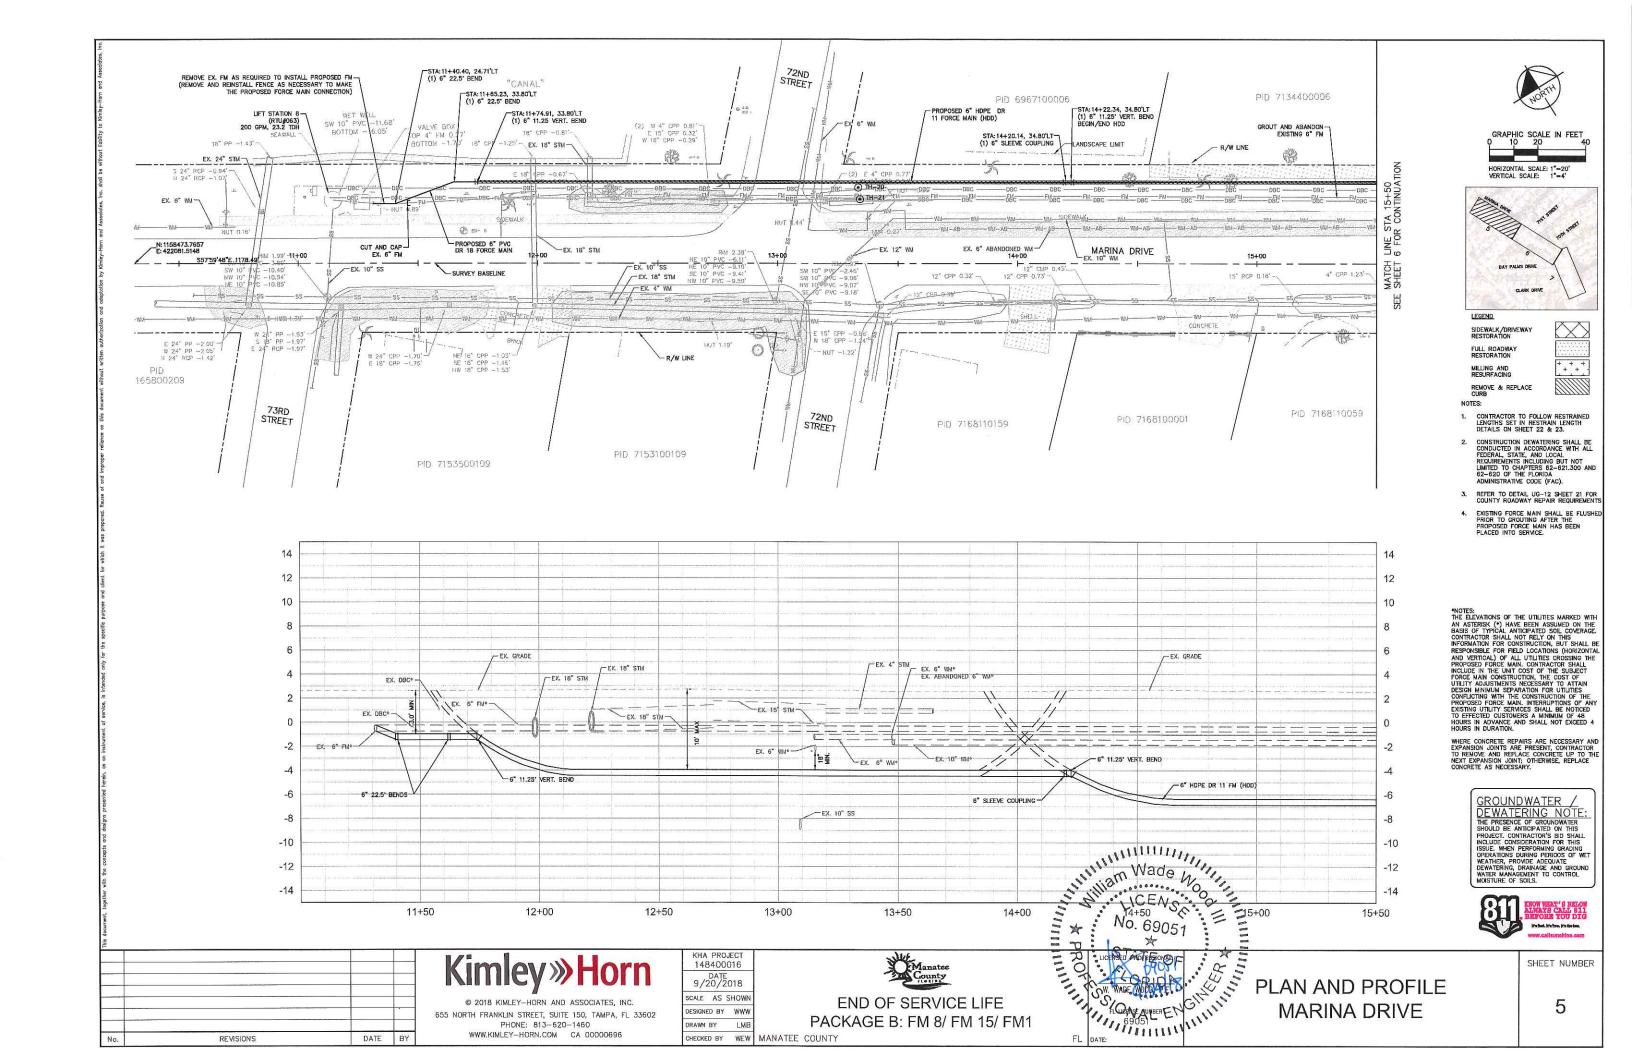
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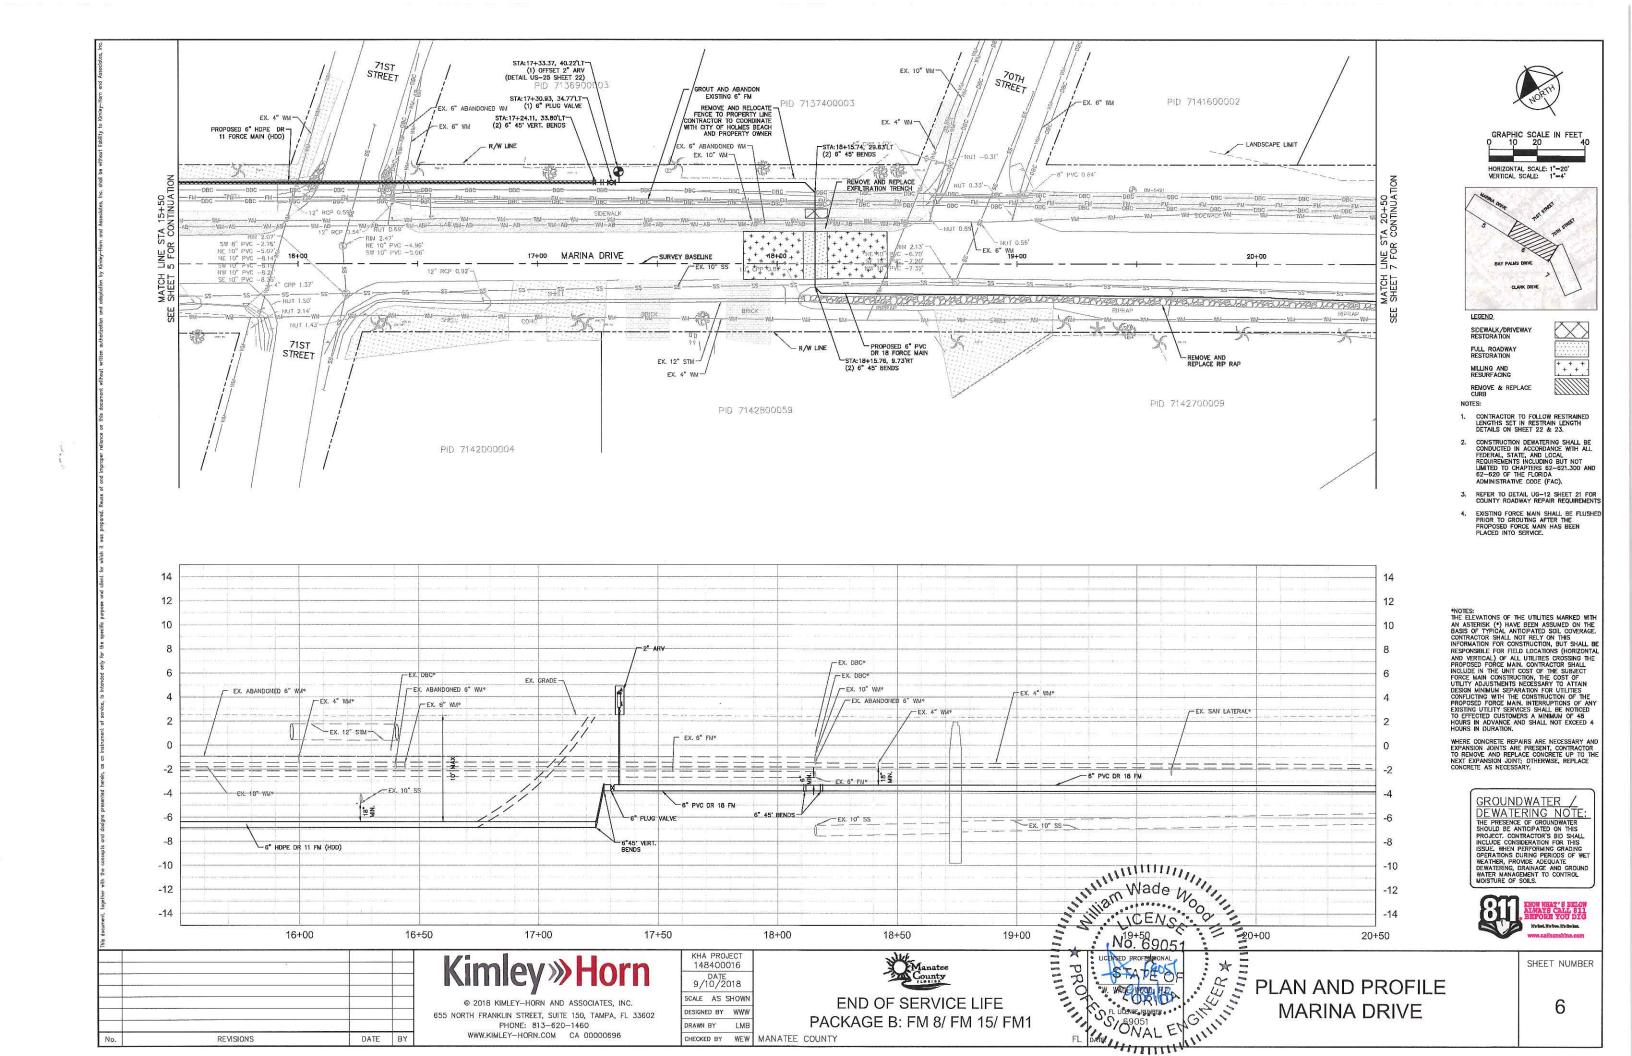
REVISIONS

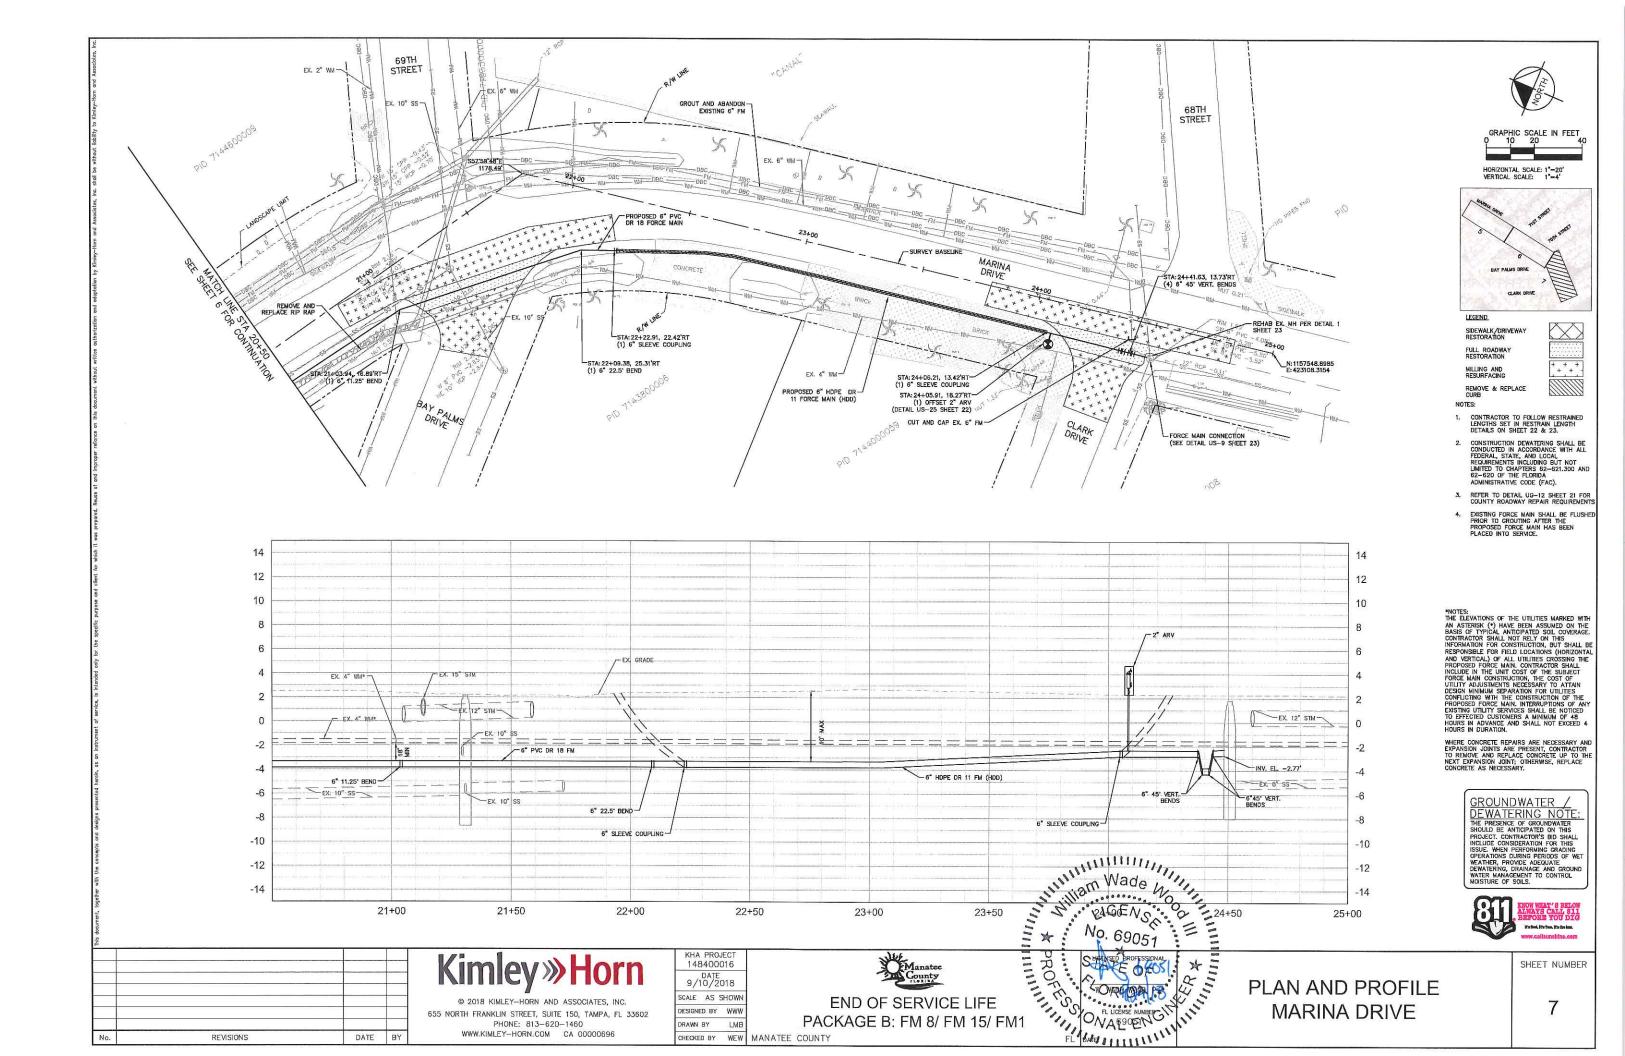
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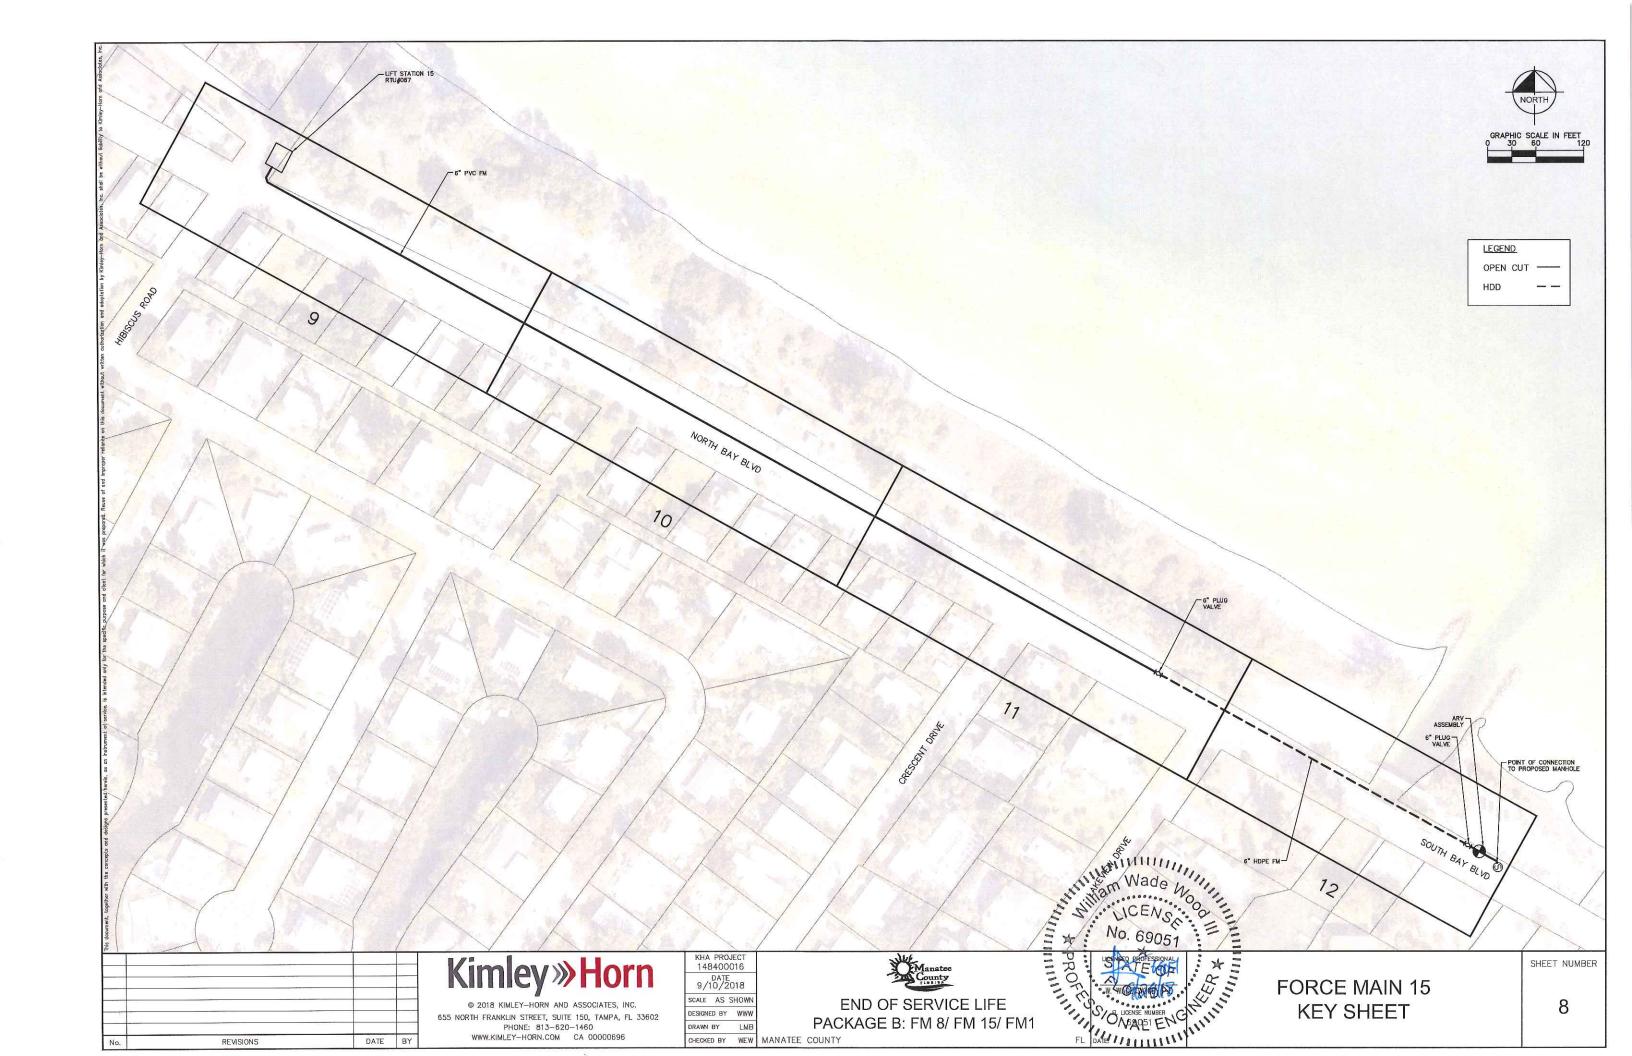
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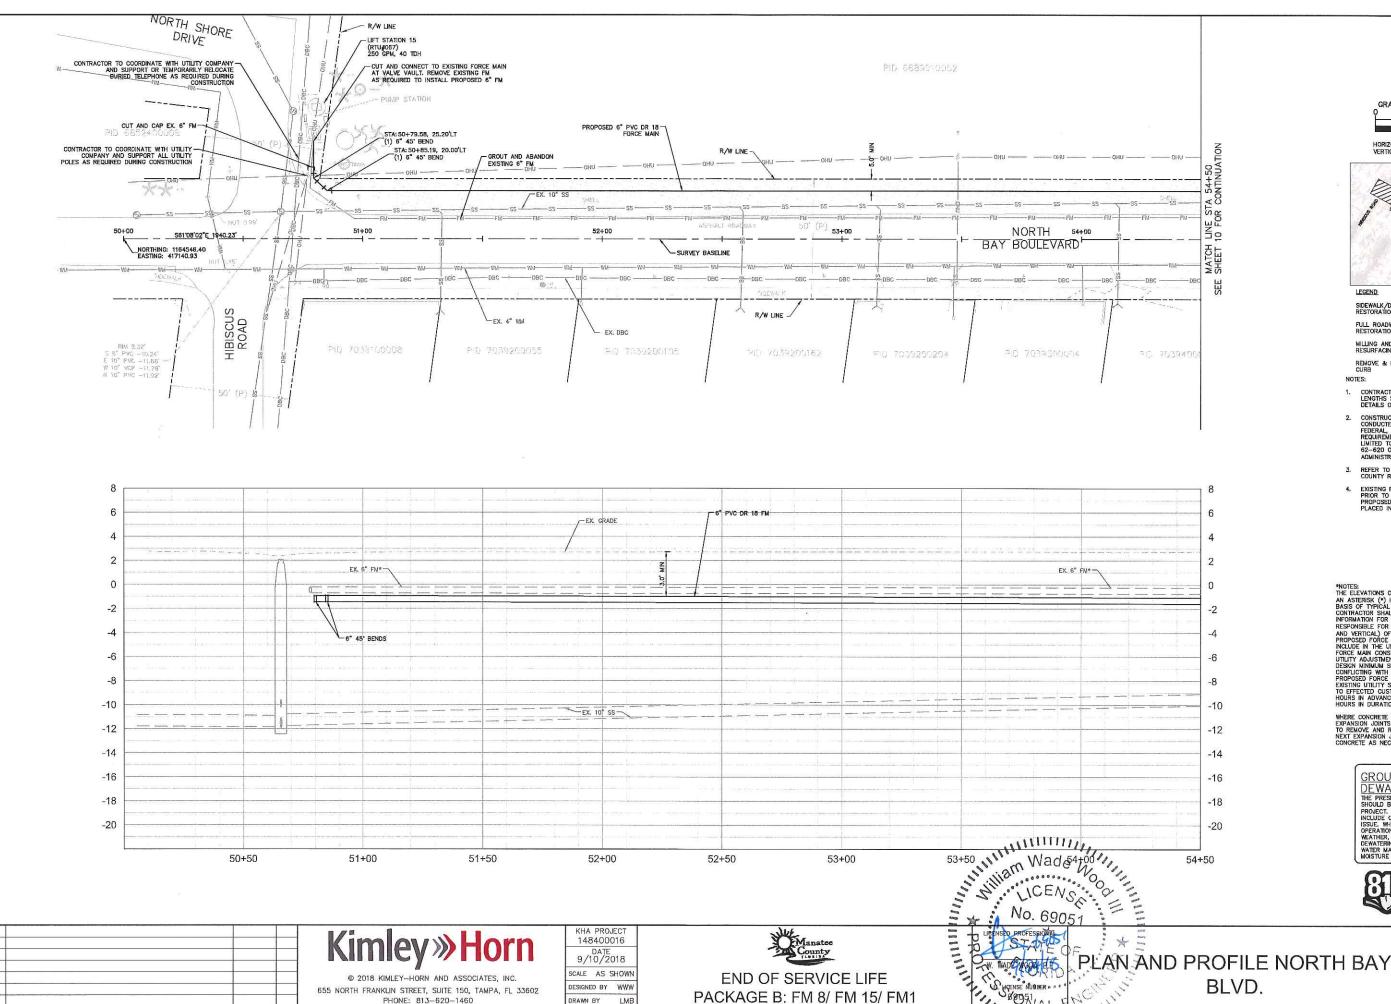












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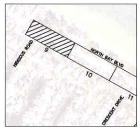
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REVISIONS

DATE BY



HORIZONTAL SCALE: 1"=20" VERTICAL SCALE: 1"=4"



+ + +

MILLING AND RESURFACING

REMOVE & REPLACE CURB

NOTES:

CONTRACTOR TO FOLLOW RESTRAINED LENGTHS SET IN RESTRAIN LENGTH DETAILS ON SHEET 22 & 23.

- 2. CONSTRUCTION DEWATERING SHALL BE CONDUCTED IN ACCORDANCE WITH ALL FEDERAL, STATE, AND LOCAL REQUIREMENTS INCLUDING BUT NOT LIMITED TO CHAPTERS 82-621.300 AND 62-620 OF THE FLORIDA ADMINISTRATIVE CODE (FAC).
- REFER TO DETAIL UG-12 SHEET 21 FOR COUNTY ROADWAY REPAIR REQUIREMENTS
- EXISTING FORCE MAIN SHALL BE FLUSHE PRIOR TO GROUTING AFTER THE PROPOSED FORCE MAIN HAS BEEN PLACED INTO SERVICE.

*NOTES:
THE ELEVATIONS OF THE UTILITIES MARKED WITH AM ASTERISK (*) HAVE BEEN ASSUMED ON THE BASIS OF TYPICAL ANTIGIPATED SOIL COVERAGE, CONTRACTOR SHALL NOT REIZ ON THIS RESPONSIBLE FOR FIELD LOCATIONS (HORIZONTAL AND VERTICAL) OF ALL UTILITIES CROSSING THE PROPOSED FORCE MAIN. CONTRACTOR SHALL INCLUDE IN THE UNIT COST OF THE SUBJECT FORCE MAIN CONSTRUCTION, THE COST OF UTILITY ADJUSTMENTS NECESSARY TO ATTAIN DESIGN MINIMUM SEPARATION FOR UTILITIES OF THE CONSTRUCTION OF THE PROPOSED FORCE MAIN. INTERRUPTIONS OF ANY EXISTING UTILITY SERVICES SHALL BE NOTICED TO EFFECTED CUSTOMERS A MINIMUM OF 48 HOURS IN ADVANCE AND SHALL NOT EXCEED 4 HOURS IN DURATION.

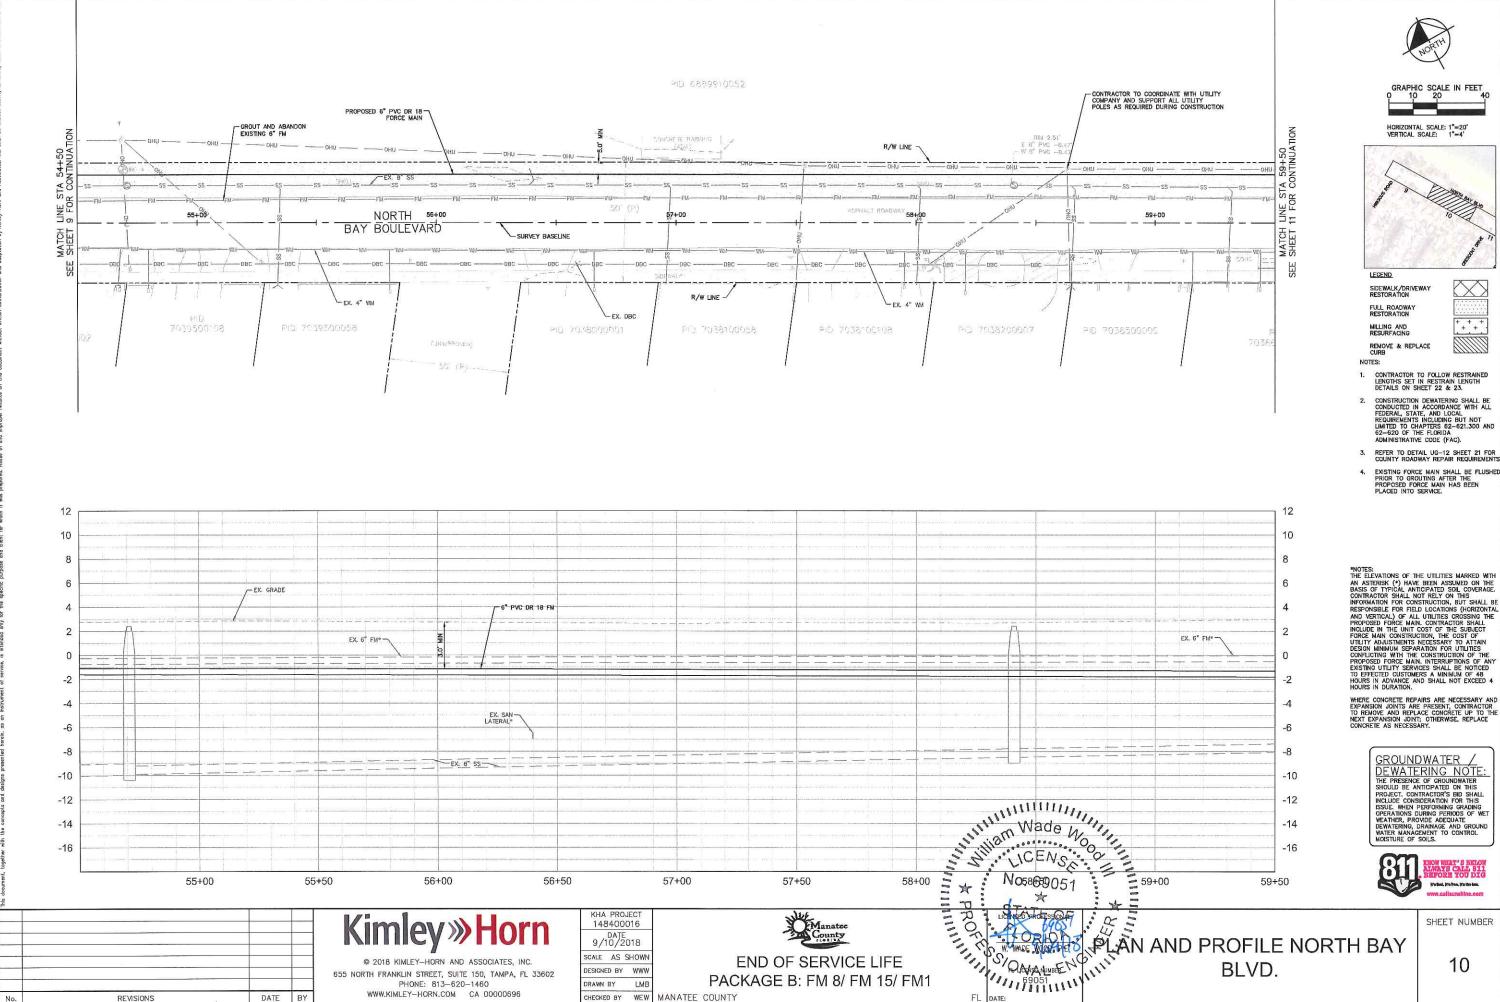
WHERE CONCRETE REPAIRS ARE NECESSARY AND EXPANSION JOINTS ARE PRESENT, CONTRACTOR TO REMOVE AND REPLACE CONCRETE UP TO THE NEXT EXPANSION JOINT, OTHERWISE, REPLACE CONCRETE AS NECESSARY.

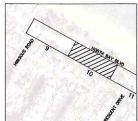
GROUNDWATER

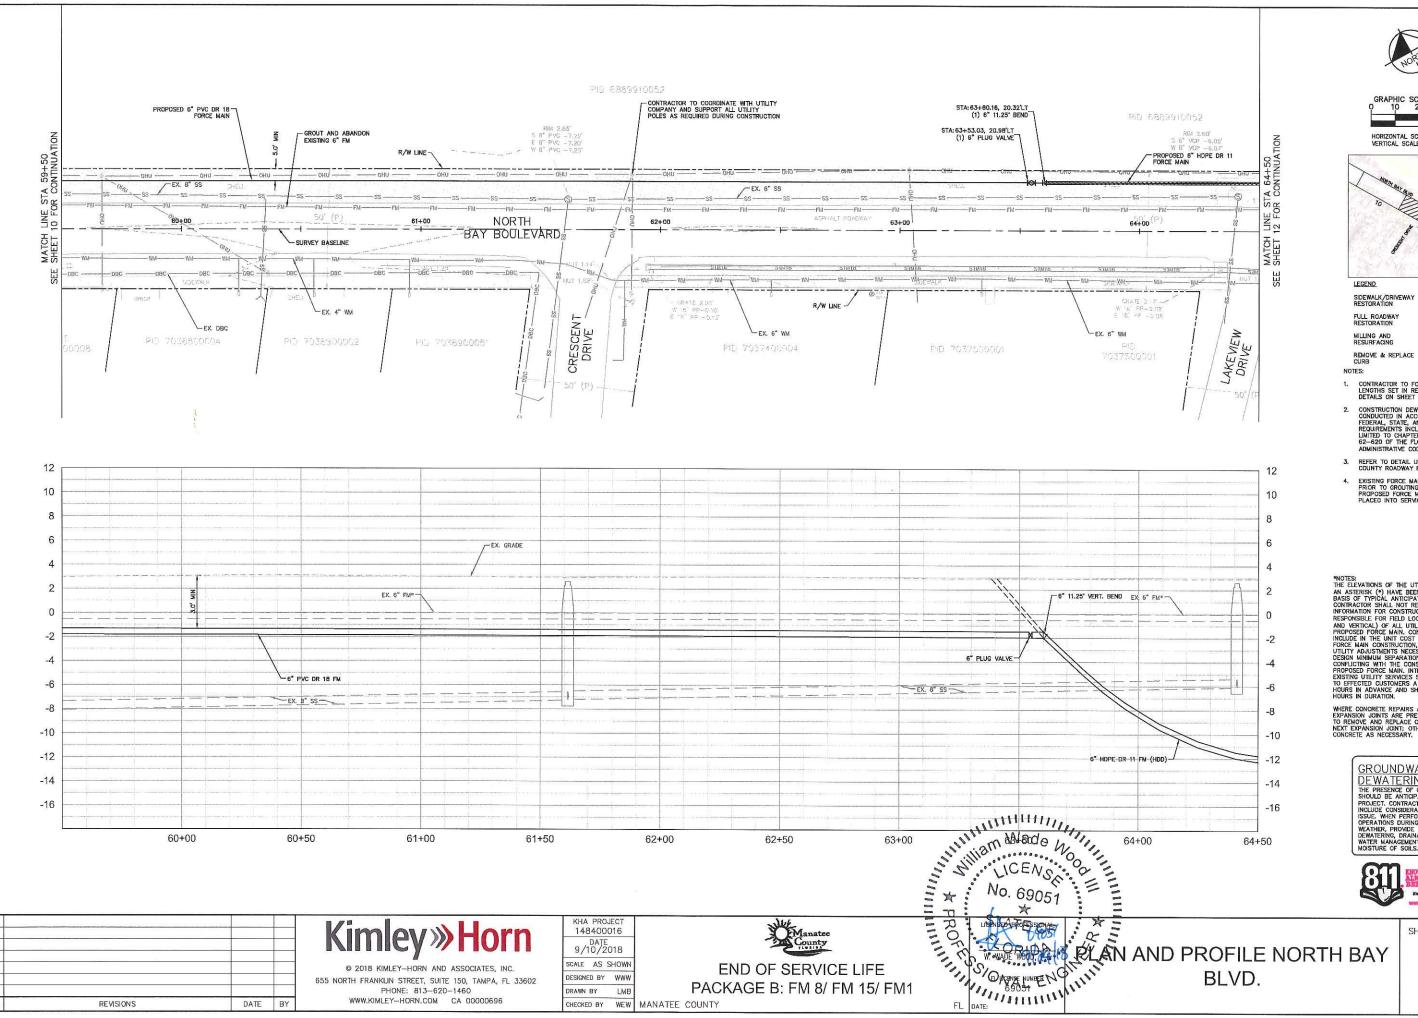
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WATER MANAGEMENT TO CONTROL
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SHEET NUMBER







HORIZONTAL SCALE: 1"=20' VERTICAL SCALE: 1"=4'



FULL ROADWAY RESTORATION

CONTRACTOR TO FOLLOW RESTRAINED LENGTHS SET IN RESTRAIN LENGTH DETAILS ON SHEET 22 & 23.

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- REFER TO DETAIL UG-12 SHEET 21 FOR COUNTY ROADWAY REPAIR REQUIREMENTS
- EXISTING FORCE MAIN SHALL BE FLUSHED PRIOR TO GROUTING AFTER THE PROPOSED FORCE MAIN HAS BEEN PLACED INTO SERVICE.

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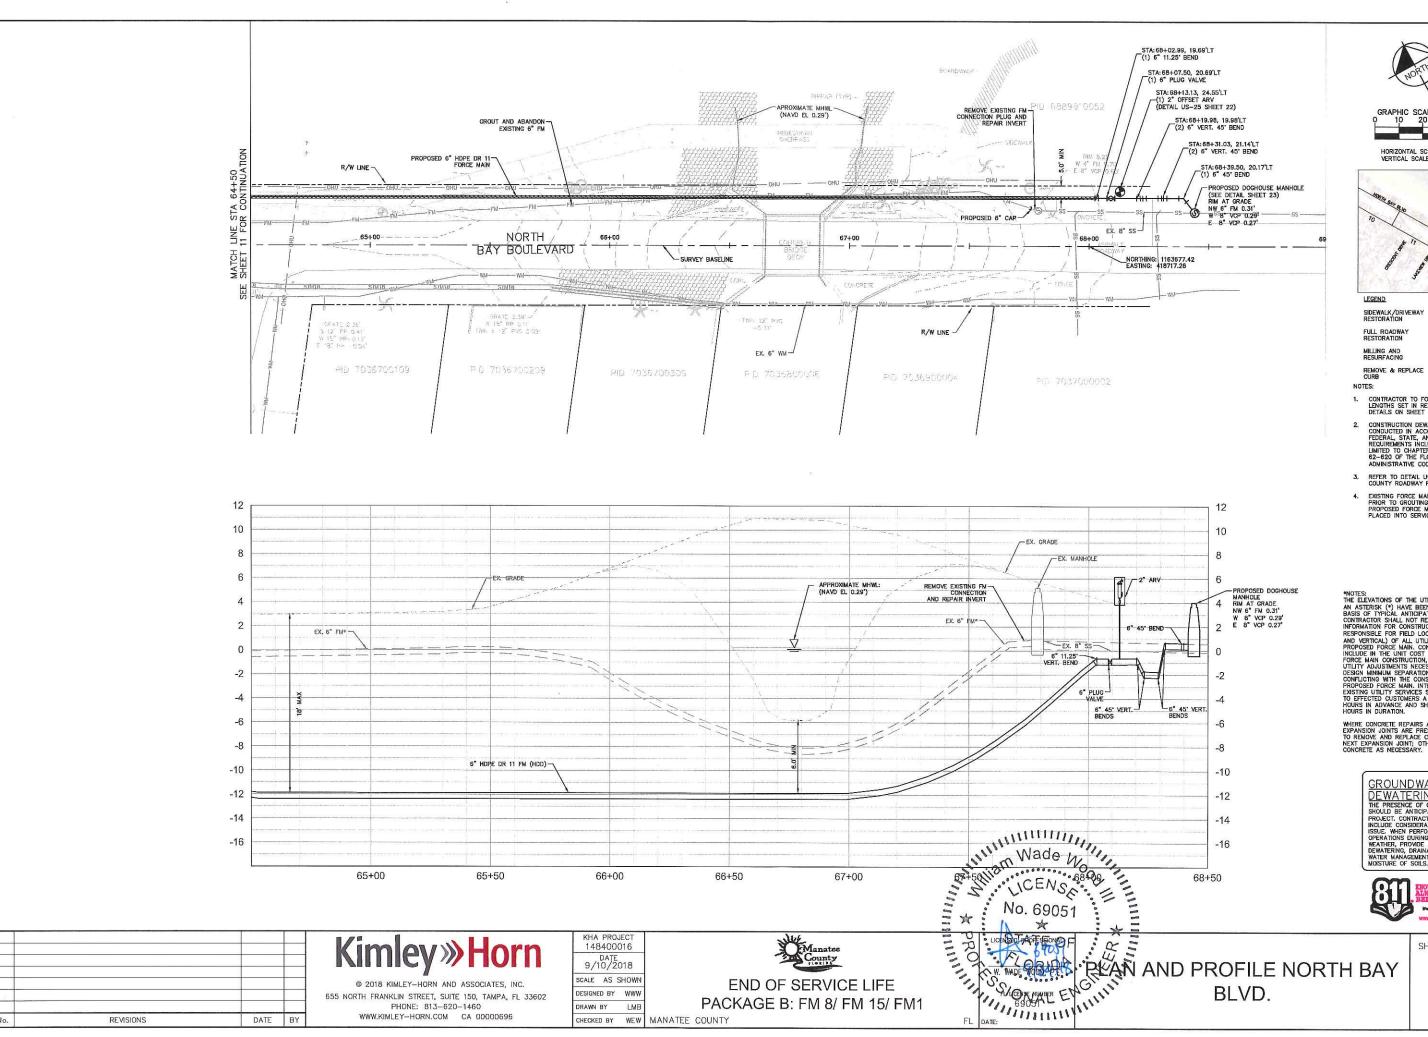
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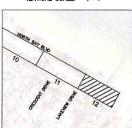


SHEET NUMBER





HORIZONTAL SCALE: 1"=20" VERTICAL SCALE: 1"=4"



CONTRACTOR TO FOLLOW RESTRAINED LENGTHS SET IN RESTRAIN LENGTH DETAILS ON SHEET 22 & 23.

+ + +

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- REFER TO DETAIL UG-12 SHEET 21 FOR COUNTY ROADWAY REPAIR REQUIREMENT
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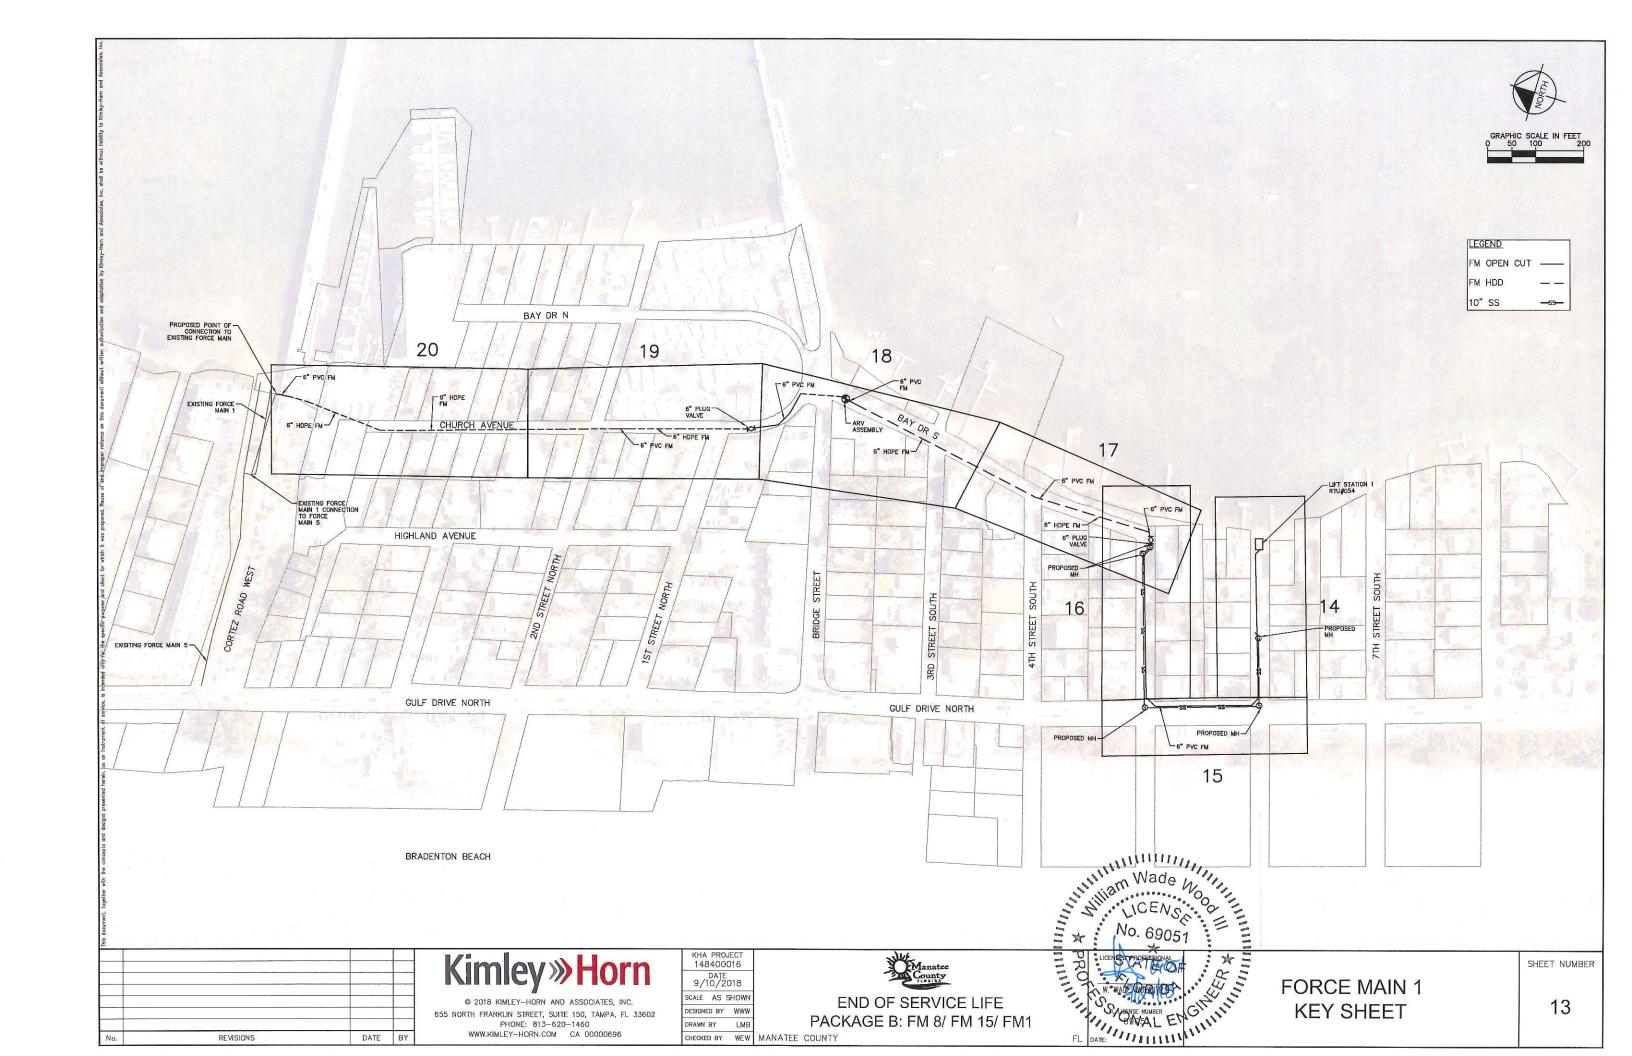
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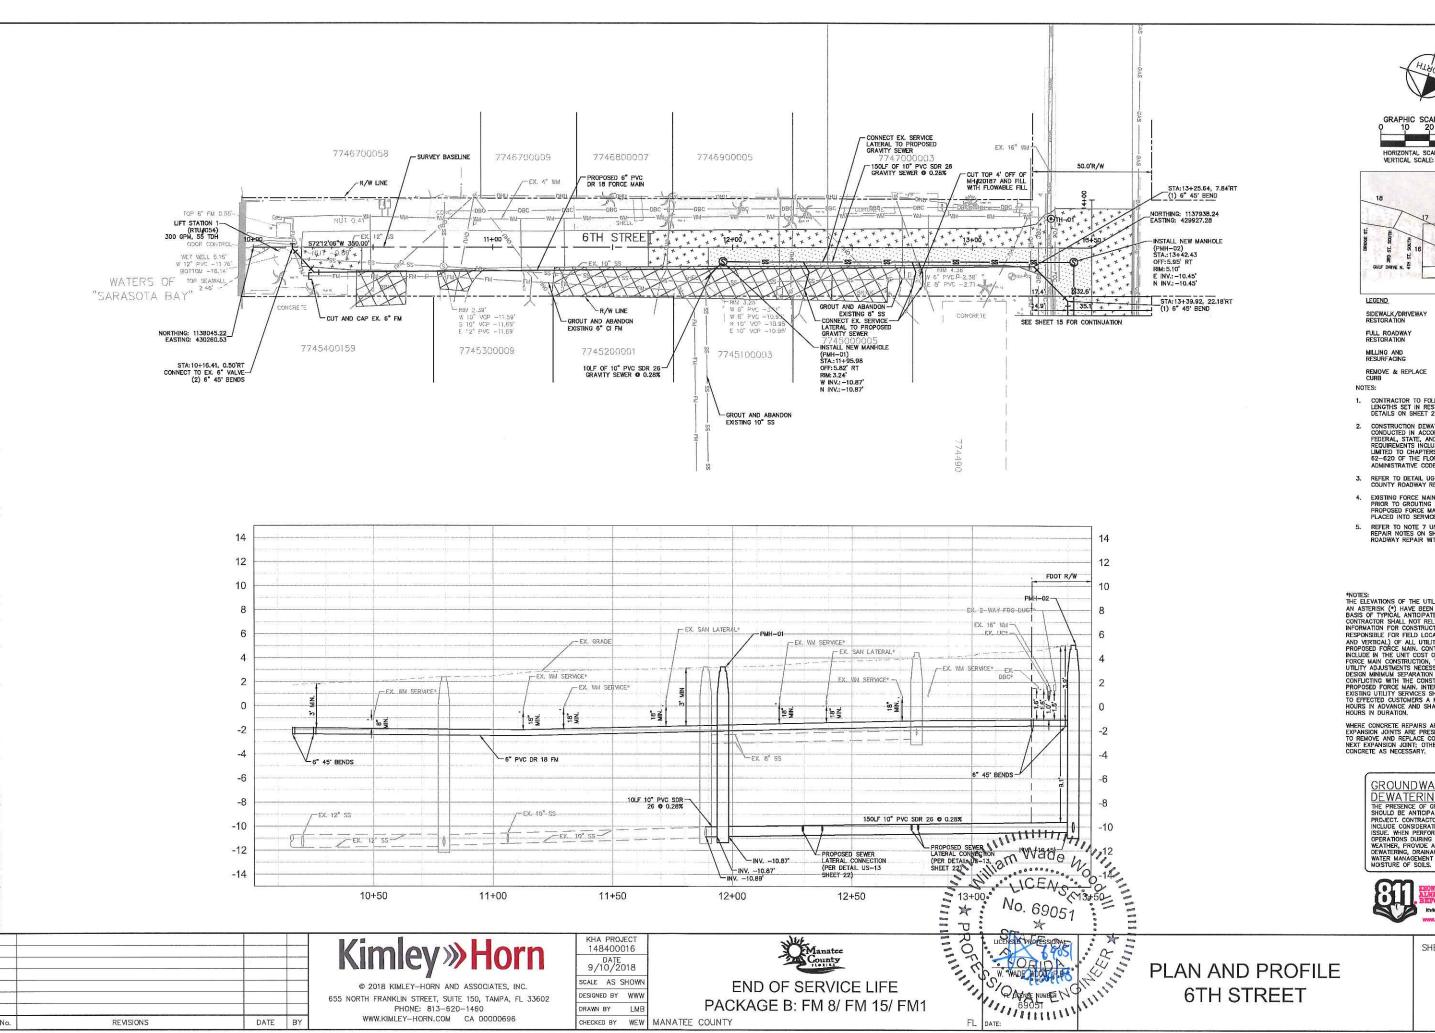
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END OF SERVICE LIFE PACKAGE B: FM 8/ FM 15/ FM1 CHECKED BY WEW MANATEE COUNTY

SHEET NUMBER





CHECKED BY WEW MANATEE COUNTY

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- PROPOSED FORCE MAIN HAS BEEN PLACED INTO SERVICE.
- REFER TO NOTE 7 UNDER FDOT APHALT REPAIR NOTES ON SHEET 2 FOR ROADWAY REPAIR WITHIN FDOT R/W.

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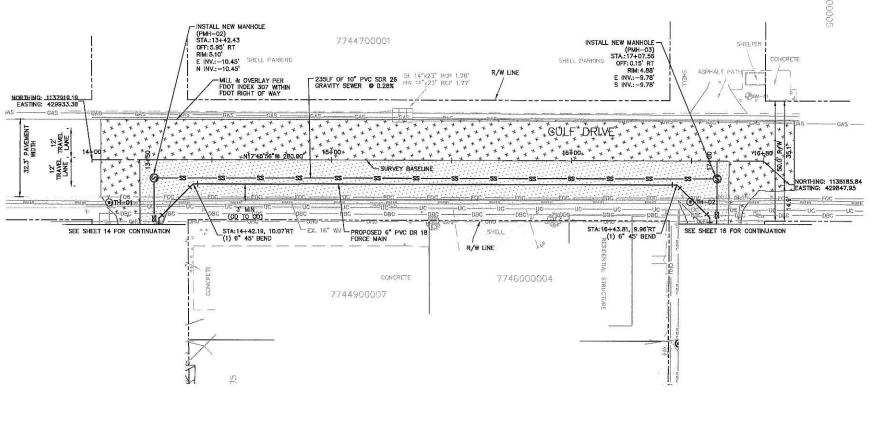
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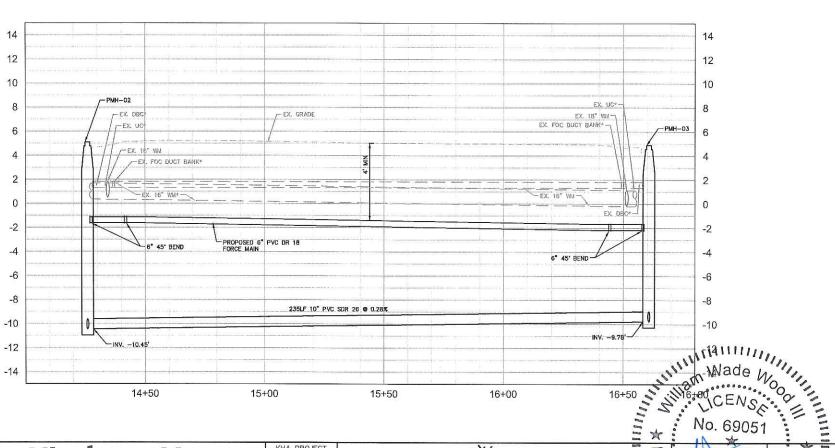


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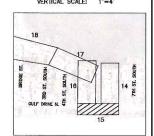






GRAPHIC SCALE IN FE
0 10 20

HORIZONTAL SCALE: 1"=20'
VERTICAL SCALE: 1"=4'



LEGEND

SIDEWALK/DRIVEWAY RESTORATION

FULL ROADWAY RESTORATION

MILLING AND RESURFACING

REMOVE & REPLACE CURB NOTES:

 CONTRACTOR TO FOLLOW RESTRAINED LENGTHS SET IN RESTRAIN LENGTH DETAILS ON SHEET 22 & 23.

- 2. CONSTRUCTION DEWATERING SHALL BE CONDUCTED IN ACCORDANCE WITH ALL FEDERAL, STATE, AND LOCAL REQUIREMENTS INCLUDING BUT NOT LIMITED TO CHAPTERS 62-621.300 AND 62-620 OF THE FLORIDA ADMINISTRATIVE CODE (FAC).
- 3. REFER TO DETAIL UG-12 SHEET 21 FO
- EXISTING FORCE MAIN SHALL BE FLUSH PRIOR TO GROUTING AFTER THE PROPOSED FORCE MAIN HAS BEEN PLACED INTO SERVICE.
- 5. REFER TO NOTE 7 UNDER FDOT APHALT REPAIR NOTES ON SHEET 2 FOR ROADWAY REPAIR WITHIN FDOT R/W.

"NOTES:
THE ELEVATIONS OF THE UTILITIES MARKED WITH AM ASTERISK (*) HAVE BEEN ASSUMED ON THE BASIS OF TYPICAL ANTICIPATED SOIL COVERAGE. CONTRACTOR SHALL NOT RELY ON THIS INFORMATION FOR CONSTRUCTION, BUT SHALL BE RESPONSIBLE FOR FIELD LOCATIONS (HORIZONTAL AND VERTICAL) OF ALL UTILITIES COSSING THE PROPOSED FORCE MAIN. CONTRACTOR SHALL INCLUDE IN THE UNIT COST OF THE SUBJECT FORCE MAIN CONSTRUCTION, THE COST OF UTILITY ADJUSTMENTS NECESSARY TO ATTAIN DESIGN MINIMUM SEPARATION FOR UTILITIES CONFLICTING WITH THE CONSTRUCTION OF THE PROPOSED FORCE MAIN. INTERRUPTIONS OF ANY EXISTING UTILITY SERVICES SHALL BE NOTICED TO EFFECTED CUSTOMERS A MINIMUM OF 48 HOURS IN ADVANCE AND SHALL NOT EXCEED 4 HOURS IN DURATION.

WHERE CONCRETE REPAIRS ARE NECESSARY AND EXPANSION JOINTS ARE PRESENT, CONTRACTOR TO REMOVE AND REPLACE CONCRETE UP TO THE NEXT EXPANSION JOINT, OTHERWISE, REPLACE CONCRETE AS NECESSARY.

GROUNDWATER

DEWATERING NOTE:
THE PRESENCE OF GROUNDWATER
SHOULD BE ANTICIPATED ON THIS
PROJECT. CONTRACTOR'S BID SHALL
INCLUDE CONSIDERATION FOR THIS
ISSUE. WHEN PERFORMING GRADING
OPERATIONS DURING PERIODS OF WET
WEATHER, PROVIDE ADEQUATE
DEWATERING, DRAINAGE AND GROUND
WATER MANAGEMENT TO CONTROL
MOISTURE OF SOILS.



Kimley Horn

REVISIONS

DATE BY

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655 NORTH FRANKLIN STREET, SUITE 150, TAMPA, FL 33602
PHONE: 813-620-1460
WWW.KIMLEY-HORN.COM CA 00000696

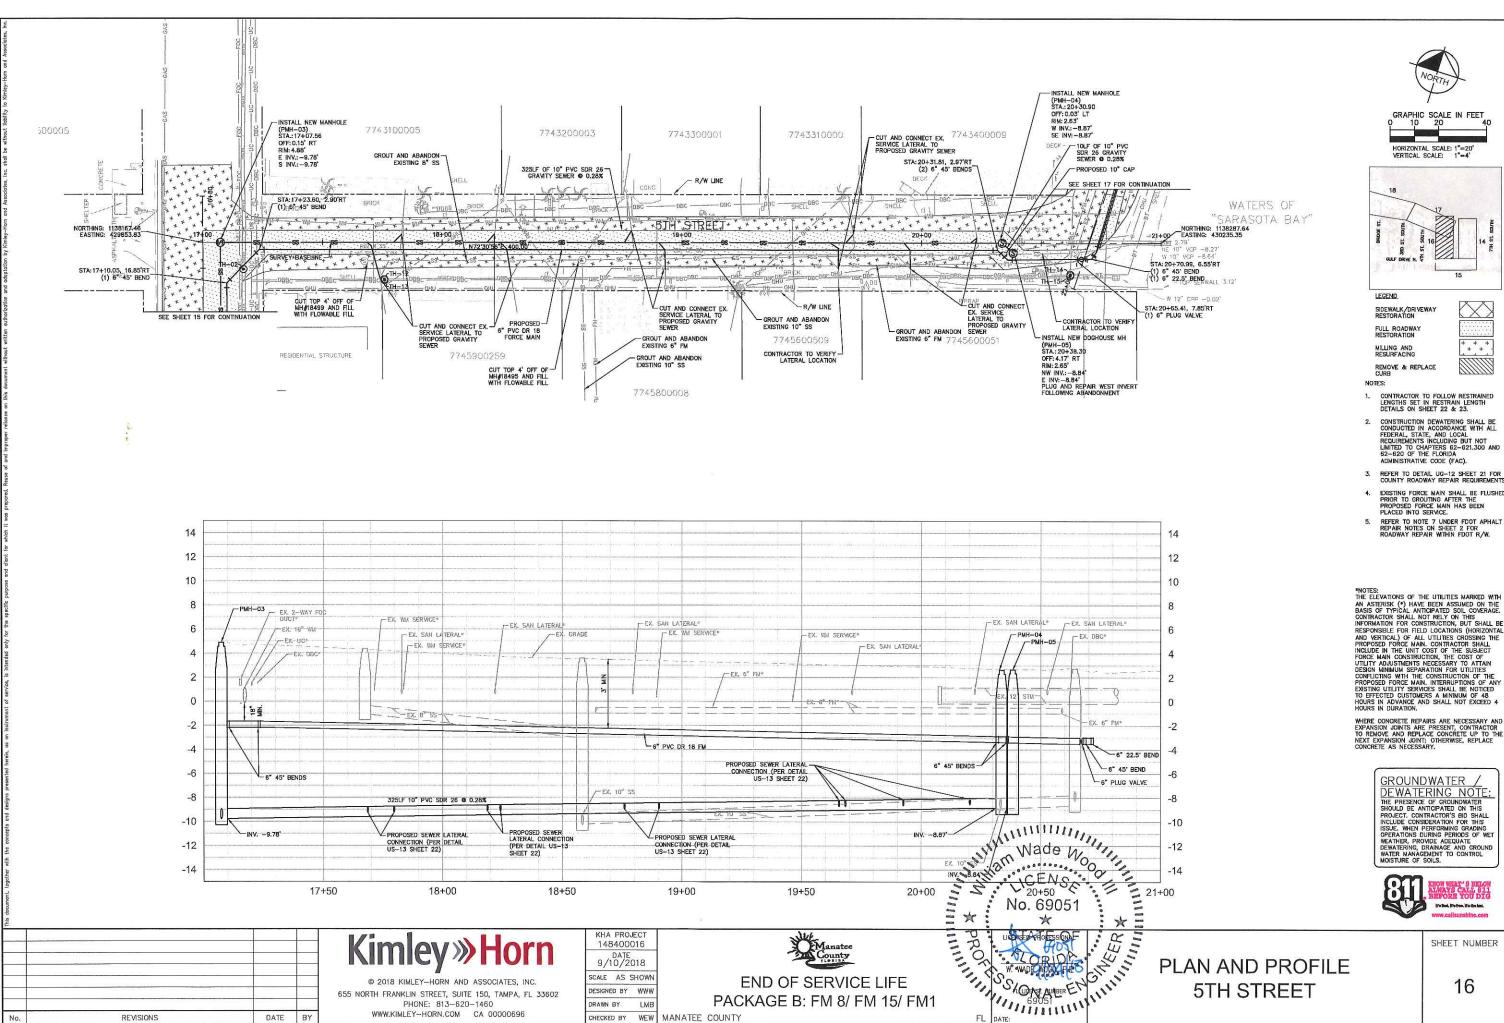
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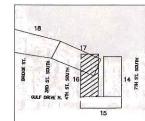
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END OF SERVICE LIFE PACKAGE B: FM 8/ FM 15/ FM1 PLAN AND PROFILE GULF DRIVE

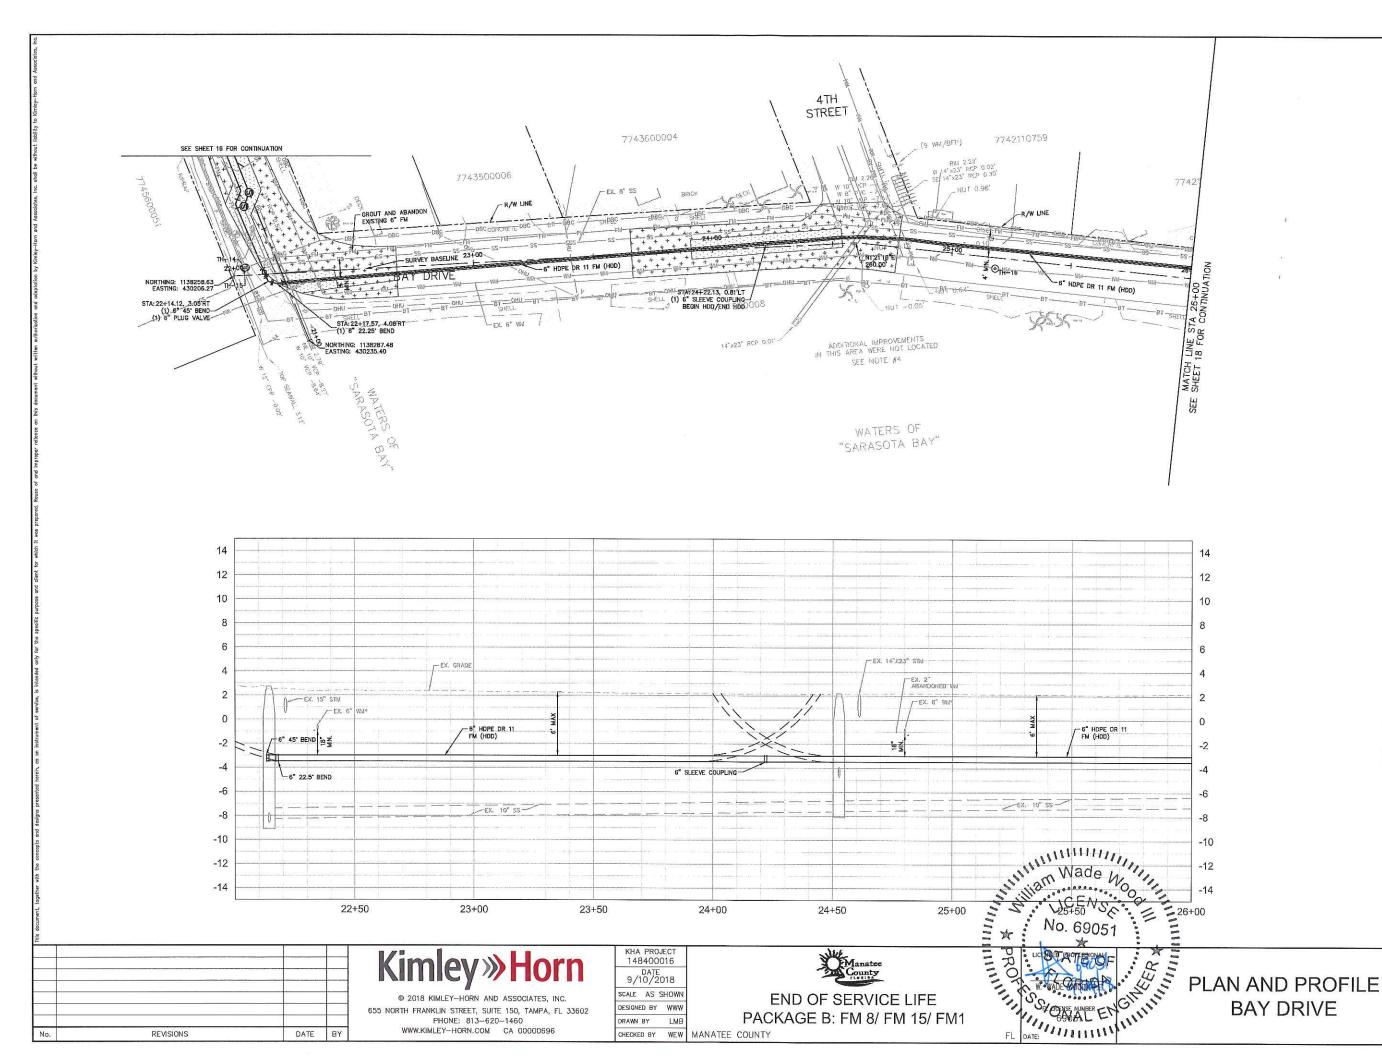
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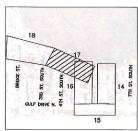
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HORIZONTAL SCALE: 1"=20" VERTICAL SCALE: 1"=4"



SIDEWALK/DRIVEWAY RESTORATION

REMOVE & REPLACE CURB

- CONSTRUCTION DEWATERING SHALL BE CONDUCTED IN ACCORDANCE WITH ALL FEDERAL, STATE, AND LOCAL REQUIREMENTS INCLUDING BUT NOT LIMITED TO CHAPTERS 62—621.300 AND 62—620 OF THE FLORION ADMINISTRATIVE CODE (FAC).
- REFER TO DETAIL UG-12 SHEET 21 FOR COUNTY ROADWAY REPAIR REQUIREMENT

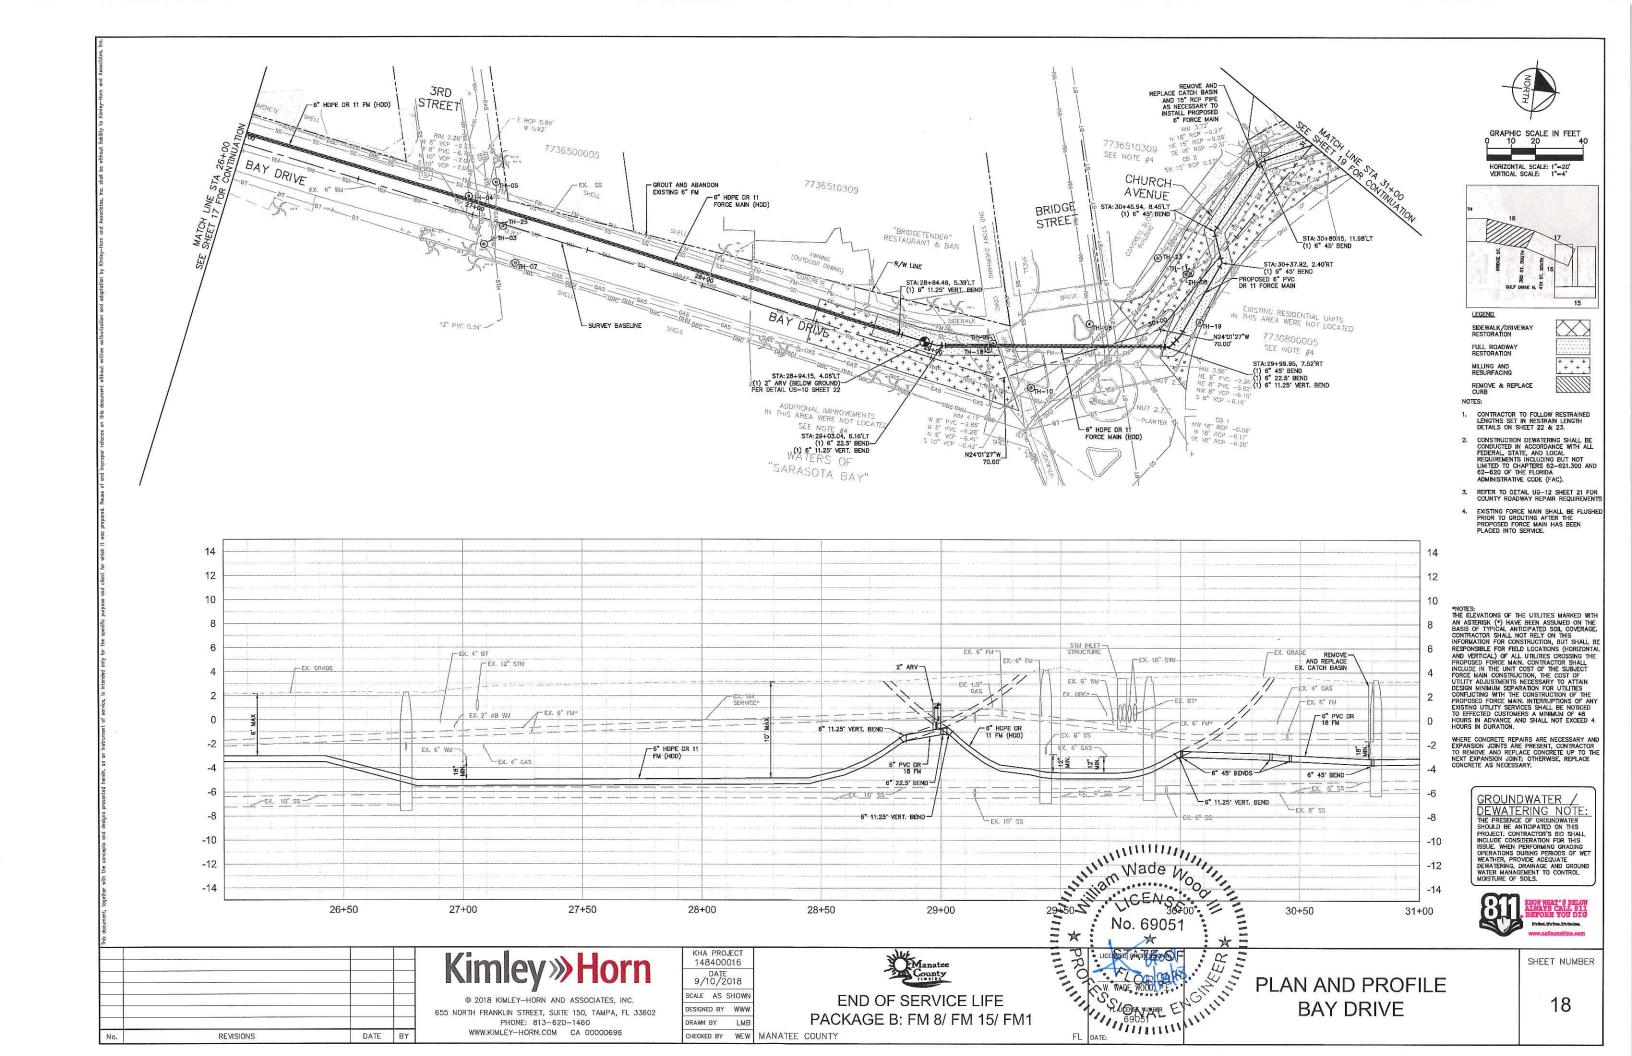
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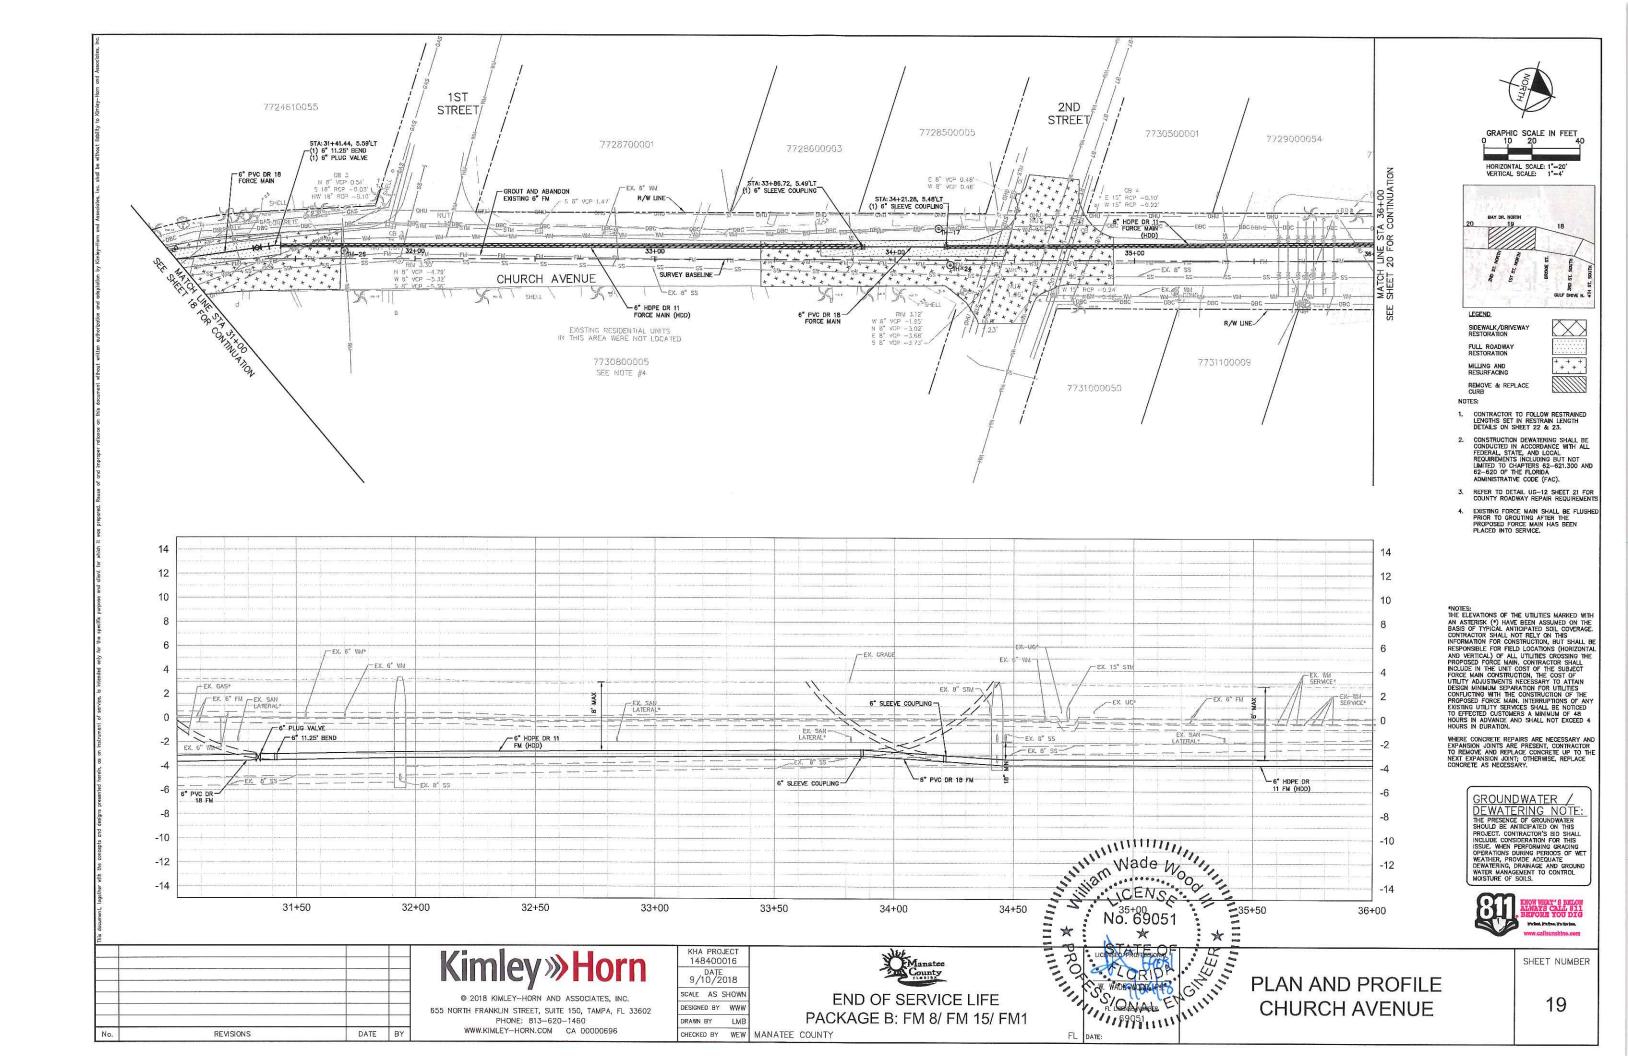
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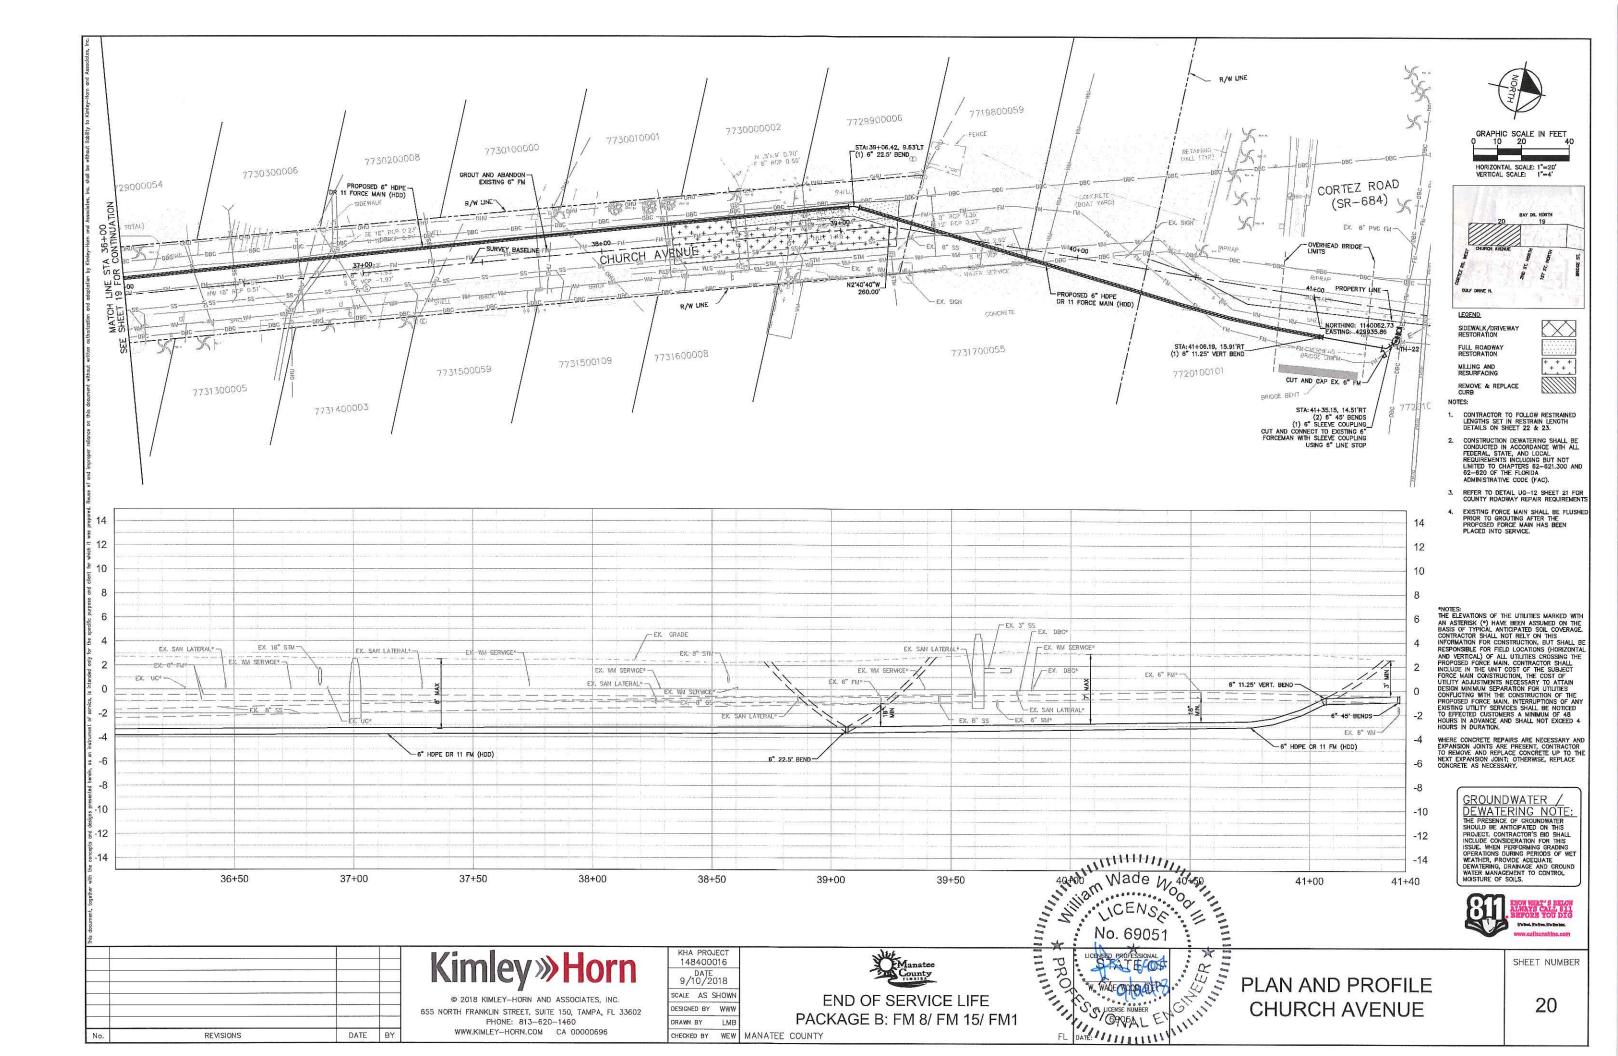
GROUNDWATER

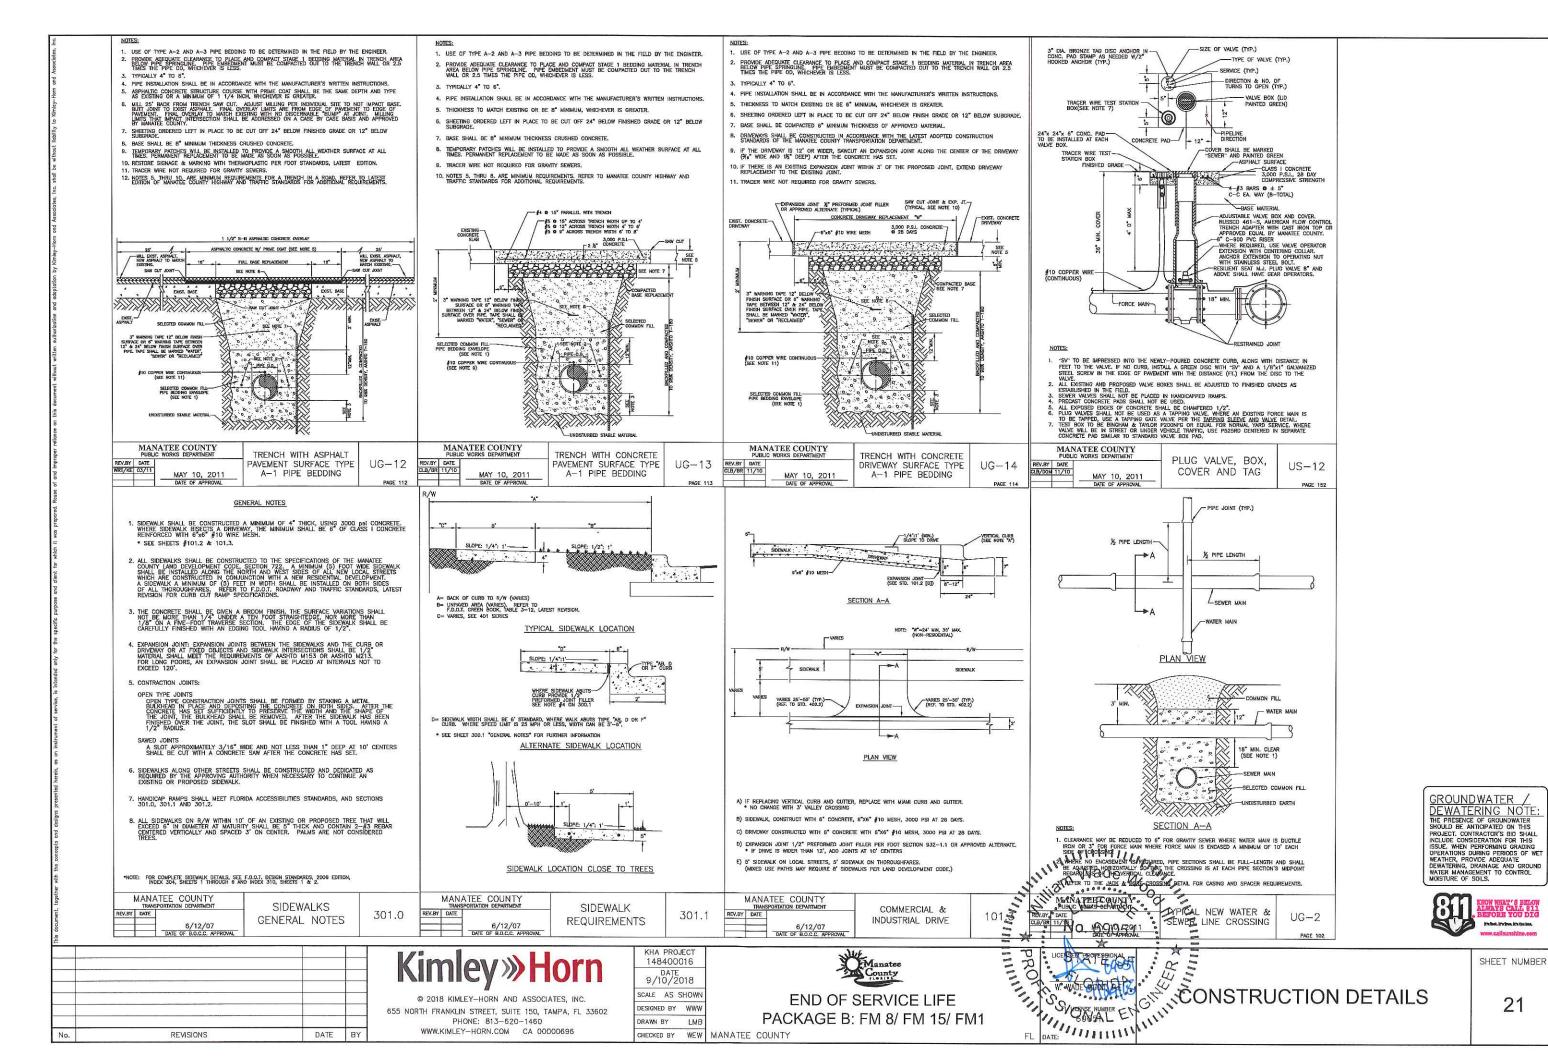
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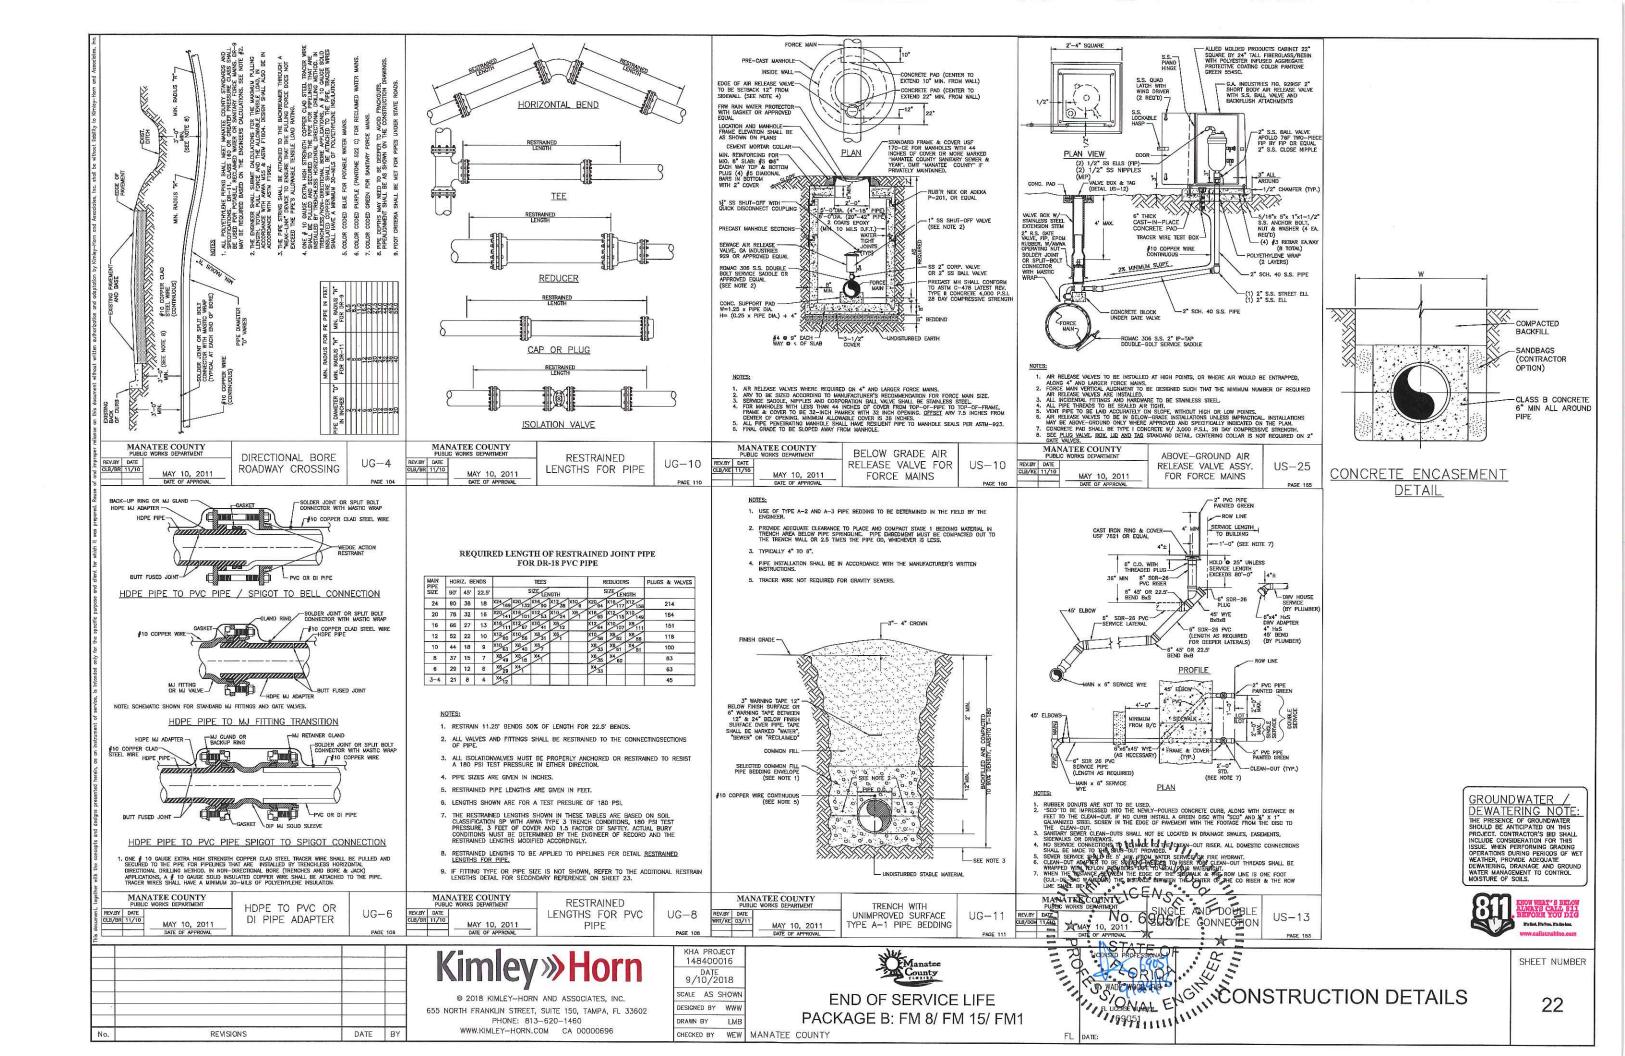


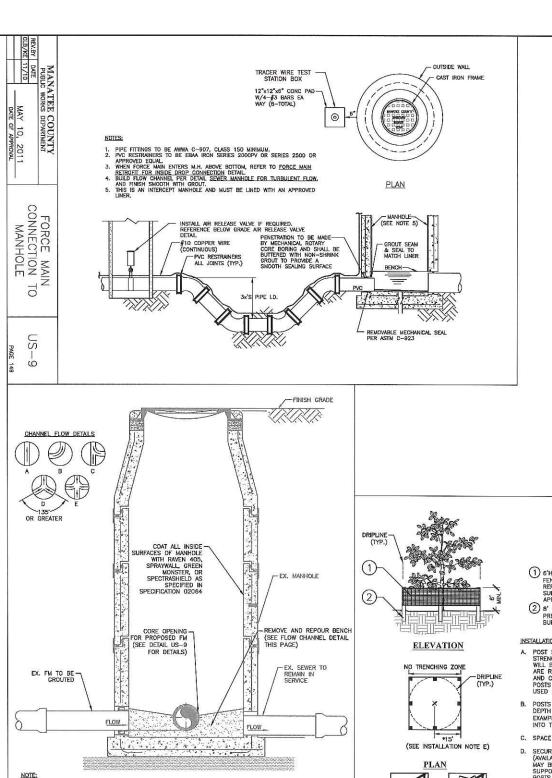












DROP MANHOLES, MANHOLES WITH OPPOSING FLOW (DETAILS D & E), MANHOLES IMMEDIATELY UPSTREAM OF A LIFT STATION WET WELL, MANHOLES WITH GRAVITY SEWERS GREATER THAN 12 INCHES IN DIAMETER, MANHOLES RECEIVING A FORCE MAIN AND THE FIRST TWO GRAVITY MANHOLES DOWNSTREAM OF MANHOLES RECEIVING A FORCE MAIN SHALL HAVE AN APPROVED LINER.

4. CONCRETE BENCH SHALL BE POURED BEFORE SHUTTING DOWN DEWATERING OPERATIONS TO PREVENT FLOTATION.

DATE BY

1. MAINTAIN DESIGN SLOPE ACROSS MANHOLE UNLESS OTHERWISE INDICATED.

2. DEPTH OF ALL CHANNELS TO BE 80% OF PIPE DIAMETER. 3. FINISH OF ALL CHANNELS TO ALLOW SMOOTH FLOW.

5. BRICK MAY BE USED TO BUILD UP CONCRETE BENCH. 6. MINIMUM ANGLE BETWEEN INLET AND OUTLET PIPING IS 90 DEGREES,

1 MANHOLE REHAB DETAIL

REVISIONS

23

6'H "PERIMETER PLUS" CONSTRUCTION FENCE BY CONWED PLASTICS OR OWNER'S REPRESENTATIVE APPROVED EQUAL SUBMIT PRODUCT INFORMATION FOR APPROVAL PRIOR TO INSTALLATION.

(2) B' TALL METAL "T" POSTS OR 2" x 2" X 8'
PRESSURE TREATED WOOD POSTS WITH 24"
BURIAL BELOW GRADE.

- A. POST SELECTION SHOULD BE BASED ON EXPECTED STRENGTH NEEDS AND THE LENGTH OF TIME FENCE WILL BE IN PLACE, FLEXIBLE FIBERGLASS ROD POSTS ARE RECOMMENDED FOR PARKS, ATHLETIC EVENTS AND GROWD CONTROL INSTALLATIONS. METAL ""POSTS OR TREATED WOOD POSTS ARE TYPICALLY USED FOR CONSTRUCTION AND OTHER APPLICATIONS.
- B. POSTS SHOULD BE DRIVEN INTO THE GROUND TO A DEPTH OF 1/3 OF THE HEIGHT OF THE POST, FOR EXAMPLE, A 6" POST SHOULD BE SET AT LEAST 2" INTO THE GROUND.
- C. SPACE POSTS EVERY 6' (MIN.) TO B' (MAX.)
- D. SECURE FENCING TO POST WITH NYLON CABLE TIES (AVAILABLE FROM CONWED PLASTICS), WOOD STRIPS MAY BE ALSO BE USED TO PROVIDE ADDITIONAL SUPPORT AND PROTECTION BETWEEN TIES AND POSTS.
- E. FOR PIPELINE CONSTRUCTION ADJACENT TO TREES: EXAMPLE: DIVIDE 30" TRUNK DIAMETER BY 2. (30/2-16) EXCANATION SHALL BE FROHIBITED WITHIN 15" OF THE TRUNK OR THE LIMITS OF THE DRIPLINE, WHICHEVER IS GREATED.

NOTE: IF WIRE TIES ARE USED, AVOID DIRECT CONTACT WITH FENCE. WIRE MAY DAMAGE FENCE OVER TIME.

2 TREE PROTECTION FENCING
23 ELEVATION / PLAN

+PER DIPRA, AS THE BEND ANGLE APPROACHES 90', LATERAL MOVEMENT OF THE OUTER LEGS APPROACHES ZERO. FOR THIS CONDITION, RESTRAIN ALL PIPE BETWEEN THE FITTINGS AND RESTRAIN THE OUTER LEGS AS DEAD ENDS.

ADDITIONAL RESTRAIN LENGTHS DETAIL FOR PVC

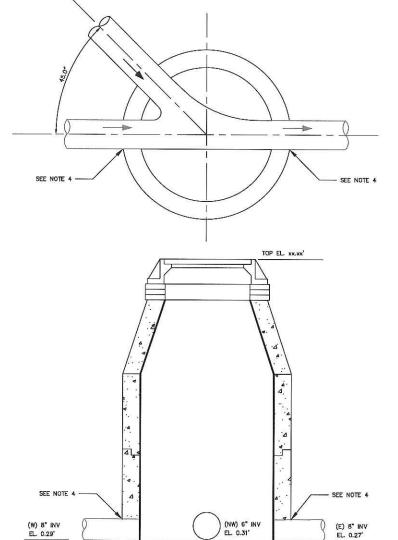
(SOURCES: EBAA IRON RESTRAINT LENGTH CALCULATION PROGRAM FOR PVC PIPE, RELEASE 7.1.2

- NOTES:

 1. THE DATA IN THE ABOVE TABLE ARE BASED UPON THE FOLLOWING INSTALLATION CONDITIONS:

 SOIL TYPE—SP
 TRENCH TYPE—3
 MINIMUM PIFE LENGTH ACLONE TER RUN—15'
 DEPTH OF BURY—3'
 VERTICAL OFFSET—3'
 VERTICAL OFFSET—3'
- 2. THE RESTRAINED PIPE LENGTHS APPLY TO PVC PIPE.
 3. ALL JOINTS BETWEEN UPPER AND LOWER BENDS SHALL BE RESTRAINED.
 4. RESTRAINED PIPE LENGTHS APPLY TO PIPE ON BOTH SIDES OF FITTINGS. CONTRACTOR TO REFER TO MANATEE COUNTY DETAIL UG-8 FOR PVC RESTRAIN LENGTHS, IF ITTING TYPE OR PIPE SIZE IS NOT SHOWN, REFER TO THIS DETAIL FOR SECONDARY REFERENCE.

6 RESTRAINED JOINTS SHALL EXTEND ONE JOINT BEYOND MIN. LENGTH REQUIRED.



INVERT ROTATED FOR CLARITY

DOGHOUSE MANHOLE DETAIL - FM 15

DOGHOUSE MANHOLE NOTES:

- 1. REFER TO DETAIL US-9 FOR FORCE MAIN CONNECTION
- OPENING IN PRECAST MANHOLES ARE TO BE 4" MINIMUM TO 8" MAXIMUM LARGER THAN THE OUTSIDE DIAMETER FOR THE EXISTING PIPE.
- 4. MORTAR AND BRICK TO CLOSE OPENING AROUND AND BELOW EXISTING PIPE.

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KHA PROJECT 148400016 DATE 9/10/2018 SCALE AS SHOWN

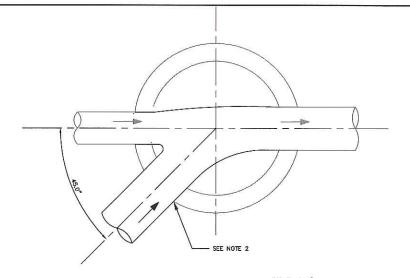
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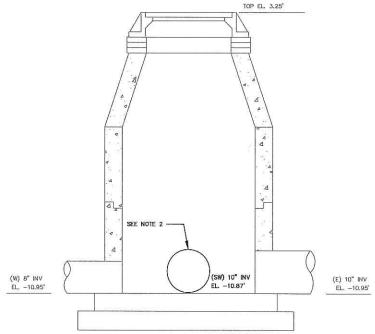
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END OF SERVICE LIFE PACKAGE B: FM 8/ FM 15/ FM1

CHECKED BY WEW MANATEE COUNTY

No. 69051 女 W. WAIE TOOK THE CONSTRUCTION DETAILS





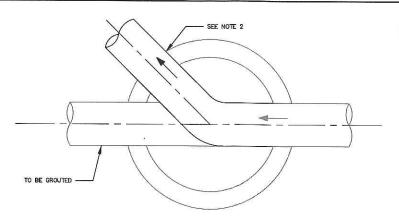
MANHOLE#20192 BENCH DETAIL - FM 1

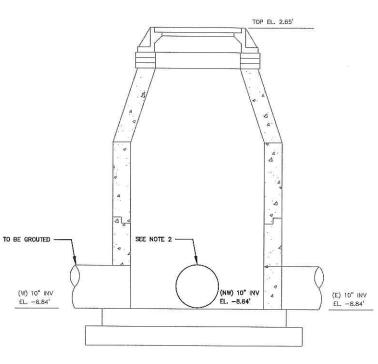
INVERT ROTATED FOR CLARITY

DATE BY

MANHOLE BENCH NOTES:

- 1. MANHOLE SHALL BE COATED PER COUNTY SPECIFICATION 02064
- 2. MORTAR AND BRICK TO CLOSE OPENING AROUND AND BELOW PROPOSED PIPE.



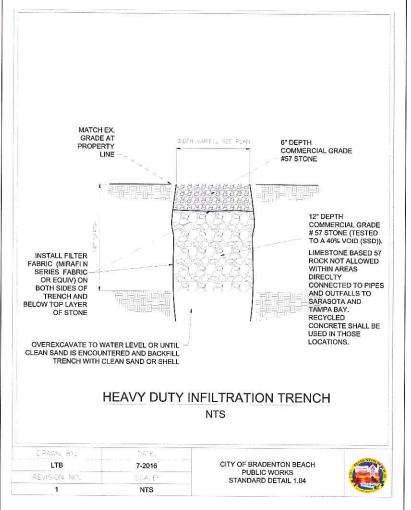


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DOGHOUSE MANHOLE DETAIL - FM 1

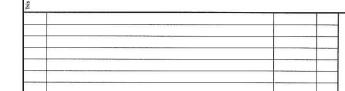
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REVISIONS

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KHA PROJECT 148400016 DATE 9/10/2018 SCALE AS SHOWN DESIGNED BY WWW

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END OF SERVICE LIFE PACKAGE B: FM 8/ FM 15/ FM1

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SHEET NUMBER