
RECORD DRAWINGS CONTRACT DRAWINGS

SOUTHEAST WATER RECLAMATION FACILITY (SEWRF) SEPTAGE/ GREASE RECEIVING STATION

MANATEE COUNTY, FLORIDA

COUNTY PROJECT No. 6083480



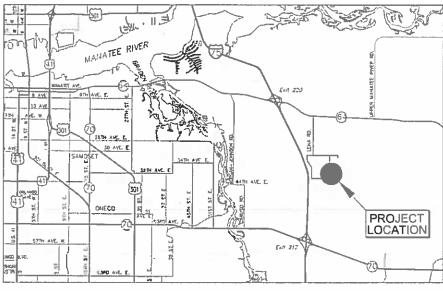

LOCATION MAP

Hyatt Survey Services, Inc.

SURVEYOR'S CERTIFICATION:

FLORDA SURVEYORS REGISTRATION NO. 5303

Cardno

PREPARED BY:



STRUCTURAL PLANS



114 W. FIRST STREET, SUITE 230 SANFORD, FLORIDA 32771 PHINE: (407) 322-0500 FAX: (407) 322-0023



00193-009-02

MARCH 2015

RECORD DRAWING


THIS RECORD DRAWING SHOWS THE REPORTED LOCATION OF WORK IN SUBSTANTIAL COMFORMANCE WITH THE APPROVED CONSTRUCTION PLANS. THIS RECORD DRAWING IS BASED ON INFORMATION PROVIDED BY THE CONTRACTOR AND SURVEYOR. CARDNO CANNOT AND DOES NOT WARRANTY ITS ACCURACY.

CONTRACTOR RECORD DRAWINGS ATTACHED

NOTE: THE CONTRACT DRAWINGS WERE ORIGINALLY APPROVED FOR CONSTRUCTION AND SEALED IN MARCH 2015 BY DAVID O'CONNOR, A LICENSED PROFESSIONAL ENGINEER IN THE STATE

IN BACK FOR INFORMATION ONLY

OF FLORIDA, FL PE NO 56803.

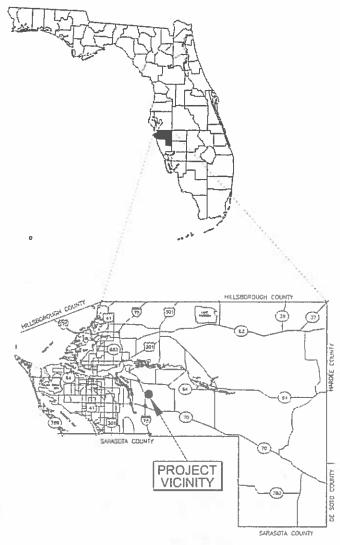

VICINITY MAP

	RECORD DRAWING	RFN	12/2017
NO.	DESCRIPTION	BY	DATE

3331 LENA ROAD BRADENTON, FLORIDA 34206

PLANS PREPARED BY:

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RECORD DRAWING

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CONTRACTOR RECORD DRAWINGS ATTACHED IN BACK FOR INFORMATION ONLY

	_		
	RECORD DRAWING	RFN	12/2017
NO.	DESCRIPTION	BY	DATE

SEWRF SEPTAGE/ GREASE RECEIVING STATION



CLEARWATER

CLEARWATER

300 PARK PLACE BLVD, STE 300, CLEARWATER, FL 33759 TEL:
(727) 531-3505 (800) 861-8314

www.cardno.com Certificate of Authorization No. 29915

DAVID A. O'CONNOR, PE DATE LIC. NO.: 56803

RECORD DRAWINGS
SHEET INDEX

PROJECT NO: 00193-009-02 DATE:

> MARCH 2015 SHEET NO: **G-2**

GENERAL NOTES

- MATERIALS USED IN THE CONSTRUCTION OF THIS PROJECT SHALL BE NEW AND CONFORM TO THE MANATEE COUNTY DEPARTMENT OF PUBLIC WORKS UTILITIES DEPARTMENT AND THE LATEST LOCAL JURISDICTION STANDARDS. UNLESS OTHERWISE NOTED.
- WHERE REFERENCED STANDARDS CONFLICT, OR WHERE THERE ARE DISCREPANCIES BETWEEN THE PROJECT MANUAL (TECH SPECS) AND CONTRACT DRAWINGS, THE MORE STRINGENT STANDARD SHALL APPLY
- 3. THE CONTRACTOR SHALL CALL "SUNSHINE STATE ONE CALL 811" A MINIMUM OF 2-DAYS AND A MAXIMUM OF 5-DAYS PRIOR TO START OF CONSTRUCTION.
- 4. THE CONTRACTOR SHALL CONTACT THE ENGINEER OF RECORD AT (727) 639-5567 IMMEDIATELY ON ANY CONFLICTS ARISING DURING CONSTRUCTION.
- ALL WORK PERFORMED SHALL COMPLY WITH THE REGULATIONS AND ORDINANCES OF THE VARIOUS GOVERNMENTAL AGENCIES HAVING JURISDICTION OVER THE WORK.
- 6. THESE DRAWINGS DO NOT INCLUDE NECESSARY COMPONENTS FOR CONSTRUCTION SAFETY AND THE CONTRACTOR IS SOLELY RESPONSIBLE FOR THE CONSTRUCTION SAFETY. SPECIAL PRECAUTIONS MAY BE REQUIRED IN THE VICINITY OF POWER LINES AND OTHER UTILITIES.
- 7. IT IS THE RESPONSIBILITY OF THE CONTRACTOR TO CONTROL AND PREVENT EROSION AND THE TRANSPORTATION OF SEDIMENT TO SURFACE DRAINS AND OUTFALLS.
- 8. ALL SECTION CORNERS OR PROPERTY CORNERS DISLOCATED OR DISTURBED BY THE CONSTRUCTION ACTIVITIES SHALL BE RESET BY A REGISTERED LAND SURVEYOR AT THE CONTRACTORS EXPENSE.
- UNLESS SHOWN OTHERWISE, FINAL GRADE IS TO GENERALLY BE THE SAME AS EXISTING GRADE. ALL DISTURBED LANDSCAPED AND/OR GRASSED AREAS SHALL BE RESTORED IN-KIND.
- ALL SODDING, SEEDING AND MULCHING SHALL INCLUDE WATERING AND FERTILIZATION AND CONTRACTOR SHALL BE RESPONSIBLE FOR MAINTAINING THESE AREAS UP TO AND INCLUDING THE INITIAL MOWING.
- 11. ALL VOIDS AFTER PLACEMENT OF SOD SHALL BE FILLED WITH PREPARED SOIL MIX. THE SOD SHALL BE ROLLED TO MEET THE PROPOSED GRADES, SOD PLACED ON SLOPES (3:1 OR STEEPER) SHALL BE PEGGED.
- 12. ALL EXCESS SOIL RESULTING FROM CONSTRUCTION ACTIVITIES THAT IS NOT CLAIMED BY THE OWNER SHALL BECOME THE PROPERTY OF THE CONTRACTOR AND PROPERLY DISPOSED OF OFFSITE BY THE CONTRACTOR.
- 13. AREAS OF EXPOSED EARTH RESULTING FROM CONSTRUCTION SHALL BE SODDED IN KIND UNLESS OTHERWISE NOTED ON PLANS.
- 14. THE LOWEST PIPE SHALL BE INSTALLED FIRST WHERE UTILITIES CROSS.
- 15. THE CONTRACTOR SHALL BE RESPONSIBLE FOR TESTING OF ALL MAINS IN ACCORDANCE WITH CURRENT STANDARDS OF LOCAL JURISDICTION. CONTRACTOR SHALL NOTIFY THE LOCAL JURISDICTION AND THE OWNER OR HIS AUTHORIZED REPRESENTATIVE AT LEAST 48 HOURS IN ADVANCE OF PERFORMING TESTS.
- 16. THE CONTRACTOR SHALL PROVIDE ALL SHEETING, SHORING AND BRACING REQUIRED TO PROTECT ADJACENT STRUCTURES AND TO MINIMIZE TRENCH WIDTH. WHERE A SEPARATE PAY ITEM IS NOT PROVIDED, THE COST OF ALL SHEETING AND BRACING REQUIRED SHALL BE INCLUDED IN THE CONTRACT PRICE FOR THE ITEM OF WORK FOR WHICH SHEETING, SHORING AND BRACING IS ANTICIPATED TO BE REQUIRED IN ACCORDANCE WITH "TRENCH SAFETY ACT".
- 17. ALL CONCRETE SHALL HAVE A MINIMUM ULTIMATE COMPRESSIVE STRENGTH OF 3,000 PSI (28 DAY STRENGTH), UNLESS OTHERWISE NOTED ON DRAWINGS. ACCESS DRIVES SHALL MEET H 20 TRAFFIC LOADING REQUIREMENTS.
- 18. LOCATIONS, ELEVATIONS AND DIMENSIONS OF EXISTING UTILITIES, STRUCTURES AND OTHER FEATURES ARE SHOWN ACCORDING TO THE BEST INFORMATION AVAILABLE AT THE TIME OF THE PREPARATION OF THESE PLANS, BUT DO NOT PURPORT TO BE ABSOLUTELY CORRECT. THE CONTRACTOR SHALL VERIFY THE LOCATION, ELEVATIONS AND DIMENSIONS OF ALL EXISTING UTILITIES, STRUCTURES AND OTHER FEATURES AFFECTING HIS WORK PRIOR TO CONSTRUCTION.
- 19. THE CONTRACTOR SHALL VERIFY IN THE FIELD THE LOCATION AND ELEVATION OF ALL EXISTING UTILITY CONNECTION POINTS PRIOR TO STARTING CONSTRUCTION AND SHALL IMMEDIATELY NOTIFY THE ENGINEER AND OWNER OF ANY DISCREPANCIES FOUND.
- ALL POTABLE, FIRE AND IRRIGATION SYSTEM COMPONENTS SHALL REMAIN OPERATIONAL DURING CONSTRUCTION. THE CONTRACTOR SHALL REPAIR ANY DAMAGE TO THESE SYSTEMS IMMEDIATELY.
- THE CONTRACTOR SHALL ENSURE THAT EXCAVATIONS ARE FREE OF DEBRIS AND ORGANIC MATERIAL PRIOR TO BACKFILLING.

- 22. THE CONTRACTOR SHALL BE RESPONSIBLE FOR OBTAINING A NPDES NOI PERMIT FROM EPA, AS WELL AS PREPARING AND MAINTAINING A STORMWATER POLLUTION PREVENTION PLAN FOR BOTH ON-SITE AND OFF-SITE IMPROVEMENTS. THE CONTRACTOR SHALL BECOME FAMILIAR WITH AND COMPLY WITH ALL REQUIREMENTS OF THE EPA NPDES PERMIT FOR THIS PROJECT. THE CONTRACTOR SHALL BE RESPONSIBLE FOR ANY STORMWATER DISCHARGE PERMIT AND/OR DEWATERING PLAN, AND SHALL BE RESPONSIBLE TO COMPLY WITH ALL CONDITIONS SET FORTH IN THE PERMIT.
- 23. THE CONTRACTOR SHALL TAKE ALL REASONABLE MEANS TO ELIMINATE THE TRANSPORT OF DUST FROM THE PROJECT SITE. SPECIAL MEASURES, SUCH AS PERIODICALLY APPLYING WATER TO THE WORK SITE TO PREVENT DUST SHALL BE INCORPORATED INTO THE CONTRACTORS WORK PLAN.
- 24. MAINTAIN ACCESS TO AND OPERATION OF ALL EXISTING PLANT OPERATIONS UNTIL NEW OPERATIONS HAVE BEEN ACCEPTED BY OWNER AND ENGINEER.
- 25. SURVEY PREPARED BY:

HYATT SURVEY SERVICES, INC. 11007 8TH AVENUE EAST, BRADENTON, FLORIDA 34212 (941) 748 4693

26. GEOTECHNICAL INVESTIGATION PREPARED BY

MC SQUARED, INC. (MC2) 5808-A BRECKENRIDGE PARKWAY, TAMPA, FLORIDA 33610 (813) 623 3300

- 27. VERTICAL AND HORIZONTAL CLEARANCES FOR WATER, SEWER, FORCE MAIN, AND RECLAIMED WATER MAINS SHALL MEET FDEP MINIMUM SEPARATION.
- ALL PLANT SERVICE WATER SPIGOTS (HOSE BIBS, IRRIGATION SYSTEM) SHALL HAVE APPROPRIATE SAFETY PLACARDS.
- 29. UNLESS OTHERWISE NOTES, ALL STAINLESS STEEL SHALL BE TYPE 316L.
- 30. THE CONTRACTOR IS SOLELY RESPONSIBLE FOR SAFEKEEPING OF EQUIPMENT AND MATERIALS LEFT ON-SITE DURING CONSTRUCTION
- 31. PIPE DEFLECTION AT THE JOINTS SHALL NOT EXCEED 75% OF MANUFACTURER'S RECOMMENDATION.
- 32. THE CONTRACTOR SHALL EXCAVATE TO CONFIRM THE LOCATIONS OF EXISTING UTILITIES ADJACENT TO OR CROSSING PROPOSED LINEWORK BEFORE STARTING CONSTRUCTION.
- 33. ALL BELOW GROUND DUCTILE IRON PIPE SHALL BE ENCASED IN A POLYETHYLENE WRAP IN ACCORDANCE WITH AWWA C105.
- 34. ALL EXISTING FENCE DISTURBED DURING CONSTRUCTION SHALL BE REPAIRED OR REPLACED AND REINSTALLED BY THE CONTRACTOR AT NO ADDITIONAL COST TO THE OWNER UNLESS SHOWN TO BE REMOVED ON CONSTRUCTION PLANS.
- 35. OTHER CONSTRUCTION PROJECTS MAY BE ONGOING AT THE FACILITY DURING THE TIME OF THIS PROJECT. THE CONTRACTOR SHALL COOPERATE WITH OTHER CONTRACTORS THAT MAY BE ON SITE. THE CONTRACTOR SHALL COORDINATE ALL WORK THROUGH THE PLANT SUPERINTENDENT.
- 36. THE CONTRACTOR SHALL RECEIVE A DESIGNATED AREA FOR STORAGE OF MATERIALS. THE CONTRACTOR IS ULTIMATELY RESPONSIBLE FOR THE SECURITY AND SAFEKEEPING OF CONTRACTOR'S OWN TOOLS AND PROJECT MATERIALS STORED ON SITE.
- 37. THE CONTRACTOR SHALL MAINTAIN ON-SITE ONE FULL-SIZE SET OF CONTRACT DRAWINGS RED-LINED TO DOCUMENT CONFIRMATION OF ALL PROPOSED WORK AND ANY DEVIATIONS FROM PROPOSED WORK.

 THESE RED-LINED DRAWINGS SHALL BE MADE AVAILABLE TO OWNER AND ENGINEER UPON REQUEST.
- 38. THE CONTRACTOR SHALL PROVIDE CERTIFIED "RECORD DRAWINGS" DRAWINGS, SIGNED AND SEALED BY A PROFESSIONAL LAND SURVEYOR, THE RECORD DRAWINGS SHALL SHOW CONFIRMATION OF ALL PROPOSED WORK AND ANY DEVIATIONS FROM THE PROPOSED WORK. THE CONTRACTOR SHALL PROVIDE FIVE HARD COPIES AND ONE ELECTRONIC AUTOCAD COPY OF THE "RECORD DRAWINGS" DRAWINGS TO THE ENGINEER.

SURVEY NOTES

- 1. THIS IS NOT A BOUNDARY SURVEY.
- THE SURVEY IS REFERENCED TO A PROJECTION OF THE FLORIDA STATE PLANE COORDINATE SYSTEM (WEST ZONE NAD 1983/2007 ADJUSTMENT).
- 3. ALL ELEVATIONS REFER TO NATIONAL GEODETIC VERTICAL DATUM OF 1929 (NGVD 29).
- 4. THE FOLLOWING BENCHMARK WAS RECOVERED AND UTILIZED FOR THIS SURVEY: RAILROAD SPIKE IN THE NE SIDE OF A POWER POLE WITH A PK NAIL AND MANATEE COUNTY BM DISK ABOVE IT, 45'± WEST OF SW CORNER PHASE 1 LENA LANDFILL (NGVD 1929 ELEVATION 38.671'). FOR CONVERSION TO NAVD 1988 ELEVATIONS, A VALUE OF (-0.96') SHOULD BE APPLIED. THIS VALUE WAS DERIVED USING CORPSCON 6 AND IS APPROXIMATE.
- SITE LIES WITHIN FLOOD ZONES "A" AND "X" AS SCALED FROM THE FEDERAL EMERGENCY MANAGEMENT AGENCY FLOOD INSURANCE RATE MAP: COMMUNITY PANEL NUMBER 120153 0352 C DATED JULY 15, 1992. SUBJECT TO FIELD VERIFICATION.
- 6. THIS SURVEY IS SUBJECT TO PERTINENT EASEMENTS, RIGHTS-OF-WAY AND RESTRICTIONS OF RECORD, IF ANY

HORIZONTAL/VERTICAL CONTROL

DESIGNATION (SEE PLAN)	NORTHING	EASTING	ELEVATION
BM # 200 (PKND LB 7203)	1139596.539	510507.125	37.66'
BM # 204 (PKND LB 7203)	1139279.956	510481.022	35.81'
BM # 208 (PKND LB 7203)	1139366.878	511102.444	37.17'

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| RECORD DRAWING | RFN | 12/2017 | NO. | DESCRIPTION | BY | DATE

SEWRF SEPTAGE/ GREASE RECEIVING STATION



MANATEE COUNTY
DEPARTMENT OF PUBLIC WORKS
UTILITIES DEPARTMENT
4410 66th Street West Bradenton, Florida 34210

(941) 792-8811

Cardno Sheping the Future

CLEARWATER
380 PARK PLACE BLVD. STE 300, CLEARWATER, FL 33759 TEL:
(727) 531-3505 (800) 861-8314
www.cardno.com Certificate of Authorization No. 29915

DESIGNE

DRAWN

Q.C.

DAVID A. O'CONNOR PE DATE APPROVE

RECORD DRAWINGS
GENERAL NOTES

PROJECT NO: 00193-009-02 DATE:

> MARCH 2015 SHEET NO: G-3

GENERAL ABBREVIATIONS

LANE

LIGHT POLE

MOTOR CONTROL CENTER MITERED END SECTION

NATURAL GROUND NOT TO SCALE

DIAMETER / PHASE

RADIUS / RISER / RELAY

REINFORCED CONCRETE PIPE

SUBSURFACE LITILITY ENGINEERING

PK NAIL W/ DISK

POWER POLE

PROPOSED

PAVEMENT

REFERENCE

REQUIRED

SANITARY

SECTION

SINGLE

SIGN

STEEL

SYMMETRICAL TOP OF BANK (DITCH)
TOP & BOTTOM

TELEPHONE

UTILITY POLE

WATER LINE WATER LEVEL WATER MAIN

WATER METER WEATHER PROOF

VERTICAL

UNDERGROUND TELEPHONE

WIDE FLANGE / WIDE / WATT / WATER

WALL SLEEVE / WATER STOP / WATER SERVICE

THICK TOE OF SLOPE (DITCH) TYPICAL UNDERGROUND GAS

RESTRAINED RECLAIM FIRE HYDRANT

RIGHT-OF-WAY

MAILBOX

NUMBER

OPENING

PLACES

POTABLE

@ AC AC ABD ACRES
ASPHALTIC CONCRETE ABANDONED ALUMINUM MB MCC MES ANCH ANCHOR APPROX APPROXIMATE MON. NG N.T.S. AVE AVENUE BLDG. BLVD. BUILDING BOULEVARD BENCHMARK CHANNEL CONDUIT PLCS CHECKERED CIR. CHAIN LINK FENCE PROP P.V. PVMT CORRUGATED METAL PIPE COLUMN CONNECTOR / CONNECTION CONCRETE C.P. CONTROL PANEL COPPER REQ'D RESTR. RFH RW; R/W DEEP / DRAIN DESIGN HIGH WATER SAN. SEC. SGL SPRK SQ. SN DISCHARGE DESIGN LOW WATER E.W. EACH WAY ST. STL. S.U.E. ELEVATION FLEC ELECTRICAL CONDUIT S.U.E. S/W;SW SYM. TOB T.&B. AND SO FORTH EXIST EXISTING TEL TEMP THK TOS TYP. UG UP FINISHED FLOOR FOOTING GALVANIZED GRATED INLET GALLONS PER MINUTE UT VERT. GRND GROUND GR./GRD. GRADE GUY WIRE POLE HDWALL HEADWALL HANDRAIL HOT WATER HEATER

INVERT ELEVATION

INVERT

IRON ROD JUNCTION BOX

FLOW ABBREVIATIONS

AL
BE
BW
CLE
CL2G
CL2S
DR
FBW
FEQ
FM
GR
HW
IRR
LC
MHL
OF BURIED ELECTRIC BACKWASH COMPRESSED AIR CLARIFIER EFFLUENT CHLORINE GAS
CHLORINE SOLUTION SAND FILTER BACKWASH SAND FILTER EFFLUENT FLOW EQUALIZATION FORCE MAIN IRRIGATION LEACHATE COLLECTION MANHOLE ELECTRIC MIXED LIQUOR OVERFLOW OF P PO PDFM OVERFLOW POLYMER
POLYMER
PLANT DRAIN FORCE MAIN PDFM PSW PW RAS RCW REJ RML RW SAM SC STORM PLANT SERVICE WATER POTABLE WATER
RETURN ACTIVATED SLUDGE RECLAIMED WATER REJECT RECIRCULATED MIXED LIQUOR RECLAIMED WATER SAMPLE STORMWATER COLLECTION STORAGE POND WATER SANITARY SEWER SPRAY WATER SANITARY WATER VALVE THICKENED SLUDGE UNDERDRAIN

PIPING ABBREVIATIONS

ABANDONED CLEANOUT CO CORP CV DI CORPORATION CHECK VALVE DUCTILE IRON DIAMETER DUCTILE IRON PIPE ELEC EXIST FH EXISTING FIRE HYDRANT FLANGED GATE VALVE HOSE BIBB HIGH DENSITY POLYETHYLENE MANHOLE MECHANICAL JOINT MH MJ PE PS PVC RED SCH SCH SS TBR PLAIN END PUMP STATION POLYVINYLCHLORIDE REDUCER SCHEDULE STAINLESS STEEL TO BE REMOVED UNDERGROUND ELECTRIC VALVE VERTICAL

LEGEND

EXISTING		PROPOSED
	PIPELINE	
	GATE VALVE	
	BUTTERFLY VALVE	
	BALL VALVE	——————————————————————————————————————
	PLUG VALVE	$ \Delta $
	REDUCER	
- — —A— — —	AIR RELEASE VALVE	A
	GAS VALVE	
	MANHOLE	
	CATCH BASIN	C.B.
F.H	FIRE HYDRANT	F.H.
- · · - · · - · · -	TOP OR TOE OF BANK	
-X X X	CHAIN LINK FENCE	xx
	R/W OR PROPERTY LINE	
////////////	PIPING, STRUCTURES OR EQUIPMENT	NT TO BE REMOVED
•	BENCHMARK	
\Diamond	FIRE HYDRANT	
\$	LIGHT POLE	
	VALVE	
SWV.	SANITARY WATER VALVE	
	RECLAIMED WATER METER	
S	SANITARY MANHOLE	
Ē	ELECTRIC MANHOLE	
	BOLLARD	
\Diamond	POWER POLE	
\circ	UTILITY RISER	
••	IRRIGATION HEAD	
	S.U.E. TEST HOLE LOCATION	
	CONCRETE PAVEMENT	
	CONCRETE PAD	
	PAINTED STRIPING	
	PROPOSED GRADE	35.50 ×
	SURFACE FLOW ARROW	~~
	STRUCTURE COLUMN	I
	SILT FENCE	0 0
	YARD HYDRANT	<u> </u>
	HOSE RACK	


SECTION DESIGNATION

UNKNOWN

WASTE ACTIVATED SLUDGE



INDICATES ONE OR MORE SECTIONS CUT AND SHOWN ON THE SAME SHEET

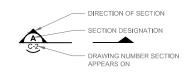

SECTION DESIGNATION

DETAIL DESIGNATION


DRAFTING LEGEND



DETAIL DESIGNATION



PIPE IDENTIFICATION

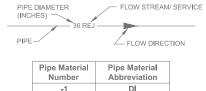

PVC

2RCW-2 PIPE DIAMETER (INCHES) FLOW STREAM SERVICE -PIPE MATERIAL

THE LEGEND LISTED REPRESENT A COMPREHENSIVE STANDARD GUIDE INTENDED FOR GENERAL USE, THEREFORE, NOT ALL OF THE SYMBOLS AND ABBREVIATIONS CONTAINED ON THIS SHEET ARE NECESSARILY USED ON THIS PARTICULAR CONTRACT

RECORD DRAWING

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REN 12/2017 RECORD DRAWING DESCRIPTION BY DATE

SEWRF SEPTAGE/ GREASE RECEIVING STATION




MANATEE COUNTY DEPARTMENT OF PUBLIC WORKS UTILITIES DEPARTMENT





CLEARWATER DRAWN

RECORD DRAWINGS **LEGEND AND ABBREVIATIONS** ROJECT NO 00193-009-02


MARCH 2015 SHEET NO: G-4

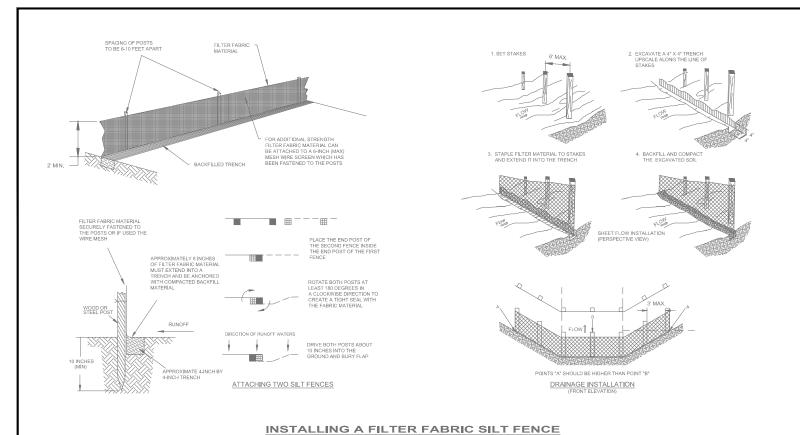

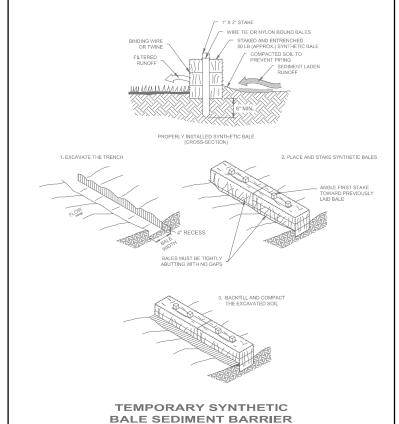

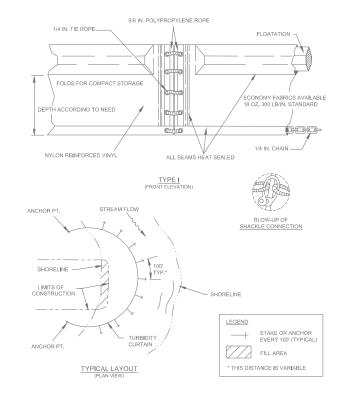


TEMPORARY FLOATING **TURBIDITY BARRIER**

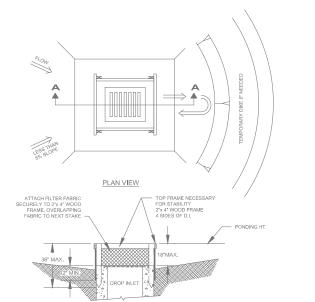

SECTION A-A

DTES:

OROP INLET SEDIMENT BARRIERS ARE TO BE USED FOR SMALL, NEARLY LEVEL DRAINAGE AREAS, (LESS THAN 5%)
USE 2"x4" WOOD OR EQUIVALENT METAL STAKES. (3 FT. MIN. LENGTH)
NISTALL 2"x4" WOOD TOP FRAME TO INSURE STABILITY.
THE TOP OF THE FRAME (PONDING HEIGHT) MUST BE WELL BELOW THE GROUND ELEVATION DOWNSLOPE TO
PREVENT RUNOFF FROM BYPASSING THE INLET. A TEMPORARY DIKE MAY BE NECESSARY ON THE DOWNSLOPE
SIDE OF THE STRUCTURE.

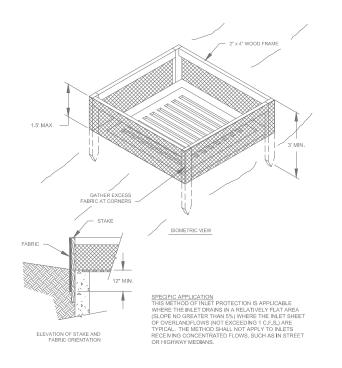

TEMPORARY SEDIMENT BARRIER AT DROP INLET NOT TO SCALE

SEWRF SEPTAGE/ GREASE



MANATEE COUNTY DEPARTMENT OF PUBLIC WORKS UTILITIES DEPARTMENT

1410 66th Street West Bradenton, Florida 342 (941) 792-8811

PLAN VIEW STAKED SYNTHETIC BALE SECTION A-A THIS METHOD OF INLET PROTECTION IS APPLICABLE WHERE THE INLET DRAINS A RELATIVELY FLAT AREA (SLOPES NO GREATER THAN 5%) WHERE SHEET OR OVERLAND FLOWS NOT EXCEDING 0.5 CFS) ARE TYPICAL. THE METHOD SHALL NOT APPLY TO INLETS RECEIVING CONCENTRATED FLOWS, SUCH AS

TEMPORARY SYNTHETIC BALE SEDIMENT BARRIER AT STORM DRAIN DROP INLET

EROSION CONTROL NOTES

- 1. IT IS THE RESPONSIBILITY OF THE CONTRACTOR TO CONTROL AND PREVENT EROSION AND THE TRANSPORTATION OF SEDIMENT TO SURFACE DRAINS AND
- THE CONTRACTOR SHALL PROVIDE SILT BARRIERS TO CONTROL EROSION AND SEDIMENTATION FROM TAKING PLACE OUTSIDE THE LIMITS OF THE PROJECT. THE SILT BARRIERS SHALL BE PLACED IN ACCORDANCE WITH THE REQUIREMENTS OF FDOT INDEX NO. 102, 103 AND 104 OR AS DIRECTED BY THE CITY ENGINEER.
- 3. REQUIRED EROSION CONTROL MEASURES SHALL REMAIN INTACT THROUGHOUT CONSTRUCTION. FAILURE TO INSTALL OR PROPERLY MAINTAIN REQUIRED EROSION CONTROL WILL RESULT IN ENFORCEMENT ACTION WHICH MAY INCLUDE CITATIONS AS PROVIDED BY APPLICABLE LOCAL ORDINANCE AND CHAPTERS 40D-4 AND 40D-40, F.A.C. INITIATION OF CIVIL PENALTY PROCEDURES PURSUANT TO SECTION 373.129, F.A.C. CAN RESULT IN A PENALTY NOT TO EXCEED \$10,000 PER OFFENSE WITH EACH DATE DURING WHICH SUCH VIOLATION OCCURS CONSTITUTING A SEPARATE OFFENSE.
- 4. ALL WORK PERFORMED SHALL COMPLY WITH THE REGULATIONS AND ORDINANCES OF THE VARIOUS GOVERNMENTAL AGENCIES HAVING JURISDICTION OVER THE WORK
- 5. CONTRACTOR SHALL CONSTRUCT TURBIDITY BARRIERS APPROXIMATELY 25 FEET DOWNSTREAM OF END SECTIONS AT POND LOCATIONS SHOWN ON PLAN SHEETS. CONTRACTOR TO INSPECT AND MAINTAIN EACH TURBIDITY BARRIER
- 6. CONTRACTOR MAY USE OTHER ACCEPTABLE EROSION CONTROL DEVICES AROUND INLETS AS APPROVED BY THE ENGINEER.

RECORD DRAWING

THIS RECORD DRAWING SHOWS THE REPORTED LOCATION OF WORK IN SUBSTANTIAL COMFORMANCE WITH THE APPROVED CONSTRUCTION PLANS. THIS RECORD DRAWING IS BASED ON INFORMATION PROVIDED BY THE CONTRACTOR AND SURVEYOR. CARDNO CANNOT AND DOES NOT WARRANTY ITS ACCURACY.

RECORD DRAWINGS EROSION CONTROL DETAILS AND NOTES

00193-009-02 SHEET NO:


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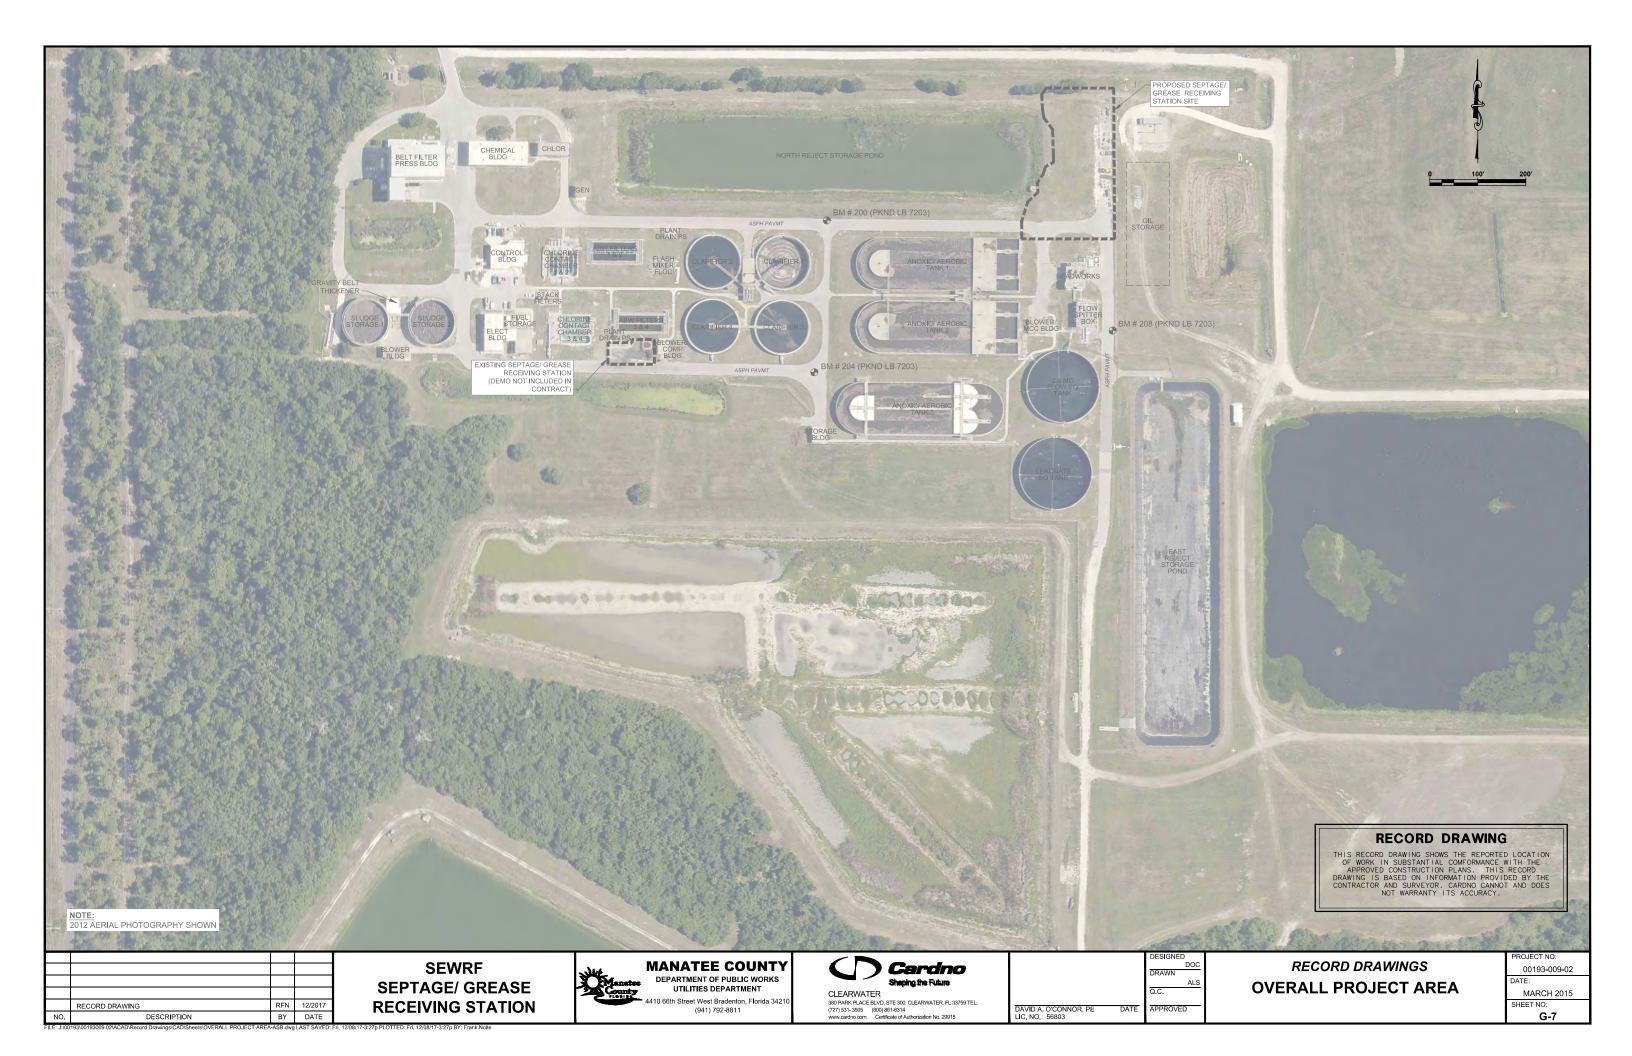
Cardno Shaping the Future CLEARWATER


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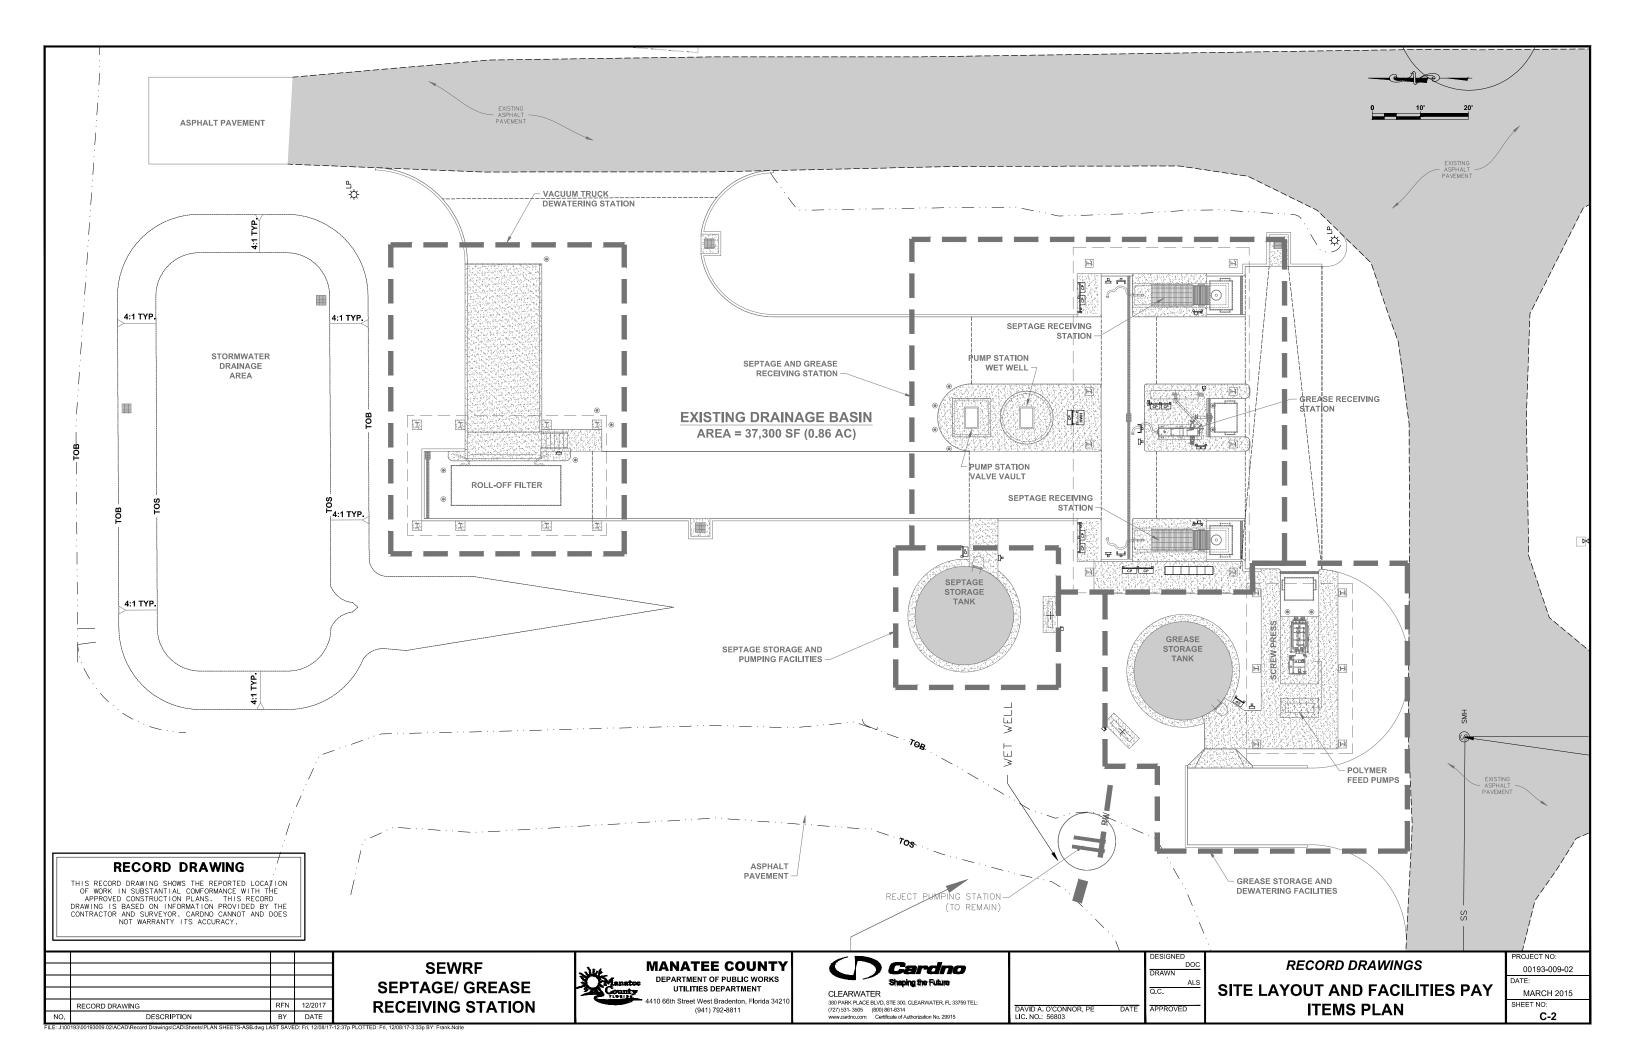
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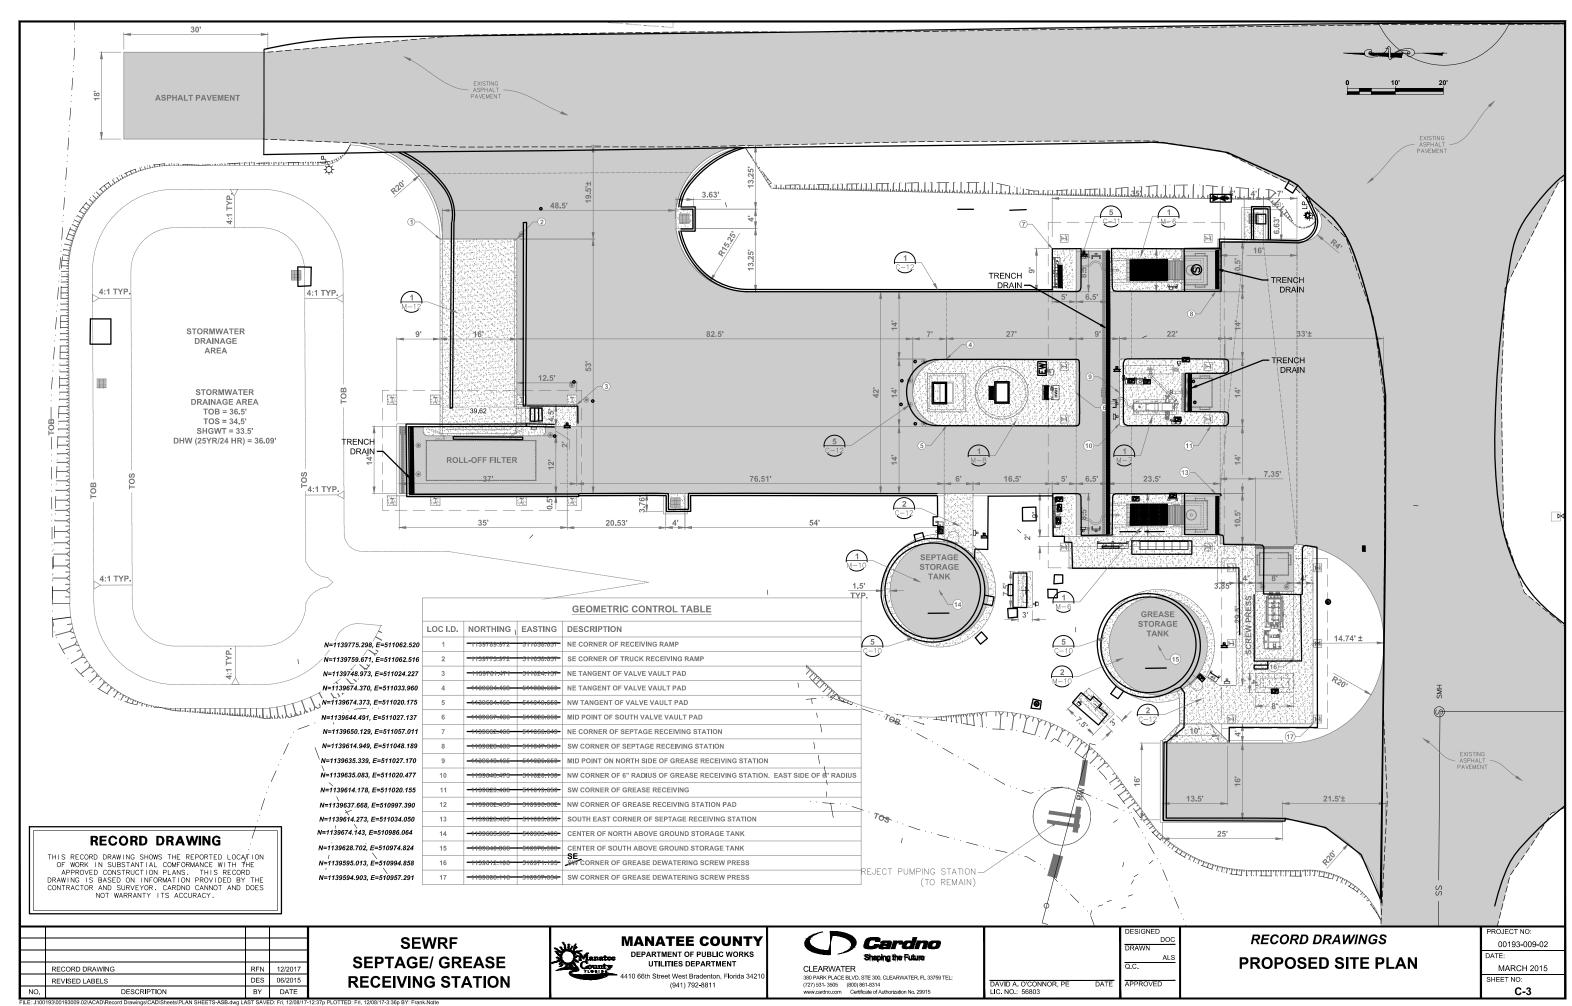
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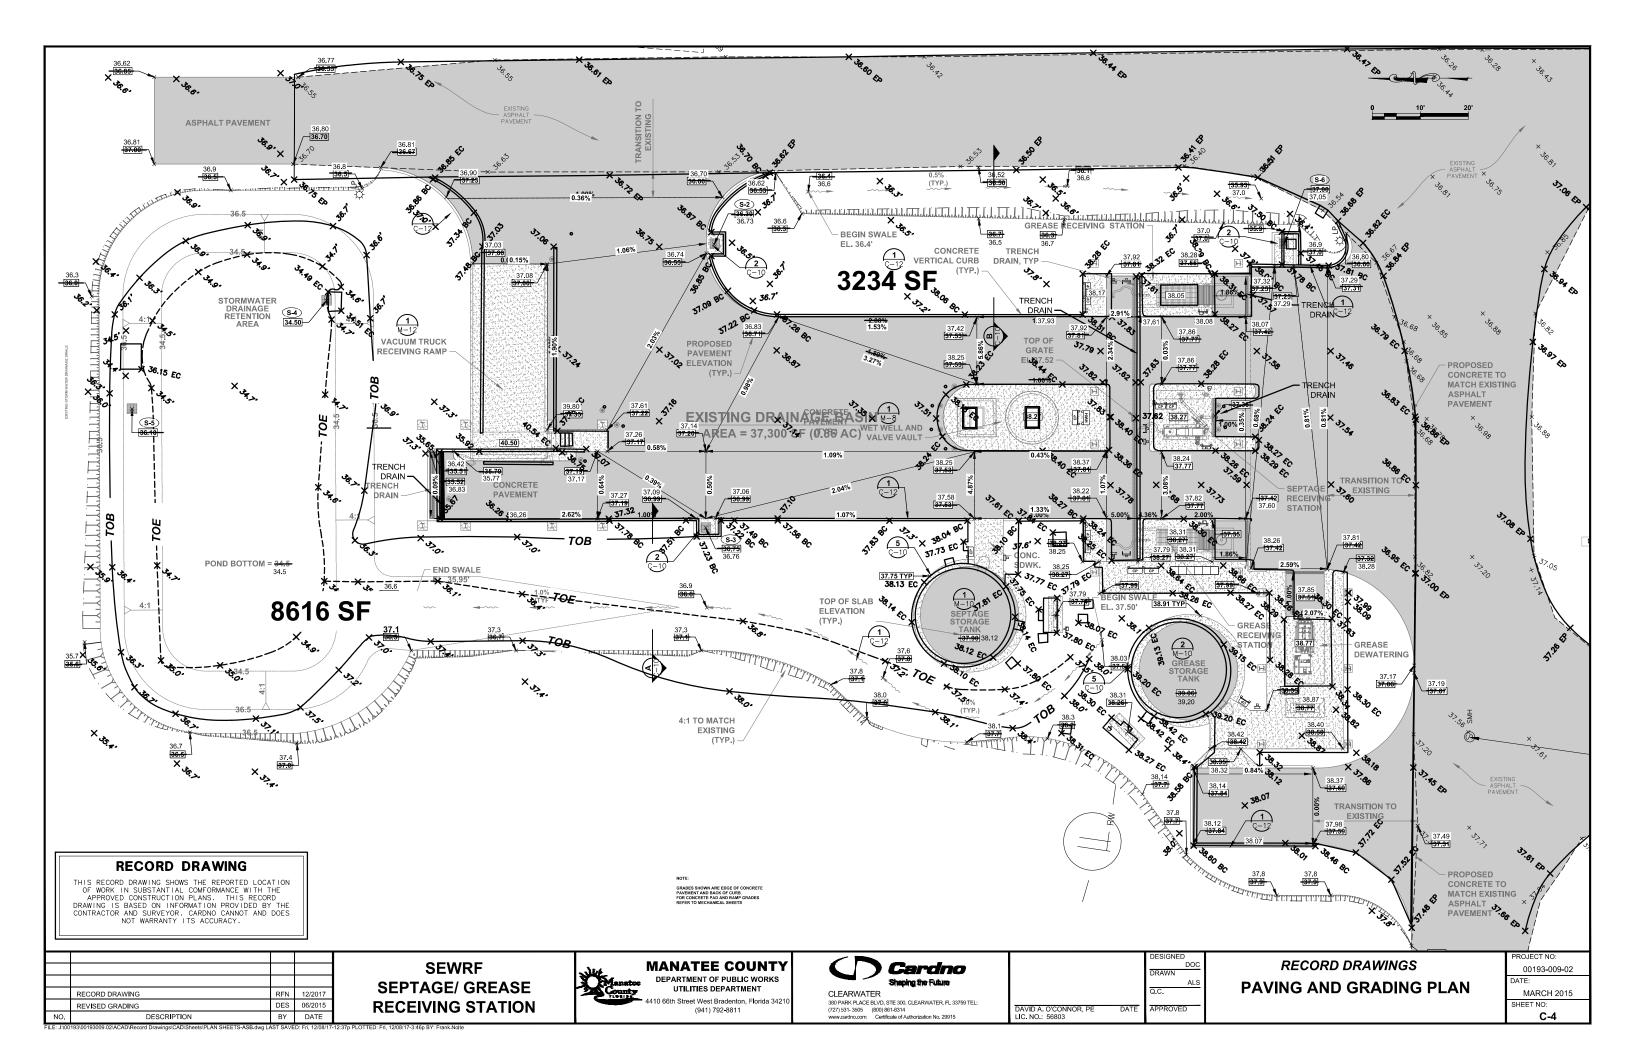











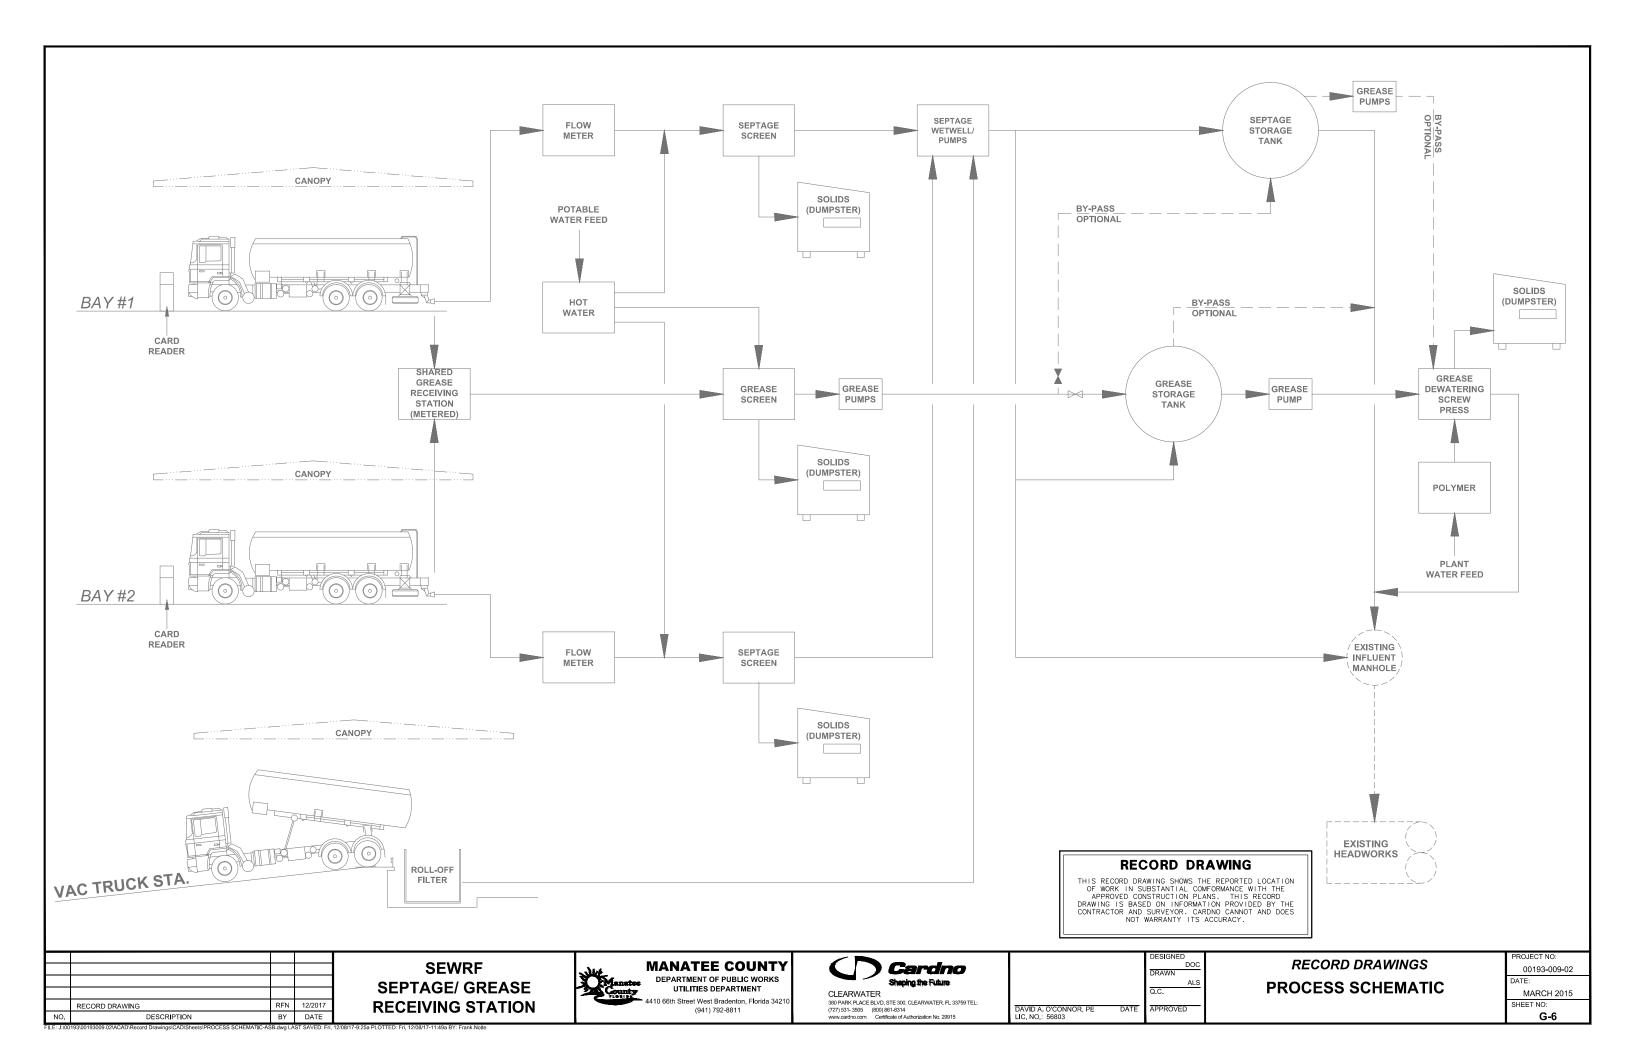


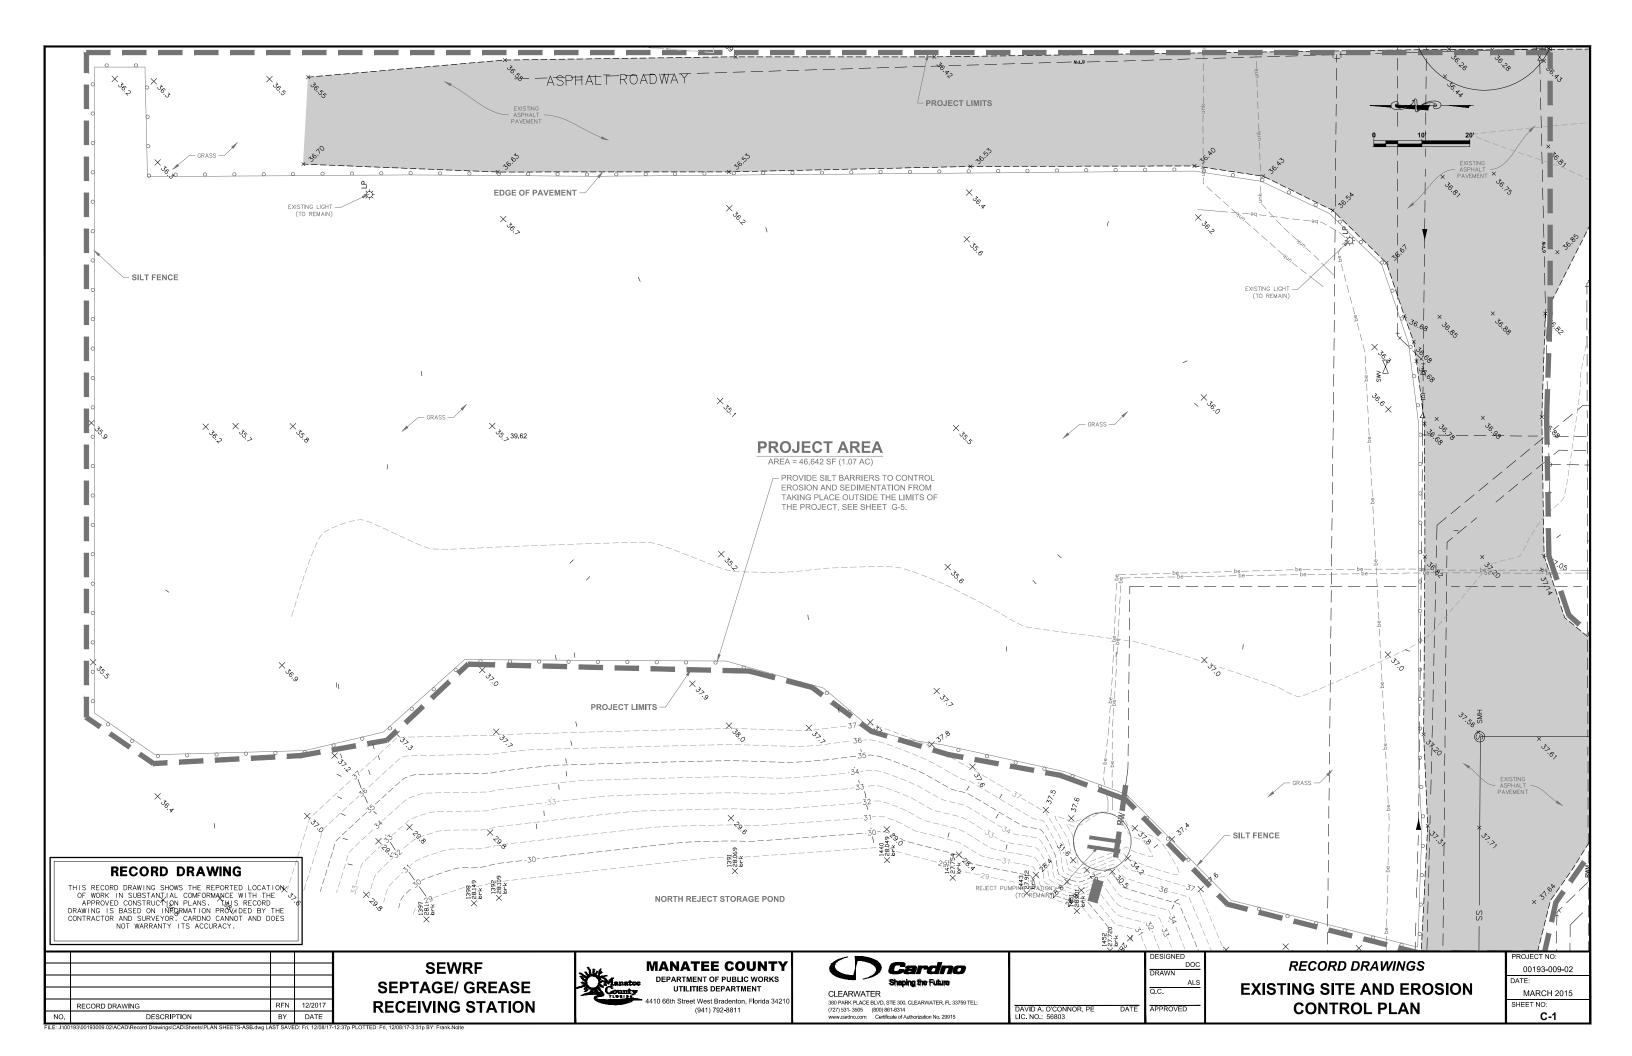

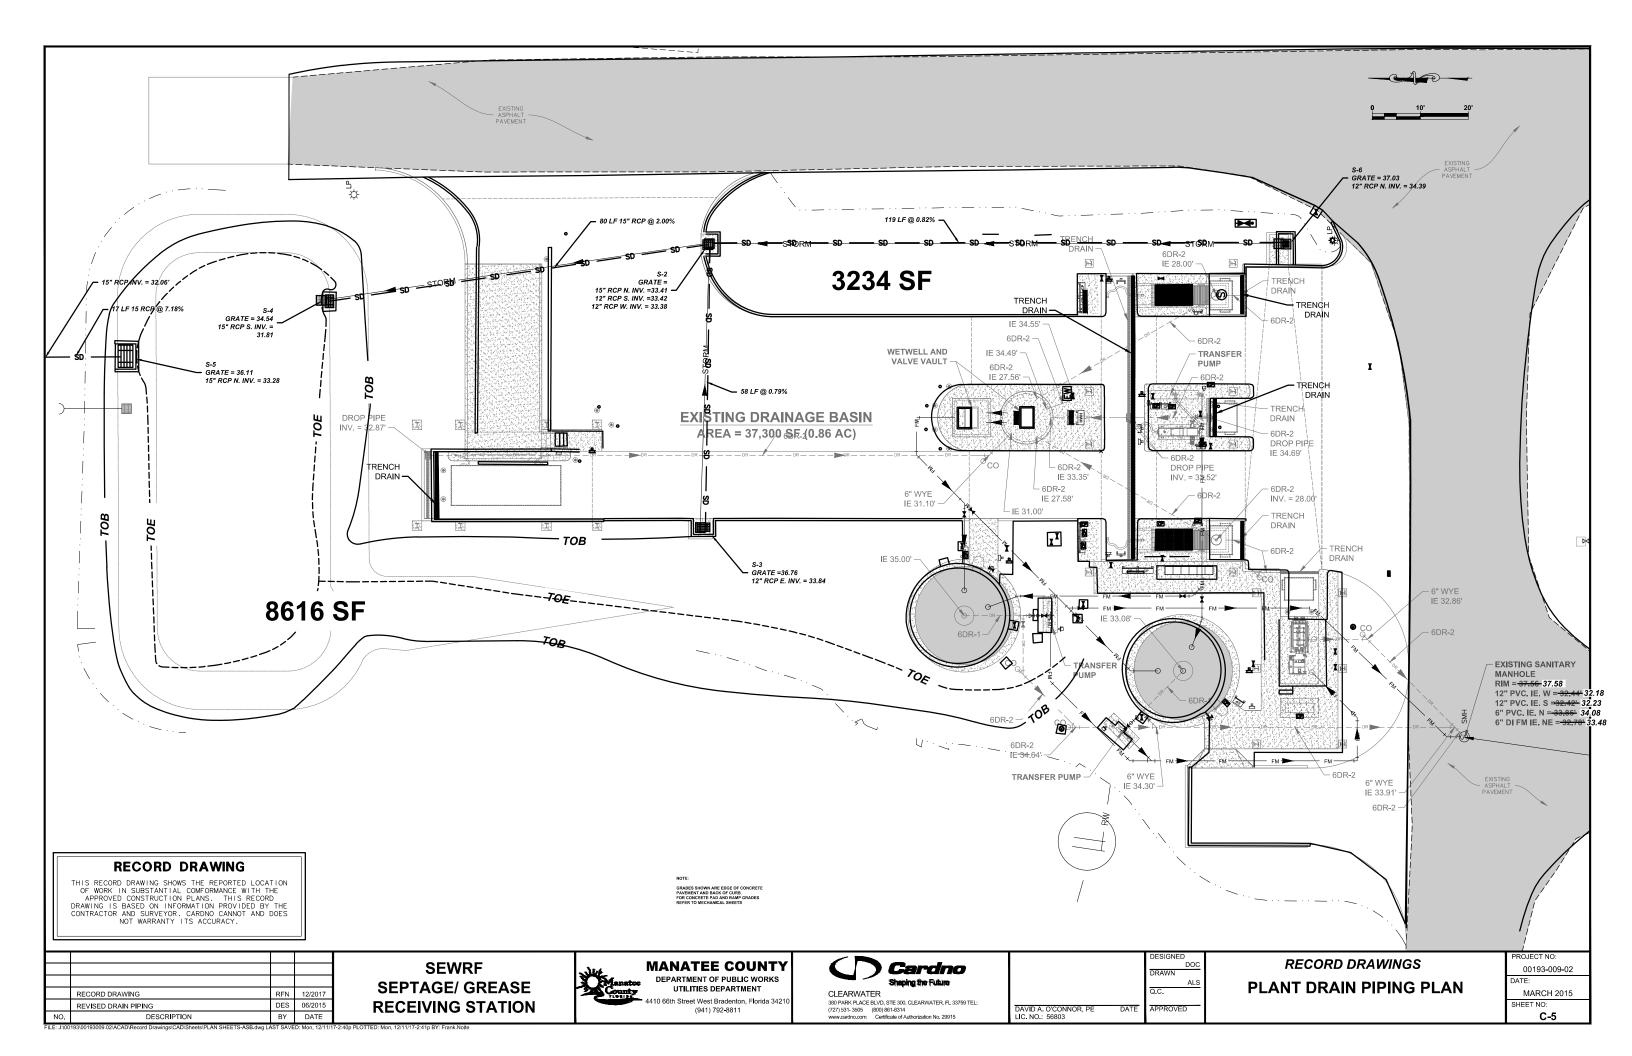

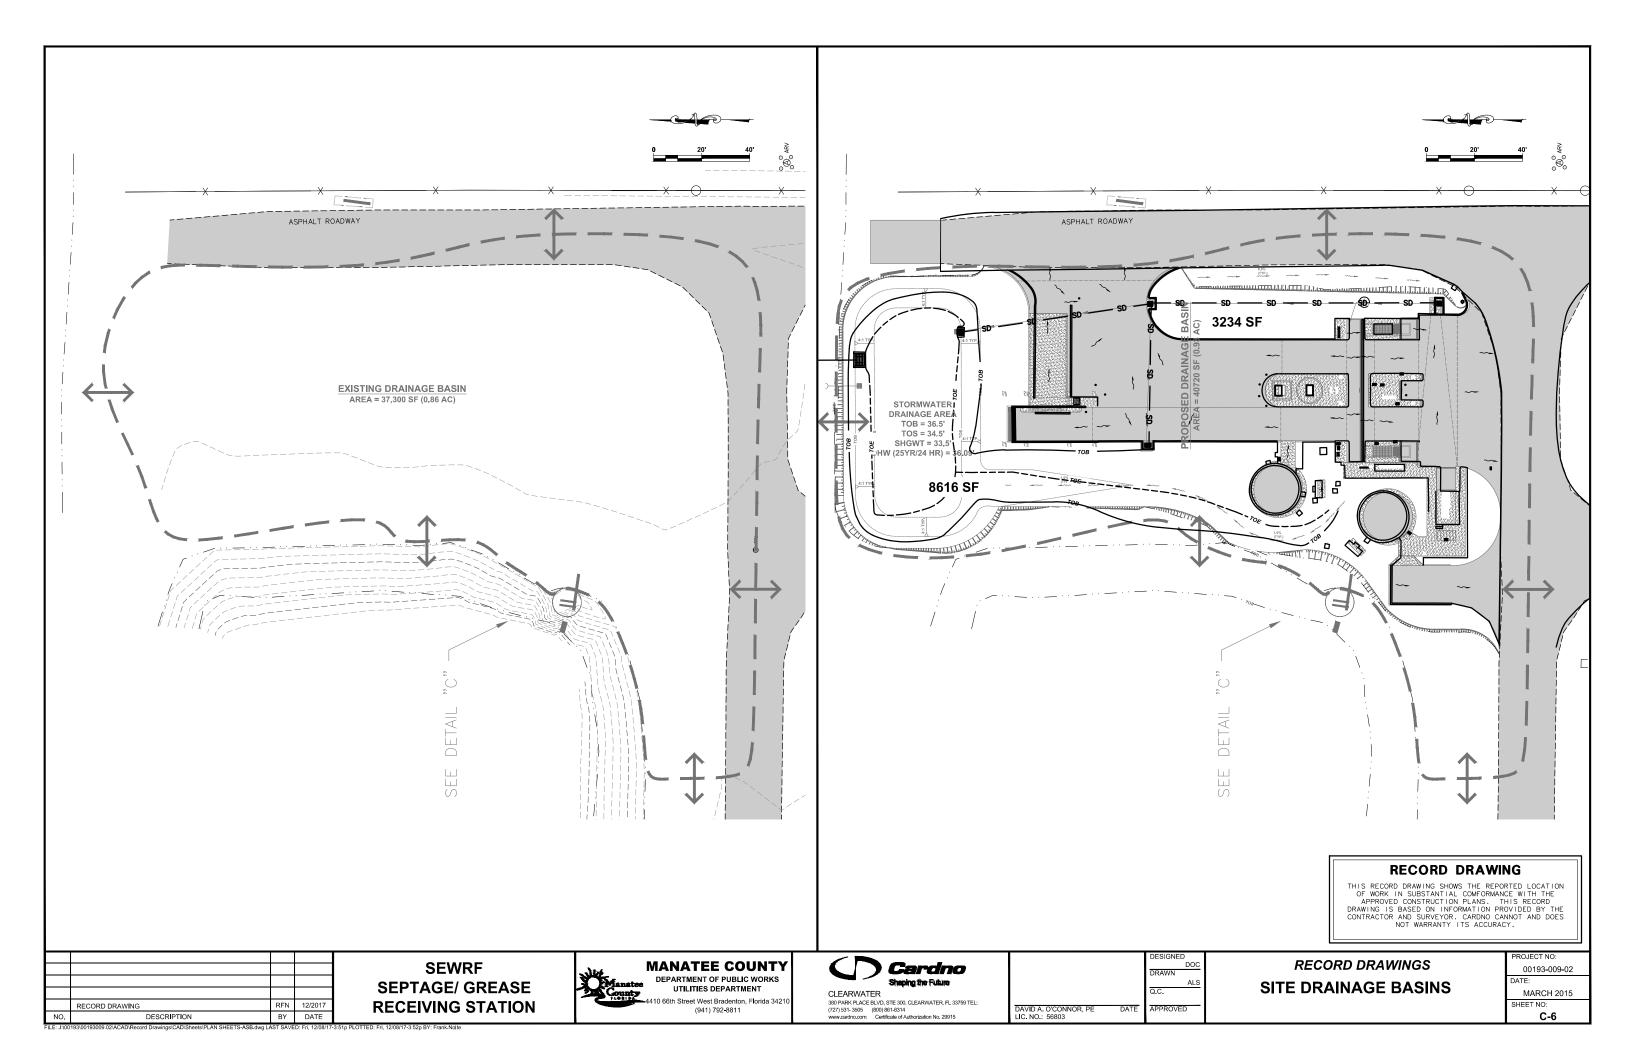


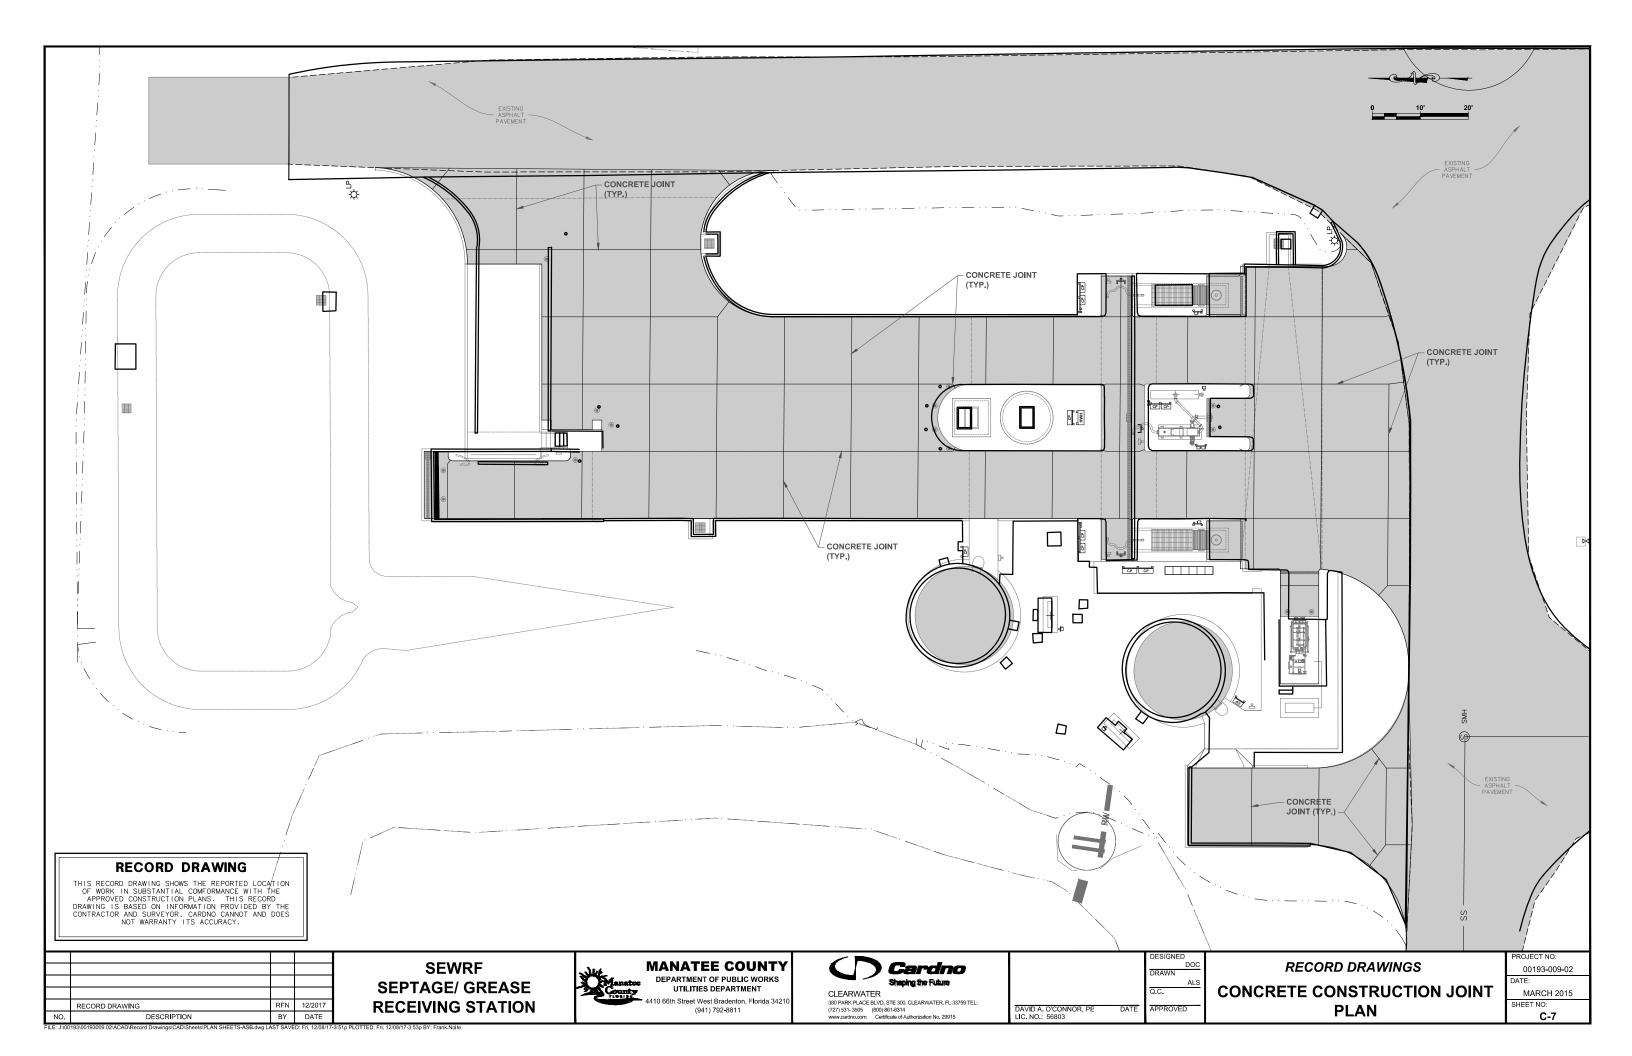

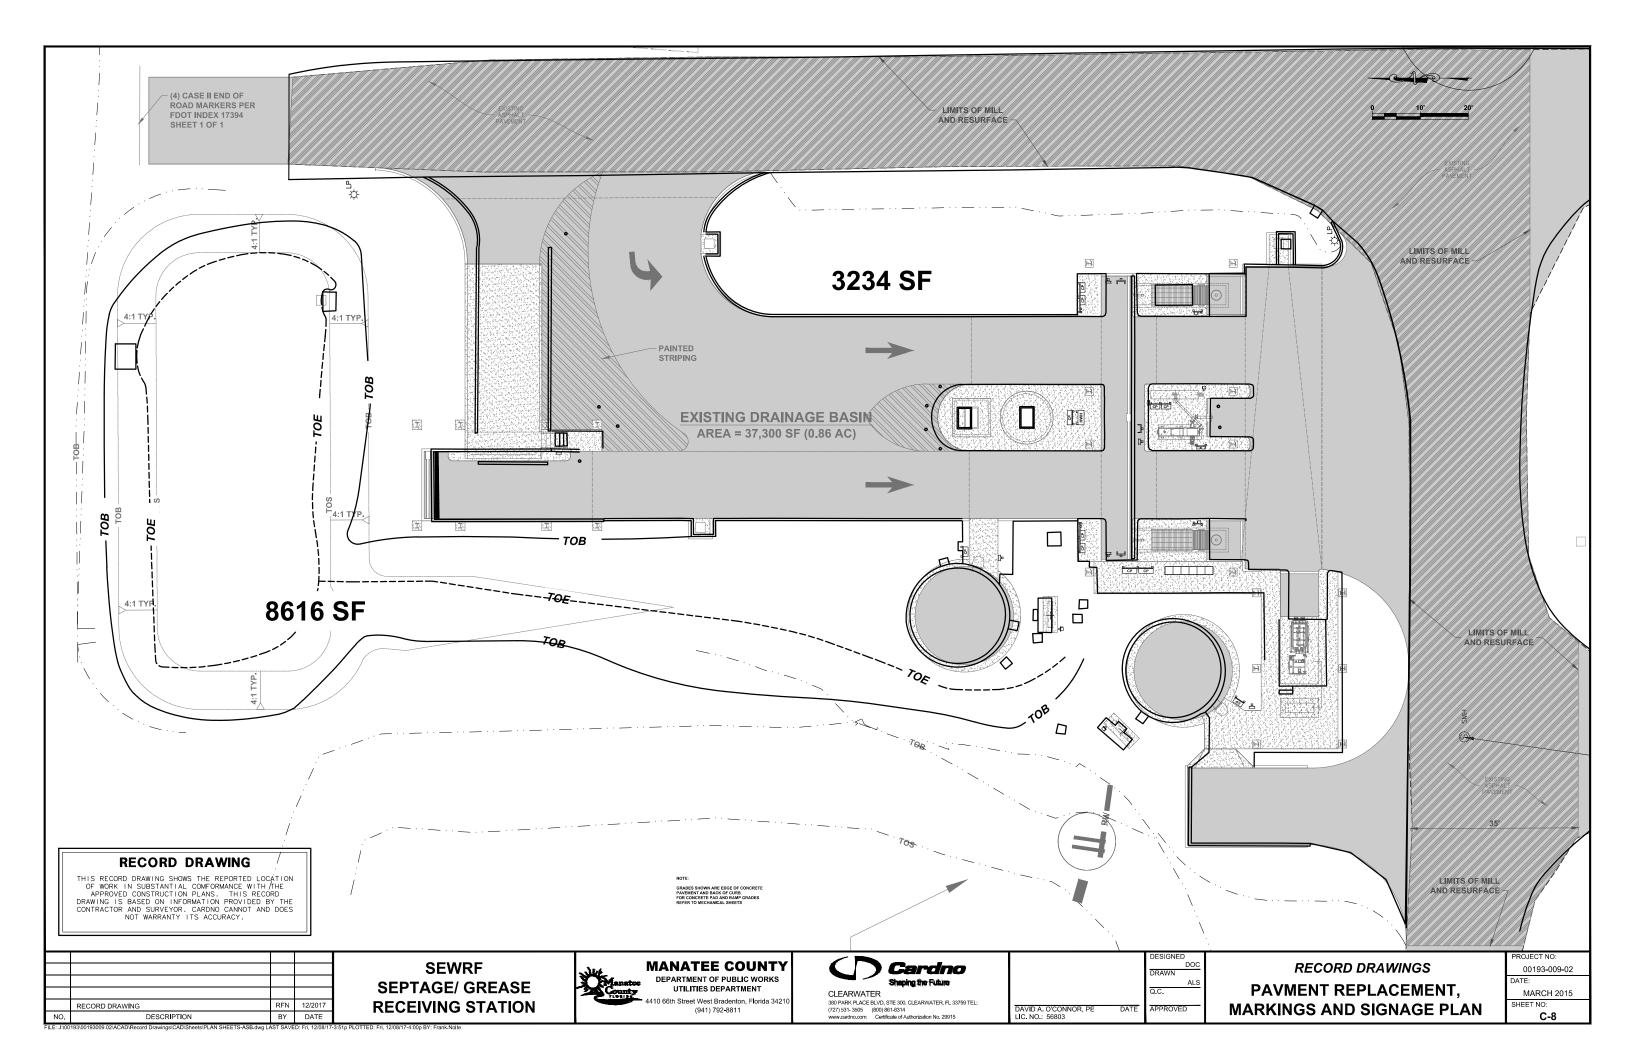


NOTES:

- 1. USE OF TYPE A-2 AND A-3 PIPE BEDDING TO BE DETERMINED IN THE FIELD BY THE
- PROVIDE ADEQUATE CLEARANCE TO PLACE AND COMPACT STAGE 1 BEDDING MATERIAL IN TRENCH AREA BELOW PIPE SPRINGLINE. PIPE EMBEDMENT MUST BE COMPACTED OUT TO THE TRENCH WALL OR 2.5 TIMES THE PIPE OD, WHICHEVER IS LESS.
- 3. TYPICALLY 4" TO 6".
- 4. PIPE INSTALLATION SHALL BE IN ACCORDANCE WITH THE MANUFACTURER'S WRITTEN
- 5. TRACER WIRE NOT REQUIRED FOR GRAVITY SEWERS.

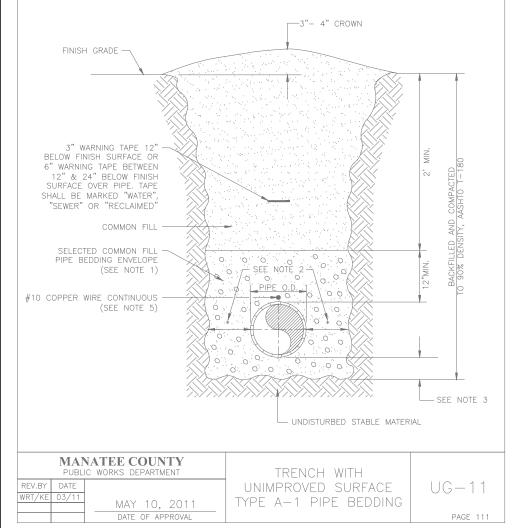


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- 2. PROVIDE ADEQUATE CLEARANCE TO PLACE AND COMPACT STAGE 1 BEDDING MATERIAL IN TRENCH AREA BELOW PIPE SPRINGLINE. PIPE EMBEDMENT MUST BE COMPACTED OUT TO THE TRENCH WALL OR 2.5
- 4. PIPE INSTALLATION SHALL BE IN ACCORDANCE WITH THE MANUFACTURER'S WRITTEN INSTRUCTIONS.
- 5. ASPHALTIC CONCRETE STRUCTURE COURSE WITH PRIME COAT SHALL BE THE SAME DEPTH AND TYPE AS EXISTING OR A MINIMUM OF 1 1/4 INCH, WHICHEVER IS GREATER.
- 6. MILL 25' BACK FROM TRENCH SAW CUT. ADJUST MILLING PER INDIVIDUAL SITE TO NOT IMPACT BASE. BUTT JOINT TO EXIST ASPHALT. FINAL OVERLAY LIMITS ARE FROM EDGE OF PAVEMENT TO EDGE OF PAVEMENT. FINAL OVERLAY TO MATCH EXISTING WITH NO DISCERNABLE "BUMP" AT JOINT. MILLING LIMITS THAT IMPACT INTERSECTION SHALL BE ADDRESSED ON A CASE BY CASE BASIS AND APPROVED BY MANATEE COUNTY.
- 7. SHEETING ORDERED LEFT IN PLACE TO BE CUT OFF 24" BELOW FINISHED GRADE OR 12" BELOW SUBGRADE
- 8. BASE SHALL BE 8" MINIMUM THICKNESS CRUSHED CONCRETE.
- 9. TEMPORARY PATCHES WILL BE INSTALLED TO PROVIDE A SMOOTH ALL WEATHER SURFACE AT ALL TIMES. PERMANENT REPLACEMENT TO BE MADE AS SOON AS POSSIBLE.
- 10. RESTORE SIGNAGE & MARKING WITH THERMOPLASTIC PER FDOT STANDARDS, LATEST EDITION.
- 11. TRACER WIRE NOT REQUIRED FOR GRAVITY SEWERS.
- 12. NOTES 5. THRU 10. ARE MINIMUM REQUIREMENTS FOR A TRENCH IN A ROAD. REFER TO LATEST EDITION OF MANATEE COUNTY HIGHWAY AND TRAFFIC STANDARDS FOR ADDITIONAL REQUIREMENTS.

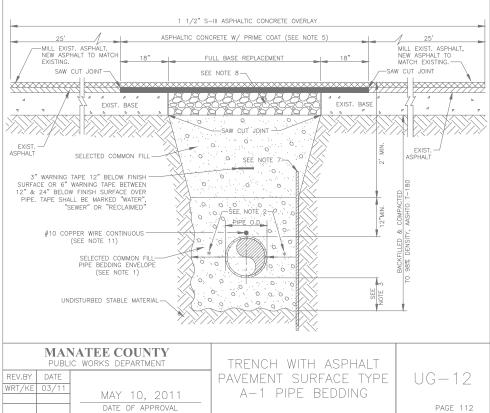

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MAY 10, 2011

DATE OF APPROVAL

PAVEMENT SURFACE TYPE A-1 PIPE BEDDING

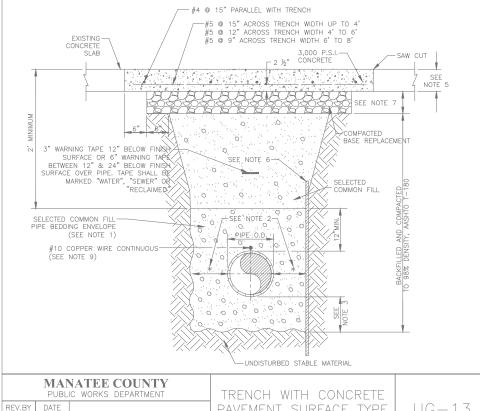UG-13

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RECORD DRAWING

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RECORD DRAWING REN 12/2017 DESCRIPTION BY DATE

SEWRF SEPTAGE/ GREASE RECEIVING STATION



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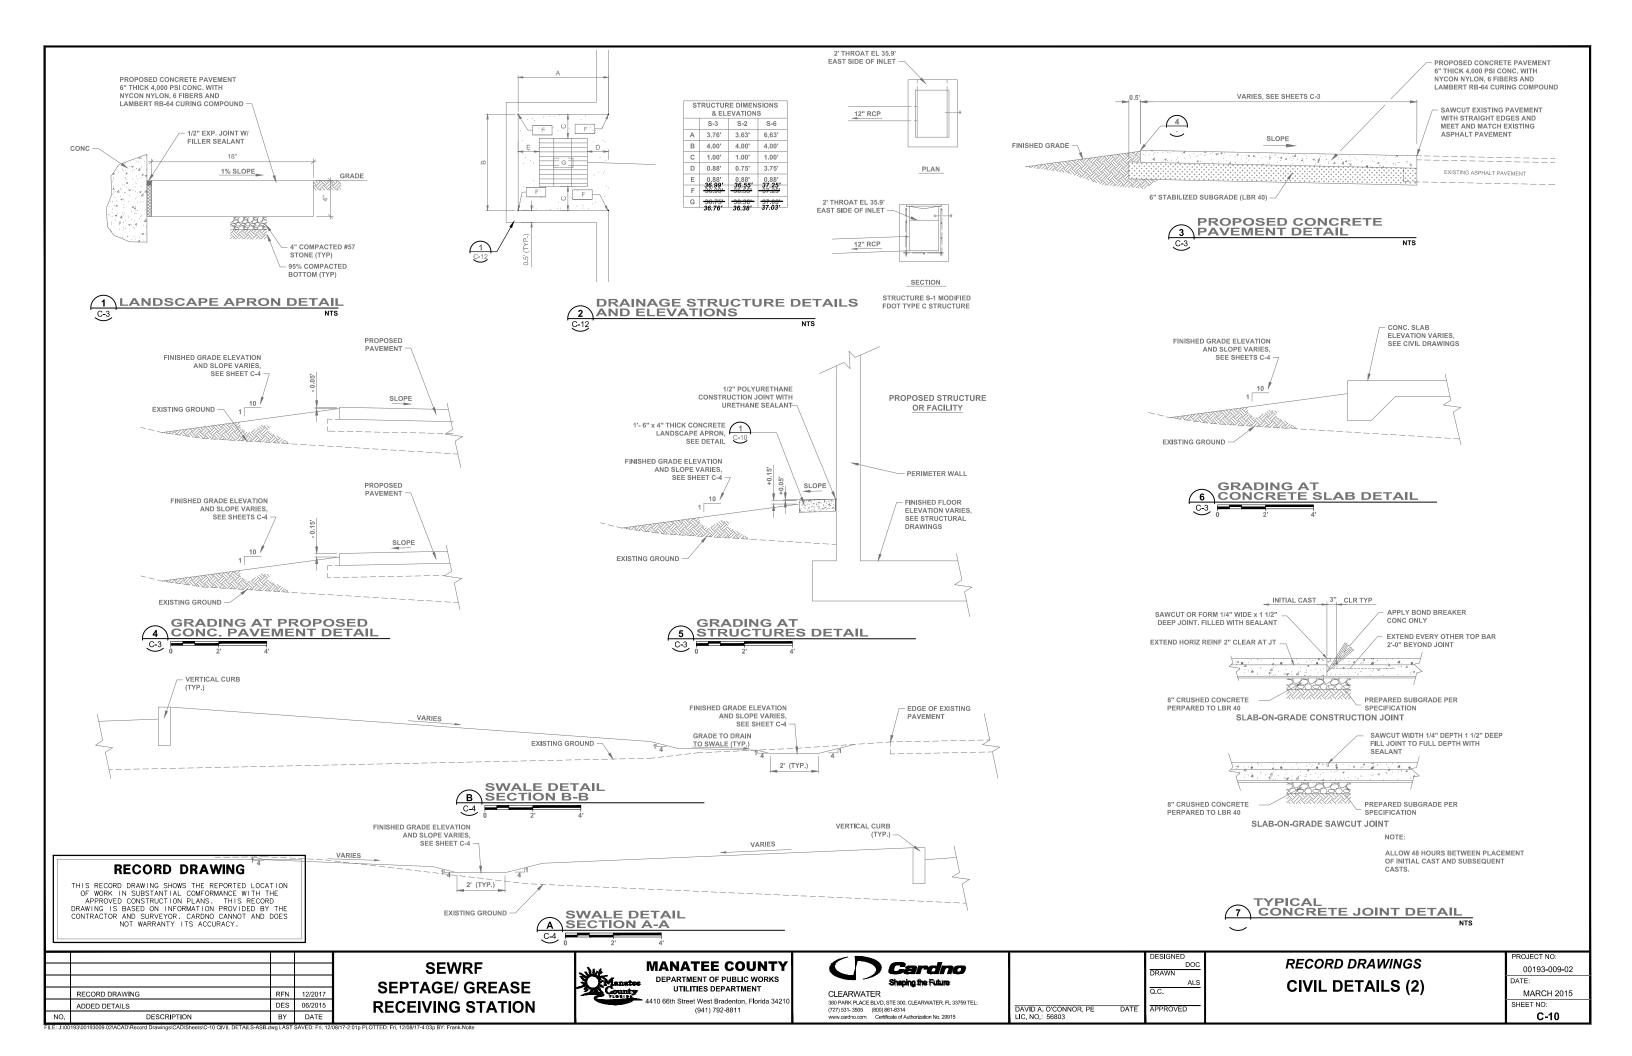
DRAWN DAVID A. O'CONNOR, PE DATE


RECORD DRAWINGS CIVIL DETAILS (1) 00193-009-02


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MARCH 2015

C-9






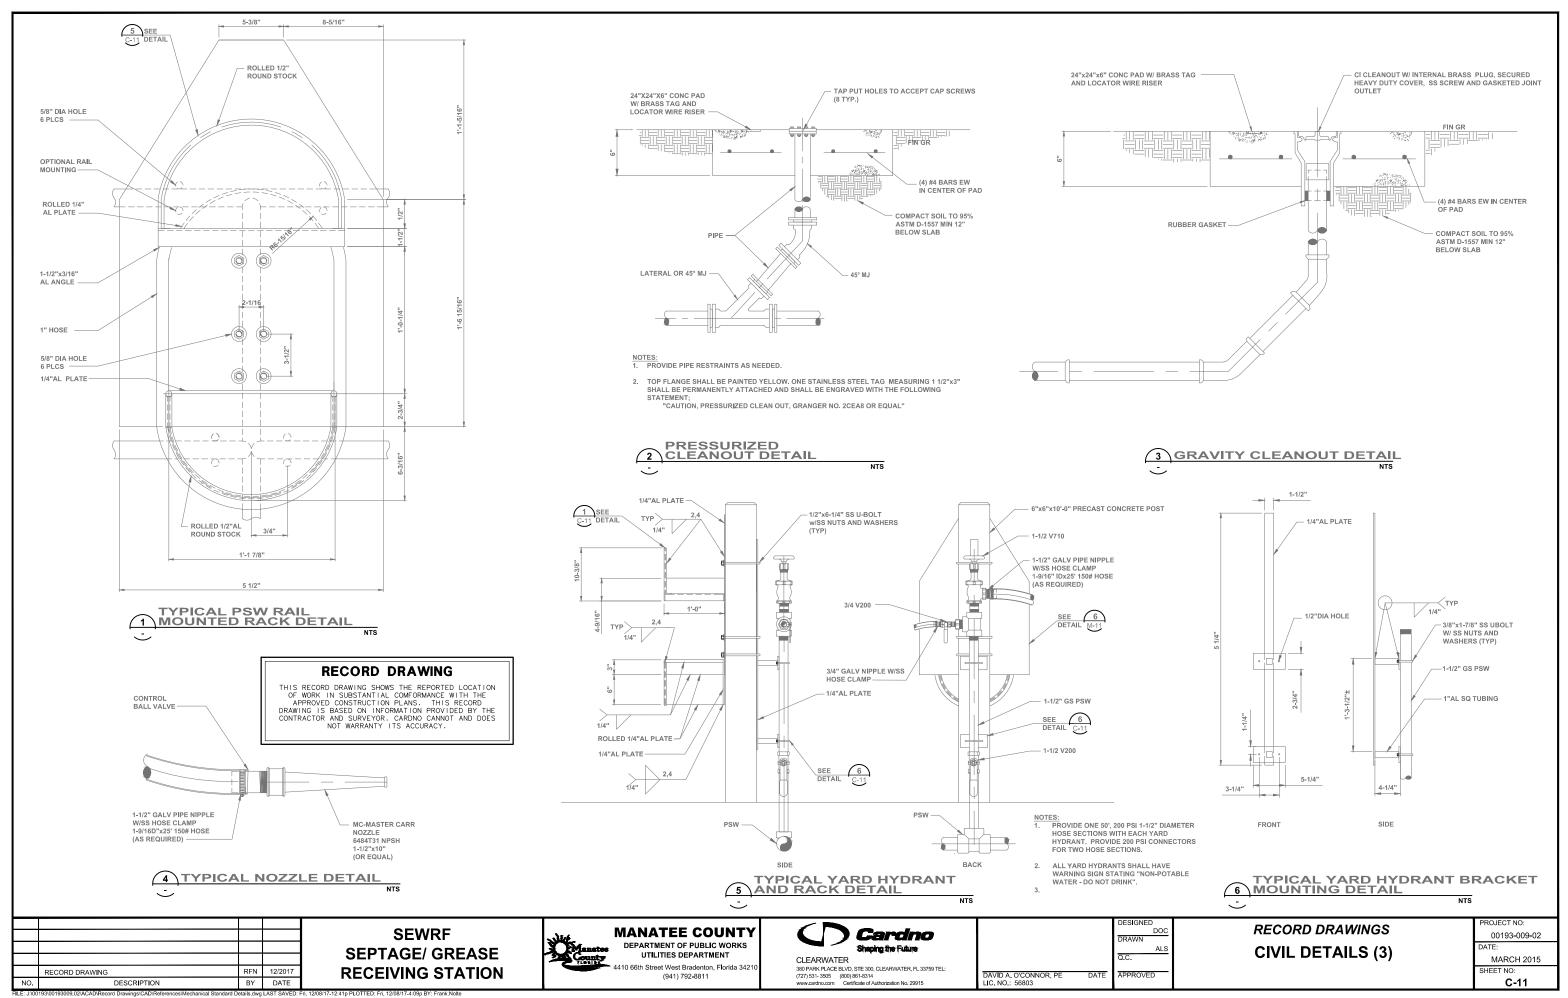

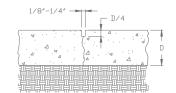TYPE 'A' UNDOWELED **CONTRACTION (CONTROL) JOINT**

UNDOWELED TRANSVERSE CONTRACTION OR LONGITUDINAL JOINT, SAWED OR PRE-MOLDED. DO NOT DOWEL PAVEMENTS LESS THAN 7" THICK

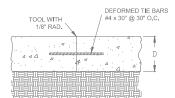


TYPE 'B' TIED JOINT

TIED LONGITUDINAL CONSTRUCTION OR CONTRACTION JOINT WHERE REQUIRED. NOTE: DO NOT TIE MORE THAN THREE LANES TOGETHER.




TYPE 'C' CONSTRUCTION JOINT

LONGITUDINAL KEYWAY CONSTRUCTION JOINT FOR PAVEMENT 6 INCHES OR GREATER, TYPE C-1 STRAIGHT BUTT TYPE JOINT USED FOR PAVEMENTS LESS THAN 6 INCHES.

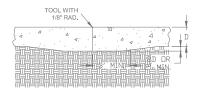


TYPE 'C-1' BUTT JOINT

IN LIEU OF THICKENING EDGES, OVERALL PAVEMENT THICKNESS MAY BE INCREASED AS FOLLOW: 6 INCHES OR LESS, ADD 0.5 INCH. MORE THAN 6 INCHES,

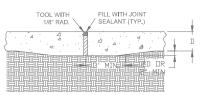


TYPE 'D' BUTT JOINT


ISOLATION JOINT FOR PAVEMENTS LESS THAN 8" THICK.

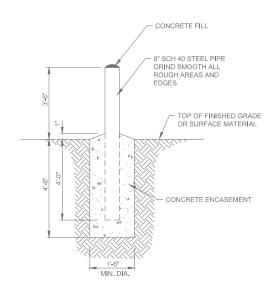





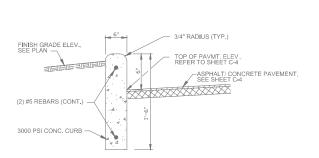

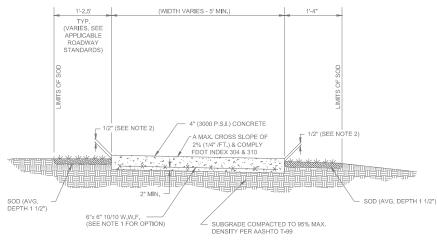



- NOTES:

 1. IN LIEU OF WIRE WOVEN FABRIC CONTRACTOR MAY USE CONCRETE REINFORCED WITH FIBERMESH AS AN ACCEPTABLE ALTERNATE.

 2. SPECIAL ATTENTION SHALL BE GIVEN TO THE GRADED SOD PLACEMENT TRENCH. THE GRADING BY THE CONTRACTOR SHALL PROVIDE A 1/2" DROP FROM THE SIDEWALK TO THE TOP OF THE SOD.

 3. SIDEWALKS ABUTTING DRAINAGE STRUCTURES SHALL BE LEVEL WITH THE TOP OF THE STRUCTURE.

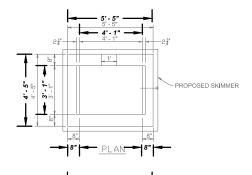

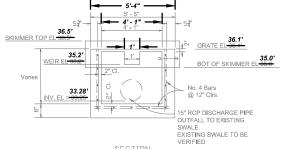

SECTION 3' - 1" Wall - 24" Pipe 4' - 1" Wall - 36" Pipe

MODIFIED FDOT TYPE D 3 S-5 CONTROL STRUCTUR

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CONCRETE VERTICAL CURB 1 DETAIL

CONCRETE SIDEWALK
2 DETAIL

RFN 12/2017 RECORD DRAWING DESCRIPTION BY DATE

SEWRF SEPTAGE/ GREASE RECEIVING STATION



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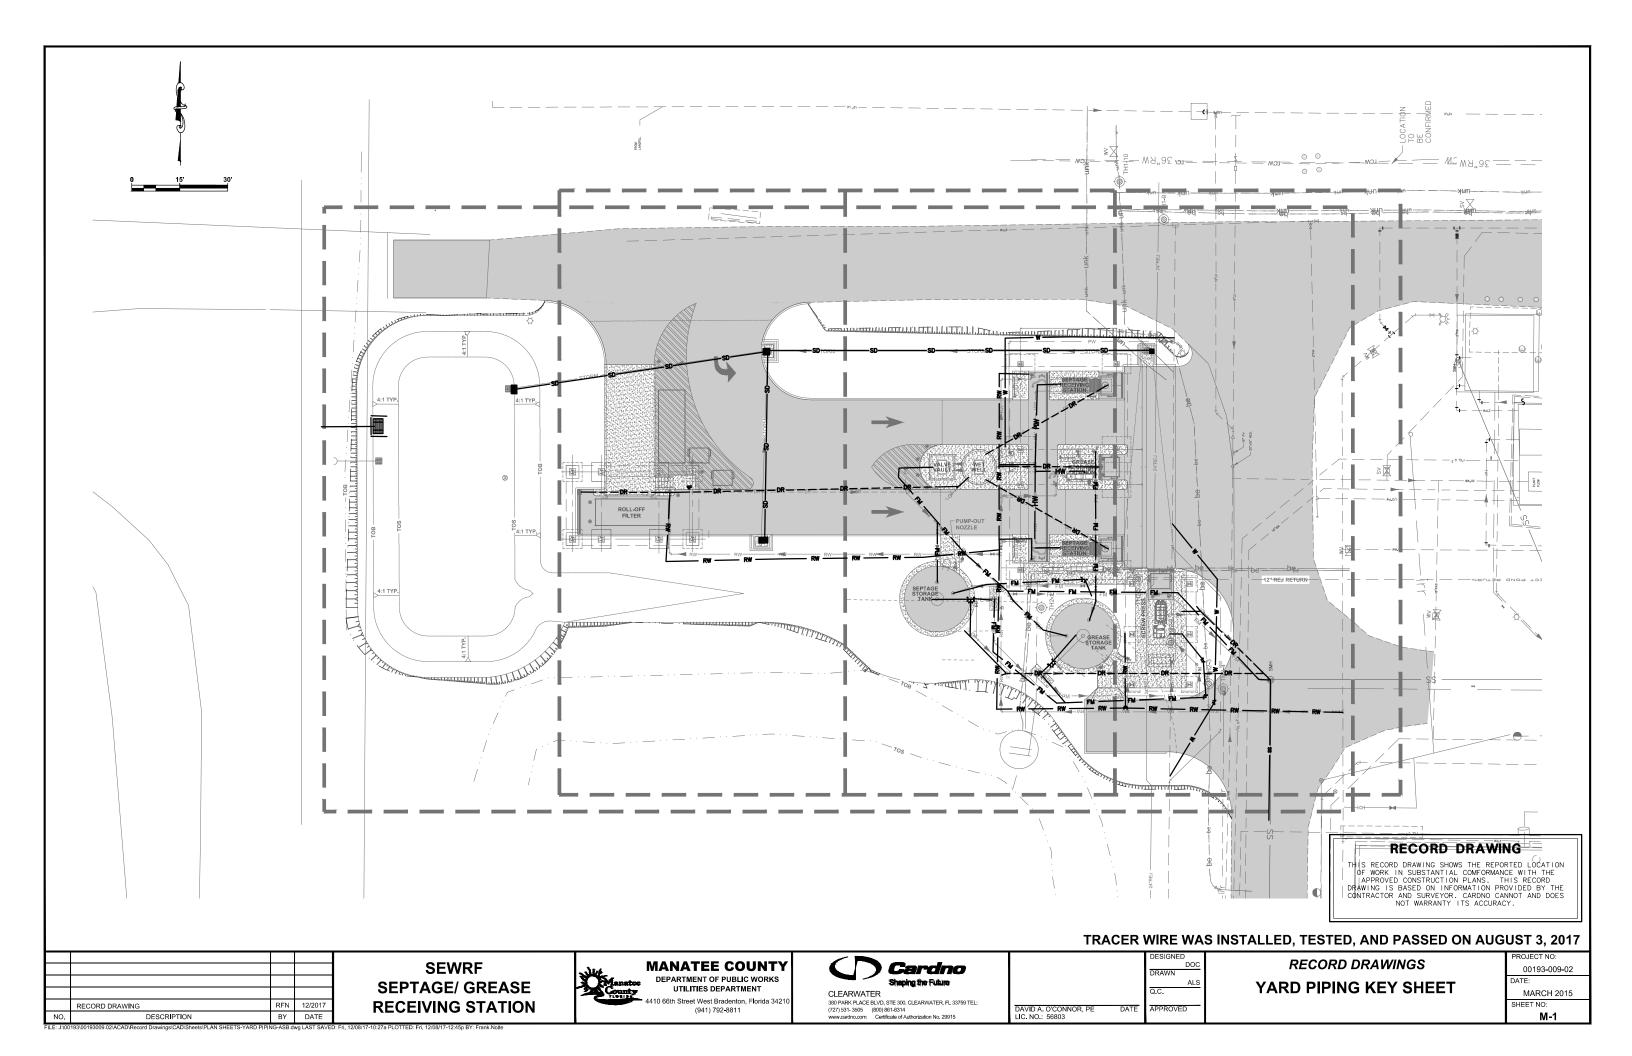
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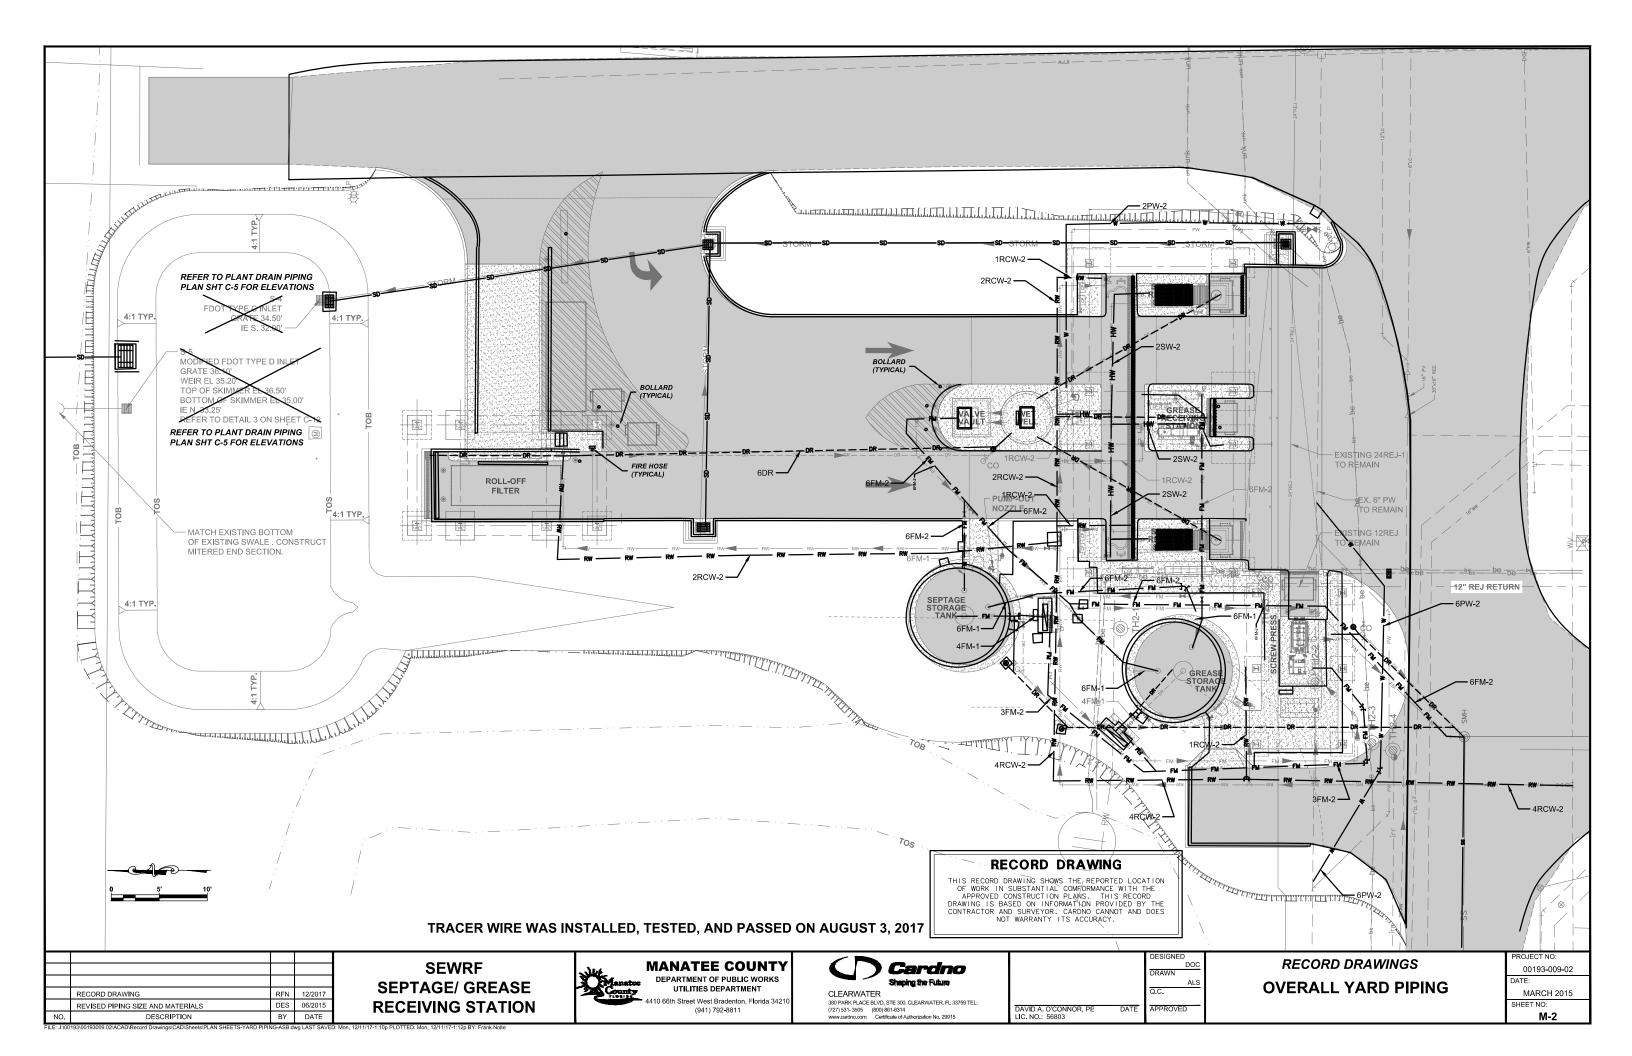
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DAVID A. O'CONNOR, PE LIC. NO.: 56803	DATE	APPROVED	


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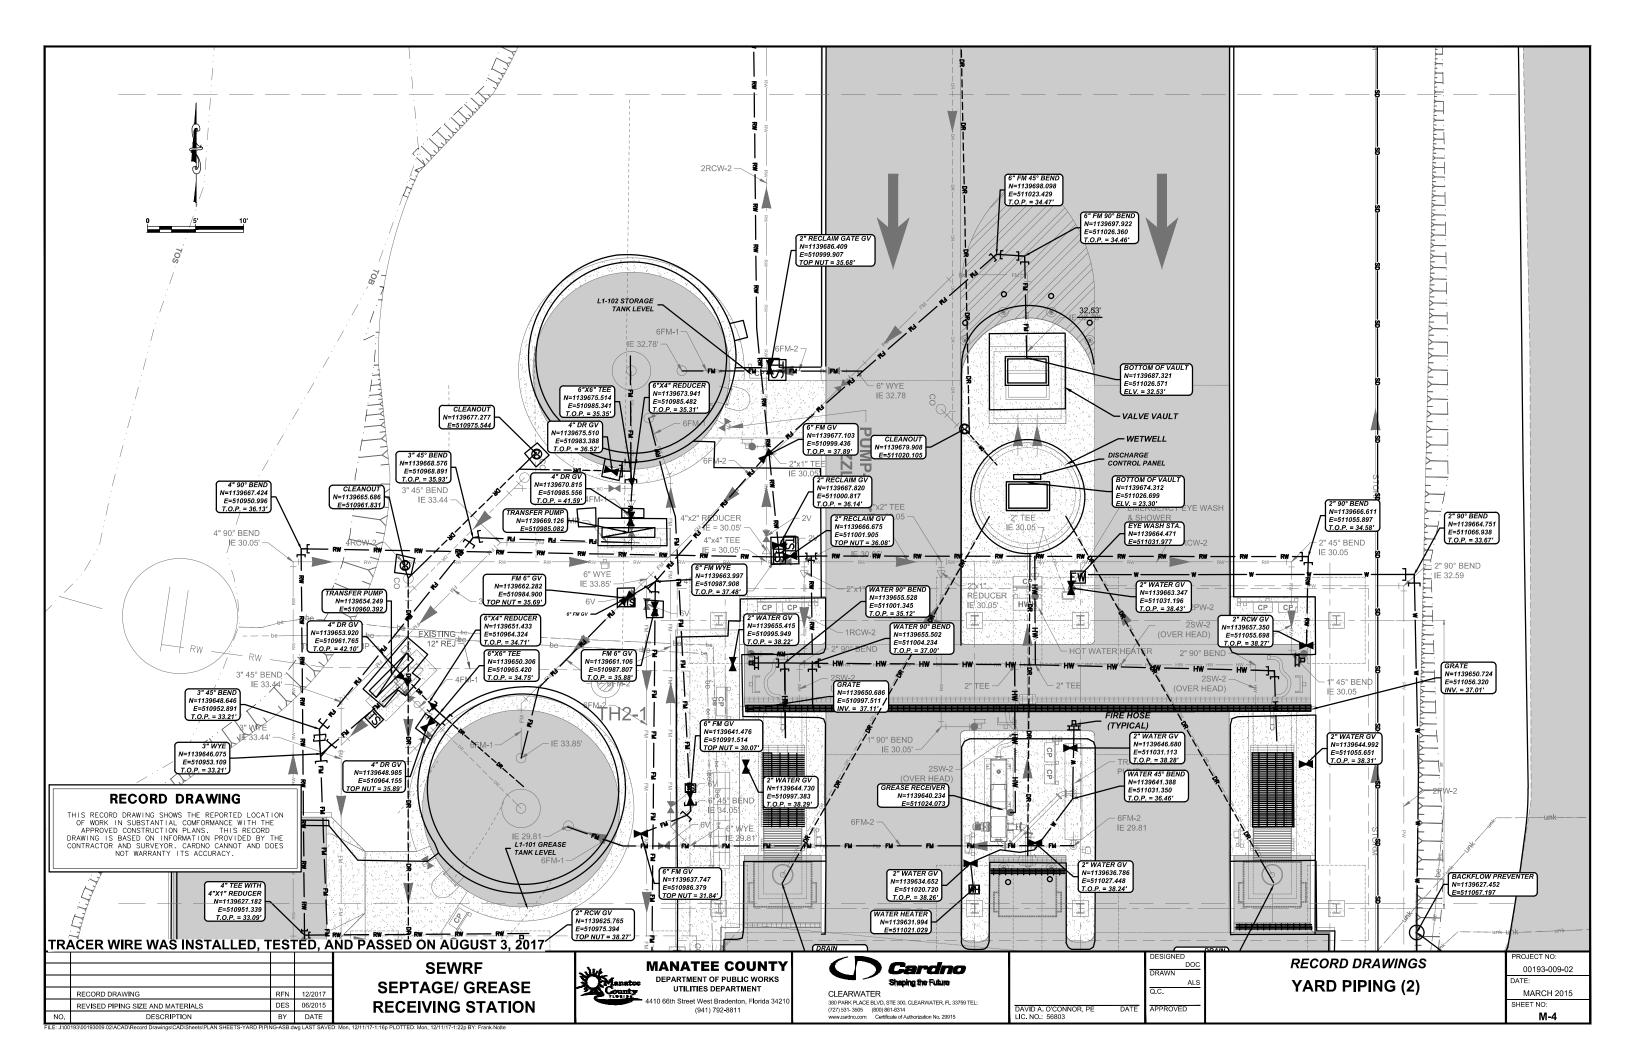
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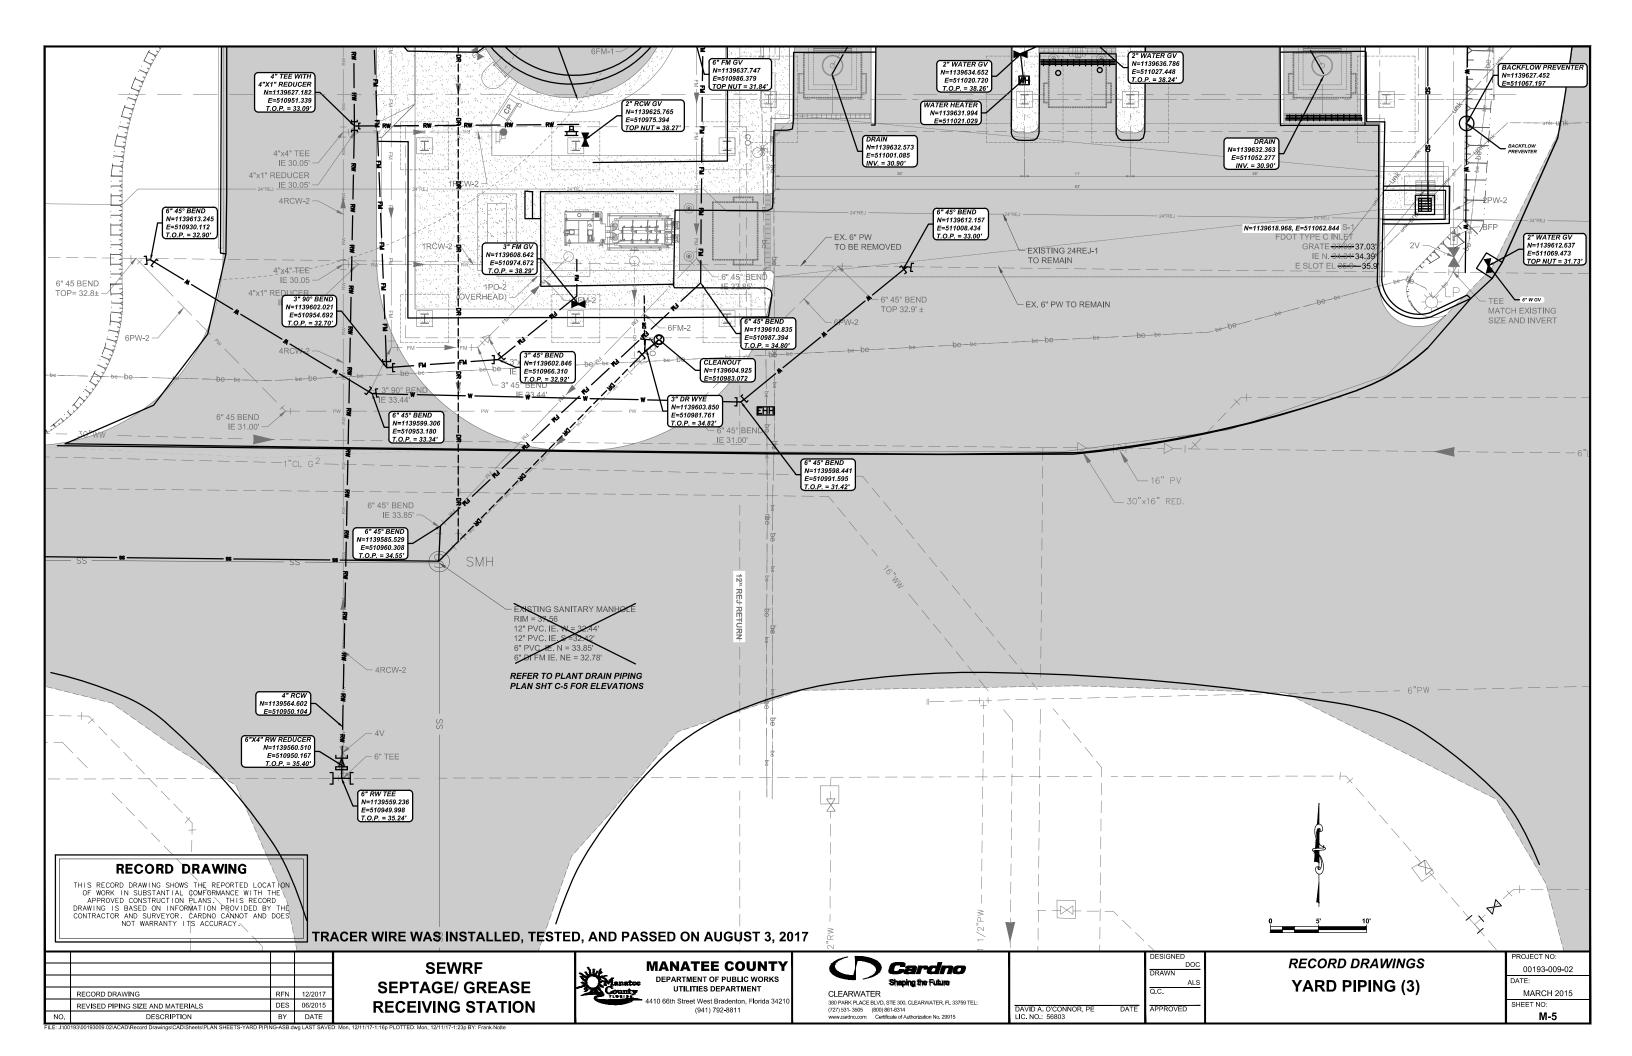
MARCH 2015 SHEET NO: C-12











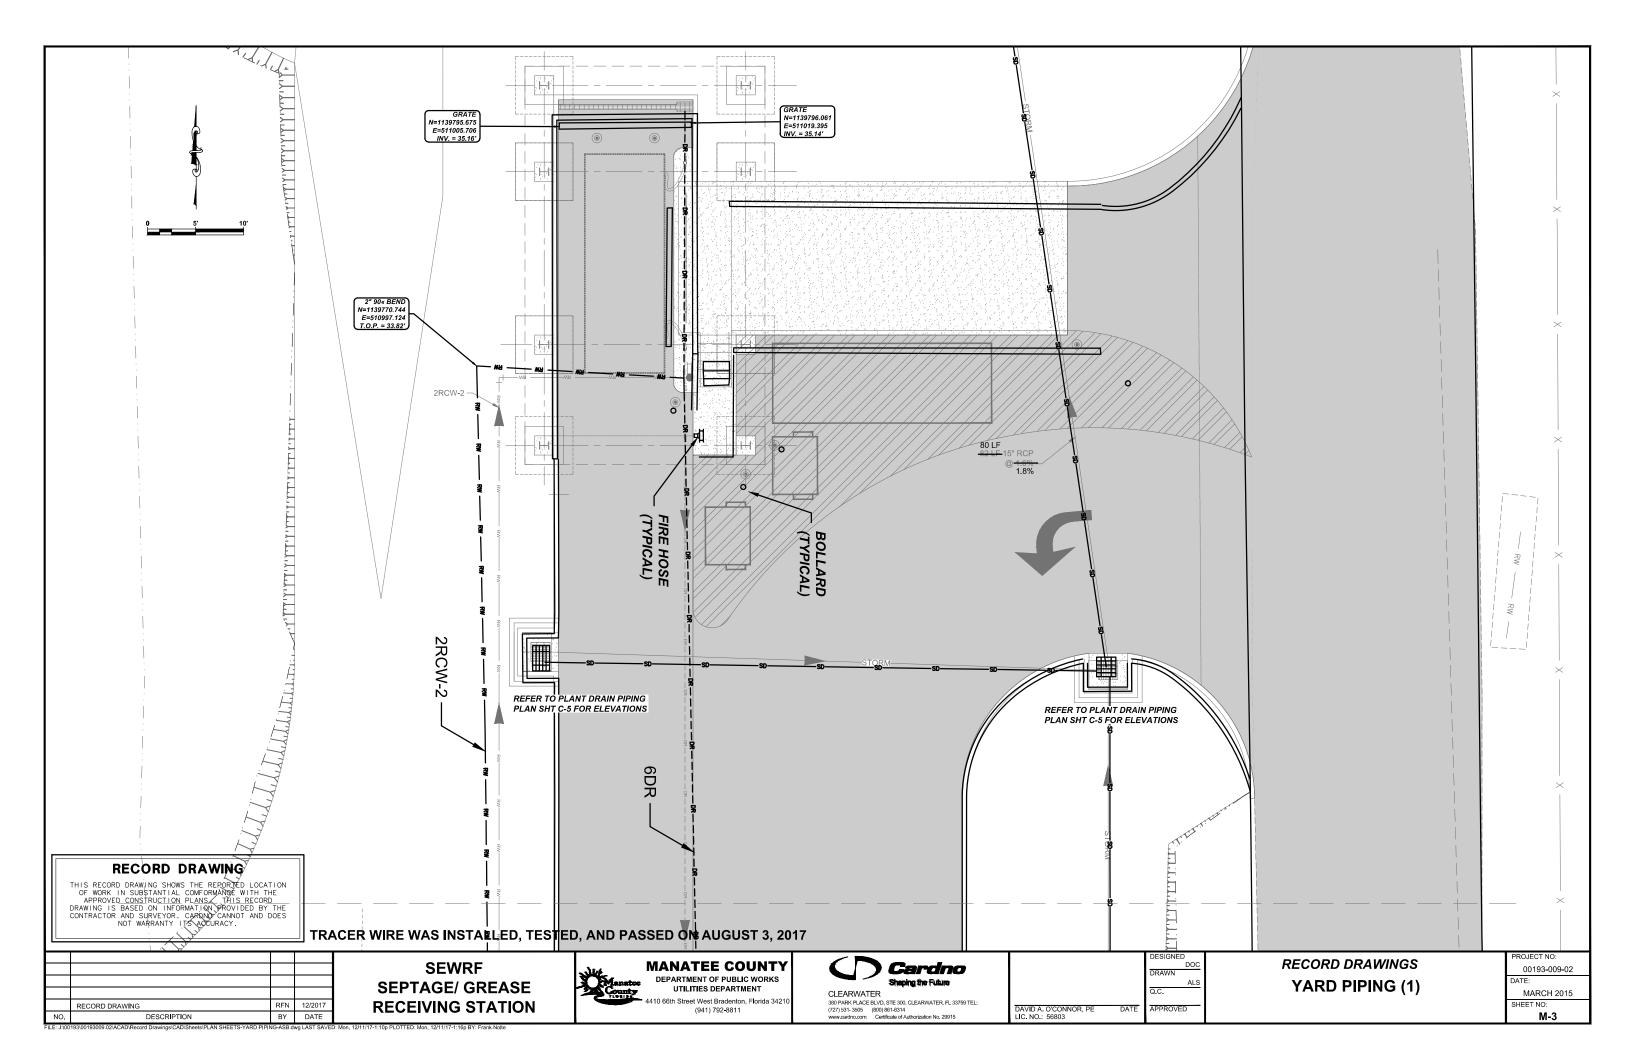

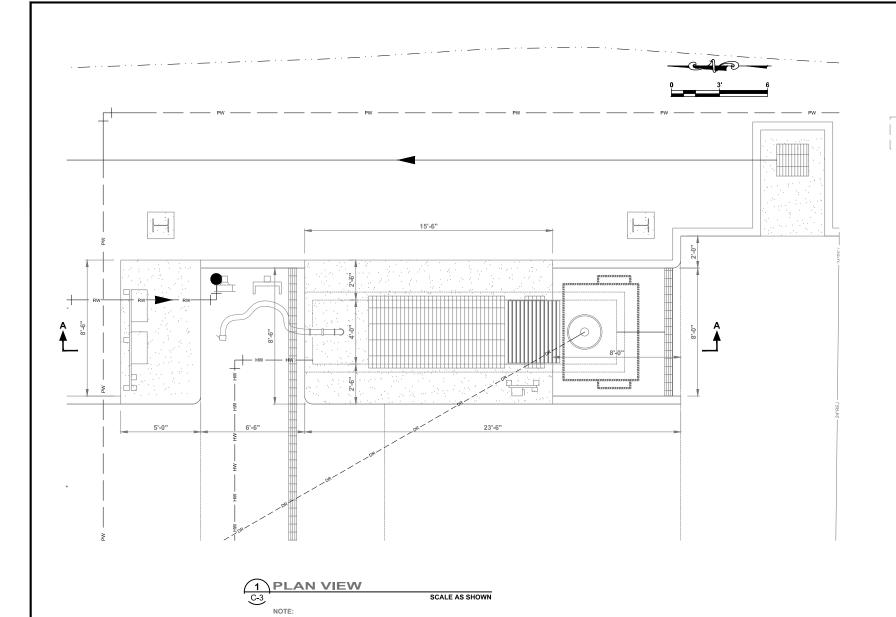

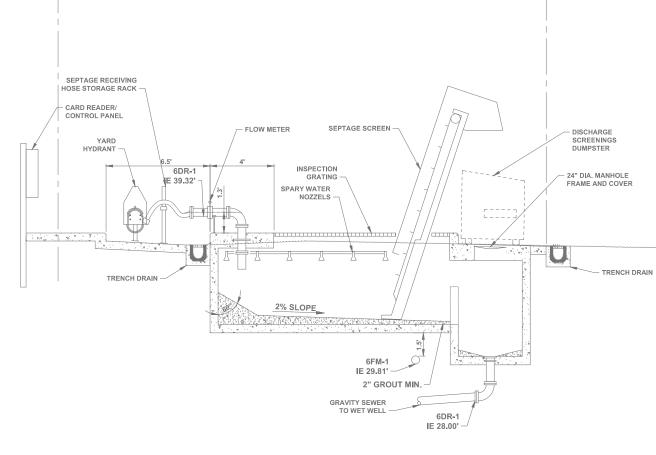

SECTION A-A

NOTE:
1. WESTERLY SEPTAGE RECEIVING STATION SIMILAR.

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	RECORD DRAWING	RFN	12/2017
NO.	DESCRIPTION	BY	DATE

SEWRF SEPTAGE/ GREASE RECEIVING STATION

1. WESTERLY SEPTAGE RECEIVING STATION SIMILAR.





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		Q.C.
DAVID A. O'CONNOR, PE LIC. NO.: 56803	DATE	APPROVED


RECORD DRAWINGS
SEPTAGE RECEIVING STATION
PLAN AND SECTION


PROJECT NO: 00193-009-02 DATE: MARCH 2015

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SECTION C-C

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RECORD DRAWING

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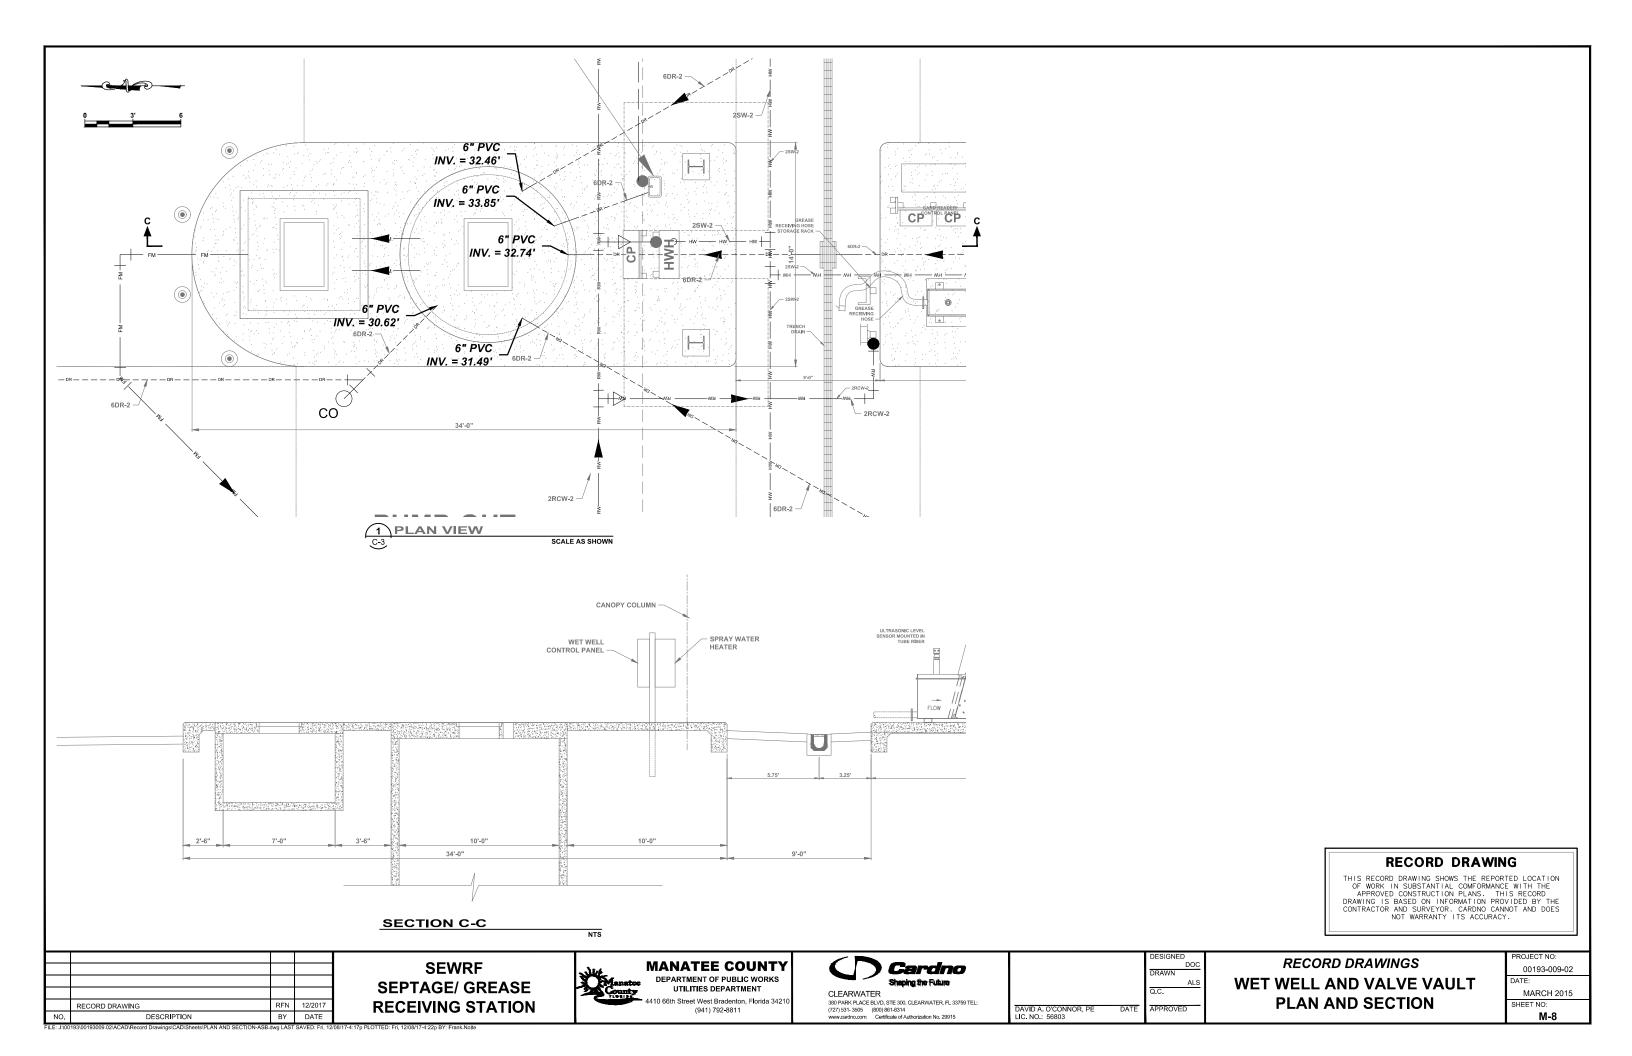
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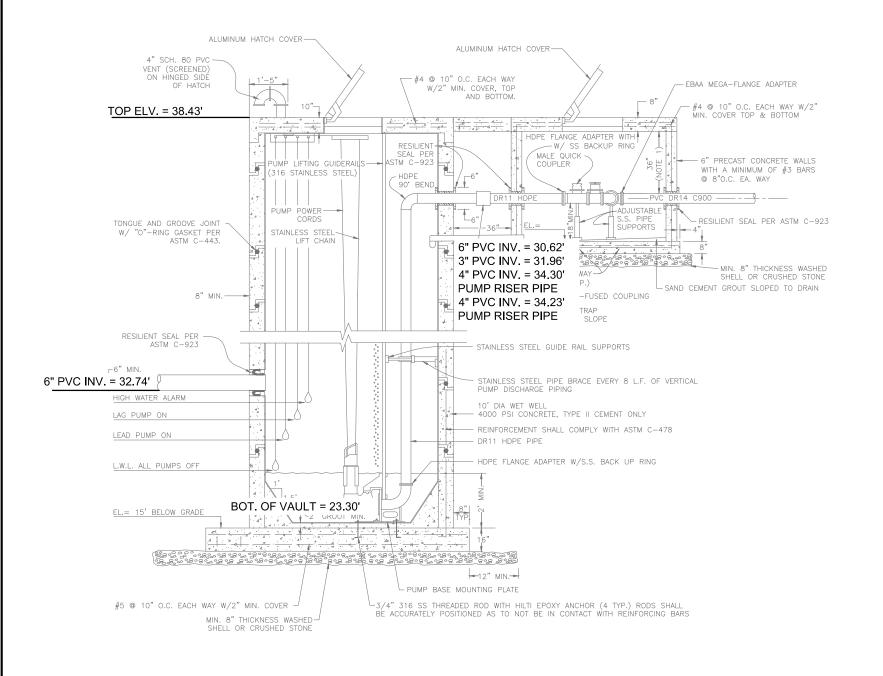
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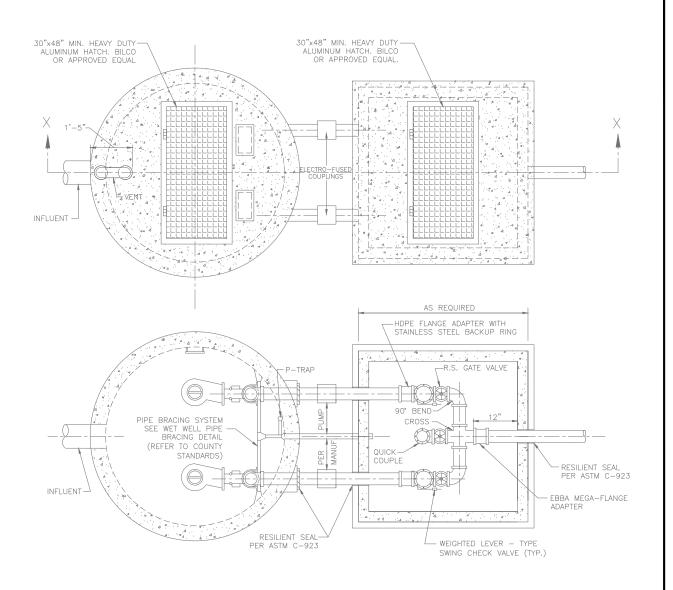
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GREASE RECEIVING STATION
PLAN AND SECTION

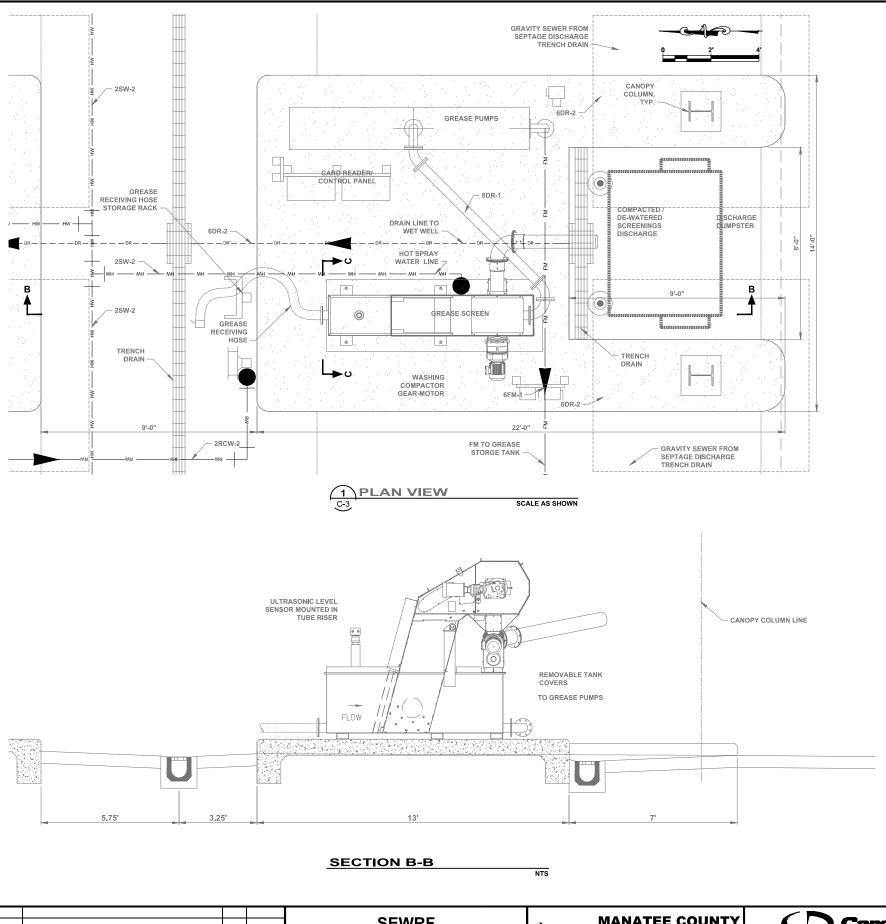PROJECT NO: 00193-009-02 DATE:
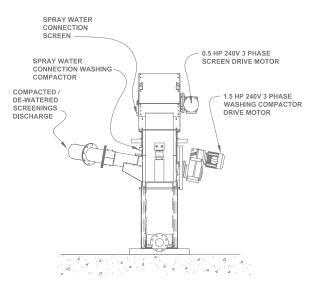
> MARCH 2015 SHEET NO: M-7









NOTE: SEE PLAN SHEETS FOR ORIENTATION.

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TRACER WIRE WAS INSTALLED, TESTED, AND PASSED ON AUGUST 3, 2017

DAVID A. O'CONNOR, LIC. NO.: 56803

	RECORD DRAWING	RFN	12/2017
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SEWRF SEPTAGE/ GREASE RECEIVING STATION



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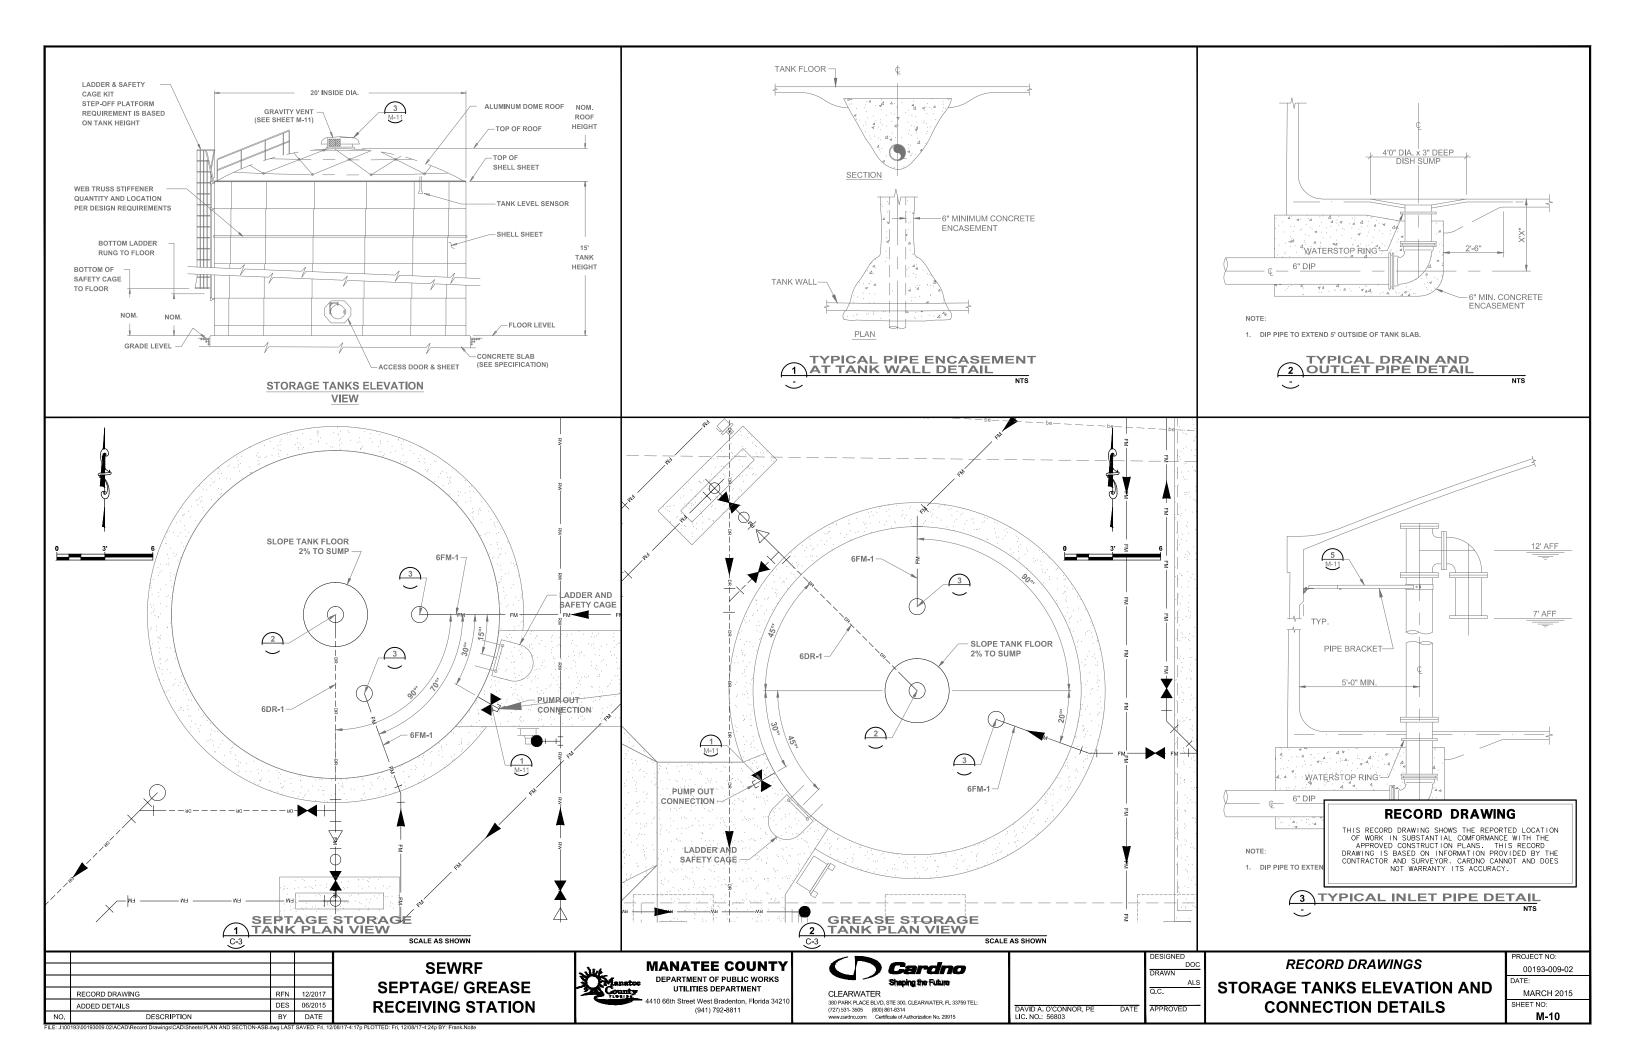
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PUMP STATION DETAILS


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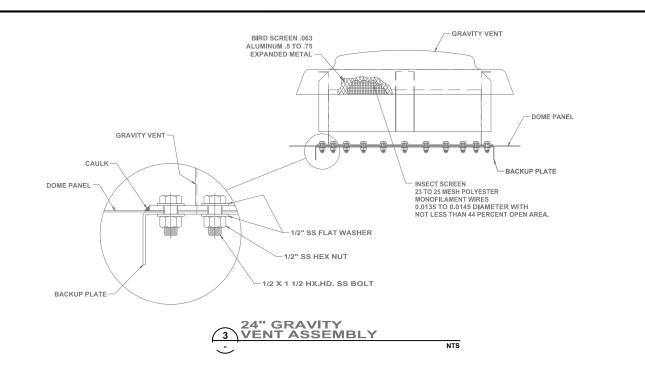
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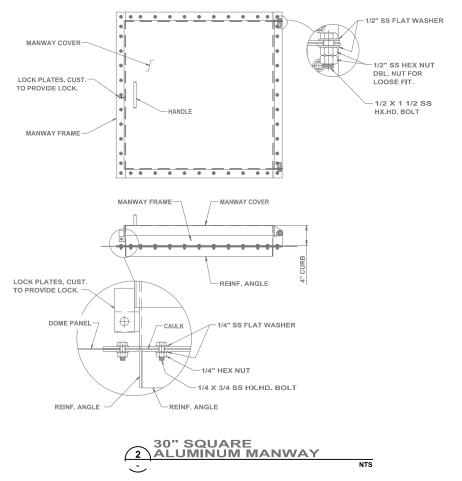
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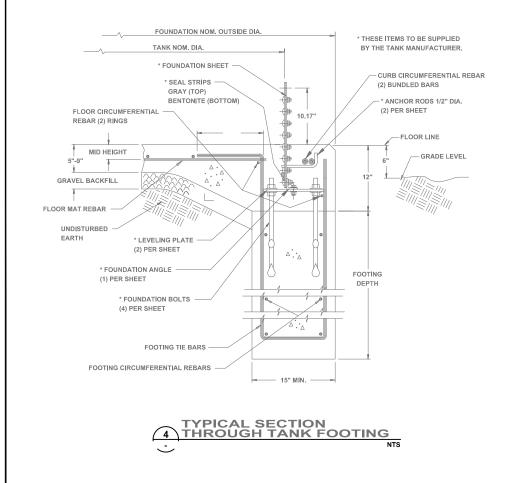
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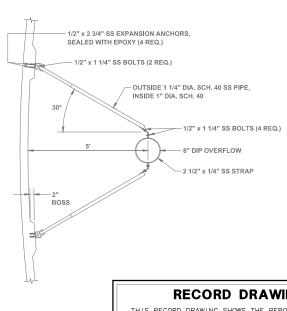










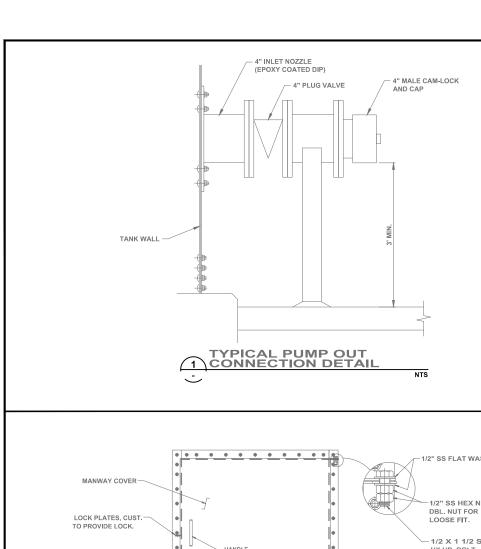

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5 PIPE BRACKET

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SEWRF SEPTAGE/ GREASE RECEIVING STATION



MANATEE COUNTY DEPARTMENT OF PUBLIC WORKS UTILITIES DEPARTMENT 1410 66th Street West Bradenton, Florida 342


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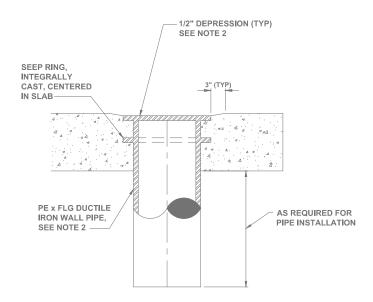
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RECORD DRAWINGS STORAGE TANK DETAILS 00193-009-02 MARCH 2015

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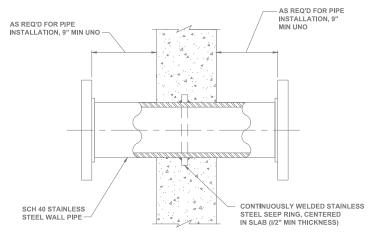




NOTES:
1. COAT FLOOR PIPE WITH SPECIFIED PAINT SYSTEM PRIOR TO CONCRETE PLACEMENT.


2. DRILL AND TAP FLANGE TO RECEIVE THREADED BOLTS.

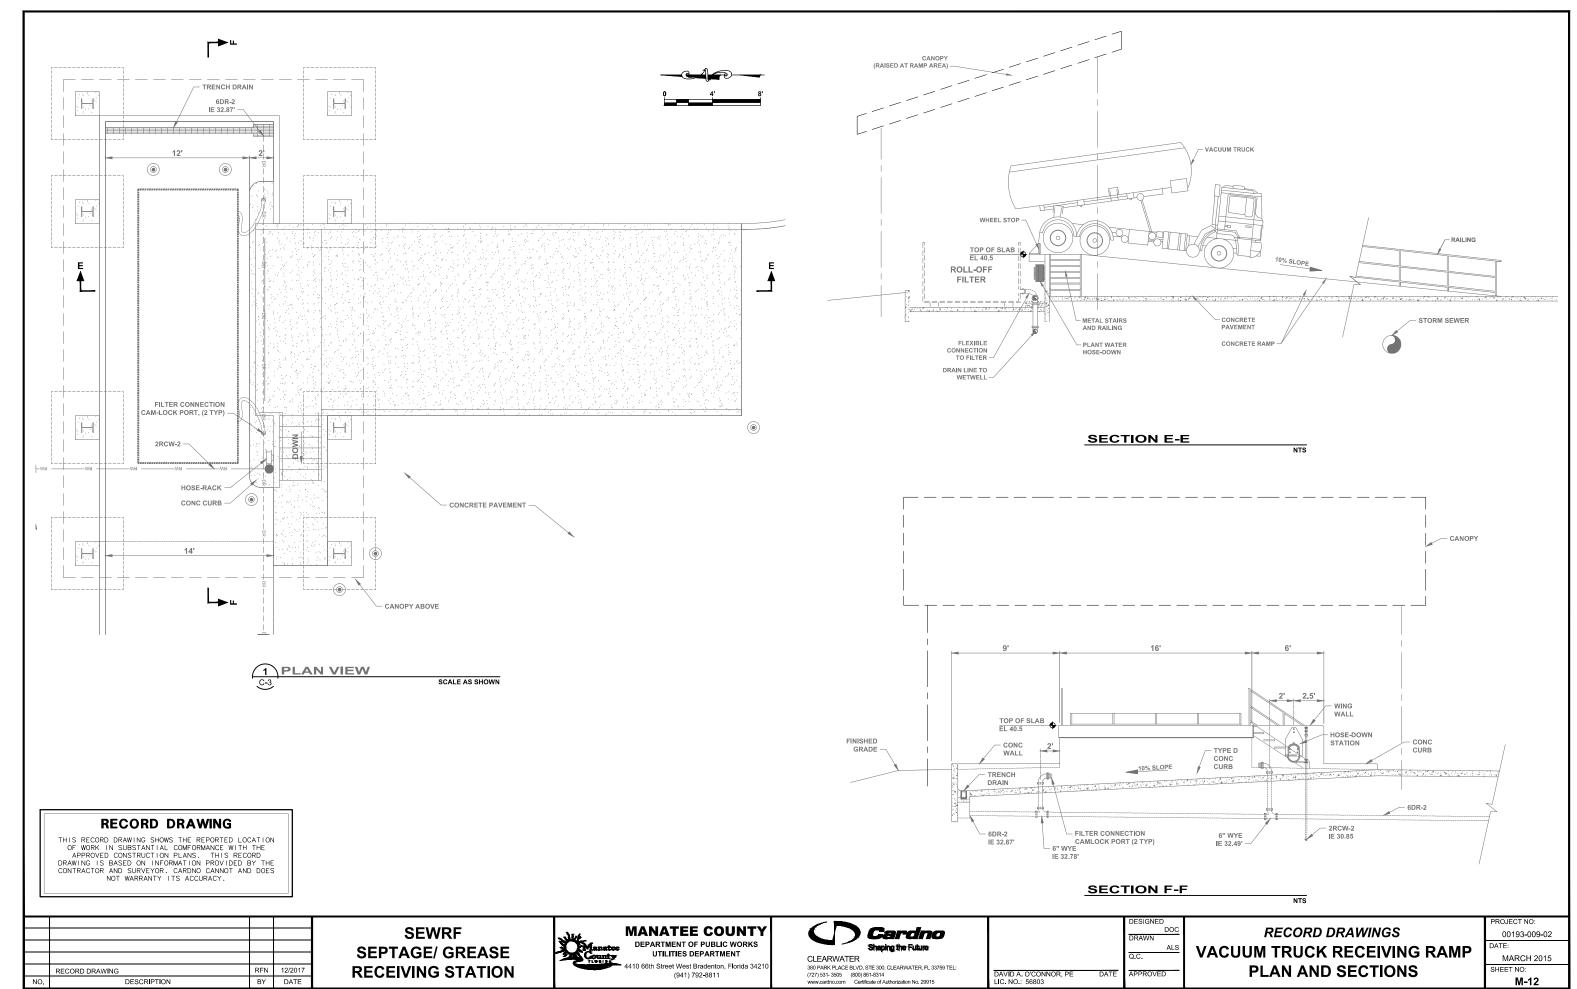




COAT WALL PIPE WITH SPECIFIED PAINT SYSTEM PRIOR TO CONCRETE PLACEMENT.

TYPICAL STAINLESS STEEL WALL PIPE DETAIL

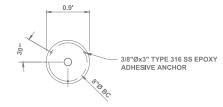

MOUNTING DETAIL

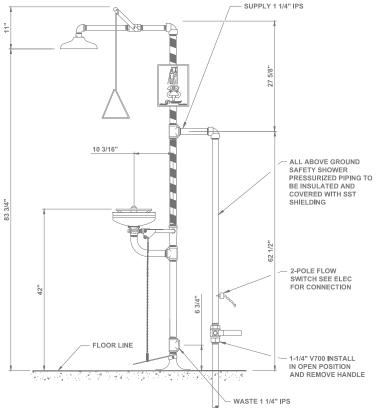

NOTES:
1. DIMENSIONS MAY VARY 1/2"±.

- 2. SS-1 EMERGENCY SHOWER AND EYE WASH STATIONS SHALL BE HAWS MODEL 8336 (OR EQUAL). ALL ASSOCIATED PIPING SHALL BE SCH 80 PVC UNO.
- SS-2 EMERGENCY SHOWER AND EYE WASH STATIONS SHALL BE HAWS MODEL 8300CRP. ALL ASSOCIATED PIPING SHALL BE SCH 40 GS UNO.
- 4. MOUNTING PER MANUFACTURER'S RECOMMENDATIONS.
- 5. PROVIDE 3/4" THICK (NOMINAL) NON-SHRINK NON-METALLIC EPOXY GROUT AS NECESSARY TO PROVIDE LEVEL/ PLUMB INSTALLATION.



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		Q.C.	
DAVID A. O'CONNOR, PE LIC. NO.: 56803	DATE	APPROVE	D

RECORD DRAWINGS MECHANICAL STANDARD DETAILS

00193-009-02

MARCH 2015 SHEET NO:

M-13

GENERAL STRUCTURAL NOTES

DESIGN CRITERIA

CODES:

2010 FLOREDA BUILDVIC CODE

WATER RETAINING STRUCTURES: ACI 250-06 "CODE REQUIREMENTS FOR ENVIRONMENTAL ENGINEERING CONCRETE STRUCTURES"

ALL OTHER STRUCTURES; ACI 318 "BUILDING CODE REQUIREMENTS FOR STRUCTURAL CENCRETE"

STRUCTURAL STEEL: AISC MANUAL OF STEEL CONSTRUCTION 13TH EDITION THE ALUMINUM ASSOCIATION, ALUMINUM DESIGN MARKAL 2005

DESIGN LIVE LOADS:

WALKWAYS, STANKWAYS AND LANDHOS	100 PSF
PLEVATED SLABS	200 PSF
PROCESS SLABS ON GRADE	300 PSF, UNO
- CAHOPY STRUCTURES	20 PSF

- CANOPY ROOF	5 PSF
- FIGOR	AS NOTED

w	ND LOADS	4						
		DESIGN DESIGN EGORY	AMMO	SPEED,	Viet Vien	(3-550000	ch21)	155 MPH 120 MPH III C

- DESIGN PRESSURES PER ASCE 7-10

SEFTAGE/GREASE RECEIVING CANOPY: - ENCLOSURE CLASSIFICATION - INTERNAL PRESSURE COEFFICIENT, G	Epi ±0.
BOLL-DEE CRITES CHICARY	

- ENCLOSURE CLASSIFICATION - INTERNAL PRESSURE COEFFICIENT, GCpl SCREW FRESS CANOPY: - ENCLOSURE CLASSIFICATION - MITERNAL PRESSURE COEFFICIENT, BCpl

- ALLOWABLE BEARDIG PRESSURE FOR SPREAD FOOTINGS OVER SUBSURFACE PREPARED AS PER SPECIFICATIONS: 1500 PSF

DECTECHNICAL REPORT

GEOTECHNICAL REPORT BY ANY INTERPRETATION OF THE CONTINUES OF THE GEOTECHNICAL REPORT IS THE RESPONSIBILITY OF THE CONTINUED OF

FLOTATION CONSIDERATION

STRUCTURES WERE DESIGNED TO BE NON-BLOTART AFTER THEY ARE PLACED INTO DEFENDING. THEREFOR THE STRUCTURES MAY BE BUDDANT DURING CONSTRUCTION, CONTRACTOR SHALL PROTECT ALL STRUCTURES FROM FLOTATION DURING CONSTRUCTION RECENTLESS OF CROWNS WATER LEVELS WITH, STRUCTURES ARE PLACED WITH DEPENDING.

ALL STRUCTURAL DRAWINGS SHALL BE USED IN CONJUNCTION WITH THE MECHANICAL, CIVIL ARCHITECTURAL, ELECTRICAL, HIVAC AND SHOP DRAWINGS AND SHOPPERATIONS.

THE CONTRACTOR SHALL REVIEW AND VERIFY DIMENSIONS SHOWN IN ALL PLANS AND REVIEW ALL FIELD CONGITIONS THAT MAY AFFECT THE RESTALLATION OF THE FACALITY. SHOULD DISCREPANCES APPEAR. THE CONTRACTOR SHALL MOTEY THE DISCREER IN WITING TO GITAN ENGINEER'S CLARIFICATION BEFORE COMMERCING WITH THE WORK.

FOR ALL ITEMS CLIPEDOED IN OR FASSED THOUGH CONCRETE, THE CONTRACTOR SHALL HITMLILY REFER TO MECHANICAL, HEATING, AND VINITATION DRAWINGS FOR TYPE, SIZE, LOCATION, AND SPECIAL INSTALLATION REDURREMENTS FOR THESE TIEMS.

THE CONTRACTOR SHALL TAKE ANY AND ALL NECESSARY MEASURES TO PROJECT EXISTING STRUCTURES FROM DAMAGE WHEN WORKING IN AND AROUND CUSTING STRUCTURES PERFORMING WORK SUCH AS DEMOLITION, FOUNDATION EXCAVATION, AND OTHERS.

SIZE AND LOCATION OF COUPUENT PAOS AND ANCHOR BOLTS SHALL BE PER EQUIPMENT MANUFACTURERS REQUIREMENTS.

MAY EQUIPMENT THAT MAY INDUCE VIBRATION TO THE STRUCTURE SHALL BE ADEQUATELY ISOLATED FROM THE STRUCTURES.

ALL DETAILS AND SECTIONS SHOWN ON THE DRAWNOS ARE BITEMOLD TO BE TYPEAL AND SHALL BE CONSTRUCE TO APPLY TO ANY SMALAR STUATION ELSCHIESE ON THE PROJECT, EXCEPT WHERE A DETERENT DITAL IS SHOWN.

STANDARD DETAILS APPLY TO ALL SINGAR SITUATIONS ON THE PROJECT EXCEPT WHERE A DIFFERENT DETAIL IS SHOWN.

REINFORCING STEEL

REDIFORCEMENT SHALL CONFORM TO ASTM ASIS, CRADE GO REQUIREMENTS.
WILDOO WATE FADRIC, ASTM A185, ALL ACCESSIONES SHALL DE PI
CONFORMANCE WITH ACI JUST REQUIREMENTS. REDIFFORMS STEEL SHALL
HAVE THE FOLLOWING CLEAR COVER LIKESS OTHERWISE NOTED:

-	CONCRETE	CAST	AGARYST	EARTH	

- FORMED SURFACES IN CONTACT WITH SOR, SEWAGE, WATER OR EXPOSED TO WEATHER

-	SLARS, WALLS, AND JOIST	3/4"
7	BEAUS AND COLUMNS	11/2"

LAP SPUCES SHALL HE AS SHOWN UN THE DRAWNOS, FUR LAP SPUCES NOT SHOWN ON THE DRAWNOS, THE CONTRACTOR SHALL OBTAIN ENGINEERS APPROVAL

THE CONTRACTOR SHALL PREPARE PLACING DRAWINGS AND SCHEDULES IN CONFORMANCE WITH ACI 315 REQUIREMENTS.

UNLESS CITERWISE NOTED. THE MINIMUM REINFORCING FOR ALL CONNETE WALL AND SLABS SHALL BE AS FOLLOWS:

MINISTAN REMFORCING							
THICKNESS	6"	8"	10"	12"-16"	18"-22"	24"	
REINF, EACH WAY	#4AT12°	#5AT12"	#4AT12"	#SAT12"	#BAT12"	#7AT12	
LOCATION	COMER	CENTER	LF.	- EF	D.	EF	

PRE-ENGINEERED METAL BUILDING

FURNISH ALL LABOR, MATERIALS, EQUIPMENT AND INCOCURALS REQUIRED TO CESSON, PARRICATE, DELATA TO JOB SITE AND EXECT THE PRE-ENCINEERED METAL BUILDING AS SHOWN ON THE DRAWINGS.

SUBMIT TO THE ENGINEER COMPLETE PLANS SHOWING SUPERSTRUCTURE COLUMN LINES SET TO COORDANIE WITH CONCRETE DIMENSIONS SHOWN. INDICATE ANCHOR BOLT SIZE AND LOCATIONS AND FOUNDATION REACTIONS IN KIPS AT ALL COLUMNS.

SUBMIT LETTER AND CALCULATIONS SIGNED AND SEALED BY A PROFESSIONAL ENGINEER REGISTERED IN THE STATE OF FLORIDA CENTERING THAT THE STRUCTURAL FRAMEN AND COVERNOR PANELS PROPOSED MEET THE DESEN CRITERIA.

PRIOR TO FOUNDATION CONSTRUCTION, PRE-ENGINEERED METAL BUILDING SUBMITTAL MUST LE APPROVED. CONSTRUCTION DETALS MAY BE VARIED TO SUITE MANUFACTURER'S STANDARD DESIGN.

ROOF DEAD LOAD: SUPERIMPOSED DEAD LOAD: ROOF LIVE LOAD: SELF WEIGHT 8 PSF 20 PSF

ALL BUILDING COLUMNS SHALL BE DESIGNED AS "PIN" CONNECTED. COLUMN ENDS SHALL NOT TRANSFER MOMENTS TO FOUNDATION.

CCLIAIN AND BASE PLATE SIZE SHALL ALLOW FOR A MURRIUM ANCHOR BOLT DISTANCE OF 8° 10 ANY VERTICAL EDGE OF CONCRETE UNICESS SPECIFICALLY APPROVED BY ENGRIEER, THE MINISTRA ANCHOR ROD DISEDMENT DEPTH IS 1'-0'.

BUTLER MARIFACTURING COMPANY, KANSAS CITY, MISSOURE VARCO PRIDEN BURDINGS, MEMPHIS, TEMPLISSIE; OR COUNT.

FRAMING - PRIMARY AND SECONDARY FRAMING SHALL CONSIST OF SHOP FABRICATED WILDED UP PLATE SECTION COLUMNS AND ROOF BEAMS COMPLETE WITH NECESSARY SPLICE, BASE, CAP, COMPRESSION, AND STIFFDIRE PLATES WITH BOLT COMPRESION HOLES FOR FIELD ASSIDEMLY, PURENTS AND GRITS SHALL BE 8-9-10 MIN, DEEP "2" SECTIONS. EAVE STRUTS SHALL BE 8-91 MIN DEEP "C" SECTIONS. LATERAL BRUCHS SHALL BE DESIGNED OF THE BILLDING MANUFACTURER. ALL BOLTS FOR STRUCTURAL TRAINING CONNECTIONS SHALL BE HIGH STRENGTH BOLTS CONFORMING TO ASTM ASS'S.

WALL SYSTEM — EXTERIOR WALL PANELS SHALL BE BUTLERIB PANELS AS FURDISHED BY BUTLER MANUFACTURING COMPANY OR EDUAL. PANEL MATERIAL SHALL BE ASTM ANER, GRADE C. 26 GAUGT CALVANIZED STEEL GOD COATING CONFIDERING TO ASTM ASSES, SERVISH EXTERIOR AND INTERIOR TIME AS PLCURED FOR ALL DOORS, FLASHINGS, CLOSURES.

ROOF SYSTDA — THE BURDING ROOF PANELS SHALL BE PRECISION ROLL FORMED MR-20 PANELS AS TURNISHED BY BUTLER MANUFACTURING COMPANY OR TOUAL PANEL MATERIAL AS SPECIFIED SHALL BE 20 GAUGE DALWANZED STELL (80,000 PSI YELD) GBO COATING CONFORMING TO ASTIM AZZS. GUTTERS, DOWNSPOUTS AND THEM PRECIS AND TO BE STANDARD PRODUCTS INSTALLED PER THE MANUFACTURER'S INSTRUCTIONS.

fastemers — Fastemers for Wall and Roof System Shall be hot depped Galvaryzed and furnished with an integral galvaryzed steel—backed neoprone washer all odposed fastemers shall be prepainted to match

ANCHER BOLTS — ANCHOR BOLTS SHALL BE F1554 CRADE 38 HOT DEPPED GALV. HEAVY HEY HERDED, ANCHOR BOLTS SHALL BE DESCRIBE BY THE BURLEN'S MANUFACTURED AND TRANSHED BY THE CONTRACTOR.

ALL STRUCTURAL STEEL SHALL BE SHOP PREPARED AND FIELD PAINTED PRIOR TO ERECTION. PRIOR TO PAINTING, ALL STEEL SHALL BE CLEANED OF LOOSE RUST. LOOSE WALL SCALE, CRIT AND OTHER TORDIGH MATERIAL SEE SPECIFICATION. PART COLOR TO BE APPROVED BY THE OWNER.

ALL MATERIALS AND METHODS OF CONSTRUCTION SHALL BE IN ACCORDANCE WITH ACT 318 REQUIREMENTS (LATEST EDITION)

ALL CONCRETE SHALL BE AIR-ENTRAINED WITH 4000 PSI COMPRESSIVE STRENGTH AT 28 DAYS UNLESS OTHERWISE HOTED.

WATER REDUCING AGENT SHALL BE IN ACCORDANCE WITH ASTN C494

ALL CONCRETE SURFACES DEPOSED TO ARE UNLESS OTHERWISE NOTED IN SPECIFICATIONS, SHALL BE TREATED WITH AN APPROPRIATE CURBOL COMPOUND AS SOON AS CEMENT FINISHMAD IS COMPLETED OR FORMS ARE REMOVED.

ALL DEPOSED CORNERS SHALL HAVE A MANMUM CHAMFER OF \S^* UNLESS OTHERWISE NOTED.

THE CONTRACTOR SHALL DISTAIN ENGINEER'S APPROVAL FOR THE LOCATIONS OF CONSTRUCTION JOINTS THAT ARE NOT SHOWN ON THE DIRAWINGS.

REDLINE DRAWINGS

PREPARED BY: **VOGEL BROS. BUILDING CO.** OCTOBER 2017

ABBREVIATIONS

STRUCTURAL ABBREVIATIONS APPLY TO "5" SHEETS ONLY

AL ALU, ALUM ADDI'L BLD BDI CMU CONST JI CONT DIA DIS	ALDERAM ADDITIONAL BUT EINE BOTTOM CONTROL JOINT CONCRETE MASONRY UNIT CONSTRUCTION JOINT CONTRIBUTOR DANAETER BITTO		EL EW CXP FE FT FRP FTG HORIZ HP
	DITTO DRAWING EACH FACE EXPANSION JOINT	**	ID JT LP MANUF

ELEVATIONS
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TIBER REINFORCED PLASTIC
FOOTING
HARMFORTED HORIZONTAL HIGH POINT INSIDE DIMICTER JOHT LOW POINT MANUTACTURER

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T/STRUCTURE TYP UND VERT WIF

SPECIFICATIONS STAINLESS STEEL STANDARD STEEL STEEL
REHETDRICHENT
THE BEAM
TOP AND BOTTOM
TOP OF STRUCTURE
TYPICAL
UNLESS NOTED OTHERWISE
VERTICAL
WELDED WARE FABRIC SYMBOLS SYMBOLS APPLY TO "S" SHEETS DRLY EL 00.00" ELEVATION TAG COLUMN TAG & CENTER LINE

- SECTION NO. OHI LICENS

DETAIL INDICATOR - DWG. No

RECORD DRAWING

THIS RECORD DRAWING SHOWS THE REPORTED LOCATION OF WORK IN SUBSTANTIAL COMFORMANCE WITH THE APPROVED CONSTRUCTION PLANS. THIS RECORD DRAWING IS BASED ON INFORMATION PROVIDED BY THE CONTRACTOR AND SURVEYOR. CARDNO CANNOT AND DOES NOT WARRANTY ITS ACCURACY.

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STATE OF CORDAN CORDANA CORDAN STATE OF GENERAL STAND

RECORD DRAWINGS GENERAL STRUCTURAL NOTES

ROJECT NO 00193-009-02 DATE-MARCH 2015 HEET NO: S-1

2551 W. LAKE MARY BLUE, SUITE 210 LAKE MARY, Ft. 32746 PHONE: 14071 322 0500 ET PROJECT NU. • 12:233 RECORD DRAWING 12/2017


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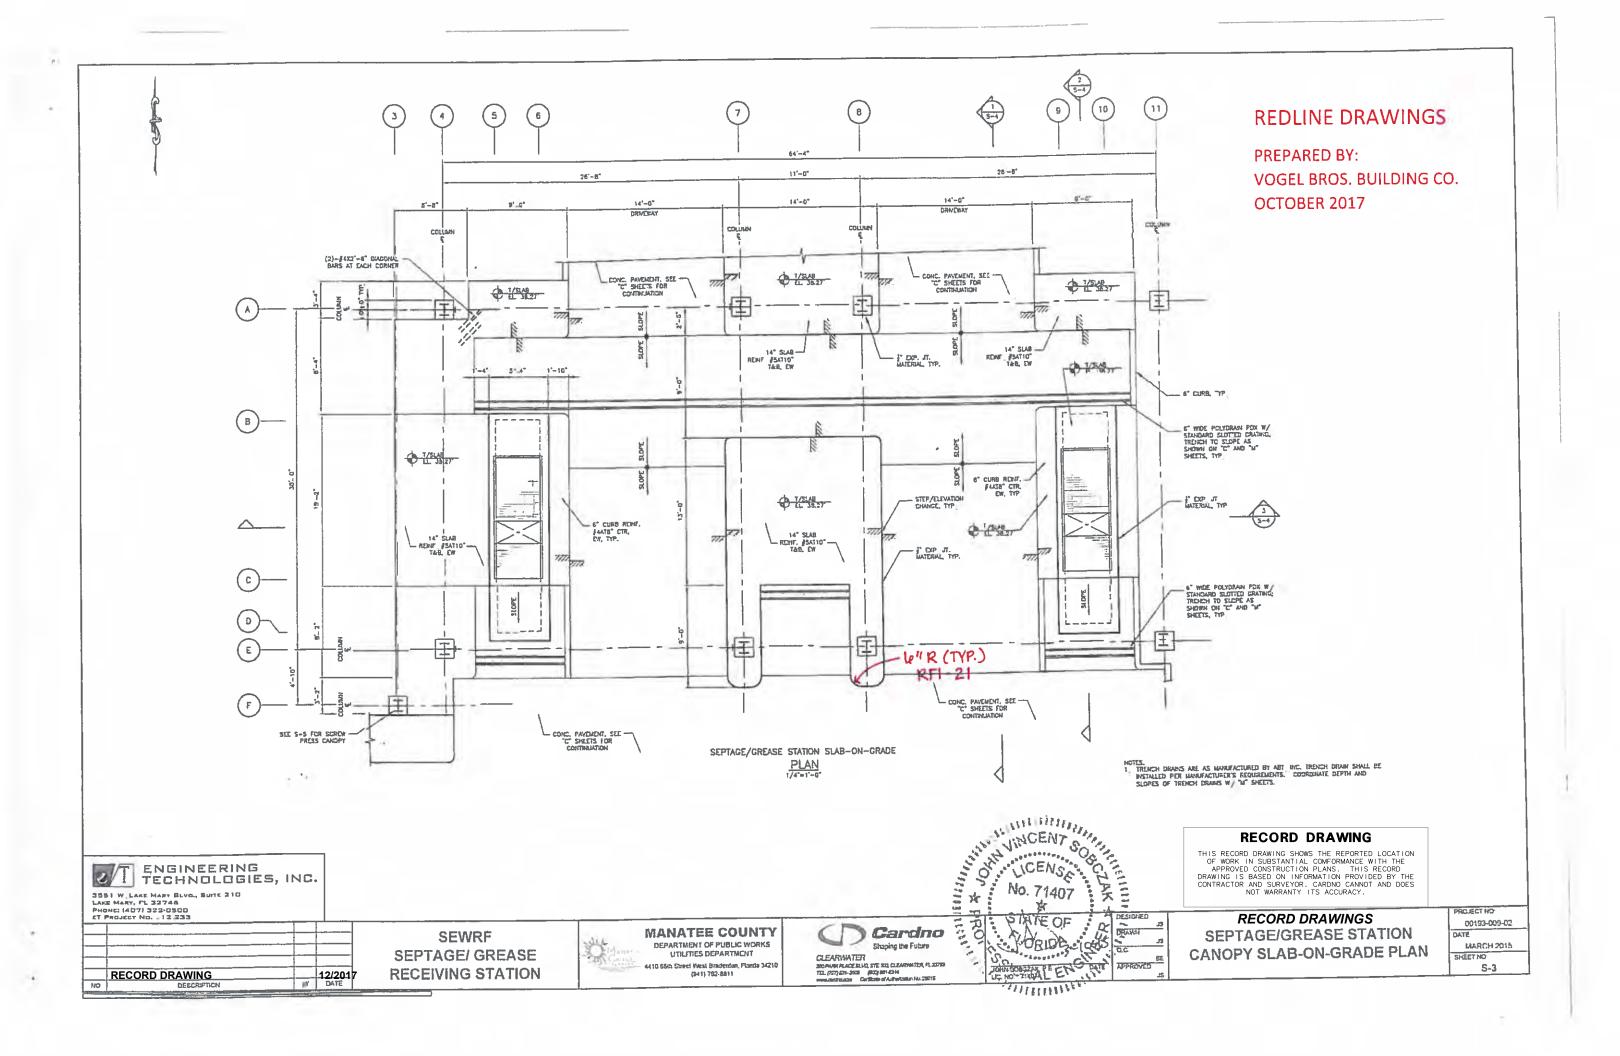
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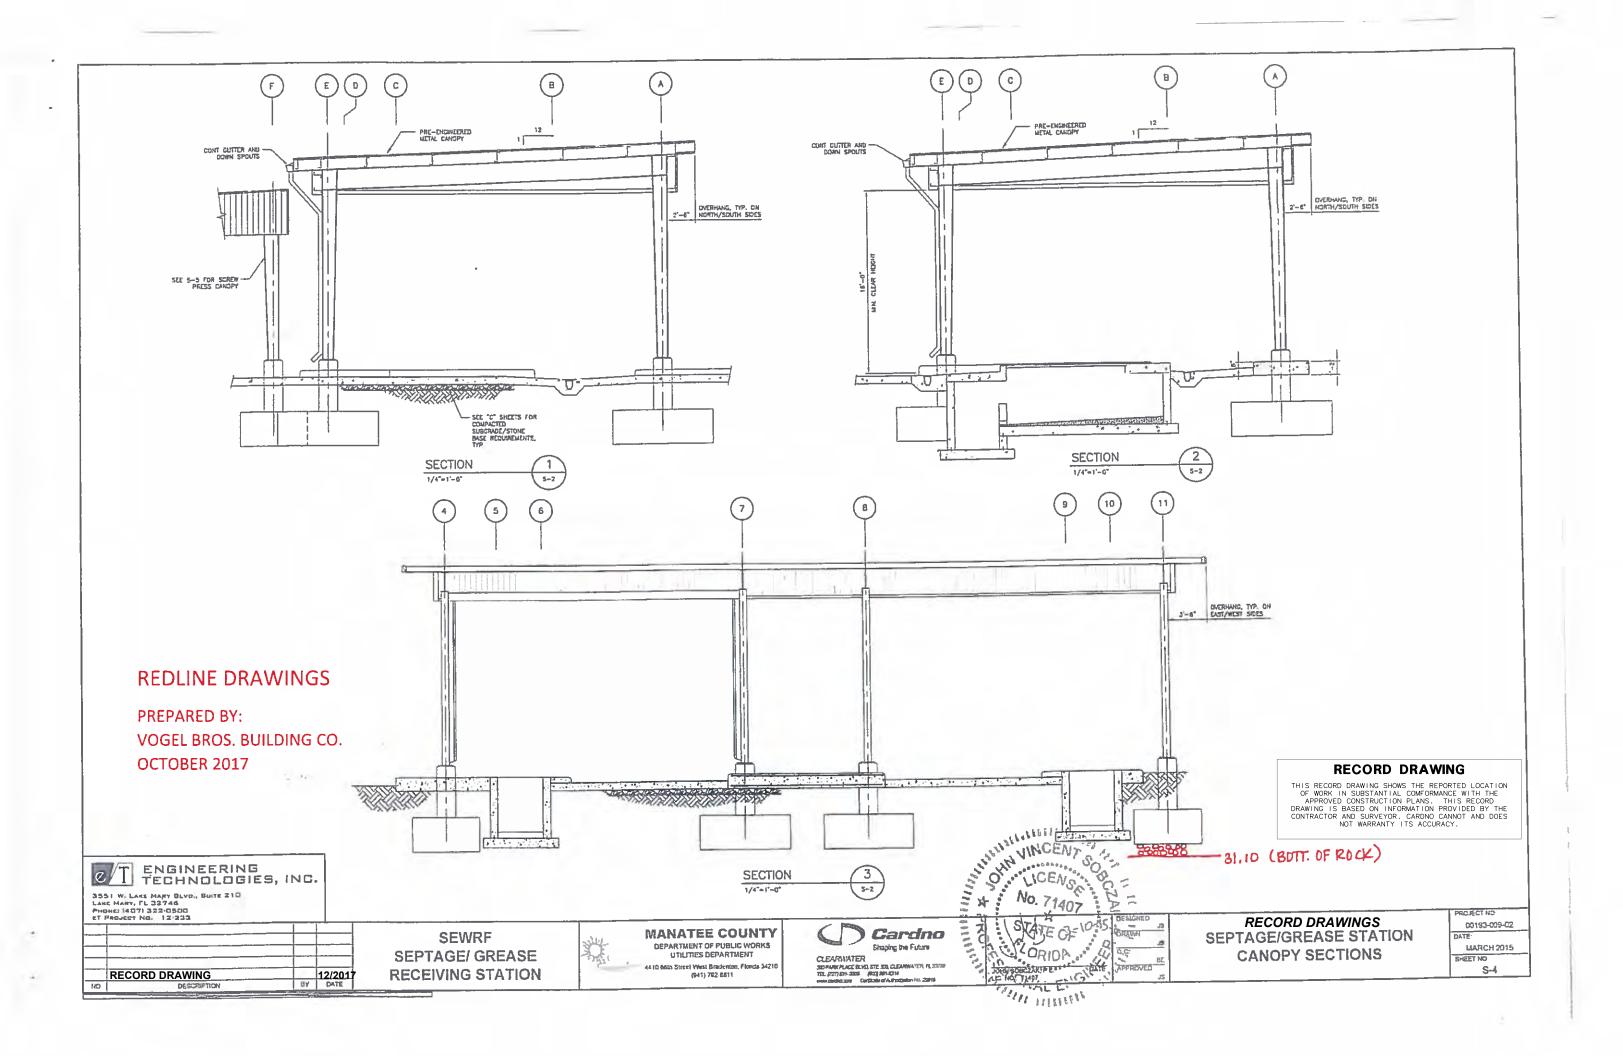



MANATEE COUNTY DEPARTMENT OF PUBLIC WORKS UTILITIES DEPARTMENT


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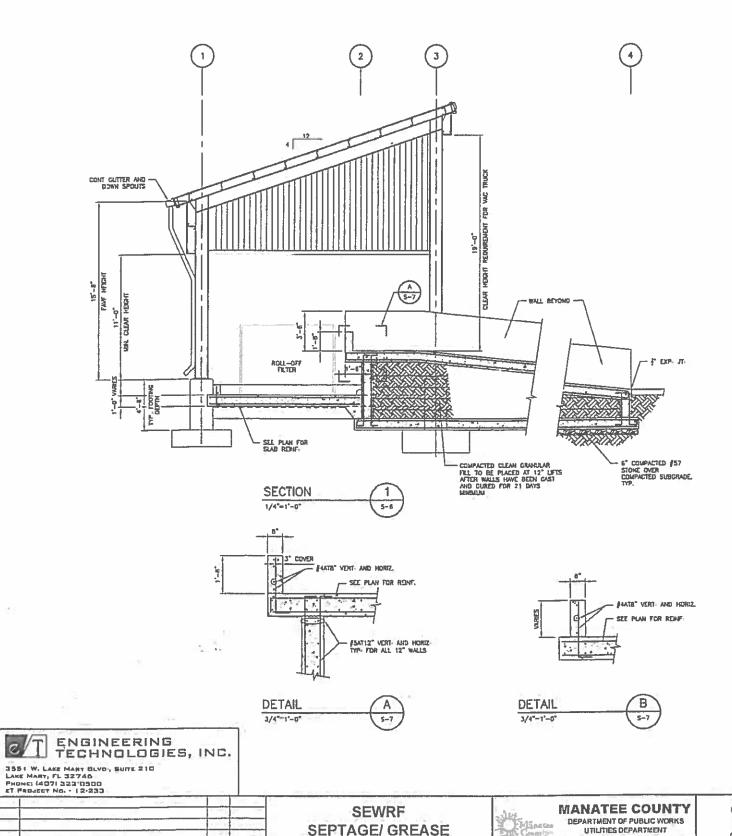






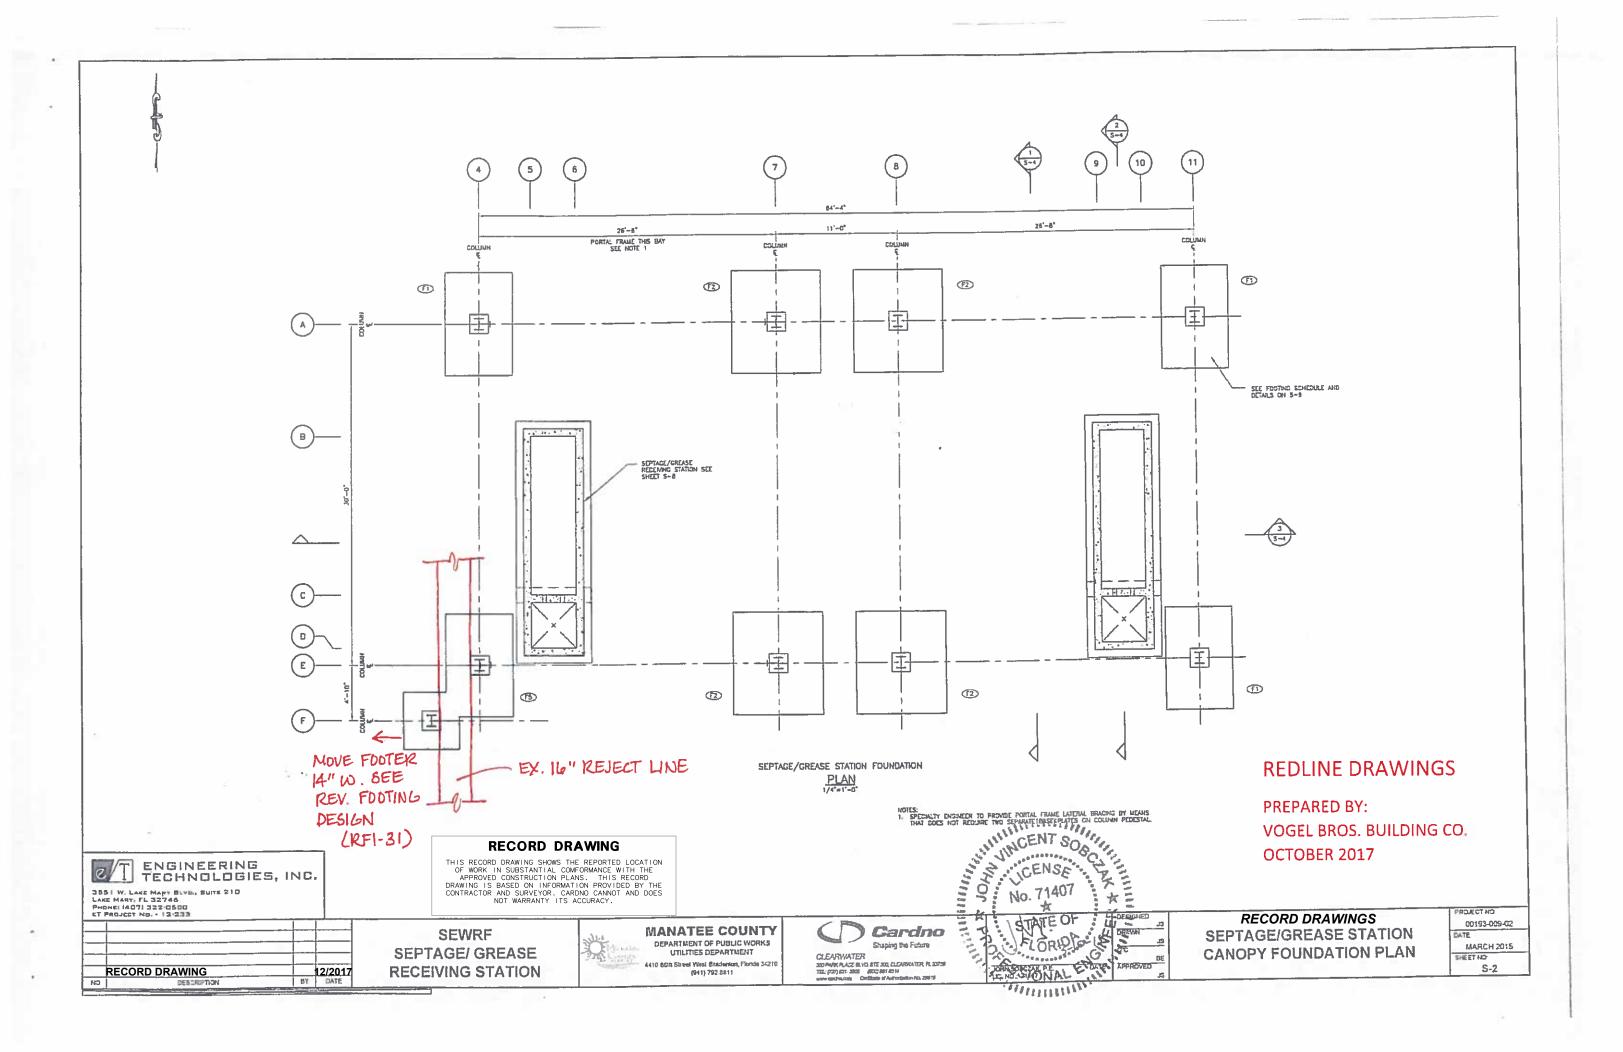

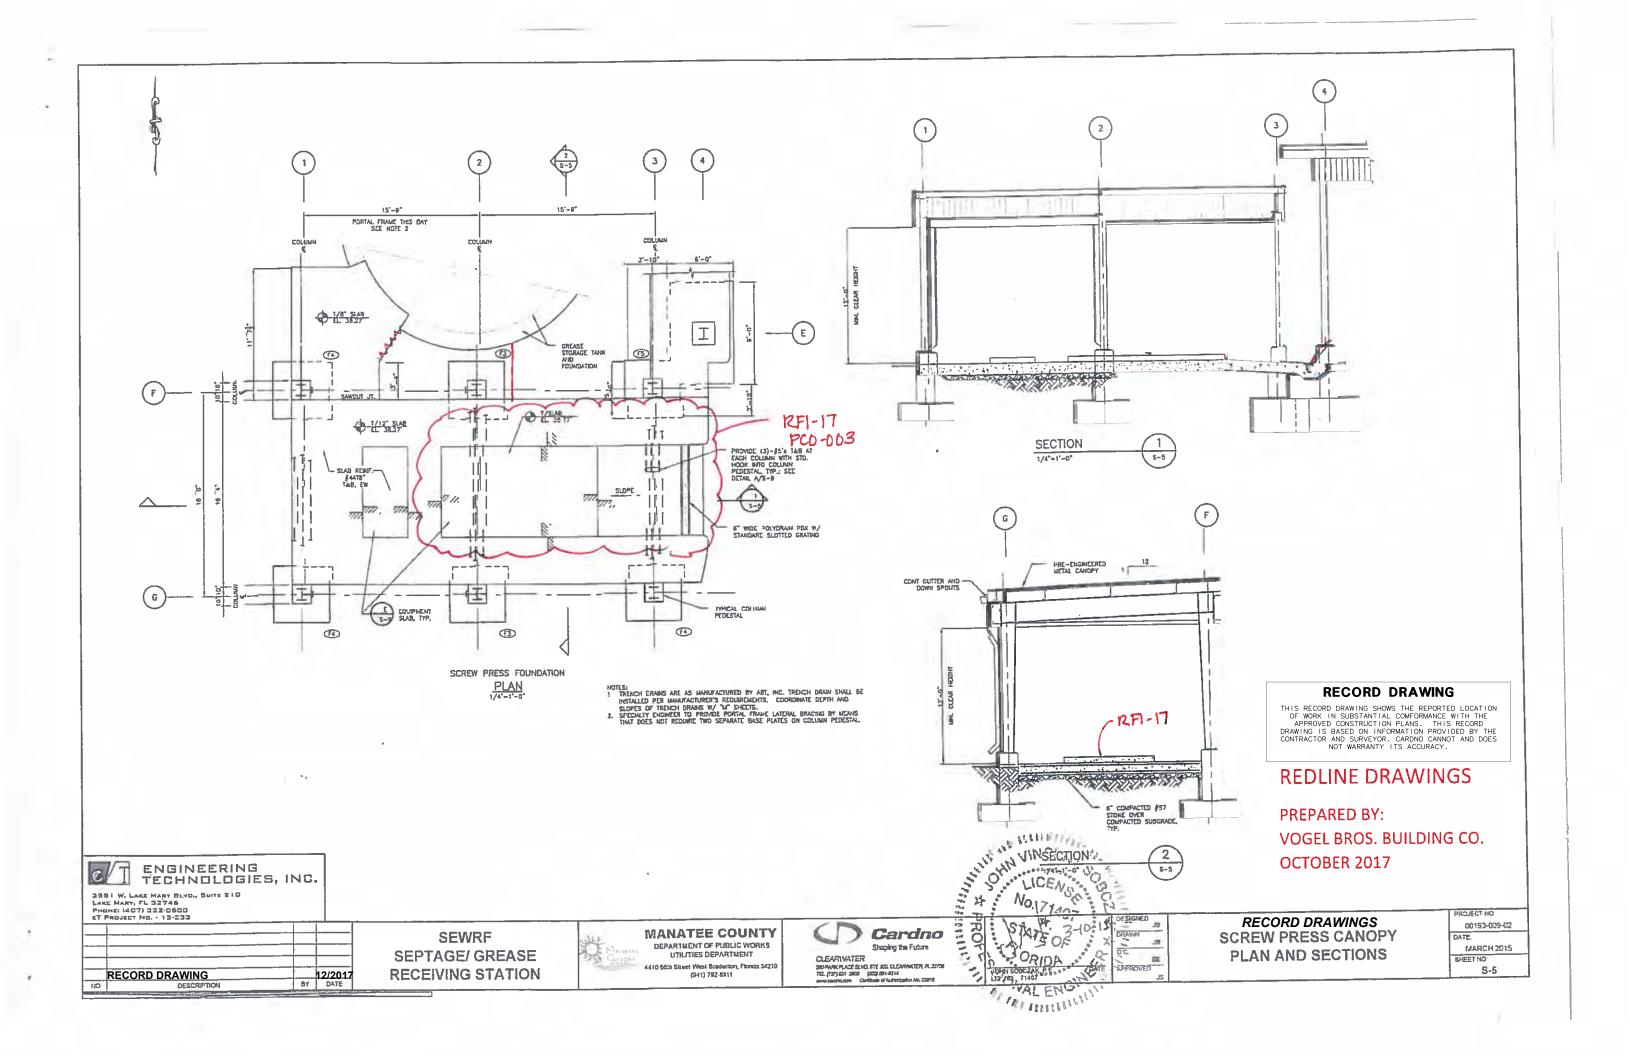


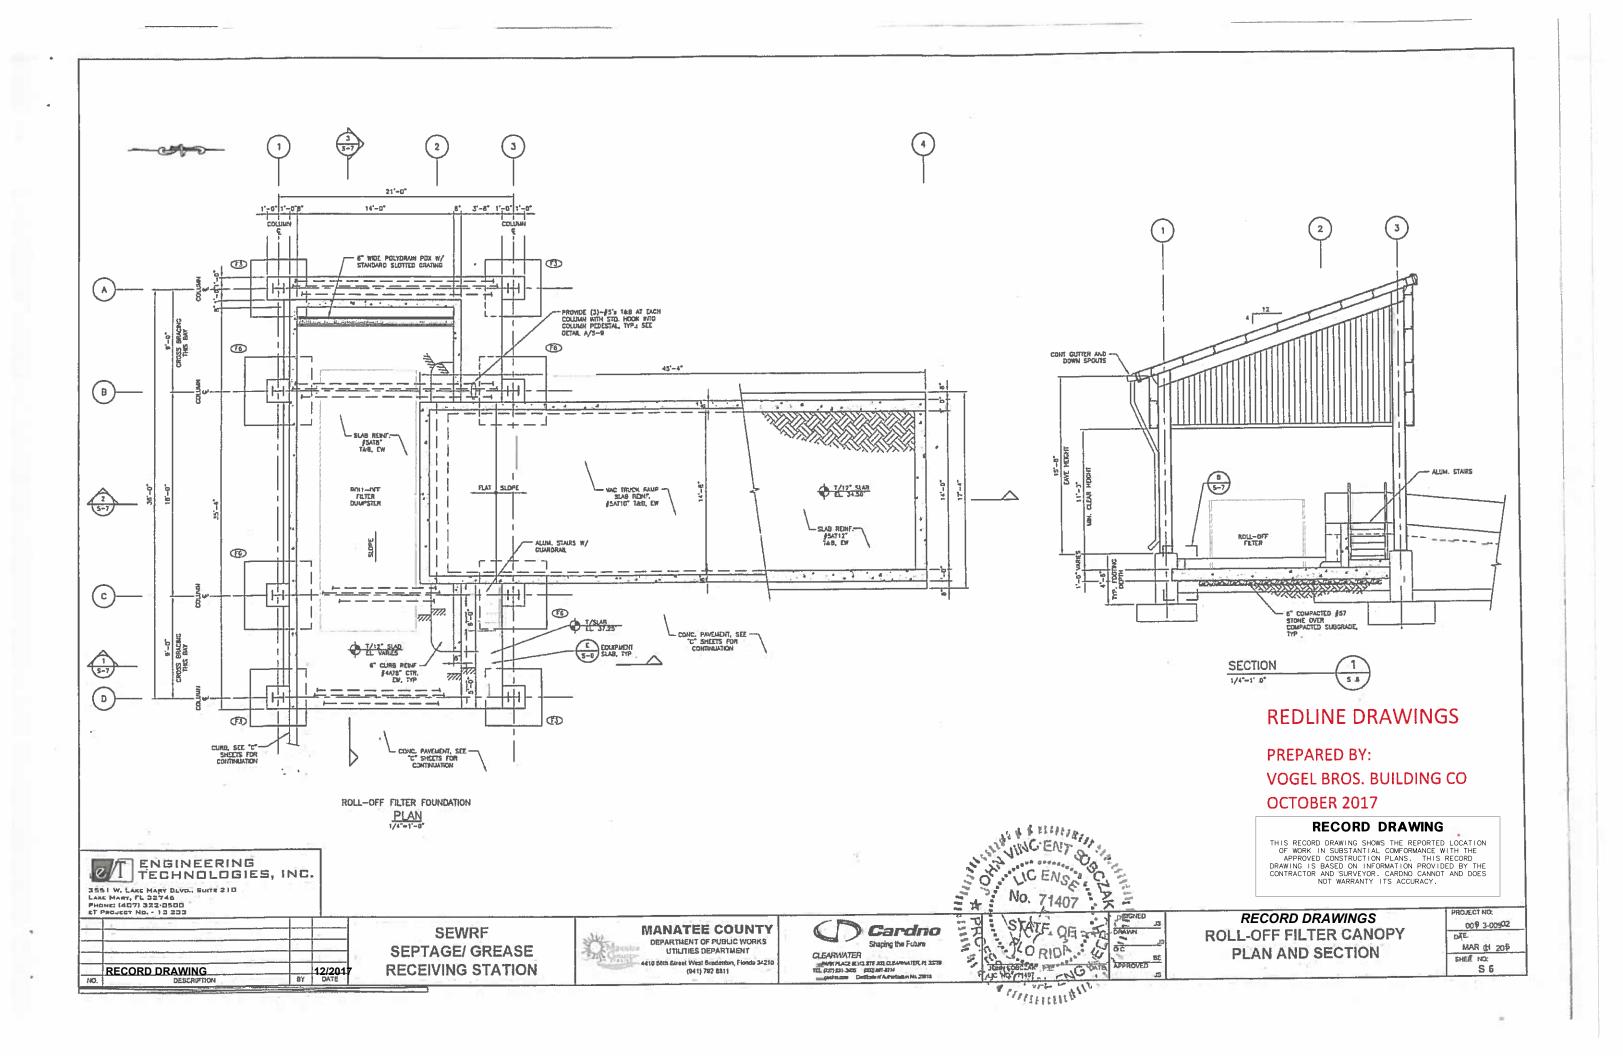

RECEIVING STATION

12/2017 BY DATE

RECORD DRAWING
DESCRIPTION

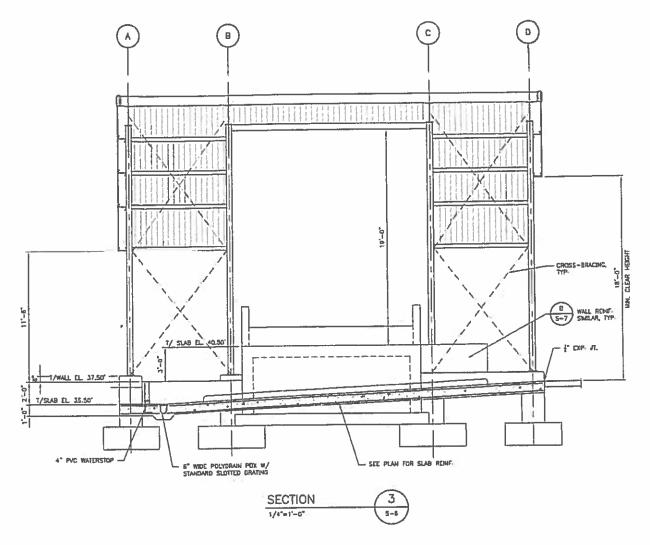

REDLINE DRAWINGS

PREPARED BY: VOGEL BROS. BUILDING CO OCTOBER 2017

RECORD DRAWING

RECORD DRAWINGS ROLL-OFF FILTER CANOPY

SECTIONS AND DETAILS

PROJECT NO 00193-009-02 DATE MARCH 2015 S-7


THIS RECORD DRAWING SHOWS THE REPORTED LOCATION OF WORK IN SUBSTANTIAL COMFORMANCE WITH THE APPROVED CONSTRUCTION PLANS. THIS RECORD DRAWING IS BASED ON INFORMATION PROVIDED BY THE CONTRACTOR AND SURVEYOR. CARDNO CANNOT AND DOES NOT WARRANTY ITS ACCURACY.


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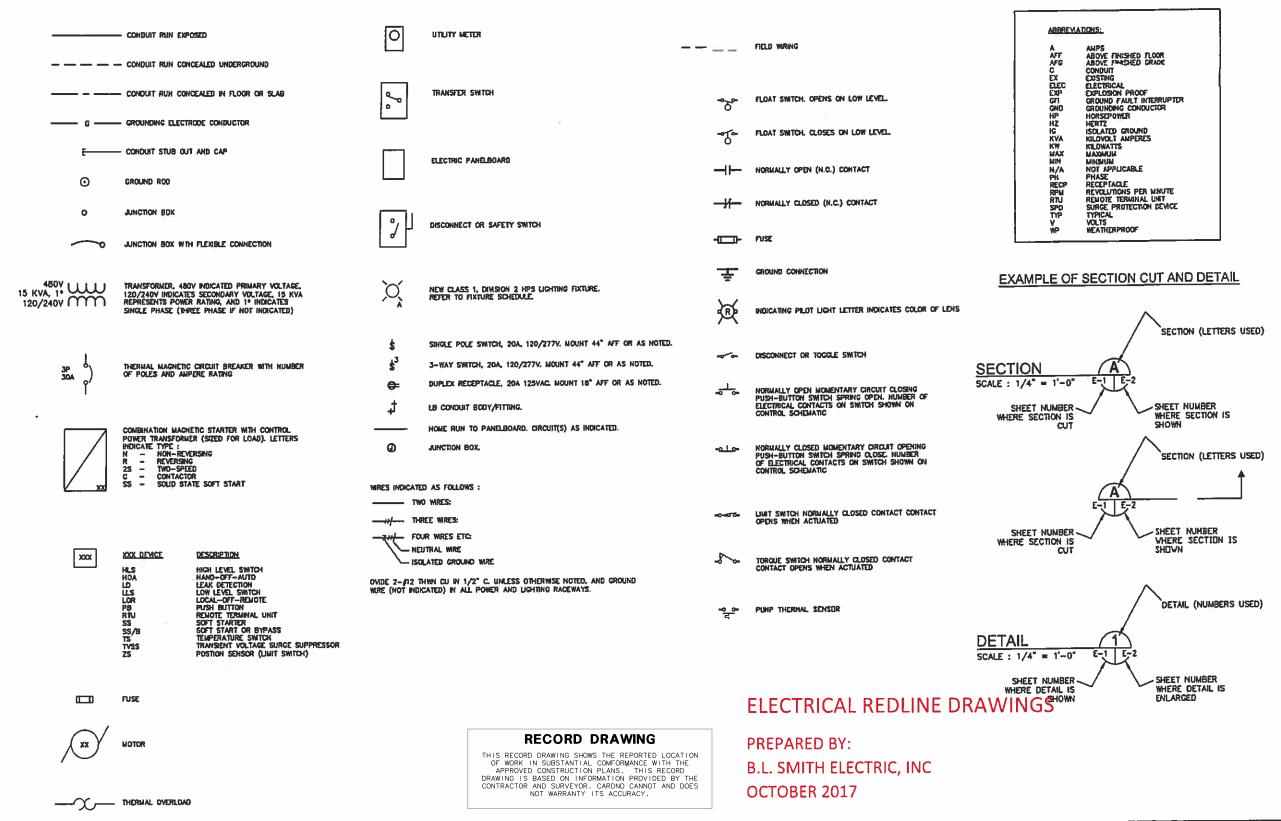
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SEWRF SEPTAGE/ GREASE **RECEIVING STATION**



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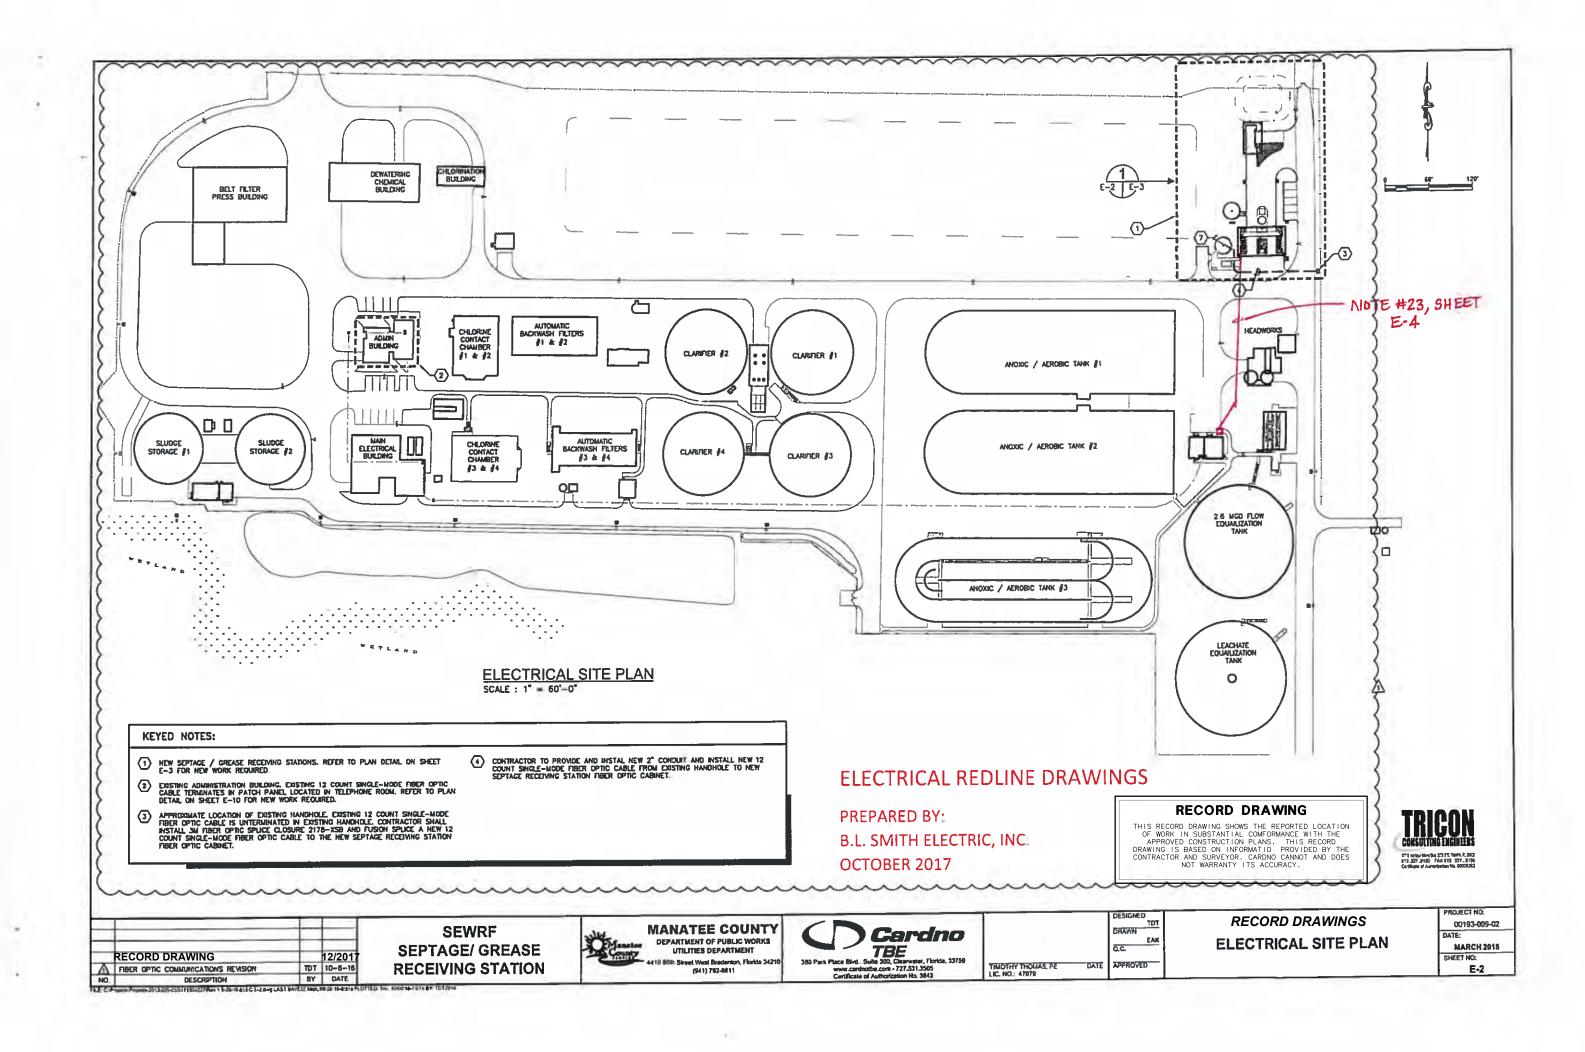



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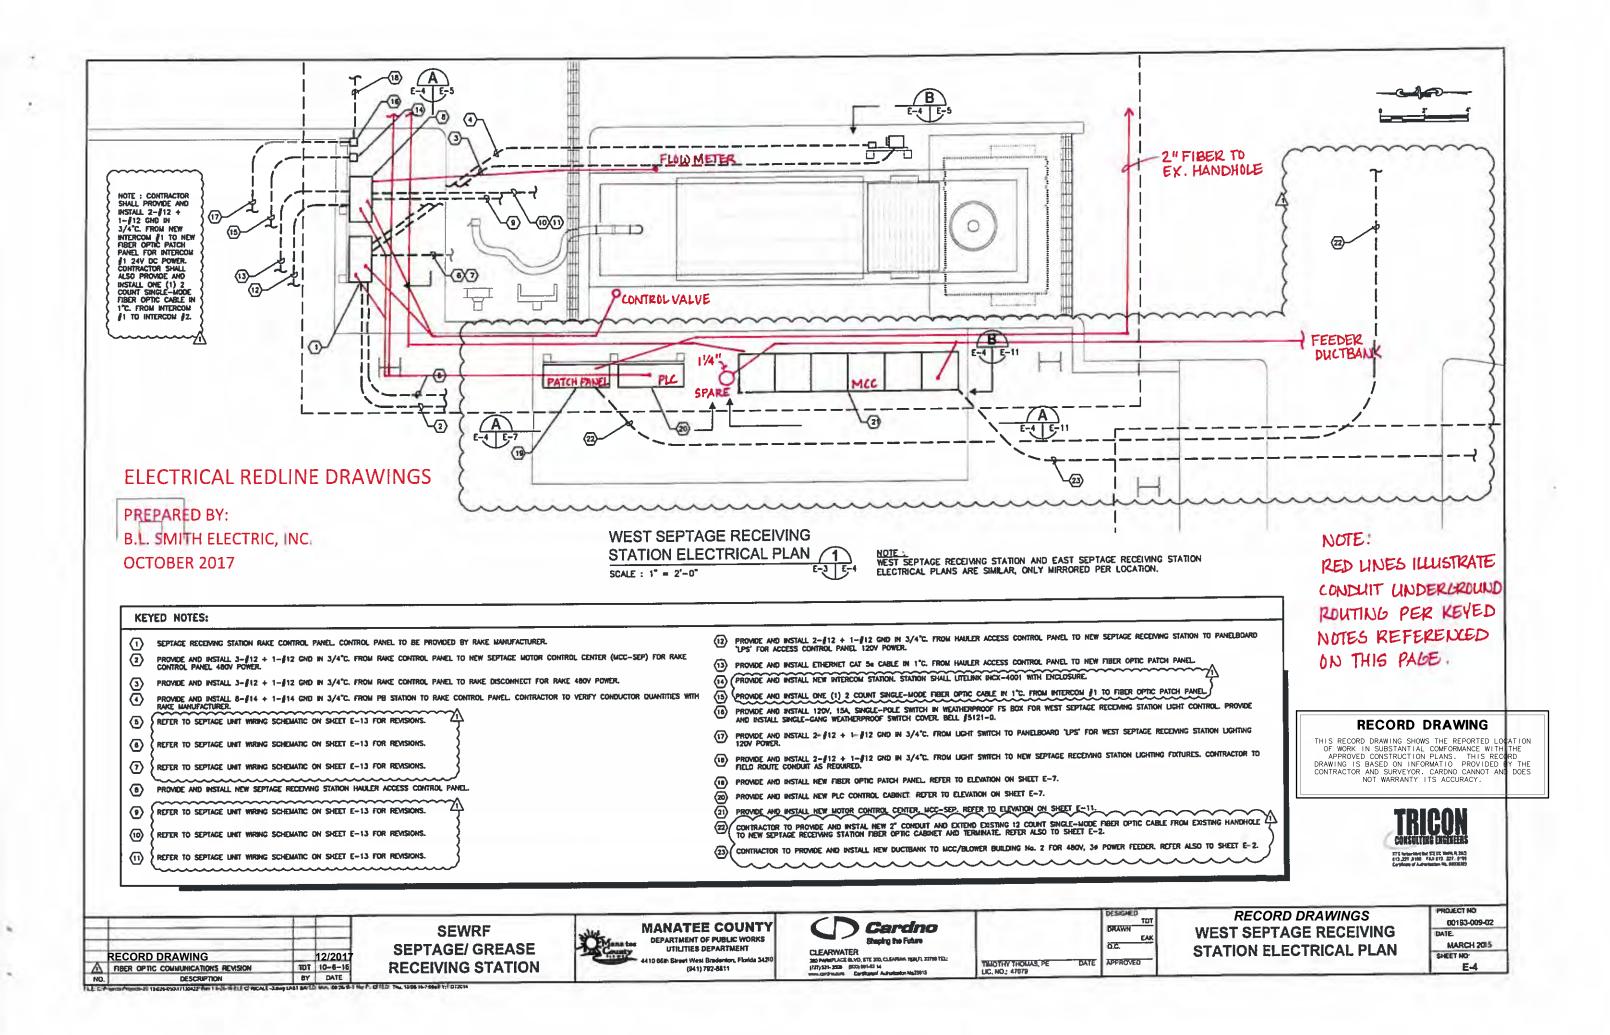
RECORD DRAWINGS ELECTRICAL LEGEND AND ABBREVIATIONS

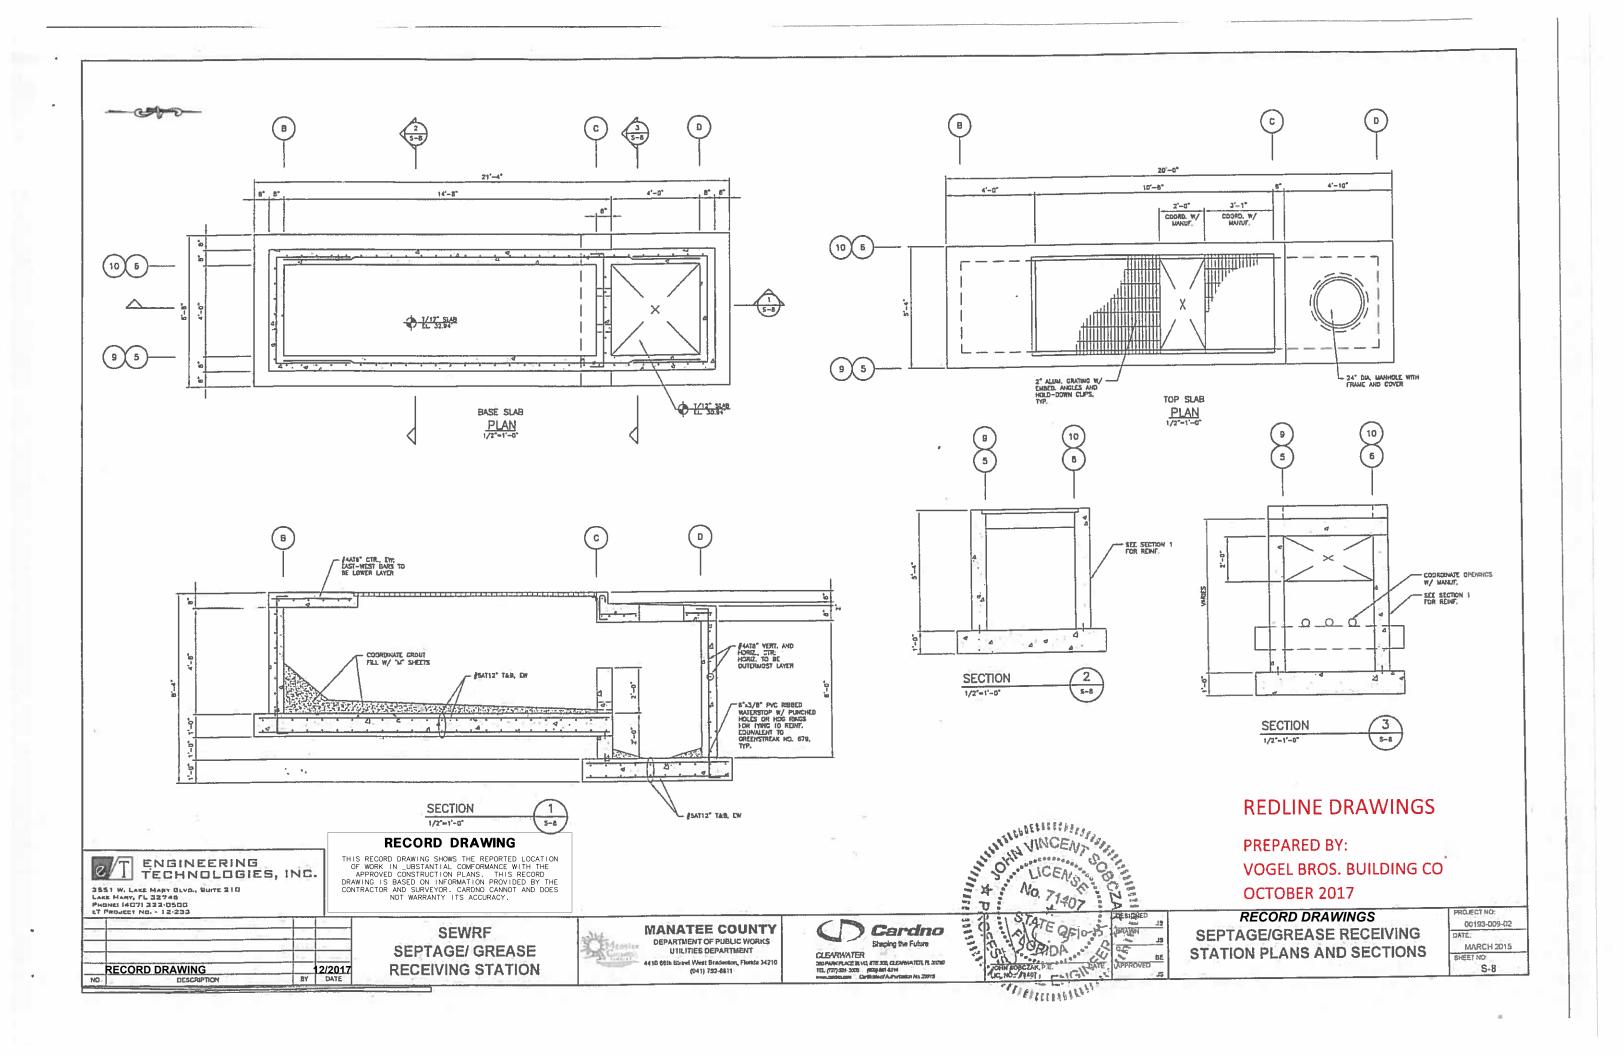
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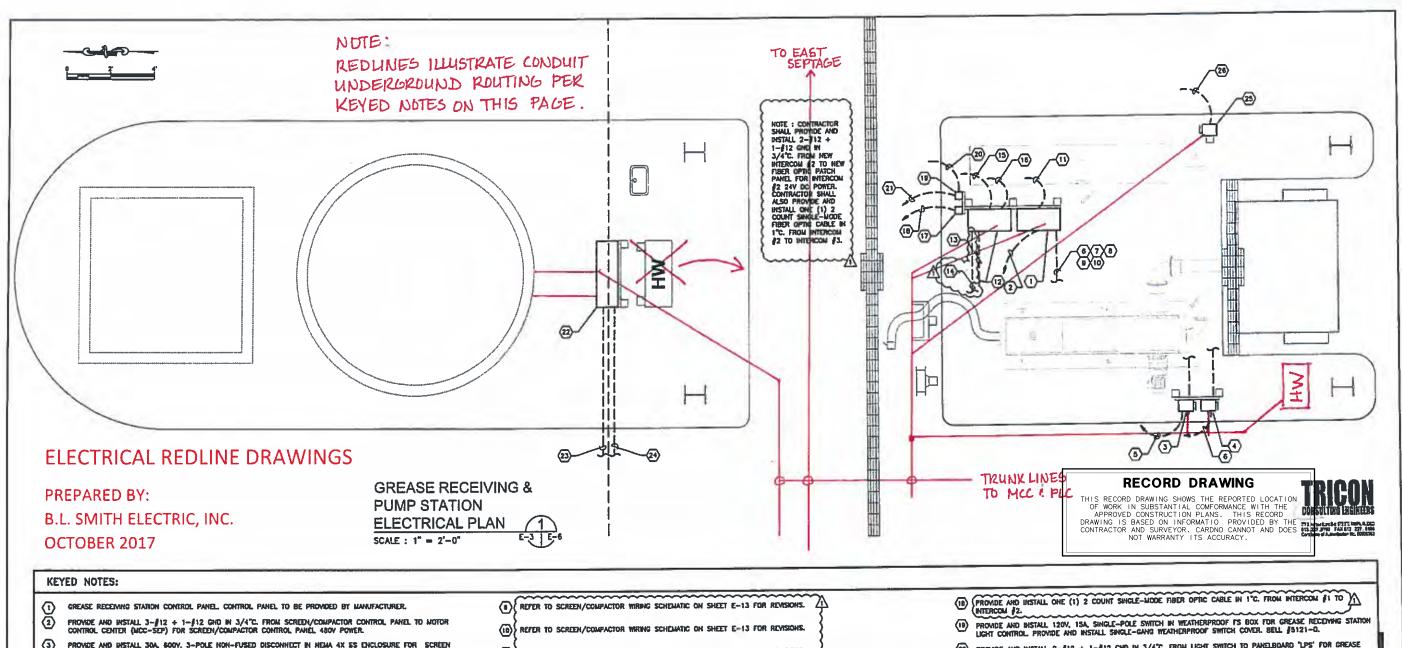
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- PROVIDE AND INSTALL 30A, 600Y, 3-POLE NON-FUSED DISCONNECT IN NEMA 4X SS ENCLOSURE FOR SCREEN DRIVE DISCONNECTING MEANS, DISCONNECT SHALL BE PROVIDED WITH INTERLOCKED AUXILIARY CONTACT FOR MANUFACTURER'S SCREEN OVERTICALP CIRCUIT, COORDINATE AUXILIARY CONTACT RATING REQUIREMENTS WITH SCREEN SYSTEM MANUFACTURER'S. 3
- PROVIDE AND INSTALL SOA, 600Y, 3-POLE NON-FUSED DISCONNECT IN NEW AX SS ENCLOSURE FOR COMPACTOR DISCONNECTING MEMIS, DISCONNECT SHALL BE PROVIDED WITH INTERLOCKED AUXILIARY CONTACT FOR MANUFACTURER'S COMPACTOR OVERTEMP CRCUIT, COORDINATE AUXILIARY CONTACT RATING REQUIREMENTS WITH COMPACTOR SYSTEM MANUFACTURER.
- PROVIDE AND INSTALL 3-#12 + 2-#12 (MOTOR THERMOSTAT) + 1-#12 GND IN 3/4°C. FROM SCREEN DISCONNECT TO CONTROL PANEL PROVIDE FLEXIBLE SEALTITE CONNECTION TO MOTOR.
- PROVIDE AND INSTALL $3-\frac{p}{2}+2-\frac{p}{2}$ 12 (MOTOR THERMOSTAT) + $1-\frac{p}{2}$ 12 (NO IN 3/4°C, FROM COMPACTOR DISCONNECT TO CONTROL PANEL, PROVIDE FLEXIBLE SEALTITE CONNECTION TO MOTOR. **(**
- 7 REFER TO SCREEN/COMPACTOR WIRING SCHEMARC ON SHEET E-13 FOR REVISIONS.
- **(6)** REFER TO SCREEN/COMPACTOR WRING SCHEMATIC ON SHEET E-13 FOR REVISIONS

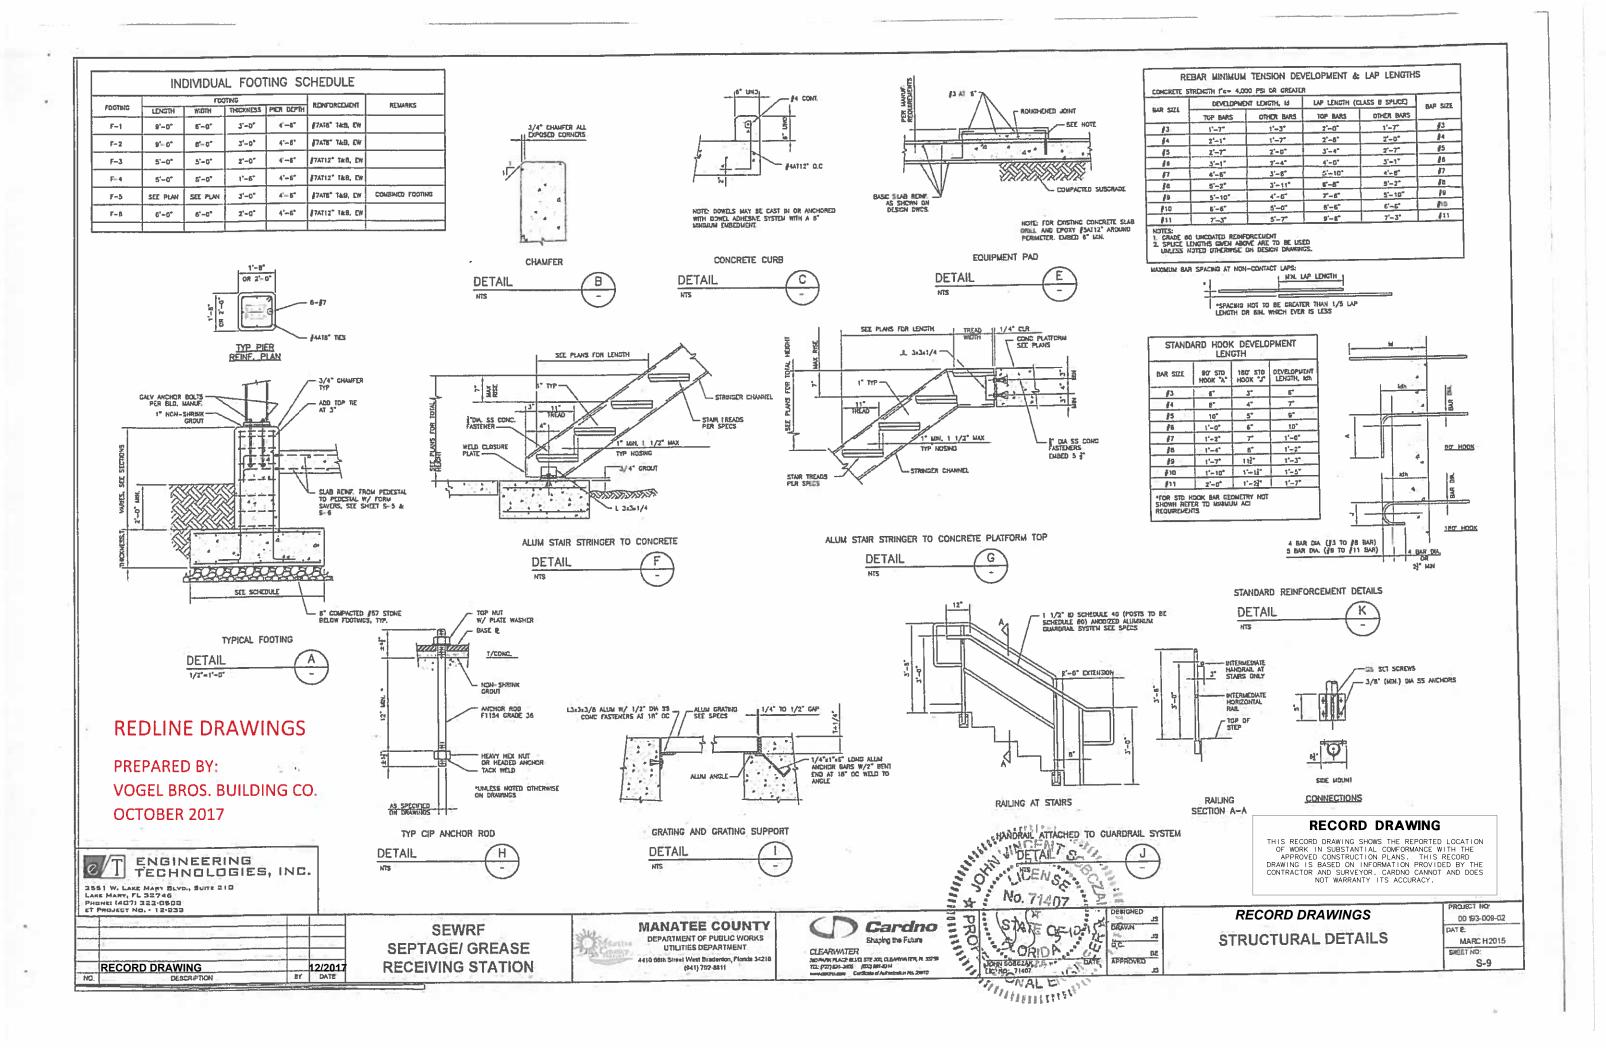- (1) REFER TO SCREEN/COMPACTOR WIRING SCHEMATIC ON SHEET E-13 FOR REVISIONS.
- REFER TO SCREEN/COMPACTOR WIRING SCHEMATIC ON SHEET E-13 FOR REVISIONS.
- REFER TO SCREEN/COMPACTOR WIRING SCHEMATIC ON SHEET E-13 FOR REVISIONS.
- PROVIDE AND INSTALL $2-\beta 12+1-\beta 12$ cad in 3/4°C. From Hauler access control panel to new septage receiving station to panelboard 'lps' for access control panel 120V power.
- (17) PROVIDE AND INSTALL NEW INTERCOM STATION, STATION SHALL LITELINK INCX-4001 WITH ENCLOSURE

- (20) PROVIDE AND DISTALL 2-\$12 + 1-\$12 CND IN 3/4°C. FROM LIGHT SWITCH TO PANELBOARD 'LPS' FOR GREASE RECEIVING STATION LIGHTING 120V POWER.
- PROVIDE AND INSTALL $2-\frac{4}{2}12+1-\frac{4}{2}12$ GNO IN 3/4°C. From Light Switch to New Grease receiving station lighting fatures. Contractor to field route conduit as redurred.
- PUMPING STATION CONTROL STATION, REFER TO SPECIFICATION 11305 FOR REQUIREMENTS, MOUNT ON 4" SQUARE CONCRETE POSTS WITH 1-8/8" STATINESS STEEL UNISTRUT (REFER TO TYPICAL CABINET MOUNTING DETAILS ON
- (23) PROVIDE AND INSTALL 3-84 THINN CU + 1-88 THINN CU GND IN 1-1/4°C. FROM NEW PUMP STATION CONTROL PANEL TO MCC-SEP FOR CONTROL PANEL 480V FEEDER.
- PROVIDE AND INSTALL 4-612+1-612 GND in $3/4^\circ$ C, from New Pump Station Control Panel to New PLC control cabinet for Well high level scada alarm and grease storage tank permissive.
- PROVIDE AND INSTALL 30A, 600V, 3-POLE NON-FUSED DISCONNECT IN NEMA 4X SS ENCLOSURE FOR GREASE PUMP DISCONNECTING NEARS. MOUNT ON 4° SOURCE CONCRETE POST WITH 1-5/8° STAINLESS STEEL UNISTRUT (REFER TO TYPICAL DISCONNECT MOUNTING DETAIL ON SHEET E-5).
- (2) PROVIDE AND INSTALL 3-512 THWN CU + 1-512 THWN CU GNO IN 3/4°C. FROM NEW GREASE PUMP DISCONNECT TO MCC-SEP FOR GREASE PUMP 480V FEEDER. PROVIDE FLEXIBLE SEALTHE CONNECTION TO MOTOR. COORDINATE MOTOR CONNECTION WITH GREASE PUMP SUPPLER.

RECORD DRAWING 12/201	SEPTAGE
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SEWRF SEPTAGE/ GREASE RECEIVING STATION

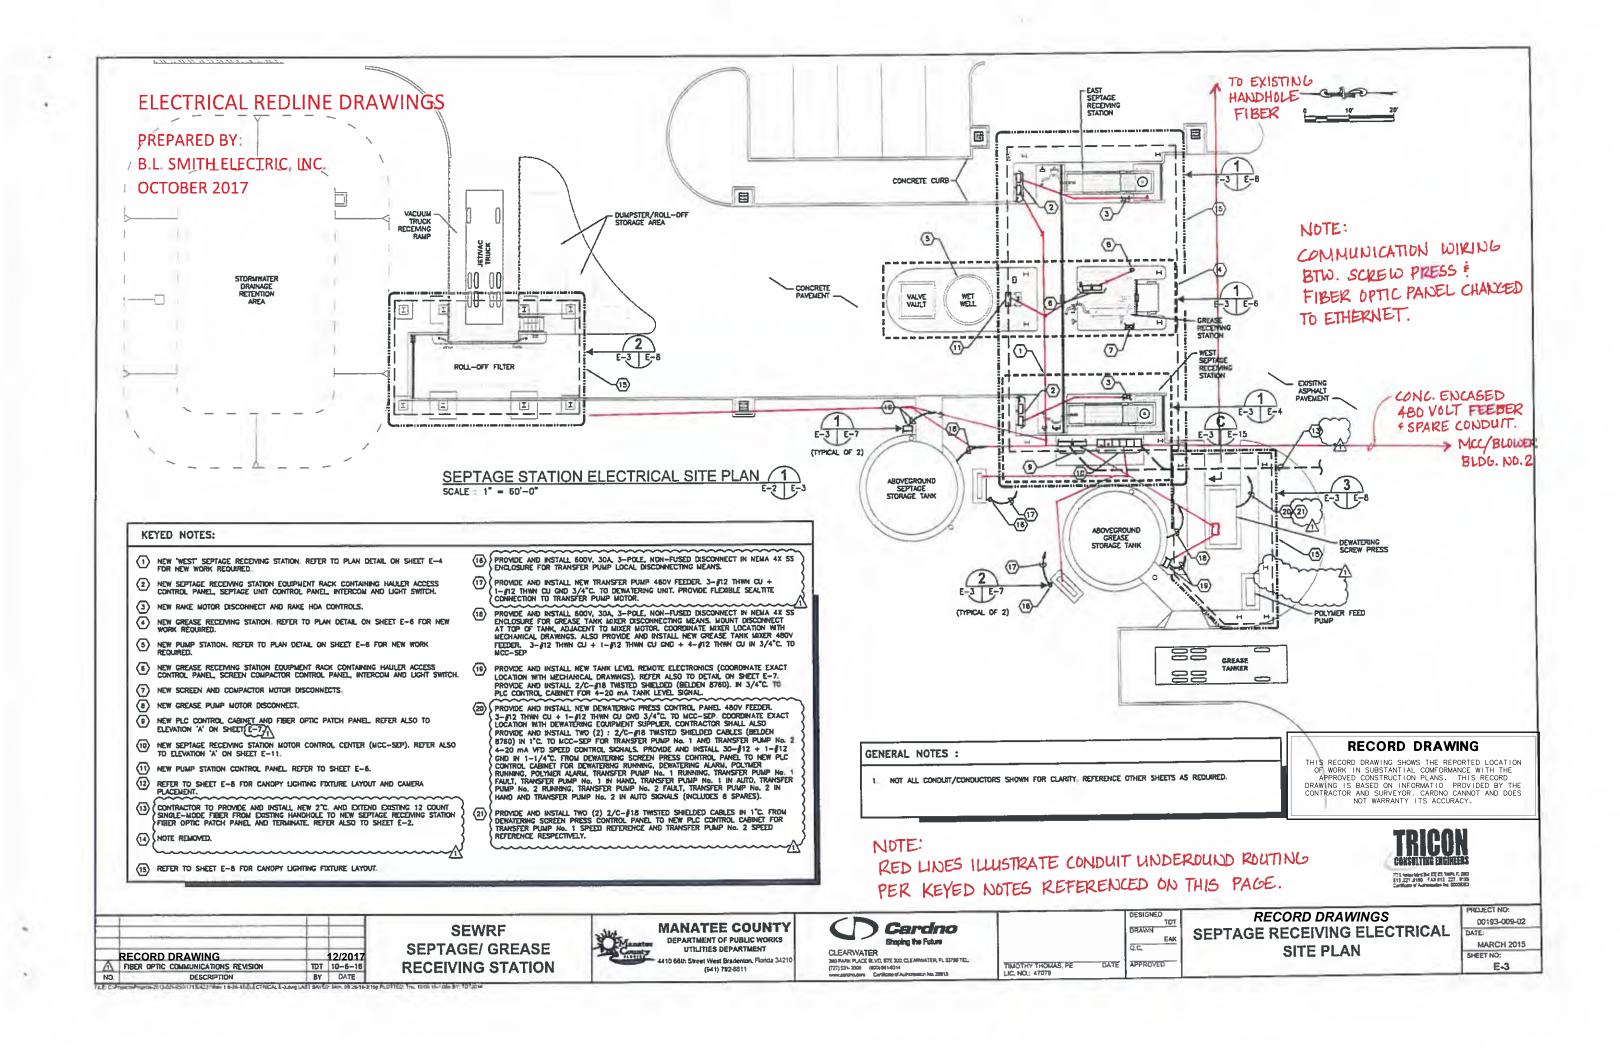

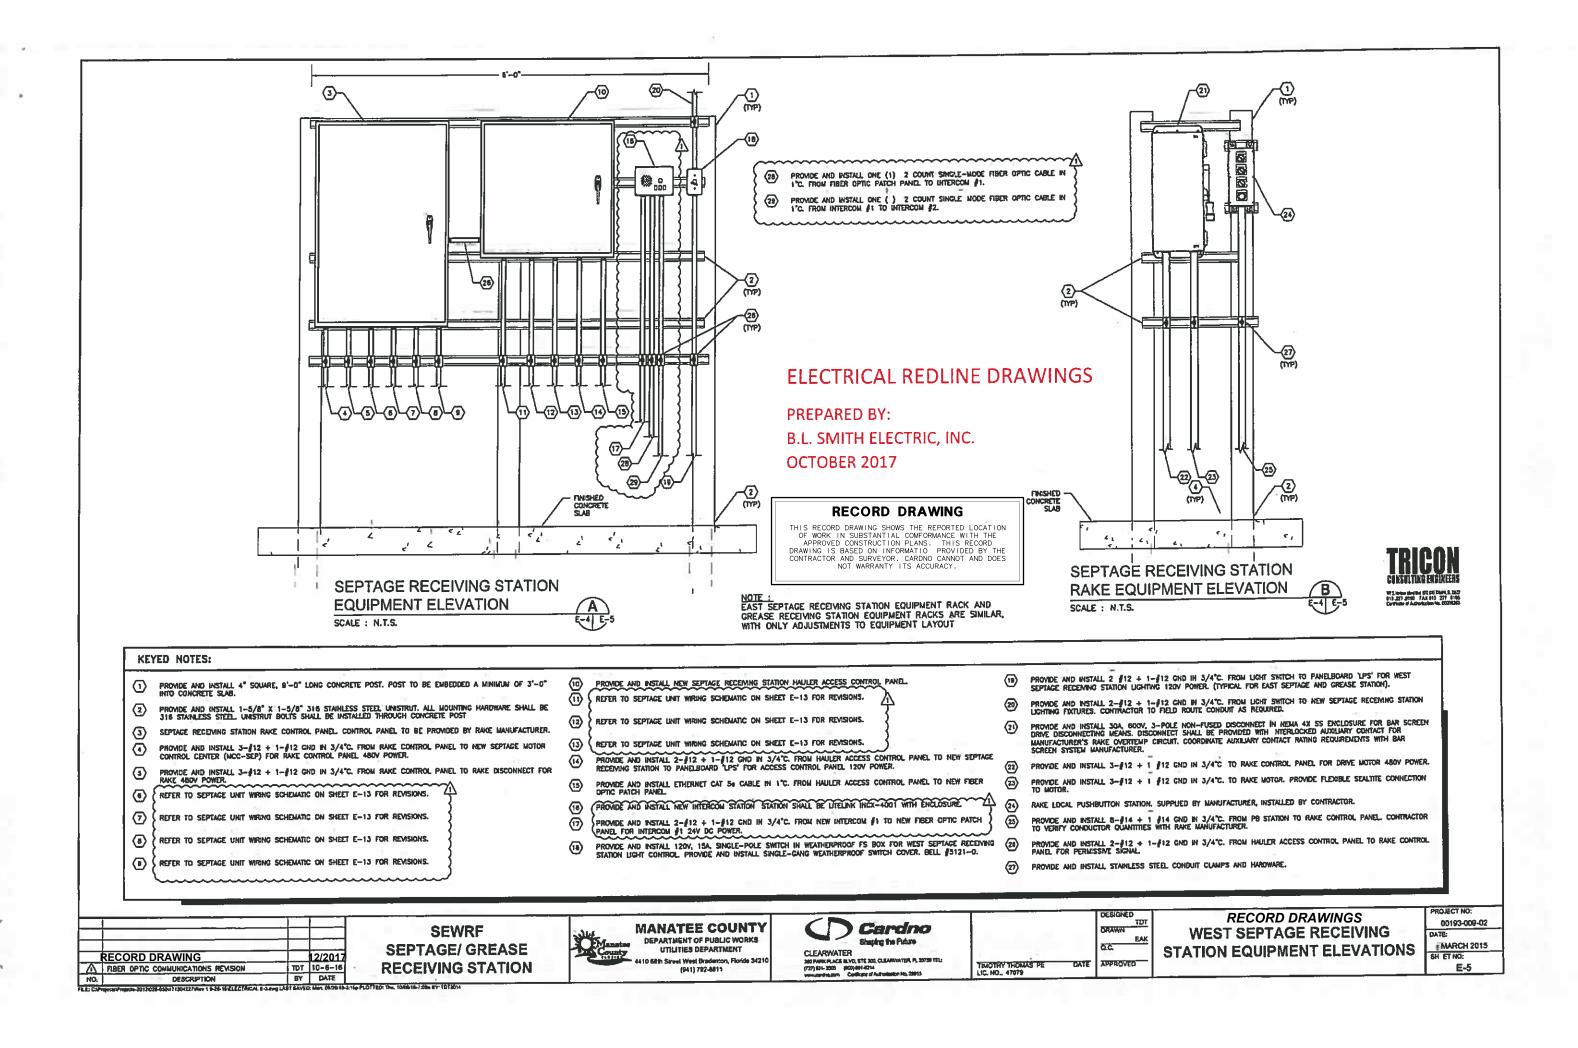MANATEE COUNTY DEPARTMENT OF PUBLIC WORKS UTR ITIES DEPARTMENT

(941) 792-8811





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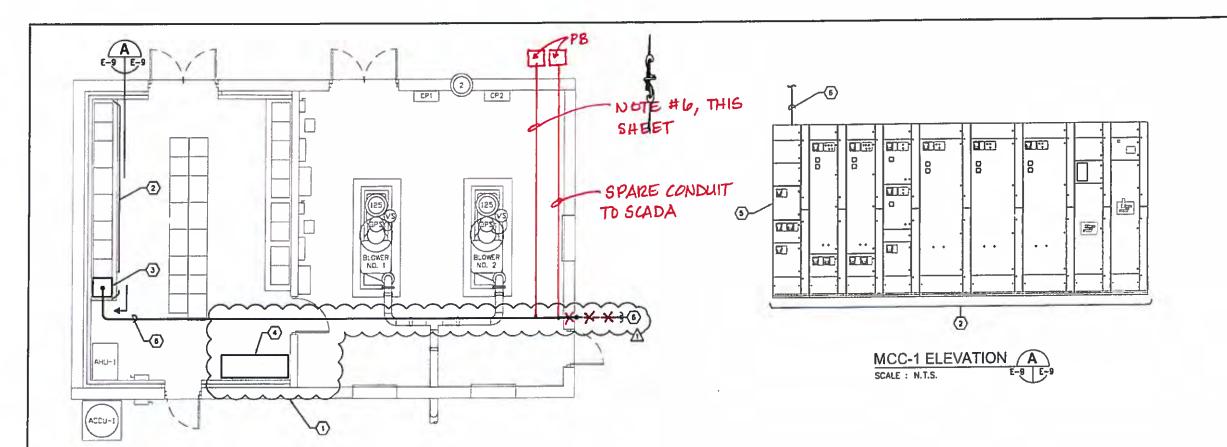
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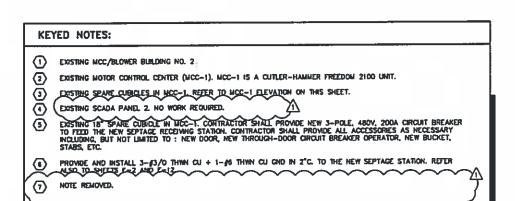
RECORD DRAWINGS GREASE RECEIVING SEPTAGE LIST STATION ELECTRICAL SITE PLAN

00193-009-02 MARCH 2015 E-6





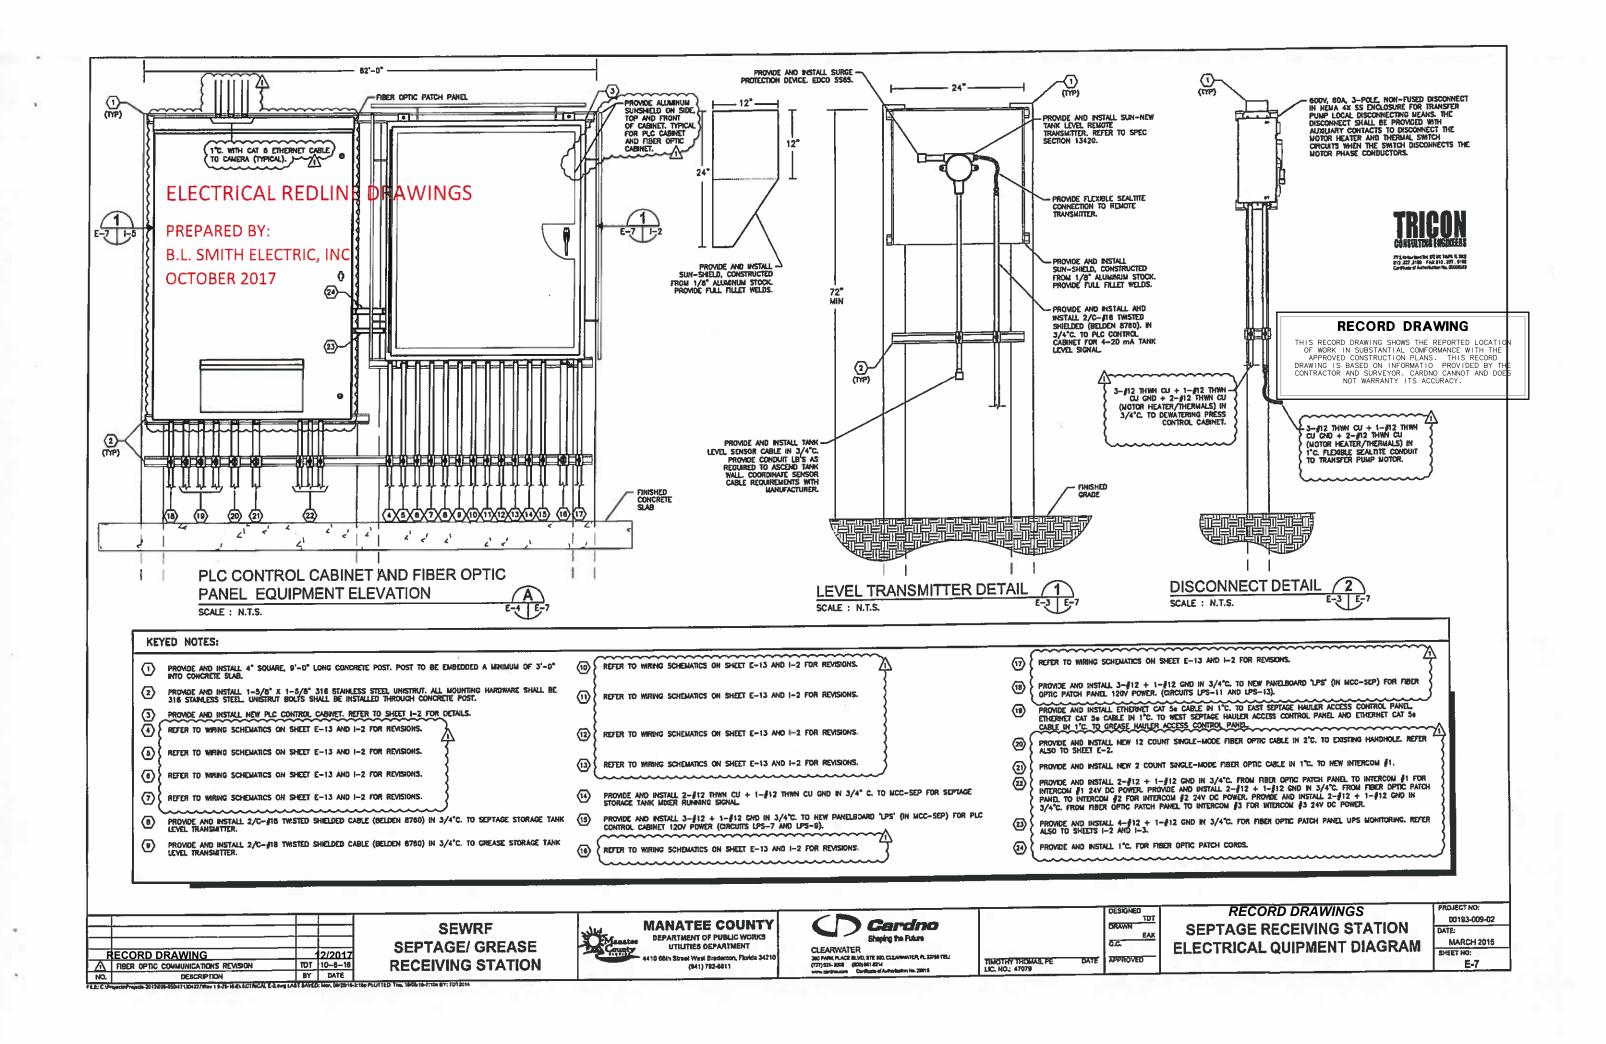

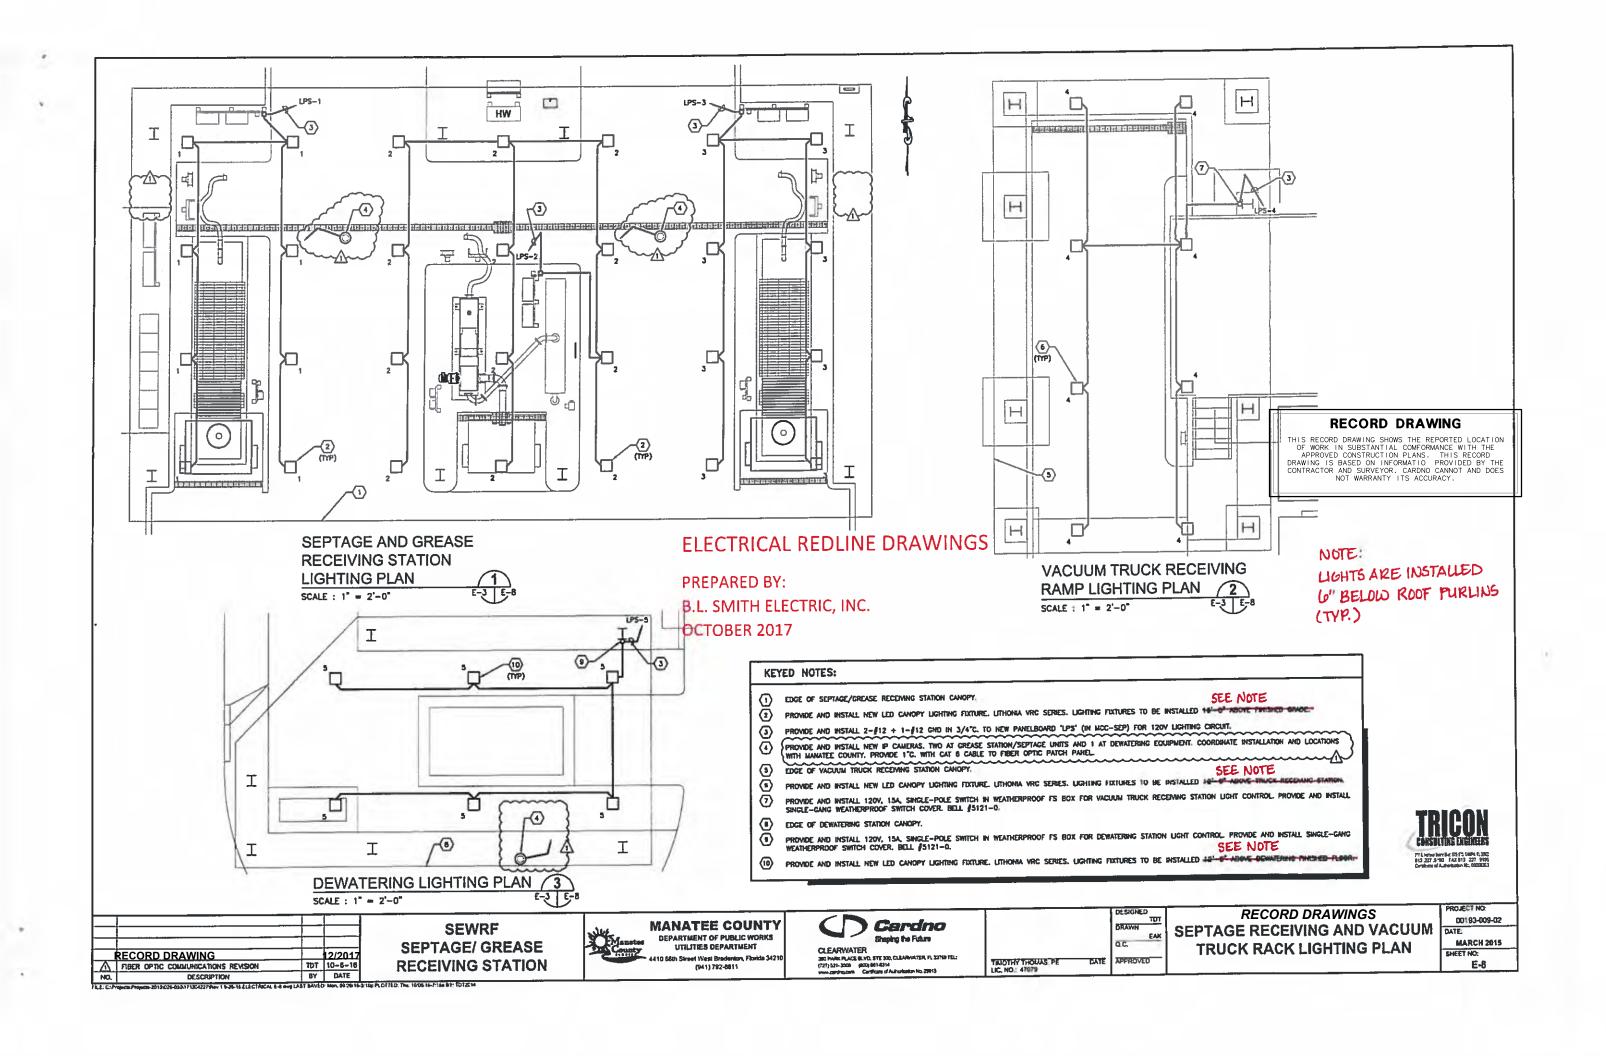

MCC/BLOWER BUILDING No. 2

FLOOR PLAN SCALE : 1/4" = 1'-0"

ELECTRICAL REDLINE DRAWINGS

PREPARED BY: B.L. SMITH ELECTRIC, INC. OCTOBER 2017

RECORD DRAWING

THIS RECORD DRAWING SHOWS THE REPORTED LOCATION OF WORK IN SUBSTANTIAL COMFORMANCE WITH THE APPROVED CONSTRUCTION PLANS. THIS RECORD DRAWING IS BASED ON INFORMATIO PROVIDED BY THE CONTRACTOR AND SURVEYOR. CARDNO CANNOT AND DOES NOT WARRANTY ITS ACCURACY.

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SEWRF SEPTAGE/ GREASE RECEIVING STATION



MANATEE COUNTY DEPARTMENT OF PUBLIC WORKS UTILITIES DEPARTMENT 10 68th Street West Bradenton, Fkwida 34210 (941) 792-8811



SECURITY STATE IE.Y 300 PARK PLACE BL.YD, STE 300 CLEARNATER FL 3798 TEL (27) SET-2009 (ECO) 881-4514 WWW.gordin.com Cardinate of Automation No. 27915


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TIMOTHY THOMAS, PE	DATE	APPROVED
LIC. NO.: 47979		

DESIGNED

DRAWN

RECORD DRAWINGS MCC-BLOWER BUILDING NO. 2 **FLOOR PLAN**

PROJECT NO:
00193-009-02
DATE:
MARCH 2015
SHEET NO:
E-9

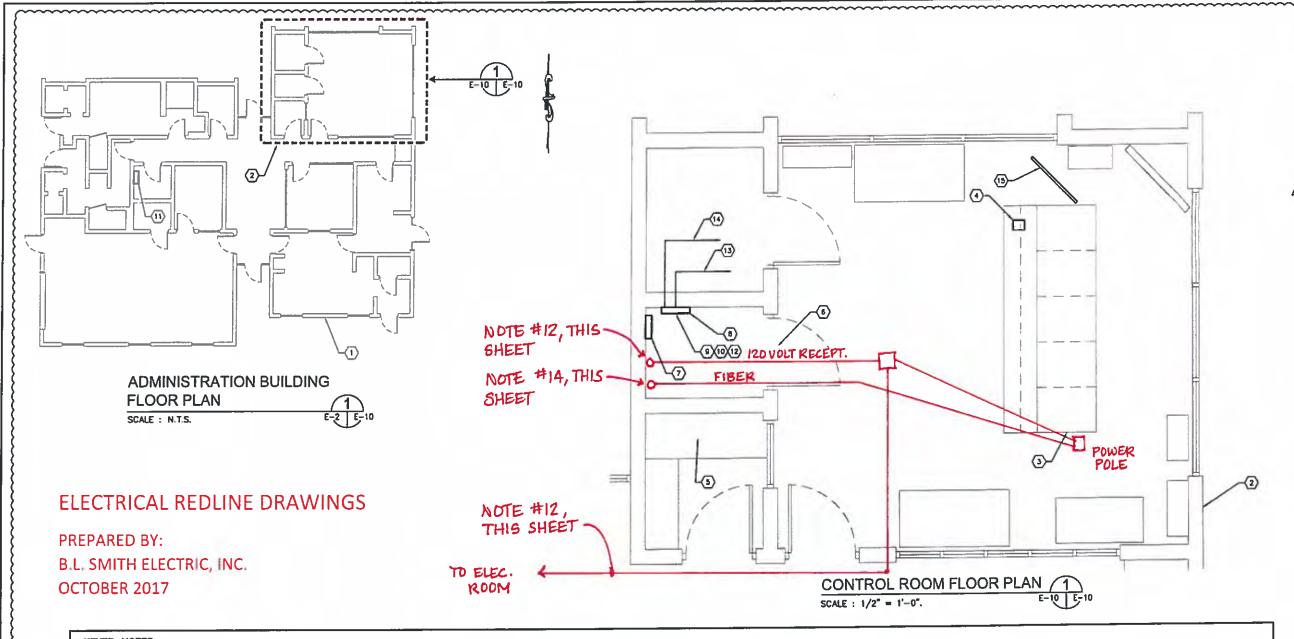

KEYED NOTES:

- EXISTING ADMINISTRATION BUILDING.
- 2 EXISTING CONTROL ROOM WITHIN ADMINISTRATION BUILDING.
- EXISTING CONSOLE CONTAINING SCADA COMPUTERS, PIC PLC, ETC. CONTRACTOR SHALL PROVIDE AND INSTALL NEW 120/AC-24/DC POWER SUPPLY WITH 5 AMPERE DUTPUT, PHOEMIX CONTACT #2866750. ALSO PROVIDE AND INSTALL 8 PORT ETHERHET SWITCH, HIRSCHMAIN SPIDER BIX, NEW POWER SUPPLY SHALL 8E UTILIZED TO PROVIDE 24/DC POWER TO NEW 8 PORT SWITCH AND NEW INTERCOM STATION (REFER TO NOTE #4 FOR INTERCOM STATION REQUIREMENTS). PROVIDE 24/DC POWER SUPPLY INPUT POWER FROM UPS SOURCE, REFER ALSO TO SHEET E-9. **③**
- PROVIDE AND INSTALL NEW INTERCOM STATION, STATION SHALL BE LITELINK INCK-4001. INTERCOM SHALL BE FLUSH MOUNTED ON EXISTING CONSOLE, COORDINATE EXACT LOCATION WITH MANAJEE COUNTY. **①**
- PROPOSED LOCATION FOR NEW HAULER ACCESS PERSONAL COMPUTER (PC).
- **①** EXISTING TELEPHONE ROOM WITHIN ADMINISTRATION BUILDING.

- EXISTING FIBER OPTIC PATCH PANEL PATCH PANEL CONTAINS TERMINATED 12 COUNT SINGLE-MODE FIBER OPTIC CABLE WHICH EXTENDS TO EXISTING HANDHOLE. REFER TO NOTE #5 ON SHEET E-2 FOR HANDHOLE. CONTRACTOR SHALL PROVIDE AND INSTALL NEW FIBER OPTIC PATCH PANELS AS RECUPRED FOR EQUIPMENT IN NOTE #8 AND #13 ON THIS SHEET.
- EXISTING MANATEE COUNTY CISCO ETHERNET SWITCH, REFER TO SHEET I-9 FOR REQUIRED MODIFICATIONS.
- PROVIDE AND INSTALL ONE (1) NEW FIBER OPTIC MEDIA CONVERTER FOR PLC COMMUNICATIONS, OMNITION 4701—1 WITH 1—MODULE 120V AC CHASSIS, NEW MEDIA CONVERTER SHALL BE DIN-RAIL MOUNTED ON WALL BELOW EXISTING (9) ETHERNET SWITCH IN NOTE #8.
- PROVIDE AND INSTALL 350VA UPS FOR MEDIA CONVERTER 120V POWER APC BE350G, INSTALL UPS ON EDISTING SHELF (BELOW MEDIA CONVERTERS, MODIFY SHELF WIDTH IF NECESSARY TO ACCOMMODATE NEW UPS WIDTH).
- EXISTING 120/208V PANELBOARD "LC". CONTRACTOR SHALL LITLIZE EXISTING SPARE SINGLE-POLE, 20A CIRCUIT BREAKER IN PANELBOARD TO SUPPLY NEW UPS 120V POWER (CIRCUIT 32, 41 OR 42).

- CONTRACTOR TO PROVIDE AND INSTALL NEW 20A DUPLEX RECEPTACLE FOR NEW UPS IN NOTE §10. PROVIDE AND INSTALL 2-§12 CU + 1-§12 CU GNO IN 3/4°C. TO PANELBOARD 'LC'.
- PROMDE AND INSTALL NEW DUPLEX SINGLE-MODE FIBER OPTIC PATCH CORD FROM EXISTING PATCH PANEL TO NEW INTERCOM IN NOTE #4. INSTALL PATCH CORD IN 1°C. CONTRACTOR MAY UTBLIZE EXISTING COMMUNICATIONS POLE FROM CELLING TO CONSOLE # THE POLE WILL ACCOMMODATE THE NEW FIBERPATCH CORD.
- PROVIDE AND INSTALL NEW CAT 50 ETHERNET CABLE FROM PLC COMMUNICATIONS
 FIBER OPTIC MEDIA CONVERTER TO NEW ETHERNET SWITCH IN NOTE #13. INSTALL
 ETHERNET CABLE IN 1°C. CONTRACTOR MAY UTULZE EDISTING COMMUNICATIONS
 POLE FROM COLLING TO CONSOLE IF THE POLE WILL ACCOMMODATE THE NEW
 TOTAL COLLING TO CONSOLE IF THE POLE WILL ACCOMMODATE THE NEW
- PROVIDE AN INSTALL NEW 55° LED MONITOR. COORDINATE LOCATION AND MOUNTING WITH MANATEE COUNTY.

RECORD DRAWING

THIS RECORD DRAWING SHOWS THE REPORTED LOCATION OF WORK IN SUBSTANTIAL COMFORMANCE WITH THE APPROVED CONSTRUCTION PLANS. THIS RECORD DRAWING IS BASED ON INFORMATIO PROVIDED BY THE CONTRACTOR AND SURVEYOR. CARDNO CANNOT AND DOES NOT WARRANTY ITS ACCURACY.

TRICON 175 Arms Inc Sc 12 (73 Table 1200 813 227 3/10 FAX 813 227 1716 Cod 227 3/10 Inches In 1872(15)

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	RECORD DRAWING		12/2017	
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SEWRF SEPTAGE/ GREASE RECEIVING STATION



MANATEE COUNTY DEPARTMENT OF PUBLIC WORKS

UTILITIES DEPARTMENT 10 66th Street West Bradenton, Florida 3421 (941) 792-8611



CLEARWATER 388 PARK PLACE BLVEL STE 300, CLEARWINTER, PL 33759 TEL (727) 351-3008 - (RDQ 881-4014 sens controllors - Conficient Authorises No. 20013


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TIMOTHY THOMAS, PE	CATE	APPROVED
LIC NO: 47079		

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RECORD DRAWINGS SEPTAGE RECEIVING STATION ADMINISTRATION BUILDING FLOOR **PLAN**


ROJECT NO: 00193-009-02 MARCH 2015

E-10

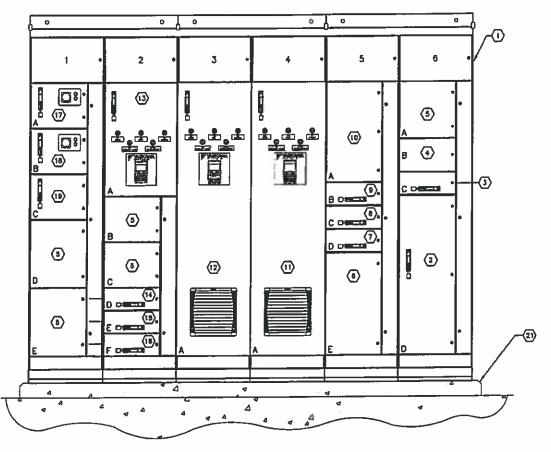

SEPTAGE AND GREASE **RECEIVING STATION** MCC FRONT ELEVATION (A SCALE : 1" = 2'-0"

NOTE: MCC SHOWN WITH OUTER ENCLOSURE DOORS REMOVED

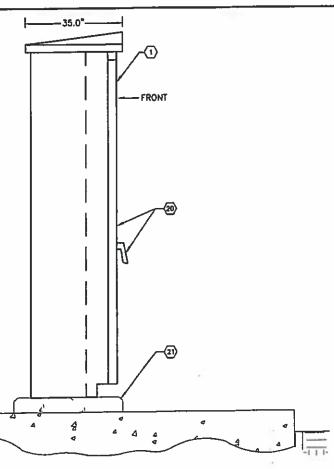

SEPTAGE AND GREASE **RECEIVING STATION** MCC SIDE ELEVATION SCALE : 1" = 2'-0"

KEYED NOTES:

- NEW SEPTAGE RECEIVING STATION MOTOR CONTROL CENTER MCC IN MEMA 3R ENCLOSURE. RETER ALSO TO ONE-LINE GRAZIAM ON SHEET E-12.
- 200A, 460V, 3-POLE MAIN CIRCUIT BREAKER.
- 30A, 480V, 3-POLE CIRCUIT BREAKER FOR SURGE PROTECTION DEVICE (SPO). 3
- **(** SURGE PROTECTION DEVICE (SPD).
- **③** SPACE
- 15 KVA, 3#, 480V-120/208V TRANSFORMER.
- 40A, 480V, 3-POLE CIRCUIT BREAKER FOR 15 KVA TRANSFORMER.
- 20A, 480V, 3-POLE CIRCUIT BREAKER FOR NEW EAST SEPTAGE STATION CONTROL PANEL **(**
- **③**
- NEW 120/208V, 36, 4-WIRE PANELBOARD WITH 100A M.C.B. PANELBOARD DESIGNATION 'LPS', REFER TO SHEET E-15 FOR SCHEDULE. **®**
- NEW 7.5 HP, 480V, VFD FOR NEW TRANSFER PUNP No. 1. : NO LONGER TO BE USED. 12 NEW 7.5 HP, 480V, VFD FOR NEW TRANSFER PUNP No. 2. : NO LONGER TO BE USED.
- NEW 40.0 HP, 480V, VFD FOR NEW GREASE PUMP.
- SPARE 20A, 480V, 3-POLE CIRCUIT BREAKER.
- 20A, 480V, 3-POLE CIRCUIT BREAKER FOR DEWATERING PRESS CONTROL PANEL. 20A, 480V, 3-POLE CIRCUIT BREAKER FOR NEW CREASE STATION CONTROL PANEL. (15)
- Ō STARTER FOR NEW GREASE TANK MIXER No. 1.
- (B) STARTER FOR NEW GREASE TANK MIXER No. 2.
- (B) 70A, 480V, 3-POLE CIRCUIT BREAKER FOR NEW WET WELL CONTROL PANEL.
- PROVIDE CASKETED RAIN TIGHT DOOR WITH LOCKING HANDLE. **②**
 - PROVIDE 4" CONCRETE HOUSKEEPING PAD WITH CHAMFERED EDGES.

ELECTRICAL REDLINE DRAWINGS

PREPARED BY B.L SMITH ELECTRIC, NC OCTOBER 2017

RECORD DRAWING

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SEWRF SEPTAGE/ GREASE **RECEIVING STATION**



MANATEE COUNTY DEPARTMENT OF PUBLIC WORKS UTILITIES DEPARTMENT

6th Street West Bredenton, Floride 342 (941) 782-8811



CLEARWATER 200 PARK PLACE BLYO, 81E 303, CLEARWATER, PL 2 (277) 531-3505 (BIOS) 851-4514 WWW.CONTROLOM Cardiome of Automobin No. 2015


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IOMAS, PE DATE	APPROVED

DESIGNED

RECORD DRAWINGS SEPTAGE RECEIVING STATION MCC **ELEVATION**

00193-009-02 MARCH 2015 SHEET NO: E-11

ES-2013/C28-000x17150x2277Rev 1 B-26-14-ELECTRICAL E-8-0-19 LAST BAVED: Mon. 50/28/16-2-10p PLOTTED: Time, 18:00x16-7:160 BY: 1072871-

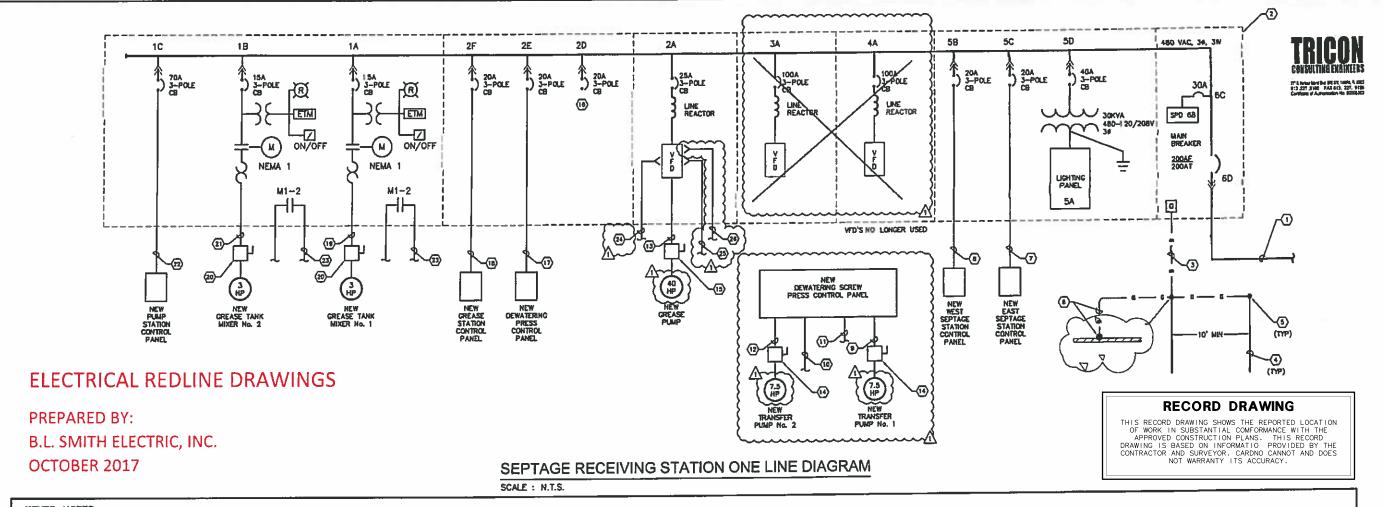

KEYED NOTES:

- PROMDE AND INSTALL NEW SEPTAGE RECEIVING STATION MOTOR CONTROL FEEDER. 3-#3/0 THWN CJ + 1-#8
 THWN CJ GND IN 2° C. REFER ALSO TO SHEETS E-2 AND E-8
- PROVIDE AND INSTALL NEW SEPTAGE RECEIVING STATION MOTOR CONTROL CENTER ("MCC-SEP").
- (3) PROVIDE AND INSTALL #1 BARE CU GROUNDING ELECTRODE CONDUCTOR IN 1-1/2" C..
- 4 PROVIDE AND INSTALL 5/8" X 20'-0" GROUNDING ELECTRODE.
- (5) PROVIDE AND INSTALL EXOTHERNIC WELDS.
- PROVIDE AND INSTALL #1 BARE CU GROUNDING CONDUCTOR AND EXOTHERMICALLY WELD TO REBAR IN NEW SEPTAGE STATION CONCRETE SLAB.
- PROVIDE AND INSTALL NEW EAST SEPTAGE STATION CONTROL PANEL FEEDER. 3-#12 THWN CU + 1-#12 THWN CU GNO IN 3/4°C.
- PROVIDE AND INSTALL NEW WEST SEPTAGE STATION CONTROL PANEL FEEDER. 3-/12 THWN CU + 1-/12 THWN CU CNO IN 3/4°C.
- (B) PROVIDE AND INSTALL NEW TRANSFER PUMP No. 1 FEEDER. 3-\$12 THWN CU + 1-\$12 THWN CU GND IN 3/4°C. TO DEWATERING SCREW PRESS CONTROL PANEL.

- PROVIDE AND INSTALL 30-\$12 THINN CU + 1-\$12 THINN CU GND IN 1-1/4" FROM DEWATERING SCREW PRESS CONTROL PANEL CONDUIT TO NEW PLC CONTROL CABNET FOR (4-\$12 VFD 1 & 2 RUNNING, 4-\$12 VFD 1 & 2 FAILT, 4-\$12 VFD 1 & 2 IN HAND, 4-\$12 VFD 1 & 2 IN AUTO, 6 SPARES).
- PROVIDE AND INSTALL TWO (2) 2/C-\$18 TWISTED SHIELDED CABLE (BELDEN 8780) IN 1° CONDUIT FROM DEVALUE FOR VED 1 & 2 4-20mA SPEED REFERENCE SCREW PRESS CONTROL PANEL TO NEW PLC CONTROL CABINET FOR VED 1 & 2 4-20mA SPEED REFERENCE SIGNAL.
- PROVIDE AND INSTALL NEW TRANSFER PUNIP No. 2 FEEDER, 3-g12 THWN CU + 1-g12 THWN CU GHO IN 3/4°C. TO DEWATERING SCREW PRESS CONTROL PANEL.
- PROVIDE AND INSTALL NEW GREASE PUMP FEEDER. 3-#8 THINN CU + 1-#8 THINN CU GNO + 4-#12 THINN CU (MOTOR MEATER/THERNALS) IN 1°C.
- PROVIDE AND INSTALL BODY, 30A, 3-POLE, NON-FUSED DISCONNECT IN NEMA 4X SS ENCLOSURE FOR TRANSFER PUMP LOCAL DISCONNECTING MEANS.
- PROVIDE AND INSTALL 600Y, 60A, 3-POLE, NON-FUSED DISCONNECT IN NEMA 4X SS ENCLOSURE FOR GREASE PUMP LOCAL DISCONNECTING MEANS. THE DISCONNECT SHALL BE PROVIDED WITH AUXILIARY CONTACTS TO DISCONNECT THE MOTOR HEATER AND THERMAL SWITCH CIRCUITS WHEN THE SWITCH DISCONNECTS THE MOTOR PHASE CONDUCTORS.

- (16) SPARE CIRCUIT BREAKER.
- PROVIDE AND INSTALL NEW DEWATERING PRESS CONTROL PANEL FEEDER. 3-#12 THWN CU + 1-#12 THWN CU GND IN 3/4°C.
- (18) PROVIDE AND INSTALL NEW GREASE STATION CONTROL PANEL FEEDER. 3-#12 THWN CU + 1-#12 THWN CU GND IN 3/4°C.
- PROVIDE AND INSTALL NEW GREASE TANK MIXER No. 1 FEEDER. 3-812 THWN CU + 1-812 THWN CU GND IN
- PROVIDE AND INSTALL BODY, JOA, 3-POLE, NON-FUSED DISCONNECT IN NEMA 4X SS ENCLOSURE FOR CREASE TANK MIXER DISCONNECTING MEANS. MOUNT DISCONNECT AT TOP OF TANK, ADJACENT TO MOER MOTOR.
- 21) PROVIDE AND INSTALL NEW GREASE TANK MIXER No. 2 FEEDER, 3-\$12 THEN CU + 1-\$12 THEN CU GHO IN
- PROVIDE AND INSTALL NEW PUMP STATION CONTROL PANEL FEEDER, 3-34 THWN CU + 1-38 THWN CU CND IN 1-1/4°C.
- PROVIDE AND INSTALL 2-\$12 THAN CU + 1-\$12 THAN CU GND IN 3/4° C. TO PLC CONTROL CABINET FOR GREASE STORAGE TANK MIXER OR SEPTAGE STORAGE TANK MIXER RUNNING SIGNAL.
- PROVOE AND INSTALL 2-#12 THAN CU + 1-#12 THAN CU CHO IN 3/4" CONDUIT TO SCREEN/COMPACTOR

 CONTROL PANEL TO FOR 40 HP GREASE PUMP VFD FOR VFD RUN SIGNAL

 PROVOE AND INSTALL 12-#12 THAN CU + 1-#12 THAN CU CHO IN 3/4" CONDUIT TO NEW PLC CONTROL

 PROVOE AND INSTALL 12-#12 THAN CU + 1-#12 THAN CU CHO IN 3/4" CONDUIT TO NEW PLC CONTROL

 CONTROL FOR (3, 4/2) 4FD PUMPINE 2-#12 VFD RIVER 2-#12 VFD IN MAND 2-#12 VF
- PROVIDE AND INSTALL 12-#12 THWN CU + 1-#12 THWN CU GND IN 3/4" CONDUIT TO NEW PLC CONTROL
 CABINET FOR (2-#12 VFD RUNNING, 2-#12 VFD FAULT, 2-#12 VFD IN HAND, 2-#12 VFD IN AUTO, 4 SPARES)
 ALSO PROVIDE AND INSTALL 2/0-#18 TWISTED SHELDED CABLE (BELDEN 8760) IN 1-1/4" CONDUIT TO NEW PLC
 CONTROL CABINET FOR VFD 4-20ma SPEED REFERENCE SIGNAL
- (20) SCREEN/COMPACTOR CONTROL CABINET FOR VFD 4-20thA SPEED CONTROL SIGNAL.

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SEWRF SEPTAGE/ GREASE RECEIVING STATION



MANATEE COUNTY
DEPARTMENT OF PUBLIC WORKS

DEPARTMENT OF PUBLIC WORKS
UTILITIES DEPARTMENT
10 58th Street West Brederdon, Florida 34210
(941) 782-8811




CLEARWATER 200 PANK PLACE BLVD, STE 201, CLEARWATER, PL 20789 TEL: (227) 551-3803 (200) 851-8514 www.targatom Carllings of Automation No. 20013

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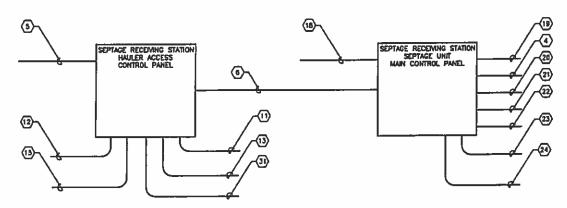
RECORD DRAWINGS
SEPTAGE RECEIVING STATION ONE
LINE DIAGRAM

PROJECT NO: 00193-009-02 DATE: MARCH 2015 SHEET NO:

E-12

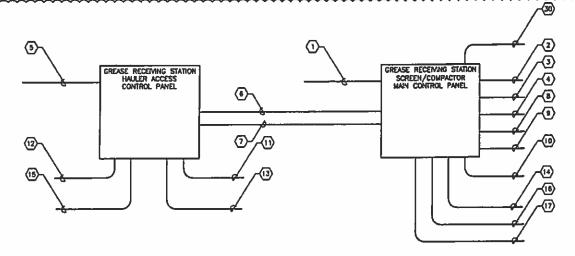


GREASE STATION WIRING SCHEMATIC



TYPICAL SEPTAGE UNIT WIRING SCHEMATIC

ELECTRICAL REDLINE DRAWINGS

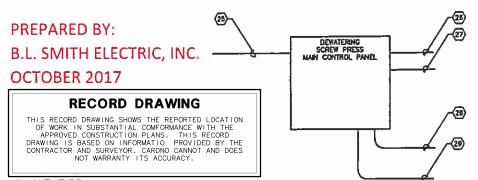

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DEWATERING SCREW PRESS WIRING SCHEMATIC

KEYED NOTES:

- PROVIDE AND INSTALL 3-\$12 + 1-\$12 CND IN 3/4°C. FROM SCREEN/COMPACTOR CONTROL PANEL TO MOTOR CONTROL CENTER (MCC-SEP) FOR SCREEN/COMPACTOR CONTROL PANEL 480V POWER.
- PROVIDE AND INSTALL 3-\$12 + 2-\$12 (MOTOR THERMOSTAT) + 1-\$12 GNO IN 3/4°C. FROM SCREEN DISCONNECT TO CONTROL PANEL. PROVIDE FLEXIBLE SEALITIE CONNECTION TO MOTOR.
- (3) PROVIDE AND INSTALL J-\$12 + 2-\$12 (MOTOR THERMOSTAT) + 1-\$12 CHO IN 3/4"C. FROM COMPACTOR DISCONNECT TO CONTROL PANEL, PROVIDE FLEDIBLE SEALTITE CONNECTION TO MOTOR.
- PROVIDE AND INSTALL 2-\$12 + 1-\$12 GND IN 3/4"C. FROM SCREEN TORQUE SMITCH TO CONTROL PANEL.
- PROVIDE AND INSTALL 2-\$12 + 1-\$12 GND IN 3/4°C. FROM HALLER ACCESS CONTROL PANEL TO NEW SEPTAGE RECEIVING STATION TO PANELBOARD 'LPS' FOR ACCESS CONTROL PANEL 120V POWER.
- PROVIDE AND INSTALL 4-\$12 + 1-\$12 GND IN 3/4°C. FROM HAULER ACCESS CONTROL PANEL TO NEW SCREEN/COMPACTOR CONTROL PANEL (2-\$12 FOR HAULER STATION IN USE CONTACT, 2-\$12 FOR CONTROL PANEL PERMISSIVE).
- PROVIDE AND INSTALL 6-\$12 + 1-\$12 OND IN 3/4°C. FROM HAULER ACCESS CONTROL PANEL TO INLET VALVE FOR OPEN/CLOSE CONTROL AND INLET VALVE STATUS.
- PROVIDE AND INSTALL 2-\$12 + 1-\$12 GND IN 3/4°C. FROM SCREEN/COMPACTOR CONTROL PANEL TO PRESS SPRAY WASH SOLENOID VALVE FOR SOLENOID VALVE OPEN/CLOSE CONTROL.
- PROVIDE AND INSTALL 2-\$12 + 1-\$12 GND IN 3/4°C. FROM SCREEN/COMPACTOR CONTROL PANEL TO PRESS DRAIN FLUSH SOLENOID VALVE FOR SOLENOID VALVE OPEN/CLOSE CONTROL.
- PROVIDE AND INSTALL ULTRASONIC LEVEL SENSOR CABLE IN 3/4°C. CABLE REQUIREMENTS FOR ULTRASONIC LEVEL SENSOR BY SCREEN/COMPACTOR CONTROL PANEL MANUFACTURER. COORDINATE EXACT CONDUIT LOCATION WITH SCREEN/COMPACTOR MANUFACTURER.
- PROVIDE AND INSTALL PH SENSOR CABLE IN 3/4°C. CABLE REQUIREMENTS FOR PH SENSOR BY HALLER ACCESS CONTROL PANEL MANUFACTURER. COORDINATE EXACT CONDUCT LOCATION WITH SCREEN/COMPACTOR MANUFACTURER.
- (12) PROVIDE AND INSTALL ETHERNET CAT So CABLE IN 1°C. FROM HAULER ACCESS CONTROL PANEL TO NEW FIBER OPTIC PATCH PANEL.
- (13) PROVIDE AND INSTALL 2/C-#18 TWISTED SHIELDED CABLE IN 3/4°C. FROM HAULER ACCESS CONTROL PANEL TO GREASE STATION FLOW METER.
- PROVIDE AND INSTALL 10-\$12 + 1-\$12 GND IN 3/4°C. FROM SCREEN/COMPACTOR CONTROL PANEL TO NEW PLC CONTROL CABINET FOR SCREEN RUNNING, SCREEN FAULT, PRESS RUNNING, PRESS FAULT AND GREASE TANK HIGH LEVEL PERMISSIVE SIGNALS.
- (15) PROVIDE AND INSTALL 2-\$12 + 1-\$12 CND IN 3/4"C. FROM HAULER ACCESS CONTROL PANEL TO NEW PLC CONTROL CABINET FOR GREASE HIGH pH ALARM SIGNAL
- PROVIDE AND INSTALL 2/C-#18 TWISTED SHIELDED CABLE (BELDEN 8780) IN 1-1/4" CONDUIT FROM NEW SCREEN/COMPACTOR CONTROL PANEL TO MOTOR CONTROL CENTER (MCC-SEP) CUBICLE 2A FOR 40 HP GREASE PUMP VFD SPEED CONTROL
- PROVIDE AND INSTALL 2-\$12 THWN CU + 1-\$12 THWN CU GND IN 3/4" CONDUIT FROM SCREEN/COMPACTOR CONTROL PANEL TO MOTOR CONTROL CENTER (NCC-SEP) CUBICLE 2A FOR 40 HP GREASE PUMP VFD FOR VFD RUN SIGNAL.
- PROVIDE AND INSTALL 3-\$12 + 1-\$12 GND IN 3/4°C. FROM SEPTAGE UNIT CONTROL PANEL TO NOTOR CONTROL CENTER (MCC-SEP) FOR SEPTAGE CONTROL PANEL 480V POWER.
- PROVIDE AND INSTALL 3-\$12 + 2-\$12 (MOTOR THERMOSTAT) + 1-\$12 GND IN 3/4°C. FROM SCREEN DRIVE DISCONNECT TO CONTROL PANEL PROVIDE FLEXIBLE SEALTITE CONNECTION TO MOTOR.
- PROVIDE AND INSTALL 8-\$14 + 1-\$14 GND IN 3/4°C. FROM PB STATION TO SEPTAGE UNIT CONTROL PANEL CONTRACTOR TO VERIFY CONDUCTOR QUANTITIES WITH RAKE MANUFACTURER.
- MANUFACTURER.

 (2) PROVIDE AND INSTALL 2-\$12 + 1-\$12 CND IN 3/4°C. FROM SEPTAGE UNIT CONTROL PANEL TO PRESS SPRAY WASH SOLEROID VALVE FOR SOLEHOID VALVE OPEN/CLOSE CONTROL.
- CONTROL

 22) PROVIDE AND INSTALL 2-\$12 + 1-\$12 GND IN 3/4°C. FROM SEPTAGE UNIT CONTROL PANEL TO PRESS DRAIN FLUSH SOLENOID VALVE FOR SOLENOID VALVE OPEN/CLOSE CONTROL
- CONTROL.

 (23) PROVIDE AND INSTALL 4-\$12 + 1-\$12 GND IN 3/4°C. FROM SEPTAGE UNIT CONTROL PANEL TO START LEVEL FLOAT SWITCH AND HIGH LEVEL FLOAT SWITCH.
- (4) PROVIDE AND INSTALL 6-\$12 + 1-\$12 CND IN 3/4°C. FROM SEPTAGE UNIT CONTROL PANEL TO NEW PLC CONTROL CABINET FOR SCREEN RUNNING, SCREE FAULT AND PANEL LEVEL SIGNALS.
- PROVIDE AND INSTALL 3-\$12 + 1-\$12 GNO IN 3/4°C. FROM DEWATERING SCREW PRESS CONTROL PANEL TO MOTOR CONTROL CENTER (MCC-SEP) FOR DEWATERING SCREW PRESS CONTROL PANEL 480V POWER.
- PROVIDE AND INSTALL 3-\$12 + 1-\$12 GND IN 3/4°C. FROM DEWATERING SCREW PRESS CONTROL PANEL TO TRANSFER PUMP No. 1 FOR TRANSFER PUMP No. 1 480V POWER
- PROVIDE AND INSTALL 3-\$12 + 1-\$12 GND IN 3/4°C. FROM DEWATERING SCREW PRESS CONTROL PANEL TO TRANSFER PUMP No. 2 FOR TRANSFER PUMP No. 2 480V POWER.
- PROVIDE AND INSTALL 30-\$12 + 1-\$12 CND IN 1-1/4°C. FROM DEWATERING SCREEN PRESS CONTROL PANEL TO NEW PLC CONTROL CABINET FOR DEWATERING RUNNING, DEWATERING ALARM, POLYMER RUNNING, POLYMER ALARM, TRANSFER PUMP No. 1 RUNNING, TRANSFER PUMP No. 1 N HAID, TRANSFER PUMP No. 2 IN AUTO SIGNALS (INCLUDES 8 SPARES).

 IN AUTO, TRANSFER PUMP No. 2 RUNNING, TRANSFER PUMP No. 2 FAULT, TRANSFER PUMP No. 2 IN AUTO SIGNALS (INCLUDES 8 SPARES).
- PROVIDE AND INSTALL TWO (2) 2/C-#18 TWISTED SHIELDED CABLES IN 1°C. FROM DEWATERING SCREEN PRESS CONTROL PANEL TO NEW PLC CONTROL CABINET FOR TRANSFER PUMP No. 1 SPEED REFERENCE AND TRANSFER PUMP No. 2 SPEED REFERENCE RESPECTIVELY.

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APPROVED

O.C.

- (30) PROVIDE AND INSTALL 7-\$12 + 1-\$12 CND IN 3/4°C. FROM SCREEN/COMPACTOR CONTROL PANEL TO INLET VALVE FOR VALVE CONTROL AND STATUS MONITORING
- (31) PROVIDE AND INSTALL 4-\$12 + 1-\$12 GND IN 3/4°C. FROM SEPTAGE UNIT CONTROL PANEL TO INLET VALVE FOR VALVE CONTROL AND STATUS MONITORING.

SEWRF SEPTAGE/ GREASE RECEIVING STATION



MANATEE COUNTY
DEPARTMENT OF PUBLIC WORKS
UTRITIES DEPARTMENT

(941) 792-8811



CLEARWATER
300 PANK PLACE SLVD, STE 300, CLEARWATER PLED'SD TEL
(727) 131-300. SCOTS-811-4114
www.smithum.fr. Confidence of Antiquistry No. 27818


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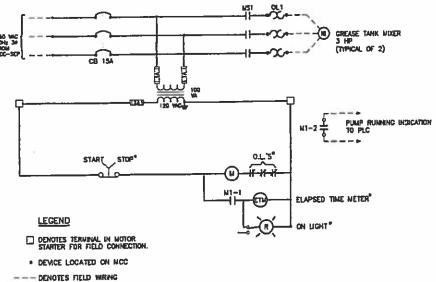
SEPTAGE RECEIVING STATION EQUIPMENT WIRING SCHEMATICS

RECORD DRAWINGS

PROJECT NO: 00183-009-02 DATE: MARCH 2015

SHEET NO: E-13



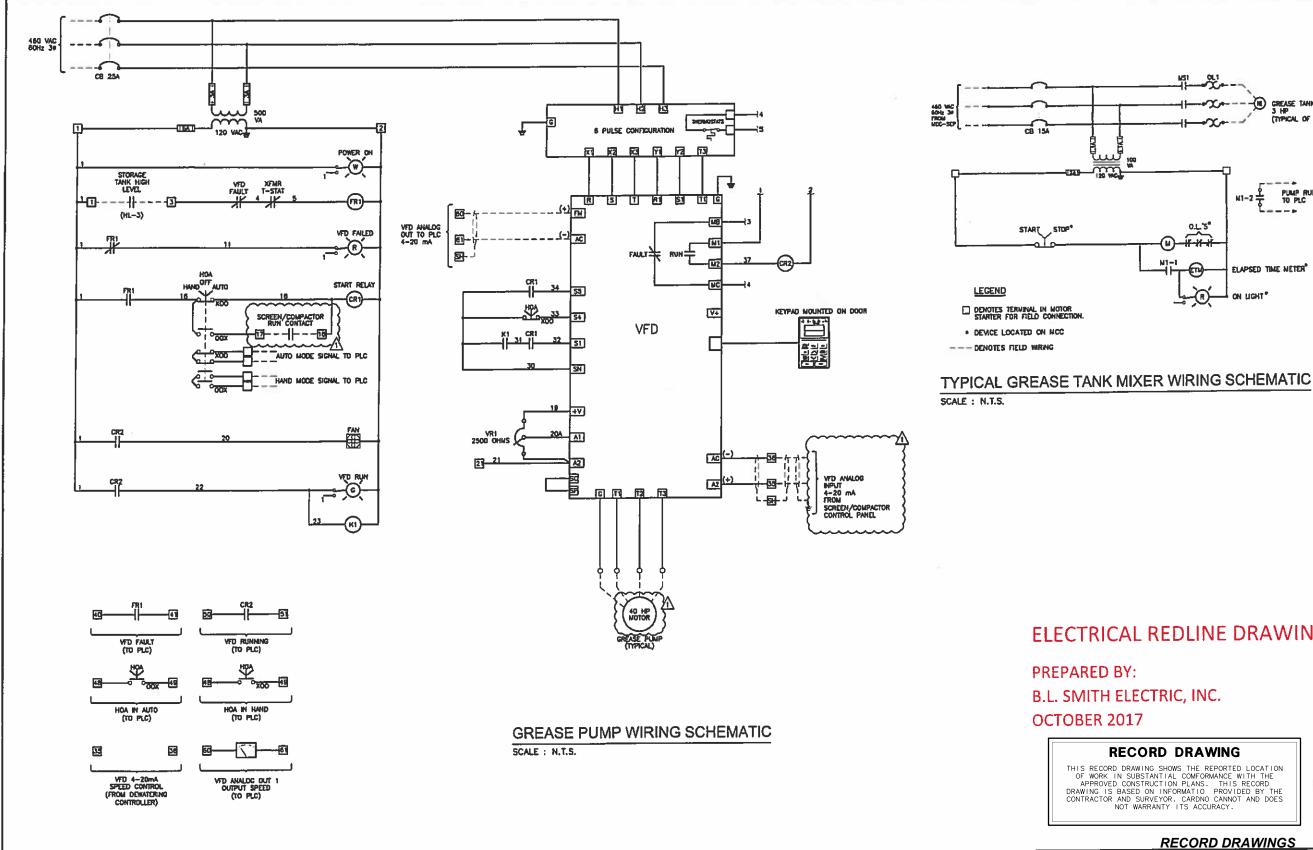

ELECTRICAL REDLINE DRAWINGS

PREPARED BY: B.L. SMITH ELECTRIC, INC. OCTOBER 2017

RECORD DRAWING

THIS RECORD DRAWING SHOWS THE REPORTED LOCATION OF WORK IN SUBSTANTIAL COMFORMANCE WITH THE APPROVED CONSTRUCTION PLANS. THIS RECORD DRAWING IS BASED ON INFORMATIO PROVIDED BY THE CONTRACTOR AND SURVEYOR. CARDNO CANNOT AND DOES NOT WARRANTY ITS ACCURACY.



RECORD DRAWINGS

RECORD DRAWING 12/2017 A FIBER OPTIC COMMUNICATIONS REVISION NO. DESCRIPTION TDT 10-6-16 BY DATE

SEWRF SEPTAGE/ GREASE RECEIVING STATION



MANATEE COUNTY DEPARTMENT OF PUBLIC WORKS UTILITIES DEPARTMENT 410 68th Street West Bradenton, Plonice 34210 (941) 792-8811



200 PARKACE MLVD, STE 300, CLEARWATER, FL 33759 TID.: (727) 531-3206 (800) 891-6314 www.aerdis.com Christian of Autoristics No. 23918

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		O.C.	
			_
TIMOTHY THOMAS, PE	DATE	APPROVE	D
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SEPTAGE RECEIVING STATION **GREASE PUMP AND MIXER WIRING SCHEMATIC**

ROJECT NO: 00193-009-02 MARCH 2015 SHEET NO:

E-14

DUCTBANK 'A' SECTION REMOVED

- Power feed duct bank to Blower Bldg. encased per this detail DUCTBANK SECTION 'B' B

SCALE : NTS. DUCTBANK 'B' SCHEDULE :

A. 2°C. WITH 3-3/0 THWN CU + 1-#6 THWN CU GNO.

HANDHOLE DETAIL REMOVED






DUCTBANK SECTION 'C'

SCALE : N.T.S.



DUCTBANK "C" SCHEDULE :

- A. 2°C. WITH 3-3/0 THWN CU + 1-76 THWN CU GND.
- B. 2°C. WITH 12 COUNT SHOLE-MODE FIBER OPTIC CABLE.

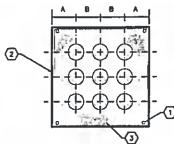

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DUCTBANK CONDUIT SPACING DIMENSION SCHEDULE

ED NOTES:

- #4 REBARS (TYPICAL). #4 HOOP AT 24" O.C.. CONCRETE ENCASEMENT
- GENERAL NOTES :
- 1. DUCTBANK SHALL BE INSTALLED AT A MINIMUM OF 24" BELOW FINISHED GRADE
- 2. CONCRETE SHALL BE 3000 PSI MINIMUM COMPRESSION STRENGTH.
- 3. DUCTBANKS MAY BE REARRANGED FOR CONVENIENCE OF EGRESS.

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PANEL 'LPS' SQUARE		; 120/	208 VC	LTS, 3	s, 4W			P WAIN Breakt	: н			AIC R			NSTALLED IN MCC. 10P AT 5'-6" AFF
		UT BRE	AKER	10	/A/PHA	SE	CIRC.	CIRC.	10	A/PHA	SE		urt ar		EQUIPMENT SERVED
EQUIPMENT SERVED	POLE	AMPS	TRAME	A	8	C	NO.	NO.	A	8_	C_	POLE		FRAME	THE PERSON LANGUAGE
MEST SEPTAGE LICHTHIG	1	20	908	0.5			1	2	0.6				20	008	CREASE CHAOPY LIGHTING
EAST SEPTAGE LICHTING	1 1	20	000		0.5		3	. 4		0.5			20	008	VACUUM TRUCK LIGHTING WEST SEPEACE HAULER ACCESS
DEWATERING CANOPY LIGHTING	1	20	008			0.4	5	- 6			0.5	<u> </u>	20	008	CREASE HALLER ACCESS
PLC CONTROL CABINET	1	20	908	0.5			7	-8-	0.5			1	20	000	EAST SEPTAGE HAULER ACCESS
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FIBER OPTIC CABINET	1	20	908			0.8	11	12			<u> </u>	1	20	008	SPARE
FIBER OPTIC CABINET] 1	20	008	0.4			13	14	<u> </u>			1	20		SPARE
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ELECTRICAL REDLINE DRAWINGS

PREPARED BY: B.L. SMITH ELECTRIC, INC OCTOBER 2017

RECORD DRAWING

THIS RECORD DRAWING SHOWS THE REPORTED LOCATION OF WORK IN SUBSTANTIAL COMFORMANCE WITH THE APPROVED CONSTRUCTION PLANS. THIS RECORD DRAWING IS BASED ON INFORMATIO PROVIDED BY THE CONTRACTOR AND SURVEYOR. CARDNO CANNOT AND DOES NOT WARRANTY ITS ACCURACY.



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	RECORD DRAWING		12/2017	İ
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SEWRF SEPTAGE/ GREASE RECEIVING STATION



MANATEE COUNTY DEPARTMENT OF PUBLIC WORKS UTILITIES DEPARTMENT 86th Street West Bradenton, Florida 3421 (941) 792-8811




· · · · · · · · · · · · · · · · · · ·	DESIGNED
	DRAWN
	a.c.
TIMOTHY THOMAS PE DATE	APPROVED.
LIC, NO. 470 ₇₀	

RECORD DRAWINGS SEPTAGE RECEIVING STATION **DETAILS AND PANEL SCHEDULE**

	PROJECT NO:
1	00193-009-02
	DATE:
	MARCH 2015
	SHEET NO:
	E-15

FUNCTION SYMBOL SCHEDULE

		IDENTI	ICATION LETTER	S	_
	FIRST L	ETTER		SUCCEEDING LETTERS	
	MEASURED OR INITIATING VARIABLE	MODIFIER	READOUT OR PASSIVE FUNCTION	OUTPUT FUNCTION	MODIFIER
A	ANALYSIS		ALARM		
B	BURNER, COMBUSTION		PROGRAMMER		
C	CONDUCTIVITY			CONTROL	CLOSED
D	DENSITY	DIFFERENTIAL	H		
Ē	VOLTAGE		SEASOR (PRIMARY ELEMENT)		
F	FLOW RATE	RATIO (FRACTION)	25.00		
G	GAGING		CLASS VIEWING DEVICE		
Н	HANO]		HICH
1	(ELECTRICAL)		INDICATE		
j	POWER	SCAN			
ĸ	TIME, TIME SCHEDULE	TIME RATE OF CHANGE		CONTROL STATION	
L	LEVEL.		UCHT (PLOT)		FOM
М	NOTOR	MOMENTARY			MIDOLE, INTERMEDIATE
N	VIBRATION		IGNITOR	ISOLATOR	
0	OPERATION	OFFSET	ORIFICE, RESTRICTION		OPEN
P	PRESSURE, VACUUM		POINT (TEST) CONNECTION		
Q	QUANTITY, EVENT	INTEGRATE, TOTALIZE	INTEGRATE		<u> </u>
R	RADIATION		RECORD, PRINT		
5	SPEED, FREQUENCY	SAFETY		SWITCH	
Т	TENPERATURE	<u> </u>		TRANSMIT	
Ų	MULTIVARIABLE	TREND	MULTIFUNCTION	MULTIFUNCTION	MULTIFUNCTIO
٧	VISCOSITY	VACUUM		VALVE, DANIPER, LOUVER, GATE	
W	WEIGHT, FORCE, TORQUE		WELL		
X	UNCLASSIFIED		UNCLASSIFIED	UNCLASSIFIED	UNCLASSIFIED
Y				RELAY, COMPUTE, CONVERT	
2	POSITION			FINAL CONTROL ELEMENT	UNCLASSIFIET

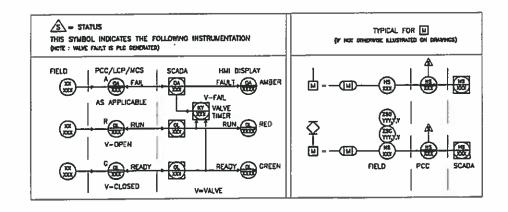

MISCELLANEOUS NOTATIONS LINE DESIGNATIONS S/D = SHUTDOWN INSTRUMENTATION SIGNAL ---FLECTRICAL POWER MCS - MASTER CONTROL STATION DATA LINK -p--p-VITO - VARIABLE FREQUENCY DRIVE RAZIO LINX -R-R-PCC - PROCESS CONTROL CABINET FIBER OPTIC DATA LCP = LOCAL CONTROL PANEL ES = ELECTRICAL SUPPLY (120VAC) CONTROLLER NOTATION **EQUIPMENT NOTATION** PV= PROCESS VARIABLE INPUT B - BLOWER OR FAN SP = SET POINT IMPUT E = ENGINE C= CONTROL OUTPUT G = GENERATOR INPUT/OUTPUT NOTATIONS F = FILTER GS = GRINDER/SCREEN AI - ANALOG INPUT K = COMPRESSOR AD = AVALOG OUTPUT H - HOIST DI = DISCRETE INPUT ME - NECHANICAL EQUIPMENT DO = DISCRETE OUTPUT MX = MIXER T = TANK OR SUMP HAND SWITCH NOTATION VALVE DESIGNATIONS HOA = HAND-OFF-AUTO S/S = START/STOP MOV = MOTOR OPERATED VALVE SEL - SELECTOR

O/C - OPEN/CLOSE GENERAL ABBREVIATIONS 0/0 = OH/OFFLOS - LOCKOUT-START

SCADA - SUPERMISORY CONTROL AND DATA ACQUISITION. LOR = LOCAL-OFF-REMOTE PLC - PROGRAMMABLE LOGIC CONTROL CAO = CLOSED-AUTO OPEN SA - SURGE SUPPRESSOR DEVICE

(I) INTERLOCK

MUTIPLE

FUNCTION

DAG = OPEN-AUTO CLOSE

OR

OR

BASIC SYMBOLS

SINGLE FUNCTION CONTINUATION OF SIGNAL OR DATA TO/FROM SHEET NUMBER INDICATED

FIELD MOUNTED INSTRUMENT OR DEVICE FRONT OF PANEL MOUNTED INSTRUMENT ON LCP, PCC, MCS, OR VFD Θ OR REAR OF PANEL MOUNTED INSTRUMENT ON LCP, PCC, MCS, OR VFD Θ 0R FRONT OF PANEL MOUNTED INSTRUMENT ON MAIN PANEL Θ OR REAR OF PANEL MOUNTED INSTRUMENT ON MAIN FANEL Θ

PLC AND/OR COMPUTER GENERATED COMPONENT (NOT OPERATOR ACCESSIBLE UNDER NORMAL OR

(OPERATOR ACCESSIBLE UNDER NORMAL

DATA FLOW SYSTEMS RTU INPUT/OUTPUT

ELECTRICAL REDLINE DRAWINGS

PREPARED BY: B.L SMITH ELECTRIC, INC. OCTOBER 2017

RECORD DRAWING

THIS RECORD DRAWING SHOWS THE REPORTED LOCATION OF WORK IN SUBSTANTIAL COMFORMANCE WITH THE APPROVED CONSTRUCTION PLANS. THIS RECORD DRAWING IS BASED ON INFORMATIO PROVIDED BY THE CONTRACTOR AND SURVEYOR. CARDNO CANNOT AND DOES NOT WARRANTY ITS ACCURACY.



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SEWRF SEPTAGE/ GREASE RECEIVING STATION



MANATEE COUNTY DEPARTMENT OF PUBLIC WORKS UTILITIES DEPARTMENT Street West Bredenton, Florida 3421 (941) 792-8811




Q.C. APPROVED

DESIGNED

DRAWN

RECORD DRAWINGS INSTRUMENTATION AND **CONTROLS LEGEND**

ROJECT NO: 00193-009-02 MARCH 2015 SHEET NO: 1-1

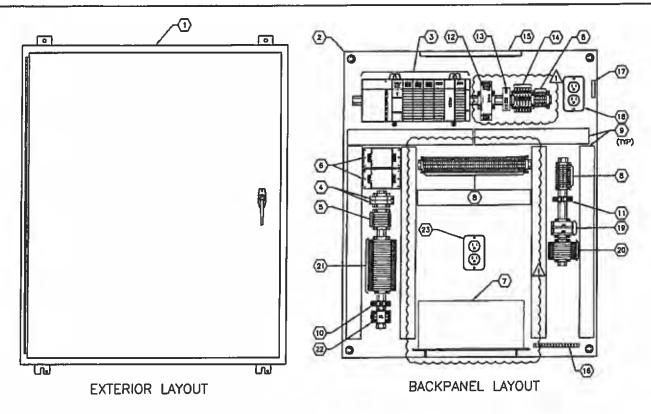

SEPTAGE RECEIVING STATION PLC CONTROL CABINET ELEVATION SCALE: N.T.S.




KEYED NOTES:

- PROVIDE AND INSTALL 42" X 36" X 12", 316 STAINLESS STEEL ENCLOSURE, INCLUDE BACKPANEL, PAD-LOCKABLE 3-POINT LATCH, DEADFRONT INTERIOR DOOR AND DOOR-STOP KIT.
- 2) PROVIDE AND INSTALL CONTROL CABINET 42° X 36° BACKPANEL.
- PROVIDE ALLEN-BRADLEY PLC, PROCESSOR: 1747-LB32; THREE (3) A/C INPUT MODULES: 1748-IA18; A/C OUTPUT MODULE: 1748-OXB; AVALOG INPUT MODULE: 1748-NB; POWER SUPPLY: 1746-P2; 7-SLOT RACK: 1746-A7; BLANK FILLER: 1748-M2.
- PROMDE AND INSTALL 120V CIRCUIT BREAKERS. 15 AMPERE SQUARE-D QUUITS AS REQUIRED.
- (B) PROMDE AND INSTALL 120V, THERMAL CIRCUIT BREAKERS. REFER TO POWER WIRING DIAGRAM FOR QUANTITY/SIZE, ALL THERMAL CIRCUIT BREAKERS SHALL BE PHOENIX CONTACT TCP TYPE.
- PROMDE AND INSTALL 120Y SURGE PROTECTION DEVICE, EDCD HSP1218T-1RU.

 (7) PROMDE AND INSTALL APC SMART-UPS 750VA LCD 120V US. PROVIDE SHELF TO KEEP UPS OFF BOTTOM OF ENCLOSURE.
- (B) PROVIDE AND INSTALL DIN-RAL MOUNTED TERMINAL BLOCKS, ALLEN-BRADLEY 1492-W1D.
- PROVIDE AND INSTALL 2"X2" PANDUIT (OR EQUAL) WRING SYSTEM WITH COVERS.
- (10) PROVIDE AND INSTALL SQUARE-D 8501 R SERIES RELAY, SINGLE-POLE, 120V AC COIL FOR NORMAL AC POWER LOSS SIGNAL PROVIDE RELAY BASE AND HOLD DOWN SPRING FOR RELAY PROVIDED.
- PROVIDE AND INSTALL SQUARE-D 8501 R SERIES RELAY. SINGLE-POLE, 24V DC COIL FOR 24V DC POWER LOSS SIGNAL PROVIDE RELAY BASE AND HOLD DOWN SPRING FOR RELAY PROVIDED.
- (12) PROVIDE AND INSTALL 120VAC-24VDC POWER SUPPLY WITH 5 AMPERE DUTPUT. PRIODINX CONTACT #2866750.

- PROVIDE AND INSTALL FIBER OPTIC MEDIA CONVERTER FOR PLC COMMUNICATIONS TYSTEM. OMNITRON 4701-1 WITH 1-MODULE 120V CHASSIS.
- PROMDE AND INSTALL FUSE TERMINAL BLOCKS FOR DC POWER SUPPLY, MEDI CONVERTER AND INTERCOMS, PHOEMIX CONTACT UK TYPE AS REQUIRED.
- (13) PROVIDE AND INSTALL 120V, BW, CABINET LIGHT, PRESCOUTE UCS12-1-08-PH-120-WSW. PROVIDE F8TS/CW LAMP AND BRACKET TO MOUNT FIXTURE TO BACKPANEL.
- (18) PROVIDE AND INSTALL EQUIPMENT GROUND ASSEMBLY.
- PROVIDE AND INSTALL LIMIT SWITCH FOR CABINET LIGHT, CUTLER HANNER E47BCC06.
- (18) PROVIDE AND INSTALL UTILITY DUPLEX GFI RECEPTACLE, HUBBELL, GFR5352IA OR FOLIAL.
- (19) PROVIDE AND INSTALL SIGNAL ISOLATOR/LOOP POWER UNITS. NOORE INDUSTRIES TYPE ECT, WITH 2-WIRE TRANSMITTER EXCITATION OPTION FOR PRESSURE TRANSMITTER LOOP POWER.
- (20) PROVIDE AND INSTALL ANALOG SURGE PROTECTION DEVICES AS REDURED. MTL
- (2) PROMIDE AND INSTALL DIGITAL SURGE PROTECTION DEVICES AS REQUIRED. WTL CATALOG § 50150K.
- PROVIDE AND INSTALL SQUARE-D 8501 R SERIES RELAY, 4-POLE, 120V AC COLL FOR HIGH TANK ALARM INTERLOCKS. PROVIDE RELAY BASE AND HOLD DOWN SPRING FOR BEAY PROVIDED.
- (3) PROVIDE AND INSTALL UPS DUPLEX GFI RECEPTACLE, HUBBELL, GFR5352IA OR EQUAL.

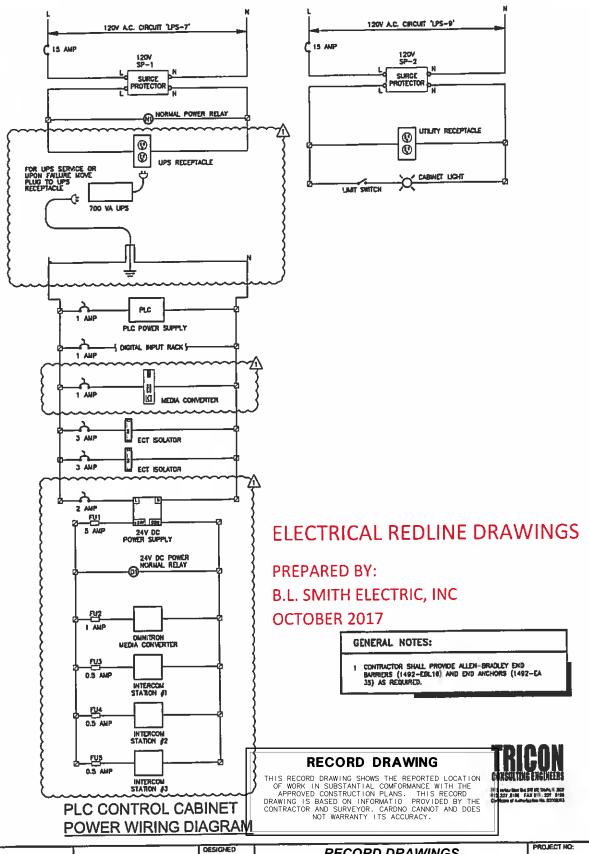

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SEWRF SEPTAGE/ GREASE RECEIVING STATION



MANATEE COUNTY
DEPARTMENT OF PUBLIC WORKS
UTILITIES DEPARTMENT
4410 Fifth Street West Bradenton, Florida 34210

(841) 792-8811




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		O.C.
TIMOTHY THOMAS PE	DATE	APPROVED
LIC. NO.: 47079	i	


RECORD DRAWINGS
SEPTAGE STATION PLC CONTROL
CABINET DETAILS

PROJECT NO: 00193-009-02 DATE: MARCH 2015 SHEET NO:


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PLC - DISCRETE INPUT CARD WIRING DIAGRAM

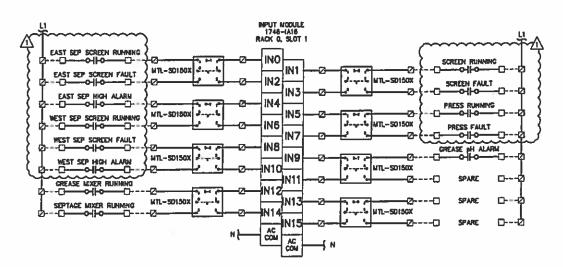


PLC - DISCRETE INPUT CARD WIRING DIAGRAM

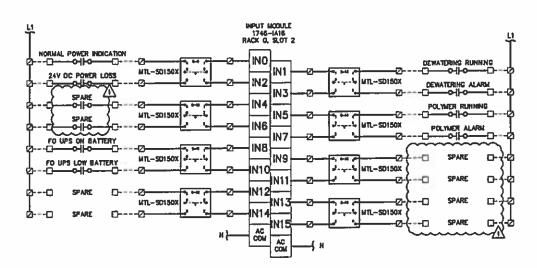

PLC - DISCRETE INPUT CARD WIRING DIAGRAM

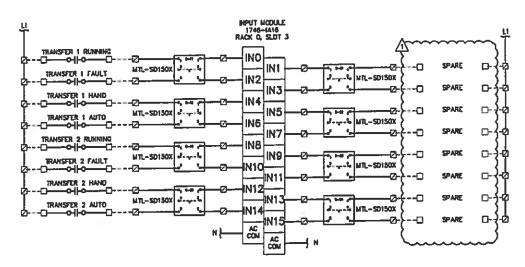ELECTRICAL REDLINE DRAWINGS

PREPARED BY:
B.L. SMITH ELECTRIC, INC.
OCTOBER 2017

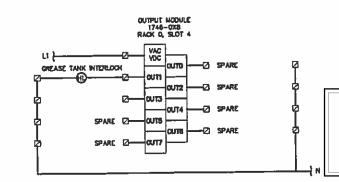

RECORD DRAWING

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PLC - DISCRETE OUTPUT CARD WIRING DIAGRAM

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SEWRF SEPTAGE/ GREASE RECEIVING STATION



MANATEE COUNTY
DEPARTMENT OF PUBLIC WORKS
UTILITIES DEPARTMENT
4410 65th Street West Brackenton, Florido 34210




CLEARWATER
300 PARK PLACE BLVG. STE 200, CLEARWATER PL 2015S TEL:
(727) \$31-200 (200) (01-214)
www.authologo (2016) (2016) (2016) (2016) (2016)

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		D.C.
OTHY THOMAS, PE	DATE	APPROVED

SEPTAGE STATION PLC CONTROL CABINET DISCRETE WIRING DIAGRAMS

PROJECT NO: 00193-009-02 DATE: MARCH 2015 SHEET NO: 1-3

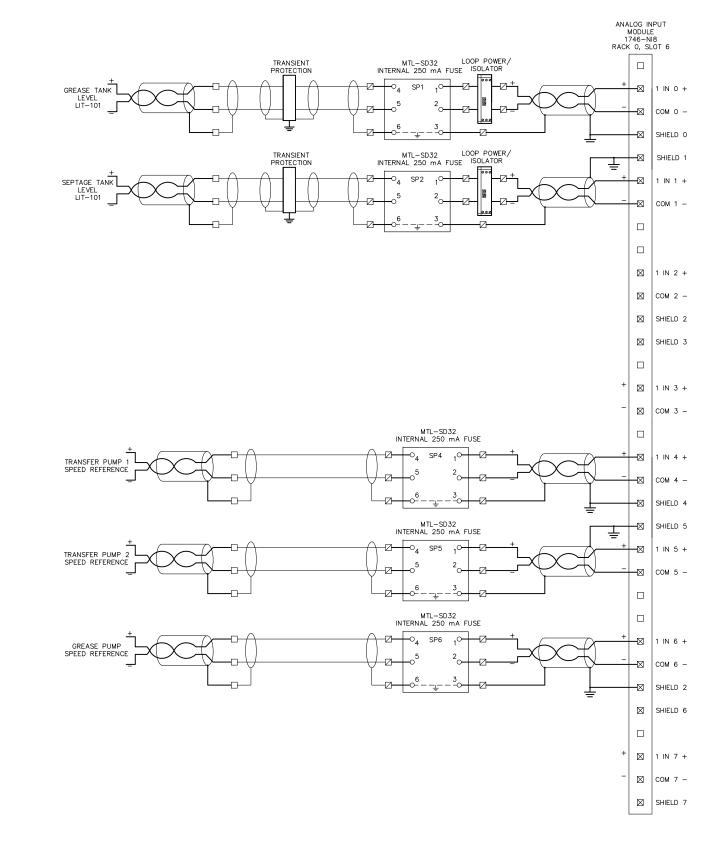

PLC - ANALOG INPUT CARD WIRING DIAGRAM

RECORD DRAWING

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RECORD DRAWINGS

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CLEARWATER
380 PARK PLACE BLVD, STE 300, CLEARWATER, FL 33759 TEL:
(727) 531- 3505 (800) 861-8314
www.cardno.com Certificate of Authorization No. 29915

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		TD
		DRAWN
		EA
		Q.C.
TIMOTHY THOMAS, PE	DATE	APPROVED
LIC. NO.: 47079		

SEPTAGE STATION PLC CONTROL CABINET ANALOG WIRING DIAGRAMS


PROJECT NO:
00193-009-02
DATE:
MARCH 2015
SHEET NO:
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ENCLOSURE & DEADFRONT LAYOUT

SEPTAGE RECEIVING STATION FIBER OPTIC CABINET ELEVATION

SCALE : N.T.S.



KEYED NOTES:

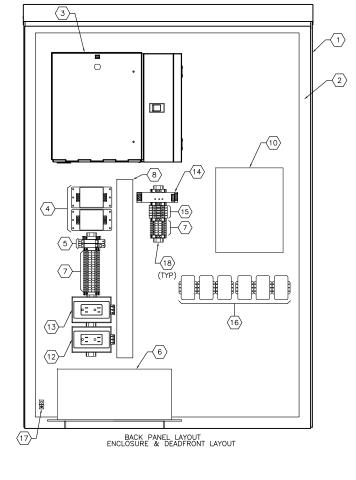- PROVIDE AND INSTALL 53" X 36" X 16", OMEGA SCE-53VR3616.
- PROVIDE AND INSTALL OMEGA SCE-48P36 BACKPANEL.
- PROVIDE WALL MOUNT CONNECTOR AND SPLICE HOUSING SIZED TO ACCOMMODATE FIBER OPTIC CABLE AND FIBER COUNT. CORNING WCH-02P OR APPROVED EQUAL. PROVIDE SPLICE TRAYS, SPLICE TRAY HOLDERS, STRAIN RELIEF KIT AND ALL REQUIRED ACCESSORIES.
- PROVIDE AND INSTALL 120V SURGE PROTECTION DEVICES. EDCO HSP121BT-1RU.
- (5) PROVIDE AND INSTALL 120V CIRCUIT BREAKERS. 15 AMPERE SQUARE-D QOU115.
- PROVIDE AND INSTALL APC SMART-UPS 750VA LCD 120V US. PROVIDE SHELF TO KEEP UPS OFF BOTTOM OF ENCLOSURE.
- PROVIDE AND INSTALL DIN-RAIL MOUNTED TERMINAL BLOCKS, ALLEN-BRADLEY

12/2017


- (8) PROVIDE AND INSTALL 2"X2" PANDUIT (OR EQUAL) WIRING SYSTEM WITH COVERS.
- 9 NOT USED.

- NEW CISCO 3560CX-12TC-S TO BE PROVIDED AND INSTALLED BY MANATEE COUNTY.
- $\langle 11 \rangle$ NOT USED.
- (12) PROVIDE AND INSTALL 120V, 20A DUPLEX RECEPTACLE. PHOENIX CONTACT #5600525,
- PROVIDE AND INSTALL 120V, 20A DUPLEX UTILITY RECEPTACLE. PHOENIX CONTACT
- PROVIDE AND INSTALL 120VAC-24VDC POWER SUPPLY 'PS1' WITH 3.5 AMPERE OUTPUT FOR INTERCOM SYSTEM 24V DC POWER. PHOENIX CONTACT #2866747.
- PROVIDE AND INSTALL FUSED TERMINAL BLOCK WITH LED INDICATOR, 24VDC. SQUARE D AB1FUSE435U5XB.
- PROVIDE AND INSTALL CAT 6 ETHERNET CABLE SURGE PROTECTION DEVICES. DITEK DTK-MRJPOE.
- PROVIDE EQUIPMENT GROUND LUG.
- PROVIDE ALUMINUM DIN-RAIL.

GENERAL NOTES:

CONTRACTOR SHALL PROVIDE ALLEN-BRADLEY END BARRIERS (1492-EBL16) AND END ANCHORS (1492-EA 35) AS REQUIRED.

ADMINISTRATION BUILDING FIBER OPTIC CABINET HAS BEEN DELETED FROM THE PROJECT

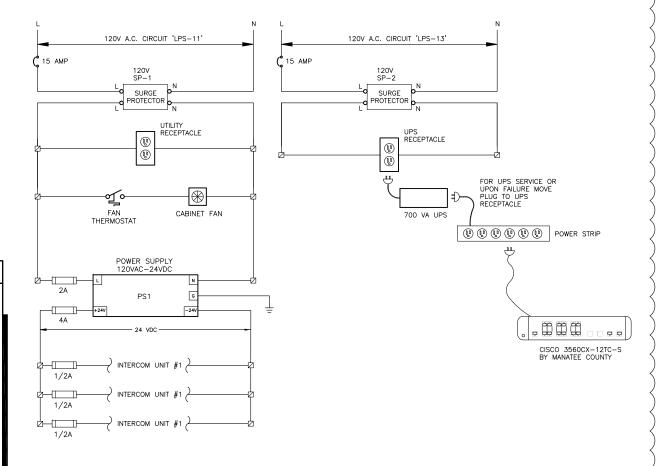


SEPTAGE RECEIVING STATION

FIBER OPTIC CABINET WIRING SCHEMATIC

RECORD DRAWING

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SEWRF SEPTAGE/ GREASE RECEIVING STATION

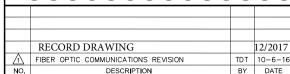

MANATEE COUNTY DEPARTMENT OF PUBLIC WORKS UTILITIES DEPARTMENT 66th Street West Bradenton, Florida 3421

(941) 792-8811



DRAWN TIMOTHY THOMAS, PE LIC. NO.: 47079 APPROVED

DESIGNED

RECORD DRAWINGS **SEPTAGE STATION AND ADMIN** FIBER OPTIC CABINET DETAILS 00193-009-02 MARCH 2016

BY DATE

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SHEET NO:

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RECORD DRAWING

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NO.	DESCRIPTION	BY	DATE

SEWRF SEPTAGE/ GREASE **RECEIVING STATION**





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380 PARK PLACE	BLVD, STE 300, CLEARWATER, FL 33759 TEL:
(727) 531- 3505	(800) 861-8314
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		DESIGNED
		TDT
		DRAWN
		EAK
		Q.C.
TIMOTHY THOMAS, PE LIC. NO.: 47079	DATE	APPROVED

RECORD DRAWINGS **SCADA PANEL 2 CONTROL CABINET DETAILS**

MARCH 20
DATE:
00193-009-
PROJECT NO:

SHEET NO:

I-6

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RECORD DRAWING

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	RECORD DRAWING		12/2017
Λ	FIBER OPTIC COMMUNICATIONS REVISION	TDT	10-6-16
NO.	DESCRIPTION	BY	DATE

SEWRF SEPTAGE/ GREASE RECEIVING STATION





3759 TEL:	
	TIMOTHY THOMAS, PE LIC. NO.: 47079

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PROPOSED SCADA SYSTEM FIBER OPTIC COMMUNICATION TOPOLOGY

ŘÉCORD DRAWINGS

	PROJECT NO:
₹	00193-009-02
	DATE:
	MARCH 2015
	SHEET NO:

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RECORD DRAWING

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Λ	FIBER OPTIC COMMUNICATIONS REVISION	TDT	10-6-16
NO.	DESCRIPTION	BY	DATE

SEWRF SEPTAGE/ GREASE RECEIVING STATION





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		ALS	
		Q.C.	
TIMOTHY THOMAS, PE LIC. NO.: 47079	DATE	APPROVED	

RECORD DRAWINGS
FIBER OPTIC
CONNECTION DIAGRAMS

PROJECT NO:
00193-009-02
DATE:
MARCH 2015
SHEET NO:

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