# MANATEE COUNTY S.W.R.W.T.P

## ADMINISTRATION BUILDING RENOVATIONS

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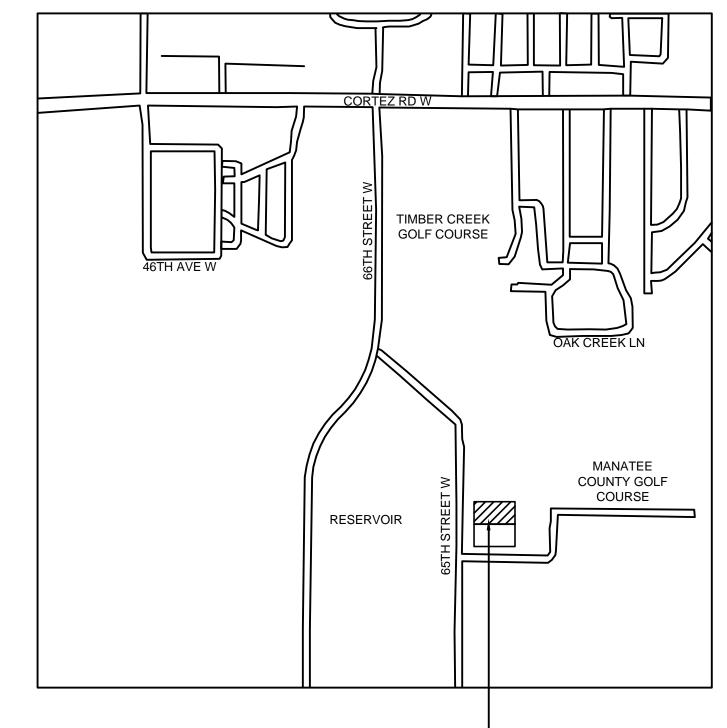
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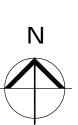
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ADMINISTRATION BUILDING LOCATION 4410 66TH STREET WEST BRADENTON, FLORIDA

SITE LOCATION MAP

ISSUED FOR BIDDING DECEMBER 8, 2008

**URS Corporation Southern** 7650 West Courtney Campbell Causeway Tampa, FL 33607-1462 No. 00000002

LENGTH

1. ABBREVIATIONS APPLY TO DRAWING SHEETS. ADDITIONAL ABBREVIATIONS NOT NOTED BELOW MAY OCCUR ON OTHER DRAWING SHEETS.

2. WORDS MAY OCCUR AS ABBREVIATIONS OR SPELLED OUT IN FULL.

3. THE CONTRACTOR SHALL BE FAMILIAR WITH THE ABBREVIATIONS AS LISTED BELOW.

<ul><li>3. THE CONTRACTOR SHALL BE FA</li><li>4. ABBREVIATIONS FOLLOWED BY A</li></ul>			
AIR CONDITIONING UNIT	ACU	LIGHTING	LTG
AIR CONDITIONING  ABOVE FINISH FLOOR	A/C	LINEAR	LIN
ADDITIONAL	AFF ADDNL	LINEAR FEET LONG	LF LG
ALUMINUM	ALUM	MATERIAL	MATL
ANCHOR ANCHOR BOLT	ANC AB	MANUFACTURER	MANUF
ASPHALT	ASPH	MAXIMUM MEAN SEA LEVEL	MAX MSL
AUXILIARY	AUX	MECHANICAL	MECH
AVERAGE BETWEEN	AVG B/W	MEDIUM METAL	MED MTL
BLOCK	BLK	MINIMUM	MIN
BOTTOM	BOT OR B	MISCELLANEOUS	MISC
BUILDING BUILDING LINE	BLDG BL	NORTH/NORTHING NORTHEAST	N NE
CAST IRON	CI	NORTHWEST	NW
CENTERLINE	CL	NOT APPLICABLE	N/A
CENTER TO CENTER CEILING HEIGHT	C TO C CH	NOT IN CONTRACT NOT TO SCALE	NIC NTS
CIRCUIT	CKT	NUMBER	NO OR #
CLEARANCE	CLR	ON CENTER	0/C
COLUMN CONCRETE	COL CONC	OPPOSITE OUTSIDE DIAMETER	OPP OD
CONCRETE MASONRY UNIT	CMU	OVERHEAD	OH
CONSTRUCTION CONTROL JOINT	CONST CJ	PANEL	PNL
CONTINUOUS	CONT	PAVEMENT PERCENT	PVMT %
COPPER	CU	PLATE	PL
CUBIC INCH DETAIL	CI DET	POLYVINYL CHLORIDE	PVC
DIAMETER	DIA OR Ø	POUNDS POUNDS PER SQUARE INCH	LBS PSI
DIAGONAL	DIAG	PRESSURE TREATED	PT
DIMENSION DISTANCE	DIM DIST	RADIUS	RAD OR
DOWN	DN	REFERENCE REINFORCING	RE REINF
DRAWING	DWG	REINFORCING BAR	REBAR
DRIVE EACH	DR EA	REQUIRED	REQD
EACH WAY	EW	REVISED ROOF DRAIN	REV RD
EAST/EASTING	E OD ELEV	ROADWAY	RDWY
ELEVATION ELECTRICAL	EL OR ELEV ELEC	ROOM SCHEDULE	RM SCH
EQUIPMENT	EQUIP	SECOND	SEC
EQUAL EXHAUST FAN	EQ EX	SECTION	SECT
EXISTING	EXIST	SHEET SIDEWALK	SHT S/W
EXPANSION JOINT	EJ	SIMILAR	SIM
EXPOSED STRUCTURE EXTERIOR	EXP STR EXT	SOUTH SOUTHEAST	S SE
FEEDER	FDR	SOUTHWEST	SW
FEET	FT	SPECIFICATION	SPEC
FINISH FLOOR ELEVATION FIRE EXTINGUISHER	FFE FE	SQUARE SQUARE FEET	SQ OR SF
FLOOR	FL	STANDARD	STD
FLOOR DRAIN	FD	STAINLESS STEEL	SS
FOOT FOOTING	FT FTG	STEEL STIRRUP	STL STR
GALVANIZED	GALV	STREET	ST
GAS GAS METER	G GM	SWITCH SYMMETRICAL	SWT
GLAZING	GLZ	TANGENT	SYM TAN
GRADE	GR	TELEPHONE	TELE
GROUND GROUND FAULT INTERRUPTER	GND GFI	TEMPORARY THICKNESS	TEMP THK
GYPSUM BOARD	GYP BD	TOP AND BOTTOM	T/B
HEATER VENT	HV	TOP FACE	T/F
HEIGHT HIGH INTENSITY DISCHARGE	HT HID	TOP OF CONCRETE TOP OF CURB	T/C TC
HORIZONTAL	HORIZ	TOP OF SLAB	T/S
HEIGHT	HT	TOP OF STEEL	T/STL
INSIDE DIAMETER INCH	ID IN	TYPICAL UNLESS NOTED OTHERWISE	TYP UNO
INFORMATION	INFO	UNDERWRITERS LABORATORIES INC	UL
INSIDE DIAMETER INVERT	ID INV	VARIABLE VENT THRU BOOF	VAR
IRON PIPE	IP	VENT THRU ROOF VERIFY IN FIELD	VTR VIF
JOINT JUNCTION BOX	JT IR	VERTICAL	VERT
KIPS	JB K	WATER LINE WIDTH	WL W
KIPS PER SQUARE INCH	KSI	WITH	W/
KILOVOLT-AMPERES LIGHT	KVA LT	WITHOUT	W/O
LIGHTWEIGHT	LT WT	WOOD	WD
LENGTH			

#### **GENERAL PROJECT NOTES**

- 1. GENERAL NOTES APPLY TO ALL DRAWINGS AND SPECIFICATIONS.
- 2. ALL CONSTRUCTION SHALL COMPLY WITH ALL APPLICABLE CODES AND LOCAL REGULATIONS.

3. THE CONTRACTOR SHALL TAKE ALL NECESSARY PRECAUTIONS AND IMPLEMENT NECESSARY MEASURES TO ENSURE THE SAFETY OF ALL PERSONS ON SITE, VISITING THE SITE, WORKING ON THE SITE, AND THOSE MUNICIPAL EMPLOYEES REMAINING IN THE EXISTING ADMINISTRATION BUILDING PHASE II RENOVATIONS OF THE EXISTING ADMINISTRATION BUILDING.

4. THE CONTRACTOR SHALL FULLY BRACE AND OTHERWISE PROTECT WORK IN PROGRESS UNTIL PHASE II CONSTRUCTION IS COMPLETE.

5. THE CONTRACTOR SHALL BE RESPONSIBLE FOR ALL STATE AND LOCAL PERMITTING AND ASSOCIATED FEES. DO NOT OBSTRUCT STREETS, SIDEWALKS, OR OTHER RIGHT-OF-WAYS WITHOUT FIRST OBTAINING PROPER PERMITS AND NOTIFYING OWNER'S REPRESENTATIVE.

6. THE CONTRACTOR SHALL BE RESPONSIBLE FOR ALL SECURITY OF THE PORTION OF THE SITE CONTROLLED BY THIS CONTRACT, 24 HOURS PER DAY, WHILE THE JOB IS IN PROGRESS AND UNTIL THE PROJECT IS OFFICIALLY DECLARED SUBSTANTIALLY COMPLETE.

- 7. ALL DEBRIS SHALL BE REMOVED FROM THE SITE AND DISPOSED OF OFF SITE, IN COMPLIANCE WITH ALL APPLICABLE LAWS AND REGULATIONS.
- 8. THE CONTRACTOR SHALL NOT DETERMINE THE SIZE OF CONSTRUCTION BY MEASURING WITH A SCALE OBJECTS REFERENCED IN THE DRAWINGS.
- 9. THE CONTRACTOR SHALL FIELD VERIFY ALL CONDITIONS AND DIMENSIONS PRIOR TO COMMENCING ANY WORK AND SHALL BE RESPONSIBLE FOR COORDINATION OF ALL DIMENSIONS, WORK, AND MATERIALS REQUIRED.

10. THE CONTRACTOR SHALL REPORT TO THE ARCHITECT ANY ERROR, INCONSISTENCY, OR OMISSION DISCOVERED PRIOR TO THE START OF CONSTRUCTION. THE CONTRACTOR SHALL BE RESPONSIBLE FOR CORRECTING ANY ITEM(S) OF CONSTRUCTION NOT CONFORMING TO THE CONSTRUCTION DOCUMENTS IF AT THE START OF CONSTRUCTION IF SUCH AN ITEM WAS NOT PREVIOUSLY BROUGHT TO THE ATTENTION OF THE ARCHITECT. THE MEANS OF CORRECTION SHALL FIRST BE REVIEWED & APPROVED BY THE ARCHITECT.

11. IT SHALL BE THE RESPONSIBILITY OF THE CONTRACTOR TO LOCATE ALL EXISTING ABOVE & BELOW GROUND UTILITIES WITHIN CONTRACT LIMITS & PROTECT THEM FROM DAMAGE DURING THE COURSE OF THIS CONSTRUCTION. THE CONTRACTOR SHALL BEAR ALL EXPENSE OF, AND RESPONSIBILITY FOR, REPAIR OR REPLACEMENT OF UTILITIES OR OTHER PROPERTY DAMAGE CAUSED BY HIS OPERATIONS & SUBCONTRACTORS. UTILITIES DEACTIVATED OR ABANDONED IN PLACE BY THIS PROJECT SHALL BE CAPPED OR SEALED OFF IN ACCORDANCE WITH LOCAL REGULATIONS.

12. THE OWNER SHALL BE RESPONSIBLE FOR PROVIDING THE CONTRACTOR WITH ROUGH-IN INFORMATION NECESSARY TO ACCOMMODATE THE INSTALLATION OF ANY OWNER FURNISHED / INSTALLED OR OWNER FURNISHED / CONTRACTOR INSTALLED ITEMS. THE CONTRACTOR IS RESPONSIBLE FOR THE SCHEDULING AND SEQUENCING OF THE INSTALLATION OF THESE ITEMS.

13. CONDITIONS & ITEMS SHOWN IN SECTIONS & DETAILS APPLY TO ALL SIMILAR DRAWINGS UNLESS SPECIFICALLY NOTED OTHERWISE.

14. THE CONTRACTOR SHALL PROVIDE FOR OWNER/ARCHITECT REVIEW, STAGING PLAN & SECURITY FENCING PLAN FOR ALL MATERIAL STORED ON SITE, EQUIPMENT STORAGE AREA, PARKING AREA, PHASING AREAS AND OTHER AREAS DEFINED AS REQUIRED FOR THE CONTRACTOR'S EXCLUSIVE USE DURING CONSTRUCTION. THE CONTRACTOR MAY ERECT AND MAINTAIN AROUND THE PERIMETER SUITABLE FENCING, MARKING AND/OR WARNING DEVICES VISIBLE FOR DAY / NIGHT USE WITHIN CONTRACT LIMITS. DAMAGE TO EXISTING SURFACES OR FACILITIES WILL BE REPAIRED TO ORIGINAL STATE. REFER TO SPECIFICATIONS SECTION "TEMPORARY CONSTRUCTION FACILITIES". DESIGNATED PARKING FOR CONTRACTOR VEHICLES MUST BE INDICATED & SHALL BE AS APPROVED BY OWNER. CONTRACTOR SHALL BE RESPONSIBLE FOR TRAFFIC CONTROL AT CONSTRUCTION SITE AND SURROUNDING PUBLIC ROADWAYS. THE CONTRACTOR IS RESPONSIBLE FOR DAILY CLEAN UP OF ANY DEBRIS DEPOSITED IN THE CONSTRUCTION AREA & ALONG ANY ROUTE AS A RESULT OF THE CONSTRUCTION TRAFFIC.

15. ALL WASTE, RUBBLE AND WASTE DEBRIS MATERIALS FROM THE CONSTRUCTION SITE AND BUILDINGS SHALL BE DISPOSED OF OFF THE PROPERTY BY THE CONTRACTOR IN ACCORDANCE WITH STATE AND LOCAL LAWS & REQUIREMENTS.

16. THE CONTRACTOR & ALL SUBCONTRACTORS SHALL REFER TO & BECOME FAMILIAR WITH ALL CONSTRUCTION DRAWINGS & SPECIFICATIONS & BASE THEIR BIDS ON THE TOTALITY OF THE CONTRACT DOCUMENTS

17. AN INVENTORY OF ACOUSTICAL CEILING MATERIALS, CERAMIC FLOOR TILE, TOILET ACCESSORIES, TOILET FIXTURES. LABORATORY CASEWORK, WOOD DOORS AND ALUMINUM DOOR FRAMES EXISTS ON THE PROJECT AND IS CURRENTLY IN STORAGE. THIS INVENTORY IS NEW AND HAS BEEN PURCHASED BY THE OWNER UNDER A SEPARATE CONTRACT

- A. COORDINATE THE REQUIREMENTS OF THIS SECTION WITH THE OWNER FOR PROVIDING ADDITIONAL ACOUSTICAL CEILING MATERIALS, CERAMIC FLOOR TILE, TOILET ACCESSORIES, TOILET FIXTURES, LABORATORY CASEWORK, WOOD DOORS AND ALUMINUM DOOR FRAMES TO COMPLETE THIS PROJECT. REFER TO SECTION 01020 - OWNER'S ALLOWANCE FOR REQUIREMENTS REGARDING PAYMENT OF ADDITIONAL MATERIALS REQUIRED TO COMPLETE THIS WORK.
- B. ADDITIONAL ACOUSTICAL CEILING MATERIALS, CERAMIC FLOOR TILE, TOILET ACCESSORIES, TOILET FIXTURES, LABORATORY CASEWORK, WOOD DOORS AND ALUMINUM DOOR FRAMES USED TO COMPLETE THIS WORK, AS APPLICABLE, SHALL MATCH EXISTING INVENTORY IN MANUFACTURE, TYPE, STYLE AND COLOR.
- C. INSTALLATION OF ALL ACOUSTICAL CEILING MATERIALS, CERAMIC FLOOR TILE, TOILET ACCESSORIES, TOILET FIXTURES, LABORATORY CASEWORK. WOOD DOORS AND ALUMINUM DOOR FRAMES IS INCLUDED UNDER THE WORK OF THIS SECTION WHETHER USING EXISTING INVENTORY OR NEWLY FURNISHED.

#### **SECURITY NOTES**

1. ACCESS TO SITE: CONTRACTOR MUST COORDINATE WITH OWNER FOR ACCESS REQUIREMENTS FOR ALL EMPLOYEES AND EQUIPMENT OF THE CONTRACTOR AND SUBCONTRACTORS.

#### ACCESSIBILITY NOTES

1. ALL OCCUPIABLE ROOMS AND SPACES IN THE RENOVATED AREAS ARE PLANNED TO BE ACCESSIBLE TO PERSONS WITH DISABILITIES. SINKS SHALL HAVE PIPE PROTECTION.

#### WALL AND PARTITION NOTES

THE CONTRACTOR SHALL FURNISH AND INSTALL WOOD BLOCKING IN STUD PARTITIONS FOR ANCHORAGE OF WALL ATTACHED ITEMS, INCLUDING BUT NOT LIMITED TO THE FOLLOWING; GRAB BARS, VANITY UNITS, TOILET ACCESSORIES, HANDRAIL BRACKETS, WALL CABINETS, WALL MOUNTED FIXTURES, ETC.

#### REFLECTED CEILING PLAN NOTES

- 1. ALL RECESSED LIGHTS AND SMOKE OR THERMAL DETECTORS SHALL BE CENTERED IN ACOUSTICAL TILE UNLESS NOTED OTHERWISE.
- 2. CEILING HEIGHTS ARE AS NOTED IN THE ROOM FINISH SCHEDULE UNLESS DETAILED OTHERWISE.

#### MILLWORK NOTES

- 1. FIELD VERIFY ALL DIMENSIONS PRIOR TO FABRICATION.
- 2. BASE CABINETS TO BE 24' DEEP, WALL CABINETS TO BE 12" DEEP UNLESS NOTED OTHERWISE.
- 3. CLOSURE PANELS AND NAILERS TO BE PROVIDED BY MILLWORK MANUFACTURER.
- 4. BACK SPLASHES TO BE 4" HIGH WITH RETURNS ALONG ALL ADJACENT WALLS AS REQUIRED.
- 5. PROVIDE APPLIED BASE AT ALL MILLWORK UNITS.

#### FINISH NOTES


WHERE FLOOR FINISH CHANGES, SET JOINT UNDER THE CENTER OF DOOR.


#### EQUIPMENT / FURNISHINGS / SPECIALTIES NOTES

- 1. PROVIDE NEW FIRE EXTINGUISHERS AND BRACKETS OR CABINETS AT LOCATIONS SHOWN ON PLAN. DIMENSION NOTES
- 1. DIMENSIONS FOR DOOR OPENINGS ARE SHOWN NOMINAL. OPENING SHALL ALLOW FOR 1/4" SHIMMING AND SEALANT BEAD AROUND FRAMES.
- 2. ALL DIMENSIONS ARE ACTUAL AND ARE TO FACE OF METAL STUD OR FACE OF MASONRY WALLS, UNLESS NOTED OTHERWISE.

#### **ASBESTOS NOTE**

THE CONTRACTOR IS HEREBY NOTIFIED THAT THE BUILDING CONTAINS ASBESTOS; VINYL FLOOR TILE & MASTIC. THE CONTRACTOR SHALL REMOVE THE TILE & MASTIC IN ACCORDANCE WITH THE SPECIFICATIONS. THE CONTRACTOR IS RESPONSIBLE FOR PROTECTING THE WORKERS & PUBLIC IN ACCORDANCE WITH 29 CFR 1910.1001 ASBESTOS.

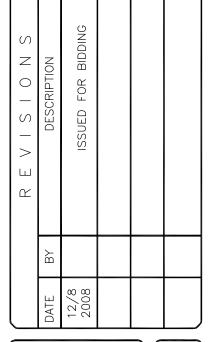

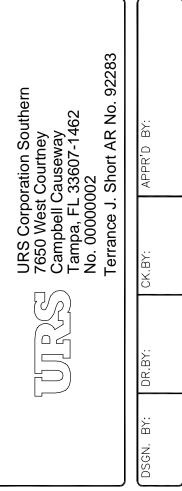


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#### SYMBOLS LEGEND





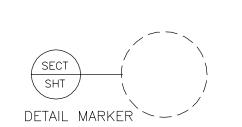

# WALL TYPE (SEE SHEET 2A6.3)

2G1.0

SHEET NO.

LIFE SAFETY PLAN

2A0.1 | SCALE: 1/8"= 1'-0"

#### CODE ANALYSIS

#### **APPLICABLE CODES**

- 2004 FLORIDA BUILDING CODE (FBC) WITH 2006 AMMENDMENTS
- AMERICANS WITH DISABILITIES ACT (FBC CHAPTER 11)
- 2004 FLORIDA MECHANICAL CODE
- 2004 FLORIDA PLUMBING CODE
- 2004 FLORIDA ELECTRICAL CODE
- 2003 NATIONAL FIRE PROTECTION ASSOCIATION (NFPA)

OCCUPANCY CLASSIFICATION

**FBC Reference Section** 

SECTION: 304.1

TYPE OF CONSTRUCTION

GROUP B - BUSINESS

23,000 SQ. FT.

EXISTING BUILDING: TYPE II B

SECTION: 603

**ALLOWABLE BUILDING AREA & HEIGHT** 

ALLOWABLE AREA: ACTUAL AREA:

7,800 SQ. FT. (APPROX.) TABLE 503

ALLOWABLE HEIGHT: ACTUAL HEIGHT:

4 STORIES 1 STORY

TABLE 500

FIRE RESISTANCE REQUIREMENTS

FOR BUILDING ELEMENTS TABLE 601

EXTERIOR BEARING WALLS
EXTERIOR NONBEARING WALLS
INTERIOR BEARING WALLS
INTERIOR NONBEARING WALLS
COLUMNS
TRUSSES, GIRDERS AND BEAMS
FLOOR ASSEMBLIES
ROOF ASSEMBLIES

#### **MEANS OF EGRESS**

TABLE 1004.1.2 SECTION 1004

OCCUPANCY FLOOR AREA IN SQ. FT. AREA OF OCCUPANT NUMBER OF EXITS

PER OCCUPANT RENOVATION LOAD REQUIRED PROVIDED

BUSINESS 100 GROSS 3,606 37 2 2

**EGRESS WIDTH** 

EGRESS WIDTH

AREA

OCCUPANT LOAD

REQUIRED PER PERSON

Required Provided per exit total all

BUILDING

37

0.2 INCHES @ DOORS

7.4

108

#### **ACCESSIBLE MEANS OF EGRESS**

NUMBER REQUIRED = 1 (FBC TABLE 1014.1)

NUMBER PROVIDED = 2

DEAD END (FBC 1016.3)

MAXIMUM PERMITTED 20' PROVIDED 20'

PATH OF TRAVEL TO EXIT (FBC 1013.3)

MAXIMUM PERMITTED 75' PROVIDED 75'

#### MINIMUM PLUMBING REQUIREMENTS

TOTAL OCCUPANT LOAD AS STIPULATED BY CODE: 37 PERSONS

ASSUME 50% MALE AND 50% FEMALE

PLUMBING FIXTURE TYPEREQUIREDWATER CLOSET (M)1WATER CLOSET (F)1

WATER CLOSET (M)
WATER CLOSET (F)
LAVATORY (M)
LAVATORY (F)

PROVIDED

1

GRAPHIC SCALE

SCALE: 1/8"= 1'-0"

 $\begin{array}{c|c}
\hline
 & \text{SHEET NO.} \\
\hline
 & 2A0.1
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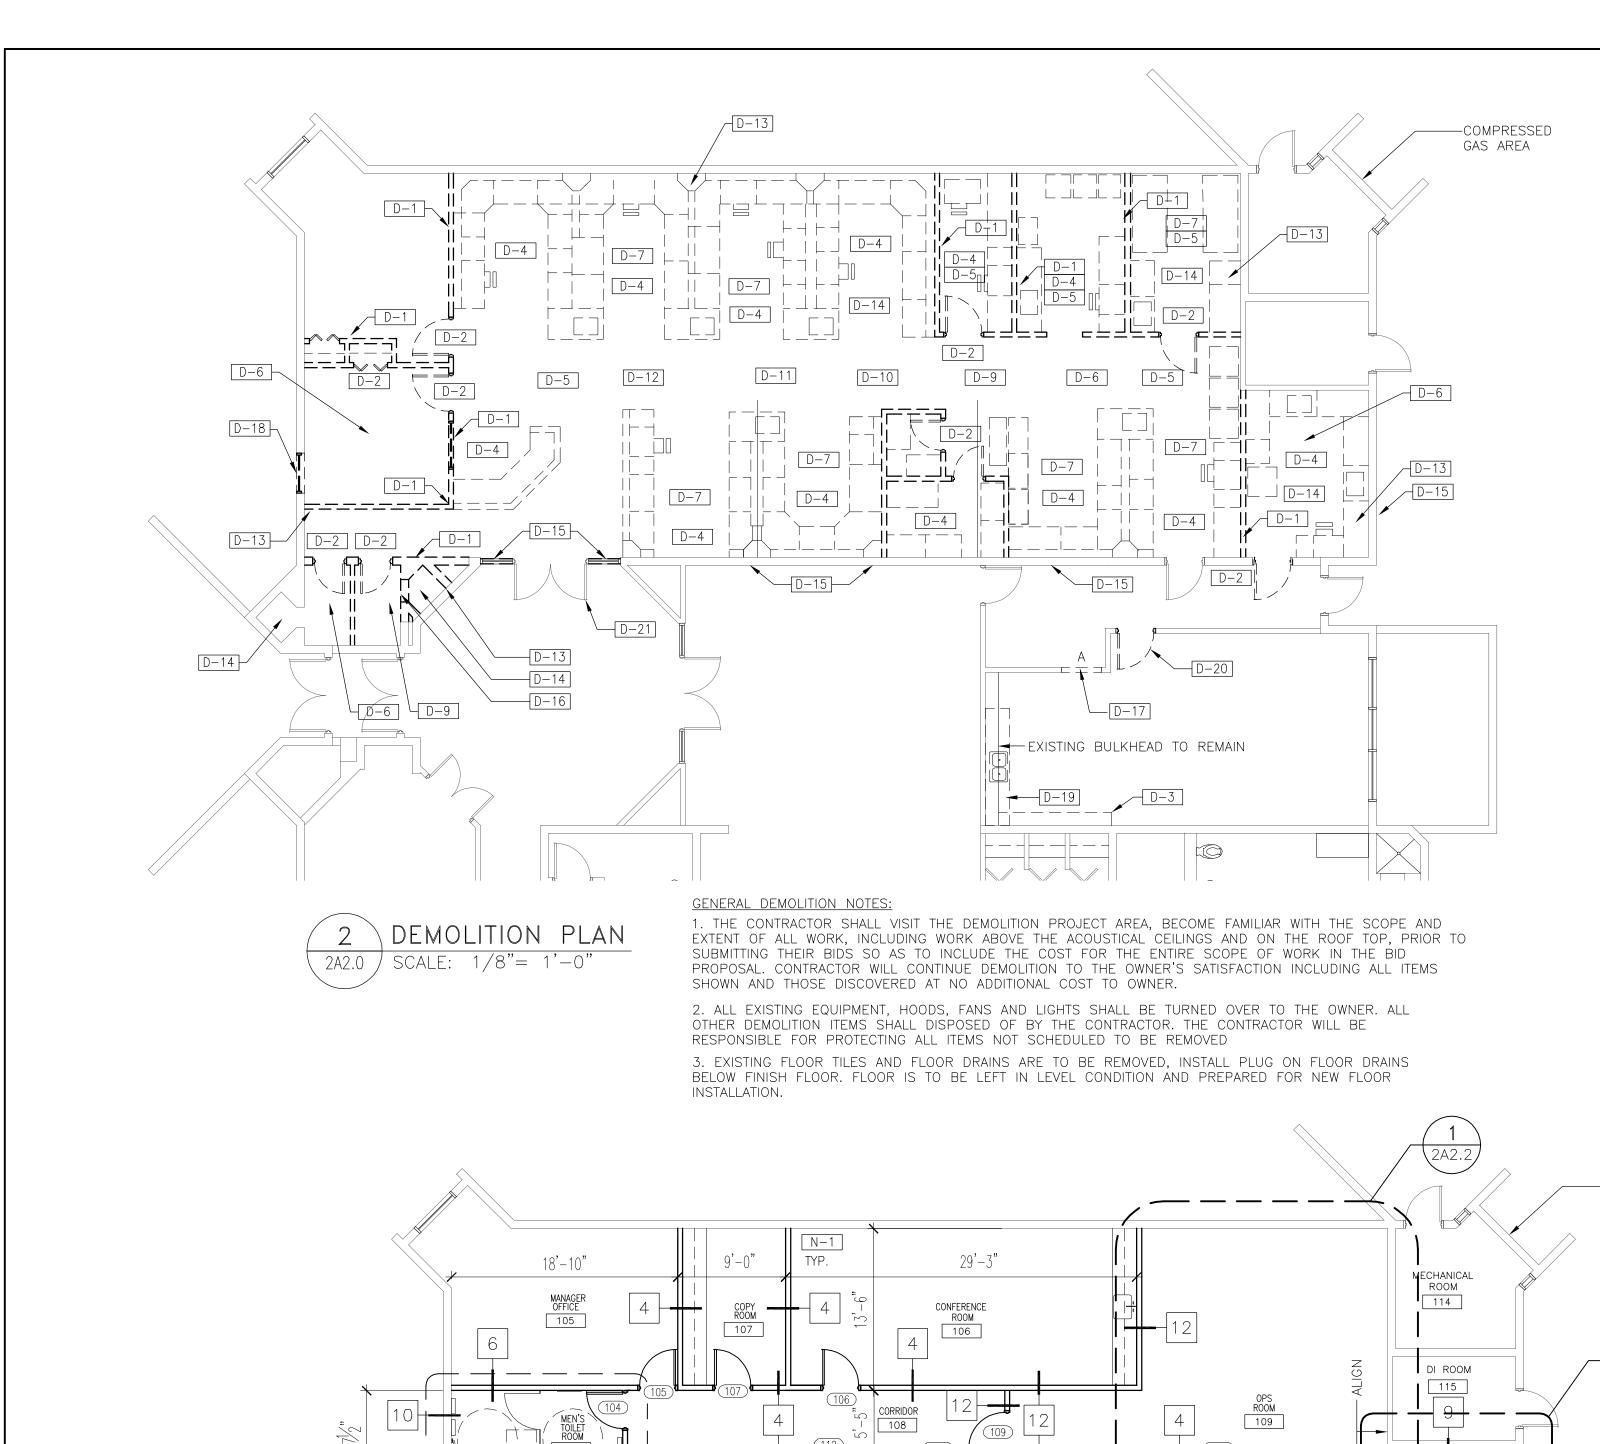
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COUNTY S. TION BUILDING F

MANATEE COU ADMINISTRATION E

DRAWINGS ARE REDUCED IF LESS THAN 34" X 22"



2A2.0 | SCALE: 1/8"= 1'-0"

#### DEMOLITION KEY NOTES

D-1 REMOVE EXISTING WALLS, INCLUDING ALL GLASS, VIEW PANELS, SWITCHES, WIRING CONDUIT, ETC. FROM FLOOR TO ROOF ABOVE, TYP.

D-2 REMOVE EXISTING FRAME, DOOR AND HARDWARE. PROTECT AND STORE FOR REFINISHING AND RE-INSTALLATION. SEE GENERAL NOTES FOR MATERIALS WHICH ALREADY REMOVED AND PURCHASED BY OWNER.

D-3 REMOVE PORTION OF CEILING TO ALLOW CONSTRUCTION OF NEW BULKHEAD.

D-4 REMOVE ALL EXISTING LAB CASEWORK.

D-5 REMOVE EXISTING MECH. GRILLES, CEILING SYSTEM LIGHTS, ETC. COORDINATE WITH MECH. PLANS FOR DUCTS TO REMAIN AND BE REUSED.

D-6 SAWCUT EXISTING CONCRETE SLAB IN THIS AREA AS REQUIRED TO INSTALL NEW PLUMBING LINES. (REFER TO PLUMBING PLANS FOR EXTENT OF DEMOLITION REQUIRED FOR NEW BELOW SLAB PIPING). PATCH AND REPAIR CONCRETE FLOOR AFTER PIPE LINES HAVE BEEN INSTALLED.

D-7 REMOVE EXISTING HOODS (U.N.O.) AND ASSOCIATED EXHAUST FANS ON ROOF AND ASSOCIATED WIRING BACK TO ELECTRIC PANEL. TURN EQUIP. OVER TO THE OWNER. CAP ALL ROOF TOP OPENINGS/CURBS WHERE EQUIP. IS REMOVED WITH GALVÁNIZED SHEET MTL. FLASHING AND SEALANTS FOR WATER TIGHT SEALS. REFER TO THE MECHANICAL PLANS IN ORDER TO SEE AND COORDINATE MECHANICAL EQUIPMENT TO REMAIN.

D-8 NOT USED

D-9 REMOVE EXISTING PLUMBING FIXTURES, EQUIPMENT, ETC.

D-10 CONTRACTOR SHALL BE RESPONSIBLE FOR DISPOSAL OF ALL ITEMS NOT SALVAGED (SPECIFICALLY NOTED TO BE TURNED OVER TO OWNER OR REUSED).

#### DEMOLITION SYMBOLS

EXISTING ITEMS TO BE REMOVED

EXISTING ITEMS TO REMAIN

D-11 REMOVE EXISTING ABANDONED ROOF VENT. PATCH AND REPAIR ROOF AS REQUIRED TO CREATE WATER-TIGHT CONDITION. SEE MECH PLANS FOR LOCATIONS. THE CONTRACTOR SHALL BE RESPONSIBLE FOR REPAIRS AND WATERPROOFING AT ROOF AND WILL PROVIDE INSPECTION REPORT AND CERTIFICATION FOR AFTER REPAIR CONDITIONS.

D-12 REMOVE ALL EXISTING CEILING FANS.

D-13 PATCH AND REPAIR ALL EXISTING FINISHES ON THE INTERIOR FACE OF EXTERIOR WALLS THAT ARE DAMAGED AS A RESULT OF THE DEMOLITION. REPAIR THE DAMAGED INSULATION AND PROVIDE UNINTERRUPTED INSULATION AT EXTERIOR WALLS.

REMOVE AND RELOCATE EXISTING PIPES. REFER TO THE PLUMBING PLANS FOR THE EXTENT OF RENOVATION PIPES TO BE REMOVED AND/OR RELOCATED. FILL, PATCH AND REPAIR THE RECESSED AREA OF THE SLAB AFTER REMOVING THE EXISTING PIPES AND PREPARE SLAB AND WALLS TO RECEIVE CERAMIC TILE APPLICATION.

PROVIDE DUST BARRIERS AT ALL INTERFACES BETWEEN RENOVATION AREA AND ADJACENT AREAS TO REMAIN.

D-16 EXISTING MARBLE THRESHOLDS AT SHOWER ROOM TO BE REMOVED AND TURNED OVER TO THE

D-17 REMOVE PORTION OF EXISTING WALL FOR NEW

D-18 REMOVE WINDOW AND FRAME.

REMOVE EXISTING MILLWORK, SINK AND PLUMBING TO ALLOW FOR INSTALLATION OF NEW MILLWORK, SINK AND PLUMBING.

D-20 RELOCATE EXISTING DOOR AND FRAME TO LOCATION "A".

D-21 EXISTING DOOR, FRAME AND SIDE LITES TO REMAIN. PROTECT DURING CONSTRUCTION.

NEW METAL STUD PARTITION

EXISTING ITEMS TO REMAIN

NEW DOOR & FRAME

MASONRY INFILL


#### RENOVATION SYMBOLS

& MATCH EXISTING ADJACENT FINISHES.

N-2 PROVIDE MOISTURE RESISTANT GYPSUM BOARD WALL OVER GALV. METAL FURRING ALONG THIS

N-3 PROVIDE NECESSARY SOLID BLOCKING FOR GRAB BARS AND OTHER ACCESSORIES AT TOILETS AND



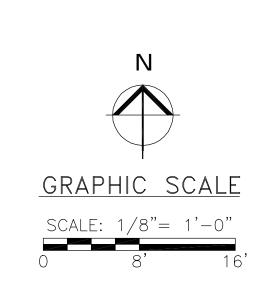

SHEET NO. 2A2.0

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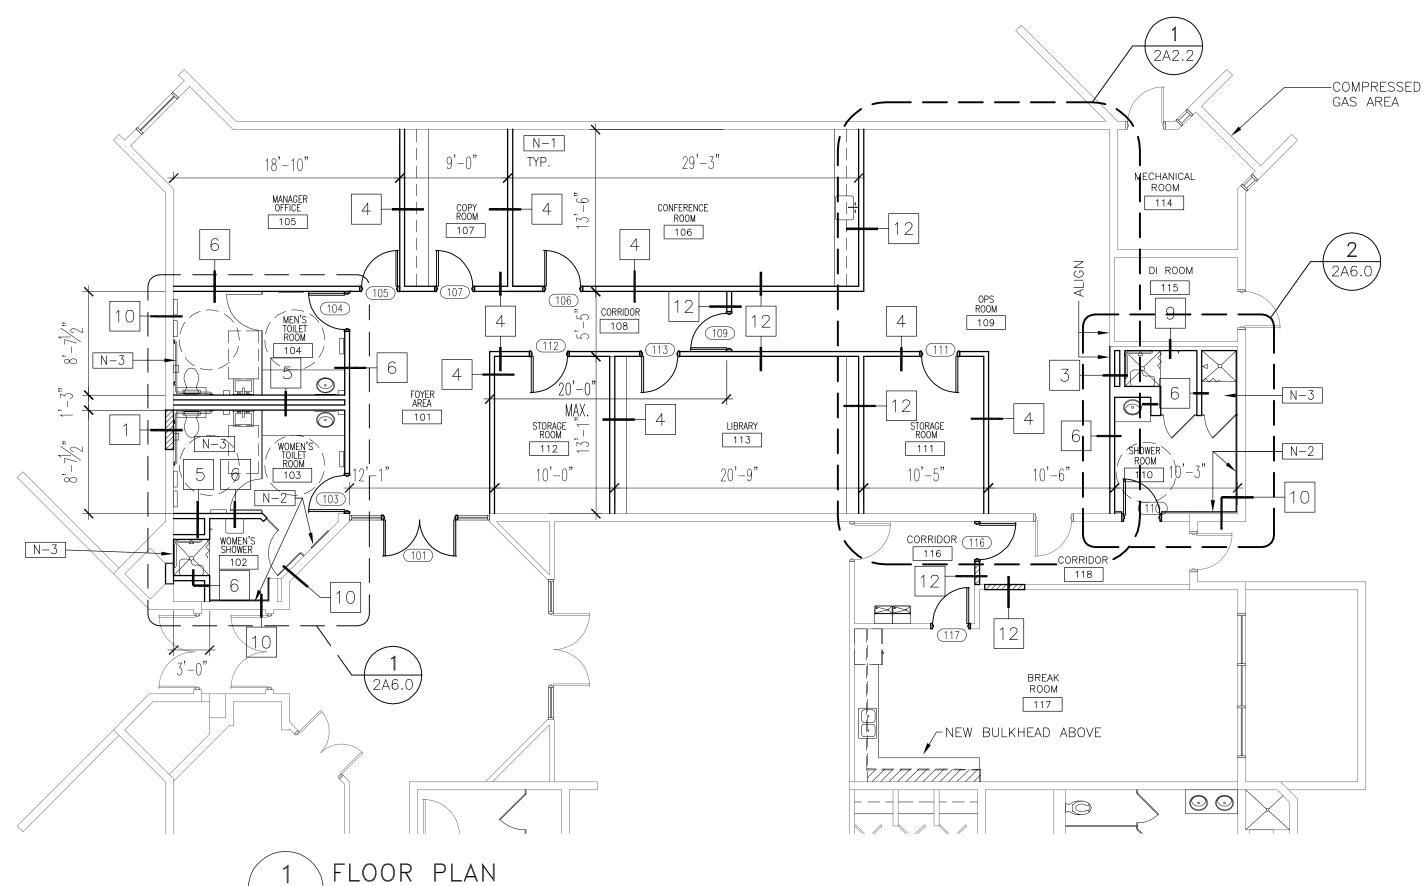
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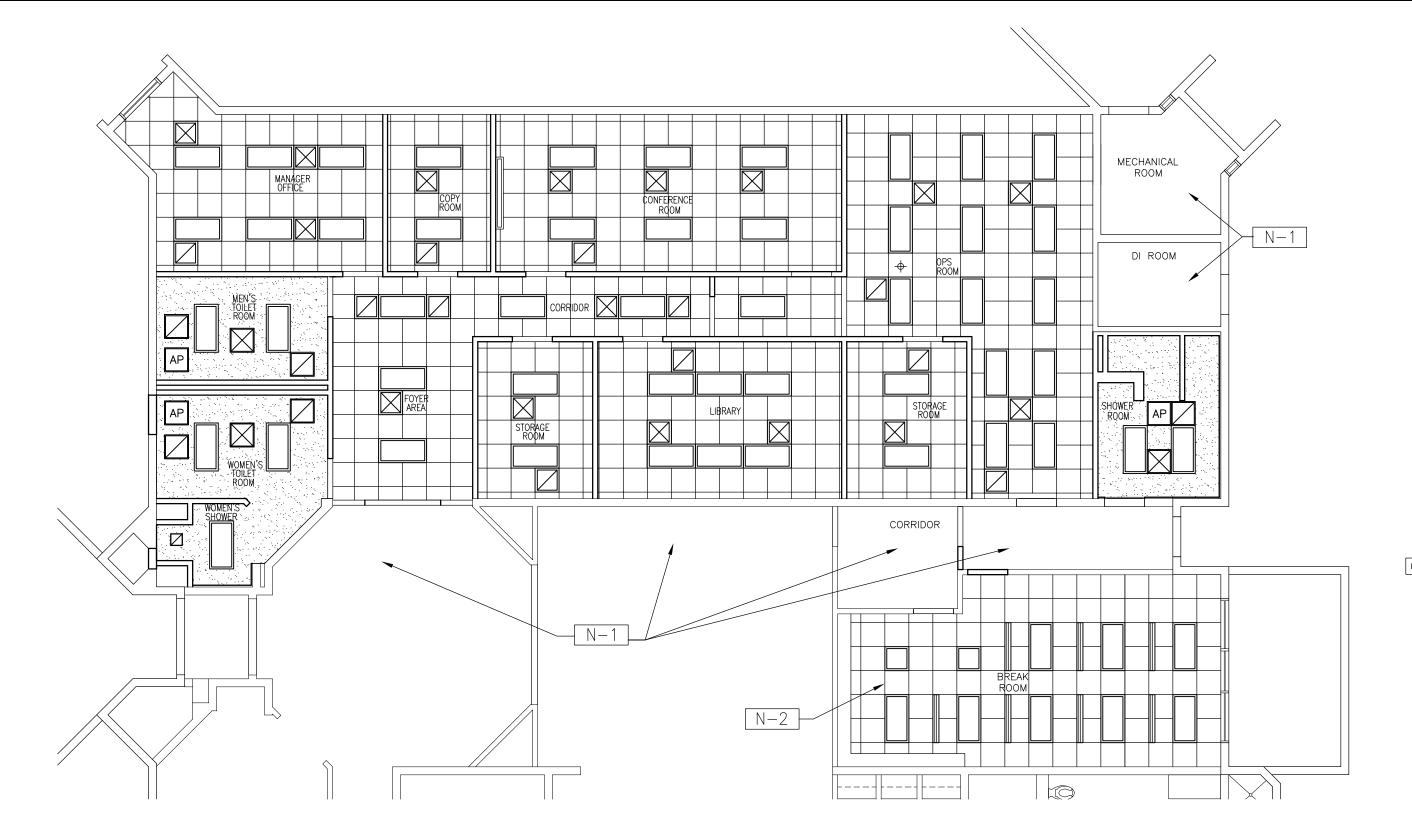
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DRAWINGS ARE REDUCED IF LESS THAN 34" X 22"



NOTE: FOR WALL TYPE INFORMATION ( $\longrightarrow$  X), REFER TO SHEET 2A6.3.

FOR MILLWORK ITEMS, REFER TO SHEET 2A2.1.



#### REFLECTED CEILING PLAN SCALE: 1/8"= 1'-0"


NOTE: REFER TO THE ELEVATION SYMBOLS SHOWN ABOVE FOR

ADDITIONAL CONTRACTOR PROVIDED CASEWORK, FURNITURE AND

EQUIPMENT.

#### FURNITURE & EQUIPMENT NOTES

- 1. PLANS INDICATE BOTH OWNER PROVIDED AND CONTRACTOR PROVIDED FURNISHINGS AND EQUIPMENT. CONTRACTOR TO COORDINATE MECHANICAL AND ELECTRICAL STUB-OUTS WITH OWNER'S FURNISHINGS AND EQUIPMENT SUPPLIERS.
- 2. COMPUTERS, FAX MACHINES, PRINTERS AND COPIERS SHALL BE PROVIDED AND INSTALLED BY THE OWNER.
- 3. REFER TO PLUMBING PLANS, MECHANICAL PLANS AND ELECTRICAL PLANS FOR ADDITIONAL EQUIPMENT AND FIXTURE REQUIREMENTS.
- 4. NOT USED
- 5. THE BASIS OF DESIGN FOR ALL LABORATORY CASEWORK, COUNTERTOPS, HOODS, EQUIPMENT, AND ACCESSORIES SHALL BE BY KEWAUNEE CORPORATION.
- 6. PROVIDE FILLER PANELS (F.P.) WHERE REQUIRED FOR COMPLETE INSTALLATION.
- 7. REFER TO THE FINISH SCHEDULE AND NOTES FOR FINISH INSTALLATION REQUIREMENTS PRIOR TO INSTALLING LABORATORY CASEWORK AND EQUIPMENT.
- 8. VERIFY IN THE FIELD ALL WALL DIMENSIONS AND EQUIPMENT SIZES PRIOR TO ORDERING AND INSTALLING LAB CASEWORK AND COUNTERTOPS AND BEFORE FABRICATING MILLWORK ITEMS.
- 9. CONTRACTOR SHALL INSTALL CERAMIC TILE ON ALL LAB ROOM WALLS FROM FLOOR TO CEILING. THEN INSTALL CHEMICAL RESISTANT SHEET FLOORING PRIOR TO THE FURNITURE AND EQUIPMENT INSTALLATION. REFER TO THE FINISH SCHEDULE AND REQUIREMENTS.
- 10. FOR TYPICAL WALL FINISH ELEVATION IN THE OPS ROOM SEE DETAIL 2 ON SHEET 2A8.0.

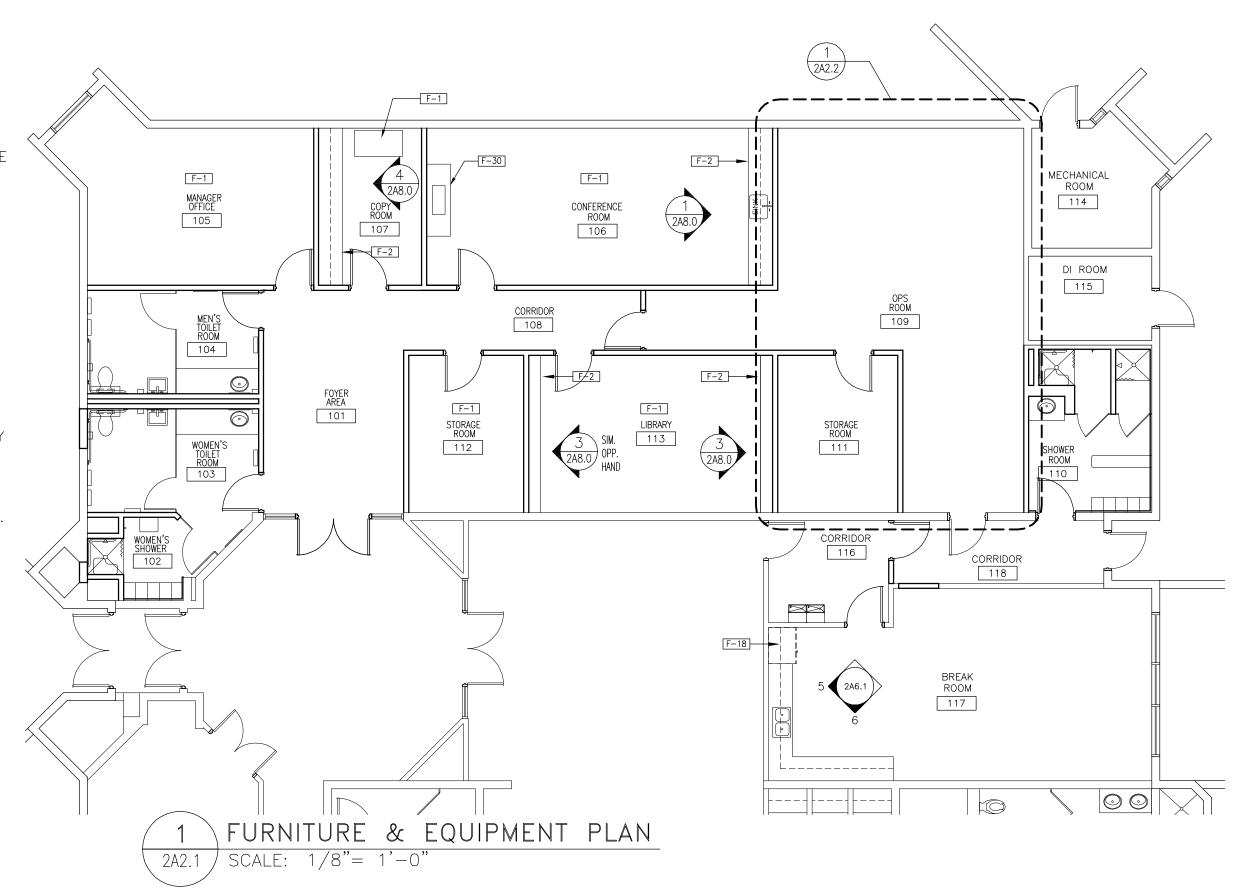

#### REFLECTED CEILING SYMBOLS

CEILING MOUNTED EMERGENCY SHOWER - REFER TO PLUMBING PLANS

NEW SUPPLY AIR DIFFUSER

NEW RETURN AIR GRILLE

EXHAUST FAN - SEE MECHANICAL DRAWINGS

2'x4' RECESSED FLUORESCENT FIXTURE

NEW 2'x2' LAY-IN ACOUSTICAL TILE WITH

PREFINISHED METAL SUSPENSION GRID

6'-0" MOTORIZED PROJECTION SCREEN COORDINATE LOCATION WITH OWNER

THIN COAT PLASTER ON %" MOISTURE RESISTANT GYPSUM BOARD ON SUSPENDED GRID SYSTEM. ANCHOR GRID SUSPENSION TO THE EXISTING ROOF DECK ABOVE

NEW 2'x2' ACCESS PANEL. COORDINATE LOCATION WITH MECHANICAL EQUIPMENT

FURNITURE AND

F-10 | MOLDED EPOXY SINK

F-12 D.I. POLISHER

A-#

B-#

C-#

D-#

E-#

F-2 | MILLWORK

**EQUIPMENT SCHEDULE** 

F-1 OFFICE FURNITURE & EQUIPMENT OPOL

F-31 48" WIDE SS COMMERCIAL REFRIG CPCI

"A" SERIES CASEWORK

"B" SERIES CASEWORK

"C" SERIES CASEWORK

"D" SERIES CASEWORK

"E" SERIES CASEWORK

H-1 | REAGENT RACK & SHELVING SYS | CPCI

CPCI = CONTRACTOR PROVIDED, CONTRACTOR INSTALLED

OPCI = OWNER PROVIDED, CONTRACTOR INSTALLED

CPOI = CONTRACTOR PROVIDED, OWNER INSTALLED

OPOI = OWNER PROVIDED, OWNER INSTALLED

G-1 | FILLER PANELS FOR CABINETS

G-2 MARINE EDGE COUNTERTOPS

G-3 4'-0" FUME HOOD

DEFINITION OF ABBREVIATIONS:

F-8 | MOLDED EPOXY RESIN COUNTER |

F-9 | RESIN BACK SPLASH W/8" CURB |

F-11 RACK W/ TROUGH AND HOSE

F-13 | CEILING SHOWER W/ FL DRAIN

 $F-18 \mid 36$ " WIDE REFRIGERATOR

F-30 | TV, VCR,DVD W/CABINET

ID NO. | FURNITURE & EQUIPMENT | SOURCE | REMARKS

LABORATORY CASEWORK (SEE NOTE 8)

NOTE: FURNITURE & EQUIPMENT SCHEDULE, NOTES, AND

REMARKS APPLY TO DRAWING SHEETS 2A2.1 & 2A2.2

CPCI

CPCI

CPCI

CPCI

CPCI

CPCI CPCI

OPOI

OPOI

CPCI

CPCI

CPCI

CPCI

CPCI

CPCI

CPCI

CPCI 4

\*5

6, 9

\*

AS REQ'D

## REFLECTED CEILING KEY NOTES

N-1 EXISTING CEILING SYSTEM TO REMAIN.

N-2 | EXISTING 2'x4' GRID TO REMAIN. CLEAN GRID AFTER REMOVAL/DISPOSAL OF EXISTING TILES. INSTALL ADDITIONAL MATCH GRID MEMBERS TO SUPPORT NEW 2'x2' CEILING TILES. INSTALL NEW MOISTURE RESISTANT (WASHABLE) ACOUSTICAL CEILING TILES IN EXISTING GRID. EXISTING LIGHTS AND HVAC TO REMAIN.

REVISIONS	DESCRIPTION	ISSUED FOR BIDDING		
	ВУ			
	DATE	12/8 2008		

URS Corporation Southern 7650 West Courtney Campbell Causeway Tampa, FL 33607-1462 No. 00000002 Ferrance J. Short AR No. 92283	APPR'D BY:
URS Corporation So 7650 West Courtney Campbell Causeway Tampa, FL 33607-14 No. 00000002 Terrance J. Short AR	CK.BY:
	DR.BY:
J	OSGN. BY:

HOOD REUSE & REINSTALLATION REQUIREMENTS.

CONTRACTOR PROVIDE INSTALLATION NECESSARY

6. COMPOSITE RESIN LAB "PEGBOARD" RACK 20" LONG x 29" HIGH WITH S.S. DRIP TROUGH WITH ½" DRAIN OUTLET AND HOSE.

# 1. REFER TO MILLWORK ELEVATIONS FOR ADDITIONAL

2. REFER TO PLUMBING PLANS FOR ADDITIONAL REQUIREMENTS. REFER TO MECH/ELEC/PLUMB PLANS FOR

FOR THE OPERATION OF OWNER INSTALLED EQUIPMENT. 4. REFER TO MECH/ELEC/PLUMB PLANS FOR FUME

5. PROVIDE STEEL APRON RAILS AND PANELS FOR PRIVACY AT ALL KNEE SPACE WORK SURFACES OPEN BELOW COUNTER TOPS, TYP.

7. REFER TO PLUMBING PLANS.

FURNITURE AND

REQUIREMENTS.

EQUIPMENT REMARKS

8. REFER TO 2 ON SHEET 2A2.2 FOR TYPICAL LAB CASEWORK SERIES TYPE ELEVATIONS "A","B","C","D","E","G" AND "H".


9. PROVIDE REAGENT RACK WITH 24" HIGH UPRIGHTS AS REQUIRED WITH INTERMEDIATE EPOXY SHELF AND TOP SHELF. PROVIDE 4" EPOXY BASE FOR REAGENT RACK WITH HOSE TO SINK.

CEILING PLAN AND & EQUIPMENT PLAN COUNTY S. FION BUILDING F REFLECTED (FURNITURE & **ADMINISTRATION** MANATEE

RENOVATION

8

 $\geqslant$ 

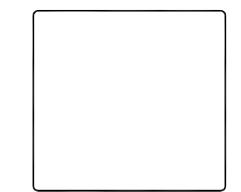

SHEET NO.

2A2.1

GRAPHIC SCALE SCALE: 1/8" = 1'-0"

TYPICAL LAB CASEWORK ELEVATIONS 2A2.2 | SCALE: 1/4"= 1'-0"

#### FURNITURE & EQUIPMENT NOTES

- 1. PLANS INDICATE BOTH OWNER PROVIDED AND CONTRACTOR PROVIDED FURNISHINGS AND EQUIPMENT. CONTRACTOR TO COORDINATE MECHANICAL AND ELECTRICAL STUB-OUTS WITH OWNER'S FURNISHINGS AND EQUIPMENT SUPPLIERS.
- 2. COMPUTERS, FAX MACHINES, PRINTERS AND COPIERS SHALL BE PROVIDED AND INSTALLED BY THE OWNER.
- 3. REFER TO PLUMBING PLANS, MECHANICAL PLANS AND ELECTRICAL PLANS FOR ADDITIONAL EQUIPMENT AND FIXTURE REQUIREMENTS.
- 4. NOT USED
- 5. THE BASIS OF DESIGN FOR ALL LABORATORY CASEWORK, COUNTERTOPS, HOODS, EQUIPMENT, AND ACCESSORIES SHALL BE BY KEWAUNEE CORPORATION.
- 6. PROVIDE FILLER PANELS (F.P.) WHERE REQUIRED FOR COMPLETE INSTALLATION.
- 7. REFER TO THE FINISH SCHEDULE AND NOTES FOR FINISH INSTALLATION REQUIREMENTS PRIOR TO INSTALLING LABORATORY CASEWORK AND EQUIPMENT.
- 8. VERIFY IN THE FIELD ALL WALL DIMENSIONS AND EQUIPMENT SIZES PRIOR TO ORDERING AND INSTALLING LAB CASEWORK AND COUNTERTOPS AND BEFORE FABRICATING MILLWORK ITEMS.
- 9. CONTRACTOR SHALL INSTALL CERAMIC TILE ON ALL LAB ROOM WALLS FROM FLOOR TO CEILING. THEN INSTALL CHEMICAL RESISTANT SHEET FLOORING PRIOR TO THE FURNITURE AND EQUIPMENT INSTALLATION. REFER TO THE FINISH SCHEDULE AND REQUIREMENTS.
- 10. FOR TYPICAL WALL FINISH ELEVATION IN THE OPS ROOM SEE DETAIL 2 ON SHEET 2A8.0.

#### FURNITURE AND EQUIPMENT SCHEDULE

ID NO.	FURNITURE & EQUIPMENT	SOURCE	REMARKS
F-1	OFFICE FURNITURE & EQUIPMENT	OPOI	
F-2	MILLWORK	CPCI	1
F-8	MOLDED EPOXY RESIN COUNTER	CPCI	*5
F-9	RESIN BACK SPLASH W/8" CURB	CPCI	*
F-10	MOLDED EPOXY SINK	CPCI	7
F-11	RACK W/ TROUGH AND HOSE	CPCI	6, 9
F-12	D.I. POLISHER	CPCI	
F-13	CEILING SHOWER W/ FL DRAIN	CPCI	
F-18	36" WIDE REFRIGERATOR	OPOI	
F-30	TV, VCR,DVD W/CABINET	OPOI	
F-31	48" WIDE SS COMMERCIAL REFRIG	CPCI	
	LABORATORY CASEWORK (S	SEE NOTE	8)
A-#	LABORATORY CASEWORK (S	SEE NOTE	8)
A-# B-#	`		8)
	"A" SERIES CASEWORK "B" SERIES CASEWORK	CPCI	8)
B-#	"A" SERIES CASEWORK	CPCI CPCI	8)
B-# C-#	"A" SERIES CASEWORK "B" SERIES CASEWORK "C" SERIES CASEWORK	CPCI CPCI CPCI	8)
B-# C-# D-#	"A" SERIES CASEWORK "B" SERIES CASEWORK "C" SERIES CASEWORK "D" SERIES CASEWORK	CPCI CPCI CPCI	8)
B-# C-# D-#	"A" SERIES CASEWORK "B" SERIES CASEWORK "C" SERIES CASEWORK "D" SERIES CASEWORK "E" SERIES CASEWORK	CPCI CPCI CPCI	8) AS REQ'D
B-# C-# D-# E-#	"A" SERIES CASEWORK "B" SERIES CASEWORK "C" SERIES CASEWORK "D" SERIES CASEWORK "E" SERIES CASEWORK	CPCI CPCI CPCI CPCI	,
B-# C-# D-# E-#	"A" SERIES CASEWORK  "B" SERIES CASEWORK  "C" SERIES CASEWORK  "D" SERIES CASEWORK  "E" SERIES CASEWORK  FILLER PANELS FOR CABINETS	CPCI CPCI CPCI CPCI	,
B-# C-# D-# E-# G-1 G-2	"A" SERIES CASEWORK  "B" SERIES CASEWORK  "C" SERIES CASEWORK  "D" SERIES CASEWORK  "E" SERIES CASEWORK  FILLER PANELS FOR CABINETS  MARINE EDGE COUNTERTOPS	CPCI CPCI CPCI CPCI CPCI CPCI	AS REQ'D

DEFINITION OF ABBREVIATIONS:

CPCI = CONTRACTOR PROVIDED, CONTRACTOR INSTALLED


OPCI = OWNER PROVIDED, CONTRACTOR INSTALLED OPOI = OWNER PROVIDED, OWNER INSTALLED

CPOI = CONTRACTOR PROVIDED. OWNER INSTALLED

NOTE: FURNITURE & EQUIPMENT SCHEDULE, NOTES, AND REMARKS APPLY TO DRAWING SHEETS 2A2.1 & 2A2.2


#### FURNITURE AND **EQUIPMENT REMARKS**

- 1. REFER TO MILLWORK ELEVATIONS FOR ADDITIONAL REQUIREMENTS.
- 2. REFER TO PLUMBING PLANS FOR ADDITIONAL REQUIREMENTS.
- 3. REFER TO MECH/ELEC/PLUMB PLANS FOR CONTRACTOR PROVIDE INSTALLATION NECESSARY FOR THE OPERATION OF OWNER INSTALLED EQUIPMENT.
- 4. REFER TO MECH/ELEC/PLUMB PLANS FOR FUME HOOD REUSE & REINSTALLATION REQUIREMENTS.
- 5. PROVIDE STEEL APRON RAILS AND PANELS FOR PRIVACY AT ALL KNEE SPACE WORK SURFACES OPEN BELOW COUNTER TOPS, TYP.
- 6. COMPOSITE RESIN LAB "PEGBOARD" RACK 20" LONG x 29" HIGH WITH S.S. DRIP TROUGH WITH ½" DRAIN OUTLET AND HOSE.
- 7. REFER TO PLUMBING PLANS.
- 8. REFER TO 2 ON SHEET 2A2.2 FOR TYPICAL LAB CASEWORK SERIES TYPE ELEVATIONS "A","B","C","D","E","G" AND "H".
- 9. PROVIDE REAGENT RACK WITH 24" HIGH UPRIGHTS AS REQUIRED WITH INTERMEDIATE EPOXY SHELF AND TOP SHELF. PROVIDE 4" EPOXY BASE FOR REAGENT RACK WITH HOSE TO

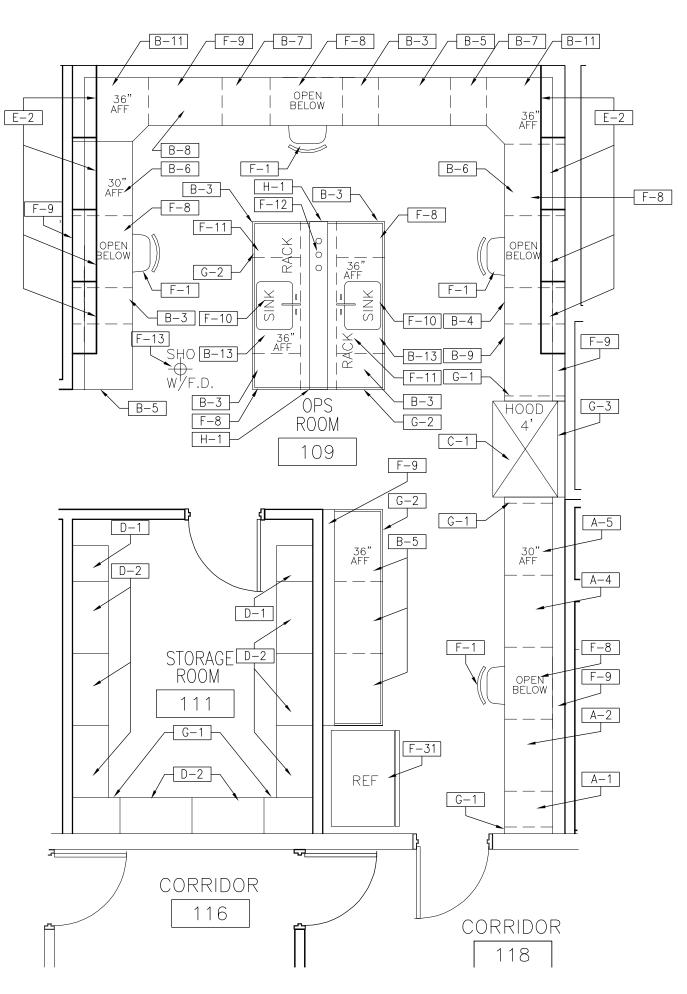

OPS ROOM AND STORAGE ROOM EQUIPMENT PLAN 2A2.2 | SCALE: 1/4"= 1'-0"

NOTE: FOR FURNITURE AND EQUIPMENT SCHEDULE, SEE 2/2A2.1

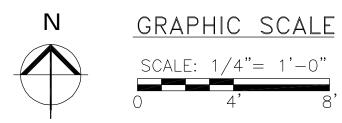

2A2.2

SHEET NO.

 $\mathbf{\Sigma}$ 

 $\aleph$ 

R.


COUNTY S. FION BUILDING F


MANATEE


**ADMINISTRA** 

OPS AND STORAGE ROOM EQUIPMENT PLAN & CASEWORK ELEVATIONS

DRAWINGS ARE REDUCED IF LESS THAN 34" X 22"

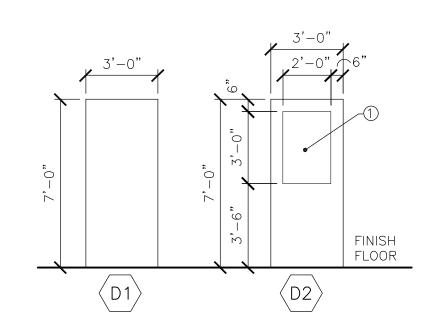

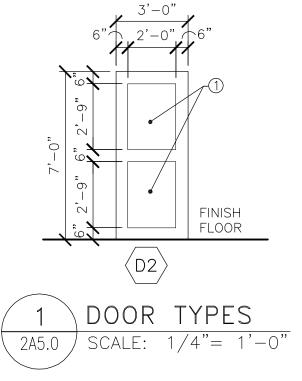

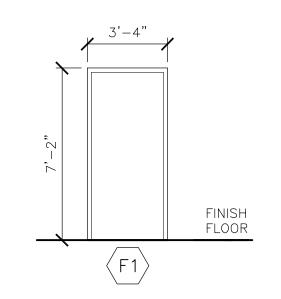



#### DOOR SCHEDULE NOTES & REMARKS

- 1. HARDWARE SETS ARE LISTED IN THE PROJECT SPECIFICATIONS.
- 2. ALUMINUM DOOR FRAME TO INCLUDE FRAME COMPONENTS FOR REQUIRED HARDWARE.
- 3. SELECT AN EXISTING SOLID DOOR (TYPE D1) AND FRAME TO RELOCATE TO THIS OPENING. SWING CHANGES FROM EXISTING DOOR.

#### FINISH SCHEDULE NOTES & REMARKS

- 1. CHEMICAL RESISTANT SHEET VINYL FLOORING SHALL BE INSTALLED OVER THE ENTIRE FLOOR AREA IN THE ROOM. (TO BE INSTALLED AFTER WALL FINISH IS IN PLACE)
- 2. NOT USED.
- 3. CERAMIC TILE SHALL BE INSTALLED FROM THE FLOOR TO THE CEILING AND OVER ALL GYPSUM BOARD WALLS (TO BE INSTALLED PRIOR TO SHEET VINYL FLOORING).
- 4. NOT USED.
- 5. PROVIDE MOISTURE RESISTANT (WASHABLE) ACOUSTICAL CEILING TILES AND GALV. METAL CEILING TRACK SYSTEM THROUGH OUT THE BUILDING USING "ULTIMA" BY ARMSTRONG AS THE BASIS OF DESIGN.
- 6. PROVIDE FLOOR DRAINS FLUSH WITH NEW FLOOR FINISH AS INDICATED ON THE PLUMBING PLANS.
- 7. REFER TO THE ENLARGED TOILET ROOM PLANS FOR NEW TOILET ACCESSORIES REQUIRED AND CERAMIC TILE PATTERN DESIGN.
- 8. REFER TO 2A6.0 FOR CERAMIC TILE SIZES AND TO THE PROJECT SPECIFICATION FOR CERAMIC TILE INFORMATION.
- 9. ALL CT1 WALL BASE SHALL BE THE COVED TYPE.
- 10. FOR CERAMIC WALL TILE PATTERN AND EXTENT REQUIRED REFER TO DRAWING 2 ON SHEET 2A8.0.
- 11. EXISTING 2'X4' GRID TO REMAIN. CLEAN GRID AFTER REMOVAL/DISPOSAL OF EXISTING TILES. INSTALL ADDITIONAL MATCH GRID MEMBERS TO SUPPORT NEW 2'X2' CEILING TILES. INSTALL NEW MOISTURE RESISTANT (WASHABLE) ACOUSTICAL CEILING TILES IN EXISTING GRID. EXISTING LIGHTS AND HVAC TO REMAIN.

#### FINISH SCHEDULE ABBREVIATIONS

ACT:	ACOUSTICAL CEILING TILE
CONC:	CONCRETE
CT1:	CERAMIC TILE 1
CT2:	CERAMIC TILE 2
CT3:	CERAMIC TILE 3
CT4:	CERAMIC TILE 4
GB:	GYPSUM BOARD (PAINTED)
CRV:	CHEMICAL RESISTANT VINYL FLOORING
MGB:	MOISTURE RESISTANT GYP BD W/THIN COAT PLASTER AND PAINT
NR:	FINISH NOT REQUIRED
P1:	INTERIOR PAINT 1
P2:	INTERIOR PAINT 2
P3:	INTERIOR PAINT 3

VINYL BASE

EXISTING FINISH TO REMAIN

DOOR SCHEDULE														
DOOD.							FRAME DETAILS							
NUMBER	SIZE	LABEL		DOOR		GLZ	HDWR		FRAME		(DE	TAIL#/SHEE	ET#)	REMARKS
			MATL	FINISH	TYPE			MATL	FINISH	TYPE	HEAD	JAMB	SILL	
101	EXISTING TO REMAIN	-	ALUM	-	-	-	-	ALUM	-	-	-	-	-	
103	3'-0"x7'-0"x1 3/4"	-	WD	S	D1		11	ALUM	PF	F1	2 / 2A6.1	1 / 2A6.1	3 / 2A6.1	
104	3'-0"x7'-0"x1 3/4"	-	WD	S	D2		11	ALUM	PF	F1	2 / 2A6.1	1 / 2A6.1	3 / 2A6.1	
105	3'-0"x7'-0"x1 3/4"	-	WD	S	D2	1	12	ALUM	PF	F1	2 / 2A6.1	1 / 2A6.1	-	
106	3'-0"x7'-0"x1 3/4"	-	WD	S	D2	1	12	ALUM	PF	F1	2 / 2A6.1	1 / 2A6.1	-	
107	3'-0"x7'-0"x1 3/4"	-	WD	S	D2	1	12	ALUM	PF	F1	2 / 2A6.1	1 / 2A6.1	-	
109	3'-0"x7'-0"x1 3/4"	-	WD	S	D2	1	12	ALUM	PF	F1	2 / 2A6.1	1 / 2A6.1	-	
110	EXISTING - RELOCATE	-	WD	S	D1	-	-	-	P-3	F1	-	-	3 / 2A6.1	3
111	3'-0"x7'-0"x1 3/4"	-	WD	S	D1		12	ALUM	PF	F1	2 / 2A6.1	1 / 2A6.1	-	
112	3'-0"x7'-0"x1 3/4"	-	WD	S	D2	1	12	ALUM	PF	F1	2 / 2A6.1	1 / 2A6.1	-	
113	3'-0"x7'-0"x1 3/4"	-	WD	S	D2	1	12	ALUM	PF	F1	2 / 2A6.1	1 / 2A6.1	-	
116	3'-0"x7'-0"x1 3/4"	-	ALUM	PF	D3	1	12	ALUM	PF	F1	2 / 2A6.1	1 / 2A6.1	-	
117	EXISTING TO BE RELOCATED	-	-	-				-	P-3	-				

### DOOR & FRAME ABBREVIATIONS GLAZING TYPES

ALUMINUM	1	¼" CLEAR	TEMPERED	GLASS

P PAINTED

ALUM

PF PAINTED FINISH WITH FACTORY FINISH

S CLEAR FINISH OVER NATURAL BIRCH

WD WOOD — SOLID CORE

ROOM FINISH SCHEDULE (8)										
ROOM NO.	ROOM NAME	FLOOR	BASE (0)	WA	ALLS (MAT	ERIAL / FINIS	SH)	CEIL	.ING	REMA RKS
ROOM NO.	ROOW NAME	FLOOR	BASE (9)	N	S	E	W	MATERIAL	HEIGHT	KEWAKKS
101	FOYER AREA	CRV	VB	P1	P1	P1	P1	ACT	9'-0"	-
102	WOMEN'S SHOWER	CT3/4	CT3	CT3	CT3	CT3	CT3	MGB/P2	8'-0"	6,7
103	WOMEN'S TOILET ROOM	CT3/4	CT3	CT3	CT3	CT3	CT3	MGB/P2	8'-0"	6,7
104	MEN'S TOILET ROOM	CT3/4	CT3	CT3	CT3	CT3	CT3	MGB/P2	8'-0"	6,7
105	MANAGER OFFICE	CRV	VB	P1	P1	P1	P1	ACT	9'-0"	1
106	CONFERENCE ROOM	CRV	VB	P1	P1	P1	P1	ACT	9'-0"	1
107	COPY ROOM	CRV	VB	P1	P1	P1	P1	ACT	9'-0"	1
108	CORRIDOR	CRV	VB	P1	P1	P1	P1	ACT	9'-0"	4
109	OPS ROOM	CRV	CT1/2	CT1/2	CT1/2	CT1/2	CT1/2	ACT	9'-0"	1, 3 , 6 , 10
110	SHOWER ROOM	CT3/4	СТ3	CT3	СТ3	CT3	CT3	MGB/P2	8'-0"	6 , 7
111	STORAGE ROOM	CRV	CT1/2	CT1/2	CT1/2	CT1/2	CT1/2	ACT	9'-0"	1, 3 , 10
112	STORAGE ROOM	CRV	VB	P1	P1	P1	P1	ACT	9'-0"	1
113	LIBRARY	CRV	VB	P1	P1	P1	P1	ACT	9'-0"	1
116	CORRIDOR	Х	Х	P1	P1	P1	P1	Х	Х	
117	BREAK ROOM	CRV	VB	P1	P1	P1	P1	ACT	9'-0"	11
118	CORRIDOR	Х	Х	P1	P1	P1	P1	Х	Х	

R E V I S I O N S
DESCRIPTION
12/8
ISSUED FOR BIDDING

URS Corporation Southern
7650 West Courtney
Campbell Causeway
Tampa, FL 33607-1462
No. 00000002
Terrance J. Short AR No. 92283

DSGN. BY: CK.BY: CK.BY: APPR'D BY:


AS NOTED


DATE:

NOVEMBER 2008

MANATEE COUNTY S. W. R. W. T. I ADMINISTRATION BUILDING RENOVATIONS DOOR & FINISH SCHEDULE, NOTES &


2A5.0

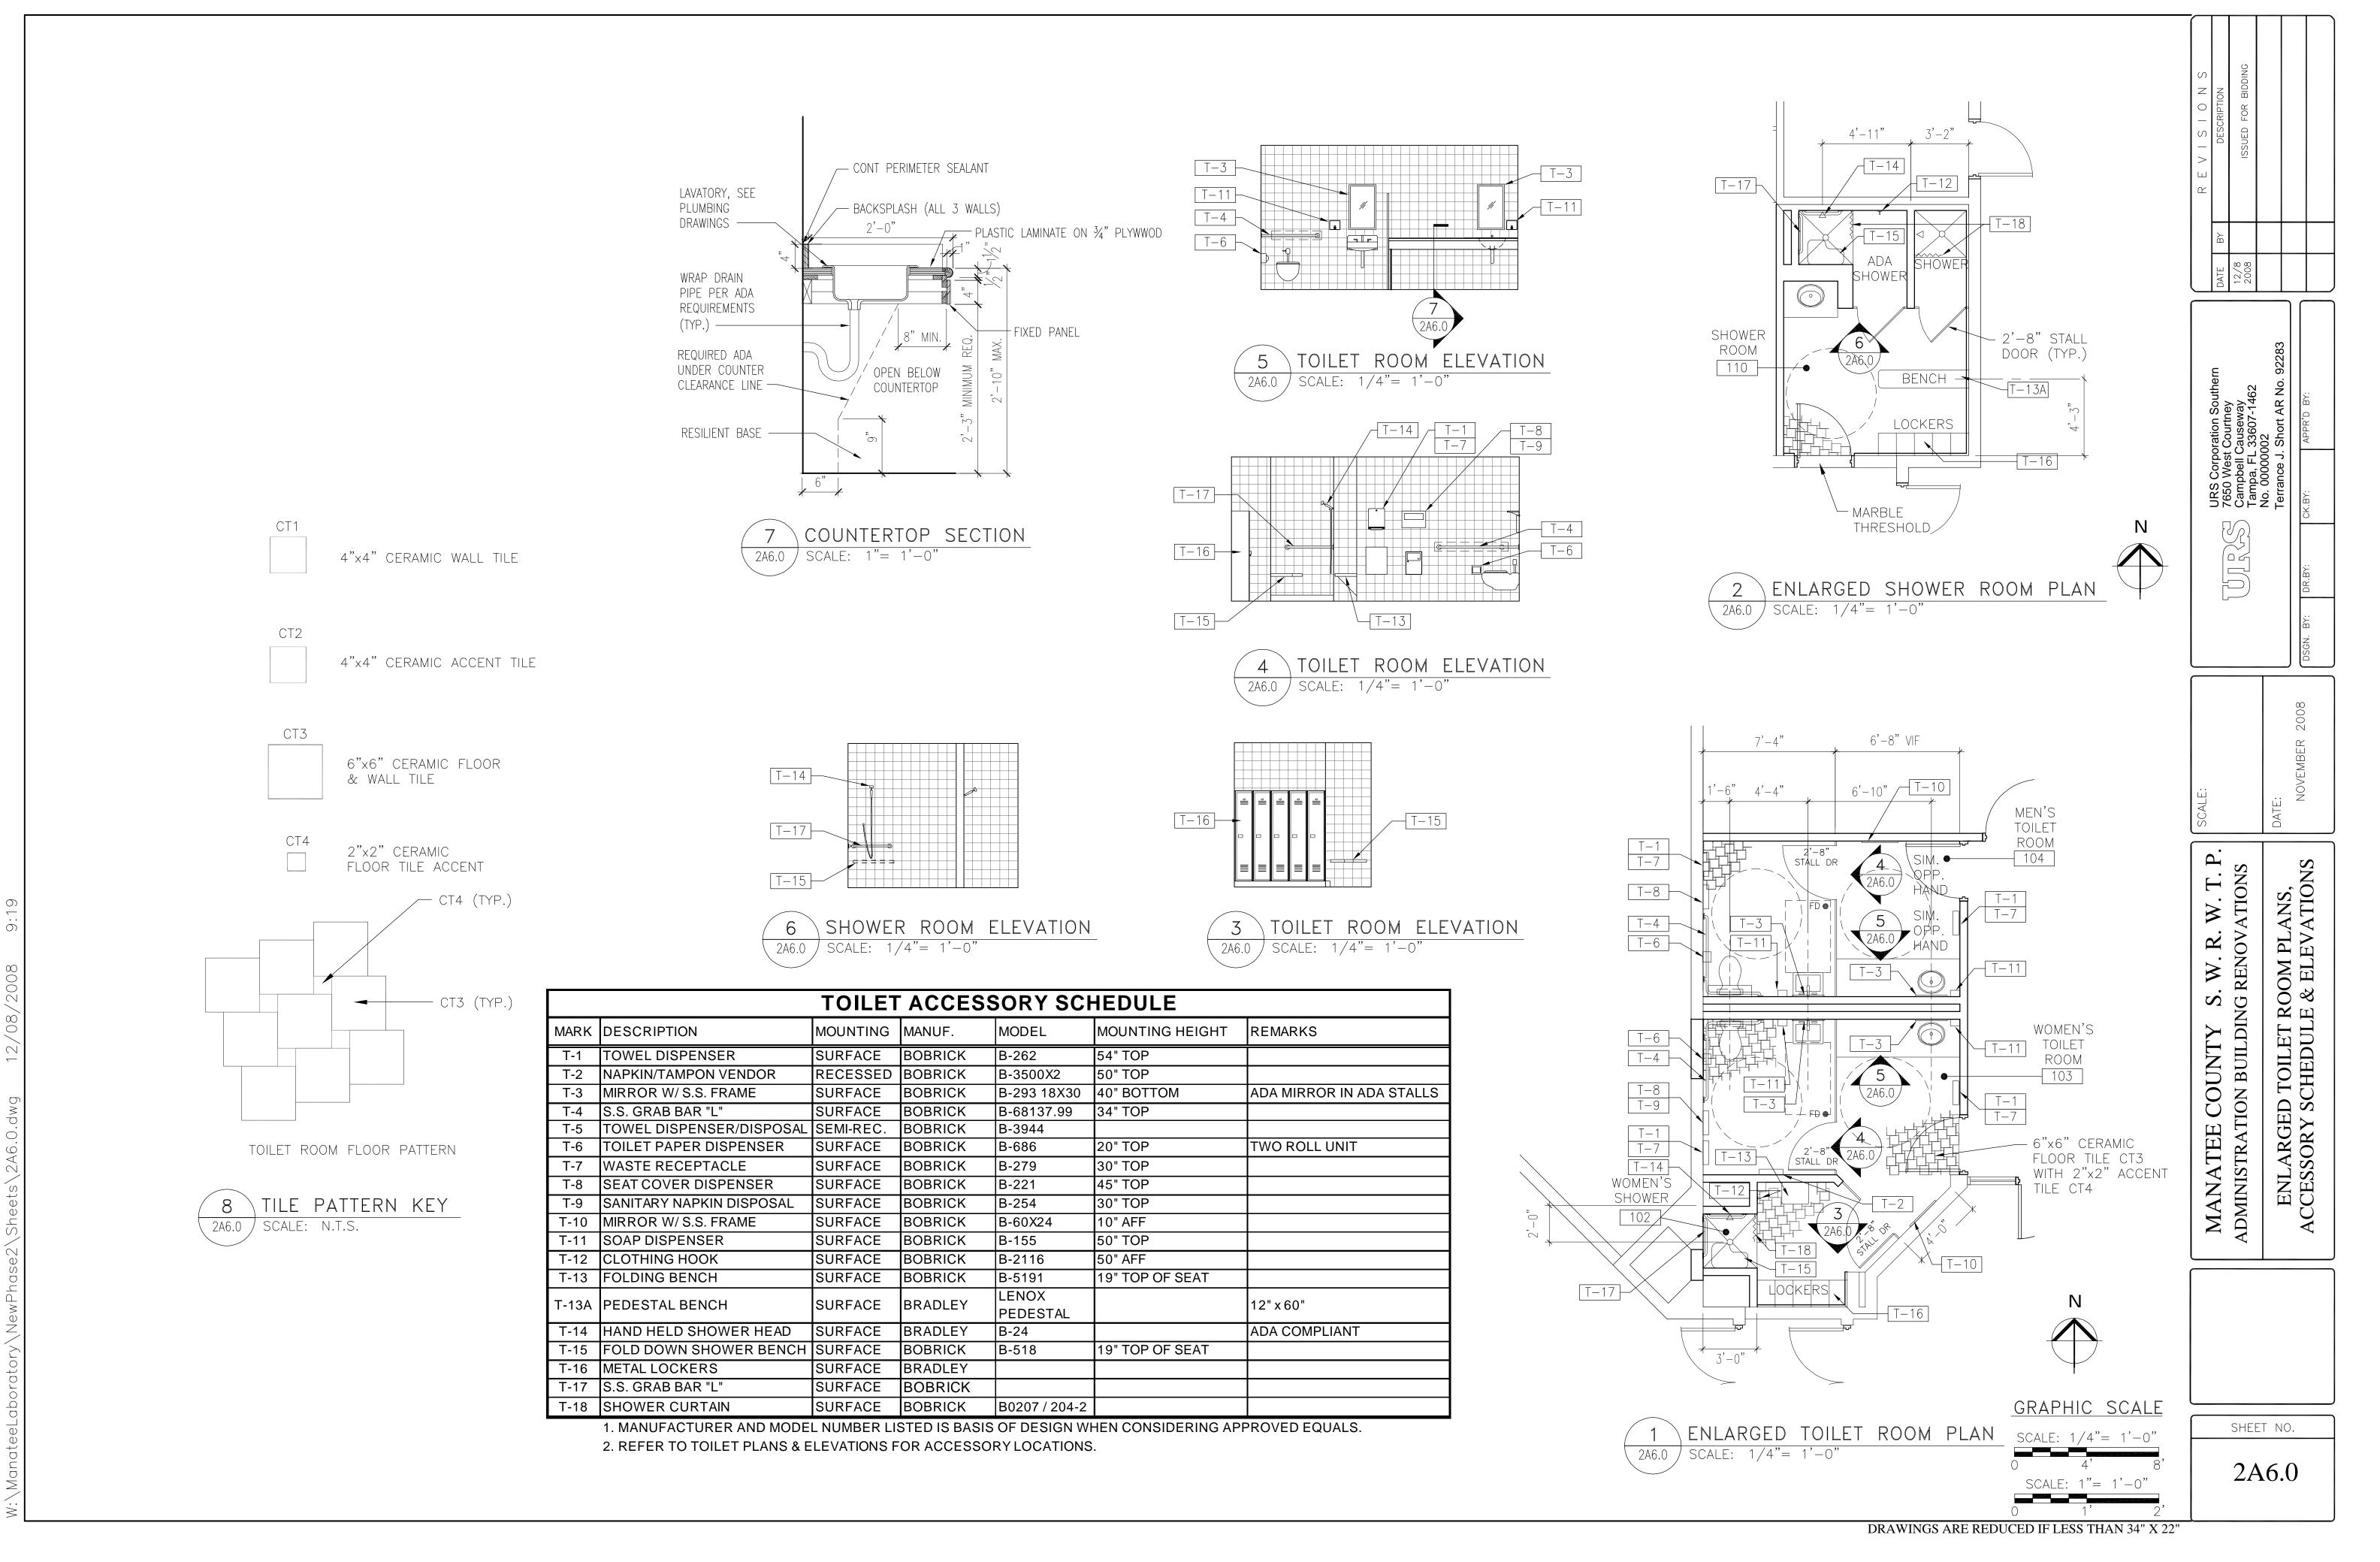

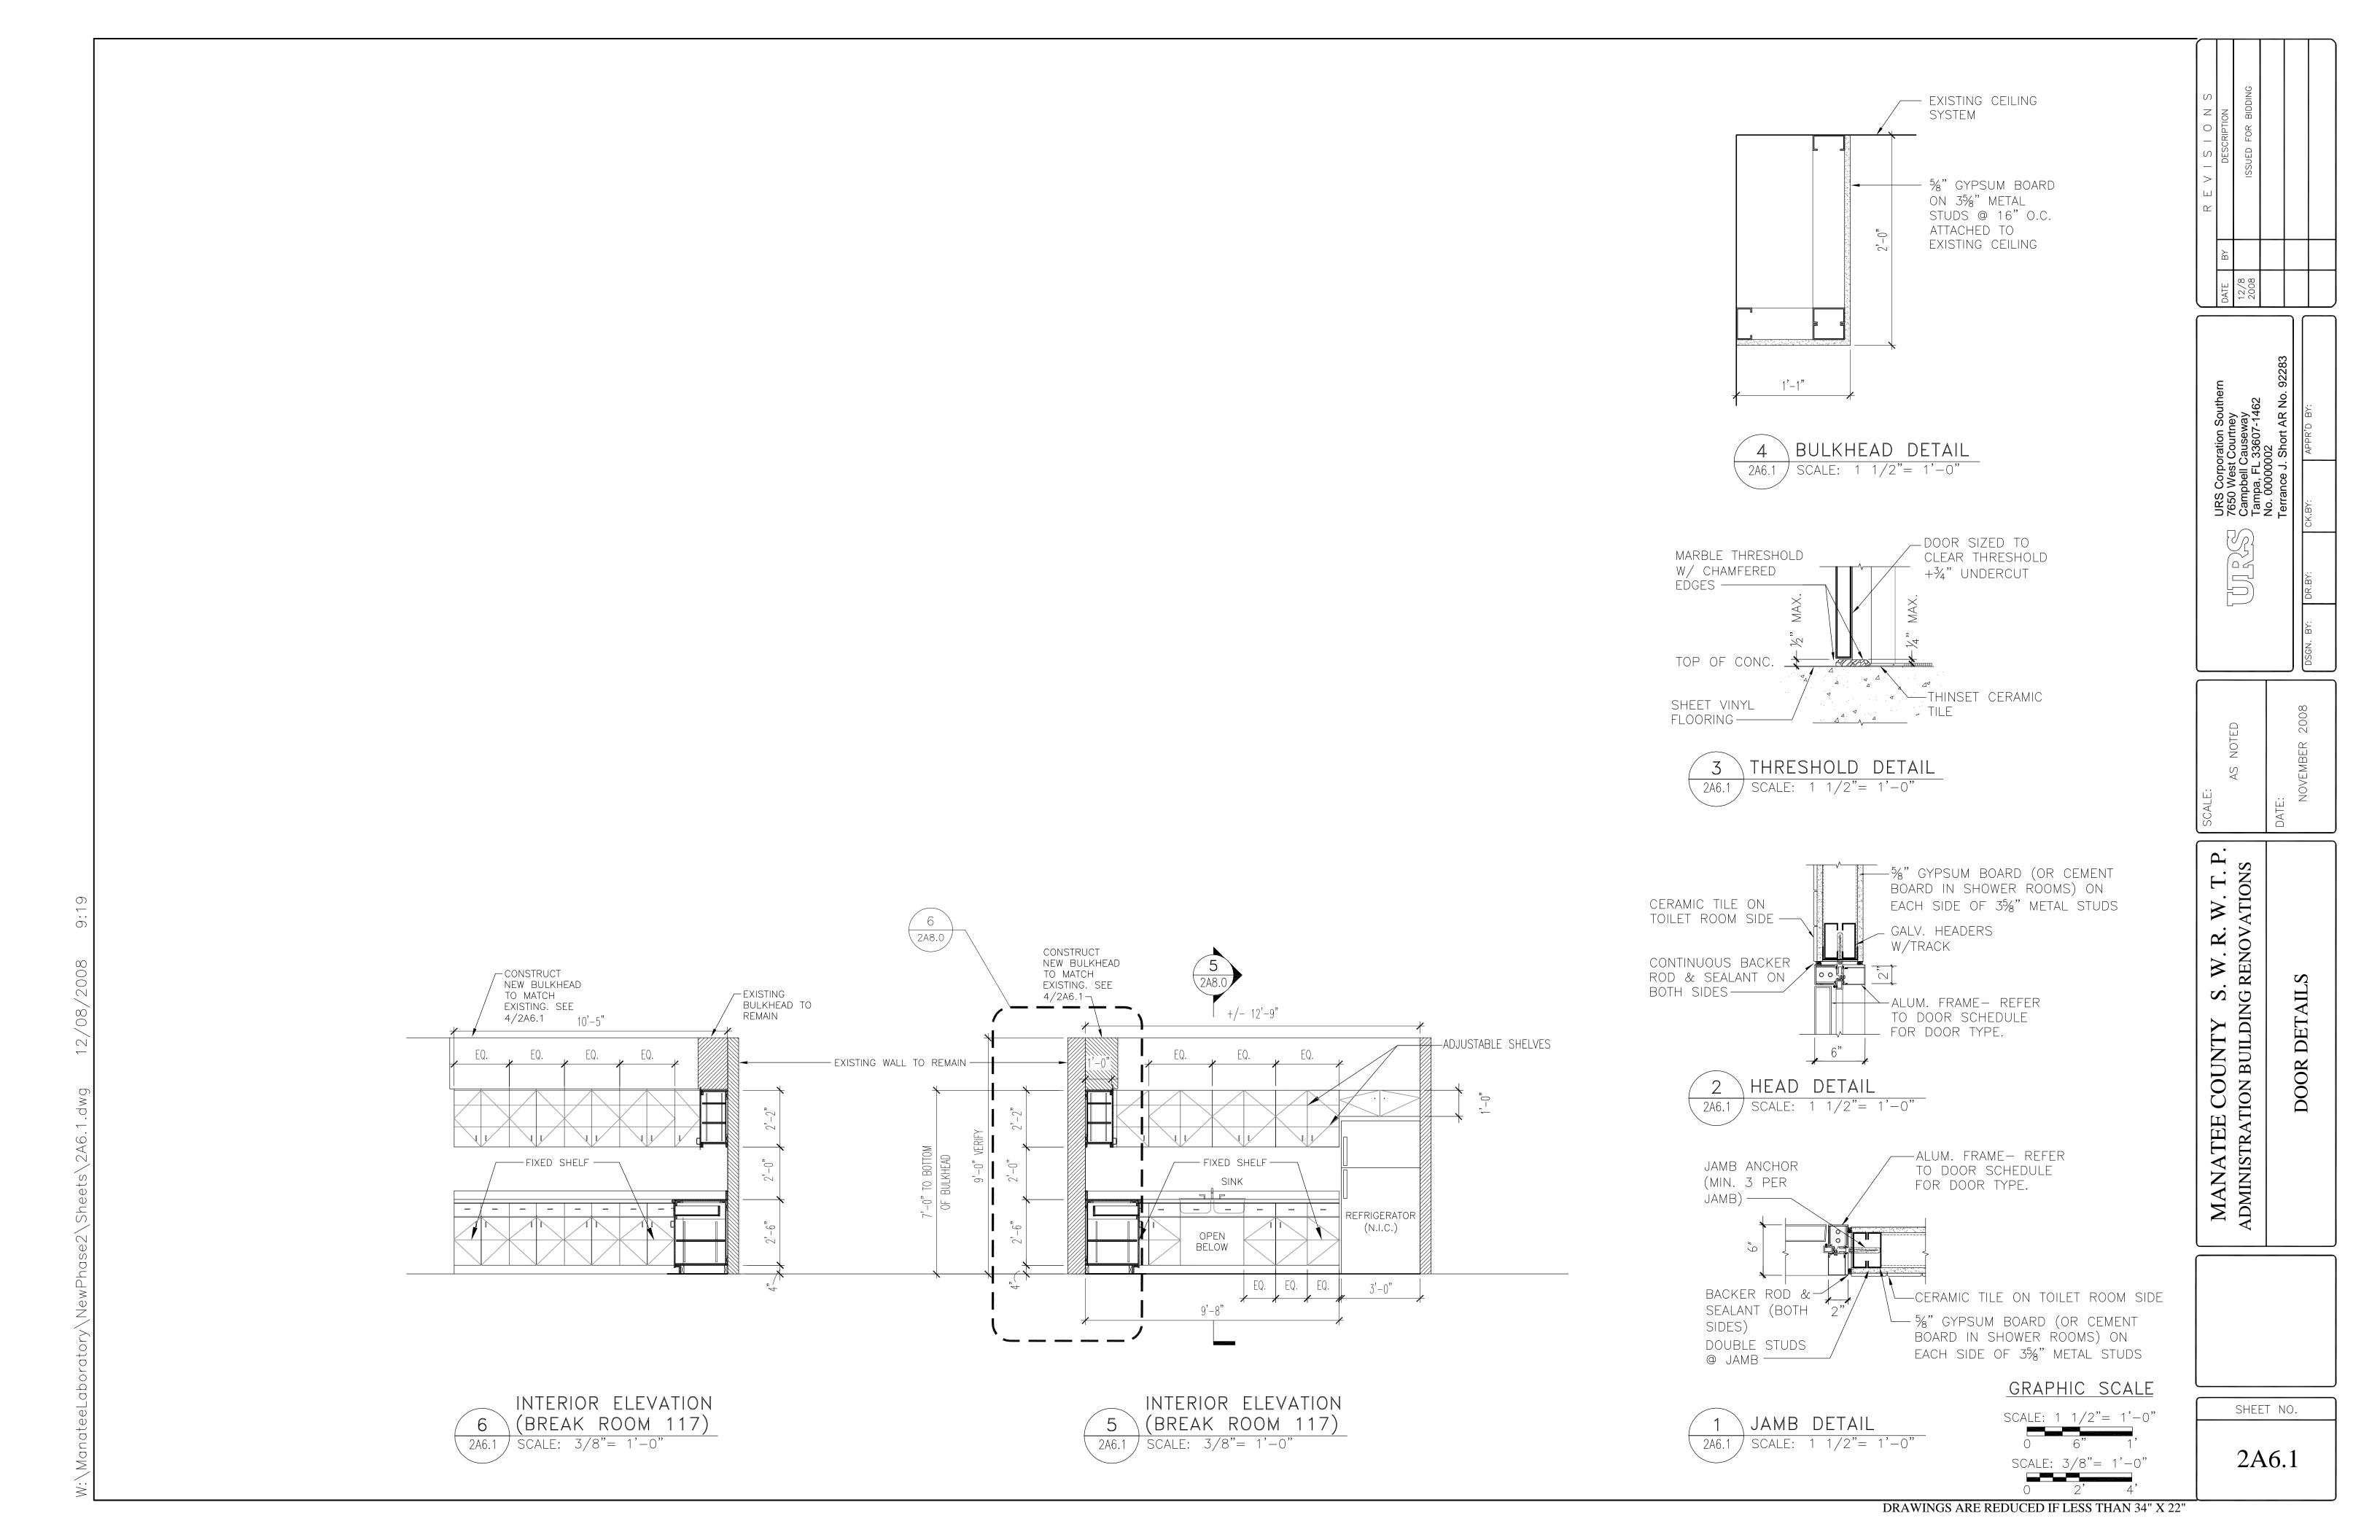

SIGN SCHEDULE							
ROOM NO.	TEXT	PRIORITY LOCATION	PICTOGRAM	"IN USE"			
103	WOMEN'S TOILET & SHOWER	ONE	YES	-			
104	MEN'S TOILET	ONE	YES	-			
105	MANAGER	TWO	-	-			
106	CONFERENCE ROOM	ONE	-	YES			
107	COPY ROOM	ONE	-	-			
109	OPS ROOM	ONE	-	-			
110	SHOWER ROOM	ONE	-	-			
111	STORAGE	ONE	-	-			
112	STORAGE	ONE	-	-			
113	LIBRARY	ONE	-	-			
117	BREAK ROOM	ONE	-	-			



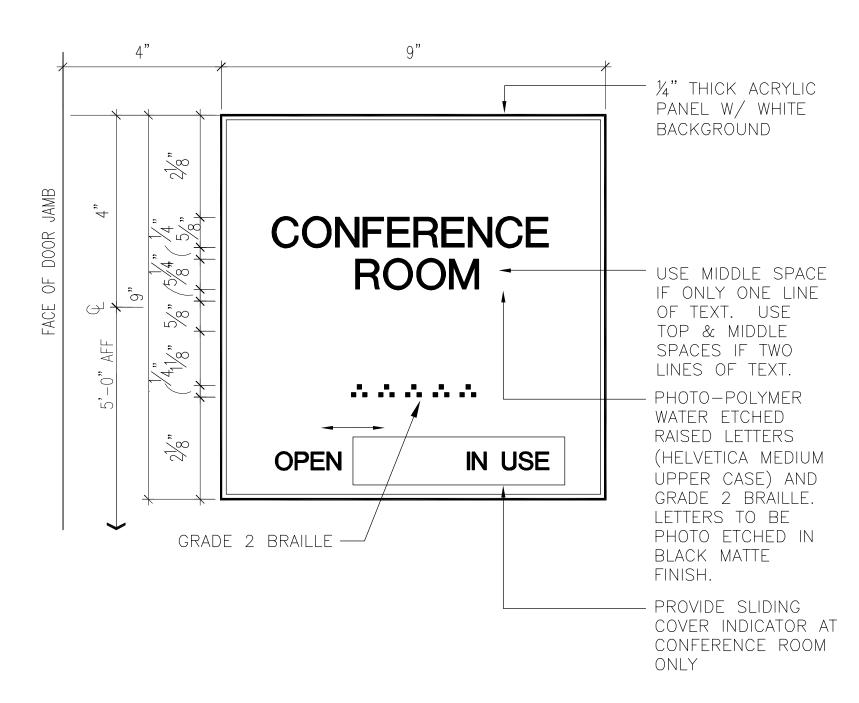

## 4 SIGN TYPE "A" DETAIL A9.0 SCALE: 6"= 1'-0"


#### SIGNAGE GENERAL NOTES

- 1. NOT USED.
- 2. PROVIDE SIGN SAMPLES FOR EACH TYPE OF SIGN WITH COLOR CHART, PATTERNS AVAILABLE, AND TEXTURES FOR OWNER/ARCHITECT REVIEW AND APPROVAL.
- 3. CONFIRM SIGN MOUNTING LOCATION WITH THE OWNER'S REPRESENTATIVE PRIOR TO INSTALLATION.
- 4. THE EXTENT OF SIGNS IS INDICATED ABOVE.
- 5. PROVIDE SIGN TYPE "B" WITH GRAPHIC SYMBOLS INDICATING ACCESSIBILITY FOR ALL TOILET ROOM DOORS.
- 6. SIGNS SHALL BE INSTALLED USING CONCEALED FASTENERS.




A9.0 / SCALE: 6"= 1'-0"


5 SIGN TYPE "B" DETAIL

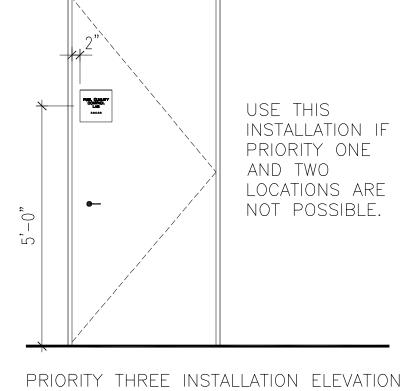



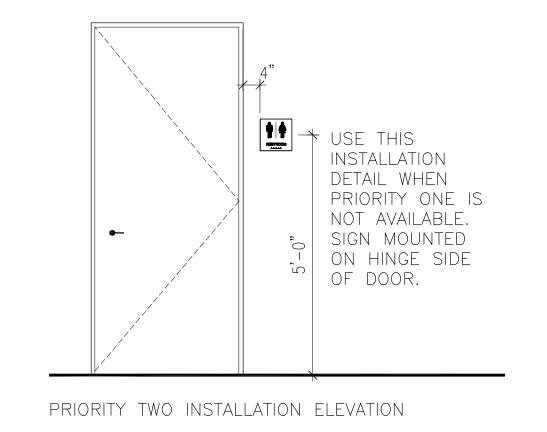



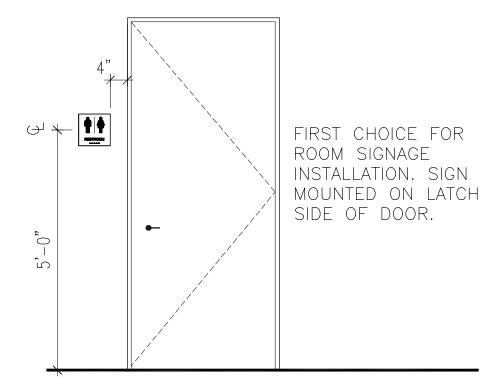

PRIORITY ONE INSTALLATION ELEVATION



JRS Corporation Southern 7650 West Courtney Campbell Causeway Fampa, FL 33607-1462 No. 00000002 Terrance J. Short AR No.: 92283	APPR'D BY:
URS Corporation Sor 7650 West Courtney Campbell Causeway Tampa, FL 33607-14 No. 00000002 Terrance J. Short AF	CK.BY:
	DR.BY:
	DSGN. BY:


AS NOTED	DATE: January 1, 2005


MANATEE COUNTY S. W. R. W. T. P.
NEW LABORATORY BUILDING AND
ADMINISTRATION BUILDING RENOVATIONS
PROJECT SIGNAGE, DETAILS & NOTES


BID DOCUMENTS

SHEET NO.

2A6.2

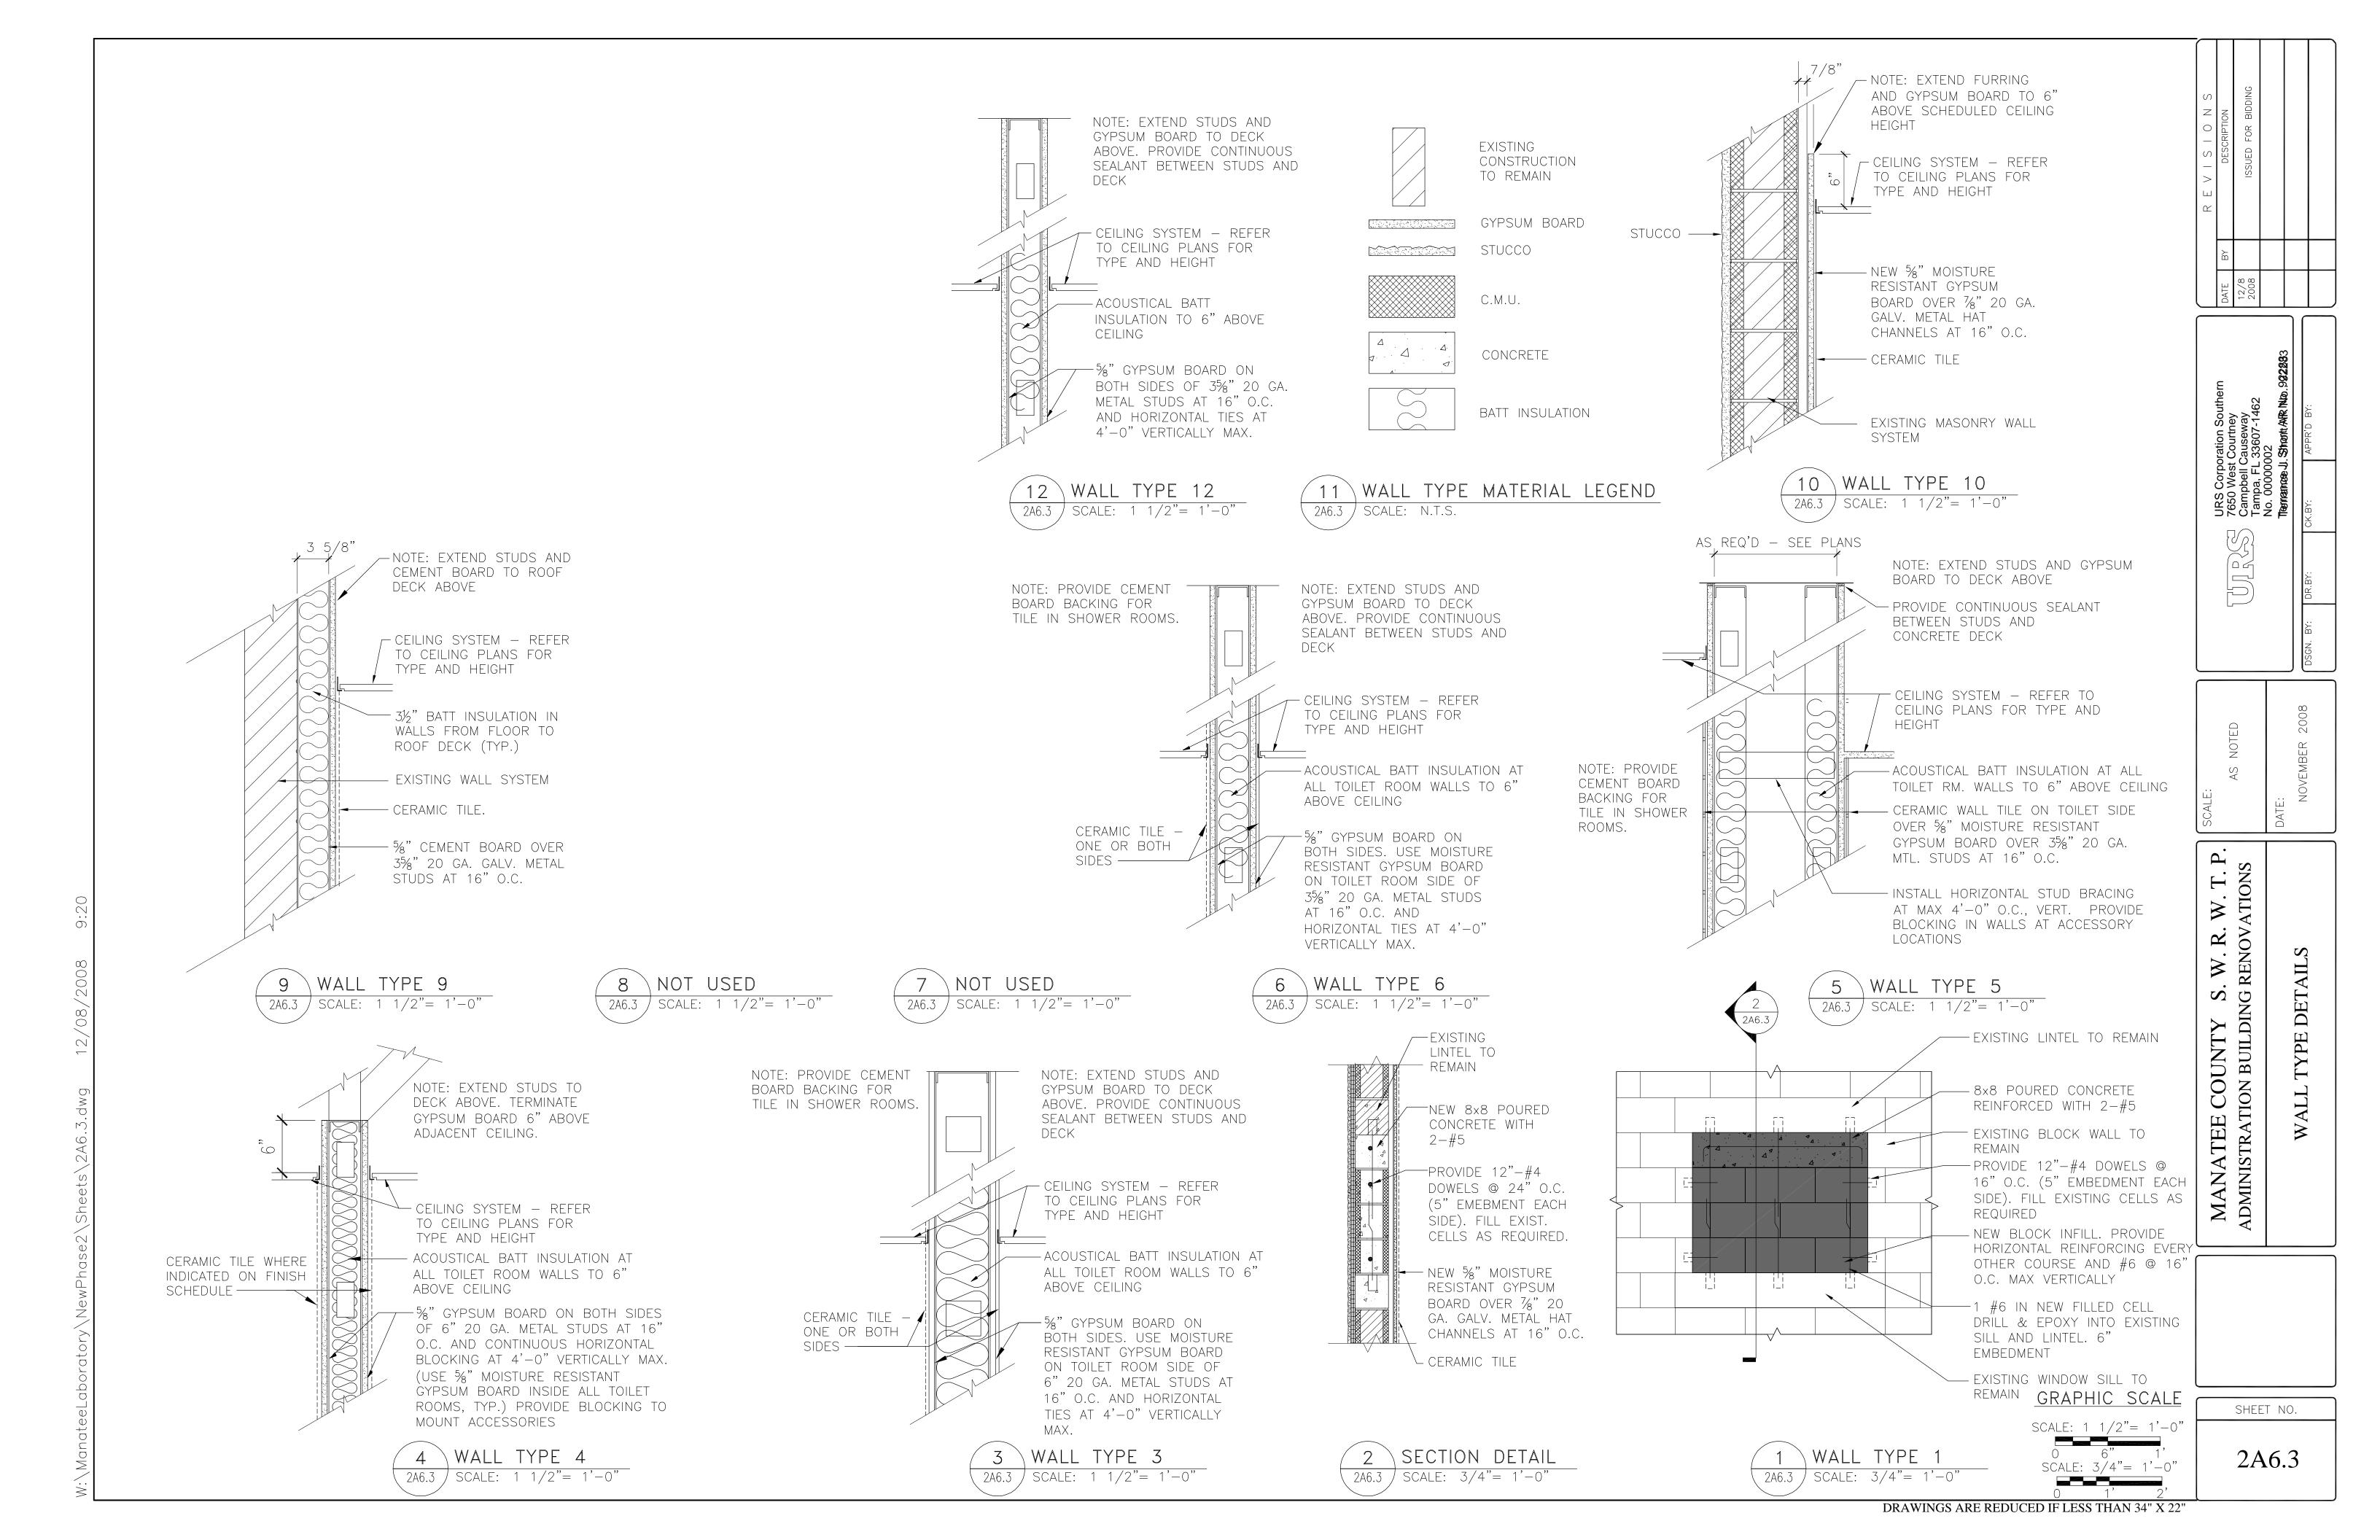

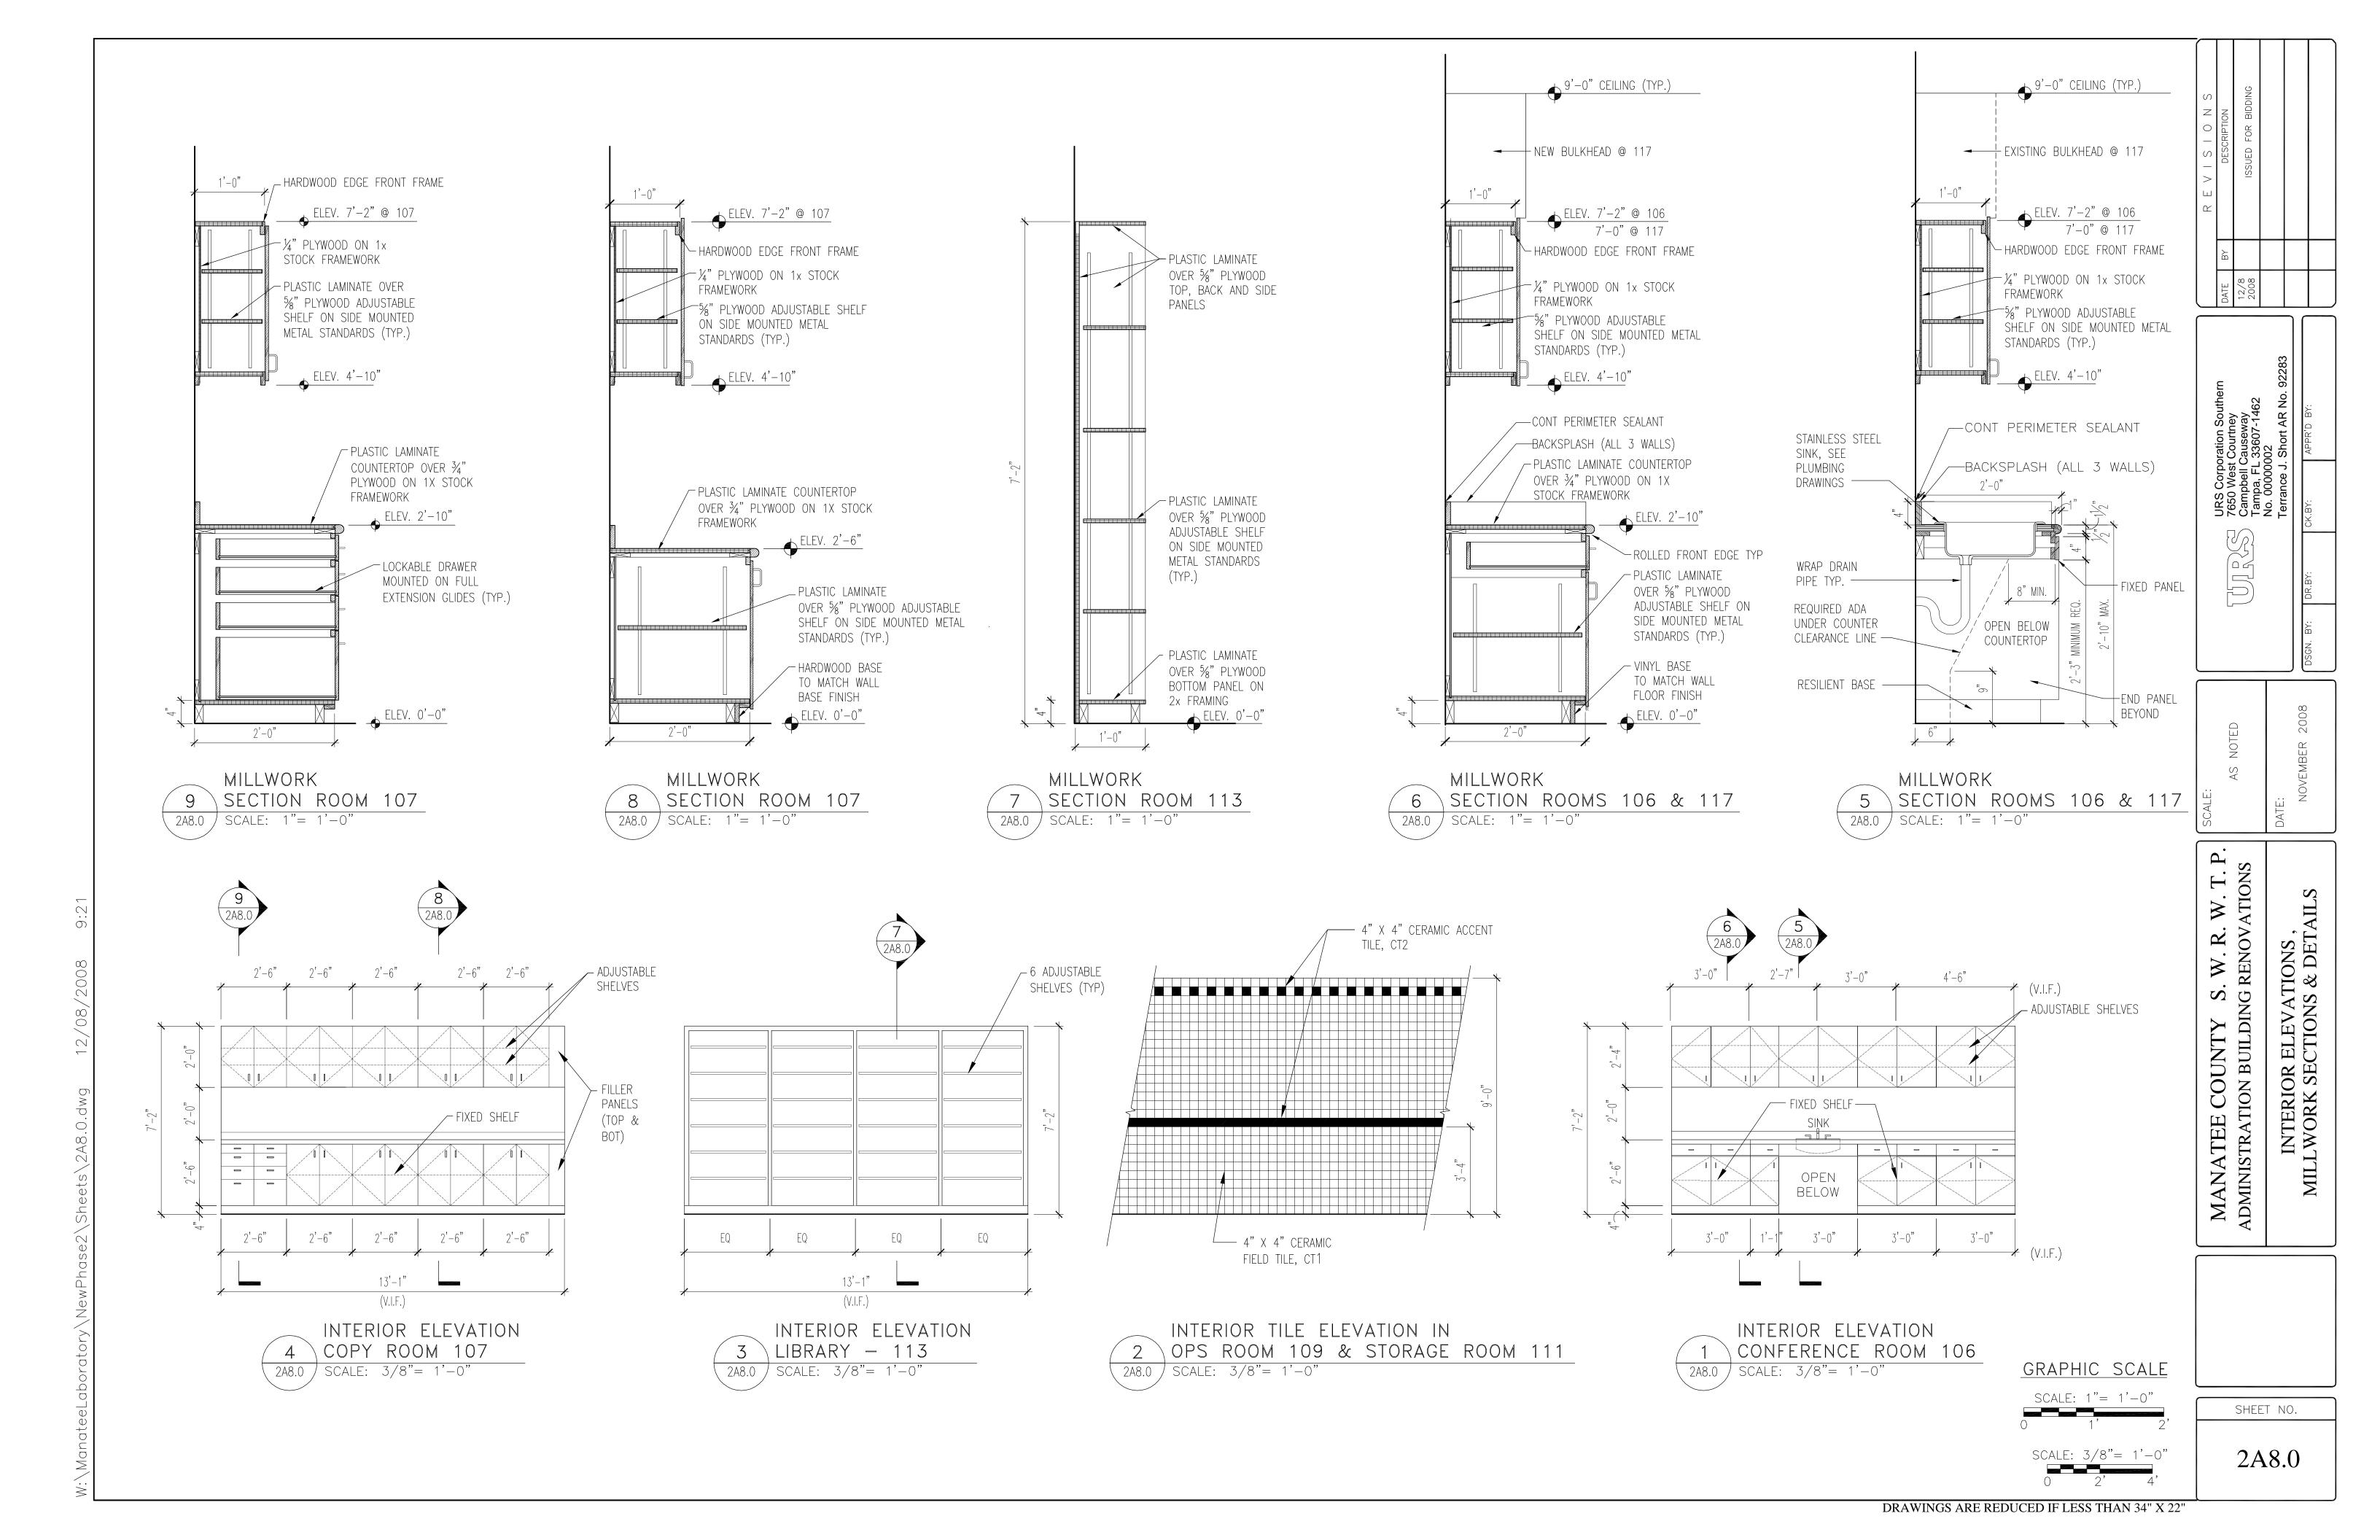

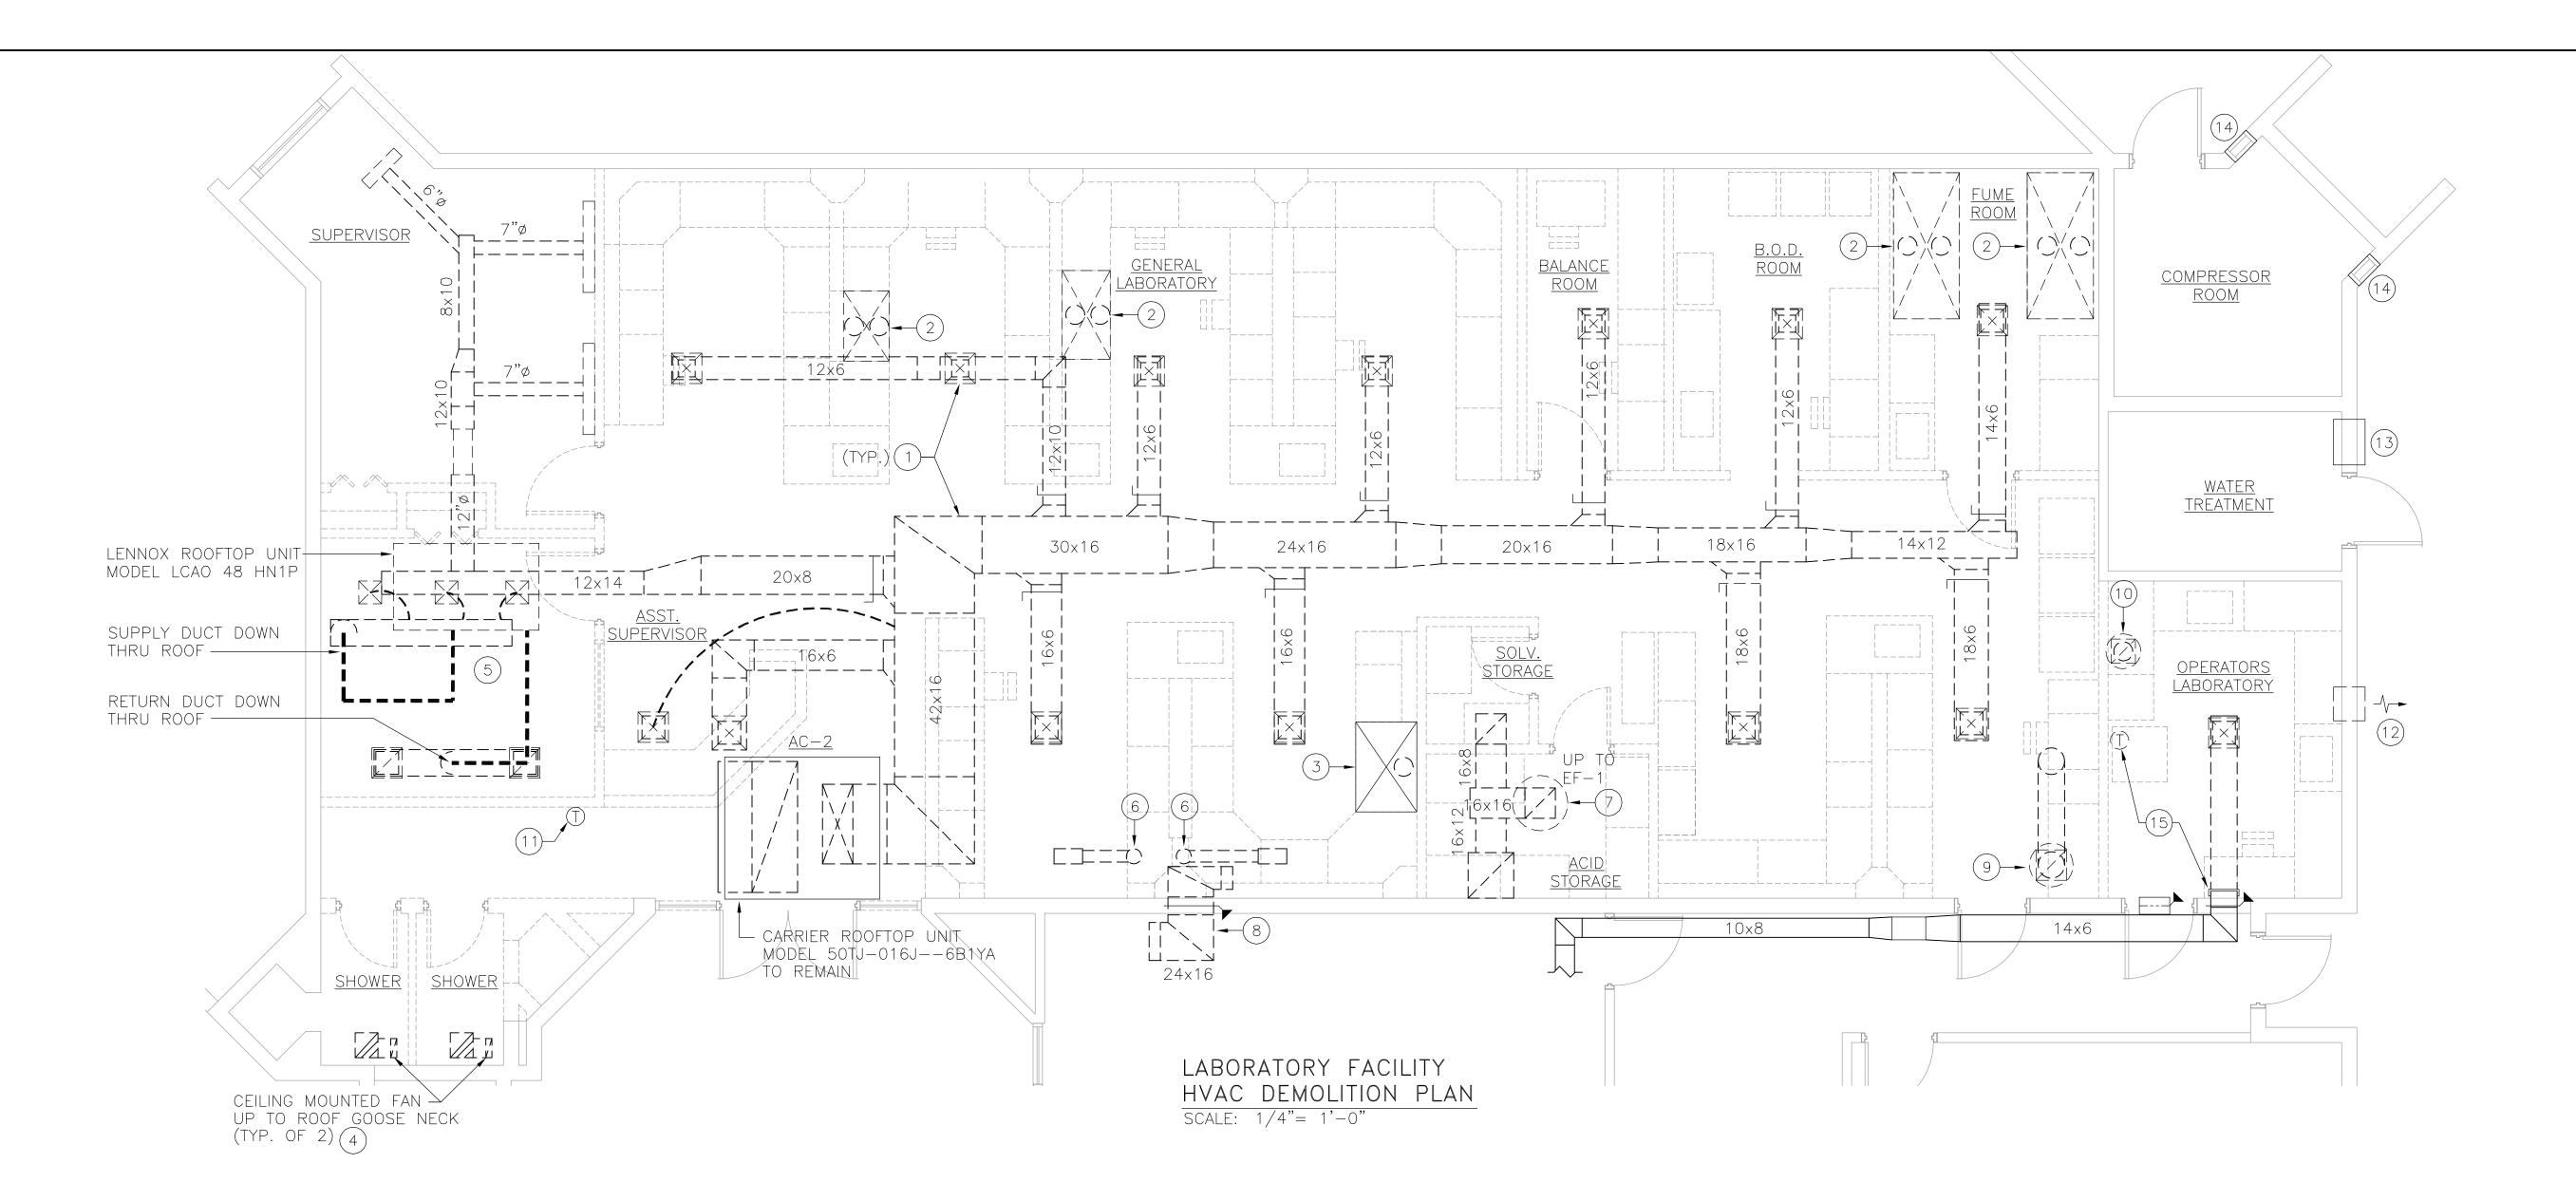


#### HVAC GENERAL DEMOLITION NOTES:


- 1. IN GENERAL, THE DRAWINGS OF EXISTING SYSTEMS ARE SCHEMATIC ONLY AND SHOULD NOT BE SCALED FOR FABRICATION. SIZES AND LOCATIONS OF ALL ALL EXISTING HVAC EQUIPMENT, DUCTWORK, PIPING, ETC., AS SHOWN, ARE TO THE BEST OF OUR KNOWLEDGE CORRECT AND ARE PROVIDED TO ASSIST THE CONTRACTORS IN THE PREPARATION OF THEIR BID.
- 2. THE CONTRACTOR SHALL CAREFULLY STUDY AND COMPARE THE CONTRACT DRAWINGS AND SPECIFICATIONS WITH EACH OTHER AND ACTUAL FIELD CONDITIONS AND SHALL NOTIFY THE OWNER/ENGINEER OF ANY ERROR, INCONSISTENCY, OR OMMISION DISCOVERED BEFORE SUBMITTAL OF BID.
- 3. THE CONTRACTOR SHALL DISPOSE OF OR RECYCLE REFRIGERANT IN ACCORDANCE WITH LOCAL AND FEDERAL REGULATIONS.
- 4. ALL ROOF MOUNTED EQUIPMENT AND ASSOCIATED ROOF PENETRATIONS SHALL REMAIN UNLESS INDICATED OTHERWISE.
- 5. THE MECHANICAL CONTRACTOR SHALL PROVIDE ALL ROOF PATCHING REQUIRED FOR THE EXISTING BUILT-UP ROOFING SYSTEM IN CONJUNCTION WITH THE REMOVAL AND INSTALLATION OF ROOFTOP MECHANICAL EQUIPMENT. ALL PATCHING WORK SHALL BE IN ACCORDANCE WITH THE ROOFING MANUFACTURER'S PRINTED INSTRUCTIONS AND CURRENT RECOMMENDATIONS. THE COMPLETED PATCHING WORK SHALL RESULT IN MAINTAINING THE WATERTIGHT INTEGRITY OF THE ROOFING SYSTEM.
- 6. THE CONTRACTOR SHALL VISIT THE PROJECT DEMOLITION AREA, BECOME FAMILIAR WITH THE SCOPE AND EXTENT OF ALL PHASE TWO WORK, INCLUDING WORK ABOVE THE ACOUSTICAL CEILINGS AND ON THE ROOF TOP, PRIOR TO SUBMITTING THEIR BIDS SO AS TO INCLUDE THE COST FOR THE EXTIRE SCOPE OF WORK IN THE BID PROPOSAL. CONTRACTOR WILL CONTINUE DEMOLITION TO THE OWNER'S SATISFACTION INCLUDING ALL ITEMS SHOWN AND THOSE DISCOVERED AT NO ADDITIONAL COST TO OWNER.
- 7. ALL EQUIPMENT, HOODS AND FANS SHALL BE TURNED OVER TO THE OWNER. ALL OTHER DEMOLITION ITEMS SHALL BE PROPERLY DISPOSED OF BY THE CONTRACTOR. THE CONTRACTOR SHALL BE RESPONSIBLE FOR PROTECTION, CLEANING AND REUSE AND/OR RESTART OF ALL MATERIALS AND EQUIPMENT INDICATED FOR REUSE. (REFINISHING, REINSTALLATION AND RESTARTING.)

#### HVAC DEMOLITION KEYED NOTES:

- 1 REMOVE MAIN AND BRANCH DUCTS AND SUPPLY/RETURN DIFFUSERS AS INDICATED. COORDINATE SCOPE OF DEMOLITION WITH HVAC CONSTRUCTION PLAN 2M2.1
- ROOF MOUNTED COMBINATION SUPPLY/EXHAUST FAN UNIT SERVING CHEMICAL FUME HOOD IN LAB. CAREFULLY REMOVE ROOF MOUNTED FAN UNIT AND FUME HOOD AND DELIVER TO OWNER. EXISITNG ROOF EQUIPMENT CURBS SHALL REMAIN AND BE CAPPED. PROVIDE GALVANIZED SHEET METAL CAP, INSULATE, ANCHOR, AND SEAL.
- 3 REMOVE COMBINATION FAN AND FUME HOOD AS INDICATED IN NOTE 2. RELOCATE AS INDICATED ON HVAC CONSTRUCTION PLAN 2M2.1.
- REMOVE CEILING MOUNTED EXHAUST FAN AND EXHAUST DUCT. CAP EXHAUST DUCT BELOW ROOF. GOOSE NECKS WITH ROOF PENETRATION TO REMAIN.
- 5 CAREFULLY REMOVE LENNOX ROOF TOP PACKAGE UNIT AND DELIVER TO OWNER. REMOVE ALL ASSOCIATED DUCT, SUPPLY/RETURN DIFFUSERS, CONTROLS, ETC. CAP EQUIPMENT CURBS AND ROOF PENETRATIONS AS INDICATED IN NOTE 2. SUPPLY DUCT ROOF PENETRATION SHALL REMAIN FOR INSTALLATION OF NEW EXHAUST FAN. COORDINATE WITH NEW HVAC PLAN 2M2.1.
- 6 REMOVE EXHAUST FAN AND EXHAUST DUCT. CAP EXHAUST DUCT BELOW ROOF. EXISTING ROOF PENETRATION AND WATER PROOFING TO REMAIN.
- 7) REMOVE ROOF MOUNTED EXHAUST FAN. REMOVE ALL ASSOCIATED DUCT, GRILLES, CONTROLS, ETC. CAP EQUIPMENT CURB AS INDICATED IN NOTE 2.
- 8 REMOVE TRANFER DUCT WITH FIRE DAMPER. PATCH WALL TO MATCH EXISTING WALL CONSTRUCTION.

- 9 REMOVE ROOF MOUNTED EXHAUST FAN. REMOVE ALL ASSOCIATED DUCT, GRILLES, CONTROLS, AND ROOFCURB. ROOF PENETRATION SHALL BE RE-USED AS INDICATED ON NEW HVAC CONSTRUCTION PLAN 2M2.1
- (10) REMOVE ROOF MOUNTED EXHAUST FAN. REMOVE ALL ASSOCIATED DUCT, GRILLES, CONTROLS, AND ROOFCURB. ROOF PENETRATION SHALL BE RE-USED AS INDICATED ON NEW HVAC CONSTRUCTION PLAN 2M2.1
- (1) REMOVE THERMOSTAT AND PROVIDE NEW AS SPECIFIED AT LOCATION INDICATED ON HVAC CONSTRUCTION PLAN 2M2.1
- REMOVE THROUGH WALL EXHAUST FAN. PATCH WALL TO MATCH EXISTING WALL CONSTRUCTION.
- (13) THROUGH WALL AIR CONDITIONING UNIT TO REMAIN.
- (14) WALL VENTILATION LOUVER TO REMAIN.
- (15) PATCH, SEAL AND INSULATE ABANDONED DUCT AIR TIGHT.
  REMOVE ROOM THERMOSTAT AND CONTROL WIRING.
  TERMINATE AT CONTROL PANEL.

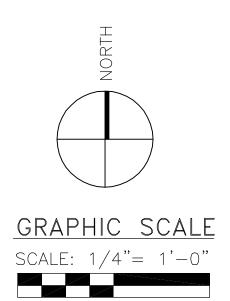

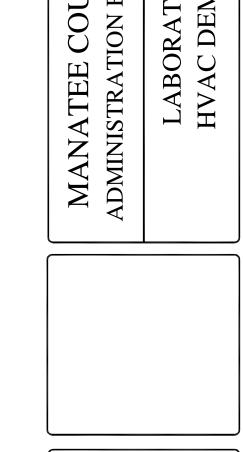


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LABORATORY FACILITY HVAC DEMOLITION PLAN

2M2.0



#### HVAC GENERAL CONSTRUCTION NOTES:

- 1. DUCT SIZES SHOWN ARE CLEAR INSIDE FREE AREA SHEET METAL SIZES.
- 2. VERIFY COLLAR SIZES ON ALL AIR TERMINALS, EQUIPMENT INLETS AND OUTLETS. TRANSITION DUCTWORK AS NECESSARY. EXTERNALLY INSULATE TRANSITIONS AT EQUIPMENT CONNECTIONS.
- 3. SEE REFLECTED CEILING PLANS FOR EXACT LOCATION OF ALL CEILING OUTLETS.
- 4. CONTRACTOR SHALL VERIFY CLEARANCE SPACE AVAILABLE, OFFSETS REQUIRED, STRUCTURAL OPENINGS, AND WORK BY OTHER TRADES PRIOR TO FABRICATION OF DUCTWORK. SUBMIT SHOP DRAWINGS ON DUCTWORK LAYOUT. COORDINATE WITH ROOF TRUSSES/STRUCTURE. PRESSURE TEST ALL DUCTWORK FOR LEAKS, SEE SPECIFICATIONS.
- 5. PROVIDE DUCT FLEX CONNECTIONS FOR ALL UNITS. EXTERNALLY INSULATE FLEXIBLE CONNECTIONS.
- 6. PROVIDE FULL SIZE INSULATED COPPER CONDENSATE DRAINS FROM ALL UNITS TO DISPOSAL POINT INDICATED ON THE DRAWINGS.
- 7. PROVIDE A TRAP ON ALL CONDENSATE DRAIN OUTLETS. SLOPE ALL CONDENSATE DRAIN PIPING 1/8" INCH PER FOOT.
- 8. CONTRACTOR SHALL INSTALL ALL EQUIPMENT, PIPING AND DUCTWORK SUCH THAT MANUFACTURERS' RECOMMENDED CLEARANCES ARE MET FOR ALL ACCESS PANELS, COILS, MOTORS, FANS, BELTS, FILTERS, AND AIR INTAKES.
- 9. PROVIDE ACCESS PANELS IN ALL NON-ACCESSIBLE CONSTRUCTIONS (INCLUDING CEILING, WALLS, ETC.) SIZED AND LOCATED AS REQUIRED TO PROVIDE PROPER SERVICE ACCESS IN ACCORDANCE WITH THE MANUFACTURERS RECOMMENDATION FOR ALL HVAC EQUIPMENT INCLUDING DAMPERS AND VALVES.
- 10. ALL ROOF MOUNTED EQUIPMENT MUST ADHERE TO CURRENT HURRICANE WIND LOADING CODES REGARDING EQUIPMENT TIE-DOWN AND WIND RESISTANCE. PROVIDE TIE-DOWN STRAPS OR STAINLESS STEEL CABLE GUY WIRES, THIMBLES AND TURNBUCKLES SECURED TO STAINLESS STEEL EYEBOLTS FASTENED TO CONCRETE DECK. COORDINATE ROOF REPAIR WORK WITH ARCHITECTURAL PLANS AND DETAILS.
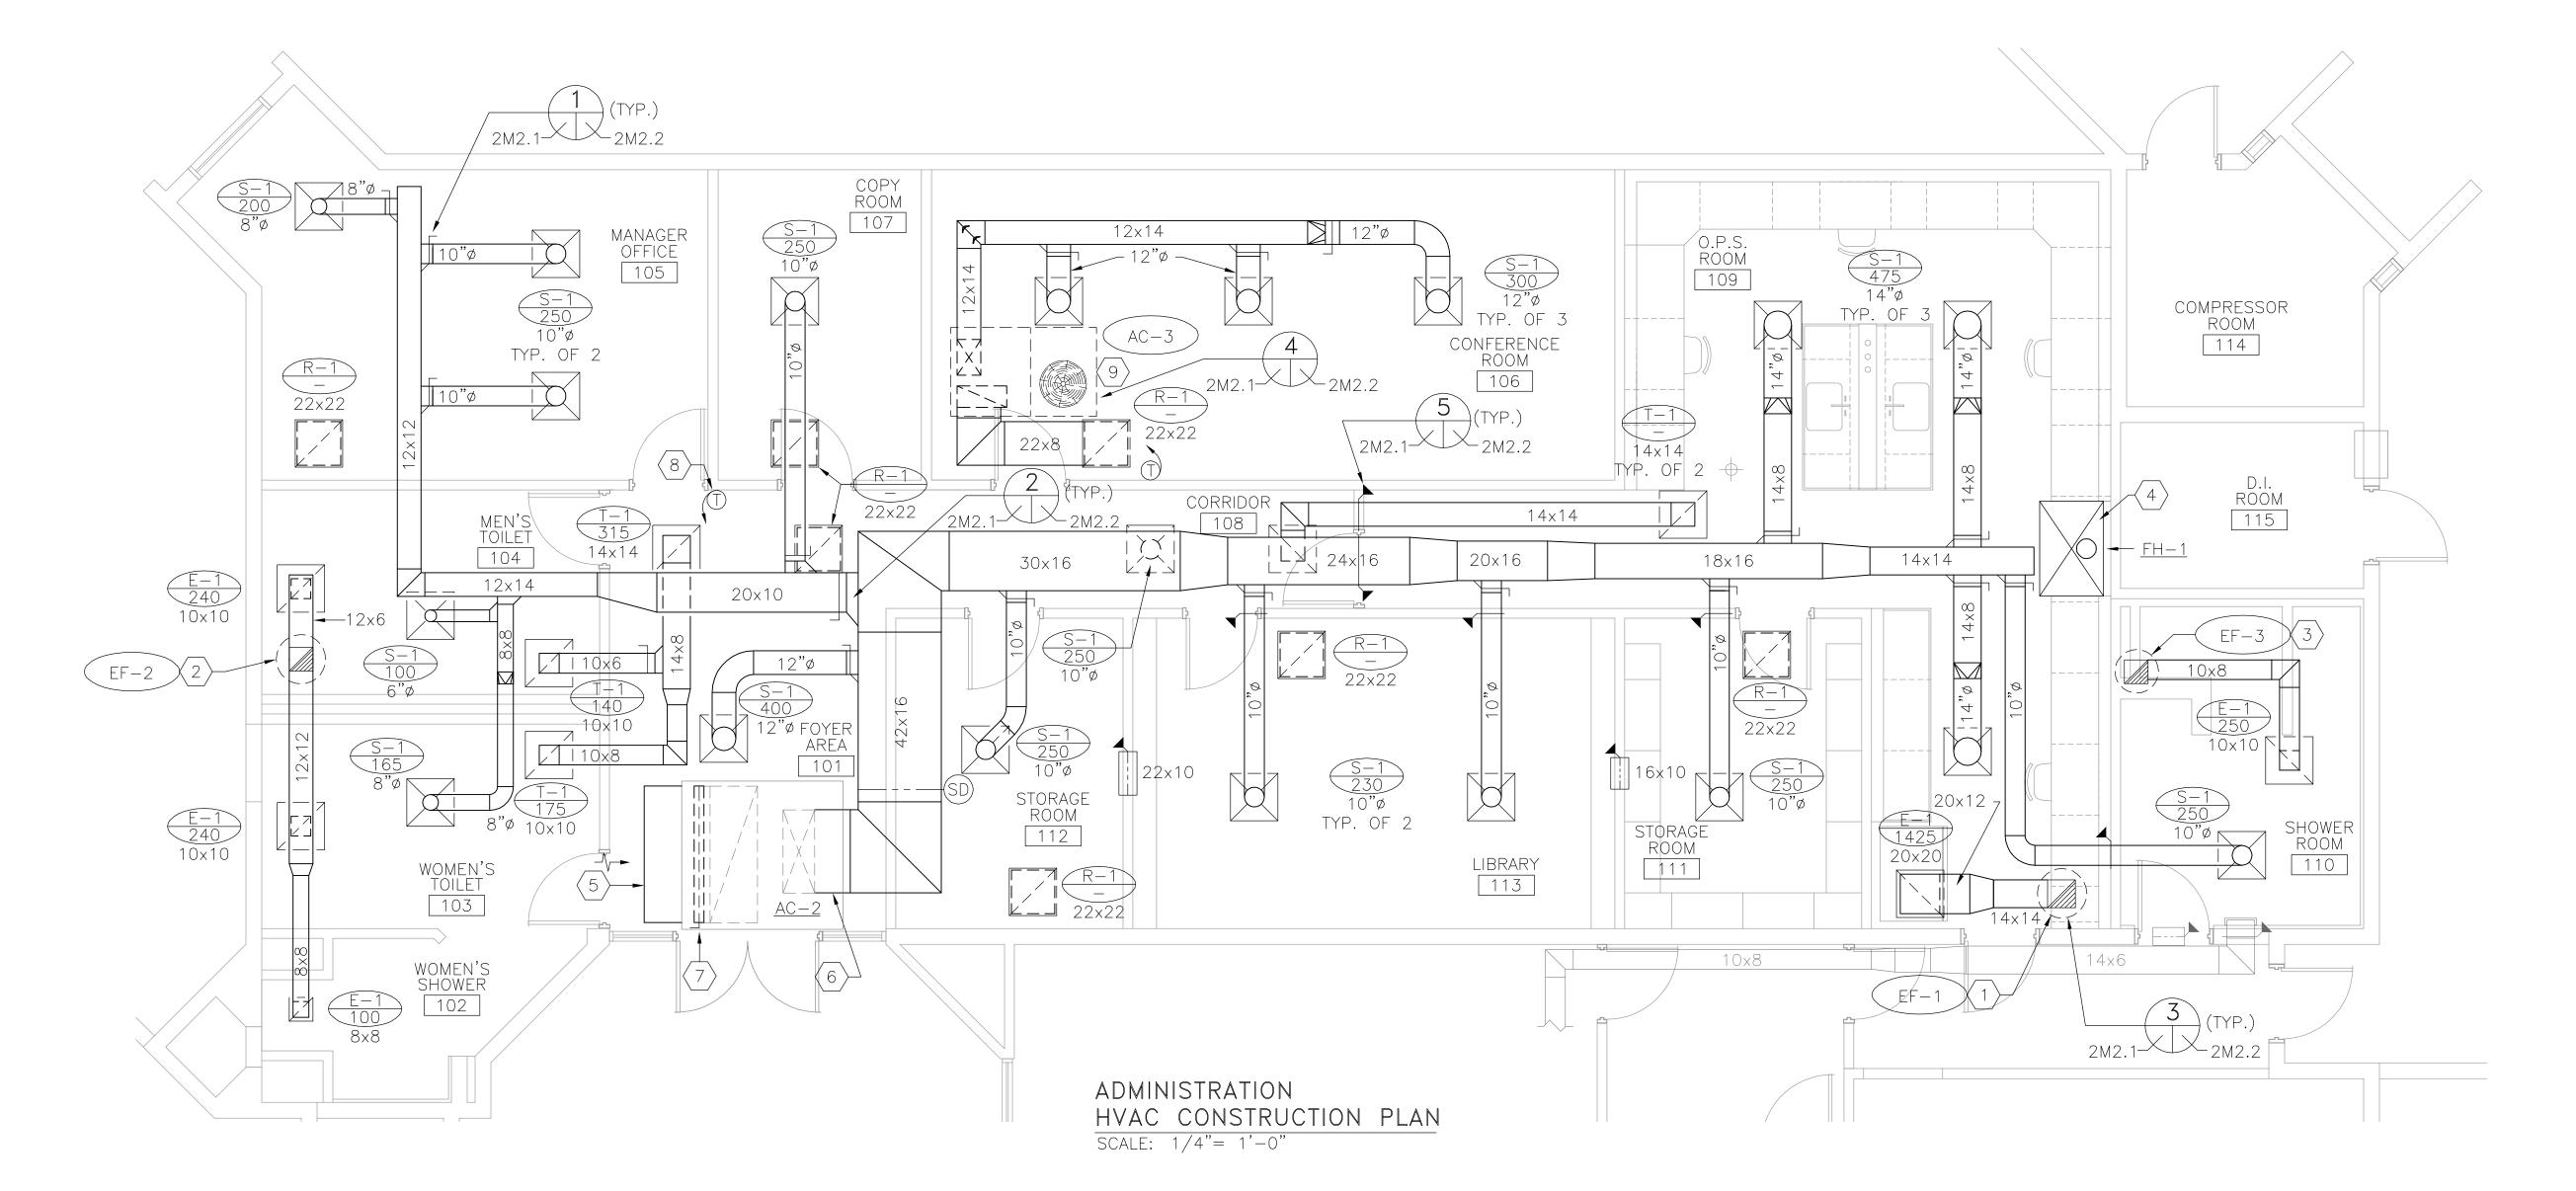
#### AC-2 SEQUENCE OF OPERATION

#### UN-OCCUPIED MODE:

OUTSIDE AIR INTAKE DAMPER SHALL BE CLOSED.

INTERLOCKED EXHAUST FANS (EF-1, EF-2 AND EF-3) SHALL BE DE-ENERGIZED.

UNIT FAN AND COMPRESSOR SHALL CYCLE AS REQUIRED TO MAINTAIN SPACE TEMPERATURE.

#### OCCUPIED MODE:

OUTSIDE AIR INTAKE DAMPER SHALL BE OPEN. INTERLOCKED EXHAUST FANS (EF-1, EF-2 AND EF-3) SHALL BE ENERGIZED. UNIT FAN SHALL RUN CONTINUOUSLY AND COMPRESSOR SHALL

### AC-3 SEQUENCE OF OPERATION

#### UN-OCCUPIED MODE:

OUTSIDE AIR INTAKE DAMPER SHALL BE CLOSED.
UNIT FAN AND COMPRESSOR SHALL CYCLE AS REQUIRED TO
MAINTAIN SPACE TEMPERATURE.


CYCLE AS REQUIRED TO MAINTAIN SPACE TEMPERATURE.

#### OCCUPIED MODE:

OUTSIDE AIR INTAKE DAMPER SHALL BE OPEN. UNIT FAN SHALL RUN CONTINUOUSLY AND COMPRESSOR SHALL CYCLE AS REQUIRED TO MAINTAIN SPACE TEMPERATURE.

#### HVAC CONSTRUCTION KEYED NOTES:

- 1 14x14 EXHAUST DUCT UP TO ROOF EXHAUST FAN EF-1. COORDINATE LOCATION WITH EXISTING ROOF PENETRATION.
- 2 12x12 EXHAUST DUCT UP TO ROOF EXHAUST FAN EF-2. COORDINATE LOCATION WITH EXISTING ROOF PENETRATION.
- 3 10x8 EXHAUST DUCT UP TO ROOF EXHAUST FAN EF-3. COORDINATE LOCATION WITH EXISTING ROOF PENETRATION.
- CONTRACTOR SHALL RELOCATE EXISTING FUME HOOD AND ROOF MOUNTED EXHAUST FAN. PROVIDE NEW ROOF CURB, ROOF PATCHING, DUCT, CONTROL WIRING, ETC. AS REQUIRED TO RESTORE OPERATION OF RELOCATED HOOD. INSTALLATION SHALL COMPLY WITH NFPA 45, 70 AND 91 REQUIREMENTS.
- THE CONTRACTOR SHALL FABRICATE AND INSTALL OUTSIDE AIR INTAKE HOOD WITH MOTORIZED DAMPER AND REPLACEABLE CARBON FILTERS. BALANCE AC-2 AIRFLOW TO 4,500 TOTAL SUPPLY, 2,105 CFM OUTSIDE AIR.
- 6 PROVIDE ALL FITTINGS REQUIRED TO CONNECT NEW DUCT TO EXISTING.
- PROVIDE NEW OPPOSED BLADE DAMPER ASSEMBLY (FULL SIZE OF OPENING) AT RETURN AIR OPENING FOR SYSTEM BALANCING.
- 8 PROVIDE NEW 7 DAY PROGRAMMABLE THERMOSTAT FOR AC-2. SEE SEQUENCE OF OPERATION FOR CONTROL POINTS.
- (9) DISCHARGE CONDENSATE TO NEAREST ROOF DRAIN. FINAL TERMINATION IS SITE STORM SEWER.

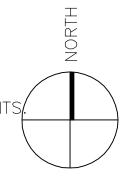

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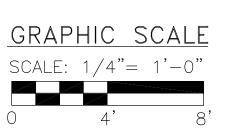
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SHEET NO.

2M2.1



#### NOTES:

- 1. PROVIDE WITH UNIT MOUNTED DISCONNECT SWITCH.
- 2. PROVIDE WITH UNIT MANUFACTURERS 14" HIGH ROOF CURB.
- 3. INTERLOCK WITH AC-2.
- 4. PROVIDE WITH GRAVITY BACKDRAFT DAMPER.
- 5. PROVIDE WITH SOLID STATE SPEED CONTROL.


#### CONTRACTOR NOTE:


THE FOLLOWING ITEMS ARE OWNER PURCHASED, CONTRACTOR INSTALLED. COORDINATE AND VERIFY INVENTORY WITH OWNER AND PLANS PRIOR TO COMMENCEMENT OF WORK.

NOT TO SCALE

|EF-2|

AIR DISTRIBUTION DEVICES

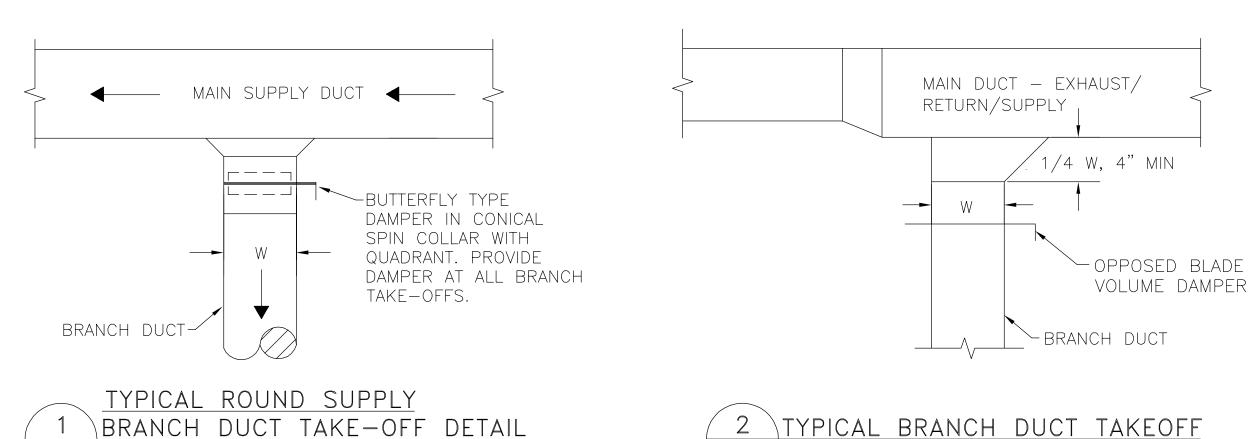

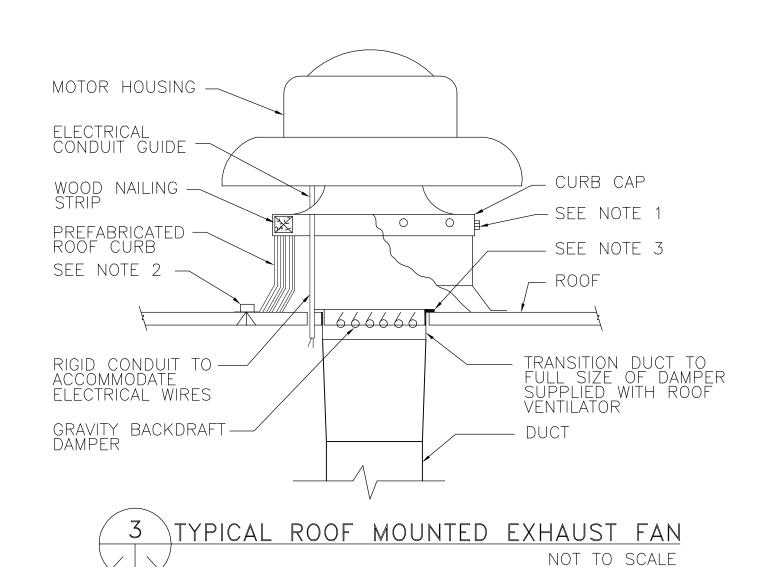

#### NOTES:

- 1. SECURE CURB CAP TO WOOD NAILING STRIP WITH 3/8" CADMIUM PLATED LAG BOLTS NOT OVER 12" ON CENTER.
- 2. SECURE ROOF CURB, DUCTWORK AND DAMPER TO ROOF WITH EXPANSION BOLTS (CONCRETE ROOF) OR RUST RESISTANT BOLTS (METAL DECK AND BAR JOIST ROOF) REFER TO STRUCTURAL DRAWINGS FOR ADDITIONAL INFORMATION.
- 3. SIZE OF DUCT THROUGH ROOF SHALL NOT BE LARGER THAN CURB SUPPLIED WITH ROOF VENTILATOR.
- 4. RUN ELECTRICAL LINES THROUGH CLEARANCE HOLE PROVIDED IN GRAVITY DAMPER, THEN THROUGH VENTILATOR ELECTRICAL CONDUIT GUIDE.
- 5. PROVIDE WITH HURRICANE TIE DOWN POINTS AND STRAPS.

#### AIR DISTRIBUTION DEVICE SCHEDULE

MARK	SERVICE	DESCRIPTION	MATERIAL	DESIGN MANUFACTURER/ MODEL	ACCESSORIES
				,	
S-1	SUPPLY	24x24 PERFORATED MODULE ROUND NECK	ALUMINUM	TITUS/ PAS-AA	123
R-1	RETURN	24x24 PERFORATED MODULE SQUARE NECK	ALUMINUM	TITUS/ PAR-AA	123
E-1	EXHAUST	EGGCRATE GRILLE	ALUMINUM	TITUS/ 50F	123
T-1	TRANSFER	24x24 PERFORATED MODULE SQUARE NECK	ALUMINUM	TITUS/ PAR-AA	123


- (1) PROVIDE OPPOSED BLADE VOLUME DAMPER.
- (2) STANDARD BAKED-ON WHITE ENAMEL FINISH.
- (3) PROVIDE 24x24 CEILING MODULE AS REQUIRED.

DX ROOFTOP UNIT SCHE	EDULE
EQUIPMENT NO.	AC-3
AREA SERVED	CONF. ROOM 106
TOTAL CAPACITY (BTU/HR)	46,048
SENSIBLE CAPACITY (BTU/HR)	32,901
MINIMUM SYSTEM SEER/EER/IPLV	13.25/11.3/-
TOTAL SUPPLY AIR FLOW (CFM)	900
OUTSIDE AIR FLOW (CFM)	150
AIR TEMP (°E) DR (WR	77.6/65.7
AIR TEMP. (°F) DB/WB LEAVING	56.0/54.7
EXTERNAL STATIC PRESSURE DROP (IN. W.G.)	0.5
FILTER TYPE	2"/30% DISP.
BLOWER FAN TYPE	FC
BLOWER FAN HORSEPOWER - FLA (AMPS)	1.5 - 4.9
HEATER SIZE (KW) — STAGES	4.9-1
COMPRESSOR NO./RLA (AMPS)	1/10.3
CONDENSER FAN NO./FLA (FLA)	1/0.7
MCA/MOCP (AMPS)	23.1/25
ELEC. SERVICE (VOLTS/PHASE/HERTZ)	208/3/60
REFERENCE MANUFACTURER	CARRIER
REFERENCE MODEL NO.	50HE-004
WEIGHT (LBS.)	585
NOTES	1-9


#### NOTES:

NOT TO SCALE


- 1. PROVIDE 2"-30% EFFICIENCY PLEATED FILTERS. PROVIDE ONE SET OF REPLACEMENT FILTERS.
- 2. PROVIDE THROUGH-THE-BOTTOM POWER AND CONTROL CONNECTIONS.
- 3. PROVIDE SINGLE POINT POWER CONNECTION, UNIT MOUNTED DISCONNECT SWITCH AND STARTER.
- 4. PROVIDE IAQ CONDENSATE DRAIN PAN.
- 5. PROVIDE ANTI-CYCLE TIMER, TIME DELAY RELAY AND HEAD PRESSURE
- 6. PROVIDE MANUFACTURER'S 14" INSULATED ROOF CURB WITH SLOPED BASE TO MATCH ROOF PITCH.
- 7. PROVIDE FULL HEIGHT HINGED ACCESS DOORS PANELS.
- 8. PROVIDE WITH FACTORY 7 DAY PROGRAMMABLE THERMOSTAT. SEE
- SEQUENCE OF OPERATION FOR CONTROL POINTS.
- 9. PROVIDE WITH MOTORIZED OUTSIDE AIR DAMPER.

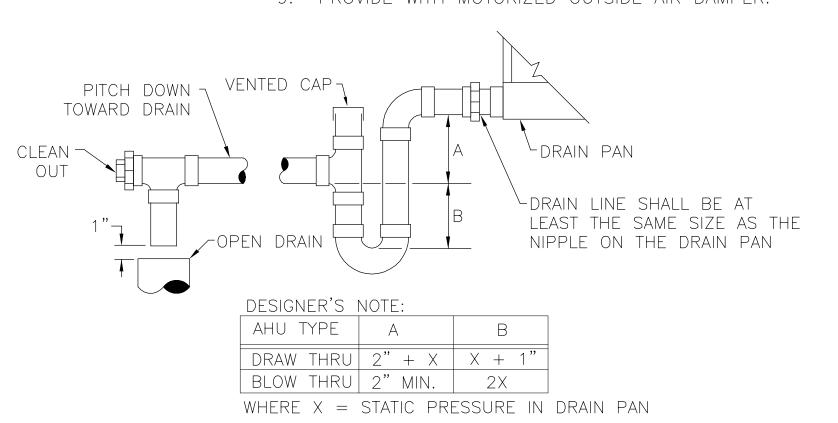



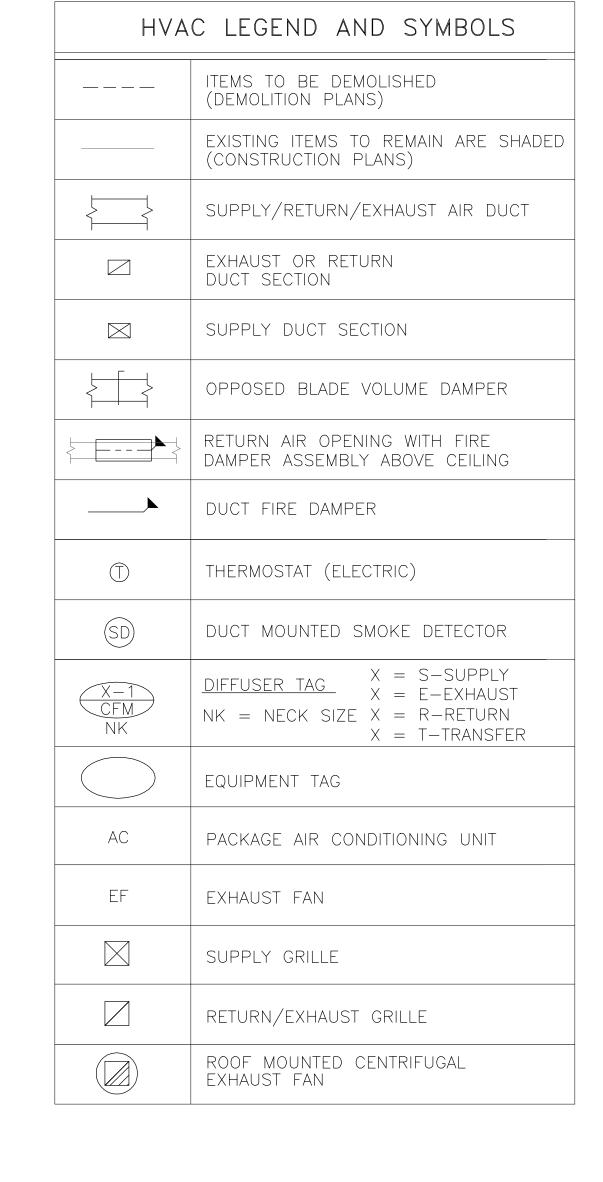


DESIGN	CONDITIONS SCHEDULE  SUMMER WINTER										
	SUMN	SUMMER WINTER									
	DB(°F)	WB(°F)	DB(°F)								
OUTDOOR	92.4	79.6	39.1								
INDOOR	75.0	62.5	68.0								

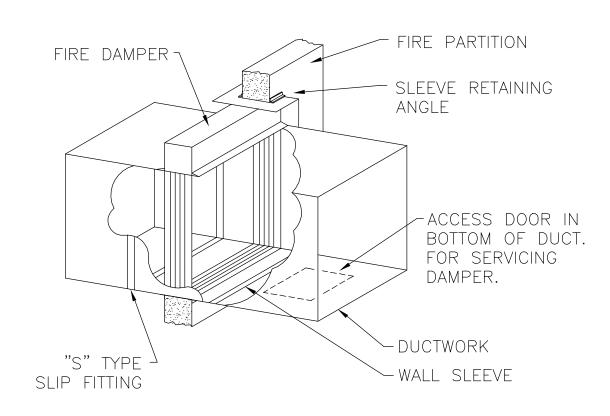



TYPICAL FIRE DAMPER DETAIL 5 TYPE "B" NOMINAL 100% FREE AREA NOT TO SCALE COUNTY S. FION BUILDING F MANATEE (
ADMINISTRATI


URS Corporation Souther 7650 West Courtney Campbell Causeway Tampa, FL 33607-1462 No. 00000002 John T. Rector, P.E. 5329


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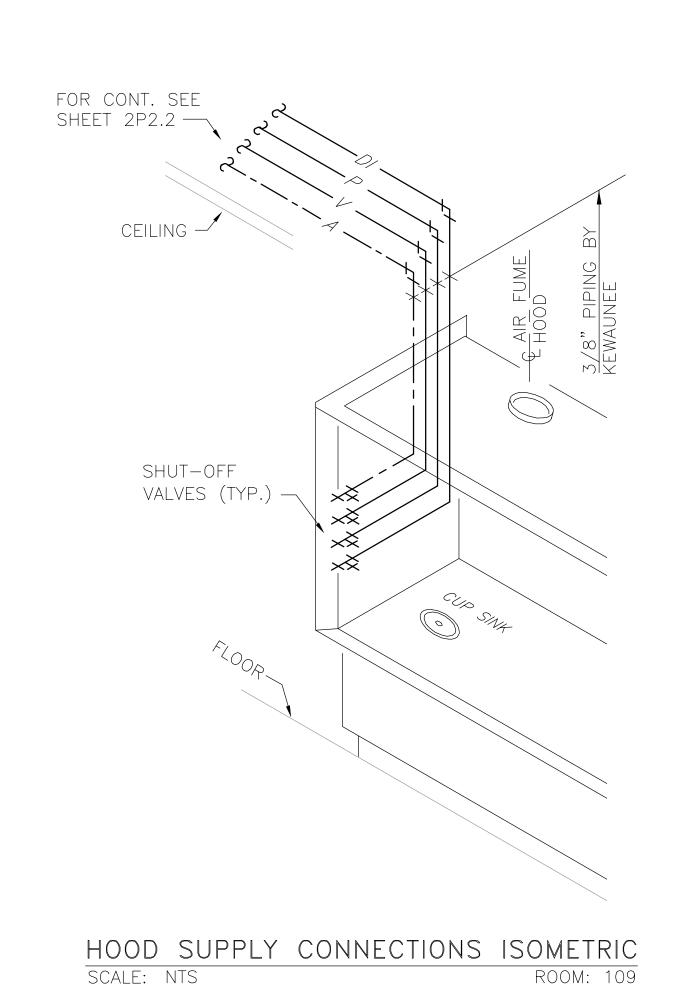

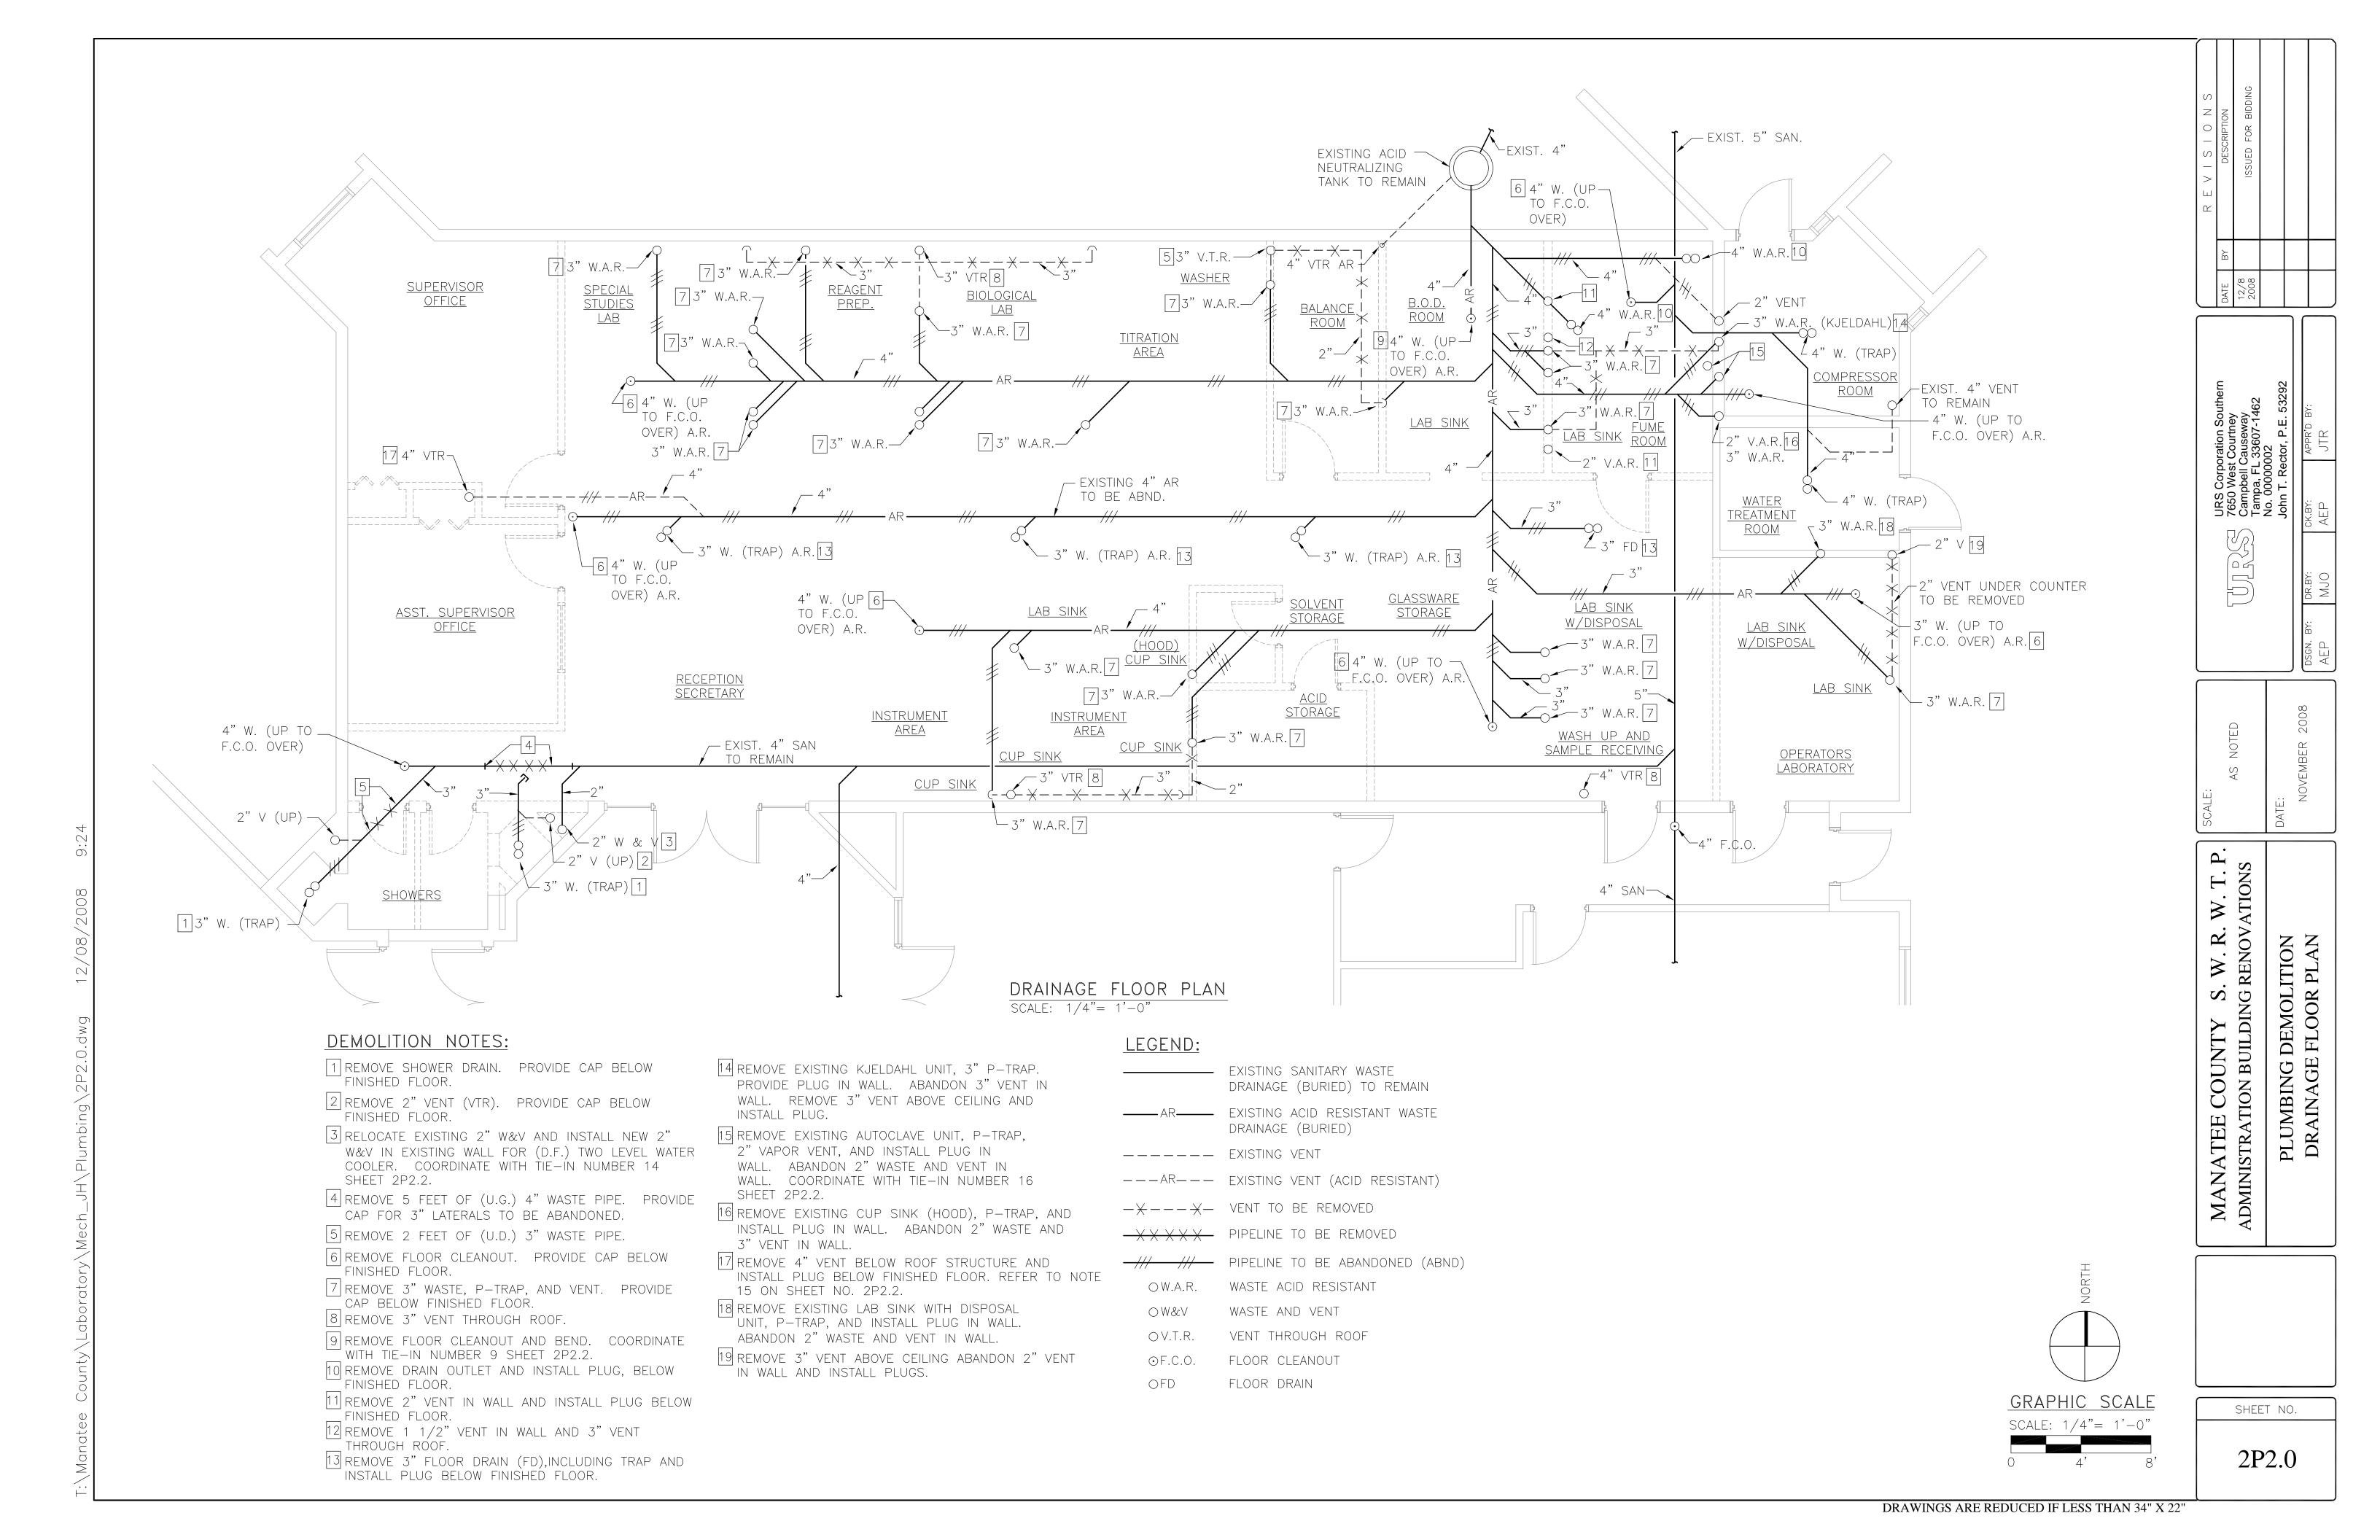
## WATER SAVER TRAP PRIMER DETAIL SCALE: NTS

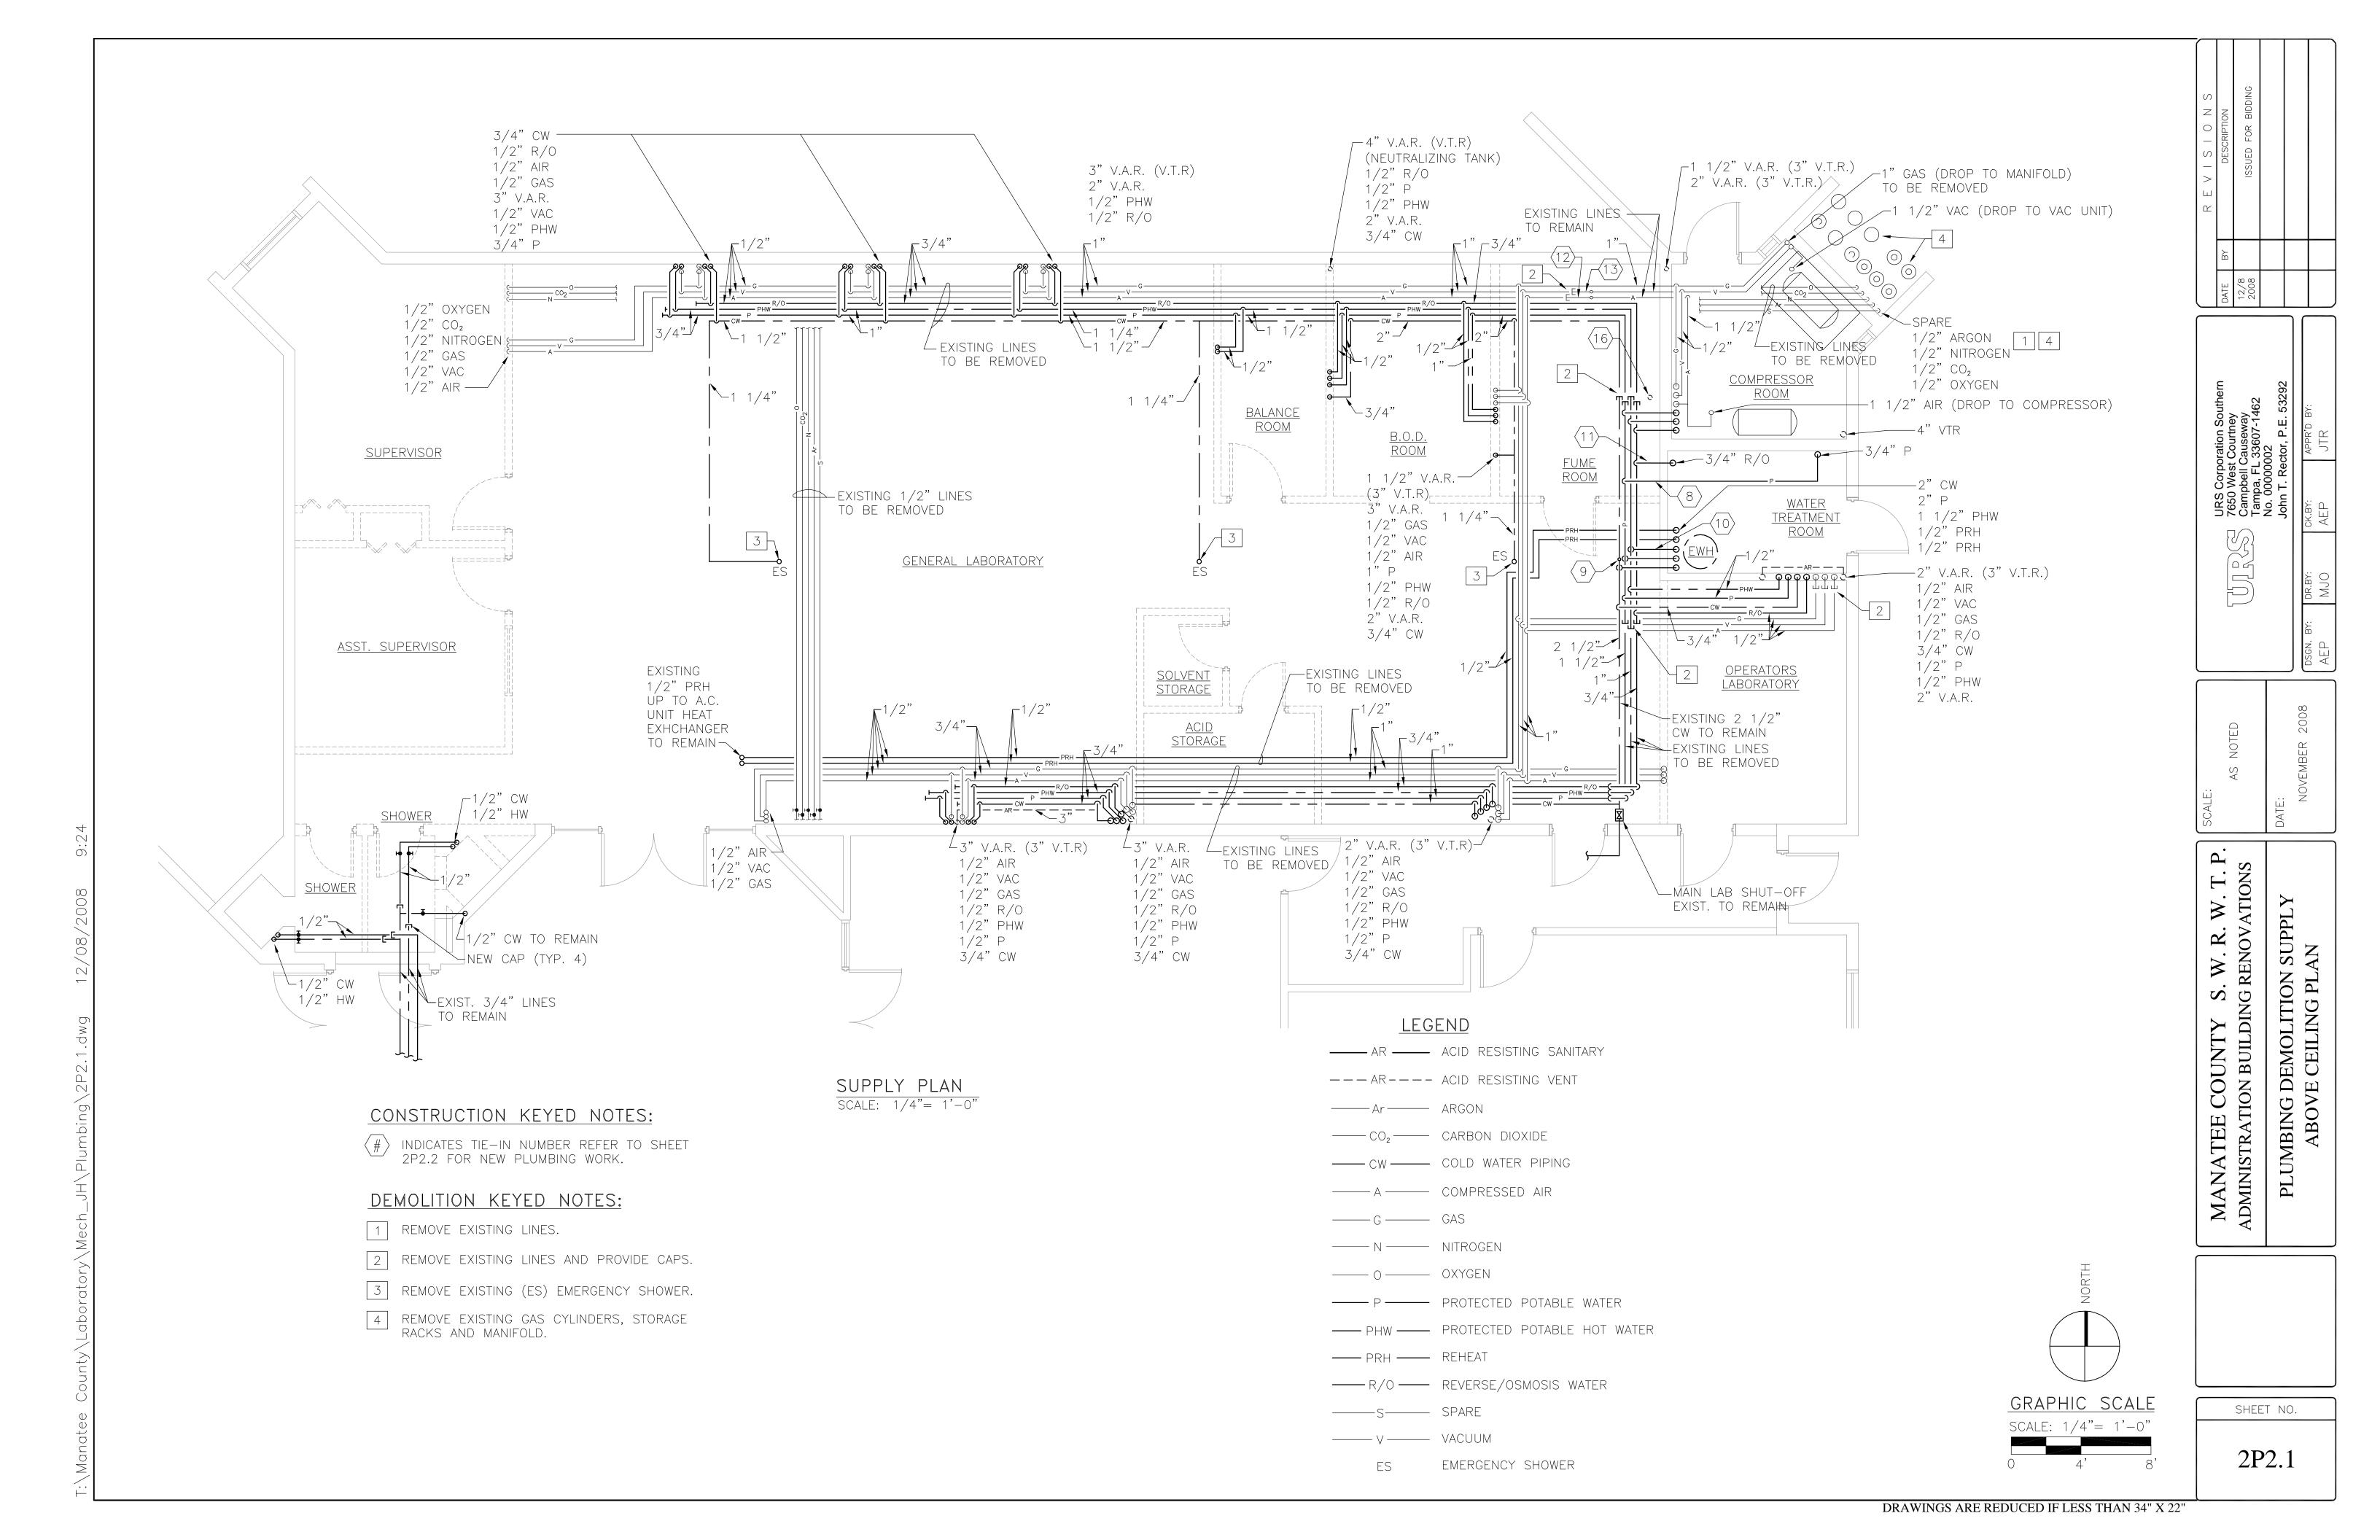- 1/2" BALL VALVE  CW LINE
S — CW LINE
TRAP PRIMER VALVE. PROVIDE ACCESS PANEL, UNLESS ABOVE LAY—IN CEILING
-FD-2
FLOOR DRAIN WITH TRAP PRIMER CONNECTION
JOINT BETWEEN HARD— DRAWN COPPER AND SOFT COPPER
FINISHED FLOOR  —1/2" SOFT COPPER BELOW FLOOR  SLAB TO FLOOR DRAIN (NO JOINTS
PERMITTED BELOW FLOOR). PROTECT PIPING WITH VINYL SHEATING (TYPICAL).

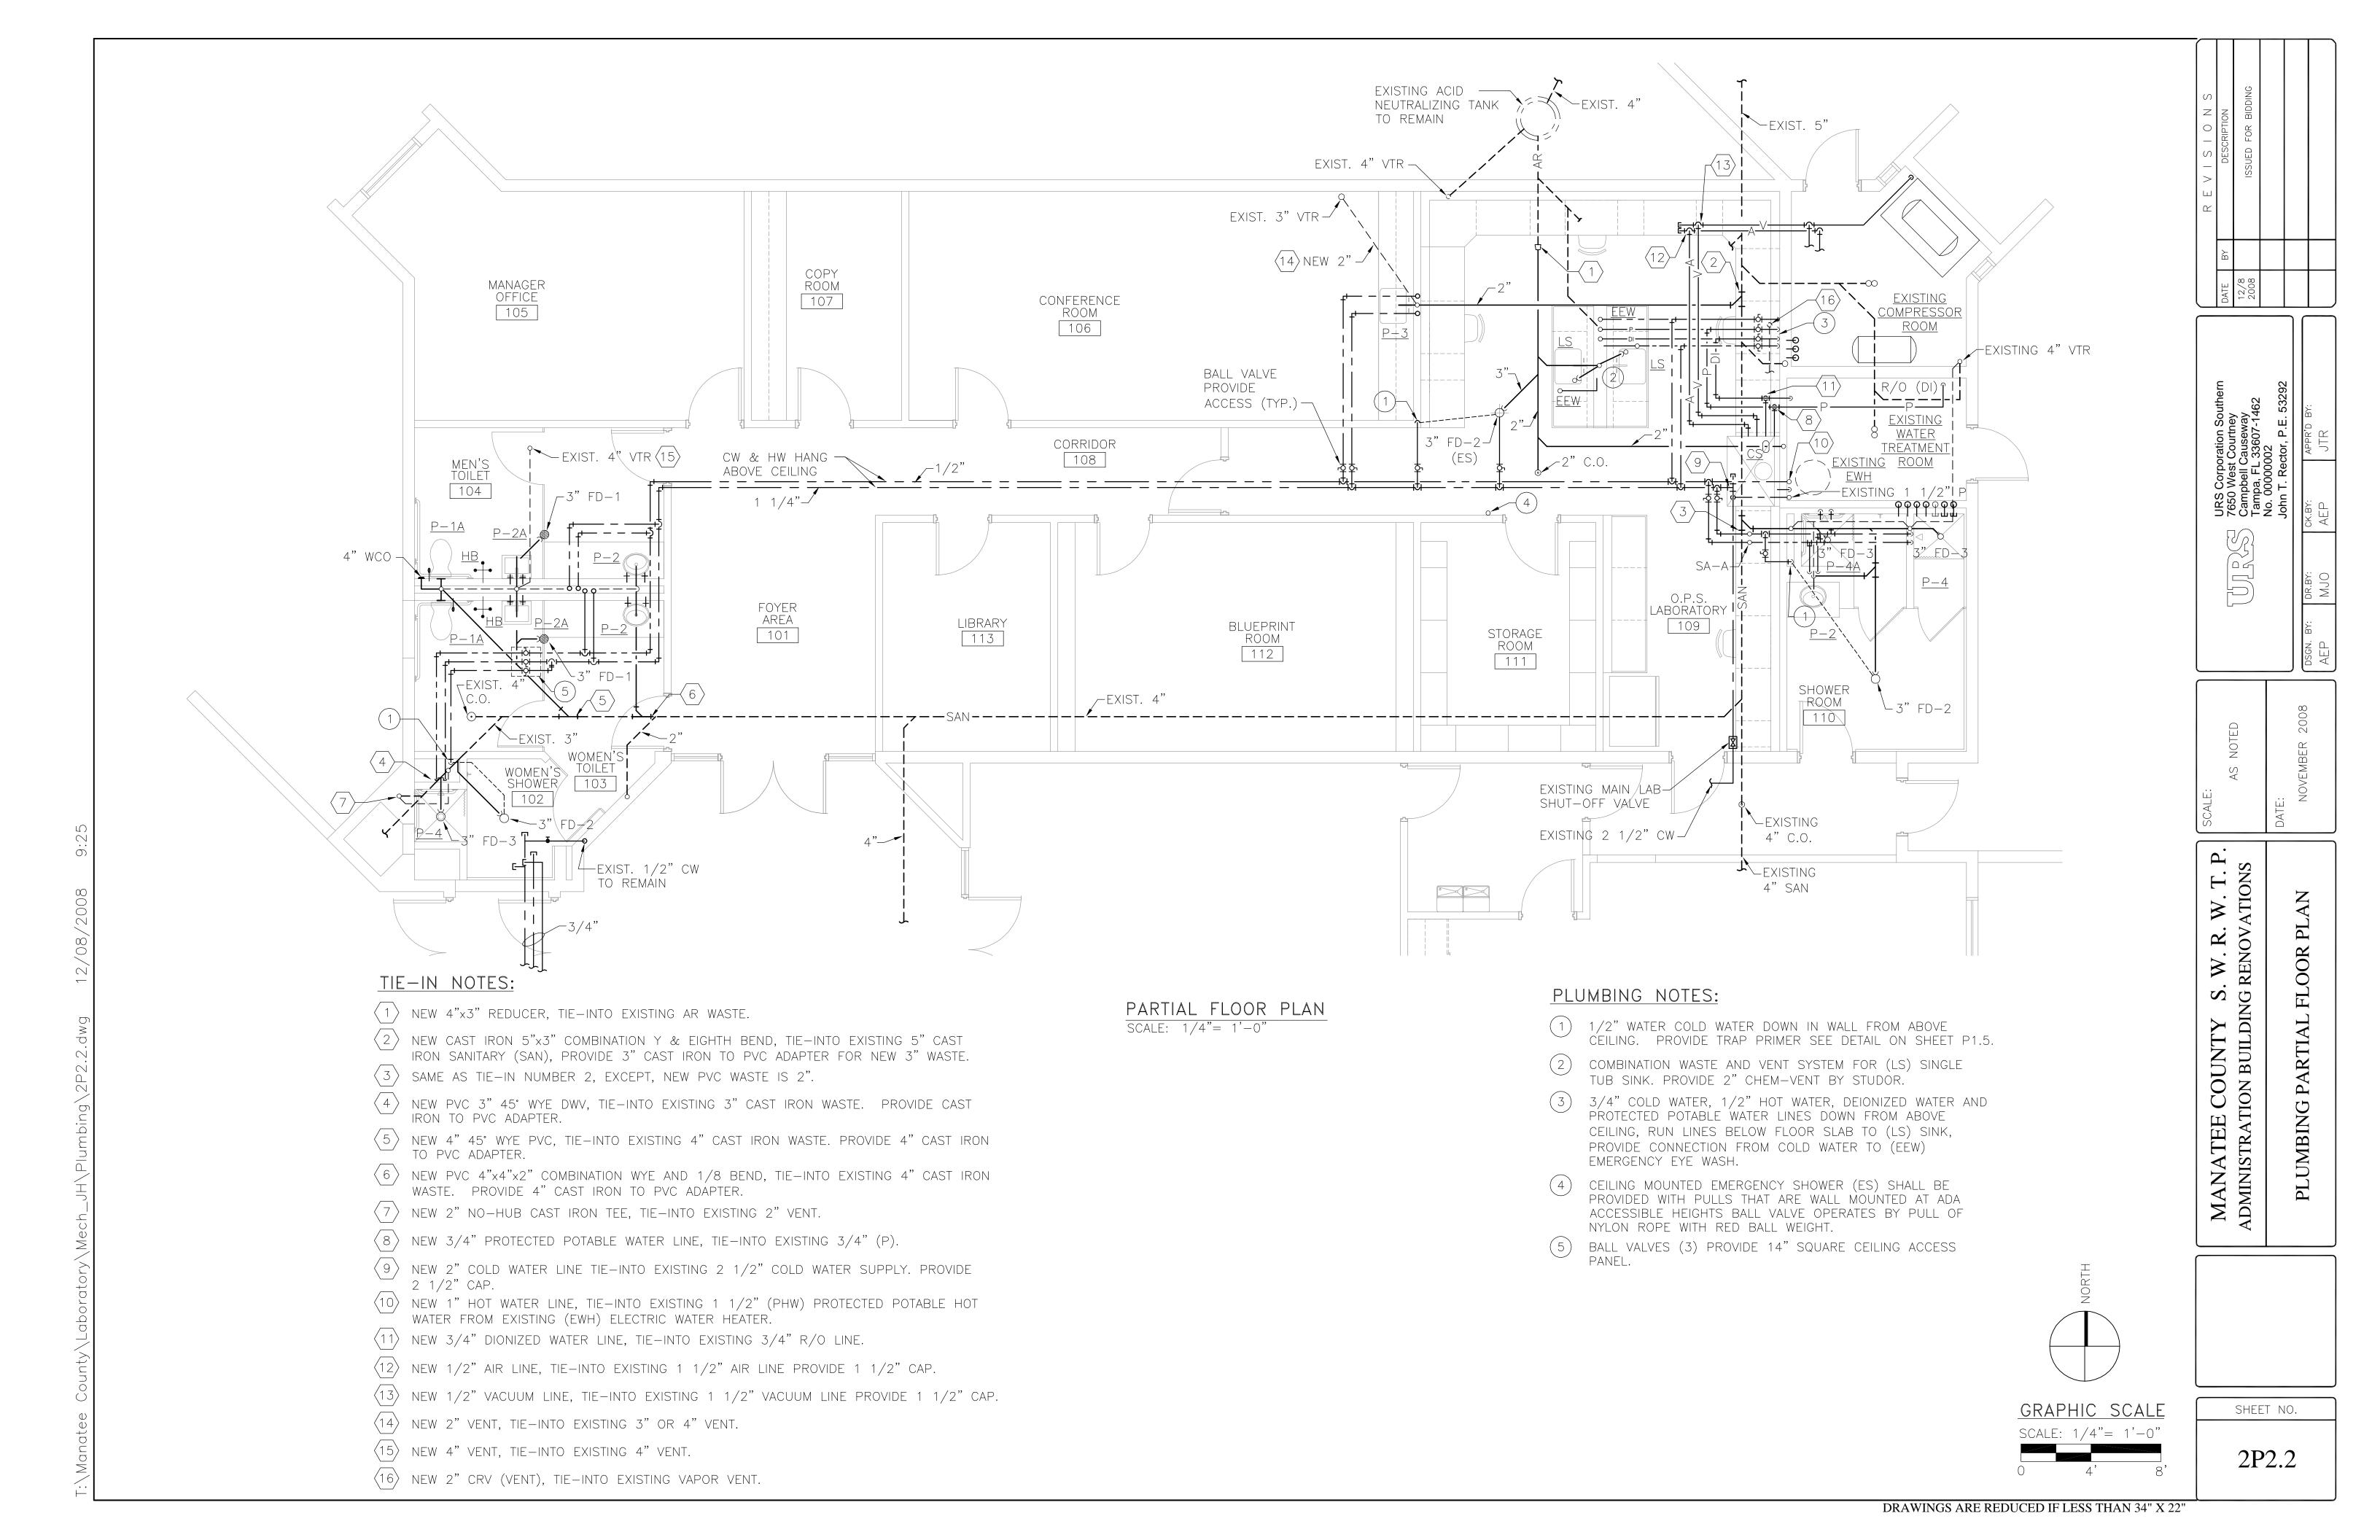FLOOR	DRAIN	AUTOMATIC	TRAP	SEAL	PRIMER	SCHEMATIC
SCALE: NTS	S					

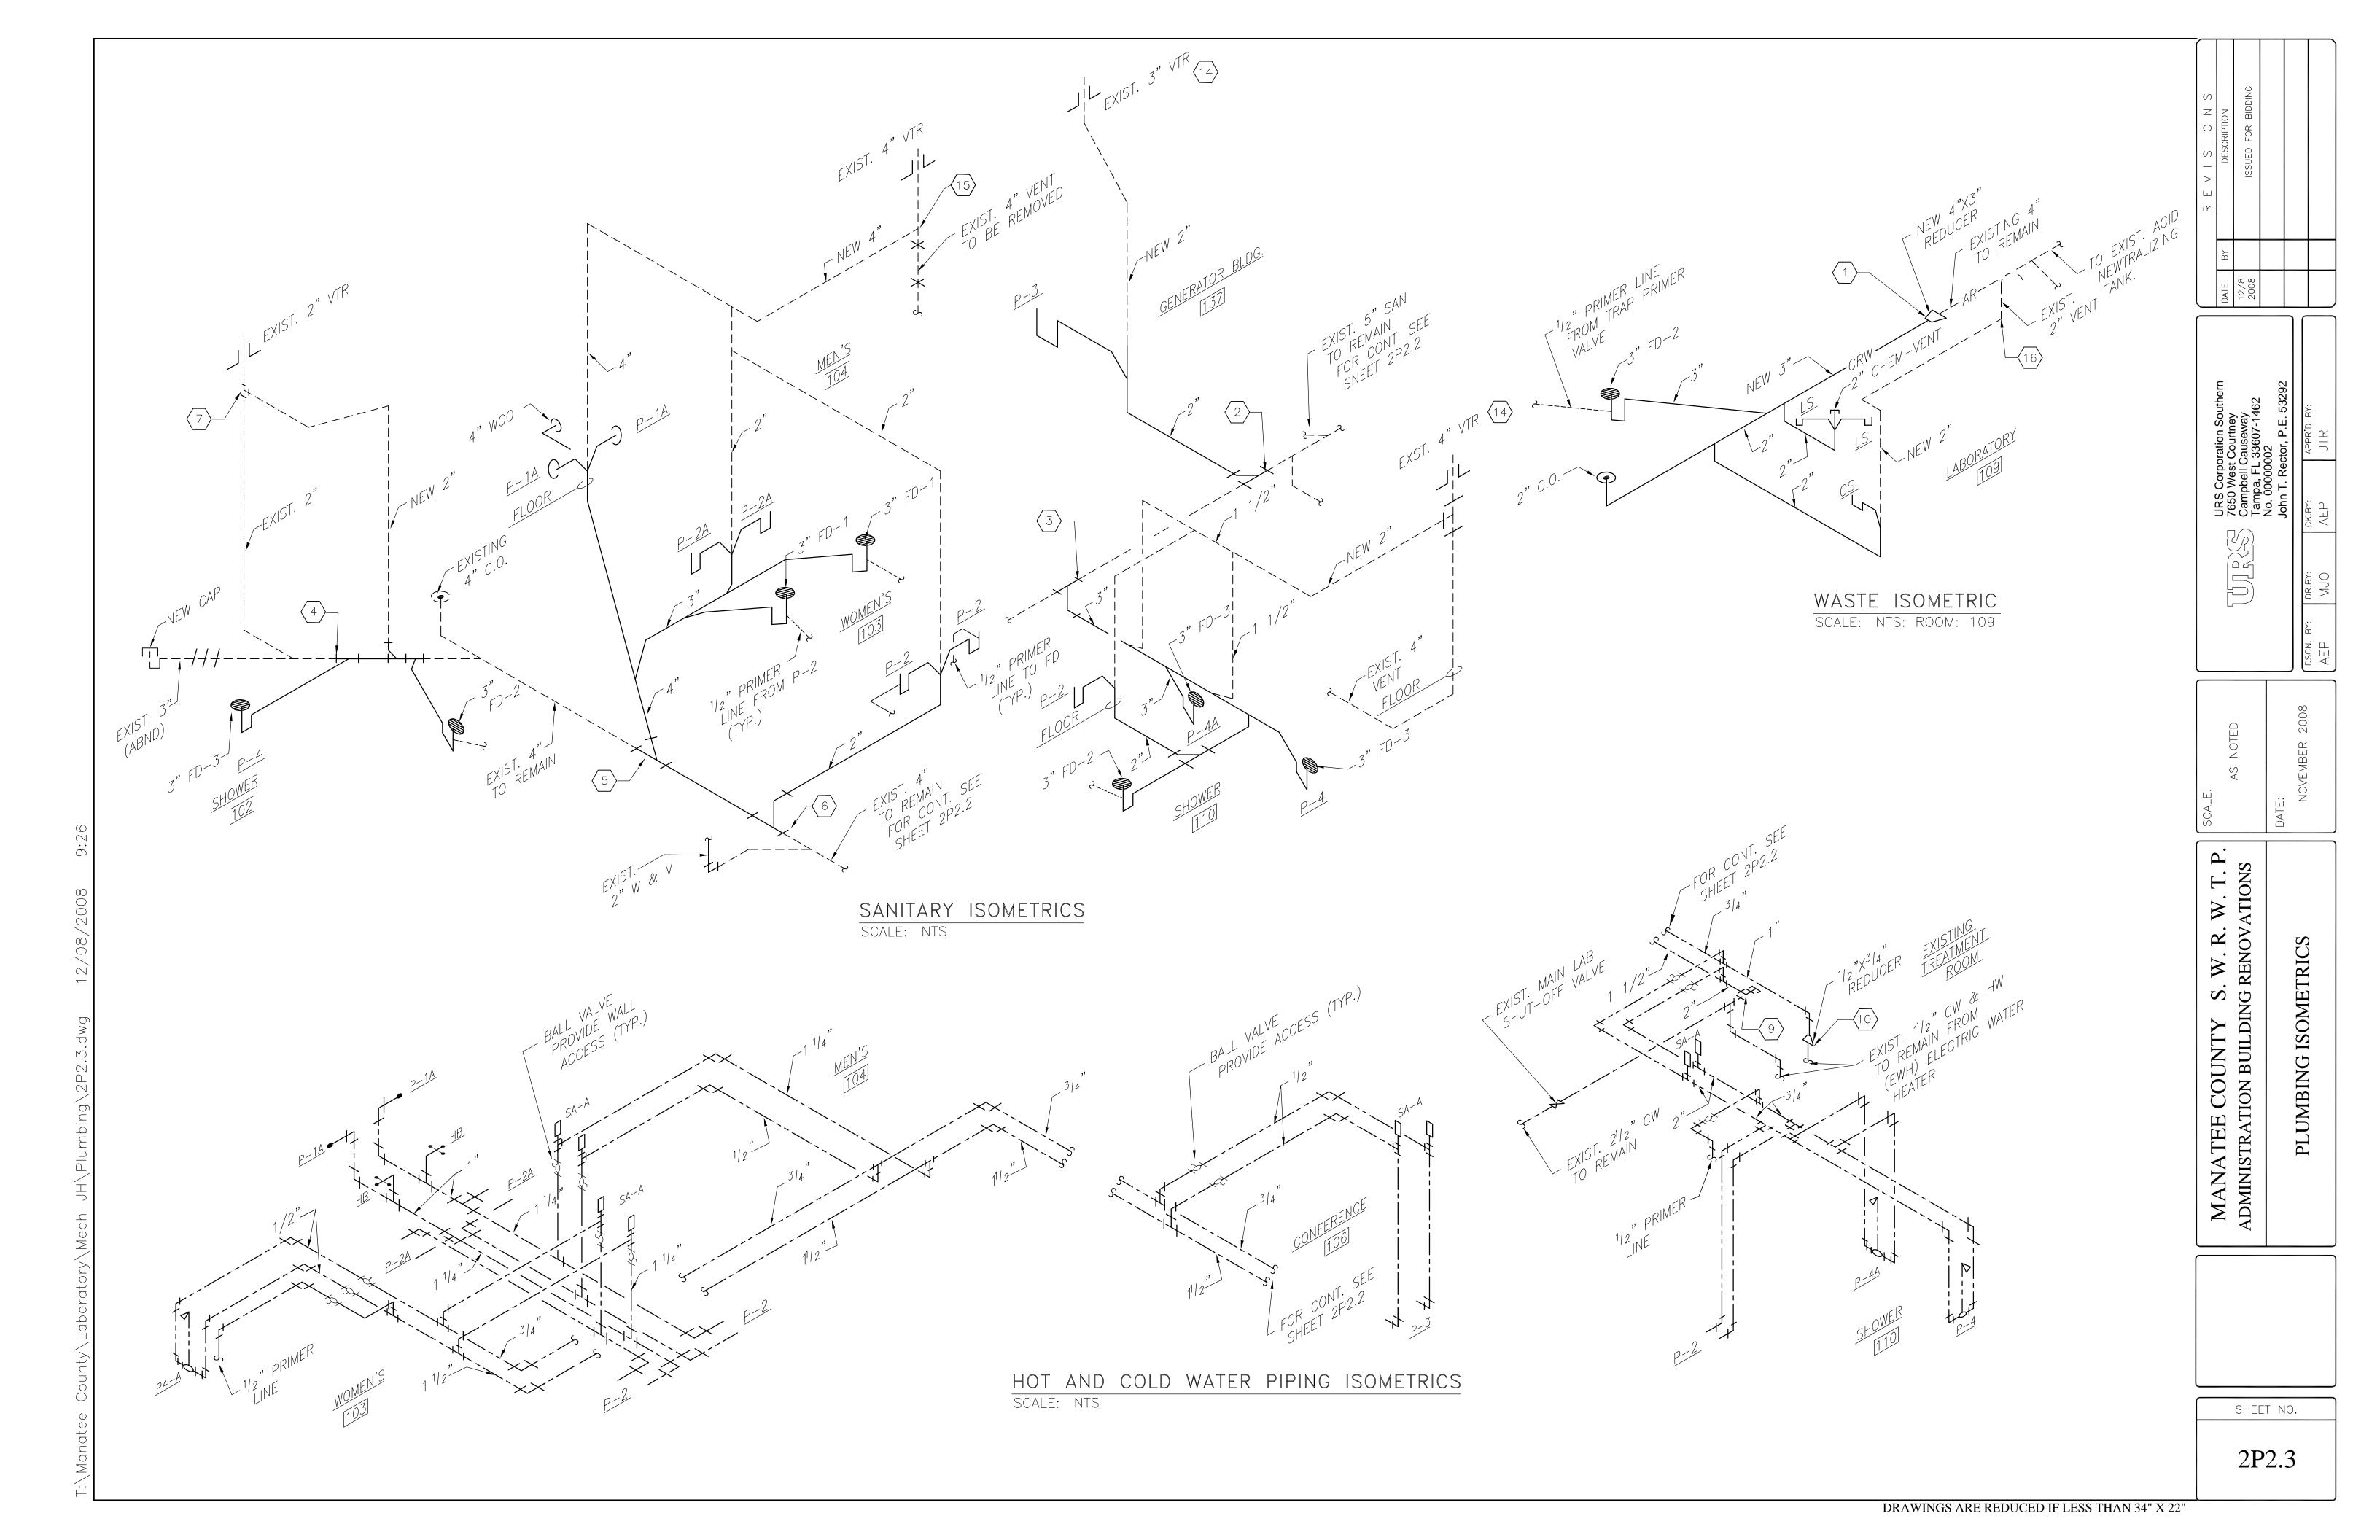	PLUMBING FIXTU	RES	SCH	EDUL	E.		
ITEM	DESCRIPTION		NCH	SUPPL FIXT COLD	URE	TRAP	MIN. VENT
P-1A	WATER CLOSET WALL HUNG — HANDICAPPED	1"	_	1"	_	4"	2"
P-2	LAVATORY — COUNTERTOP	1/2"	1/2"	3/8"	3/8"	1-1/4"	1-1/2"
P-2A	LAVATORY — WALL HUNG WHEELCHAIR	1/2"	1/2"	3/8"	3/8"	1-1/4"	1-1/2"
P-3	SINGLE COMPARTMENT SINK	1/2"	1/2"	3/8"	3/8"	1-1/2"	1-1/2"
P-4	SHOWER	1/2"	1/2"	1/2"	1/2"	3"	1-1/2"
P-4A	SHOWER — HANDICAPPED	1/2"	1/2"	1/2"	1/2"	3"	1-1/2"
LS	SINGLE TUB SINK	1/2"	1/2"	3/8"	3/8"	1-1/2"	1-1/2"
CS	CUP SINK	1/2"	1/2"	3/8"	3/8"	1-1/2"	1-1/2"
НВ	HOSE BIBB	3/4"	_	3/4"	-	_	_
EEW	EMERGENCY EYE WASH	1/2"	_	1/2"	_	_	_
ES	EMERGENCY SHOWER	1 "	_	1"	_	_	_

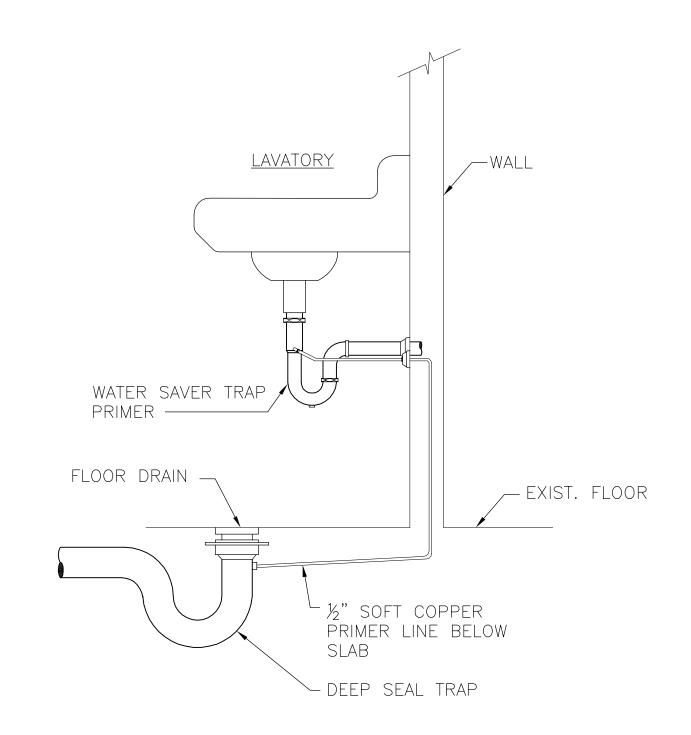

# PLUMBING LEGEND SAN—— SANITARY D

A — COMPRESSED AIR LINEVACUUM PIPE

— H — HELIUM
— N — NITROGEN
— AR — ARGON

—— NO—— NITROUS OXIDE
—— AC —— ACETYLENE

EWH ELECTRIC WATER HEATER

CO • FLOOR CLEANOUT

WCO I— WALL CLEANOUT

FD FLOOR DRAIN

→ BALL VALVE

GATE VALVE

SA D SHOCK ABSORBER

VENT THRU ROOF

HB HOSE BIBB

VTR JL

REVISION S

BY DESCRIPTION

SB ISSUED FOR BIDDING

URS Corporation Southern
7650 West Courtney
Campbell Causeway
Tampa, FL 33607-1462
No. 00000002
John T. Rector, P.E. 53292
John T. Rector, P.E. 53292

GN. BY:
APPR'D BY:
APPR'D BY:
AEP
JTR

AS NOTED

DATE:

NOVEMBER 2008

AEF

NATEE COUNTY S. W. R. W. T. P.
NISTRATION BUILDING RENOVATIONS
IMBING SCHEDITE AND DETAILS

2P2.4

SHEET NO.

#### ABBREVIATIONS

- A AMPS
- AFF ABOVE FINISH FLOOR
- AFG ABOVE FINISH GRADE
- BLDG. BUILDING
- C CONDUIT
- C.B. CIRCUIT BREAKER
- CLG. CEILING
- CV CONSTANT VOLUME
- DN DOWN
- DWG DRAWING
- EWC ELECTRIC WATER COOLER
- EWH ELECTRIC WATER HEATER
- G GROUND
- GFI GROUND FAULT INTERRUPTER
- HP HORSEPOWER
- KVA KILOVOLTAMP
- KW KILOWATT
- LTG LIGHTING
- ..P. LIGHTNING PROTECTION
- MIN MINIMUM
- MNT. MOUNTED
- N.T.S. NOT TO SCALE
- OH OVERHEAD
- REC RECEPTACLE
- RGS RIGID GALVANIZED STEEL
- TEL TELEPHONE
- TYP TYPICAL
- TVSS TRANSIENT VOLTAGE SURGE
  - SUPPRESSOR
- TYP TYPICAL
- U.O.N. UNLESS OTHERWISE NOTED
- VAV VARIABLE AIR VOLUME
- v volt
- VP WEATHERPROOF (NEMA 3R)

#### PROJECT GENERAL NOTES

(APPLICABLE TO ALL DRAWINGS)

- G1 COORDINATE THE MOUNTING OF ALL OUTLETS WITH FINAL FURNITURE, EQUIPMENT AND MILLWORK LAYOUT, AND ARCHITECTURAL ELEMENTS.
- G2 COORDINATE WITH ARCHITECTURAL REFLECTED CEILING GRID AND EXACT LOCATION OF LIGHTING FIXTURES.
- G3 WHEN CONDUCTOR SIZE IS INDICATED FOR BRANCH CIRCUIT HOMERUN, THE CONDUCTOR SIZE INDICATED SHALL BE USED FOR THE COMPLETE CIRCUIT.
- G4 CONDUCTORS SHALL BE #12 AWG IN 3/4" RACEWAY (PLUS GREEN EQUIPMENT GROUNDING CONDUCTOR). UNLESS OTHERWISE NOTED.
- G5 COORDINATE WITH DIVISION 15 FOR EXACT LOCATION OF MECHANICAL EQUIPMENT AND WITH MANUFACTURER'S SHOP DRAWING REQUIREMENTS. DISCONNECT SWITCHES SHALL BE FUSED AS REQUIRED BY MANUFACTURER WITH FUSES SIZED PER MANUFACTURER'S RECOMMENDATIONS.
- G6 PROVIDE BLACK DUPLEX RECEPTACLES WITH STAINLESS STEEL COVERPLATE, TYPICAL, UNLESS OTHERWISE NOTED.

#### ELECTRICAL DRAWING LIST

- 2E1.0 ELECTRICAL LEGEND AND GENERAL NOTES
- 2E2.0 LIGHTING PLAN
- 2E3.0 POWER PLAN
- 2E4.0 COMMUNICATION SYSTEM PLAN
- 2E5.0 POWER RISER DIAGRAM
- 2E6.0 PANELBOARD SCHEDULES

REVISIONS	DESCRIPTION	ISSUED FOR BIDDING		
	ВУ			
	DATE	12/8 2008		

- AS NOTED
DATE:
NOVEMBER 2008

MANATEE COUNTY S. W. R. W. T
ADMINISTRATION BUILDING RENOVATION
ELECTRICAL LEGEND AND
GENERAL NOTES

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SHEET NO.

2E1.0

8. PROVIDE UNSWITCHED CIRCUIT FOR ALL EMERGENCY, EXIT AND NIGHT LIGHT (NL) FIXTURES.

WHEN A SIMILAR TYPE FIXTURE IS NOT PROVIDED BY THE OWNER AN APPROVED EQUAL BY

9. FIXTURES SHALL BE OF THE SAME MANUFACTURER AND MODEL AS PROVIDED BY OWNER.

OTHER MANUFACTURERS WILL BE CONSIDERED.

3. CONTRACTOR SHALL VERIFY CEILING COMPATIBILITY PRIOR TO ORDERING LIGHTING FIXTURES.

5. ALL LAMPS SHALL BE FACTORY INSTALLED INTEGRAL WITH LIGHTING FIXTURES.


OF MAINTENANCE.

4. PROVIDE AN OUTLET BOX FOR EACH SURFACE/PENDANT MOUNTED LIGHTING FIXTURE FOR EASE

DRAWINGS ARE REDUCED IF LESS THAN 34" X 22"

SHEET NO.

2E2.0

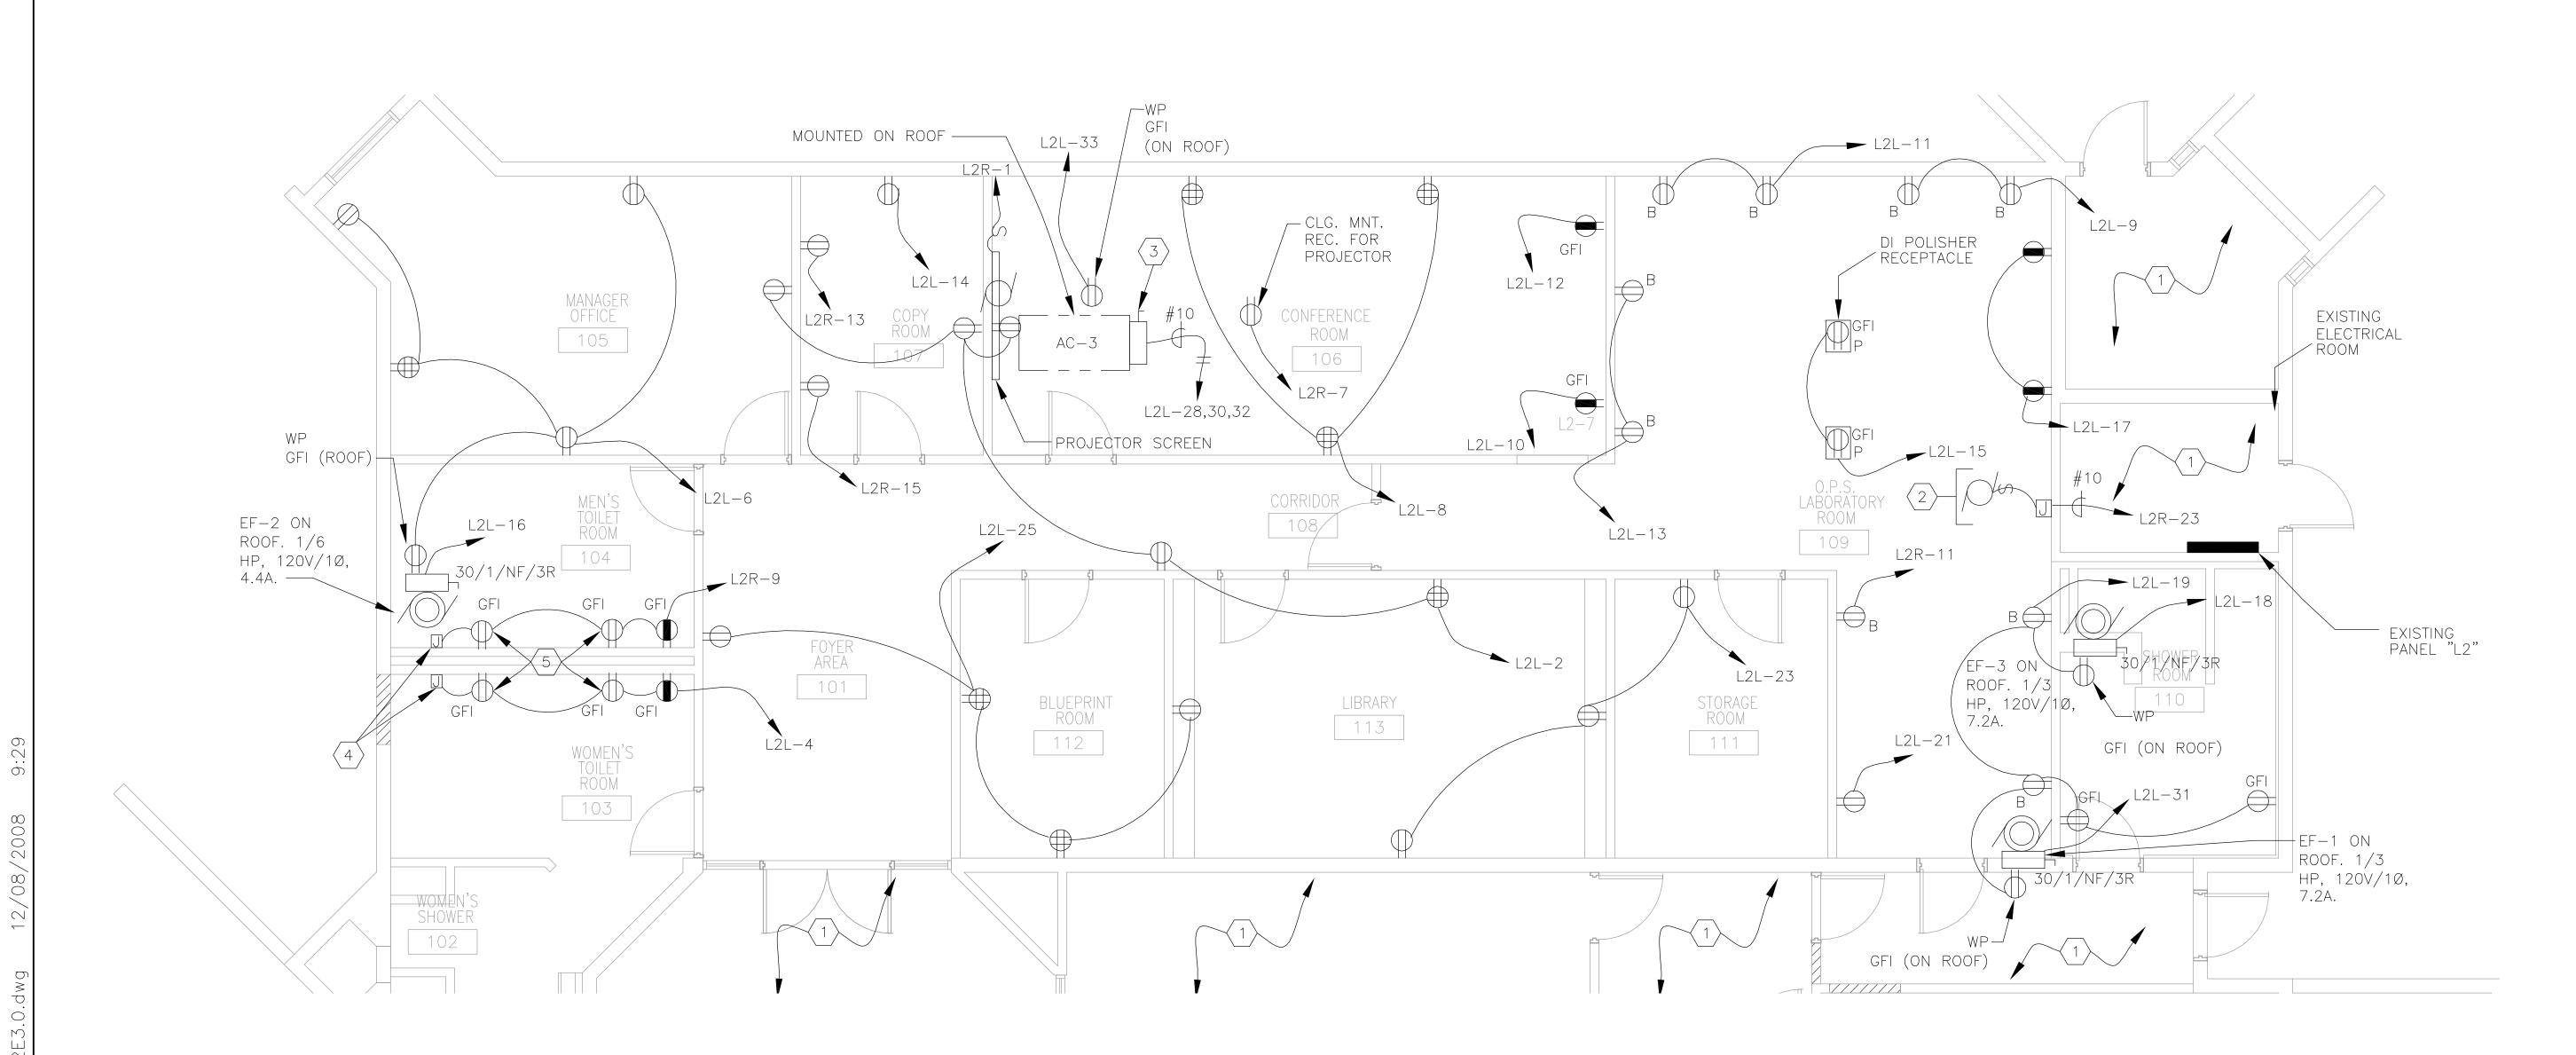

POWER PLAN SCALE: 1/4" = 1'-0"


#### NOTES:


- EXISTING RECEPTACLES AND POWER CONNECTIONS TO REMAIN IN THIS AREA.
- PROVIDE POWER/CONTROL CONNECTIONS TO RELOCATED TOWN TOOD. LANGEST OF THE PROPERTY OF THE PROPE PROVIDE POWER/CONTROL CONNECTIONS TO RELOCATED FUME HOOD. EXHAUST FAN TO BE MOUNTED COORDINATE EXACT LOCATION WITH MECHANICAL CONTRACTOR PRIÓR TO ROUGH—IN. REFERENCE MECHANICAL DRAWINGS 2M2.0 AND 2M2.1.
- NEMA 4X STAINLESS STEEL, 3-POLE, 30A, 240V FUSED DISCONNECT SWITCH. COORDINATE FUSE SIZE WITH RTU NAME PLATE DATA.
- 4 TWO (2) 4" X 4" SQUARE JUNCTION BOXES FOR TOILET MOTION SENSORS. COORDINATE EXACT LOCATIONS AND REQUIREMENTS WITH PLUMBING CONTRACTOR PRIOR TO ROUGH IN.
- PROVIDE GFI RECEPTACLES FOR SINK MOTION SENSORS. MOUNT RECEPTACLES UNDER SINK. COORDINATE EXACT LOCATIONS AND REQUIREMENTS WITH THE PLUMBING CONTRACTOR. PRIOR TO ROUGH

T. P. ONS W. R. W. T. RENOVATIONS MANATEE COUNTY S. ADMINISTRATION BUILDING I

SHEET NO.

2E3.0

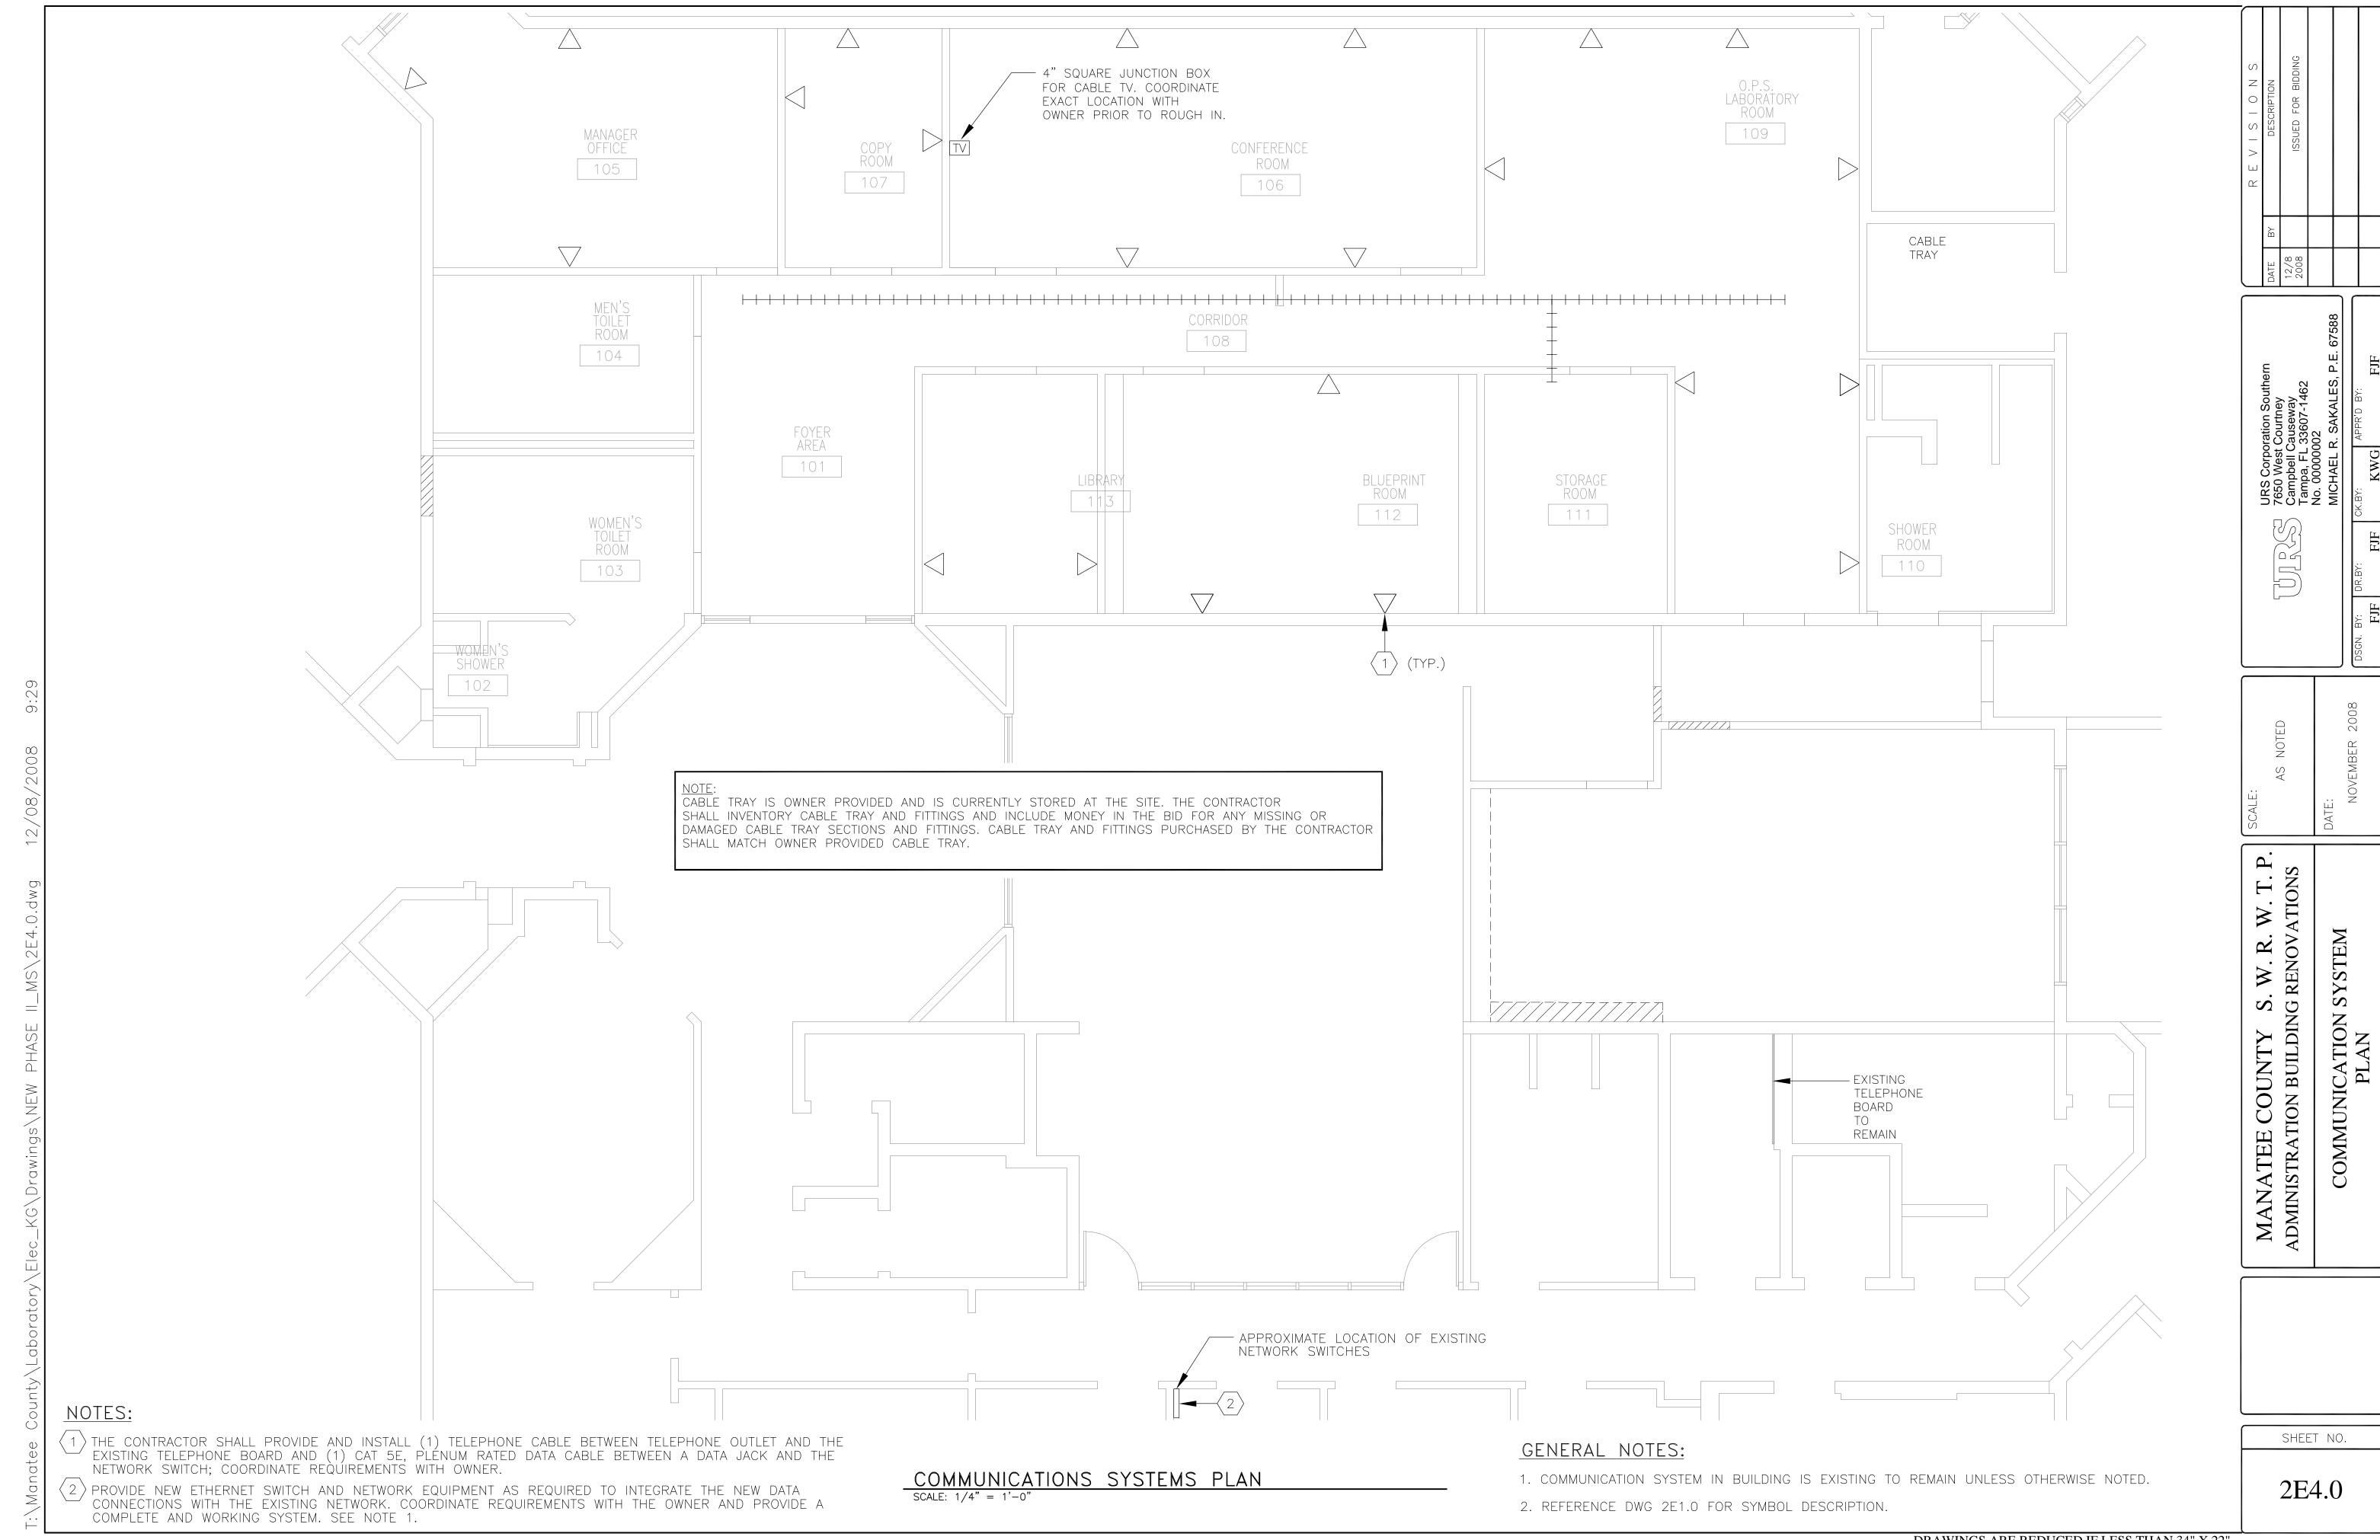

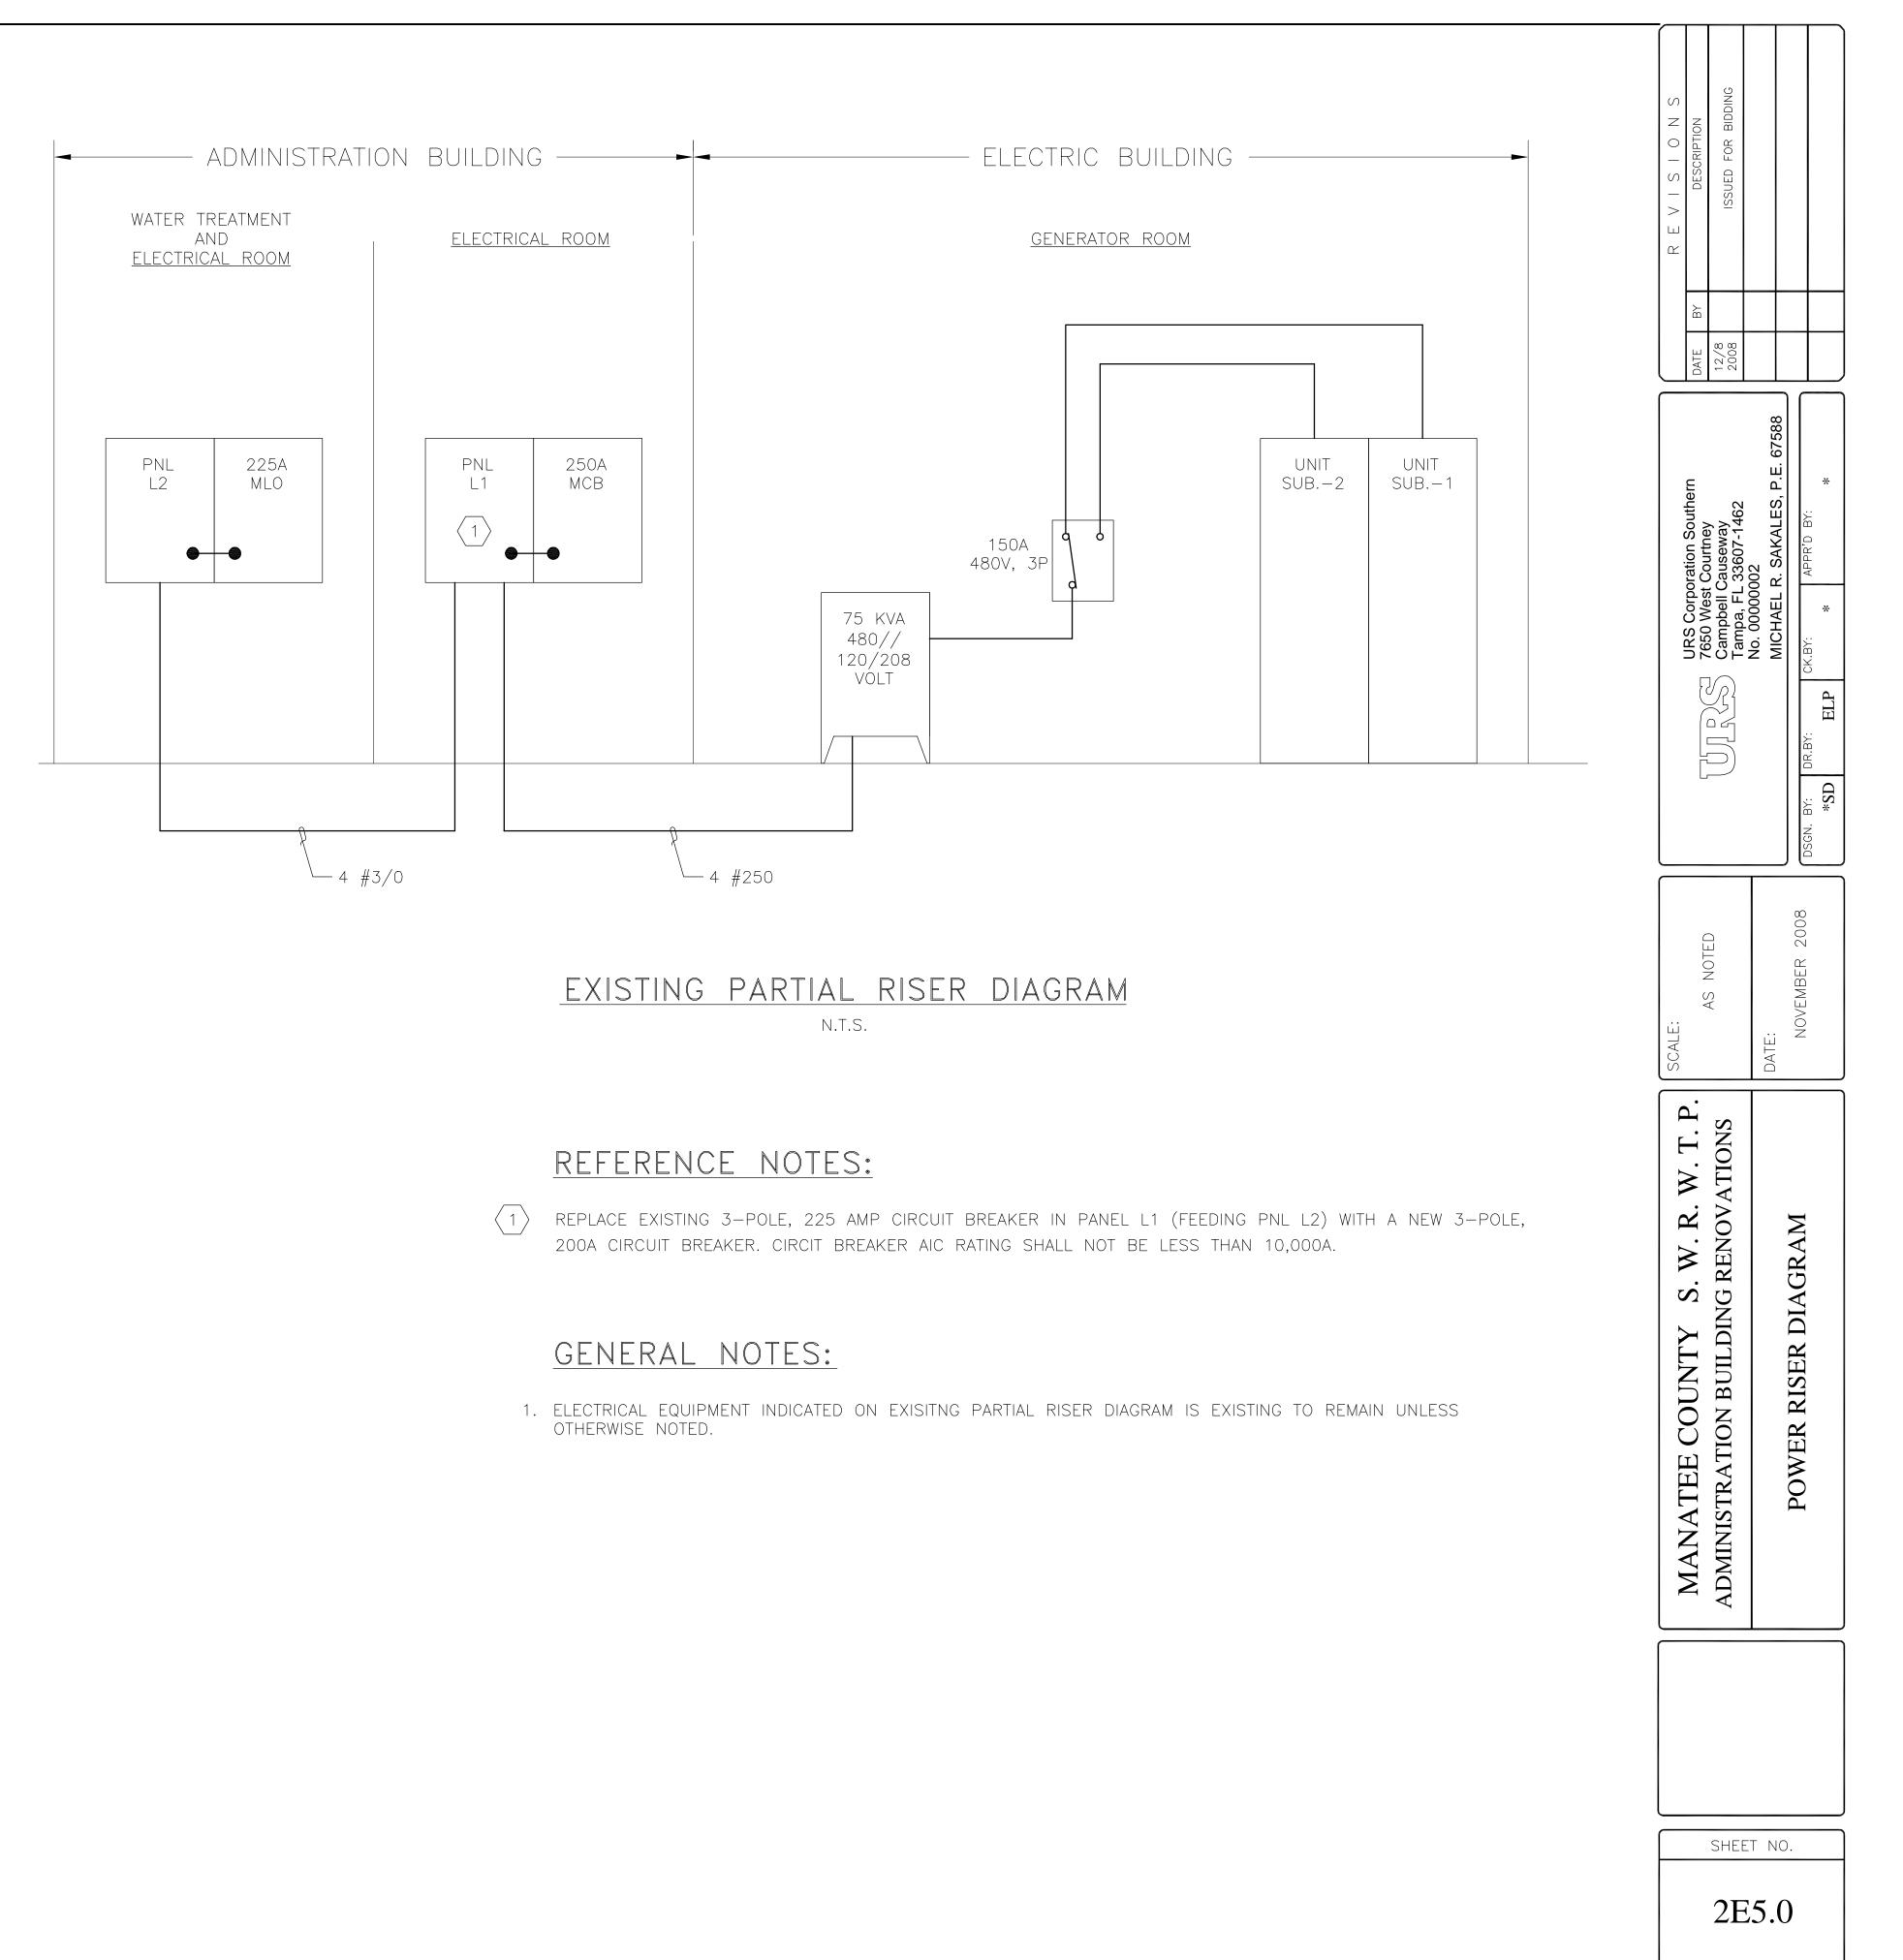

MCE VOL	IS RATING: 400A : 250A FAGE: 120/208V, 3ø, 4W		(ISTI)	PANEI NG S	EC.	1 LE		MOUNTING: SURFACE LOCATION: ELECTRICAL F	ROOM
CKT NO	DESCRIPTION	BREAI POLE	KERS AMPS	KVA	KVA	BREA POLE	KERS AMPS	DESCRIPTION	CKT NO
1	LIGHTS-CONFERENCE ROOM	1	20	.94	.96	1	20	RECEPTACLE—GFI FRONT BATH, HALL, OFFICE	2
3	LIGHTS-CONFERENCE ROOM	1	20	.94	.39	1	20	LIGHTING—FRONT BATH, HALL	4
5	LIGHTS-CONFERENCE ROOM	1	20	.94	.30	1	20	FRONT WATER COOLER	6
7	DOOR GATE-LUNCHROOM HUM.	1	20	.60	.96	1	20	LIGHTING-LOBBY	8
9	RECEPTACLE-LOBBY	1	20	.80	.96	1	20	LIGHTING-LOBBY	10
11	EXHAUST FAN-WEST FRONT BATH	1	20	.20	.96	1	20	LIGHTING-LOBBY	12
13	SPARE	1	20	_	.10	1	20	LIGHTING-ELEC. ROOM, EXIT, HALL, #1 OFFICE	14
15	LIGHTING-PIC ROOM	1	20	.33	_	1	20	SPARE	16
17	LIGHTING-PIC ROOM	1	20	.33	.72	1	20	LIGHTING-BACK CORRIDOR	18
19	LIGHTING-PIC ROOM	1	30	.33	.96	1	20	LIGHTING LUNCH ROOM	20
21	RECEPTACLE-VENDING MACHINE	1	20	.80	_	1	20	SPARE	22
23	RECEPTACLE-VENDING MACHINE	1	20	.80	.075			A/C CONTROL CABINET	24
25	RECEPTACLE-LUNCH ROOM	1	20	1.62	.04			INSTRUMENT CABINET	26
27	RECEPTACLE-VENDING MACHINE	1	20	.80	.07			ROCHA CABINET-MARS	28
29	REFRIDGERATOR	1	20	.80	.60			RECEPTACLE-DISPOSAL, LUNCH ROOM	30
31	PHONE BOARD	1	20	.25	_	_	_	SPACE	32
33	SPACE	_	_	_	_	_	_	SPACE	34
35	SPACE	_	_	_	_	_	_	SPACE	36
37	SPACE	_	_	_	_	_	_	SPACE	38
39	SPACE	_	_	_	_	_	_	SPACE	40
41	SPACE	_	_	_	_	_	_	SPACE	42
CO	NNECTED LOAD: 17.58 KVA					•	•		•

MCB	NS RATING: 400A : MLO FAGE: 120/208V, 3ø, 4W	(EX	ISTIN	PANEL NG SE	"L	1" 2 RIC	GHT)	MOUNTING: SURFACE LOCATION: ELECTRICAL R	ROOM
CKT NO	DESCRIPTION	BREA POLE	KERS AMPS	KVA	KVA	BREA POLE	KERS AMPS	DESCRIPTION	CKT NO
1	LIGHTING-#2 OFFICE	1	20	.32	.80	1	20	RECEPTACLE-WOMEN'S BATH & LUNCH ROOM	2
3	LIGHTING-#3 OFFICE	1	20	.96	.60	1	20	EAST DOOR SHUTTER	4
5	LIGHTS-SUPERVISOR'S OFFICE	1	20	.64	.80	1	20	LIGHTING SHOWER WOMEN'S	6
7	MAIN PC	1	20	.25	.65	1	20	RECEPTACLE-MEN'S GFI, HALL, #2 OFFICE	8
9	MAIN TC	1	20	.25	.30	1	20	WATER COOLER-HALL	10
11	LIGHTING-JANITOR, PHOTOCELL-PLANT	1	20	.30	.40	1	20	LIGHTING-MEN'S SHOWER	12
13	RECEPTACLE-SUPERVISOR	1	20	.72	_	1	20	SPARE	14
15	#2,3 OFFICE AND RECORDER RM, EAST/WEST WALL	1	20	.97	.60	1	20	RECEPTACLE—SO. OFFICE & SO. EXTERIOR WALL	16
17	ASSISTANT SUPERVISOR #4 OFFICE	1	20	.96	.20	1	20	EXHAUST FAN-SHOWER EAST	18
19	SPARE	1	20	_	.25	1	20	SOUND BOARDS.	20
21	SPARE	1	20	_	_	1	20	SPARE	22
23	SPACE	_	_	_	9	2	60	WATER HEATER	24
25	SPACE	_	_	_	9		00		26
27	SPACE	_	_	_	9	2	60	WATER HEATER	28
29	SPACE	_	_	_	9		00		30
31									32
33									34
35	DANEL LO (N)	7				_			36
37	PANEL L2 (N)	3	225	33.77	_	3	_	SPARE	38
39									40
41									42
CO	NNECTED LOAD: 52.38 KVA	•	TO	TAL [	DEMA	ND	LOAD	SECTION 1 & 2: 74.82 KVA	•

MAINS RATING: 225A MCB: MLO VOLTAGE: 120/208V, 3ø, 4W	(EX		PANE IG S			FT)	MOUNTING: SURFACE LOCATION: ELECTRIC	
CKT DESCRIPTION	BREA POLE	KERS AMPS	KVA	KVA	BREA	KERS	DESCRIPTION	CKT NO
1 LIGHTING 110-113	1	20	1.54	0.90	1	20	RECEPT 101-113	2
3 LIGHTING 109	1	20	1.56	0.54	1	20	MOTION SENSORS	4
5 LIGHTING 101-108	1	20	1.32	0.90	1	20	RECEPT 105	6
7 LIGHTING 105-106	1	20	1.44	0.10	1	20	RECEPT 106	8
9 RECEPT 109	1	20	0.36	0.86	1	20	MICROWAVE 106	10
11 RECEPT 109	1	20	0.36	0.20	1	20	COFFEE 106	12
13 RECEPT 109	1	20	0.36	0.20	1	20	COPIER 107	14
15 RECEPT 109	1	20	0.36	0.53	1	20	EF-2 (N)	16
17 RECEPT 109	1	20	0.36	0.86	1	20	EF-3 (N)	18
<b>19</b> RECEPT 109	1	20	0.54	_	2	30	SPARE	20
21 RECEPT 109	1	20	0.36	_			31 AINE	22
23 RECEPT 111-112	1	20	0.8	3.30		20	ECU	24
25 RECEPT-113	1	20	0.72	] 3.30	2	20		26
27 SPARE	2	30	_	. 70	_	0.5		28
29 517(()	1	0.0	-	6.70	3	25	RTU (N)	30
31 EF-1 (N)		20	.86					32
33 RTU RECEPT (LOCATED ON ROOF) (N)	1	20	.18	_	2	60	SPARE	34
35 SPARE	2	30	_	_				36
37			_	_	2	60	SPARE	38
39 41 SPARE	2	100	_	_ 	1	20	SPARE	40

MAINS RATING: 225A MCB: MLO VOLTAGE: 120/208V, 3ø, 4W	(EX		PANE IG SE			MOUNTING: SURFACE LOCATION: ELECTRICAL ROOM		
CKT DESCRIPTION	BREA POLE	KERS AMPS	KVA	KVA	BREAI POLE	KERS AMPS	DESCRIPTION	CKT NO
1 PROJECTOR SCREEN	1	20	.5	1.2	1	20	SPECIAL RECEPTACLE	2
3 5 SPARE	2	100	_	1.2	1 1	20	R/O UNIT PUMP-ELECTRIC ROOM R/O PUMP	6
7 CLG. MNT. PROJECTOR	1	20	.12	_	1	20	SPARE	8
9 MOTION SENSORS	1	20	.05	_	1	20	SPARE	10
11 RECEPT 109	1	20	.18	_	1	30	SPARE	12
13 RECEPT 107	1	20	.18	_	1	20	SPARE	14
15 RECEPT 107	1	20	.18	_	1	20	SPARE	16
17 SPARE	1	20	_	_	1	20	SPARE	18
19 21 SPARE	2	30	_	1.2	1 1	20	UPS UPS	20
23 FUME HOOD EXHAUST FAN (N)	1	30	1.2	_	1 1	20	SPARE	24
25 SPARE	1	20	_	_	1	20	SPARE	26
27		7.0	_	_	1	20	SPARE	28
29 SPARE 31 OBARE	2	30		_ _	2	30	SPARE	30 32
SPARE	2	20	_	_		7.0		34
35 SPARE	1	20	_	_	2	30	SPARE	36
37 SPARE	1	20	_	_		7.0	CDADE	38
39 SPARE	1	20	_	_	2	30	SPARE	40
41 SPARE	1	20	_	_	1 1	20	SPARE	42

- GENERAL NOTES:

  1. EXISTING LOADS INDICATED ON PANEL SCHEDULES ARE FOR REFERENCE ONLY. CONTRACTOR SHALL FIELD VERIFY EXISTING CONDITIONS AND CONTACT ENGINEER IF DISCREPANCIES ARE FOUND.
- 2. (N) INDICATES NEW CIRCUIT BREAKER PROVIDED AND INSTALLED BY CONTRACTOR. CIRCUIT BREAKER AIC RATINGS SHALL BE EQUAL TO OR GREATER THAN EXISTING CIRCUIT BREAKER RATINGS AND IN NO CASE LESS THAN 10,000A.
- 3. PROVIDE REVISED PANEL SCHEDULES TO INDICATE LOADS AT PROJECT COMPLETION. REVISED PANEL SCHEDULES SHALL BE TYPED. HAND WRITTEN SCHEDULES WILL NOT BE ACCEPTED.

MANATEE COUNTY S. W. R. W. T. F ADMINISTRATION BUILDING RENOVATIONS

2E6.0

SHEET NO.