

# CONSTRUCTION PLANS

## FOR

# BAYSHORE YACHT BASIN FORCE MAIN AND LIFT

# STATION REPLACEMENT

MANATEE COUNTY, FLORIDA

FEBRUARY 2022  
MANATEE COUNTY PROJECT #6097484



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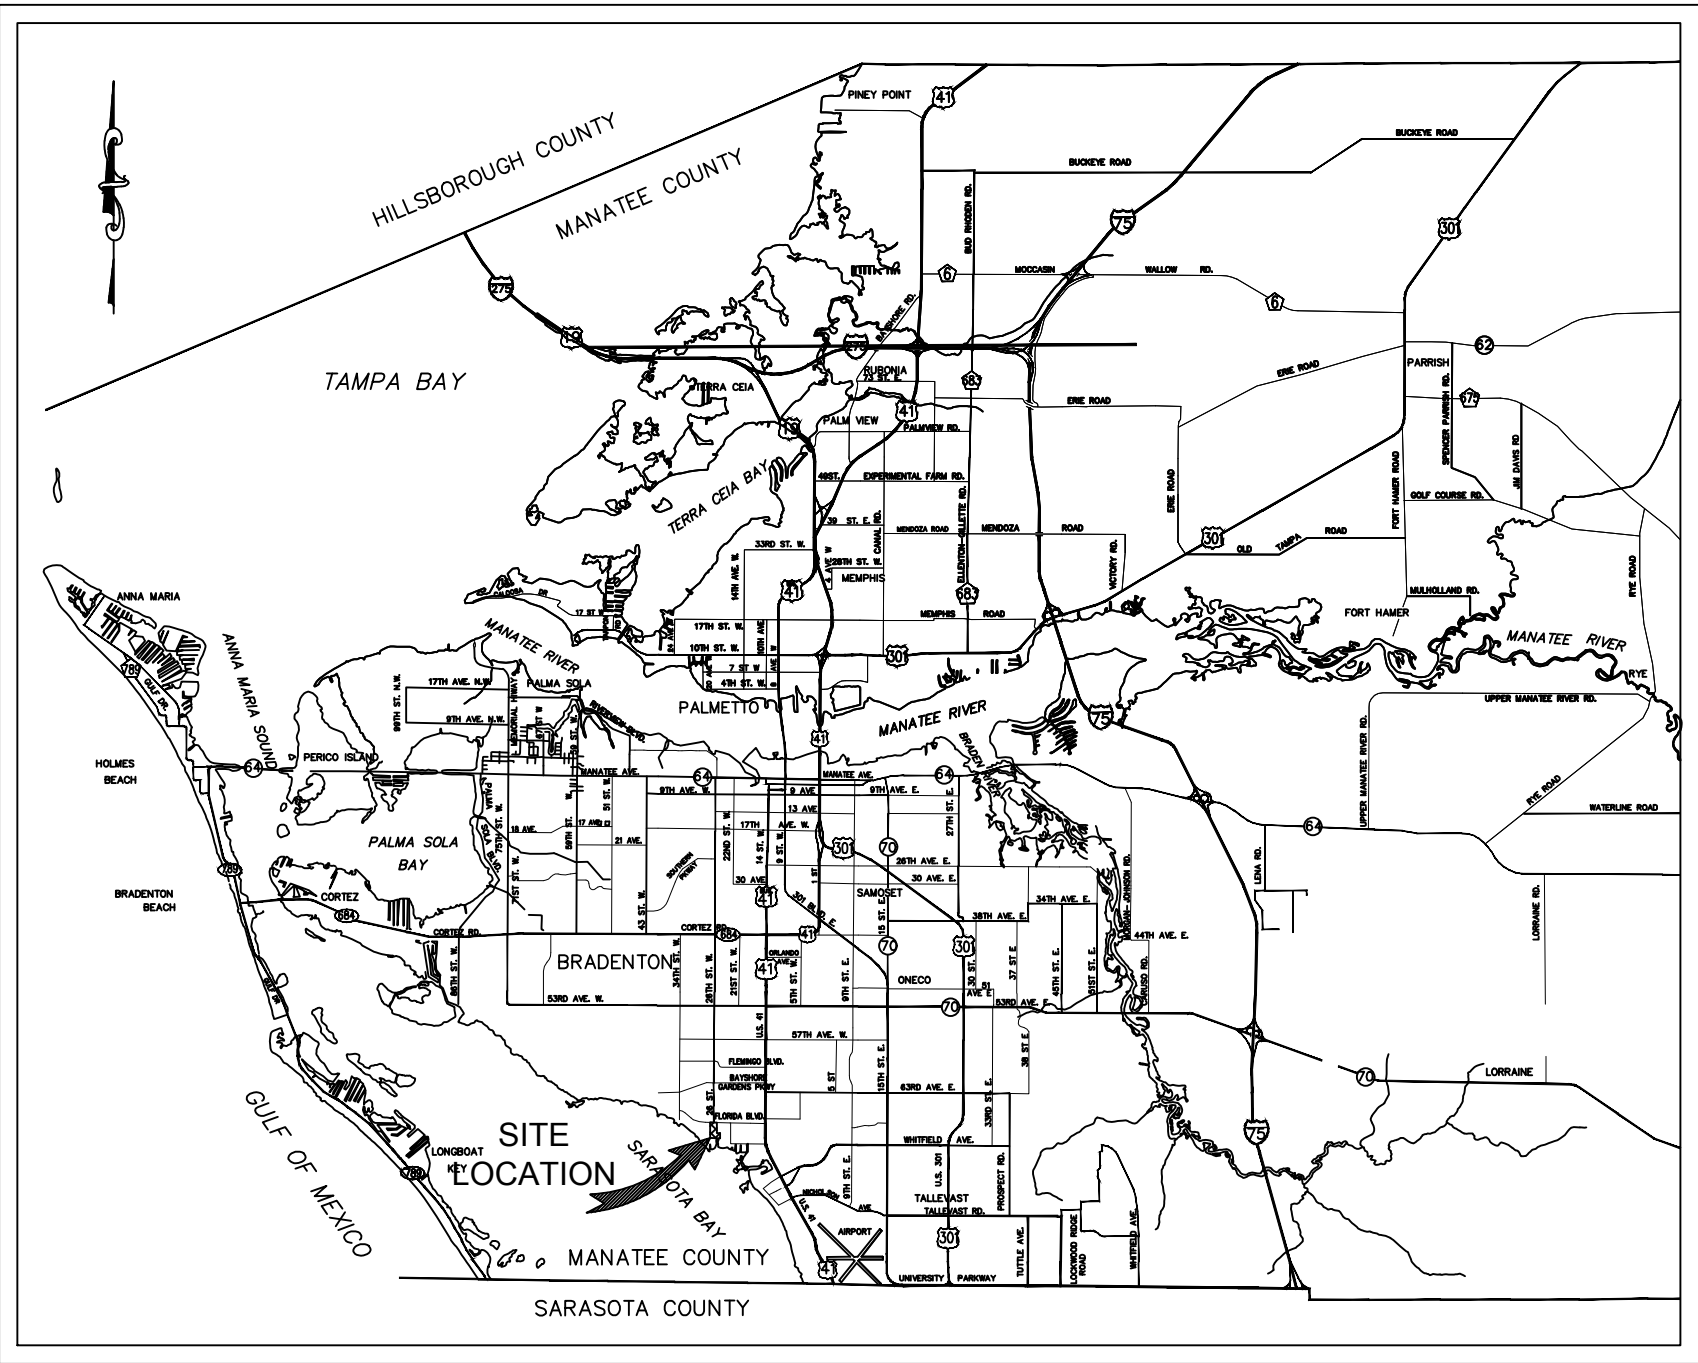
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PROJECT VICINITY MAP  
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## BID PLANS

PREPARED BY  
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PROJECT NO.  
148400067

SHEET NUMBER

G-1



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SHEET LIST TABLE	
SHEET NUMBER	SHEET TITLE
G-1	COVER SHEET
G-2	DRAWING INDEX & GENERAL NOTES
G-3	SURVEY & SUE NOTES
G-4	CONSTRUCTION PHASING PLAN
G-5	KEY SHEET
C-1	LIFT STATION EXISTING SITE PLAN
C-2	LIFT STATION DEMOLITION PLAN
C-3	EXISTING WETWELL DEMOLITION PLAN
C-4	LIFT STATION SITE PLAN
C-5	DIMENSIONAL CONTROL PLAN
C-6	GRADING PLAN
C-7	PLAN AND PROFILE (STA 0+00 – STA 4+50)
C-8	PLAN AND PROFILE (STA 4+50 – STA 7+00)
C-9	PLAN AND PROFILE (STA 7+00 – STA 11+00)
C-10	PLAN AND PROFILE (STA 11+00 – STA 15+31)
C-11	CIVIL DETAILS
C-12	CIVIL DETAILS
C-13	CIVIL DETAILS
C-14	CIVIL DETAILS
M-1	LIFT STATION SITE PLAN
M-2	ISOMETRIC VIEWS
M-3	WET WELL PLAN
M-4	WETWELL CROSS SECTION I
M-5	WETWELL CROSS SECTION II
M-6	WETWELL CRANE
M-7	ELEVATED PLATFORM PLAN
M-8	ELECTRICAL BUILDING WEST ELEVATION
M-9	ELECTRICAL BUILDING NORTH ELEVATION
M-10	PREFABRICATED BUILDING – PLAN
M-11	PREFABRICATED BUILDING – SECTION
M-12	HVAC ABBREVIATIONS AND SCHEDULES
M-13	HVAC FLOOR PLAN
M-14	MECHANICAL DETAILS
M-15	MECHANICAL DETAILS
S-1	STRUCTURAL NOTES/EQUIPMENT LAYOUT
S-2	ELEVATED PLATFORM DETAILS
S-3	ELEVATED PLATFORM DETAILS
S-4	STAIR AND RAILING DETAILS
S-5	WETWELL TOP SLAB PLAN
S-6	WETWELL TOP SLAB SECTION
S-7	WETWELL SECTION
S-8	STRUCTURAL WETWELL DETAILS
S-9	VALVE ASSEMBLY AND ODOR CONTROL SLABS
L-1	LANDSCAPE NOTES AND DETAILS
L-2	LANDSCAPE PLAN
IR-1	IRRIGATION NOTES
IR-2	IRRIGATION PLAN
IR-3	IRRIGATION DETAILS
E-1	ELECTRICAL LEGEND AND ABBREVIATIONS
E-2	ELECTRICAL SITE PLAN
E-3	SITE LIGHTING PLAN
E-4	LIGHTING PROTECTION SYSTEM PLAN
E-5	ELECTRICAL GROUNDING PLAN
E-6	ELECTRICAL BUILDING POWER AND LIGHTING PLANS
E-7	GENERATOR DETAILS
E-8	MOTOR CONTROL CENTER ELEVATION
E-9	MOTOR CONTROL CENTER ONE-LINE DIAGRAM
E-10	TYPICAL VFD WIRING DIAGRAM
E-11	EQUIPMENT RACK ELEVATIONS
E-12	WET WELL JUNCTION BOX RACK ELEVATION
E-13	WET WELL JUNCTION BOX DETAILS
E-14	PANELBOARD SCHEDULE AND ESO DETAIL
E-15	AREA LIGHT DETAILS
E-16	LIGHTNING PROTECTION DETAILS
E-17	LIGHTING PROTECTION DETAILS AND NOTES
E-18	CONDUIT AND CABLE SCHEDULE
E-19	CONDUIT AND CABLE SCHEDULE
I-1	INSTRUMENTATION LEGEND AND ABBREVIATIONS
I-2 – I-14	DATA FLOW SYSTEMS CONTROL PANEL WIRING DIAGRAMS
I-15	DATA FLOW SYSTEMS TCU/VFD PANEL LAYOUT
I-16	INSTRUMENTATION DETAILS

GENERAL


- ALL CONSTRUCTION ACTIVITIES SHALL BE COORDINATED WITH THE PROJECT MANAGEMENT DIVISION. THE PROJECT MANAGER IS: BRETT GOCKA, P.E. AND CAN BE REACHED AT (941) 708-7450 X 7232.
  - IF THE CONTRACTOR WANTS A SITE VISIT PRIOR TO BIDDING, THESE SHALL BE ARRANGED THROUGH THE COUNTY'S PURCHASING DIVISION.
  - ALL CONSTRUCTION ON THIS PROJECT SHALL BE IN ACCORDANCE WITH THE LATEST EDITION OF MANATEE COUNTY PUBLIC WORKS STANDARDS UTILITIES STANDARDS MANUAL AND HIGHWAY & TRAFFIC STANDARDS MANUAL AND/OR FDOT "STANDARD PLANS FOR ROAD AND BRIDGE CONSTRUCTION" UNLESS OTHERWISE INDICATED ON THE PLANS.
  - THE CONTRACTOR SHALL BE RESPONSIBLE FOR MEETING ALL CONDITIONS AND REQUIREMENTS OF ALL PERMITS AND ALL GOVERNING FEDERAL, STATE, AND LOCAL AGENCIES. THE CONTRACTOR SHALL OBTAIN AND PAY FOR ALL REQUIRED PERMITS THAT ARE NOT PROVIDED IN THE BID DOCUMENTS, AT NO ADDITIONAL COST TO THE OWNER.
  - THE INFORMATION PROVIDED IN THESE PLANS IS SOLELY TO ASSIST THE CONTRACTOR IN ASSESSING THE NATURE AND EXTENT OF THE CONDITIONS WHICH MAY BE ENCOUNTERED DURING THE COURSE OF WORK. ALL CONTRACTORS ARE DIRECTED, PRIOR TO BIDDING, TO CONDUCT WHATEVER INVESTIGATION THEY MAY DEEM NECESSARY TO ARRIVE AT THEIR OWN CONCLUSIONS REGARDING THE ACTUAL CONDITIONS THAT WILL BE ENCOUNTERED, AND UPON WHICH THEIR BIDS WILL BE BASED.
  - THE CONTRACTOR SHALL REVIEW AND VERIFY ALL DIMENSIONS ON THE PLANS AND REVIEW ALL FIELD CONDITIONS THAT MAY AFFECT CONSTRUCTION. SHOULD DISCREPANCIES OCCUR, THE CONTRACTOR SHALL NOTIFY THE ENGINEER TO OBTAIN THE ENGINEER'S CLARIFICATION BEFORE COMMENCING WITH CONSTRUCTION.
  - THE CONTRACTOR SHALL NOTIFY SUNSHINE 811 (1-800-432-4770) AT LEAST 2 FULL BUSINESS DAYS PRIOR TO CONSTRUCTION OPERATIONS. THE CONTRACTOR SHALL BE RESPONSIBLE FOR COORDINATING WITH ALL UTILITIES FOR THE POSSIBLE RELOCATION OR THE TEMPORARY MOVEMENT OF ANY EXISTING UTILITIES WITHIN THE RIGHTS-OF-WAY OR UTILITY EASEMENTS. IT IS THE CONTRACTOR'S RESPONSIBILITY TO PROTECT EXISTING UTILITIES FROM DAMAGE. EXPLORATORY EXCAVATION MAY BE REQUIRED PRIOR TO CONNECTION TO EXISTING UTILITIES.
  - NO WORK, EXCEPT FOR EMERGENCY TYPE, SHALL BE PERFORMED AFTER 7:00 PM AND BEFORE 7:00 AM. FOR ADDITIONAL PROJECT RESTRAINTS, REFER TO SECTION 01310 OF THE SPECIFICATIONS.
  - THE CONTRACTOR SHALL PROVIDE CERTIFIED RECORD DRAWINGS AS OUTLINED IN THE SPECIFICATIONS. RED-LINE DRAWINGS SHALL BE CURRENT WITH EACH PAY APPLICATION SUBMITTED AND WILL BE CHECKED AS PART OF THE PAY APPLICATION REVIEW PROCESS. PAYMENT WILL NOT BE MADE TO CONTRACTOR WITHOUT APPROVED RED-LINE DRAWINGS. THE MOST CURRENT SET OF RED-LINE DRAWINGS SHALL ALSO BE BROUGHT TO EACH MONTHLY PROGRESS MEETING.
  - THE CONTRACTOR SHALL INCLUDE IN HIS BID: DEWATERING PUMPING EQUIPMENT, PUMPS, FITTINGS, LABOR, ETC. AS NECESSARY, BASED ON METHOD AND SEASON OF CONSTRUCTION TO COMPLETE ALL WORK WHILE MAINTAINING UTILITY SERVICE. OPERATIONS AT ALL TIMES.
  - ALL PROPOSED WORK SHALL BE COORDINATED WITH MANATEE COUNTY UTILITIES DEPARTMENT AT LEAST TWO WEEKS IN ADVANCE OF PROPOSED CONSTRUCTION.
  - THE CONTRACTOR SHALL FURNISH SHOP DRAWINGS TO THE ENGINEER FOR REVIEW OF ALL PIPE CONNECTIONS, TRANSITIONS, AND SPECIAL APPURTENANCES PRIOR TO FABRICATION OR DELIVERY TO THE JOB SITE.
  - UNLESS OTHERWISE INDICATED OR APPROVED, ALL BELOW GROUND PVC PIPE SHALL HAVE PUSH-ON JOINTS, AND ALL ABOVE GROUND DIP PIPE SHALL HAVE FLANGED JOINTS. JOINTS SHALL BE RESTRAINED PER THE DETAILS IN THESE PLANS.
  - SANITARY SEWERS AND FORCE MAINS CROSSING OVER OR UNDER WATER MAINS SHALL BE LAID TO PROVIDE A MINIMUM VERTICAL DISTANCE OF 18" BETWEEN THE INVERT OF THE UPPER PIPE AND THE CROWN OF THE LOWER PIPE. WHERE THIS MINIMUM SEPARATION CANNOT BE MAINTAINED, THE CROSSING SHALL BE ARRANGED SO THAT THE SEWER OR FORCE MAIN PIPE JOINTS ARE EQUIDISTANT FROM THE POINT OF CROSSING WITH NO LESS THAN 10" BETWEEN ANY TWO JOINTS. AS AN ALTERNATIVE, THE SEWER OR FORCE MAIN MAY BE PLACED IN A WATERTIGHT CASING PIPE, CONSISTENT WITH F.A.C. RULE 62-555.314.
  - ALL BELOW-GRADE FITTINGS 4-INCHES & GREATER IN DIAMETER SHALL BE MECHANICAL JOINT DUCTILE IRON WITH AN APPROVED LINING FOR THEIR INTERIOR SURFACES AND COAL TAR ENAMEL COATING ON EXTERIOR SURFACES, AS NOTED IN SECTION 02615 OF SPECIFICATIONS.
  - IT SHALL BE THE CONTRACTOR'S RESPONSIBILITY TO SECURE PROPERTY FOR STAGING MATERIALS AND EQUIPMENT.
  - IT WILL BE THE CONTRACTOR'S RESPONSIBILITY TO ACQUIRE, OR ENTER INTO AGREEMENTS, FOR LANDS FOR LAY DOWN AREAS AND STAGING. THE COUNTY WILL COORDINATE AND ADVISE, TO HELP IDENTIFY POSSIBLE PARCELS. IT IS FINALLY THE CONTRACTOR'S RESPONSIBILITY TO SECURE THE NEEDED AREAS, AND THE COUNTY TAKE NO RESPONSIBILITY FOR DELAYS IN THIS REGARD.
  - COORDINATION AND PUBLIC INFORMATION FOR AND WITH AREA RESIDENTS ARE OF THE UTMOST IMPORTANCE. CONTRACTOR WILL INSURE ADHERENCE TO THE COUNTY'S NOISE ORDINANCE, HAZARD AND SAFETY, AND NUISANCE ABATEMENT DIRECTIONS, PLANS, OBJECTIONS AND ORDINANCES. THE ENGINEER WILL HAVE THE FINAL DISCRETION IN THIS REGARD, AS REPRESENTED ONSITE BY THE COUNTY INSPECTOR AND ENGINEER'S STAFF.
- SAFETY**
- THE CONTRACTOR SHALL BE RESPONSIBLE FOR COMPLIANCE WITH THE FLORIDA TRENCH SAFETY ACT, 90-96, LAWS OF FLORIDA EFFECTIVE OCTOBER 1, 1990 AND THE OCCUPATIONAL SAFETY AND HEALTH ADMINISTRATION EXCAVATION SAFETY STANDARDS, 29 CFR 1926.650, SUBPART P, AS AMENDED. THE CONTRACTOR SHALL INCLUDE IN THE TOTAL BID PRICE ALL COSTS FOR COMPLIANCE WITH THESE REGULATIONS.
  - THE CONTRACTOR SHALL USE SHEET PILING, SHEETING, BRACING, ETC., AS REQUIRED IN ALL EXCAVATION AREAS AND CONFORM TO ALL OSHA REQUIREMENTS.
  - THE CONTRACTOR SHALL USE ALL NECESSARY SAFETY PRECAUTIONS TO AVOID CONTACT WITH OVERHEAD AND UNDERGROUND UTILITIES, POWER LINES, ETC.
  - THESE DRAWINGS DO NOT INCLUDE NECESSARY COMPONENTS FOR CONSTRUCTION SAFETY. THESE EXCLUSIONS DO NOT RELIEVE THE CONTRACTOR FROM PROVIDING ANY REQUIRED SAFETY EQUIPMENT, SUPPLIES, OR APPARATUS AS NEEDED TO EXECUTE THE WORK EFFECTIVELY AND SAFELY. THE OUTLINES IN THE PLANS AND SPECIFICATIONS, THE CONTRACTOR ACCEPTS ANY AND ALL LIABILITY FROM THE CONTRACTOR'S FAILURE TO PROVIDE A SAFE WORK ENVIRONMENT.
- ENVIRONMENTAL**
- THE CONTRACTOR SHALL PROVIDE AND INSTALL ALL NECESSARY STORM WATER, EROSION, AND SEDIMENTATION CONTROL MEASURES IN ACCORDANCE WITH THE FDP "FLORIDA STORM WATER, EROSION AND SEDIMENTATION CONTROL INSPECTOR'S MANUAL". IT IS THE RESPONSIBILITY OF THE CONTRACTOR TO CONTROL AND PREVENT EROSION AND TRANSPORT OF SEDIMENT TO SURFACE DRAINS AND TO DITCHES DURING CONSTRUCTION.
  - STOCKPILES SHALL BE PROTECTED AT ALL TIMES BY ON-SITE DRAINAGE CONTROLS WHICH PREVENT EROSION OF THE STOCKPILED MATERIAL. CONTROL OF DUST FROM SUCH STOCKPILES IS REQUIRED, DEPENDING UPON THEIR LOCATION AND THE EXPECTED LENGTH OF TIME THE STOCKPILES WILL BE PRESENT. IN NO CASE SHALL ANY STOCKPILED MATERIAL REMAIN AFTER THIRTY (30) CALENDAR DAYS.
  - STORM WATER INLETS IN THE VICINITY OF THE PROJECT SHALL BE PROTECTED BY SEDIMENT TRAPS SUCH AS SECURED HAY BALES, SOD, STONE, ETC., WHICH SHALL BE MAINTAINED AND MODIFIED AS REQUIRED BY CONSTRUCTION PROGRESS, AND WHICH MUST BE APPROVED BY THE ENGINEER BEFORE INSTALLATION. THIS WILL BE MAINTAINED TO PREVENT DEGRADATION OF THE WATERS OF THE COUNTY AND STATE.
  - SEDIMENT BASINS AND TRAPS, PERIMETER BERMS, SEDIMENT BARRIERS, VEGETATIVE BUFFERS, AND OTHER MEASURES INTENDED TO TRAP SEDIMENT AND/OR PREVENT THE TRANSPORT OF SEDIMENT ONTO ADJACENT PROPERTIES, OR INTO EXISTING BODIES OF WATER, MUST BE INSTALLED, CONSTRUCTED, OR IN THE CASE OF VEGETATIVE BUFFERS, PROTECTED FROM DISTURBANCE, AS A FIRST STEP IN THE LAND ALTERATION PROCESS. SUCH SYSTEMS SHALL BE FULLY OPERATIVE BEFORE ANY OTHER DISTURBANCE OF THE SITE BEGINS. EARTHEN STRUCTURES INCLUDING BUT NOT LIMITED TO BERMS, EARTH FILTERS, DAMS OR DIKES SHALL BE STABILIZED AND PROTECTED FROM DRAINAGE DAMAGE OR EROSION WITHIN ONE (1) WEEK OF INSTALLATION.
  - ALL SWALES, DITCHES, AND CHANNELS LEADING FROM THE SITE SHALL BE PROTECTED FROM SILTATION AND EROSION PRIOR TO THE START OF CONSTRUCTION AND MAINTAINED THRU THE CONTRACT TERM. ALL SODDING SHALL BE PERFORMED WITHIN THREE (3) DAYS OF EXCAVATION.
  - SOIL DISPLACED BY CONSTRUCTION WILL BE REMOVED. EROSION CONTROL SHALL BE IMPLEMENTED IN AREAS WHICH ARE CONSIDERED ENVIRONMENTALLY SENSITIVE. EROSION CONTROL SYSTEMS SHALL BE REQUIRED FOR ALL WORK WITHIN JURISDICTIONAL AREAS. THESE SYSTEMS MAY INCLUDE STAKED HAY BALES, SILT SCREENS, FILTER FABRIC, AND TURBIDITY SCREENS.
  - ALL EROSION AND POLLUTION CONTROL DEVICES SHALL BE CHECKED REGULARLY, ESPECIALLY AFTER EACH

RAINFALL AND SHALL BE CLEANED OUT AND/OR REPAIRED AS REQUIRED.

- THE CONTRACTOR SHALL NOT ENTER UPON OR IN ANY WAY ALTER WETLAND AREAS THAT MAY BE ON OR NEAR THE CONSTRUCTION SITE. ALL WORK IN THE VICINITY OF OPEN WATER AND/OR WETLANDS IS TO BE PERFORMED IN COMPLIANCE WITH THE ENVIRONMENTAL REGULATIONS AND/OR PERMITS FOR THE SITE. THE CONTRACTOR WILL BE RESPONSIBLE FOR ANY FINES RESULTING FROM HIS VIOLATION OF ANY REGULATIONS OR PERMIT CONDITIONS.
  - CONTRACTOR SHALL PROVIDE PROTECTIVE MATTING, FUEL CONTAINMENT AND ALL OTHER MATERIALS, EQUIPMENT AND LABOR TO PROTECT THE STAGING AREA DURING CONSTRUCTION.
  - CONTRACTOR SHALL, PRIOR TO BEGINNING CONSTRUCTION, SUBMIT A "FUELING SPILL PREVENTION PLAN" THAT SHALL CLEARLY INDICATE HOW FUEL SPILLS WILL BE PREVENTED WHEN FUELING BOTH WITHIN AND OUTSIDE OF THE STAGING AREA.
- RIGHT-OF-WAY**
- ALL CONSTRUCTION ACTIVITIES SHALL BE LIMITED TO WITHIN THE MANATEE COUNTY RIGHT-OF-WAY, OTHER PUBLIC RIGHT-OF-WAYS OR EASEMENTS SHOWN ON THE DRAWINGS.
  - THE CONTRACTOR SHALL EMPLOY A LAND SURVEYOR REGISTERED IN THE STATE OF FLORIDA TO REFERENCE AND RESTORE PROPERTY CORNER MONUMENTS, PINS, AND LANDMARKS THAT MAY BE DISTURBED BY CONSTRUCTION AT NO ADDITIONAL COST TO THE OWNER.
  - THE CONTRACTOR, PRIOR TO CONSTRUCTION AND RESTRICTING ANY TRAFFIC, MUST OBTAIN ANY REQUIRED RIGHTS-OF-WAY USE PERMITS AND A TRAFFIC CONTROL PLAN. THE CONTRACTOR SHALL OBTAIN ALL REQUIRED PERMITS FROM OTHER GOVERNMENTAL AGENCIES HAVING RELEVANT JURISDICTION. ALL MAINTENANCE AND PROTECTION OF TRAFFIC SHALL BE IN ACCORDANCE WITH THE APPLICABLE REQUIREMENTS OF THE CURRENT FLORIDA DEPARTMENT OF TRANSPORTATION "STANDARD PLANS FOR ROAD CONSTRUCTION MAINTENANCE OF TRAFFIC" INDEX 102-600 THROUGH 102-680. A TRAFFIC CONTROL PLAN SHALL BE SUPPLIED BY THE CONTRACTOR AT THE PRE-CONSTRUCTION MEETING, PER SPECIFICATIONS 01570.
  - THE CONTRACTOR SHALL BE RESPONSIBLE FOR REPLACING ALL DAMAGED STORM WATER STRUCTURES, PIPING, ENTRANCE PIPE AND HEADWALLS WHETHER SHOWN ON THE PLANS OR NOT. THE HEADWALLS SHALL BE REPLACED IN ACCORDANCE WITH F.D.O.T. STANDARDS, OR THE APPLICABLE JURISDICTION.
  - IT IS THE RESPONSIBILITY OF THE CONTRACTOR TO ESTABLISH IN THE FIELD THE RIGHT-OF-WAY LINES, BASE LINES, BENCH MARKS (ELEV.), CENTER LINES, AND STATIONING AS REQUIRED TO CONSTRUCT THIS PROJECT.
  - THE CONTRACTOR SHALL BE RESPONSIBLE FOR COORDINATING WITH PROPERTY OWNERS PRIOR TO PERFORMING ANY WORK ON THE OWNER'S DRIVEWAY. CONTRACTOR SHALL MAINTAIN SAFE ACCESS TO THE PROPERTY AT ALL TIMES DURING CONSTRUCTION.
  - A RIGHT OF ENTRY AGREEMENT SHALL BE OBTAINED BY THE CONSTRUCTION MANAGER FROM THE PROPERTY OWNER BEFORE ANY DRIVEWAY CONSTRUCTION WORK IS DONE OUTSIDE OF THE RIGHT-OF-WAY OR EASEMENT.
- UTILITIES**
- LOCATIONS, ELEVATIONS AND DIMENSIONS OF EXISTING UTILITIES, STRUCTURES AND OTHER FEATURES ARE SHOWN TO THE BEST INFORMATION AVAILABLE AT THE TIME OF PREPARATION OF THESE PLANS BUT DO NOT PURPORT TO BE ABSOLUTELY CORRECT. THERE MAY BE OTHER IMPROVEMENTS, UTILITIES, ETC. WHICH ARE WITHIN THE PROJECT AREA AND WHICH HAVE NOT BEEN LOCATED OR IDENTIFIED, MAY NOT BE IN THE EXACT LOCATION SHOWN, OR RELATED SINKHOLE. THE CONTRACTOR SHALL VERIFY, PRIOR TO CONSTRUCTION, THE LOCATIONS, ELEVATIONS AND DIMENSIONS OF ALL EXISTING UTILITIES, STRUCTURES AND OTHER FEATURES (WHETHER OR NOT SHOWN ON THE PLANS) THAT MAY EFFECT HIS WORK. ALL EXISTING UTILITIES TO BE EXTENDED, CROSSED OR CONNECTION POINTS SHALL BE EXPOSED PRIOR TO CONSTRUCTION TO VERIFY LOCATION AND ELEVATION. ANY DISCREPANCIES OR CONFLICTS FOUND SHALL BE BROUGHT TO THE ENGINEER'S ATTENTION FOR RESOLUTION.
  - THE CONTRACTOR SHALL PROTECT ALL EXISTING STRUCTURES, WATER AND SEWER LINES, STORM DRAINS, UTILITIES, DRIVEWAYS, SIDEWALKS, SIGNS, MAIL BOXES, FENCES, TREES, LANDSCAPING, AND ANY OTHER IMPROVEMENT OR FACILITY IN THE CONSTRUCTION AREA. THE CONTRACTOR SHALL REPAIR AND/OR REPLACE ANY DAMAGED ITEM DUE TO HIS CONSTRUCTION ACTIVITIES TO EQUAL OR BETTER THAN PRE-CONSTRUCTION CONDITIONS AT NO ADDITIONAL COST TO THE OWNER.
  - THE CONTRACTOR SHALL USE APPROPRIATE TECHNIQUES, AS APPROVED, RECOMMENDED OR OFFERED BY FLORIDA POWER AND LIGHT TO PREVENT INTERFERING OF POWER POLES DURING CONSTRUCTION. IF HOLDING OF POWER POLES IS RECOMMENDED OR REQUIRED BY THE UTILITY, THE CONTRACTOR SHALL COORDINATE THIS ACTIVITY WITH THE UTILITY AND BEAR ALL RELATED COSTS.
  - ANY TEMPORARY SHUTDOWNS FOR MODIFICATIONS OF EXISTING UTILITY SYSTEMS THAT MUST REMAIN IN SERVICE DURING CONSTRUCTIONS SHALL BE KEPT TO A MINIMUM AND SHALL BE COORDINATED WITH AND APPROVED BY THE MANATEE COUNTY UTILITY OPERATIONS DEPARTMENT IN ACCORDANCE WITH THE CONTRACT DOCUMENTS. IT IS NOTED THAT TEMPORARY SHUTDOWNS MAY BE RESTRICTED TO CERTAIN HOURS AT ANY TIME OF THE DAY OR NIGHT AND WILL BE COMPLETED AT NO ADDITIONAL COST TO THE OWNER.
  - THE ELEVATIONS OF THE UTILITY SERVICES AND LATERALS HAVE BEEN ASSUMED ON THE BASIS OF TYPICAL ANTICIPATED SOIL COVERAGE. CONTRACTOR SHALL NOT RELY ON THIS INFORMATION FOR CONSTRUCTION, BUT SHALL BE RESPONSIBLE FOR FIELD LOCATIONS (HORIZONTAL AND VERTICAL) OF ALL UTILITIES CROSSING THE PROPOSED FORCE MAIN. CONTRACTOR SHALL INCLUDE IN THE UNIT COST OF THE SUBJECT FORCE MAIN CONSTRUCTION, THE COST OF UTILITY ADJUSTMENTS NECESSARY TO ATTAIN DESIGN MINIMUM SEPARATION FOR UTILITIES CONFLICTING WITH THE CONSTRUCTION OF THE PROPOSED FORCE MAIN. INTERRUPTIONS OF ANY EXISTING UTILITY SERVICES SHALL BE NOTICED TO EFFECTED CUSTOMERS A MINIMUM OF 48 HOURS IN ADVANCE AND SHALL NOT EXCEED 4 HOURS IN DURATION.
- RESTORATION**
- ALL RESTORATION WORK PERFORMED THROUGHOUT THE PROJECT SHALL CONFORM TO EXISTING LINES AND GRADES UNLESS SHOWN OTHERWISE.
  - ALL DISTURBED GRASSSED AREAS SHALL BE SODDED UNLESS OTHERWISE INDICATED. THE TYPE OF SOD USED TO REPLACE OWNER MAINTAINED AREAS IN RIGHT-OF-WAY SHALL BE COORDINATED WITH THE PROPERTY OWNER.
  - ALL CONCRETE THRUST BLOCKS INSTALLED FOR TESTING PURPOSES AND NOT REQUIRED FOR THE OPERATION OF THE PIPELINE SHALL BE REMOVED AND DISPOSED OF BY THE CONTRACTOR, PRIOR TO FINAL ACCEPTANCE, AT NO ADDITIONAL COST TO THE OWNER.
  - ASPHALT DRIVES THAT ARE CUT SHALL BE RESTORED PER SECTION 02513 OF THE SPECIFICATIONS.
  - CONCRETE DRIVEWAYS OR SIDEWALKS THAT ARE CUT SHALL BE RESTORED TO MATCH EXISTING PER MANATEE COUNTY PUBLIC WORKS STANDARDS AND ACCORDING TO THE 2020-2021 EDITIONS OF THE F.D.O.T. STANDARD PLANS FOR ROAD CONSTRUCTION CONCRETE SIDEWALK AND DRIVEWAYS INDEX 522-001 THROUGH 522-003.
  - WHENEVER A PERMANENT ROADWAY SURFACE IS NOT REPLACED IMMEDIATELY AFTER BACKFILLING AND COMPACTION OF THE NEWLY INSTALLED PIPE LINE IN AREAS WHERE TRAFFIC MUST PASS, THE CONTRACTOR SHALL INSTALL A TEMPORARY SURFACE CONSISTING OF NINE INCHES OF COMPACTED LIME ROCK BASE AND A COAT OF ASPHALT EMULSION. PERMANENT ROADWAY REPAIR SHALL BE PERFORMED A MAXIMUM OF TWENTY-ONE CALENDAR DAYS AFTER THE INITIAL OPEN CUTTING.
  - RESTORATION OF CURBS, DRIVEWAYS, SIDEWALKS, AND PLACEMENT OF SOD SHALL BE COMPLETED AS SOON AS THE CONTRACTOR HAS COMPLETED WORK IN THE AREA OF IMPACT. RESTORATION SHALL BE COMPLETED NO MORE THAN 10 DAYS FROM COMPLETION OF CONSTRUCTION IN THE AREA OF IMPACT.
  - ALL EXISTING FENCES DISTURBED DURING CONSTRUCTION SHALL BE REPAIRED OR REPLACED AND REINSTALLED BY THE CONTRACTOR AT NO ADDITIONAL COST TO THE OWNER UNLESS SHOWN TO BE REMOVED ON CONSTRUCTION PLANS.
  - WHERE CONCRETE REPAIRS ARE NECESSARY AND EXPANSION OR CONTRACTION JOINTS ARE PRESENT, CONTRACTOR SHALL REMOVE AND REPLACE CONCRETE UP TO THE NEXT EXPANSION OR CONTRACTION JOINT. ANY CURB REQUIRING CONCRETE REPAIRS SHALL BE REPLACED AT A MINIMUM OF TEN (10) FEET IN LENGTH.
  - ALL SIGNING AND PAVEMENT MARKINGS AFFECTED BY ANY IMPROVEMENTS, ROADWAY RESTORATION, OR MILLING AND RESURFACING SHALL BE RESTORED BY THE CONTRACTOR.
  - LANDSCAPE REMOVAL AND TREE REMOVAL SHALL BE PERFORMED IN ACCORDANCE WITH THE CLEARING AND GRUBBING PAY ITEM IN MEASUREMENT AND PAYMENT SECTION 01150. CONTRACTOR TO RESTORE AFFECTED AREAS TO EXISTING CONDITION MATCHING EXISTING GRADE. MEETING COUNTY COMPACTON REQUIREMENTS. ALL AFFECTED LANDSCAPE AREAS SHALL BE RESTORED TO EXISTING CONDITION. ALL OTHER AREAS SHALL BE SODDED UNLESS OTHERWISE INDICATED.
- CONSTRUCTION**
- THE EXHAUST SYSTEM OF ALL GASOLINE AND DIESEL ENGINES SHALL BE EQUIPPED WITH MUFFLERS THAT MEET THE EQUIPMENT MANUFACTURER'S REQUIREMENTS FOR NOISE SUPPRESSION. THE CONTRACTOR SHALL INSTALL NOISE ABATEMENT BAFFLES POSITIONED TO BREAK LINE-OF-SITE FROM THE NOISE SOURCE TO AFFECTED RESIDENCES, AS APPROVED BY THE ENGINEER.

- NO MATERIAL SHALL BE STOCKPILED IN ROADWAYS. ALL DIRT AND DEBRIS SHALL BE REMOVED FROM THE JOB SITE DAILY. ROADS SHALL BE SWEEPED DAILY AS PART OF DAILY CLEAN UP.
  - THE CONTRACTOR IS TO CONTROL ALL FUGITIVE DUST ORIGINATING ON THIS PROJECT BY WATERING OR OTHER METHODS AS REQUIRED.
  - INGRESS AND EGRESS TO ALL THE PROPERTIES IN THE CONSTRUCTION AREA SHALL BE MAINTAINED AT ALL TIMES.
  - PRIOR APPROVAL WILL BE REQUIRED FOR REMOVAL OR TRIMMING OF ANY TREE WITHIN THE CONSTRUCTION AREA.
  - THE CONTRACTOR SHALL PROVIDE ALL DEWATERING EQUIPMENT NECESSARY TO KEEP ALL EXCAVATIONS DRY. DEWATERING IS REQUIRED TO 18" BELOW TRENCH BOTTOM. REFER TO THE PLANS FOR ADDITIONAL DETAILS.
  - ALL PIPING AND FITTINGS USED ON THIS PROJECT SHALL BE AS NOTED ON THE PLANS AND IN THE CONTRACT DOCUMENT AND SHALL BE INSTALLED TO THE LINES AND GRADES SHOWN ON THE PLANS AND PROFILES.
  - ALL PIPE SHALL BE COLOR CODED TO CONFORM TO MANATEE COUNTY STANDARDS.
  - ALL FITTINGS FOR PRESSURE CLASS-RATED PIPE SHALL BE RESTRAINED DUCTILE IRON. FITTINGS AND PIPE JOINTS SHALL BE RESTRAINED PER THE DETAILS IN THE PLANS.
  - WHERE IT IS NECESSARY TO DEFLECT PIPE EITHER HORIZONTALLY OR VERTICALLY, PIPE DEFLECTION SHALL NOT EXCEED 75% OF THE MANUFACTURER'S MAXIMUM ALLOWABLE RECOMMENDED DEFLECTION.
  - ALL ROCKS OR STONES LARGER THAN SIX INCH DIAMETER SHALL BE REMOVED FROM THE BACKFILL MATERIAL. BACKFILL MATERIAL PLACED WITHIN ONE FOOT OF PIPING AND APPURTENANCES SHALL NOT CONTAIN ANY STONES LARGER THAN TWO INCH DIAMETER.
  - ONLY MANATEE COUNTY UTILITY OPERATIONS STAFF ARE AUTHORIZED TO OPERATE VALVES AND PUMP STATIONS ON COUNTY OWNED AND MAINTAINED UTILITY SYSTEMS.
  - ALL TEST POINT PIPING SHALL BE CUT LOOSE FROM THE CORPORATION STOP AND COMPLETELY REMOVED AND DISPOSED OF BY THE CONTRACTOR PRIOR TO FINAL ACCEPTANCE. A CORPORATION STOP PLUG SHALL BE INSTALLED AND THE CORPORATION STOP SHALL REMAIN IN PLACE.
  - ALL EXISTING MAINS THAT ARE BEING REPLACED SHALL BE ABANDONED IN PLACE UPON ACCEPTANCE AND ACTIVATION OF THE NEW MAINS. ABANDONED MAINS SHALL BE CUT AND CAPPED. REFER TO SECTION 02064 OF THE SPECIFICATIONS FOR CUT AND CAPPING ABANDONED PIPE.
  - FIELD CONDITIONS MAY NECESSITATE MINOR ALIGNMENT AND GRADE DEVIATION OF THE PROPOSED UTILITIES TO AVOID OBSTACLES, AS ORDERED BY THE ENGINEER.
  - THE CONTRACTOR SHALL OBTAIN AUTHORIZATION FROM THE MANATEE COUNTY UTILITIES DEPARTMENT (MCUD) WASTEWATER COMPLIANCE DIVISION PRIOR TO DEWATERING. COMPLETION OF A CONSTRUCTION DEWATERING AUTHORIZATION TO DISCHARGE APPLICATION IS REQUIRED. FILL OUT FORM AS COMPLETELY AS POSSIBLE AS MISSING INFORMATION DELAYS THE APPROVAL PROCESS.
  - THE MCUD WASTEWATER COMPLIANCE DIVISION WILL DETERMINE WHETHER A LETTER OF APPROVAL, A DISCHARGE AUTHORIZATION, OR A DISCHARGE PERMIT IS REQUIRED.
  - FOR SITES SUSPECTED OF CONTAMINATED GROUNDWATER MANATEE COUNTY WILL REQUIRE AN APPLICANT TO DEMONSTRATE THAT THE DISCHARGE MEETS THE MANATEE COUNTY SEWER USE ORDINANCE.
  - CONTRACTOR SHALL REPLACE ANY DAMAGED VALVE BOXES AND ADJUST THE BOX TO THE FINISHED GRADE. IF ANY RECLAIMED OR WATER MAINS INCLUDING SERVICE LINES ARE DAMAGED DURING CONSTRUCTION, THEY SHALL BE REPLACED FROM THE VALVE TO THE OTHER POINT OF CONNECTION OUTSIDE OF THE ROADWAY PER MANATEE COUNTY'S STANDARDS. SERVICES SHALL BE REPLACED FROM THE CORP STOP TO THE METER.
- TRAFFIC CONTROL NOTES**
- TRAFFIC SHALL BE MAINTAINED IN ACCORDANCE WITH F.D.O.T. LATEST DESIGN STANDARDS NO. 102-600, 102-601, 102-602, 102-604 AND 102-660 DEPENDING ON THE OPERATION BEING PERFORMED.  
  
FOR ALL TWO-LANE, TWO-WAY, WORK OUTSIDE OF SHOULDER UTILIZE INDEX 102-601.  
FOR ALL TWO-LANE, TWO-WAY, WORK ON SHOULDER UTILIZE INDEX 102-602.  
FOR ALL TWO-LANE, TWO-WAY, INTERSECTION WORK UTILIZE INDEX 102-604.  
FOR PEDESTRIAN CONTROL FOR CLOSURE OF SIDEWALK, UTILIZE INDEX 102-660.
  - CONTRACTOR TO COORDINATE WITH FDOT FOR ALL WORK DONE ON A STATE FACILITY.
  - PEDESTRIANS, BICYCLES, AND WHEELCHAIRS:  
AT THE END OF EACH WORKDAY OR WHENEVER THE WORK ZONE BECOMES INACTIVE, ANY DROP-OFF ADJACENT TO A SIDEWALK SHALL BE BACKFILLED AT A SLOPE NOT TO EXCEED 1:4, OR SHALL BE PROTECTED IN ACCORDANCE WITH DESIGN STANDARD 102-600.
  - THE CONTRACTOR IS RESPONSIBLE TO RETIME THE TRAFFIC SIGNALS WITHIN THE PROJECT LIMITS (INCLUDING LIMITS OF WORK ZONE TRAFFIC CONTROL) THAT ARE POTENTIALLY AFFECTED DURING VARIOUS PHASES OF CONSTRUCTION. COORDINATE ALL SIGNAL RETIME EFFORTS MUKUNDA GOPALAKRISHNA, P.E., PTCE, COUNTY TRAFFIC ENGINEER, AT 941-749-3500, EXT. 7813.
  - CONTRACTOR TO MAINTAIN VEHICLE DETECTION IN OPERATION FOR LANES THAT WILL REMAIN OPEN. CONTRACTOR TO COORDINATE ALL VEHICLE DETECTION ISSUES WITH AARON BURKETT OF MANATEE COUNTY AT 941-708-7509, OR AARON.BURKETT@MYMANATEE.ORG
  - MAINTENANCE OF TRAFFIC AND ANY SIGNAL RETIMING WILL BE THE RESPONSIBILITY OF THE CONTRACTOR.
  - ANY SIGNAL RETIMING REQUIRED FOR THE INTERSECTIONS IMPACTED BY THE PROJECT WILL BE THE RESPONSIBILITY OF THE CONTRACTOR. SIGNAL TIMING MODIFICATIONS TO BE SUBMITTED TO MANATEE COUNTY TRAFFIC DESIGN. ATTENTION MR. MUKUNDA GOPALAKRISHNA FOR REVIEW AND APPROVAL AT LEAST 15 WORKING DAYS BEFORE PROPOSED CHANGES. THIS DOES NOT GOVERN EMERGENCY SITUATIONS, PENDING THE APPROVAL OF THE ENGINEER.
  - A DETAILED MAINTENANCE OF TRAFFIC PLANS ARE TO BE SUBMITTED TO MANATEE COUNTY AND THE ENGINEER, BY THE CONTRACTOR, FOR REVIEW AND APPROVAL A MINIMUM OF 5 WORKING DAYS PRIOR TO PROPOSED IMPLEMENTATION OF PARTIAL OR FULL DAY CLOSURE, OR A MINIMUM OF 8 WORKING DAYS PRIOR TO PROPOSED IMPLEMENTATION OF A MULTI-DAY CLOSURE.
  - PRIOR TO COMMENCING WORK, CONTRACTOR SHALL RECEIVE APPROVAL FOR A COUNTY RIGHT-OF-WAY PERMIT. CONTACT MATT MEUCCHI AT MATT.MEUCCHI@MYMANATEE.ORG OR 941-708-7450 EXT 7342 FOR PERMIT APPLICATION. PERMIT FEES WILL BE WAIVED FOR ALL COUNTY CAPITAL IMPROVEMENT PROJECTS.
  - THE CONTRACTOR SHALL MAINTAIN TEMPORARY VEHICLE DETECTION ON ALL APPROACHES THROUGHOUT CONSTRUCTION UNTIL MANATEE COUNTY ACCEPTS THE PROJECT. ANY DAMAGE TO THE EXISTING DETECTION SYSTEM AT AN INTERSECTION MUST BE RESTORED WITHIN TWENTY-FOUR (24) HOURS AT NO ADDITIONAL COST TO THE COUNTY. MANATEE COUNTY TRAFFIC OPERATIONS DIVISION WILL ASSIST AS NEEDED WHENEVER POSSIBLE.
  - THE PRIME CONTRACTOR SHALL BE RESPONSIBLE FOR THE SIGNAL MAINTENANCE, TIMING AND OPERATION OF ANY AND ALL SIGNALS AND SIGNAGE FROM THE COMMENCEMENT TO THE ACCEPTANCE OF THE PROJECT (I.E.: EXISTING LOOPS CUT, SYSTEM COMMUNICATION TERMINATED, LANE OR PAVEMENT MODIFICATIONS, PEDESTRIAN MODIFICATIONS, TRAFFIC SIGNAL SCHOOL FLASHER, WARNING FLASHER, ROADWAY LIGHTING, COUNT STATIONS, AND ANY OTHER TRAFFIC RELATED DEVICE LOCATED WITHIN THE CONSTRUCTION ZONE). MANATEE COUNTY WILL ASSIST IN PROVIDING EXISTING SYSTEM TIMES WHEN POSSIBLE.

No.	REVISIONS	DATE	BY		



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WWW.KIMLEY-HORN.COM    REGISTRY NO. 35106

KHA PROJECT  
148400067

DATE  
FEB 2022

SCALE    AS SHOWN

DESIGNED BY    MAS

DRAWN BY        GMB

CHECKED BY    SNR



**BAYSHORE YACHT BASIN FORCE MAIN  
AND LIFT STATION REPLACEMENT**

MANATEE COUNTY

LICENSED PROFESSIONAL

MICHAEL A. SEMAGO, P.E.

FL LICENSE NUMBER  
87501

FL DATE:

SHEET NUMBER

**DRAWING INDEX & GENERAL  
NOTES**

**G-2**



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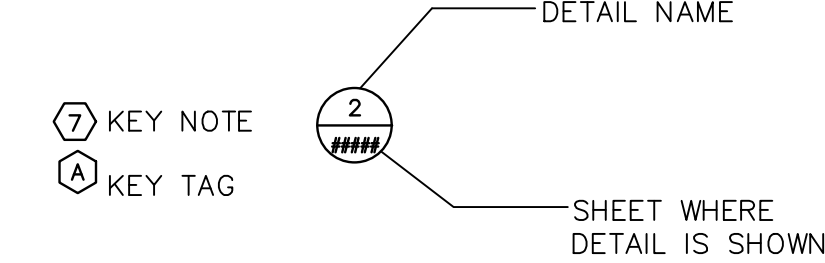
KIMLEY HORN LEGEND

EX. RECLAIMED WATER	———X RCW———X RCW———X RCW———
EX. FORCE MAIN	——X-FM———X-FM———X-FM———X-FM———
EX. POTABLE WATER	———X WT———X WT———X WT———
EX. SANITARY SEWER	———X SS———X SS———X SS———X SS———
EX. STORM	——— ——— ——— ——— ——— ——— ——— ——— ———
EX. BURIED TELEPHONE/FIBER	——X BT———X BT———X BT———X BT———
EX. BURIED ELECTRIC	——X BE———X BE———X BE———X BE———
EX. GAS	———X-GAS———X-GAS———
EX. OVERHEAD ELECTRIC	——X OE———X OE———X OE———X OE———

ABBREVIATIONS

ARV	—	AIR RELEASE VALVE
BT	—	BURIED TELEPHONE
DIP	—	DUCTILE IRON PIPE
EX.	—	EXISTING
FM	—	FORCE MAIN
LF	—	LINEAR FEET
PVC	—	POLYVINYL CHLORIDE
RJ	—	RESTRAINED JOINT
R/W	—	RIGHT-OF-WAY
RCP	—	REINFORCED CONCRETE PIPE
RCW	—	RECLAIMED WATER MAIN
SS	—	SANITARY SEWER

PLAN CALLOUT LEGEND



GENERAL NOTES

1. THE FOLLOWING MANATEE COUNTY VERTICAL CONTROL MONUMENT WAS RECOVERED AND UTILIZED FOR THE ELEVATIONS INDICATED HEREIN:  
"2015 136 88 02" NAVD 1988 ELEVATION 8.57'.
2. THIS SURVEY IS REFERENCED TO A GRID PROJECTION OF THE FLORIDA STATE PLANE COORDINATE SYSTEM (WEST ZONE NAD 1983/2011 ADJUSTMENT).
3. THIS IS NOT A BOUNDARY SURVEY. TITLE WORK WAS NOT PROVIDED.
4. THIS SURVEY IS SUBJECT TO PERTINENT EASEMENTS, RIGHTS-OF-WAY AND RESTRICTIONS OF RECORD, IF ANY.
5. THIS SURVEY DRAWING WAS PREPARED FOR THE EXCLUSIVE USE OF THE PARTY OR PARTIES CERTIFIED TO BELOW FOR THE EXPRESS PURPOSE STATED HEREON AND/OR CONTAINED IN THE CONTRACT BETWEEN HYATT SURVEY SERVICES, INC. AND THE CLIENT FOR THIS PROJECT. COPYING, DISTRIBUTING AND/OR USING THIS DRAWING, IN WHOLE OR IN PART FOR ANY PURPOSE OTHER THAN ORIGINALLY INTENDED WITHOUT WRITTEN CONSENT FROM HYATT SURVEY SERVICES, INC. IS STRICTLY PROHIBITED AND RENDERS THE SURVEYOR'S CERTIFICATION, SIGNATURE AND SEAL NULL AND VOID. ANY QUESTIONS CONCERNING THE CONTENT OR PURPOSE OF THIS DRAWING SHOULD BE DIRECTED TO HYATT SURVEY SERVICES, INC.

LEGEND

● SITE CONTROL POINT	PP	CONCRETE UTILITY POLE	▣ UTILITY RISER	✎ PALM
• IRON ROD FOUND	◇	WOOD UTILITY POLE	• BOLLARD	✎ PINE
■ CONCRETE MONUMENT FOUND	⌘	GUY WIRE	○ UTILITY HANDHOLE	✎ OAK
○ IRON PIPE FOUND	●	GAS WITNESS	✎ LIGHT POLE	✎ TREE
• NAIL W/ DISC FOUND	△	SIGN	✎ TRAFFIC SIGNAL POLE	
R/W RIGHT-OF-WAY	□	WATER METER	✎ PED CROSSWALK POLE	
BM BENCHMARK	⌘	WATER VALVE	▣ UTILITY CABINET/BOX	
	⌘	BACKFLOW PREVENTER	■ COMMUNICATION WITNESS	
	✎	FIRE HYDRANT	• SEWER VALVE	
	●	SANITARY MANHOLE	⌘ RECLAIM VALVE	
	●	STORM MANHOLE	• ANTENNA	
	●	CLEANOUT	▣ CONTROL PANEL	
	●	AIR RELEASE VALVE		
	⌘	MAILBOX		

SITE CONTROL

DESIGNATION	NORTHING	EASTING	ELEVATION	DESCRIPTION
BM #1	1123317.236	465516.919	9.06'	IR (LB 7203)
BM #2	1122639.879	465515.342	7.48'	IR (LB 7203)
BM #3	1122606.551	466255.442	5.74'	IR (LB 7203)

VVH TABLE


VVH NUMBER	UTILITY	SIZE	MATERIAL	DEPTH OF COVER	COLOR	SURFACE TYPE	TRACER FOUND
1	FORCE MAIN	10"	PVC	2.90'	GREEN	GRASS	PLASTIC TAPE
2	GAS	2"	PVC	3.05'	YELLOW	GRASS	NONE
3	NO UTILITY FOUND	—	—	—	—	GRASS	—
4	BURIED TRAFFIC POWER	(2) 3"	PVC	2.80'	GRAY	GRASS	NONE
5	FORCE MAIN	10"	PVC	4.38'	GREEN	GRASS	NONE
6	WATER MAIN	6"	DUCTILE IRON	2.65'	GRAY	GRASS	NONE
7	NO UTILITY FOUND	—	—	—	—	GRASS	—
8	FORCE MAIN	10"	PVC	3.23'	GREEN	GRASS	PLASTIC TAPE
9	BURIED ELECTRIC	4"	PVC	2.35'	GRAY	GRASS	NONE
10	FORCE MAIN	10"	PVC	3.08'	GREEN	GRASS	PLASTIC TAPE
11	BURIED ELECTRIC	4"	PVC	2.66'	GRAY	GRASS	NONE

No.	REVISIONS	DATE	BY



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KHA PROJECT 148400067
DATE FEB 2022
SCALE AS SHOWN
DESIGNED BY MAS
DRAWN BY GMB
CHECKED BY SNR



**BAYSHORE YACHT BASIN FORCE MAIN  
AND LIFT STATION REPLACEMENT**

MANATEE COUNTY

LICENSED PROFESSIONAL

MICHAEL A. SEMAGO, P.E.

FL LICENSE NUMBER  
87501


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SURVEY & SUE NOTES

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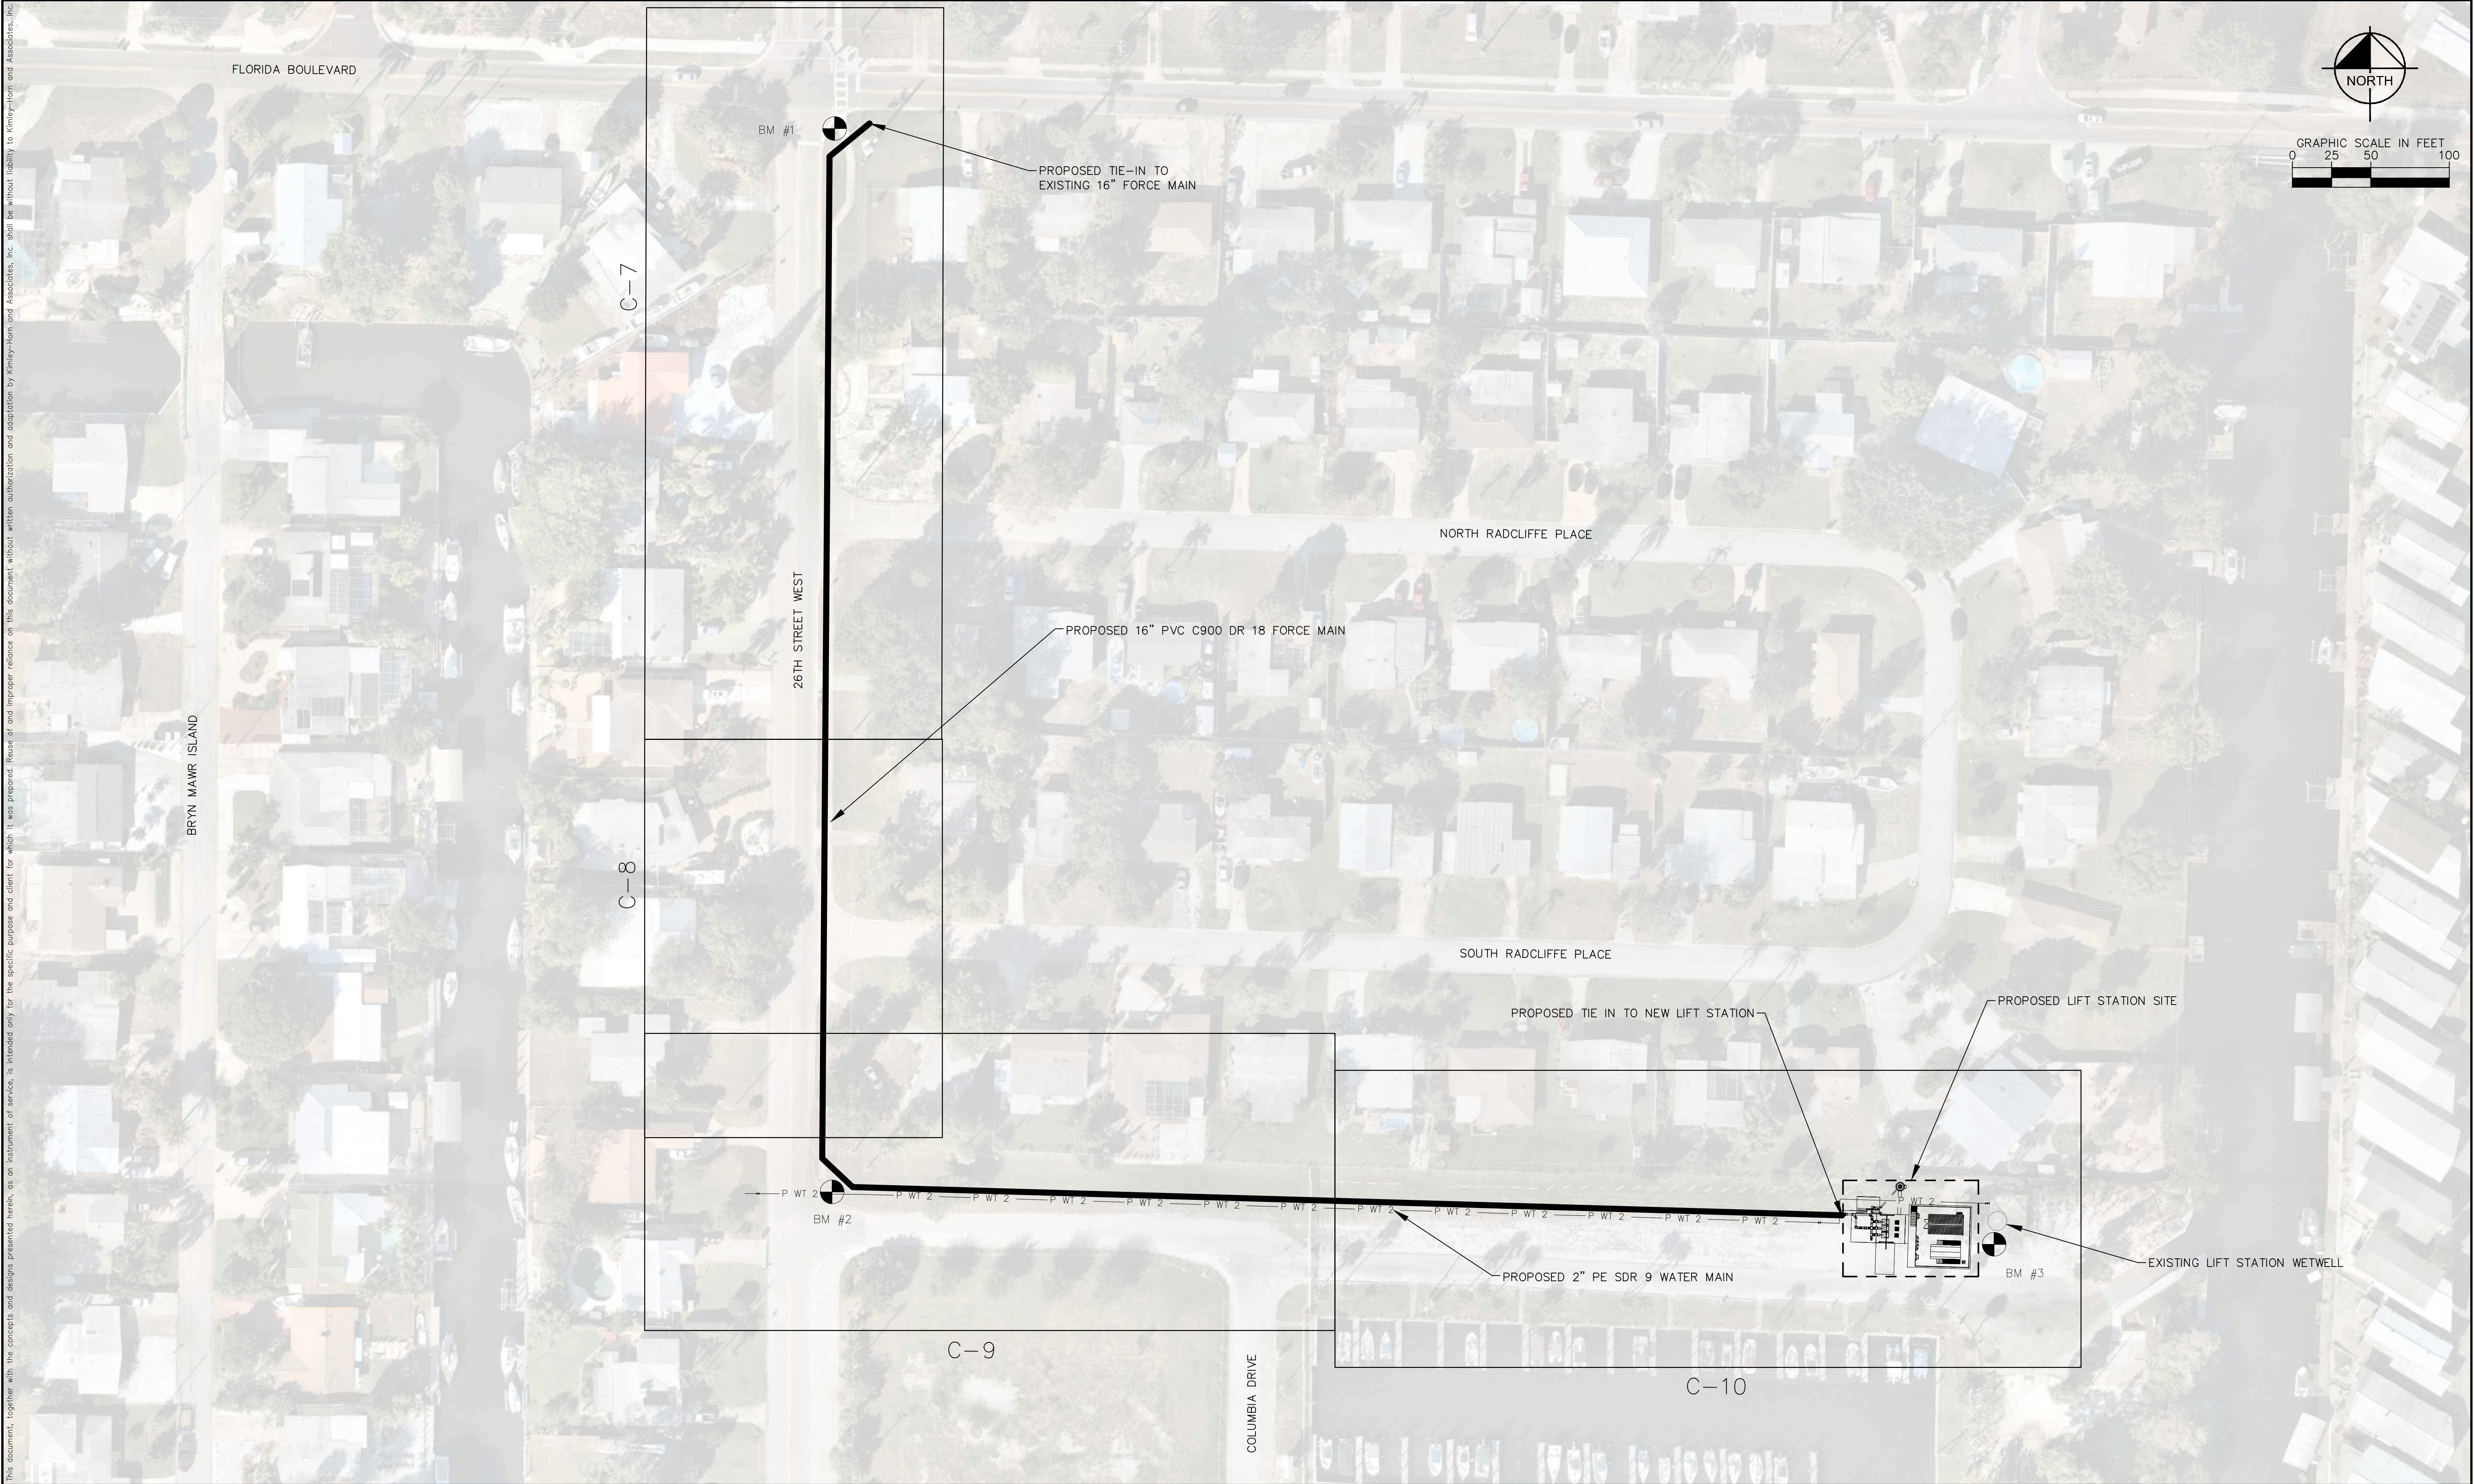
G-3





G-4

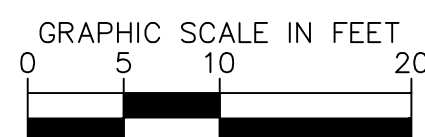




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**BAYSHORE YACHT BASIN FORCE MAIN  
AND LIFT STATION REPLACEMENT**

MANATEE COUNTY

LICENSED PROFESSIONAL
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FL LICENSE NUMBER 87501
FL DATE:

KEY SHEET

SHEET NUMBER
G-5



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**GROUNDWATER / DEWATERING NOTE:**  
THE PRESENCE OF GROUNDWATER SHOULD BE ANTICIPATED ON THIS PROJECT. CONTRACTOR'S BID SHALL INCLUDE CONSIDERATION FOR THIS ISSUE. WHEN PERFORMING GRADING OPERATIONS DURING PERIODS OF WET WEATHER, PROVIDE ADEQUATE DEWATERING, DRAINAGE AND GROUND WATER MANAGEMENT TO CONTROL MOISTURE OF SOILS.



No.	REVISIONS	DATE	BY

# Kimley»Horn

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DATE  
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DRAWN BY GMB

CHECKED BY SNR

## BAYSHORE YACHT BASIN FORCE MAIN AND LIFT STATION REPLACEMENT

MANATEE COUNTY

LICENSED PROFESSIONAL

MICHAEL A. SEMAGO, P.E.

FL LICENSE NUMBER  
87501


FL DATE:

# LIFT STATION EXISTING SITE PLAN

SHEET NUMBER

# C-1



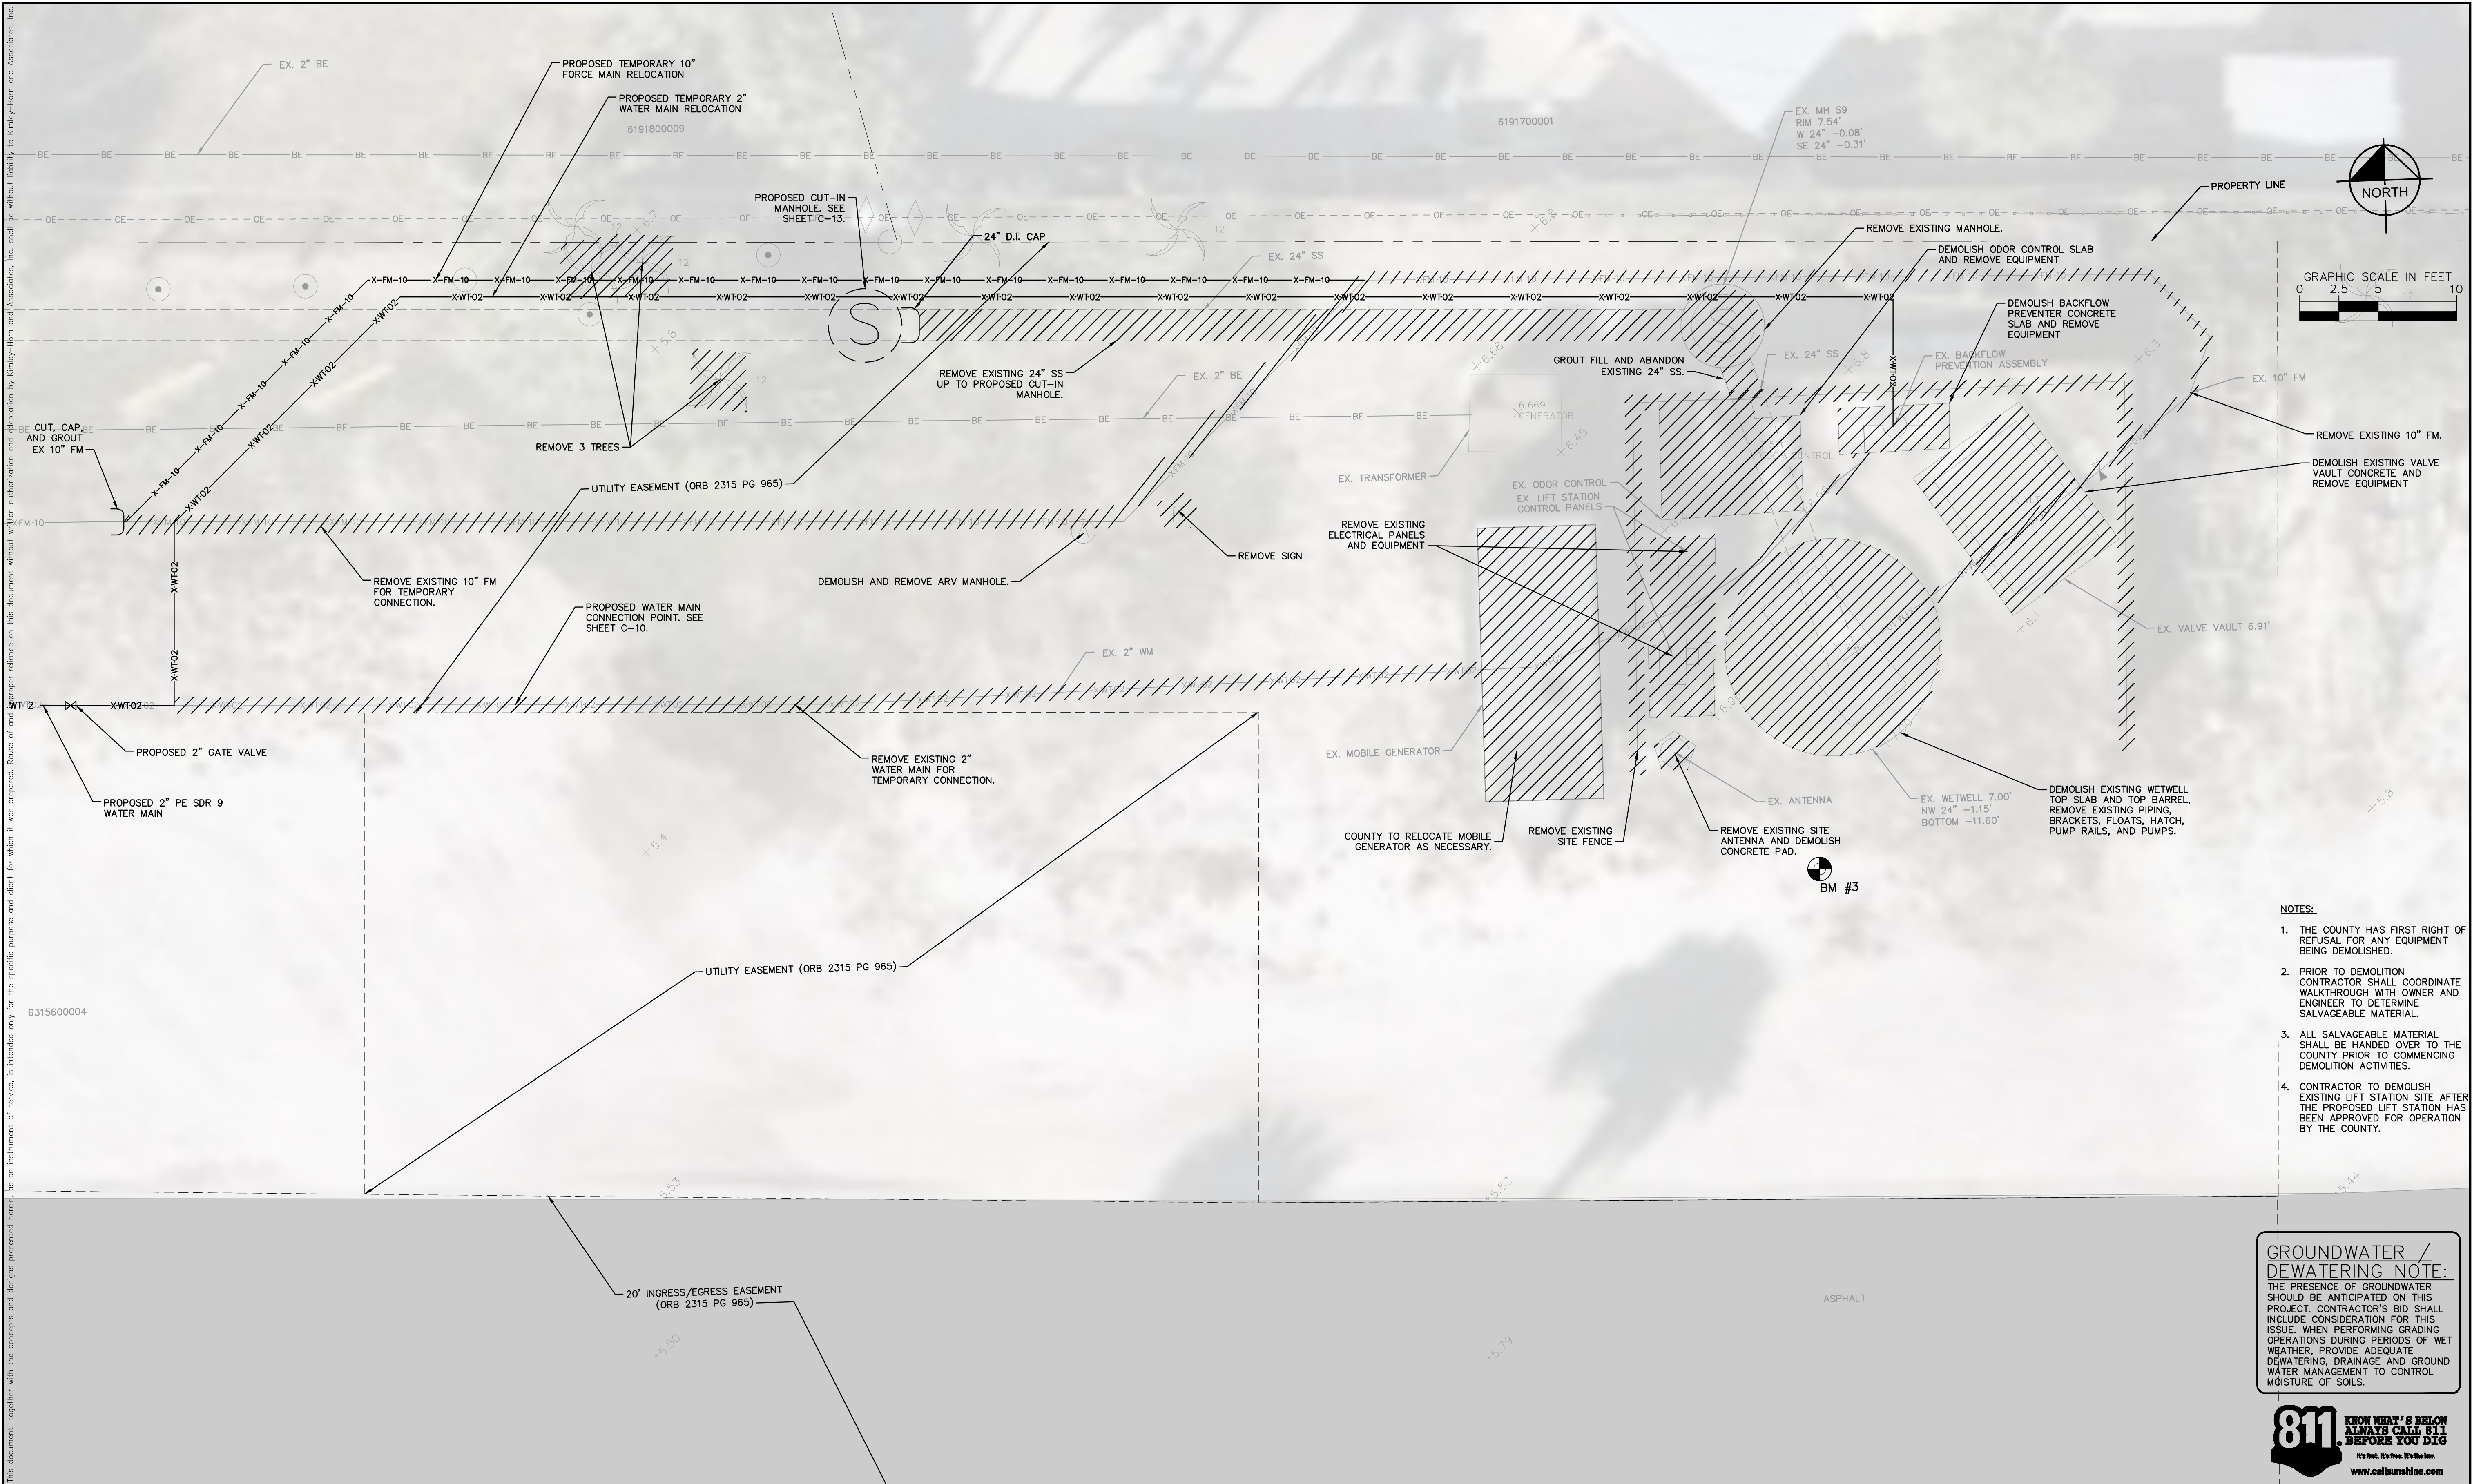

- NOTES:
1. THE COUNTY HAS FIRST RIGHT OF REFUSAL FOR ANY EQUIPMENT BEING DEMOLISHED.
  2. PRIOR TO DEMOLITION CONTRACTOR SHALL COORDINATE WALKTHROUGH WITH OWNER AND ENGINEER TO DETERMINE SALVAGEABLE MATERIAL.
  3. ALL SALVAGEABLE MATERIAL SHALL BE HANDED OVER TO THE COUNTY PRIOR TO COMMENCING DEMOLITION ACTIVITIES.
  4. CONTRACTOR TO DEMOLISH EXISTING LIFT STATION SITE AFTER THE PROPOSED LIFT STATION HAS BEEN APPROVED FOR OPERATION BY THE COUNTY.

**GROUNDWATER / DEWATERING NOTE:**  
THE PRESENCE OF GROUNDWATER SHOULD BE ANTICIPATED ON THIS PROJECT. CONTRACTOR'S BID SHALL INCLUDE CONSIDERATION FOR THIS ISSUE. WHEN PERFORMING GRADING OPERATIONS DURING PERIODS OF WET WEATHER, PROVIDE ADEQUATE DEWATERING, DRAINAGE AND GROUND WATER MANAGEMENT TO CONTROL MOISTURE OF SOILS.



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DESIGNED BY	MAS
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**BAYSHORE YACHT BASIN FORCE MAIN AND LIFT STATION REPLACEMENT**

MANATEE COUNTY

LICENSED PROFESSIONAL

MICHAEL A. SEMAGO, P.E.

FL LICENSE NUMBER 87501

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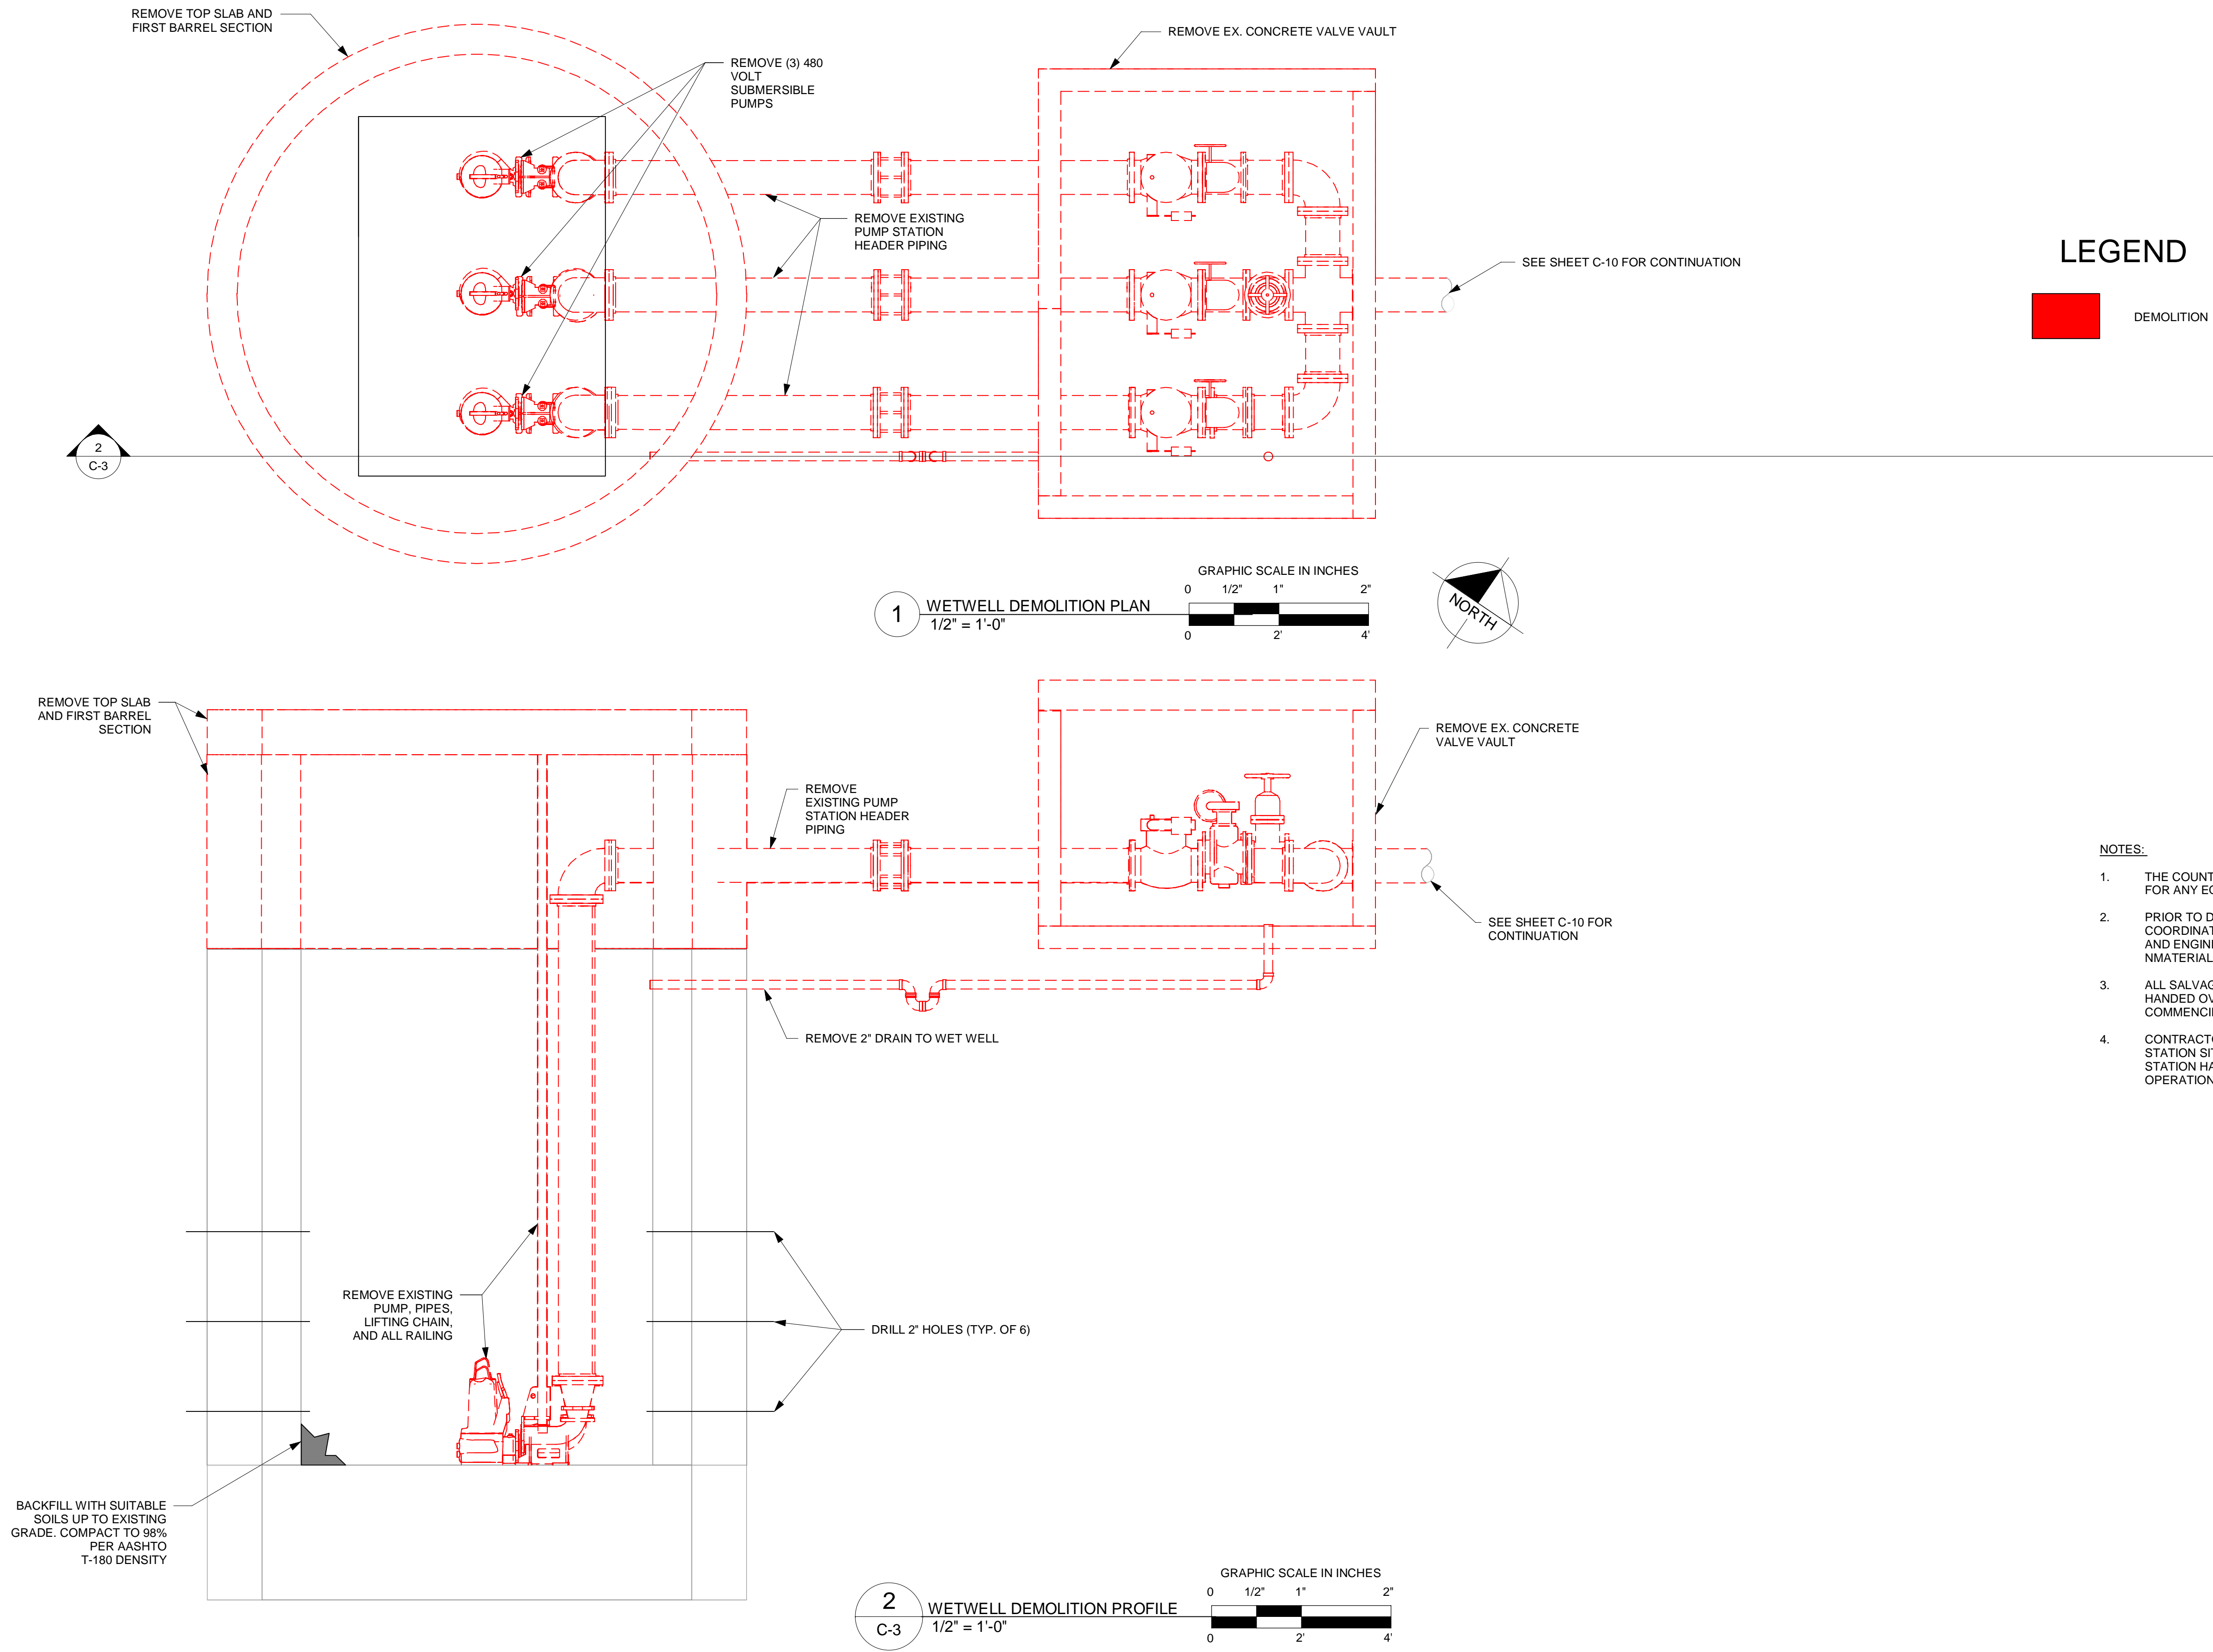
**LIFT STATION DEMOLITION PLAN**

SHEET NUMBER

**C-2**



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NOTES:

1. THE COUNTY HAS FIRST RIGHT OF REFUSAL FOR ANY EQUIPMENT BEING DEMOLISHED.
2. PRIOR TO DEMOLITION, CONTRACTOR SHALL COORDINATE WALKTHROUGH WITH OWNER AND ENGINEER TO DETERMINE SALVAGEABLE MATERIAL.
3. ALL SALVAGEABLE MATERIAL SHALL BE HANDED OVER TO THE COUNTY PRIOR TO COMMENCING DEMOLITION ACTIVITIES.
4. CONTRACTOR TO DEMOLISH EXISTING LIFT STATION SITE AFTER THE PROPOSED LIFT STATION HAS BEEN APPROVED FOR OPERATION BY THE COUNTY.

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DRAWN BY: RLL
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BAYSHORE YACHT BASIN FORCE MAIN  
AND LIFT STATION REPLACEMENT  
MANATEE COUNTY FL


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FL LICENSE NUMBER 87501
DATE:

EXISTING WETWELL DEMOLITION PLAN

SHEET NUMBER  
C-3



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THE PRESENCE OF GROUNDWATER SHOULD BE ANTICIPATED ON THIS PROJECT. CONTRACTOR'S BID SHALL INCLUDE CONSIDERATION FOR THIS ISSUE. WHEN PERFORMING GRADING OPERATIONS DURING PERIODS OF WET WEATHER, PROVIDE ADEQUATE DEWATERING, DRAINAGE AND GROUND WATER MANAGEMENT TO CONTROL MOISTURE OF SOILS.

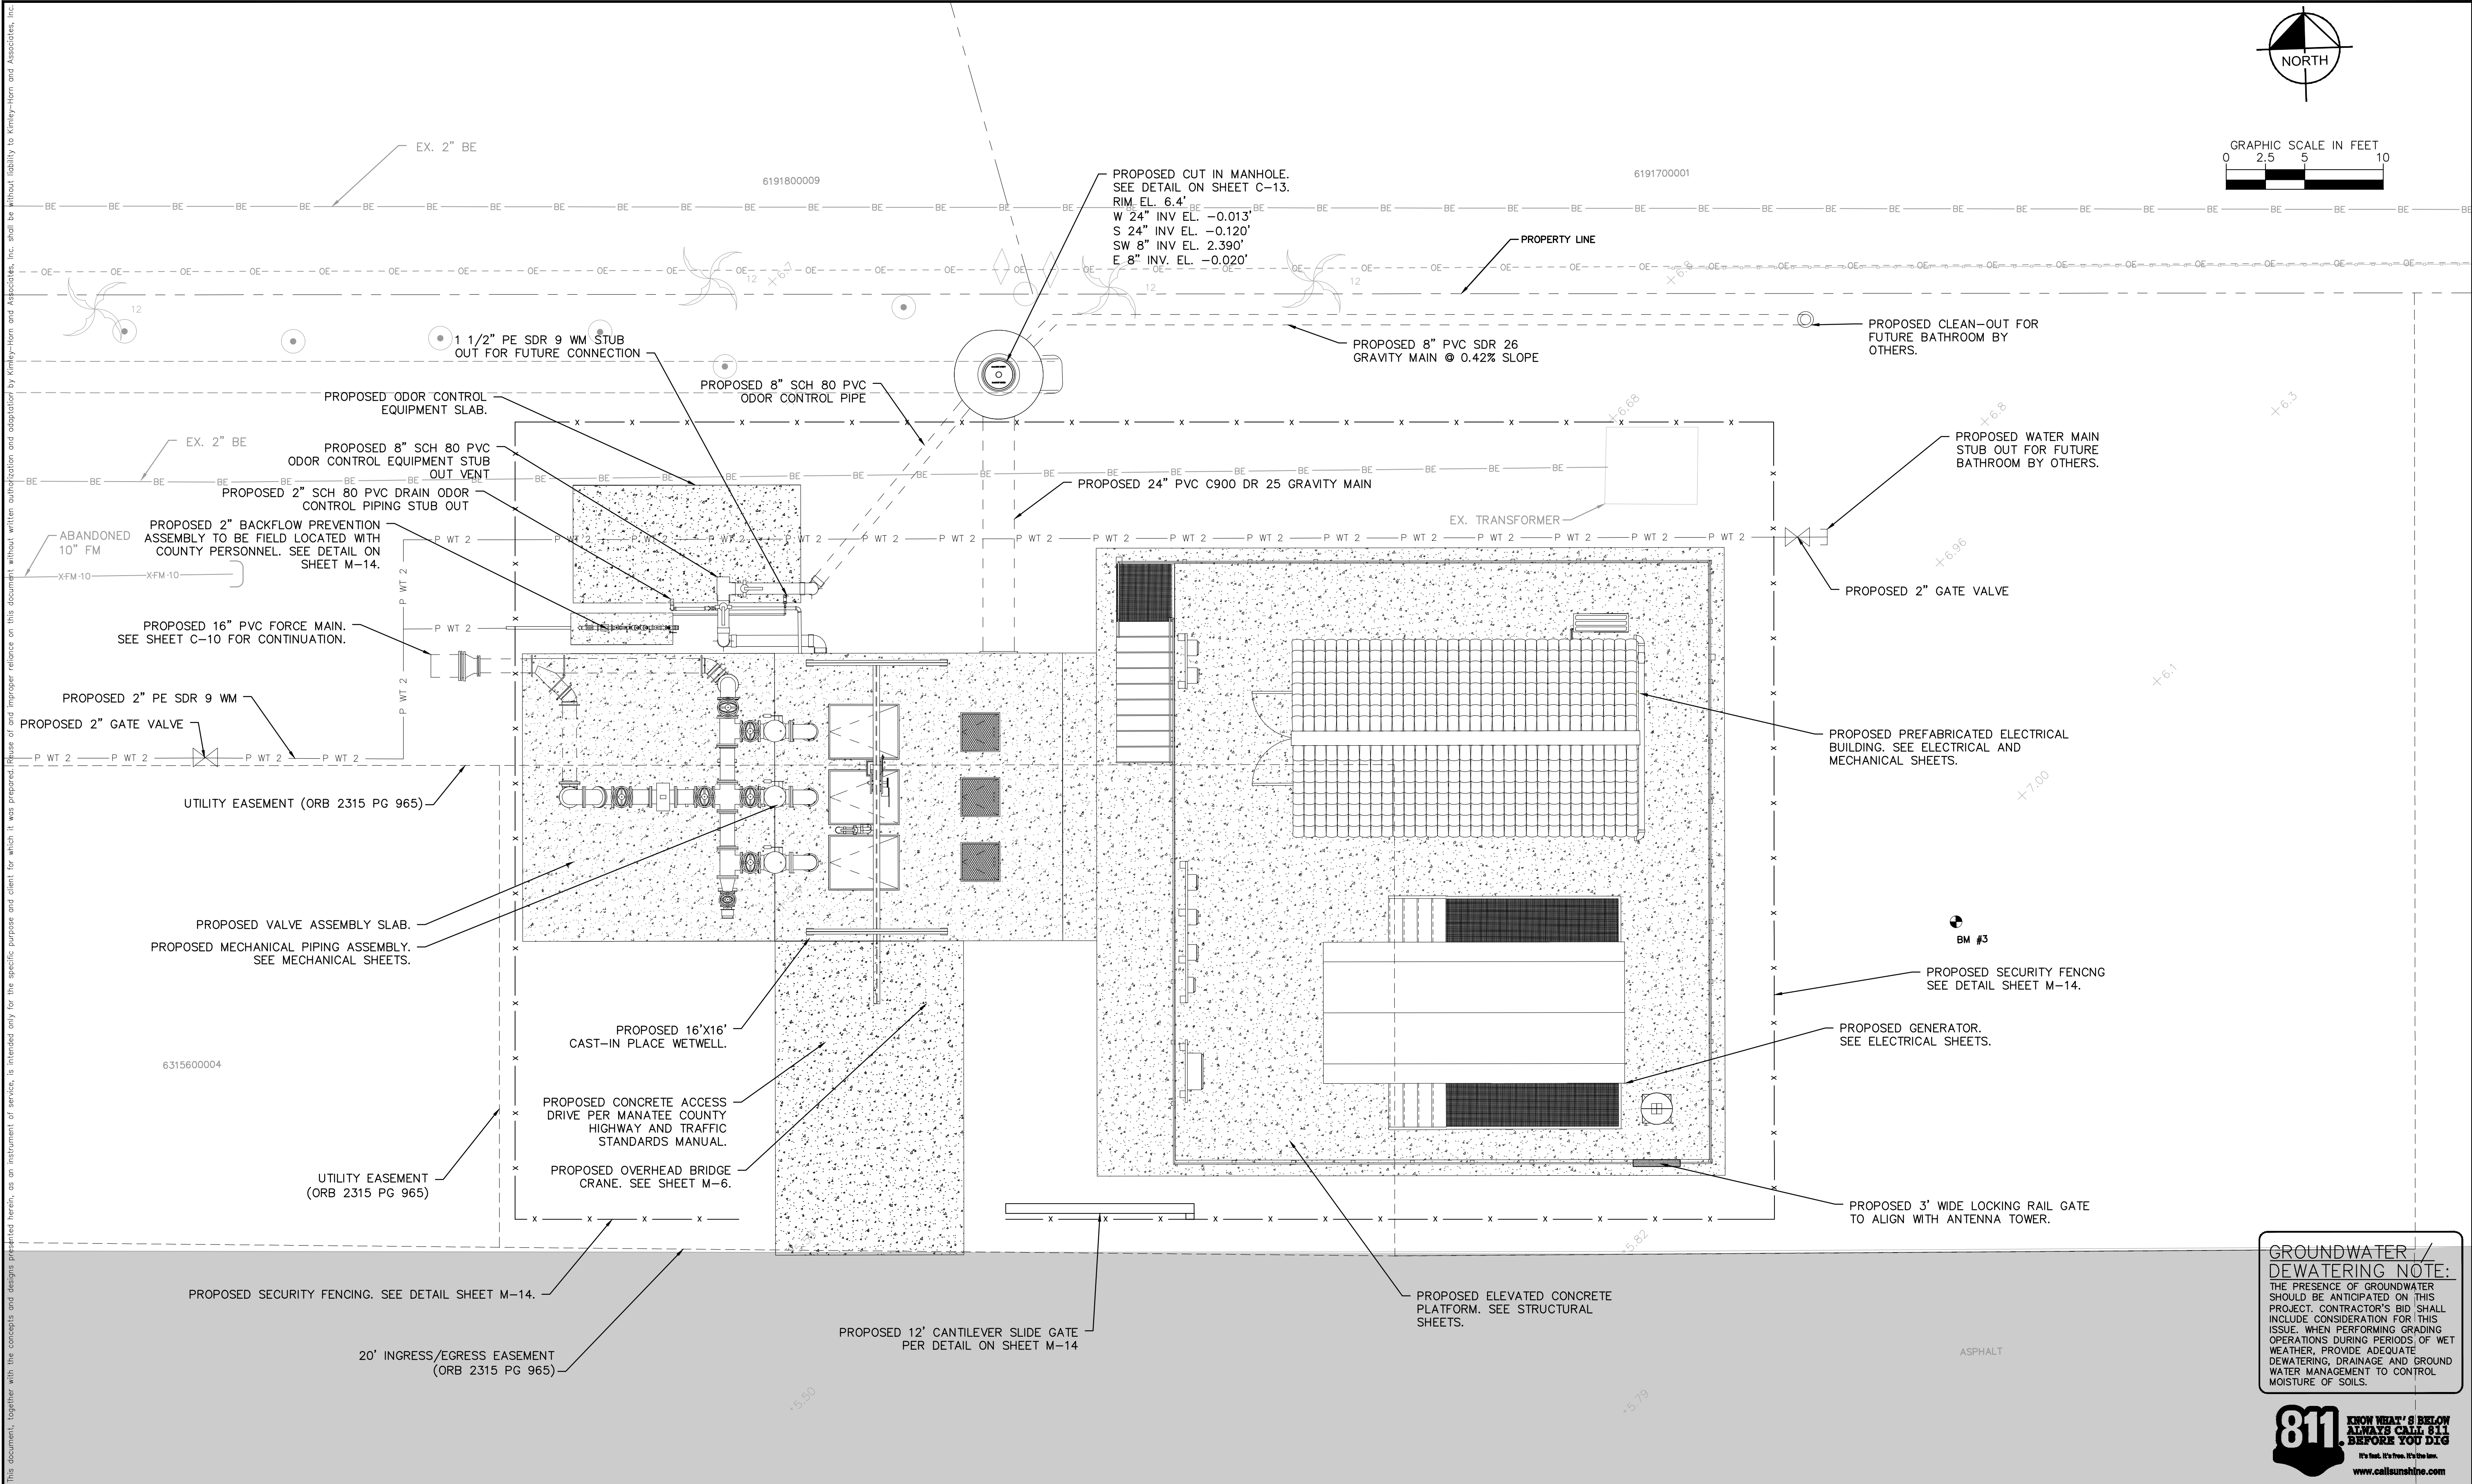

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**BAYSHORE YACHT BASIN FORCE MAIN  
AND LIFT STATION REPLACEMENT**

MANATEE COUNTY


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**LIFT STATION SITE PLAN**

SHEET NUMBER  
  
**C-4**



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DIMENSIONAL CONTROL TABLE		
POINT NUMBER	NORTHING	EASTING
1	1122592.0101	466200.2787
2	1122590.8399	466240.2616
3	1122630.8227	466241.4317
4	1122631.9928	466201.4488
5	1122625.3943	466199.0711
6	1122607.0949	466198.5401
7	1122607.2228	466192.2130
8	1122607.6007	466180.2056
9	1122625.9263	466180.7374
10	1122626.3922	466164.6813
11	1122608.0692	466164.1496
12	1122629.1033	466182.5400
13	1122629.5275	466168.0462
14	1122636.8026	466168.2591
15	1122636.6001	466182.7594
16	1122643.2353	466195.5502
17	1122589.9592	466177.3739
18	1122587.9388	466179.6484
19	1122587.2606	466191.6338
20	1122589.4422	466194.3660
21	1122587.9534	466243.3012
22	1122638.7191	466244.7964
23	1122641.1566	466164.6767
24	1122590.3925	466163.1316

GROUNDWATER /  
DEWATERING NOTE:

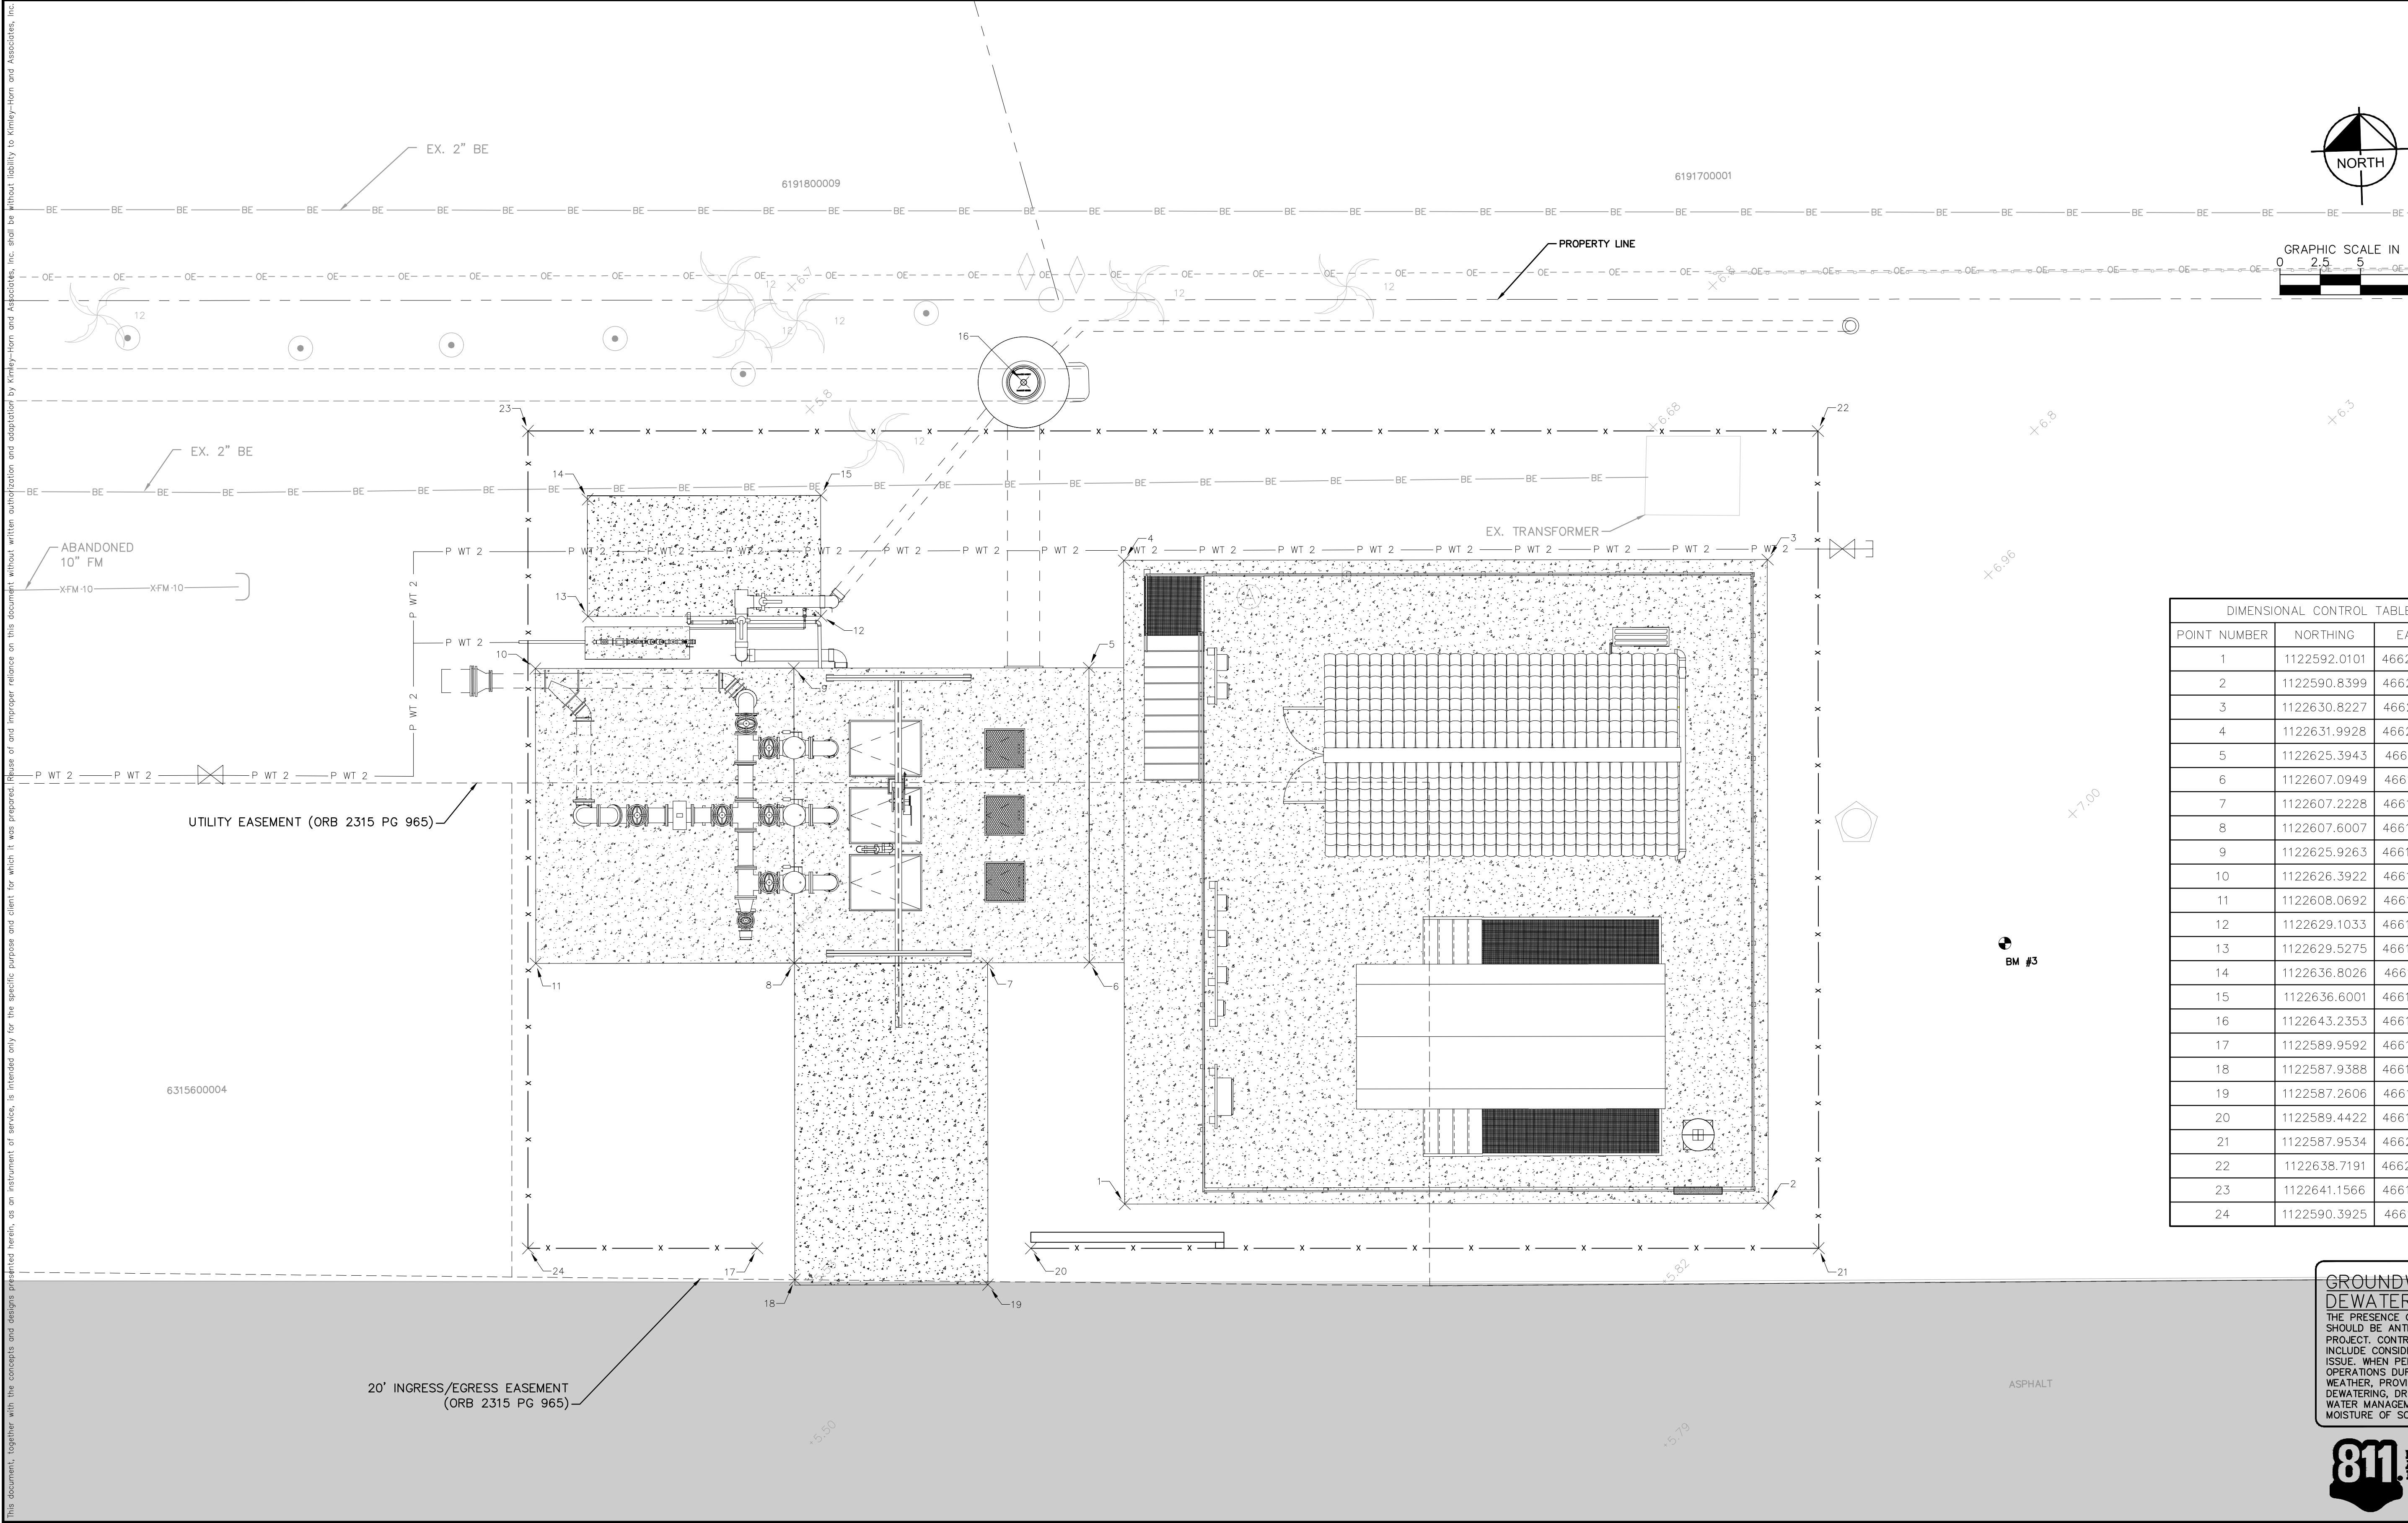THE PRESENCE OF GROUNDWATER SHOULD BE ANTICIPATED ON THIS PROJECT. CONTRACTOR'S BID SHALL INCLUDE CONSIDERATION FOR THIS ISSUE. WHEN PERFORMING GRADING OPERATIONS DURING PERIODS OF WET WEATHER, PROVIDE ADEQUATE DEWATERING, DRAINAGE AND GROUND WATER MANAGEMENT TO CONTROL MOISTURE OF SOILS.

811

KNOW WHAT'S BELOW  
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100 2ND AVENUE SOUTH, SUITE 105-N, ST. PETERSBURG, FL 33701  
PHONE: 727-547-3999  
WWW.KIMLEY-HORN.COM    REGISTRY NO. 35106

KHA PROJECT  
148400067

DATE  
FEB 2022

SCALE AS SHOWN

DESIGNED BY MAS

DRAWN BY GMB

CHECKED BY SNR

Manatee  
County  
FLORIDA

BAYSHORE YACHT BASIN FORCE MAIN  
AND LIFT STATION REPLACEMENT

MANATEE COUNTY

LICENSED PROFESSIONAL

MICHAEL A. SEMAGO, P.E.

FL LICENSE NUMBER  
87501

FL DATE:


DIMENSIONAL CONTROL PLAN

SHEET NUMBER

C-5




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**GROUNDWATER /  
DEWATERING NOTE:**  
THE PRESENCE OF GROUNDWATER  
SHOULD BE ANTICIPATED ON THIS  
PROJECT. CONTRACTOR'S BID SHALL  
INCLUDE CONSIDERATION FOR THIS  
ISSUE. WHEN PERFORMING GRADING  
OPERATIONS DURING PERIODS OF WET  
WEATHER, PROVIDE ADEQUATE  
DEWATERING, DRAINAGE AND GROUND  
WATER MANAGEMENT TO CONTROL  
MOISTURE OF SOILS.

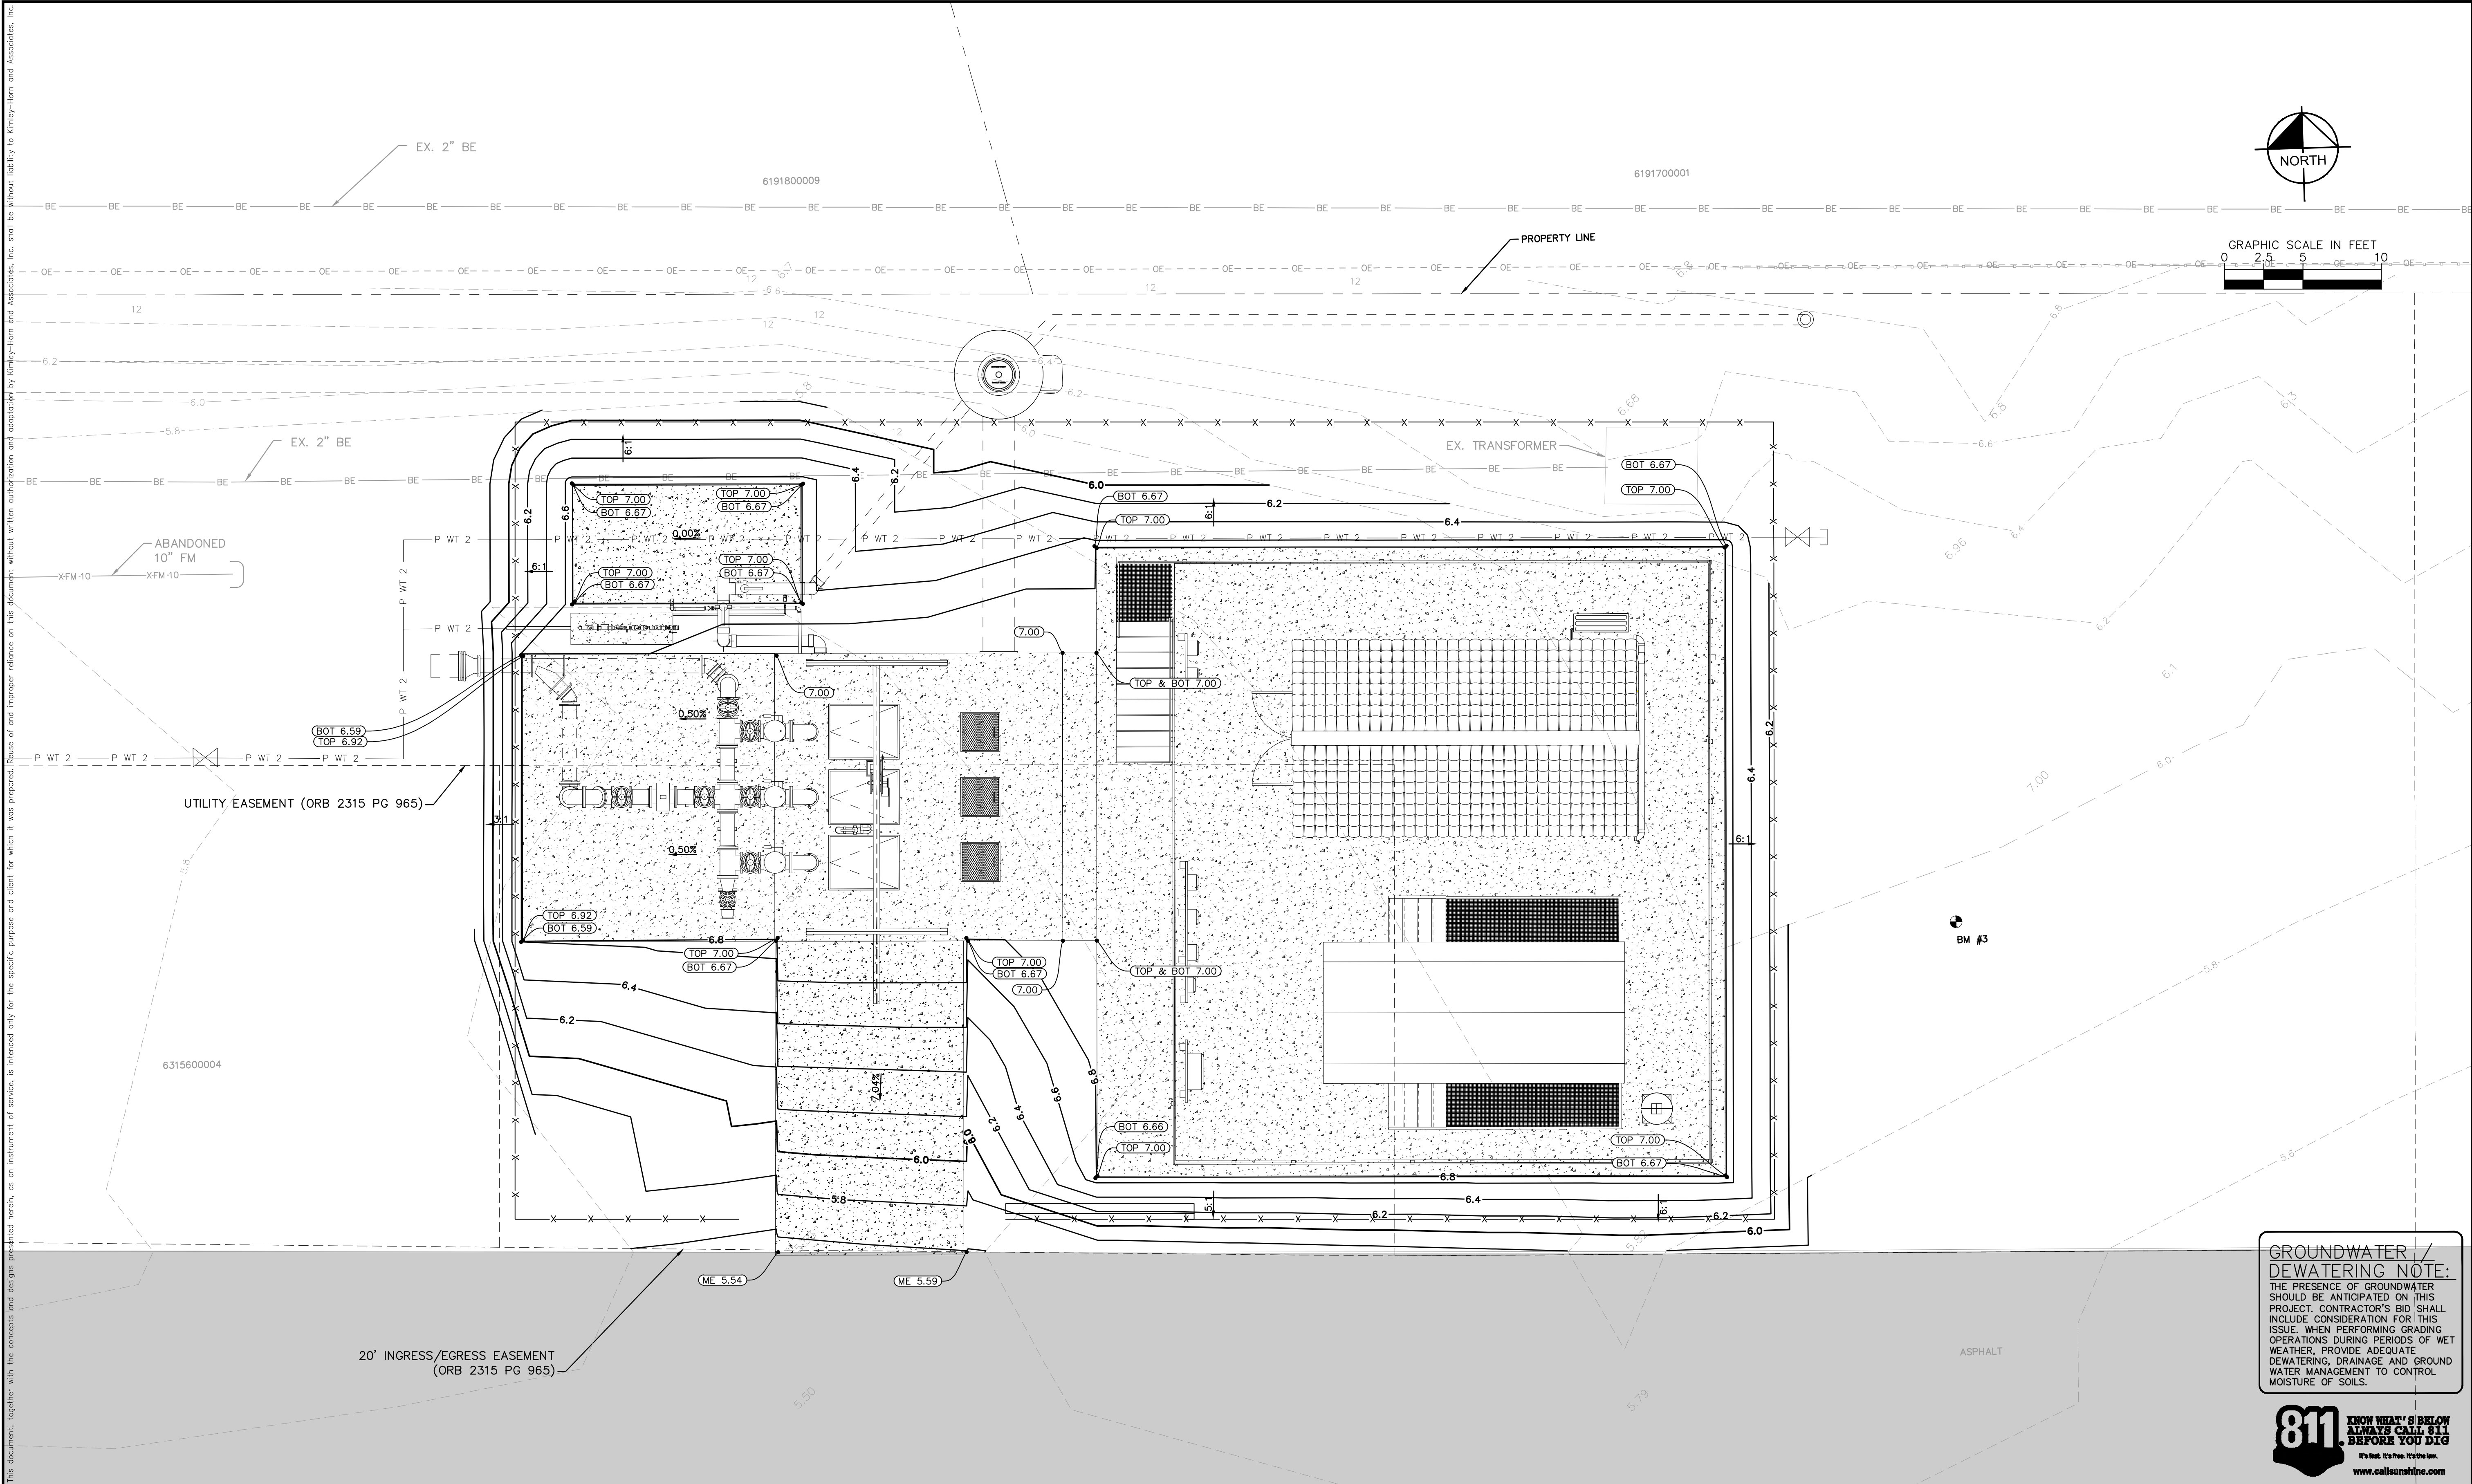


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**BAYSHORE YACHT BASIN FORCE MAIN  
AND LIFT STATION REPLACEMENT**


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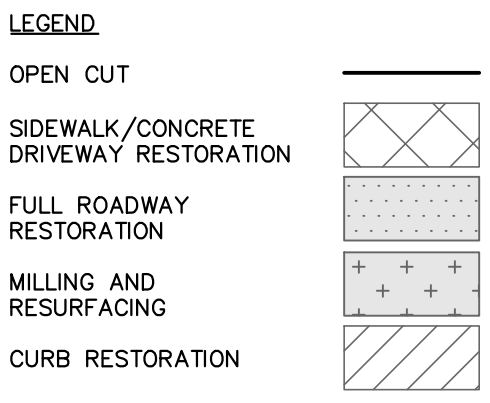
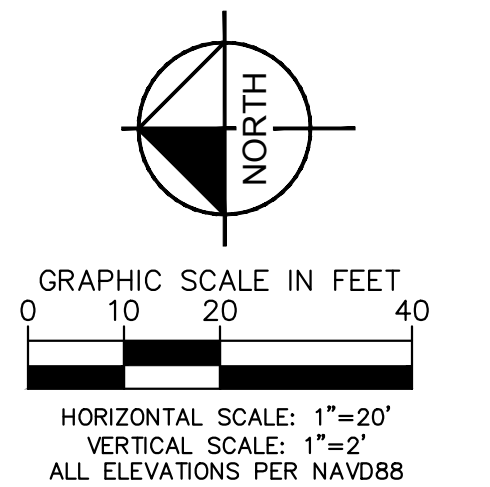
**GRADING PLAN**

SHEET NUMBER  
  
**C-6**





MATCH LINE STA 4+50  
SEE SHEET C-8

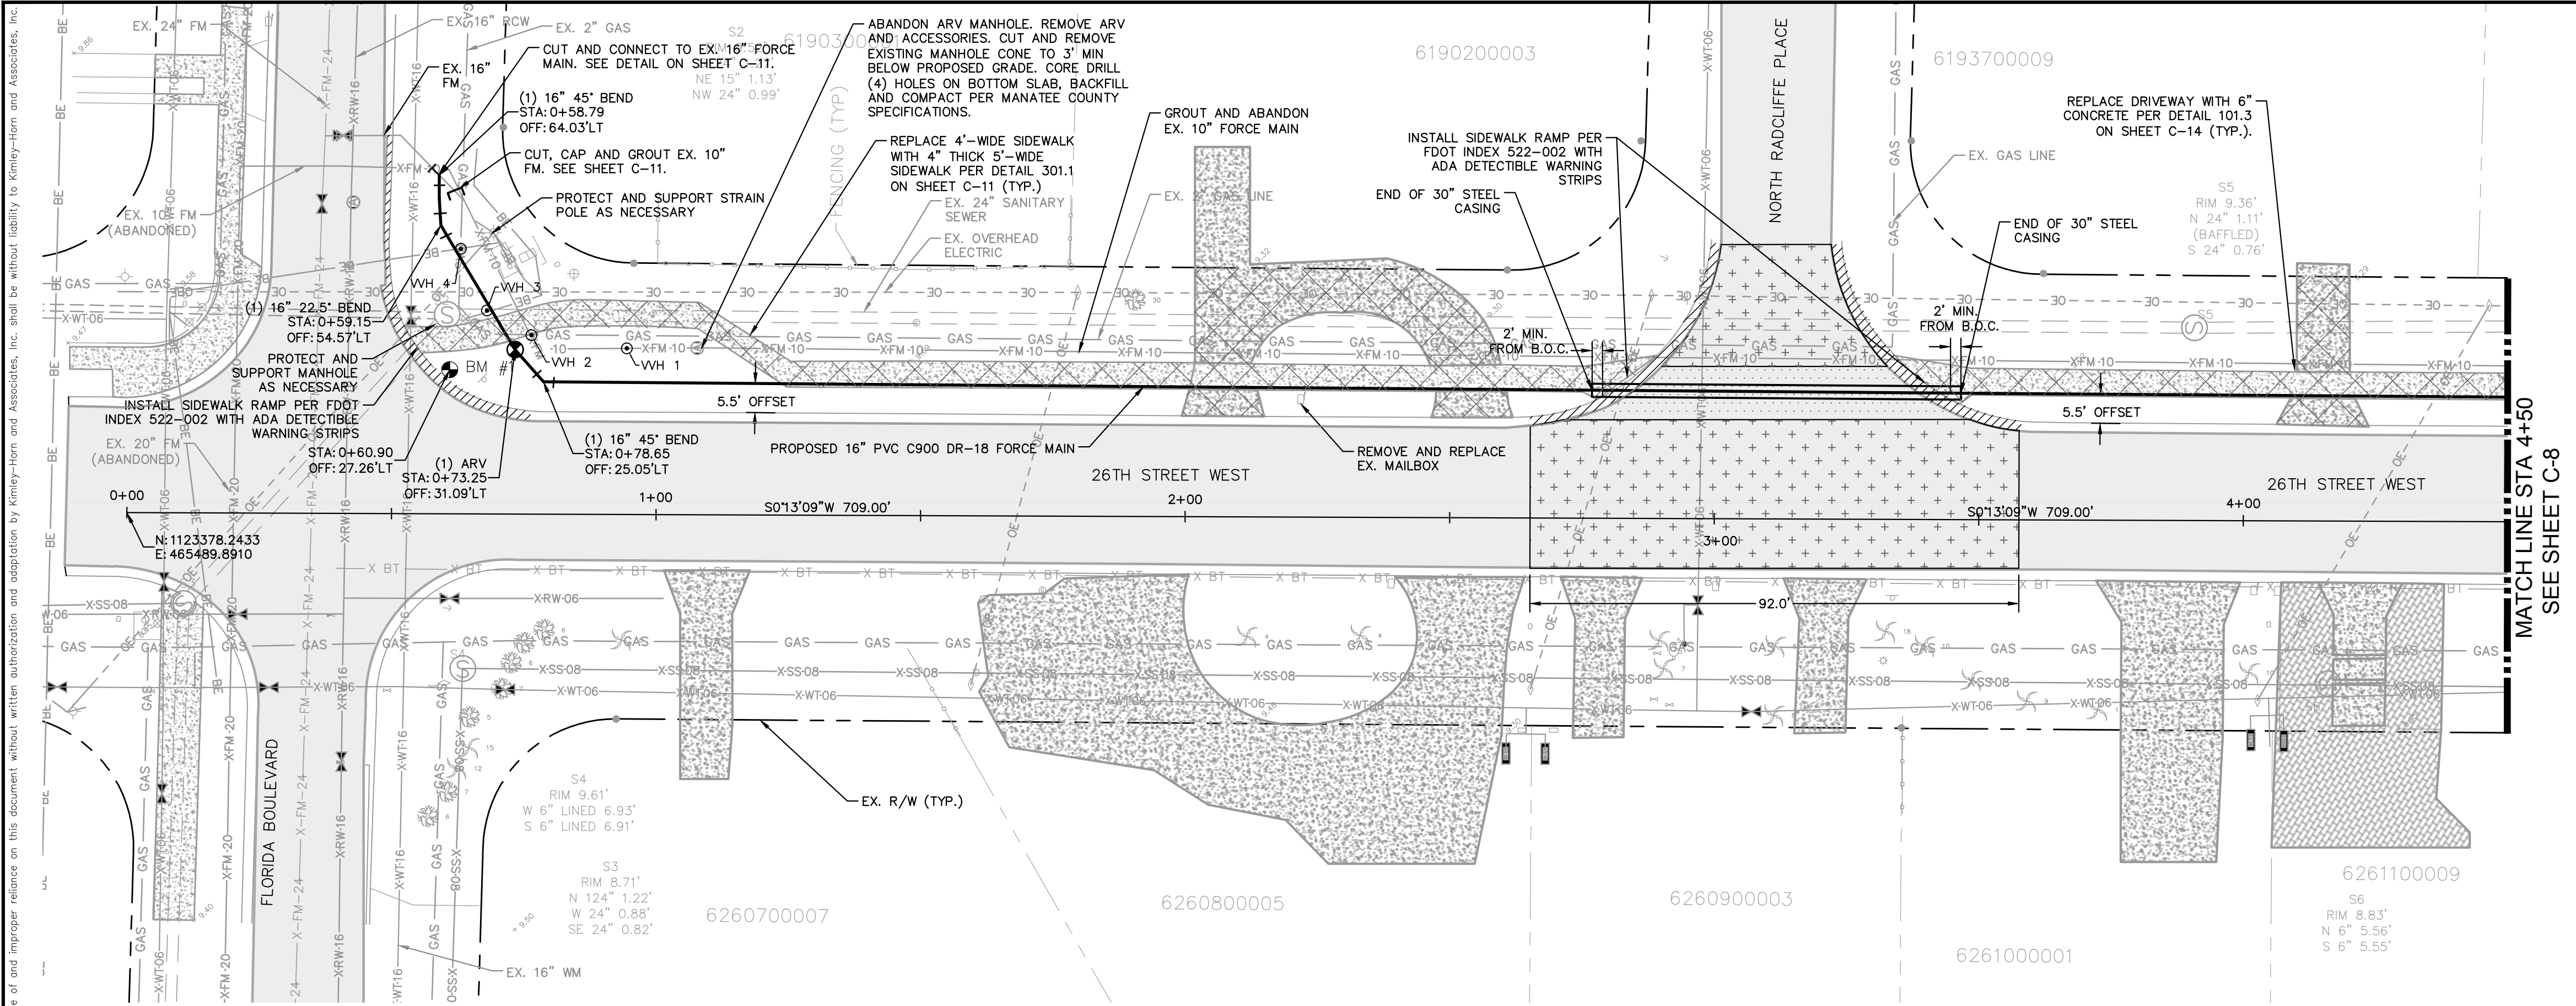


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WHERE CONCRETE REPAIRS ARE NECESSARY AND EXPANSION JOINTS ARE PRESENT, CONTRACTOR TO REMOVE AND REPLACE CONCRETE UP TO THE NEXT EXPANSION JOINT; OTHERWISE, REPLACE CONCRETE AS NECESSARY.


**NOTES:**

- CONTRACTOR SHALL RESTRAIN PIPE PER RESTRAIN LENGTHS TABLE ON SHEET C-12
- CONSTRUCTION DEWATERING SHALL BE CONDUCTED IN ACCORDANCE WITH ALL FEDERAL, STATE, AND LOCAL REQUIREMENTS INCLUDING BUT NOT LIMITED TO CHAPTERS 62-621.300 AND 62-620 OF THE FLORIDA ADMINISTRATIVE CODE (FAC)
- EXISTING 2" GAS LINE AND BURIED ELECTRIC TO BE FIELD LOCATED WHERE NECESSARY PRIOR TO CONSTRUCTION
- CONTRACTOR TO RESTORE ANY PIPELINE TRENCH DIGGING WITHIN 24 HOURS OF DISTURBANCE

**GROUNDWATER / DEWATERING NOTE:**  
THE PRESENCE OF GROUNDWATER SHOULD BE ANTICIPATED ON THIS PROJECT. CONTRACTOR'S BID SHALL INCLUDE CONSIDERATION FOR THIS ISSUE. WHEN PERFORMING GRADING OPERATIONS DURING PERIODS OF WET WEATHER, PROVIDE ADEQUATE DEWATERING, DRAINAGE AND GROUND WATER MANAGEMENT TO CONTROL MOISTURE OF SOILS.

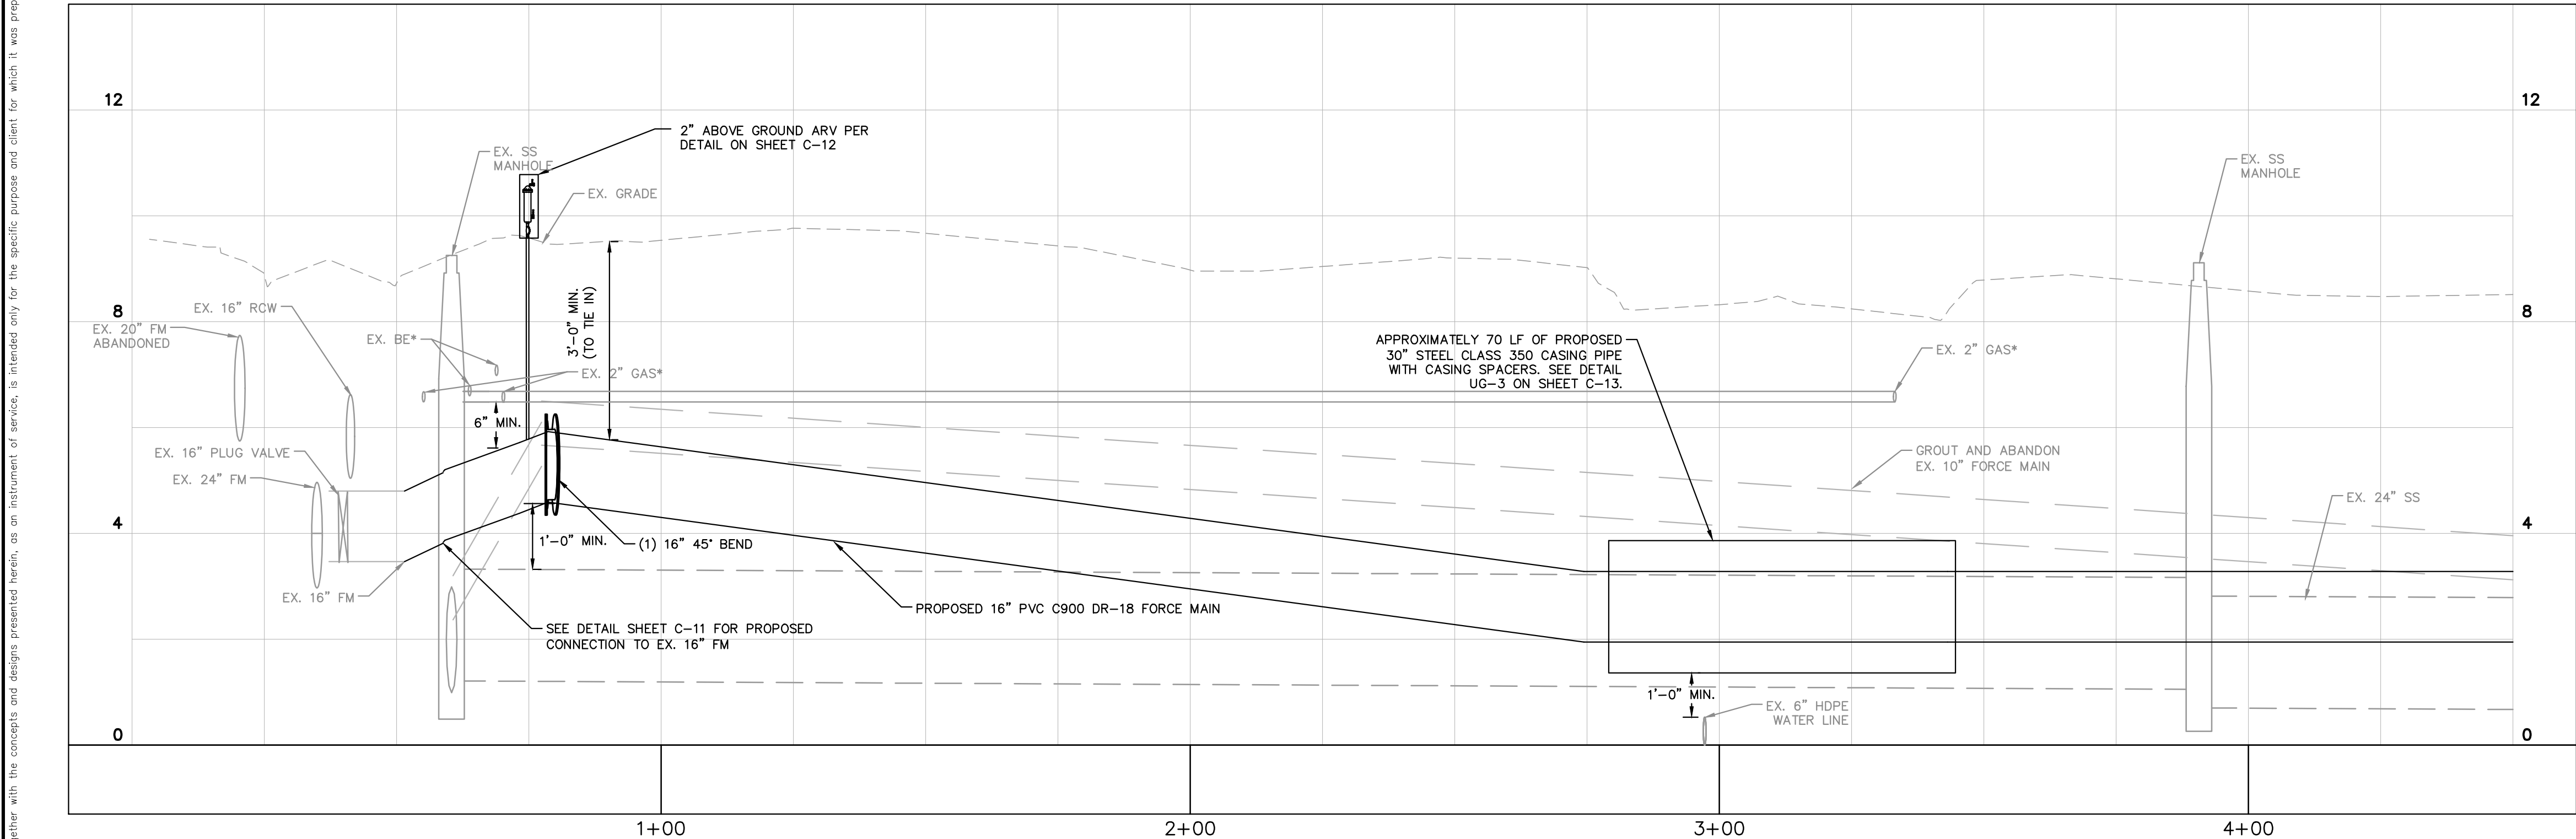

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**BAYSHORE YACHT BASIN FORCE MAIN  
AND LIFT STATION REPLACEMENT**

MANATEE COUNTY

LICENSED PROFESSIONAL  
  
MICHAEL A. SEMAGO, P.E.  
  
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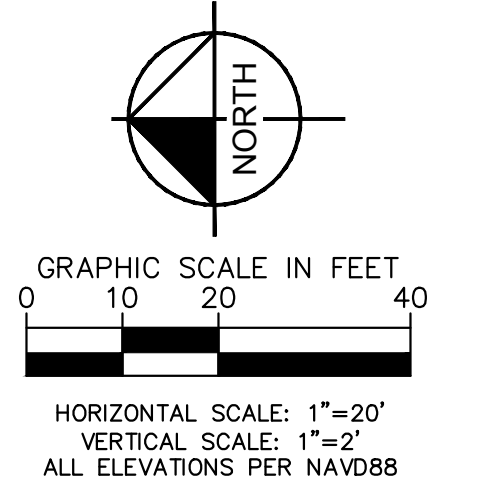
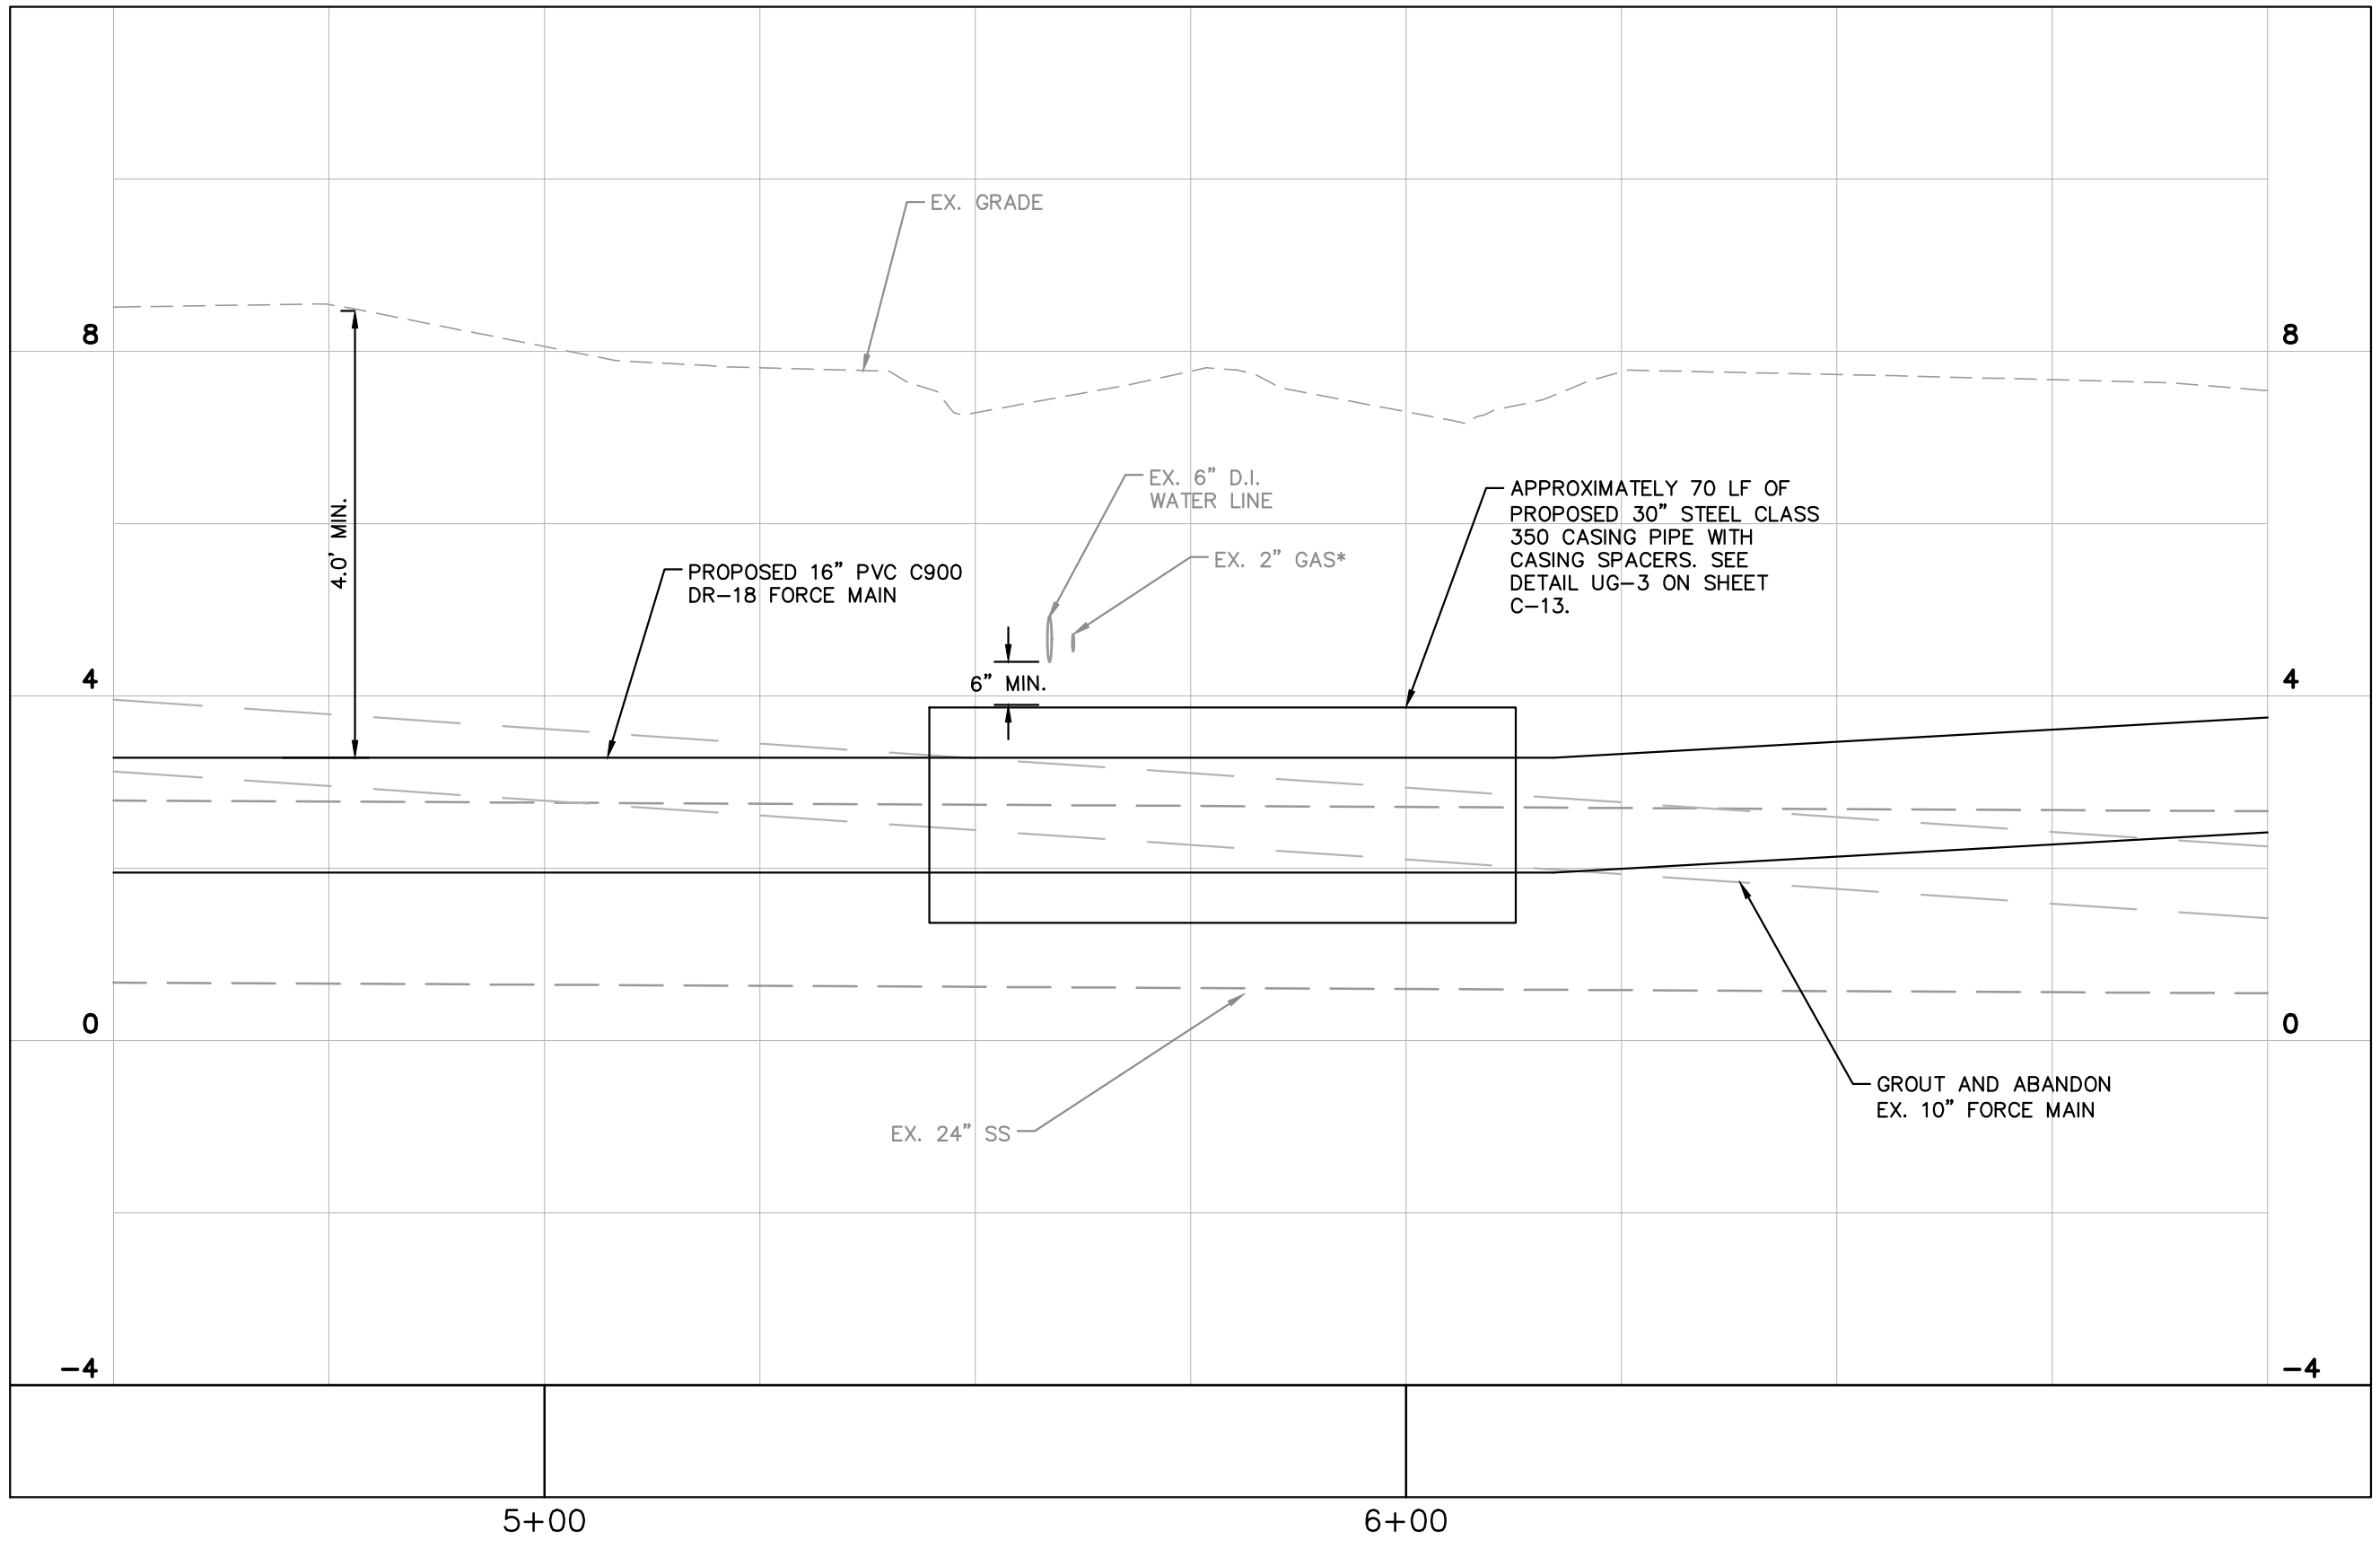
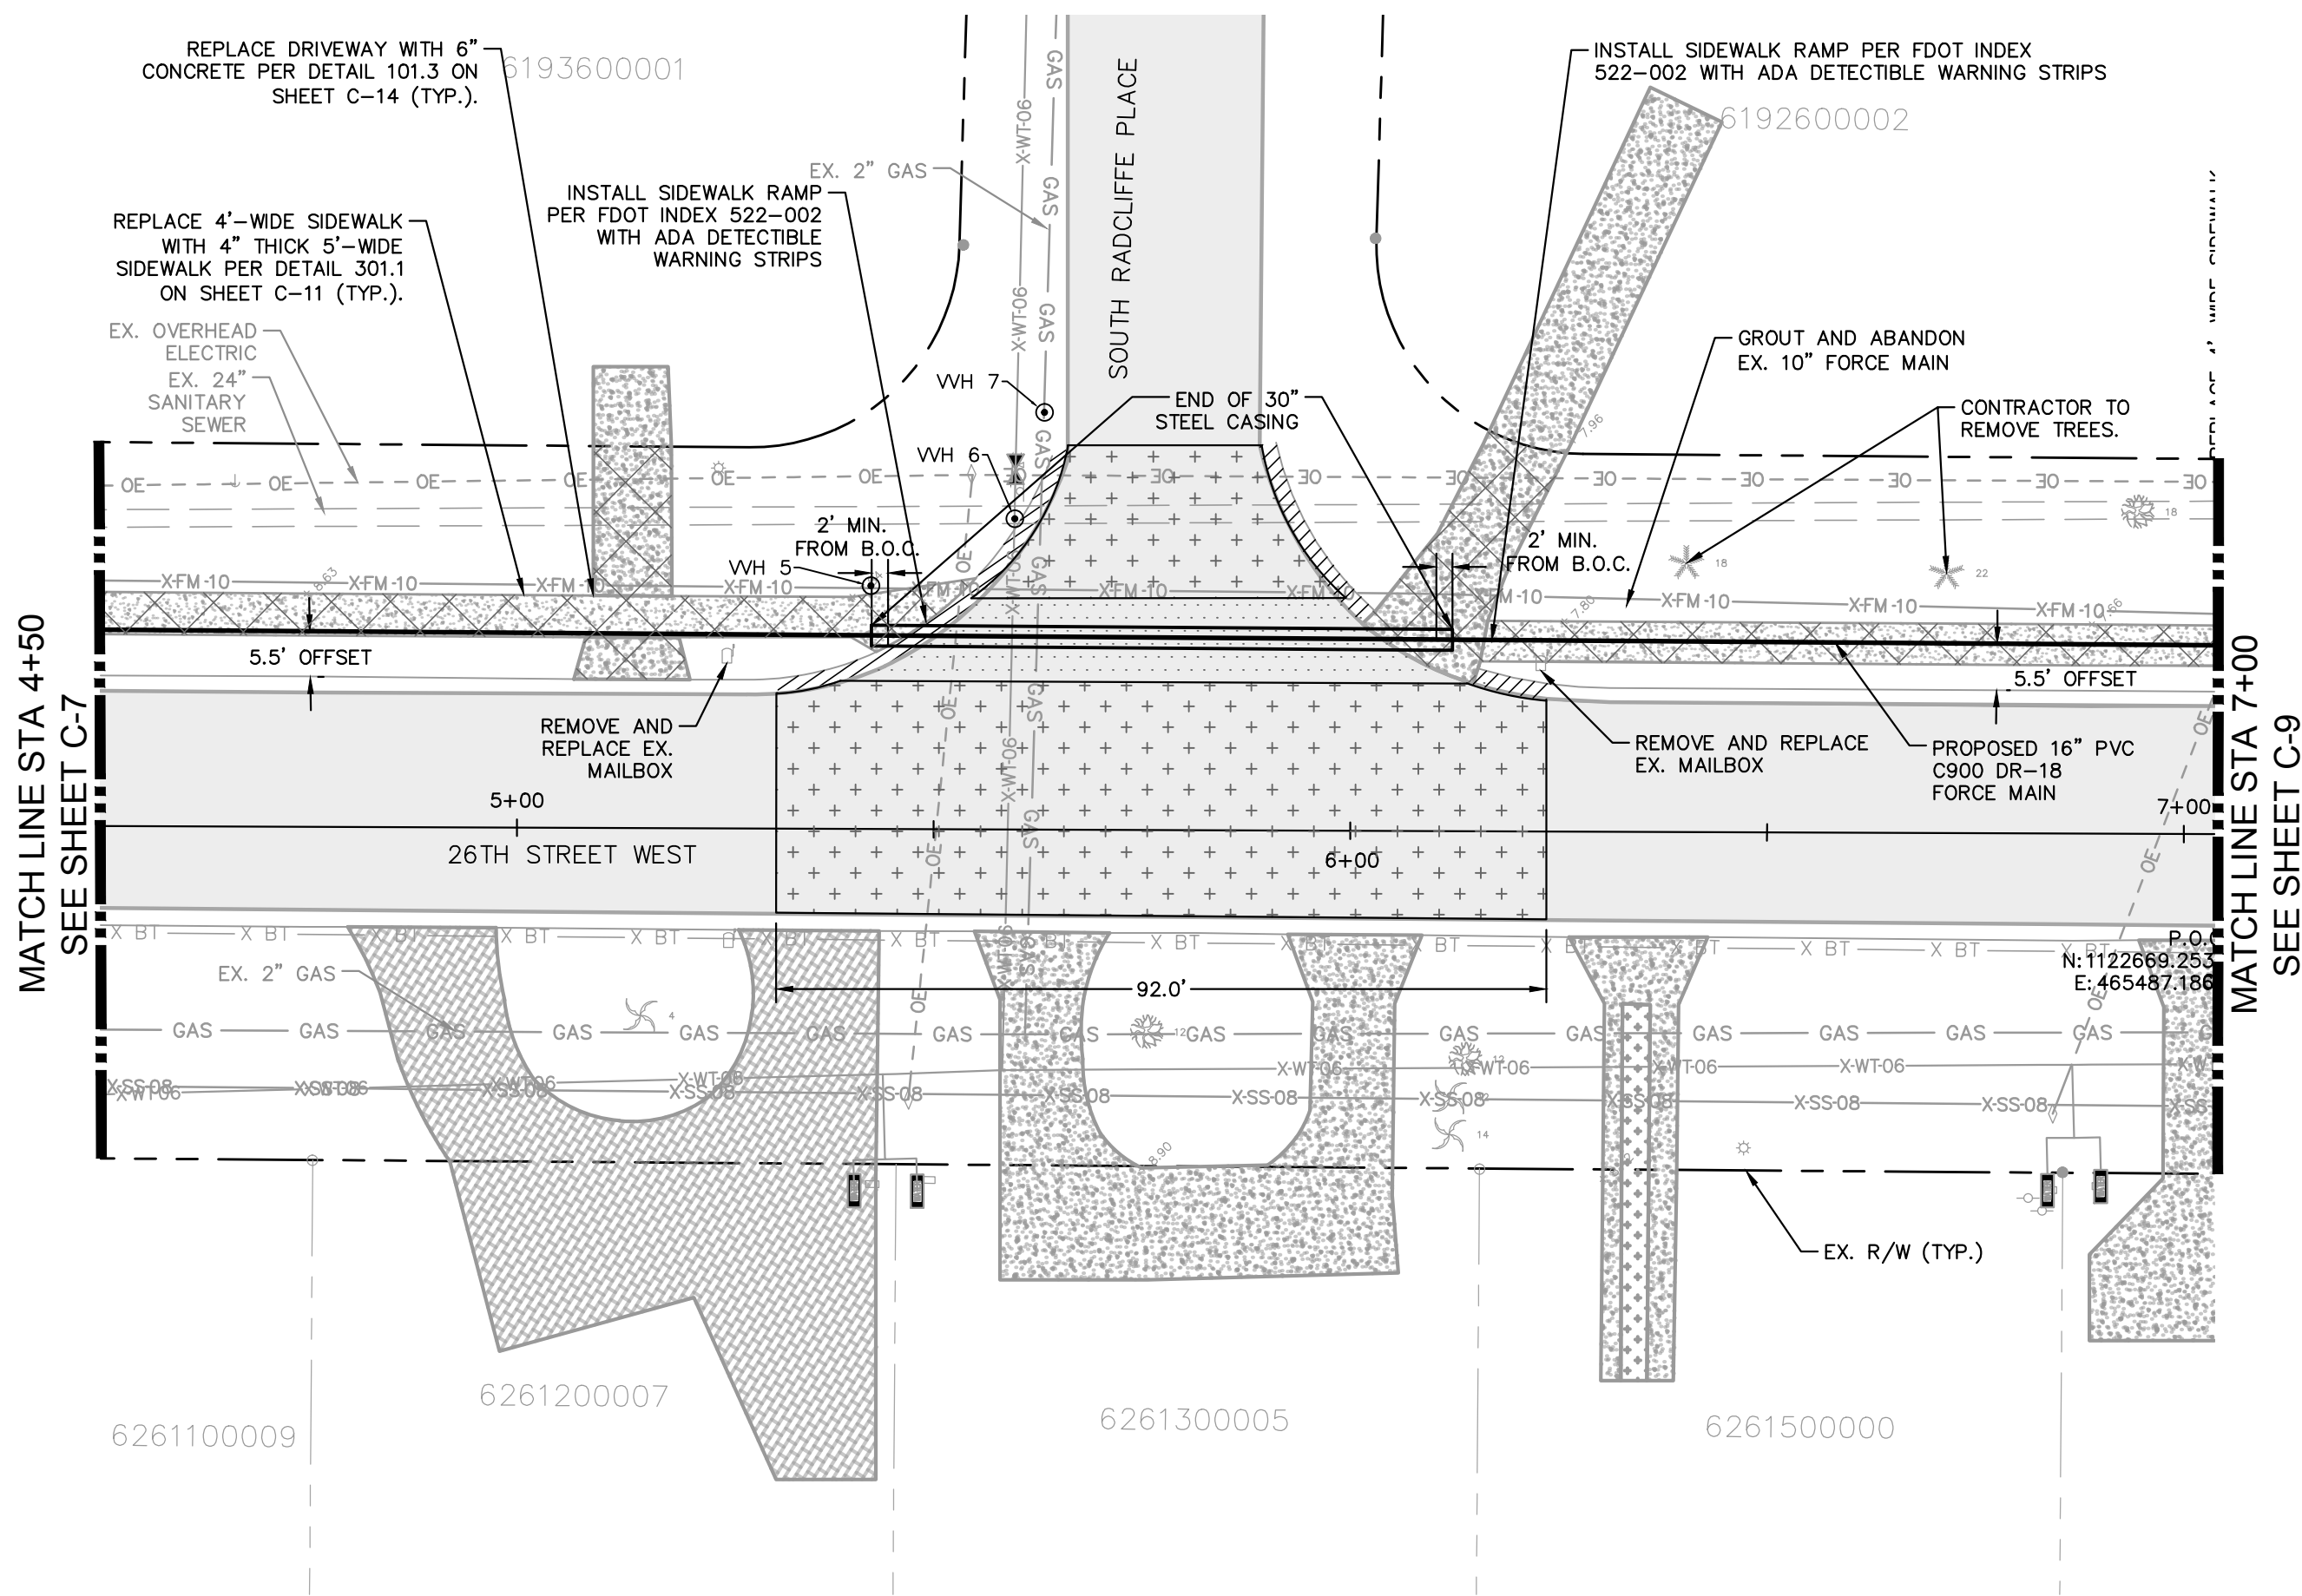
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**PLAN AND PROFILE  
(STA 0+00 - STA 4+50)**

SHEET NUMBER  
  
**C-7**



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LEGEND	
OPEN CUT	
SIDEWALK/CONCRETE DRIVEWAY RESTORATION	
FULL ROADWAY RESTORATION	
MILLING AND RESURFACING	
CURB RESTORATION	

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WHERE CONCRETE REPAIRS ARE NECESSARY AND EXPANSION JOINTS ARE PRESENT, CONTRACTOR TO REMOVE AND REPLACE CONCRETE UP TO THE NEXT EXPANSION JOINT; OTHERWISE, REPLACE CONCRETE AS NECESSARY.

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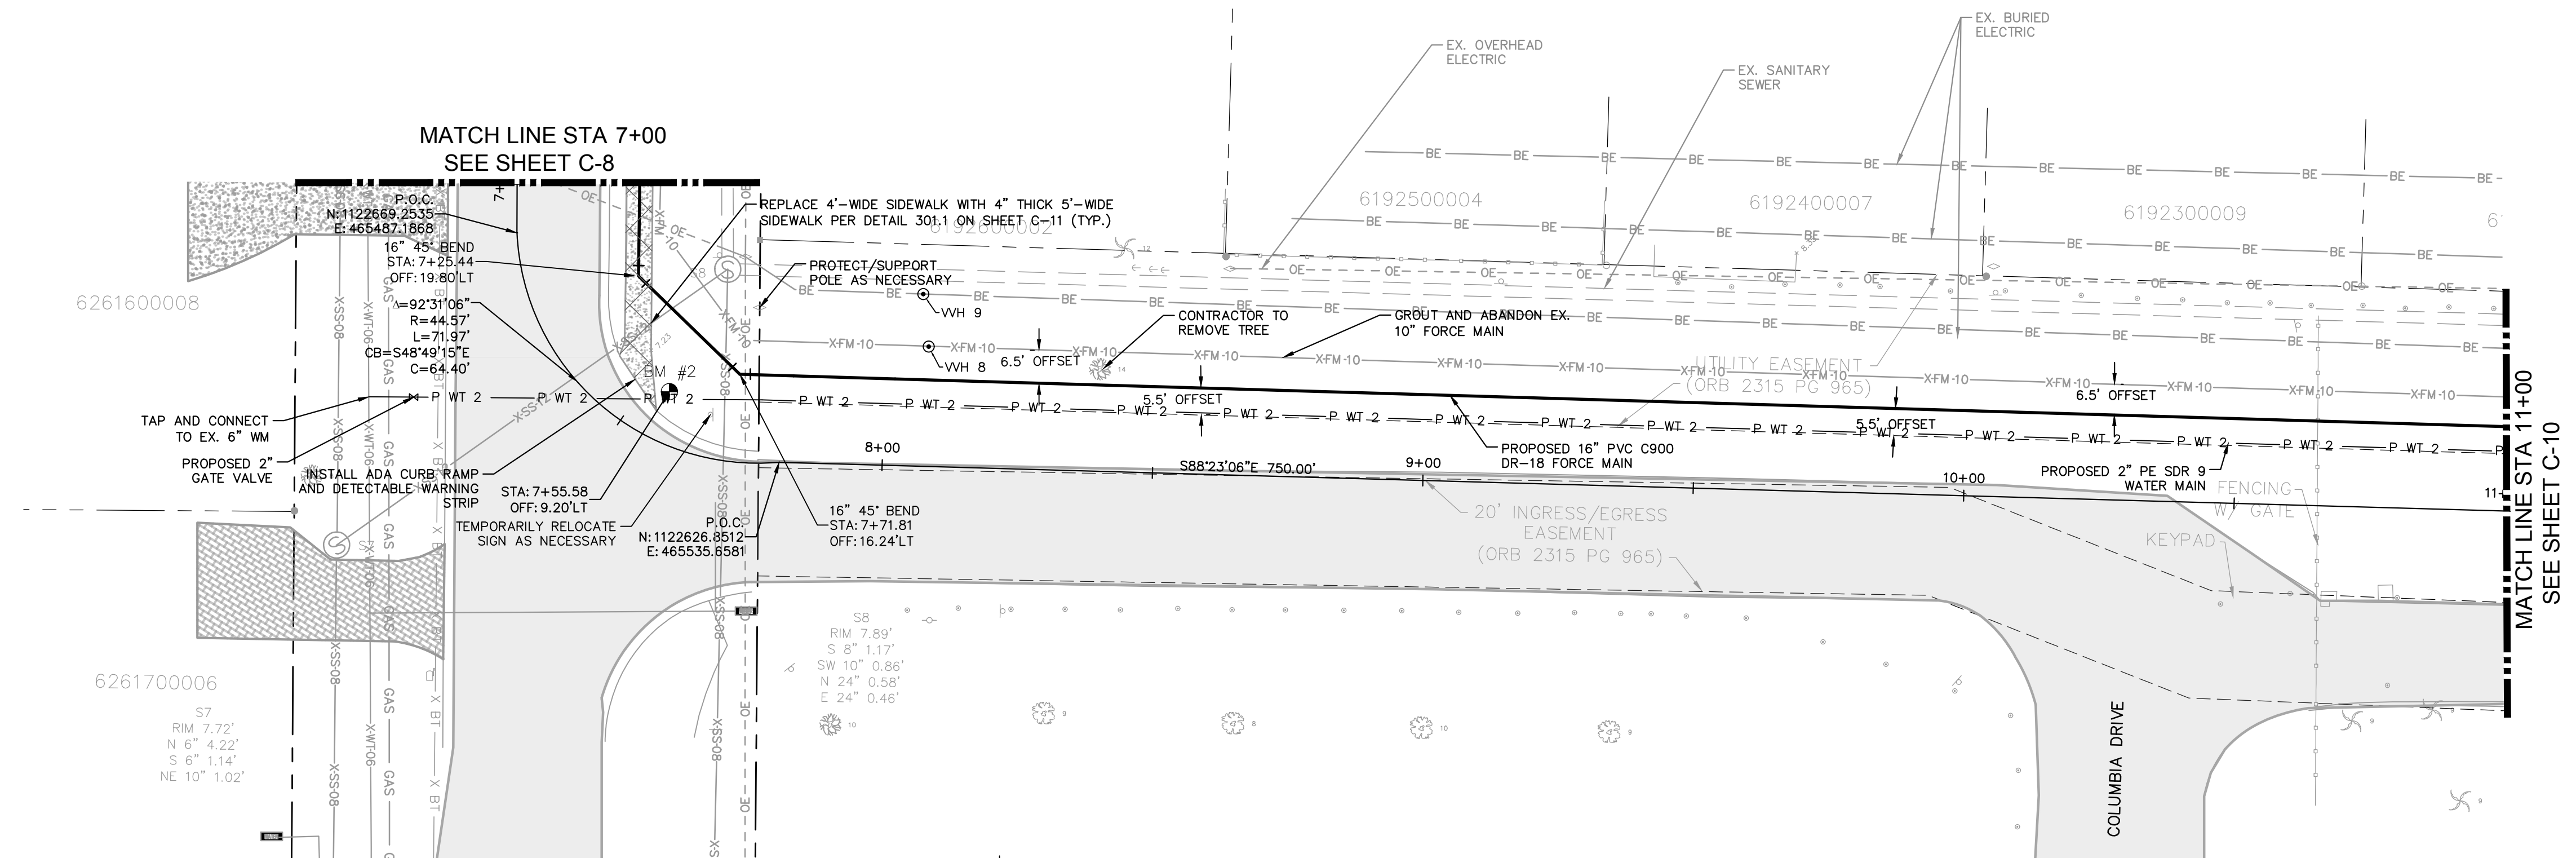
**BAYSHORE YACHT BASIN FORCE MAIN  
AND LIFT STATION REPLACEMENT**  
MANATEE COUNTY

LICENSED PROFESSIONAL  
  
MICHAEL A. SEMAGO, P.E.  
  
FL LICENSE NUMBER  
87501  
  
FL DATE:

**PLAN AND PROFILE  
(STA 4+50 - STA 7+00)**

SHEET NUMBER  
  
**C-8**





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- NOTES:
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


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C-9






# BAYSHORE YACHT BASIN FORCE MAIN AND LIFT STATION REPLACEMENT

MANATEE COUNTY

## PLAN AND PROFILE (STA 7+00 - STA 11+00)



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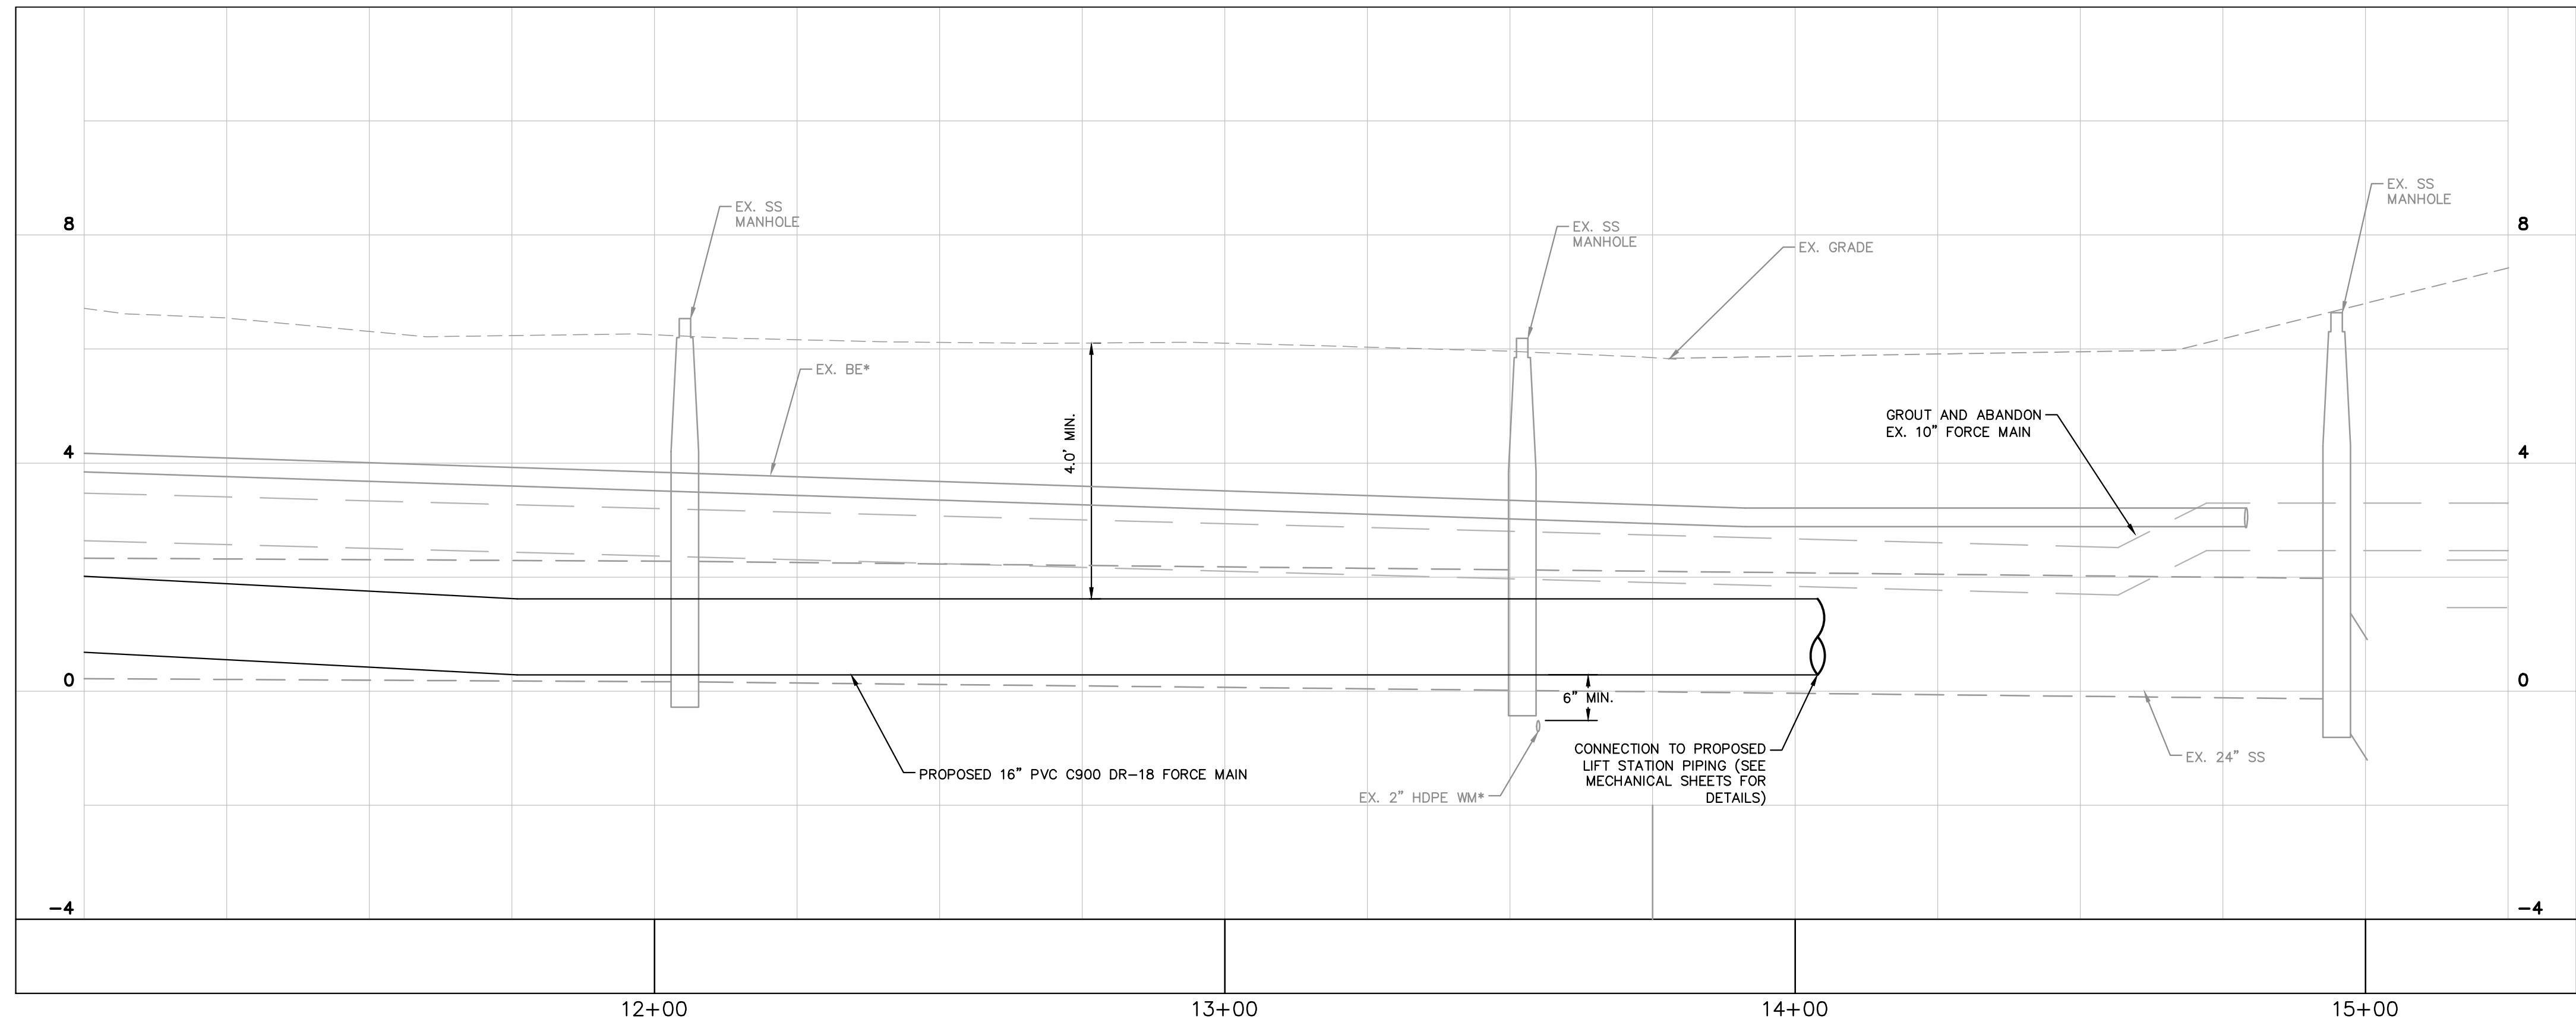
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
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

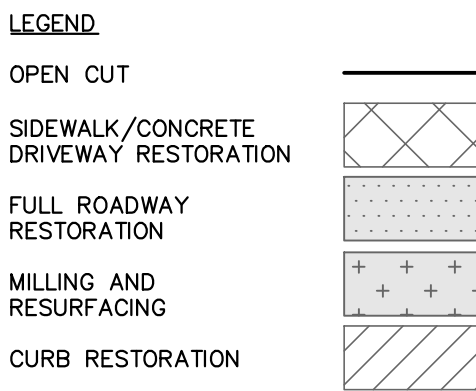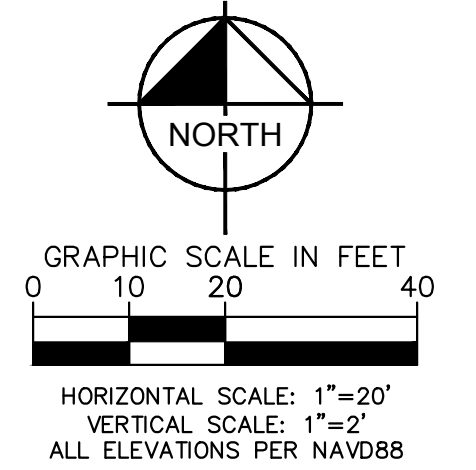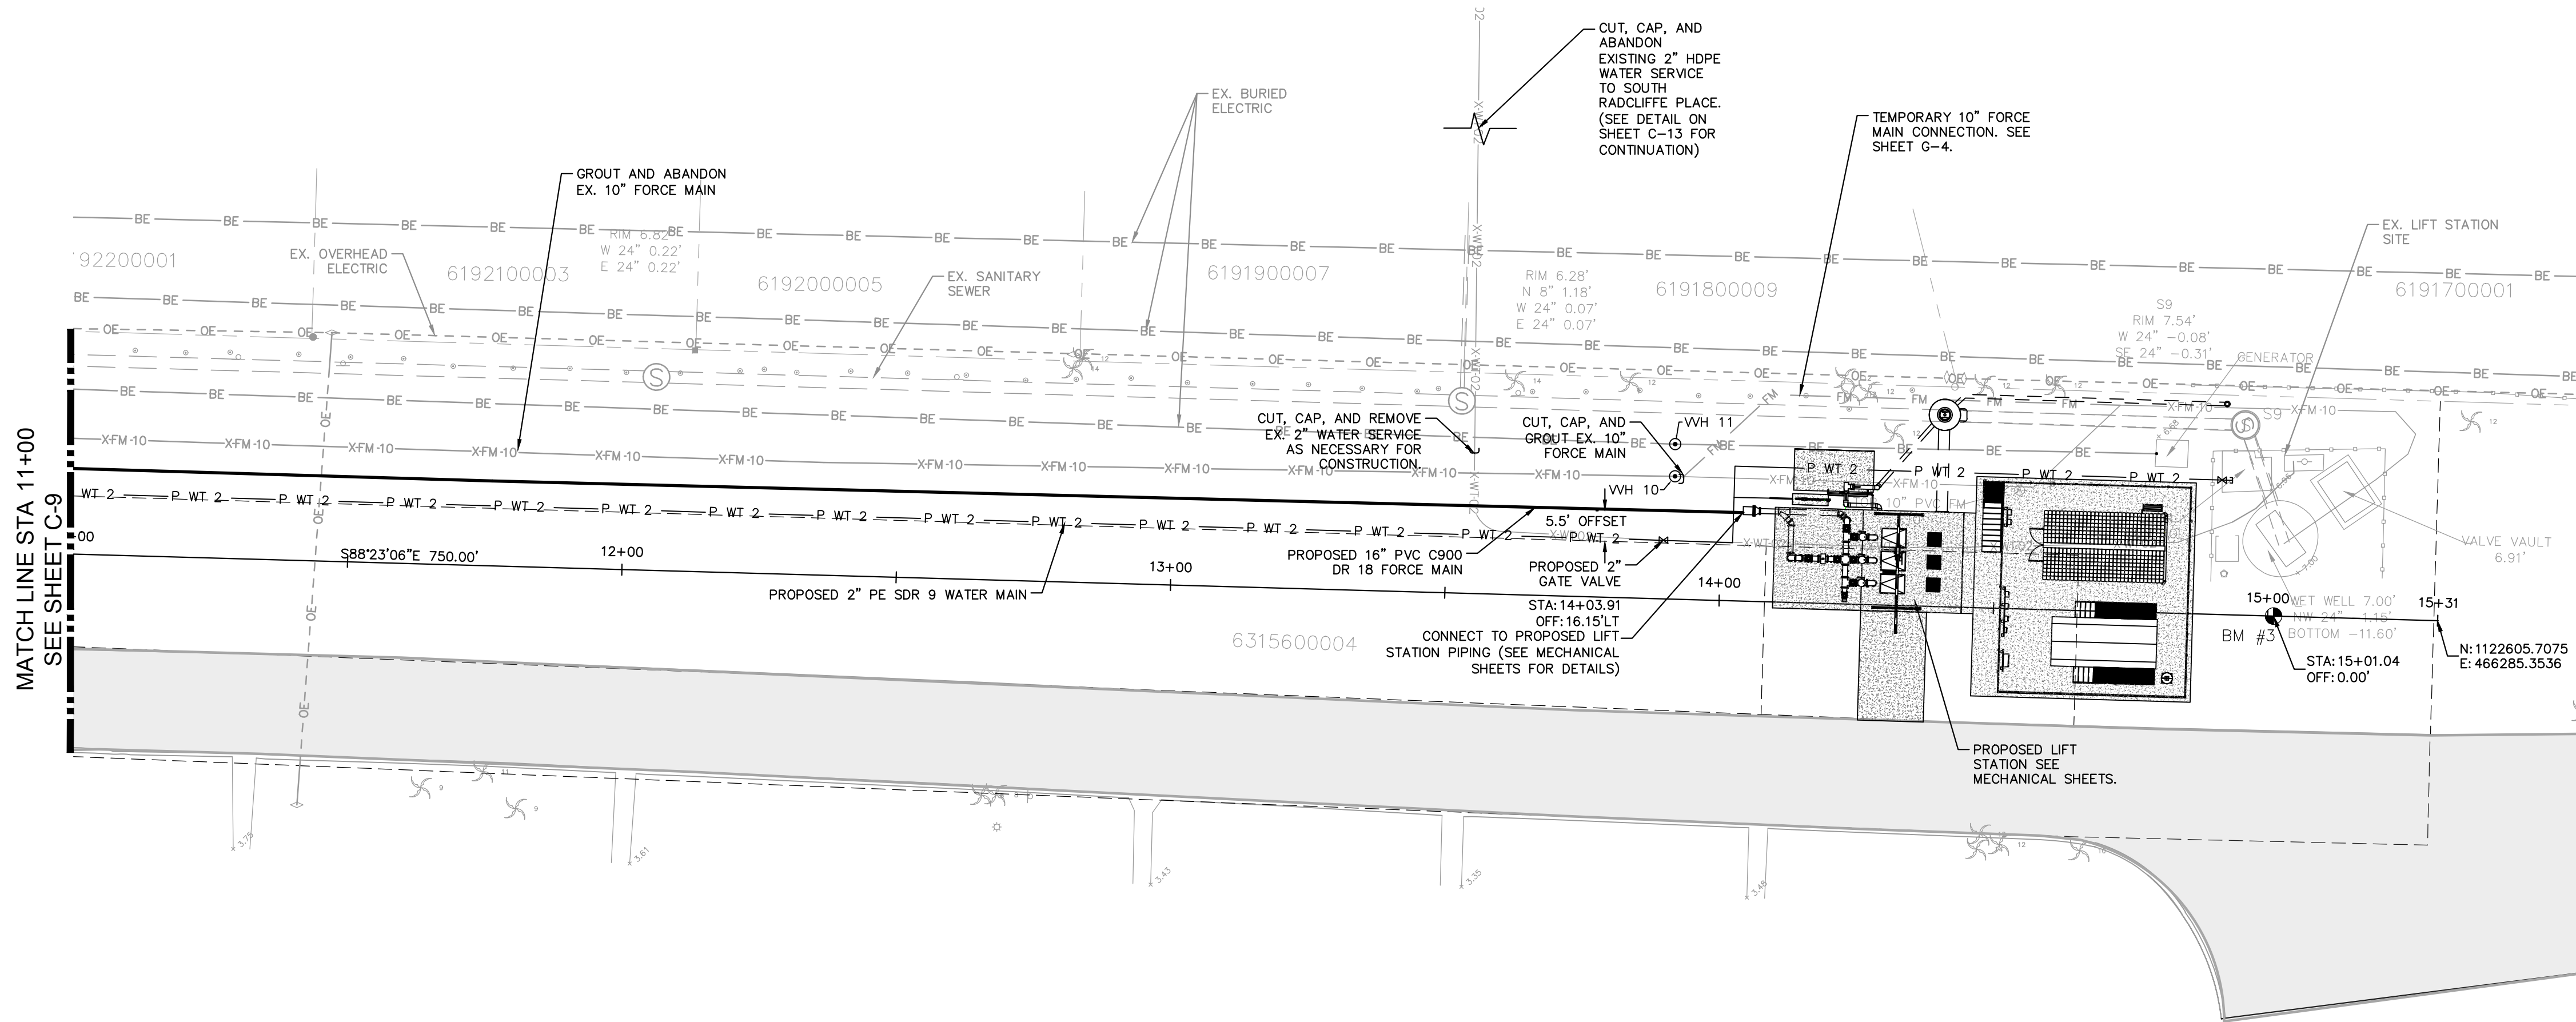
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KHA PROJECT  
148400067  
DATE  
FEB 2022  
SCALE AS SHOWN  
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**BAYSHORE YACHT BASIN FORCE MAIN  
AND LIFT STATION REPLACEMENT**

MANATEE COUNTY









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FL LICENSE NUMBER  
87501  
  
FL DATE:

**PLAN AND PROFILE  
(STA 11+00 - STA 15+31)**


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SCALE AS SHOWN  
DESIGNED BY MAS  
DRAWN BY GMB  
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BAYSHORE YACHT BASIN FORCE MAIN  
AND LIFT STATION REPLACEMENT

MANATEE COUNTY

LICENSED PROFESSIONAL
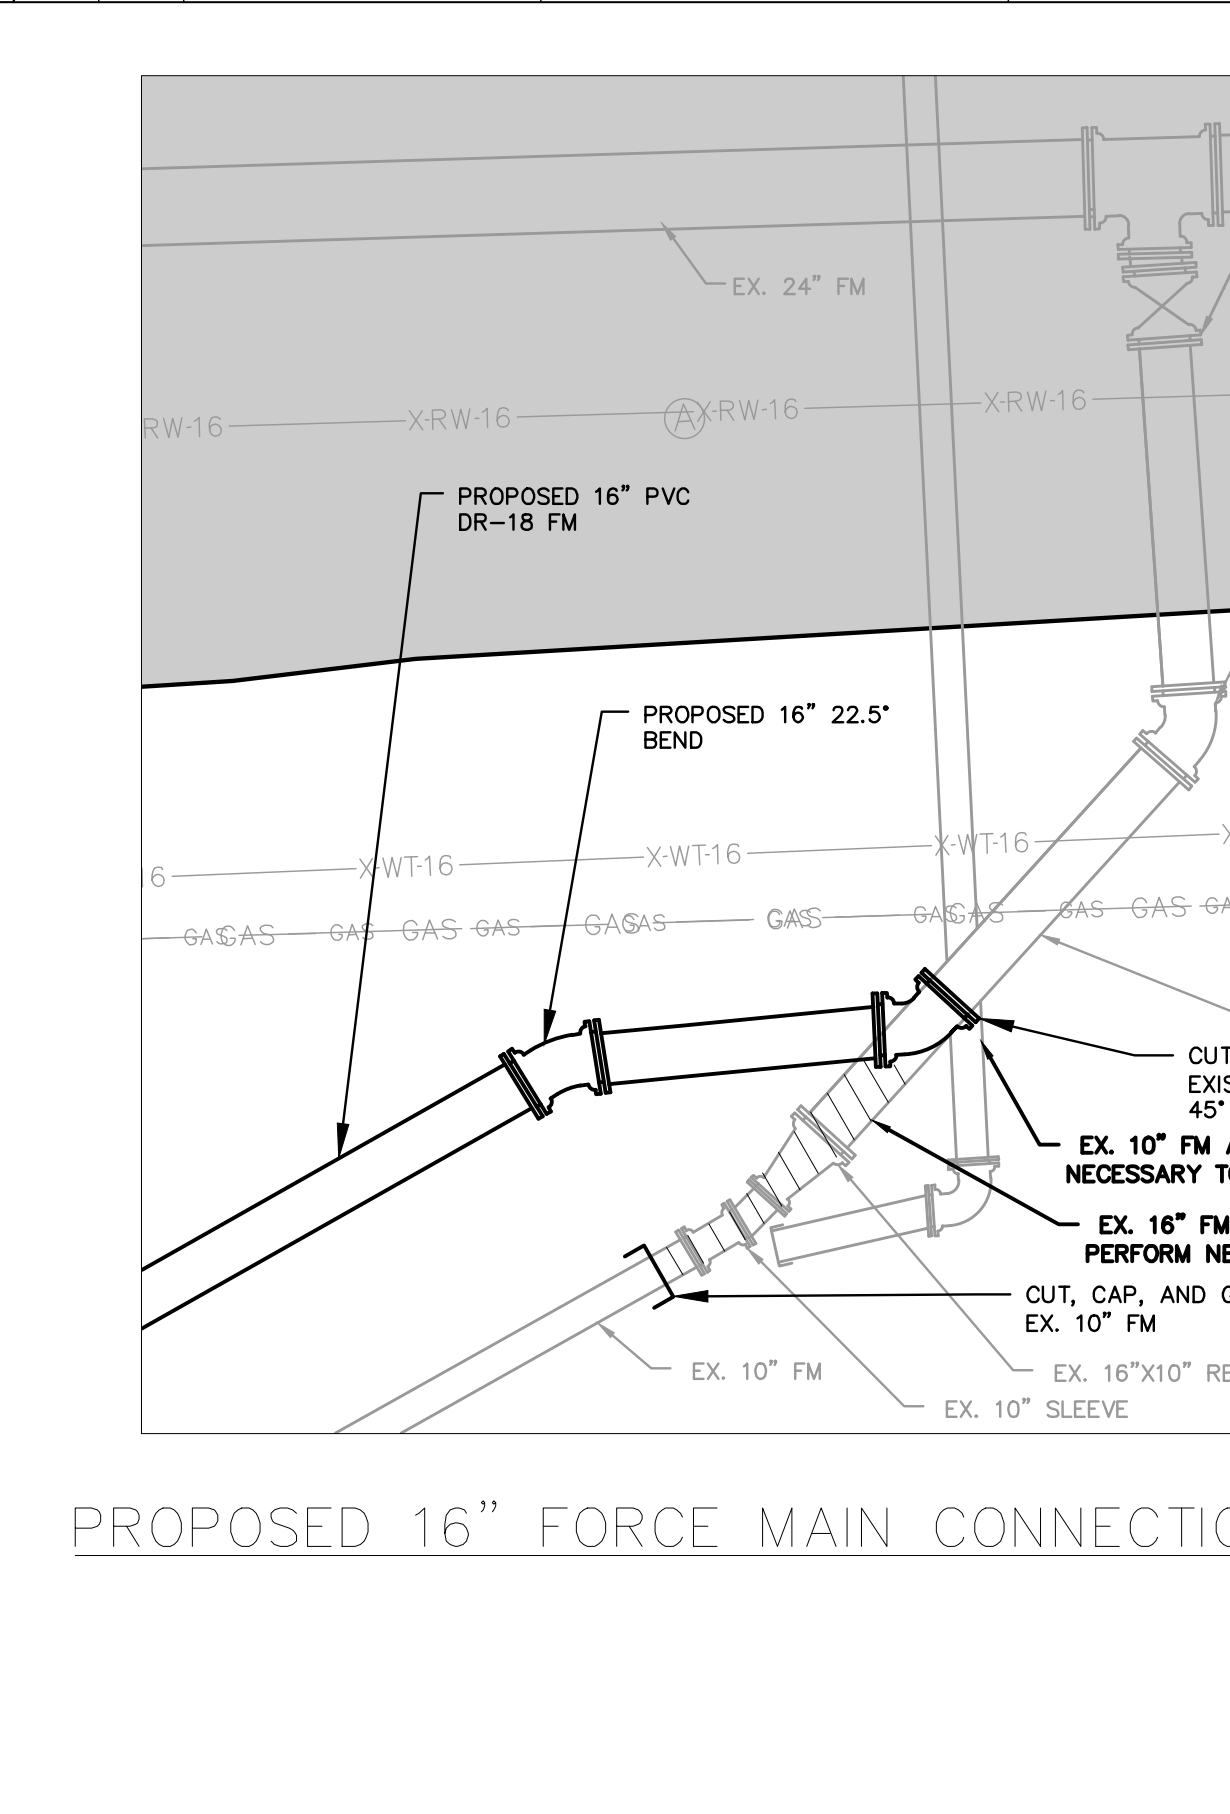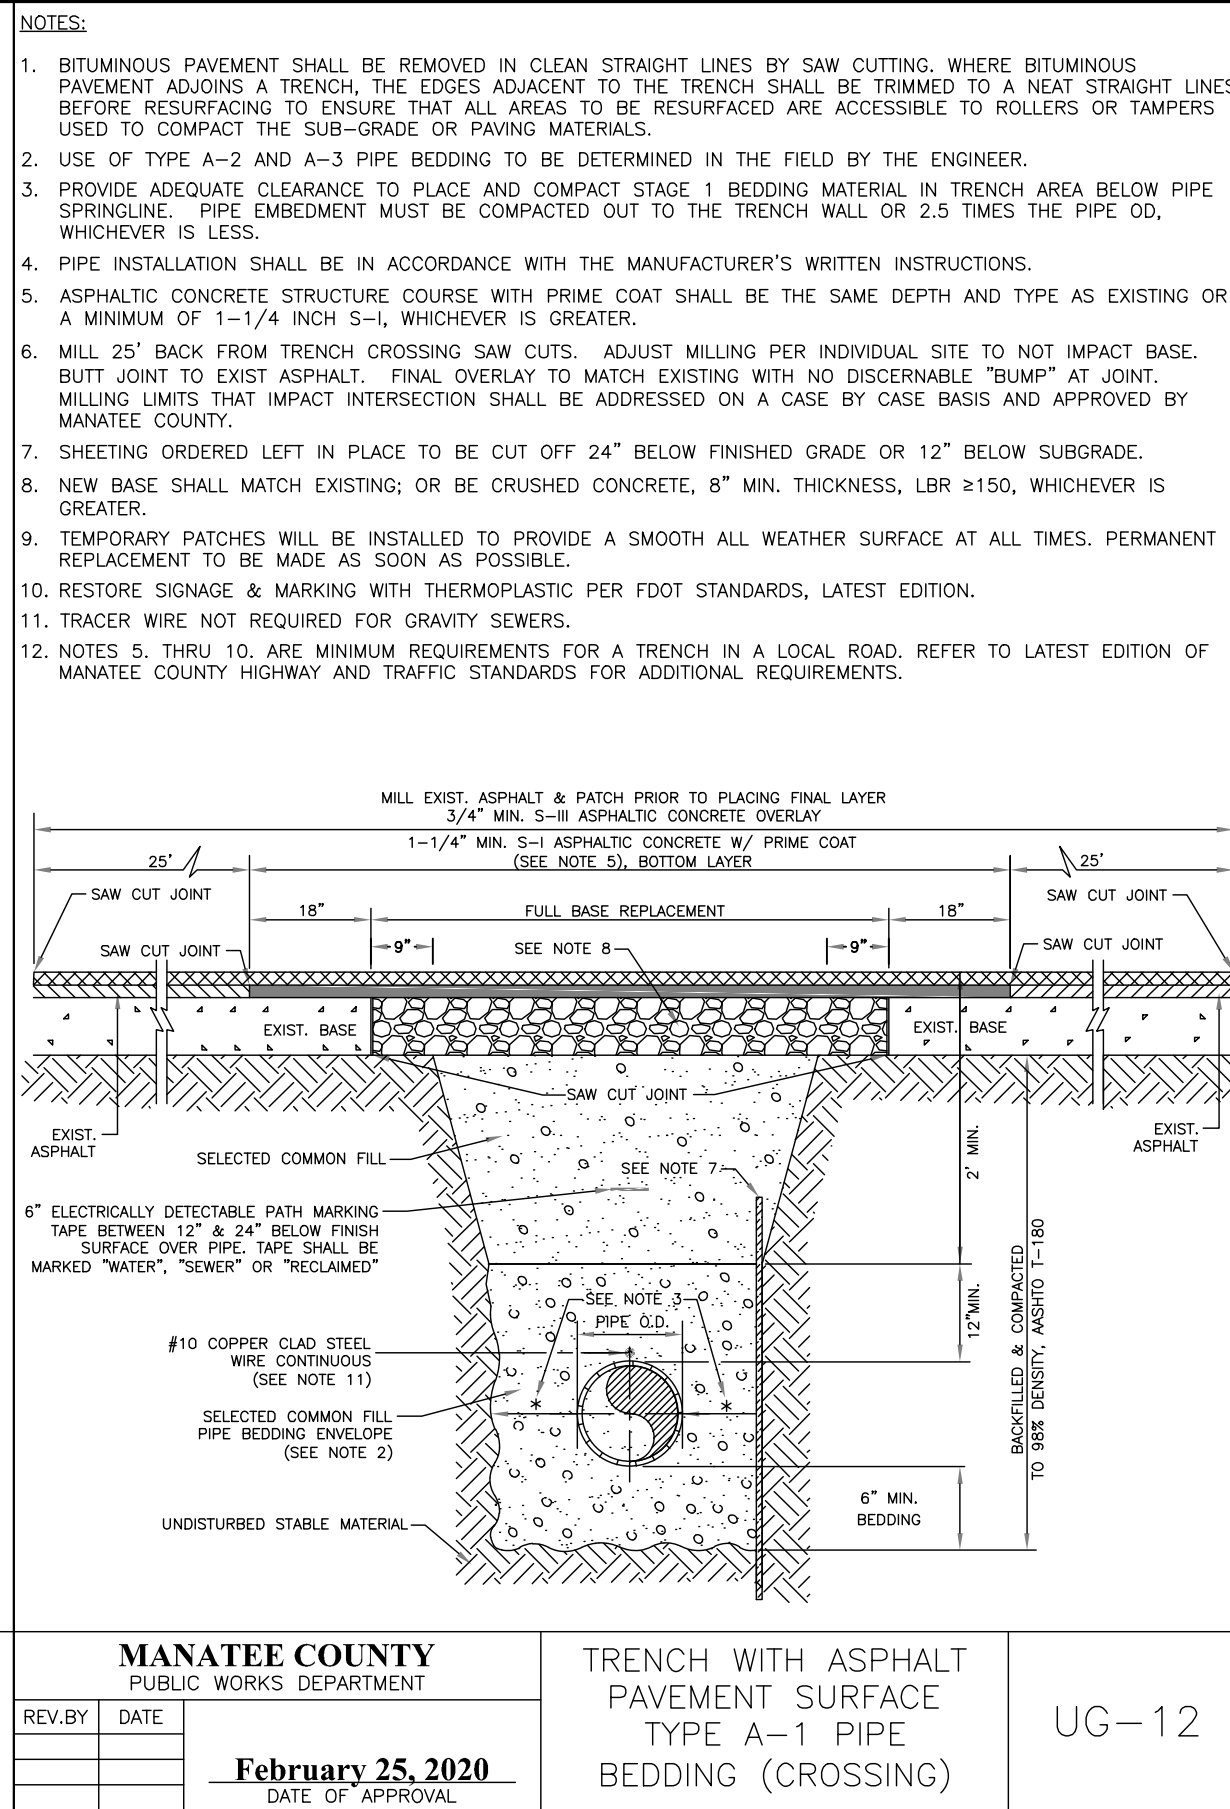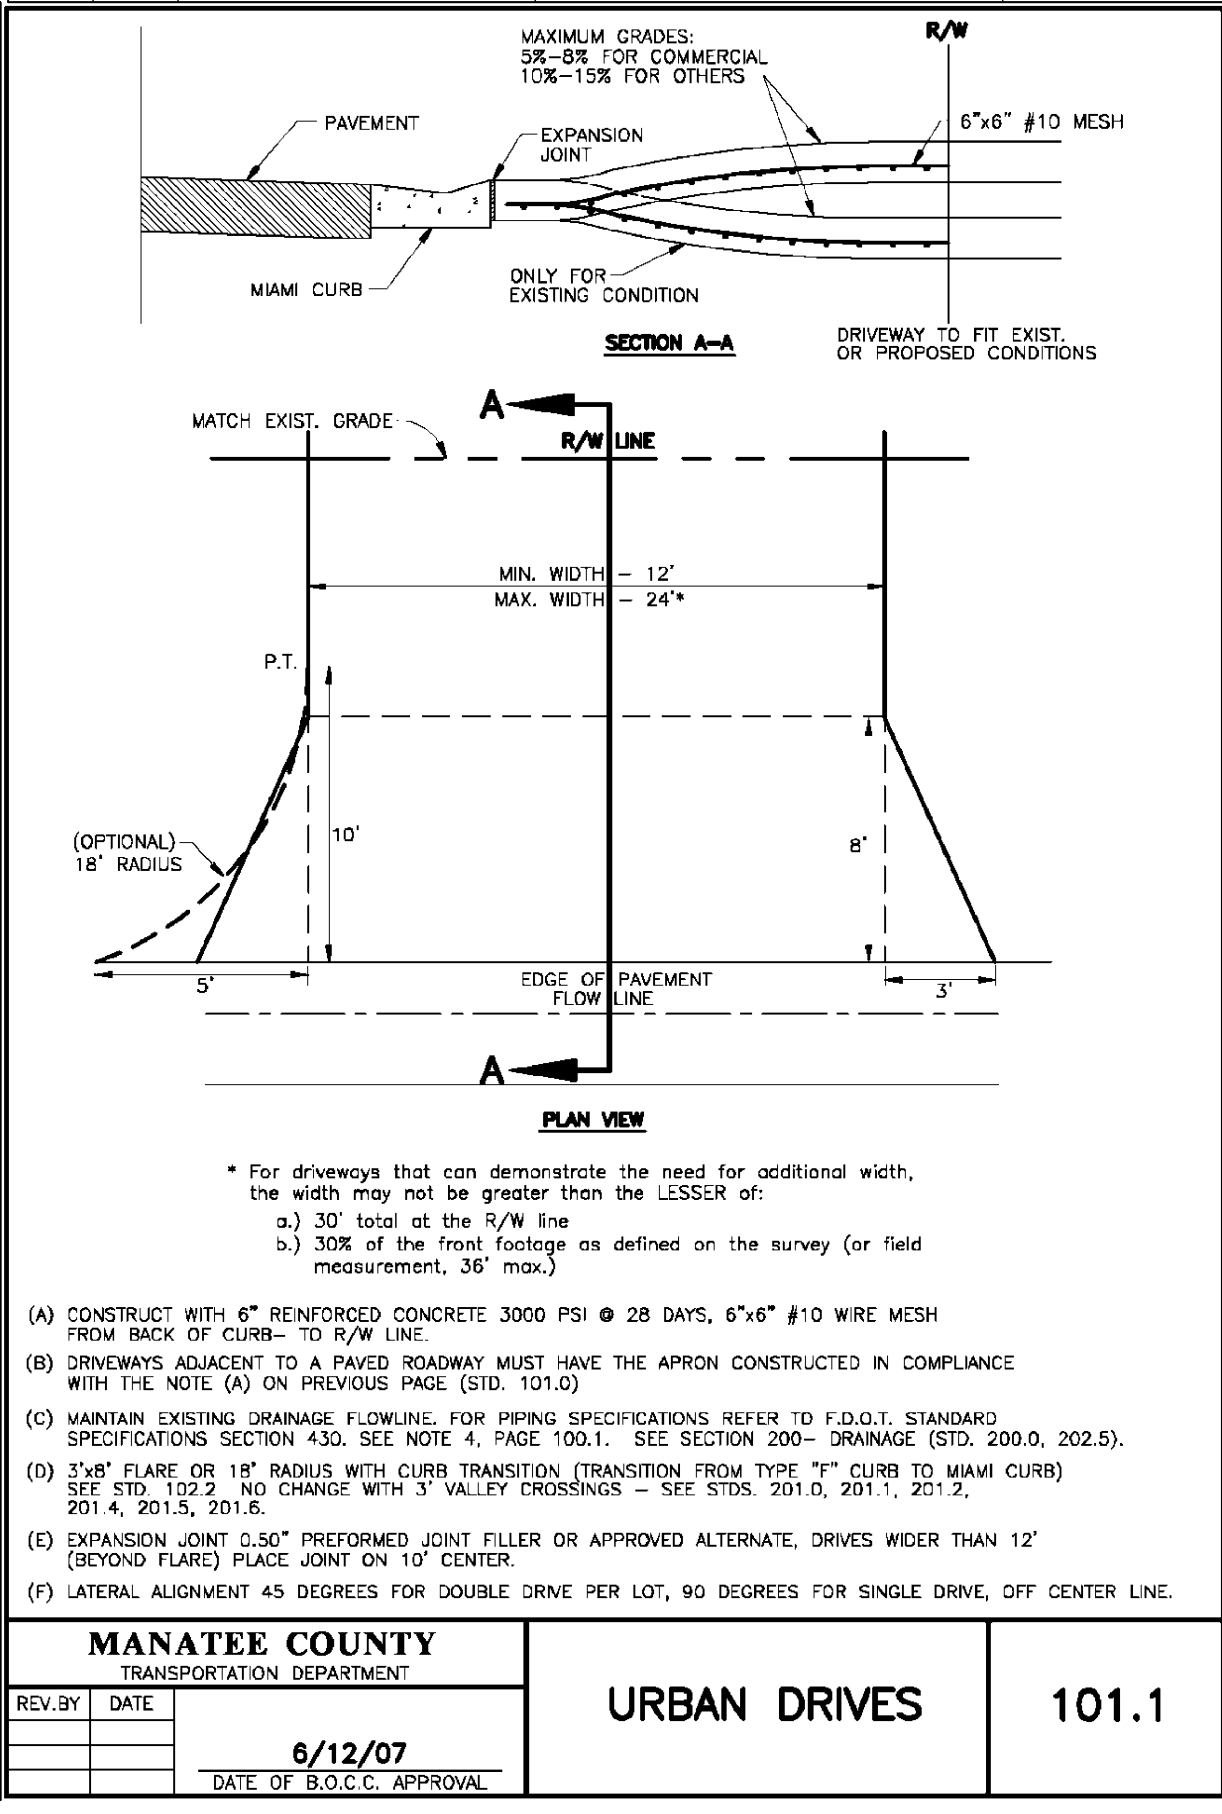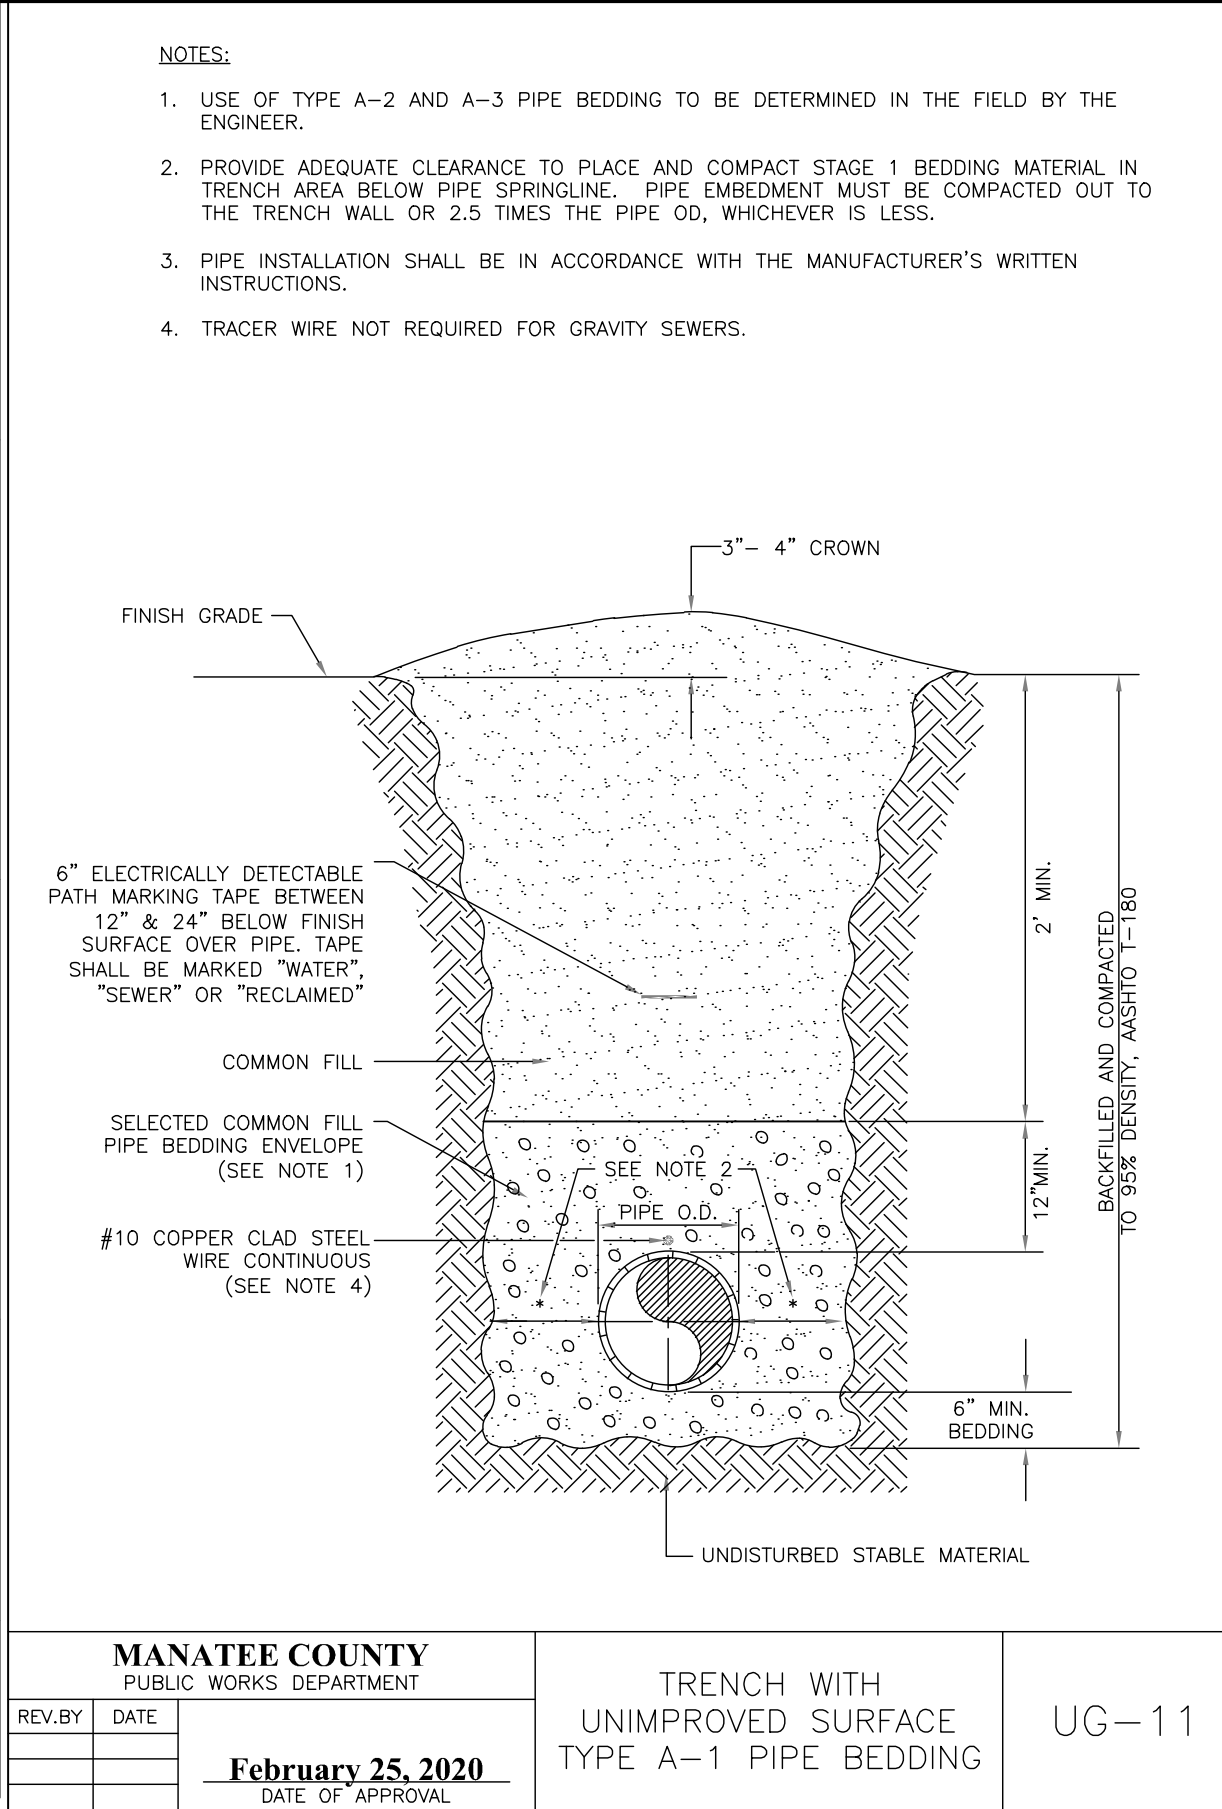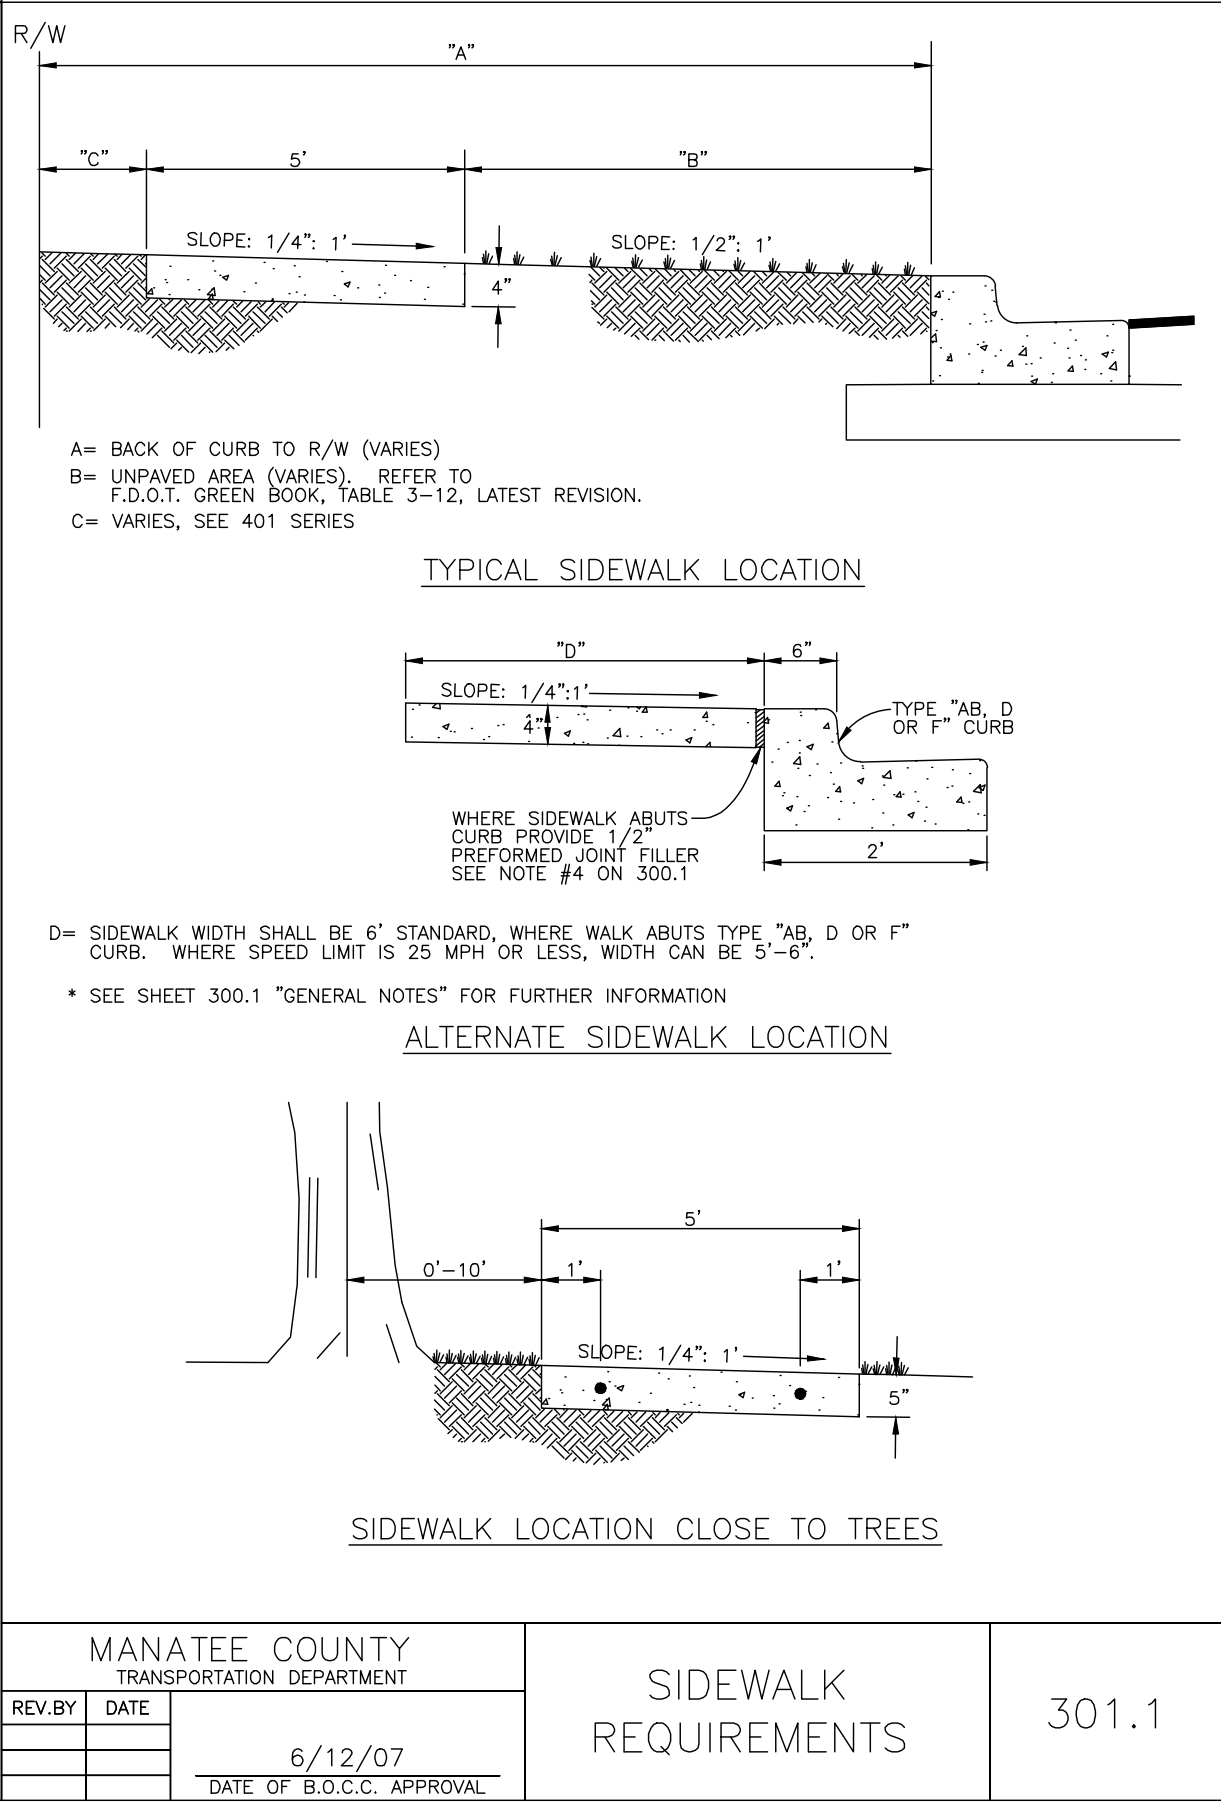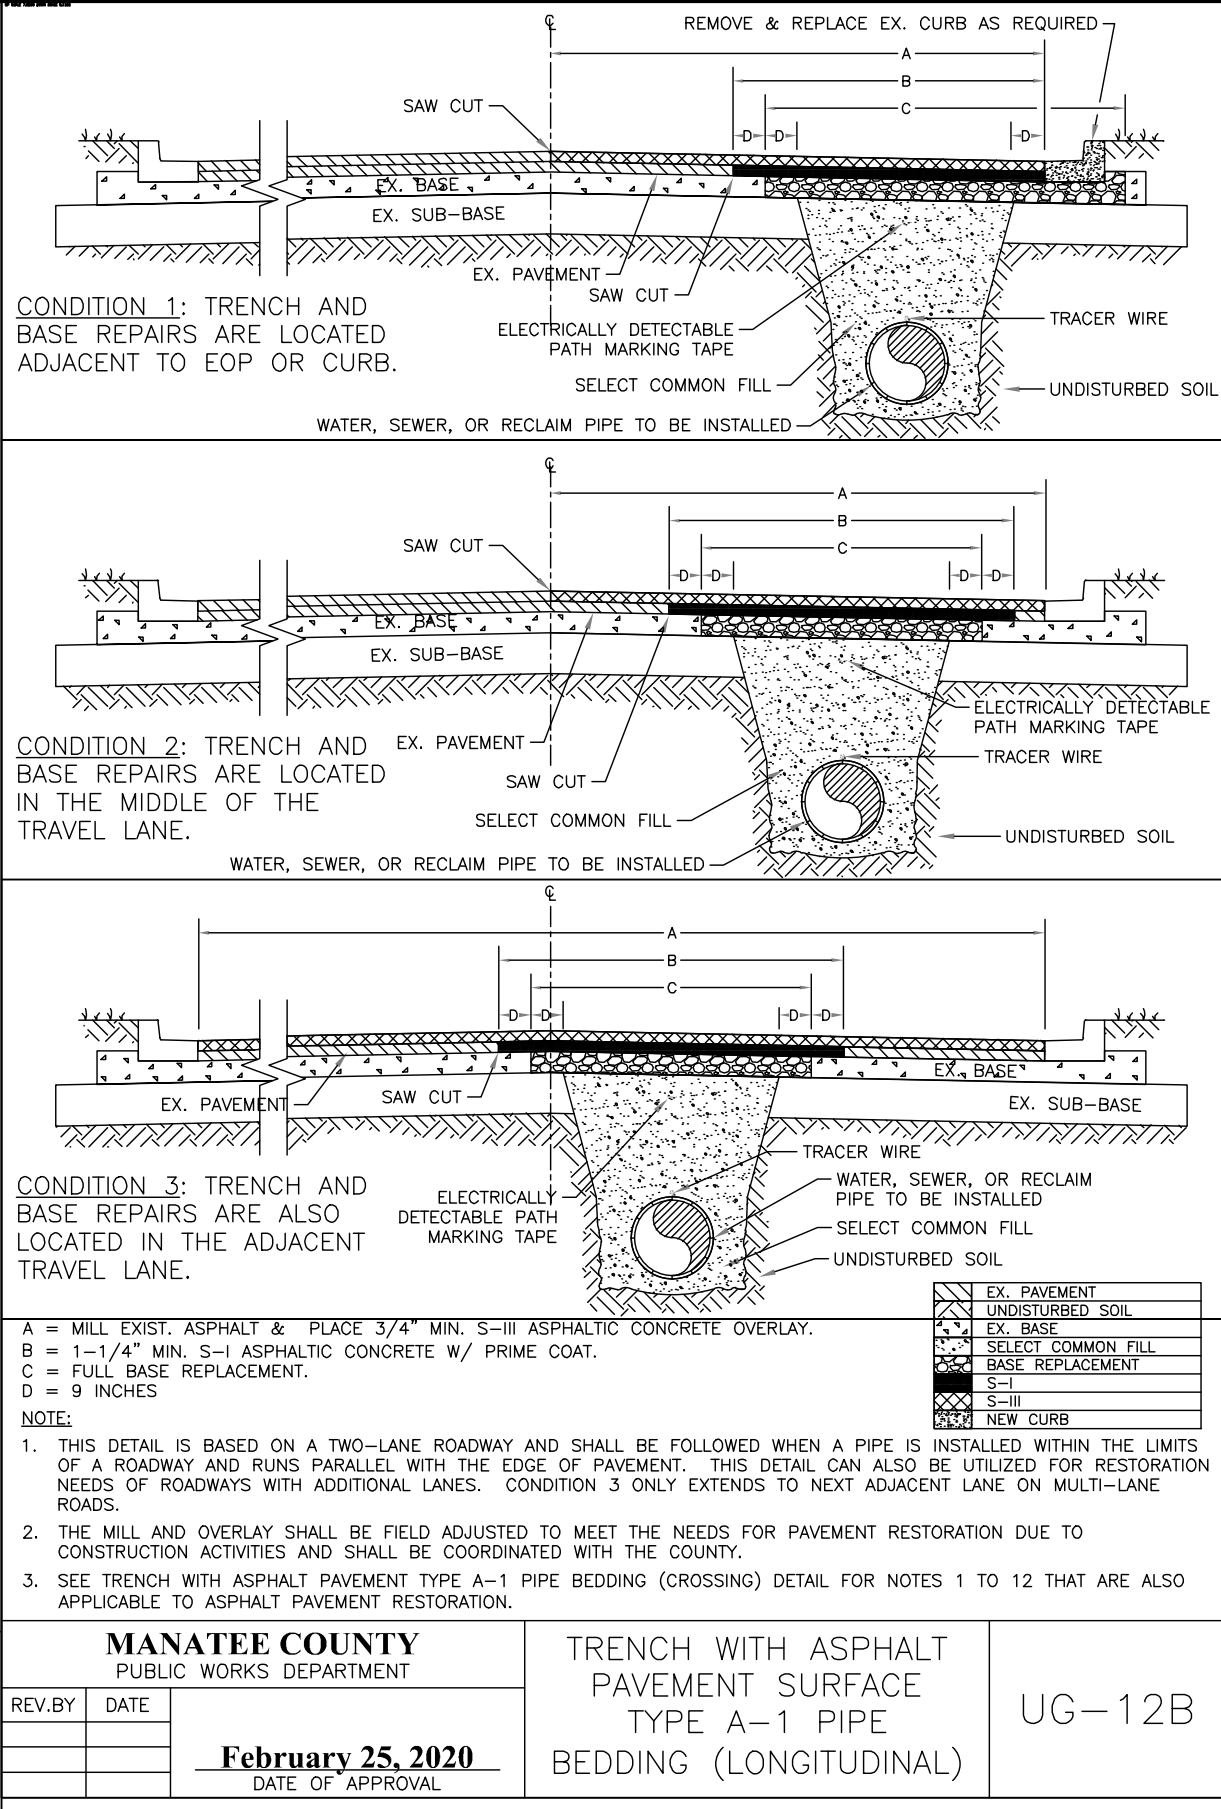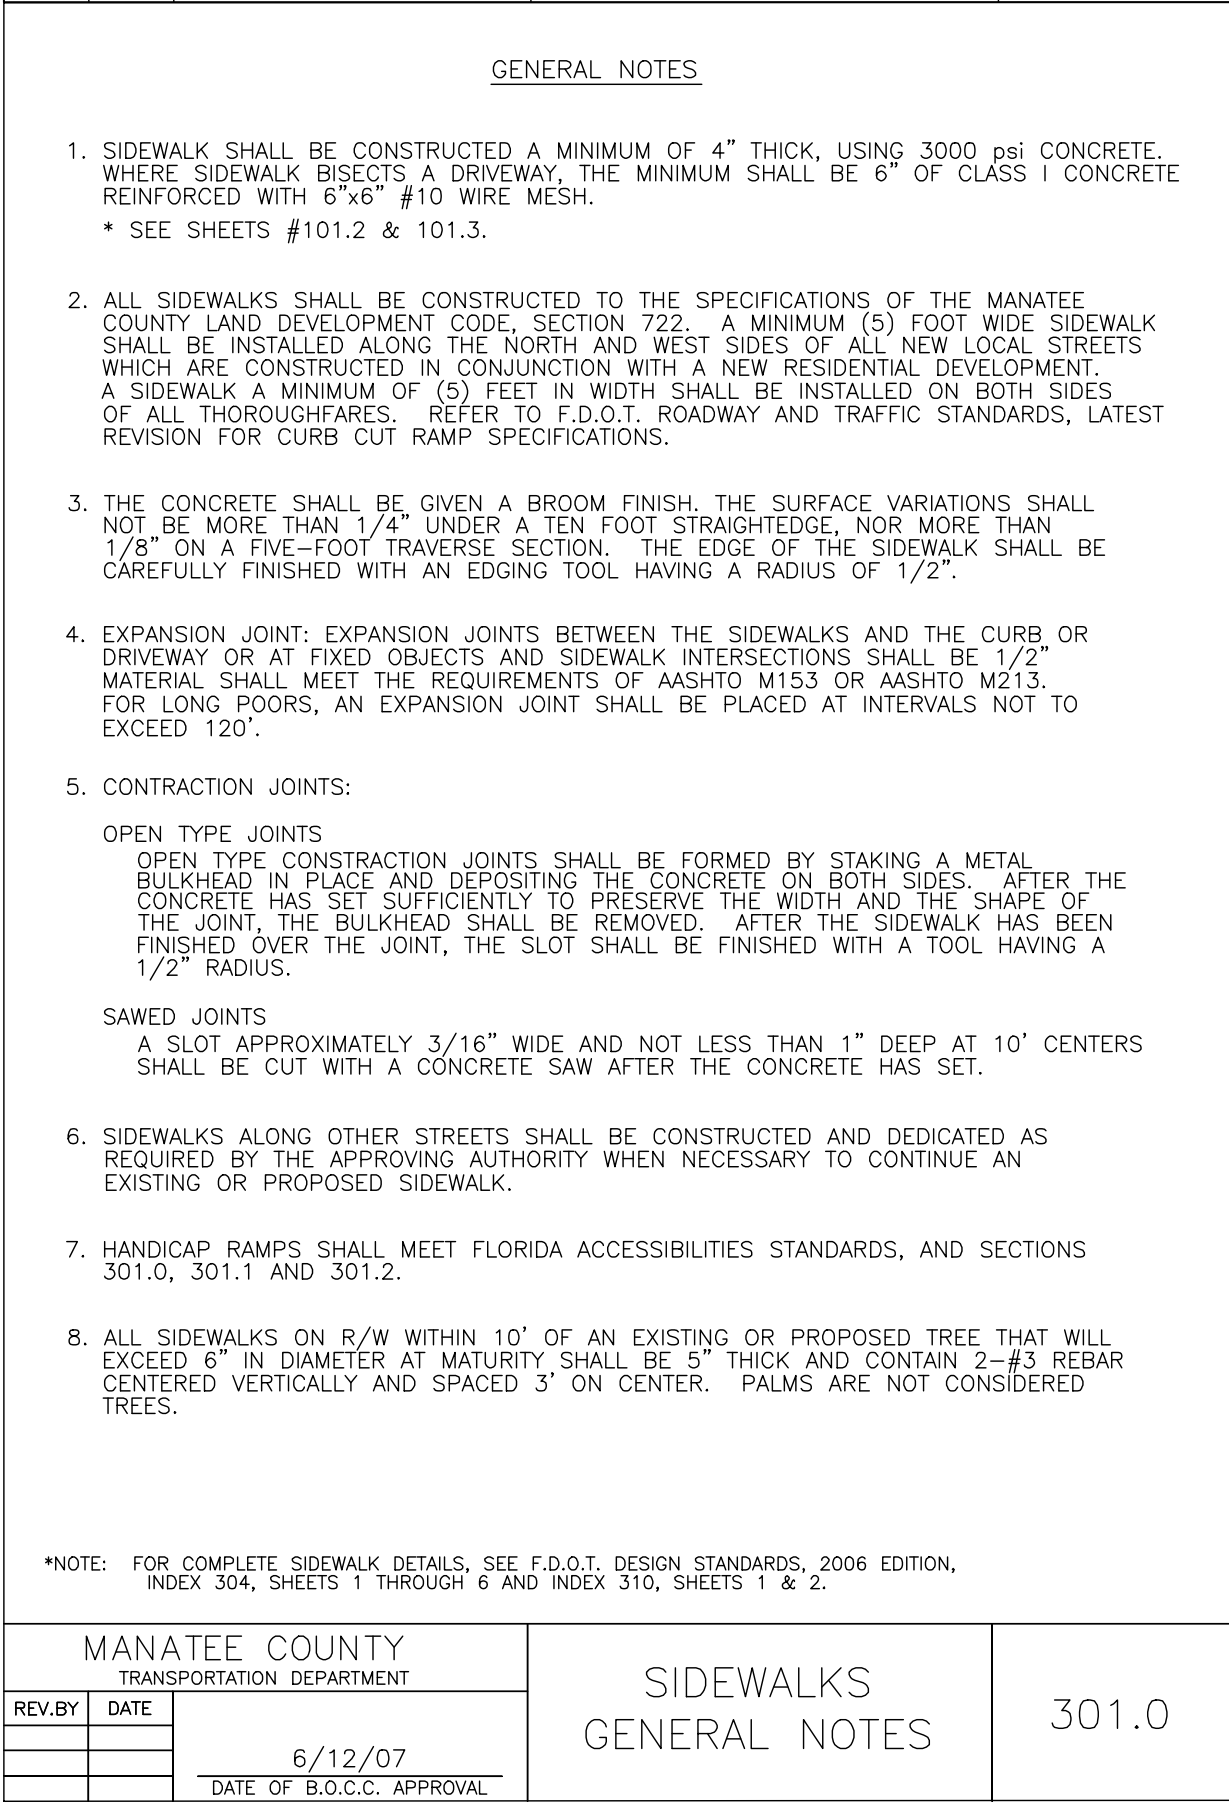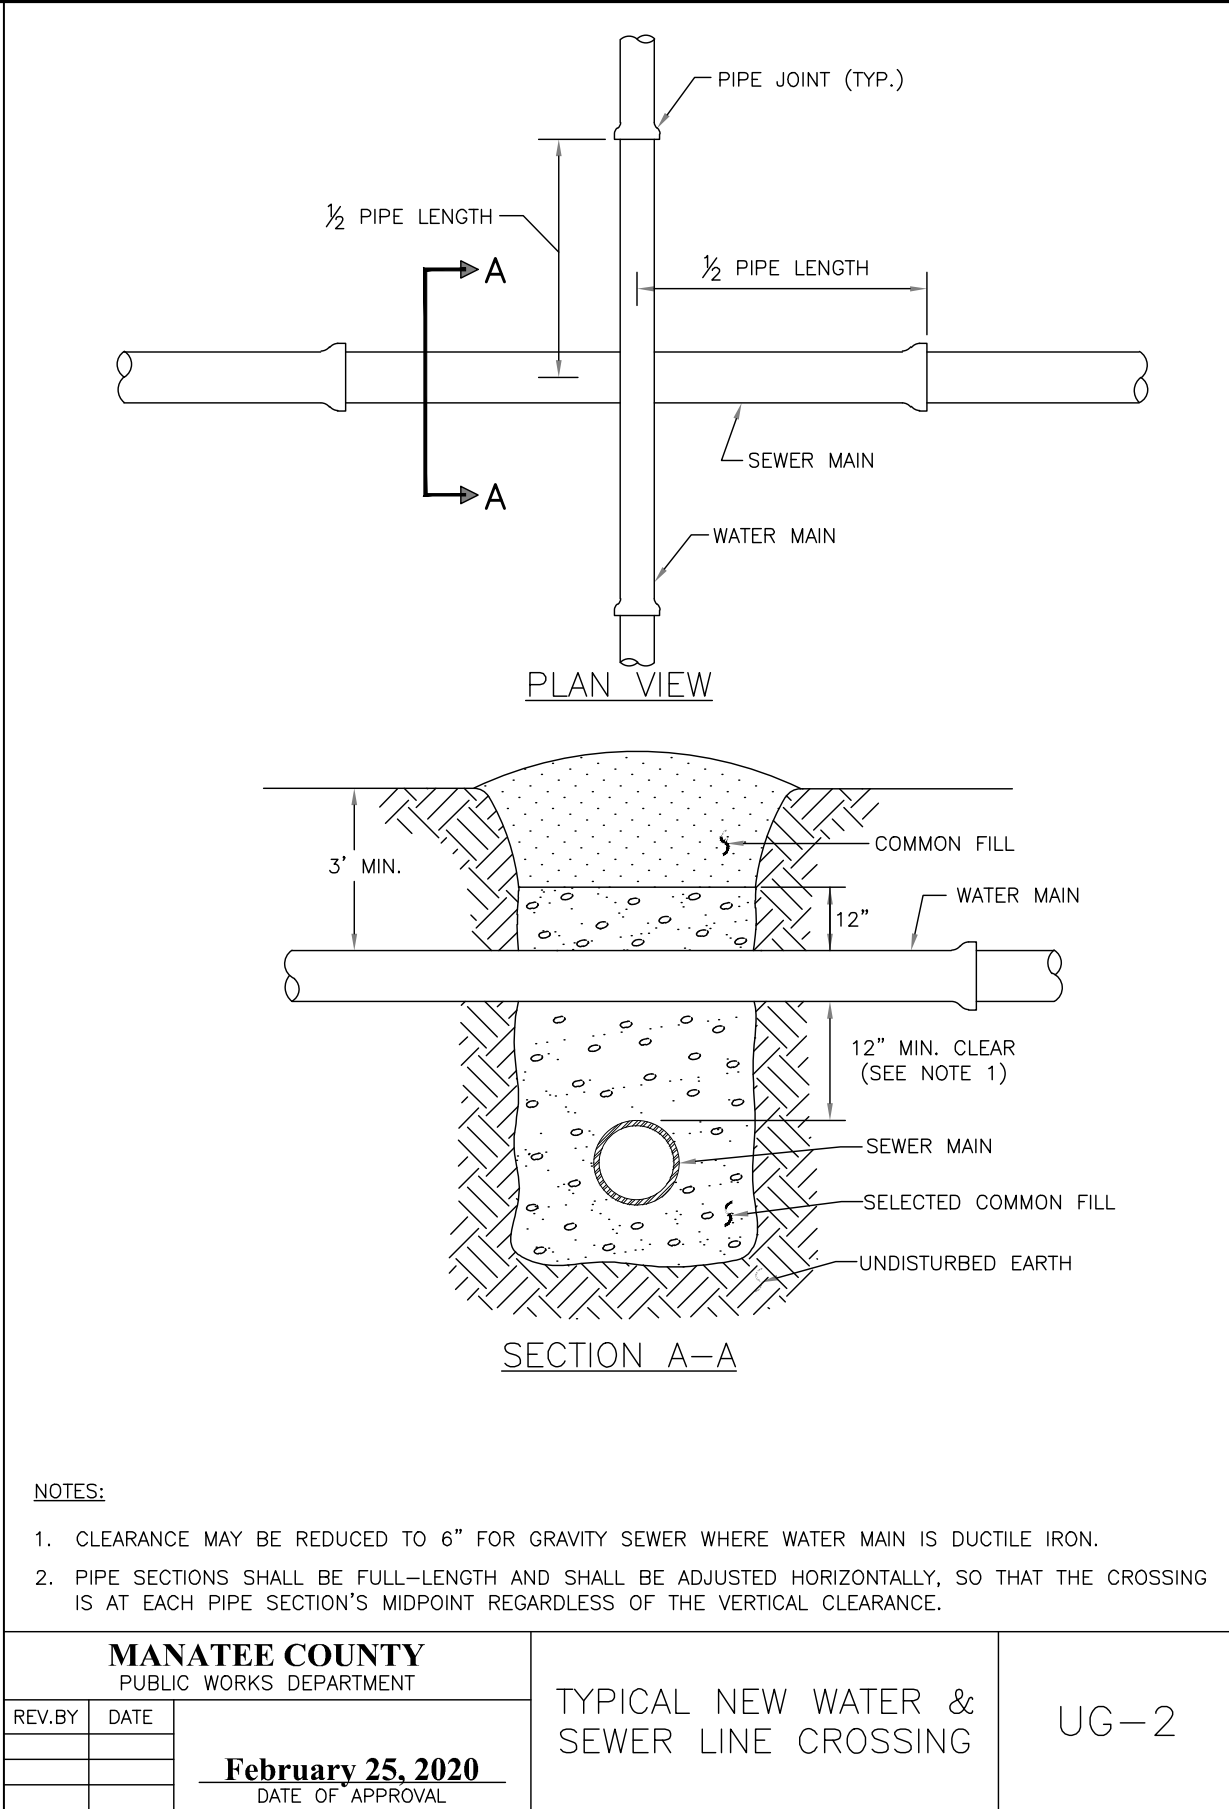
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FL LICENSE NUMBER  
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FL DATE:

CIVIL DETAILS


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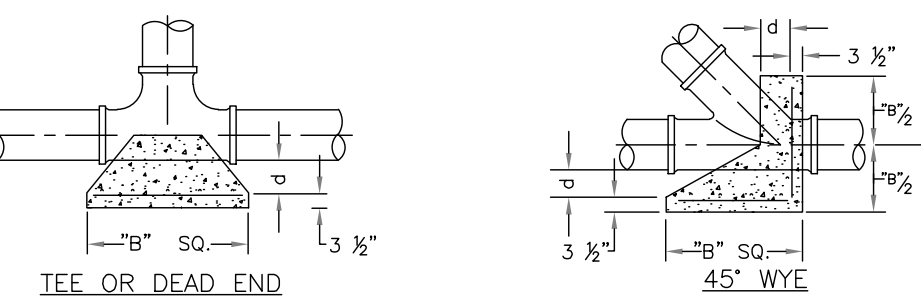
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THRUST BLOCK DIMENSIONS B ft. x d inches									
PIPE SIZE (IN.)	90° BEND		45° BEND		22.5° BEND		11.25° BEND		DEAD END & TEE
	B	d	B	d	B	d	B	d	
4	1.5	3 1/2	1.1	3 1/2	0.8	3 1/2	0.6	3 1/2	1.3 3 1/2
6	2.2	5 1/4	1.6	3 3/4	1.2	3 1/2	0.8	3 1/2	1.9 4 1/2
8	2.9	7	2.1	5	1.5	3 1/2	1.1	3 1/2	2.4 5 1/4
10	3.5	8 1/2	2.6	6 1/4	1.9	4 1/2	1.3	3 1/2	3.0 7 1/4
12	4.2	10	3.1	7 1/2	2.2	5 1/4	1.6	3 3/4	3.5 8 1/4
14	4.9	11 3/4	3.6	8 3/4	2.6	6 1/4	1.8	4 1/4	4.1 9 1/4
16	5.5	13 1/4	4.1	9 3/4	2.9	7	2.1	5	4.7 11 1/4
18	6.2	15	4.6	11	3.3	8	2.3	5 1/2	5.2 12 1/2
20	6.9	16 1/2	5.0	12	3.6	8 3/4	2.6	6 1/4	5.8 14
24	8.2	19 3/4	6.0	14 1/2	4.3	10 1/4	3.1	7 1/2	6.9 16 1/2
30	10.1	24 1/4	7.5	18	5.3	12 1/2	3.8	9	8.5 20 1/2
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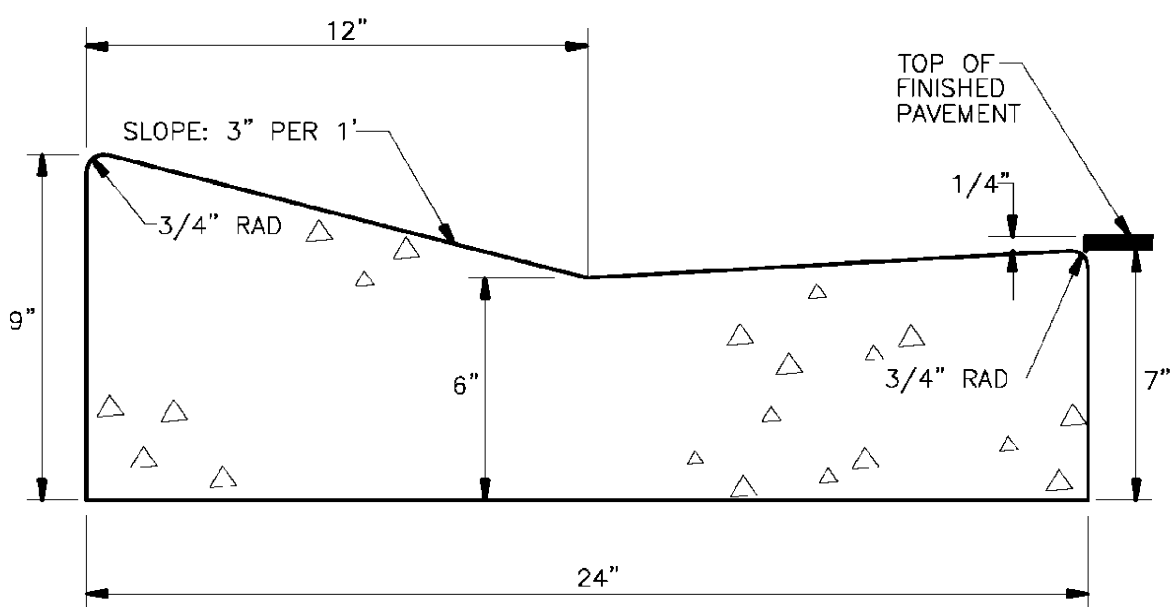


FOR DIM. "B" BETWEEN 5.75' & 12.5' USE #4 @ 8" EACH WAY  
FOR DIM. "B" LESS THAN 5.75' USE #3 @ 8" EACH WAY

- NOTES:
- ALL THRUST BLOCKS SHALL BE CAST IN PLACE. FITTINGS ADJACENT TO THRUST BLOCKS SHALL BE WRAPPED IN POLYETHYLENE.
  - THIS TABLE IS BASED ON WATER PRESSURE=180 PSI WITH AN ALLOWABLE SOIL BEARING PRESSURE=2000 PSF. CONCRETE STRENGTH  $f_c$  =3000 PSI, REINFORCEMENT  $f_y$  =60.0 KSI. THRUST BLOCK SHALL BE CAST AGAINST FIRM UNDISTURBED SOIL.
  - FOR LARGER "B" DIMENSIONS IT IS NECESSARY TO CHECK THAT PIPE IS SUFFICIENTLY DEEP TO ALLOW 15" MIN. SOIL COVER OVER TOP EDGE OF THRUST BLOCK.
  - RESTRAINED JOINTS MAY BE USED IN LIEU OF THRUST BLOCKS TO SAVE SPACE. HOWEVER, WHERE THRUST BLOCKS AND RESTRAINED JOINTS ARE CALLED OUT/ILLUSTRATED IN THE DETAILS, BOTH SHALL BE INSTALLED.



MANATEE COUNTY PUBLIC WORKS DEPARTMENT		CONCRETE THRUST BLOCKS	UG-7
REV. BY	DATE		
	February 25, 2020		
	DATE OF APPROVAL		

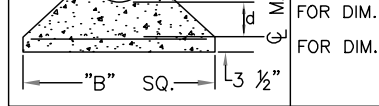

- A) CLASS 1 CONCRETE 3,000 P.S.I. AT 28 DAYS.
- B) CURB AND GUTTER SHALL MEET THE SPECIFICATIONS ESTABLISHED BY FLORIDA D.O.T. STANDARD SPECIFICATIONS PER F.D.O.T. ROADWAY AND TRAFFIC DESIGN STANDARDS INDEX NO. 300, LATEST REVISION.


MANATEE COUNTY TRANSPORTATION DEPARTMENT		TYPE A MIAMI CURB & GUTTER	201.1
REV. BY	DATE		
	6/12/07		
	DATE OF B.O.C.C. APPROVAL		

### REQUIRED LENGTH OF RESTRAINED JOINT PIPE FOR C900-16 PVC PIPE (DR-18)

MAIN PIPE SIZE	HORIZ. BENDS			TEES						REDUCERS						PLUGS & VALVES
	90°	45°	22.5°	SIZE			LENGTH			SIZE			LENGTH			
24	90	38	18	X24 169	X20 132	X16 90	X12 38	X10 6	X20 64	X16 117	X12 158			214		
20	78	32	16	X20 141	X16 101	X12 53	X10 24	X8 6	X16 65	X12 110	X10 149			184		
16	66	27	13	X16 111	X12 67	X10 41	X8 12		X12 64	X10 107	X8 111			151		
12	52	22	10	X12 80	X10 56	X8 31	X6 1		X10 58	X8 62	X6 86			118		
10	44	18	9	X10 63	X8 40	X6 7	X4 1		X8 53	X6 61	X4 81			100		
8	37	15	7	X8 49	X6 18	X4 1			X6 35	X4 60				83		
6	29	12	6	X6 29	X4 1				X4 33					63		
4	21	8	4	X4 12										45		

- NOTES:
- RESTRAIN 11.25° BENDS 50% OF LENGTH FOR 22.5° BENDS.
  - ALL VALVES AND FITTINGS SHALL BE RESTRAINED TO THE CONNECTING SECTIONS OF PIPE.
  - ALL ISOLATION VALVES MUST BE PROPERLY ANCHORED OR RESTRAINED TO RESIST A 180 PSI TEST PRESSURE IN EITHER DIRECTION.
  - PIPE SIZES ARE GIVEN IN INCHES.
  - RESTRAINED PIPE LENGTHS ARE GIVEN IN FEET.
  - LENGTHS SHOWN ARE FOR A TEST PRESSURE OF 180 PSI.
  - THE RESTRAINED LENGTHS SHOWN IN THESE TABLES ARE BASED ON SOIL CLASSIFICATION 'SP' WITH AWWA TYPE 3 TRENCH CONDITIONS, 180 PSI TEST PRESSURE, 3 FEET OF COVER AND 1.5 FACTOR OF SAFETY. ACTUAL BURY CONDITIONS MUST BE DETERMINED BY THE ENGINEER OF RECORD AND THE RESTRAINED LENGTHS MODIFIED ACCORDINGLY.
  - RESTRAINED LENGTHS TO BE APPLIED TO PIPELINES PER DETAIL UG-10 RESTRAINED LENGTHS FOR PIPE.
  - ALL RESTRAINED JOINT HARDWARE SHALL CONFORM TO 1.11.17 OF THE PUBLIC WORKS UTILITIES STANDARDS MANUAL.
  - ALL THREE "LEGS" OF TEES SHALL BE RESTRAINED PER THE STATED LENGTH IN THE TABLE.

MANATEE COUNTY PUBLIC WORKS DEPARTMENT		RESTRAINED LENGTHS FOR PVC PIPE	UG-8
REV. BY	DATE		
	February 25, 2020		
	DATE OF APPROVAL		

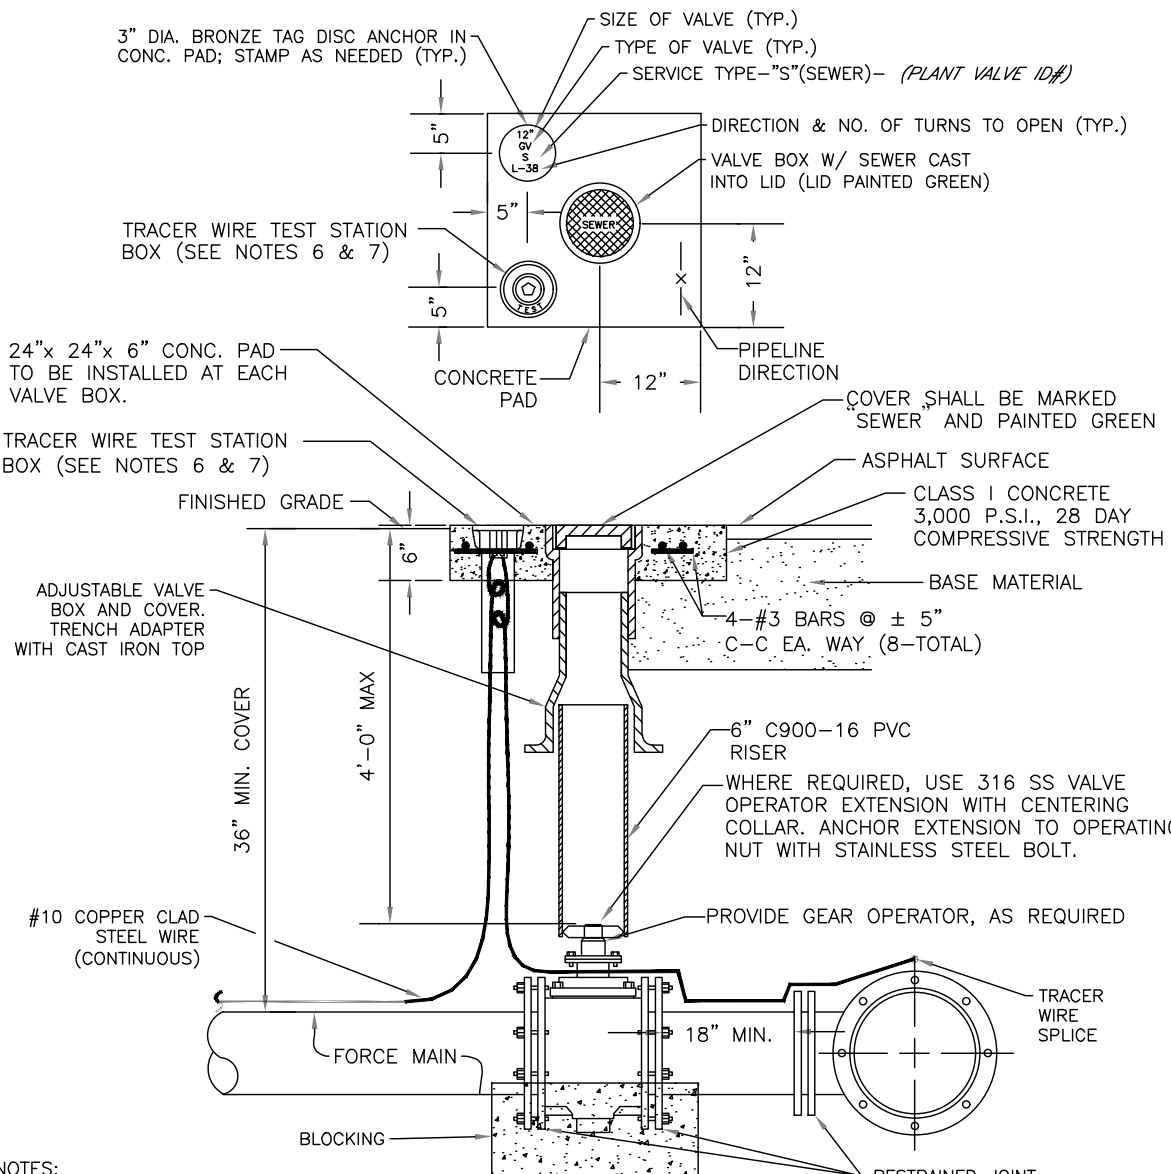


- NOTES:
- "SV" TO BE IMPRESSED INTO THE NEWLY-POURED CONCRETE CURB, ALONG WITH DISTANCE IN FEET TO THE VALVE. IF NO CURB, INSTALL A GREEN DISC WITH "SV" AND A 1/8" x 1" GALVANIZED STEEL SCREW IN THE EDGE OF PAVEMENT WITH THE FOOTAGE FROM THE DISC TO THE VALVE.
  - ALL EXISTING AND PROPOSED VALVE BOXES SHALL BE ADJUSTED TO FINISHED GRADES AS DETERMINED IN THE FIELD.
  - VALVES SHALL NOT BE PLACED IN HANDICAPPED RAMPS, CURBS OR GUTTERS.
  - PRECAST CONCRETE PADS AND THRUST BLOCKS SHALL NOT BE USED.
  - ALL EXPOSED EDGES OF CONCRETE SHALL BE CHAMFERED 1/2".
  - USE NON-TRAFFIC RATED BOXES FOR NORMAL YARD SERVICE WHERE VALVE WILL BE IN STREET OR PARKING UNDER VEHICLE TRAFFIC. USE TRAFFIC RATED BOXES. WHERE POSSIBLE, LOCATE TRACER WIRE TESTING STATION OUTSIDE OF TRAVEL LANE OR IN MEDIAN, CENTERED IN SEPARATE CONCRETE PAD SIMILAR TO STANDARD VALVE BOX PAD.
  - TRACER WIRE BOX SHALL BE LOCATED OUTSIDE THE ROADWAY ON THOROUGHFARES, LOCAL ARTERIAL AND STATE ROADWAYS.
  - THE BRASS TAG SHALL HAVE A "PLANT VALVE ID#" WHEN VALVES ARE INSTALLED WITHIN THE COUNTY TREATMENT PLANT LIMITS. THE PLANT VALVE ID# SHALL BE SHOWN ON THE CONSTRUCTION PLANS AND RECORD DRAWINGS.
  - REFER TO SECTION 1.11 IN THE PUBLIC WORKS UTILITY STANDARDS MANUAL FOR FURTHER DETAILS.

MANATEE COUNTY PUBLIC WORKS DEPARTMENT		VALVE, BOX, COVER AND TAG	US-11
REV. BY	DATE		
	February 25, 2020		
	DATE OF APPROVAL		

### EXTRA REQUIRED LENGTHS OF RESTRAINED JOINT PIPE FOR C900-16 PVC PIPE (DR-18)


(SOURCES: EBAA IRON RESTRAINT LENGTH CALCULATION PROGRAM FOR PVC PIPE, RELEASE 7.1.2)

FITTING TYPE		PIPE SIZE										200 PSI	
		4"	6"	8"	10"	12"	16"	18"	20"	24"	30"	36"	
90° HORIZ. BEND		—	—	—	—	—	—	—	—	—	119	136	
45° HORIZ. BEND		—	—	—	—	—	—	—	—	—	49	56	
22.5° HORIZ. BEND		—	—	—	—	—	—	—	—	—	24	27	
11.25° HORIZ. BEND		—	—	—	—	—	—	—	—	—	12	14	
90° VERT. OFFSET	UPPER BEND	38	53	70	84	99	115	140	153	179	285	330	
	LOWER BEND	38	53	70	84	99	115	140	153	179	285	330	
45° VERT. OFFSET	UPPER BEND	16	22	29	35	41	53	58	64	74	118	137	
	LOWER BEND	4	6	7	9	10	13	14	15	18	29	33	
22.5° VERT. OFFSET	UPPER BEND	8	11	14	17	20	26	28	31	36	57	66	
	LOWER BEND	2	3	4	4	5	6	7	8	9	14	16	
11.25° VERT. OFFSET	UPPER BEND	4	6	7	9	10	13	14	16	18	29	33	
	LOWER BEND	1	1	1	2	3	3	4	4	5	7	8	
PLUG/ IN-LINE VALVE		—	—	—	—	—	—	—	—	—	285	330	
TEE (BRANCH RESTRAINT)	4"X Ø	—	—	—	—	—	—	—	—	—	—	—	
	6"X Ø	—	—	—	—	—	—	—	—	—	—	—	
	8"X Ø	—	—	—	—	—	—	—	—	—	—	—	
	10"X Ø	—	—	—	—	—	—	—	—	—	—	—	
	12"X Ø	—	—	—	—	—	—	—	—	—	—	—	
	16"X Ø	—	—	—	—	—	—	—	—	—	—	—	
	18"X Ø	1	1	24	47	68	104	120	—	—	—	—	
	20"X Ø	—	—	—	—	—	—	—	—	—	—	—	
	24"X Ø	—	—	—	—	—	—	—	—	—	—	—	
	30"X Ø	1	1	1	15	42	84	103	120	152	193	—	
	36"X Ø	1	1	1	1	26	73	93	111	144	187	226	
REDUCER (LARGER PIPE RESTRAINT)	6"X Ø	28	—	—	—	—	—	—	—	—	—	—	
	8"X Ø	50	30	—	—	—	—	—	—	—	—	—	
	10"X Ø	68	52	28	—	—	—	—	—	—	—	—	
	12"X Ø	86	—	—	—	—	—	—	—	—	—	—	
	16"X Ø	117	107	—	—	—	—	—	—	—	—	—	
	18"X Ø	131	122	110	95	76	29	—	—	—	—	—	
	20"X Ø	146	138	—	—	—	—	29	—	—	—	—	
	24"X Ø	173	166	157	146	132	—	—	—	—	—	—	
200 PSI	30"X Ø	279	272	262	251	237	201	179	155	100	—	—	
	36"X Ø	325	320	312	303	291	262	245	225	181	100	—	

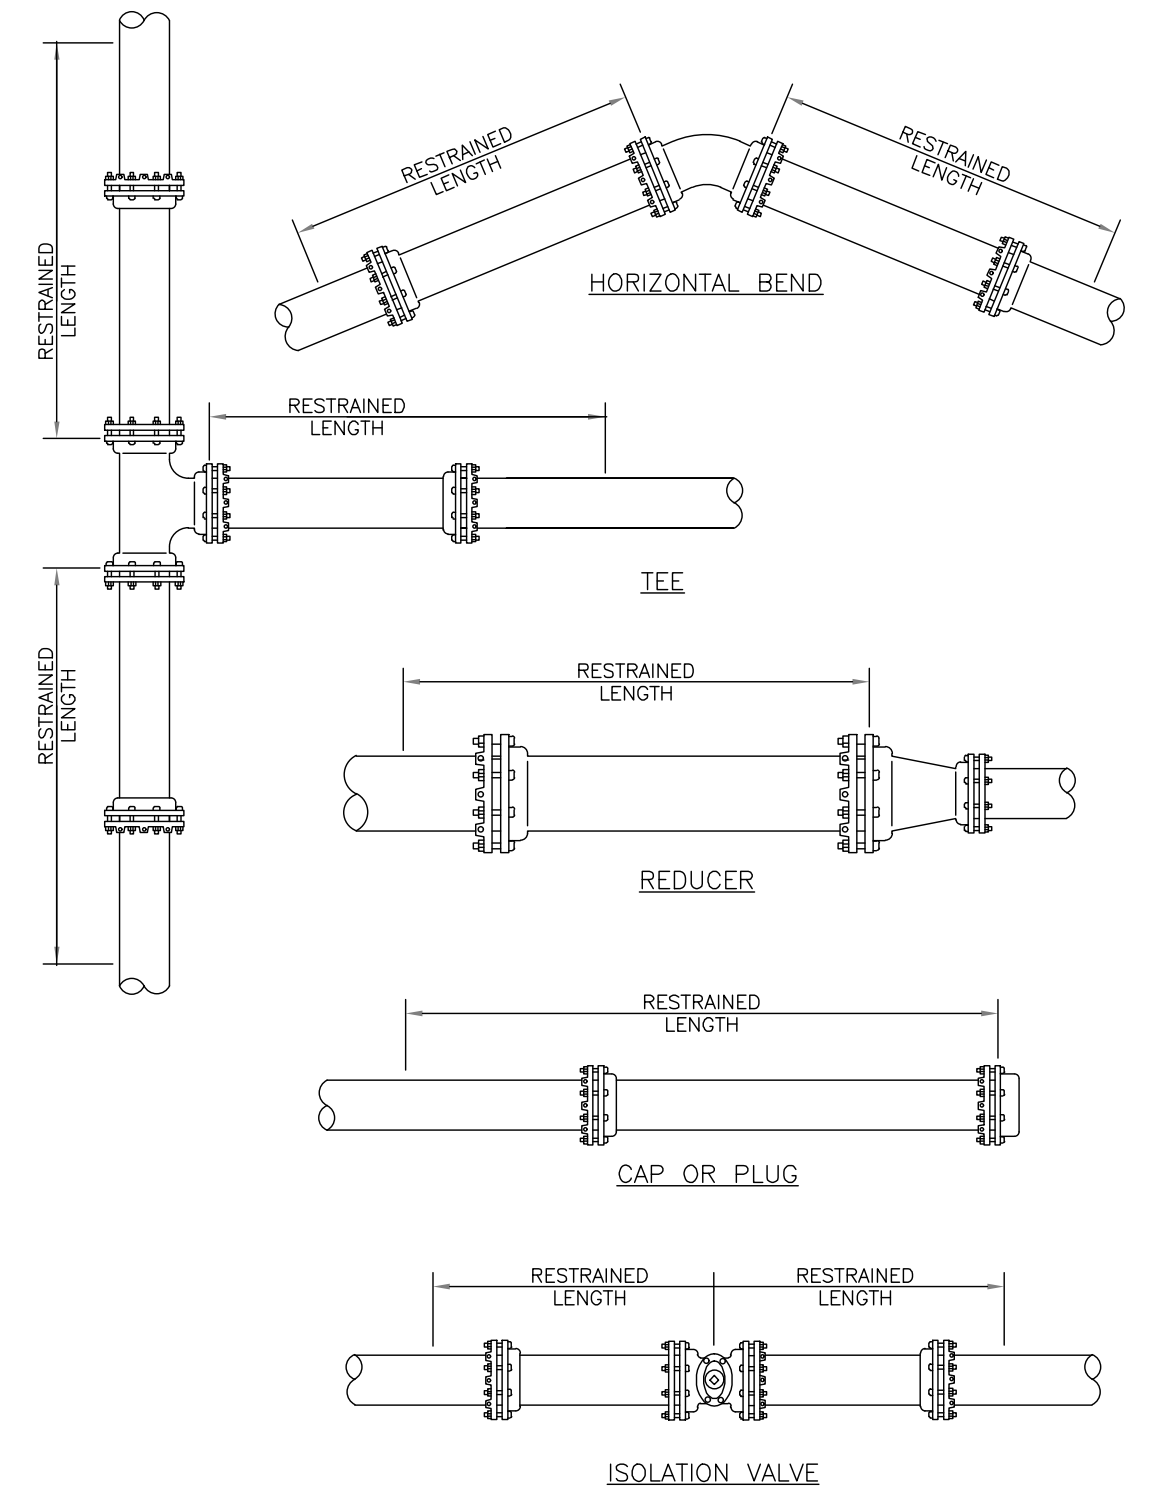


- NOTE:
- SEE DETAIL UG-8 RESTRAINED LENGTHS FOR PVC PIPE FOR NOTES 1 THROUGH 9 THAT ARE ALSO APPLICABLE TO RESTRAINED LENGTHS FOR PIPE.

MANATEE COUNTY PUBLIC WORKS DEPARTMENT		RESTRAINED LENGTHS FOR PIPE	UG-10
REV. BY	DATE		
	February 25, 2020		
	DATE OF APPROVAL		

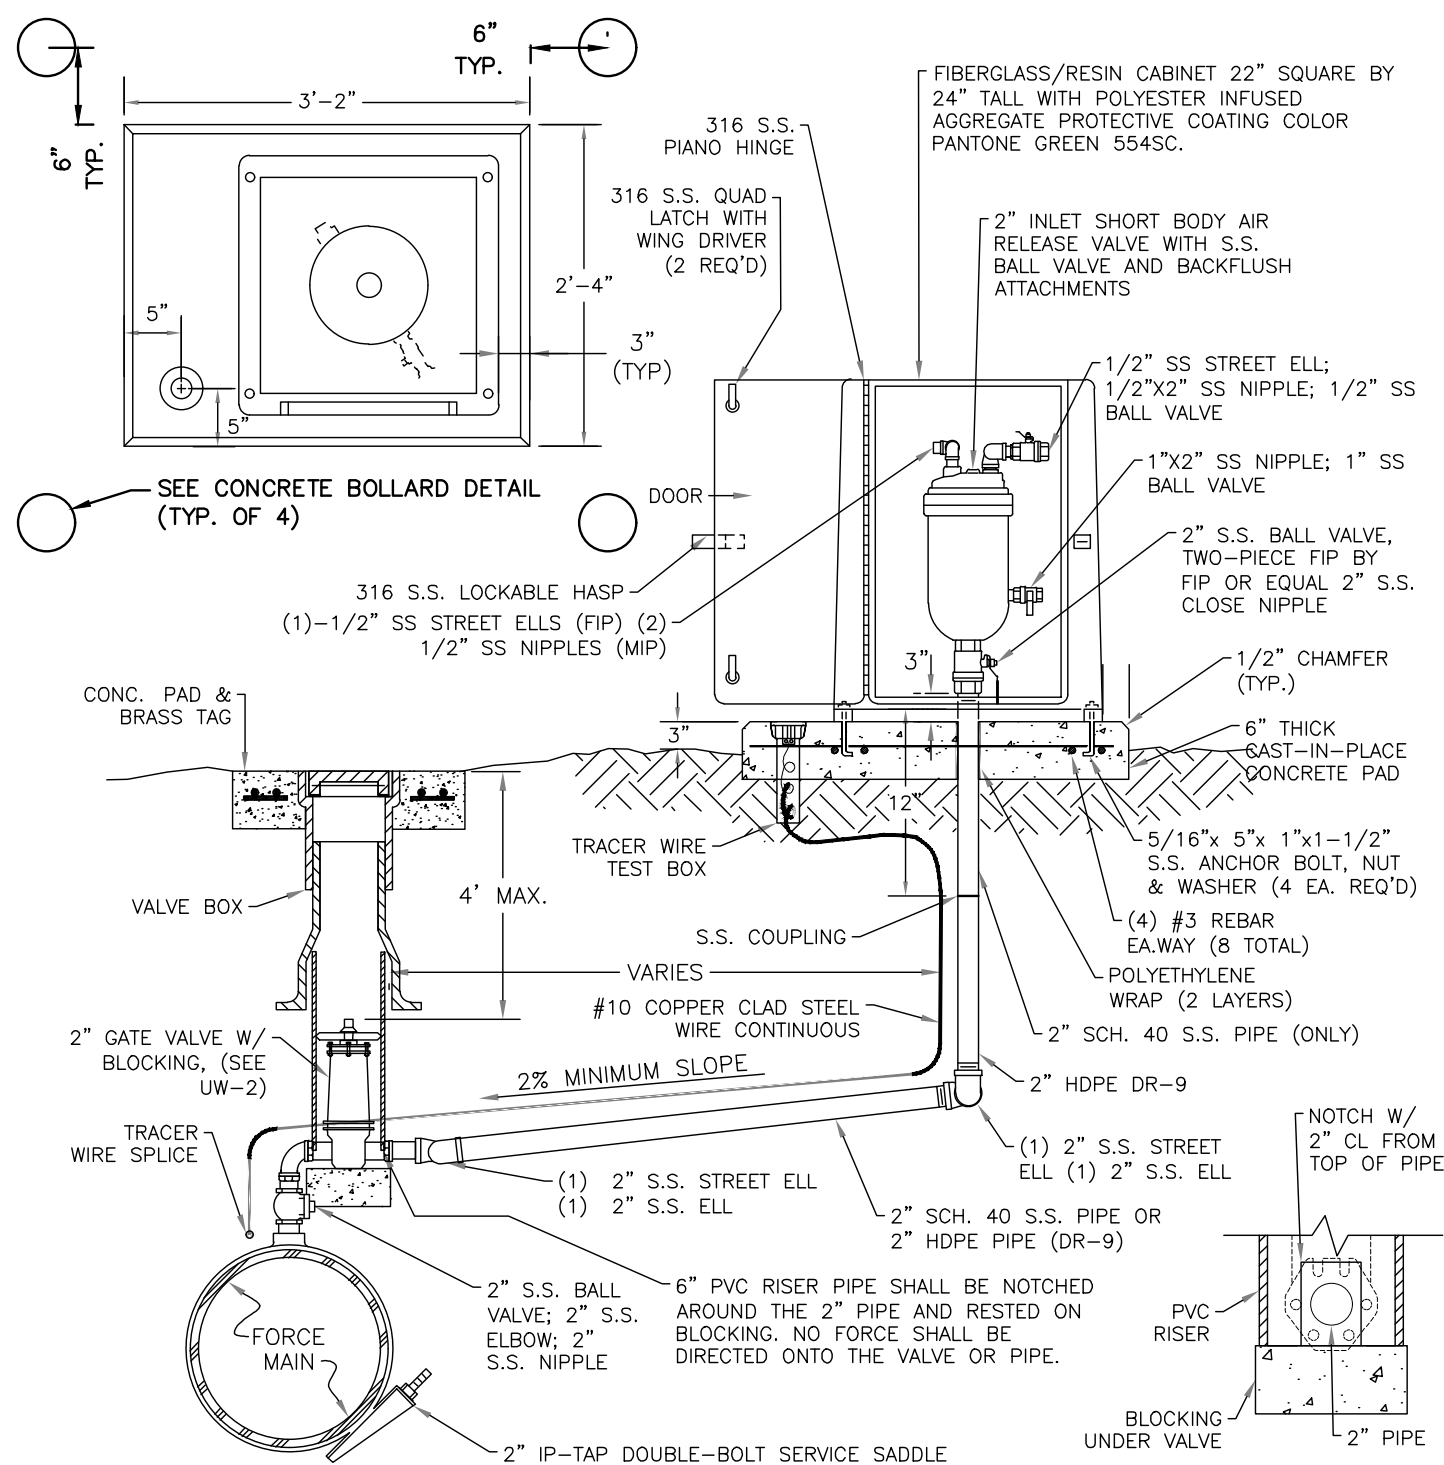

- NOTES:
- AIR RELEASE VALVES TO BE ABOVE-GROUND INSTALLATIONS, UNLESS IMPRACTICAL. INSTALLATIONS MAY BE BELOW-GROUND ONLY WHERE APPROVED AND SPECIFICALLY INDICATED ON THE PLAN.
  - AIR RELEASE VALVES TO BE INSTALLED AT HIGH POINTS, OR WHERE AIR WOULD BE ENTRAPPED, ALONG 4" AND LARGER FORCE MAINS.
  - FORCE MAIN VERTICAL ALIGNMENT TO BE DESIGNED SUCH THAT THE MINIMUM NUMBER OF REQUIRED AIR RELEASE VALVES ARE INSTALLED.
  - ALL INCIDENTAL FITTINGS AND HARDWARE TO BE 316 STAINLESS STEEL.
  - ALL PIPE THREADS TO BE SEALED AIR TIGHT.
  - VENT PIPE TO BE LAID ACCURATELY ON SLOPE, WITHOUT HIGH OR LOW POINTS.
  - CONCRETE PAD SHALL BE TYPE I CONCRETE W/ 3,000 P.S.I., 28 DAY COMPRESSIVE STRENGTH.
  - ARV SHALL BE INSTALLED MINIMUM 6 FT FROM EDGE OF PAVEMENT; 10 FT MAXIMUM FROM BACK OF CURB; 4 FT MIN. MAY BE APPROVED BY UTILITIES IN SOME EXISTING AREAS.
  - SEE US-11 VALVE, BOX, COVER AND TAG STANDARD DETAIL. CENTERING COLLAR IS NOT REQUIRED ON 2" GATE VALVES.

### ABOVEGROUND AIR RELEASE ASSEMBLY FOR FORCE MAINS

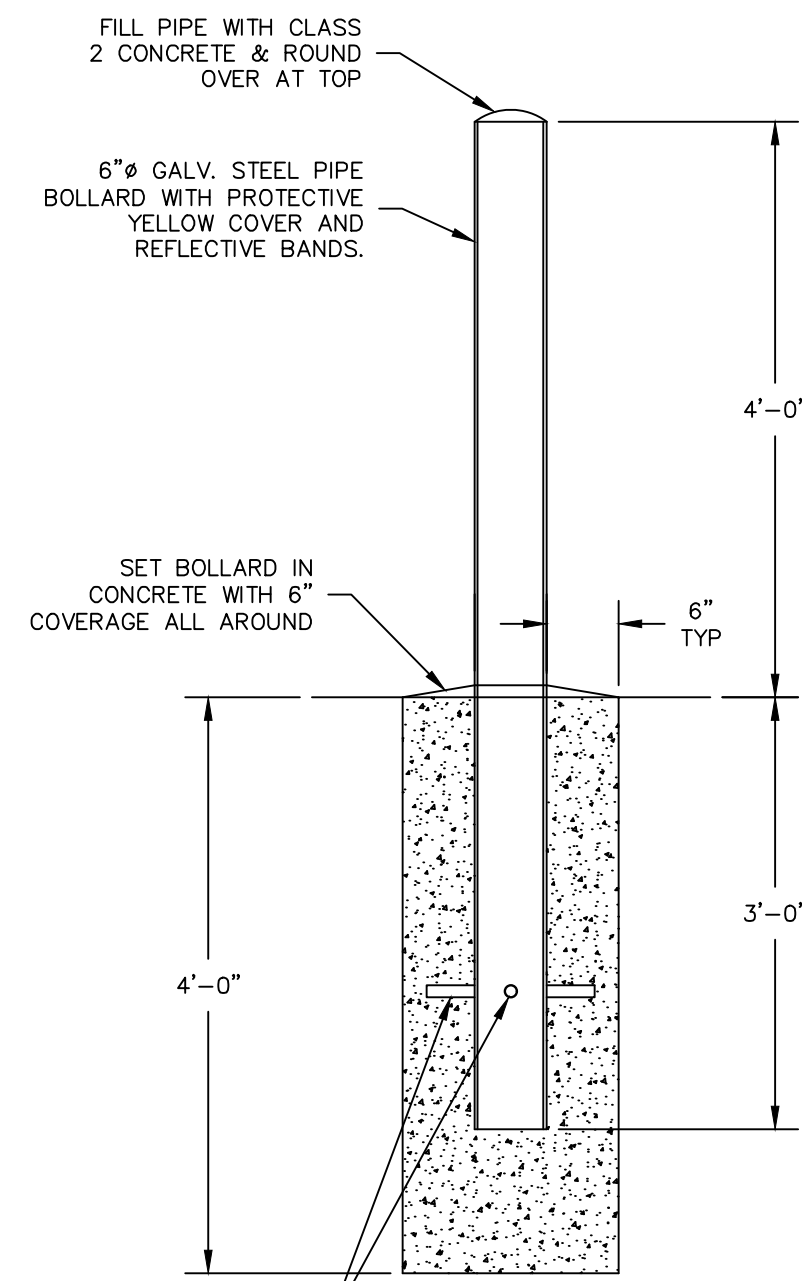

- NOTES:
- GRIND ALL EDGES SMOOTH
  - COAT IN ACCORDANCE WITH CONTRACT SPECIFICATIONS

CONCRETE FILLED BOLLARD DETAILS  
N.T.S.

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WWW.KIMLEY-HORN.COM REGISTRY NO. 35106

KHA PROJECT  
148400067  
DATE  
FEB 2022  
SCALE AS SHOWN  
DESIGNED BY MAS  
DRAWN BY GMB  
CHECKED BY SNR

**BAYSHORE YACHT BASIN FORCE MAIN  
AND LIFT STATION REPLACEMENT**  
MANATEE COUNTY



LICENSED PROFESSIONAL  
MICHAEL A. SEMAGO, P.E.  
FL LICENSE NUMBER  
87501  
FL DATE:







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**Manatee County**

**BAYSHORE YACHT BASIN FORCE MAIN AND LIFT STATION REPLACEMENT**

MANATEE COUNTY

LICENSED PROFESSIONAL

MICHAEL A. SEMAGO, P.E.

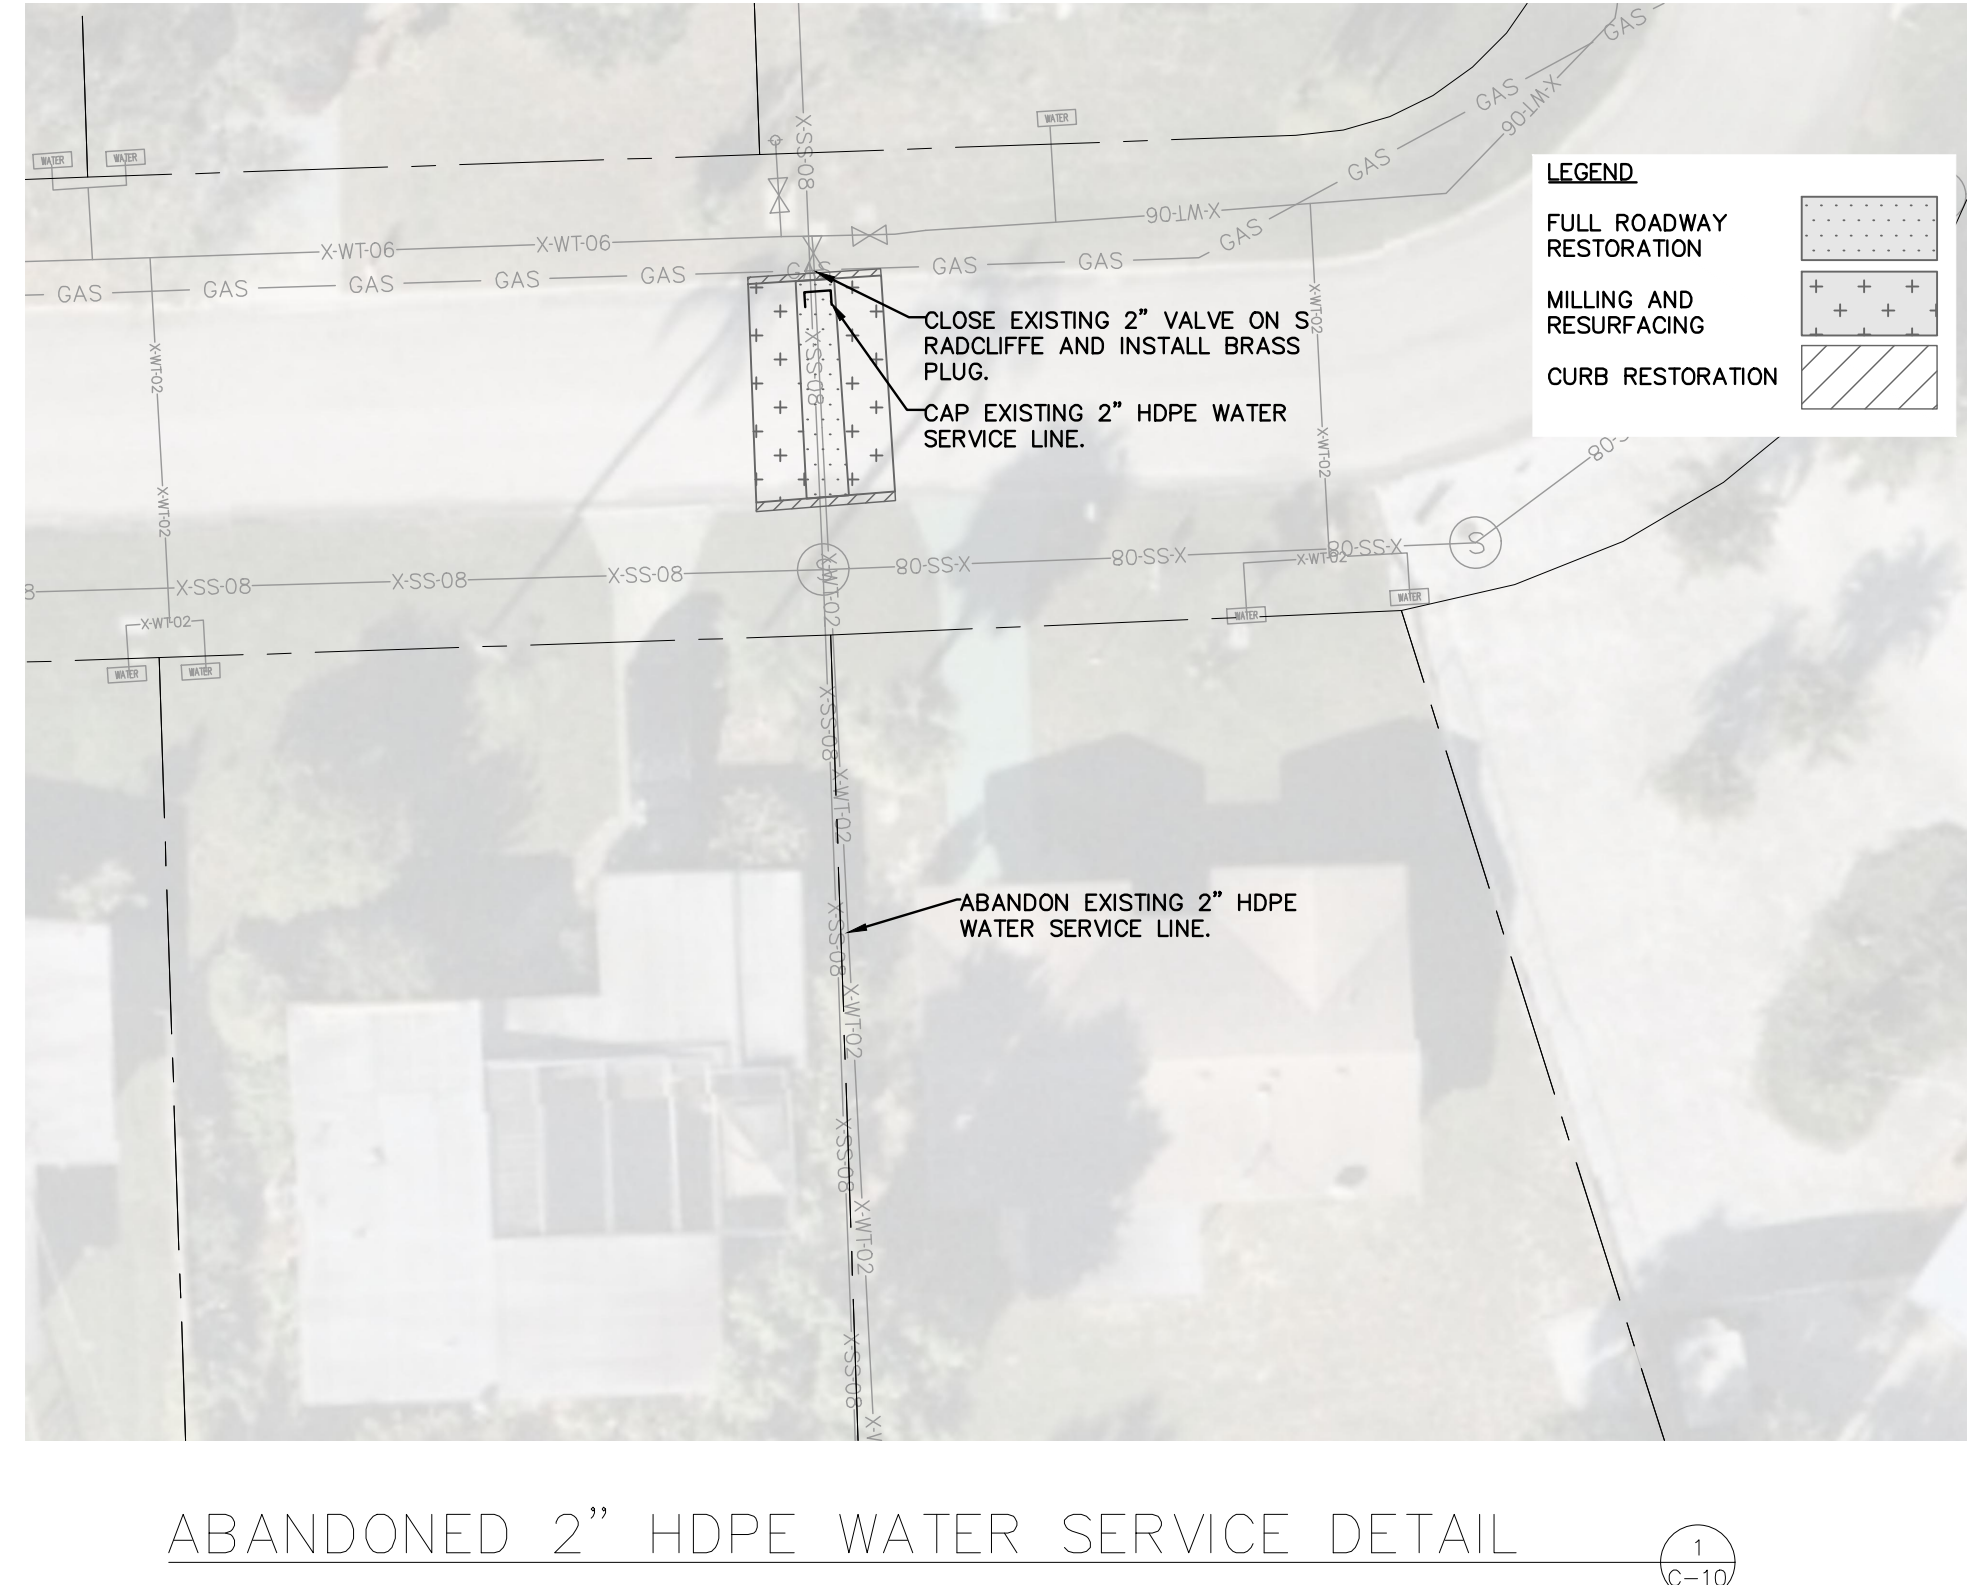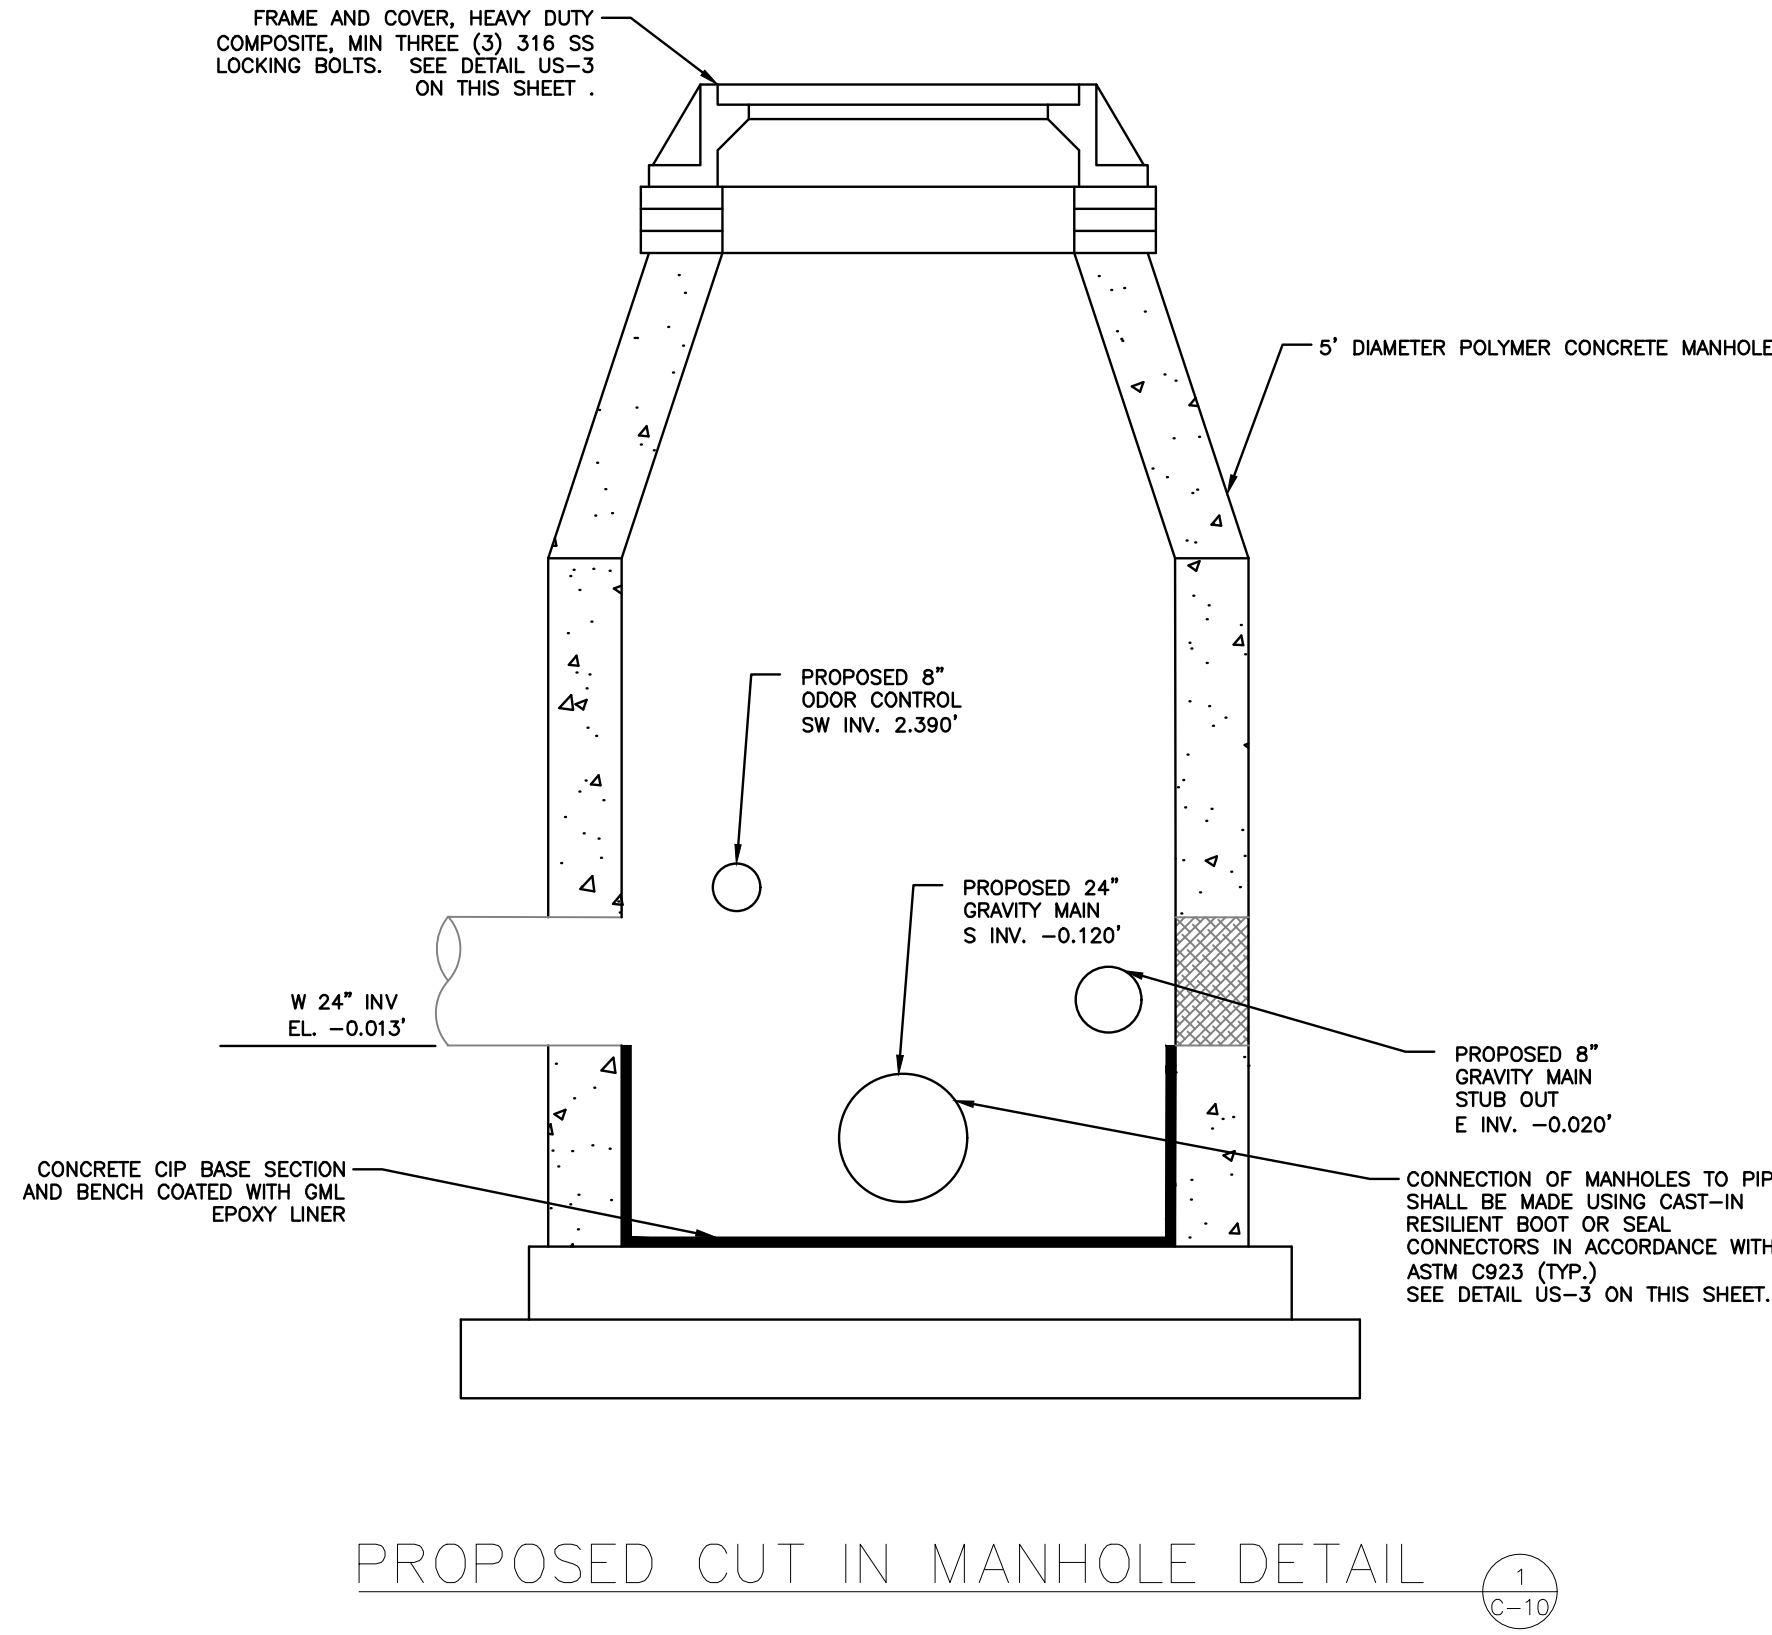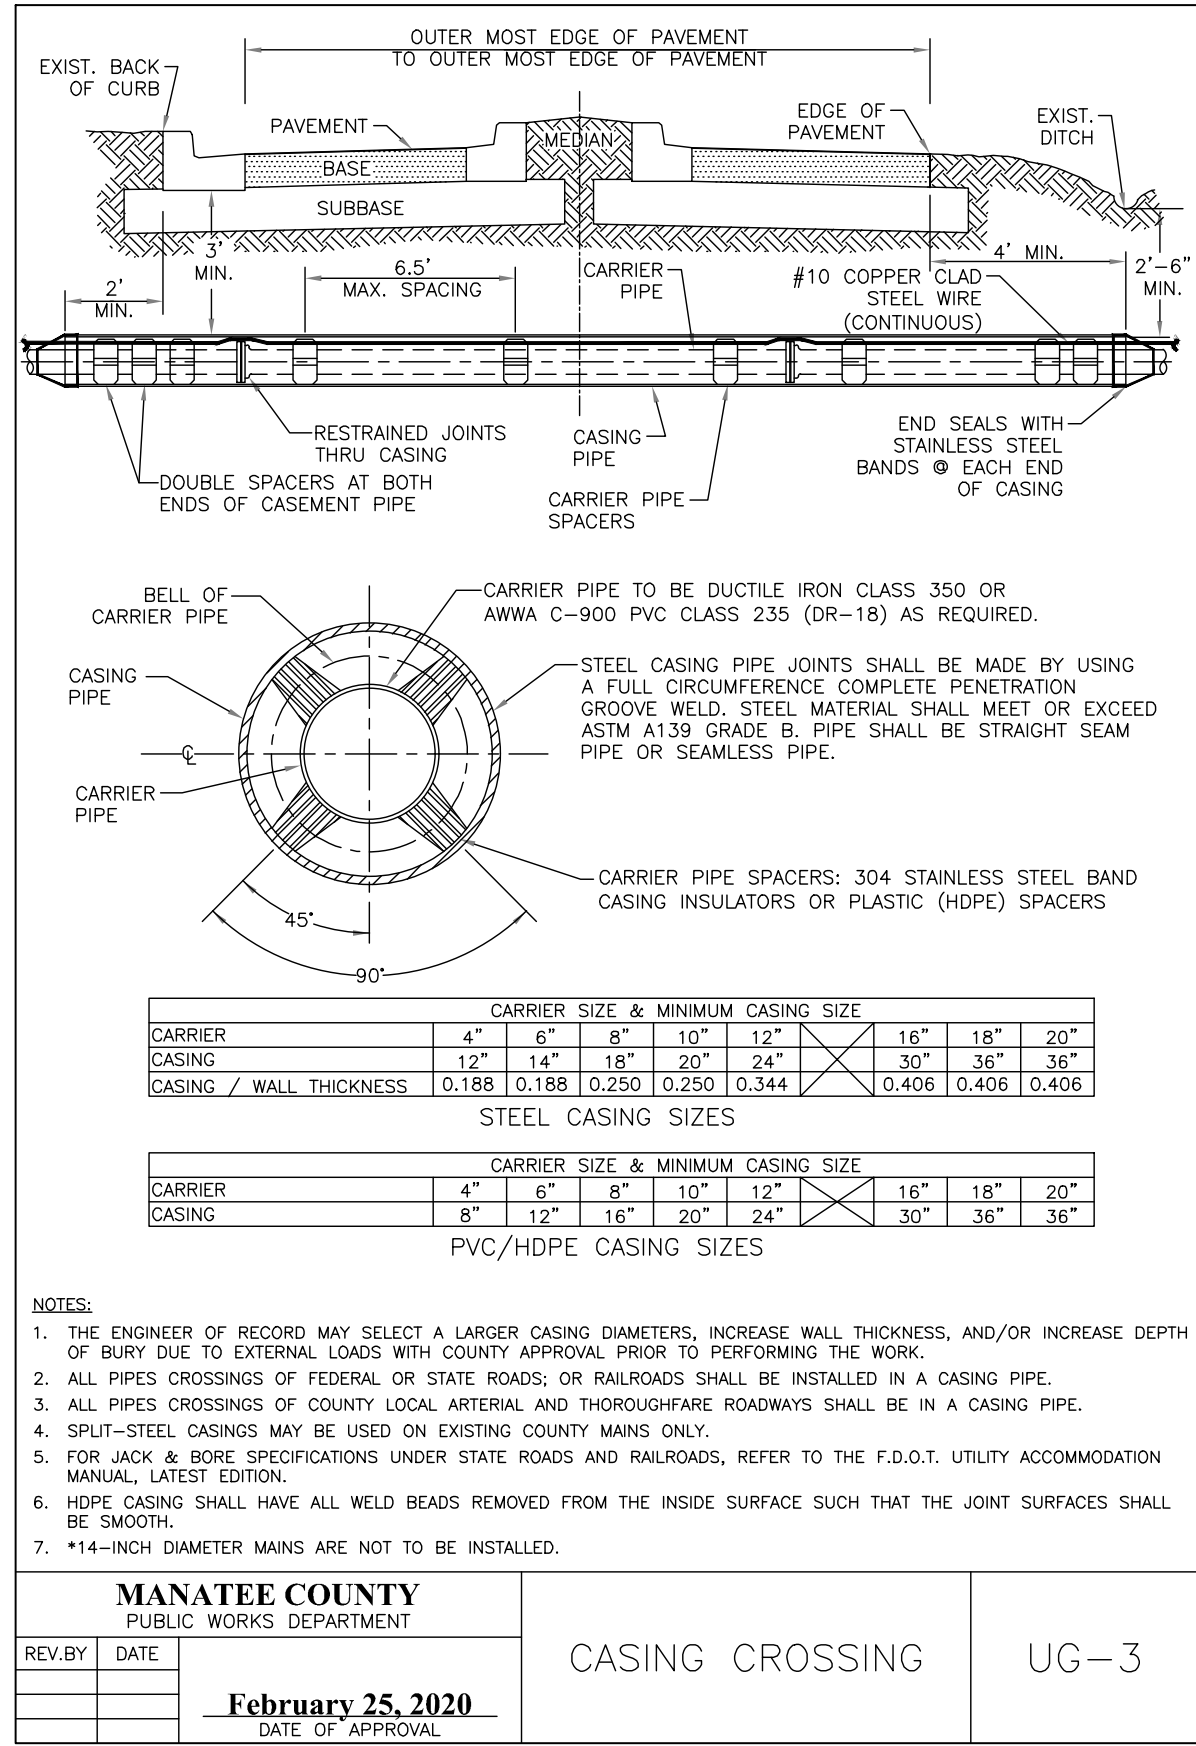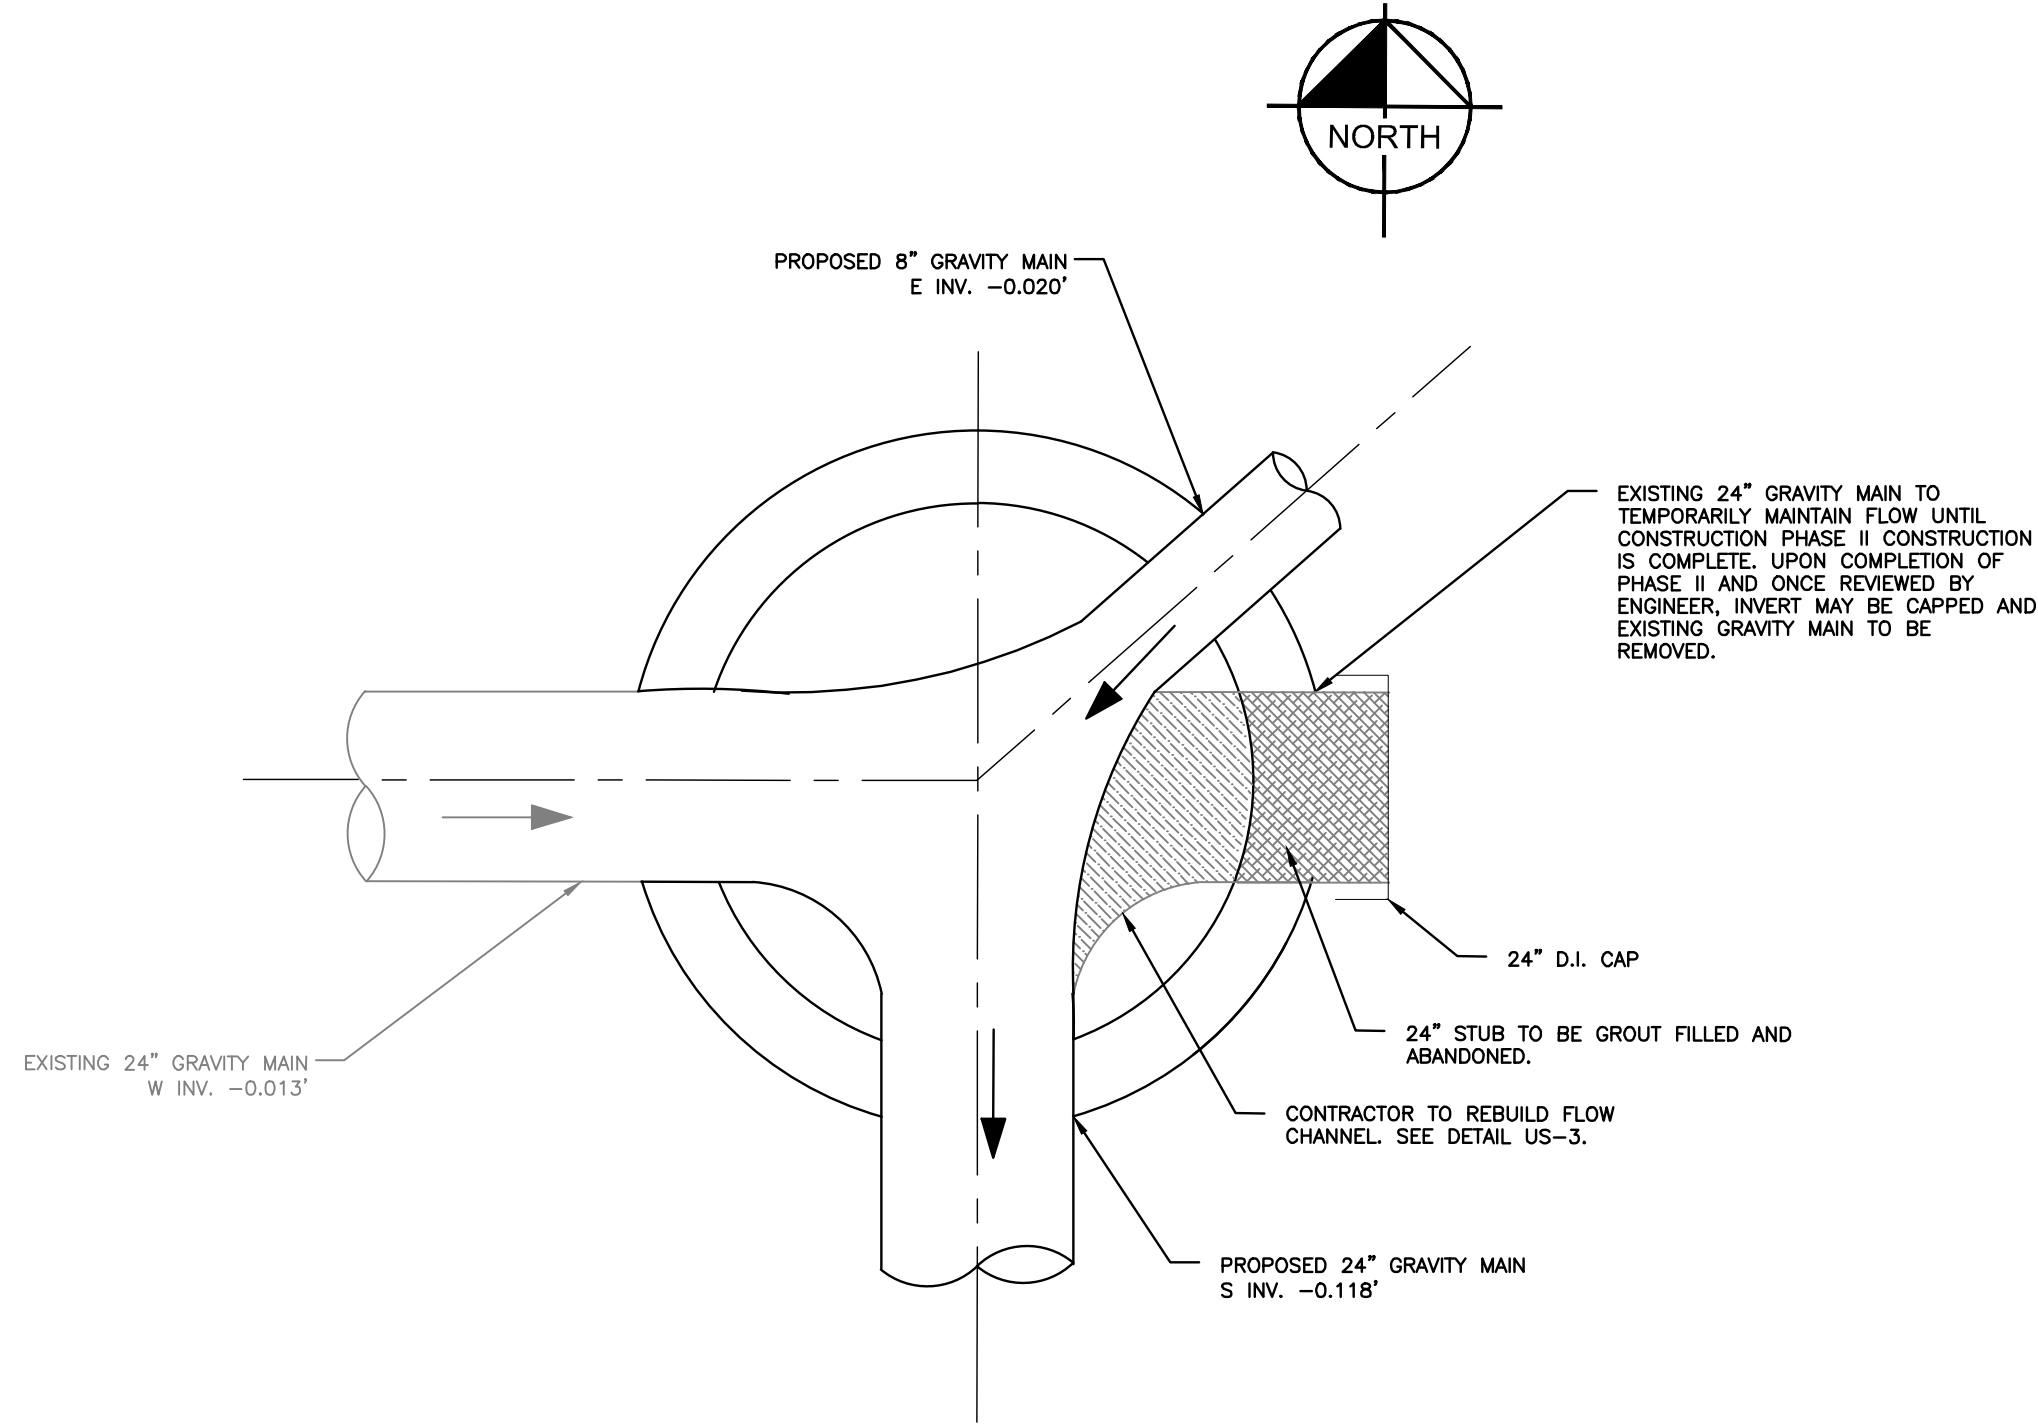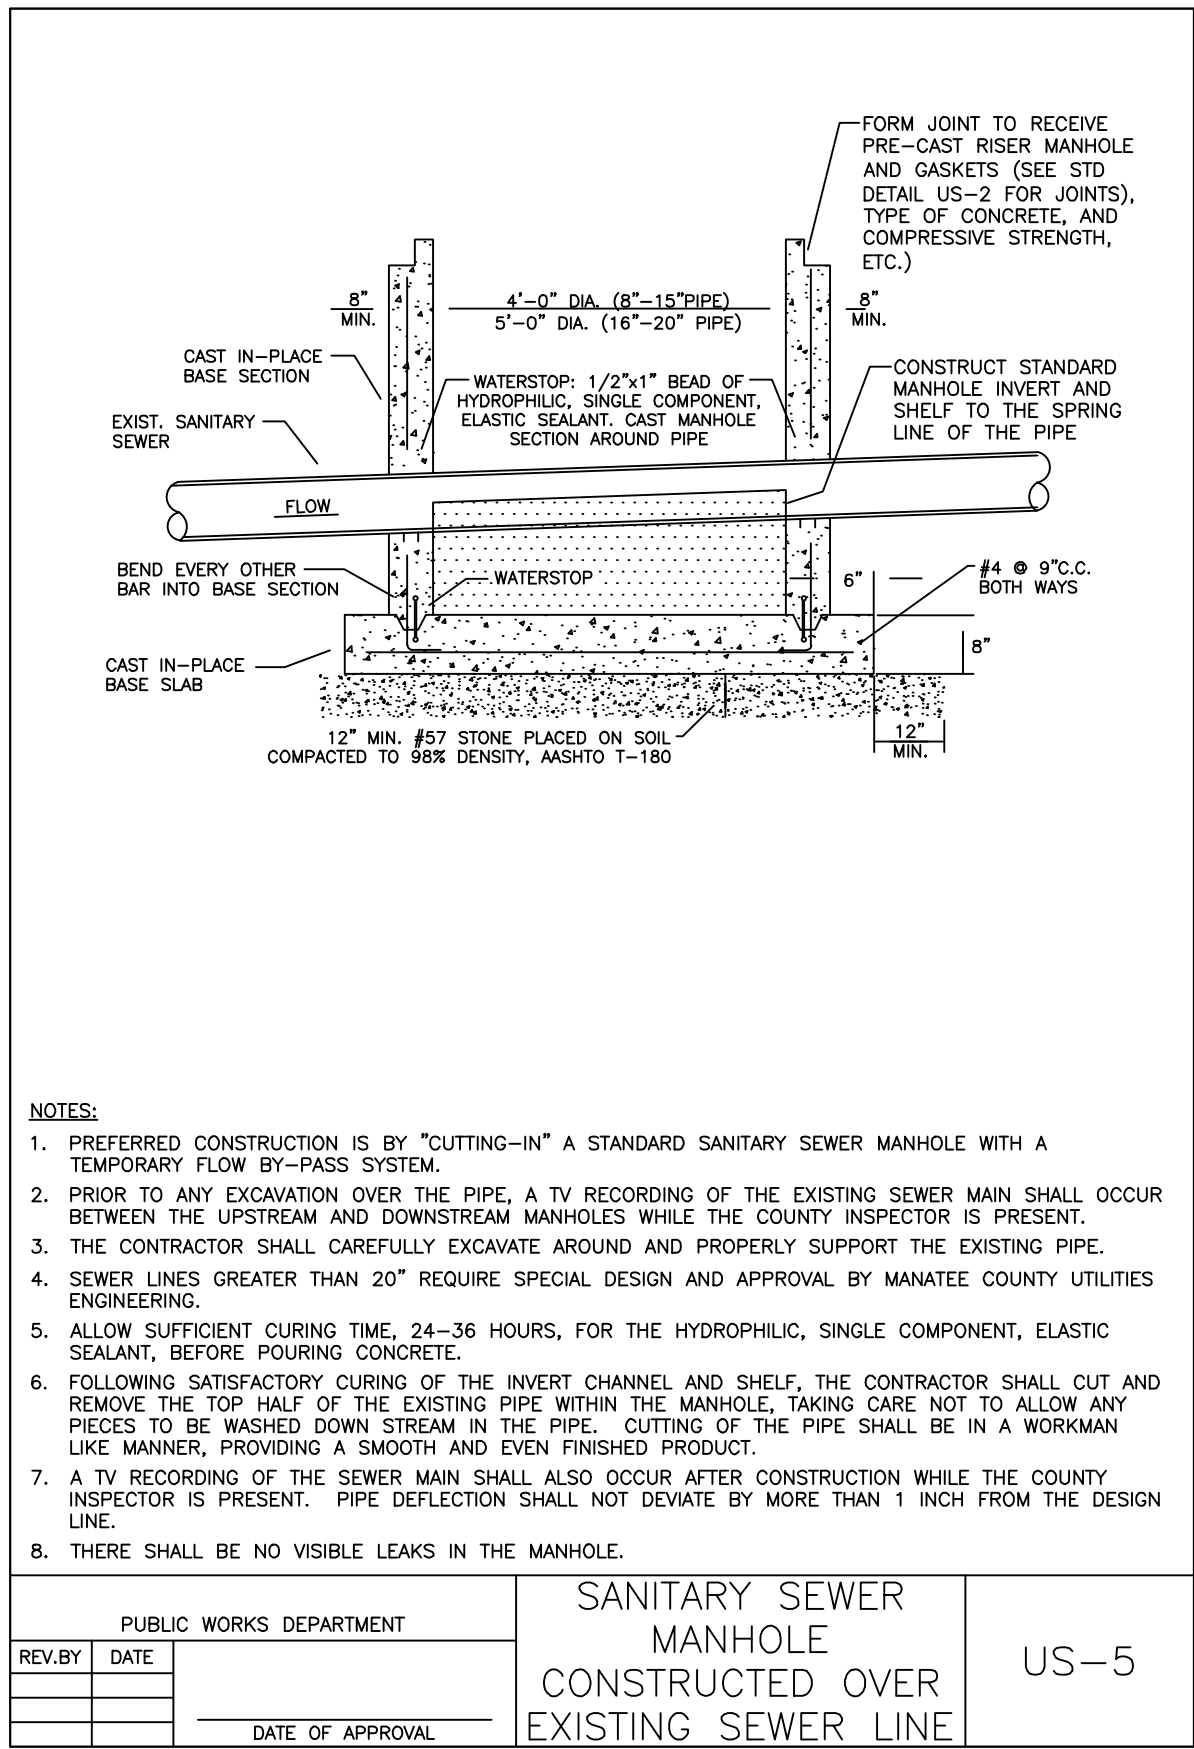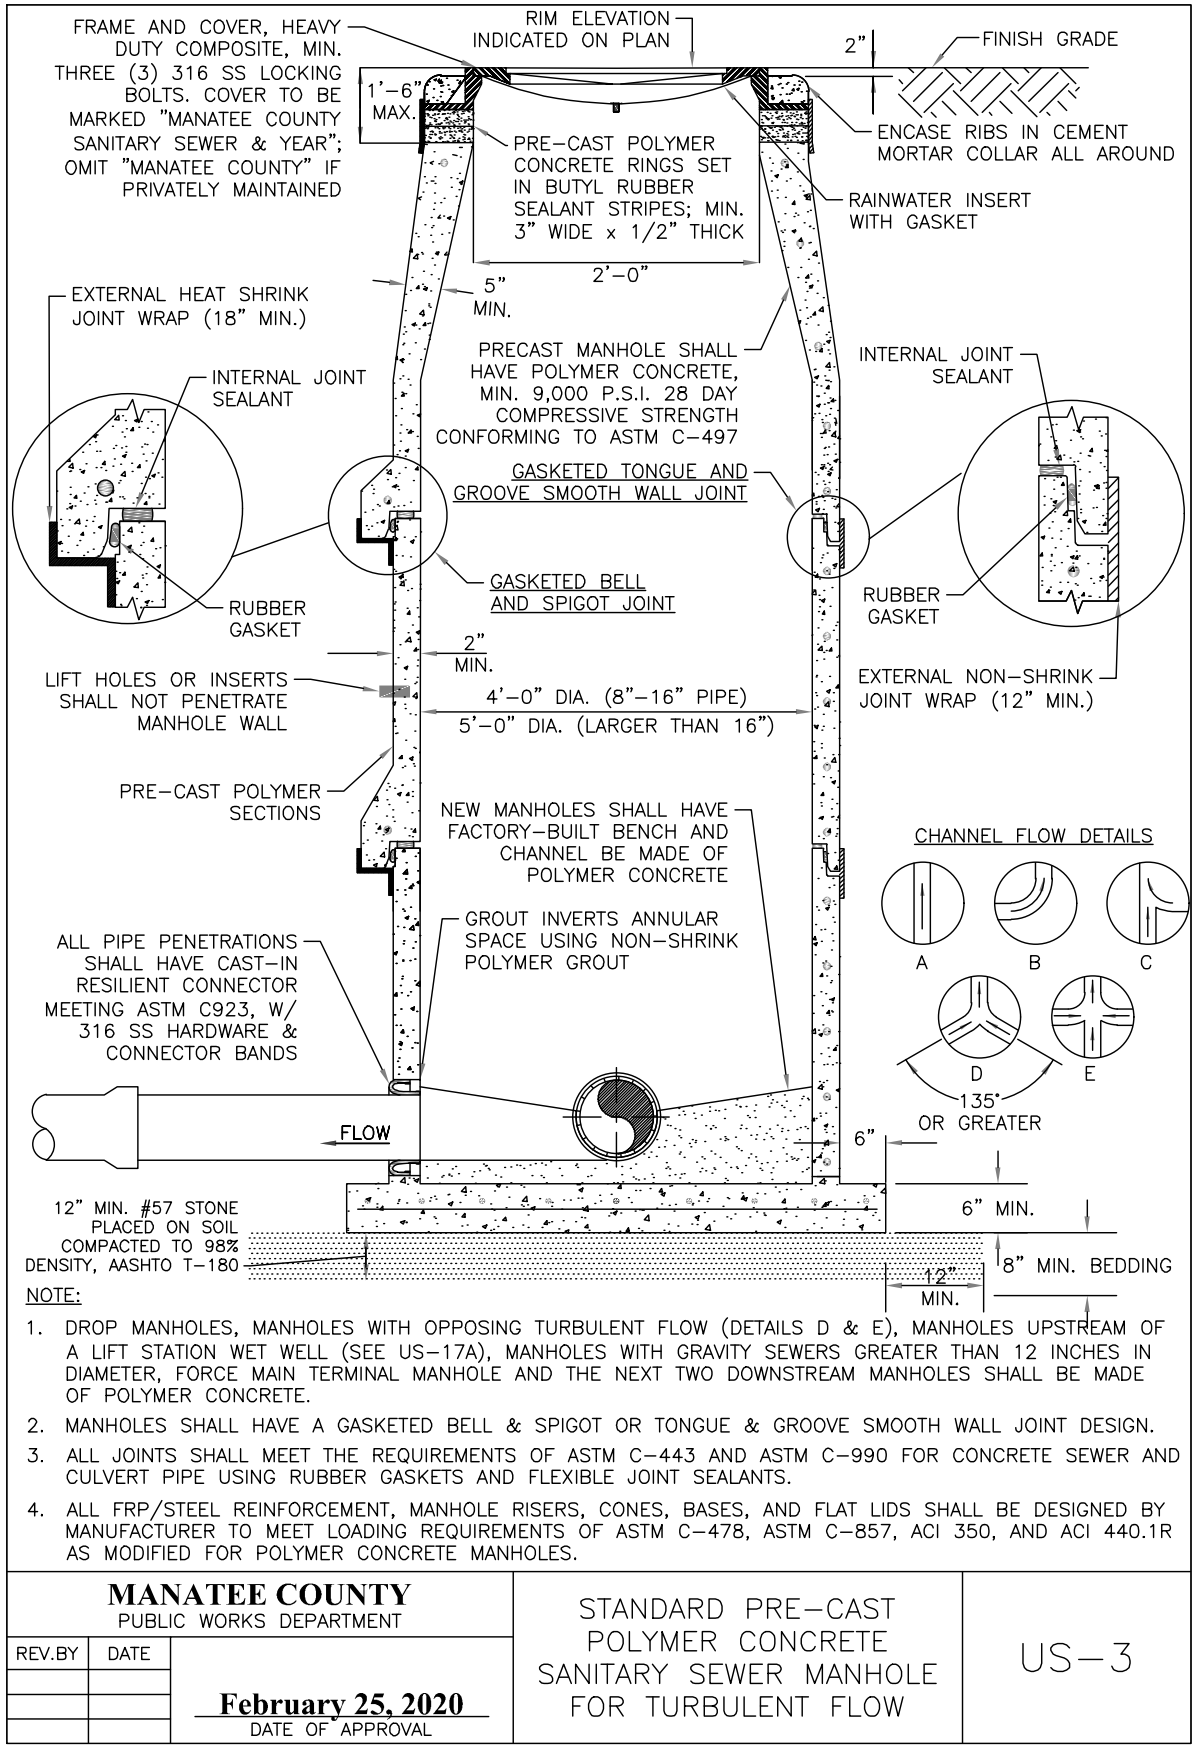FL LICENSE NUMBER 87501

FL DATE:








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Manatee  
County  
FLORIDA

BAYSHORE YACHT BASIN FORCE MAIN  
AND LIFT STATION REPLACEMENT

MANATEE COUNTY



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DATE FEB 2022
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DESIGNED BY: MAS
DRAWN BY: RLL
CHECKED BY: SNR

  
**BAYSHORE YACHT BASIN FORCE MAIN  
AND LIFT STATION REPLACEMENT**  
MANATEE COUNTY FL

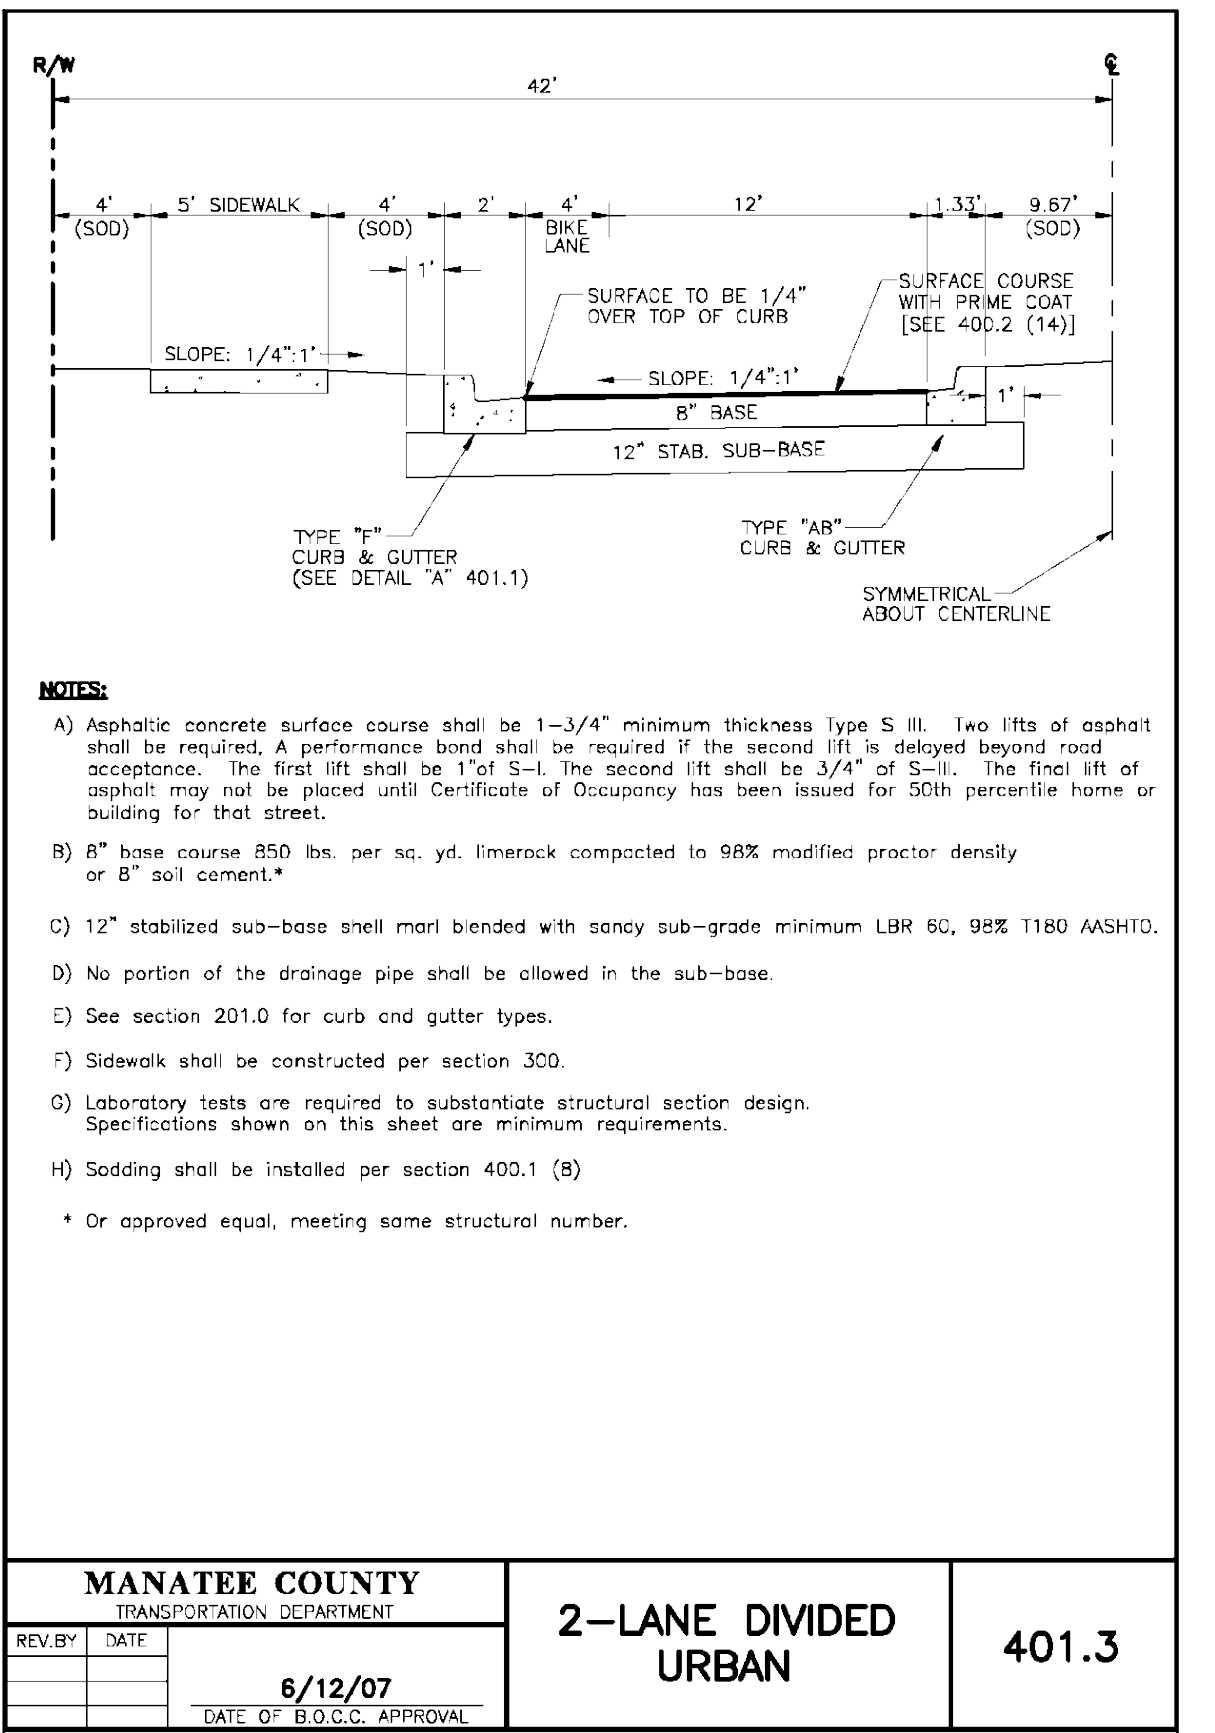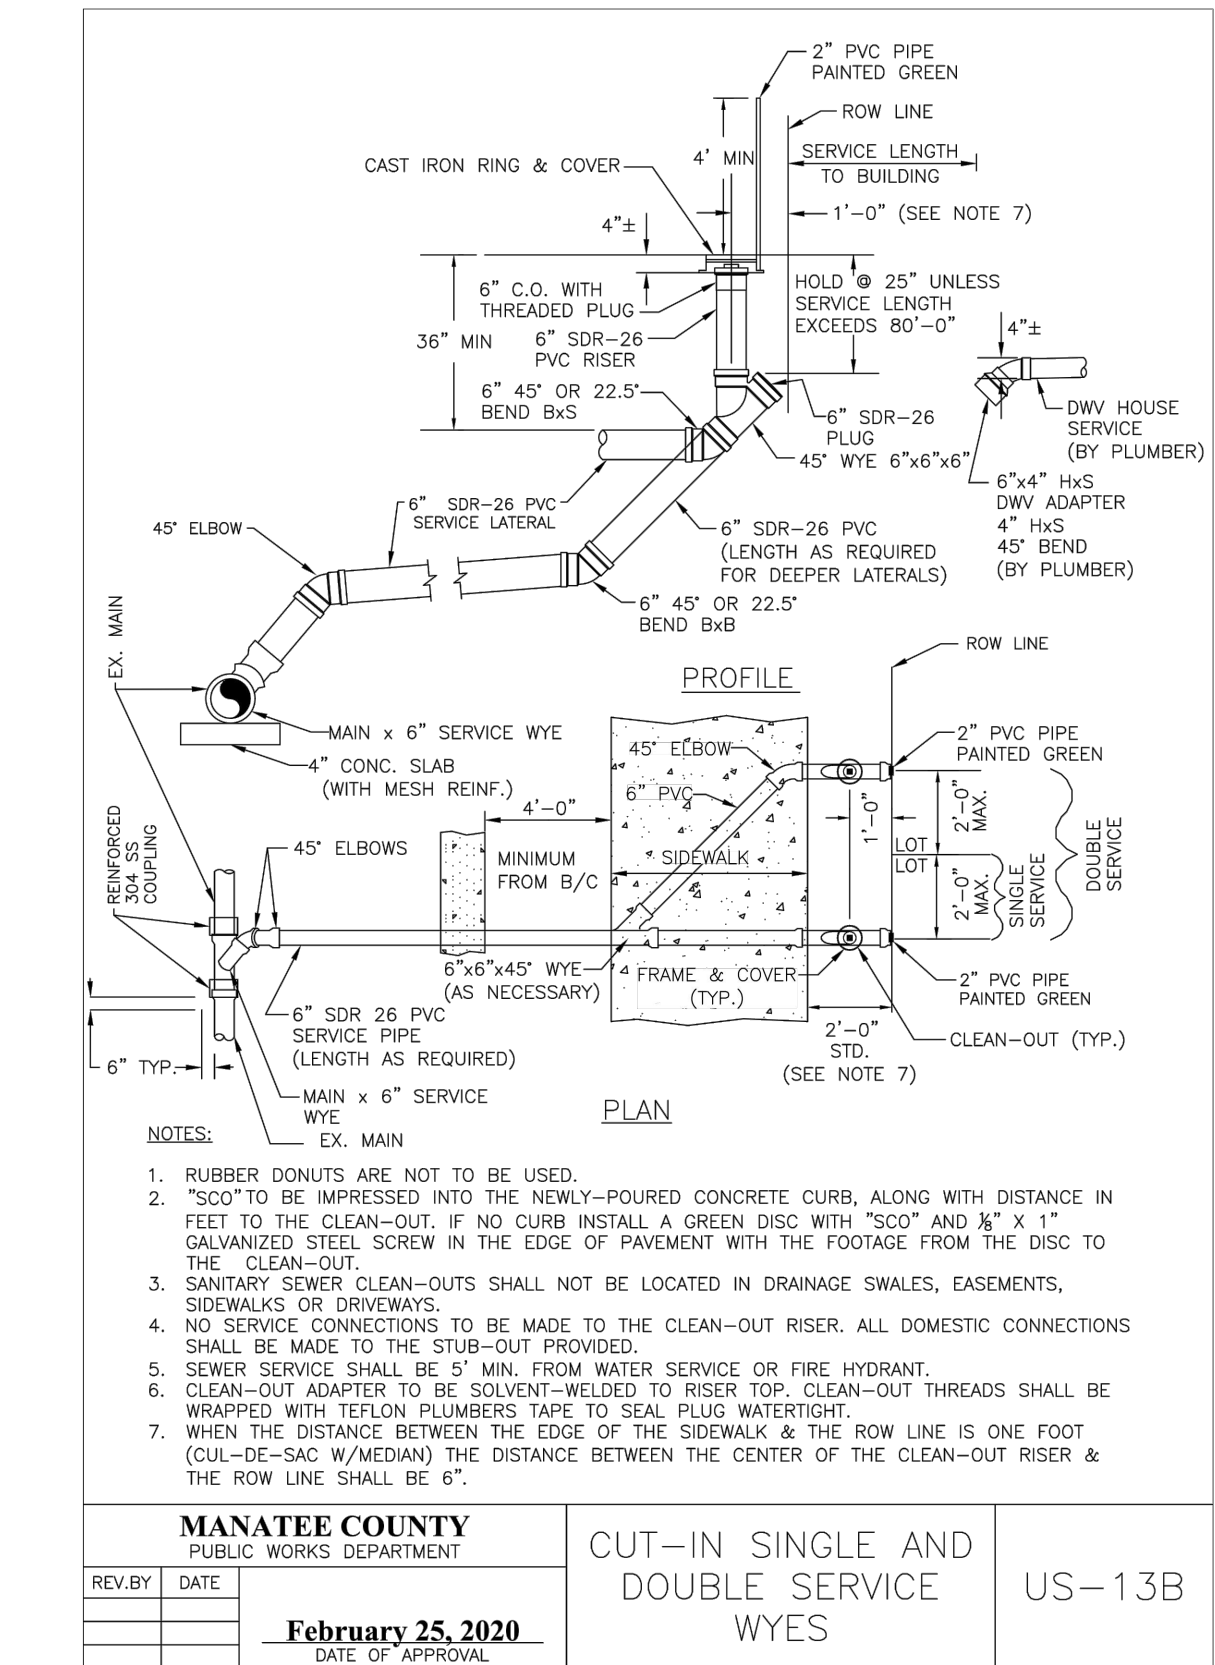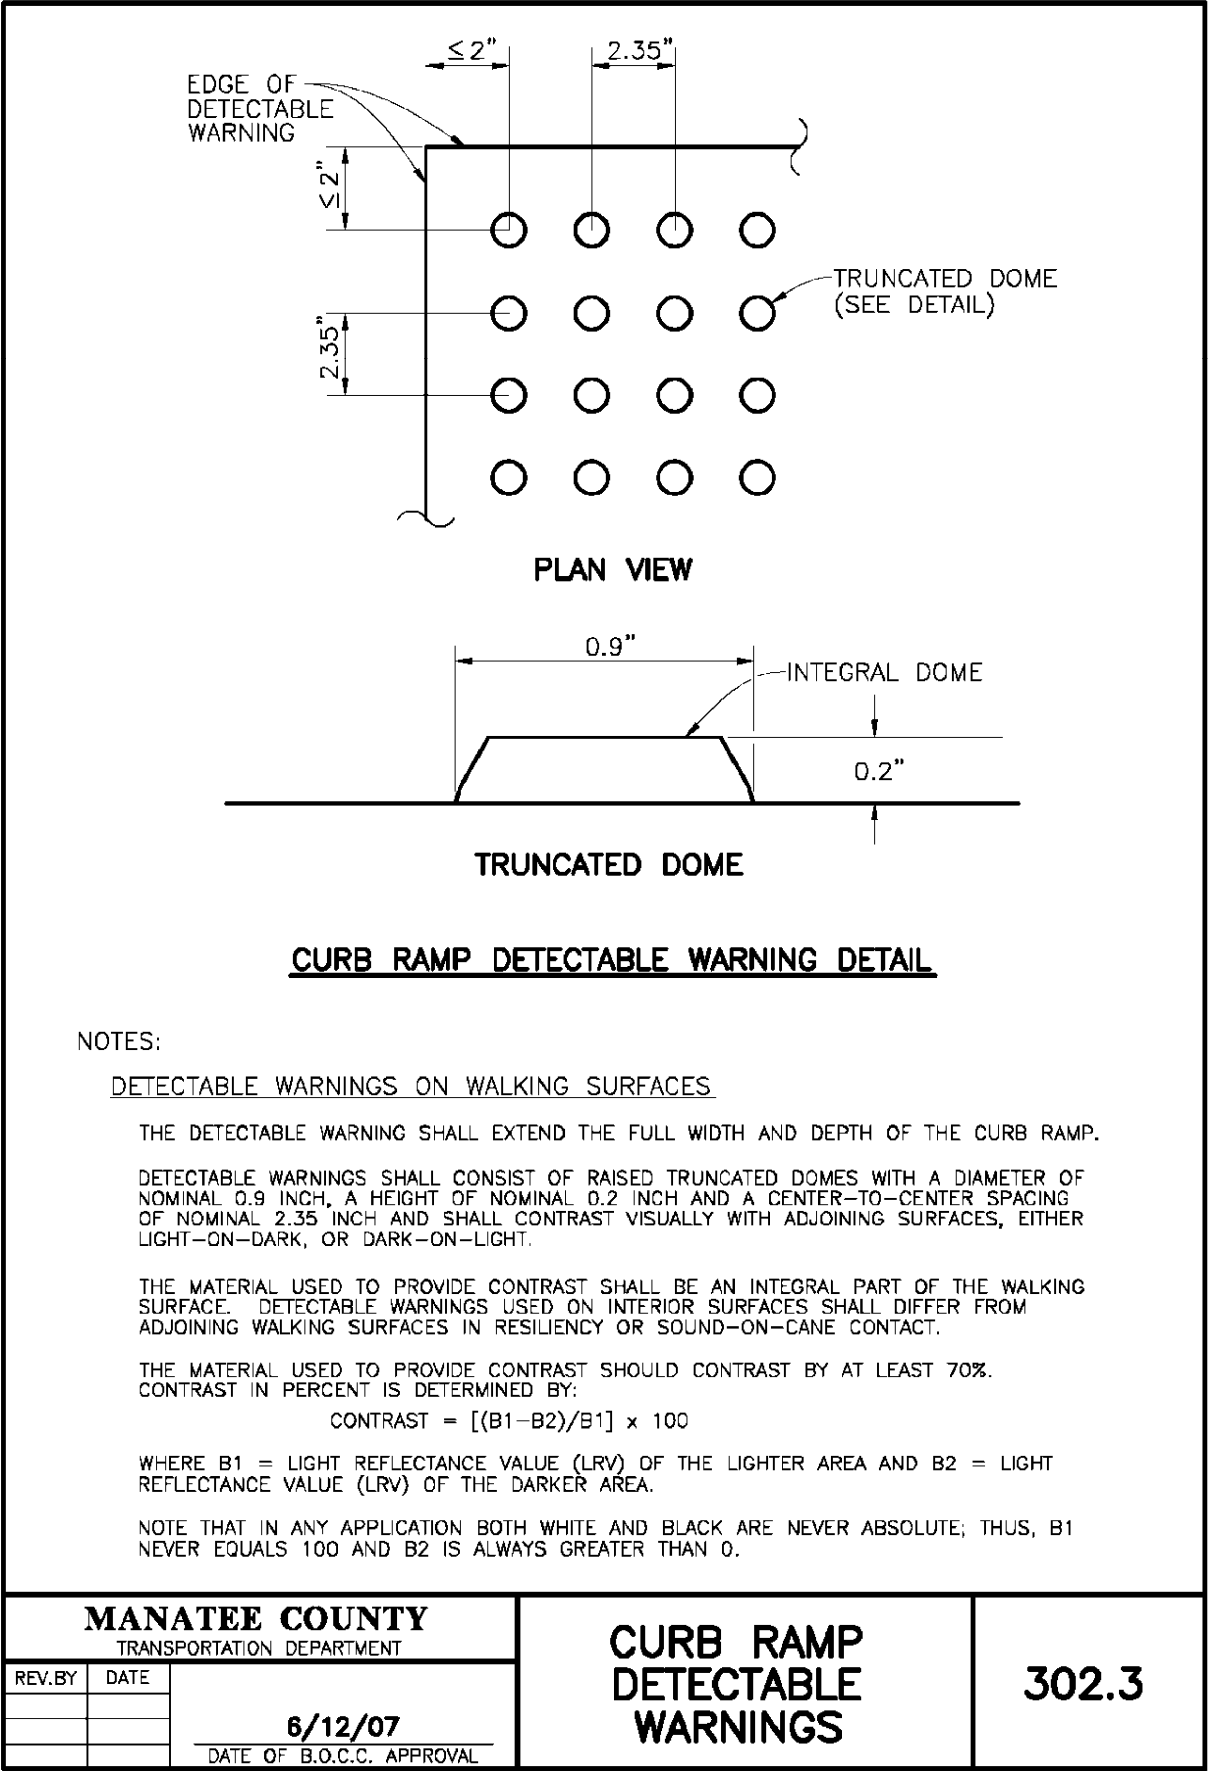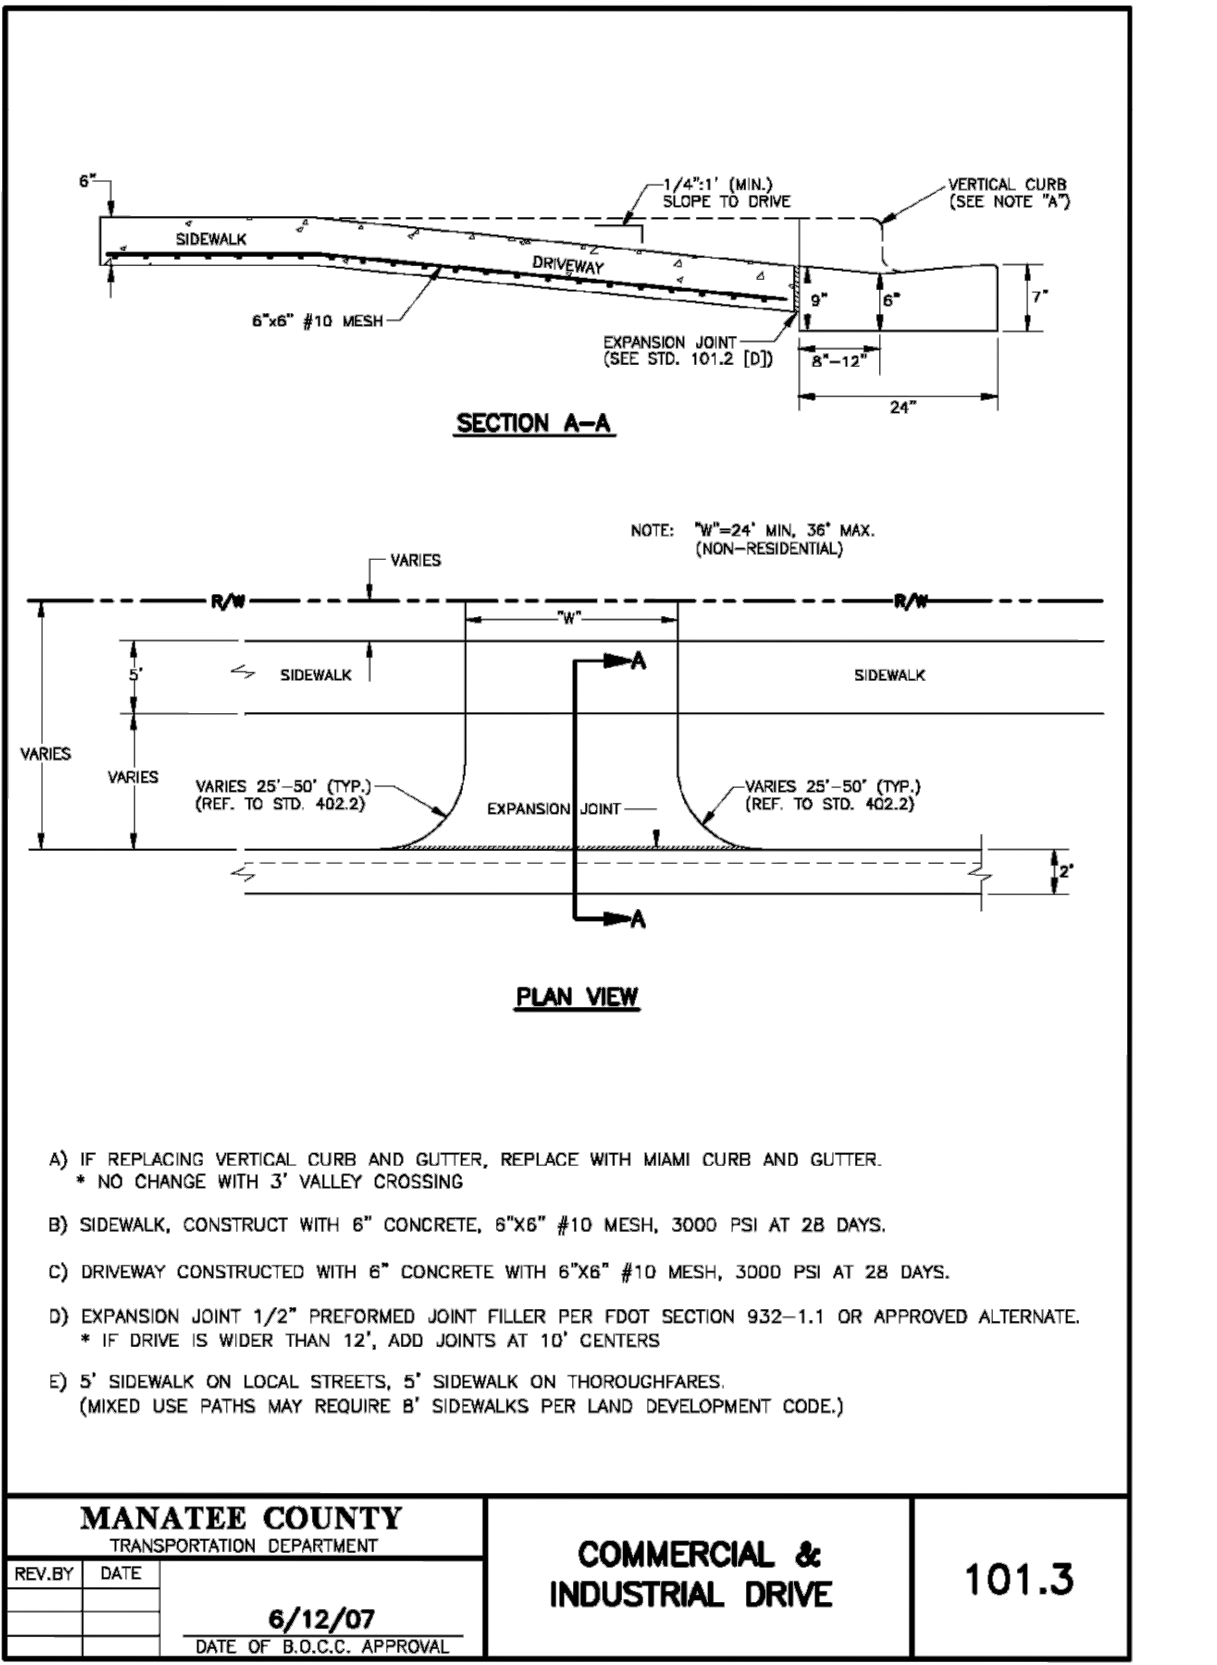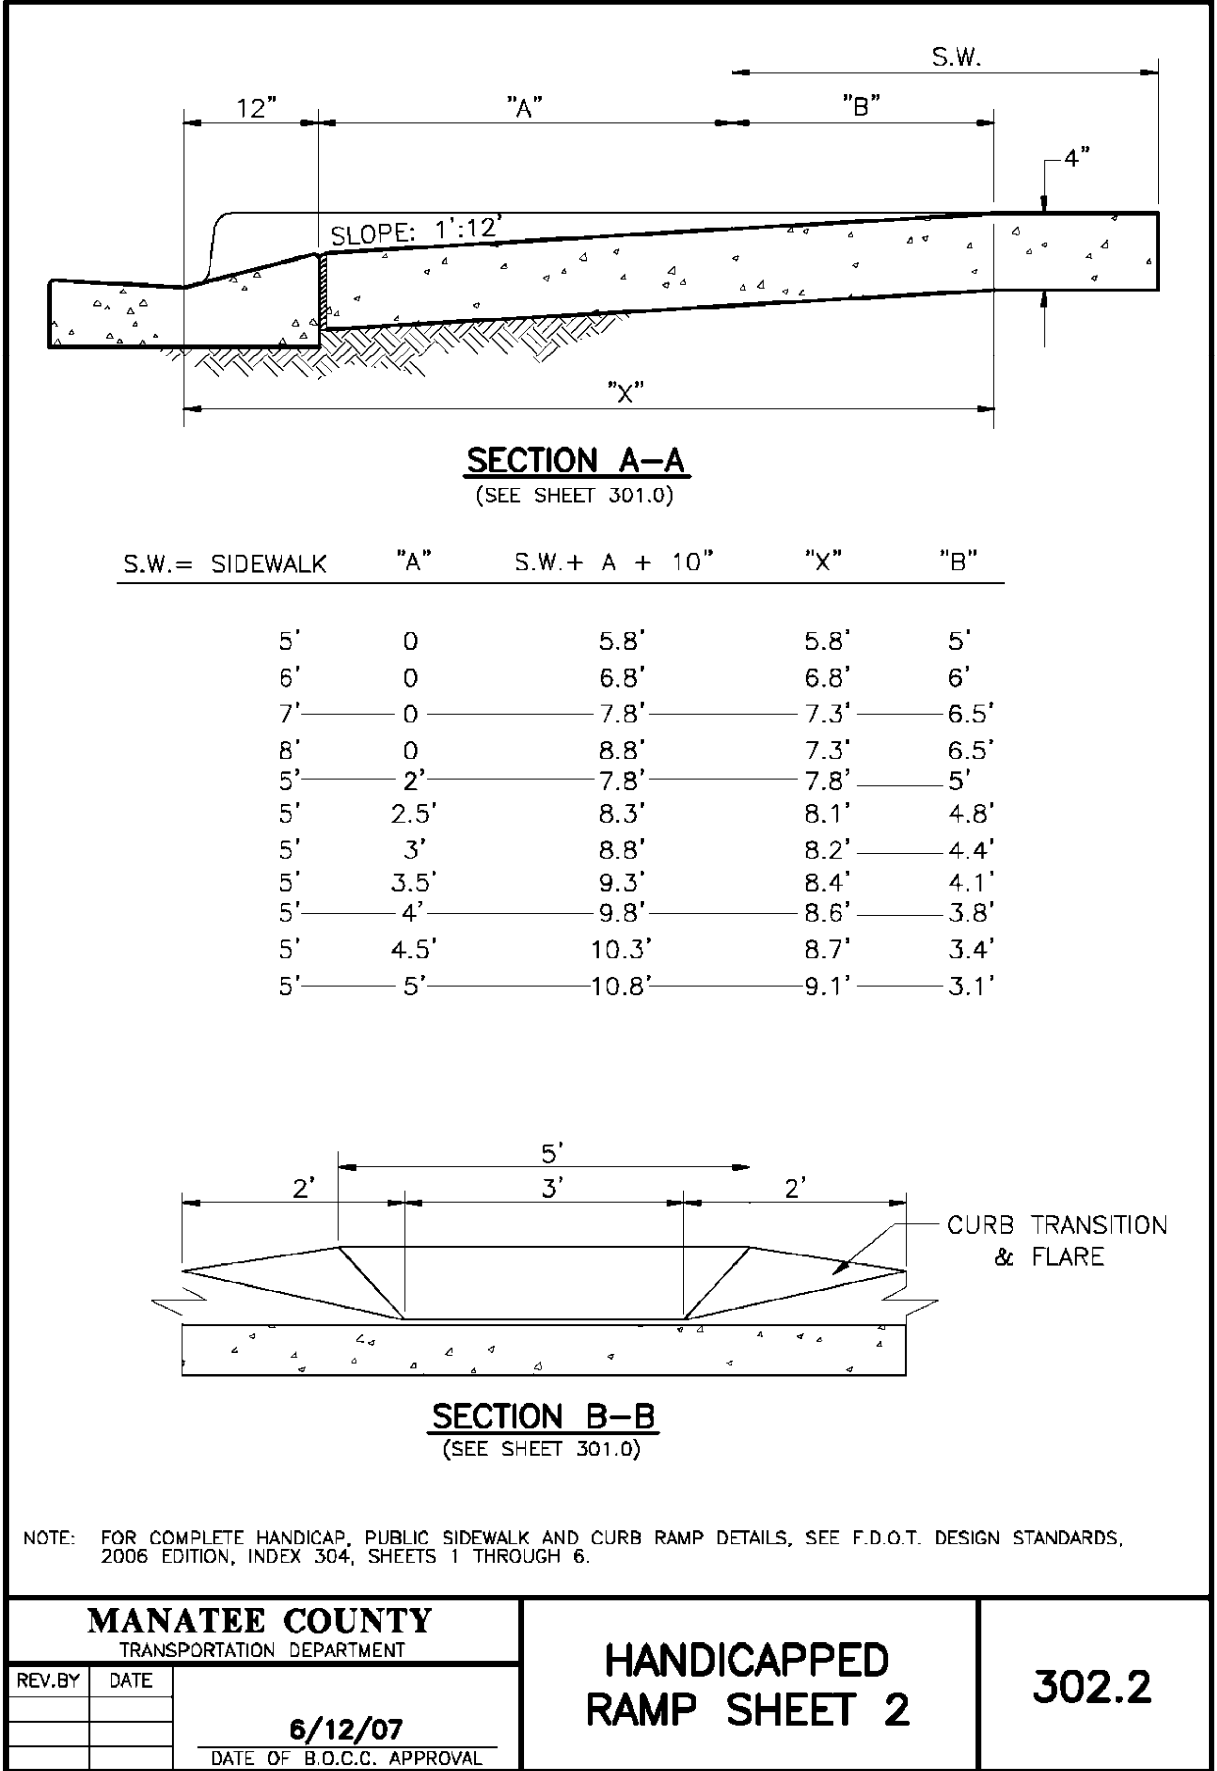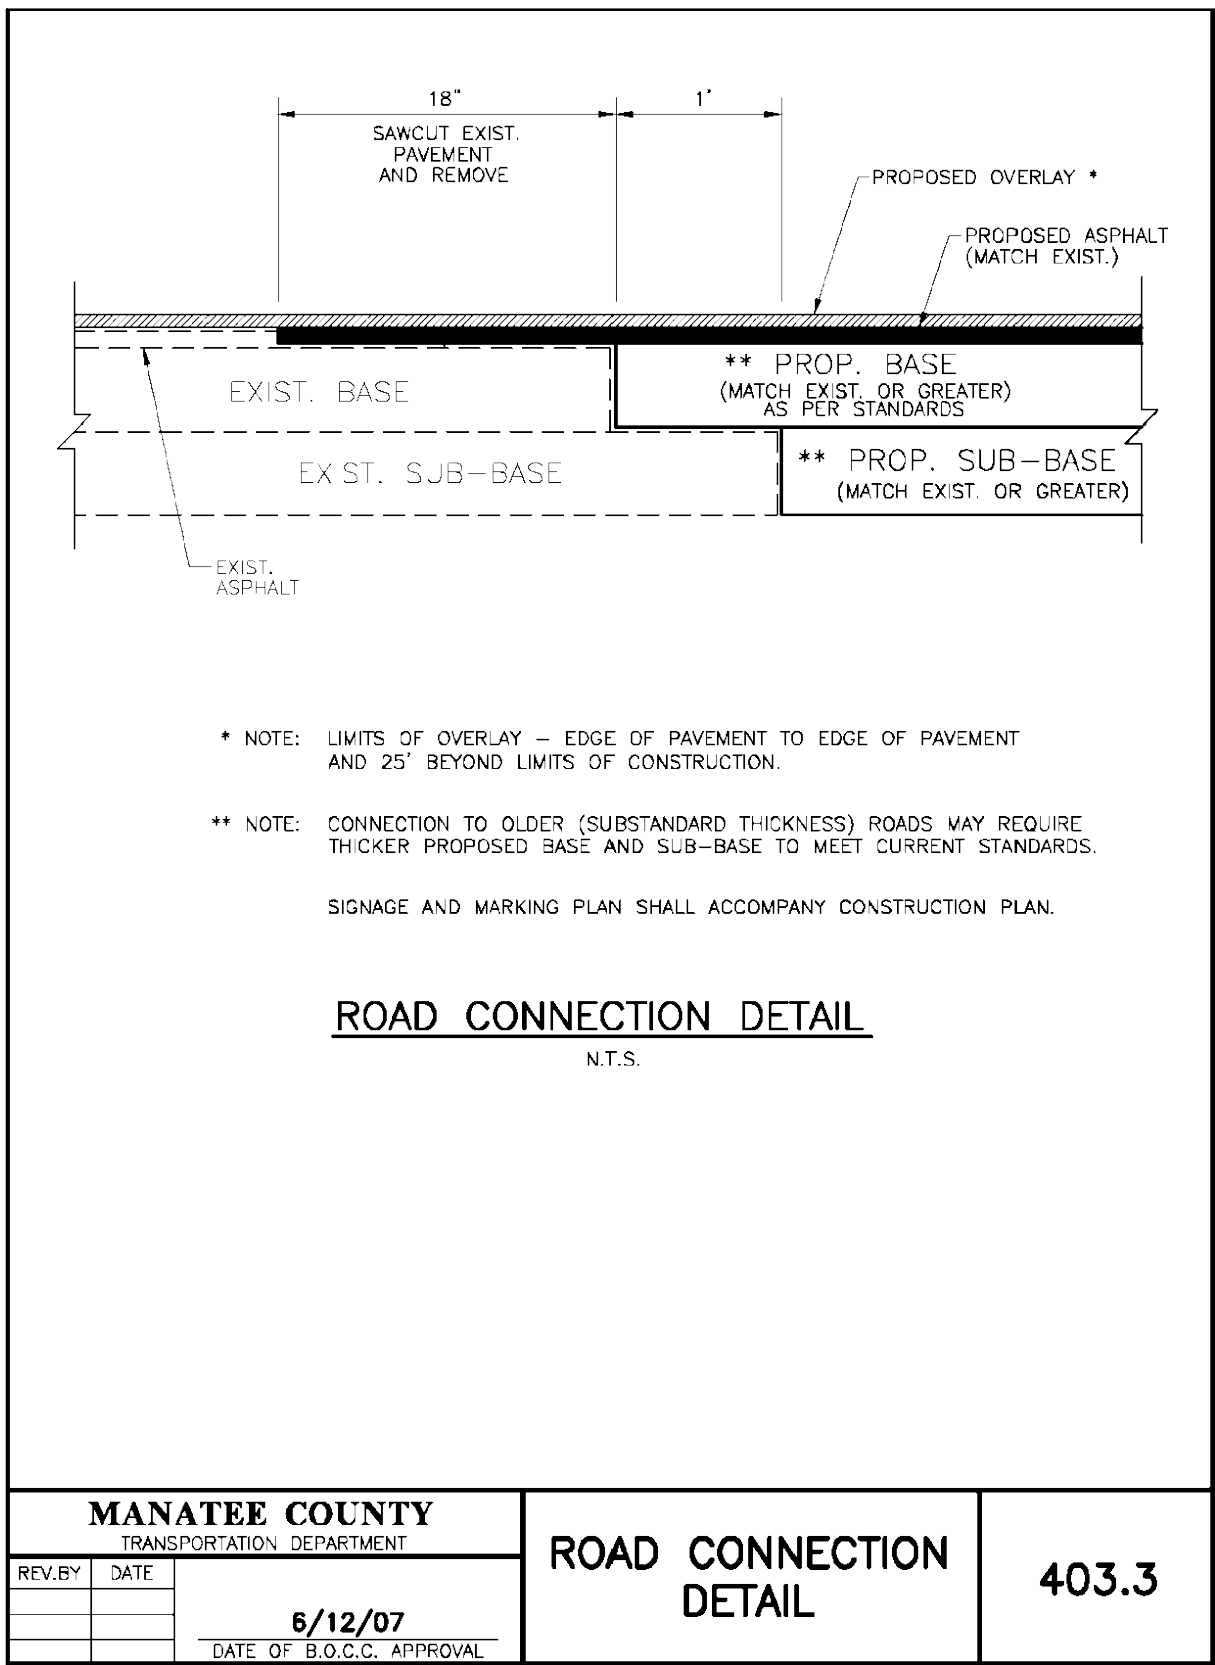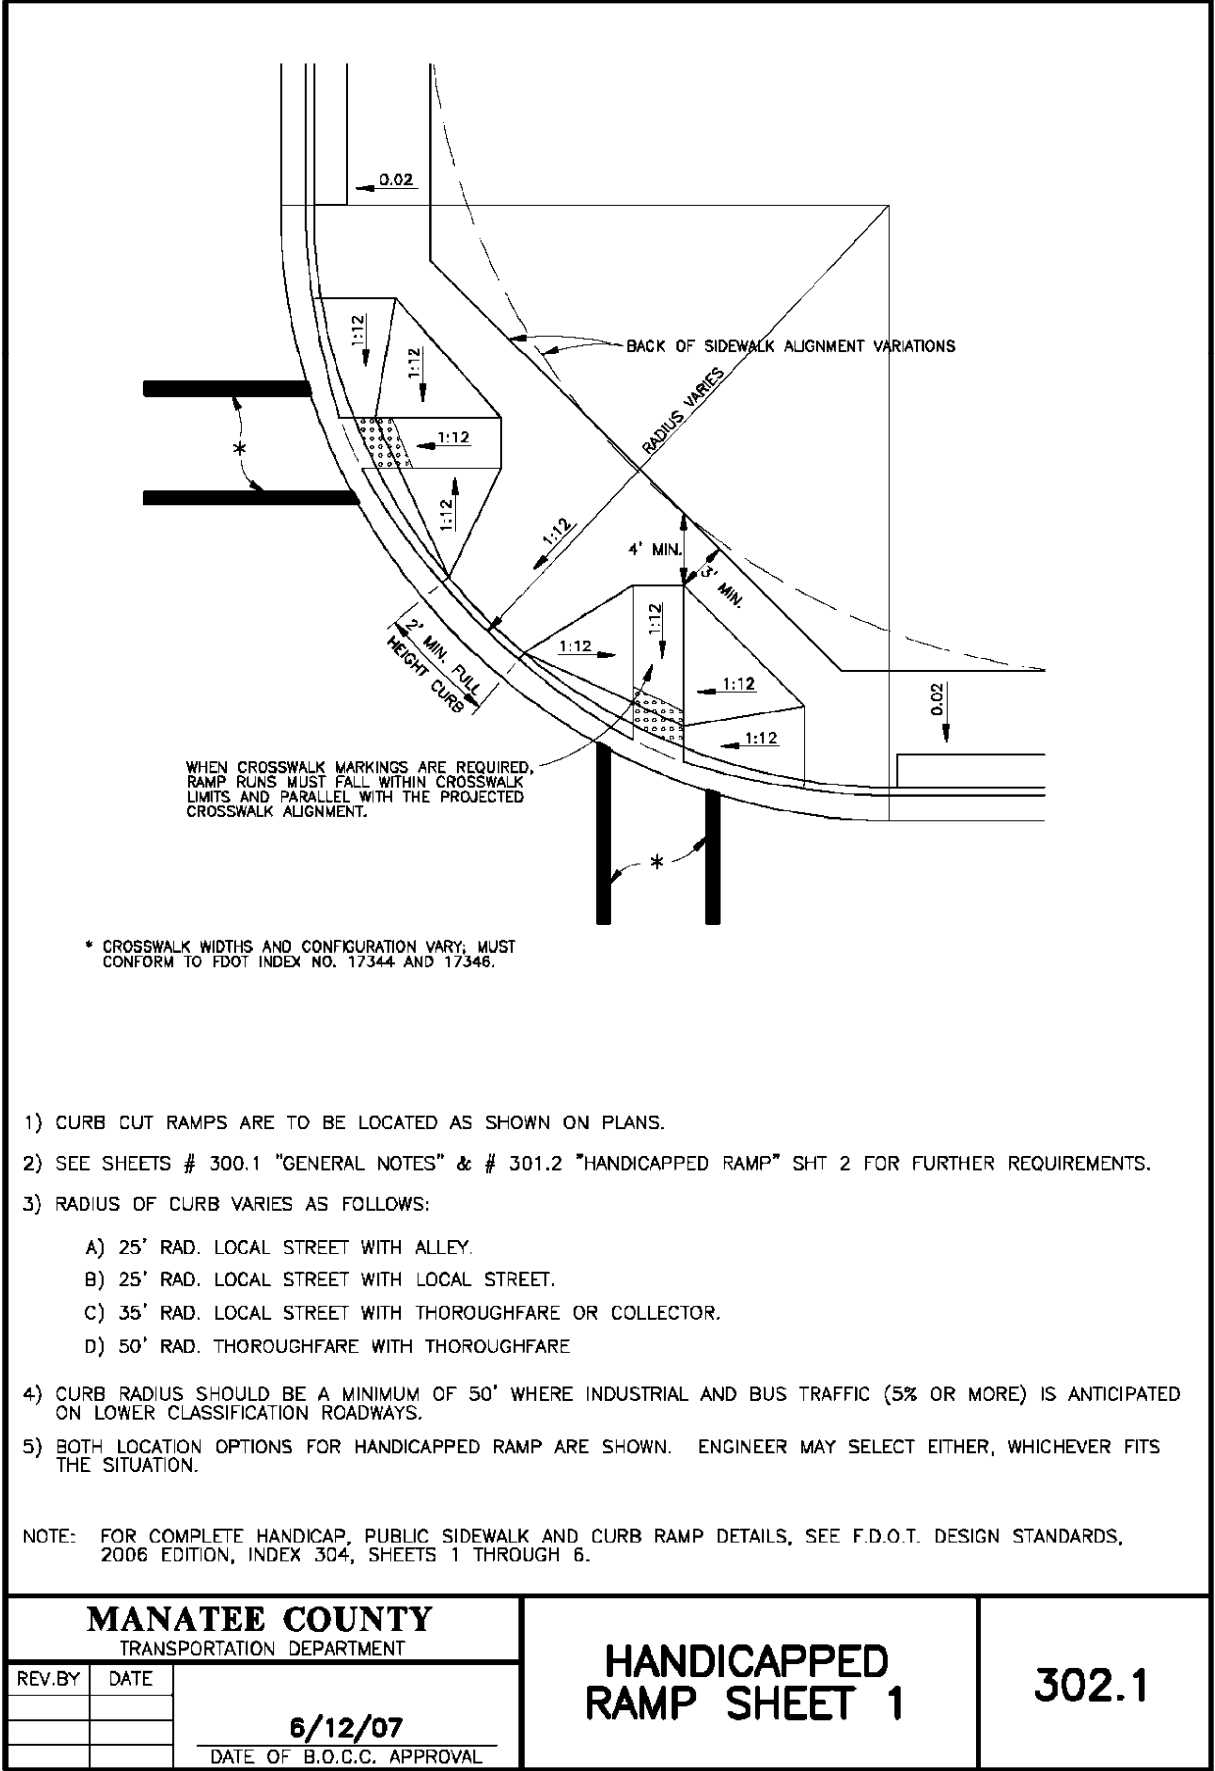
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MICHAEL A. SEMAGO, P.E.
FL LICENSE NUMBER 87501
DATE:

LIFT STATION SITE PLAN


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M-1

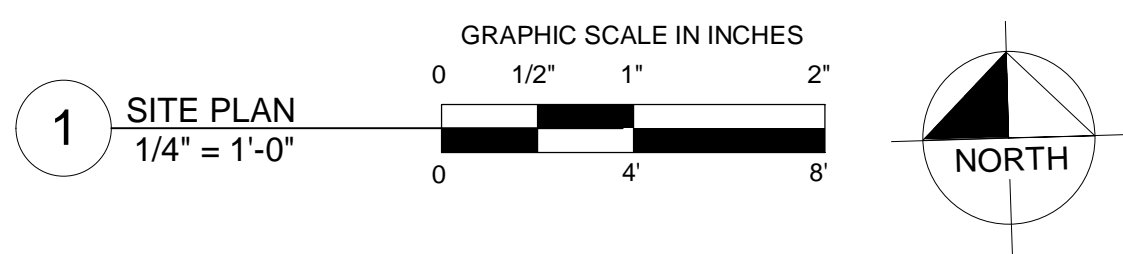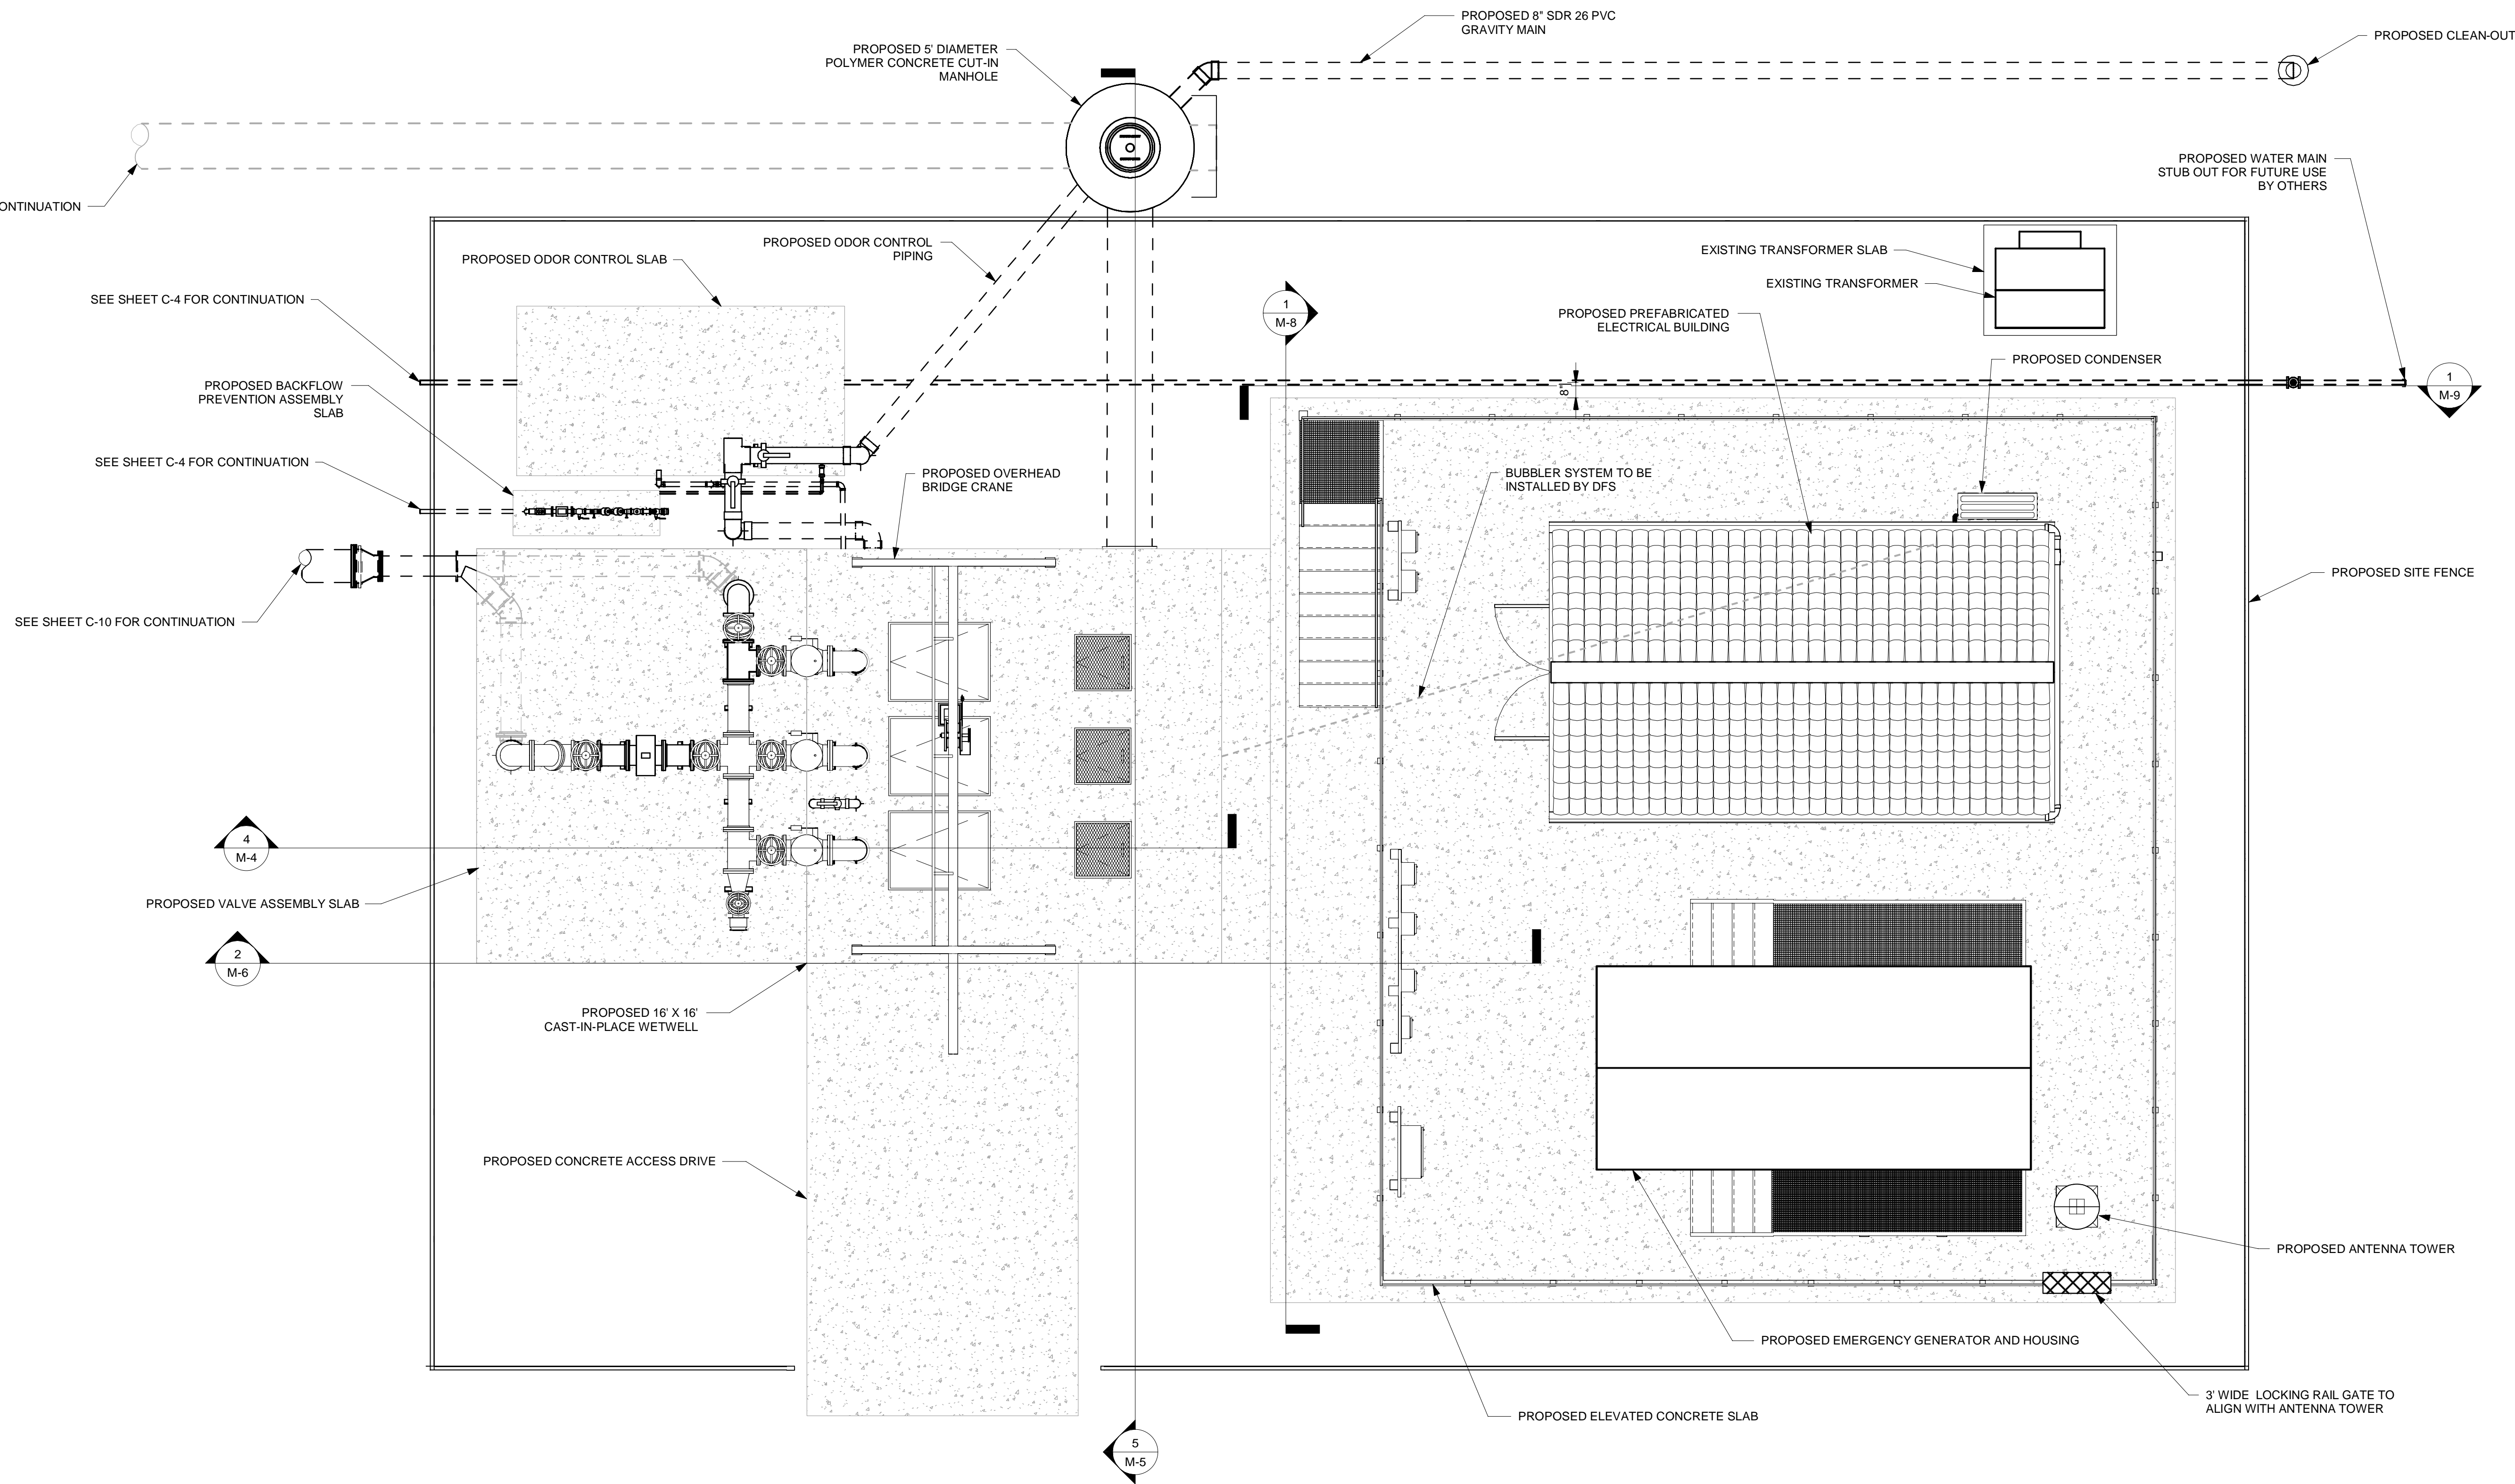

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1 ISOMETRIC VIEW 1

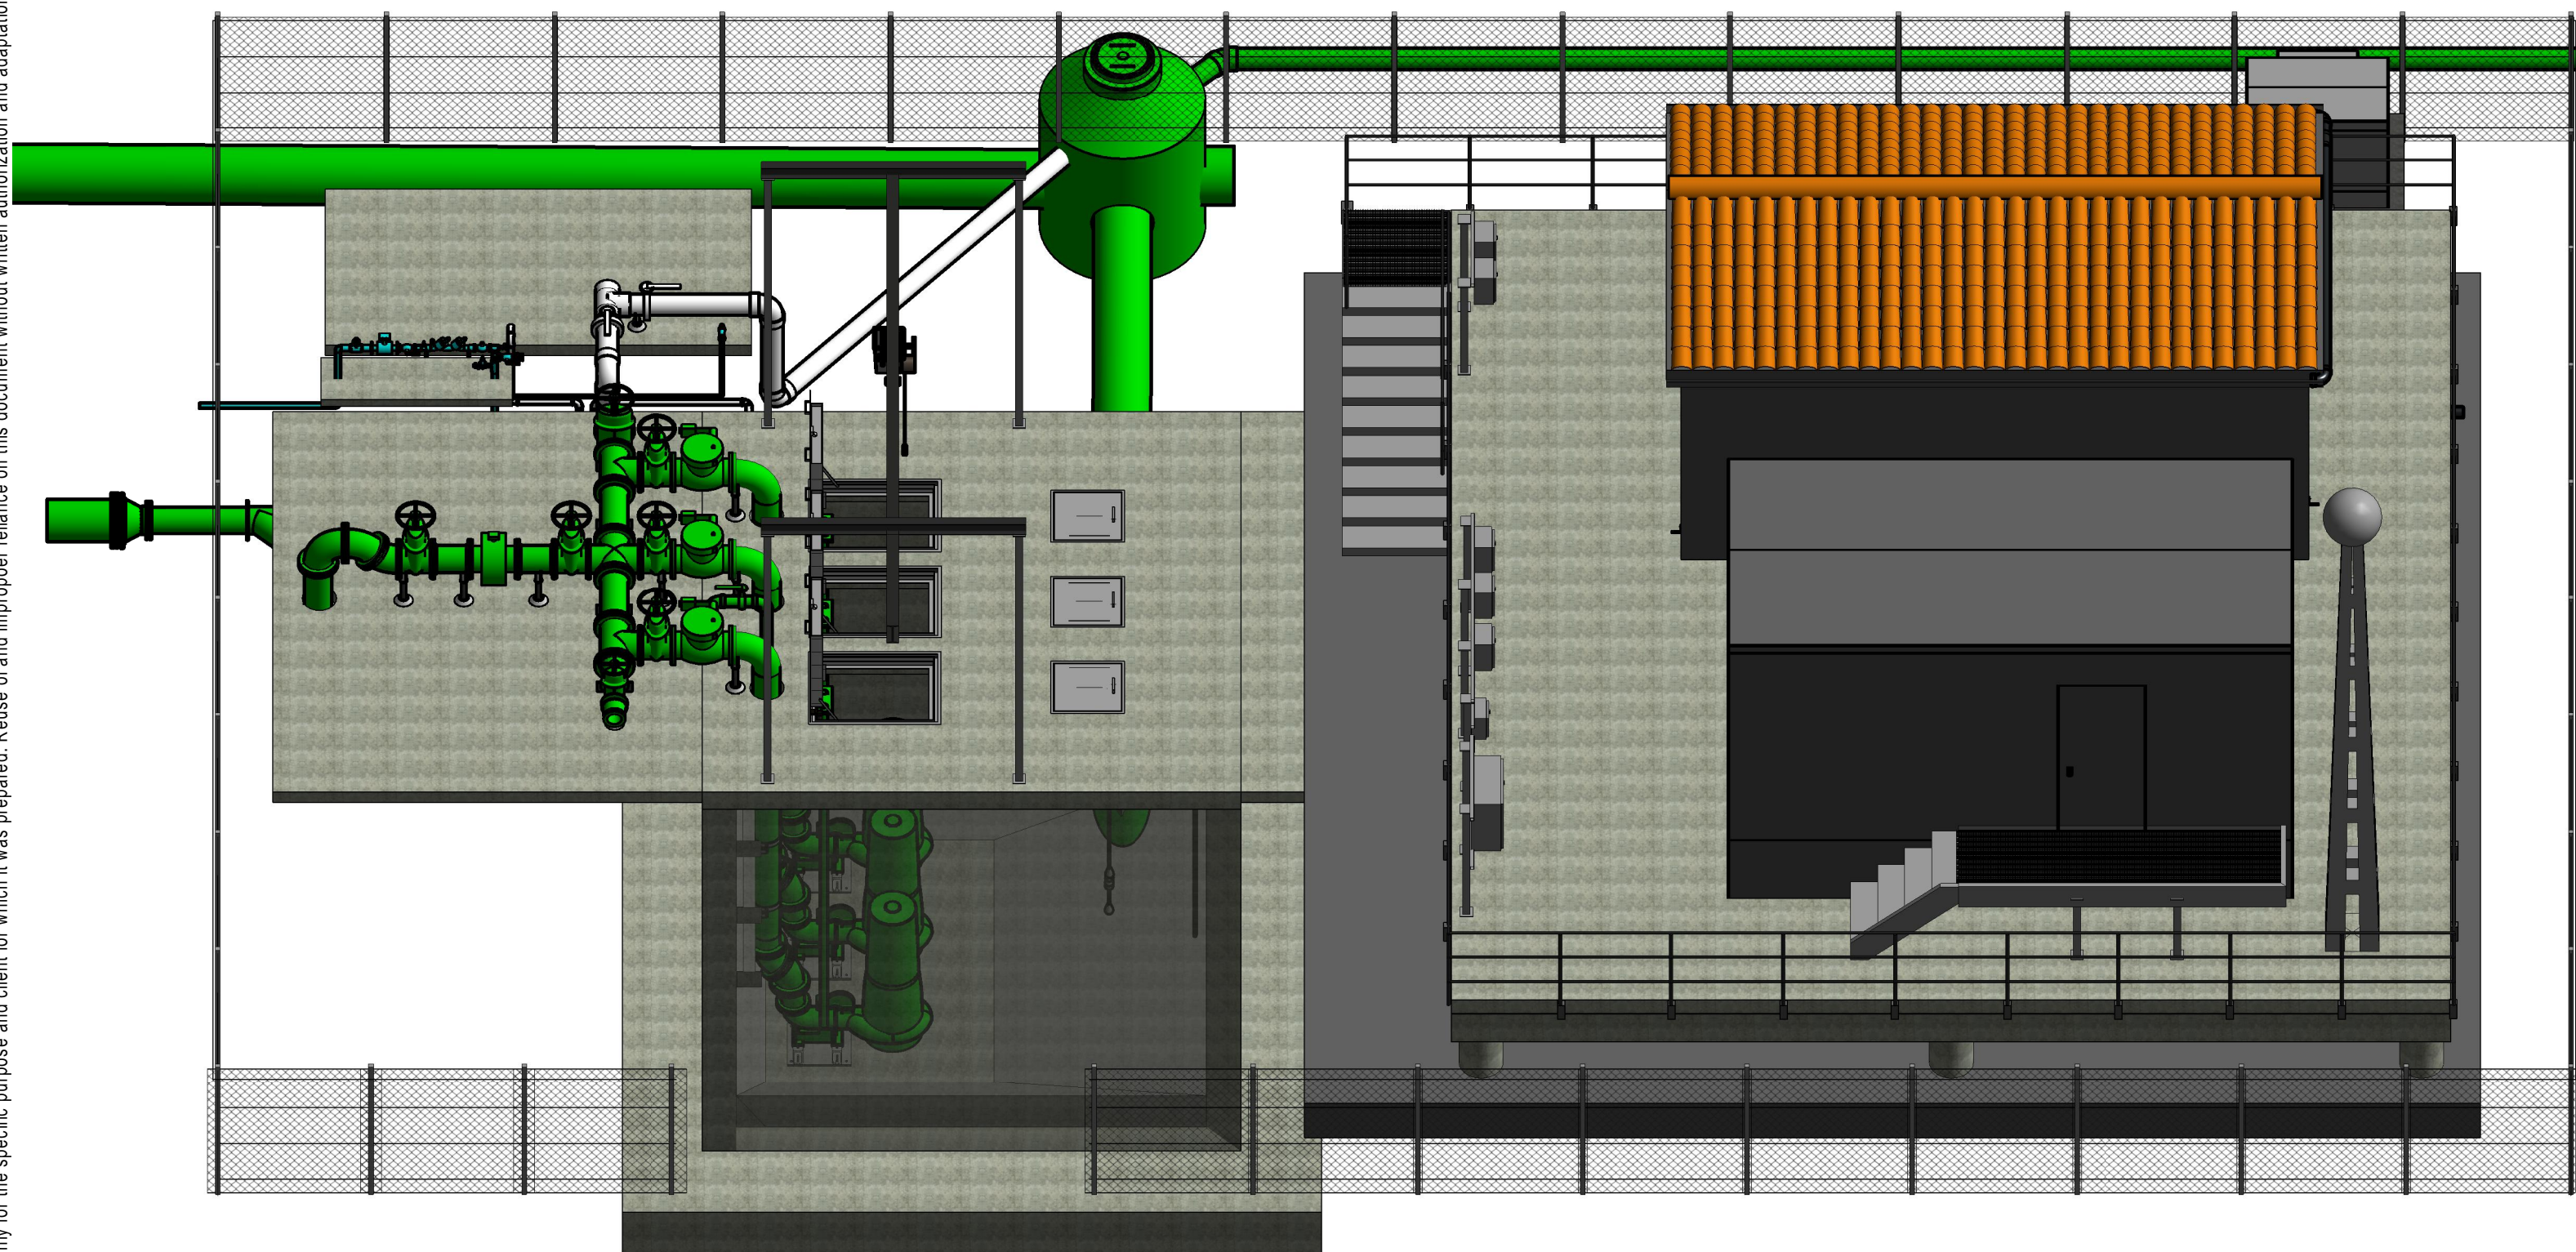


2 ISOMETRIC VIEW 2
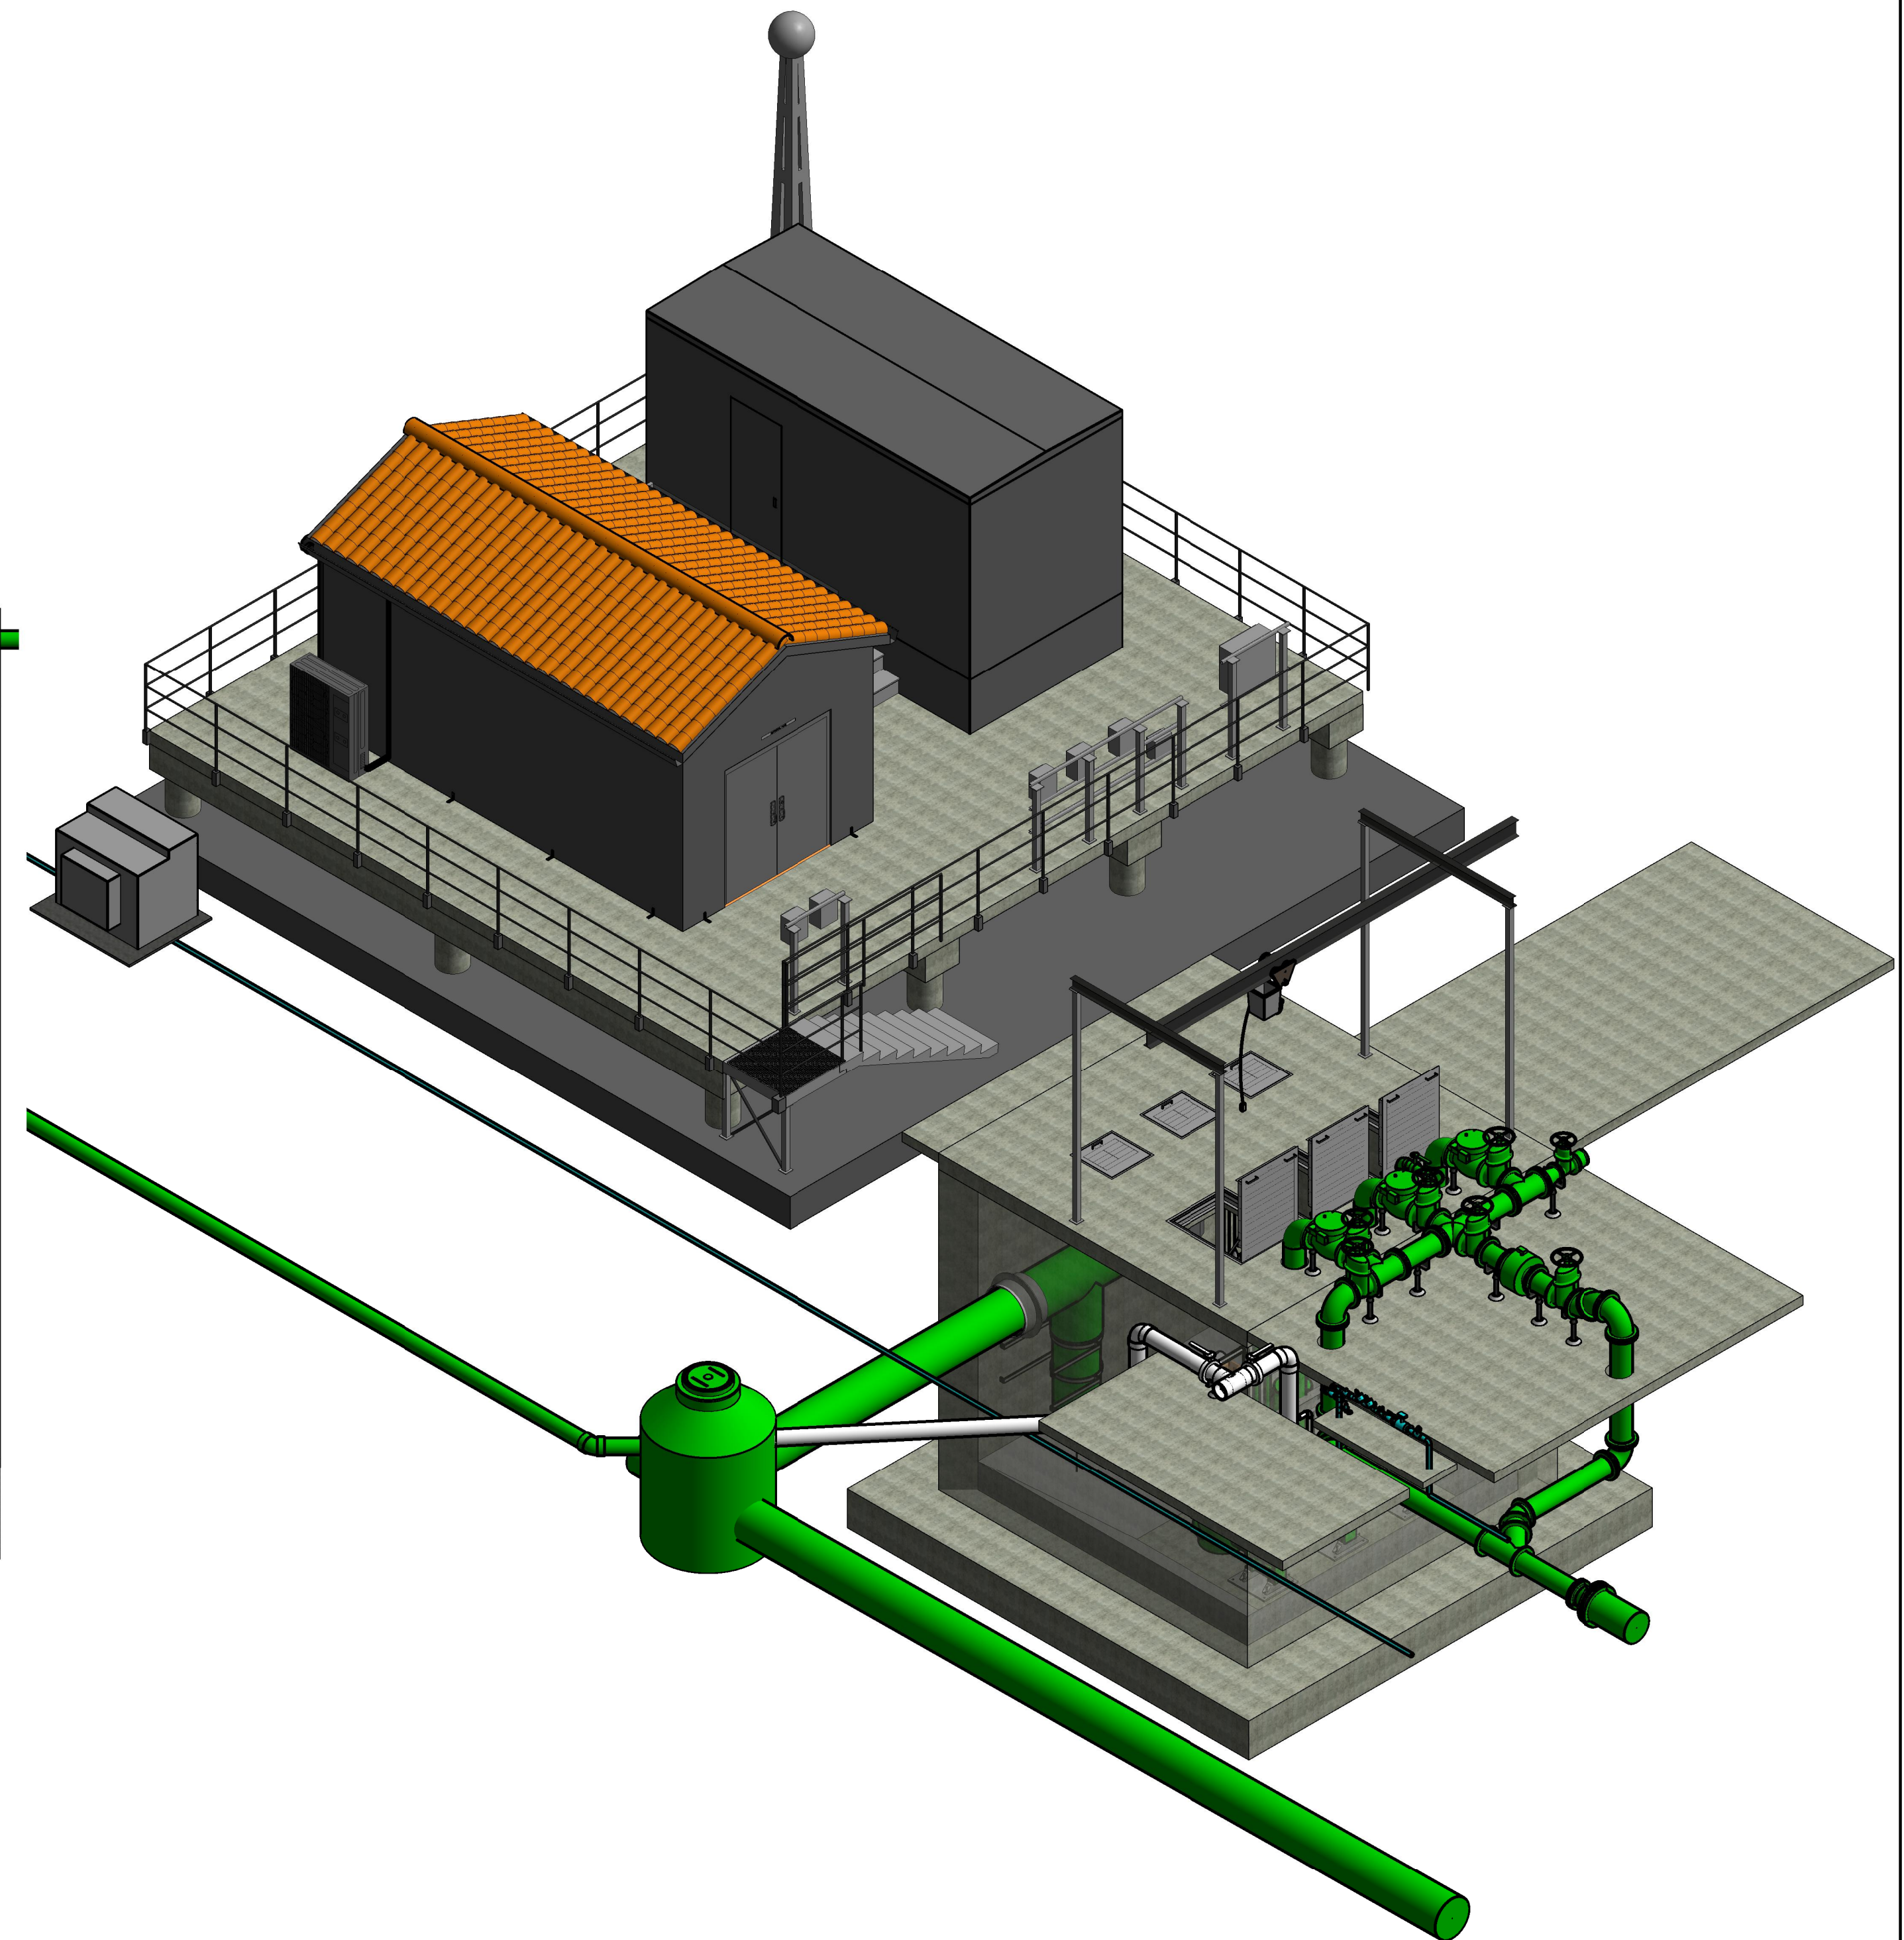
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**BAYSHORE YACHT BASIN FORCE MAIN  
AND LIFT STATION REPLACEMENT**  
MANATEE COUNTY

LICENSED PROFESSIONAL:
MICHAEL A. SEMAGO, P.E.
FL LICENSE NUMBER 87501
DATE:

**ISOMETRIC VIEWS**

SHEET NUMBER
M-2



EXISTING 24" SEWER

ODOR CONTROL SLAB (EQUIPMENT TO BE FURNISHED AND INSTALLED BY OTHERS)

14' - 6"

7' - 6"

3' - 3"

SEE SHEET C-4 FOR CONTINUATION

SEE SHEET C-10 FOR CONTINUATION

2" PVC SCH 80 ODOR CONTROL DRAIN

2" BACK FLOW PREVENTER ASSEMBLY. SEE DETAIL ON SHEET M-14

2" P-TRAP, MIN 10" DROP PER DETAIL ON SHEET M-15

STUB OUTS FOR FUTURE ODOR CONTROL EQUIPMENT

4' - 11"

16

11

21

14

12

12

12

8" PVC SCH 80 ODOR CONTROL SUCTION HEADER

17 LF OF 24" PVC C900 DR 25 @ 0.1% SLOPE

CONNECT TO RESILIENT CAST-IN MANHOLE BOOT INV: -0.14

CONNECT 24" SEWER MAIN TO MANHOLE INV: -0.12

PROPOSED 8" SDR 26 PVC GRAVITY MAIN @ 0.42% SLOPE INV: -0.02'

CUT AND CAP EXISTING 24" SEWER PIPE AFTER NEW LIFT STATION IS OPERATIONAL AND ACCEPTED BY COUNTY

PROPOSED 2" WATER MAIN FOR FUTURE USE. SEE SHEET C-4 FOR CONTINUATION

18' - 4"

1' - 2"

3' - 10"

4' - 2"

4' - 2"

3' - 10"

1' - 2"

4' - 0"

CONNECT DRIVEWAY SLAB TO TOP OF WETWELL

REFER TO SHEET M-6 FOR BRIDGE CRANE DETAILS

20' - 0"

14' - 7"

12' - 0"

6' - 4"

GRAPHIC SCALE IN INCHES

0 1/2" 1" 2"

0 4' 8'

3 MECHANICAL PLAN

1/4" = 1'-0"


NORTH

KEYNOTE LEGEND	
KEY VALUE	KEYNOTE TEXT
1	100 HP HYDROMATIC SUBMERSIBLE PUMP MODEL S8LXP, 1350 GPM @ 120 TDH, IMPELLER: HYDROMATIC 12-13"
2	10" SWING CHECK VALVE, FL
3	10" NRS GATE VALVE, FL
4	ALUMINUM FLANGE WITH ALUMINUM 6" CAMLOCK FITTING AND DUST CAP (SEE DETAIL ON SHEET M-15)
5	6" NRS GATE VALVE, FL
6	10"X6" D.I. REDUCER, FL
7	10" D.I. TEE, FL
8	10" D.I. CROSS , FL
9	10" MCCROMETER ULTRA MAG UM-06
10	36" X 48" ALUMINUM PUMP ACCESS HATCH
11	8" PVC SCH 80 BUTTERFLY VALVE
12	8" PVC SCH 80 90 DEG BEND
13	24" X 24" ALUMINUM ACCESS HATCH WITH SAFETY GRATE (TYP. OF 3)
14	8" PVC SCH 80 PIPE
15	8" PVC SCH 80 TEE
16	316 SS FLANGE PIPE SUPPORT (SEE DETAIL ON SHEET M-14)
17	10" D.I. 45 DEG BEND, FL
18	10" D.I. 90 DEG BEND, MJ
19	10" D.I. 90 DEG BEND, FL
20	2" PVC SCH 80 90 DEG BEND
21	2" PVC SCH 80 PIPE
22	10" D.I. SPOOL PIECE, FL
23	1 LF 10" D.I. SPOOL PIECE, FL
24	10" PVC C900 DR 18 PIPE
25	10" D.I. 45 DEG BEND, MJ
26	16" PVC C900 DR 18 PIPE
27	4" PVC BUTTERFLY VALVE
28	10" MOLDED HDPE 90 DEG BEND, DIPIS
29	FLANGE ADAPTER
30	1.5" PVC SCH80 BALL VALVE
31	10" D.I. WYE, MJ
32	10"X16" D.I. REDUCER, MJ

[illegible]



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3	10" NRS GATE VALVE, FL
4	10" D.I. TEE, FL
5	10" MCCROMETER ULTRA MAG UM-06
6	36" X 48" ALUMINUM PUMP ACCESS HATCH WITH SAFETY GRATE (TYP. OF 3)
7	10" D.I. 45 DEG BEND, FL
8	2" PVC SCH 80 PIPE
9	2" PVC SCH 80 90 DEG BEND
10	10" D.I. 90 DEG BEND, FL
11	16" PVC C900 DR 18 PIPE
12	10"X16" D.I. REDUCER, MJ
13	1 LF 10" D.I. SPOOL PIECE, FL
14	10" PVC C900 DR 18 PIPE
15	10" D.I. SPOOL PIECE, FL
16	10" D.I. 45 DEG BEND
17	10" HDPE FLANGE ADAPTOR W/ 316 SS BACKUP RING, DIPS
18	10" HDPE DR 11 DIPS PIPE
19	10" D.I. CROSS, FL
20	10" MOLDED HDPE 90 DEG BEND, DIPS
21	LEVEL FLOAT
22	24" X 24" ALUMINUM ACCESS HATCH WITH SAFETY GRATE (TYP. OF 3)
23	BUBBLER SYSTEM/TCU 800 CONTROLLER INSTALLED BY DATA FLOW SYSTEMS
24	10" D.I. WYE, MJ
25	10" D.I. 90 DEG BEND, MJ
26	10" D.I. 45 DEG BEND, MJ
27	10" X 8" D.I. ECCENTRIC REDUCER WITH PERMOX CTF COATING OR APPROVED EQUAL
28	8" BPIU PUMP BASE ELBOW

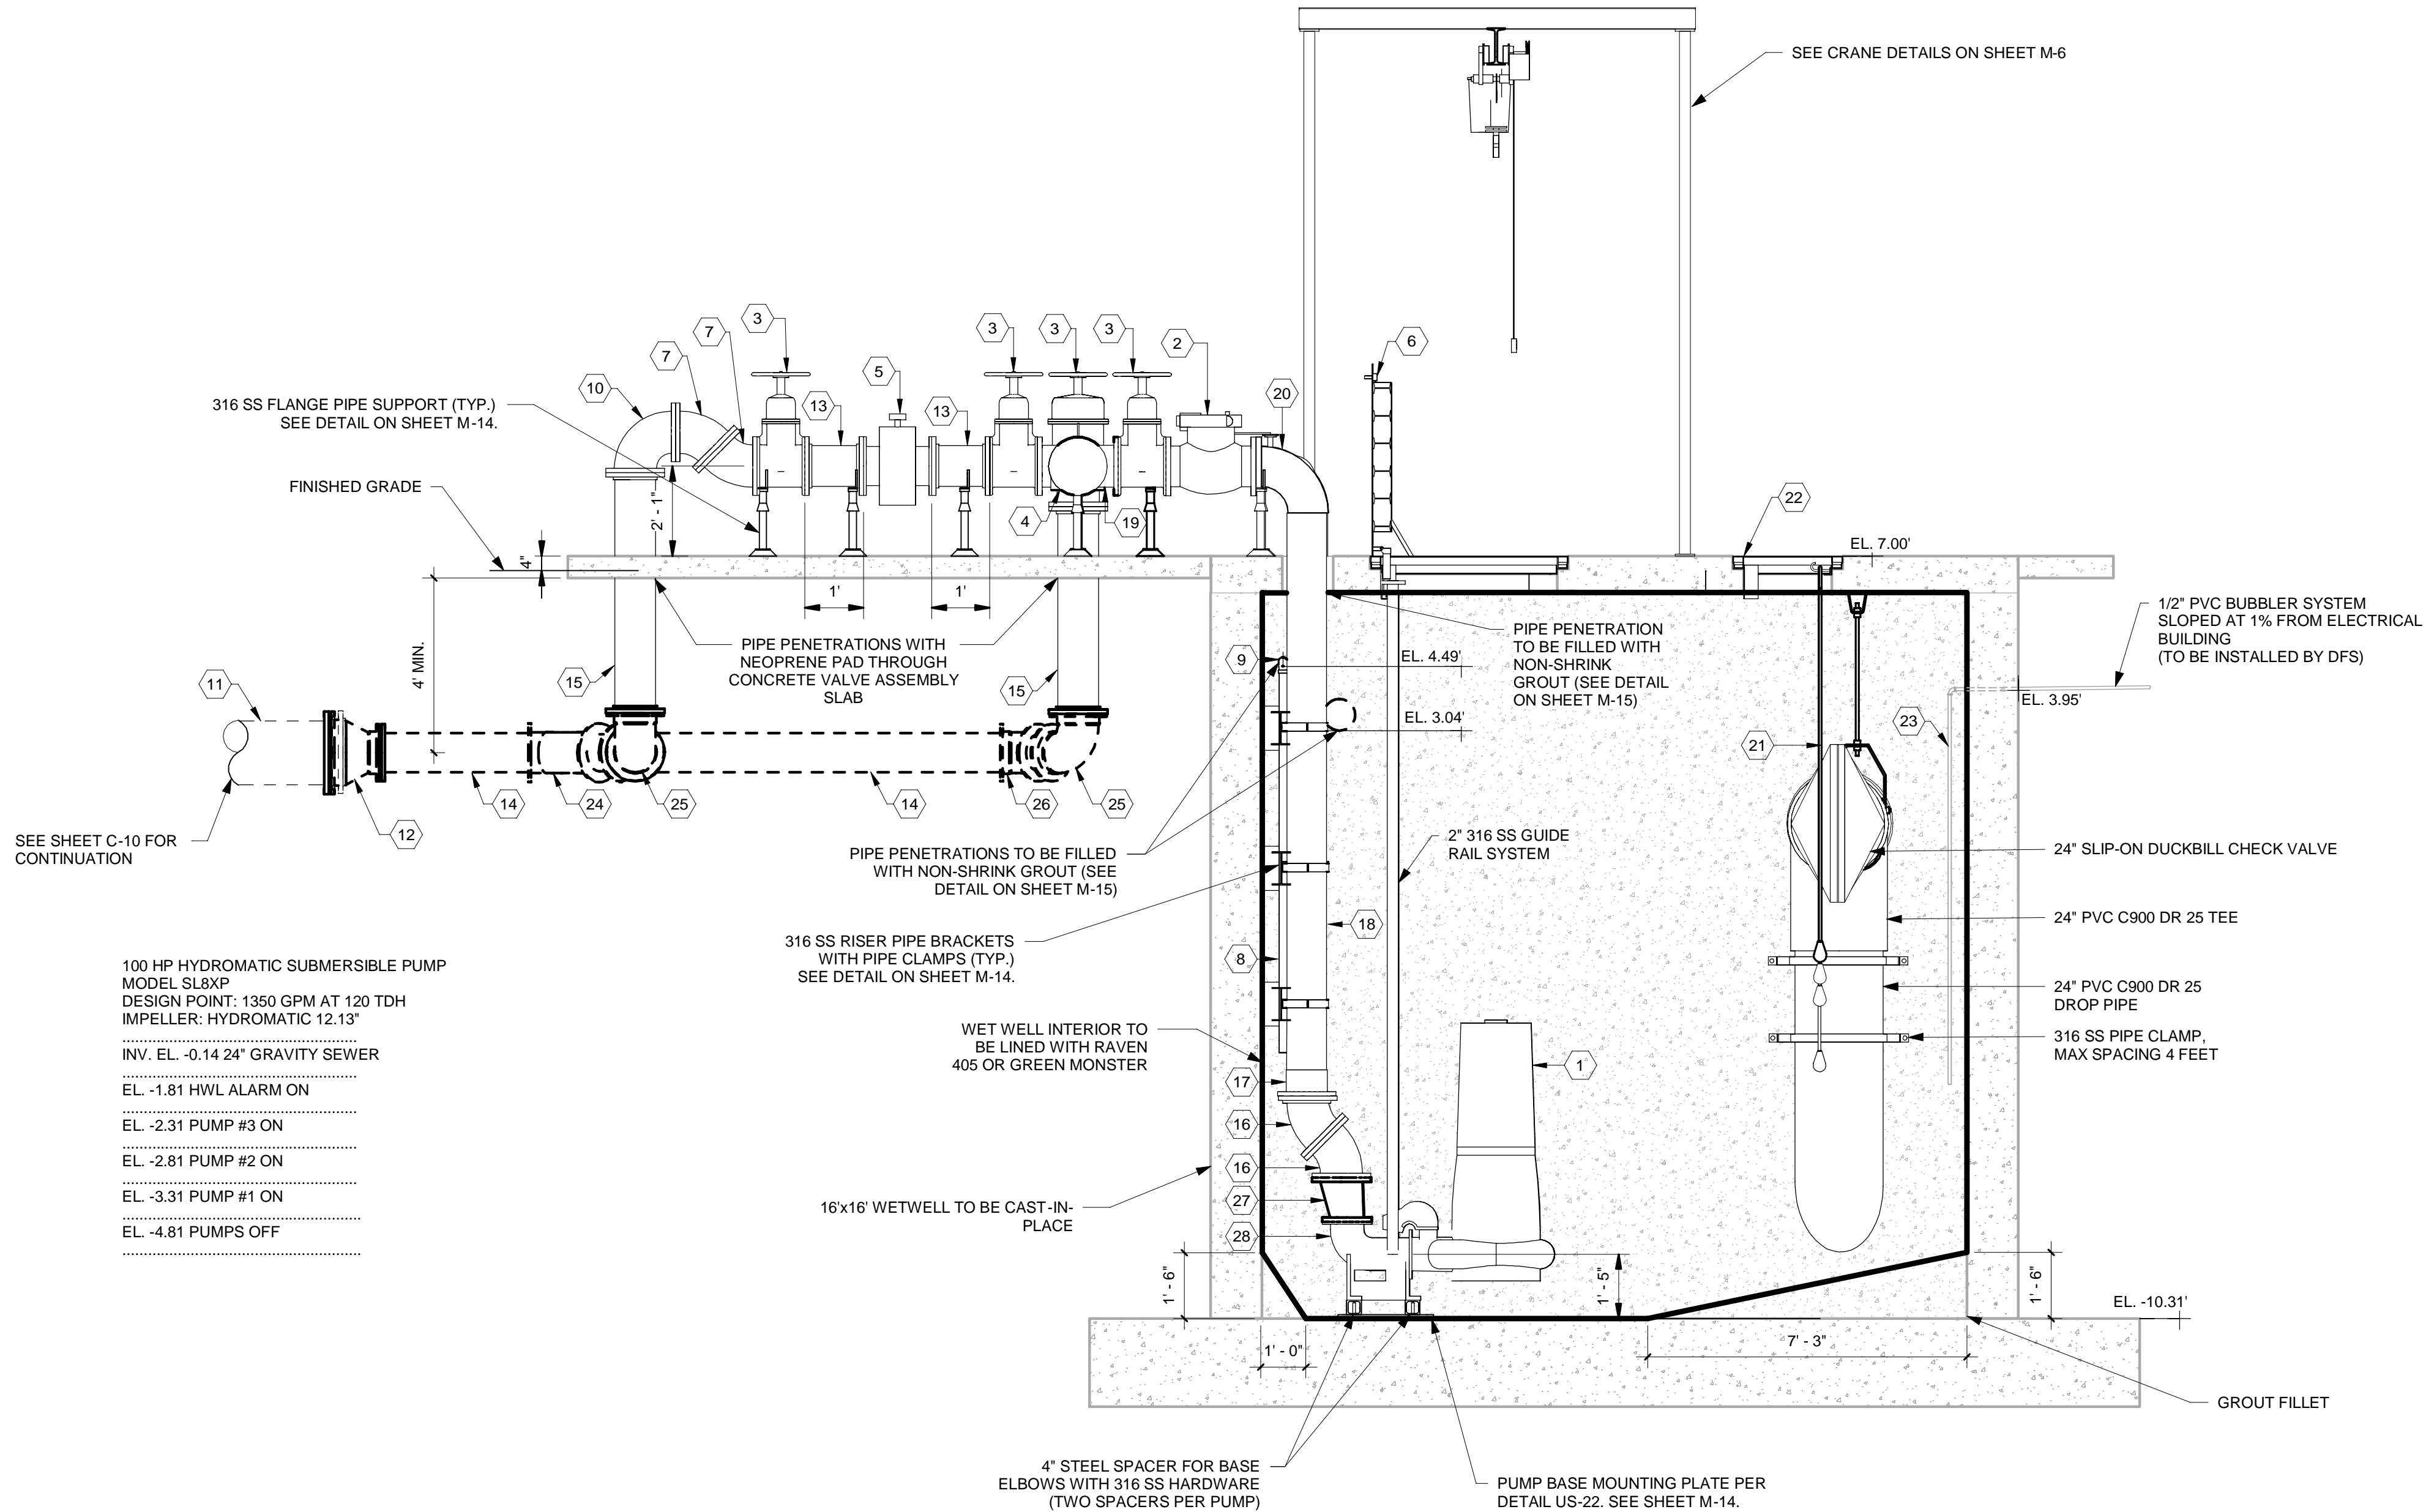

4 WET WELL SECTION  
M-1 3/8" = 1'-0"

No.	REVISIONS	DATE	BY



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PHONE: 727-547-3999  
WWW.KIMLEY-HORN.COM    REGISTRY No. 35106

KHA PROJECT 148400067
DATE FEB 2022
SCALE: AS SHOWN
DESIGNED BY: MAS
DRAWN BY: RLL
CHECKED BY: SNR



BAYSHORE YACHT BASIN FORCE MAIN  
AND LIFT STATION REPLACEMENT  
MANATEE COUNTY FL


LICENSED PROFESSIONAL:
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FL LICENSE NUMBER 87501
DATE:

WETWELL CROSS SECTION I

SHEET NUMBER  
M-4



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SHEET KEYNOTE LEGEND	
KEYNOTE	DESCRIPTION
1	100 HP HYDROMATIC SUBMERSIBLE PUMP MODEL S8LXP, 1350 GPM @ 120 TDH, IMPELLER: HYDROMATIC 12.13"
2	8" PVC SCH 80 BUTTERFLY VALVE
3	8" PVC SCH 80 90 DEG BEND
4	8" PVC SCH 80 PIPE
5	10" NRS GATE VALVE, FL
6	ALUMINUM FLANGE WITH ALUMINUM 6" CAMLOCK FITTING AND DUST CAP (SEE DETAIL ON SHEET M-15)
7	2" PVC SCH 80 PIPE
8	2" PVC SCH 80 90 DEG BEND
9	6" NRS GATE VALVE, FL
10	10"x6" D.I. REDUCER, FL
11	10" MOLDED HDPE 90 DEG BEND, DIPS
12	316 SS FLANGE PIPE SUPPORT (SEE DETAIL ON SHEET M-14)
13	10" D.I. 90 DEG BEND, FL
14	FLANGE ADAPTER
15	10" D.I. SPOOL PIECE, FL

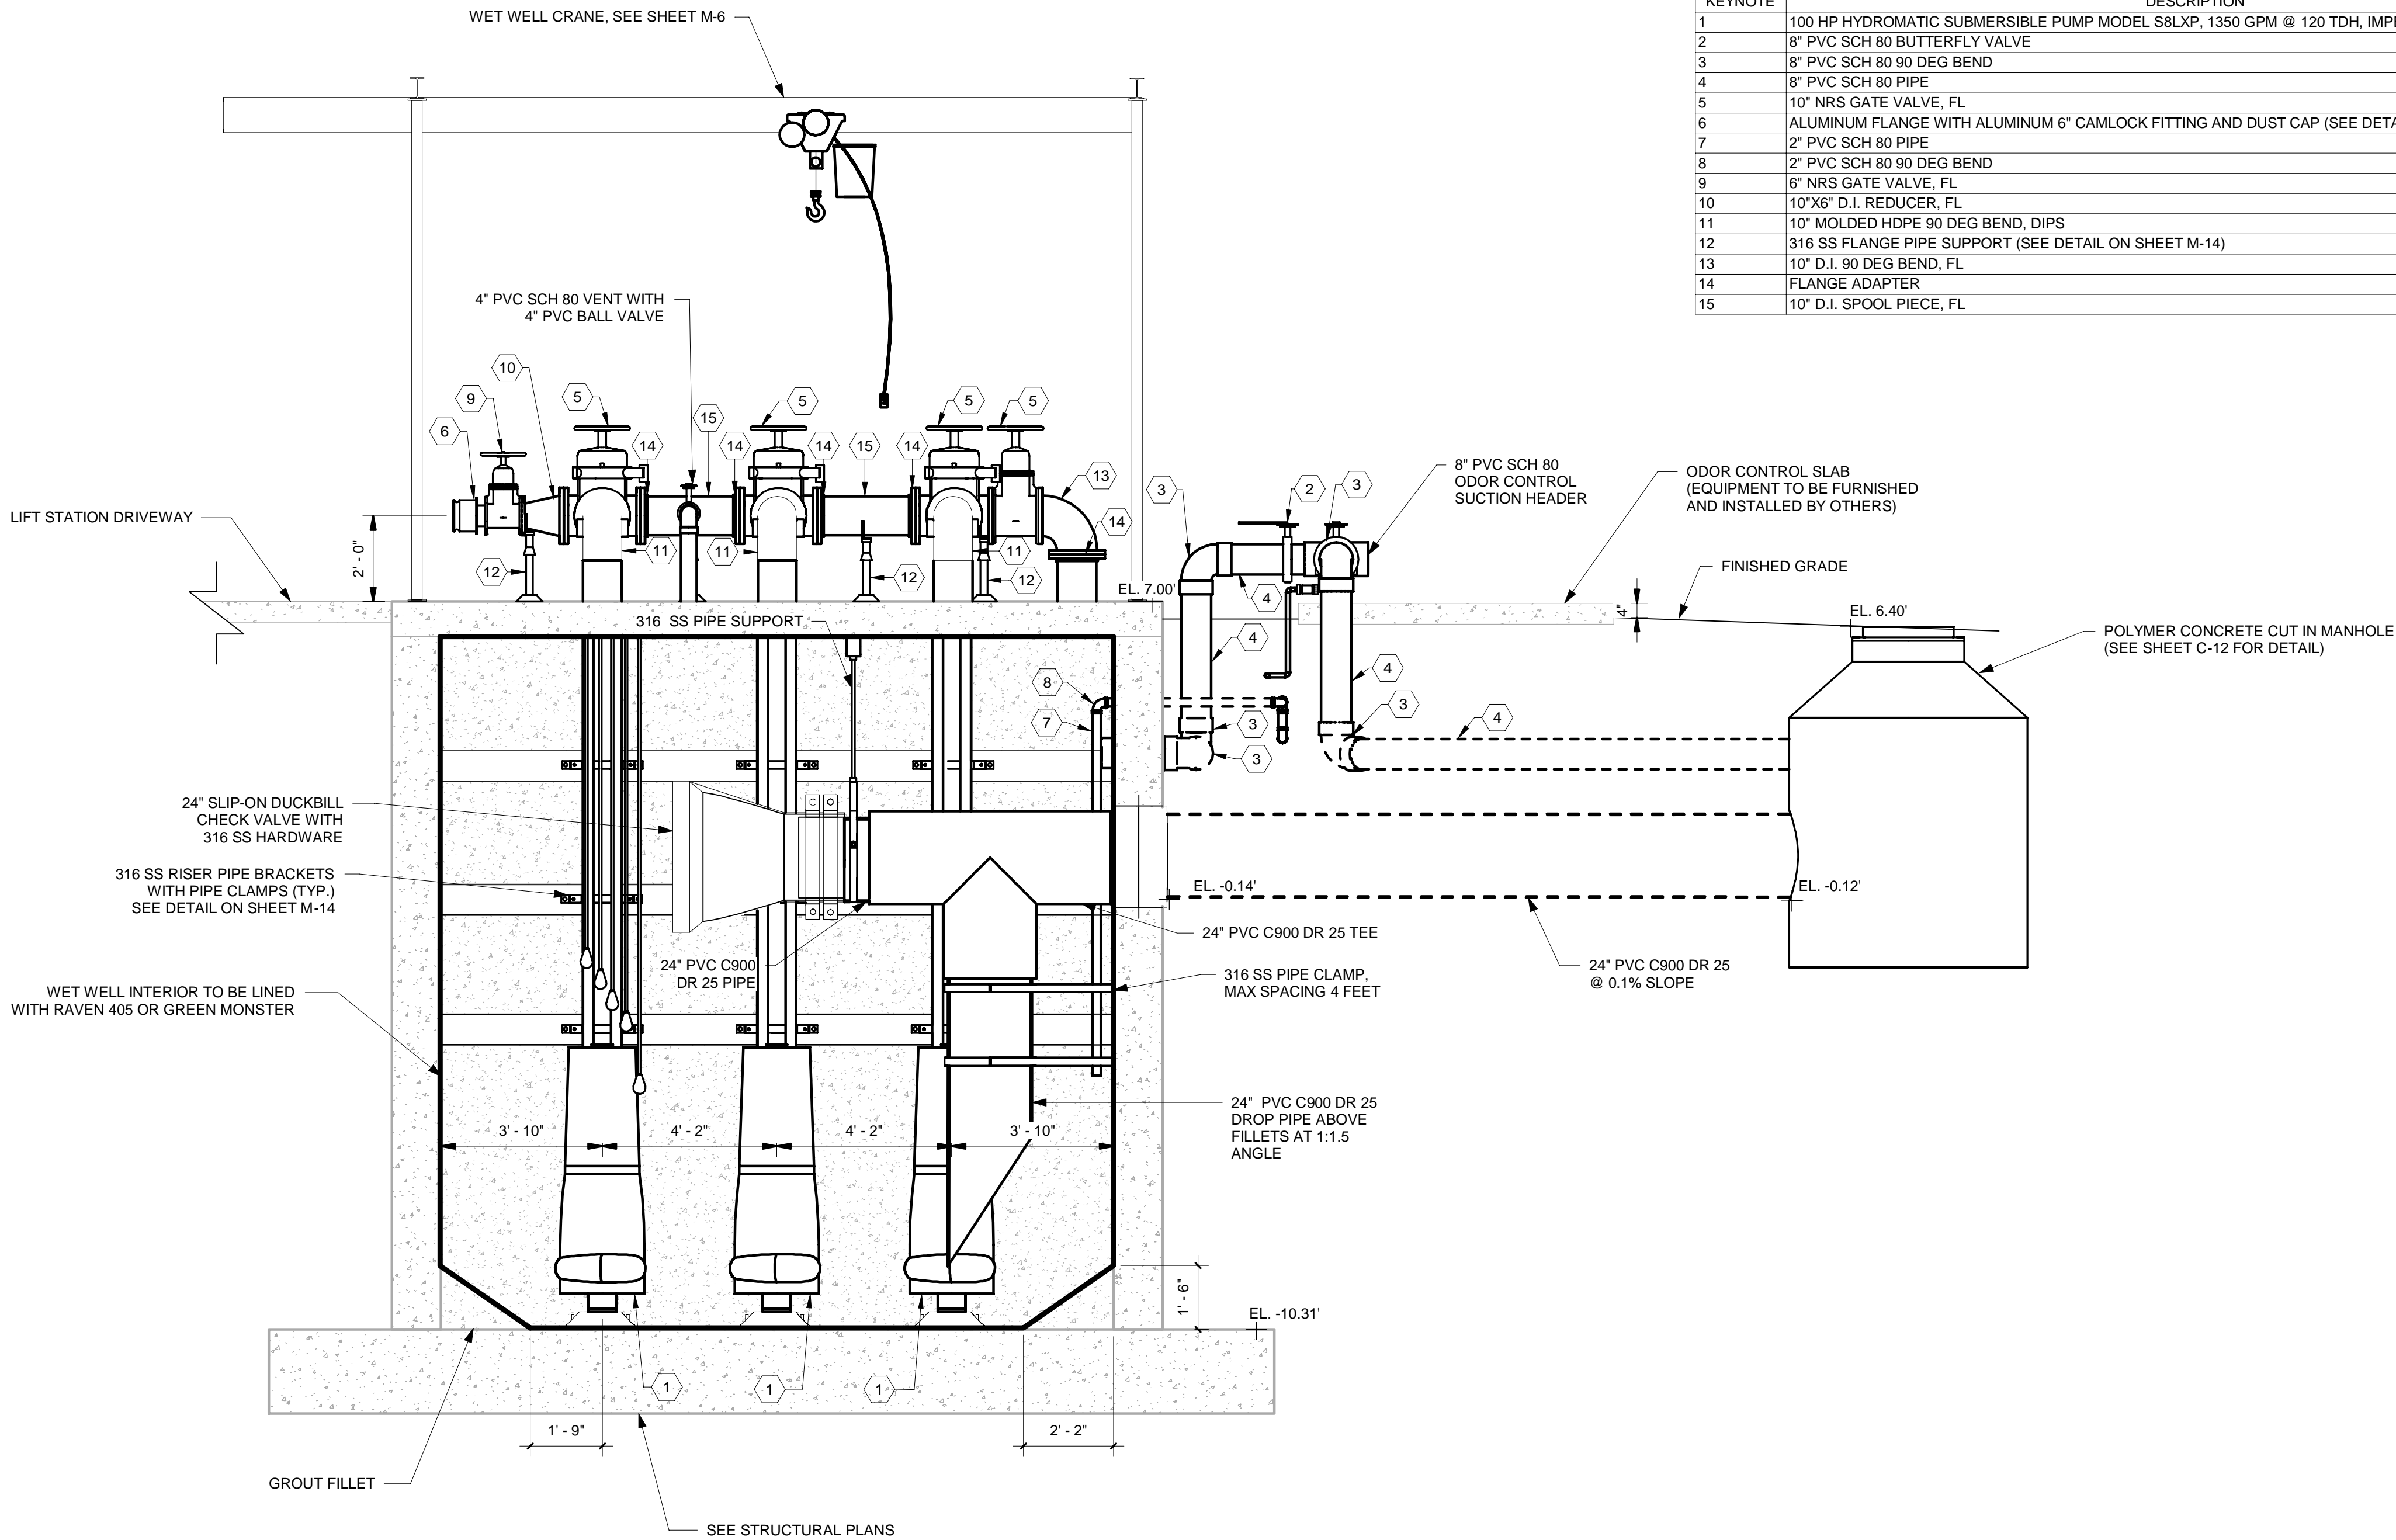5  
M-1

WET WELL INLET SECTION  
3/8" = 1'-0"

GRAPHIC SCALE IN INCHES  
0 2' 4'  
0 3/4" 1-1/2"

No.	REVISIONS	DATE	BY

KimleyHorn

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Manatee  
County  
FLORIDA

BAYSHORE YACHT BASIN FORCE MAIN  
AND LIFT STATION REPLACEMENT  
MANATEE COUNTY  
FL


LICENSED PROFESSIONAL:
MICHAEL A. SEMAGO, P.E.
FL LICENSE NUMBER 87501
DATE:

WETWELL CROSS SECTION II

SHEET NUMBER
M-5





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1 FREE STANDING CRANE PLAN  
3/8" = 1'-0"

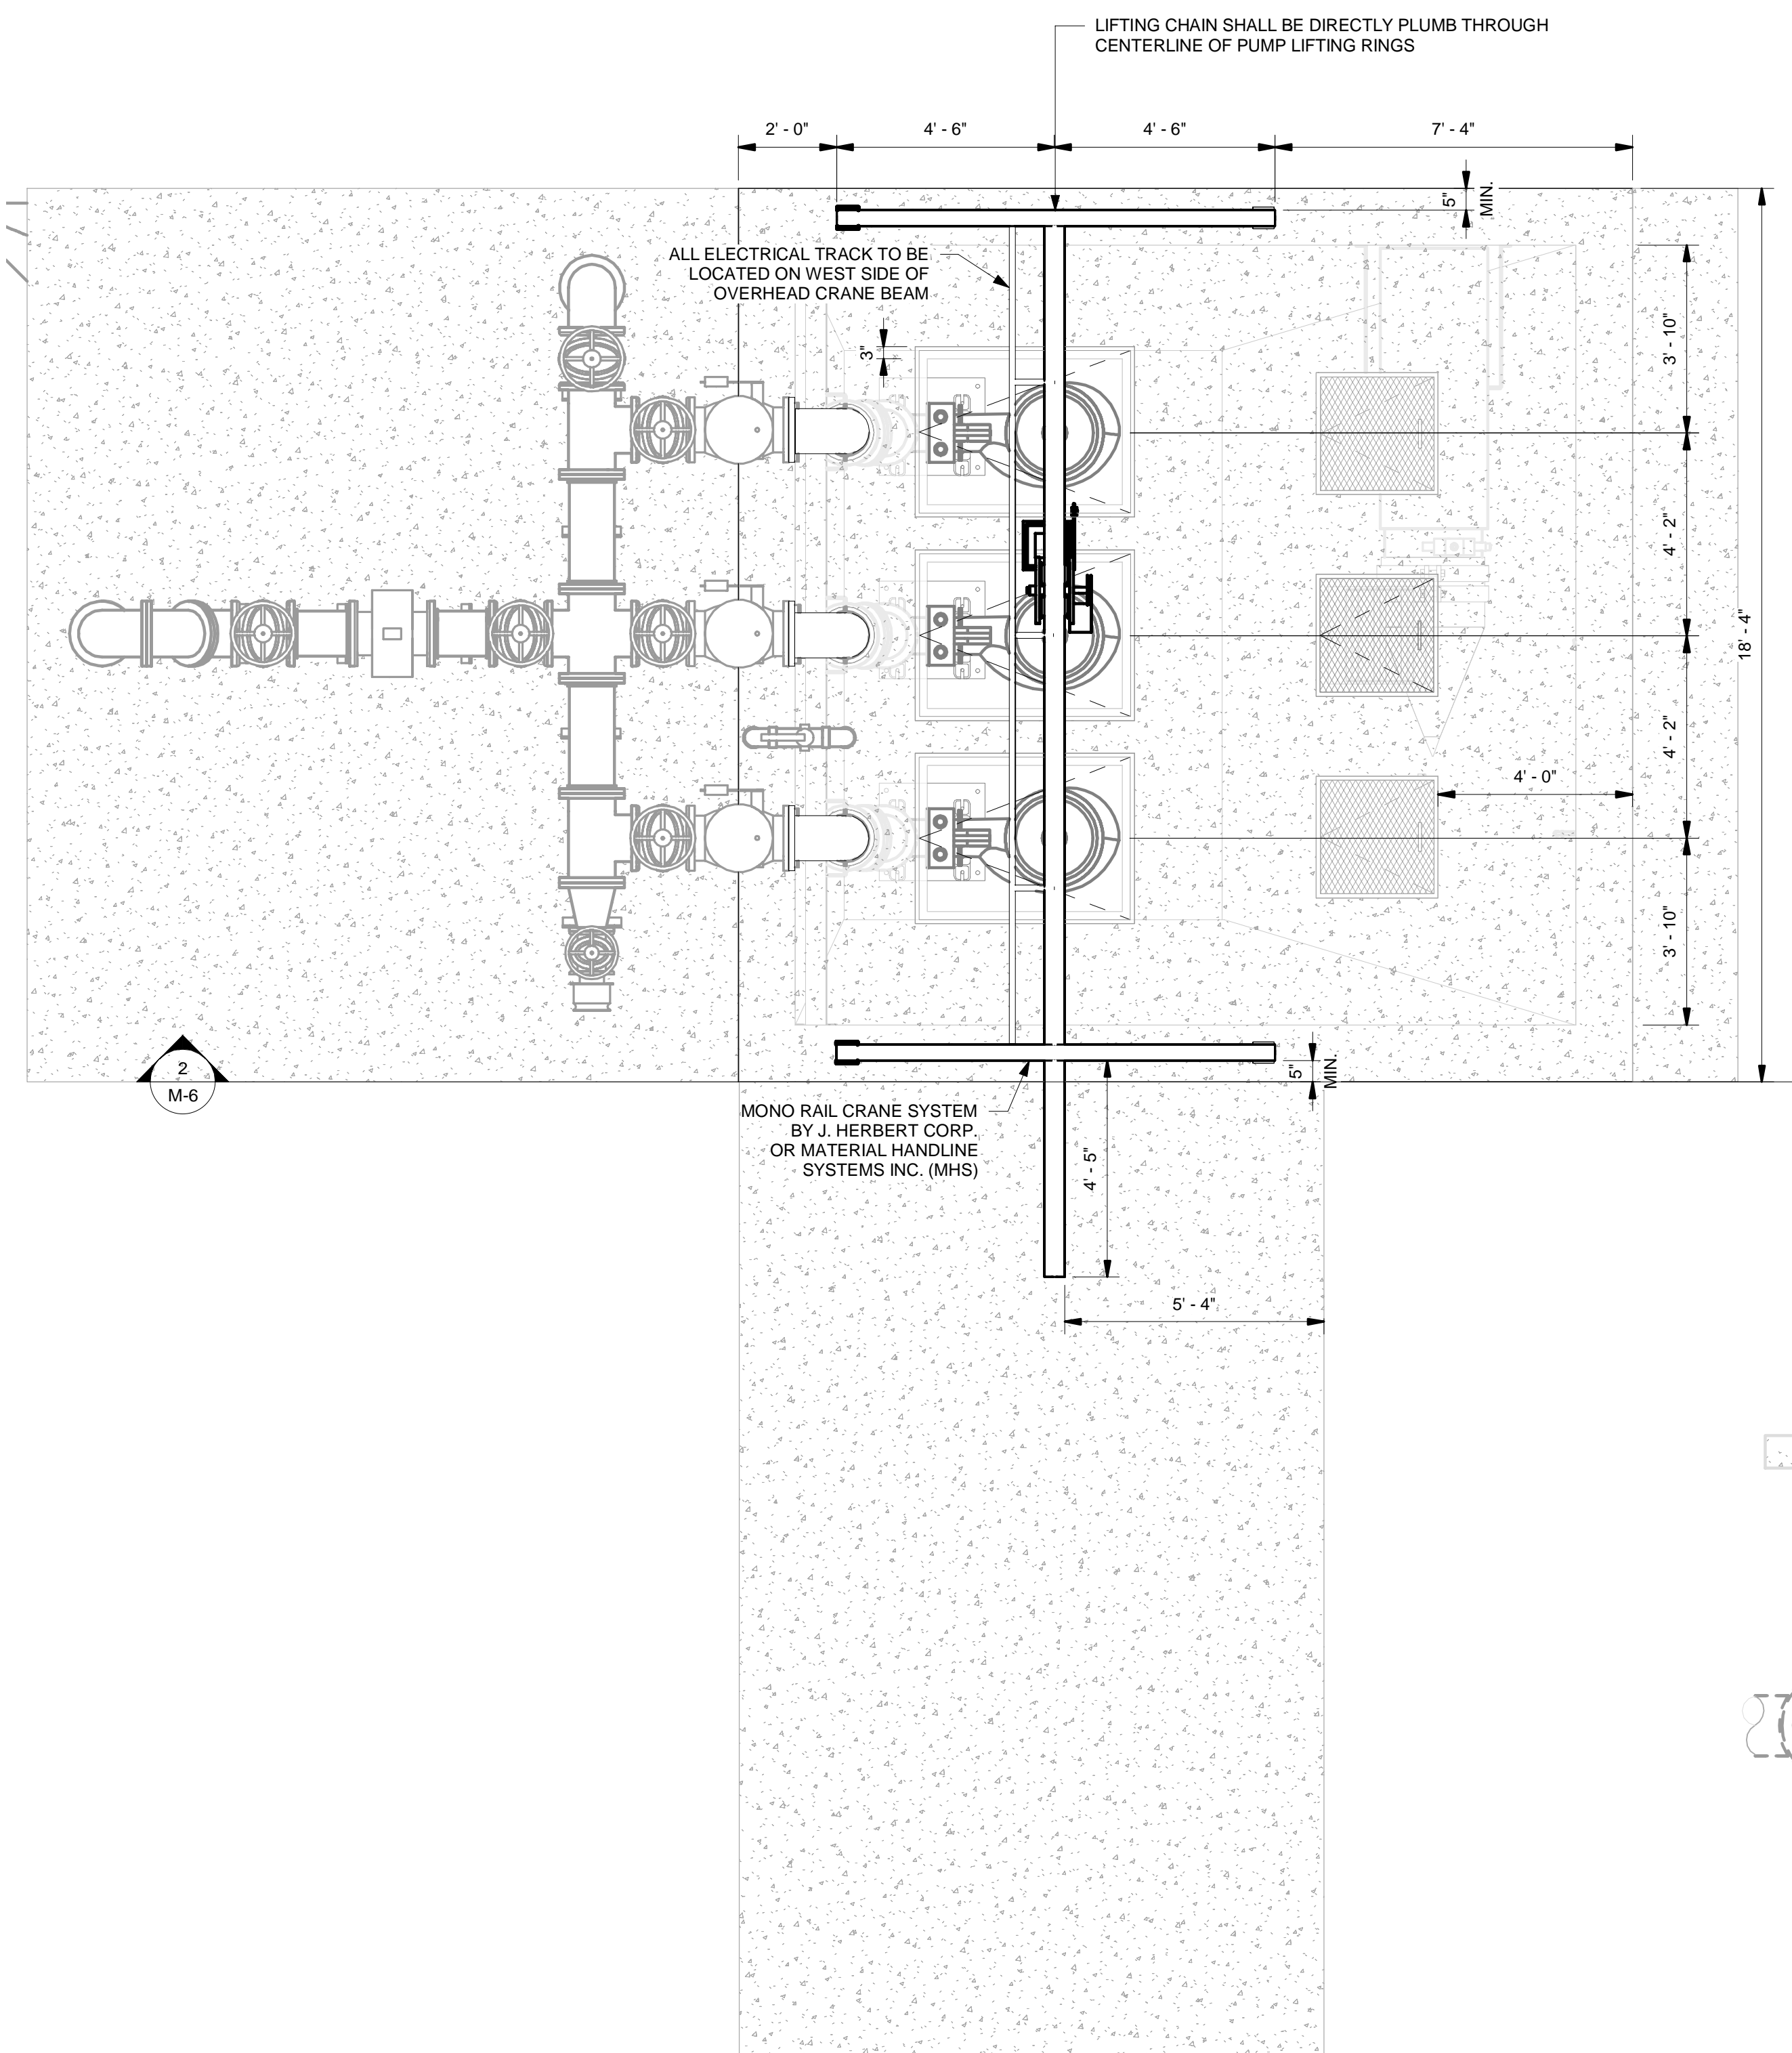GRAPHIC SCALE IN INCHES  
0 2' 4'  
0 3/4" 1-1/2"



2  
M-1

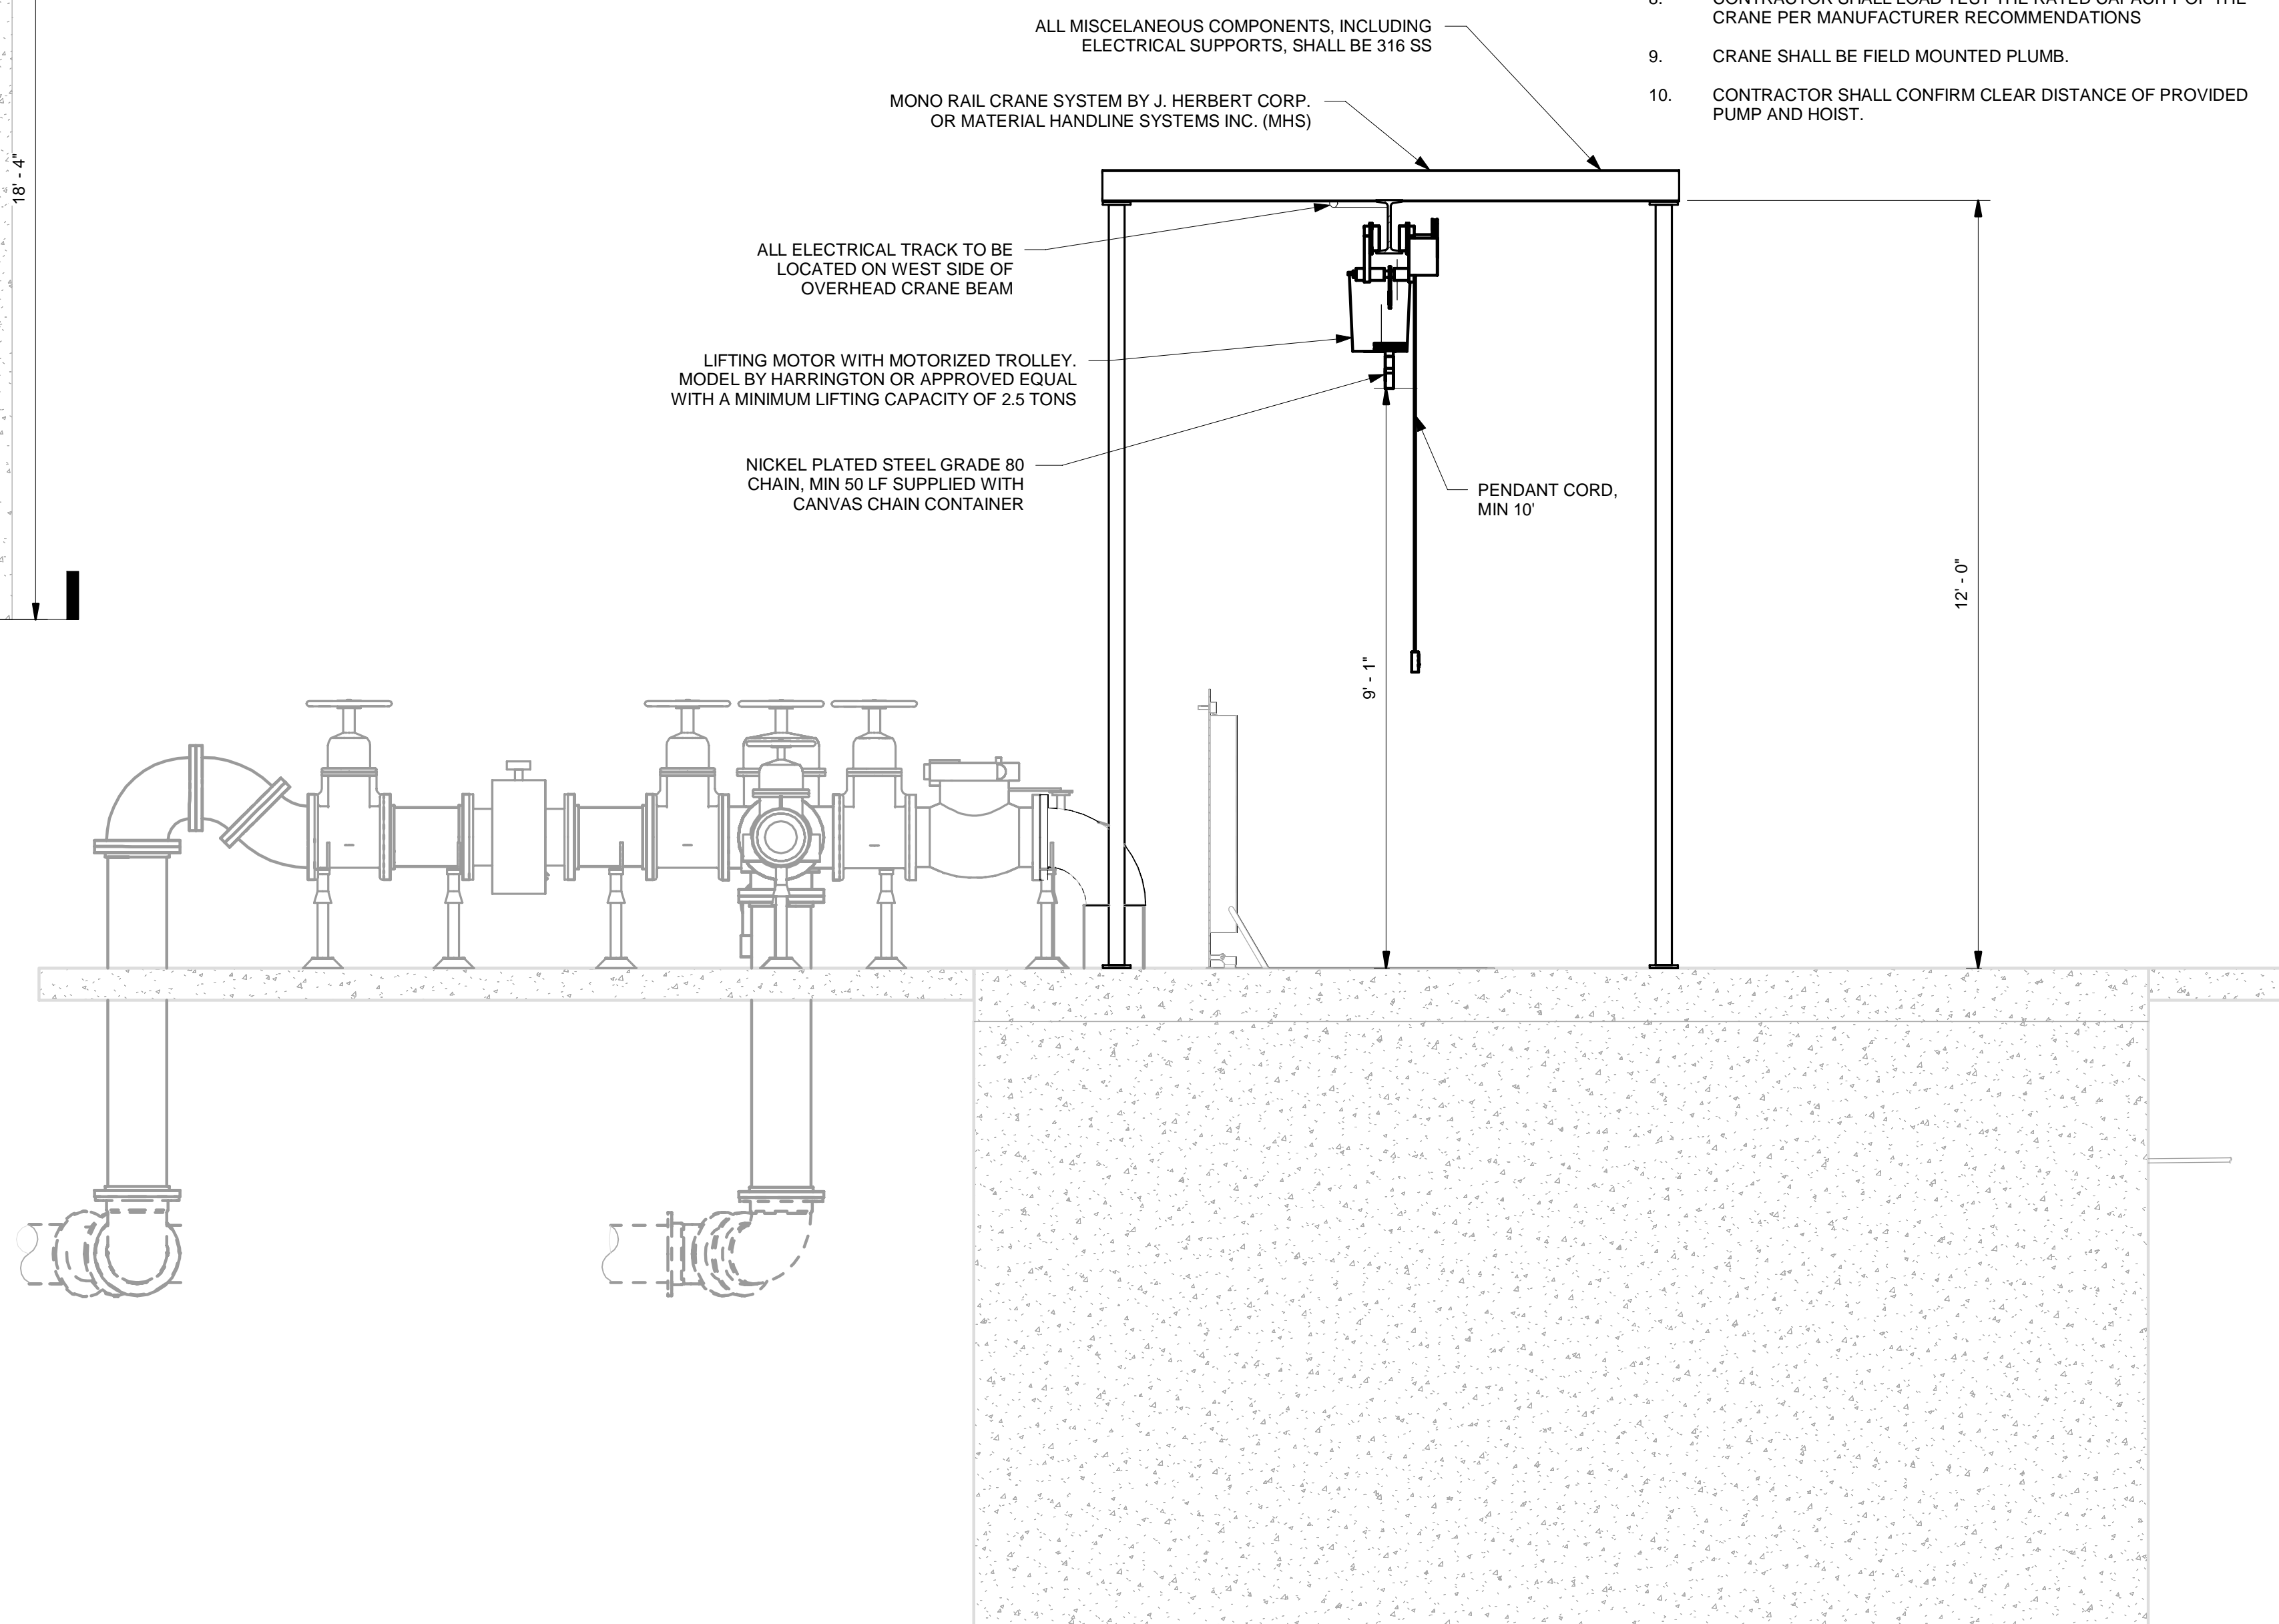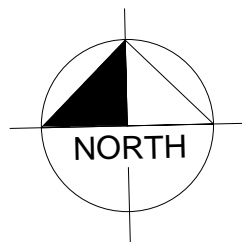FREE STANDING CRANE SECTION

1/2" = 1'-0"

0 1/2' 1' 2'



0 2' 4'

- NOTE:**
1. ALL CRANE STRUCTURAL COMPONENTS SHALL BE DESIGNED, SIGNED AND SEALED BY PROFESSIONAL ENGINEER FROM MANUFACTURER
  2. ALL CRANE COMPONENTS SHALL BE GRAY PRIMED AND HAVE AN OUTDOOR CORROSION RESISTANT ACRYLIC ENAMEL PAINT FINISH
  3. ALL ELECTRICAL EQUIPMENT SHALL BE IP55 RATED FOR OUTDOOR ENVIRONMENTAL USE
  4. CONTRACTOR TO INSTALL CRANE AND COMPONENTS PER MANUFACTURER RECOMMENDATION
  5. CONTRACTOR TO COORDINATE WITH MANUFACTURER FOR BOLTS PATTERN TEMPLATES AND ANCHOR BOLTS
  6. CONTRACTOR TO INSTALL FULLY FUNCTIONAL CRANE SYSTEM
  7. CONTRACTOR TO SUPPLY ENOUGH ELECTRICAL CABLE TO REACH HOIST DISCONNECT FROM ALL POINTS OF TRAVEL
  8. CONTRACTOR SHALL LOAD TEST THE RATED CAPACITY OF THE CRANE PER MANUFACTURER RECOMMENDATIONS
  9. CRANE SHALL BE FIELD MOUNTED PLUMB.
  10. CONTRACTOR SHALL CONFIRM CLEAR DISTANCE OF PROVIDED PUMP AND HOIST.

[illegible]



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DATE FEB 2022
SCALE: AS SHOWN
DESIGNED BY: MAS
DRAWN BY: RLL
CHECKED BY: SNR

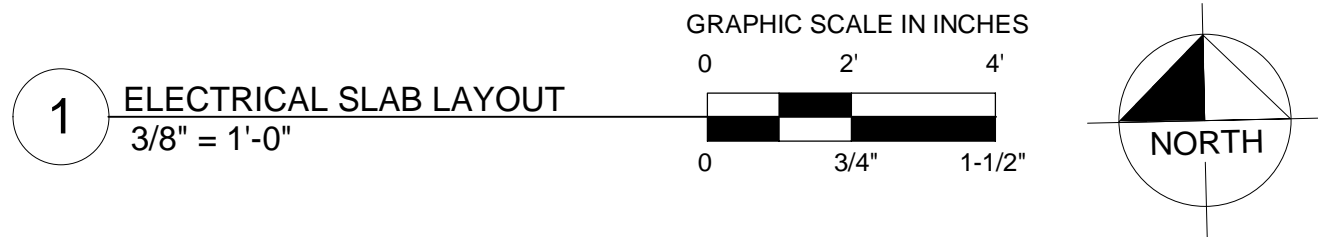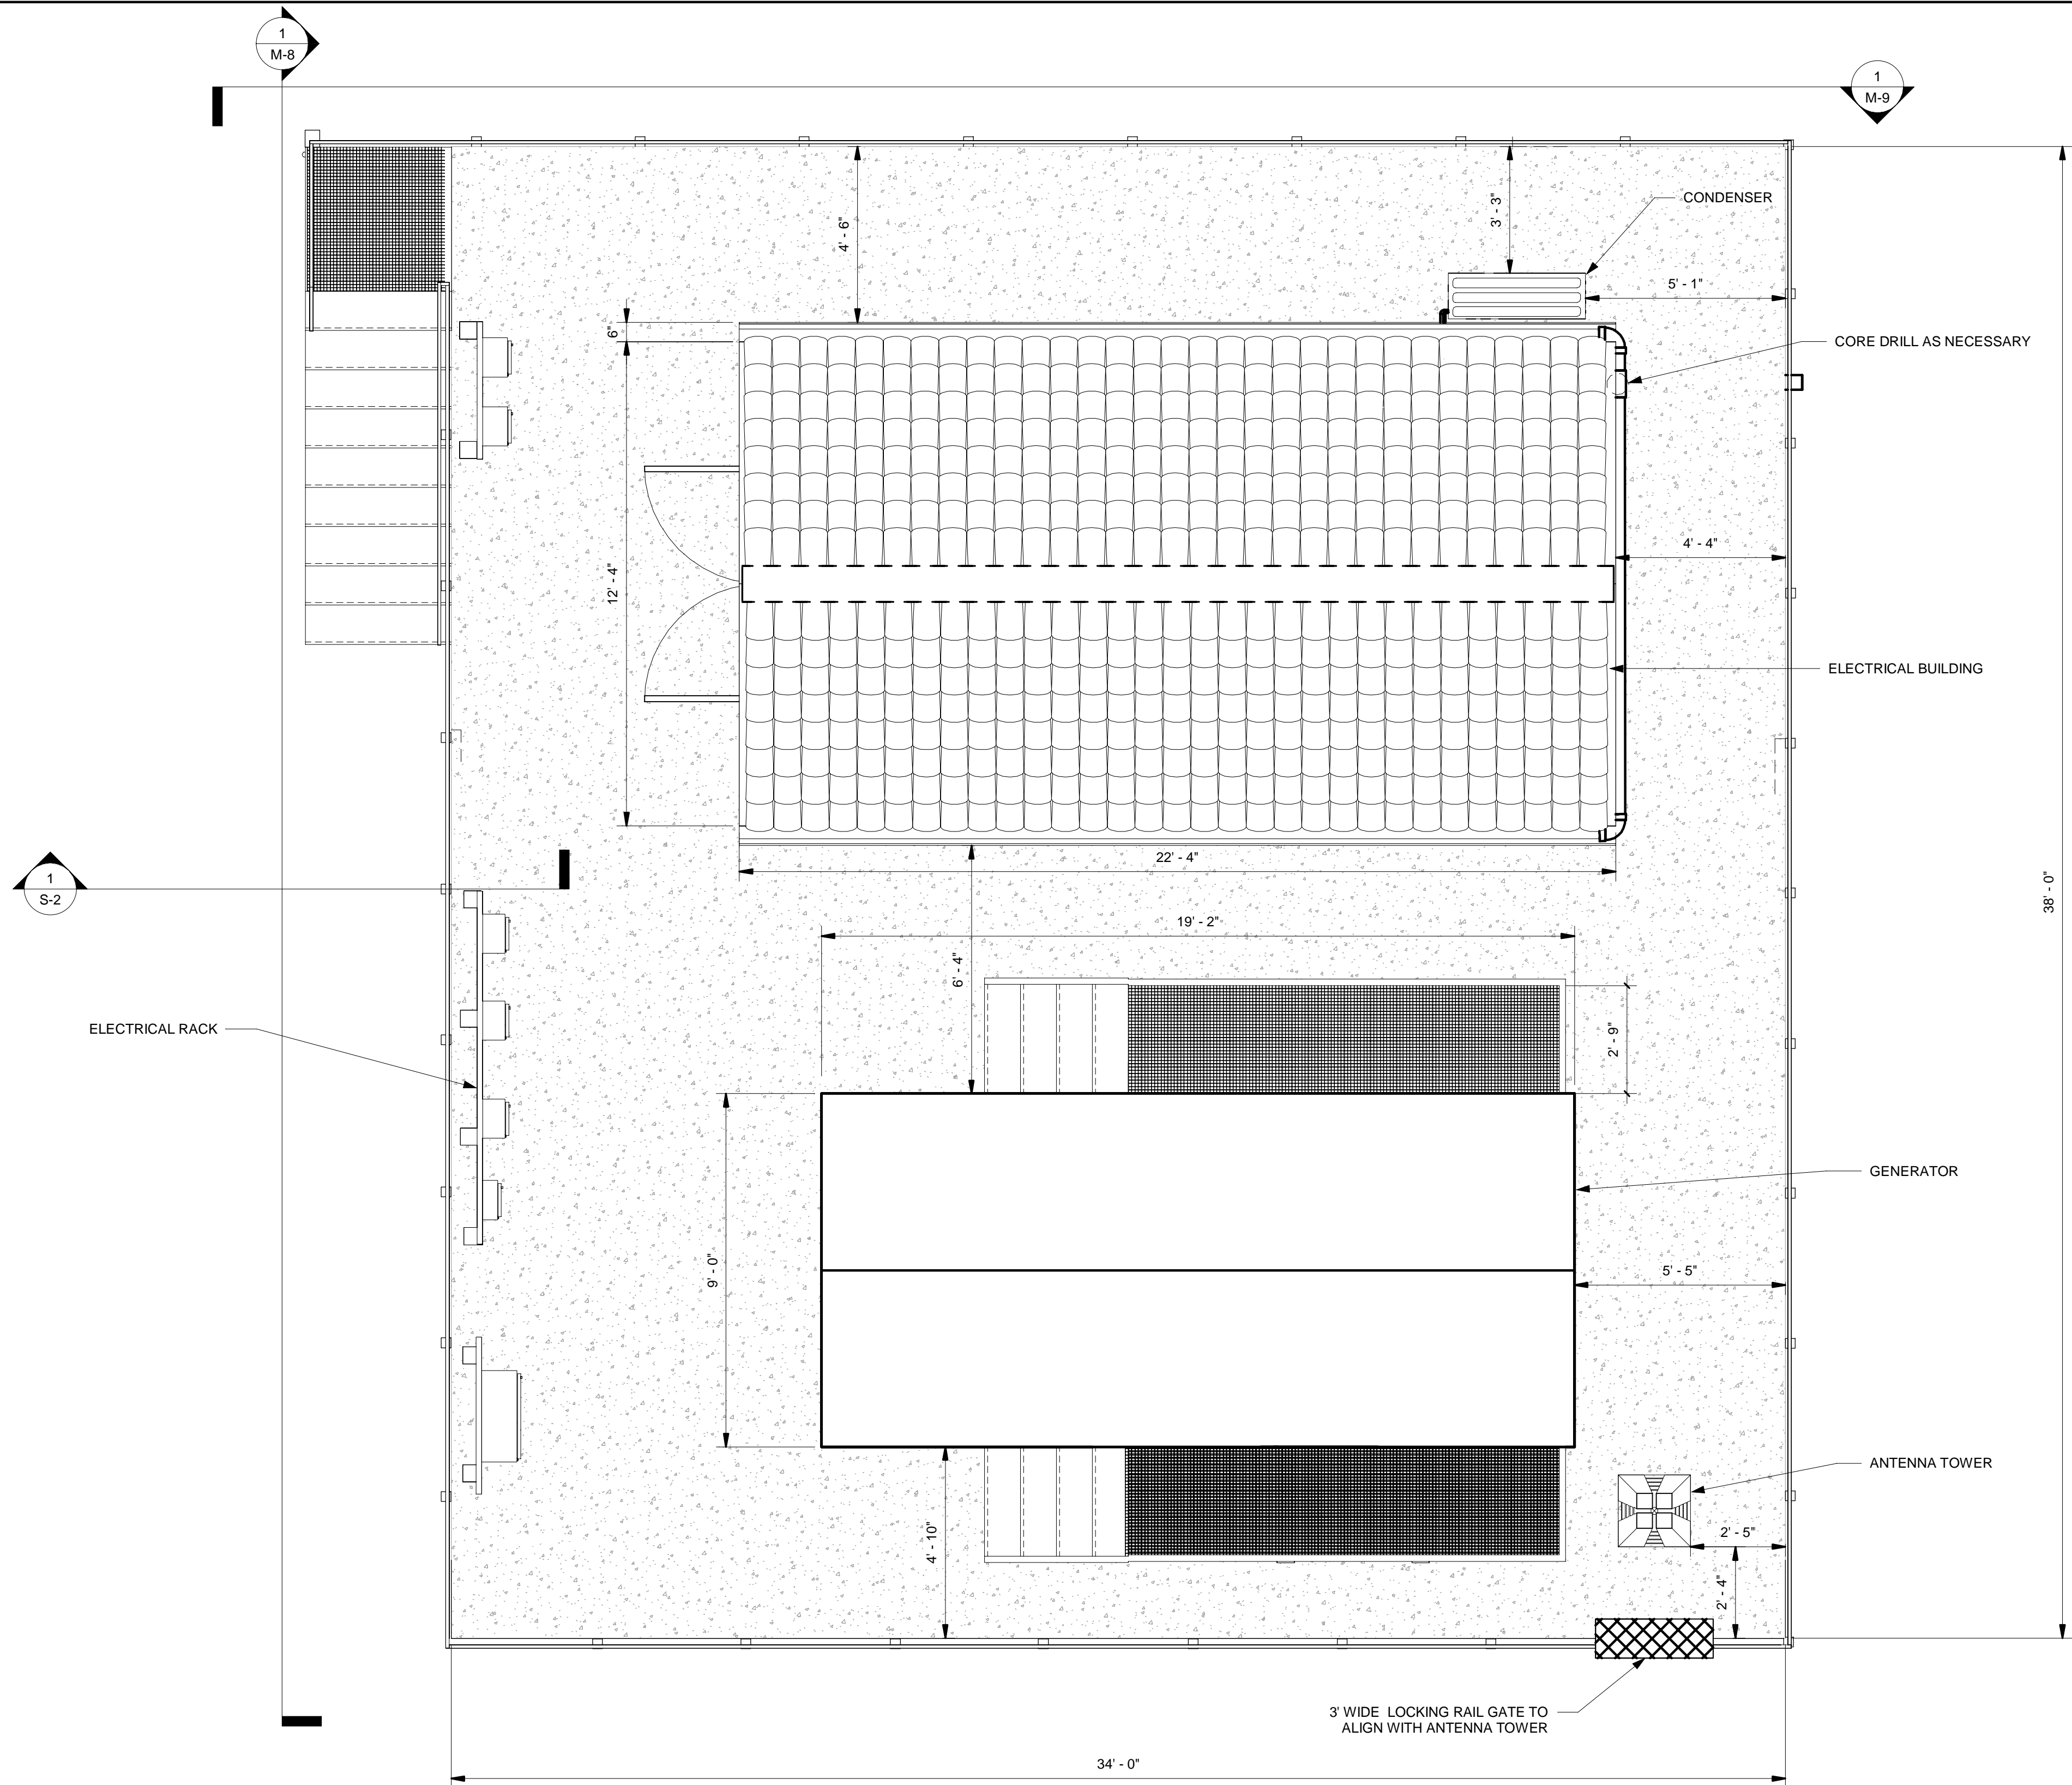  
**BAYSHORE YACHT BASIN FORCE MAIN  
AND LIFT STATION REPLACEMENT**  
MANATEE COUNTY FL


LICENSED PROFESSIONAL:
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FL LICENSE NUMBER 87501
DATE:

**ELEVATED PLATFORM PLAN**

SHEET NUMBER
M-7




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1

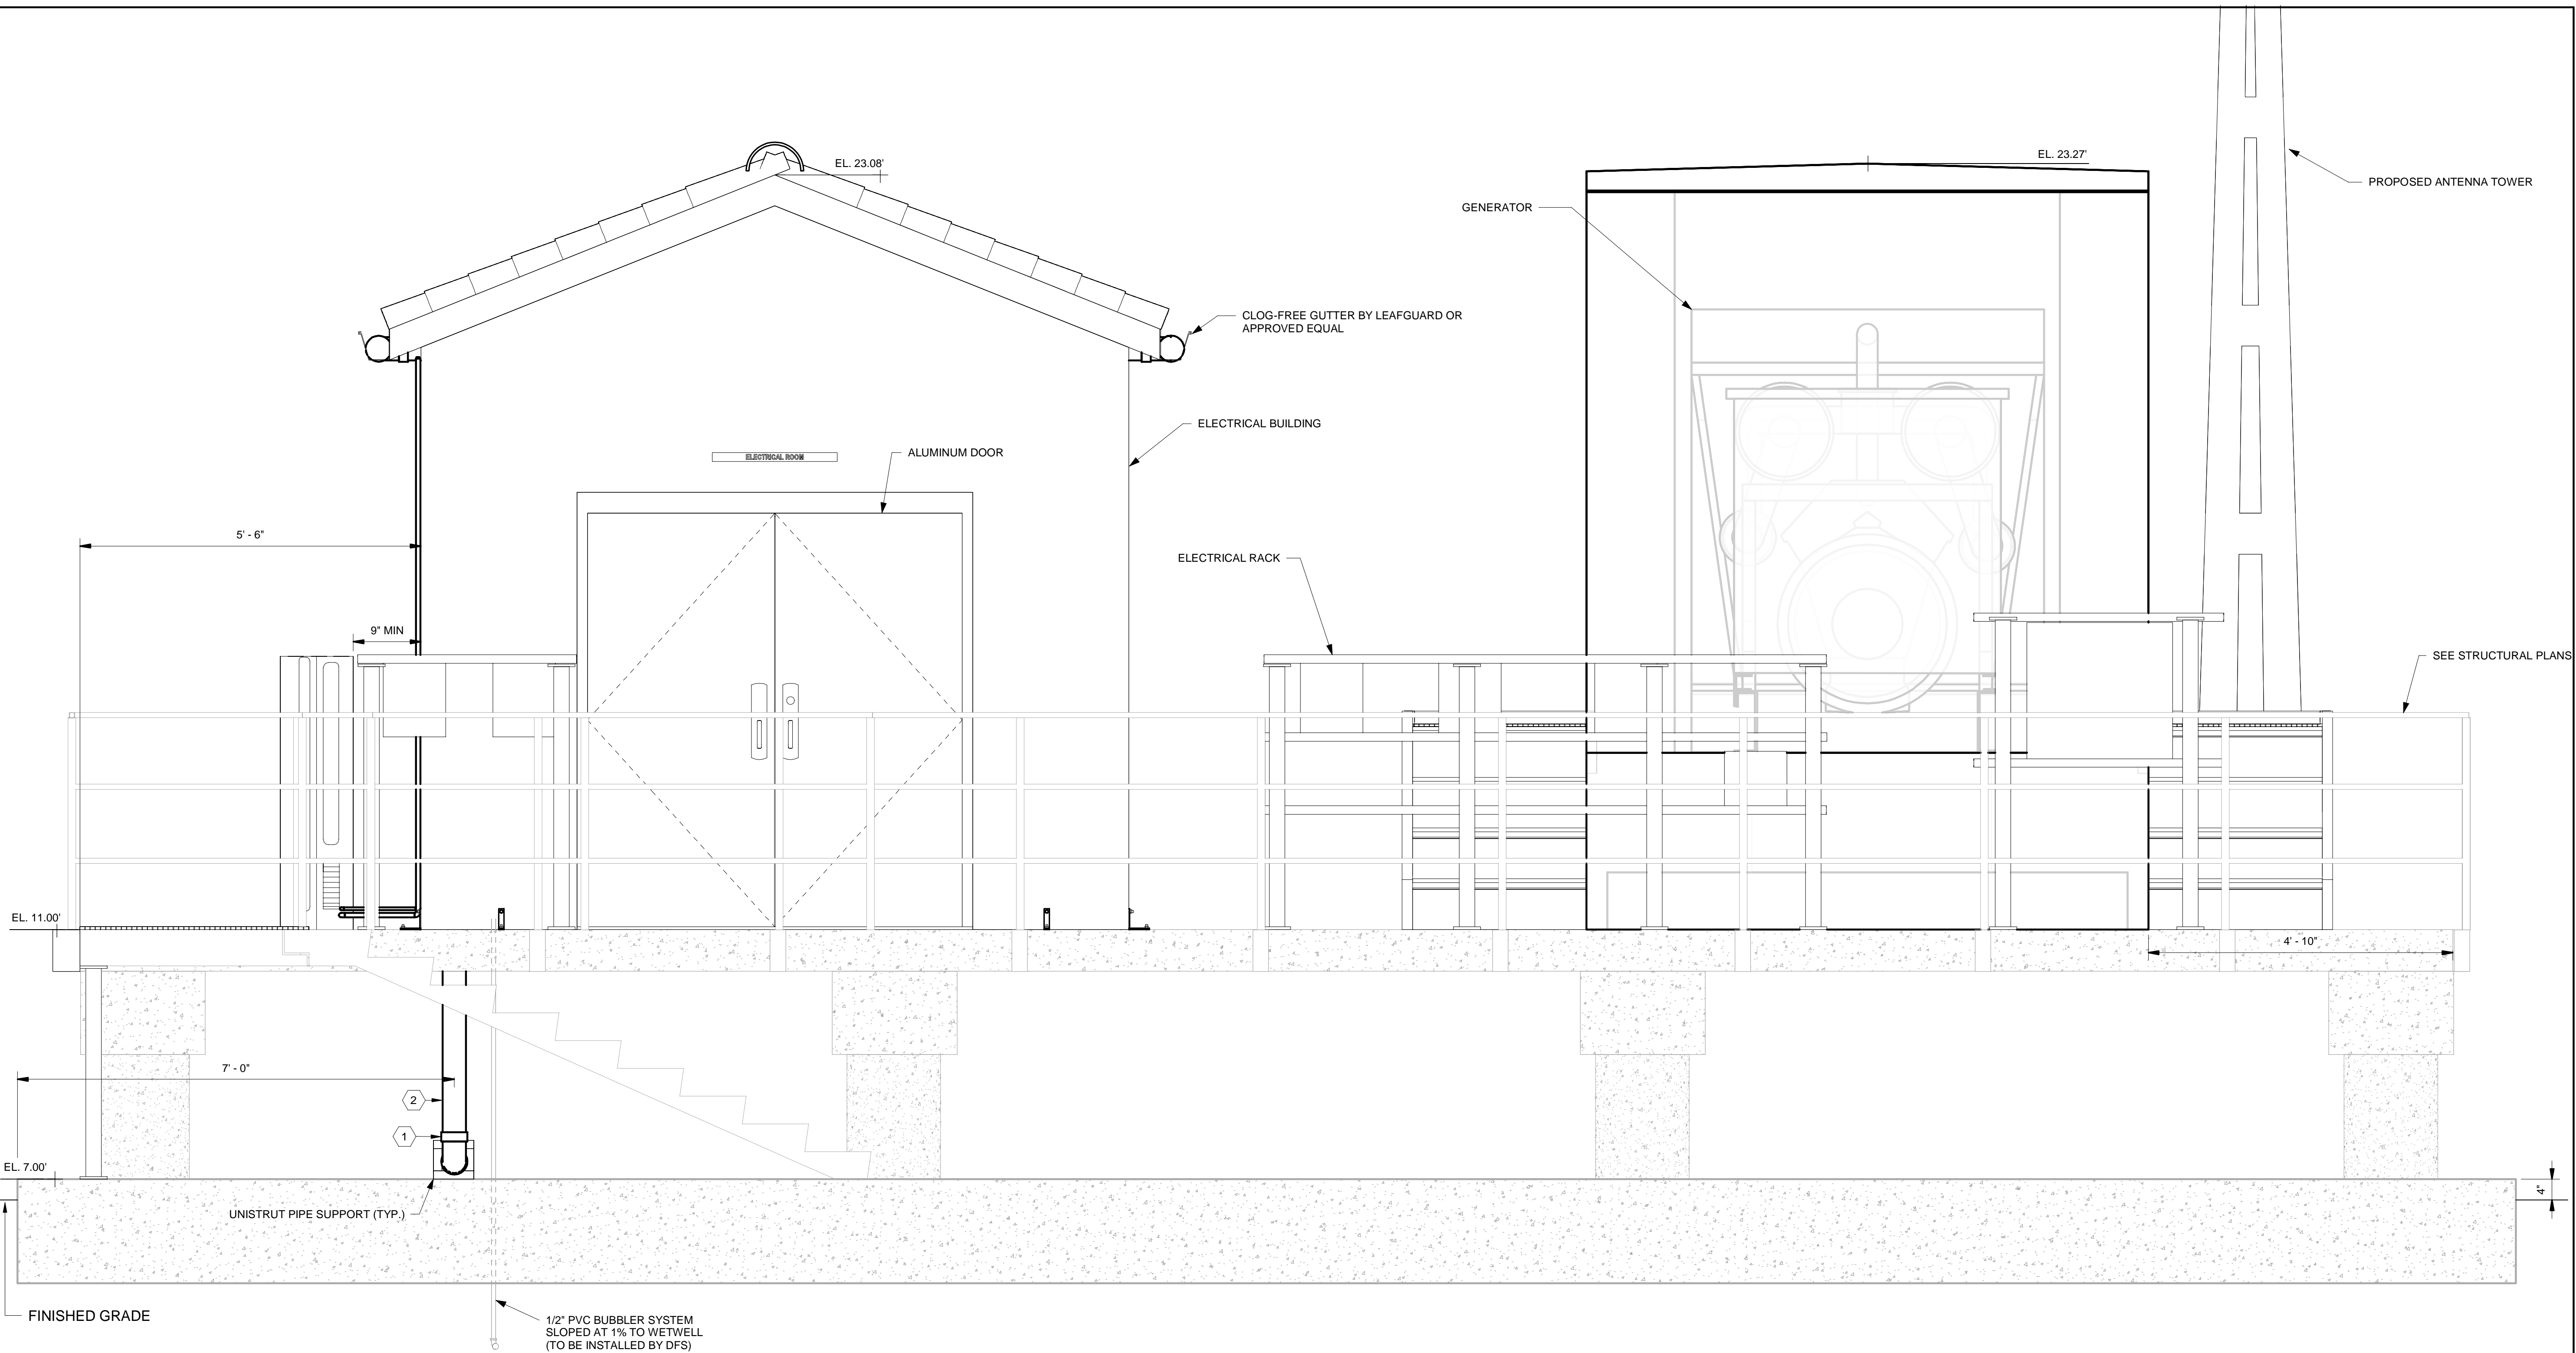ELECTRICAL BUILDING WEST  
ELEVATION  
3/4" = 1'-0"




KEYNOTE LEGEND	
KEY VALUE	KEYNOTE TEXT
1	4" PVC SCH 80 90 DEG BEND
2	4" PVC SCH 80 PIPE
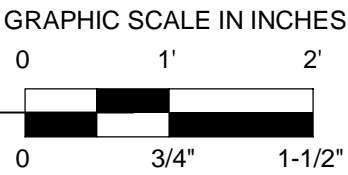
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DRAWN BY: RLL
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**BAYSHORE YACHT BASIN FORCE MAIN  
AND LIFT STATION REPLACEMENT**  
MANATEE COUNTY    FL


LICENSED PROFESSIONAL:
MICHAEL A. SEMAGO, PE
FL LICENSE NUMBER 87501
DATE:

**ELECTRICAL BUILDING WEST  
ELEVATION**

SHEET NUMBER  
**M-8**



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KEYNOTE LEGEND	
KEY VALUE	KEYNOTE TEXT
1	4" PVC SCH 80 PIPE
2	4" PVC SCH 80 90 DEG BEND
3	4" PVC SCH 80 TEE

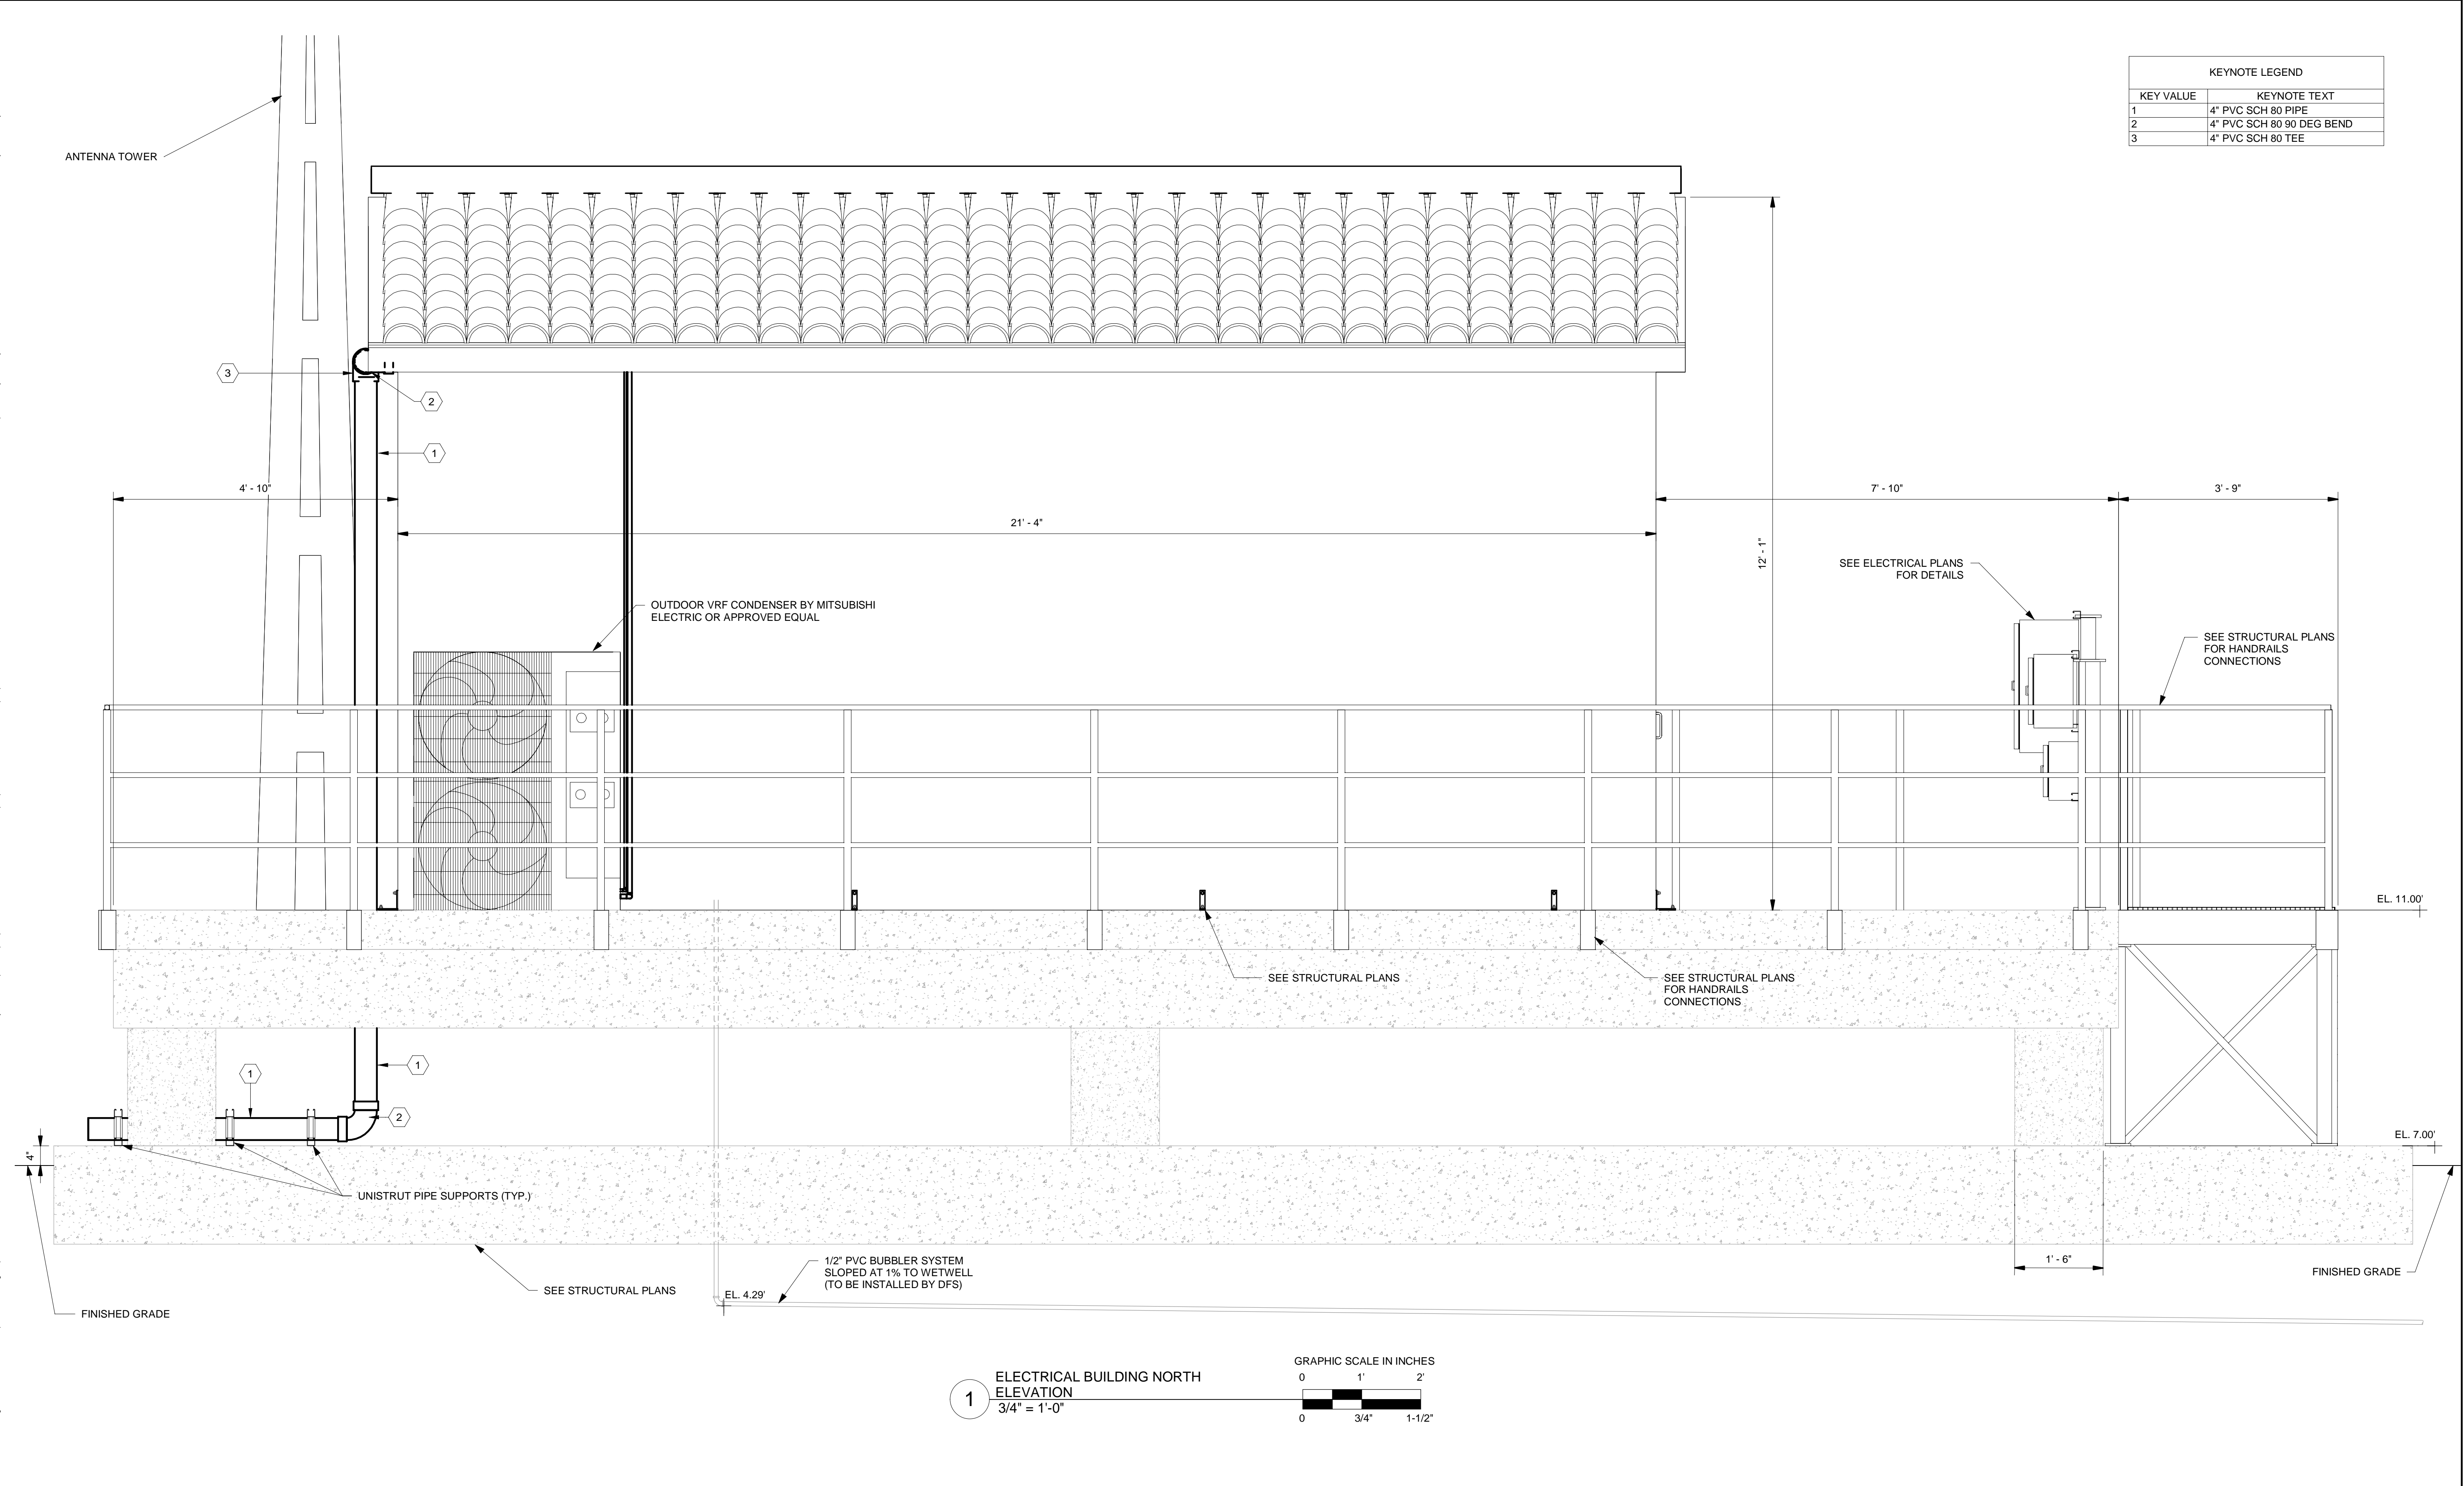1 ELECTRICAL BUILDING NORTH  
ELEVATION  
3/4" = 1'-0"



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DATE FEB 2022
SCALE: AS SHOWN
DESIGNED BY: MAS
DRAWN BY: RLL
CHECKED BY: SNR



BAYSHORE YACHT BASIN FORCE MAIN  
AND LIFT STATION REPLACEMENT  
MANATEE COUNTY



LICENSED PROFESSIONAL:
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FL LICENSE NUMBER 87501
DATE:

ELECTRICAL BUILDING NORTH  
ELEVATION

SHEET NUMBER
M-9



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- NOTES:
1. CONTRACTOR SHALL COORDINATE WITH PREFABRICATED BUILDING SUPPLIER FOR PIPE PENETRATIONS AND EQUIPMENT INSTALLATION DURING SHOP DRAWING REVIEW.
  2. BUILDING SHALL BE FURNISHED PER SPECIFICATION SECTION 13340.
  3. ALL HARDWARE SHALL BE ALUMINUM WHERE POSSIBLE OR 316 STAINLESS STEEL.
  4. BUILDING DOORS SHALL BE ALUMINUM.
  5. ALL GUTTERS AND DOWN SPOUTS SHALL BE LEAFGUARD® OR APPROVED EQUAL.
  6. FIRE EXTINGUISHER SHALL BE FURNISHED INSIDE BUILDING (FIELD LOCATE WITH COUNTY INSPECTOR).
  7. BUILDING SHALL HAVE A LIGHT BEIGE STUCCO FINISH WITH RED TILE ROOF APPLIED PER MANUFACTURER'S RECOMMENDATIONS. FINISH COLOR SHALL BE COORDINATED AND APPROVED BY MANATEE COUNTY BEFORE FABRICATION OR CONSTRUCTION.

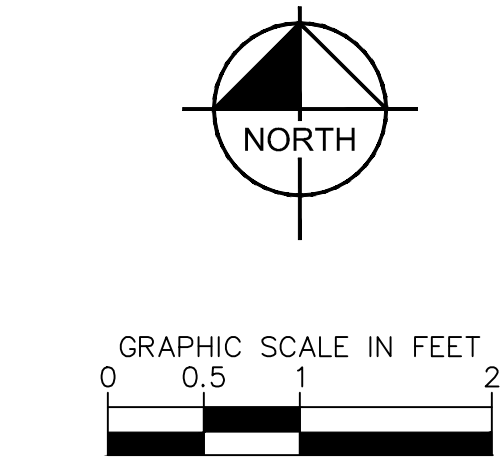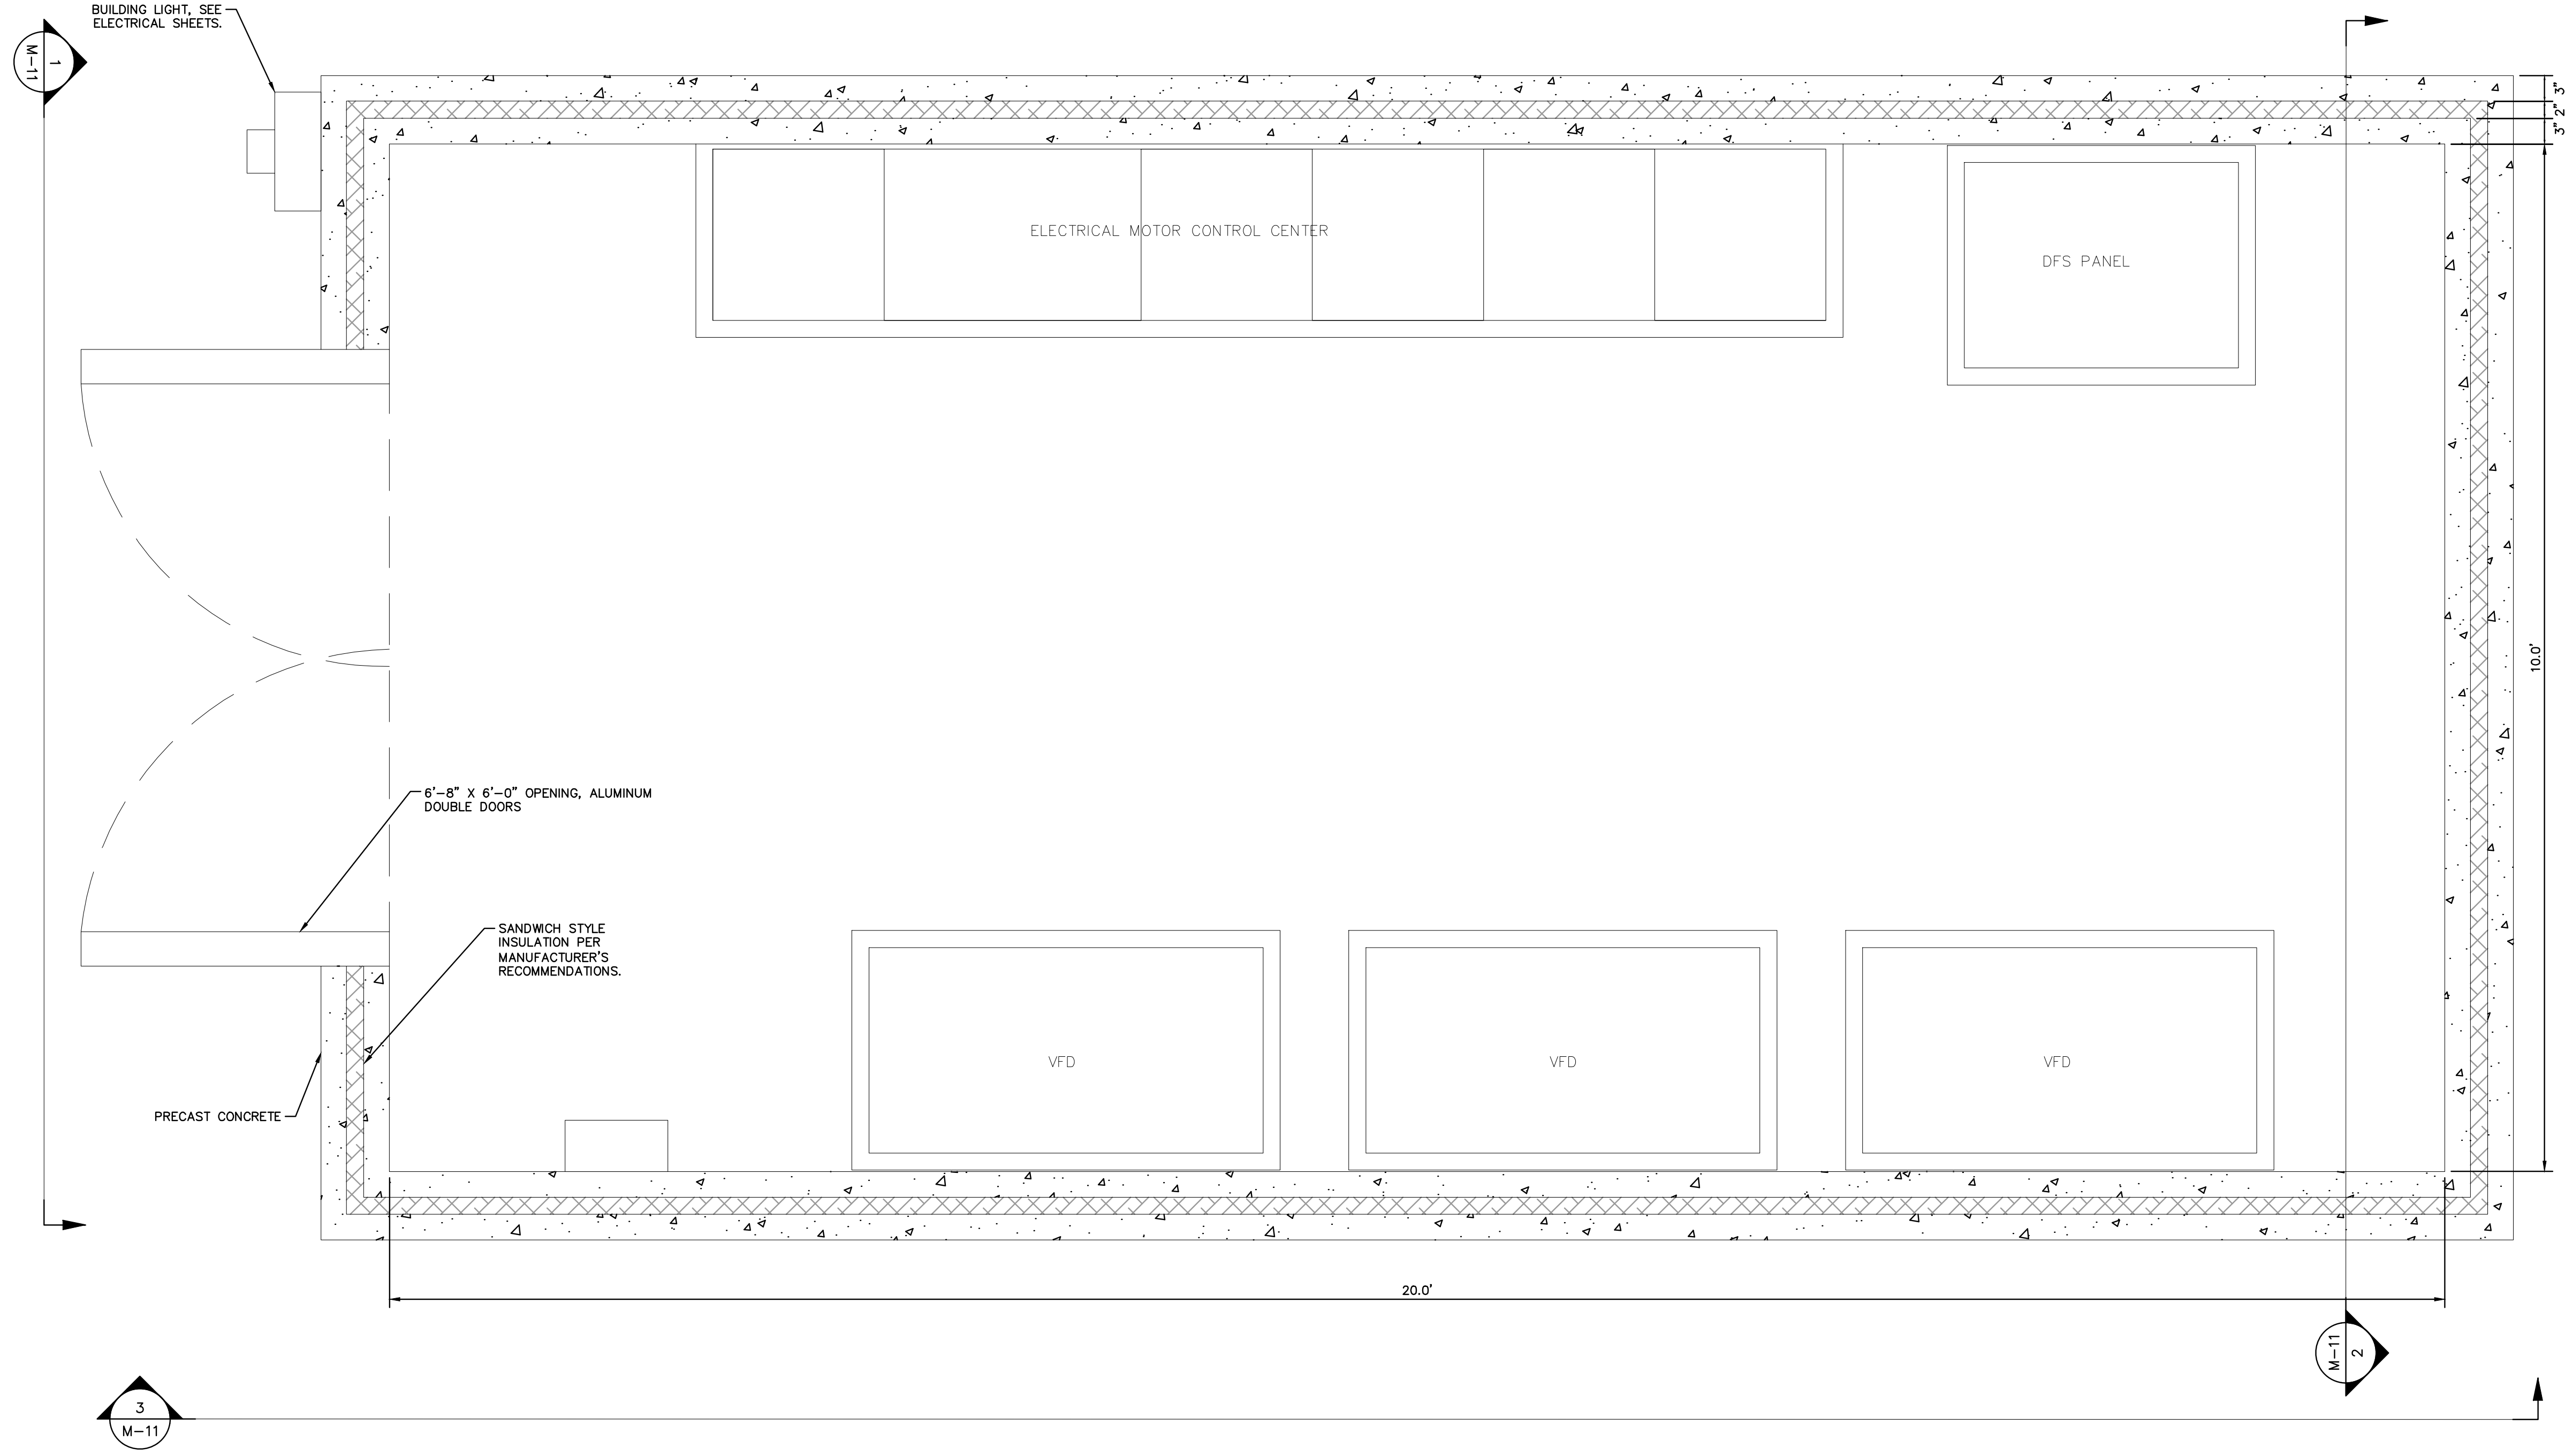1  
M-10


PREFABRICATED BUILDING PLAN  
SCALE: 1" = 1'

No.	REVISIONS	DATE	BY



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KHA PROJECT	148400067
DATE	FEB 2022
SCALE	AS SHOWN
DESIGNED BY	MAS
DRAWN BY	GMB
CHECKED BY	SNR



**BAYSHORE YACHT BASIN FORCE MAIN  
AND LIFT STATION REPLACEMENT**

MANATEE COUNTY

LICENSED PROFESSIONAL

MICHAEL A. SEMAGO, P.E.

FL LICENSE NUMBER  
87501

FL DATE:




**PREFABRICATED BUILDING -  
PLAN**

SHEET NUMBER


**M-10**



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

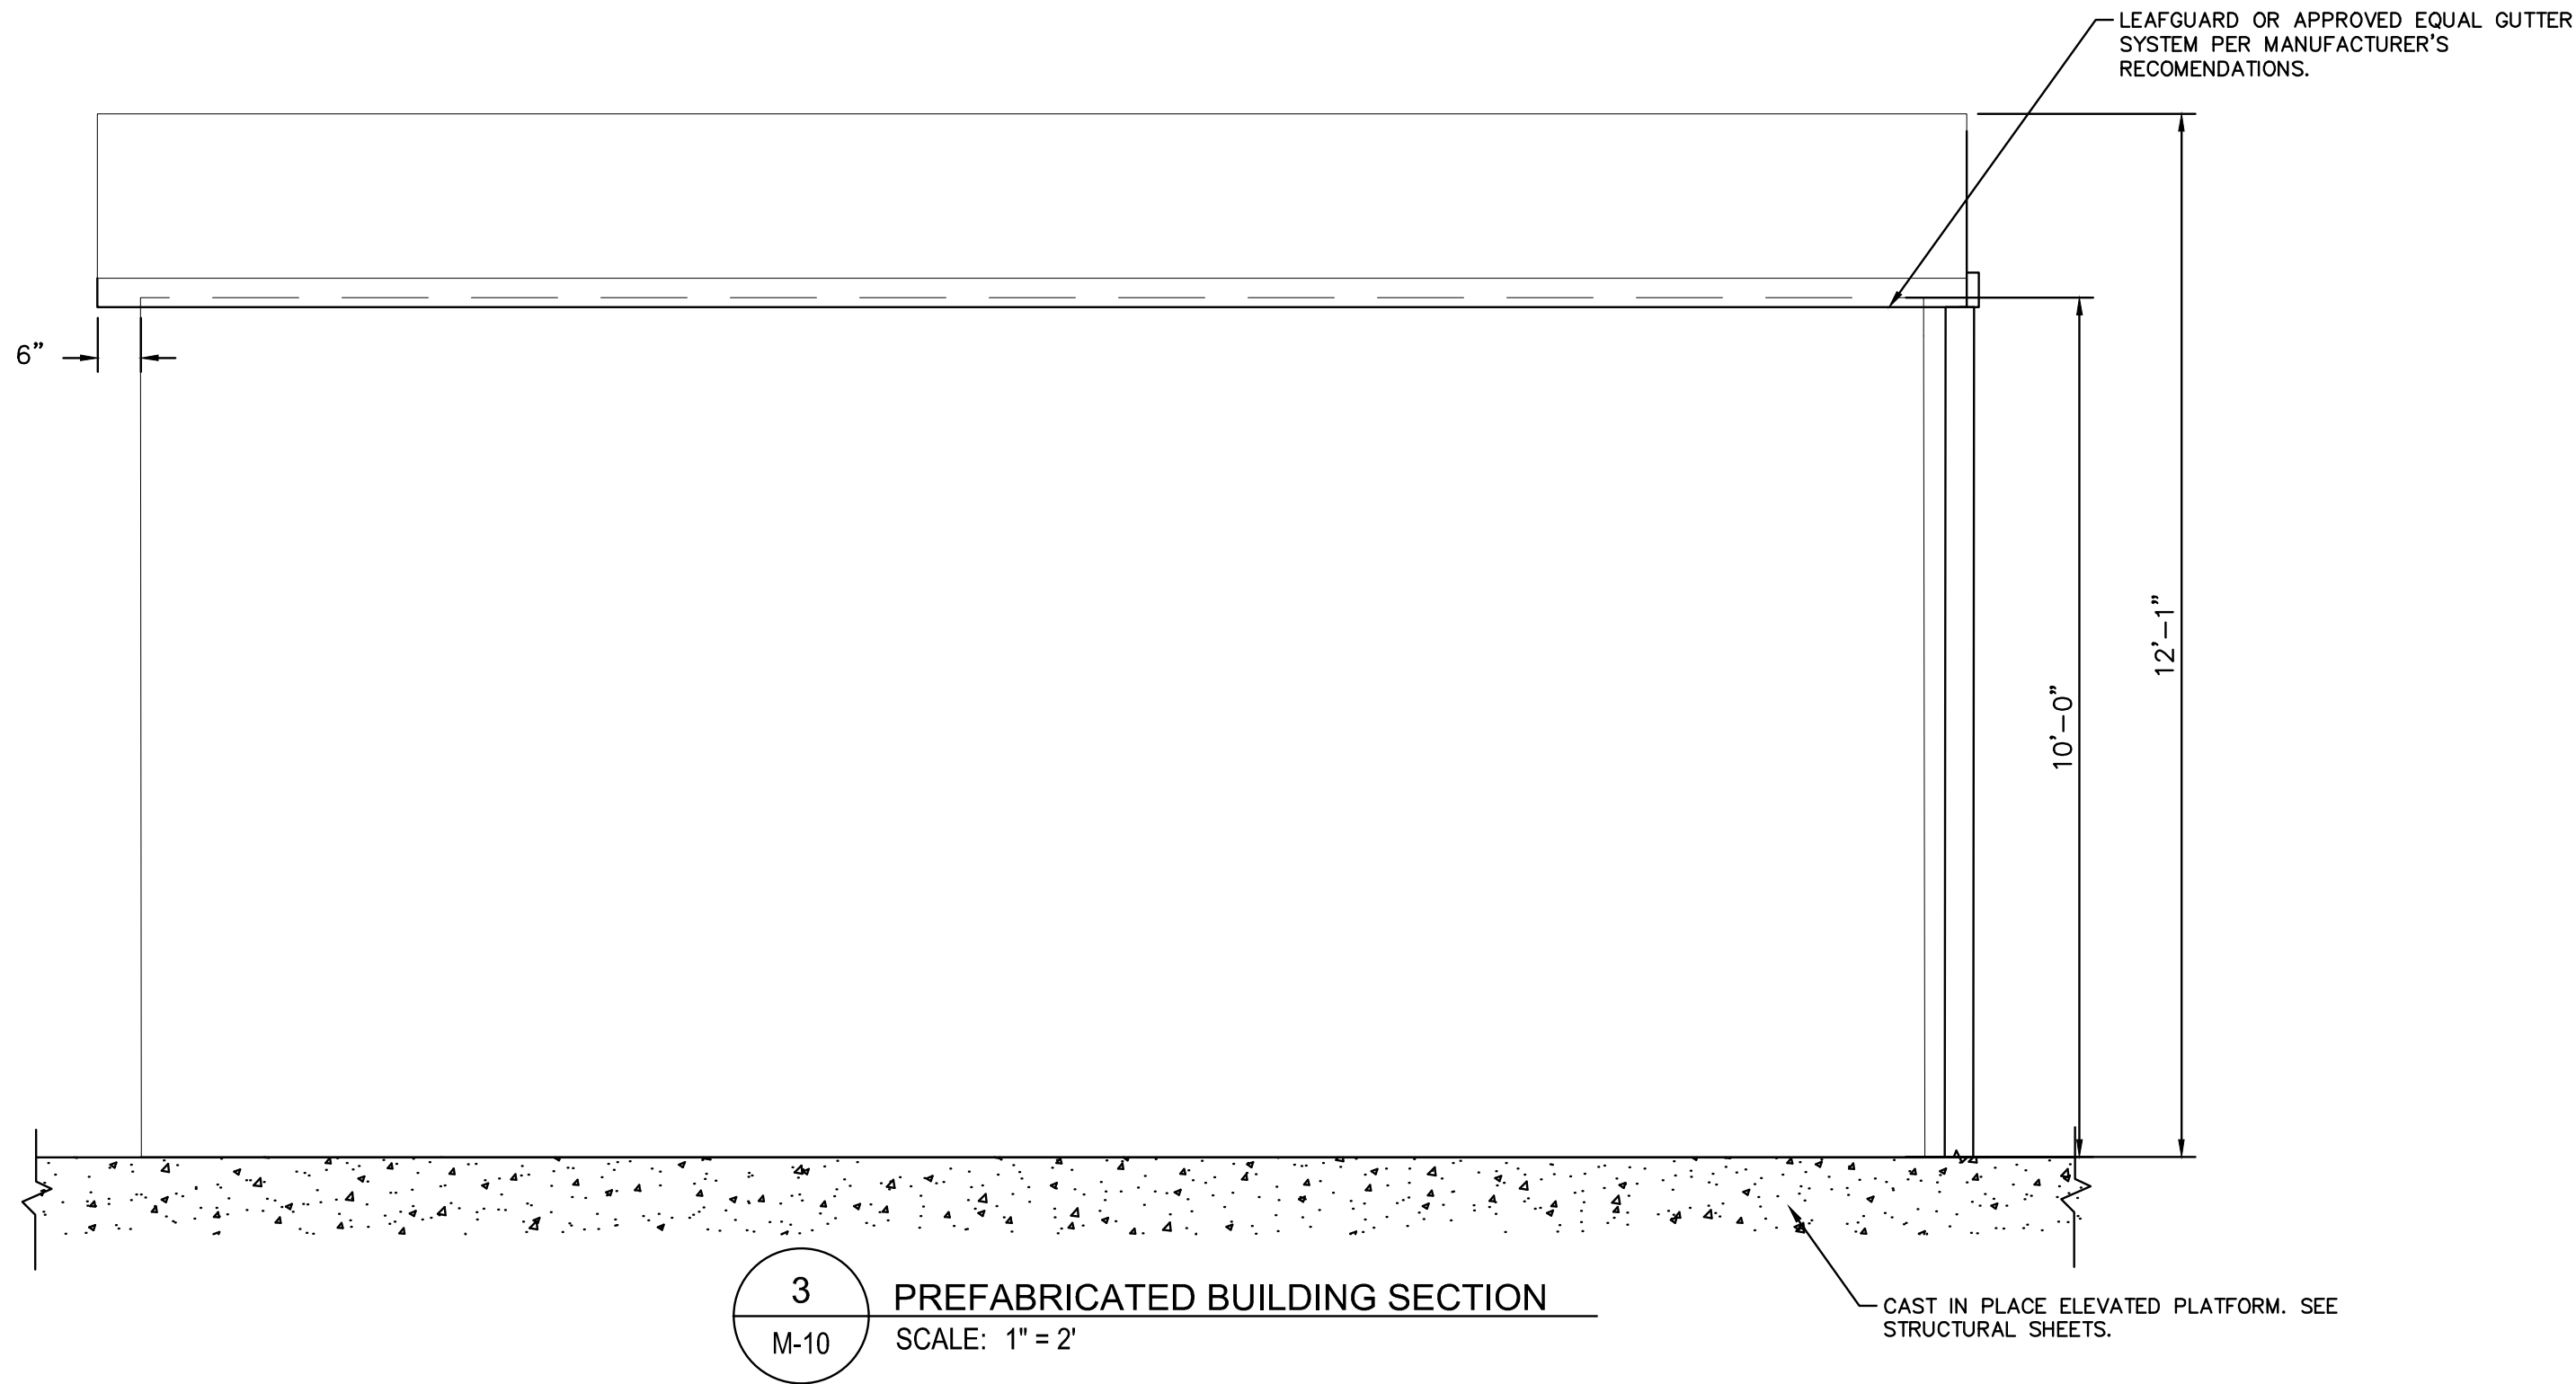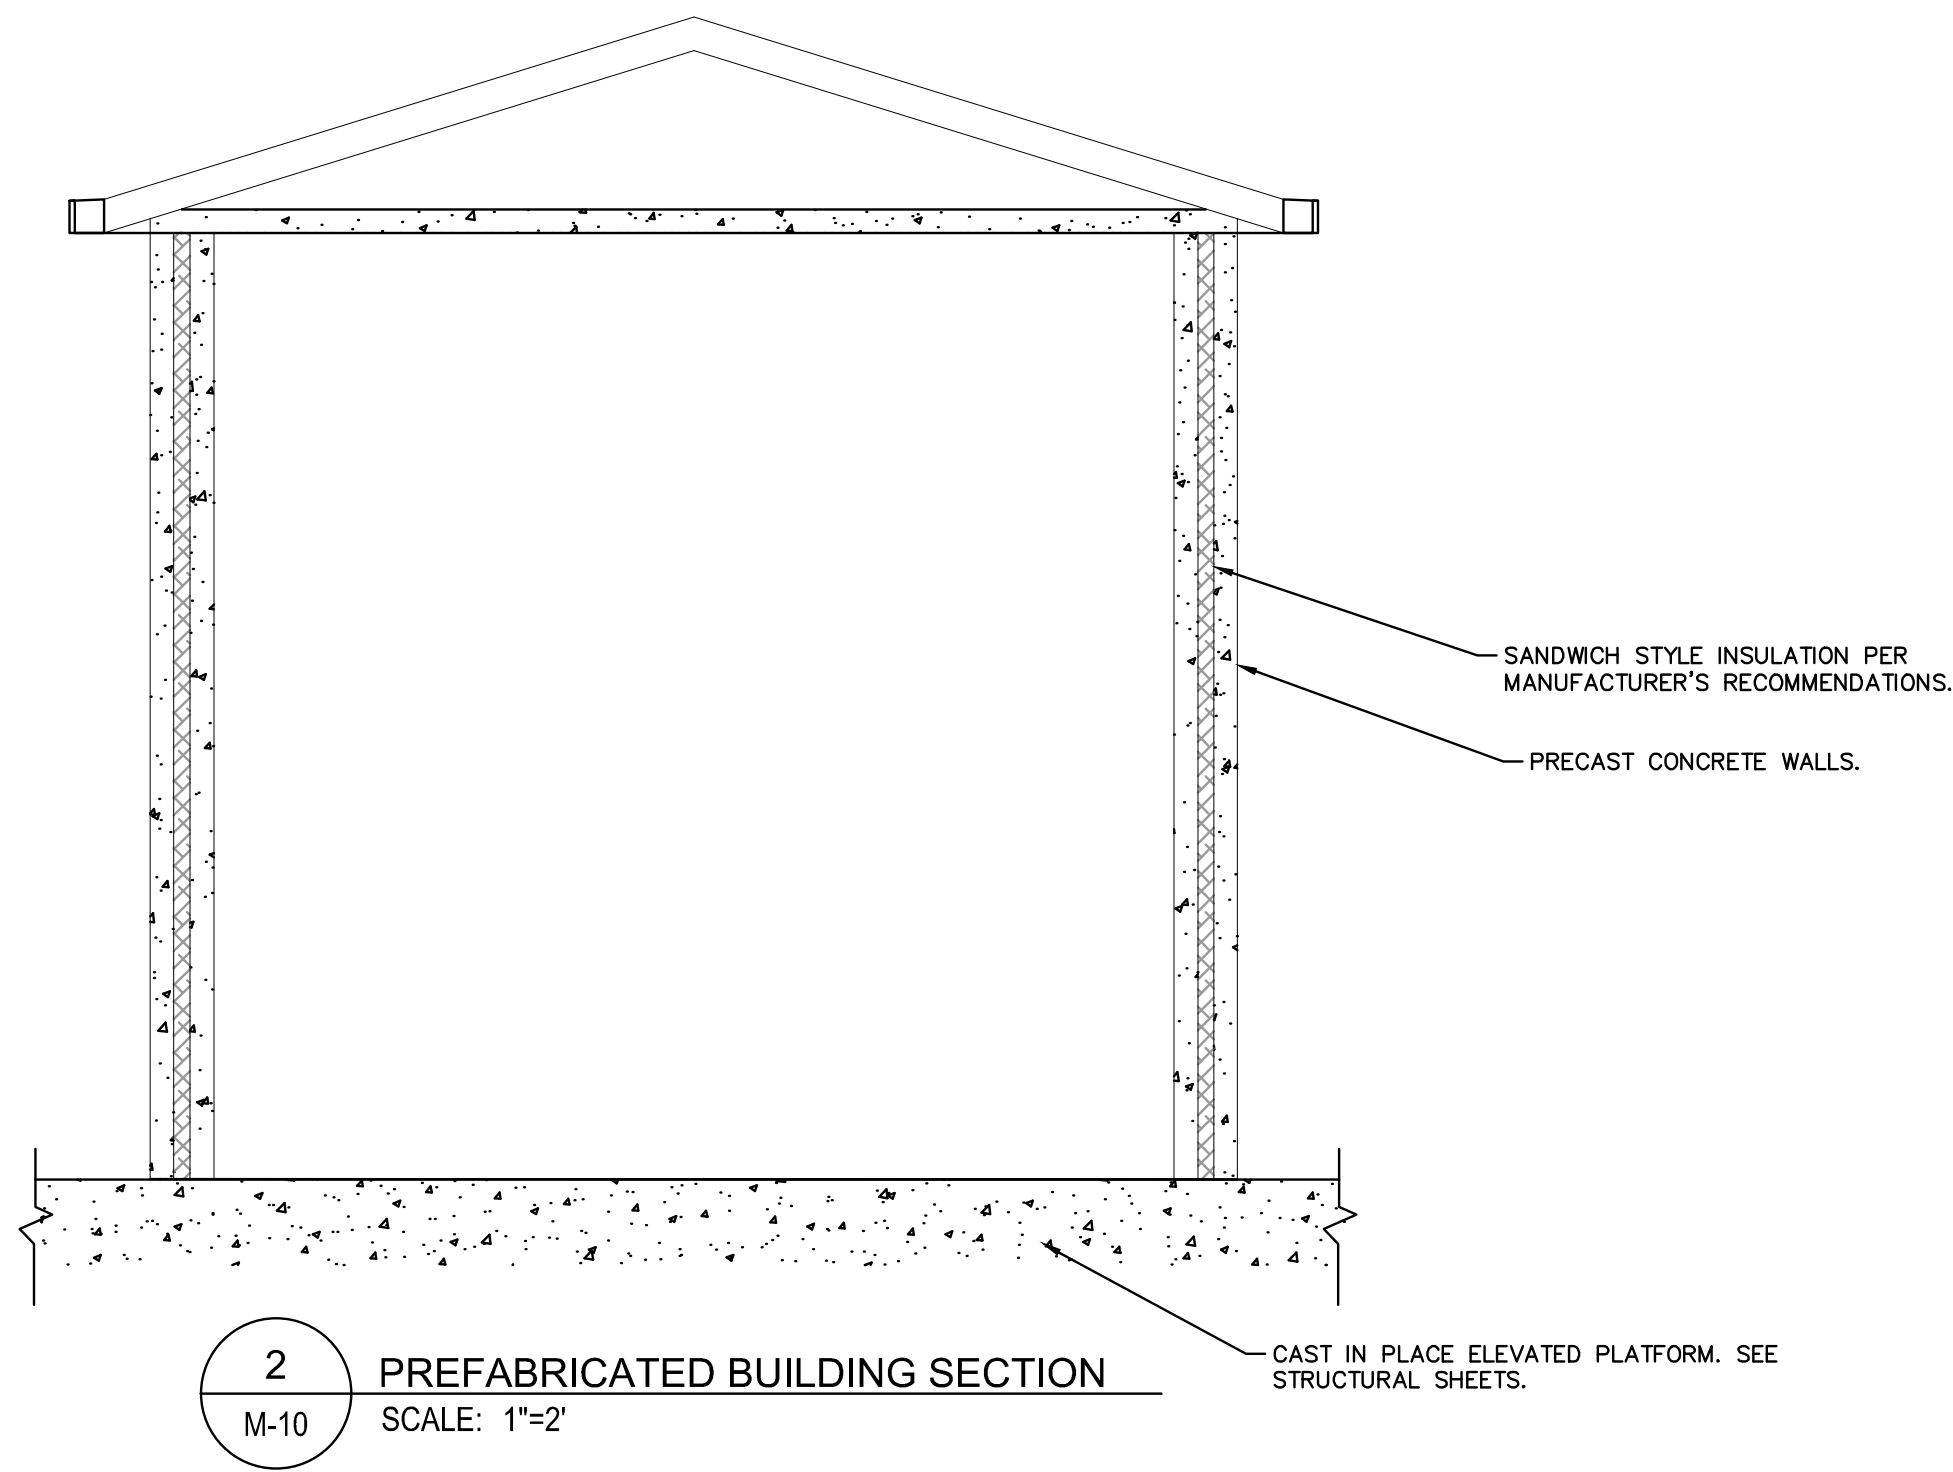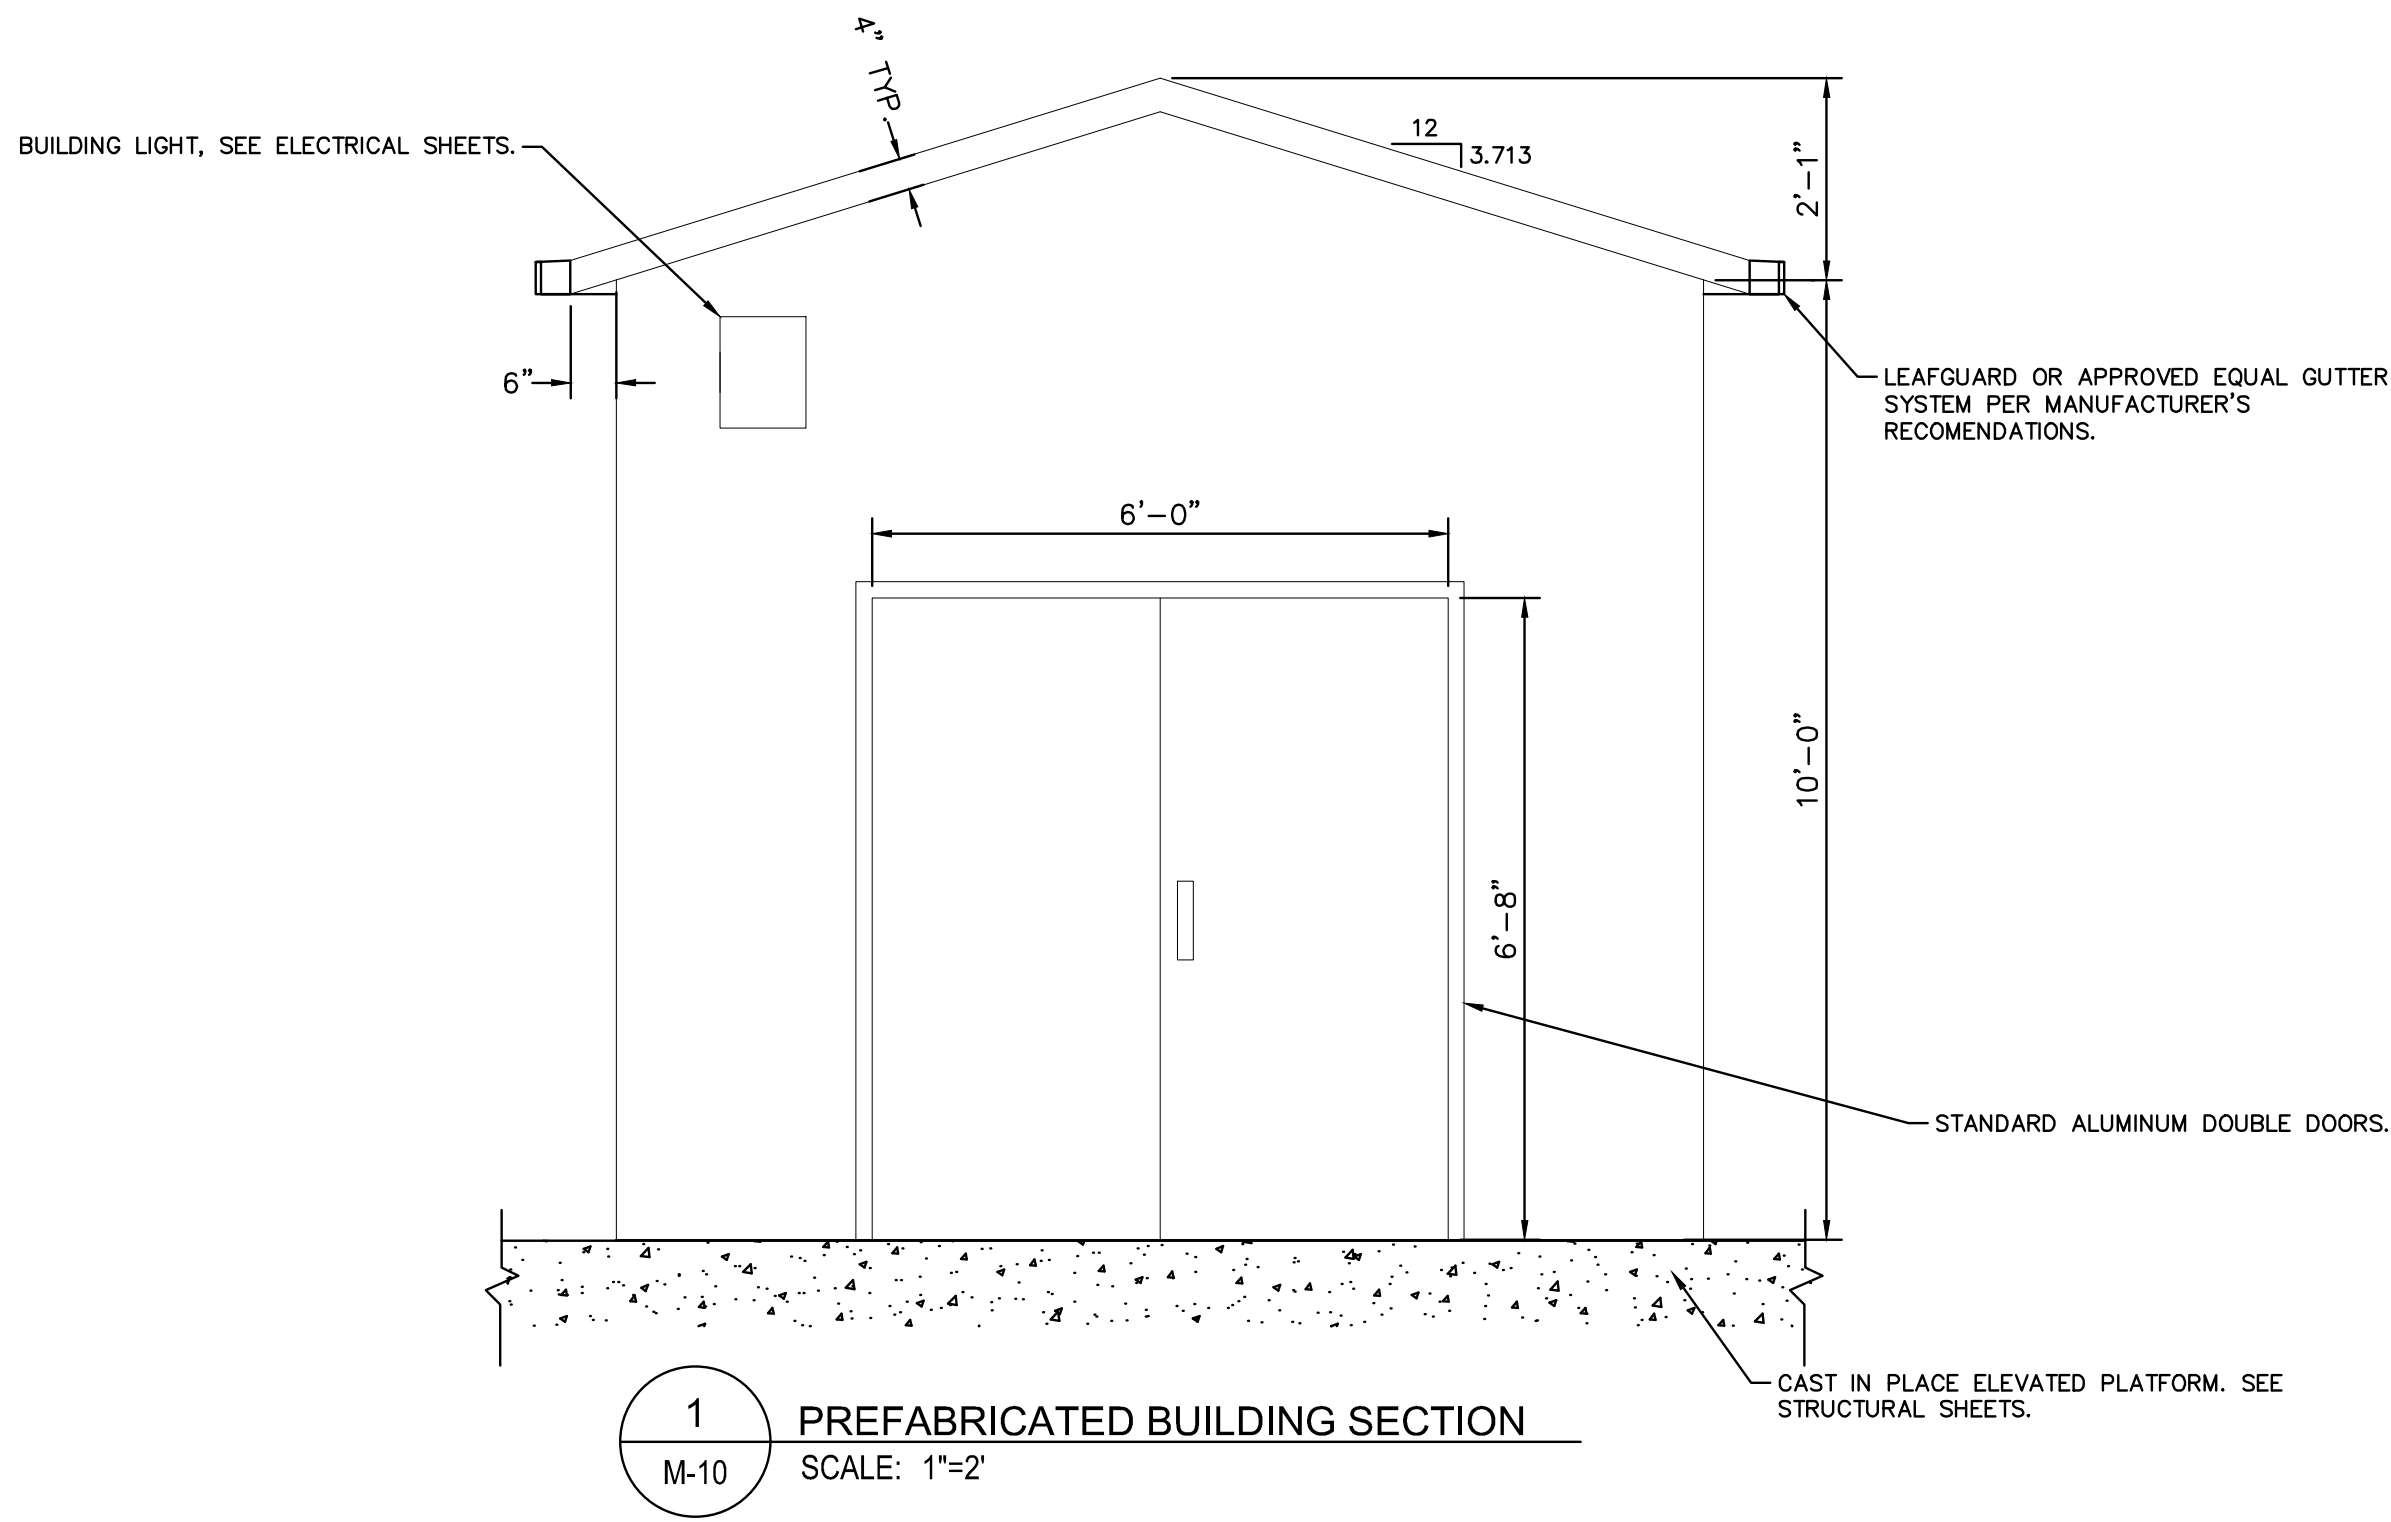
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KHA PROJECT 148400067
DATE FEB 2022
SCALE AS SHOWN
DESIGNED BY MAS
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BAYSHORE YACHT BASIN FORCE MAIN  
AND LIFT STATION REPLACEMENT

MANATEE COUNTY

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FL DATE:

PREFABRICATED BUILDING -  
SECTION

SHEET NUMBER
M-11



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## MECHANICAL SYMBOL LIST

(NOTE: ALL OF THE SYMBOLS INDICATED BELOW MAY NOT APPEAR ON THIS PROJECT)

	RL	REFRIGERANT LIQUID PIPING	DB	DRY BULB TEMPERATURE
	RS	REFRIGERANT SUCTION PIPING	DL	DOOR LOUVER
	U	UNION	DN	DOWN
	P.D.	PIPING TEE DOWN	(E)	EXISTING
	P.U.	PIPING TEE UP	EAT	ENTERING AIR TEMPERATURE
	P.U.	PIPING ELBOW UP	EDB	ENTERING DRY BULB
	P.D.	PIPING ELBOW DOWN	°F	DEGREES FARENHEIT
		BRANCH - TOP CONNECTION	LAT	LEAVING AIR TEMPERATURE
		BRANCH - BOTTOM CONNECTION	MAX	MAXIMUM
	OR	ARROW INDICATES DIRECTION OF FLOW	MBH	BRITISH THERMAL UNITS PER HOUR (THOUSANDS)
	P.O.C.	POINT OF CONNECTION - NEW ITEMS TO EXISTING ITEMS	MIN	MINIMUM
		MECHANICAL EQUIPMENT INDICATED (SEE SCHEDULE)	(N)	NEW
	T.	THERMOSTAT	S.E.E.R.	SEASONAL ENERGY EFFICIENCY RATIO
	AFF	ABOVE FINISHED FLOOR	T	TEMPERATURE
	AFG	ABOVE FINISHED GRADE	TYP	TYPICAL
	BTUH	BRITISH THERMAL UNITS PER HOUR	WB	WET BULB TEMPERATURE
	CFM	CUBIC FEET PER MINUTE		

## SPLIT SYSTEM SCHEDULE

CU - -	OUTDOOR UNIT									FC - -	INDOOR UNIT				COOLING CAPACITY	HEATING CAPACITY	ELECTRICAL
	MANUFACTURER	MODEL	AMBIENT DESIGN (°F DB/WB)	OPERATING WEIGHT (LBS)	SEER	HSPF	ELECTRICAL				MANUFACTURER	MODEL	AIRFLOW (CFM)	OPERATING WEIGHT (LBS)	TOTAL CAPACITY (MIN - MAX MBH)	TOTAL CAPACITY (MIN - MAX MBH)	
							VOLTS/ØHz	MCA	MOCP								
1	mitsubishi	TUMYPO481AK43BA	93/77	271	22.6	12	230/1/60	29	44	1-1, 1-2	mitsubishi	TPKFYP024KM142A	1942	46	24-48	27-54	FED FROM CU-1

### GENERAL NOTES:


- ALL CAPACITIES LISTED ARE AT 0 FEET ELEVATION
- PROVIDE AND INSTALL MANUFACTURER'S REFRIGERANT LINESET
- SET FAN SPEED TO MEDIUM
- MECHANICAL CONTRACTOR TO INSTALL WIRING FROM CUs TO FCs

### STANDARD FEATURES:


- REFRIGERANT SHALL BE R-410A
- INVERTER VARIABLE SPEED COMPRESSOR
- MINIMUM LINE LENGTH OF 9.8 FEET, MAX LINE LENGTH OF 49.2 FEET WITH NO ADDITIONAL REFRIGERANT REQUIRED, AND MAX ELEVATION OF 23 FEET

### OPTIONS:


- PROVIDE AND INSTALL MANUFACTURER'S PROGRAMMABLE T-STAT
- PROVIDE MANUFACTURER'S SEACOAST COATING

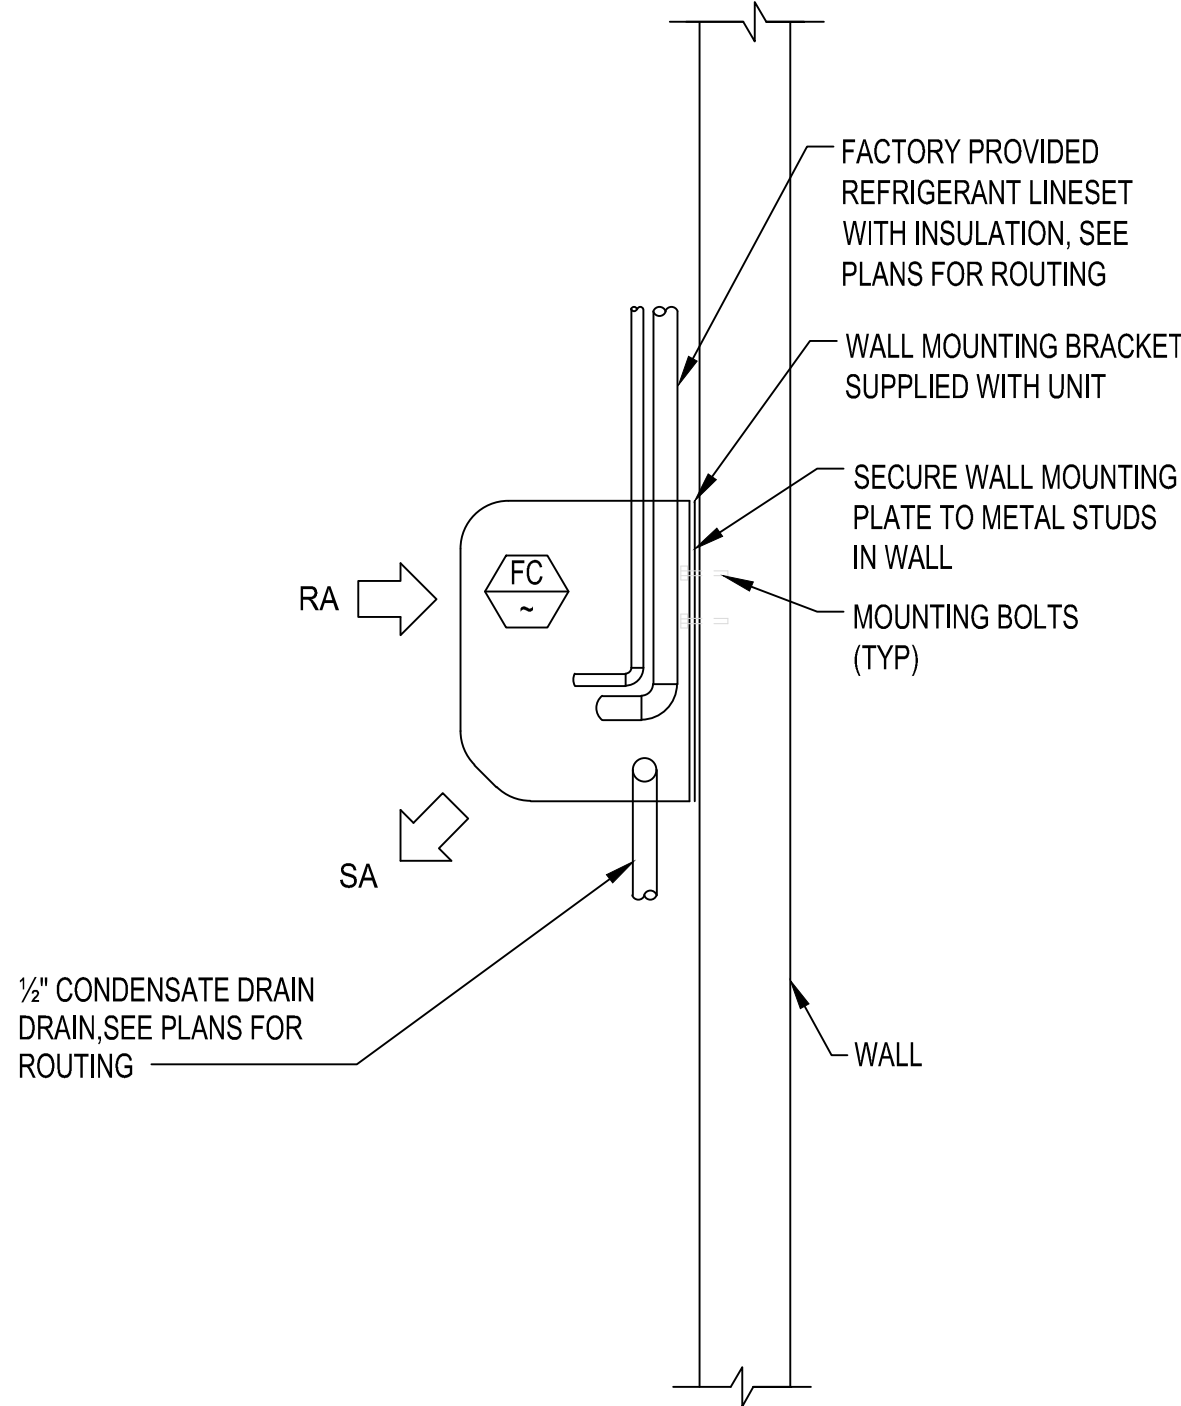


1 INDOOR FAN COIL UNIT MOUNTING DETAIL  
SCALE: NONE

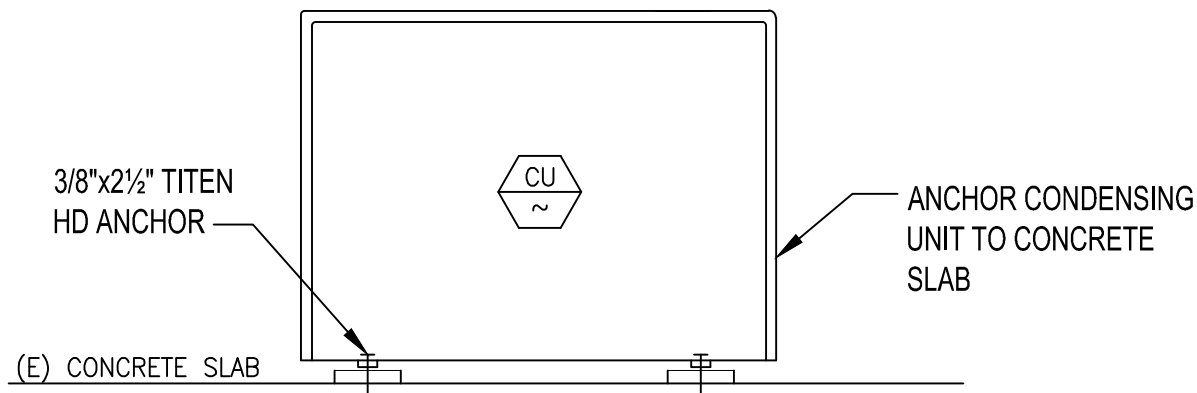

2 CONDENSING UNIT MOUNTING DETAIL  
SCALE: NONE

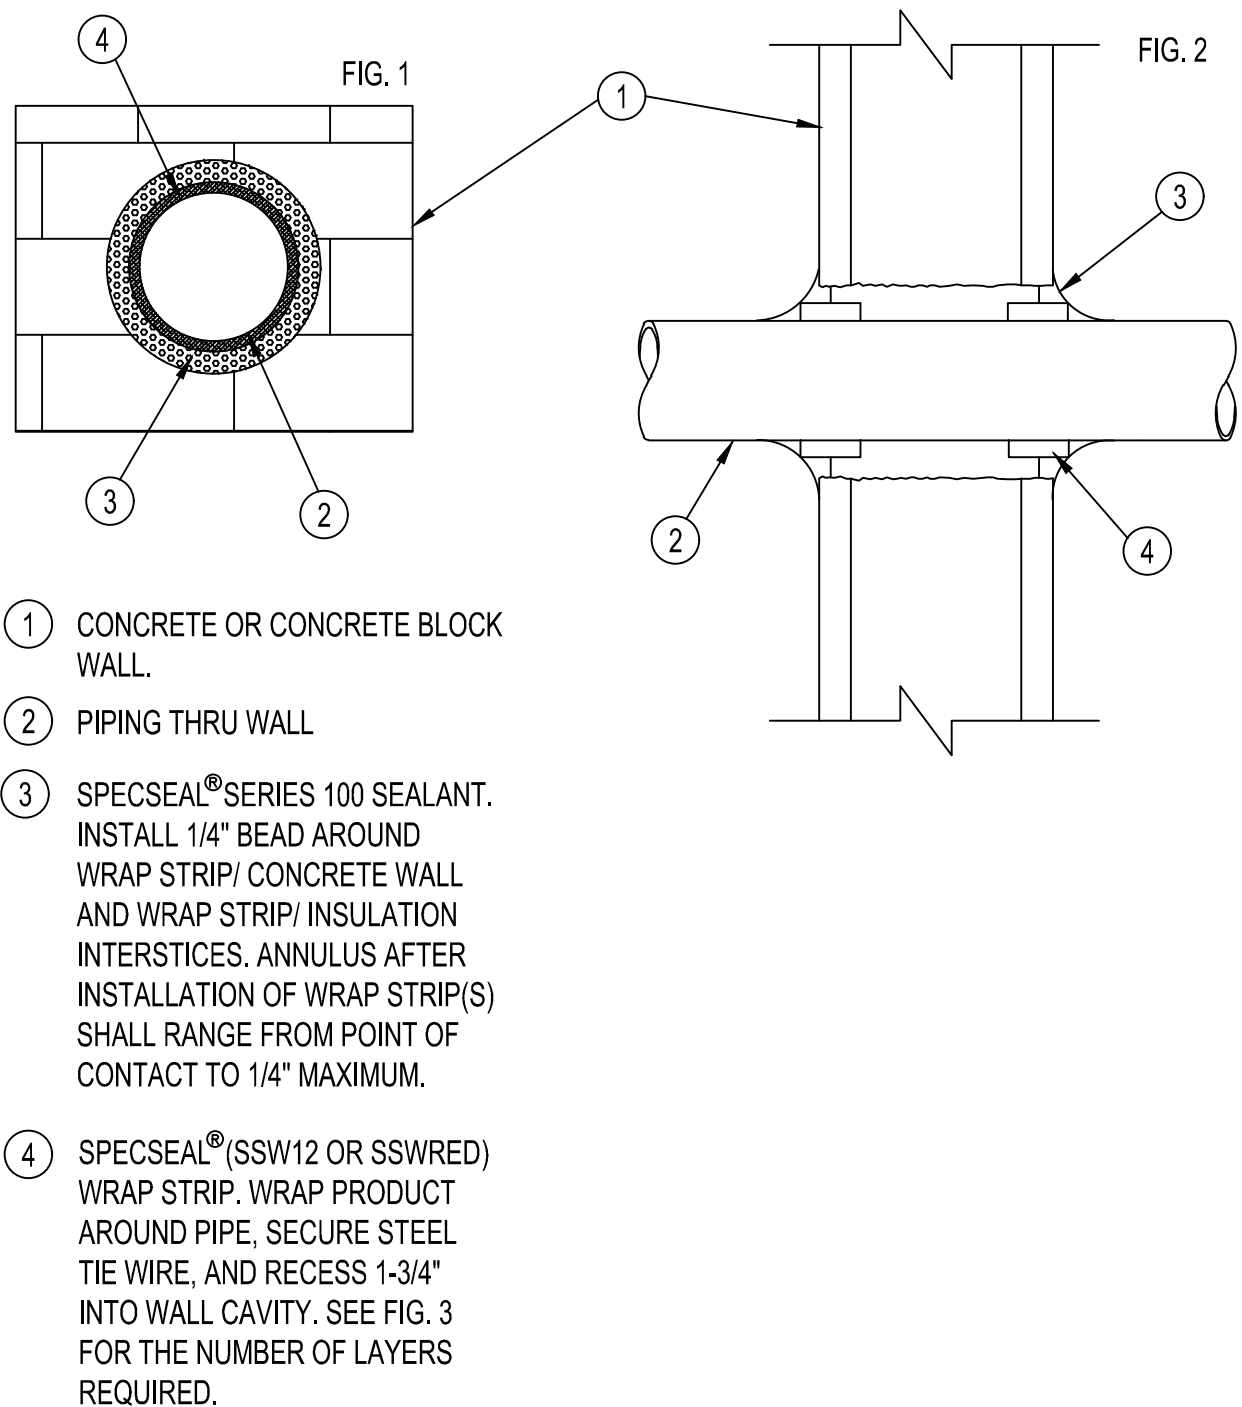

3 PIPING THRU WALL DETAIL  
SCALE: NONE

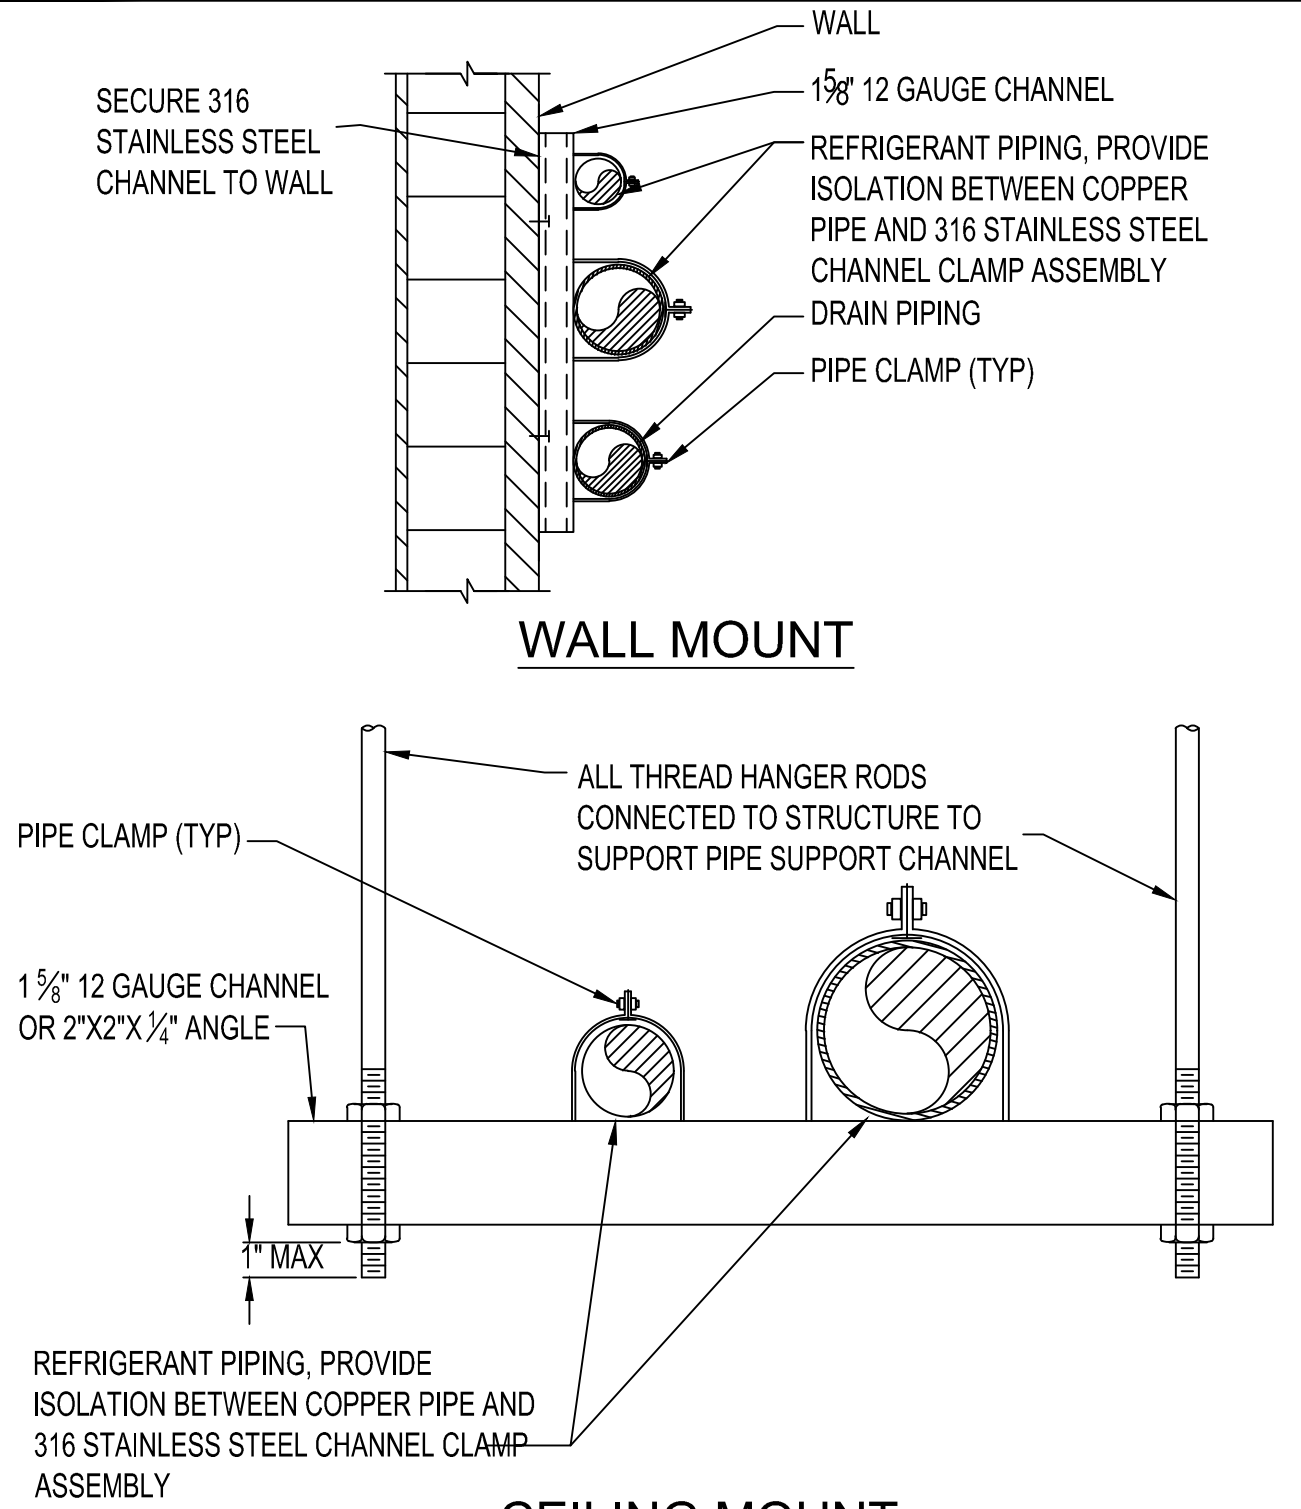


4 LINESET SUPPORT DETAIL  
SCALE: NONE

No.	REVISIONS	DATE	BY



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KHA PROJECT 148400067
DATE FEB 2022
SCALE AS SHOWN
DESIGNED BY PMS
DRAWN BY GMB
CHECKED BY SNR



BAYSHORE YACHT BASIN FORCE MAIN  
AND LIFT STATION REPLACEMENT

MANATEE COUNTY


LICENSED PROFESSIONAL
PETER M. SYNTAX, P.E.
FL LICENSE NUMBER 74259
FL DATE:

## HVAC ABBREVIATIONS AND SCHEDULES

SHEET NUMBER  
M-12



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DESIGNED BY	PMS
DRAWN BY	GMB
CHECKED BY	SNR

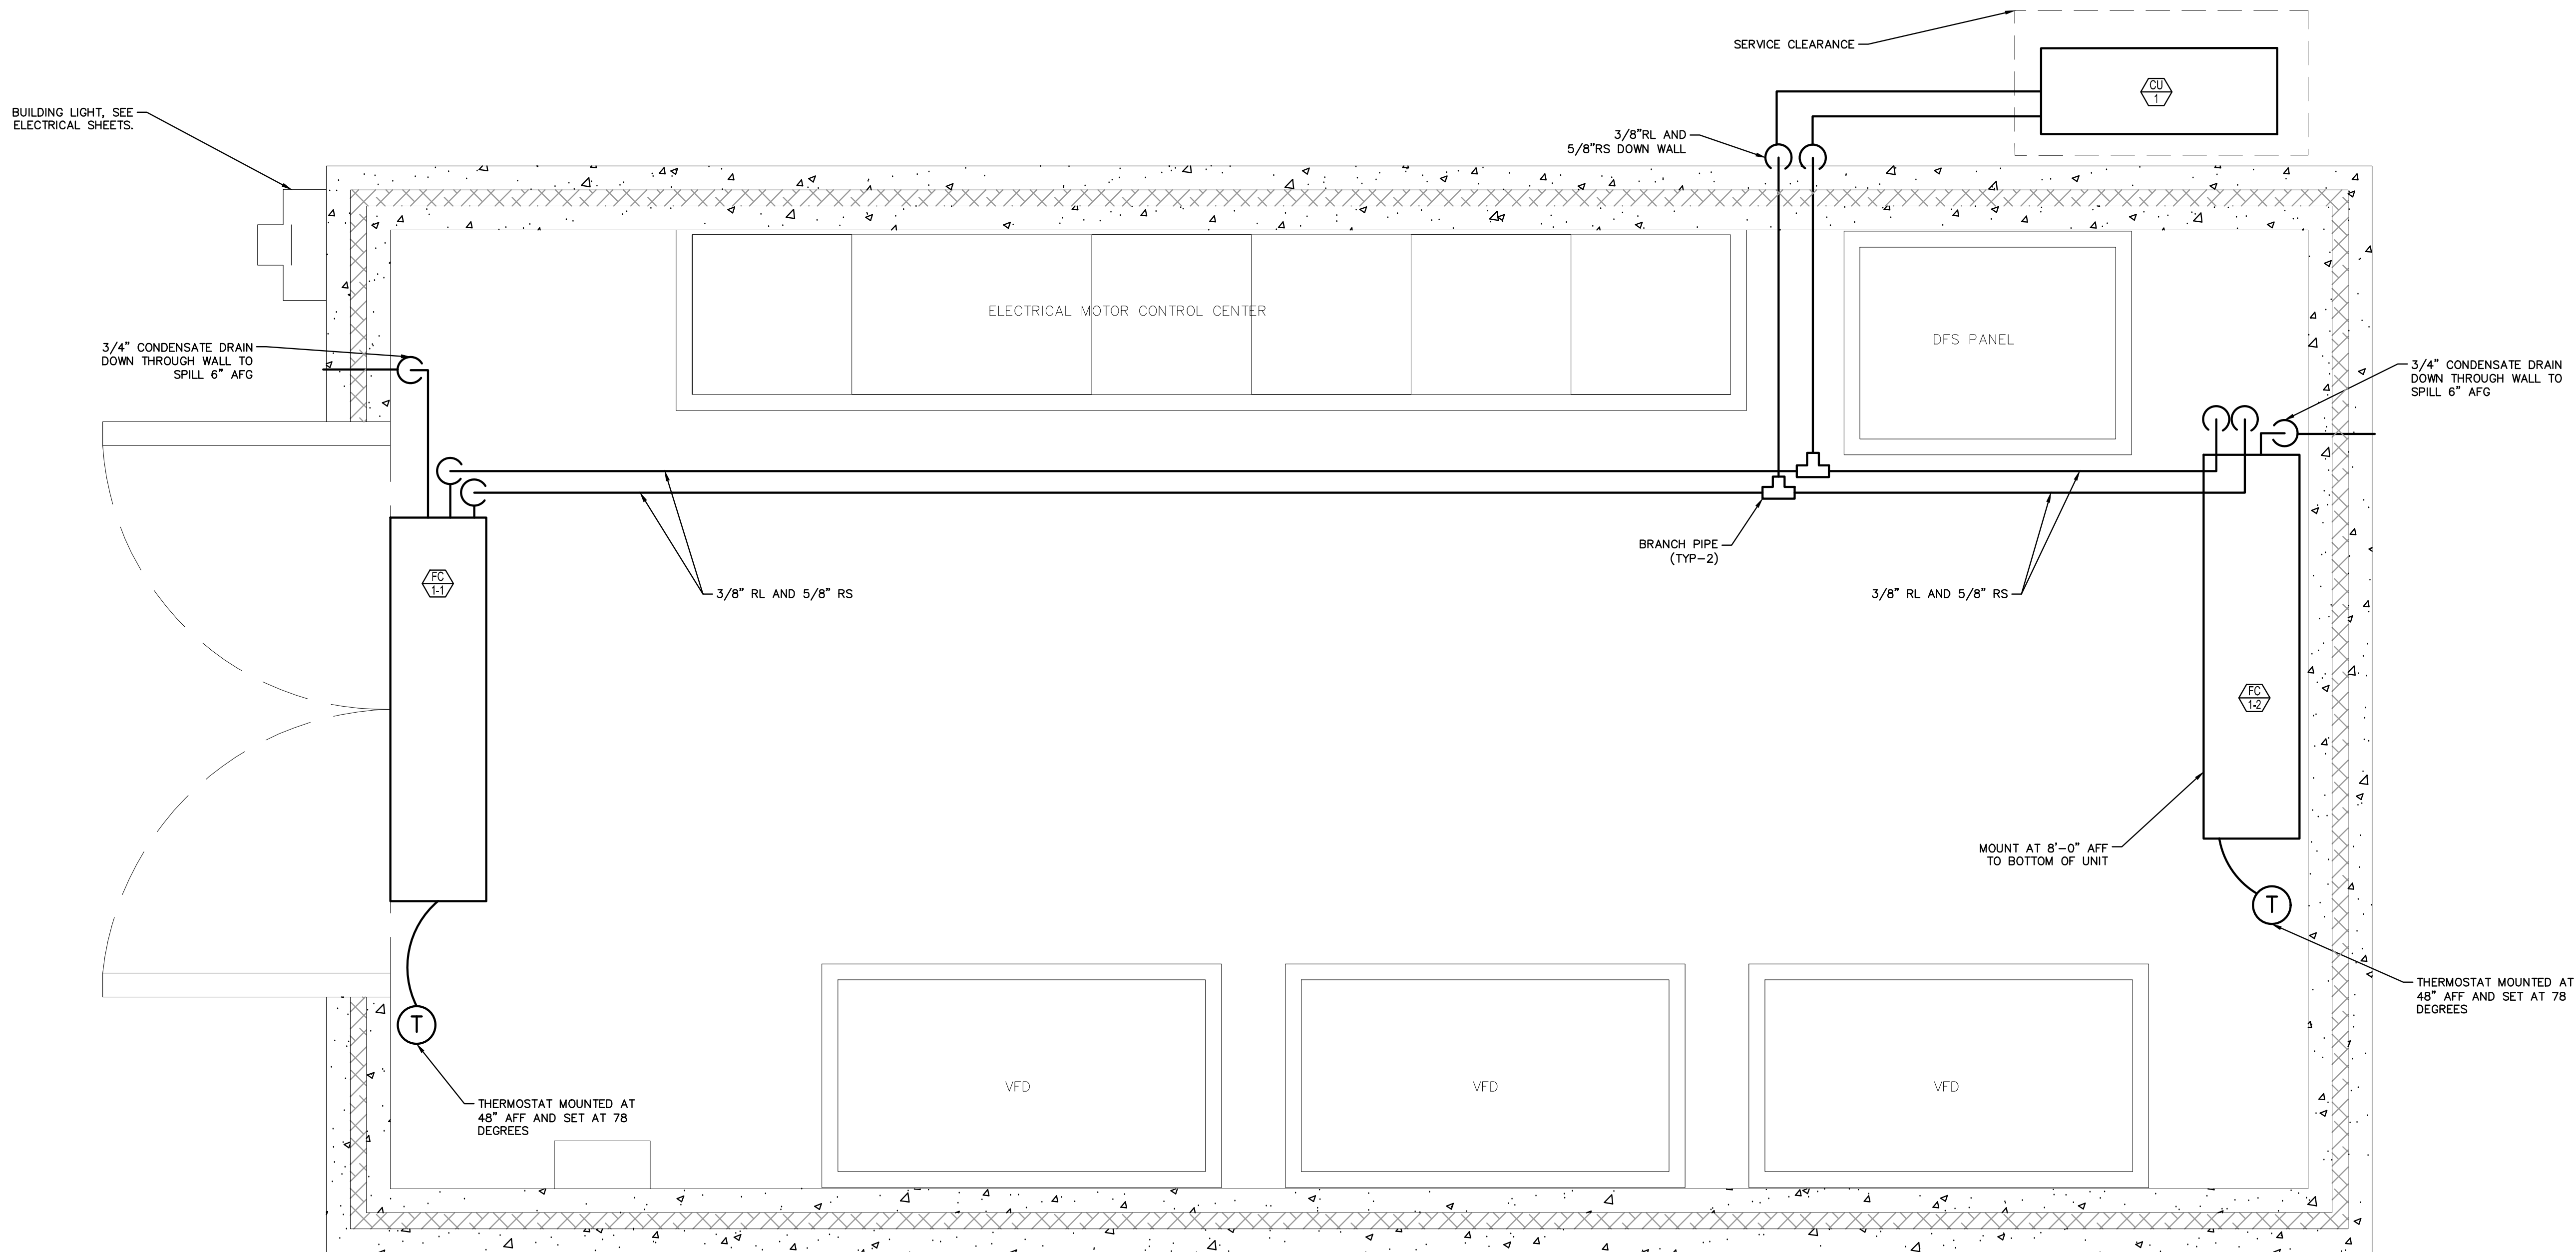**BAYSHORE YACHT BASIN FORCE MAIN  
AND LIFT STATION REPLACEMENT**

MANATEE COUNTY

LICENSED PROFESSIONAL

PETER M. SYNTAX, P.E.

FL LICENSE NUMBER  
74259

FL DATE:

# HVAC FLOOR PLAN

SHEET NUMBER


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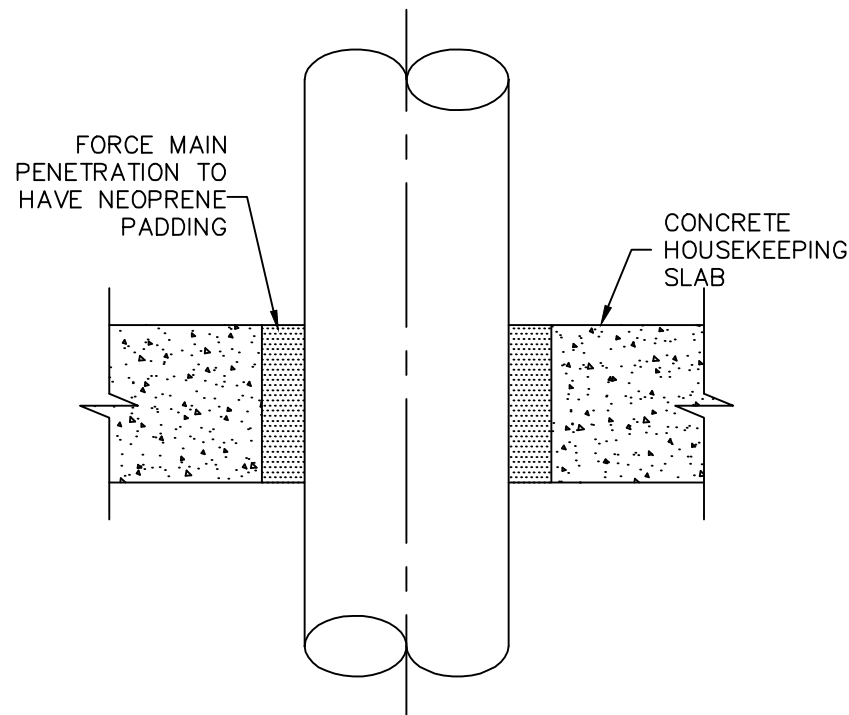





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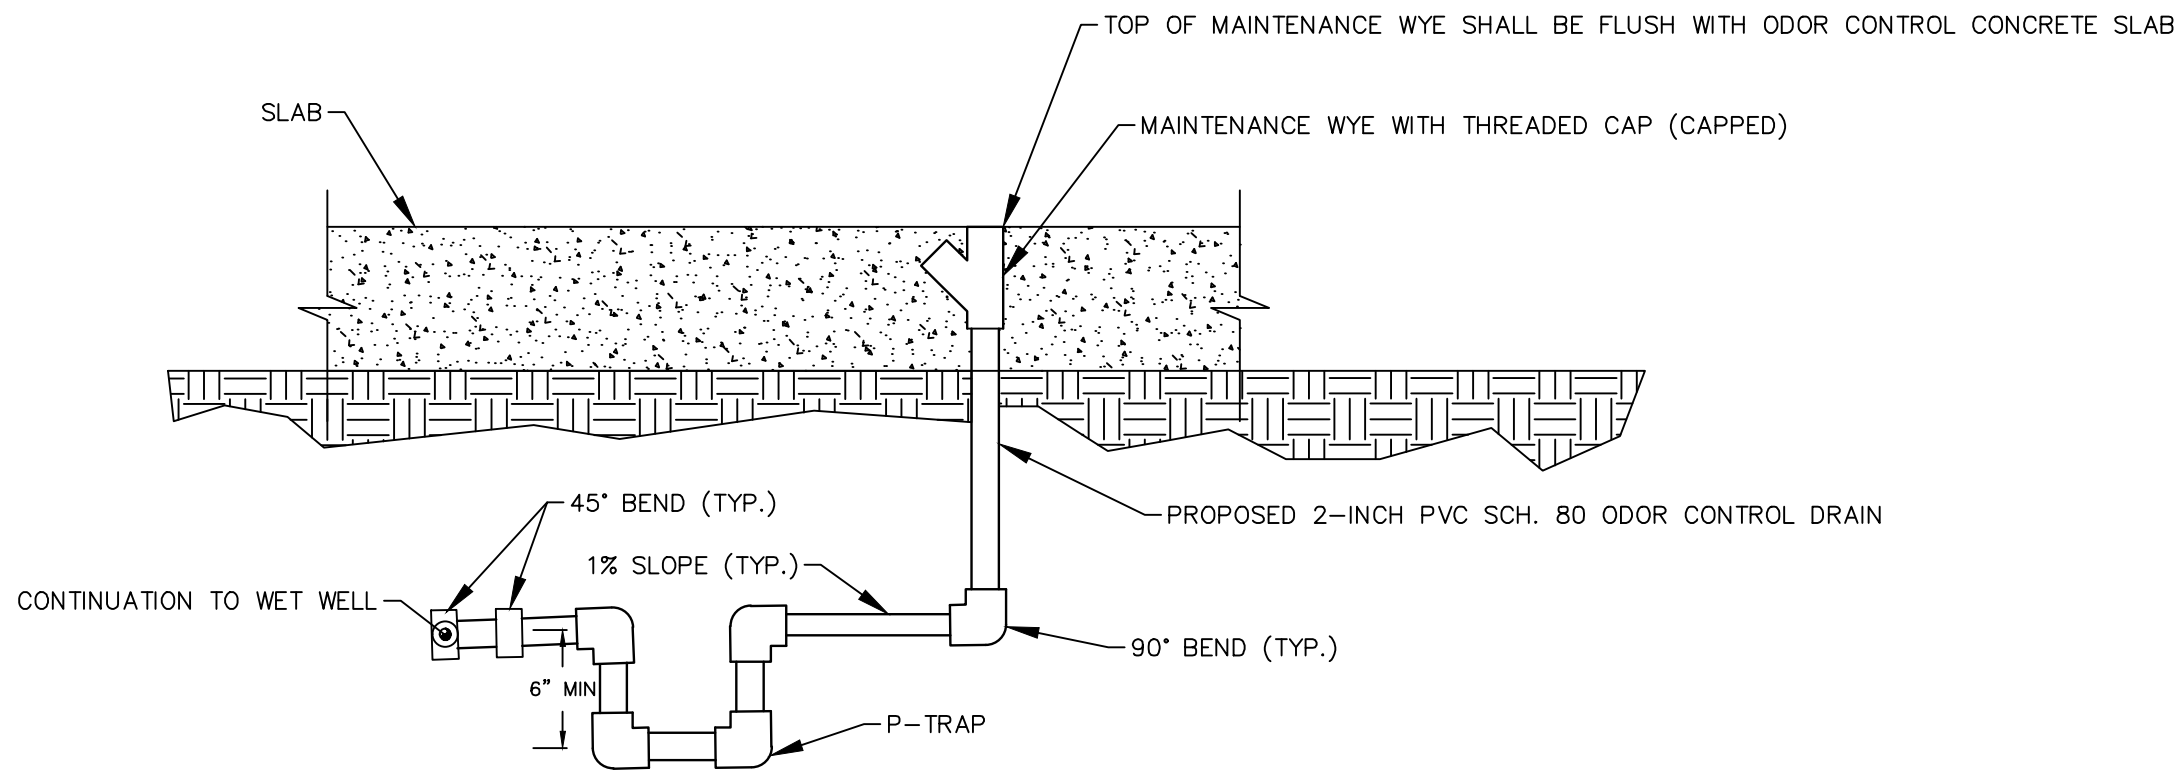
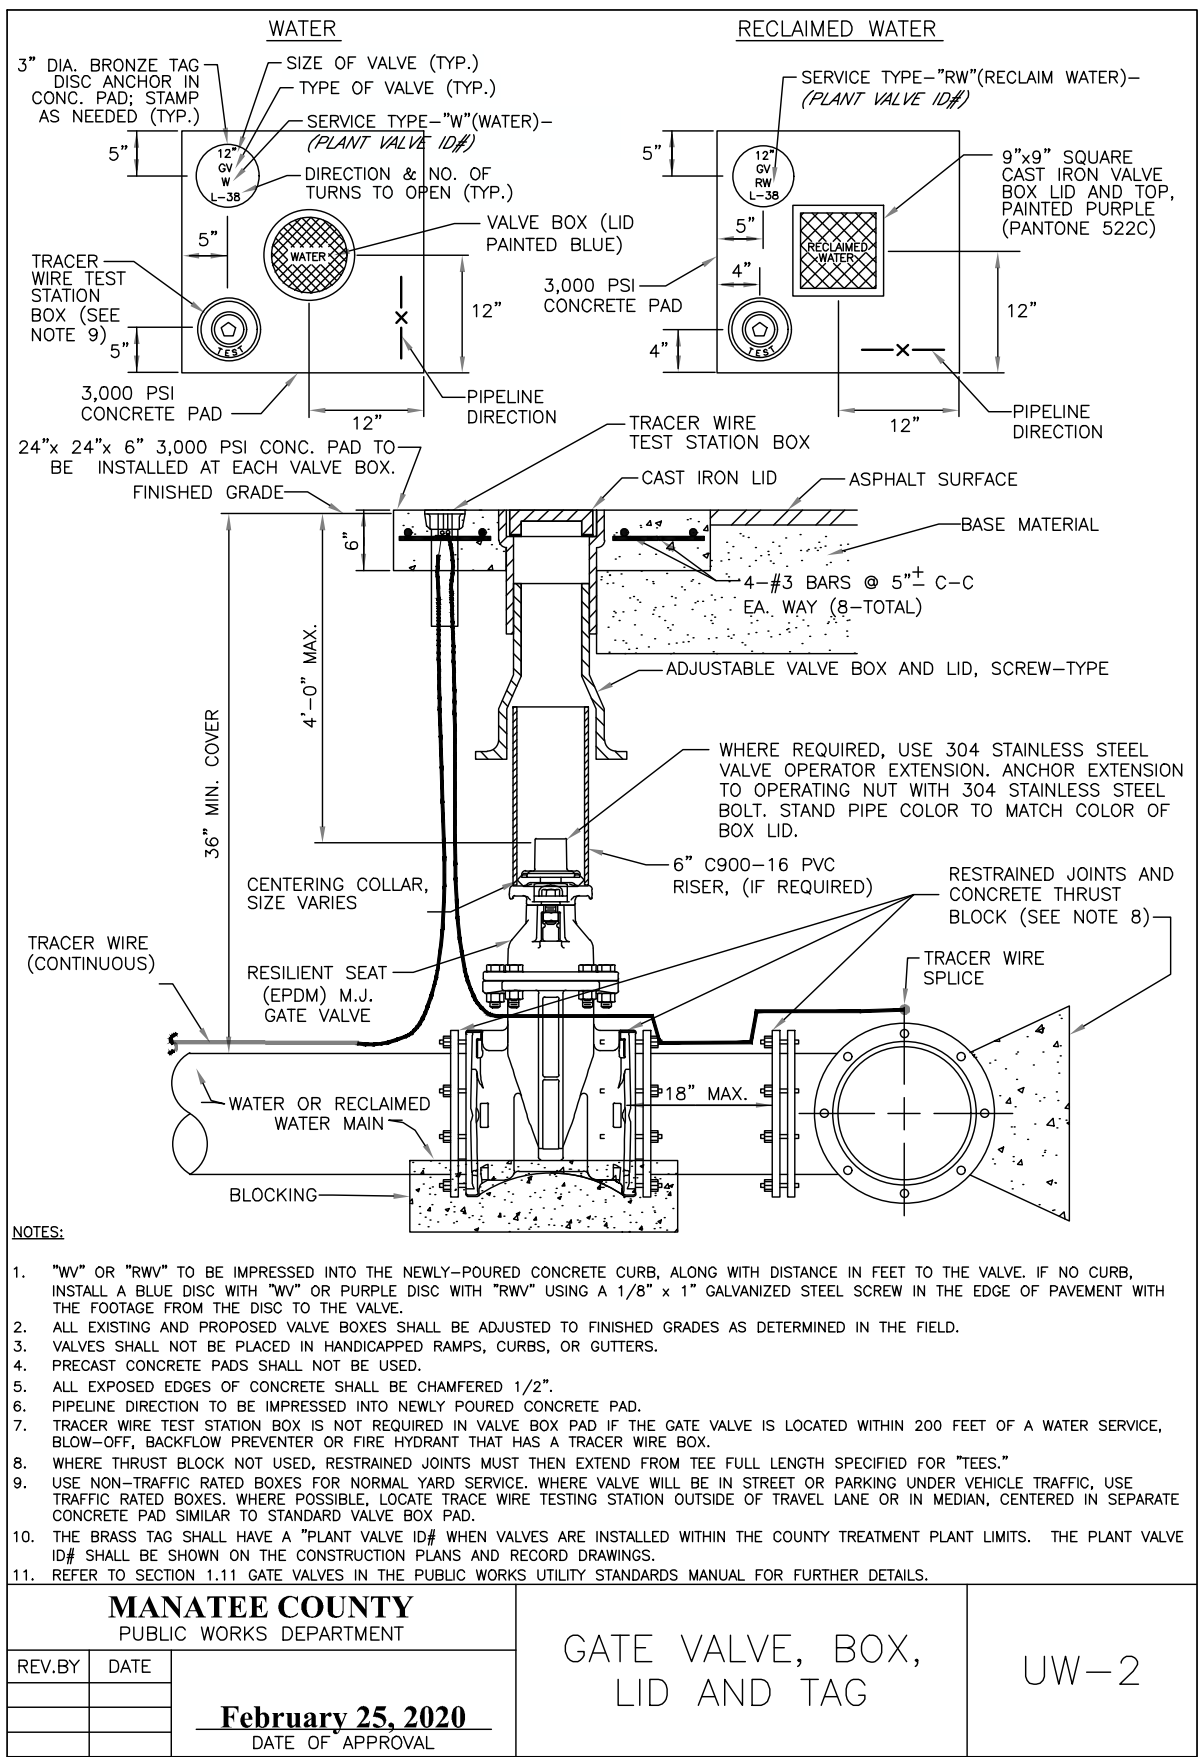
SADDLE PIPE SUPPORT



HOUSEKEEPING PAD PENETRATION DETAIL

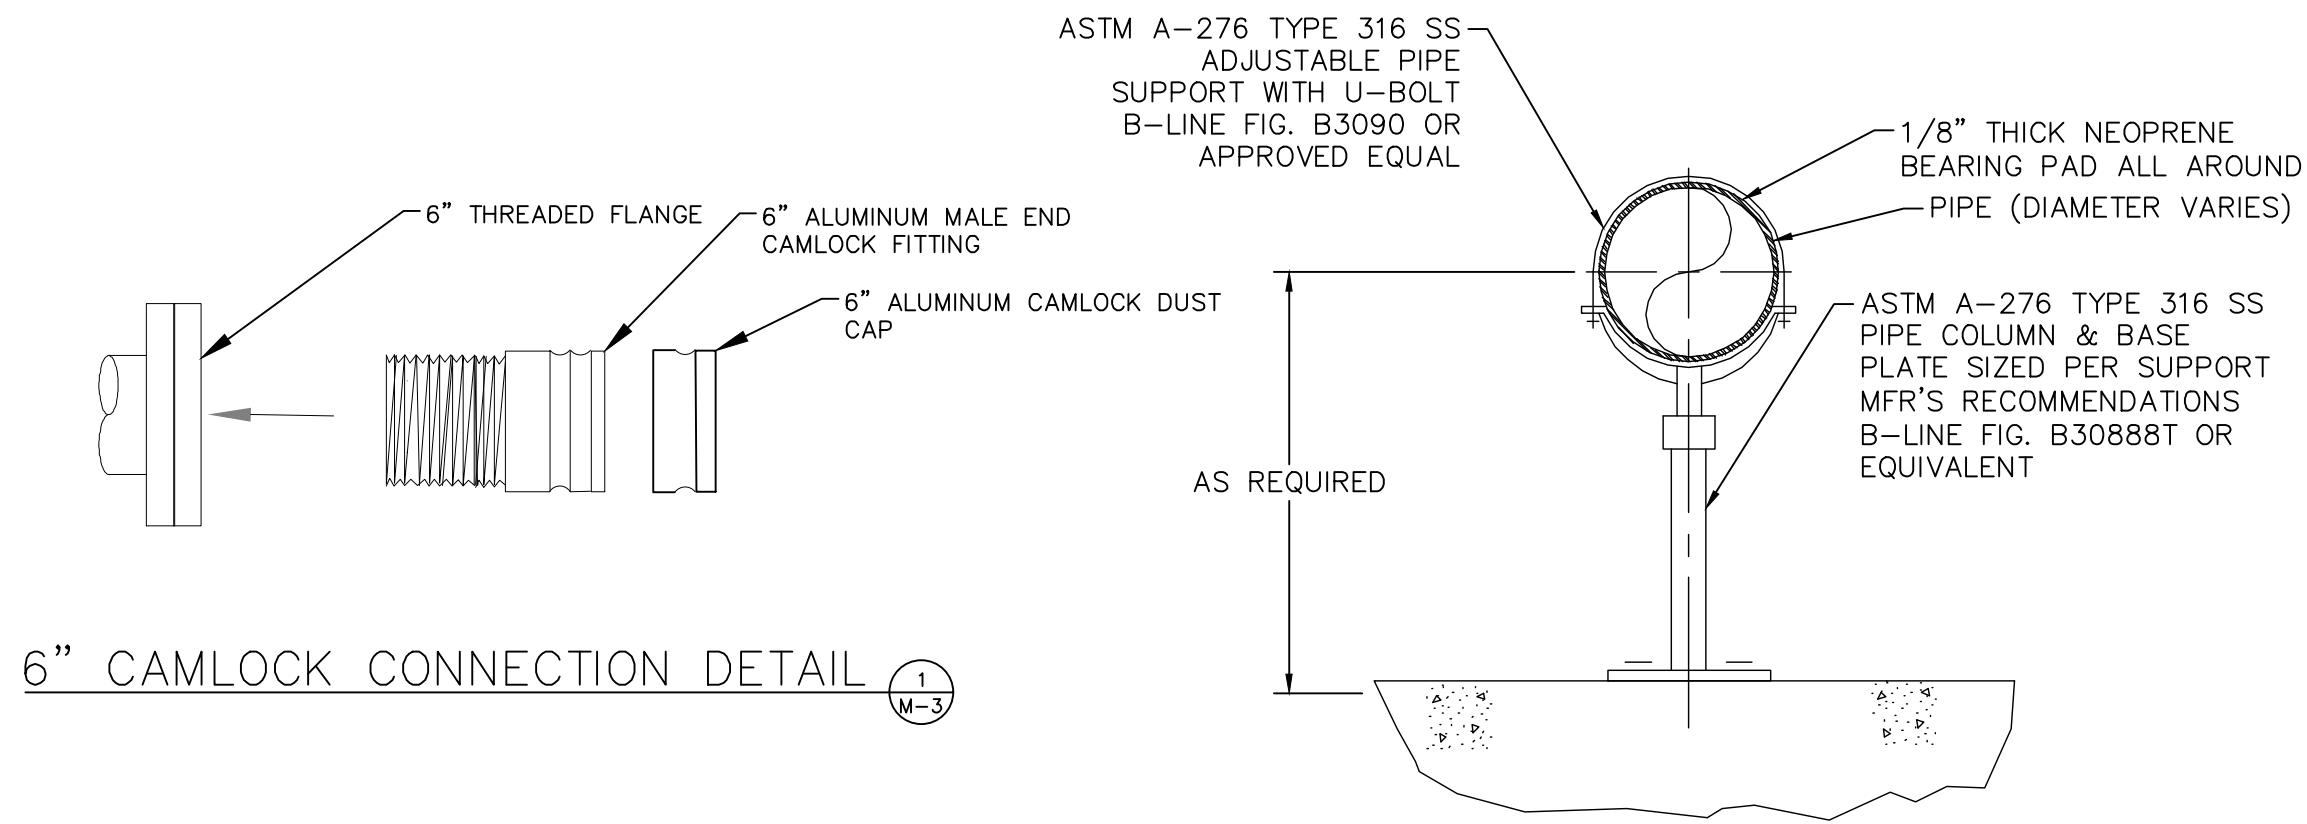

WALL/SLAB PENETRATION DETAIL

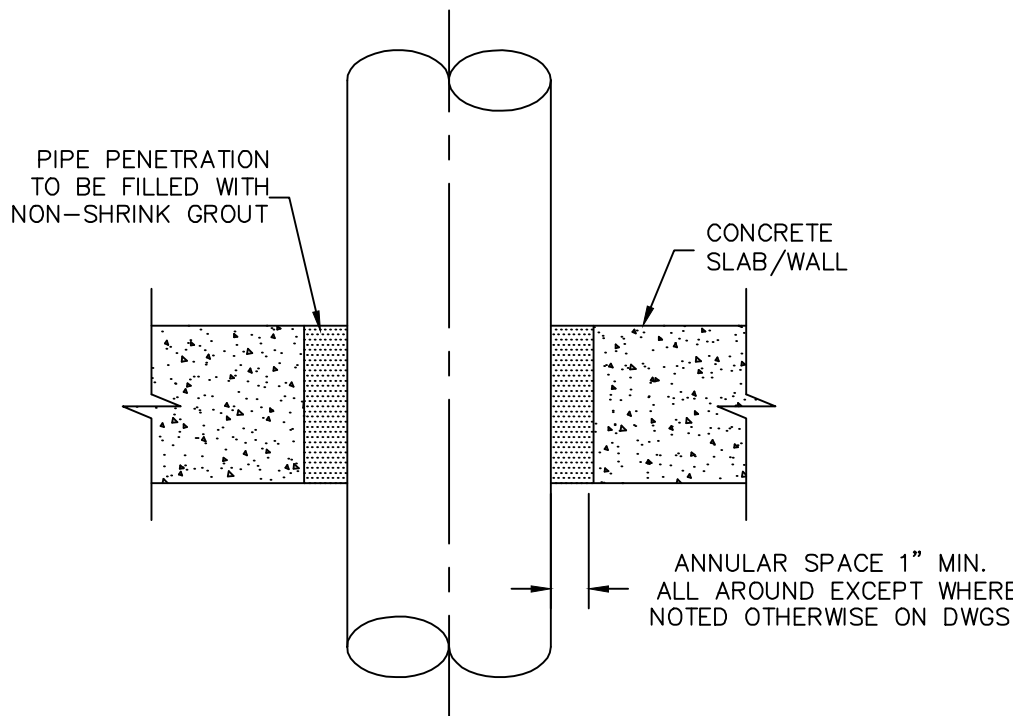

P-TRAP/MAINTENANCE WYE DETAIL

No.	REVISIONS	DATE	BY

<b>Kimley»Horn</b>	KHA PROJECT 148400067
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SCALE AS SHOWN	DESIGNED BY MAS
DRAWN BY GMB	CHECKED BY SNR

	<b>BAYSHORE YACHT BASIN FORCE MAIN AND LIFT STATION REPLACEMENT</b>
MANATEE COUNTY	FL DATE:

LICENSED PROFESSIONAL
MICHAEL A. SEMAGO, P.E.
FL LICENSE NUMBER 87501

<b>MECHANICAL DETAILS</b>
---------------------------

SHEET NUMBER
<b>M-15</b>



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STRUCTURAL NOTES

1. GENERAL:

A) PROTECT EXISTING FACILITIES, STRUCTURES AND UTILITY LINES FROM ALL DAMAGE. PROTECT THE WORK, ADJACENT PROPERTY, AND THE PUBLIC. CONTRACTOR IS SOLELY RESPONSIBLE FOR DAMAGE OR INJURY DUE TO HIS ACT OR NEGLIGENCE.

B) THE CONTRACTOR IS SOLELY RESPONSIBLE FOR JOB SAFETY AND CONSTRUCTION PROCEDURES.

C) PRIOR TO CONSTRUCTION, FIELD VERIFY ALL DIMENSIONS IN THE DRAWINGS AND DETAILS AND REPORT ANY DISCREPANCIES IMMEDIATELY TO THE ENGINEER.

D) REFER TO THE ENGINEER FOR INSTRUCTION FOR ANY DIMENSION NOT GIVEN ON DRAWINGS. SCALING OF DRAWINGS SHALL NOT BE USED TO OBTAIN OR VERIFY ANY DIMENSION SHOWN ON THE DRAWINGS.

E) CONTRACTOR IS RESPONSIBLE FOR HIRING GEOTECHNICAL CONSULTANT FOR CONSTRUCTION TESTING AND APPROVAL OF FILL AND COMPACTION.

F) CONTRACTOR SHALL BE RESPONSIBLE FOR DEWATERING FOR FOUNDATION CONSTRUCTION, IF REQUIRED.
2. CONCRETE:

A) ALL CONCRETE MATERIALS, PLACING AND HANDLING SHALL BE IN ACCORDANCE WITH THE LATEST EDITION OF ACI 318 AND ACI 301.

B) STRUCTURAL CONCRETE SHALL HAVE THE FOLLOWING MINIMUM 28-DAY COMPRESSIVE STRENGTHS:

1. ELEVATED PLATFORM, INCLUDING MAT FOUNDATION AND COLUMNS4000 PSI

2. WET WELL, INCLUDING TOP SLAB5000 PSI

3. SLAB-ON-GRADE4000 PSI

C) PROVIDE 2" CONCRETE COVER OVER REINFORCING BARS ADJACENT TO FORMS AND 3" CONCRETE COVER ADJACENT TO EARTH EXCEPT AS OTHERWISE NOTED.

D) FORM TIES AND REINFORCING BAR SUPPORTS SHALL BE OF NON-CORROSIVE MATERIAL INCLUDING, BUT NOT LIMITED TO, FIBERGLASS, PLASTIC, AND/OR CONCRETE BLOCK.

E) CONCRETE FINISHES: FORMED SURFACE-SMOOTH FORM FINISH PER ACI 301 AND BROOM FINISH: HORIZONTAL SLAB SURFACES

F) ALL GROUT SHALL BE NON-SHRINK, NON-METALLIC.

G) CONCRETE SHALL BE CURED IMMEDIATELY AFTER FINISHING OPERATIONS IN ACCORDANCE WITH ONE OF THE FOLLOWING METHODS:

1. APPLY A LIQUID MEMBRANE CHEMICAL CURING COMPOUND IN ACCORDANCE WITH ASTM C-309.

2. WET CURE IN ACCORDANCE WITH ACI 301.

H) ALL CONCRETE CONSTRUCTION SHALL BE DONE IN THE DRY.

I) BEAMS AND SLABS SHALL BE POURED MONOLITHICALLY.

J) CONCRETE SHALL BE IN ACCORDANCE WITH ASTM C94:

1. TYPE II PORTLAND CEMENT - ASTM C150

2. AGGREGATES (3/4" MAX.) - ASTM C39

3. USE OF CALCIUM CHLORIDE IS NOT PERMITTED

4. AIR ENTRAINING (4% MAX.) - ASTM C260

5. WATER REDUCING - ASTM C494

6. FLY ASH (MAX 20% BY WEIGHT), TYPE F - ASTM C618

7. WATER - CLEAN AND POTABLE

8. MAXIMUM WATER CEMENT RATIO FOR 4,000 PSI, 28-DAY COMPRESSIVE STRENGTH = 0.45

K) REQUIRED SLUMP: 2" TO 4"

L) CONTRACTOR IS RESPONSIBLE FOR THE PROPER DESIGN AND CONSTRUCTION OF ALL FORMWORK AND SHORING. DESIGN SHALL BE PERFORMED BY A LICENSED FLORIDA PROFESSIONAL ENGINEER.

M) A QUALIFIED TESTING LABORATORY SHALL BE RETAINED TO PERFORM THE FOLLOWING CONCRETE TESTS:

1. CYLINDER STRENGTH TESTS - ASTM C39. ONE SET OF FIVE CYLINDERS FOR EACH 50 CUBIC YARDS OR FRACTION THEREOF PLACED. TEST ONE AT 3 DAYS, ONE AT 7 DAYS, TWO AT 28 DAYS, AND HOLD ONE.

2. SLUMP TESTS - ASTM C143

N) ONE COPY OF ALL TEST REPORTS SHALL BE SENT DIRECTLY TO OWNER, ENGINEER, AND CONTRACTOR.

O) CONCRETE SHALL BE PLACED WITHIN 90 MINUTES OF BATCH TIME

P) ALL CONCRETE SHALL BE CONSOLIDATED IN PLACE USING INTERNAL VIBRATORS

Q) SUBMITTALS:

1. SUBMIT PROPOSED CONCRETE MIX DESIGN PRIOR TO CONSTRUCTION
2. SUBMIT DETAILED SHOP DRAWINGS OF REINFORCING BARS SHOWING NUMBER, SIZE, AND LOCATION. INCLUDE BAR LISTS AND BEND DIAGRAM.
3. REINFORCEMENT:

A) REINFORCING STEEL SHALL BE A.S.T.M. A-615 WITH SUPPLEMENT, GRADE 60: MINIMUM WORKING STRESS - 24,000 PSI.

B) ALL REINFORCING SHALL BE UNCOATED (BLACK).

C) ALL DIMENSIONS PERTAINING TO LOCATION OF REINFORCING BARS ARE TO CENTERLINE BARS EXCEPT WHERE THE CLEAR DIMENSION IS SHOWN TO FACE OF CONCRETE.

D) ACI STANDARD HOOKS SHALL BE USED UNLESS OTHERWISE NOTED.

E) ALL LAP SPLICE LENGTHS SHALL BE IN ACCORDANCE WITH THE LATEST EDITION OF ACI 318 AND CRSI STANDARD PRACTICES FOR CLASS 'B' SPLICES, EXCEPT AS OTHERWISE NOTED.
4. FOUNDATIONS:

A) GEOTECHNICAL REPORTS OF SUBSURFACE CONDITIONS HAVE BEEN PREPARED BY ARDAMAN & ASSOCIATES (DATED MARCH 17, 2021 AND JUNE 21, 2021, FILE NO. 20-7220). ANY ADDITIONAL GEOTECHNICAL WORK REQUIRED WILL BE THE RESPONSIBILITY OF THE CONTRACTOR.

B) NOTIFY THE ENGINEER IMMEDIATELY OF ANY EXISTING FOUNDATION CONDITIONS OR DETAILS THAT ARE IN CONFLICT WITH THOSE INDICATED AND SHOWN IN THE DRAWINGS.

C) ADHERE TO THE SITE PREPARATION RECOMMENDATIONS MADE IN THE ENGINEERING EVALUATION AND RECOMMENDATIONS SECTION OF THE JUNE 21, 2021 GEOTECHNICAL REPORT.

D) FOUNDATION HAS BEEN DESIGNED BASED ON A MAXIMUM ALLOWABLE SOIL BEARING CAPACITY OF 1,700 PSF.
5. STRUCTURAL ALUMINUM:

A) STRUCTURAL ALUMINUM SHALL BE DOMESTIC ALLOY 6061-T6.

B) ALUMINUM WORK SHALL BE IN ACCORDANCE WITH THE ALUMINUM ASSOCIATION'S SPECIFICATIONS FOR ALUMINUM STRUCTURES, LATEST EDITION.

C) FASTENERS: UNLESS NOTED OTHERWISE, ALL FASTENERS SHALL BE 316 STAINLESS STEEL MEETING THE REQUIREMENTS OF ASTM F593 OR ASTM A193 FOR BOLTS AND ASTM F594 OR ASTM A194 FOR NUTS. ALL CONNECTIONS WITH DISSIMILAR MATERIALS (E.G. 316 STAINLESS STEEL TO ALUMINUM) SHALL RECEIVE NEOPRENE OR VINYL WASHER. WASHER SHALL BE LARGER THAN BOLT HEAD.

D) ALL WELDING SHALL CONFORMS WITH AWS D1.2, LATEST STRUCTURAL WELDING CODE - ALUMINUM.

E) ALL FILLET WELDS SHALL HAVE A MINIMUM SIZE OF 1/4" WITH 5356 FILLER ALLOY UNLESS OTHERWISE NOTED.

F) PROVIDE NON-SLIP ALUMINUM STAIR TREADS WITH A MINIMUM LIVE LOAD CAPACITY OF 100 PSF.

G) PROVIDE SHOP DRAWINGS FOR ALUMINUM STAIRS AND FRAMING PRIOR TO FABRICATION AND INSTALLATION.

H) WHERE THE CONTACT OF DISSIMILAR MATERIALS MAY CAUSE ELECTROLYSIS OR WHERE ALUMINUM WILL COME IN CONTACT WITH CONCRETE, MORTAR, OR PLASTER, THE CONTACT SURFACE OF THE ALUMINUM SHALL BE COATED WITH ONE HEAVY COAT OF BITUMINOUS PAINT.
6. DESIGN CRITERIA

A) PLATFORM LL = 125 PSF.

GENERATOR, ENCLOSURE, BASE FUEL TANK

EMPTY = 22988 LBS

FULL = 36848 LBS

PREFABRICATED BUILDING

EMPTY = 54100 LBS

WITH ELECTRICAL EQUIPMENT = 62,000 LBS

B) WETWELL TOP SLAB LL = 300 PSF

C) WIND DESIGN DATA:

VULT = 150 MPH

WIND EXPOSURE C

RISK CATEGORY II

D) FLOOD DESIGN DATA

FEMA FIRM: 12081C0312E

ZONE AE

BASE FLOOD ELEVATION = 11' NAVD 88

DESIGN STILLWATER FLOOD EL. = 9.05'



E) ALLOWABLE SOIL BEARING CAPACITY = 1,700 PSF.

F) CODES:

2020 FLORIDA BUILDING CODE

ASCE 7-16

ACI 318-14

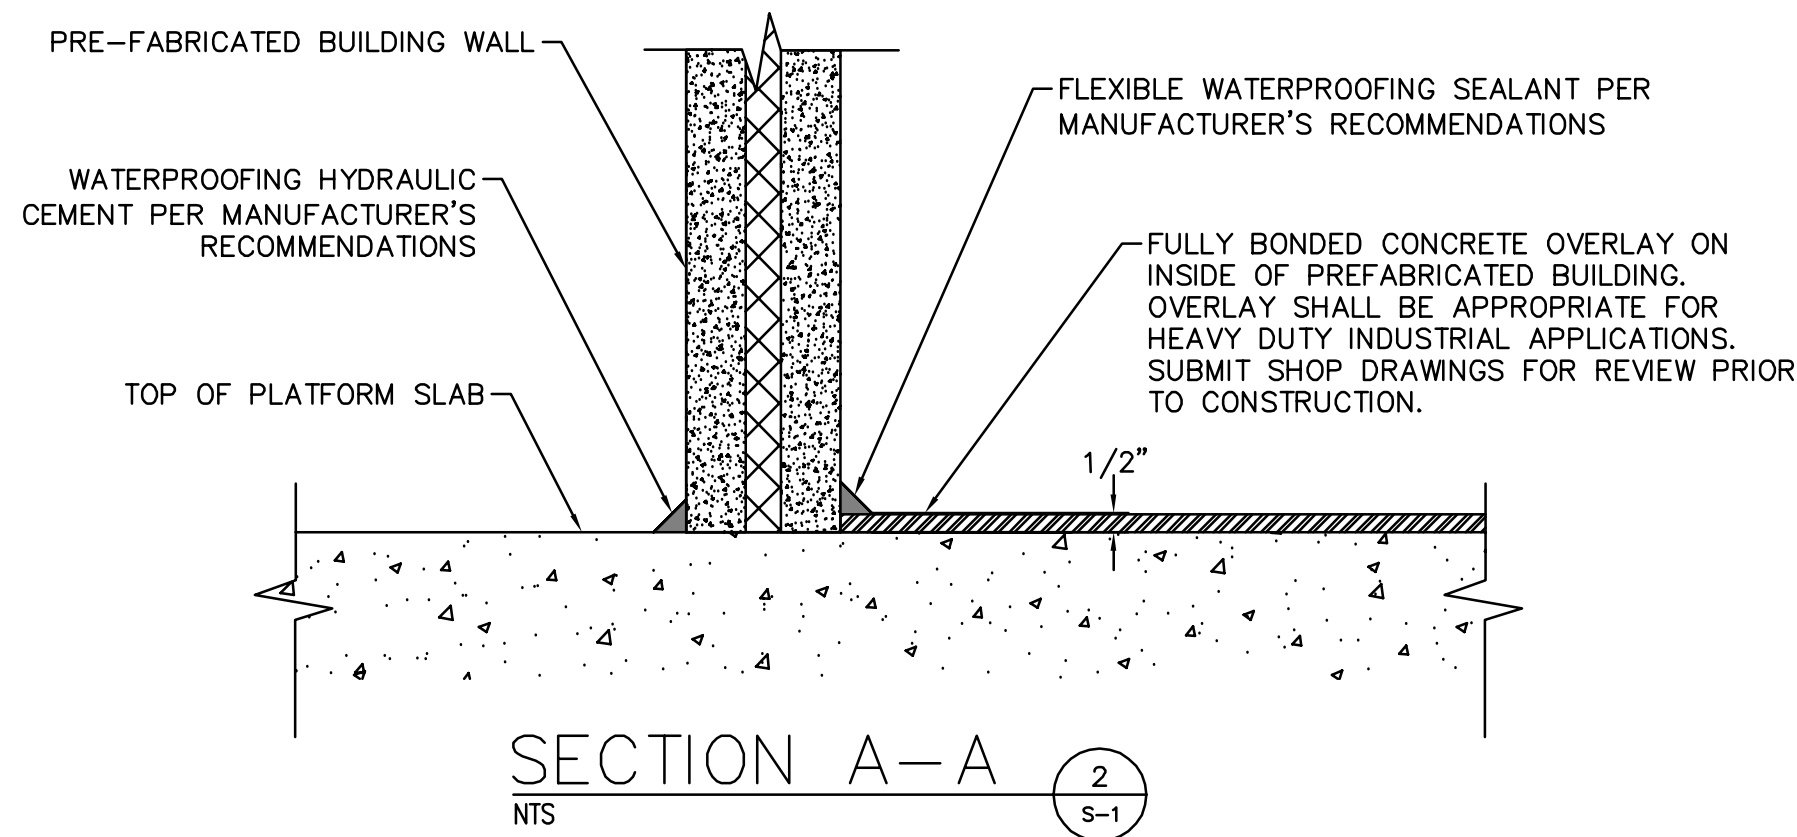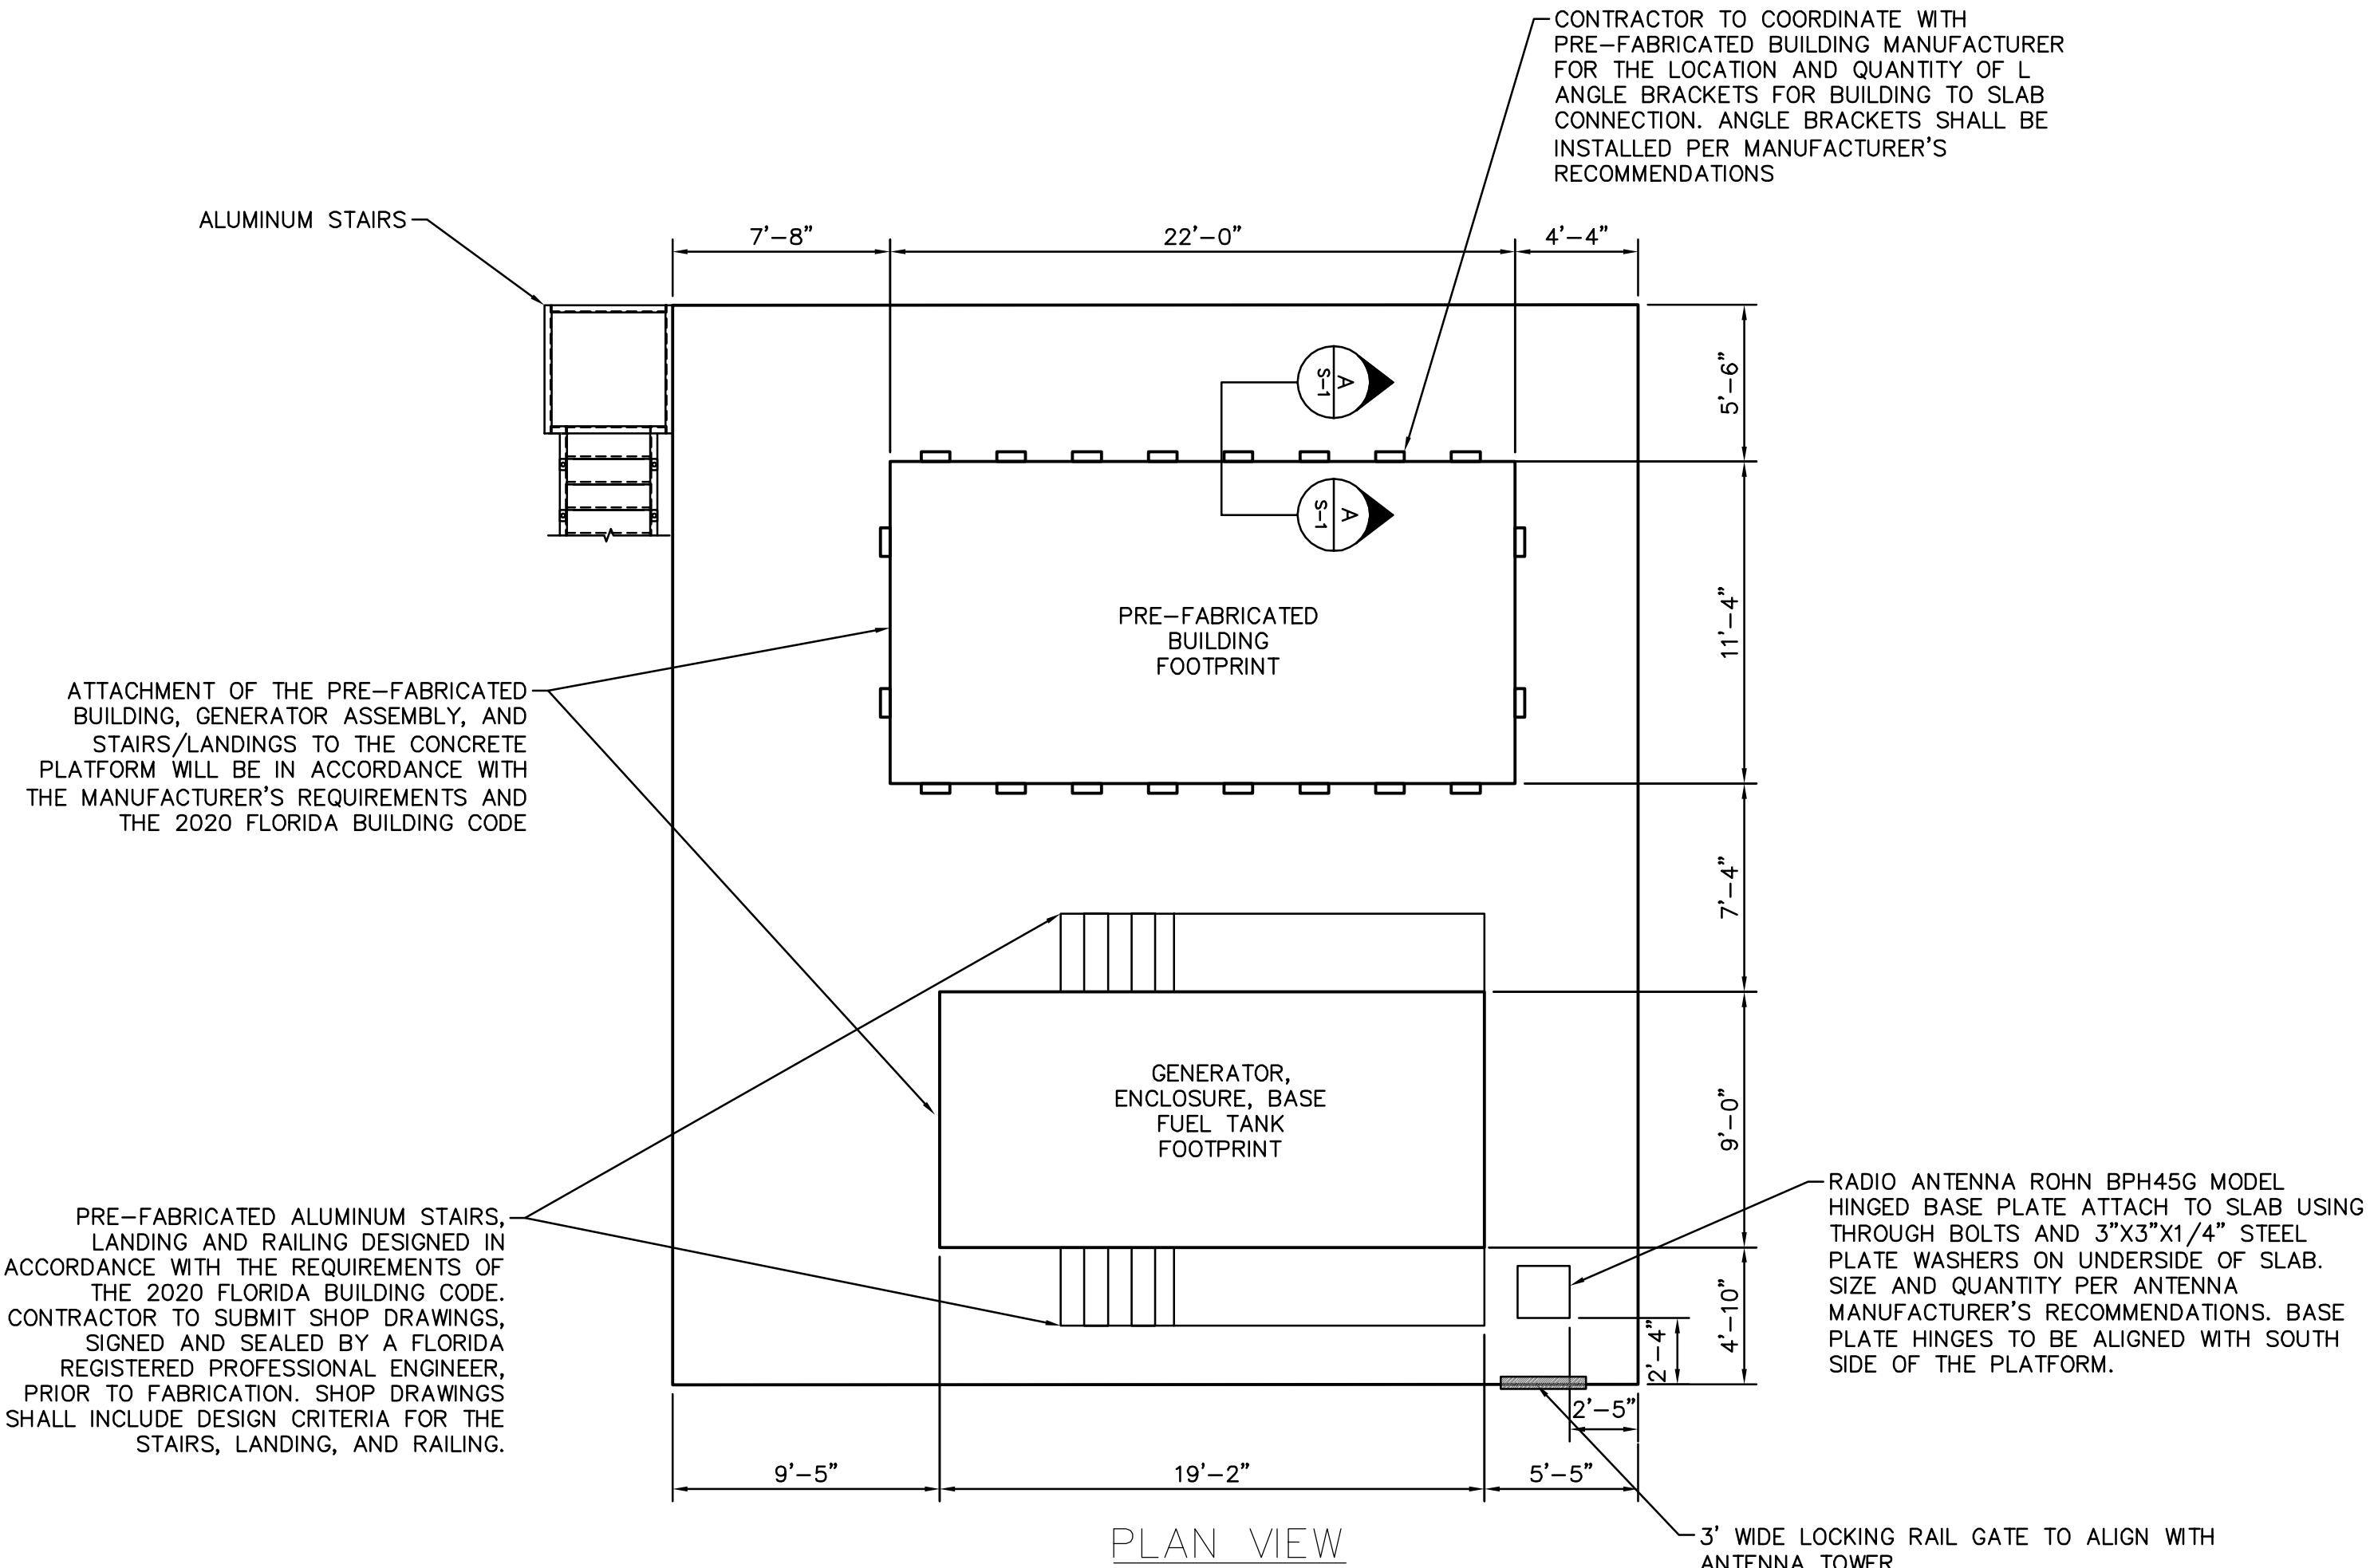

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PHONE: 727-547-3999

WWW.KIMLEY-HORN.COM    REGISTRY NO. 35106

KHA PROJECT  
148400067

DATE  
FEB 2022

SCALE AS SHOWN

DESIGNED BY SES

DRAWN BY GMB

CHECKED BY SNR

Manatee  
County  
FLORIDA

BAYSHORE YACHT BASIN FORCE MAIN  
AND LIFT STATION REPLACEMENT

MANATEE COUNTY

LICENSED PROFESSIONAL

SETH E. SCHMID, P.E.

FL LICENSE NUMBER  
54640

DATE:


STRUCTURAL NOTES/  
EQUIPMENT LAYOUT

SHEET NUMBER


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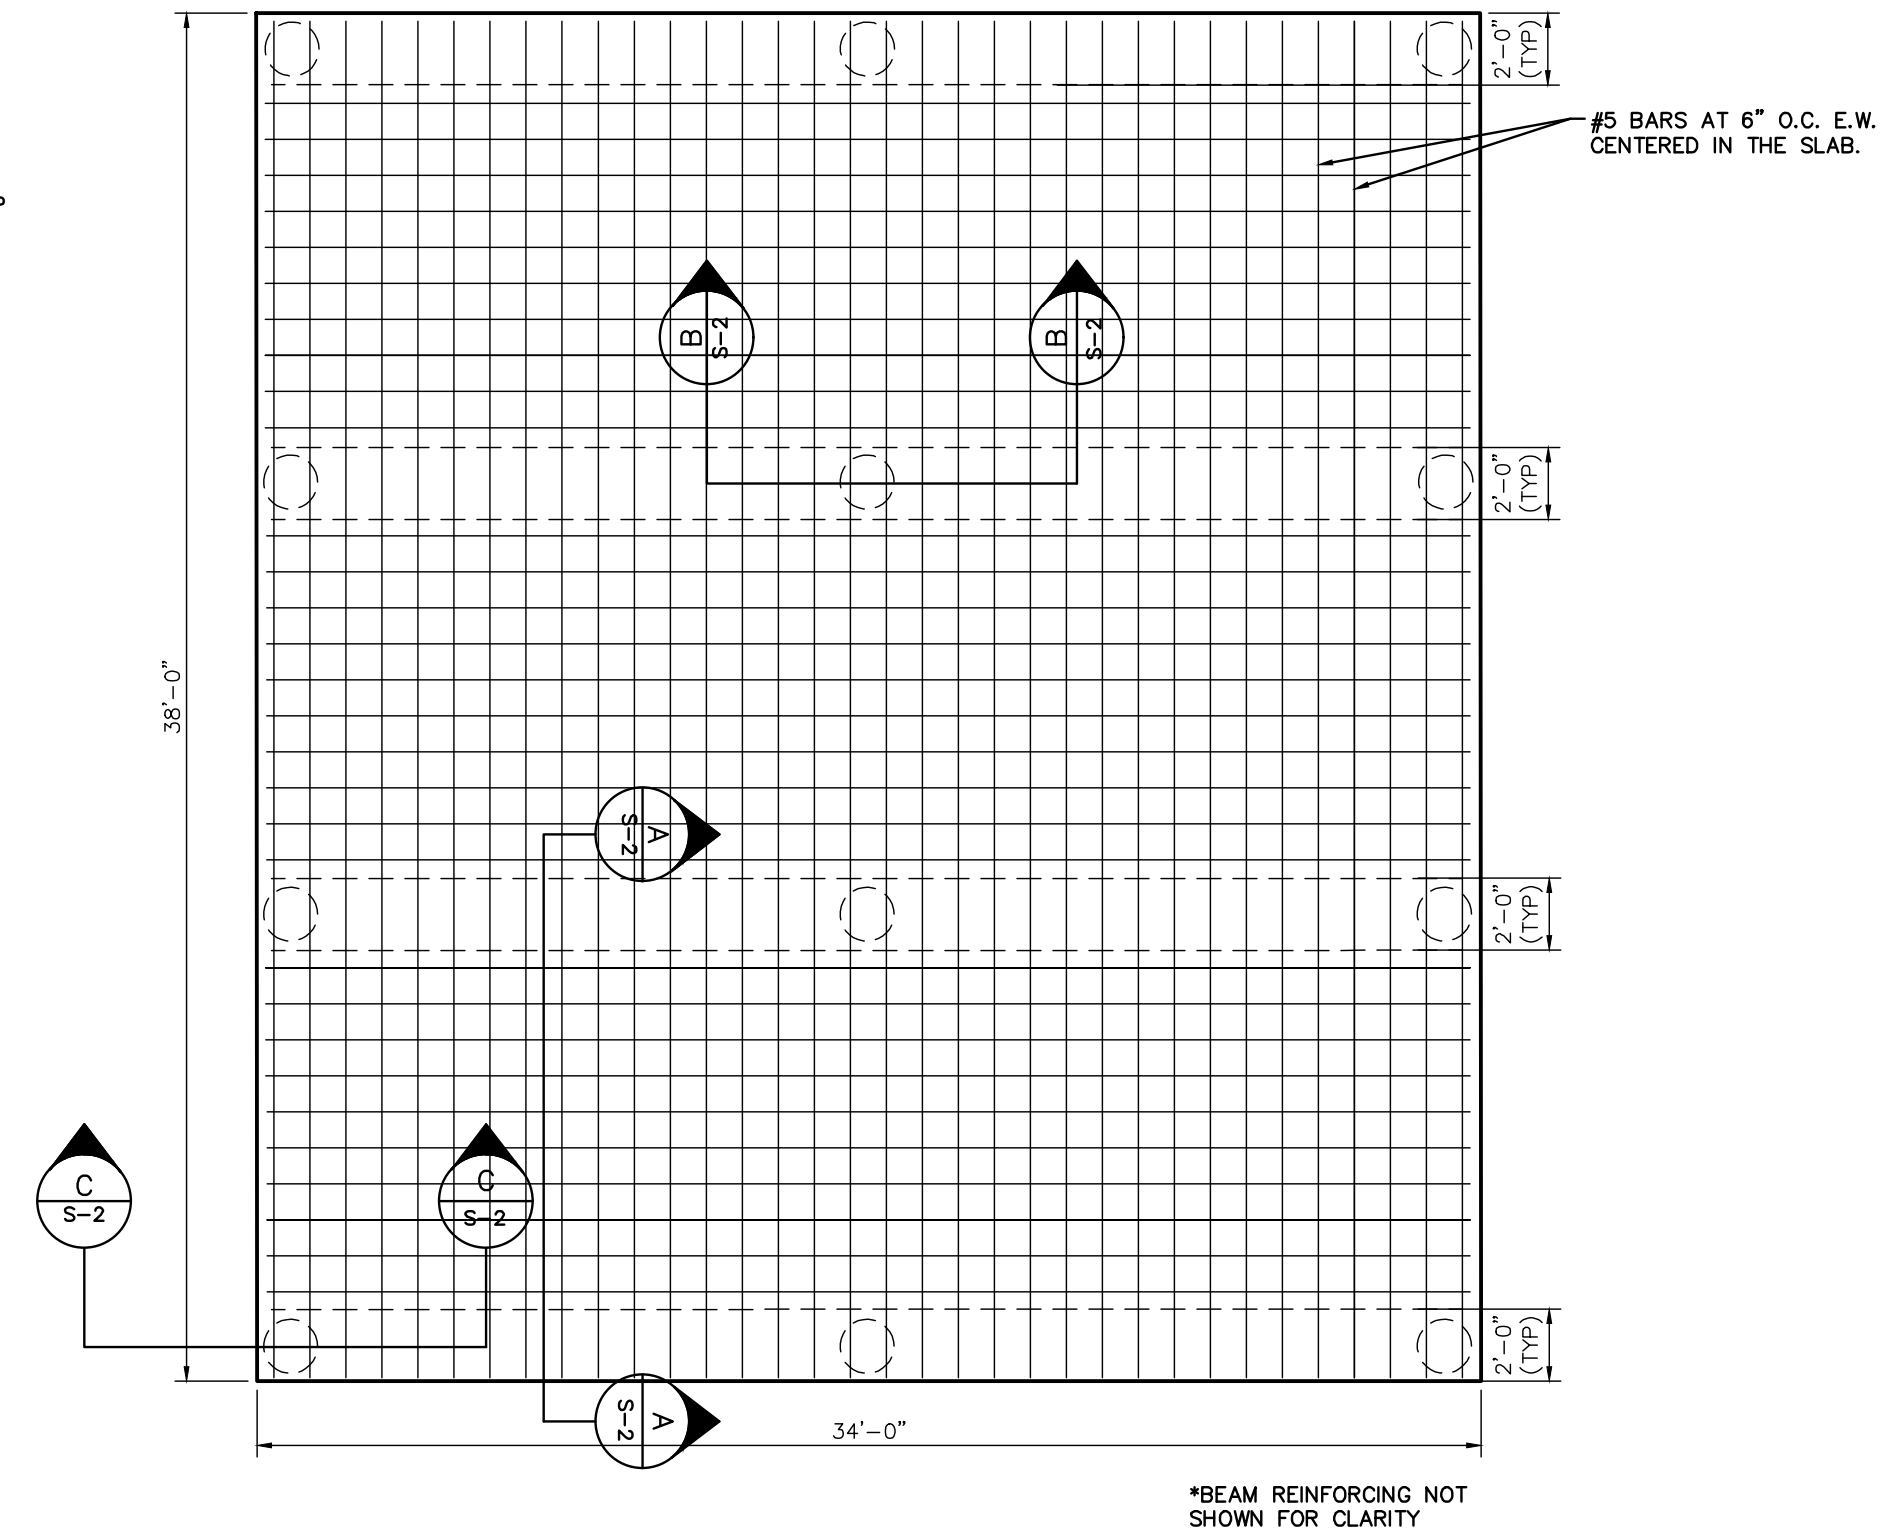
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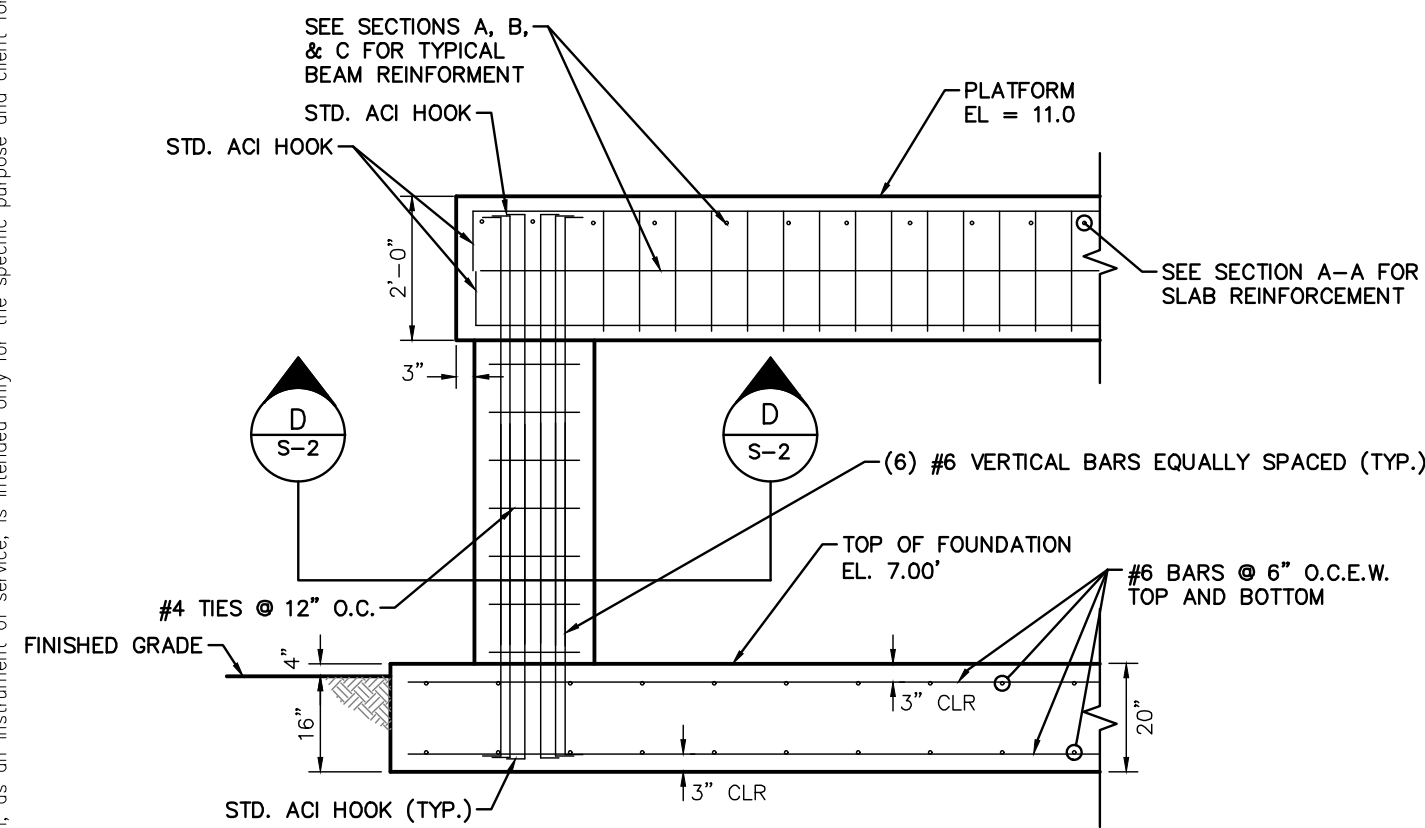
PLAN VIEW  
FOUNDATION  
 $\frac{3}{16}'' = 1'-0''$  1 S-2




PLAN VIEW  
TOP SLAB  
 $\frac{3}{16}'' = 1'-0''$  2 S-2

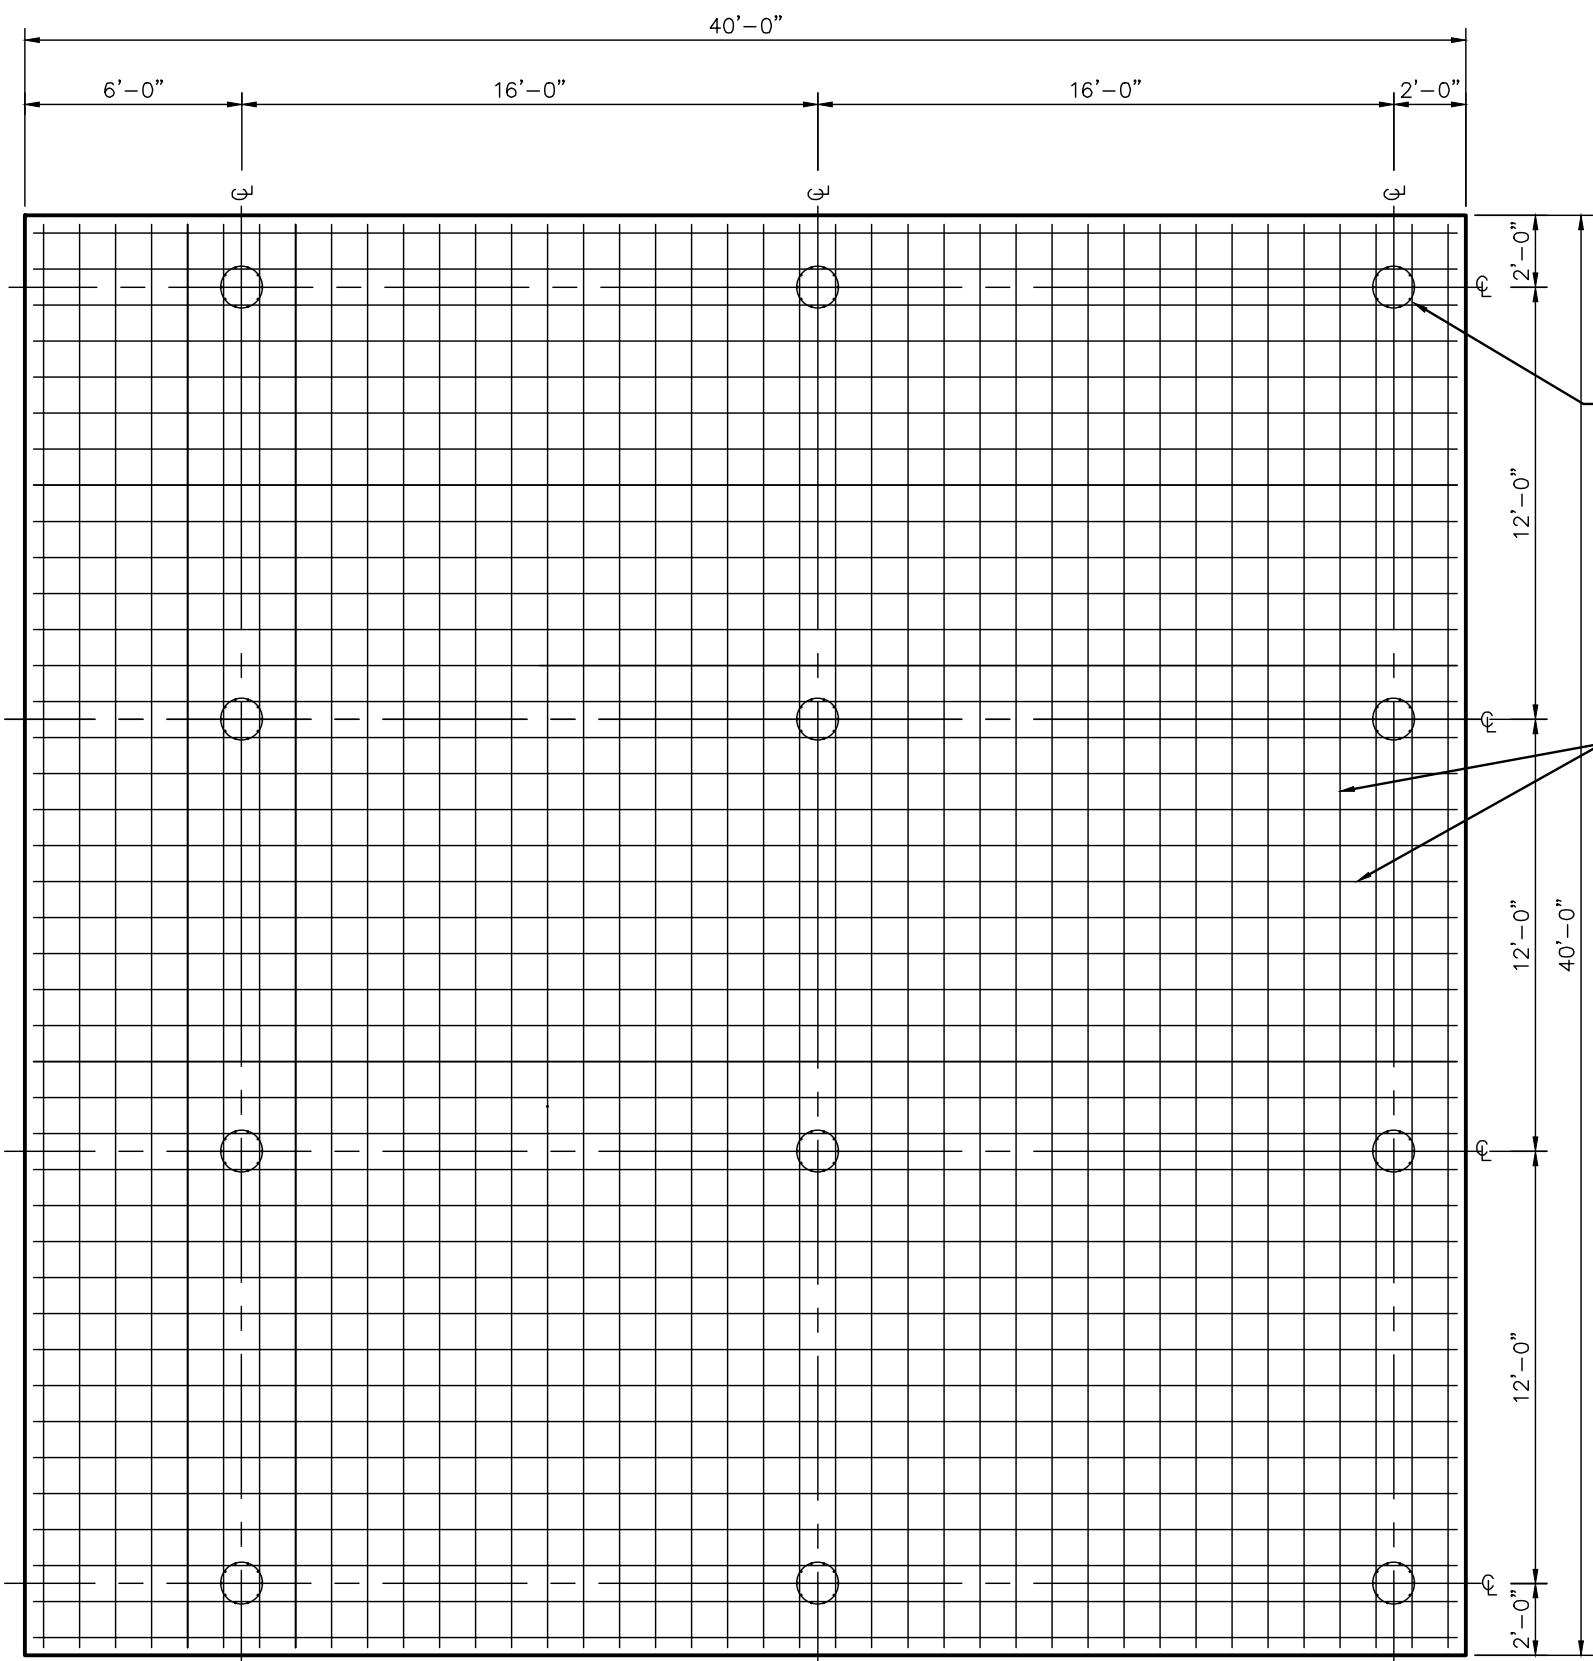


PLAN VIEW  
TOP SLAB REINFORCING PLAN  
N.T.S. 3 S-2

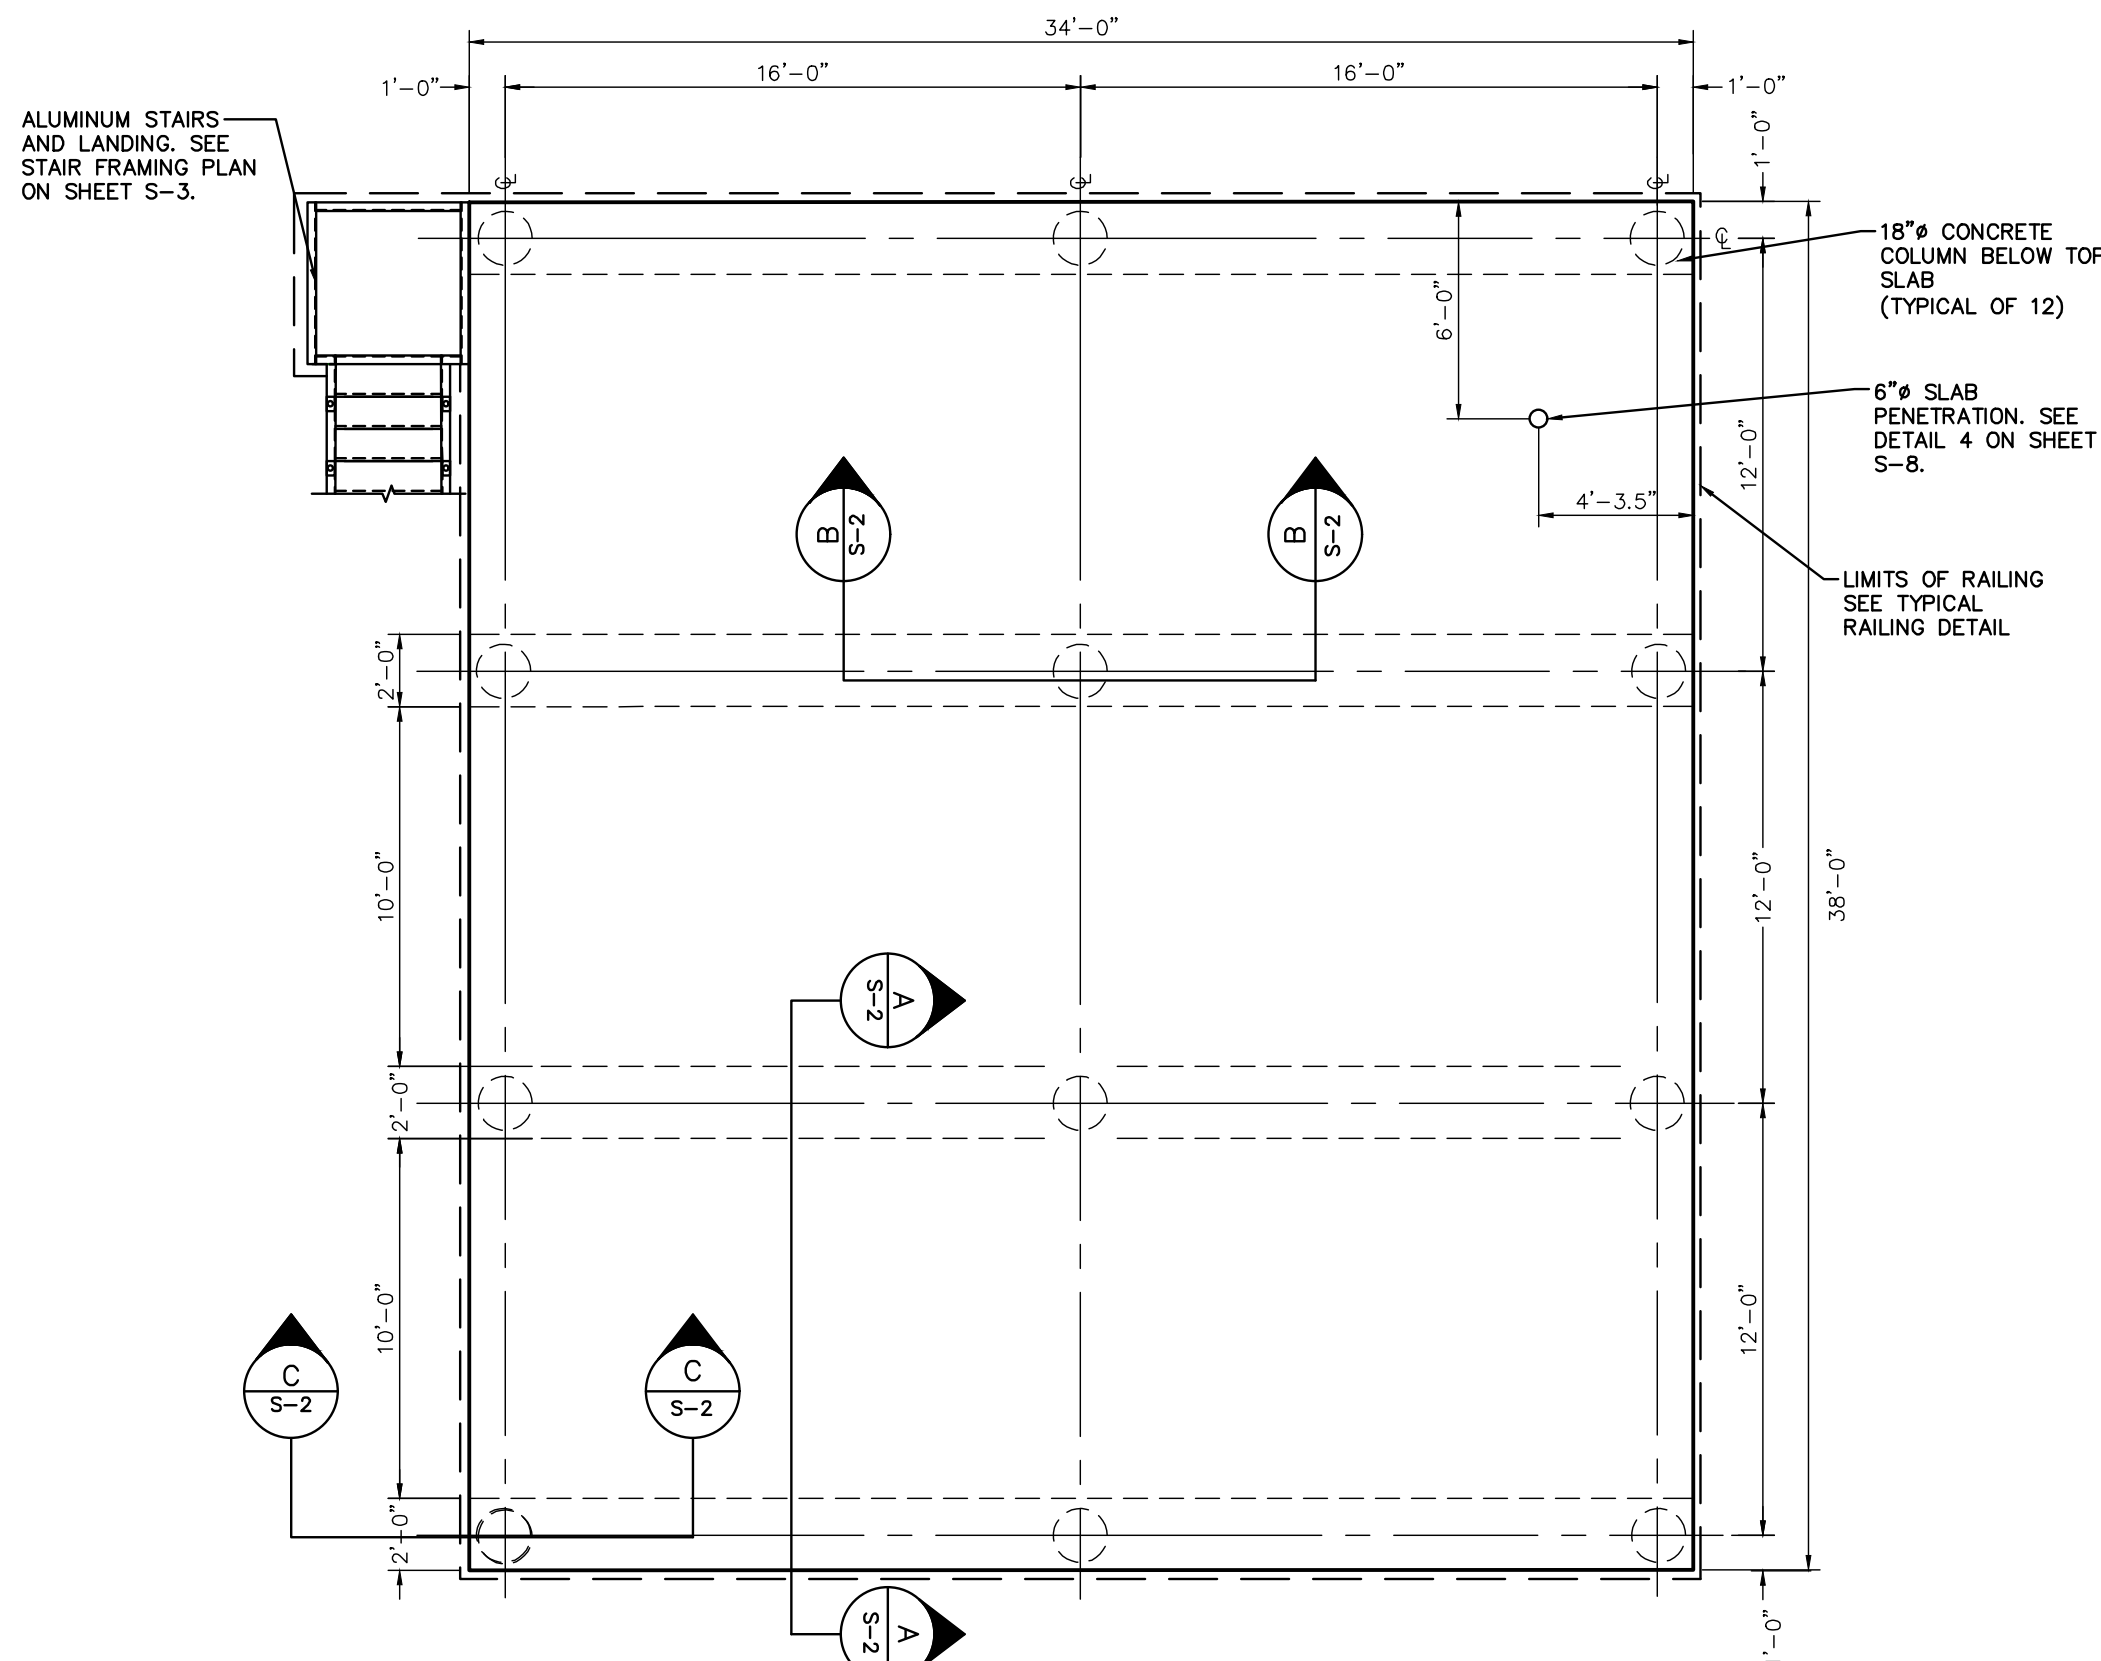


ELEVATION VIEW  
TYPICAL COLUMN REINFORCEMENT  
 $\frac{3}{8}'' = 1'-0''$  4 S-2

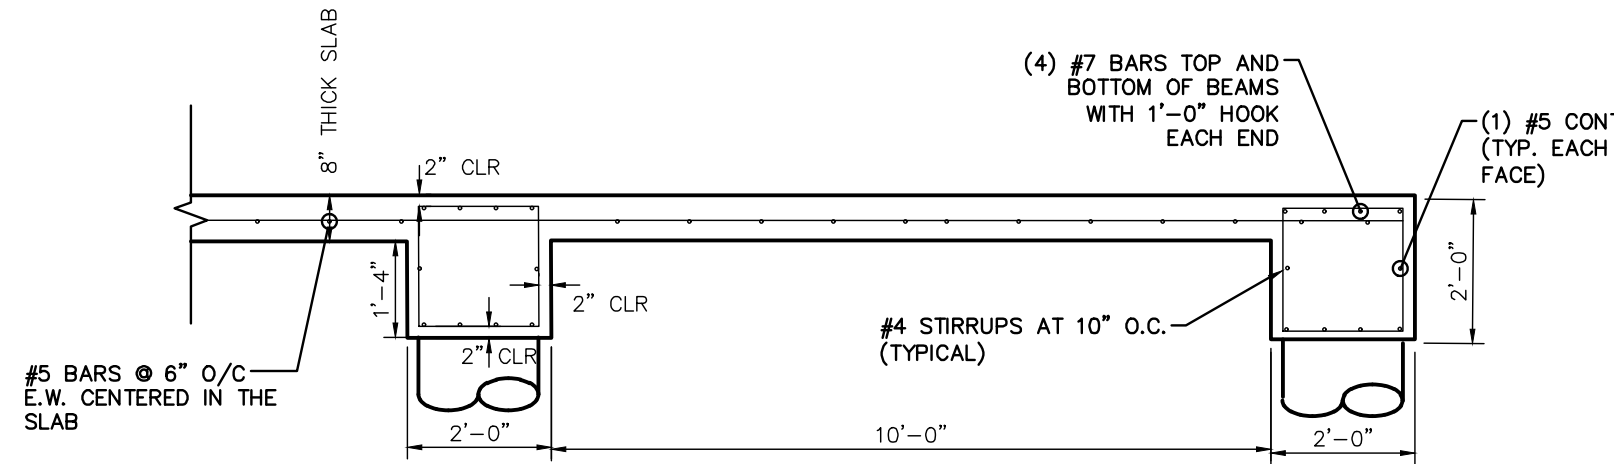


SECTION A-A  
TYPICAL BEAM AND SLAB  
 $\frac{3}{8}'' = 1'-0''$  5 S-2

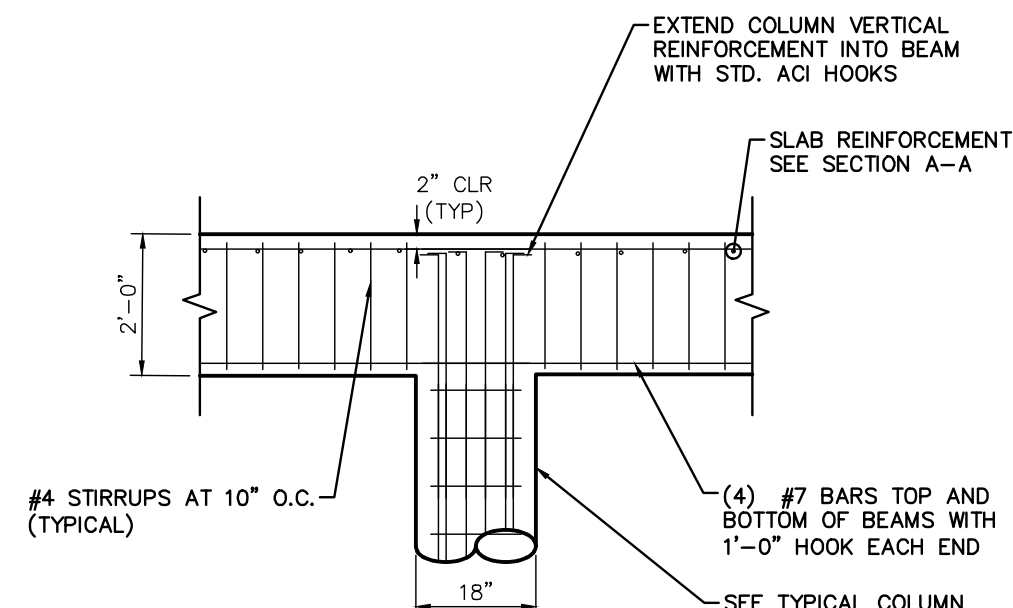

SECTION B-B  
TYPICAL INTERIOR BEAM  
 $\frac{3}{8}'' = 1'-0''$  6 S-2

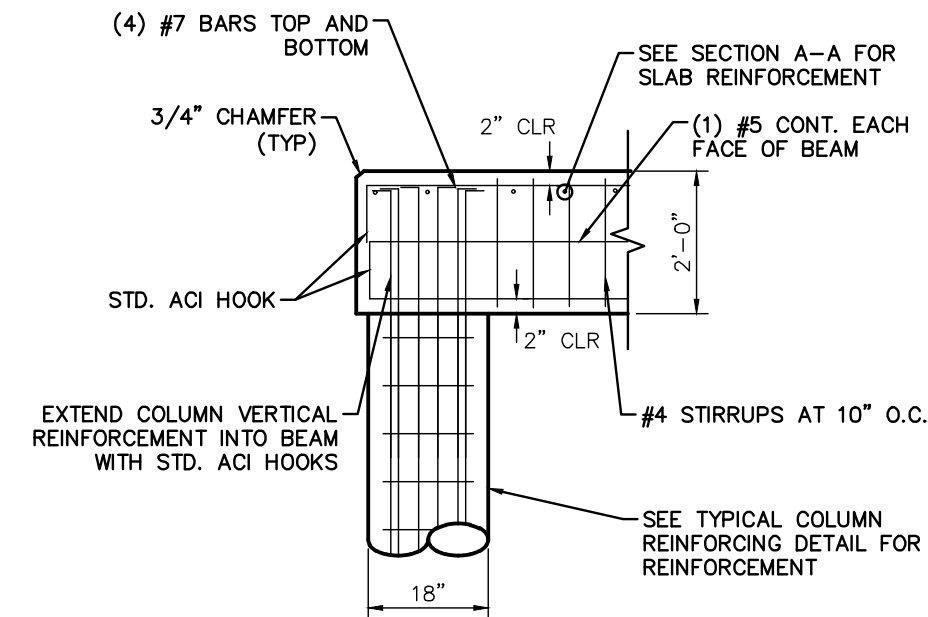

SECTION C-C  
TYPICAL EDGE BEAM  
 $\frac{3}{8}'' = 1'-0''$  7 S-2

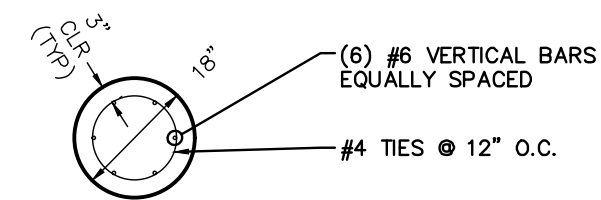

SECTION D-D  
 $\frac{3}{8}'' = 1'$  2 S-2

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	DATE FEB 2022
	SCALE    AS SHOWN
	DESIGNED BY    SES
	DRAWN BY    GMB
	CHECKED BY    SNR

<b>BAYSHORE YACHT BASIN FORCE MAIN AND LIFT STATION REPLACEMENT</b>
MANATEE COUNTY


LICENSED PROFESSIONAL
SETH E. SCHMID, P.E.
FL LICENSE NUMBER 54640
DATE:

<b>ELEVATED PLATFORM DETAILS</b>
----------------------------------


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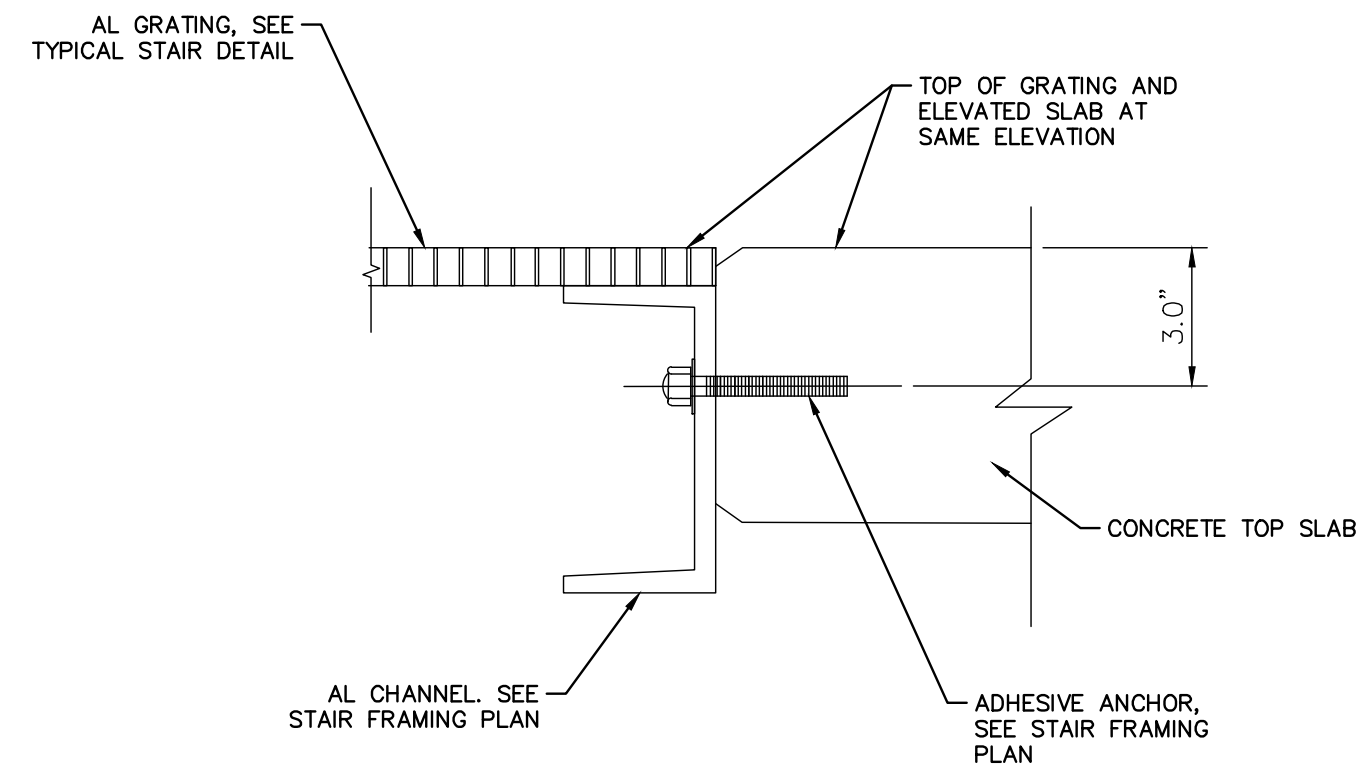
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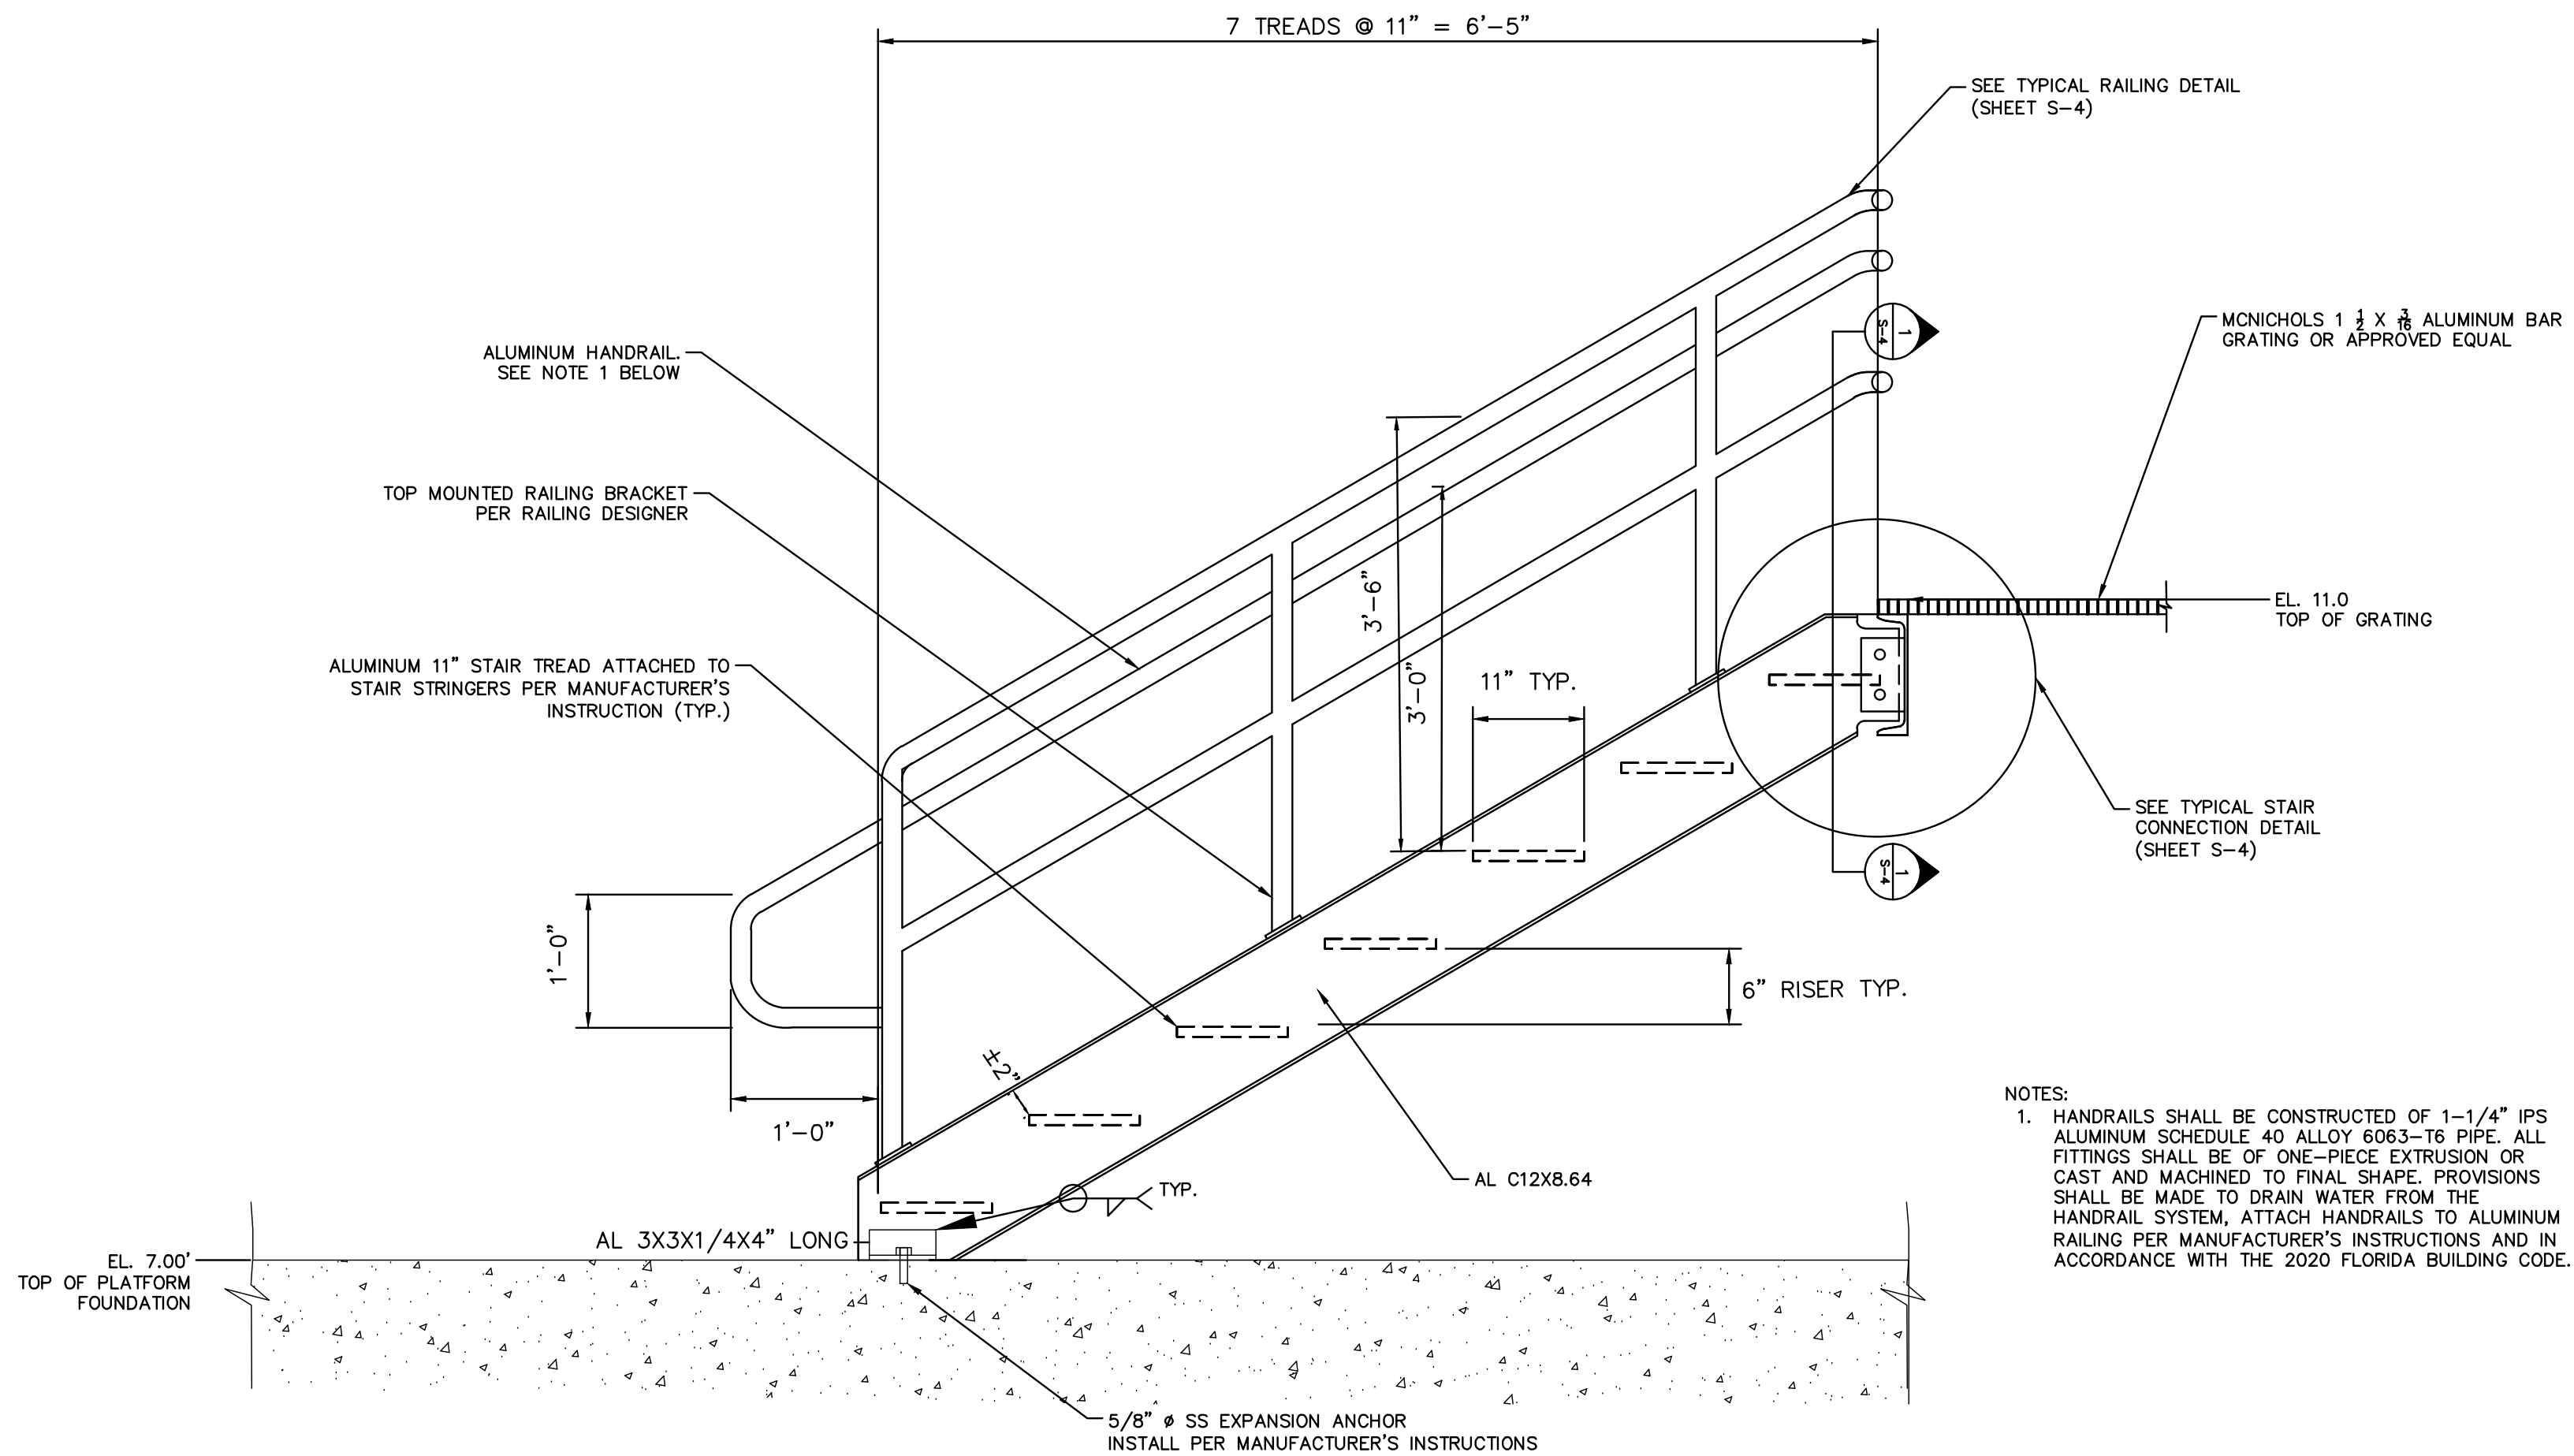
STAIR FRAMING PLAN  
N.T.S.



SECTION A-A  
N.T.S.

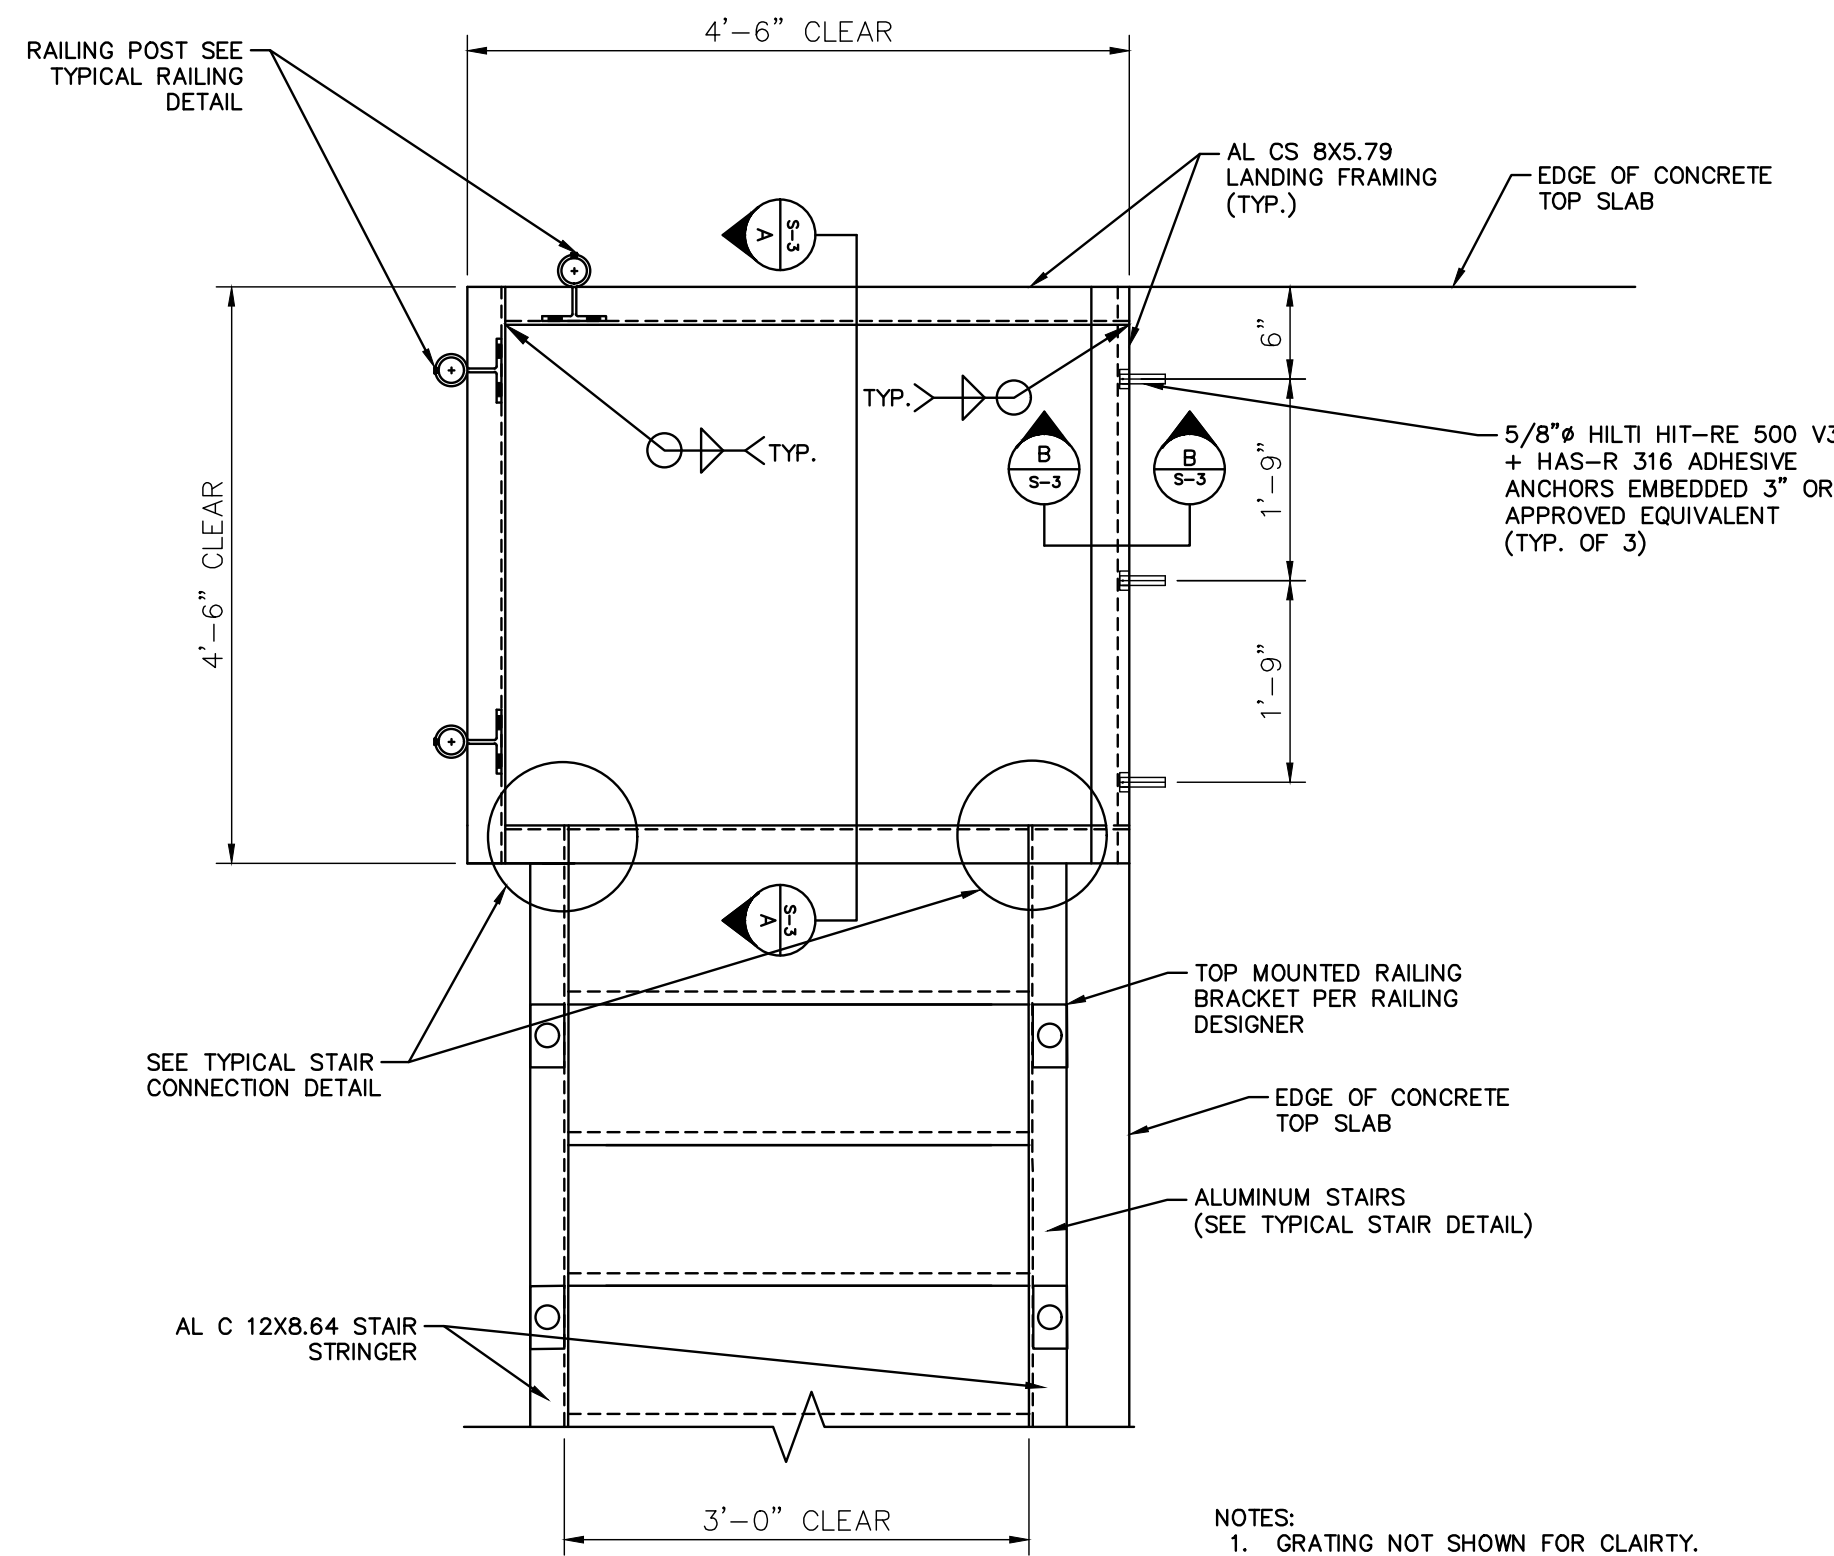

SECTION B-B  
N.T.S.

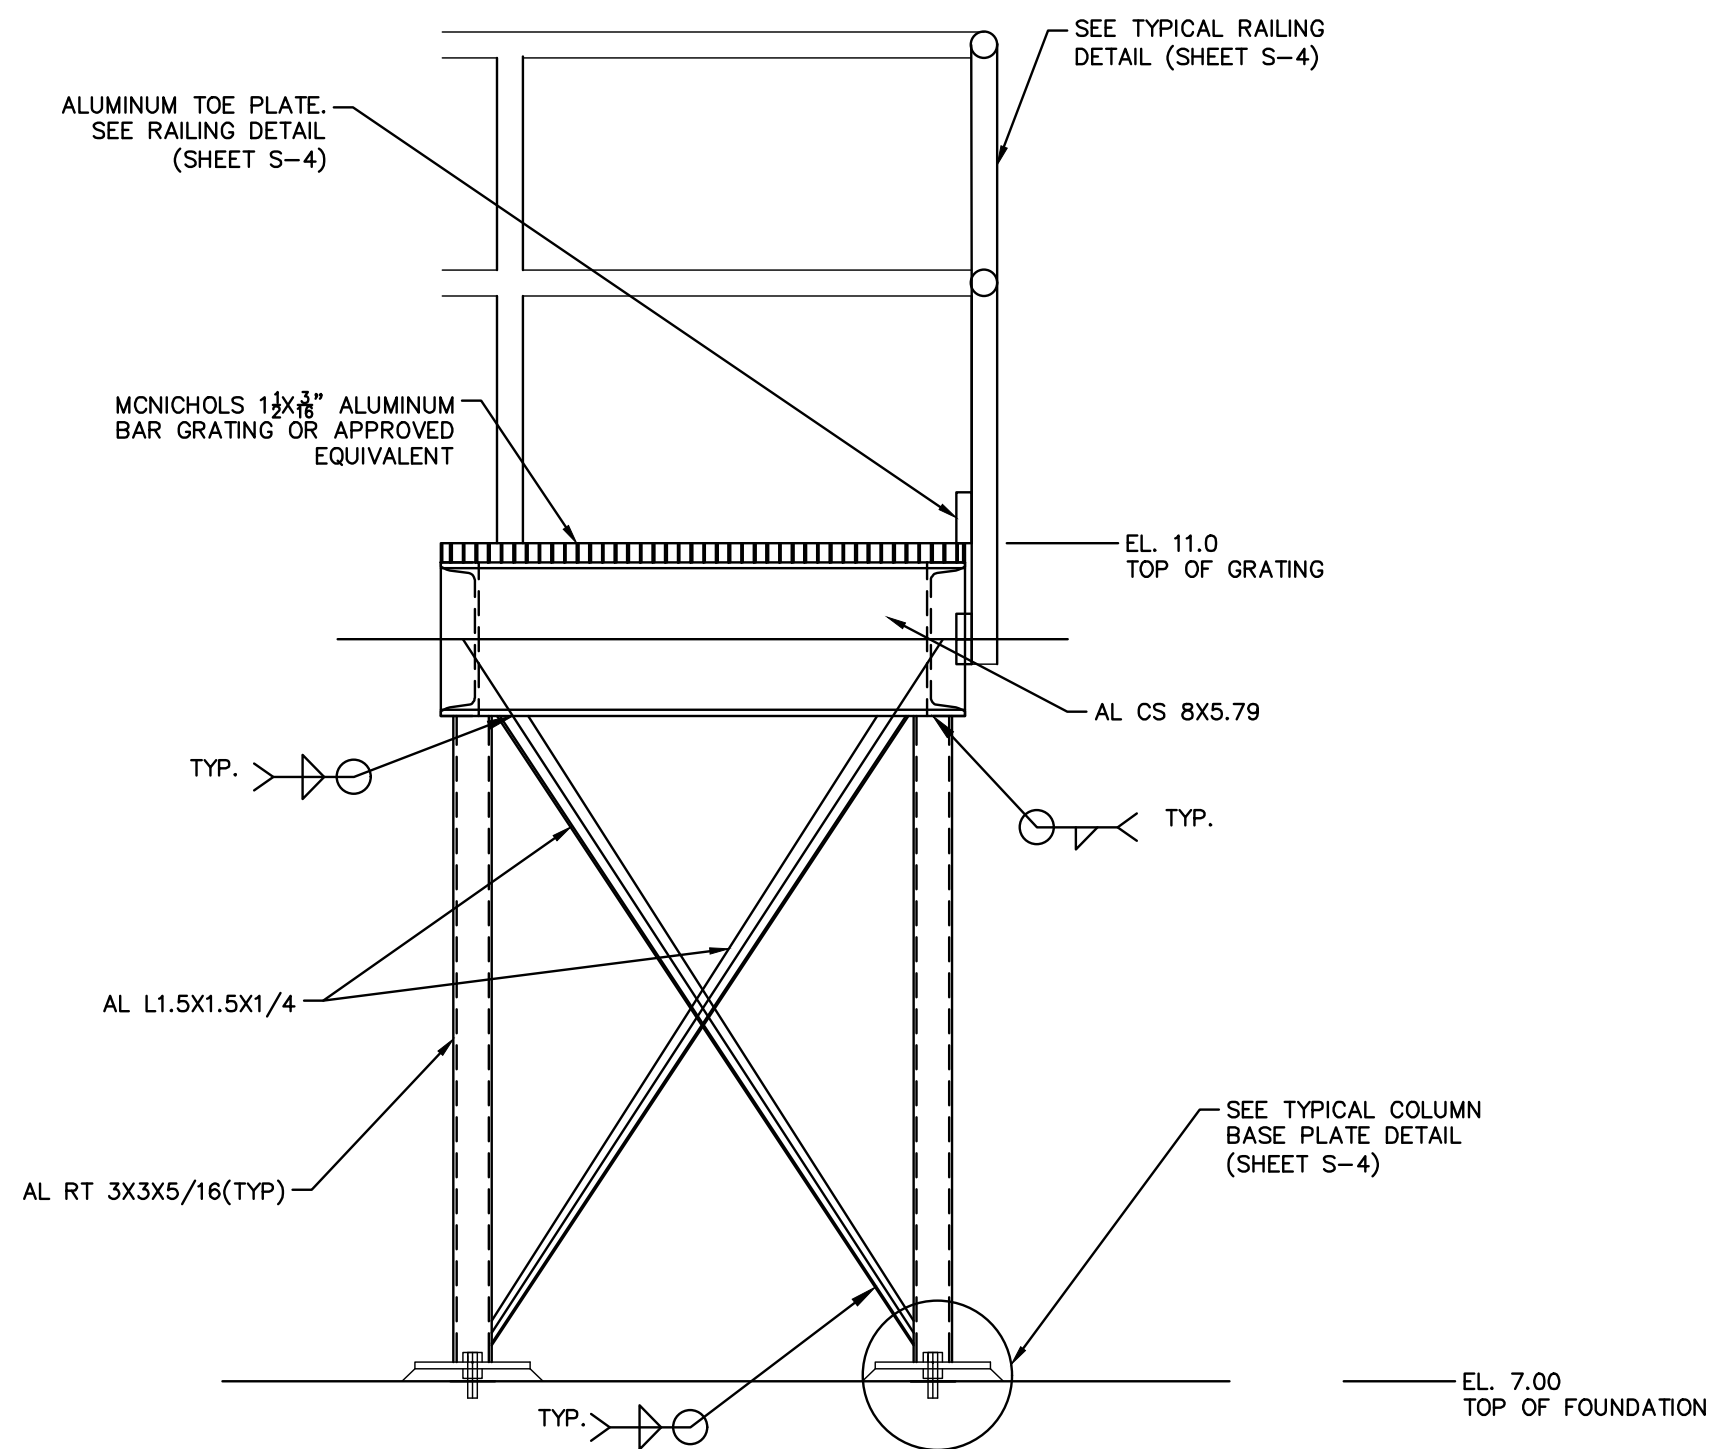

TYPICAL STAIR DETAIL  
N.T.S.

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
DATE  
FEB 2022

SCALE AS SHOWN

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**Manatee  
County  
FLORIDA**

**BAYSHORE YACHT BASIN FORCE MAIN  
AND LIFT STATION REPLACEMENT**

MANATEE COUNTY

LICENSED PROFESSIONAL

SETH E. SCHMID, P.E.

FL LICENSE NUMBER  
54640

DATE:


**ELEVATED PLATFORM DETAILS**

SHEET NUMBER


**S-3**




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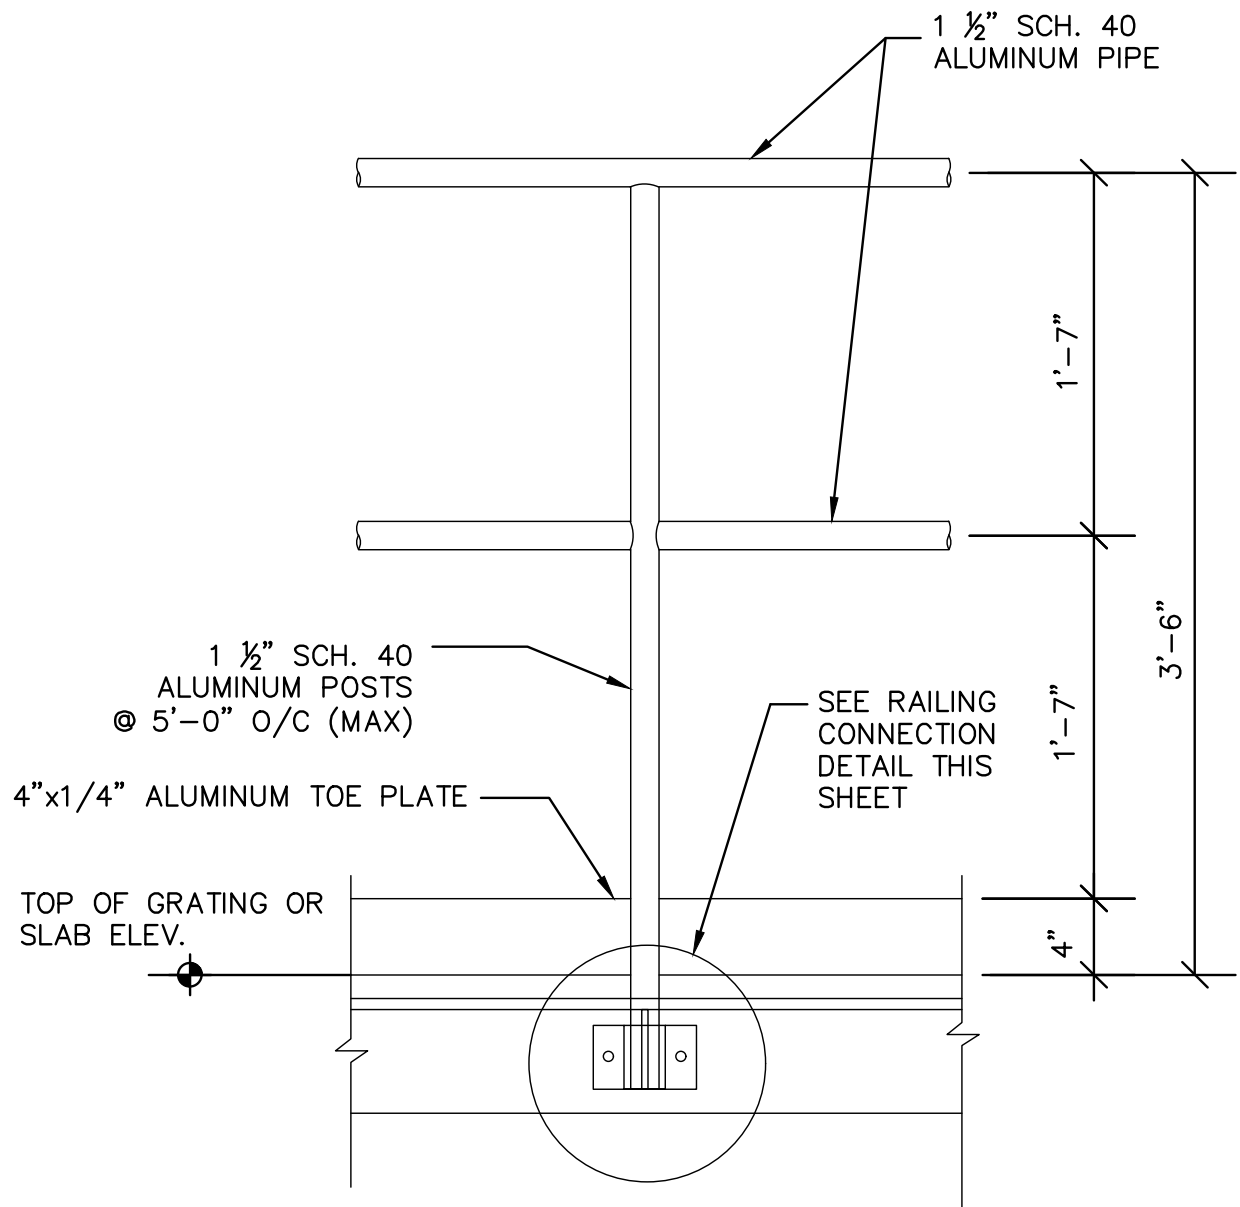
TYPICAL STAIR CROSS SECTION 1  
N.T.S. S-4

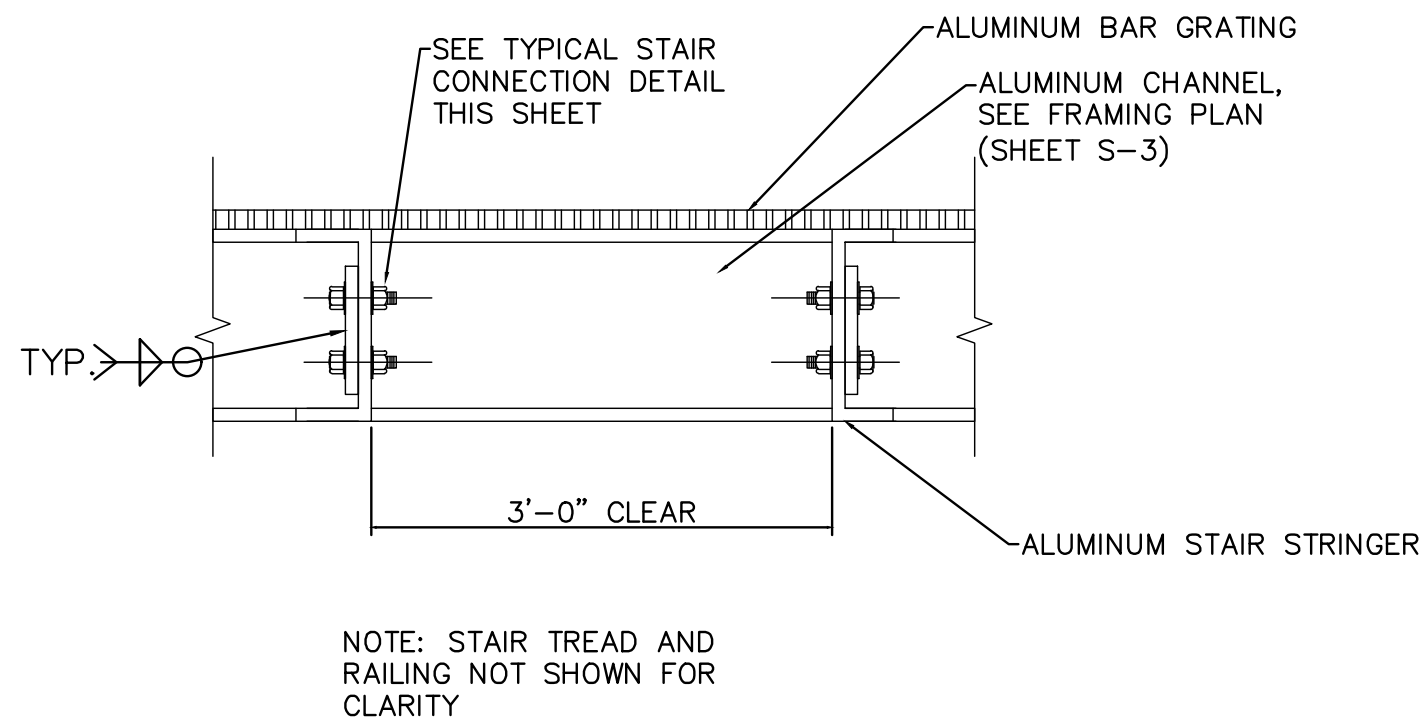


TYPICAL STAIR CONNECTION DETAIL 2  
N.T.S. S-4

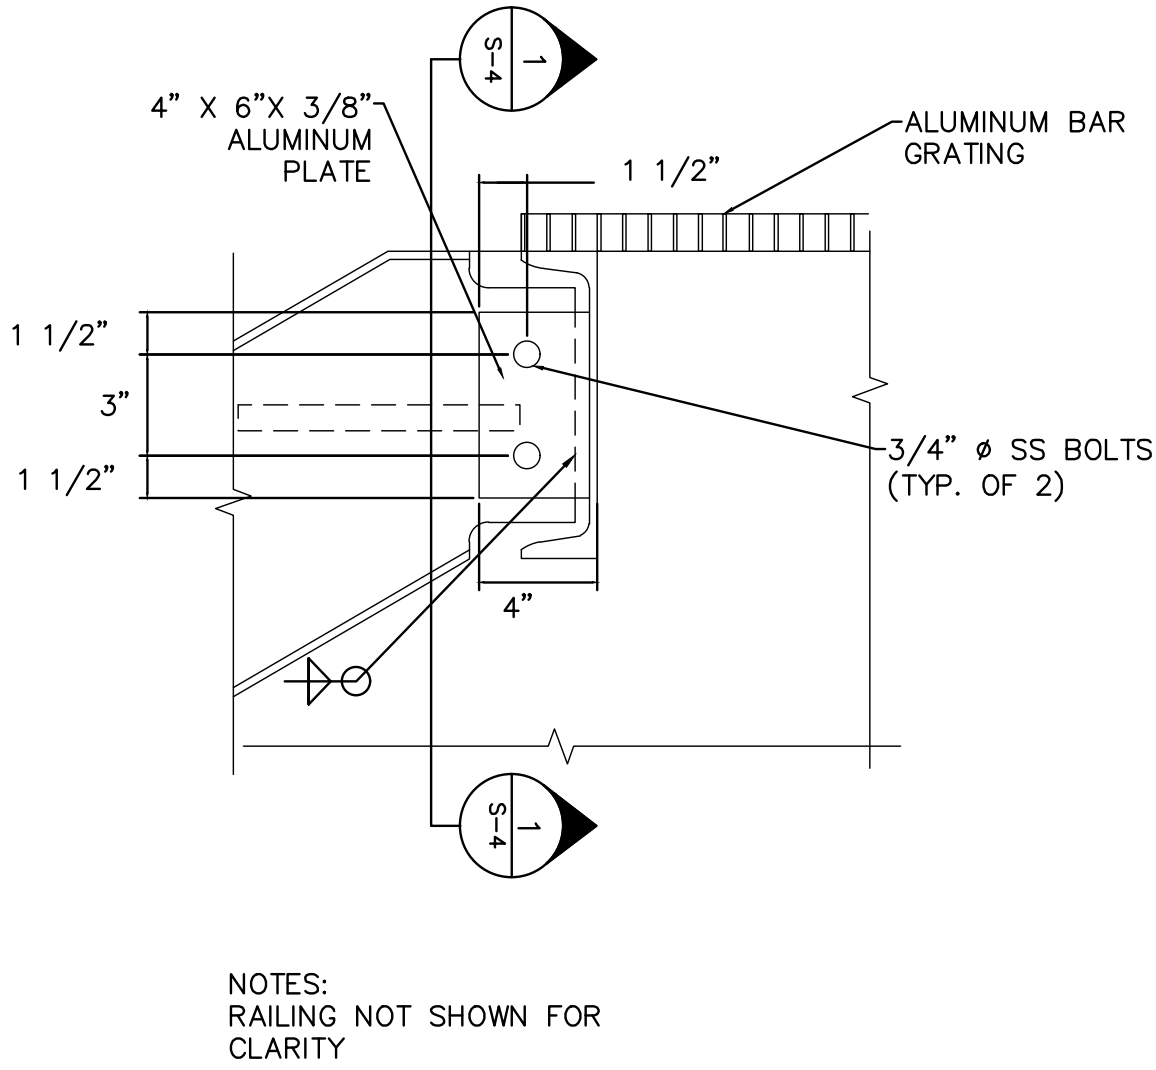

TYPICAL COLUMN BASE DETAIL 3  
N.T.S. S-4

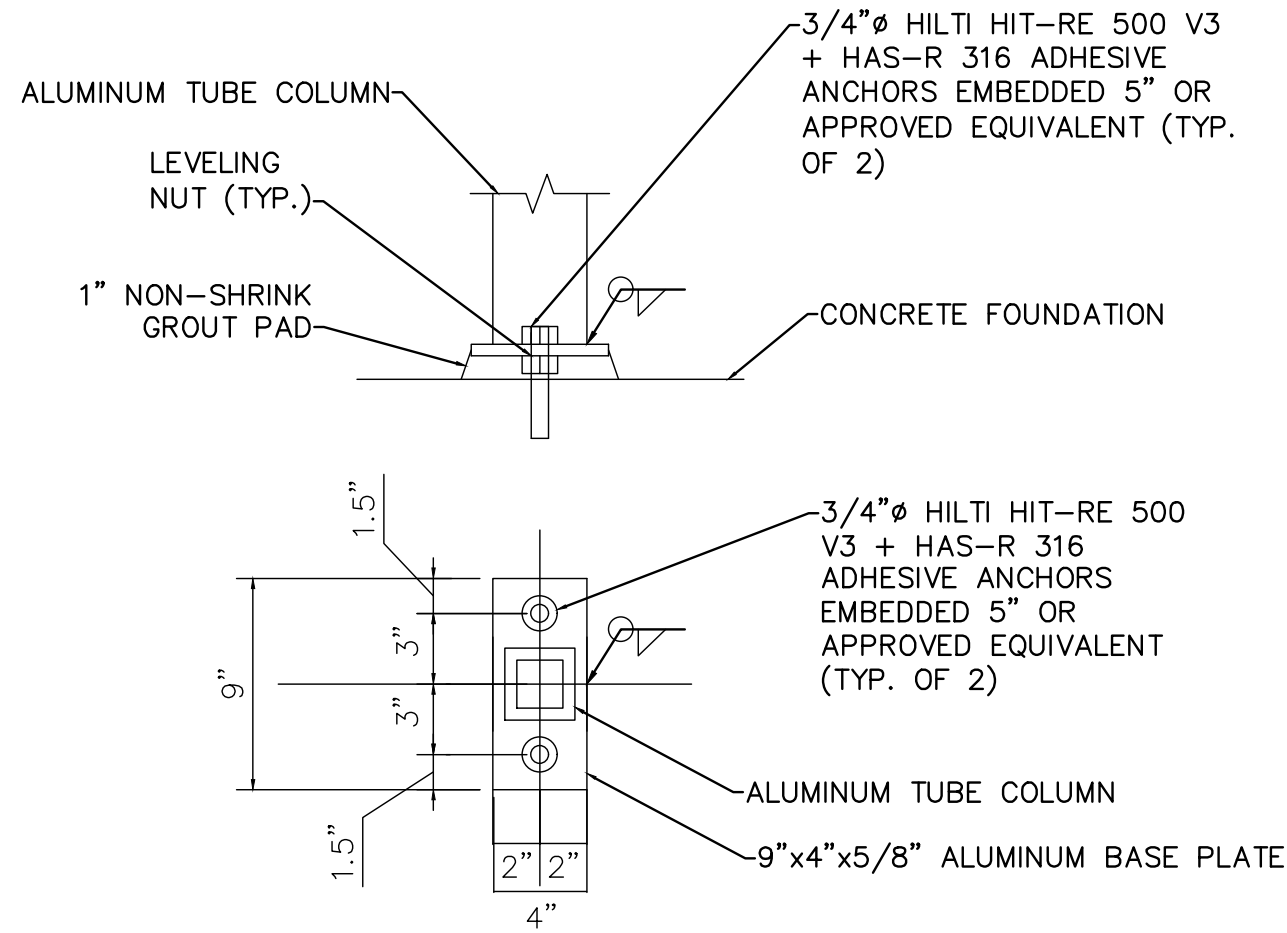

TYPICAL RAILING DETAIL 4  
N.T.S. S-4

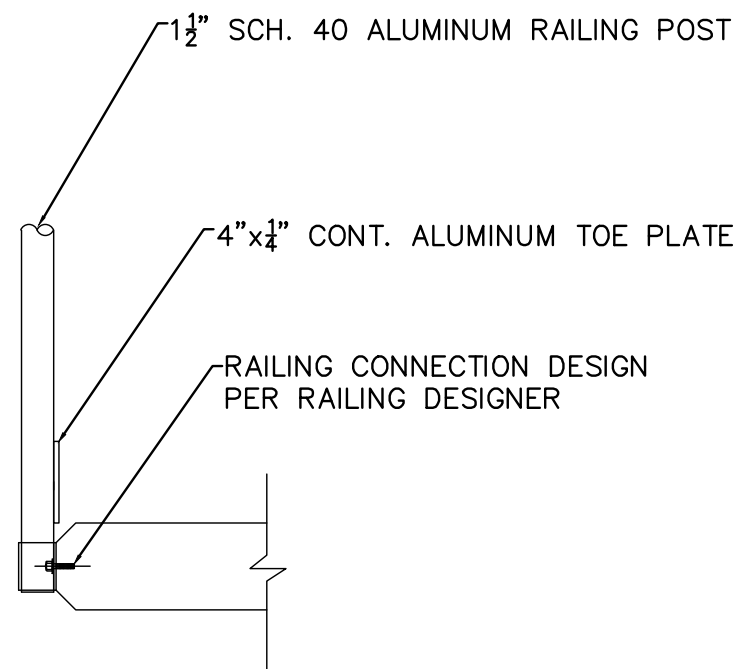


RAILING CONNECTION DETAIL 5  
N.T.S. S-4

DESIGN SPECIFICATIONS FOR FACTORY-INDUSTRIAL RAILING APPLICATIONS

1. RAILING SHALL BE DESIGNED IN ACCORDANCE WITH THE CURRENT EDITION OF THE FLORIDA BUILDING CODE.
2. THE MANUFACTURER SHALL SUBMIT CALCULATIONS SIGNED AND SEALED BY A FLORIDA REGISTERED PROFESSIONAL ENGINEER FOR REVIEW.
3. POST SPACING SHALL BE A MAXIMUM OF 5'-0". POSTS AND RAILINGS SHALL BE A MINIMUM OF 1 1/2" SCH. 40 ALUMINUM PIPE, ALLOY 6063-T6, ASTM-B-429 OR ASTM-B-221. THE RAILING MANUFACTURER SHALL SHOW THAT THEIR POSTS ARE OF ADEQUATE STRENGTH TO MEET THE LOADING REQUIREMENTS. IF THE MANUFACTURER'S POSTS ARE NOT OF ADEQUATE STRENGTH, THE MANUFACTURER MAY REDUCE POST SPACING, OR ADD REINFORCING DOWEL, OR DO BOTH TO MEET LOADING REQUIREMENTS.
4. RAILING POSTS AND HORIZONTAL MEMBERS SHALL BE WELDED TOGETHER AND SHALL NOT BE MECHANICALLY CONNECTED EXCEPT AT EXPANSION JOINTS..
5. POSTS SHALL NOT INTERRUPT CONTINUATION OF THE TOP RAIL AT ANY POINT ALONG THE RAILING, INCLUDING CORNERS AND END TERMINATIONS (OSHA 191023). THE TOP SURFACE OF THE TOP RAILING SHALL BE SMOOTH AND UNINTERRUPTED BY PROJECTING FITTINGS.
6. THE MIDRAIL AT A CORNER RETURN SHALL BE ABLE TO WITHSTAND A 200 LB. LOAD WITHOUT LOOSENING. THE MANUFACTURER IS TO DETERMINE THIS DIMENSION FOR THEIR SYSTEM.
7. TOE PLATE SHALL CONFORM TO OSHA STANDARDS. TOE PLATE SHALL BE A MINIMUM OF 4" HIGH AND SHALL BE AN EXTRUSION THAT ATTACHES TO THE POSTS TO ALLOW FOR EXPANSION AND CONTRACTION BETWEEN POSTS. TOE PLATES SHALL BE SET 1/4" ABOVE THE WALKING SURFACE. TOE PLATES SHALL BE PROVIDED ON RAILING AS REQUIRED BY OSHA AND/OR AS SHOWN ON DRAWINGS.
8. FIELD WELDING OF THE ALUMINUM RAILING IS NOT ALLOWED.

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	DATE FEB 2022
	SCALE    AS SHOWN
	DESIGNED BY    SES
	DRAWN BY    GMB
	CHECKED BY    SNR


<b>BAYSHORE YACHT BASIN FORCE MAIN AND LIFT STATION REPLACEMENT</b>
MANATEE COUNTY


LICENSED PROFESSIONAL
SETH E. SCHMID, P.E.
FL LICENSE NUMBER 54640
DATE:

<b>STAIR AND RAILING DETAILS</b>
----------------------------------

SHEET NUMBER
<b>S-4</b>



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2 WETWELL TOP SLAB PLAN  
SCALE: NTS

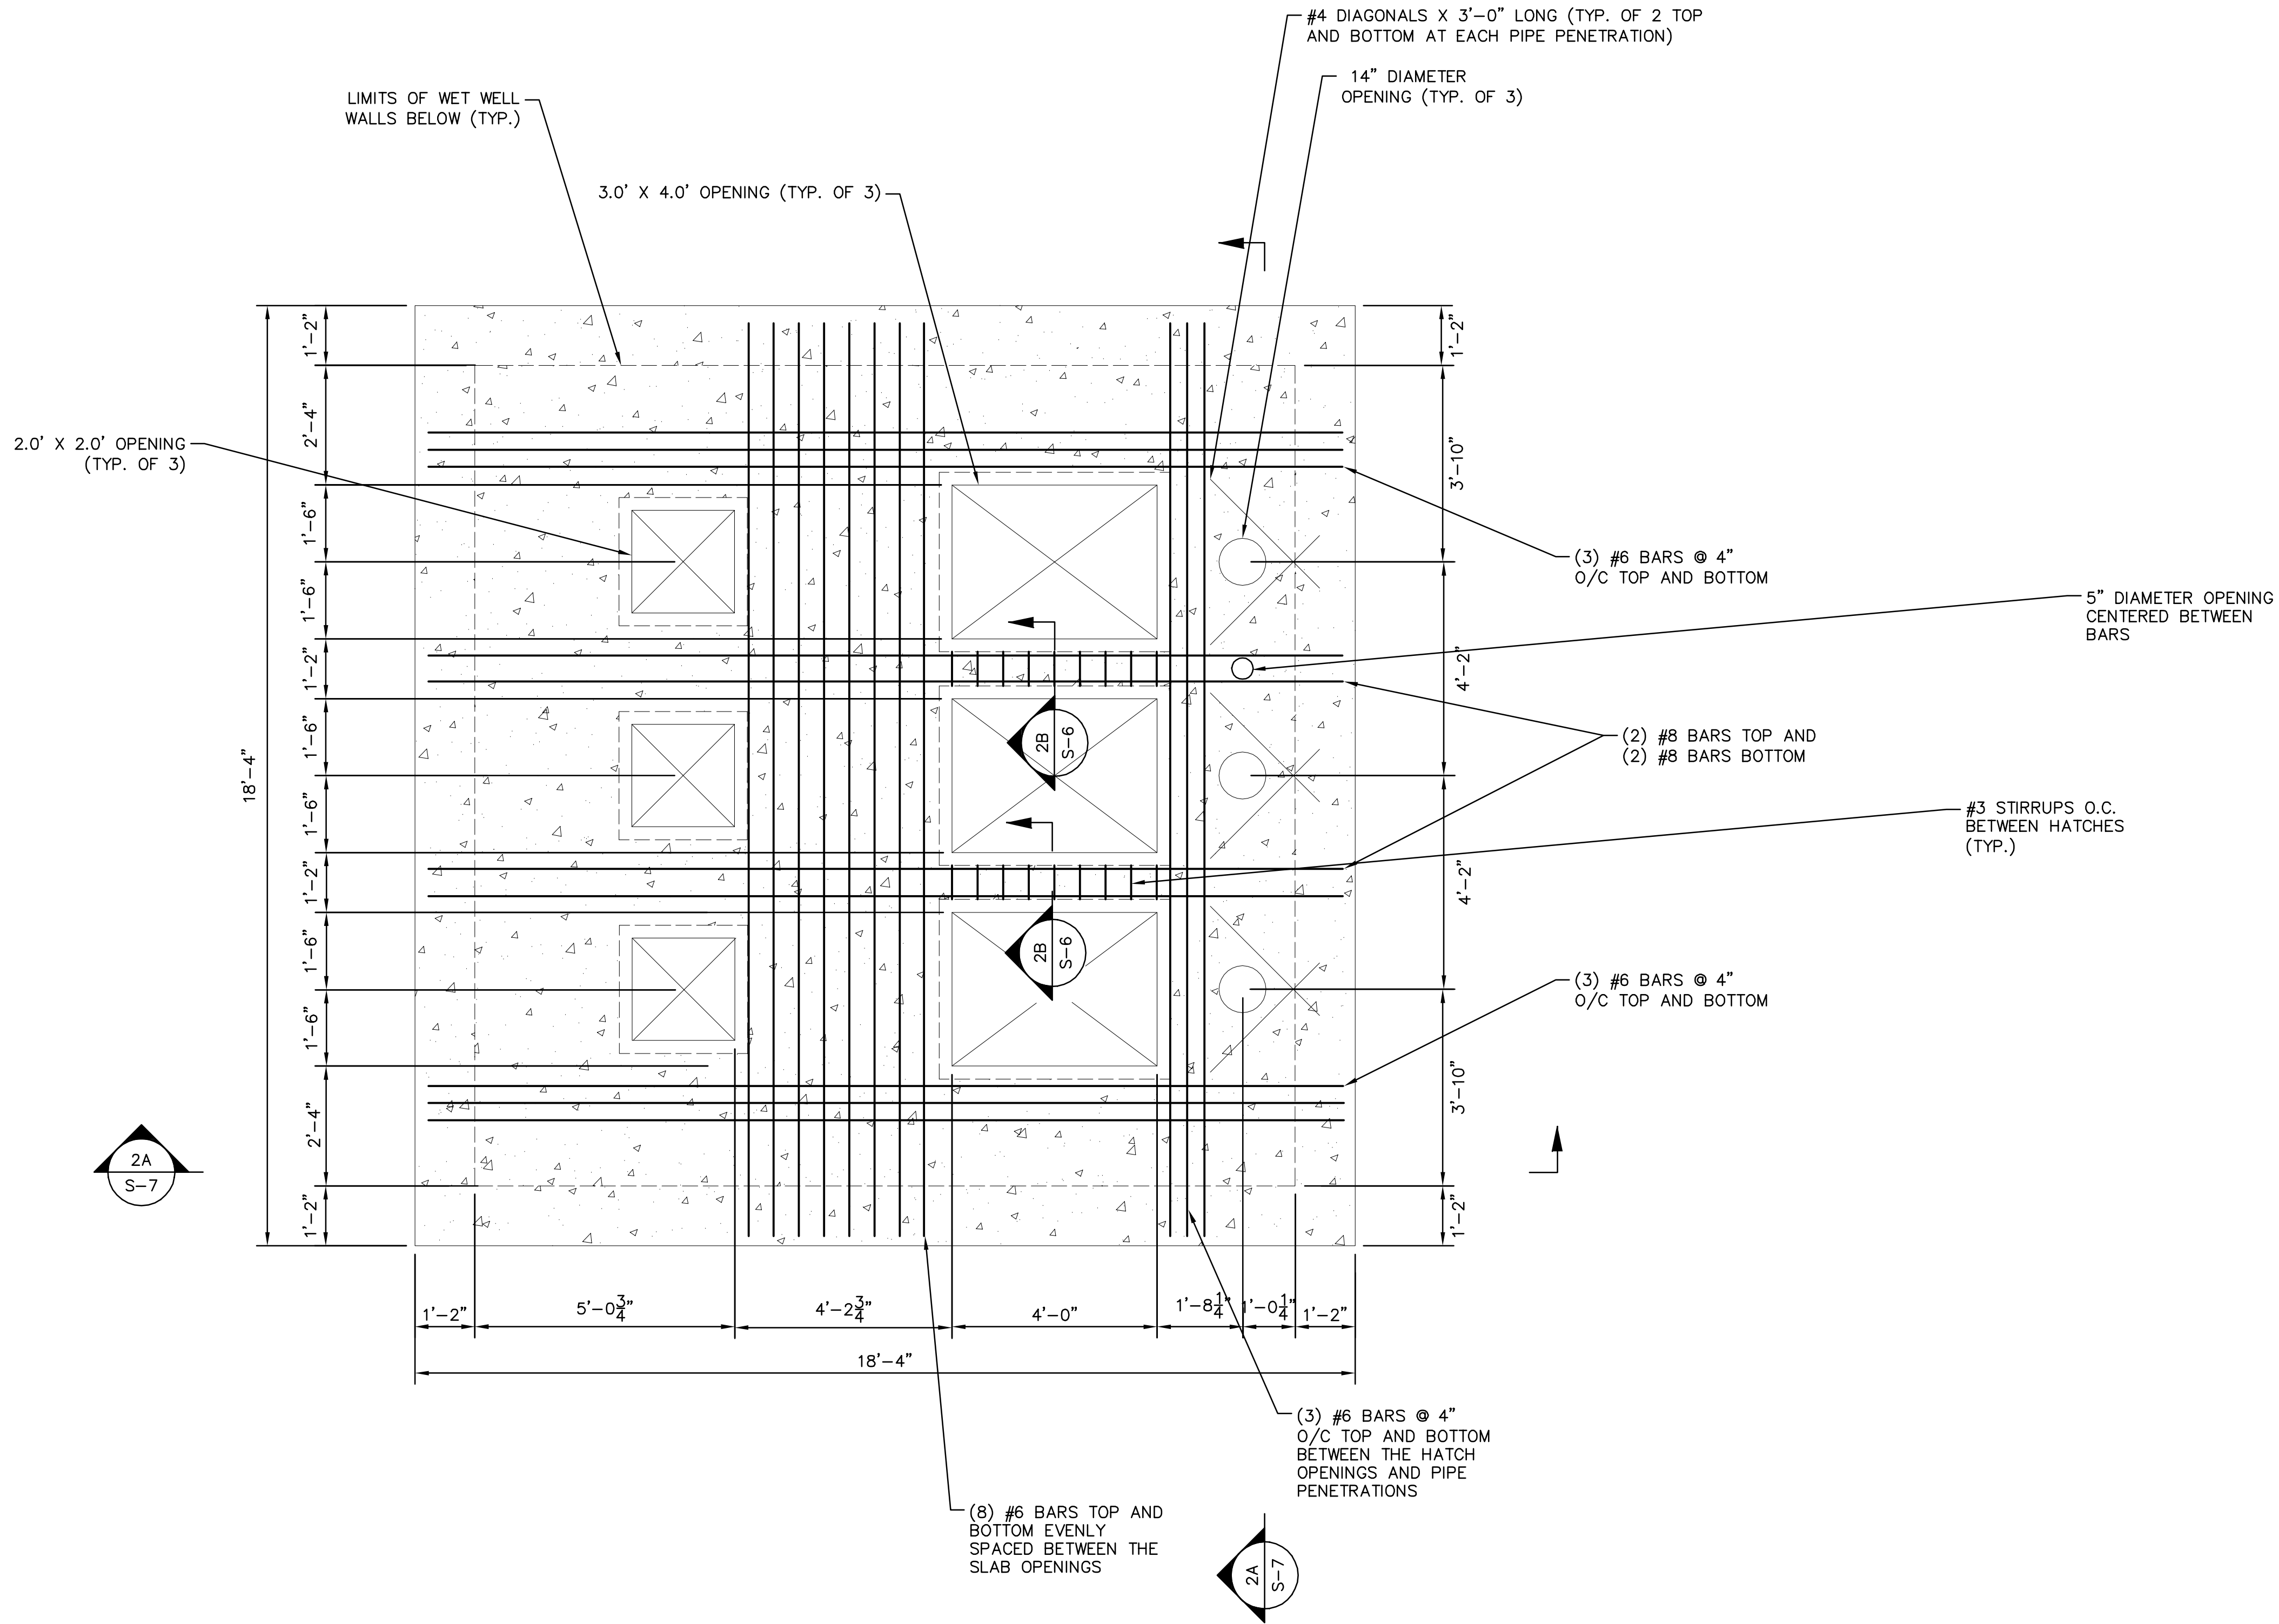- NOTE:
1. MAIN SLAB REINFORCEMENT NOT SHOWN FOR CLARITY. SEE TYPICAL WETWELL SECTION FOR TYPICAL SLAB REINFORCEMENT.

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KHA PROJECT	148400067
DATE	FEB 2022
SCALE	AS SHOWN
DESIGNED BY	SES
DRAWN BY	GMB
CHECKED BY	SNR



**BAYSHORE YACHT BASIN FORCE MAIN  
AND LIFT STATION REPLACEMENT**

MANATEE COUNTY

LICENSED PROFESSIONAL

SETH E SCHMID, P.E.

54640

DATE:


WETWELL TOP SLAB PLAN

SHEET NUMBER


S-5



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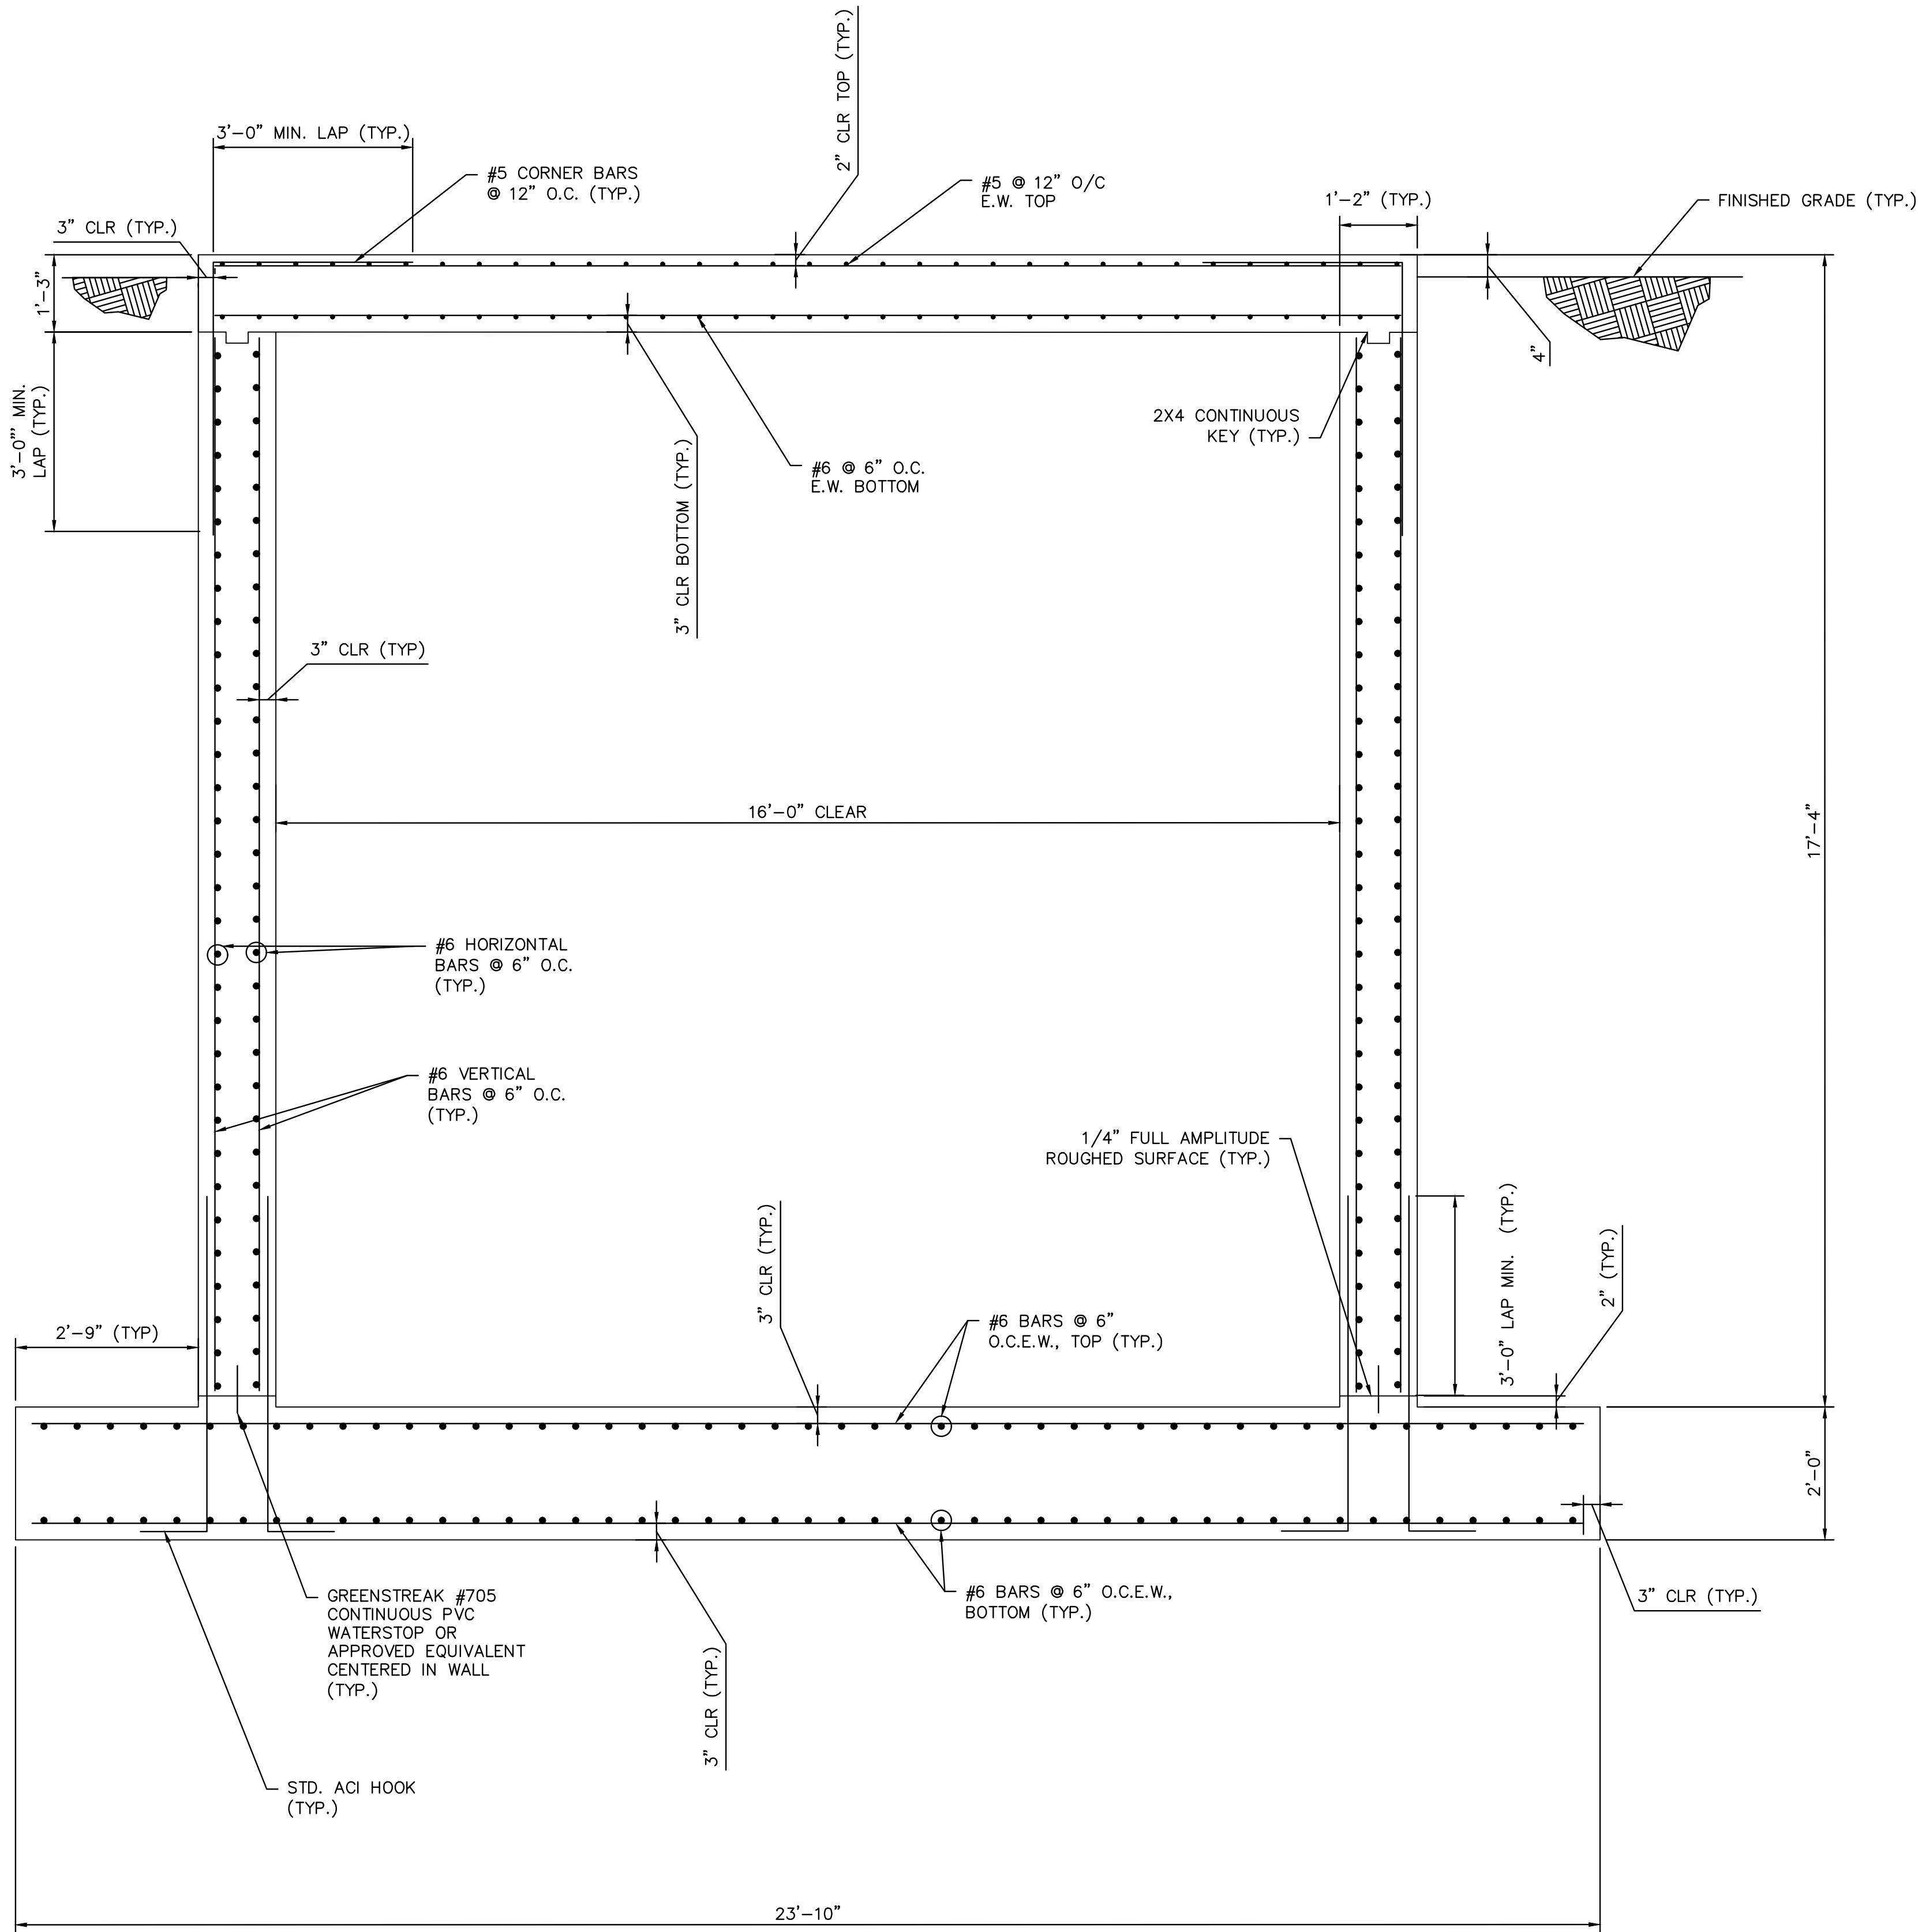


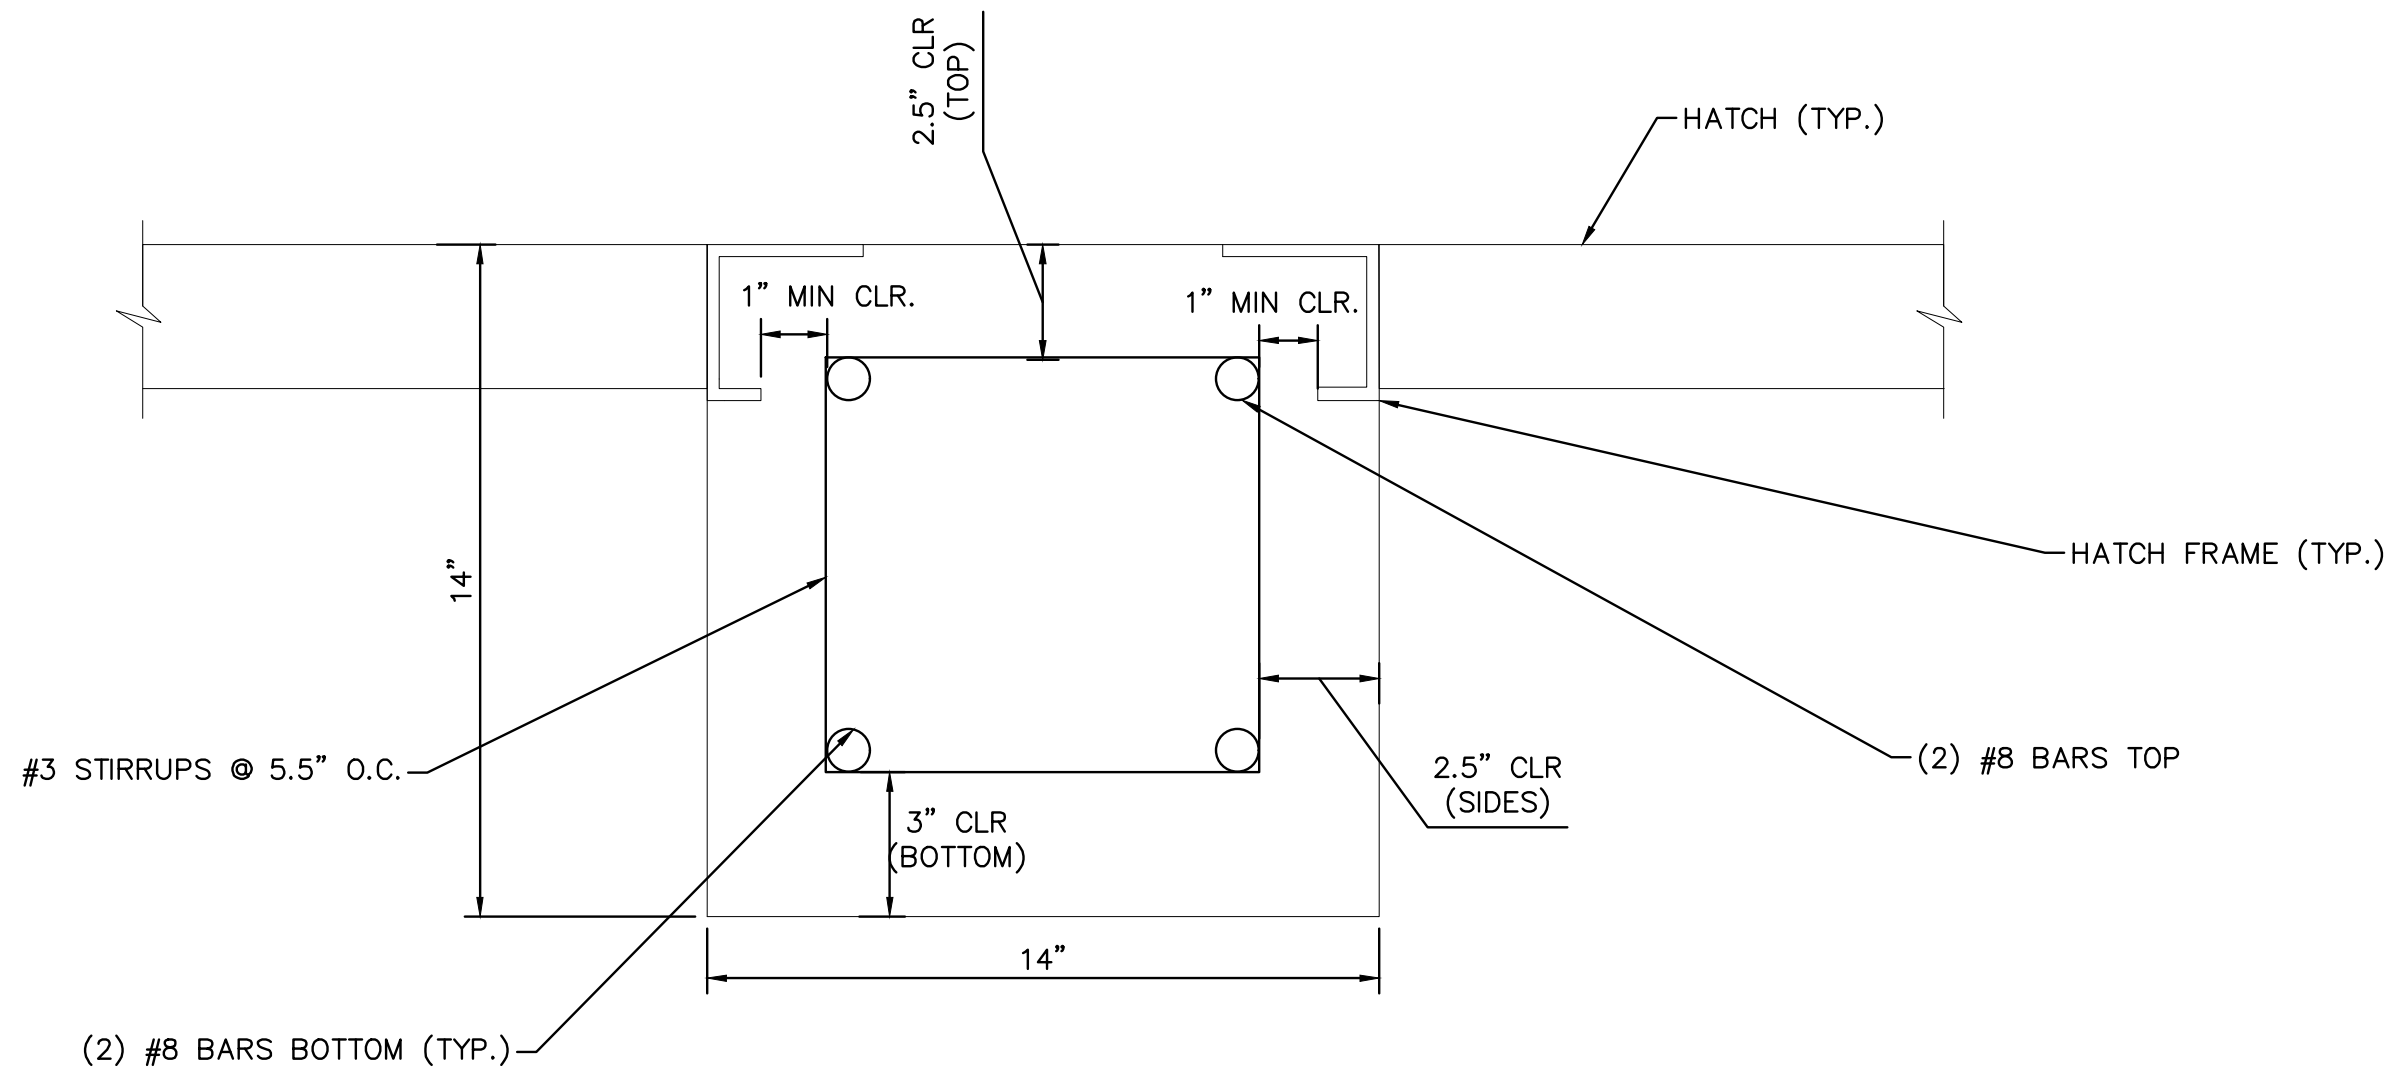2B WETWELL SECTION BETWEEN HATCH OPENINGS  
S-5 SCALE: NTS

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No.	REVISIONS	DATE	BY						



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2A WETWELL SECTION  
S-7 SCALE: N.T.S.

- NOTES:
1. ADDITIONAL TOP SLAB REINFORCEMENT NOT SHOWN FOR CLARITY. SEE WET WELL TOP SLAB PLAN SHEET S-5.
  2. PIPE PENETRATIONS NOT SHOWN FOR CLARITY. SEE MECHANICAL SHEETS FOR ALL PIPE PENETRATION INSTALLATION DETAILS.
  3. FOR DETAILS AND ADDITIONAL REINFORCING NOT SHOWN, INCLUDING WALL OPENINGS AND TYPICAL WALL CORNER REINFORCEMENT, SEE DETAILS, SHEET S-8.
  4. ADDITIONAL VERTICAL REINFORCEMENT EITHER SIDE OF WALL OPENINGS SHALL EXTEND TO BASE OF WALL AND LAP ADDITIONAL WALL DOWELS ON EITHER SIDE OF OPENING. WALL DOWELS SHALL BE DEVELOPED IN THE FOUNDATION WITH STD ACI HOOKS.

No.	REVISIONS	DATE	BY

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148400067

DATE  
FEB 2022

SCALE AS SHOWN

DESIGNED BY SES

DRAWN BY GMB

CHECKED BY SNR



**BAYSHORE YACHT BASIN FORCE MAIN  
AND LIFT STATION REPLACEMENT**

MANATEE COUNTY

LICENSED PROFESSIONAL

SETH E SCHMID, P.E.

54640

DATE:


WETWELL SECTION

SHEET NUMBER

S-7




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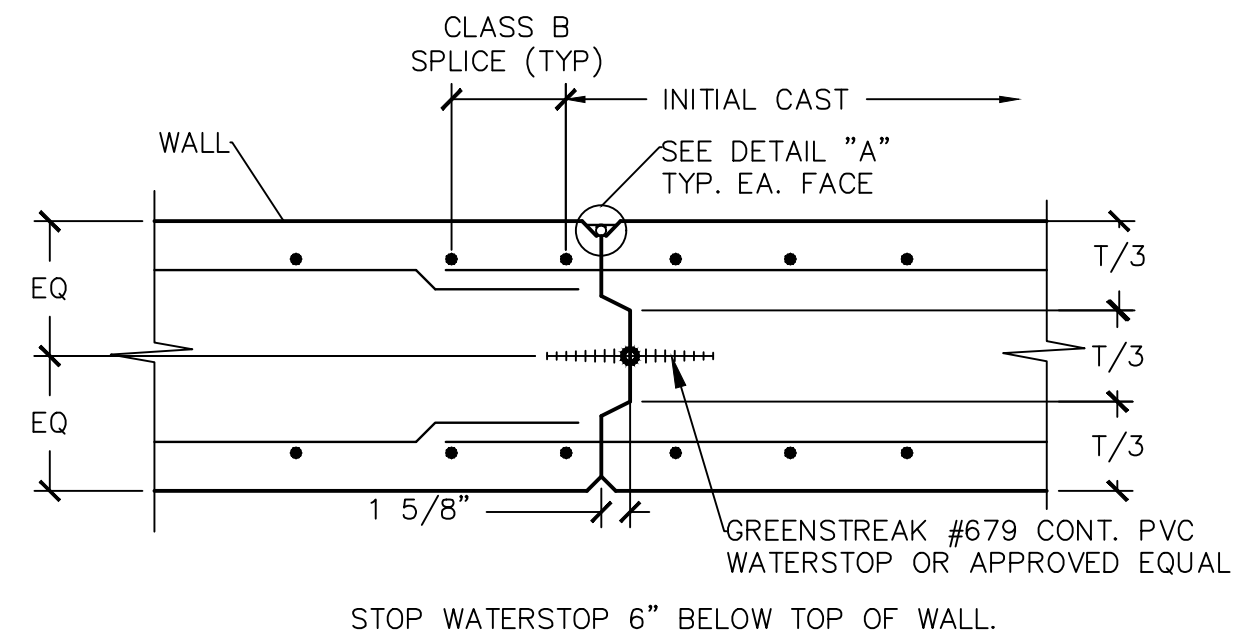
- NOTE:
1. REFER TO STRUCTURE PLANS FOR WALL AND SLAB THICKNESSES AND REINFORCING

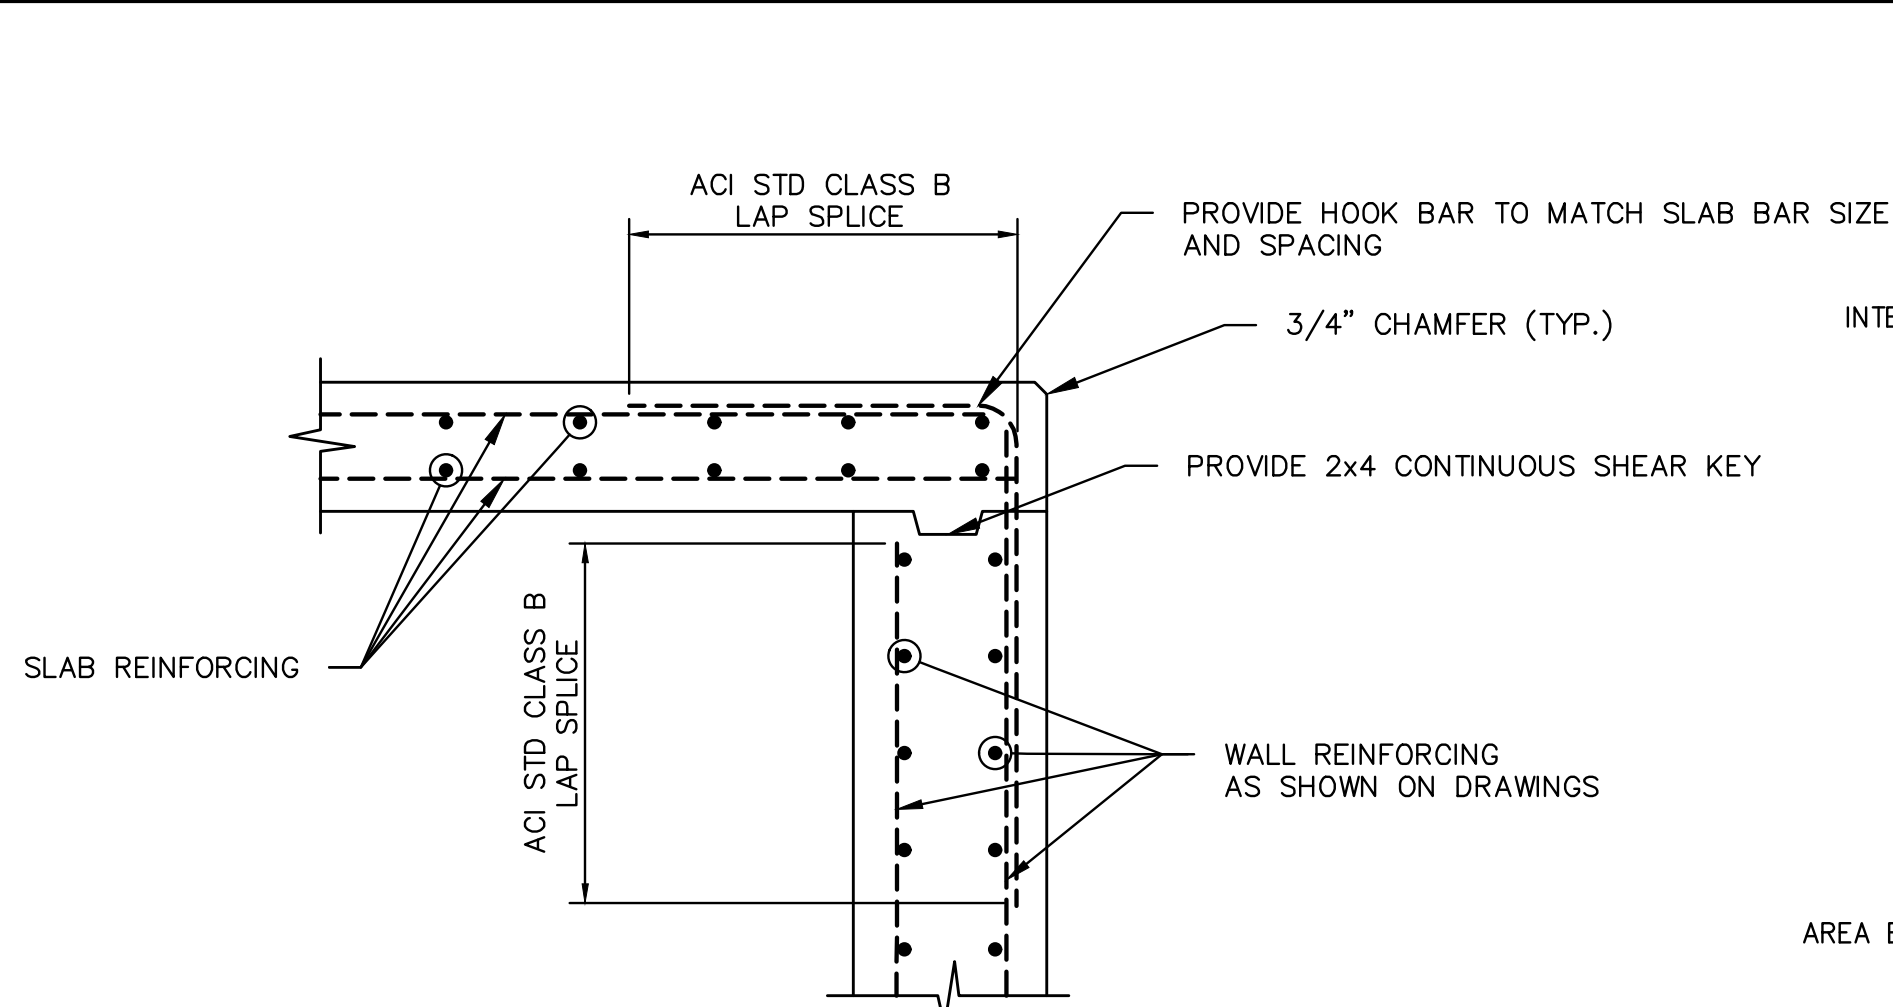1 SLAB TO WALL CONNECTION DETAIL  
SCALE: NTS




- NOTE:
1. WHERE INTEGRAL BEAMS OR DROP DOWN BEAMS ARE ADJACENT TO OPENING, ADDITIONAL REINFORCING IS NOT REQUIRED.
  2. PROVIDE 3" CLEAR AROUND OPENINGS, UNLESS NOTED OTHERWISE.
  3. ADDITIONAL VERTICAL REINFORCING SHALL BE DEVELOPED IN FOOTING WITH STD ACI HOOKS

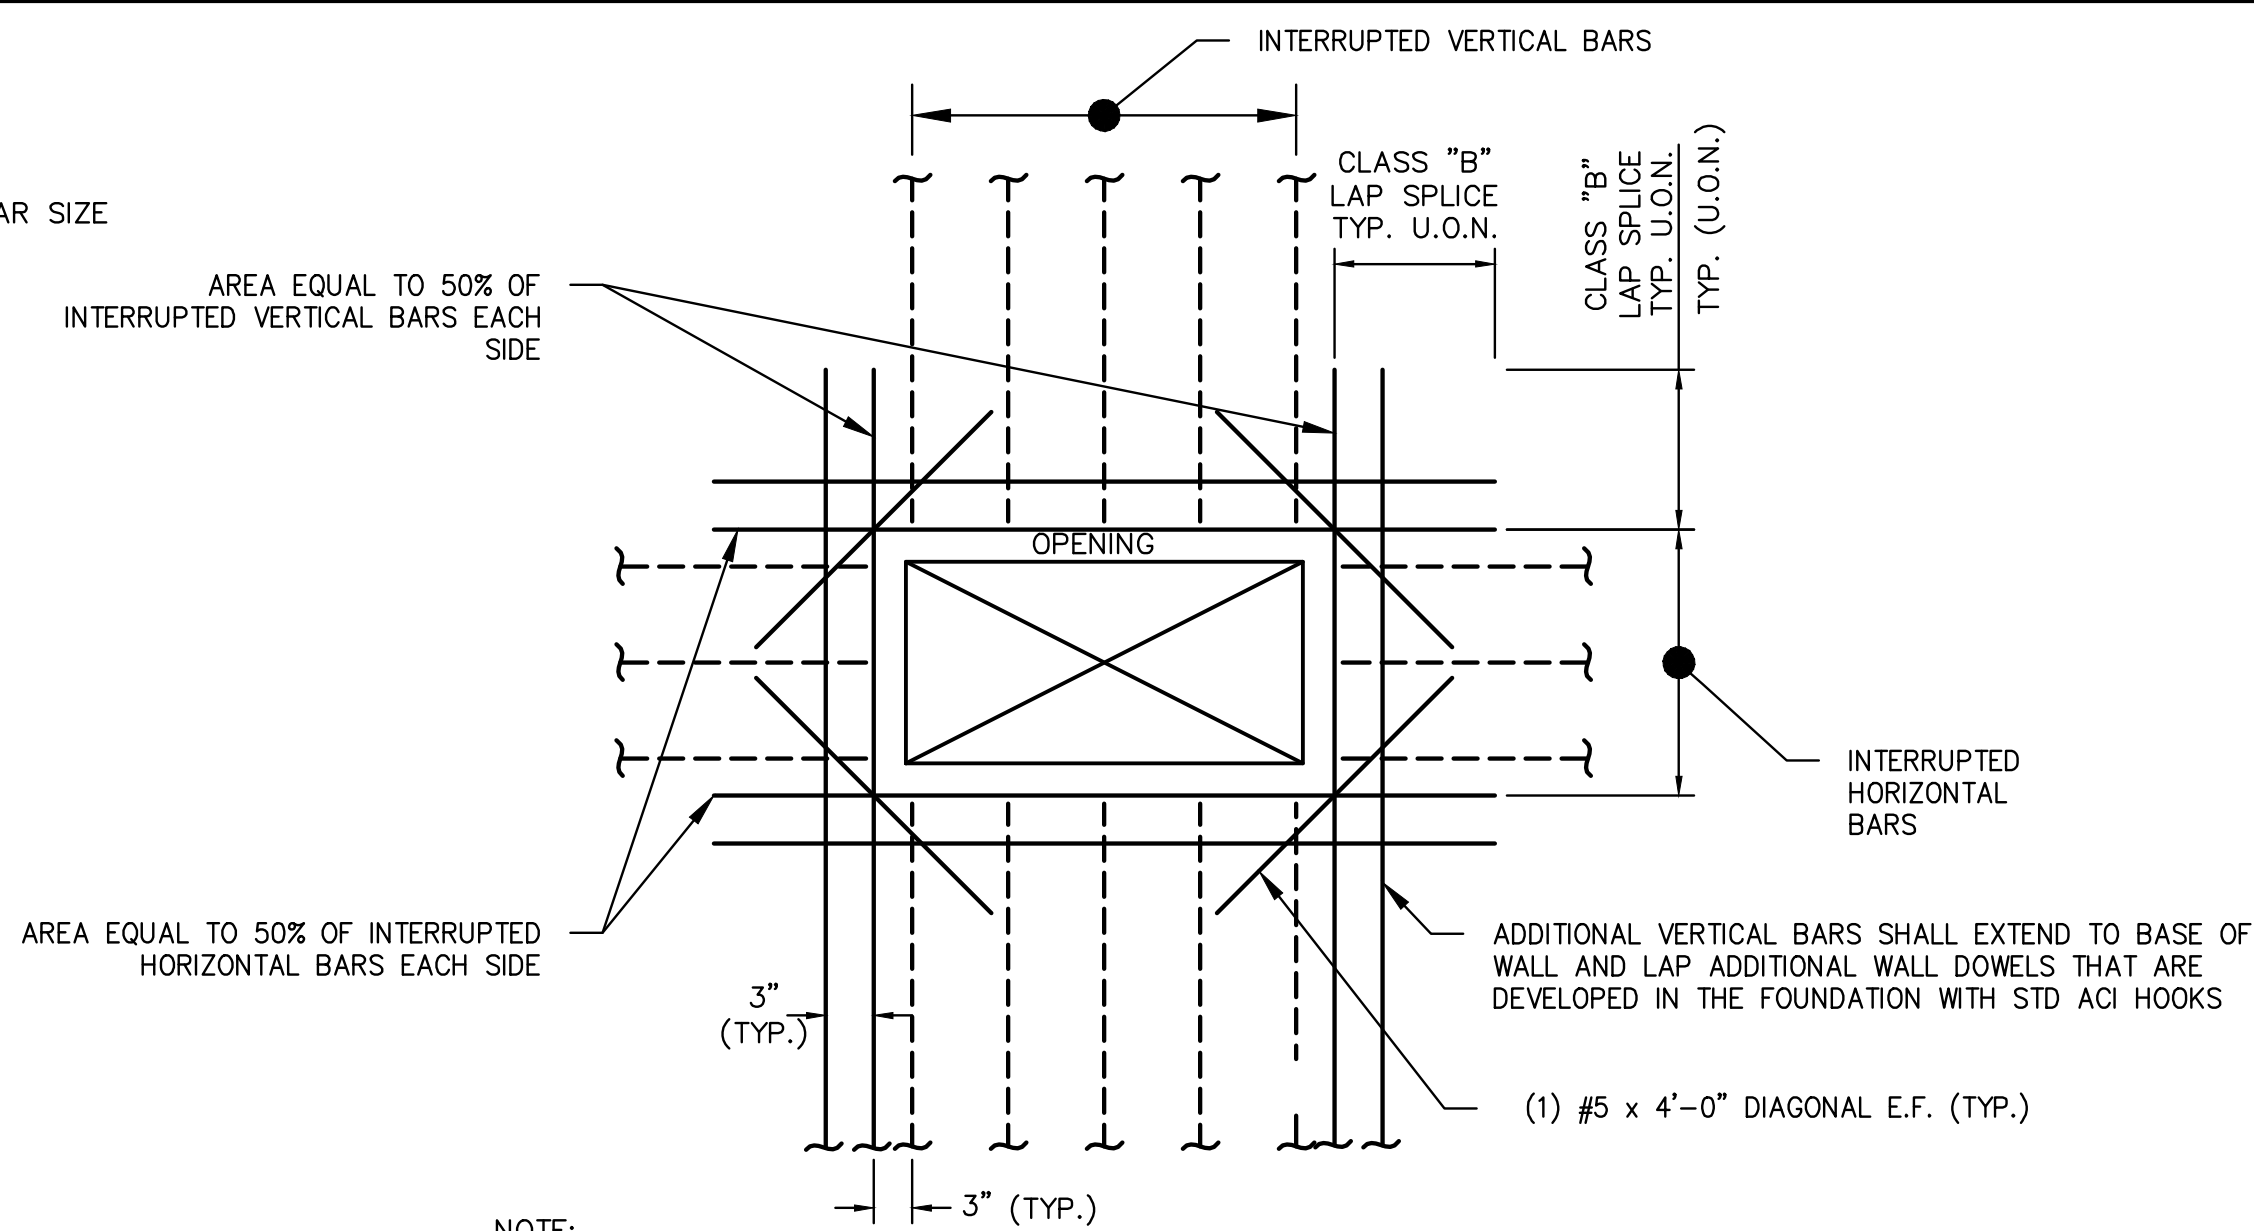3 TYPICAL RECTANGULAR OPENING REINFORCING DETAIL  
SCALE: NTS




- NOTE:
1. CONTRACTOR SUBMIT LOCATION IF NOT SPECIFIED
  2. DO NOT LOCATE VERTICAL CONSTRUCTION JOINTS WITHIN 10' OF WET WELL CORNERS
  3. CONSTRUCTION JOINT DETAIL FOR HORIZONTAL OR VERTICAL APPLICATION

5 WALL CONSTRUCTION JOINT DETAIL  
SCALE: NTS

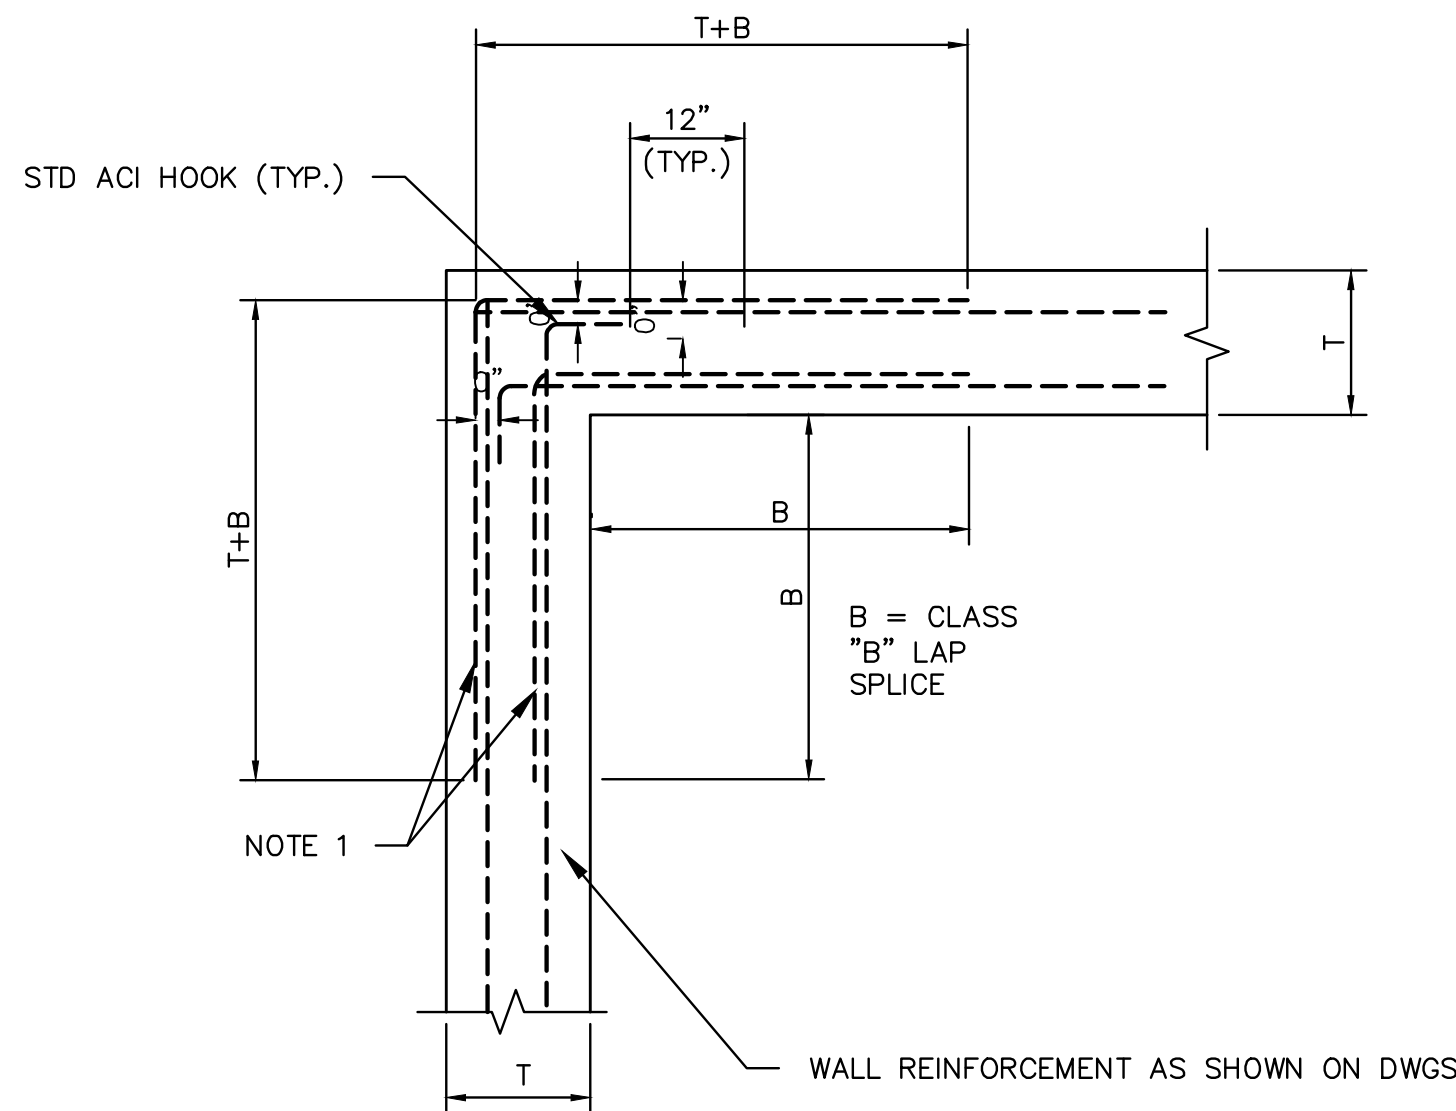


- NOTE:
1. HORIZONTAL CORNER BARS SHALL MATCH SIZE AND SPACING OF HORIZONTAL BARS

2 TYPICAL CORNER REINFORCING DETAIL  
SCALE: NTS

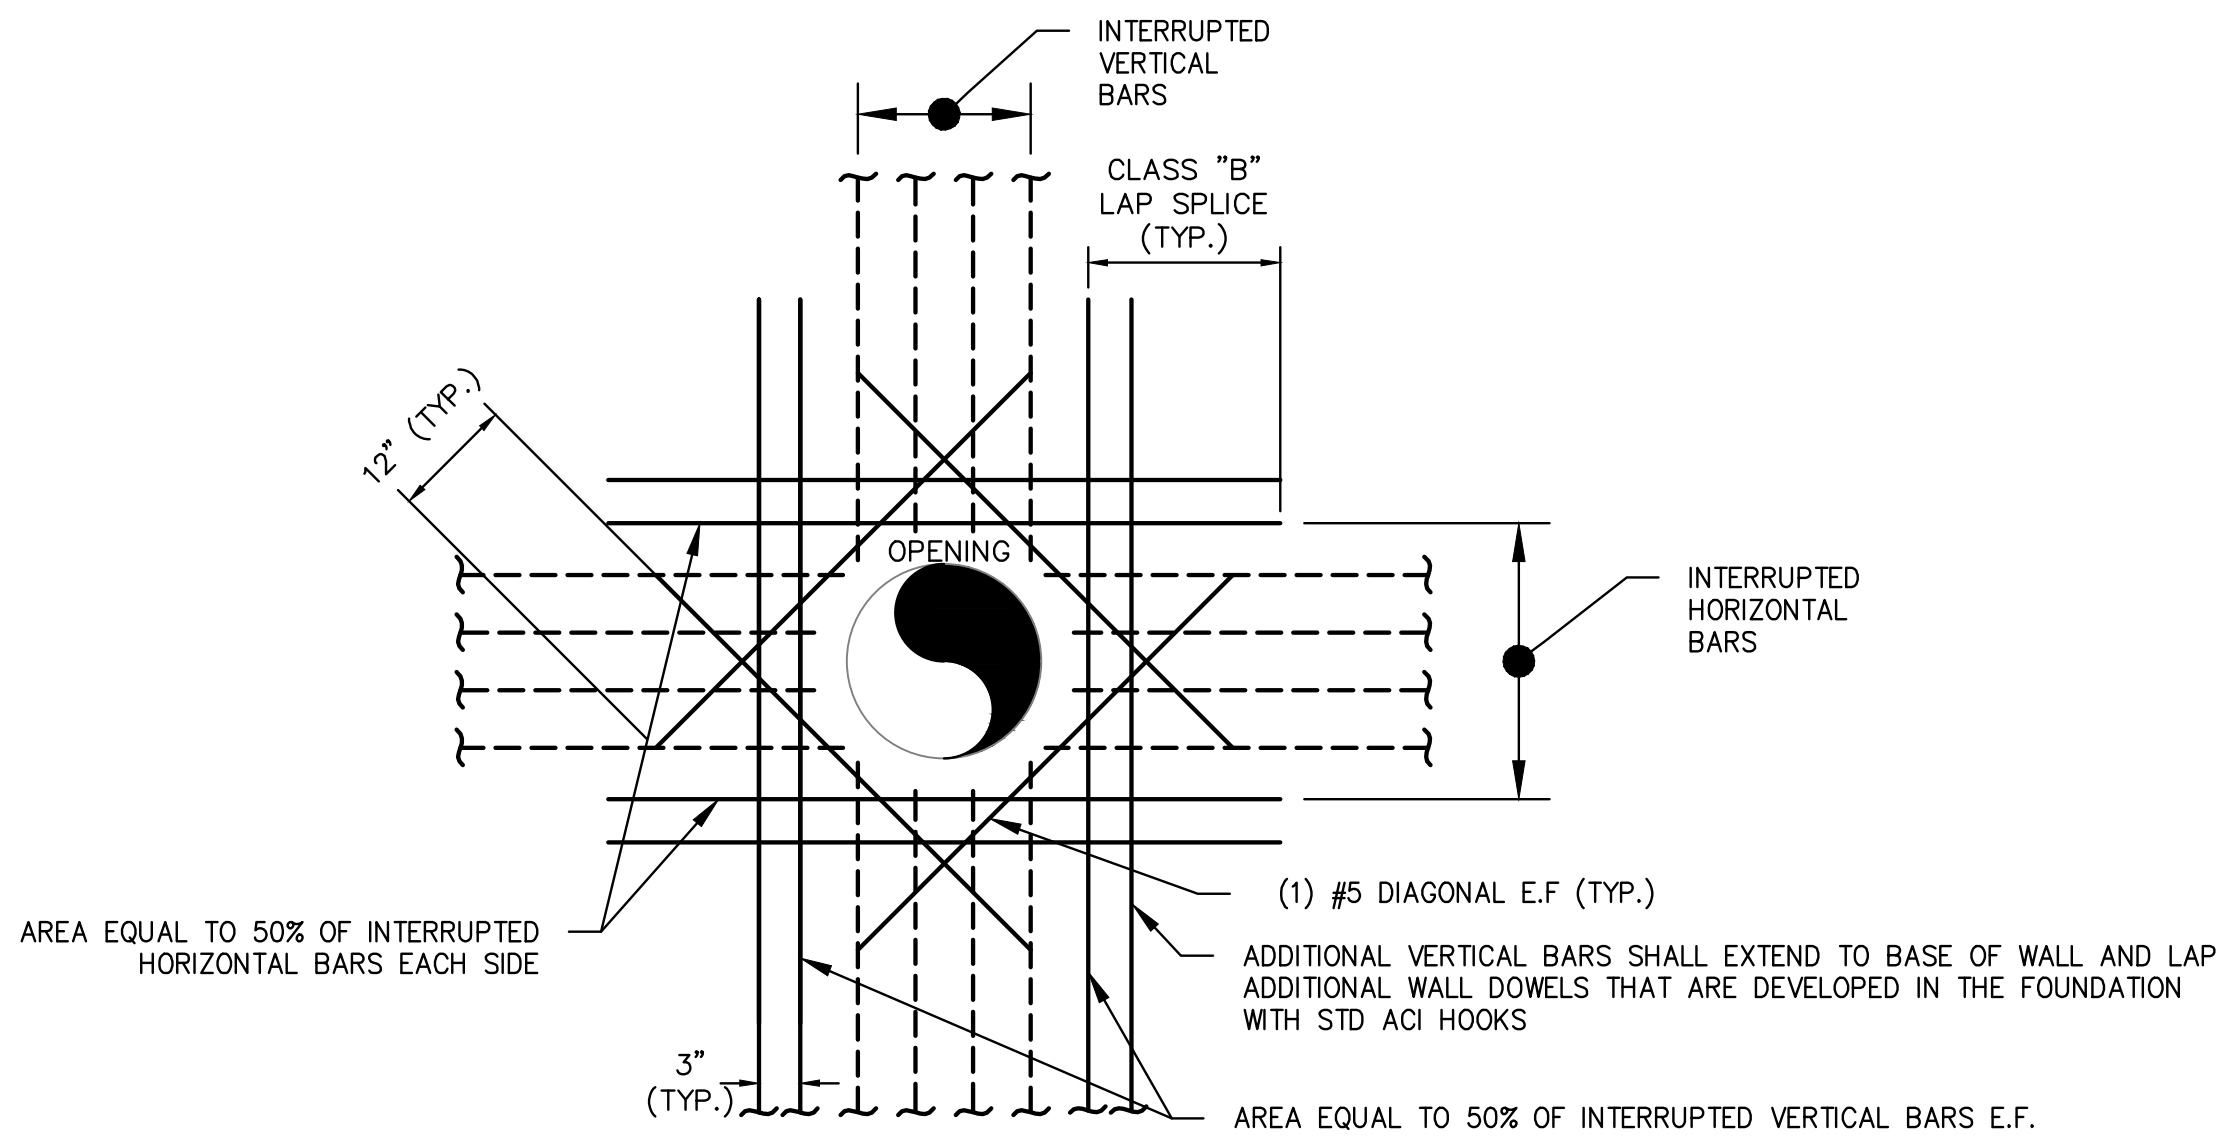

- NOTE:
1. WHERE INTEGRAL BEAMS OR DROP DOWN BEAMS ARE ADJACENT TO OPENING, ADDITIONAL REINFORCING IS NOT REQUIRED.
  2. PROVIDE 3" CLEAR AROUND OPENINGS, UNLESS NOTED OTHERWISE.
  3. ADDITIONAL VERTICAL REINFORCING SHALL BE DEVELOPED IN FOOTING WITH STD ACI HOOKS


4 TYPICAL CIRCULAR OPENING REINFORCING DETAIL  
SCALE: NTS

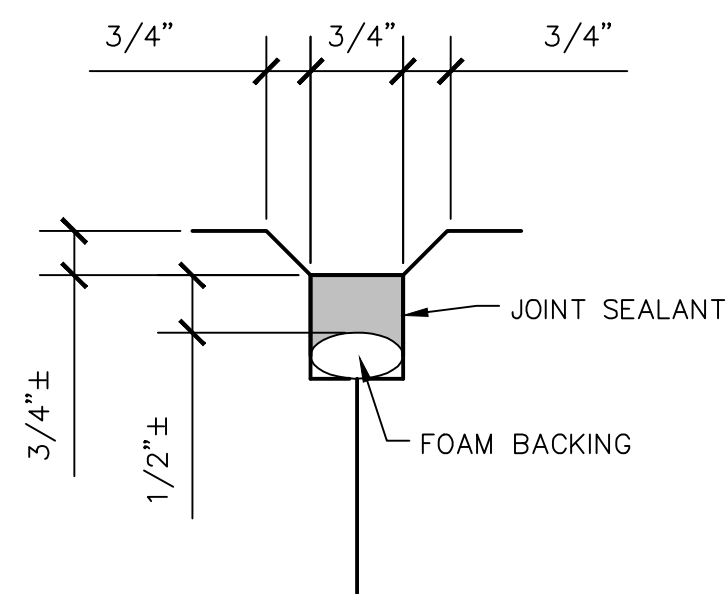

- NOTE:
1. JOINT SEALANT SHALL BE SIKAFLEX - 2C NS EZ MIX OR APPROVED EQUIVALENT. INSTALL PER MANUFACTURERS REQUIREMENTS


6 DETAIL "A" CONTROL/CONSTRUCTION JOINT  
SCALE: NTS

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PHONE: 727-547-3999  
WWW.KIMLEY-HORN.COM    REGISTRY NO. 35106

KHA PROJECT 148400067
DATE FEB 2022
SCALE AS SHOWN
DESIGNED BY SES
DRAWN BY GMB
CHECKED BY SNR



BAYSHORE YACHT BASIN FORCE MAIN  
AND LIFT STATION REPLACEMENT

MANATEE COUNTY


LICENSED PROFESSIONAL
SETH E. SCHMID, P.E.
54640
DATE:

STRUCTURAL WETWELL DETAILS


SHEET NUMBER
S-8




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7  
-  
ODOR CONTROL PAD FOUNDATION PLAN  
SCALE: NTS

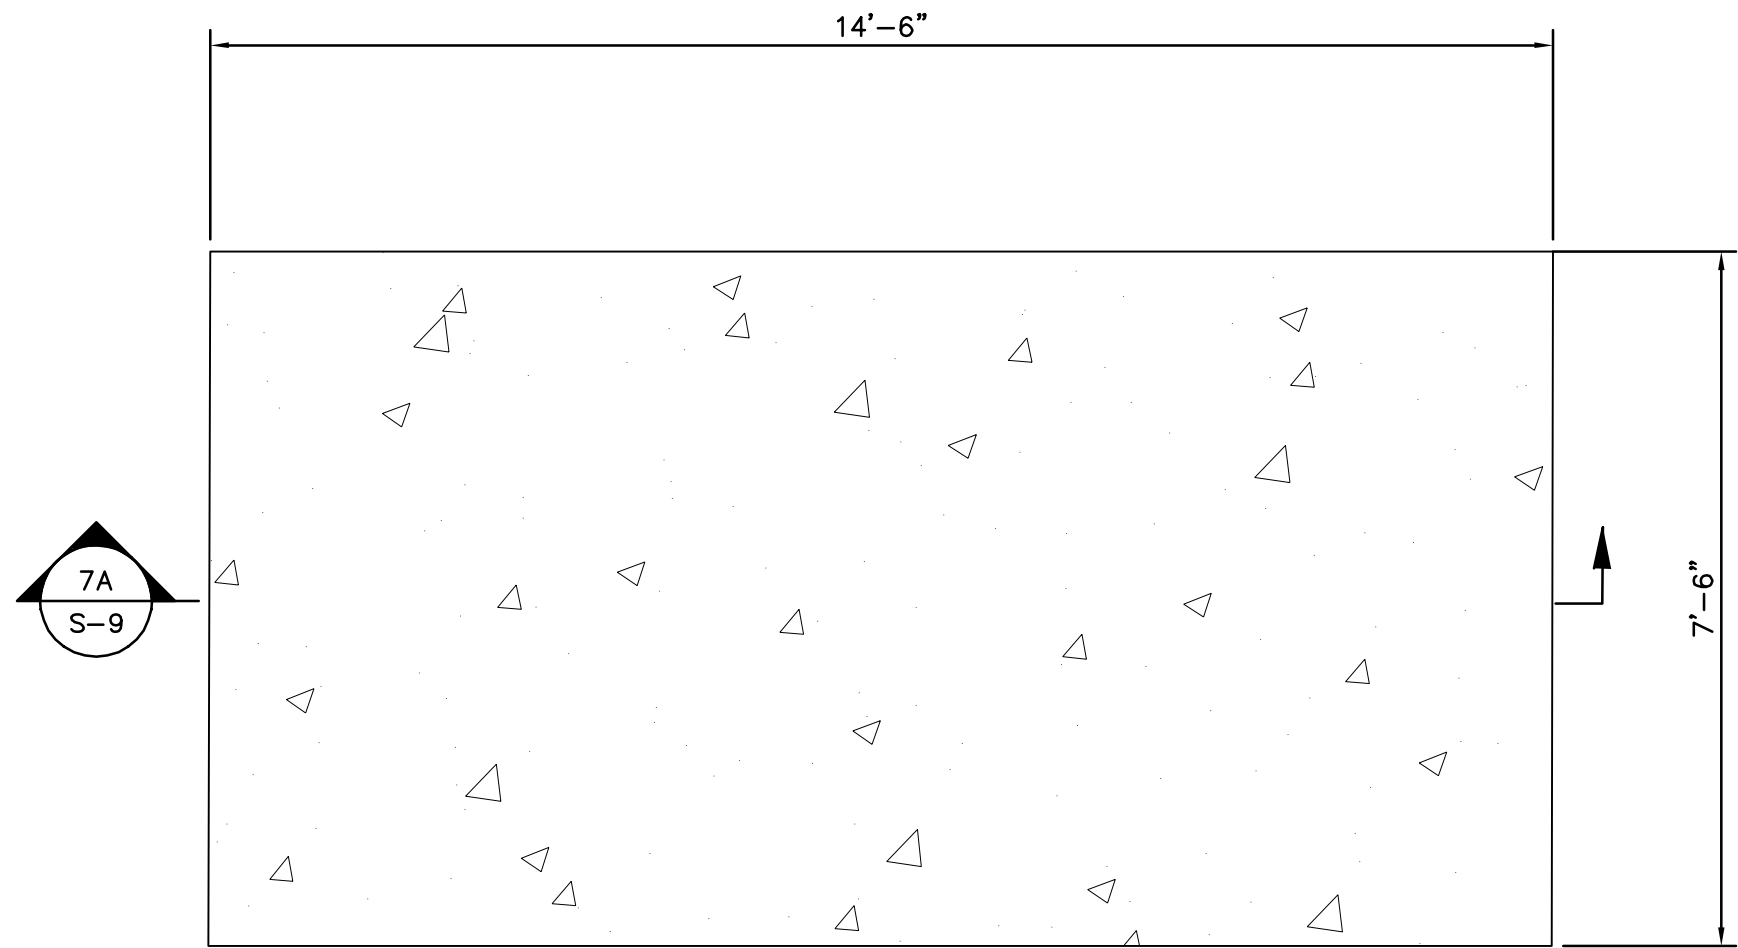


7A  
S-9  
ODOR CONTROL SLAB FOUNDATION SECTION  
SCALE: NTS

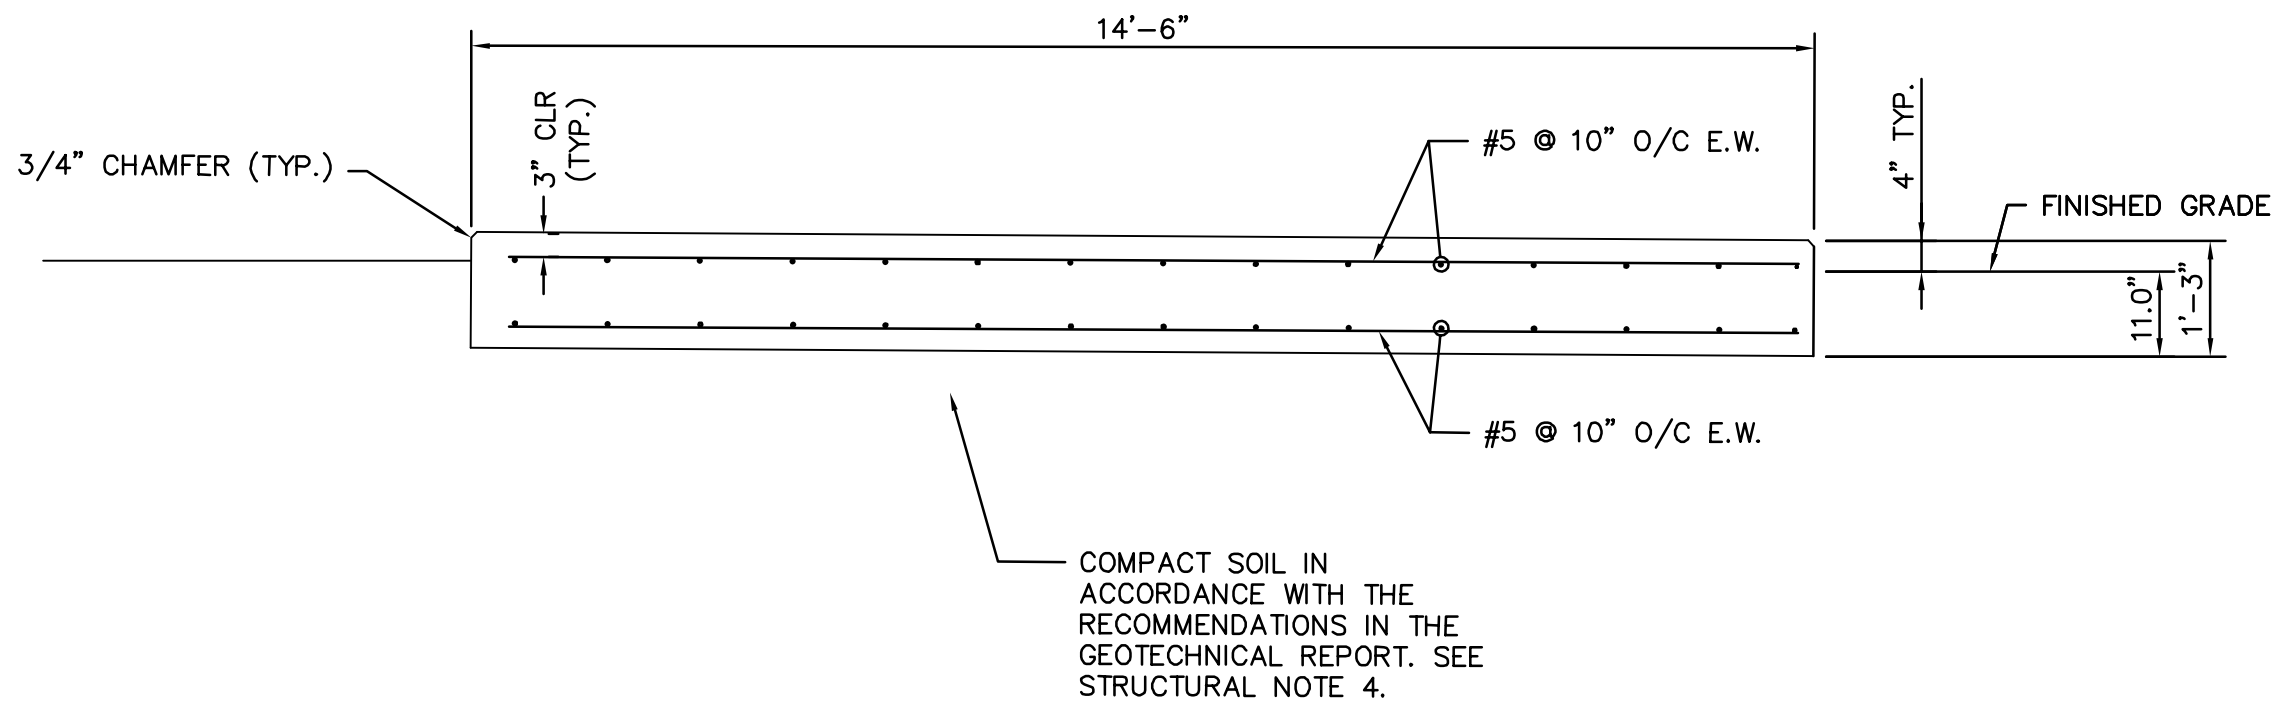

8  
S-9  
MECHANICAL ASSEMBLY SLAB PLAN  
SCALE: NTS

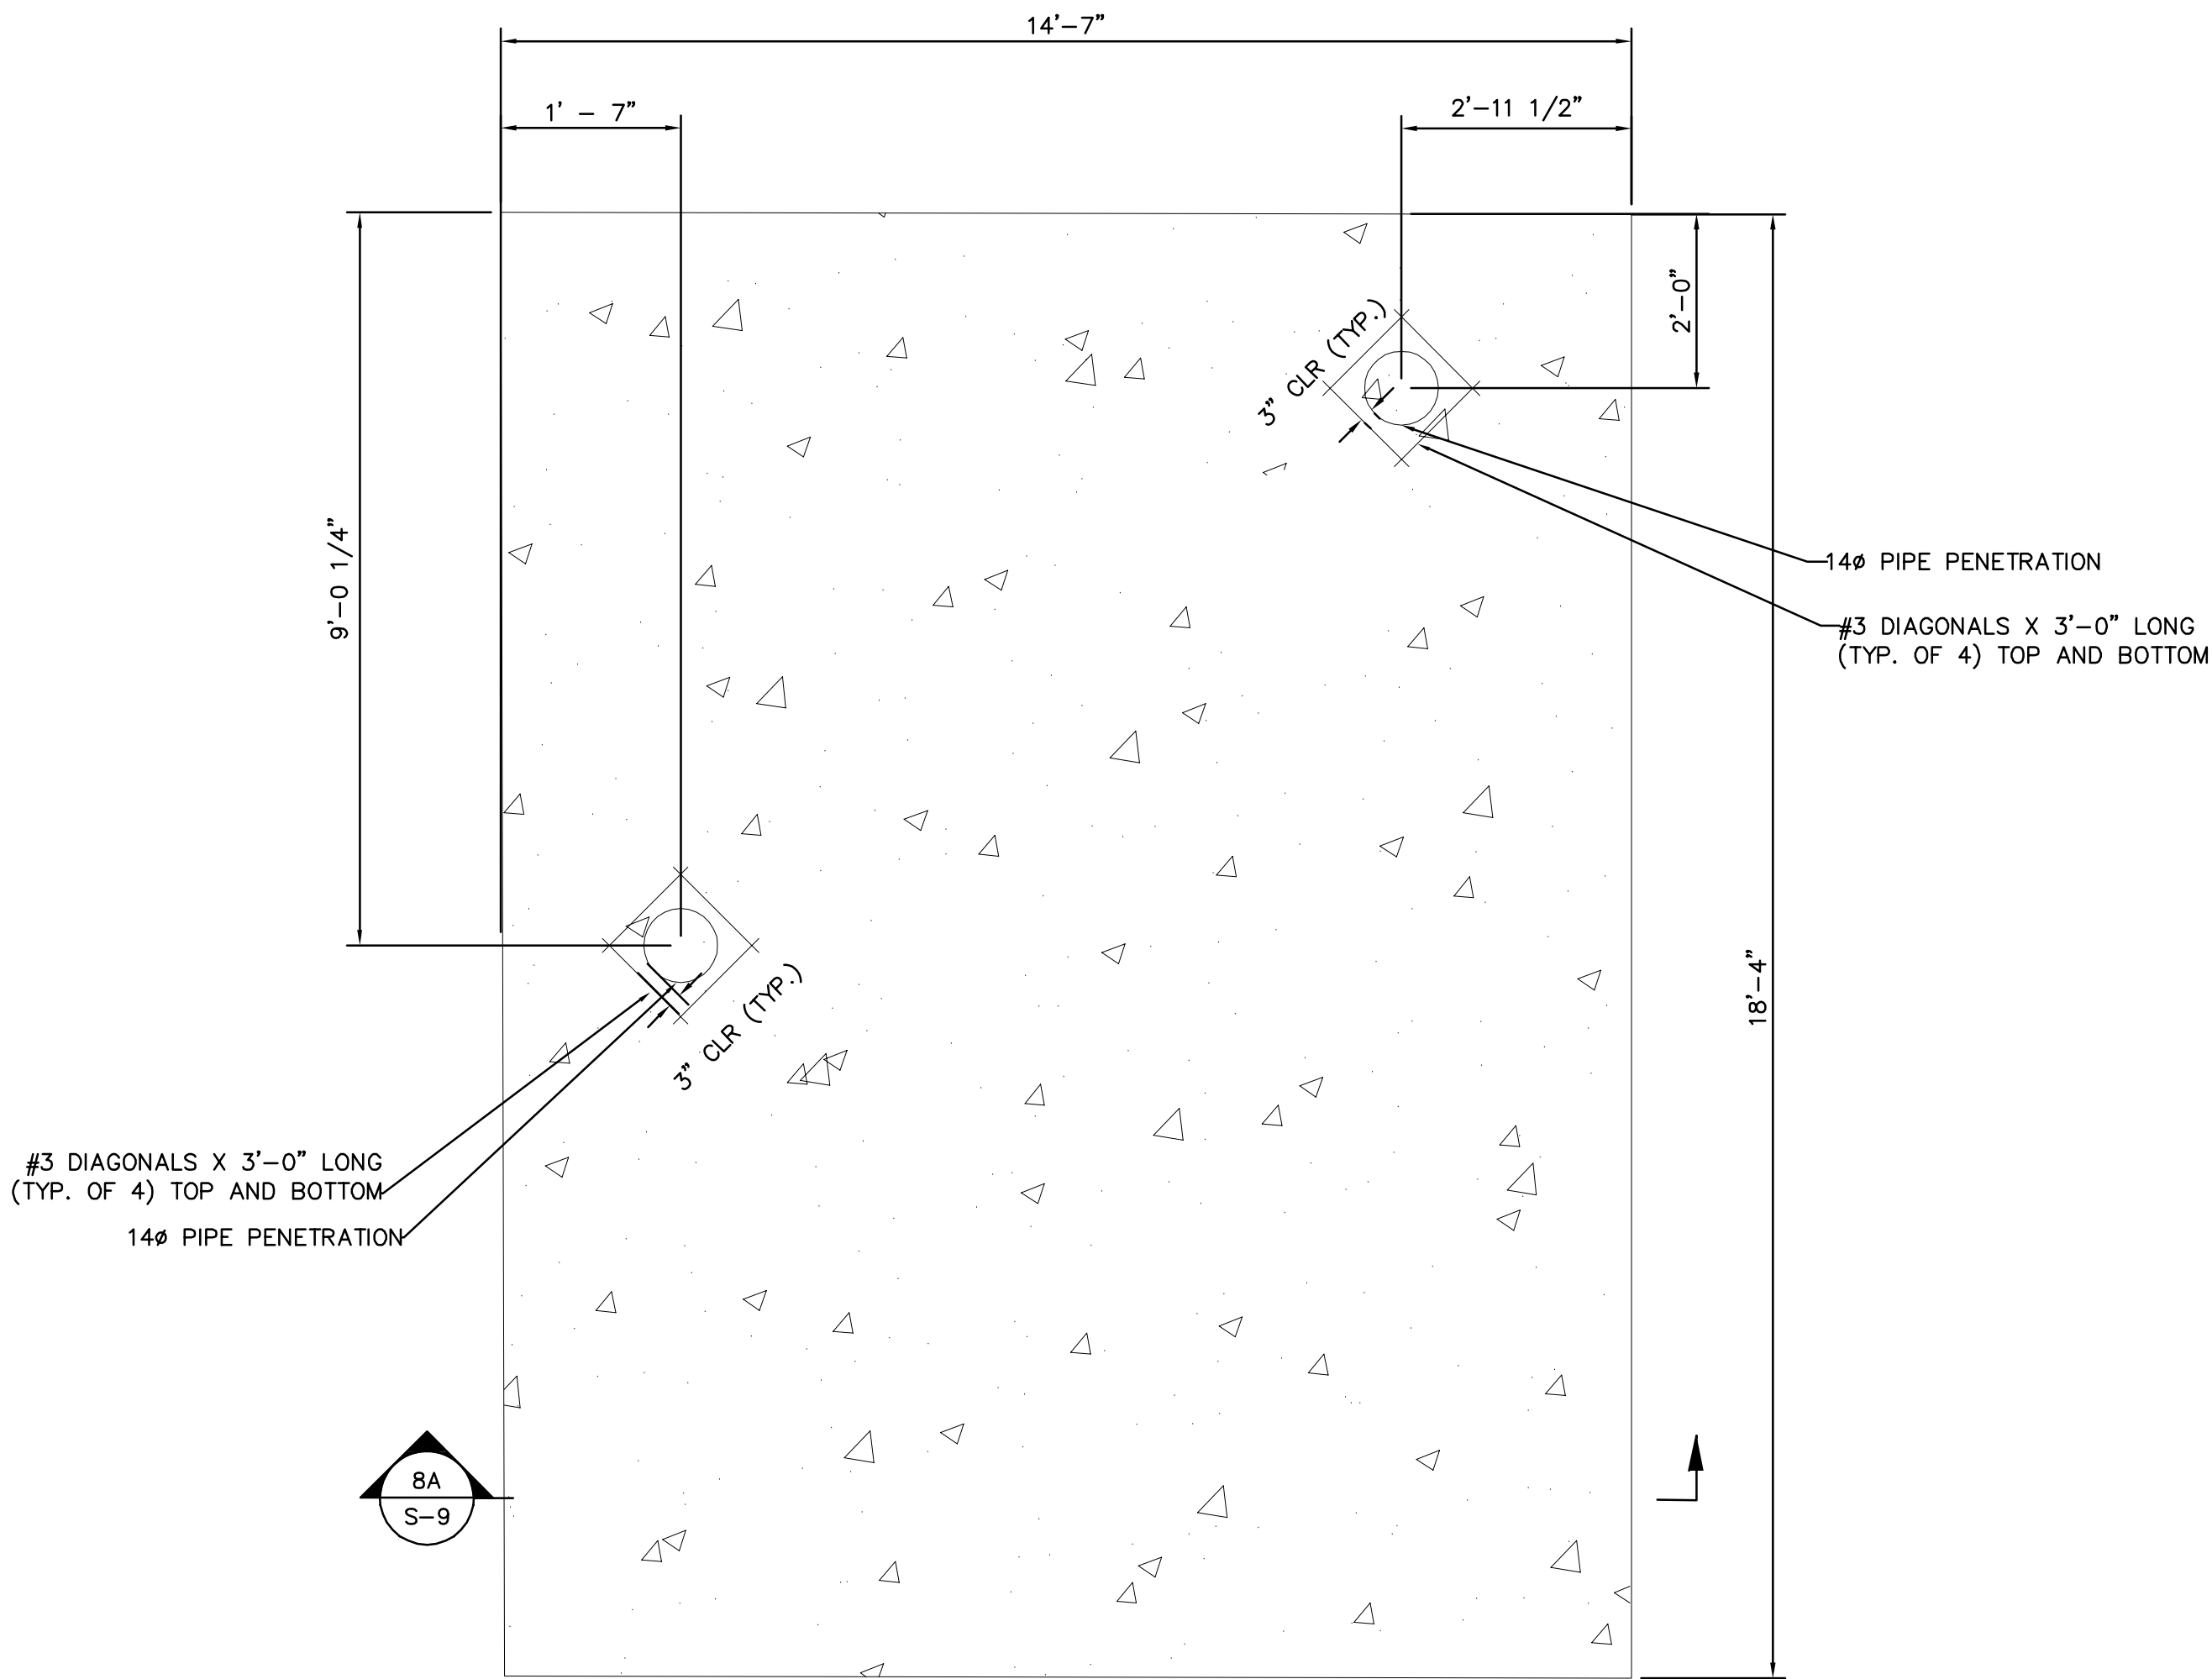NOTE:  
SEE MECHANICAL ASSEMBLY SLAB TYPICAL  
SECTION FOR SLAB REINFORCEMENT

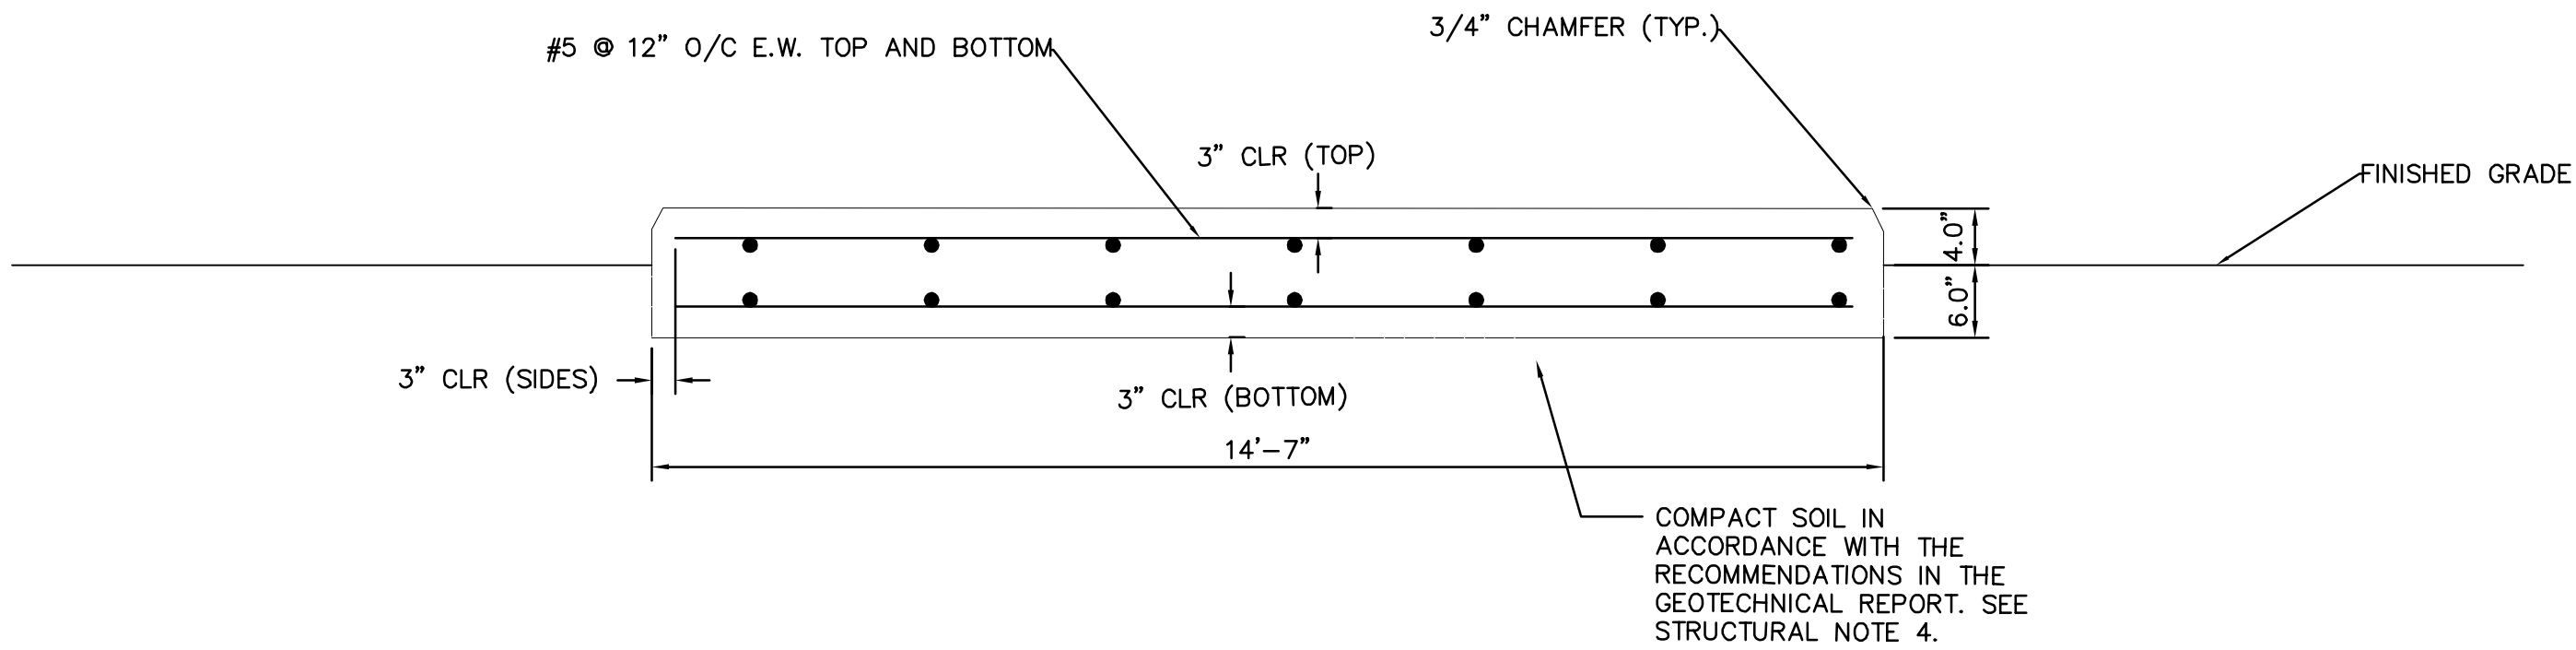

8A  
S-9  
MECHANICAL ASSEMBLY SLAB TYPICAL SECTION  
SCALE: NTS

No.	REVISIONS	DATE	BY

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	DATE FEB 2022
	SCALE    AS SHOWN
	DESIGNED BY    SES
	DRAWN BY    GMB
	CHECKED BY    SNR

 <b>BAYSHORE YACHT BASIN FORCE MAIN AND LIFT STATION REPLACEMENT</b>	LICENSED PROFESSIONAL  SETH E SCHMID, P.E.  54640  DATE:
	MANATEE COUNTY

<b>VALVE ASSEMBLY AND ODOR CONTROL SLABS</b>
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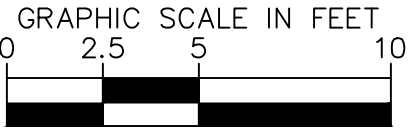
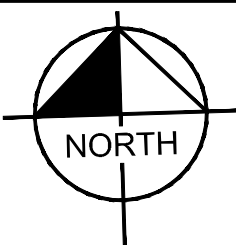
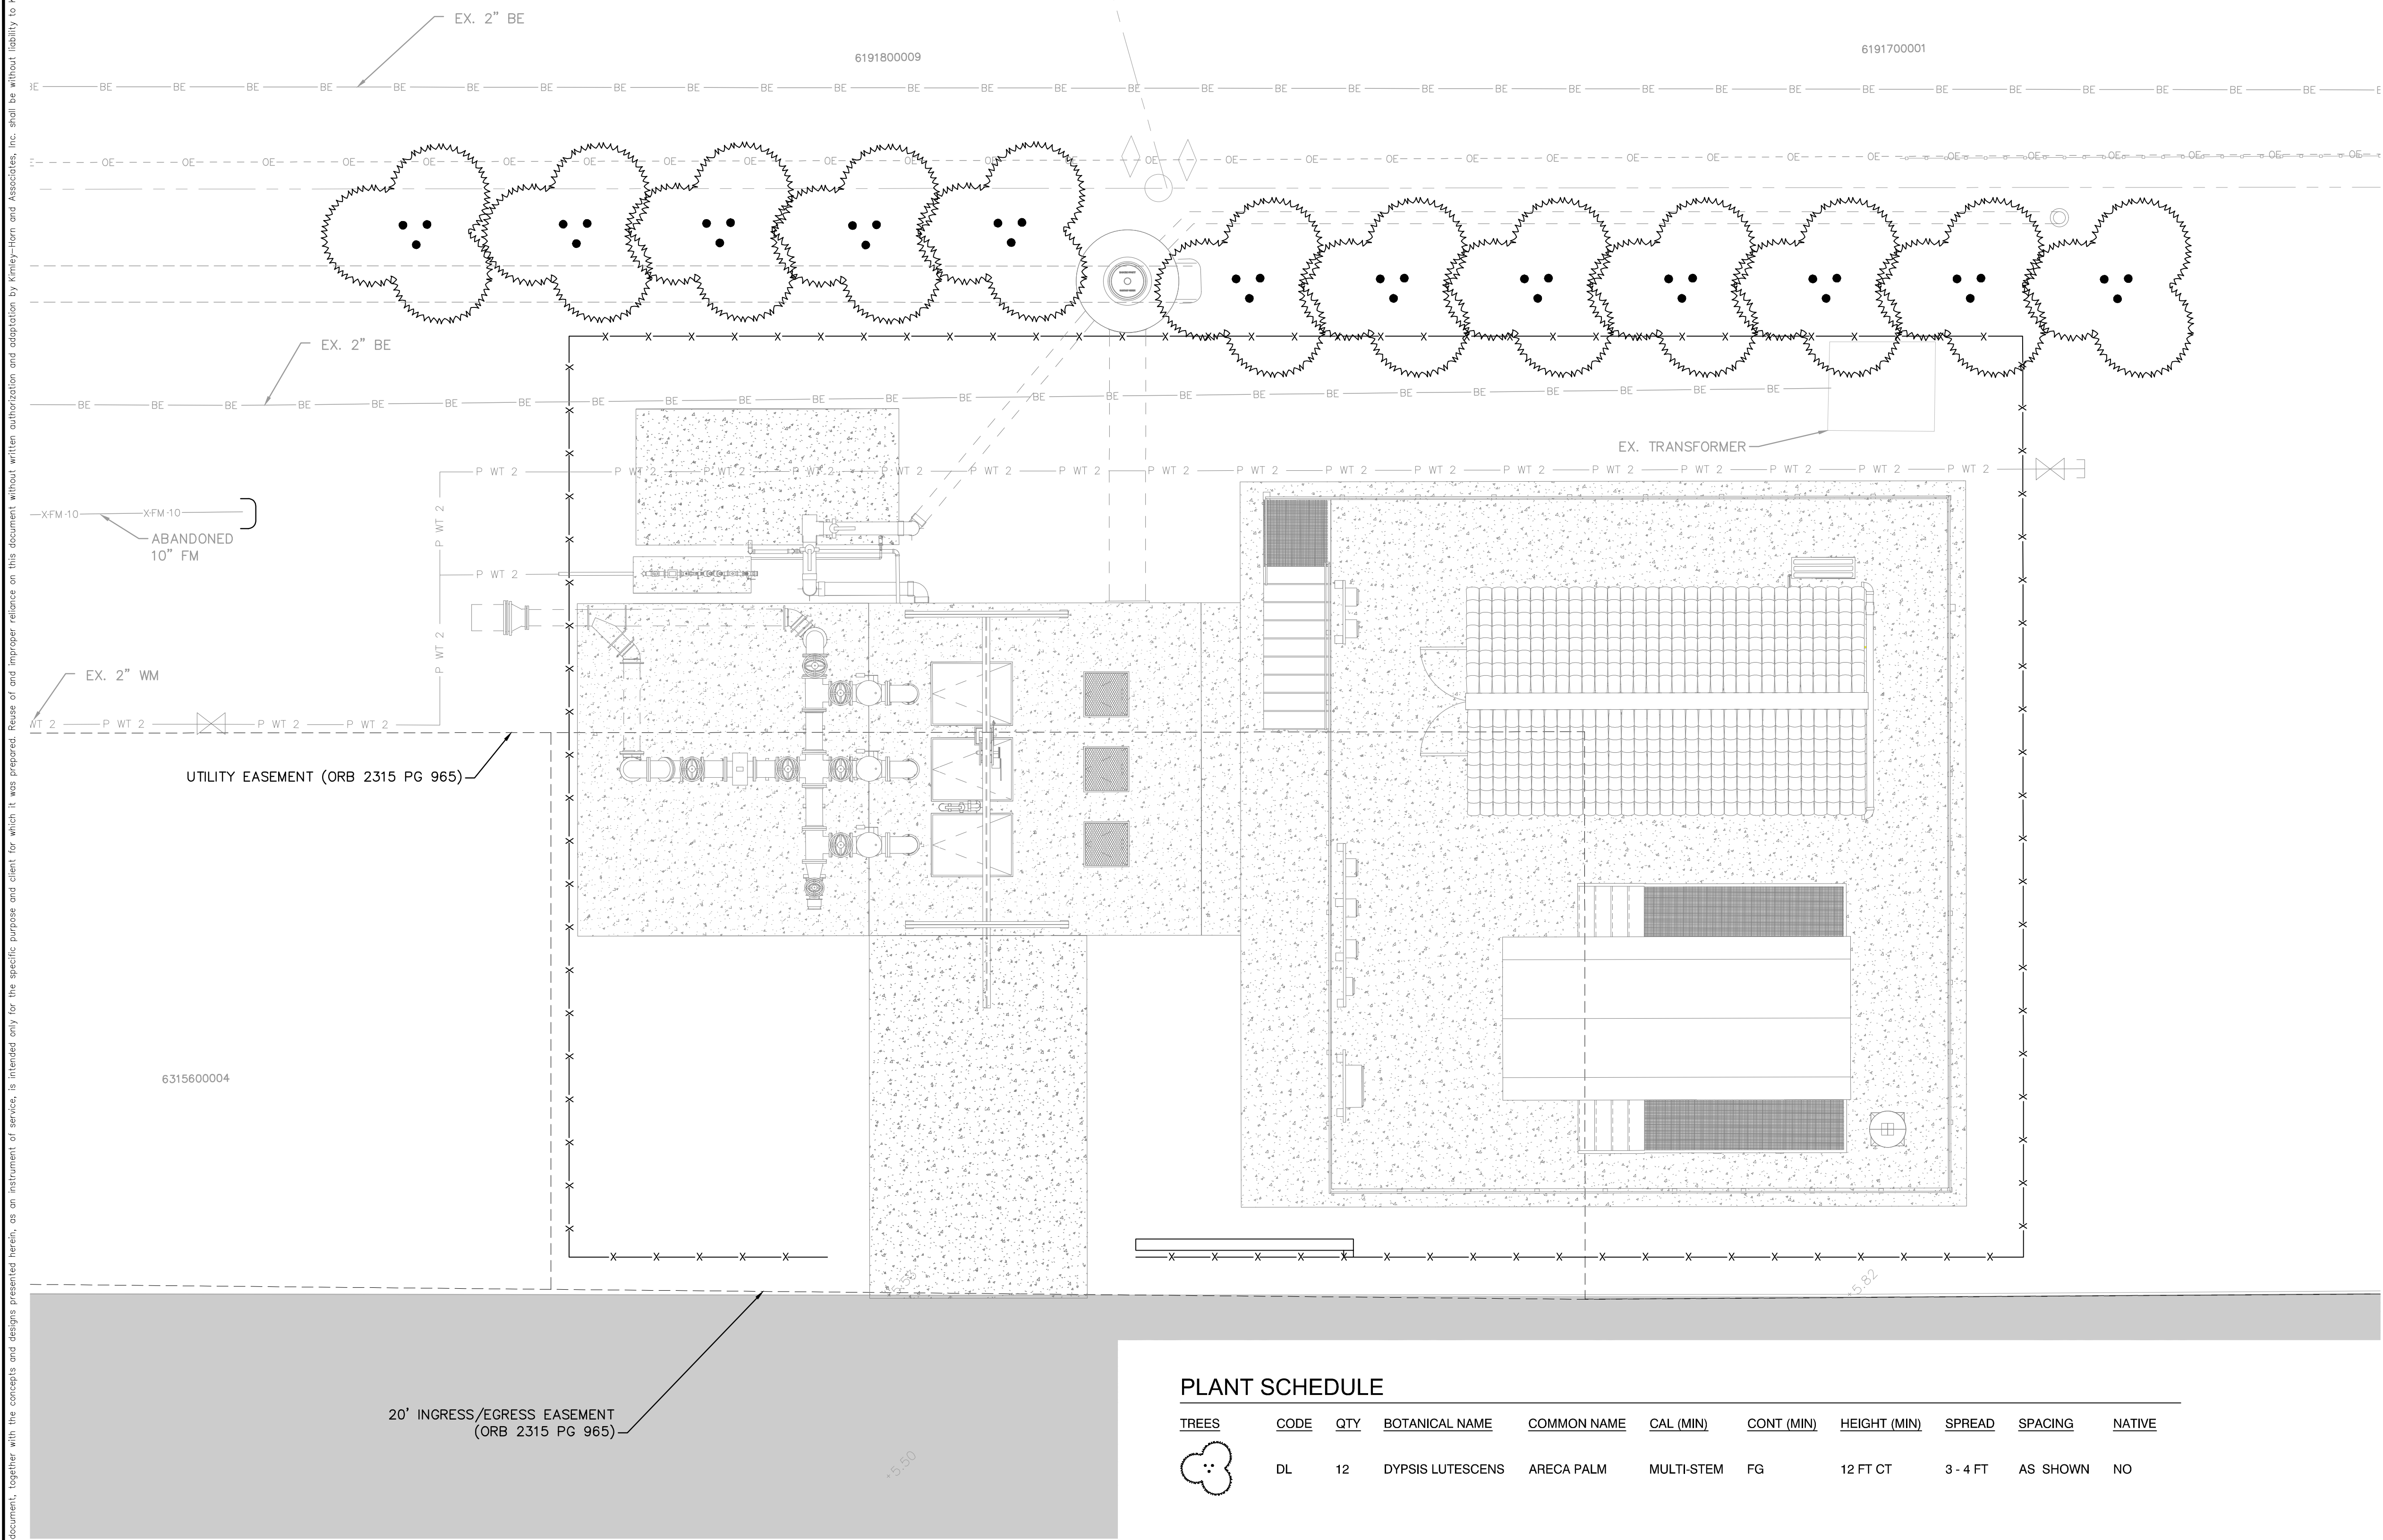
SHEET NUMBER  <b>S-9</b>
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PLANT SCHEDULE

TREES	CODE	QTY	BOTANICAL NAME	COMMON NAME	CAL (MIN)	CONT (MIN)	HEIGHT (MIN)	SPREAD	SPACING	NATIVE
	DL	12	DYPsis LUTESCENS	ARECA PALM	MULTI-STEM	FG	12 FT CT	3 - 4 FT	AS SHOWN	NO

**GROUNDWATER /  
DEWATERING NOTE:**  
THE PRESENCE OF GROUNDWATER SHOULD BE ANTICIPATED ON THIS PROJECT. CONTRACTOR'S BID SHALL INCLUDE CONSIDERATION FOR THIS ISSUE. WHEN PERFORMING GRADING OPERATIONS DURING PERIODS OF WET WEATHER, PROVIDE ADEQUATE DEWATERING, DRAINAGE AND GROUND WATER MANAGEMENT TO CONTROL MOISTURE OF SOILS.



No.	REVISIONS	DATE	BY

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KHA PROJECT  
148400067  
DATE  
FEB 2022  
SCALE AS SHOWN  
DESIGNED BY KHA  
DRAWN BY JJB  
CHECKED BY JLD

**BAYSHORE YACHT BASIN FORCE MAIN  
AND LIFT STATION REPLACEMENT**

MANATEE COUNTY

LICENSED PROFESSIONAL

JENNIFER L. DAOLAS, PLA

FL LICENSE NUMBER  
6667369

FL DATE:

**LANDSCAPE PLAN**

SHEET NUMBER

**L-2**



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## IRRIGATION SPECIFICATIONS

### 1. SCOPE OF WORK

- 1.1. THE WORK CONSISTS OF: FURNISHING ALL LABOR, MATERIALS, EQUIPMENT, TOOLS, TRANSPORTATION, AND ANY OTHER APPURTENANCES NECESSARY FOR THE COMPLETION OF THIS PROJECT AS SHOWN ON THESE PLANS.
- 1.2. INSTALL THE IRRIGATION SYSTEM TO PROVIDE 100% UNIFORM COVERAGE INCLUDING ANY CHANGES MADE IN THE LAYOUT DUE TO FIELD CONDITIONS. ALL FIELD CHANGES SHALL BE IN ACCORDANCE WITH THESE PLANS. ANY SYSTEMS THAT REQUIRE FIELD ADJUSTMENT TO PROVIDE FULL AND UNIFORM COVERAGE SHALL BE MADE PRIOR TO FINAL ACCEPTANCE AT THE DIRECTION OF THE OWNER'S REPRESENTATIVE AT NO ADDITIONAL COST.
- 1.3. SECURE ANY AND ALL NECESSARY PERMITS FOR THE WORK PRIOR TO COMMENCEMENT OF OPERATIONS ON-SITE. SEND COPIES OF THE PERMIT(S) TO THE OWNER'S REPRESENTATIVE. FOR WORK LOCATED IN THE R.O.W., CONFORM TO THE STANDARDS AND SPECIFICATIONS OF THE AGENCY HAVING JURISDICTION.
- 1.4. WORK SHALL BE COORDINATED WITH OTHER TRADES TO PREVENT CONFLICTS.

### 2. PROTECTION OF EXISTING AND PROPOSED SITE ELEMENTS

- 2.1. ALL EXISTING SITE ITEMS, ALREADY COMPLETED OR ESTABLISHED AND DESIGNATED TO REMAIN SHALL BE PROTECTED FROM DAMAGE BY THE CONTRACTOR UNLESS OTHERWISE SPECIFIED. ALL DAMAGE RESULTING FROM THE CONTRACTOR'S WORK SHALL BE REPAIRED OR REPLACED TO THE SATISFACTION OF THE OWNER, AT NO COST TO THE OWNER.
- 2.2. MAINTAIN ALL NECESSARY BMP DEVICES THROUGHOUT THE DURATION OF ALL CONSTRUCTION ACTIVITIES.
- 2.3. WHERE APPLICABLE, SUBMIT A DETAILED PROJECT SPECIFIC WORK ZONE TRAFFIC CONTROL PLAN IN ACCORDANCE WITH THE APPROPRIATE REGULATORY AGENCY STANDARDS UNLESS THE WORK REQUIRES NOTHING MORE THAN A DIRECT APPLICATION OF FDOT STANDARD PLANS FOR ROAD AND BRIDGE CONSTRUCTION, INDEX 102-600.
- 2.4. LOCATE ALL UTILITIES, WHETHER PUBLIC OR PRIVATE, PRIOR TO CONSTRUCTION ACTIVITIES. THE INFORMATION AND DATA SHOWN WITH RESPECT TO UTILITIES IS APPROXIMATE. THE OWNER AND DESIGN PROFESSIONAL SHALL NOT BE RESPONSIBLE FOR THE ACCURACY AND COMPLETENESS OF ANY SUCH INFORMATION OR DATA. THE CONTRACTOR SHALL HAVE FULL RESPONSIBILITY FOR: REVIEWING AND CHECKING ALL SUCH INFORMATION AND DATA; LOCATING ALL UTILITIES PRIOR TO CONSTRUCTION; THE SAFETY AND PROTECTION THEREOF; AND REPAIRING ANY DAMAGE RESULTING FROM THE WORK. THE COST OF ALL WILL BE CONSIDERED AS HAVING BEEN INCLUDED IN THE CONTRACT PRICE. NOTIFY ANY AFFECTED UTILITY COMPANIES OR AGENCIES IN WRITING AT LEAST 48 HOURS PRIOR TO BEGINNING CONSTRUCTION. NOTIFY THE LANDSCAPE ARCHITECT IN WRITING WHEN ANY CONFLICT BETWEEN UTILITIES AND THESE PLANS EXIST PRIOR TO INSTALLATION.

### 3. SUBMITTALS

- 3.1. SUBMIT FULL AND COMPLETE SHOP DRAWINGS OF ALL IRRIGATION EQUIPMENT AS SHOWN ON THESE PLANS TO OWNER'S REPRESENTATIVE FOR APPROVAL PRIOR TO INSTALLATION.
- 3.2. SUBMIT PRODUCT DATA SHEETS FOR ALL IRRIGATION EQUIPMENT TO BE INSTALLED TO OWNER'S REPRESENTATIVE FOR APPROVAL PRIOR TO INSTALLATION. THE IRRIGATION SYSTEM, AS SHOWN ON THESE PLANS, HAS BEEN DESIGNED AND CALCULATED WITH THE EQUIPMENT AS SPECIFIED. SUBMIT ANY REQUEST FOR PRODUCT SUBSTITUTION(S) IN WRITING. IF APPROVED, THE CONTRACTOR SHALL BE RESPONSIBLE FOR ANY NECESSARY MODIFICATION(S) AS A RESULT OF PRODUCT SUBSTITUTIONS TO THE IRRIGATION SYSTEM IN THE SHOP DRAWINGS TO MEET THE DESIGN INTENT OF THESE PLANS.

### 4. EQUIPMENT LIST

- 4.1. ALL QUANTITIES ARE PROVIDED FOR CONVENIENCE ONLY. CONFIRM ALL QUANTITIES PER PLAN PRIOR TO BIDDING AND CONSTRUCTION.

### 5. POINT OF CONNECTION

- 5.1. FIELD VERIFY ALL POINT OF CONNECTION SOURCE INFORMATION INCLUDING STATIC PSI AND GPM AVAILABLE PRIOR TO CONSTRUCTION. NOTIFY OWNER'S REPRESENTATIVE IN WRITING IF DISCREPANCIES BETWEEN THE FLOW AND PRESSURE AS LISTED IN THE CRITICAL ANALYSIS AND THE FIELD CONDITIONS EXIST.
- 5.2. COORDINATE INSTALLATION OF ANY METERS AND BACKFLOW ASSEMBLIES WITH THE AGENCY HAVING JURISDICTION AND OWNER'S REPRESENTATIVE.

### 6. MAINLINE INSTALLATION

- 6.1. INSTALL ALL MAINLINES AND LATERALS UNDER PAVEMENT WITHIN SLEEVES, WHERE VALVE CONTROL LINES PASS THROUGH A SLEEVE WITH OTHER MAIN OR LATERAL LINES, CONTAIN WIRES WITHIN A SEPARATE, SMALLER CONDUIT.
- 6.2. INSTALL COLOR CODED METAL DETECTABLE MARKING TAPE WHICH CLEARLY NOTES: "CAUTION: IRRIGATION LINE BURIED BELOW" ABOVE THE FULL LENGTH OF THE IRRIGATION MAINLINE.
- 6.3. WHERE MAINLINE RUNS PARALLEL TO PAVEMENT OR CURBING, OFFSET THE MAINLINE 24" FROM THE EDGE OF PAVEMENT OR CURB.
- 6.4. PERFORM HYDROSTATIC PRESSURE TESTING AS FOLLOWS:
  - 6.4.1. AFTER FLUSHING, AND THE INSTALLATION OF VALVES CONDUCT THE FOLLOWING TESTS IN THE SEQUENCE LISTED BELOW. FURNISH ALL EQUIPMENT, MATERIALS AND LABOR NECESSARY TO PERFORM THE TESTS. CONDUCT ALL TESTS IN THE PRESENCE OF THE OWNER'S REPRESENTATIVE. NOTIFY THE OWNER'S REPRESENTATIVE FORTY-EIGHT (48) HOURS IN ADVANCE OF TESTING.
  - 6.4.2. PERFORM WATER PRESSURE TESTS ON ALL PRESSURE MAIN LINES BEFORE ANY COUPLINGS, FITTINGS, VALVES AND THE LIKE ARE CONCEALED.
  - 6.4.3. IMMEDIATELY PRIOR TO TESTING, PURGE ALL IRRIGATION LINES OF ALL ENTRAPPED AIR OR DEBRIS BY ADJUSTING CONTROL VALVES AND INSTALLING TEMPORARY CAPS FORCING WATER AND DEBRIS TO BE DISCHARGED FROM A SINGLE OUTLET.
  - 6.4.4. TEST ALL PRESSURE MAIN LINE AT 150 PSI FOR A MINIMUM OF FOUR (4) HOURS WITH AN ALLOWABLE LOSS OF 5 PSI. PRESSURE AND GAUGES SHALL BE READ IN PSI, AND CALIBRATED SUCH THAT ACCURATE DETERMINATION OF POTENTIAL PRESSURE LOSS CAN BE ASCERTAINED.
  - 6.4.5. RE-TEST AS REQUIRED UNTIL THE SYSTEM MEETS THE REQUIREMENTS. REPAIR ANY LEAKS, WHICH OCCUR DURING TEST PERIOD, IMMEDIATELY FOLLOWING THE TEST.
  - 6.4.6. PROVIDE DOCUMENTATION STATING THE WEATHER CONDITIONS, DATE, THE START TIME AND INITIAL WATER PRESSURE READINGS, THE FINISH TIME AND FINAL WATER PRESSURE READINGS AND THE TYPE OF EQUIPMENT USED TO PERFORM THE TEST. THE DOCUMENTATION MUST BE SIGNED BY A WITNESS ACCEPTABLE TO THE OWNER, VERIFYING ALL OF THE ABOVE-MENTIONED CONDITIONS.
  - 6.4.7. SUBMIT A WRITTEN REPORT OF THE PRESSURE TESTING RESULTS WITH THE OTHER ABOVE REQUIRED INFORMATION TO THE OWNER'S REPRESENTATIVE FOR APPROVAL.

### 7. IRRIGATION VALVES AND WIRING

- 7.1. LOCATE ALL VALVES, SPLICES WITHIN CONTROL LINES, QUICK COUPLERS, AND HOSE BIBBS WITHIN VALVE BOXES. PROVIDE PURPLE VALVE BOX LIDS FOR SYSTEMS UTILIZING A NON-POTABLE WATER SOURCE.
- 7.2. NUMBER THE TOP OF ALL VALVE BOX LIDS WITH MINIMUM 1" HEIGHT BLACK LETTERS TO CORRESPOND TO THE VALVE DESIGNATIONS.
- 7.3. WHEN POSSIBLE, LOCATE ALL VALVES IN PLANTING BEDS A MINIMUM OF 24" FROM BACK OF CURB OR EDGE OF PAVEMENT, UNLESS OTHERWISE NOTED.
- 7.4. SEPARATE IRRIGATION ZONES FOR HIGH AND LOW WATER USE REQUIREMENTS AND OPERATED ON DIFFERENT WATERING CYCLES. AT NO TIME SHALL MULTIPLE IRRIGATION HEAD TYPES BE LOCATED ON THE SAME VALVE UNLESS NOTED OTHERWISE.
- 7.5. INSTALL ALL DRIP ZONES WITH A FLUSH VALVE AND AIR RELIEF VALVE. IN THE EVENT THAT A DRIP ZONE HAS MORE THAN ONE HIGH OR LOW POINT, MORE THAN ONE AIR RELIEF VALVE OR FLUSH VALVE WILL BE REQUIRED FOR THAT ZONE.
- 7.6. FOLLOW MANUFACTURER'S SPECIFICATIONS FOR ALL WIRING FOR CONNECTION OF THE VALVES TO THE CONTROLLER. ALL WIRE RUNS SHALL BE CONTINUOUS WITH SPLICING OCCURRING IN VALVE BOXES ONLY. WIRE CONNECTIONS SHALL BE MADE USING DBRY-6 CONNECTIONS OR APPROVED EQUAL.

- 7.7. INSTALL VALVE CONTROL WIRING IN THE SAME TRENCH AS THE MAINLINE WHERE PRACTICAL.
- 7.8. FOR NON TWO-WIRE SYSTEMS, RUN TWO (2) SPARE VALVE CONTROL WIRES FROM THE CONTROLLER ALONG THE ENTIRE MAINLINE TO LAST REMOTE CONTROLLED VALVE ON EACH AND EVERY LEG OF MAINLINE.

### 8. PIPES AND SLEEVING

- 8.1. DO NOT INSTALL IRRIGATION SYSTEM THROUGH PRESERVED PLANT COMMUNITIES, DRIPLINE OF EXISTING TREES, OR WITHIN WETLANDS UNLESS SPECIFICALLY NOTED OTHERWISE.
- 8.2. LOCATE ALL IRRIGATION LINES WITHIN LANDSCAPED AREAS WHENEVER POSSIBLE. ALL LINES UNDER PAVEMENT MUST BE SLEEVED.
- 8.3. SIZE ALL PIPE SLEEVES TWO PIPE SIZES GREATER THAN THE PIPE / CUMULATIVE SUM OF THE PIPES IT CARRIES.
- 8.4. SLEEVES UNDER EXISTING PAVEMENT MUST BE DIRECTIONAL BORE UNLESS APPROVED BY OWNER IN WRITING.
- 8.5. SOLVENT CEMENTS SHALL COMPLY WITH ASTM D2564.

### 9. CONTROLLER AND SENSORS

- 9.1. COORDINATE WITH OWNER'S REPRESENTATIVE FOR FINAL CONTROLLER AND RAIN SENSOR LOCATIONS. THE CONTROLLER SHALL BE PLACED IN A LOCKING CABINET APPROPRIATE FOR ITS LOCATION. (INDOOR VS. OUTDOOR USE)
- 9.2. LOCATE THE AUTOMATIC RAIN SENSOR SHUTOFF DEVICE IN AN AREA THAT IS UNOBSTRUCTED BY TREES, ROOF OVERHANGS, OR ANY OTHER OVERHEAD OBJECT. THE SENSOR SHALL NOT BE PLACED WITHIN THE SPRAY ZONE OF ANY SPRINKLER HEAD, INCLUDING OFF-SITE IRRIGATION. CONTRACTOR SHALL LOCATE SENSOR WITHIN CLOSE PROXIMITY TO THE IRRIGATION CONTROLLER.

### 10. CLEANUP

- 10.1. UPON COMPLETION OF ALL WORK AND BEFORE FINAL ACCEPTANCE, REMOVE ALL MATERIAL, EQUIPMENT, AND DEBRIS RESULTING FROM HIS WORK. ALL PAVED AREAS SHALL BE CLEANED AND THE SITE LEFT IN A NEAT AND ACCEPTABLE CONDITION AS APPROVED BY THE OWNER'S REPRESENTATIVE.

### 11. AS-BUILT IRRIGATION PLANS

- 11.1. PROVIDE "AS-BUILT" DRAWINGS OF THE FINAL INSTALLATION TO OWNER'S REPRESENTATIVE PRIOR TO FINAL ACCEPTANCE OF WORK. INCLUDE THE FOLLOWING ON THE AS-BUILT DRAWINGS AT A MINIMUM:
  - CONTROLLER LOCATION
  - CONNECTION ASSEMBLY
  - MAINLINE ROUTING
  - PIPE SLEEVING
  - VALVE(S)
  - COLORIZED ZONING DIAGRAM
- 11.2. LOCATE ALL SLEEVES UTILIZED BY THE IRRIGATION CONTRACTOR WHETHER INSTALLED BY THE IRRIGATION CONTRACTOR OR NOT ON THE "AS-BUILT" DRAWINGS. THE DEPTH BELOW FINISH GRADE, TO THE NEAREST FOOT OF EACH END OF THE SLEEVE SHALL BE NOTED AT EACH SLEEVE LOCATION ON THE "AS-BUILT" DRAWINGS.

### 12. FINAL INSPECTION AND ACCEPTANCE OF WORK

- 12.1. MINIMIZE IRRIGATION OVERTHROW TO IMPERVIOUS AND NATURAL AREAS THROUGH FIELD ADJUSTMENTS TO INDIVIDUAL HEADS.
- 12.2. PROGRAM CONTROLLER TO IRRIGATE ALL ZONES WITHIN APPLICABLE WATERING WINDOWS AND PROVIDE WATERING SCHEDULE TO OWNER'S REPRESENTATIVE.
- 12.3. EQUIPMENT TO BE FURNISHED TO OWNER PRIOR TO ACCEPTANCE OF WORK:
  - TWO (2) SETS OF KEYS FOR EACH AUTOMATIC CONTROLLER.
  - TWO (2) 48 INCH TEE WRENCHES FOR OPERATING GATE VALVES (WHEN INSTALLED AS PART OF WORK).
  - THREE (3) SETS OF SPECIAL TOOLS REQUIRED FOR REMOVING, DISASSEMBLING AND ADJUSTING EACH TYPE OF - SPRINKLER AND VALVE SUPPLIED ON THIS PROJECT.
  - FIVE (5) EXTRA SPRINKLER HEADS, NOZZLES, SHRUB ADAPTERS, NOZZLE FILTER SCREENS, FOR EACH TYPE USED ON THE PROJECT.
  - TWO (2) QUICK COUPLER KEYS TO MATCH MANUFACTURER TYPE OF QUICK COUPLER.
- 12.4. UPON COMPLETION OF ALL WORK, A FINAL INSPECTION SHALL BE PERFORMED BY THE OWNER AND/OR OWNER'S REPRESENTATIVE. THE IRRIGATION SYSTEM, CONSTRUCTION AND ALL OTHER INCIDENTAL WORK PERTAINING TO THIS CONTRACT SHALL BE INSPECTED FOR COMPLIANCE WITH THE CONTRACT DOCUMENTS. ANY ITEMS FOUND TO NOT BE IN COMPLIANCE SHALL BE CORRECTED AT NO COST TO THE OWNER.

### 13. WARRANTY

- 13.1. THE CONTRACTOR SHALL WARRANTEE ALL WORKMANSHIP AND MATERIALS FOR A PERIOD OF 1 YEAR FOLLOWING THE ACCEPTANCE OF THE WORK.
- 13.2. ANY PART OF THE IRRIGATION WORK THAT FAILS OR IS DEFECTIVE SHALL BE REPLACED OR RECONSTRUCTED AT NO COST TO THE OWNER INCLUDING BUT NOT LIMITED TO: RESTORING GRADES THAT HAVE SETTLED IN TRENCHES AND EXCAVATIONS RELATED TO THE WORK. RECONSTRUCTION SHALL INCLUDE ANY PLANTINGS, SOIL, MULCH OR OTHER PARTS OF THE CONSTRUCTED LANDSCAPE THAT MAY BE DAMAGED DURING THE REPAIR OR THAT RESULTS FROM SOIL SETTLEMENT.
- 13.3. THE DATE OF ACCEPTANCE OF THE WORK AND START OF THE GUARANTEE PERIOD SHALL BE DETERMINED BY THE OWNER, UPON THE FINDING THAT THE ENTIRE IRRIGATION SYSTEM IS INSTALLED AS DESIGNED AND SPECIFIED, AND FOUND TO BE OPERATING CORRECTLY, SUPPLYING WATER EVENLY TO ALL PLANTING AND/OR LAWN AREAS.
- 13.4. NEITHER THE FINAL ACCEPTANCE NOR ANY PROVISION IN THE CONTRACT DOCUMENTS SHALL RELIEVE THE CONTRACTOR OF RESPONSIBILITY FOR FAULTY MATERIALS OR WORKMANSHIP. REMEDY ANY DEFECTS WITHIN A PERIOD OF 7 DAYS (S) FROM THE DATE OF NOTIFICATION OF A DEFECT.

### 14. ABBREVIATIONS

GPM - GALLONS PER MINUTE  
GPH - GALLONS PER HOUR  
PSI - POUNDS PER SQUARE INCH

### LATERAL PIPE SIZING REQUIREMENTS

MAXIMUM FLOW	MINIMUM PIPE SIZE
10 GPM	3/4"
16 GPM	1"
26 GPM	1-1/4"
35 GPM	1-1/2"
55 GPM	2"
80 GPM	2-1/2"
120 GPM	3"

PIPE SIZES ILLUSTRATED IN THE ABOVE CHART ARE MINIMUM ACCEPTABLE SIZES. PIPE SIZES INDICATED ON PLAN ARE FOR CONVENIENCE ONLY. FIELD SIZE ALL LATERAL PIPING TO KEEP ALL FRICTION LOSS VELOCITIES BELOW 5.0 FPS.

No.	REVISIONS	DATE	BY

**Kimley»Horn**

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DRAWN BY JJB  
CHECKED BY JLD



## BAYSHORE YACHT BASIN FORCE MAIN AND LIFT STATION REPLACEMENT

MANATEE COUNTY

LICENSED PROFESSIONAL

JENNIFER L. DAOULAS, PLA

FL LICENSE NUMBER  
6667369

DATE:

## IRRIGATION NOTES

SHEET NUMBER

IR-1

### GROUNDWATER / DEWATERING NOTE:

THE PRESENCE OF GROUNDWATER SHOULD BE ANTICIPATED ON THIS PROJECT. CONTRACTOR'S BID SHALL INCLUDE CONSIDERATION FOR THIS ISSUE. WHEN PERFORMING GRADING OPERATIONS DURING PERIODS OF WET WEATHER, PROVIDE ADEQUATE DEWATERING, DRAINAGE AND GROUND WATER MANAGEMENT TO CONTROL MOISTURE OF SOILS.




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NOTES:  
1. CONTRACTOR TO VERIFY PREFERRED EQUIPMENT WITH OWNER.  
2. SYSTEM HAS BEEN DESIGNED ASSUMING AN AVAILABLE STATIC PRESSURE OF 40 PSI. CONTRACTOR TO VERIFY AVAILABLE GPM AND STATIC PRESSURE PRIOR TO INSTALLATION. NOTIFY THE LANDSCAPE ARCHITECT IF GPM AND/OR STATIC PRESSURE VARIES FROM DESIGN SPECIFICATIONS.

**IRRIGATION SCHEDULE**

SYMBOL	MANUFACTURER/MODEL/DESCRIPTION	QTY
	RAIN BIRD 1804-SAM-1300AF FLOOD F FLOOD BUBBLER 4.0" POP-UP WITH CHECK VALVE, WITH A PA-80 ADAPTER.	24
	RAIN BIRD PEB-PRS-D 1", 1-1/2", 2" PLASTIC INDUSTRIAL VALVES. LOW FLOW OPERATING CAPABILITY, GLOBE CONFIGURATION. WITH PRESSURE REGULATOR MODULE.	1
	RAIN BIRD ESP8LXMEF-LXMM-LXMMPED 8 STATION CAPABLE COMMERCIAL CONTROLLER. MOUNTED ON A POWDER-COATED METAL PEDESTAL. FLOW SENSING AND WATER MANAGEMENT CAPABILITIES. FLOW SENSING.	1
	RAIN BIRD RSD-BEX RAIN SENSOR, WITH METAL LATCHING BRACKET, EXTENSION WIRE.	1
	RAIN BIRD FS-200-P 2" FLOW SENSOR FOR USE WITH RAIN BIRD MAXICOM, SITECONTROL, AND ESP-LXD CENTRAL CONTROL SYSTEMS. PLASTIC (PVC) MODEL. SUGGESTED OPERATING RANGE OF 10.0 GPM TO 200.0 GPM. SENSORS SHOULD BE SIZED FOR FLOW RATHER THAN PIPE SIZE.	1
	IRRIGATION LATERAL LINE: PVC SCHEDULE 40	114.0 L.F.
	IRRIGATION MAINLINE: PVC SCHEDULE 40	9.1 L.F.

**VALVE SCHEDULE**

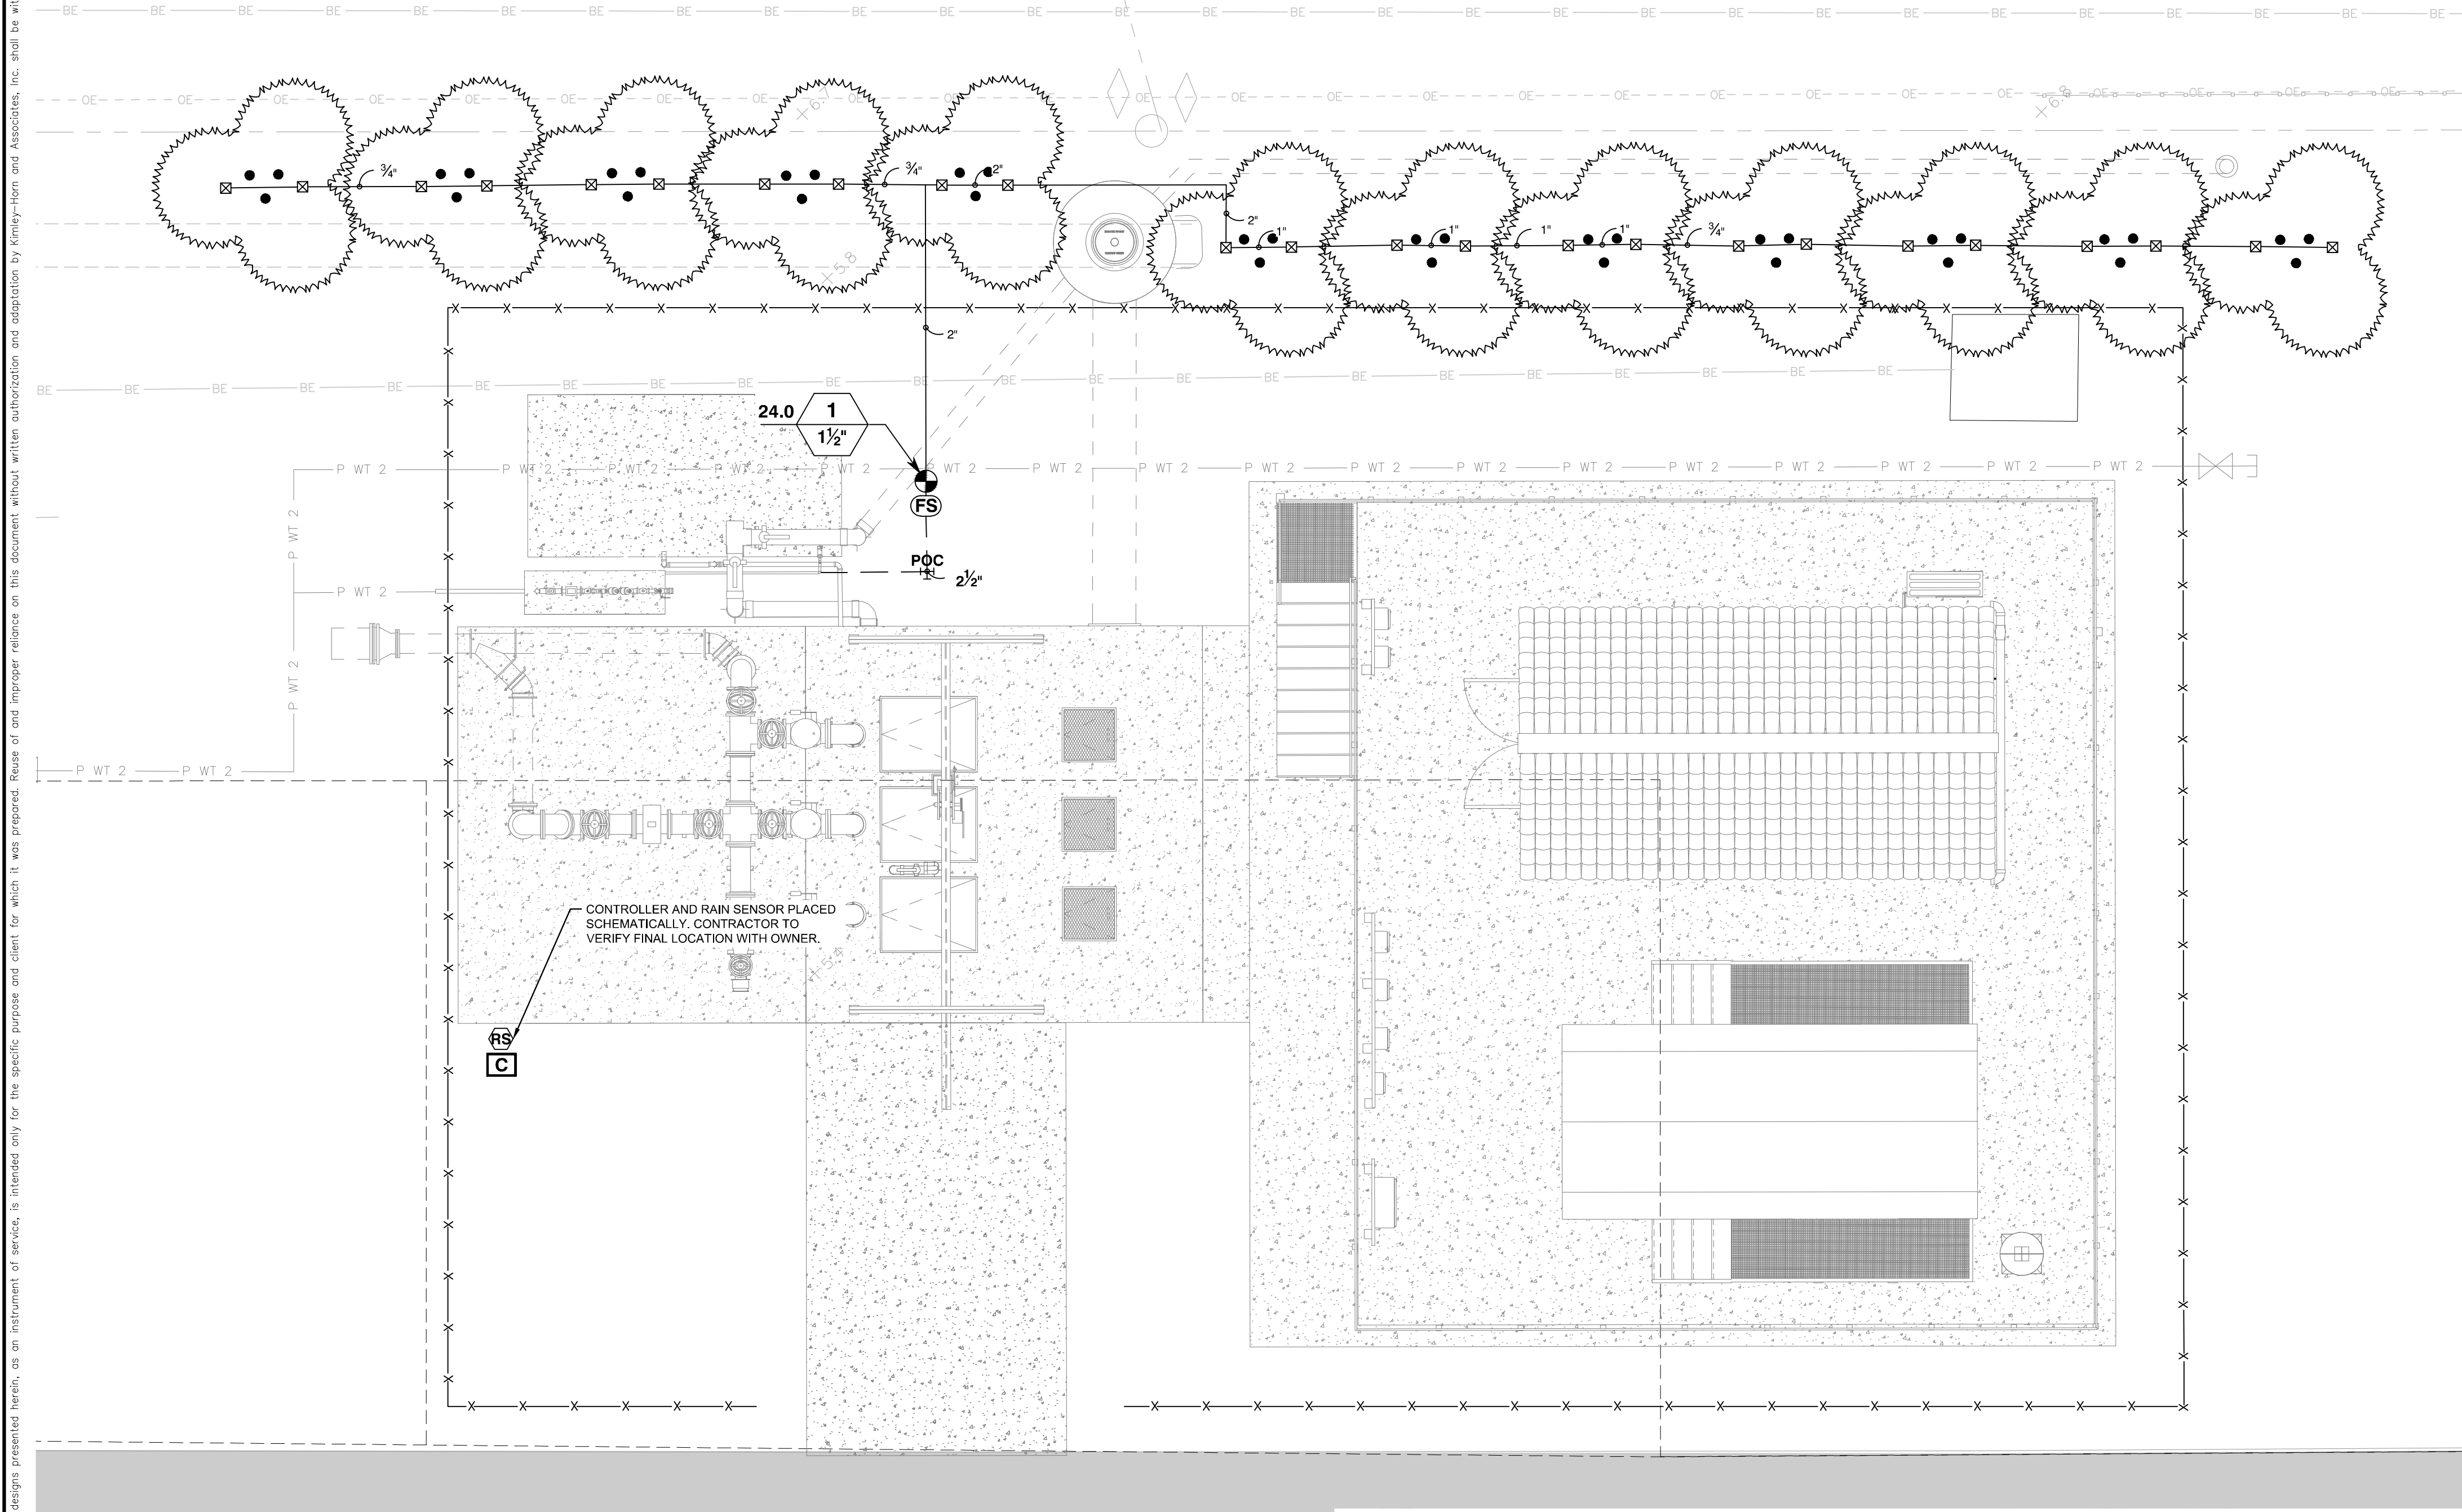NUMBER	MODEL	SIZE	TYPE	GPM	PSI	PSI @ POC	PRECIP
1	RAIN BIRD PEB-PRS-D	1-1/2"	BUBBLER	24.00	15.45	15.46	4.35 in/h

**CRITICAL ANALYSIS**

Generated: 2021-10-08 12:36

P.O.C. NUMBER: 01  
Water Source Information:

FLOW AVAILABLE  
Point of Connection Size: 2"  
Flow Available: 84.89 gpm

PRESSURE AVAILABLE  
Static Pressure at POC: 40.00 PSI  
Pressure Available: 40.00 psi

DESIGN ANALYSIS  
Maximum Station Flow: 24.00 gpm  
Flow Available at POC: 84.89 gpm  
Residual Flow Available: 60.89 gpm

Critical Station: 1  
Design Pressure: 10.00 psi  
Friction Loss: 1.51 psi  
Fittings Loss: 0.16 psi  
Elevation Loss: 0.00 psi  
Loss through Valve: 3.78 psi  
Pressure Req. at Critical Station: 15.45 psi  
Loss for Fittings: 0.00 psi  
Loss for Main Line: 0.01 psi  
Loss for POC to Valve Elevation: 0.00 psi  
Loss for Backflow: 0.00 psi  
Critical Station Pressure at POC: 15.46 psi  
Pressure Available: 40.00 psi  
Residual Pressure Available: 24.54 psi

**GROUNDWATER / DEWATERING NOTE:**  
THE PRESENCE OF GROUNDWATER SHOULD BE ANTICIPATED ON THIS PROJECT. CONTRACTOR'S BID SHALL INCLUDE CONSIDERATION FOR THIS ISSUE. WHEN PERFORMING GRADING OPERATIONS DURING PERIODS OF WET WEATHER, PROVIDE ADEQUATE DEWATERING, DRAINAGE AND GROUND WATER MANAGEMENT TO CONTROL MOISTURE OF SOILS.





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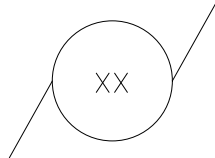
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XXX	XXX_DEVICE	DESCRIPTION
HLS		HIGH LEVEL SWITCH
HOA		HAND-OFF-AUTO
LD		LEAK DETECTION
LLS		LOW LEVEL SWITCH
LOR		LOCAL-OFF-REMOTE
PB		PUSH BUTTON
RTU		REMOTE TERMINAL UNIT
SS		SOFT STARTER
SS/B		SOFT START OR BYPASS
TS		TEMPERATURE SWITCH
TVSS		TRANSIENT VOLTAGE SURGE SUPPRESSOR
ZS		POSITION SENSOR (LIMIT SWITCH)




FUSE




MOTOR

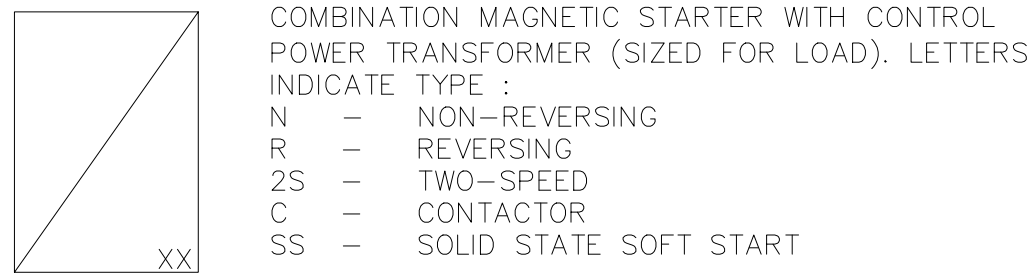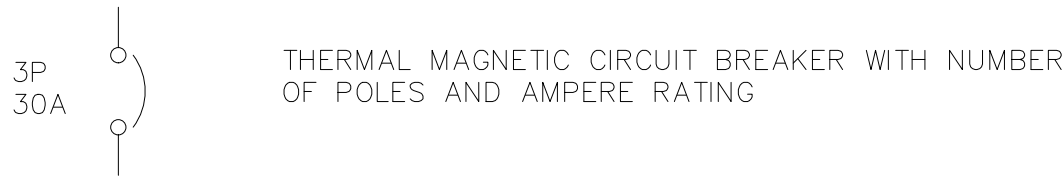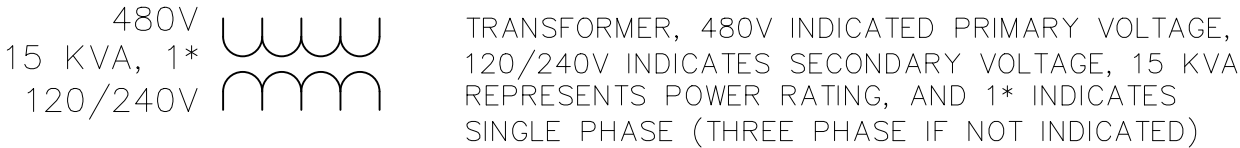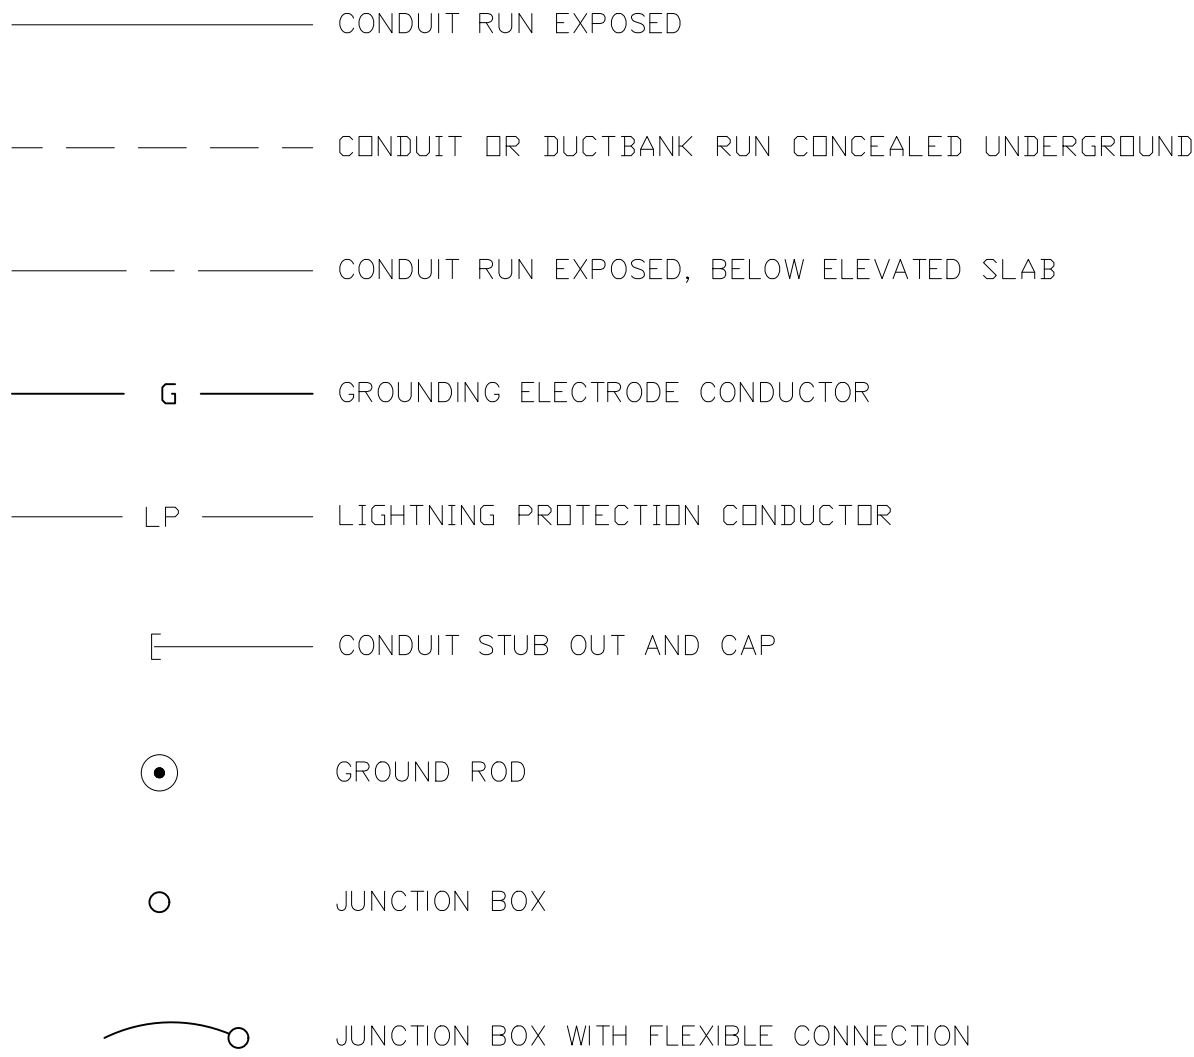

THERMAL OVERLOAD

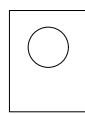


UTILITY METER

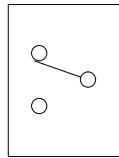



TRANSFER SWITCH




ELECTRIC PANELBOARD

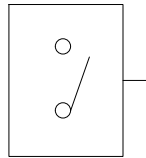


DISCONNECT OR SAFETY SWITCH

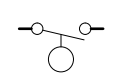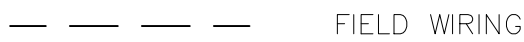

FLOAT SWITCH. OPENS ON LOW LEVEL.

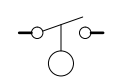


FLOAT SWITCH. CLOSES ON LOW LEVEL.

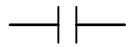


NORMALLY OPEN (N.O.) CONTACT



NORMALLY CLOSED (N.C.) CONTACT

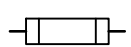


FUSE

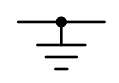


GROUND CONNECTION




INDICATING PILOT LIGHT LETTER INDICATES COLOR OF LENS

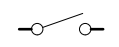

DISCONNECT OR TOGGLE SWITCH

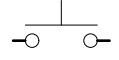


NORMALLY OPEN MOMENTARY CIRCUIT CLOSING PUSH-BUTTON SWITCH SPRING OPEN. NUMBER OF ELECTRICAL CONTACTS ON SWITCH SHOWN ON CONTROL SCHEMATIC

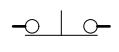


NORMALLY CLOSED MOMENTARY CIRCUIT OPENING PUSH-BUTTON SWITCH SPRING CLOSE. NUMBER OF ELECTRICAL CONTACTS ON SWITCH SHOWN ON CONTROL SCHEMATIC




LIMIT SWITCH NORMALLY CLOSED CONTACT CONTACT OPENS WHEN ACTUATED

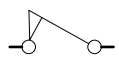

TORQUE SWITCH NORMALLY CLOSED CONTACT CONTACT OPENS WHEN ACTUATED

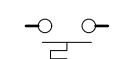

PUMP THERMAL SENSOR

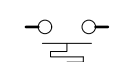

FAN THERMOSTAT

## ELECTRICAL LEGEND

SYMBOL	DESCRIPTION	MOUNTING/REMARKS
	8' LED STRIP LIGHTING FIXTURE (1)	CEILING MOUNT
	LED WALLPACK LIGHTING FIXTURE (1)	EXTERIOR WALL
	LED EMERGENCY AREA LIGHTING FIXTURE (1)	WALL MOUNTED
	LED EXIT SIGN FIXTURE (1)	SURFACE UNIVERSAL MOUNT
	SWITCH: SINGLE-POLE OR AS NOTED, 20A, 120/277VAC	TOP 48" AFF OR AS NOTED
	SWITCH: THREE-WAY, 20A, 120/277VAC	TOP 48" AFF OR AS NOTED
	SWITCH: 4-WAY, 20A, 120/277VAC	TOP 48" AFF OR AS NOTED
	DUPLEX RECEPTACLE: 20A, 125VAC	TOP 20" AFF OR AS NOTED
	COUNTER-TOP DUPLEX RECEPTACLE: 20A, 125VAC	TOP 44" AFF OR AS NOTED
	QUAD RECEPTACLE: 20A, 125VAC	TOP 20" AFF OR AS NOTED
	TELEPHONE/DATA OUTLET (2)	TOP 20" AFF OR AS NOTED
	ELECTRIC PANEL	REFER TO PANEL SCHEDULE
	FIRE ALARM PANEL	
	EQUIPMENT DISCONNECT SWITCH	
	OUTLET OR JUNCTION BOX	WIRES INDICATED AS FOLLOWS:
	CARD READER	—— TWO WIRES:
	MAGNETIC DOOR LOCK	—— THREE WIRES:
	SMOKE DETECTOR	—— FOUR WIRES, ETC.
	JUNCTION BOX WITH FLEXIBLE CONNECTION	—— NEUTRAL WIRE
	CONDUIT RUN CONCEALED IN CEILING SPACE OR WALL	—— ISOLATED GR. WIRE
	CONDUIT RUN CONCEALED IN FLOOR OR UNDERGROUND	PROVIDE 2#12 THWN CU. IN 1/2" C. UNLESS OTHERWISE NOTED AND EQUIPMENT
	CONDUIT RUN EXPOSED	GROUND WIRE (NOT INDICATED) IN ALL POWER AND LIGHTING RACEWAYS.
	HOME RUN TO PANEL/CIRCUIT(S) INDICATED	

## EXAMPLE OF SECTION CUT AND DETAIL

### SECTION

SCALE: 1/4" = 1'-0"

SHEET NUMBER  
WHERE SECTION IS  
CUT

SECTION (LETTERS USED)

SHEET NUMBER  
WHERE SECTION IS  
SHOWN

SECTION (LETTERS USED)

SHEET NUMBER  
WHERE SECTION IS  
CUT

SHEET NUMBER  
WHERE SECTION IS  
SHOWN

DETAIL (NUMBERS USED)

### DETAIL

SCALE: 1/4" = 1'-0"

SHEET NUMBER  
WHERE DETAIL IS  
SHOWN

SHEET NUMBER  
WHERE DETAIL IS  
ENLARGED

### ABBREVIATIONS:

A	AMPS
AFF	ABOVE FINISHED FLOOR
AFG	ABOVE FINISHED GRADE
C	CONDUIT
DIA	DIAMETER
EX	EXISTING
ELEC	ELECTRICAL
GFI	GROUND FAULT INTERRUPTER
GND	GROUNDING CONDUCTOR
HP	HORSEPOWER
HZ	HERTZ
IG	ISOLATED GROUND
KVA	KILOVOLT AMPERES
KW	KILOWATTS
MAX	MAXIMUM
MIN	MINIMUM
N/A	NOT APPLICABLE
PH	PHASE
PLC	PROGRAMMABLE LOGIC CONTROLLER
RECP	RECEPTACLE
RPM	REVOLUTIONS PER MINUTE
RTU	REMOTE TERMINAL UNIT
SPD	SURGE PROTECTION DEVICE
SS	STAINLESS STEEL
TYP	TYPICAL
V	VOLTS
VFD	VARIABLE FREQUENCY DRIVE
WP	WEATHERPROOF
XFMR	TRANSFORMER





- 1 PROPOSED ELEVATED SLAB. REFER TO SHEET E-4 FOR LIGHTNING PROTECTION PLAN.
- 2 PROPOSED ELECTRICAL BUILDING. REFER TO SHEET E-6 FOR POWER AND LIGHTING PLANS.
- 3 PROPOSED 400KW GENERATOR IN WEATHERPROOF, SOUND ATTENUATED ENCLOSURE. PROVIDE 1,600 SUB-BASE TANK FOR 72 HOUR RUNTIME. REFER TO SHEET E-7 FOR DETAILS. (REFER ALSO TO SPECIFICATIONS).
- 4 PROPOSED ELECTRICAL EQUIPMENT RACK. REFER TO SHEET E-11 FOR ELEVATION AND DETAILS.
- 5 PROPOSED WET WELL JUNCTION BOX RACK. REFER TO SHEET E-12 FOR ELEVATION AND DETAILS.
- 6 PROPOSED DOCKING STATION. 277/480V, 3-PHASE, 4-WIRE, 600A WITH SOLID NEUTRAL IN NEMA 4X STAINLESS STEEL ENCLOSURE. TRYSTAR GDR-065W-LLM-I.
- 7 PROPOSED DATA FLOW SYSTEMS (DFS) ANTENNA AND TOWER. REFER TO DETAILS ON SHEET I-16. CONTRACTOR TO FIELD LOCATE DFS ANTENNA AND TOWER WITH COUNTY INSPECTOR.
- 8 PROPOSED FLOW METER ELEMENT. REFER TO MECHANICAL PLANS FOR EXACT LOCATION. PROVIDE AND INSTALL MANUFACTURER SUPPLIED CABLES IN 1" CONDUIT TO FLOW METER CONVERTER (LOCATED IN ELECTRICAL ROOM). REFER ALSO TO DETAIL ON SHEET I-16.
- 9 PROPOSED ODOR CONTROL EQUIPMENT SLAB.
- 10 APPROXIMATED LOCATION FOR PROPOSED ODOR CONTROL UNIT ELECTRICAL CONNECTION. COORDINATE ELECTRICAL CONNECTION DETAILS AND CONNECTION LOCATION WITH ODOR CONTROL UNIT SUPPLIER. PROVIDE WATERPROOF, NON-METALLIC, FLEXIBLE CONNECTION TO ODOR CONTROL UNIT.
- 11 PROPOSED OVERHEAD BRIDGE CRANE.
- 12 APPROXIMATED LOCATION FOR PROPOSED CRANE ELECTRICAL CONNECTION. COORDINATE ELECTRICAL CONNECTION DETAILS AND CONNECTION LOCATION WITH CRANE SUPPLIER. PROVIDE WATERPROOF, NON-METALLIC, FLEXIBLE CONNECTION TO CRANE.
- 13 PROPOSED AREA LIGHT C1. REFER TO SHEET E-6 FOR LIGHTING FIXTURE SCHEDULE. REFER TO E-15 FOR DETAILS.
- 14 PROPOSED AREA LIGHT C2. REFER TO SHEET E-6 FOR LIGHTING FIXTURE SCHEDULE. REFER TO E-15 FOR DETAILS.
- 15 PROVIDE AND INSTALL 120V, 20A, 3-WAY SWITCH IN WEATHERPROOF, SINGLE GANG DIE CAST ALUMINUM FS BOX, BELL 5331-0, OR EQUAL. PROVIDE AND INSTALL SINGLE-GANG WEATHERPROOF 3-WAY SWITCH COVER, BELL #5141-0. INSTALL SWITCH ON 4" SQUARE CONCRETE POST EMBEDDED A MINIMUM OF 3 FEET. HEIGHT OF 3-WAY SWITCH SHALL BE 56 INCHES TO BOTTOM OF FS BOX. 3-WAY SWITCHES TO BE USED FOR AREA LIGHT C1 CONTROL. REFER TO SHEET E-15 FOR WIRING SCHEMATIC.
- 16 EXISTING UTILITY TRANSFORMER TO BE USED FOR NEW LIFT STATION POWER. COORDINATE ALL CONNECTION AND METERING REQUIREMENTS WITH UTILITY.
- 17 PROPOSED 16' x 16' CIP WETWELL.
- 18 PROPOSED CONCRETE ACCESS DRIVE.
- 19 PROPOSED 12' CANTILEVER SLIDE GATE.
- 20 PROVIDE AND INSTALL STAINLESS STEEL HANGERS (SIZED AS REQUIRED) TO ALLOW PUMP CABLES TO BE INSTALLED AND ACCESSED UNDER SLAB.



1. NOT ALL CONDUIT AND CONDUCTORS SHOWN FOR CLARITY. REFER TO OTHER SHEETS FOR ADDITIONAL REQUIREMENTS.
2. CONDUIT ROUTING SHOWN IS DIAGRAMMATICAL. CONTRACTOR MAY FIELD ROUTE CONDUCTORS BASED ON FIELD CONDITIONS WHILE COMPLYING WITH THE NATIONAL ELECTRICAL CODE FOR MAXIMUM NUMBER OF BENDS.



No.	REVISIONS	DATE	BY



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

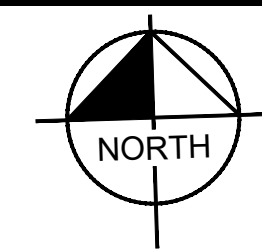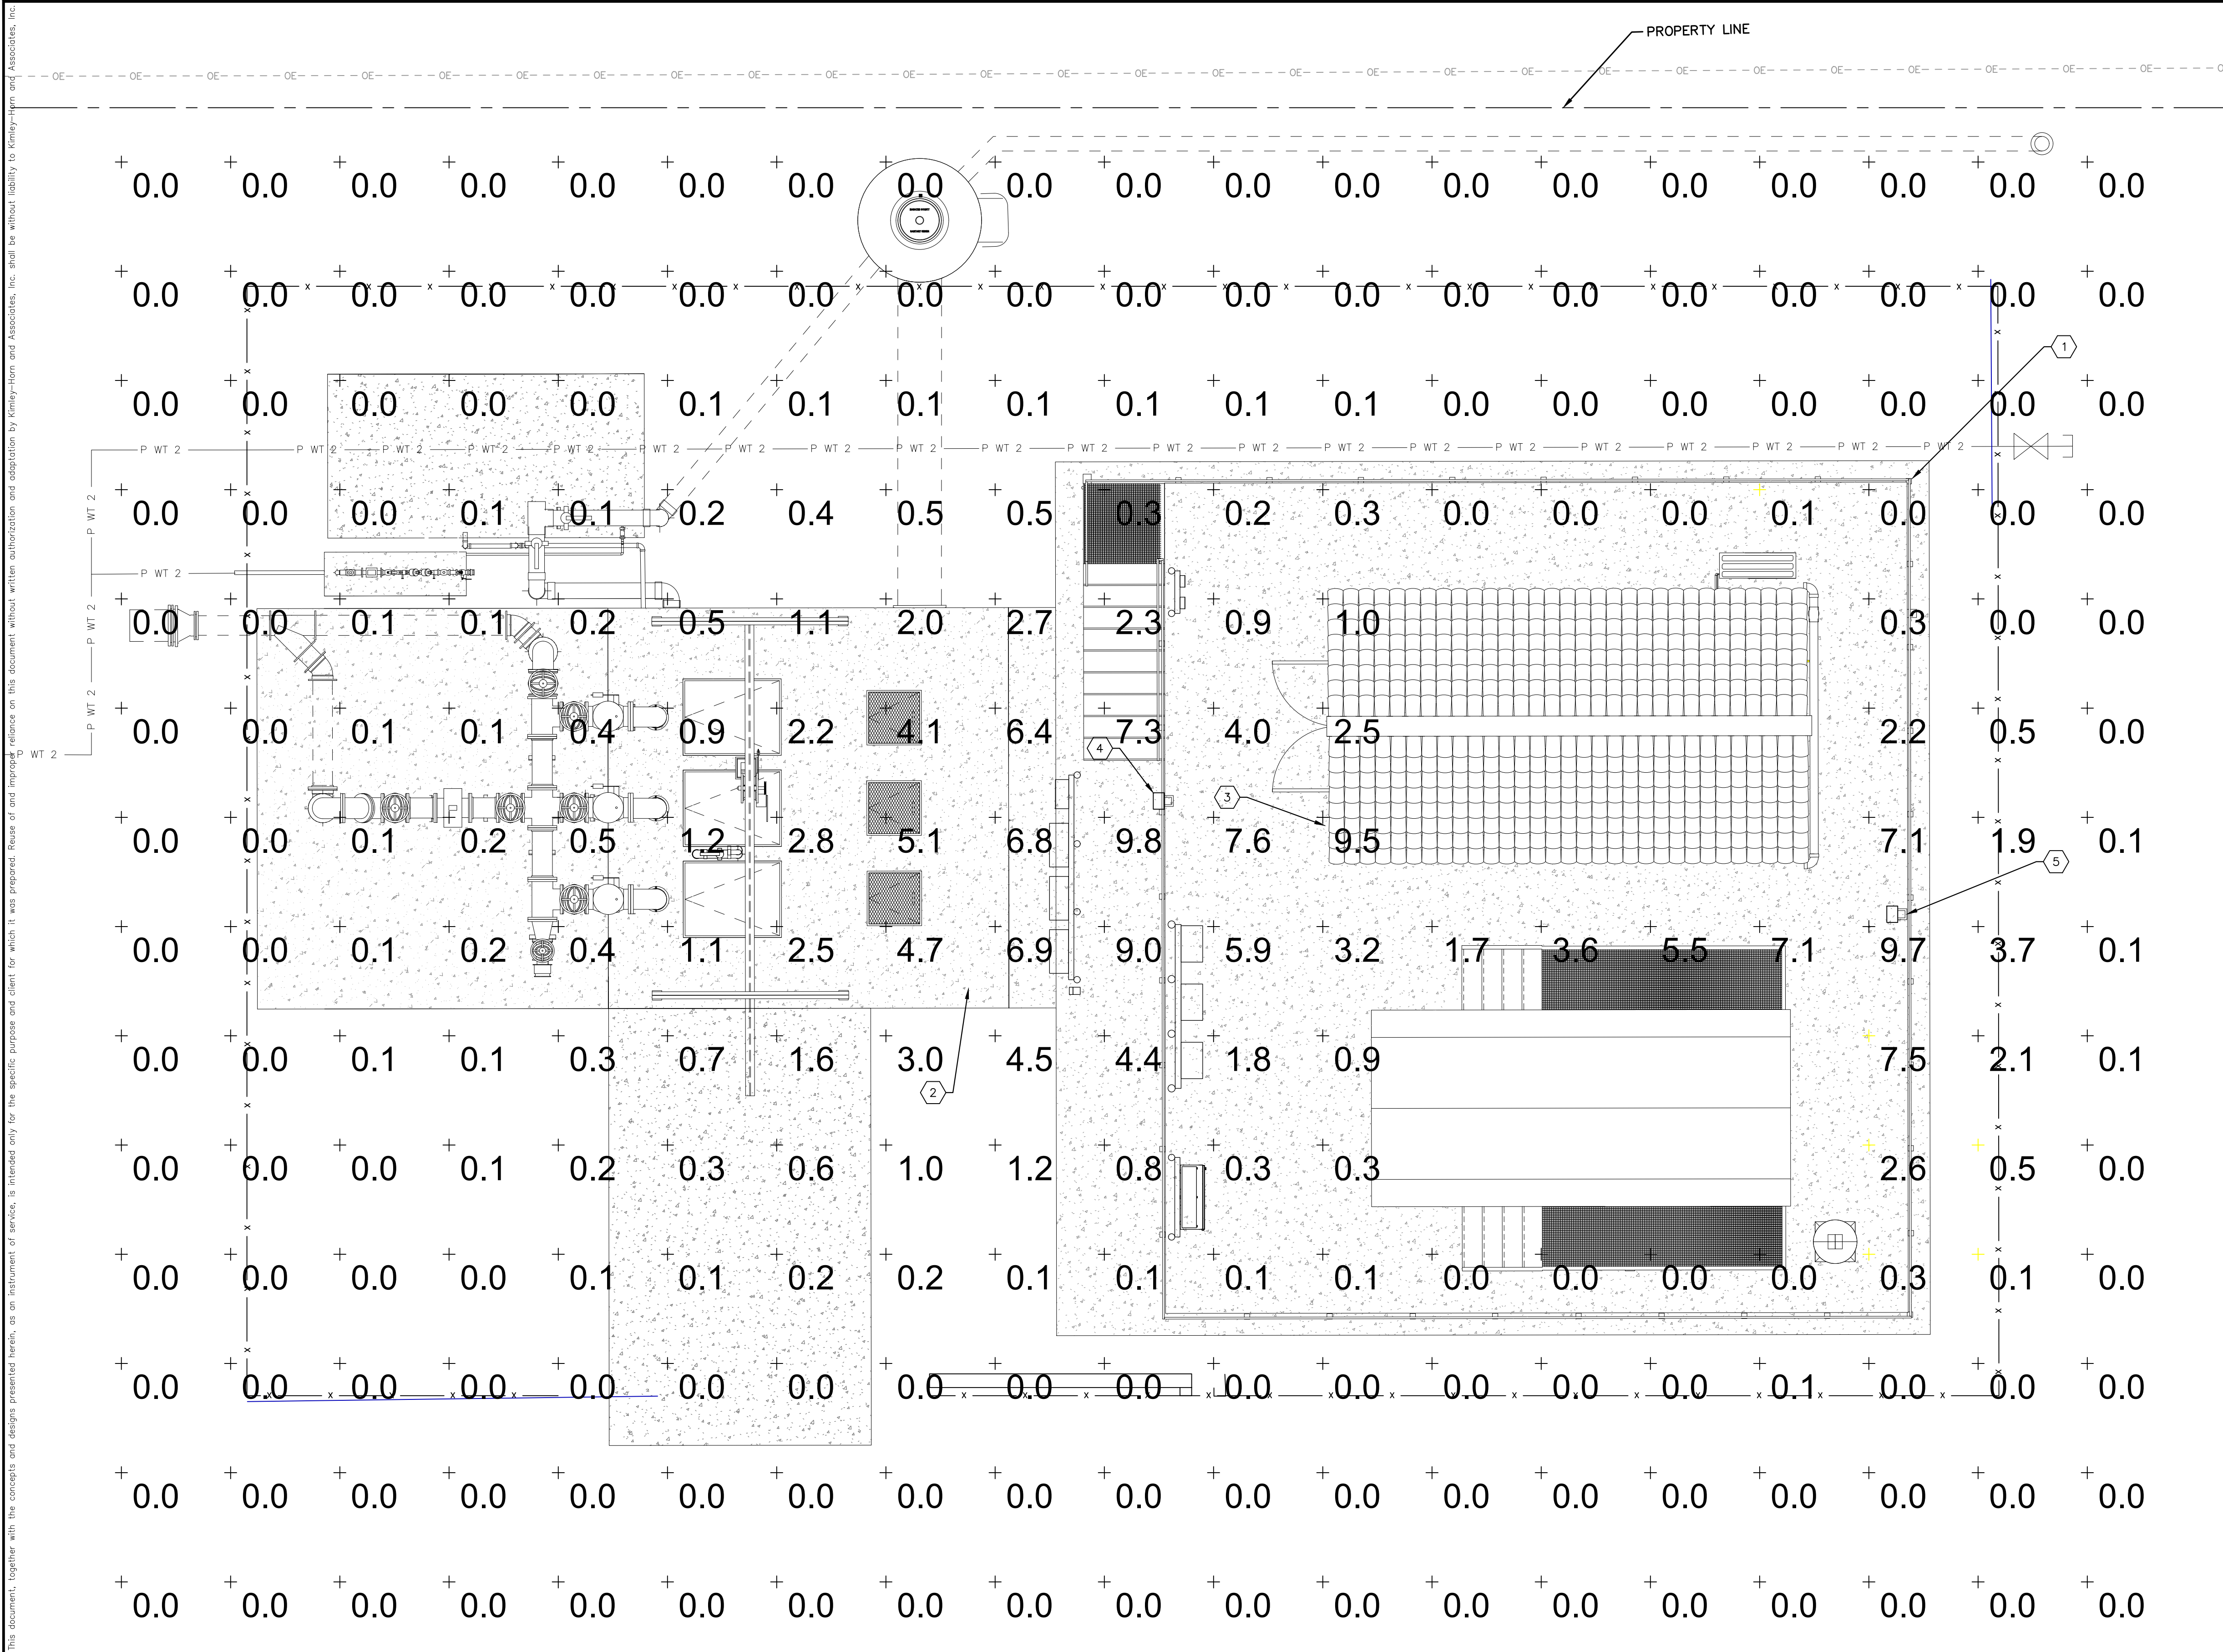
- KEYED NOTES:
- 1 PROPOSED ELEVATED SLAB.
  - 2 WET WELL SLAB AT GRADE.
  - 3 PROPOSED FIXTURE 'B'. REFER ALSO TO FIXTURE LIGHTING SCHEDULE ON SHEET E-6. FIXTURE TO BE CONTROLLED BY PHOTOCELL.
  - 4 PROPOSED FIXTURE 'C1'. REFER ALSO TO FIXTURE LIGHTING SCHEDULE ON SHEET E-6. FIXTURE TO BE CONTROLLED BY 3-WAY SWITCHES AT GATE AND WET WELL JUNCTION BOX RACK.
  - 5 PROPOSED FIXTURE 'C2'. REFER ALSO TO FIXTURE LIGHTING SCHEDULE ON SHEET E-6. FIXTURE TO BE CONTROLLED BY SWITCH WITHIN ELECTRICAL ROOM.

PHOTOMETRIC STATISTICS	
AVERAGE FOOTCANDLES	0.8fc
MAXIMUM FOOTCANDLES	9.81fc
MINIMUM FOOTCANDLES	0.0fc



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KHA PROJECT  
148400067


DATE  
OCT 2021

SCALE AS SHOWN

DESIGNED BY TDT

DRAWN BY JLT

CHECKED BY GLW



BAYSHORE YACHT BASIN FORCE MAIN  
AND LIFT STATION REPLACEMENT

MANATEE COUNTY

LICENSED PROFESSIONAL

TIMOTHY THOMAS, P.E.

FL LICENSE NUMBER  
47079

DATE:

SITE LIGHTING PLAN

SHEET NUMBER

E-3



**LIGHTNING PROTECTION SYSTEM PLAN**  
SCALE: NOT TO SCALE

- 1 EDGE OF PROPOSED ELEVATED SLAB (TYPICAL 4 SIDES).
- 2 EDGE OF PROPOSED FOUNDATION SLAB (TYPICAL 4 SIDES).
- 3 PROPOSED ELECTRICAL BUILDING.
- 4 PROPOSED STANDBY GENERATOR IN WEATHERPROOF ENCLOSURE.
- 5 ELECTRICAL EQUIPMENT RACK(S). REFER TO SHEET E-11 FOR ELEVATION AND DETAILS.
- 6 CLASS I ALUMINUM LIGHTNING CONDUCTOR RUN EXPOSED ON ROOF. FASTEN EVERY 3 FEET MAX.
- 7 PROPOSED HANDRAIL.
- 8 CONTRACTOR TO PROVIDE AND INSTALL MAIN LIGHTNING PROTECTION CONDUCTOR. INSTALL ON PROPOSED ELEVATED SLAB BEHIND PROPOSED HANDRAIL.
- 9 CONTRACTOR TO PROVIDE AND INSTALL 2/0 AWG BARE COPPER GROUNDING GRID CONDUCTOR (MINIMUM BURIAL DEPTH 24") BETWEEN ASSOCIATED GROUND RODS.
- 10 CONTRACTOR TO PROVIDE AND INSTALL LIGHTNING PROTECTION GROUND ROD IN GROUND ROD HANDHOLE. FOR TYPICAL INSTALLATION DETAIL REFER TO SHEET E-16.
- 11 CONTRACTOR TO PROVIDE AND INSTALL AIR TERMINAL. FOR TYPICAL AIR TERMINAL INSTALLATION DETAIL REFER TO SHEET E-17.
- 12 FOR TYPICAL DOWN CONDUCTOR INSTALLATION FROM ROOF, REFER TO DETAIL REFER TO SHEET E-16.
- 13 CONTRACTOR TO PROVIDE AND INSTALL HANDRAIL AIR TERMINAL. FOR TYPICAL AIR TERMINAL INSTALLATION DETAIL REFER TO SHEET E-13.
- 14 LIGHTNING PROTECTION CONDUCTOR FROM HANDRAIL CONDUCTOR SHALL BE INSTALLED DOWN PROPOSED COLUMN. INSTALLATION SHALL BE SIMILAR TO DOWN CONDUCTOR FROM ROOF.
- 15 MAIN LIGHTNING PROTECTION CONDUCTOR SHALL BE INSTALLED BELOW STAIRS IN THIS AREA.
- 16 LIGHTNING PROTECTION DOWN CONDUCTOR SHALL BE INSTALLED IN 1" PVC CONDUIT ON SIDE OF GENERATOR ENCLOSURE (LOCATION SHALL BE COORDINATED WITH DOORS OR OTHER OPENING).
- 17 LIGHTNING PROTECTION CONDUCTOR SHALL BE INSTALLED BELOW STAIRS IN THIS AREA.
- 18 CONTRACTOR TO PROVIDE AND INSTALL ALUMINUM CABLE SPLICER. THOMPSON LIGHTNING PROTECTION (TLP) A423 OR APPROVED EQUAL.
- 19 CONTRACTOR TO BOND EQUIPMENT RACK TO LIGHTNING PROTECTION SYSTEM. REFER TO DETAIL 2 ON SHEET E-17.
- 20 CONTRACTOR TO BOND STAIRS AND STAIR HANDRAIL TO LIGHTNING PROTECTION SYSTEM.
- 21 CONTRACTOR TO BOND LIGHTNING PROTECTION SYSTEM TO ELECTRICAL GROUND GRID WITH 2/0 AWG BARE COPPER CONDUCTOR. FOR CONTINUATION REFER TO SHEET E-5.
- 22 REFER TO SHEET E-15 FOR AREA LIGHT LIGHTNING PROTECTION DETAILS.


1. COORDINATE ANY LIGHTNING PROTECTION REQUIREMENTS FOR DATA FLOW SYSTEMS (DFS) ANTENNA TOWER WITH DFS.

SCALE: NOT TO SCALE

**Kimley»Horn**

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PHONE: 727-547-3999  
WWW.KIMLEY-HORN.COM CA 00000696

KHA PROJECT 148400067
DATE OCT 2021
SCALE AS SHOWN
DESIGNED BY TDT
DRAWN BY JLH
CHECKED BY GLW

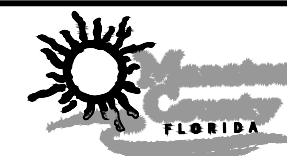

LICENSED PROFESSIONAL

---

TIMOTHY THOMAS, P.E.

FL LICENSE NUMBER  
47079

DATE:

# LIGHTNING PROTECTION SYSTEM PLAN

SHEET NUMBER

E-4





No.	REVISIONS	DATE	BY



- 1 PROPOSED ELVATED SLAB. REFER TO SHEET E-4 FOR LIGHTNING PROTECTION PLAN.
- 2 PROPOSED ELECTRICAL BUILDING.
- 3 PROPOSED 400KW GENERATOR IN WEATHERPROOF, SOUND ATTENUATED ENCLOSURE.
- 4 CONTRACTOR TO PROVIDE AND INSTALL BARE 2/0 AWG COPPER GROUNDING ELECTRODE CONDUCTOR IN 1" CONDUIT FROM GENERATOR FRAME DOWN TO GRADE LEVEL AND CONNECT TO GROUNDING GRID.
- 5 REFER TO ONE LINE DIAGRAM ON SHEET E-9 FOR ELECTRICAL SERVICE GROUNDING ELECTRODE CONDUCTOR WITHIN MOTOR CONTROL CENTER. PROVIDE AND INSTALL BARE 2/0 AWG COPPER GROUNDING ELECTRODE CONDUCTOR IN 1" CONDUIT DOWN TO GRADE LEVEL AND CONNECT TO GROUNDING GRID.
- 6 CONTRACTOR TO PROVIDE AND INSTALL NEW 3/4" X 20'-0" COPPER-CLAD GROUND ROD AND GROUND ROD TEST WELL. REFER ALSO TO GROUND ROD HANDHOLE DETAIL ON SHEET E-16. TYPICAL OF THREE (3).
- 7 CONTRACTOR TO PROVIDE AND INSTALL GROUND RING CONSISTING OF #2/0 BARE STRANDED COPPER DIRECT BURIED IN SOIL A MINIMUM OF 24" BELOW GRAVEL BASE.
- 8 CONTRACTOR TO PROVIDE AND INSTALL A #2/0 AWG BARE COPPER CONDUCTOR BETWEEN THE GROUND ROD AND THE REINFORCING STEEL EMBEDDED IN THE CONCRETE FOUNDATION (AT GRADE LEVEL). PROVIDE A MINIMUM OF 30 FEET OF CONDUCTOR LENGTH.
- 9 EMBEDDED GROUNDING ELECTRODE CONDUCTOR SHALL BE ATTACHED TO REINFORCING STEEL VIA MECHANICAL REBAR BONDING CLAMP. CONNECTIONS TO REBAR SHALL BE MADE AT 5 FOOT INTERVALS.
- 10 CONTRACTOR TO BOND ELECTRICAL GROUND GRID TO LIGHTNING PROTECTION SYSTEM WITH 2/0 AWG BARE COPPER CONDUCTOR. FOR CONTINUATION REFER TO LIGHTNING PROTECTION DRAWING ON SHEET E-4.
- 11 INDICATES ITEM TO BE INSTALLED AT GROUND LEVEL.
- 12 PROPOSED DFS TOWER. REFER TO SHEET I-16 FOR DETAILS.
- 13 CONTRACTOR TO PROVIDE AND INSTALL BARE 1/0 AWG COPPER GROUNDING ELECTRODE CONDUCTOR IN 1" CONDUIT FROM DFS TOWER DOWN TO GRADE LEVEL AND CONNECT TO GROUNDING GRID.

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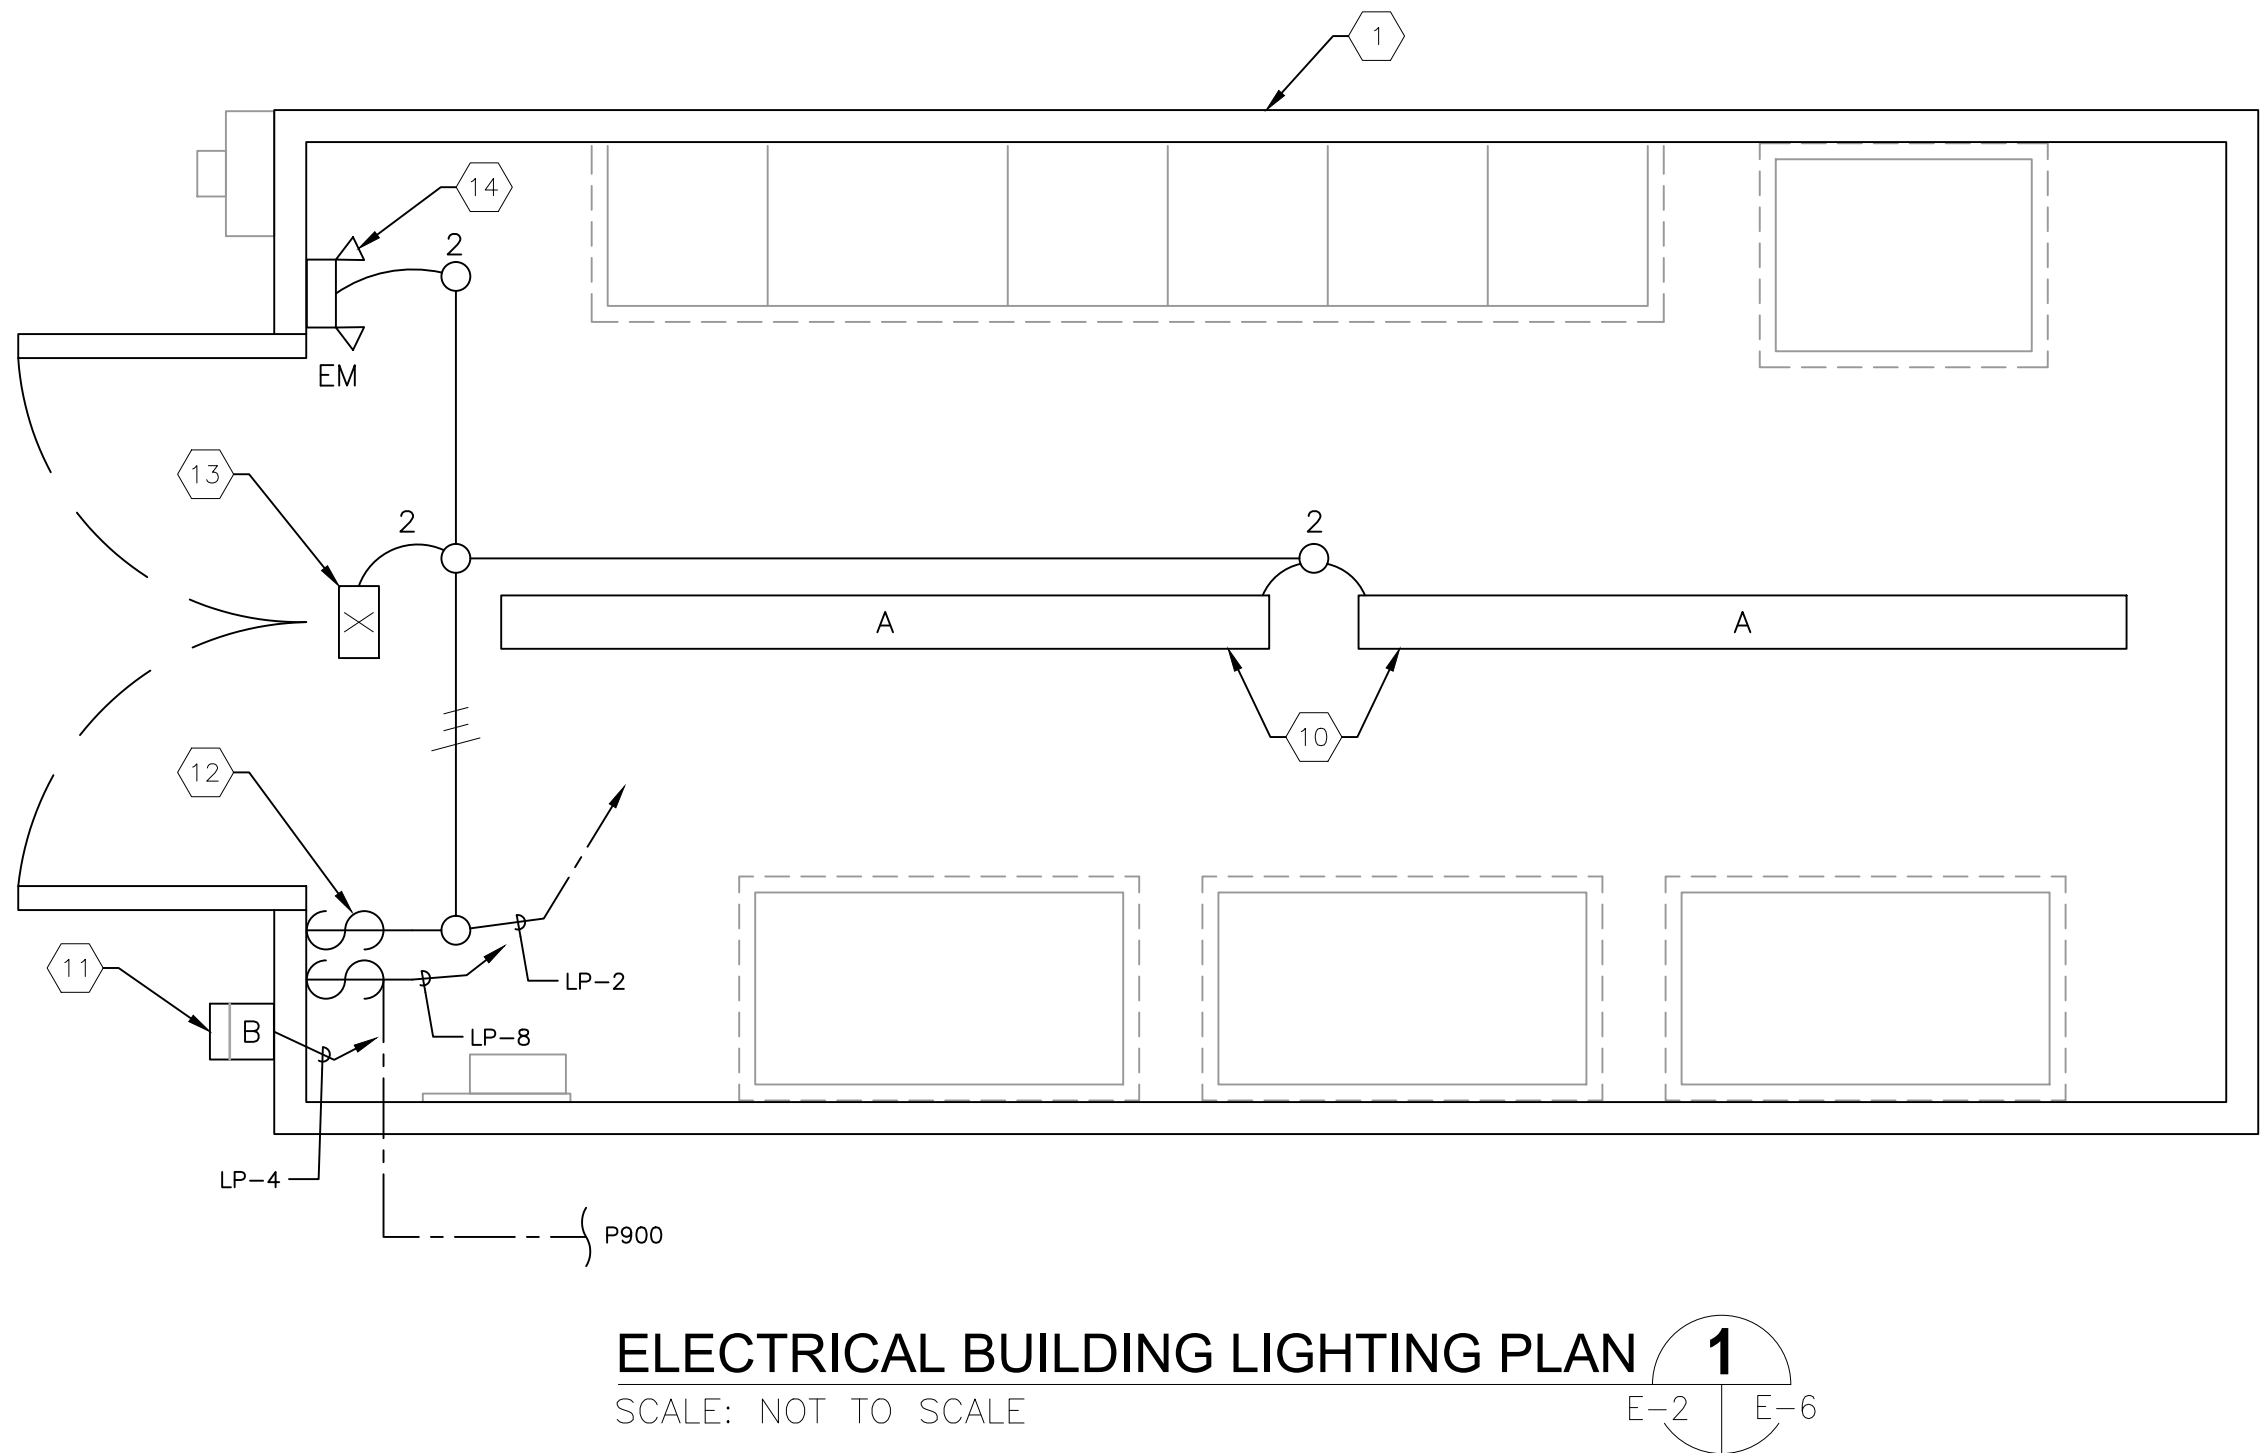
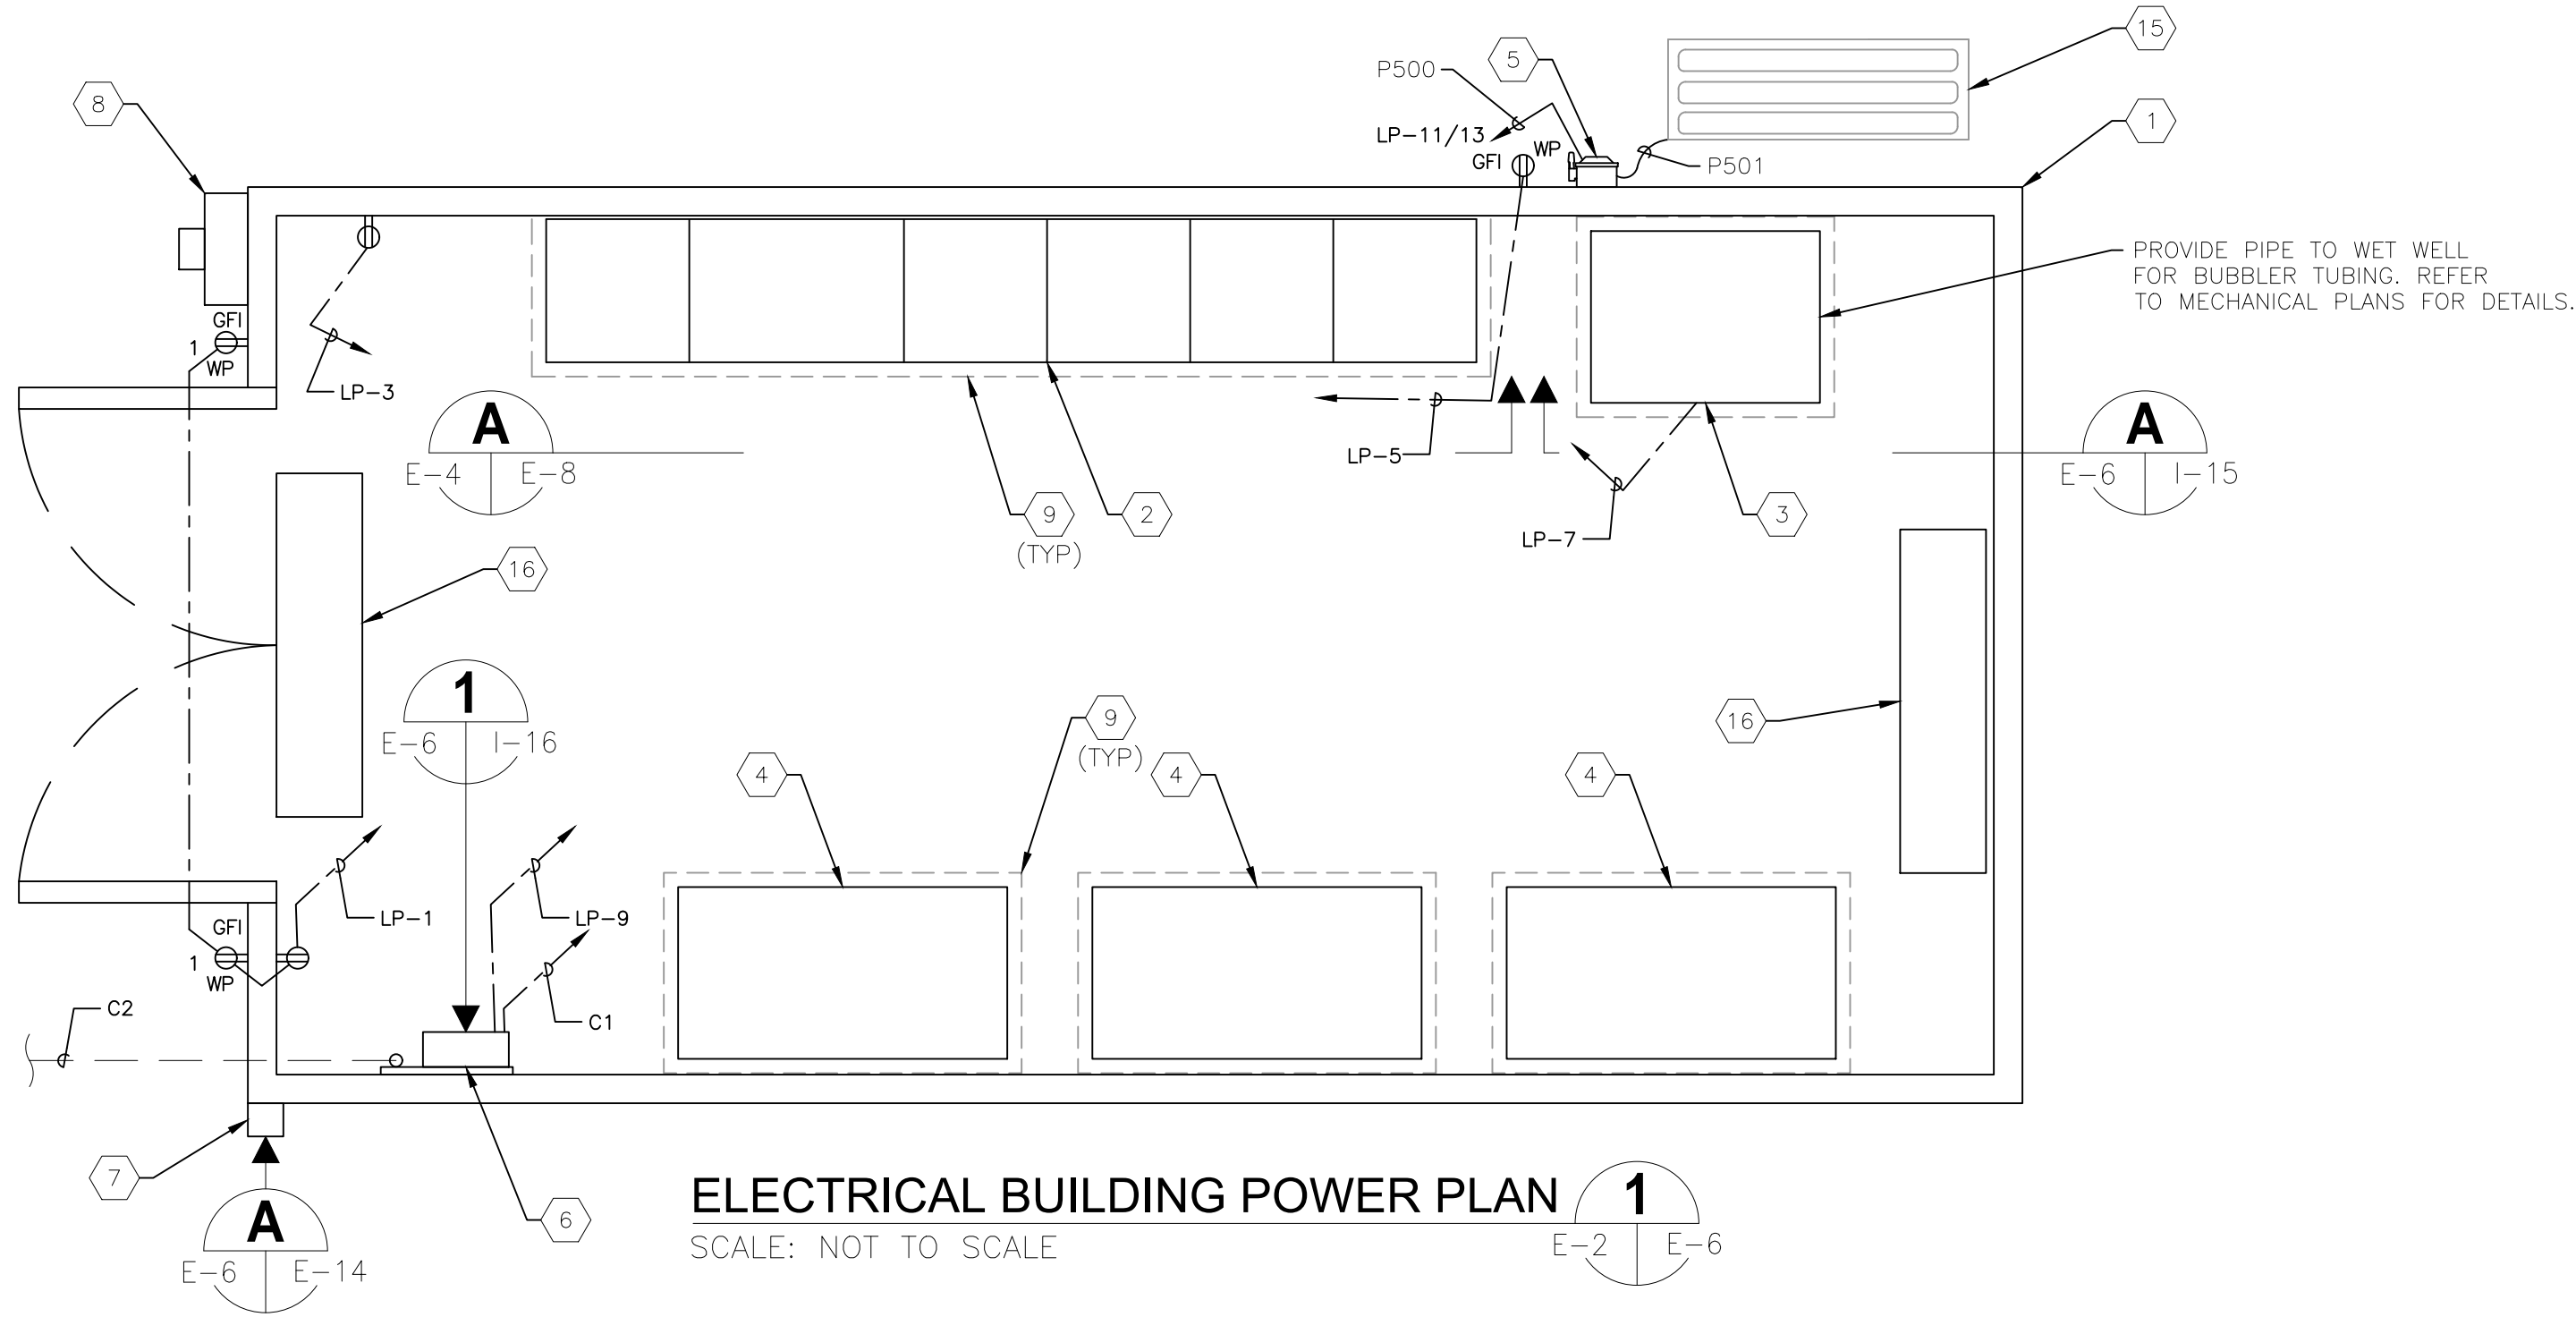
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KEYED NOTES:

- 1

PROPOSED ELECTRICAL BUILDING.
- 2

PROPOSED 277/480V, 600A, MOTOR CONTROL CENTER WITH INTEGRAL 600A AUTOMATIC TRANSFER SWITCH (ATS). REFER TO SHEET E-8.
- 3

PROPOSED DATA FLOW SYSTEMS (DFS) TCU/VFD PANEL TO BE PROVIDED. REFER ALSO TO INSTRUMENTATION DRAWING SHEET I-15.
- 4

PROPOSED 100HP VARIABLE FREQUENCY DRIVE (VFD). FUGI MEGA DRIVE TO BE PROVIDED.
- 5

PROPOSED 60A, 600V, 3-POLE NON-FUSED DISCONNECT IN NEMA 4X STAINLESS STEEL ENCLOSURE FOR HVAC UNIT DISCONNECTING MEANS.
- 6

PROPOSED FLOW METER TRANSMITTER. REFER TO DETAIL ON SHEET I-16.
- 7

PROPOSED EMERGENCY GENERATOR SHUTDOWN PUSHBUTTON STATION. REFER TO DETAIL ON SHEET E-14.
- 8

PROPOSED CT METER LOCATION. COORDINATE CT METER REQUIREMENTS WITH DUKE ENERGY. COORDINATE LOCATION WITH FPL.
- 9

PROVIDE 2" HIGH CONCRETE HOUSEKEEPING PAD FOR ALL FLOOR MOUNTED EQUIPMENT. HOUSEKEEPING PADS SHALL EXTEND AROUND EQUIPMENT 2".
- 10

PROVIDE AND INSTALL NEW 8' LED LIGHT FIXTURE. REFER TO FIXTURE SCHEDULE ON THIS SHEET.
- 11

PROVIDE AND INSTALL NEW WALLPACK LIGHT FIXTURE. REFER TO FIXTURE SCHEDULE ON THIS SHEET. CIRCUIT LP-4.
- 12

PROVIDE AND INSTALL TWO (2) SINGLE-POLE, 120/277V, 20A SWITCHES IN A TWO-GANG, ALUMINUM FS JUNCTION BOX. PROVIDE BRUSHED ALUMINUM DEVICE PLATE.
- 13

PROVIDE AND INSTALL NEW LED EXIT SIGN ABOVE DOOR. COORDINATE ELEVATION WITH HVAC EQUIPMENT. REFER TO FIXTURE SCHEDULE ON THIS SHEET.
- 14

PROVIDE AND INSTALL NEW LED EMERGENCY LIGHTING FIXTURE. REFER TO FIXTURE SCHEDULE ON THIS SHEET.
- 15

HVAC UNIT (MINI SPLIT SYSTEM CONDENSING UNIT).
- 16

HVAC AIR HANDLER, POWER DERIVED FROM CONDENSING UNIT. COORDINATE POWER WIRING WITH MINI SPLIT SYSTEM SUPPLIER.

GENERAL NOTES:

1. NOT ALL CONDUIT AND CONDUCTORS SHOWN FOR CLARITY. REFER TO OTHER SHEETS FOR ADDITIONAL REQUIREMENTS.
2. CONDUIT ROUTING SHOWN IS DIAGRAMMATICAL. CONTRACTOR MAY FIELD ROUTE CONDUCTORS BASED ON FIELD CONDITIONS WHILE COMPLYING WITH THE NATIONAL ELECTRICAL CODE FOR MAXIMUM NUMBER OF BENDS.

LIGHTING FIXTURE SCHEDULE

TYPE	MANUFACTURER	CATALOG NUMBER	LAMP(S)	VOLTS	MOUNTING	REMARKS
A	COLUMBIA	LXEM8-SOMLRA-EU	(1) 84W DRIVER	120	CEILING	LED STRIP FIXTURE.
B	LITHONIA	TWS LED P1 50K MVOLT PE DDB	(1) 36W DRIVER	120	WALL	MOUNT AT 7'-0" TO BOTTOM OF FIXTURE.
C1	LITHONIA	DSXF1 LED P1 40K FL MVOLT IS DDBXD	(1) 21W LED	120	POLE	MOUNT ON ELEVATED SLAB AT 12'-0" ABOVE SLAB. AIM WITH 20° TILT. PROVIDE ADJUSTABLE SLIPFITTER FOR 2-3/8" O.D. TENNON.
C1P	LITHONIA	SSA 12 4C T20 UL NEC DDBXD				12'-0" SQUARE ALUMINUM POLE FOR C1. PROVIDE 2-3/8" TENON MOUNT, HANDHOLE COVER AND FULL BASE COVER.
C2	LITHONIA	DSXF1 LED P1 40K FL MVOLT IS DDBXD	(1) 21W LED	120	POLE	MOUNT ON ELEVATED SLAB AT 12'-0" ABOVE SLAB. AIM WITH 20° TILT. PROVIDE ADJUSTABLE SLIPFITTER FOR 2-3/8" O.D. TENNON.
C2P	LITHONIA	SSA 16 4C T20 UL NEC DDBXD				16'-0" SQUARE ALUMINUM POLE FOR C2. PROVIDE 2-3/8" TENON MOUNT, HANDHOLE COVER AND FULL BASE COVER.
EM	LITHONIA	ELM2 LED	(2) 1.6 W LED	120/277	WALL	LED EMERGENCY LIGHT
X	LITHONIA	LQMP3R120/277ELN	(1) 1W DRIVER	120/277	UNIVERSAL	LED EXIT SIGN WITH NICKEL CADMIUM BATTERY BACKUP

ELECTRICAL BUILDING INTERIOR PHOTOMETRICS

SCALE: NOT TO SCALE

PHOTOMETRIC STATISTICS

AVERAGE FOOTCANDLES	40.1fc	MAX/MIN RATIO: 2.4/1
MAXIMUM FOOTCANDLES	54.1fc	AVE/MIN RATIO: 1.8/1
MINIMUM FOOTCANDLES	22.5fc	

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DATE	OCT 2021
SCALE	AS SHOWN
DESIGNED BY	TDI
DRAWN BY	JLH
CHECKED BY	GLW



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ELECTRICAL BUILDING  
POWER AND LIGHTING PLANS


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GENERATOR DETAILS 1  
SCALE: NO TO SCALE E-2 E-7

- KEYED NOTES:
- 1 NEW 480V, 400 KW GENERATOR IN WEATHER-PROOF, SOUND ATTENUATED ENCLOSURE. REFER ALSO TO SPECIFICATIONS.
  - 2 60 AMPERE FUSED DISCONNECT SWITCH PROVIDED AND INSTALLED AS PART OF THE ENCLOSURE PACKAGE.
  - 3 100 AMPERE, 120/208V, 3Ø, MCB LOADCENTER PROVIDED AND INSTALLED AS PART OF THE ENCLOSURE PACKAGE.
  - 4 25 KVA, 480V-120/208V, 3Ø, TRANSFORMER PROVIDED, INSTALLED AND GROUNDED PER NEC AS PART OF THE ENCLOSURE PACKAGE. TRANSFORMER LOCATED ABOVE DISCONNECT AND LOADCENTER.
  - 5 DUAL LED LIGHT FIXTURE PROVIDED AND INSTALLED AS PART OF THE ENCLOSURE PACKAGE.
  - 6 3-WAY SWITCHES PROVIDED AND INSTALLED AS PART OF THE ENCLOSURE PACKAGE.
  - 7 DC LIGHT FIXTURES PROVIDED AND INSTALLED AS PART OF THE ENCLOSURE PACKAGE.
  - 8 60 MINUTE TIMER SWITCHES FOR DC LIGHT FIXTURES PROVIDED AND INSTALLED AS PART OF THE ENCLOSURE PACKAGE.
  - 9 20A, 125V DUPLEX GFCI RECEPTACLE PROVIDED AND INSTALLED AS PART OF THE ENCLOSURE PACKAGE.
  - 10 STUBUP LOCATION FOR 480V FEEDER CIRCUIT, GENERATOR STARTER CIRCUIT, GENERATOR SHUT DOWN AND SCADA I/O. COORDINATE/VERIFY EXACT LOCATION WITH ENCLOSURE MANUFACTURER.
  - 11 PROVIDE AND INSTALL 12-#12 THWN CU + 1-#12 THWN CU GND IN 1" CONDUIT TO DFS TCU/VFD CABINET FOR SCADA MONITORING OF GENERATOR. 2-#12 FOR GENERATOR RUNNING INDICATION, 2-#12 FOR GENERATOR FAIL, 2-#12 FOR GENRATOR IN AUTO, 2-#12 FOR GENERATOR IN HAND INDICATION AND 4-#12 SPARE (C400).
  - 12 PROVIDE AND INSTALL 4-#12 THWN CU + 1-#12 THWN CU GND IN 1" CONDUIT TO AUTOMATIC TRANSFER SWITCH FOR GENERATOR START SIGNAL. CONTRACTOR TO COORDINATE/VERIFY GENERATOR STARTER CONTROL REQUIREMENTS WITH GENERATOR AND TRANSFER SWITCH MANUFACTURERS (C401).
  - 13 PROVIDE AND INSTALL 2-#12 THWN CU + 1-#12 THWN CU GND IN 1" CONDUIT TO NEW EMERGENCY SHUT DOWN PUSH BUTTON STATION FOR SHUT DOWN SIGNAL (C404).
  - 14 PROVIDE AND INSTALL TWO (2) PARALLEL RUNS CONSISTING OF 3-350 kcmil THWN CU + 1-#1 THWN CU GND IN 3" CONDUIT (P003A, P003B).
  - 15 PROVIDE AND INSTALL 3-#8 THWN CU + 1-#10 THWN CU GND IN 1-1/4" CONDUIT TO NEW MCC FEEDER CIRCUIT BREAKER FOR 480V ANCILLARY EQUIPMENT FEEDER CIRCUIT (P400).
  - 16 CONTRACTOR TO PROVIDE AND INSTALL #2/0 BARE STRANDED COPPER. BOND TO GENERATOR FRAME. INSTALL BONDING CONDUCTOR IN 1" CONDUIT AND CONTINUE TO ELECTRIC GROUND GRID. REFER ALSO TO SHEET E-5.
  - 17 REFER TO SHEET E-5 FOR CONTINUATION.
  - 18 FOR CONTINUATION REFER ONE LINE DIAGRAM OR REFER TO CONDUIT AND CABLE SCHEDULE.
  - 19 PROVIDE AND INSTALL 10-#12 THWN CU + 1-#12 THWN CU GND IN 1" CONDUIT TO NEW DFS TCU/VFD FOR SCADA MONITORING OF BASE TANK. 2-#12 BASE TANK LEAK DETECTION ALARM, 2-#12 FOR BASE TANK FUEL LOW LEVEL ALARM, 2-#12 FOR BASE TANK FUEL HIGH LEVEL ALARM AND 4-#12 SPARE. CONTRACTOR SHALL COORDINATE/VERIFY CONNECTION LOCATION AND TYPE WITH ENCLOSURE MANUFACTURER (P402).
  - 20 PROVIDE AND INSTALL 2/C-#16 SHIELDED (BELDEN 8719) IN 1" CONDUIT TO NEW DFS TCU/VFD FOR SCADA MONITORING OF BASE TANK LEVEL. CONTRACTOR SHALL COORDINATE/VERIFY CONNECTION LOCATION AND TYPE WITH ENCLOSURE MANUFACTURER (P403).

- GENERAL NOTES :
- 1. THIS DRAWING SHOWS LAYOUTS AND DIMENSIONS BASED ON A PARTICULAR MANUFACTURER. THE CONTRACTOR SHALL COORDINATE DIMENSIONS, STUBUP LOCATIONS AND EQUIPMENT LOCATIONS WITH THE MANUFACTURER SUBMITTED/PROVIDED.
  - 2. THE GENERATOR ENCLOSURE SHALL BE PROVIDED WITH A 60 AMPERE DISCONNECT SWITCH, 120/208V, 3Ø, MCB LOADCENTER, 25 KVA, 480V-120/208V, 3Ø, TRANSFORMER, LED LIGHTING FIXTURES, 3-WAY SWITCHES, DC LIGHTING FIXTURES, 60 MINUTE TIMER SWITCHES FOR DC LIGHT FIXTURES, DUPLEX GFCI RECEPTACLES, BASE TANK, BASE TANK SUPPLY AND RETURN PUMPS AND BASE TANK CONTROLLER AS NOTED AND SPECIFIED. ALL EQUIPMENT PROVIDED BY THE SUPPLIER OF THE ENCLOSURE PACKAGE SHALL BE PROVIDED AND INSTALLED WITH ALL ASSOCIATED CONDUIT AND CONDUCTORS FOR POWER AND CONTROLS AS REQUIRED FOR A COMPLETE AND FUNCTIONING UNIT.

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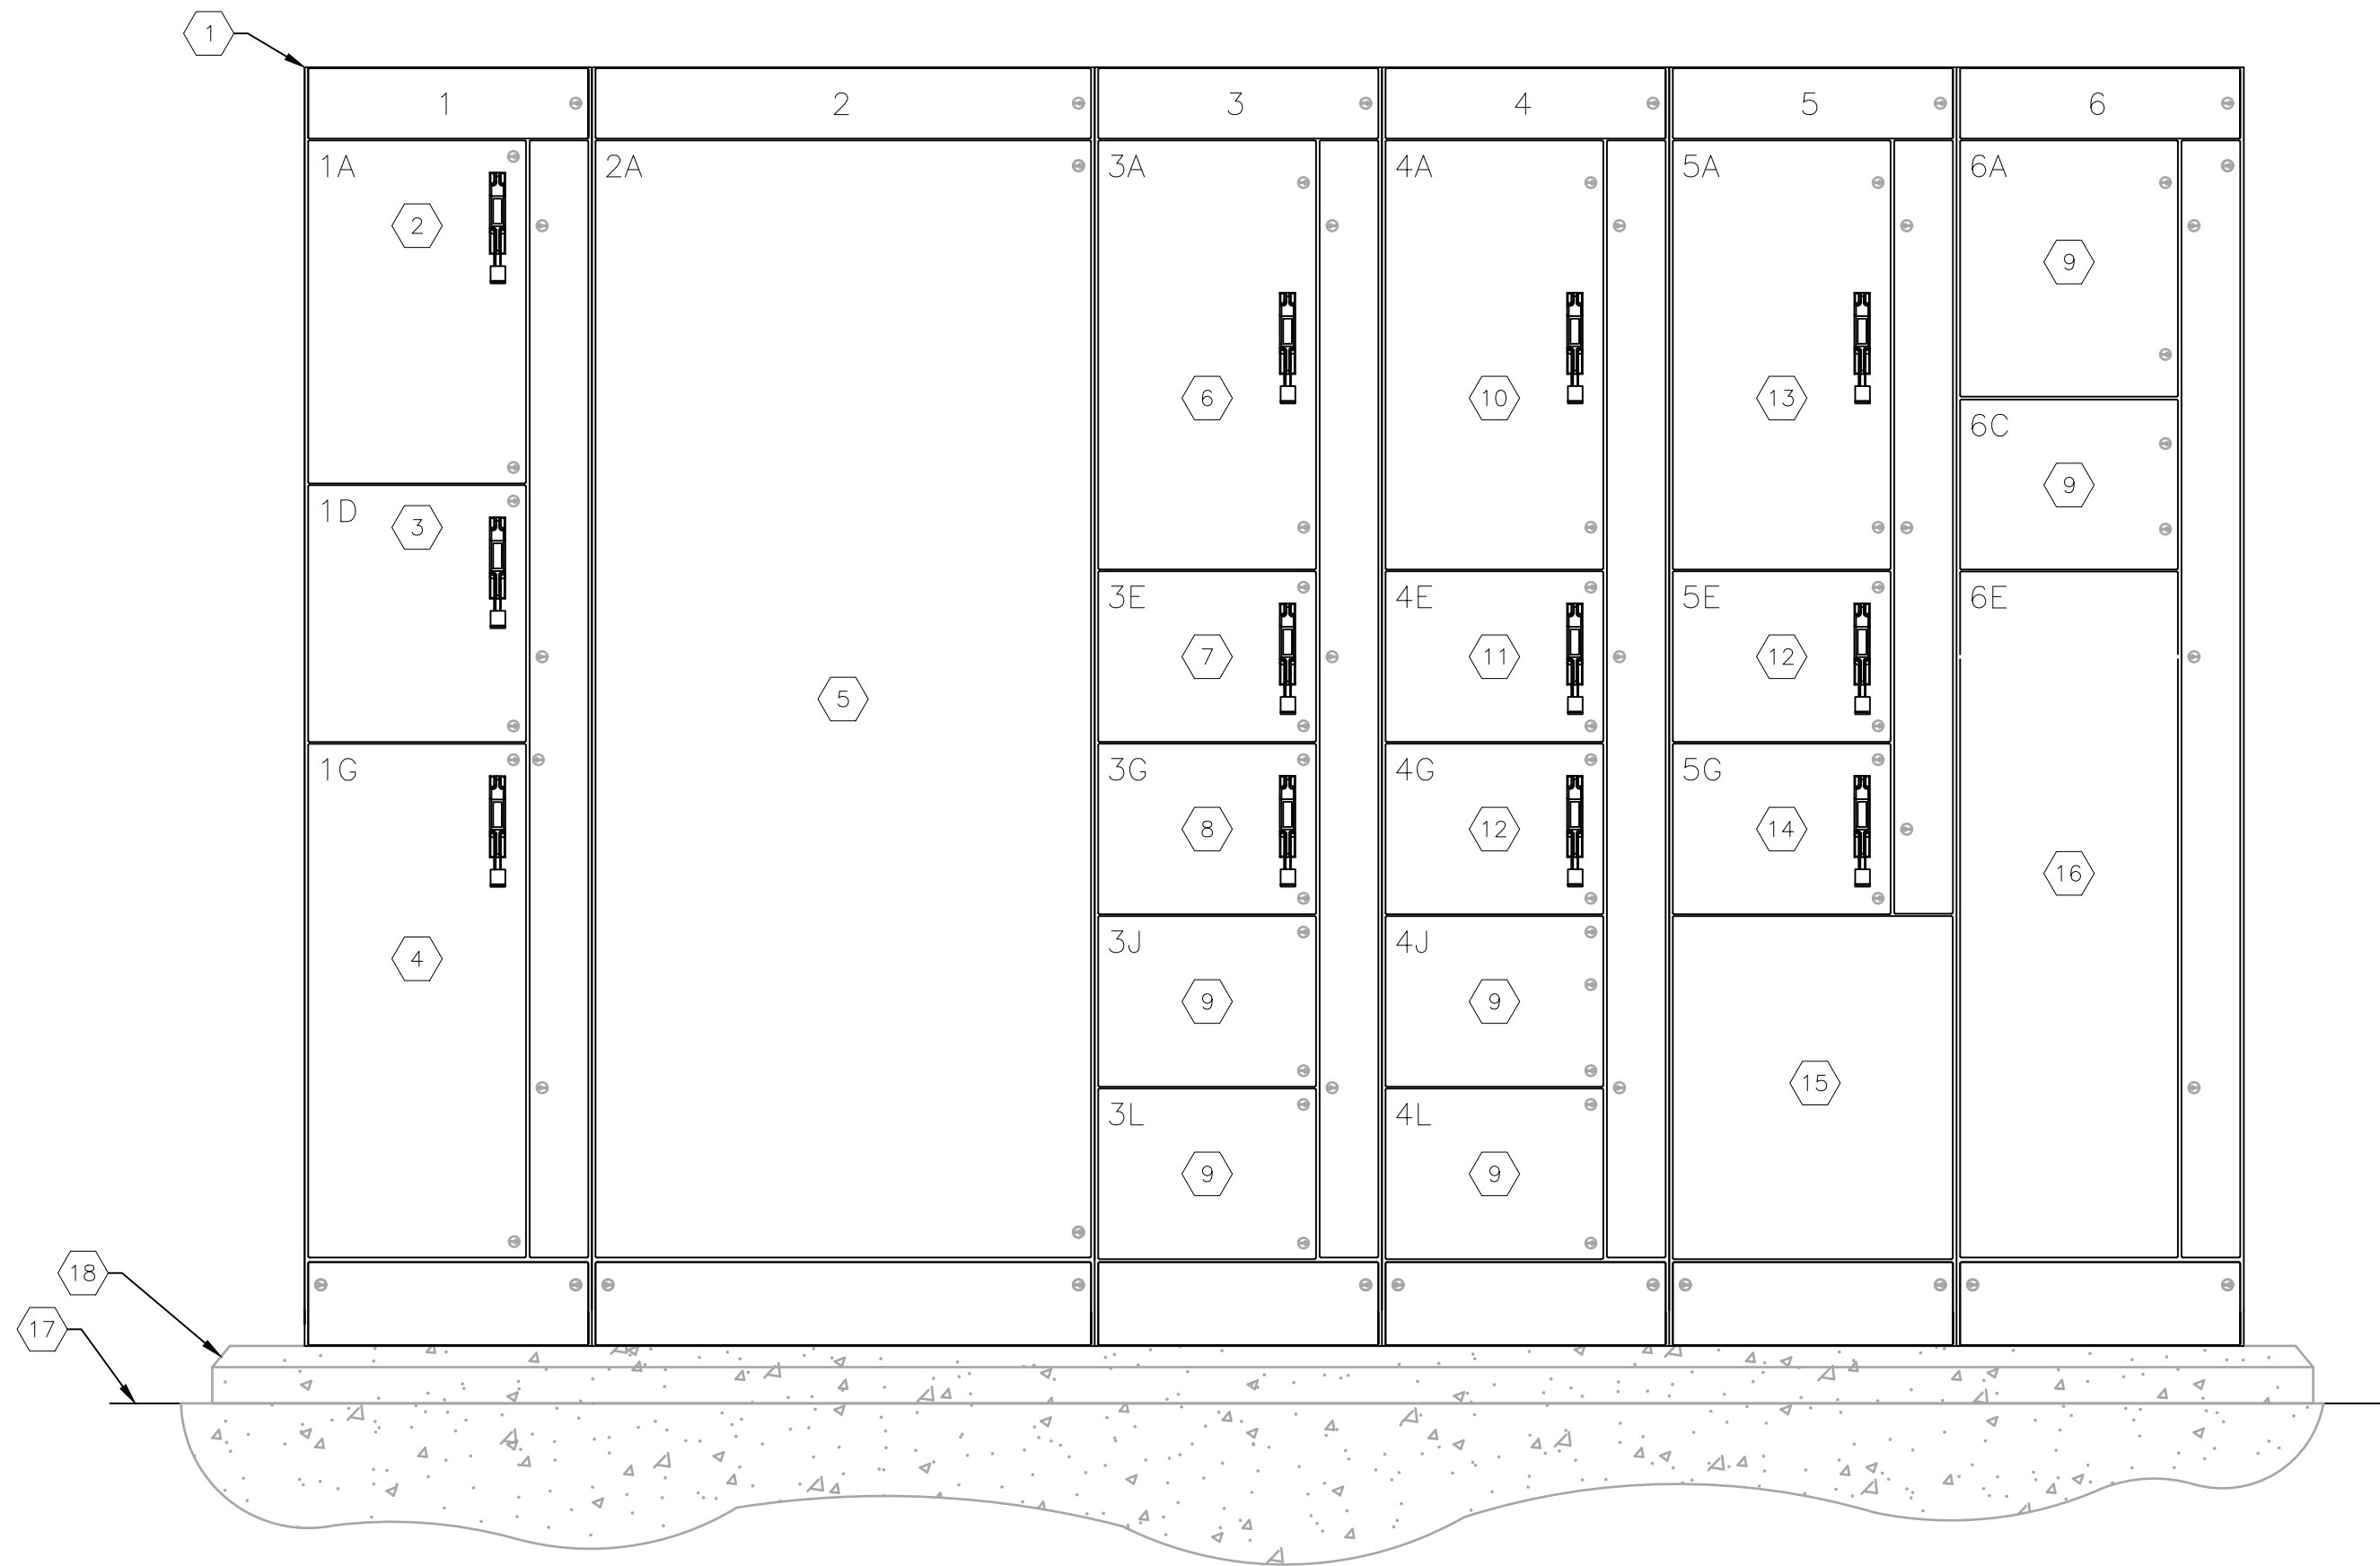
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GENERATOR DETAILS
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SHEET NUMBER
E-7

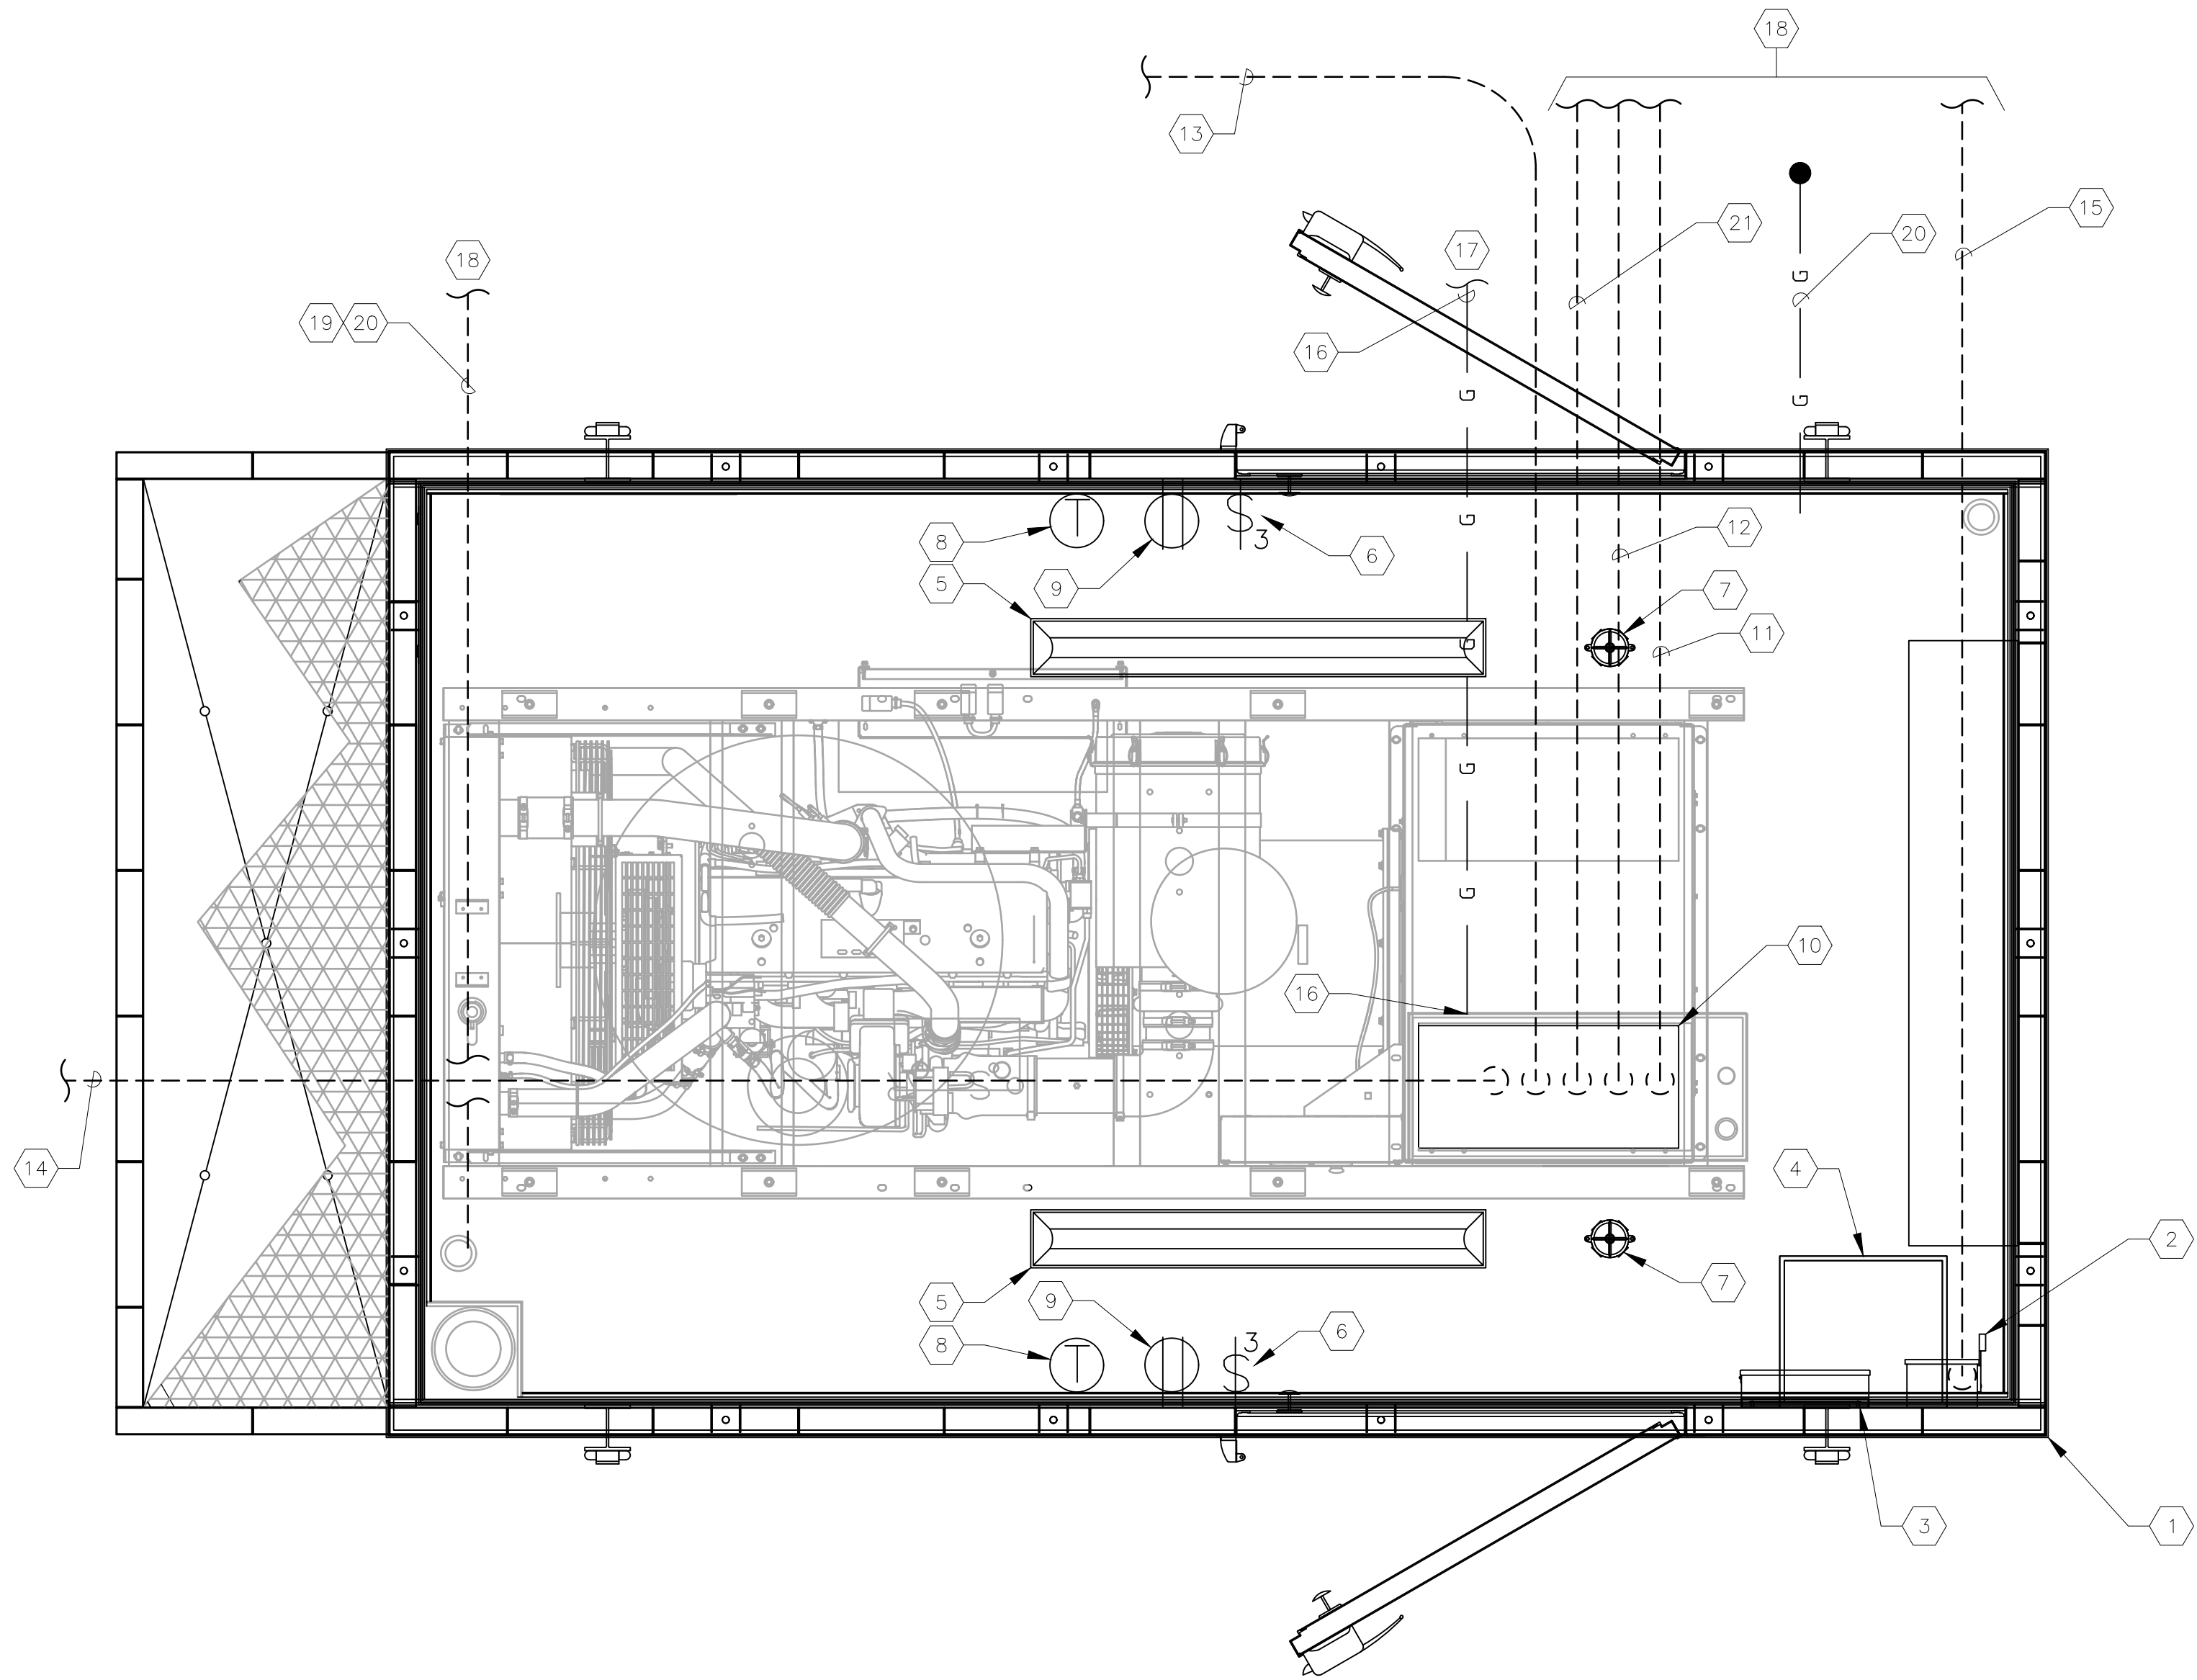


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MOTOR CONTROL SYSTEM ELEVATION

SCALE: NOT TO SCALE



KEYED NOTES:

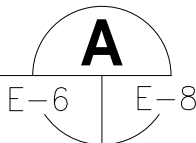- NEW ARC FLASH COMPLIANT MOTOR CONTROL CENTER: 'MCC-1'. REFER TO ONE-LINE DIAGRAM ON SHEET E-9 FOR REQUIREMENTS.
- 480V, 3-POLE, 30A CIRCUIT BREAKER FOR SURGE PROTECTION DEVICE (SPD). DISCONNECTING MEANS. SPD TO BE ASCO 450277YP20ACCN20.
- 480V, 3-POLE, 30A CIRCUIT BREAKER DISCONNECT FOR VOLTAGE AND PHASE MONITOR RELAYS. PROVIDE CT'S, CTP'S AND FUSES AS REQUIRED.
- 480V, 600A, 3-POLE MAIN CIRCUIT BREAKER.
- 480V, 600A, 3-POLE, SOLID NEUTRAL AUTOMATIC TRANSFER SWITCH (ATS).
- 200A, 3-POLE, 480V CIRCUIT BREAKER FOR NEW WET WELL PUMP #1.
- 20A, 3-POLE, 480V CIRCUIT BREAKER FOR ODOR CONTROL UNIT.
- 50A, 3-POLE, 480V CIRCUIT BREAKER FOR GENERATOR ANOILLARY EQUIPMENT.
- PREPARED SPACE FOR FUTURE USE.
- 200A, 3-POLE, 480V CIRCUIT BREAKER FOR NEW WET WELL PUMP #2.
- 15A, 3-POLE, 480V CIRCUIT BREAKER FOR CRANE HOIST.
- 20A, 3-POLE, 480V CIRCUIT BREAKER FOR FUTURE USE.
- 200A, 3-POLE, 480V CIRCUIT BREAKER FOR NEW WET WELL PUMP #3.
- 70A, 3-POLE, 480V CIRCUIT BREAKER FOR 45 KVA TRANSFORMER 'T-1' (KEYED NOTE #4).
- 480V-120/208V, 3 $\phi$ , 45 KVA TRANSFORMER 'T-1'.
- 125A MAIN CIRCUIT BREAKER, 120/208V, 3 $\phi$ , 4-WIRE, 42 POLE PANELBOARD 'LP'.
- FINISHED FLOOR OF PROPOSED ELECTRICAL BUILDING.
- PROVIDE NEW 2" HIGH CONCRETE HOUSEKEEPING PAD WITH 45° CHAMFERED EDGES. HOUSEKEEPING PADS SHALL EXTEND 2" BEYOND MCC.



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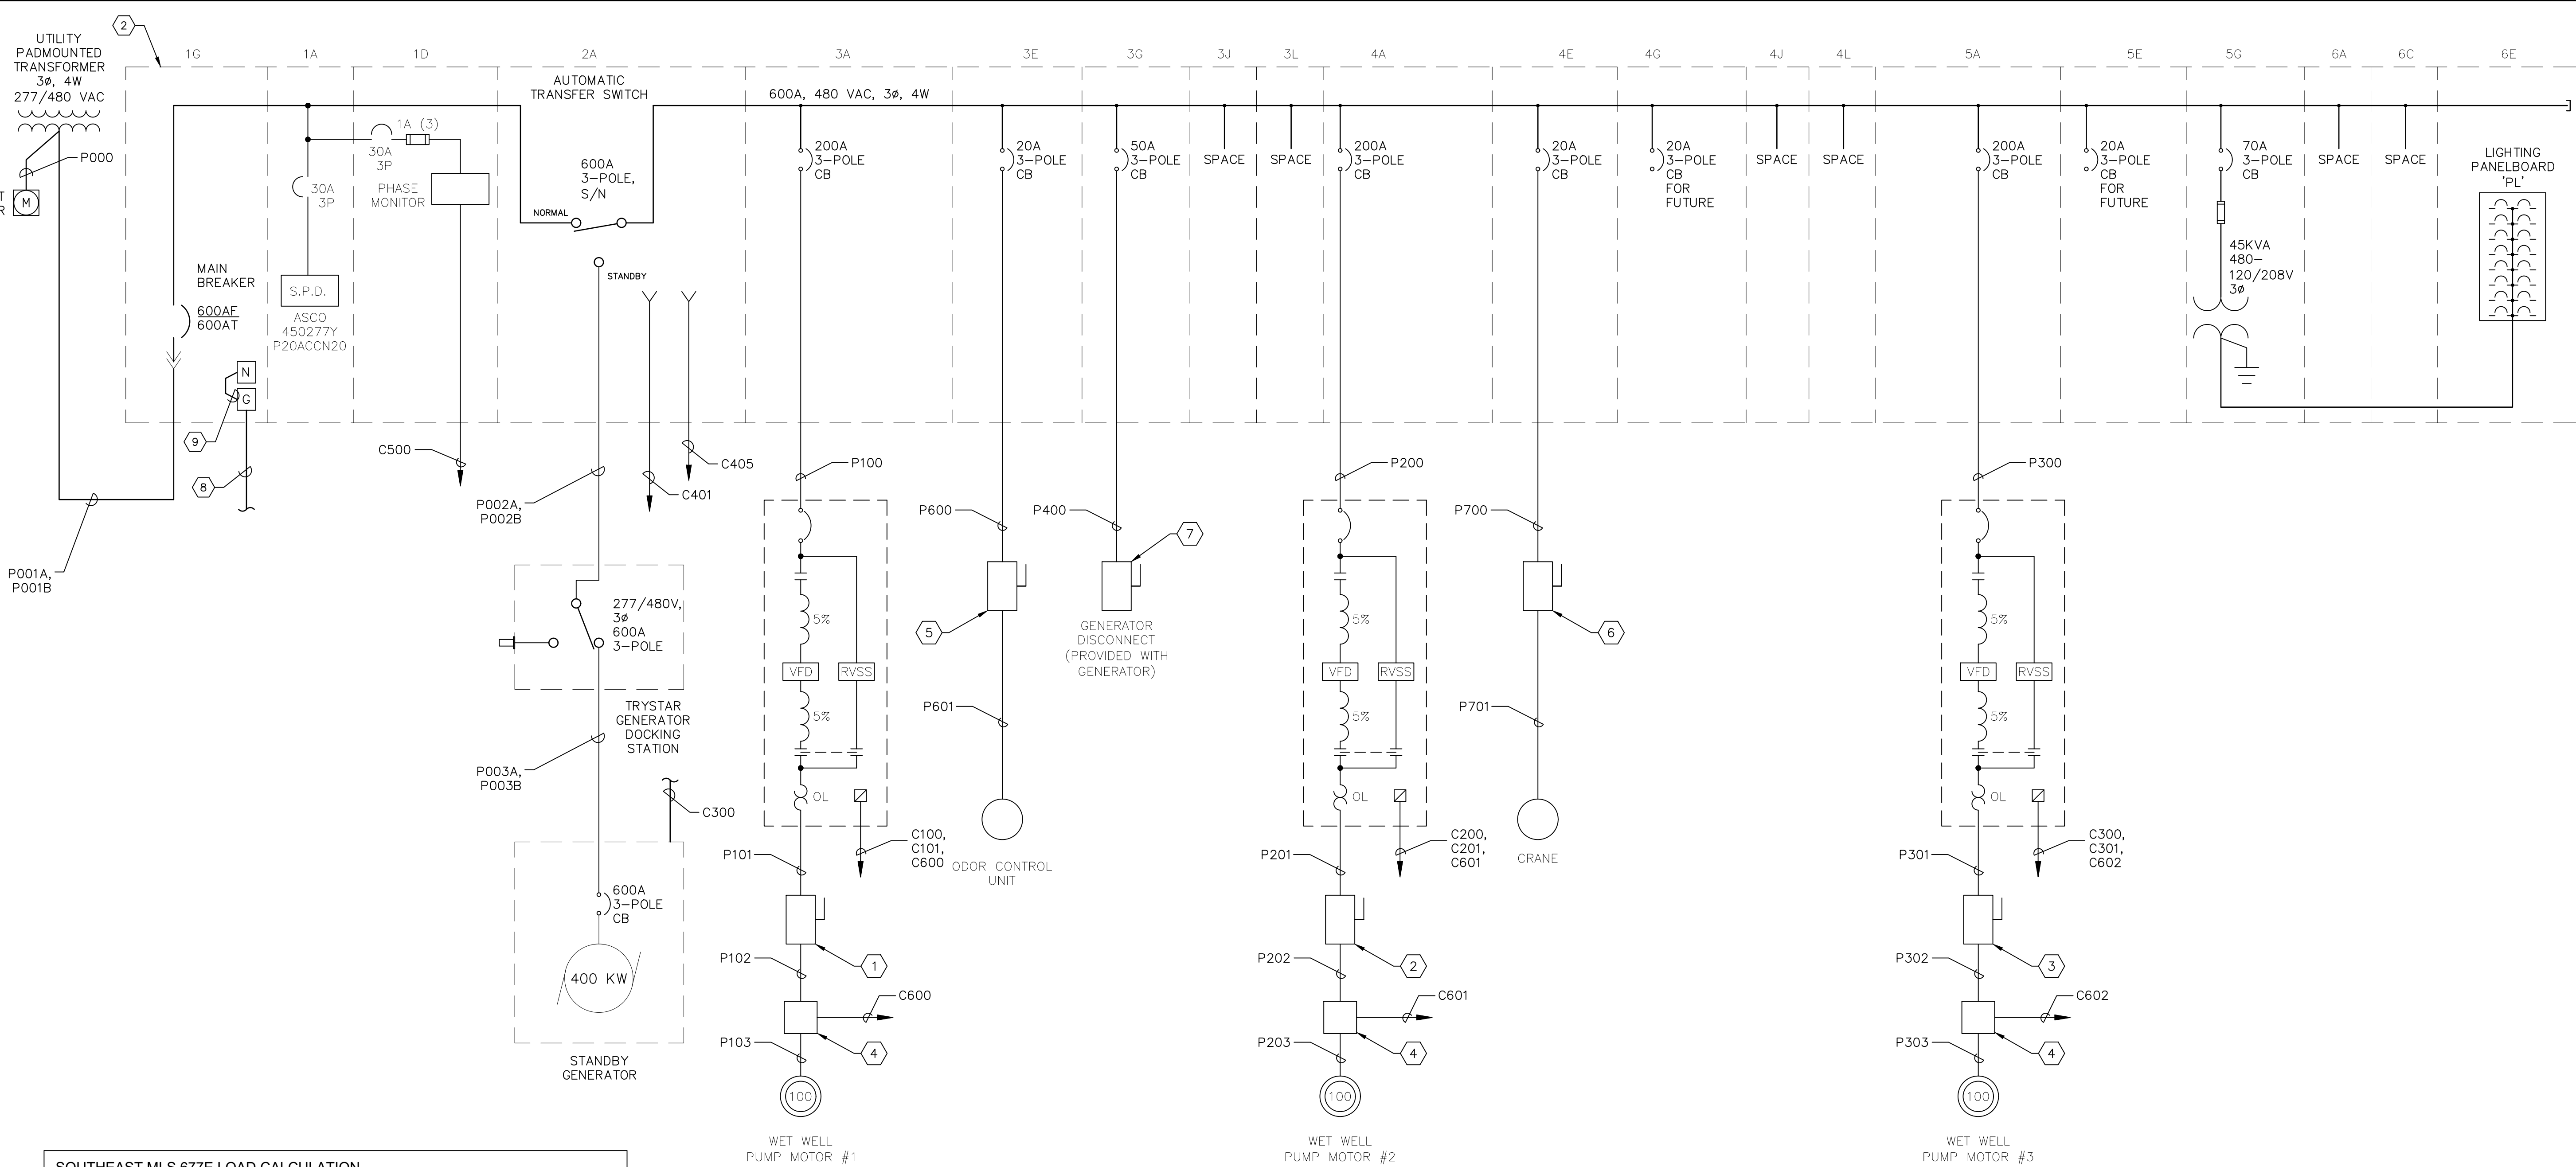
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MOTOR CONTROL CENTER ELEVATION
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E-8



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SOUTHEAST MLS 677E LOAD CALCULATION		
EQUIPMENT	H.P.	DEMAND AMPERES
PANELBOARD 'PL' (VIA TRANSFORMER)		25.0
WET WELL PUMP #1	100	125.0
WET WELL PUMP #2	100	125.0
WET WELL PUMP #3	100	125.0
ODOR CONTROL UNIT		7.0
CRANE		7.0
HVAC		12.0
GENERATOR ANCILLARY EQUIPMENT		20.0
TOTAL LOAD		446.0

NOTE: NEW ELECTRICAL SERVICE TO BE RATED FOR 600 AMPERES.

KEYED NOTES:

- 1 PROVIDE AND INSTALL MOTOR DISCONNECT FOR PUMP #1. 600V, 200A, 3-P, 3-P, 3-P, NON-FUSED IN NEMA 4X STAINLESS STEEL ENCLOSURE.

2 PROVIDE AND INSTALL MOTOR DISCONNECT FOR PUMP #2. 600V, 200A, 3-P, 3-P, 3-P, NON-FUSED IN NEMA 4X STAINLESS STEEL ENCLOSURE.

3 PROVIDE AND INSTALL MOTOR DISCONNECT FOR PUMP #3. 600V, 200A, 3-P, 3-P, 3-P, NON-FUSED IN NEMA 4X STAINLESS STEEL ENCLOSURE.

4 PROVIDE AND INSTALL NEMA 4X STAINLESS STEEL JUNCTION BOX. REFER TO SHEETS E-12 AND E-13.
- 5 PROVIDE AND INSTALL DISCONNECT FOR ODOR CONTROL UNIT. 600V, 30A, 3-P, 3-P, 3-P, NON-FUSED IN NEMA 4X STAINLESS STEEL ENCLOSURE.

6 PROVIDE AND INSTALL MOTOR DISCONNECT FOR CRANE HOIST. 600V, 30A, 3-P, 3-P, 3-P, NON-FUSED IN NEMA 4X STAINLESS STEEL ENCLOSURE.

7 DISCONNECT PROVIDED AS PART OF THE GENERATOR SET.

8 PROVIDE AND INSTALL BARE 2/0 AWG COPPER GROUNDING ELECTRODE CONDUCTOR IN 1" CONDUIT DOWN TO GRADE LEVEL AND CONNECT TO GROUNDING GRID.

9 PROVIDE AND INSTALL 2/0 AWG THWN COPPER BONDING JUMPER.



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MOTOR CONTROL CENTER  
ONE-LINE DIAGRAM

SHEET NUMBER

E-9



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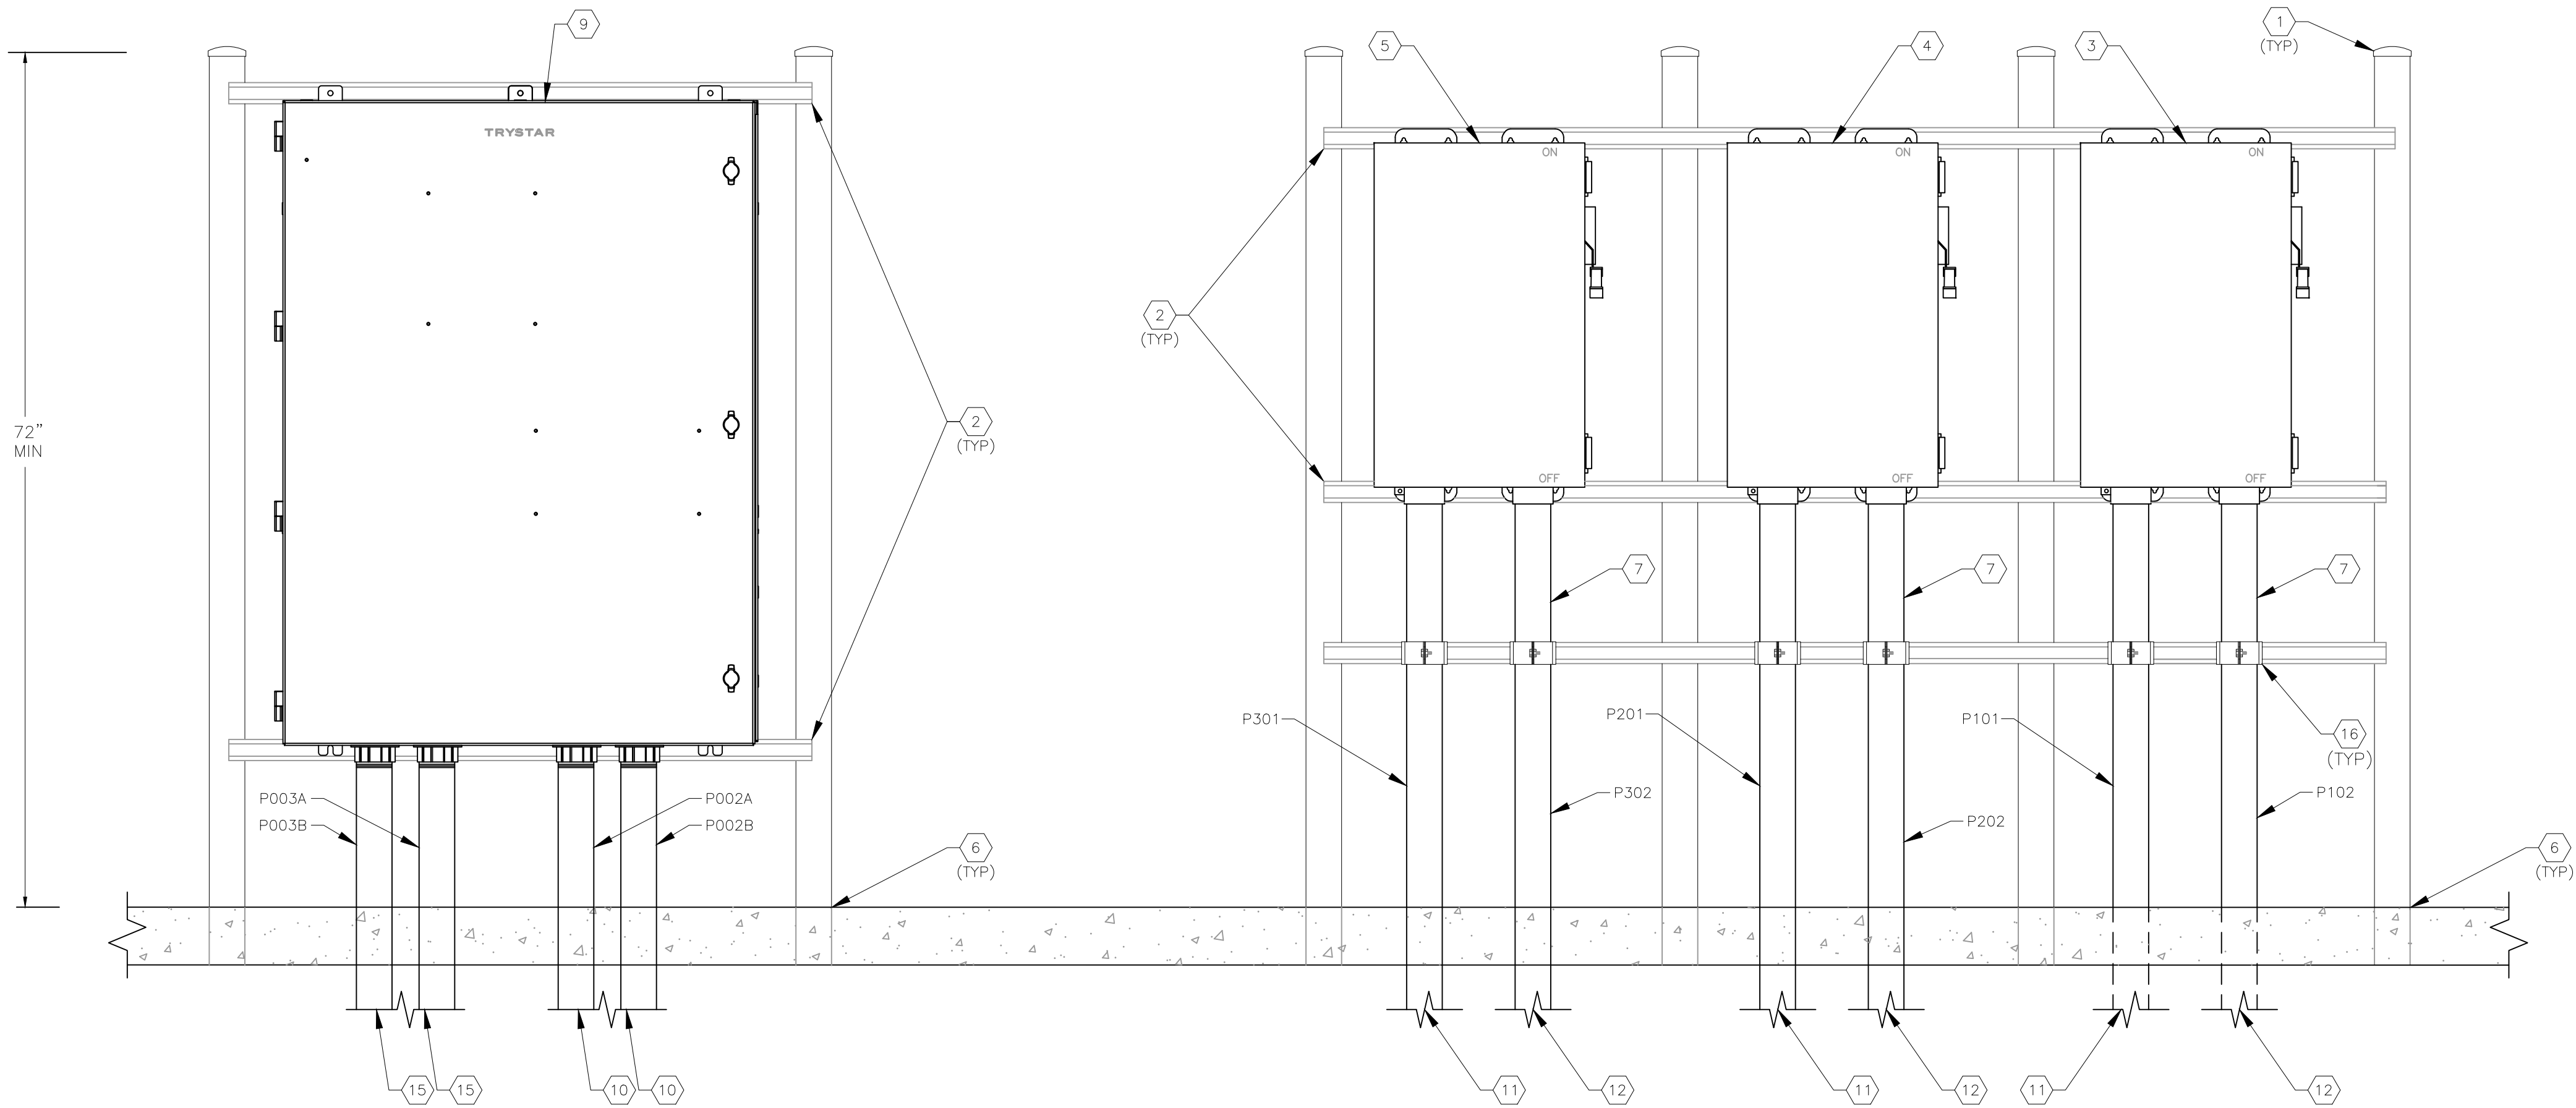
## TYPICAL VFD WIRING DIAGRAM

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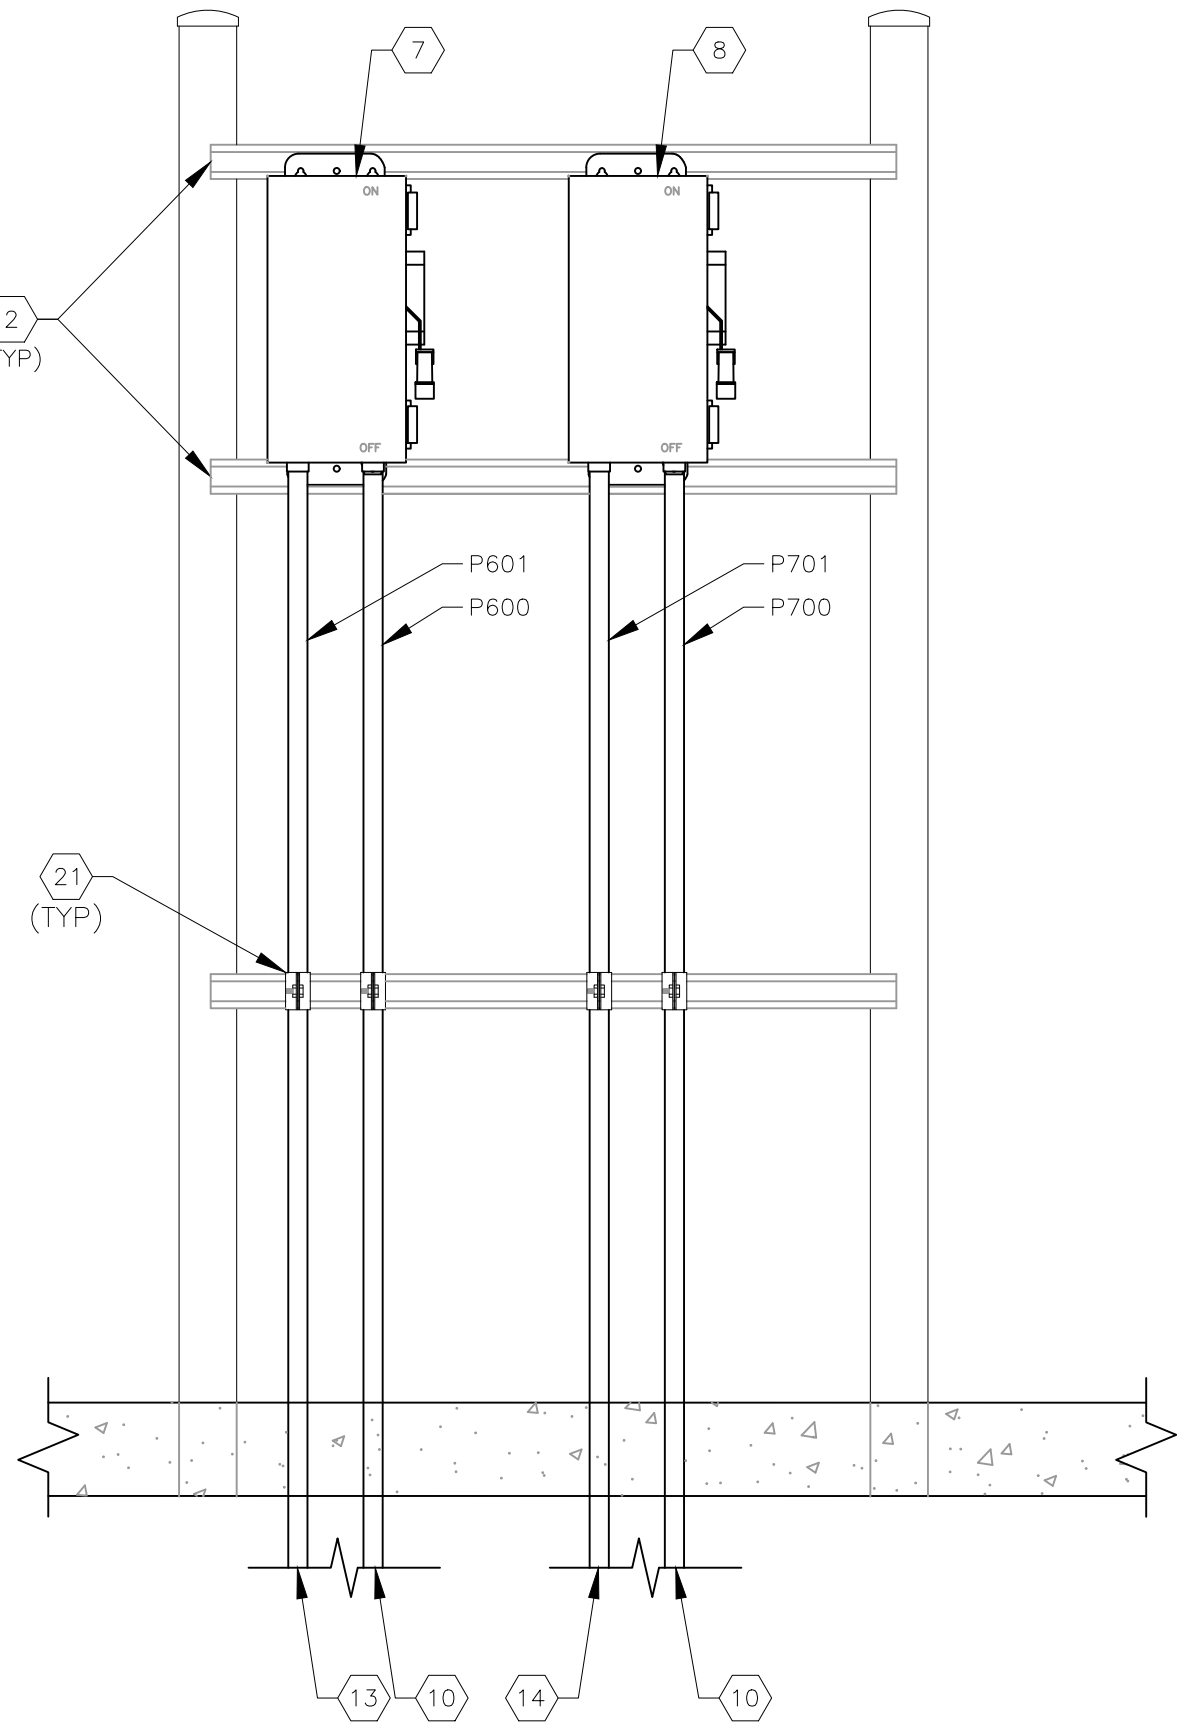
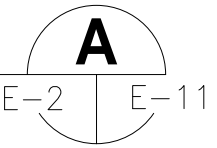
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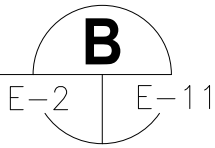
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NEW WET WELL ELECTRICAL EQUIPMENT RACK  
FRONT ELEVATION  
SCALE: NOT TO SCALE



DISCONNECT RACK  
FRONT ELEVATION  
SCALE: NOT TO SCALE



KEYED NOTES:

- 1 PROVIDE AND INSTALL FOUR (4), 3 INCH, 316 STAINLESS STEEL SCHEDULE 40 PIPES.

2 PROVIDE AND INSTALL 1-5/8" SOLID 316 STAINLESS STEEL UNISTRUT WITH GREY END CAPS.

3 PROVIDE AND INSTALL NEW MOTOR DISCONNECT FOR PUMP #1. 600V, 200A, 3-POLE, NON-FUSED IN NEMA 4X STAINLESS STEEL ENCLOSURE.

4 PROVIDE AND INSTALL NEW MOTOR DISCONNECT FOR PUMP #2. 600V, 200A, 3-POLE, NON-FUSED IN NEMA 4X STAINLESS STEEL ENCLOSURE.

5 PROVIDE AND INSTALL NEW MOTOR DISCONNECT FOR PUMP #3. 600V, 200A, 3-POLE, NON-FUSED IN NEMA 4X STAINLESS STEEL ENCLOSURE.

6 STAINLESS STEEL SUPPORT POSTS SHALL BE TREATED WITH TWO COATS OF BITUMINOUS EPOXY TO 16 MILS WHERE EMBEDDED IN CONCRETE.

7 PROVIDE AND INSTALL NEW ODOR CONTROL UNIT DISCONNECT. 600V, 30A, 3-POLE, NON-FUSED IN NEMA 4X STAINLESS STEEL ENCLOSURE.
- 8 PROVIDE AND INSTALL NEW CRANE DISCONNECT. 600V, 30A, 3-POLE, NON-FUSED IN NEMA 4X STAINLESS STEEL ENCLOSURE.

9 PROPOSED DOCKING STATION. 277/480V, 3-PHASE, 4-WIRE, 600A WITH SOLID NEUTRAL IN NEMA 4X STAINLESS STEEL ENCLOSURE. TRYSTAR TMTS-065W-LLM-I.

10 CONTINUES TO MOTOR CONTROL CENTER.

11 CONTINUES TO ASSOCIATED JUNCTION BOX ADJACENT TO WET WELL.

12 CONTINUES TO ASSOCIATED VFD.

13 CONTINUES TO ODOR CONTROL UNIT.

14 CONTINUES TO CRANE.

15 CONTINUES TO GENERATOR.

16 PROVIDE 316 STAINLESS STEEL CONDUIT CLAMP (TYP).



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DRAWN BY JLH  
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DATE:

EQUIPMENT RACK  
ELEVATIONS

SHEET NUMBER  
E-11



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1	PROVIDE AND INSTALL FOUR (4), 3 INCH, 316 STAINLESS STEEL SCHEDULE 40 PIPES.	7	STAINLESS STEEL SUPPORT POSTS SHALL BE TREATED WITH TWO COATS OF BITUMINOUS EPOXY TO 16 MILS WHERE EMBEDDED IN CONCRETE (TYP).
2	PROVIDE AND INSTALL 1-5/8" SOLID 316 STAINLESS STEEL UNISTRUT WITH GREY END CAPS. INSTALL FLAT SIDE OUT.	8	CONTINUES TO ASSOCIATED PUMP IN WET WELL.
3	PROVIDE AND INSTALL 24" x 24" x 8" NEMA 4X, 304 STAINLESS STEEL ENCLOSURE POWDER COATED WHITE FOR PUMP MOTOR CONDUCTORS. SCHAEFER'S PART #SPN4SS-24248. REFER TO DETAIL ON SHEET E-13.	9	CONTINUES TO ASSOCIATED DISCONNECT ON ELEVATED PLATFORM.
4	PROVIDE AND INSTALL 14" x 16" x 8" NEMA 4X, 304 STAINLESS STEEL ENCLOSURE. POWDER COATED WHITE FOR INSTRUMENTATION CONDUCTORS. SCHAEFER'S PART #SPN4SS-14168-587. REFER TO DETAIL ON SHEET E-13.	10	CONTINUES TO ASSOCIATED VFD.
5	PROVIDE 316 STAINLESS STEEL CONDUIT CLAMP (TYP).	11	CONTINUES TO FLOATS IN WET WELL.
6	MANATEE COUNTY SHALL PROVIDE PROVISIONS FOR MEETING THE SEALING REQUIREMENTS PER NEC 501.15(B)(2).	12	CONTINUES TO DFS TCU/VFD CONTROL PANEL.

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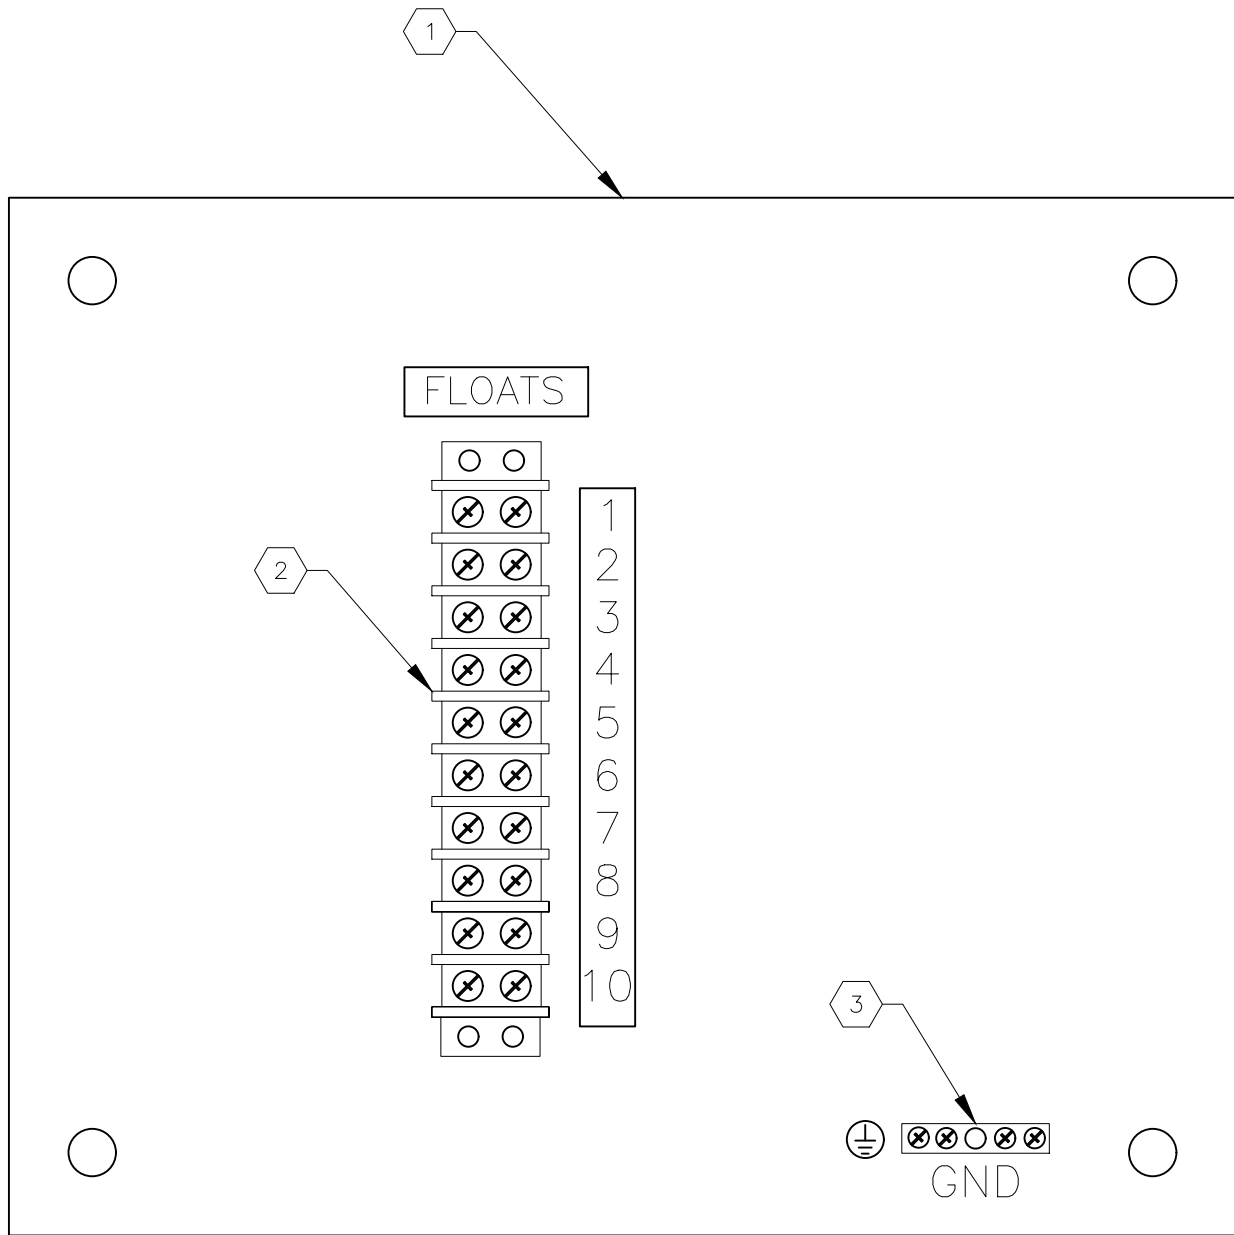
# WET WELL JUNCTION BOX RACK ELEVATION

SHEET NUMBER


E-12



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WET WELL INSTRUMENTATION  
JUNCTION BOX INTERIOR DETAIL **A**  
SCALE: NOT TO SCALE E-12 E-13



TYPICAL PUMP WET WELL  
JUNCTION BOX DETAIL **B**  
SCALE: NOT TO SCALE E-12 E-13

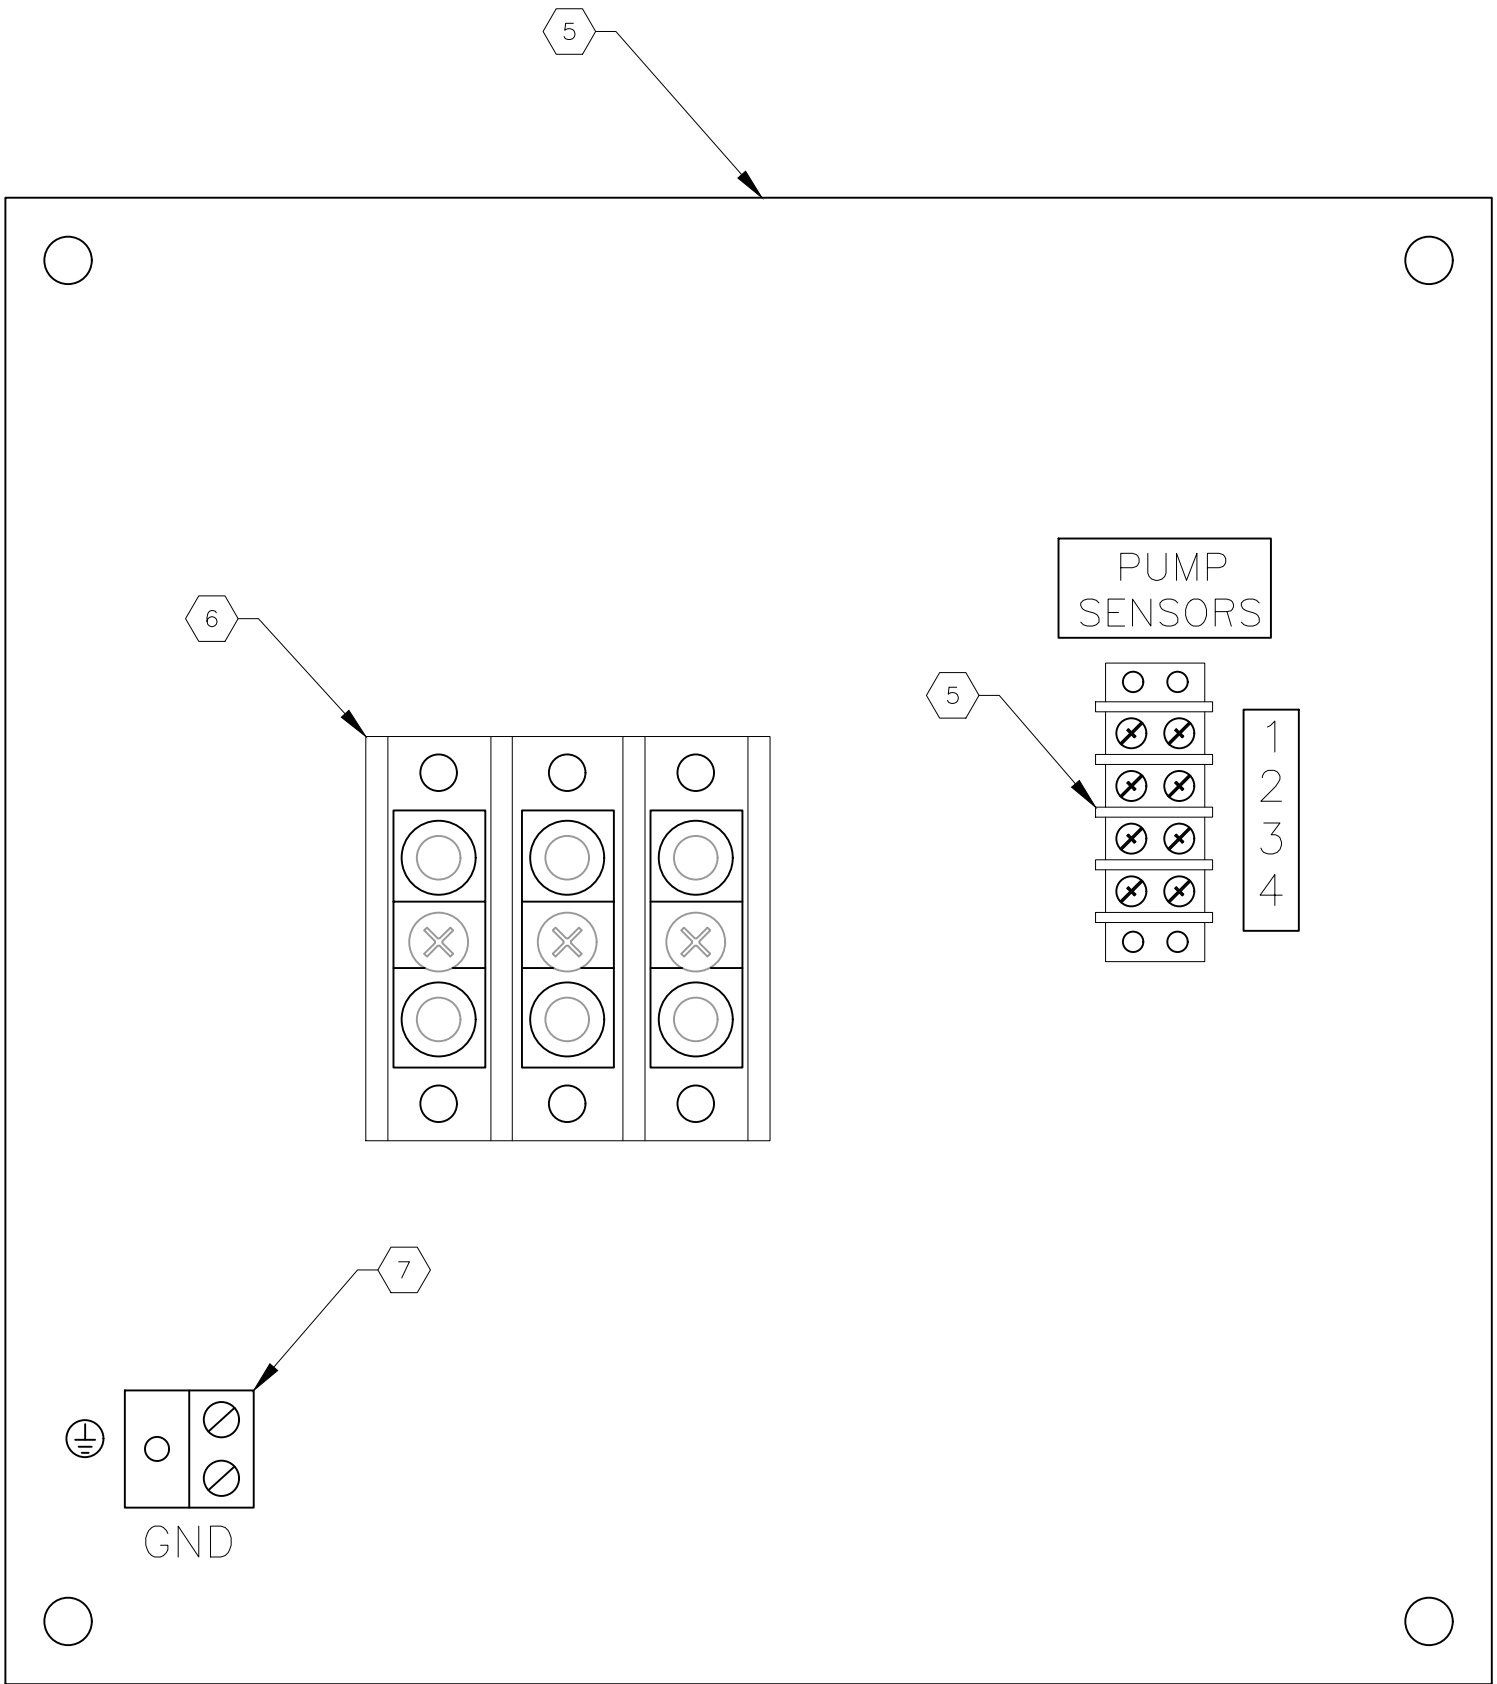KEYED NOTES:

1. PROVIDE AND INSTALL 14" x 16" SUBPANEL SCHAEFER'S PART #SPP-1416.
2. PROVIDE AND INSTALL 10-POINT TERMINAL BLOCK. IDEAL #89-210 FOR FLOAT CONDUCTORS.
3. PROVIDE AND INSTALL GROUND BAR. EATON PART #GBK5.
4. PROVIDE AND INSTALL 24" x 24" SUBPANEL SCHAEFER'S PART #SPP-2424.
5. PROVIDE AND INSTALL 4-POINT TERMINAL BLOCK. IDEAL #89-204 FOR PUMP MOTOR SENSOR CONDUCTORS.
6. PROVIDE AND INSTALL PUMP MOTOR POWER DISTRIBUTION BLOCK. MARATHON PART #1323572. PROVIDE COVER FOR POWER DISTRIBUTION BLOCK.
7. PROVIDE AND INSTALL TWO BARREL MECHANICAL LUG. BLACKBURN PART #3LN34.

GENERAL NOTES:

1. ALL JUNCTION BOX GROUNDS MUST BE BONDED TO THE CONTROL PANEL GROUND.
2. PROVIDE #12 AWG COPPER THWN (GREEN) BOND BETWEEN ENCLOSURE AND ENCLOSURE DOOR.

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	DATE OCT 2021
	SCALE AS SHOWN
	DESIGNED BY TDT
	DRAWN BY JLH
	CHECKED BY GLW


BAYSHORE YACHT BASIN

LICENSED PROFESSIONAL  TIMOTHY THOMAS, P.E.  FL LICENSE NUMBER 47079  DATE:
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WET WELL JUNCTION BOX DETAILS
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SHEET NUMBER  E-13
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NEW PANEL 'LP' SCHEDULE																
PANEL 'LP'		SQUARE D CO. TYPE NQ00			; 120/208 VOLTS, 3ø, 4W			200 AMP MAIN CIRCUIT BREAKER			; 10K AIC RATING			SURFACE ENCLOSURE TOP AT 5'-6" AFF		
EQUIPMENT SERVED	CIRCUIT BREAKER			KVA/PHASE			CIRC. NO.	CIRC. NO.	KVA/PHASE			CIRCUIT BREAKER			EQUIPMENT SERVED	
	POLE	AMPS	FRAME	A	B	C			A	B	C	POLE	AMPS	FRAME		
RECEPTACLE CIRCUIT	1	20	QOB	0.4			1	2	0.8			1	30	QOB	ELECTRICAL ROOM LIGHTING	
RECEPTACLE CIRCUIT	1	20	QOB		0.2		3	4		0.1		1	20	QOB	BUILDING EXTERIOR LIGHTING	
HVAC MAINTENANCE RECPCTACLE	1	20	QOB			0.2	5	6			0.1	1	20	QOB	AREA LIGHT 'C1'	
DFS TCU/VFD PANEL	1	20	QOB	0.8			7	8	0.1			1	20	QOB	AREA LIGHT 'C2'	
FLOW METER CONVERTER	1	20	QOB		0.2		9	10				1	20	QOB	SPARE	
BUILDING MINI SPLIT SYSTEM	1	40	QOB			4.5	11	12				1	20	QOB	SPARE	
	--	--	--	4.5			13	14				--	--	--	SPACE	
SPACE	--	--	--				15	16				--	--	--	SPACE	
SPACE	--	--	--				17	18				--	--	--	SPACE	
SPACE	--	--	--				19	20				--	--	--	SPACE	
SPACE	--	--	--				21	22				--	--	--	SPACE	
SPACE	--	--	--				23	24				--	--	--	SPACE	
SPACE	--	--	--				25	26				--	--	--	SPACE	
SPACE	--	--	--				27	28				--	--	--	SPACE	
SPACE	--	--	--				29	30				--	--	--	SPACE	
SPACE	--	--	--				31	32				--	--	--	SPACE	
SPACE	--	--	--				33	34				--	--	--	SPACE	
SPACE	--	--	--				35	36				--	--	--	SPACE	
SPACE	--	--	--				37	38				--	--	--	SPACE	
SPACE	--	--	--				39	40				--	--	--	SPACE	
SPACE	--	--	--				41	42				--	--	--	SPACE	
SUB-TOTAL KVA				5.7	0.4	4.7			0.9	0.1	0.1					
TOTAL CONNECTED LOAD = 11.9 KVA																
TOTAL DEMAND LOAD = 11.9 KVA																

PROVIDE PHENOLIC NAMEPLATE ABOVE PUSH BUTTON STATION. NAMEPLATE SHALL BE THREE-PLY PHENOLIC RED-WHITE-RED ENGRAVED THROUGH THE FIRST RED LAYER. LETTERING SHALL BE 1/2" MIN., EDGES OF NAMEPLATE SHALL BE BEVELED 45 DEG. NAMEPLATE SHALL READ AS FOLLOWS: "GENERATOR EMERGENCY SHUT DOWN".

GENERATOR EMERGENCY SHUT DOWN PUSH BUTTON STATION. MAINTAINED 2 POSITION SWITCH w/ 1-5/8" DIA. OPERATOR, 1 N.O. & 1 N.C. CONTACT MOUNTED IN A NEMA 4X 316 STAINLESS STEEL ENCLOSURE, 4'-6" ABOVE FINISHED CONCRETE SLAB GRADE.

316 STAINLESS STEEL CONDUIT CLAMP (TYPICAL).

PROVIDE AND INSTALL 2-#12 THWN CU + 1-#12 THWN CU GND IN 1" CONDUIT. FIELD ROUTE CONDUIT FROM PUSH BUTTON STATION TO NEW GENERATOR FOR SHUT DOWN SIGNAL (C404).

1-5/8" X 1-5/8" 316 STAINLESS STEEL UNISTRUT (TYPICAL).

EMERGENCY SHUTOFF PUSH BUTTON ELEVATION

SCALE : NOT TO SCALE

A  
E-6 | E-14

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SCALE	AS SHOWN
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DRAWN BY	JLH
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BAYSHORE YACHT BASIN

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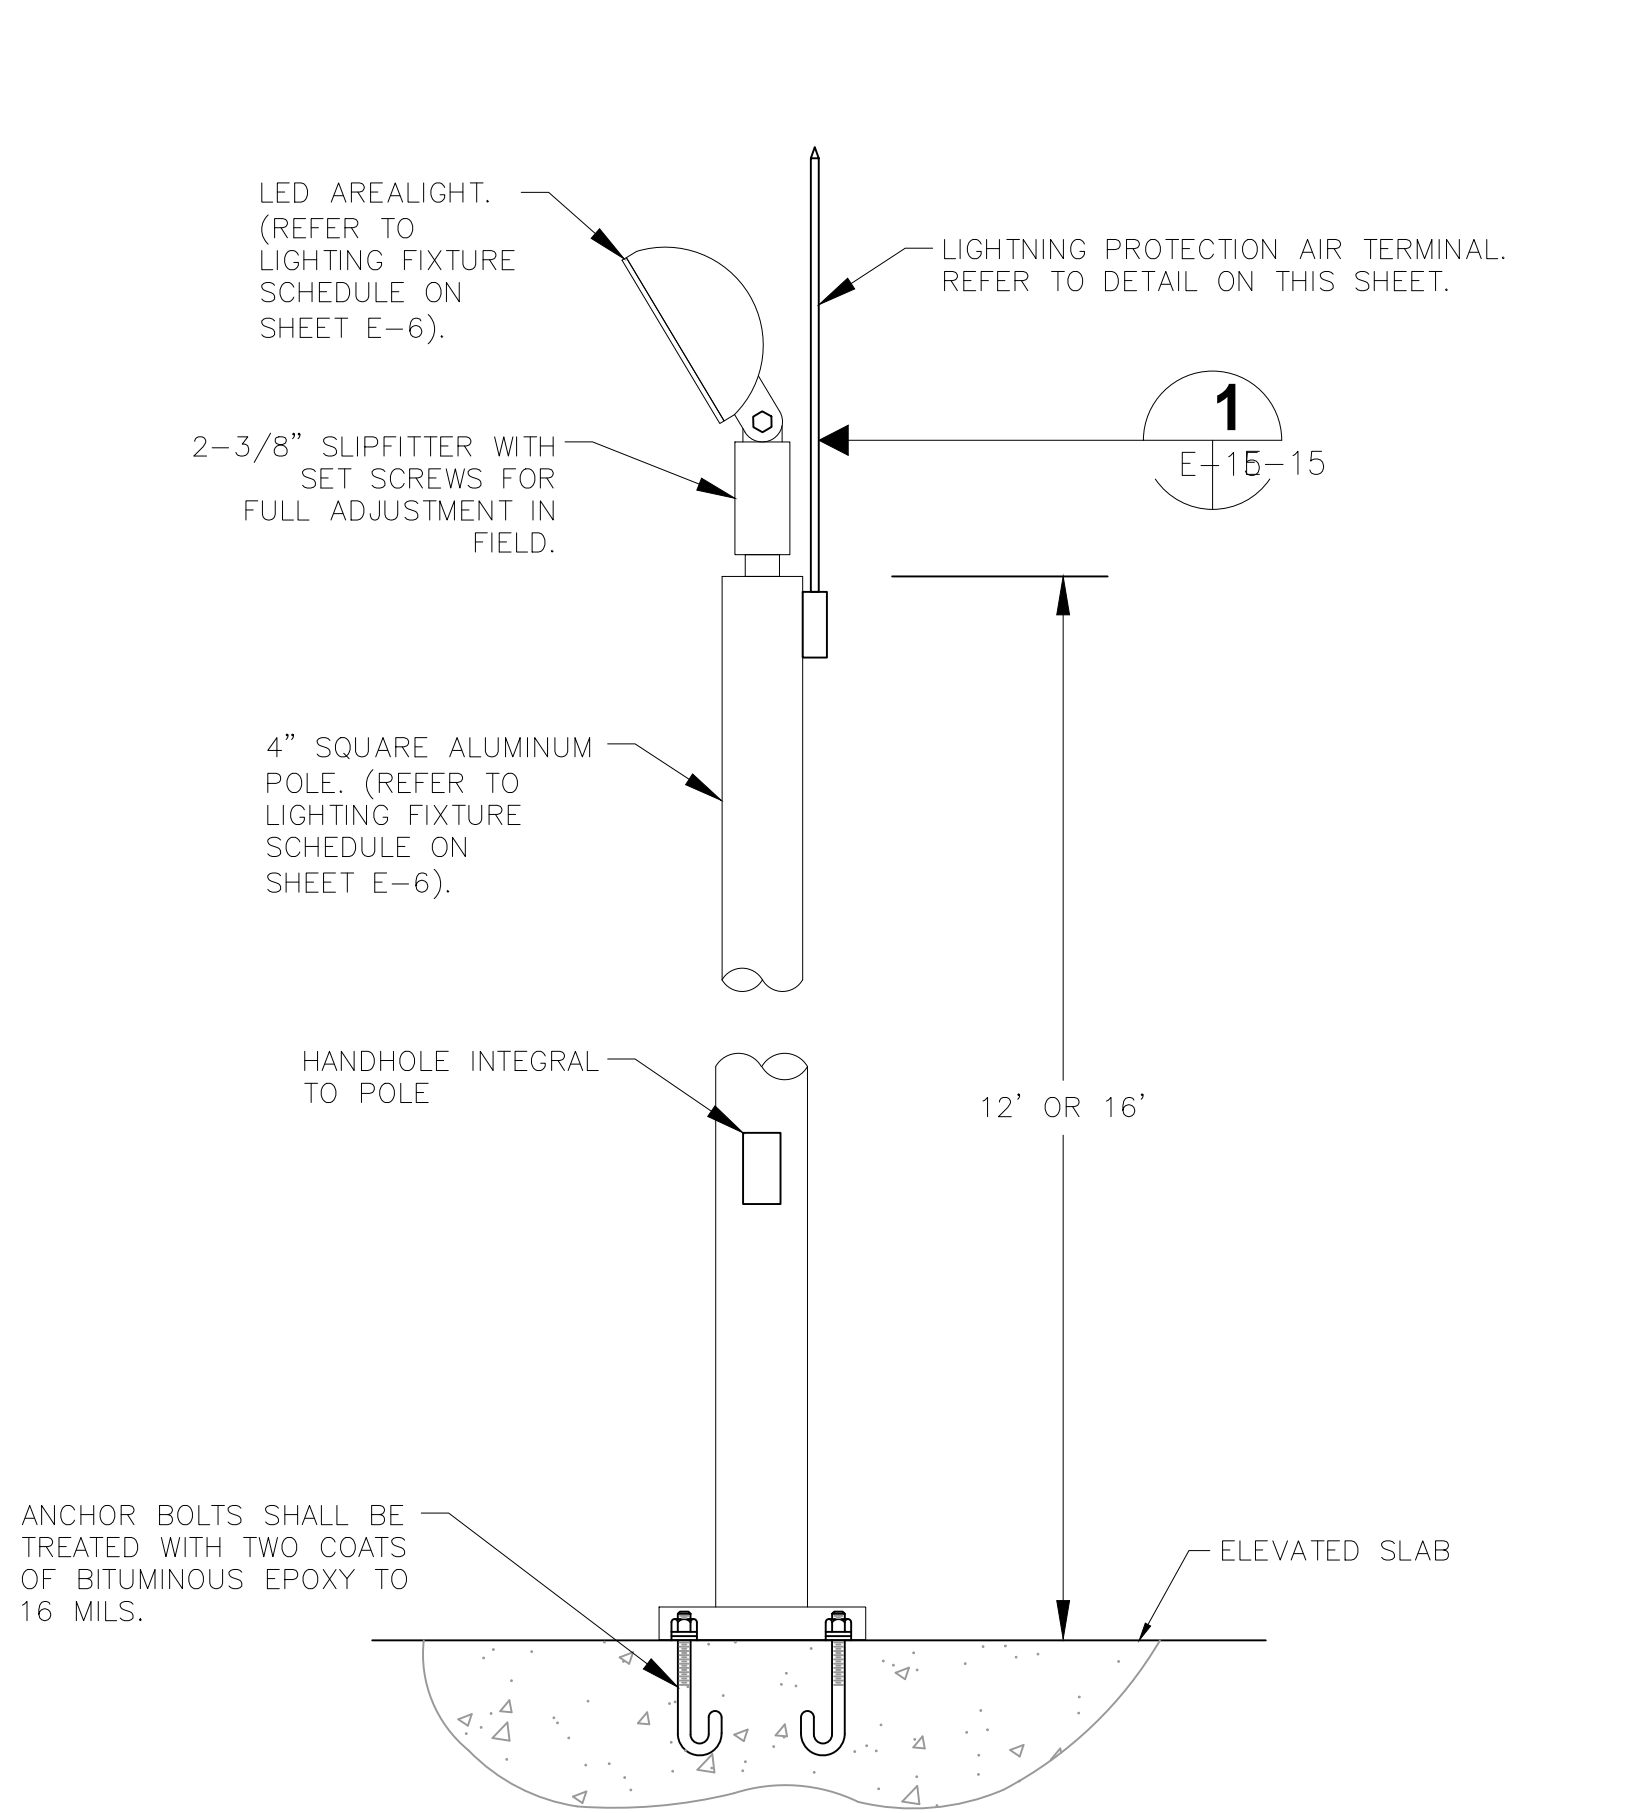
PANELBOARD SCHEDULE  
AND ESO DETAIL

SHEET NUMBER

E-14





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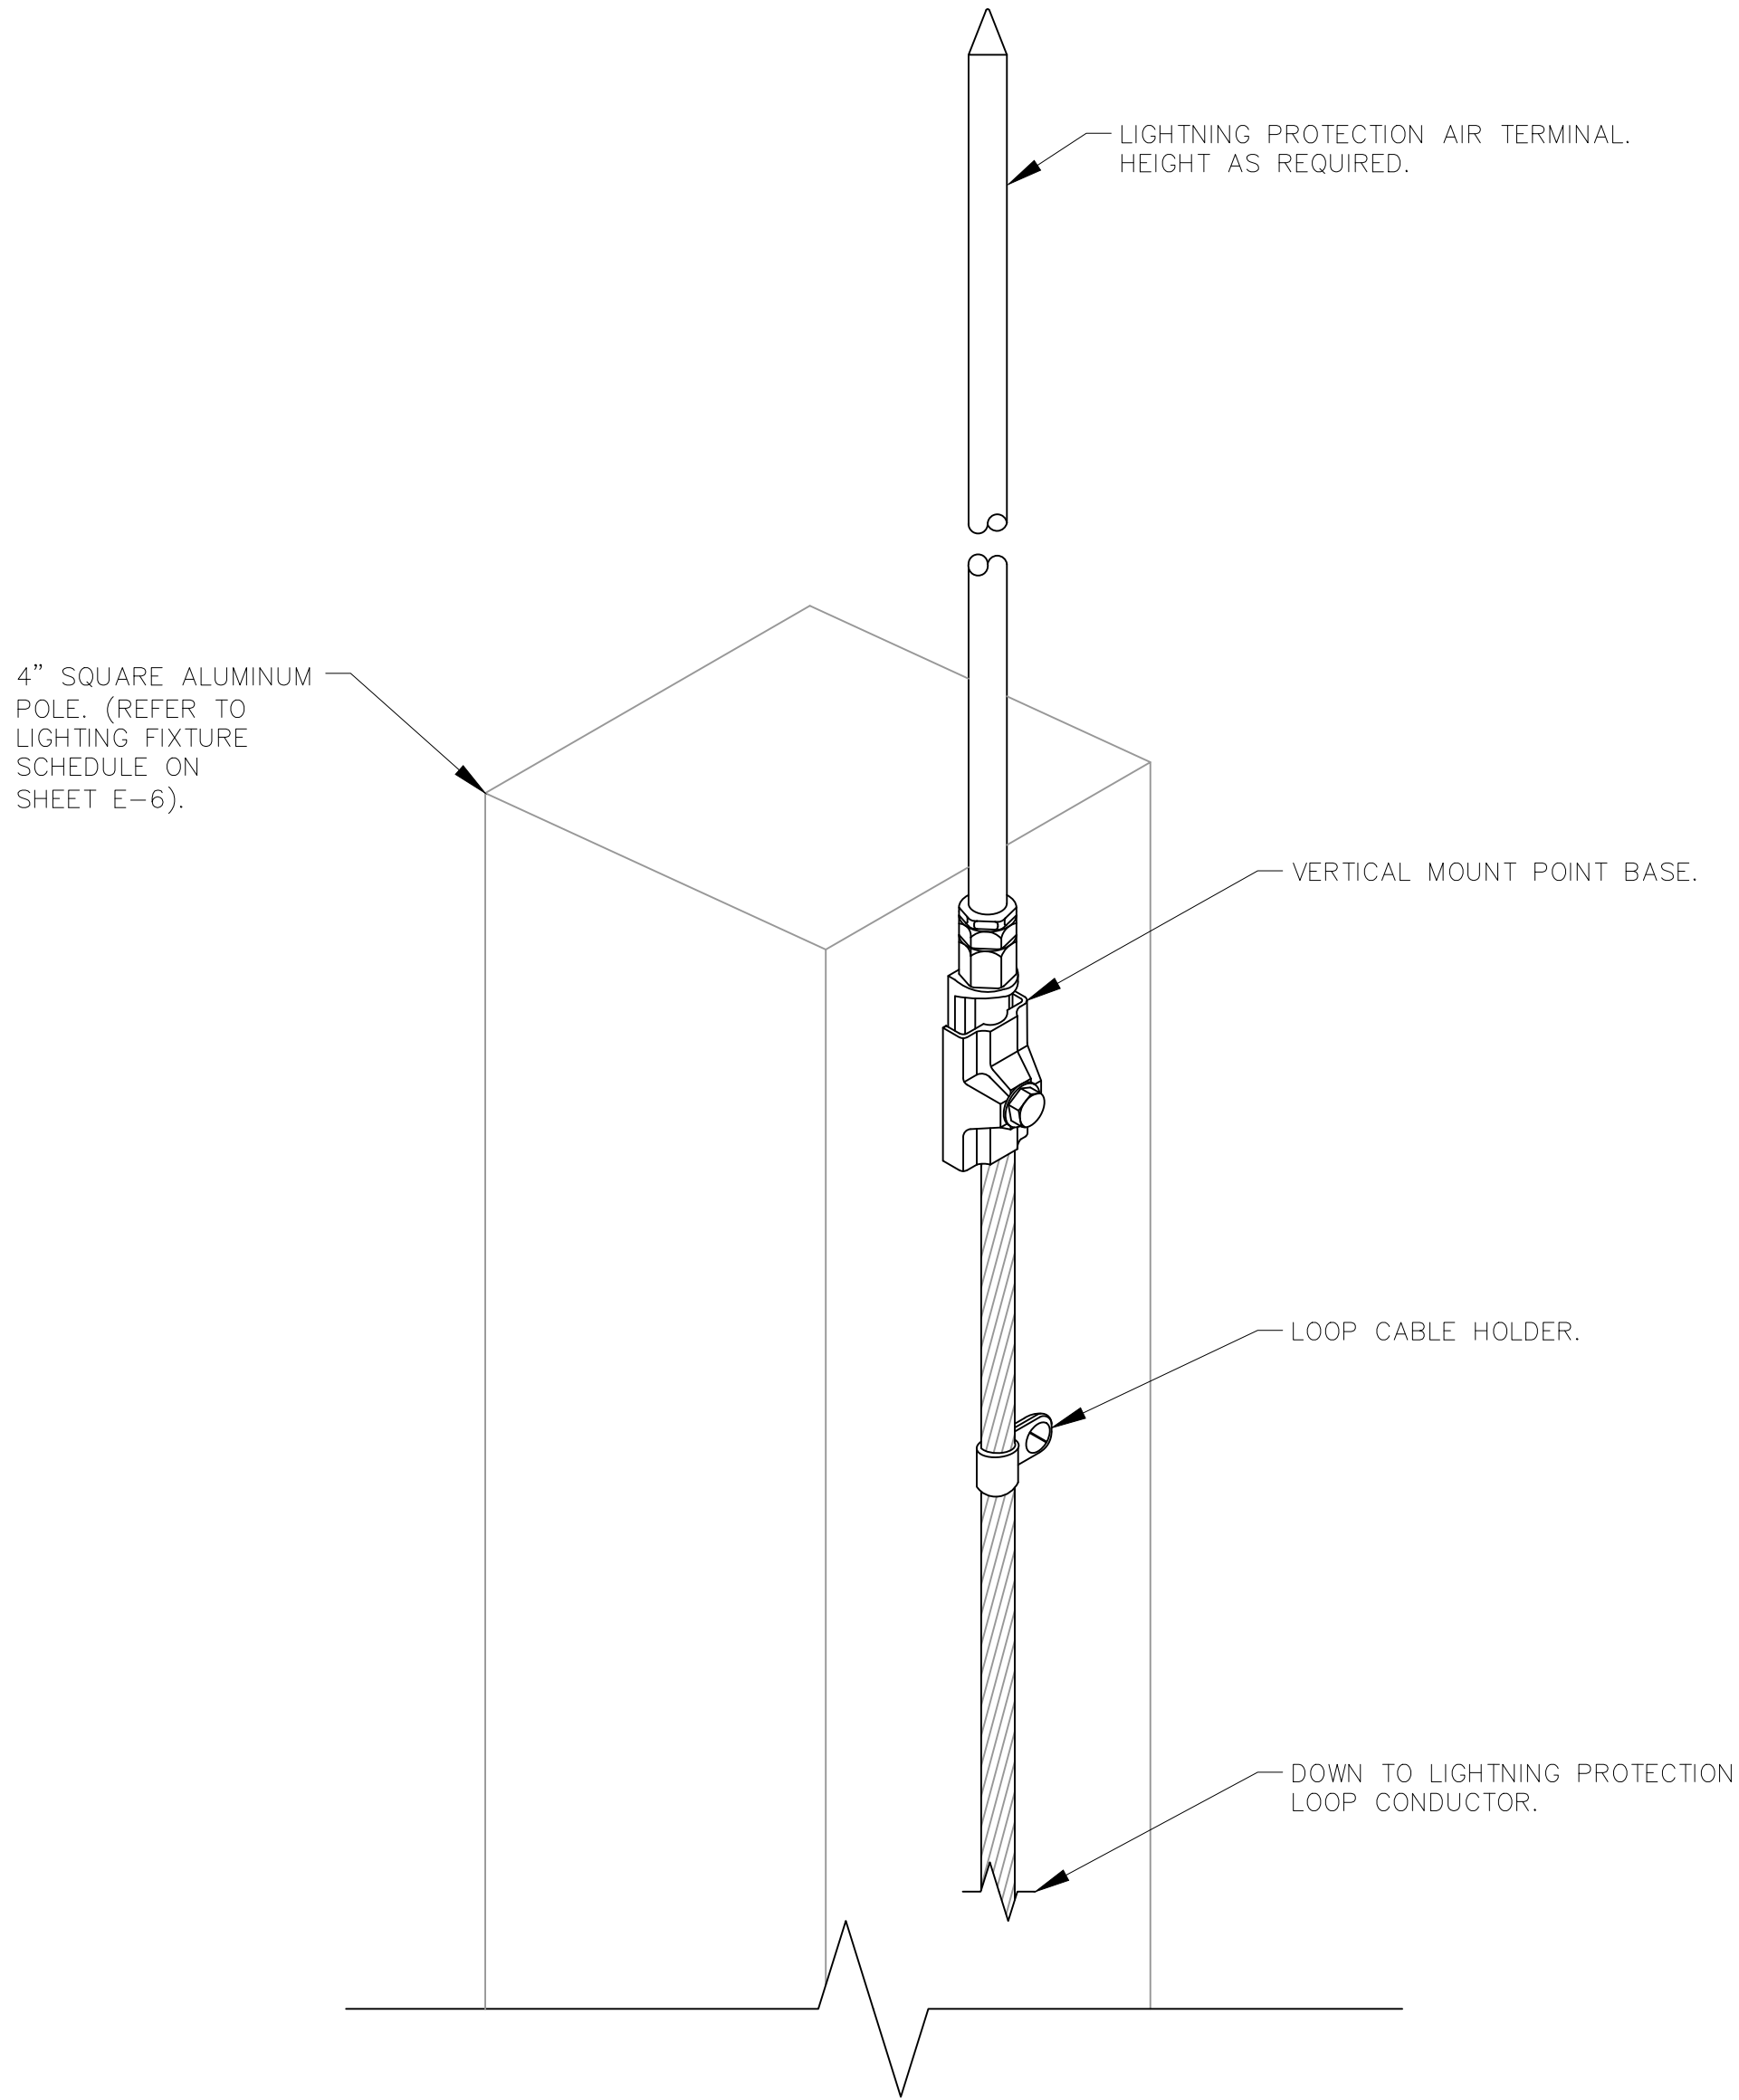
TYPICAL AREA LIGHT MOUNTING DETAIL

SCALE : NOT TO SCALE




AREA LIGHT C1 WIRING SCHEMATIC

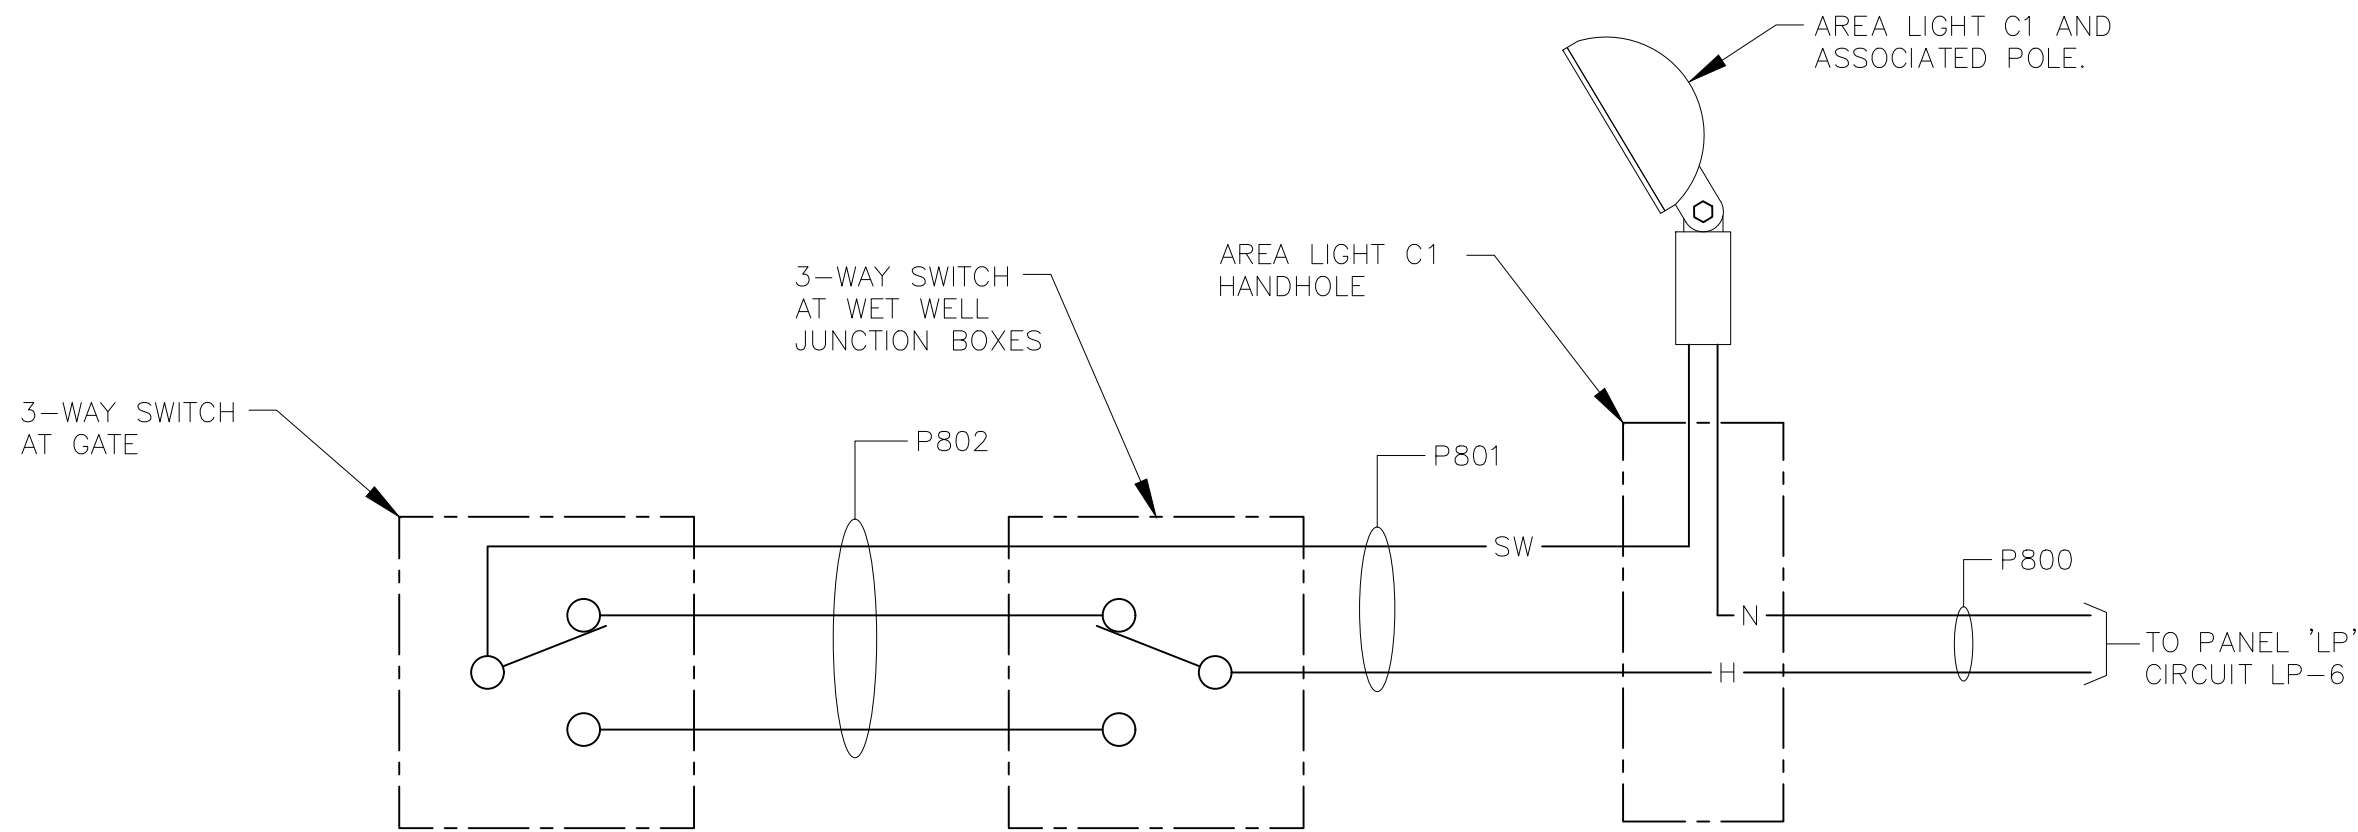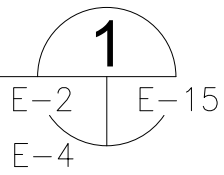NOTE: GROUNDING CONDUCTORS NOT SHOWN FOR CLARITY.



TYPICAL AREA LIGHT  
LIGHTNING PROTECTION DETAIL

SCALE : NOT TO SCALE

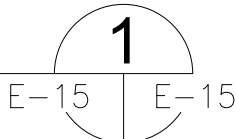

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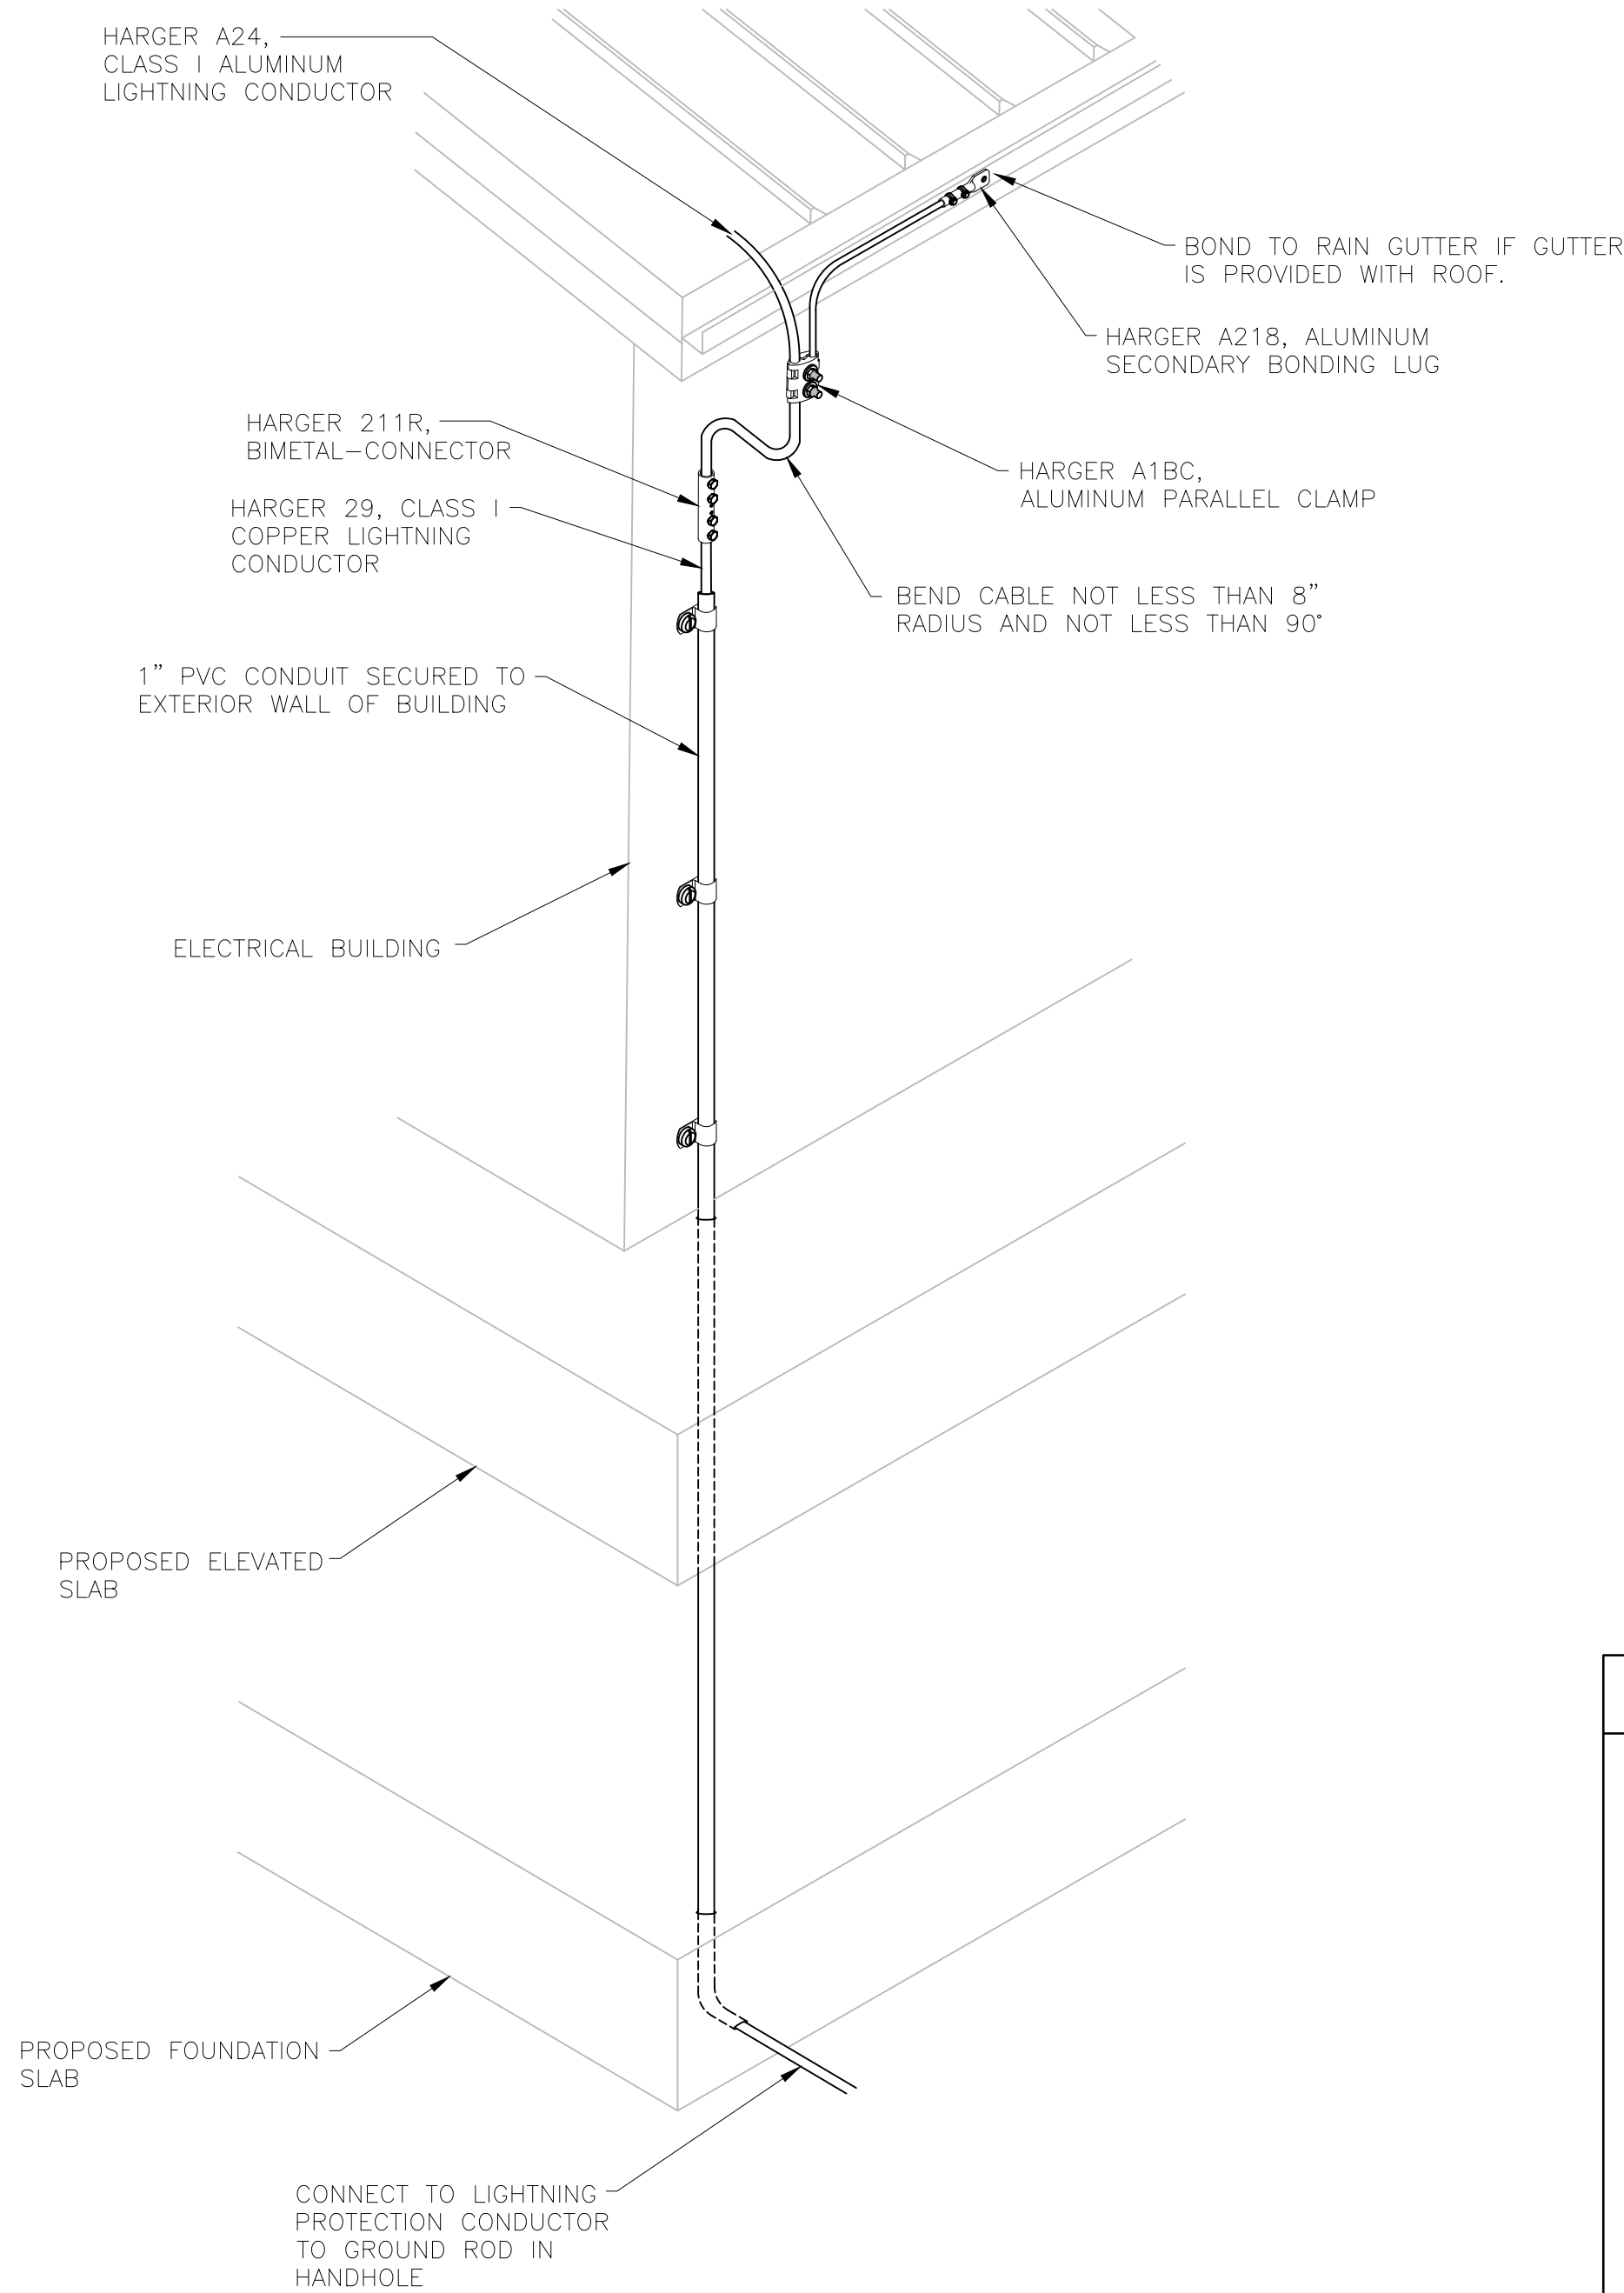
AREA LIGHT DETAILS

SHEET NUMBER

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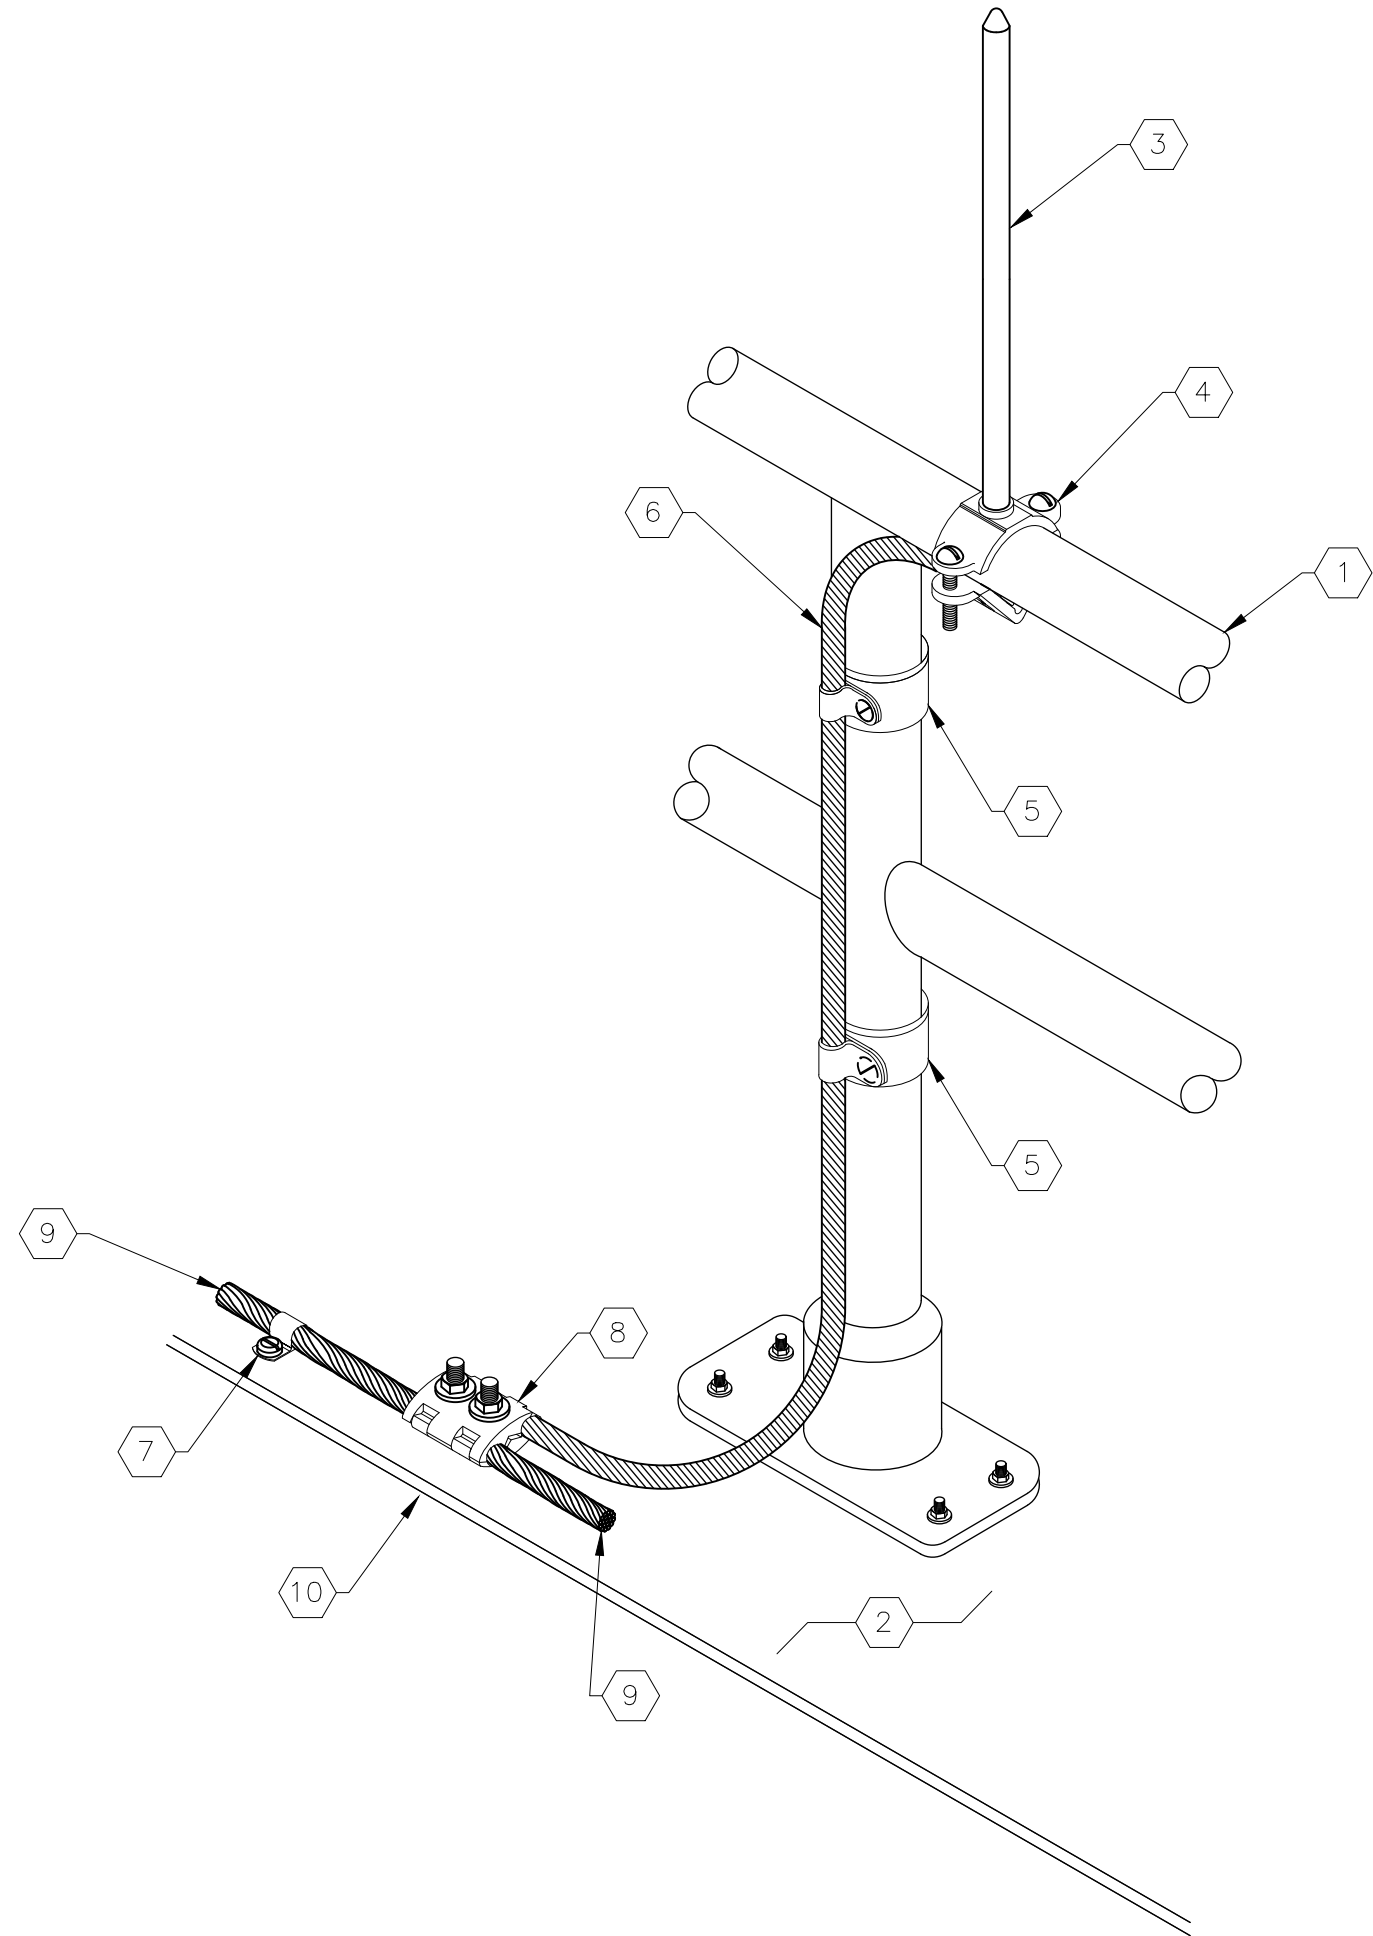
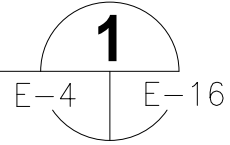


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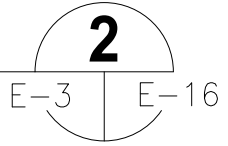
TYPICAL HANDRAIL AIR TERMINAL  
INSTALLATION DETAIL

SCALE : N.T.S.




TYPICAL HANDRAIL AIR TERMINAL  
INSTALLATION DETAIL

SCALE : N.T.S.




HANDRAIL AIR TERMINAL KEYED NOTES:

- 1 PROPOSED HANDRAIL.
- 2 TOP OF ELEVATED PLATFORM SLAB.
- 3 CONTRACTOR TO PROVIDE AND INSTALL 1/2" X 18" SOLID ALUMINUM, BLUNT TIP AIR TERMINAL. THOMPSON LIGHTNING PROTECTION (TLP) A56BT OR APPROVED EQUAL (WITHOUT ADAPTER).
- 4 CONTRACTOR TO PROVIDE AND INSTALL ALUMINUM PIPE RAIL BASE POINT. THOMPSON LIGHTNING PROTECTION (TLP) A240P-4 OR APPROVED EQUAL.
- 5 CONTRACTOR TO PROVIDE AND INSTALL ALUMINUM WRAP-AROUND STRAP AND CABLE CLIP TO SECURE LIGHTNING PROTECTION CONDUCTOR. THOMPSON LIGHTNING PROTECTION (TLP) A188M OR APPROVED EQUAL.
- 6 CONTRACTOR TO PROVIDE AND INSTALL BARE ALUMINUM LIGHTNING PROTECTION CONDUCTOR. MINIMUM BEND RADIUS NOT LESS THAN 8 INCHES.
- 7 CONTRACTOR TO PROVIDE AND INSTALL ALUMINUM LOOP CABLE HOLDER. THOMPSON LIGHTNING PROTECTION (TLP) A165 OR APPROVED EQUAL. LIGHTNING PROTECTION CONDUCTOR SHALL BE FASTENED EVERY 3'-0" MINIMUM.
- 8 CONTRACTOR TO PROVIDE AND INSTALL ALUMINUM CABLE SPLICER. THOMPSON LIGHTNING PROTECTION (TLP) A423 OR APPROVED EQUAL.
- 9 MAIN LIGHTNING PROTECTION CONDUCTOR TO CONTINUE.
- 10 EDGE OF ELEVATED PLATFORM SLAB.

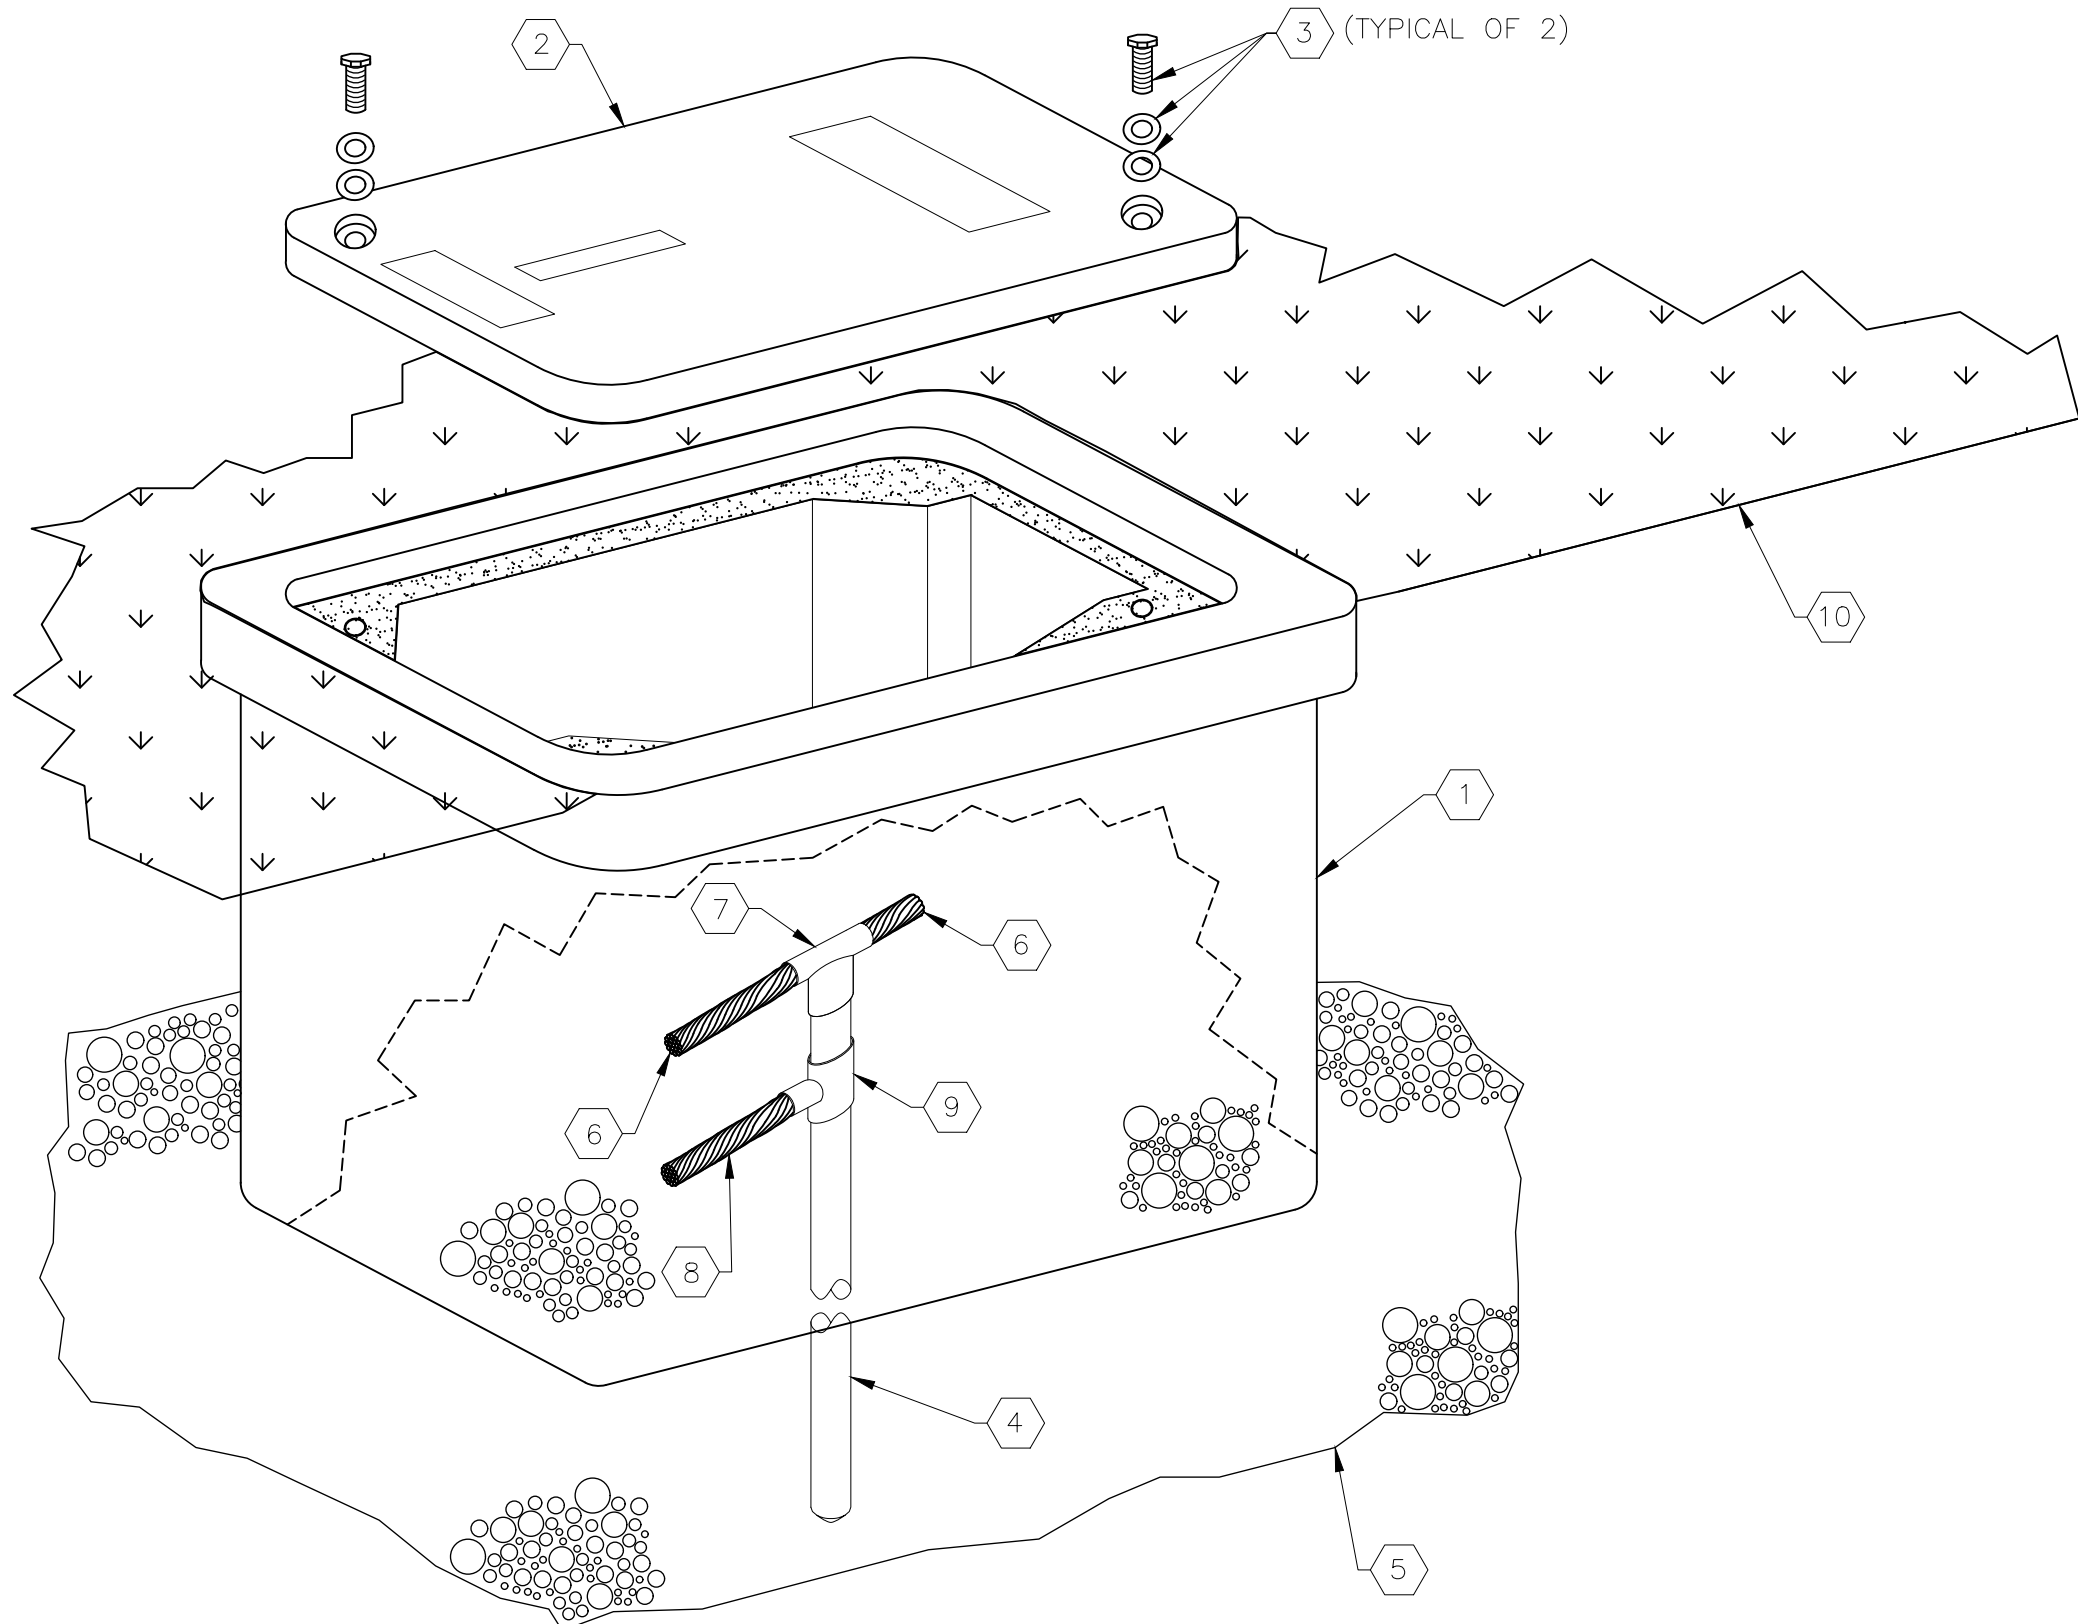

GROUND ROD HANDHOLE DETAIL

SCALE : N.T.S.

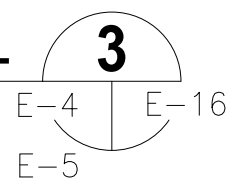

HANDHOLE KEYED NOTES:

- 1 CONTRACTOR TO PROVIDE AND INSTALL 13" x 24" x 18" POLYMER CONCRETE HANDHOLE. REFER ALSO TO SPECIFICATIONS.
- 2 20,000 POUND RATED LID. PROVIDE RECESSED IDENTIFICATION MARKING OF "LIGHTNING PROTECTION" PERMANENTLY INDENTED IN THE COVER.
- 3 STAINLESS STEEL BOLTS AND ASSOCIATED HARDWARE. BOLTS SHALL BE A MINIMUM OF 5/8".
- 4 CONTRACTOR TO PROVIDE AND INSTALL A 3/4" DIAMETER COPPER-CLAD GROUND ROD, MINIMUM OF 20 FEET IN LENGTH (WHEN REQUIRED).
- 5 CONTRACTOR TO PROVIDE AND INSTALL A BED OF PEA ROCK GRAVEL (6" MINIMUM DEPTH, 3" MINIMUM EXTERIOR OF HANDHOLE) INSIDE THE BOTTOM OF THE HANDHOLE.
- 6 CONTRACTOR TO PROVIDE AND INSTALL NEW 4/0 AWG BARE COPPER GROUNDING GRID CONDUCTOR BETWEEN ASSOCIATED GROUND RODS.
- 7 CONTRACTOR TO PROVIDE AND INSTALL EXOTHERMIC WELD. ERICO TYPE GT.
- 8 CONTRACTOR TO PROVIDE AND INSTALL NEW 57,400 CIRCULAR MIL BARE COPPER CONDUCTOR TO NEW 98,600 CIRCULAR MILS BARE ALUMINUM DOWN CONDUCTOR. REFER ALSO TO DETAIL 2 ON THIS SHEET.
- 9 CONTRACTOR TO PROVIDE AND INSTALL EXOTHERMIC WELD. ERICO TYPE GJ.
- 10 FINISHED GRADE.

NOTE: EXOTHERMIC WELD TYPES MAY DIFFER BASED ON APPLICATION.



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148400067

DATE  
OCT 2021

SCALE AS SHOWN

DESIGNED BY TDT

DRAWN BY JLH

CHECKED BY GLW



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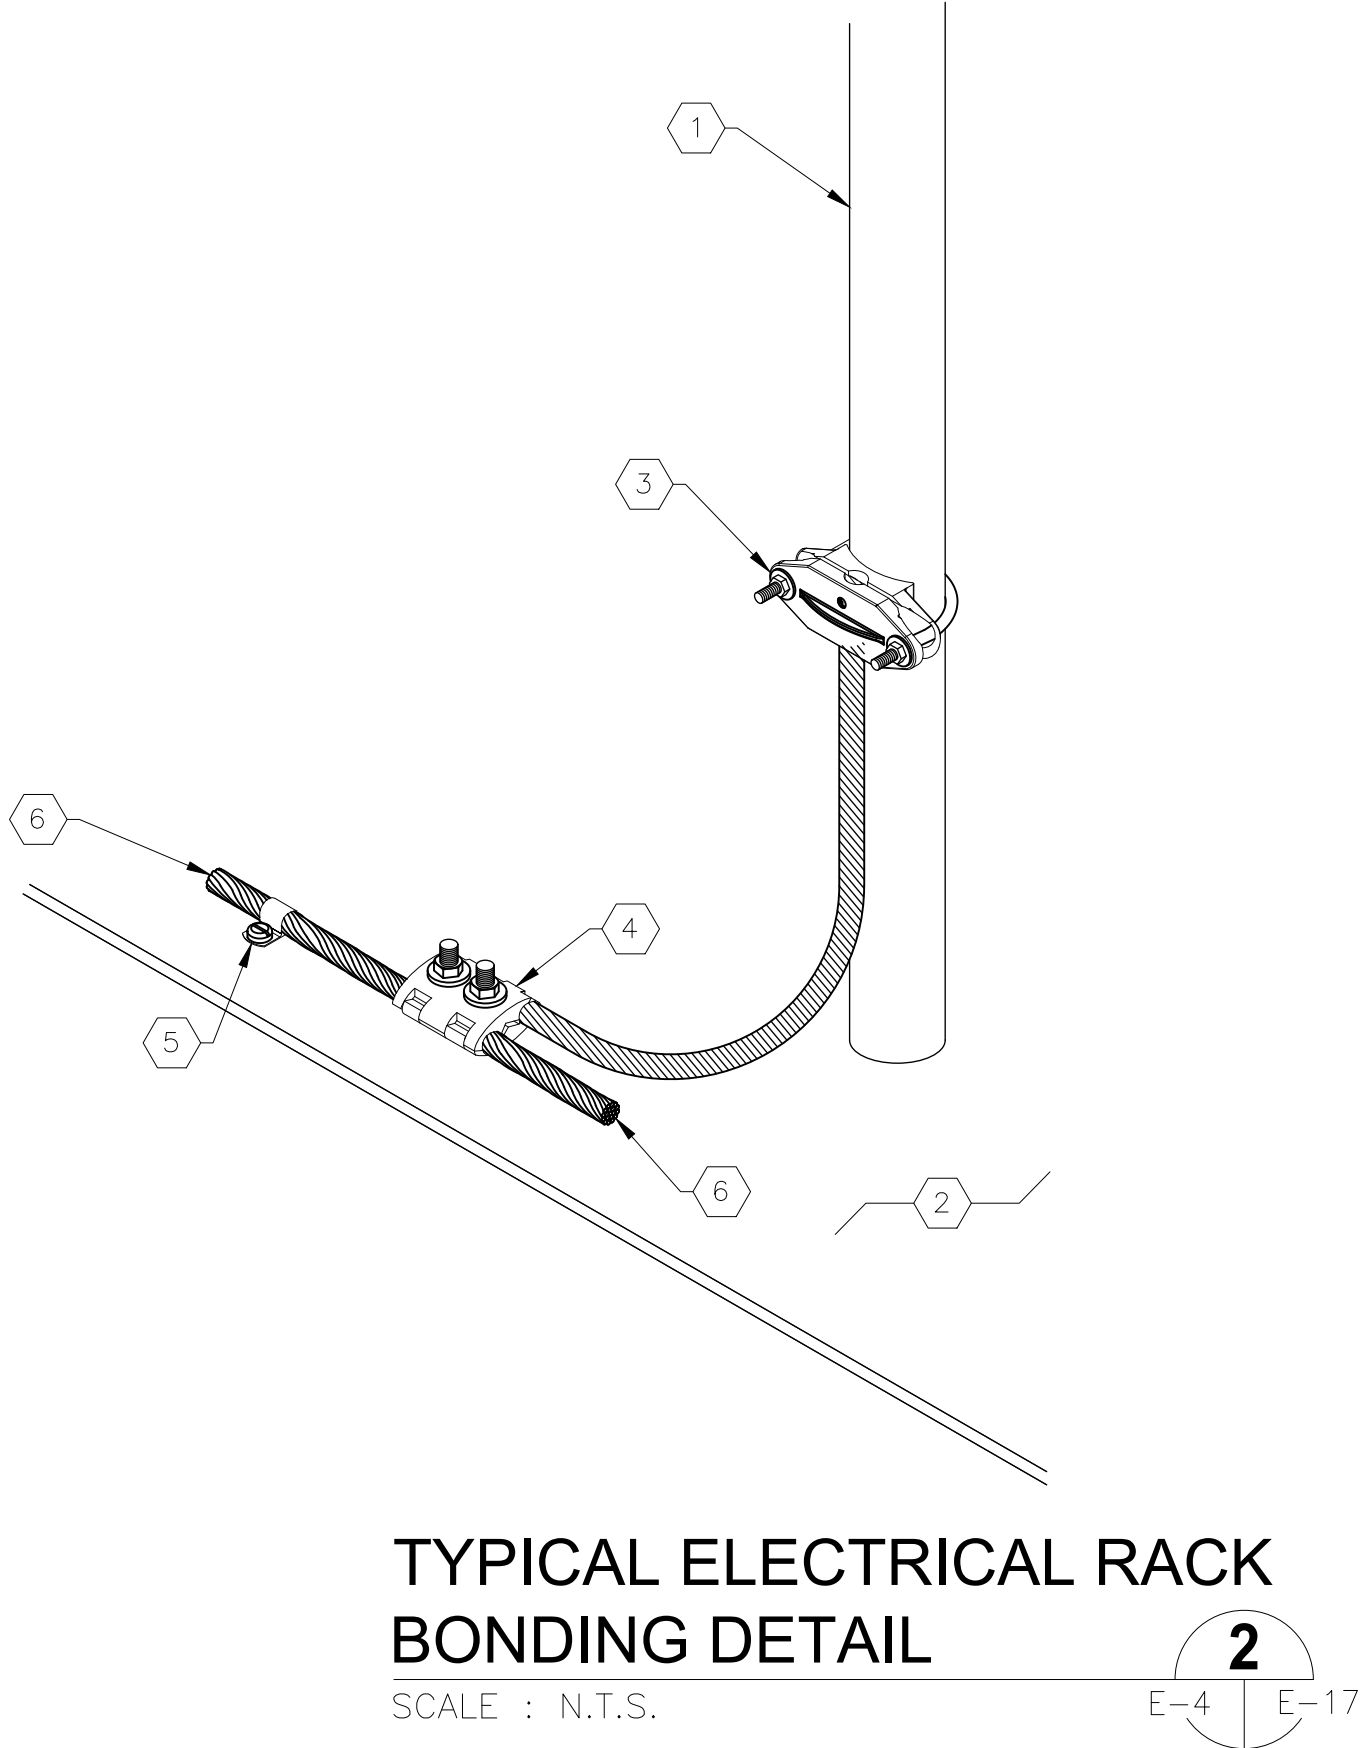
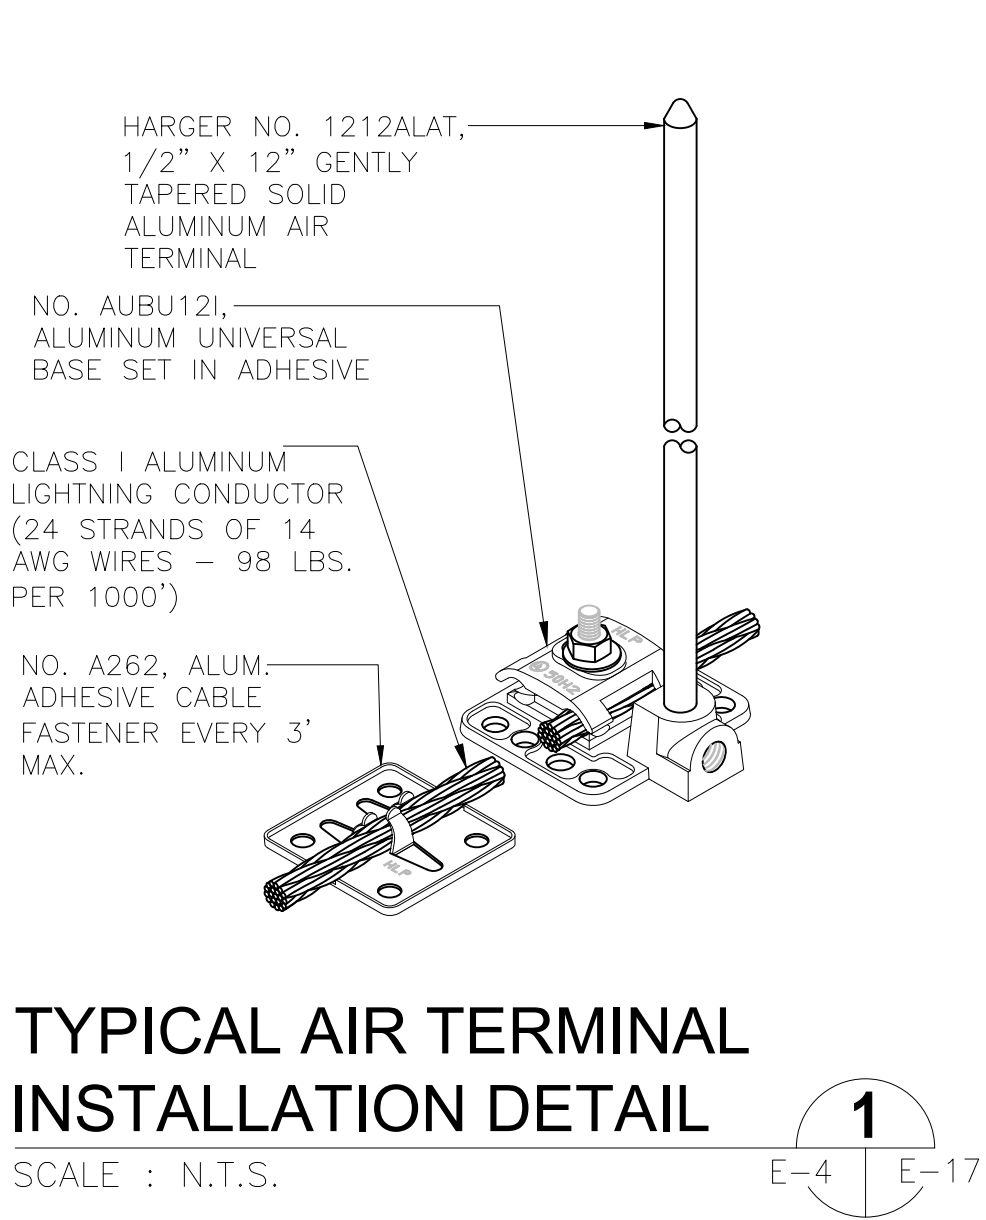
LIGHTNING PROTECTION  
DETAILS

SHEET NUMBER

E-16



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**HANDRAIL BONDING KEYED NOTES:**

- 1 PROPOSED ELECTRICAL RACK POST.
- 2 TOP OF ELEVATED PLATFORM SLAB.
- 3 CONTRACTOR TO PROVIDE AND INSTALL ALUMINUM U-BOLT BONDING CLAMP.
- 4 CONTRACTOR TO PROVIDE AND INSTALL ALUMINUM CABLE SPLICER. THOMPSON LIGHTNING PROTECTION (TLP) A423 OR APPROVED EQUAL.
- 5 CONTRACTOR TO PROVIDE AND INSTALL ALUMINUM LOOP CABLE HOLDER. THOMPSON LIGHTNING PROTECTION (TLP) A165 OR APPROVED EQUAL. LIGHTNING PROTECTION CONDUCTOR SHALL BE FASTENED EVERY 3'-0" MINIMUM.
- 6 MAIN LIGHTNING PROTECTION CONDUCTOR TO CONTINUE.
- 7 EDGE OF ELEVATED PLATFORM SLAB.

NOTE: PROPOSED HANDRAIL TO BE INSTALLED ON TOP OF ELEVATED PLATFORM NOT SHOWN FOR CLARITY.

**LIGHTNING PROTECTION GENERAL NOTES:**

- CONTRACTOR SHALL SUBMIT SHOP DRAWINGS FOR APPROVAL PRIOR TO PURCHASING EQUIPMENT OR COMMENCING CONSTRUCTION.
- LOCATE AIR TERMINALS AS SHOWN. TAKE CARE TO INSURE THAT ALL POINTS ARE WITHIN 2'-0" OF OUTSIDE BUILDING EDGE, OUTSIDE CORNERS, AND RIDGE ENDS, AND THAT MAXIMUM SPACING DOES NOT EXCEED 20'-0", AND THAT MINIMUM PROJECTION ABOVE OBJECT PROTECTED IS 18".
- MAINTAIN HORIZONTAL OR DOWNWARD COURSING OF MAIN CONDUCTOR AND INSURE THAT ALL BENDS HAVE AT LEAST AN 8" RADIUS AND DO NOT EXCEED 90°.
- ALL LIGHTNING PROTECTION COMPONENTS SHALL BE ALUMINUM EXCEPT FOR BELOW GRADE INSTALLATIONS.
- ATTACH ALL EXPOSED ROOF, DOWN LEAD AND BONDING CABLES AT 3'-0" ON CENTER MAXIMUM.
- INTERCONNECT LIGHTNING PROTECTION GROUND TO ELECTRIC, TELEPHONE, AND OTHER BUILDING GROUND SYSTEMS AS SHOWN OR AS REQUIRED BY CODE.
- ALL MATERIALS ARE UNDERWRITERS LABORATORIES APPROVED WITH LABELS ON CONDUCTORS AT 10'-0" INTERVALS AND LABELS ON ALL AIR TERMINALS.
- ALL NEW LIGHTNING PROTECTION SYSTEMS SHALL MEET THE REQUIREMENTS OF NFPA 780 AND AFTER INSTALLATION THE CONTRACTOR SHALL SUBMIT A CERTIFICATION APPLICATION TO UNDERWRITERS LABORATORIES (U.L.) FOR INSPECTION AND THE ISSUANCE OF A U.L. MASTER LABEL.
- ALL MATERIALS SHOWN AND INTENDED FOR USE ARE TO BE AS MANUFACTURED BY THOMPSON LIGHTNING PROTECTION INC., ERICO OR HARGER WILL BE CONSIDERED EQUAL.
- INSTALLATION SHALL COMPLY IN ALL RESPECTS TO L.P.I. CODE 175, U.L. 96A, NFPA 70 AND NFPA 780.
- ALL NEW LIGHTNING PROTECTION SYSTEMS SHALL MEET THE REQUIREMENTS OF NFPA 780 AND AFTER INSTALLATION THE CONTRACTOR SHALL SUBMIT A CERTIFICATION APPLICATION TO UNDERWRITERS LABORATORIES (U.L.) FOR INSPECTION AND THE ISSUANCE OF A U.L. MASTER LABEL. THE LOCATION AND QUANTITY OF AIR TERMINALS MAY DEVIATE FROM THE CONTRACT DOCUMENTS IF THE FINAL SYSTEM DESIGN CONFORMS TO THE STANDARDS IN THESE SPECIFICATIONS. HOWEVER, OTHER METHODS, MATERIALS AND MEANS SHALL NOT DEVIATE FROM THE STANDARDS ADOPTED BY THE HILLSBOROUGH COUNTY PUBLIC UTILITIES DEPARTMENT. THE HILLSBOROUGH COUNTY STANDARDS INCLUDE :
  - A. HANDHOLES ARE TO BE PROVIDED WHERE ANY BUILDING DOWN CONDUCTOR IS ATTACHED TO A GROUND ROD.
  - B. HANDHOLES ARE TO BE PROVIDED WHERE ANY GROUNDING ELECTRODE CONDUCTOR IS ATTACHED TO A GROUND ROD.
  - C. HANDHOLES ARE TO BE PROVIDED WHERE ANY TWO UNDERGROUND CONDUCTORS ARE ATTACHED.
  - D. ALL CONNECTIONS BETWEEN CONDUCTORS, OR WHERE CONDUCTORS ATTACH TO GROUND RODS, SHALL BE VIA EXOTHERMIC WELDS. NO MECHANICAL BONDING CLAMPS WILL BE PERMITTED.
  - E. ALL NEW COMPONENTS SHALL BE OF A SIMILAR MATERIAL (ALUMINUM). IN INSTANCES WHERE EXISTING COMPONENTS ARE CONSTRUCTED FROM A MATERIAL OTHER THAN ALUMINUM, METHODS FOR CONNECTING DISSIMILAR METALS WILL BE EMPLOYED.
  - F. EVEN WHERE ALLOWED BY N.F.P.A. 780, STRUCTURAL COMPONENTS, SUCH AS HANDRAILS, STANCHIONS, OR LIGHT POLES SHALL NOT BE USED AS CONDUCTORS FOR THE LIGHTNING PROTECTION SYSTEM. ALL CONNECTIONS BETWEEN AIR TERMINALS OR ANY OTHER LIGHTNING SYSTEM COMPONENTS SHALL BE VIA BRAIDED ALUMINUM CONDUCTORS.
  - G. AFTER INSTALLATION, THE CONTRACTOR SHALL MEASURE THE GROUND RESISTANCE OF ANY NEW LIGHTNING PROTECTION SYSTEM GROUND ROD. THE MEASURED RESISTANCE SHALL NOT EXCEED MAXIMUM ALLOWED LIGHTNING GROUND ROD RESISTANCE PER NFPA 780 OF 25.0 OHMS.
  - H. BENDS IN CONDUCTORS SHALL BE GRADUAL WITH A RADIUS OF 8-INCHES OR GREATER, FORMING AN ANGLE OF AT LEAST 90 DEGREES.
  - I. INTERCONNECTION OF METALS.
    - a. ALL METAL BODIES WITHIN 6-FEET OF THE CONDUCTOR SHALL BE BONDED TO THE SYSTEM WITH APPROVED FITTINGS AND CONDUCTOR.
    - b. BONDING OF ALL METALLIC OBJECTS AND SYSTEMS AT ROOF LEVELS AND ELSEWHERE ON THE STRUCTURE SHALL BE COMPLETE. PRIMARY BONDS FOR METAL BODIES OF CONDUCTANCE SHALL BE BONDED WITH APPROPRIATE FITTINGS AND FULL-SIZE CONDUCTOR; AND SHALL CONSIST OF AT LEAST THE FOLLOWING; ROOF EXHAUST FANS, METALLIC EXHAUST VENTS, METALLIC ACCESS HATCH AND ANY HANDRAILS, LADDERS OR SAFETY CAGES.
    - c. METAL BODIES OF INDUCTANCE LOCATED WITHIN 6-FEET OF A CONDUCTOR OR OBJECT WITH SECONDARY BONDS SHALL BE BONDED WITH SECONDARY CABLE AND FITTINGS. TYPICAL OF THESE ARE: STEEL SUPPORTS FOR ANCILLARY EQUIPMENT, VENTS, PIPING AND ANY OTHER SIZEABLE MISCELLANEOUS METALS, ETC.
- HANDRAILS SHALL BE BONDED TO LIGHTNING PROTECTION CONDUCTOR AT A MAXIMUM OF 40'-0" INTERVALS.

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 <b>BAYSHORE YACHT BASIN</b>
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<b>LIGHTNING PROTECTION DETAILS AND NOTES</b>
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SHEET NUMBER  <b>E-17</b>
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

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No.	REVISIONS	DATE	BY						



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FUNCTION SYMBOL SCHEDULE

IDENTIFICATION LETTERS				
	FIRST LETTER		SUCCEEDING LETTERS	
	MEASURED OR INITIATING VARIABLE	MODIFIER	READOUT OR PASSIVE FUNCTION	OUTPUT FUNCTION
A	ANALYSIS		ALARM	
B	BURNER, COMBUSTION		PROGRAMMER	
C	CONDUCTIVITY			CLOSED
D	DENSITY	DIFFERENTIAL		
E	VOLTAGE		SENSOR (PRIMARY ELEMENT)	
F	FLOW RATE	RATIO (FRACTION)		
G	GAGING		GLASS VIEWING DEVICE	
H	HAND			HIGH
I	CURRENT (ELECTRICAL)		INDICATE	
J	POWER	SCAN		
K	TIME, TIME SCHEDULE	TIME RATE OF CHANGE		CONTROL STATION
L	LEVEL		LIGHT (PILOT)	LOW
M	MOTOR	MOMENTARY		MIDDLE, INTERMEDIATE
N	VIBRATION		IGNITOR	ISOLATOR
O	OPERATION	OFFSET	ORIFICE, RESTRICTION	OPEN
P	PRESSURE, VACUUM		POINT (TEST) CONNECTION	
Q	QUANTITY, EVENT	INTEGRATE, TOTALIZE	INTEGRATE	
R	RADIATION		RECORD, PRINT	
S	SPEED, FREQUENCY	SAFETY		SWITCH
T	TEMPERATURE			TRANSMIT
U	MULTIVARIABLE	TREND	MULTIFUNCTION	MULTIFUNCTION
V	VISCOSITY	VACUUM		VALVE, DAMPER, LOUVER, GATE
W	WEIGHT, FORCE, TORQUE		WELL	
X	UNCLASSIFIED		UNCLASSIFIED	UNCLASSIFIED
Y			RELAY, COMPUTE, CONVERT	
Z	POSITION		FINAL CONTROL ELEMENT	UNCLASSIFIED

LINE DESIGNATIONS

INSTRUMENTATION SIGNAL ——— ———  
ELECTRICAL POWER ——— . ———  
DATA LINK ———D———D———  
RADIO LINK ———R———R———  
FIBER OPTIC DATA ———F———F———

CONTROLLER NOTATION

PV= PROCESS VARIABLE INPUT  
SP= SET POINT INPUT  
C= CONTROL OUTPUT

INPUT/OUTPUT NOTATIONS

AI = ANALOG INPUT  
AO= ANALOG OUTPUT  
DI = DISCRETE INPUT  
DO= DISCRETE OUTPUT

HAND SWITCH NOTATION

HOA = HAND-OFF-AUTO  
S/S = START/STOP  
SEL = SELECTOR  
O/C = OPEN/CLOSE  
O/O = ON/OFF  
LOS = LOCKOUT-START  
LOR = LOCAL-OFF-REMOTE  
OAC = OPEN-AUTO CLOSE  
CAO = CLOSED-AUTO OPEN

MISCELLANEOUS NOTATIONS

S/D = SHUTDOWN  
O/R = OVERRIDE  
MCS = MASTER CONTROL STATION  
VFD = VARIABLE FREQUENCY DRIVE  
PCC = PROCESS CONTROL CABINET  
LCP = LOCAL CONTROL PANEL  
ES = ELECTRICAL SUPPLY (120VAC)

EQUIPMENT NOTATION

B = BLOWER OR FAN  
E = ENGINE  
G = GENERATOR  
F = FILTER  
GS = GRINDER/SCREEN  
K = COMPRESSOR  
H = HOIST  
ME = MECHANICAL EQUIPMENT  
MX = MIXER  
P = PUMP  
T = TANK OR SUMP

VALVE DESIGNATIONS

MOV = MOTOR OPERATED VALVE

GENERAL ABBREVIATIONS

SCADA – SUPERVISORY CONTROL AND DATA ACQUISITION.  
PLC – PROGRAMMABLE LOGIC CONTROL  
SA – SURGE SUPPRESSOR DEVICE

I INTERLOCK  
1-3 CONTINUATION OF SIGNAL OR DATA TO/FROM SHEET NUMBER INDICATED

BASIC SYMBOLS

SINGLE FUNCTION



OR



OR



OR



OR



OR



OR



OR




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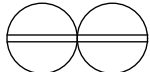


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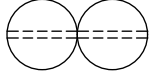
MUTIPLE FUNCTION




FIELD MOUNTED INSTRUMENT OR DEVICE

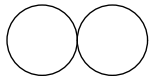


FRONT OF PANEL MOUNTED INSTRUMENT ON LCP, PCC, MCS, OR VFD




REAR OF PANEL MOUNTED INSTRUMENT ON LCP, PCC, MCS, OR VFD

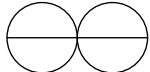


FRONT OF PANEL MOUNTED INSTRUMENT ON MAIN PANEL

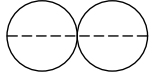

REAR OF PANEL MOUNTED INSTRUMENT ON MAIN PANEL

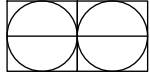

PLC AND/OR COMPUTER SOFTWARE COMPONENT (OPERATOR ACCESSIBLE UNDER NORMAL CONDITIONS) OR

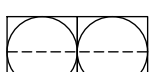


PLC AND/OR COMPUTER GENERATED COMPONENT (NOT OPERATOR ACCESSIBLE UNDER NORMAL CONDITIONS)




DATA FLOW SYSTEMS RTU INPUT/OUTPUT

= STATUS

THIS SYMBOL INDICATES THE FOLLOWING INSTRUMENTATION  
(NOTE : VALVE FAULT IS PLC GENERATED)

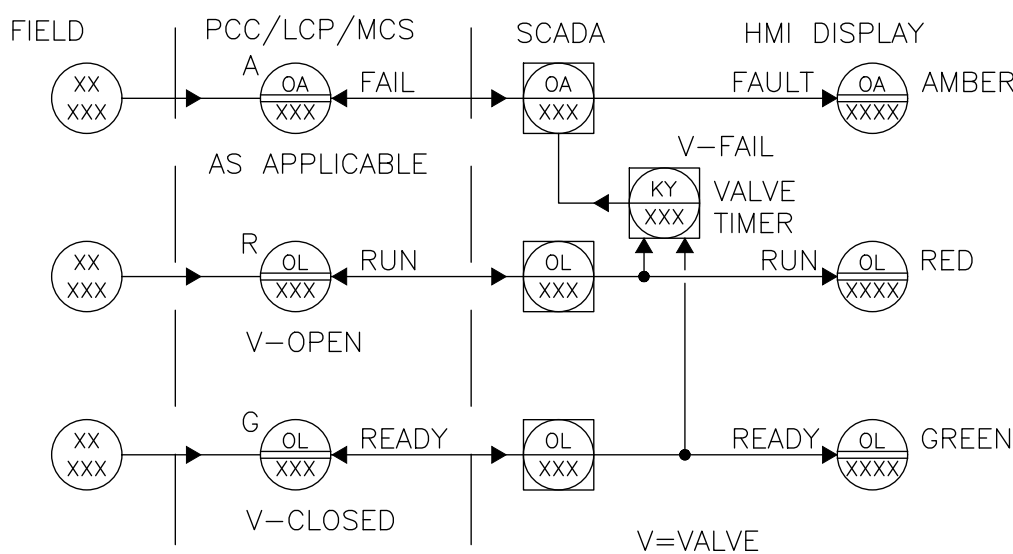

TYPICAL FOR   
(IF NOT OTHERWISE ILLUSTRATED ON DRAWINGS)

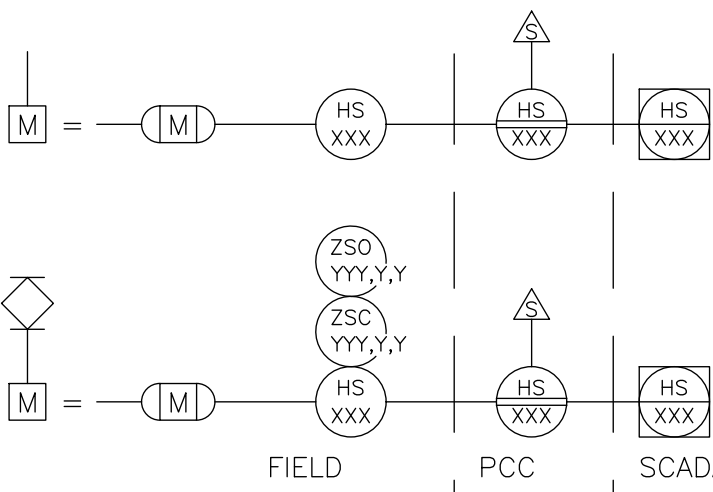

**Kimley»Horn**

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PHONE: 727-547-3999  
WWW.KIMLEY-HORN.COM REGISTRY NO. 696

KHA PROJECT  
148400067  
DATE  
OCT 2021  
SCALE AS SHOWN  
DESIGNED BY TDT  
DRAWN BY JLT  
CHECKED BY GLW



BAYSHORE YACHT BASIN FORCE MAIN  
AND LIFT STATION REPLACEMENT

LICENSED PROFESSIONAL

TIMOTHY THOMAS, P.E.

47079

DATE:

INSTRUMENTATION LEGEND  
AND ABBREVIATIONS

SHEET NUMBER

I-1

**TRICON**  
**ENGINEERING**  
777 S. Harbour Island Blvd., STE 350, TAMPA, FL 33602  
813.227.9190  
Certificate of Authorization No. 00031028




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813.227.9190  
Certificate of Authorization No. 00031028

120VAC 60Hz 1PH  
SUPPLY  
FROM PANELBOARD 'LP'  
CIRCUIT 7



WIRE LEGEND

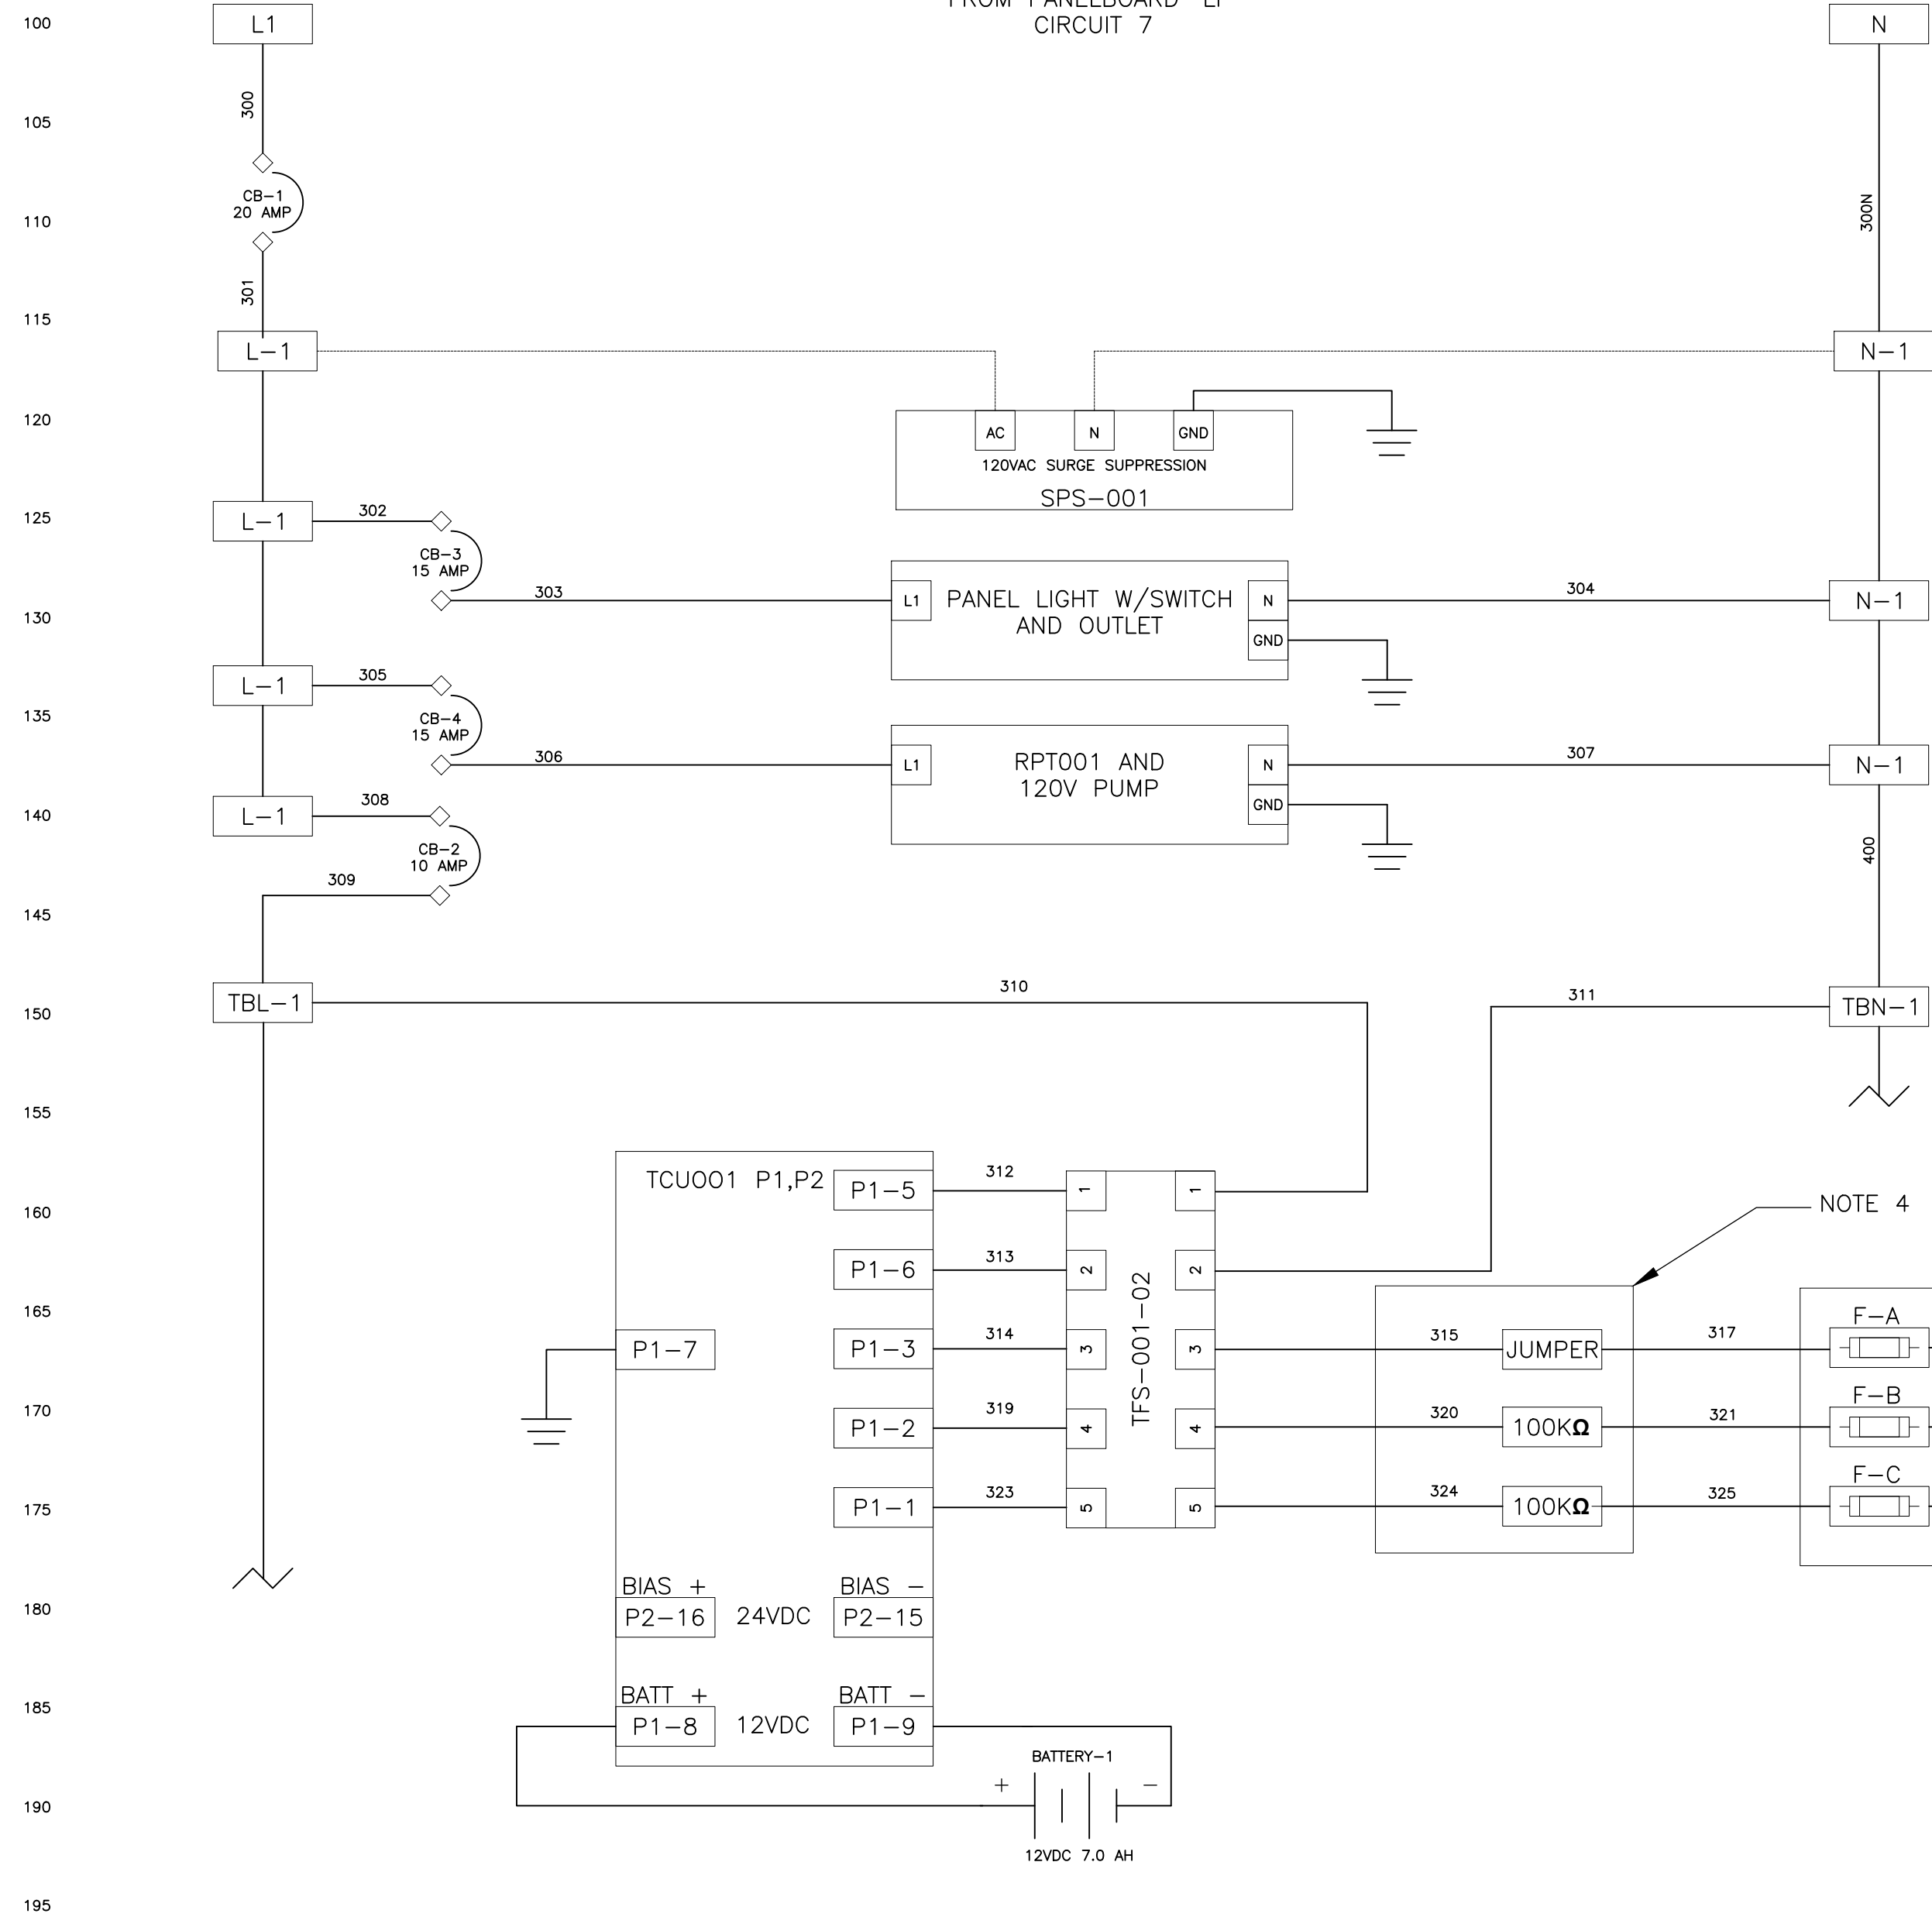CONTROL WIRE SIZE #16 UNLESS NOTED  
ANALOG WIRE #18 SHIELDED TWISTED PAIR  
AC CONTROL WIRES - RED  
NEUTRAL WIRES - WHITE  
DC+ WIRES - BLUE  
DC- WIRES - BLUE/WHITE  
POWERED FROM FIELD - YELLOW  
FIELD WIRING

NOTE:

- (1) ALL GROUNDING CONNECTIONS TO BE SINGLE POINT TO GROUND BUS ONLY.
- (2) AC AND DC BUS ARE TYPICAL TERMINAL BLOCK BUSES.
- (3) WIRES FOLLOW LEGEND UNLESS OTHERWISE MARKED.
- (4) ALL FUSES ARE 1 AMP SLOWBLOW UNLESS NOTED.
- (5) 250VAC RATED FUSES AND HOLDER REQUIRED FOR 240VAC LINE.
- (6) ALL POINT CONTACTS TO BE PROTECTED BY ANTIOXIDANT COMPOUND.

NOTE 4

NOTE 4


NOTE 4

NOTE 4

NOTE 4

NOTE 4

No.	REVISIONS	DATE	BY



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KHA PROJECT	148400067
DATE	OCT 2021
SCALE	AS SHOWN
DESIGNED BY	TDT
DRAWN BY	JLT
CHECKED BY	GLW



**BAYSHORE YACHT BASIN FORCE MAIN  
AND LIFT STATION REPLACEMENT**

LICENSED PROFESSIONAL

TIMOTHY THOMAS, P.E.

47079

DATE:


DATA FLOW SYSTEMS  
CONTROL PANEL  
WIRING DIAGRAMS

SHEET NUMBER

I-2



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WIRE LEGEND

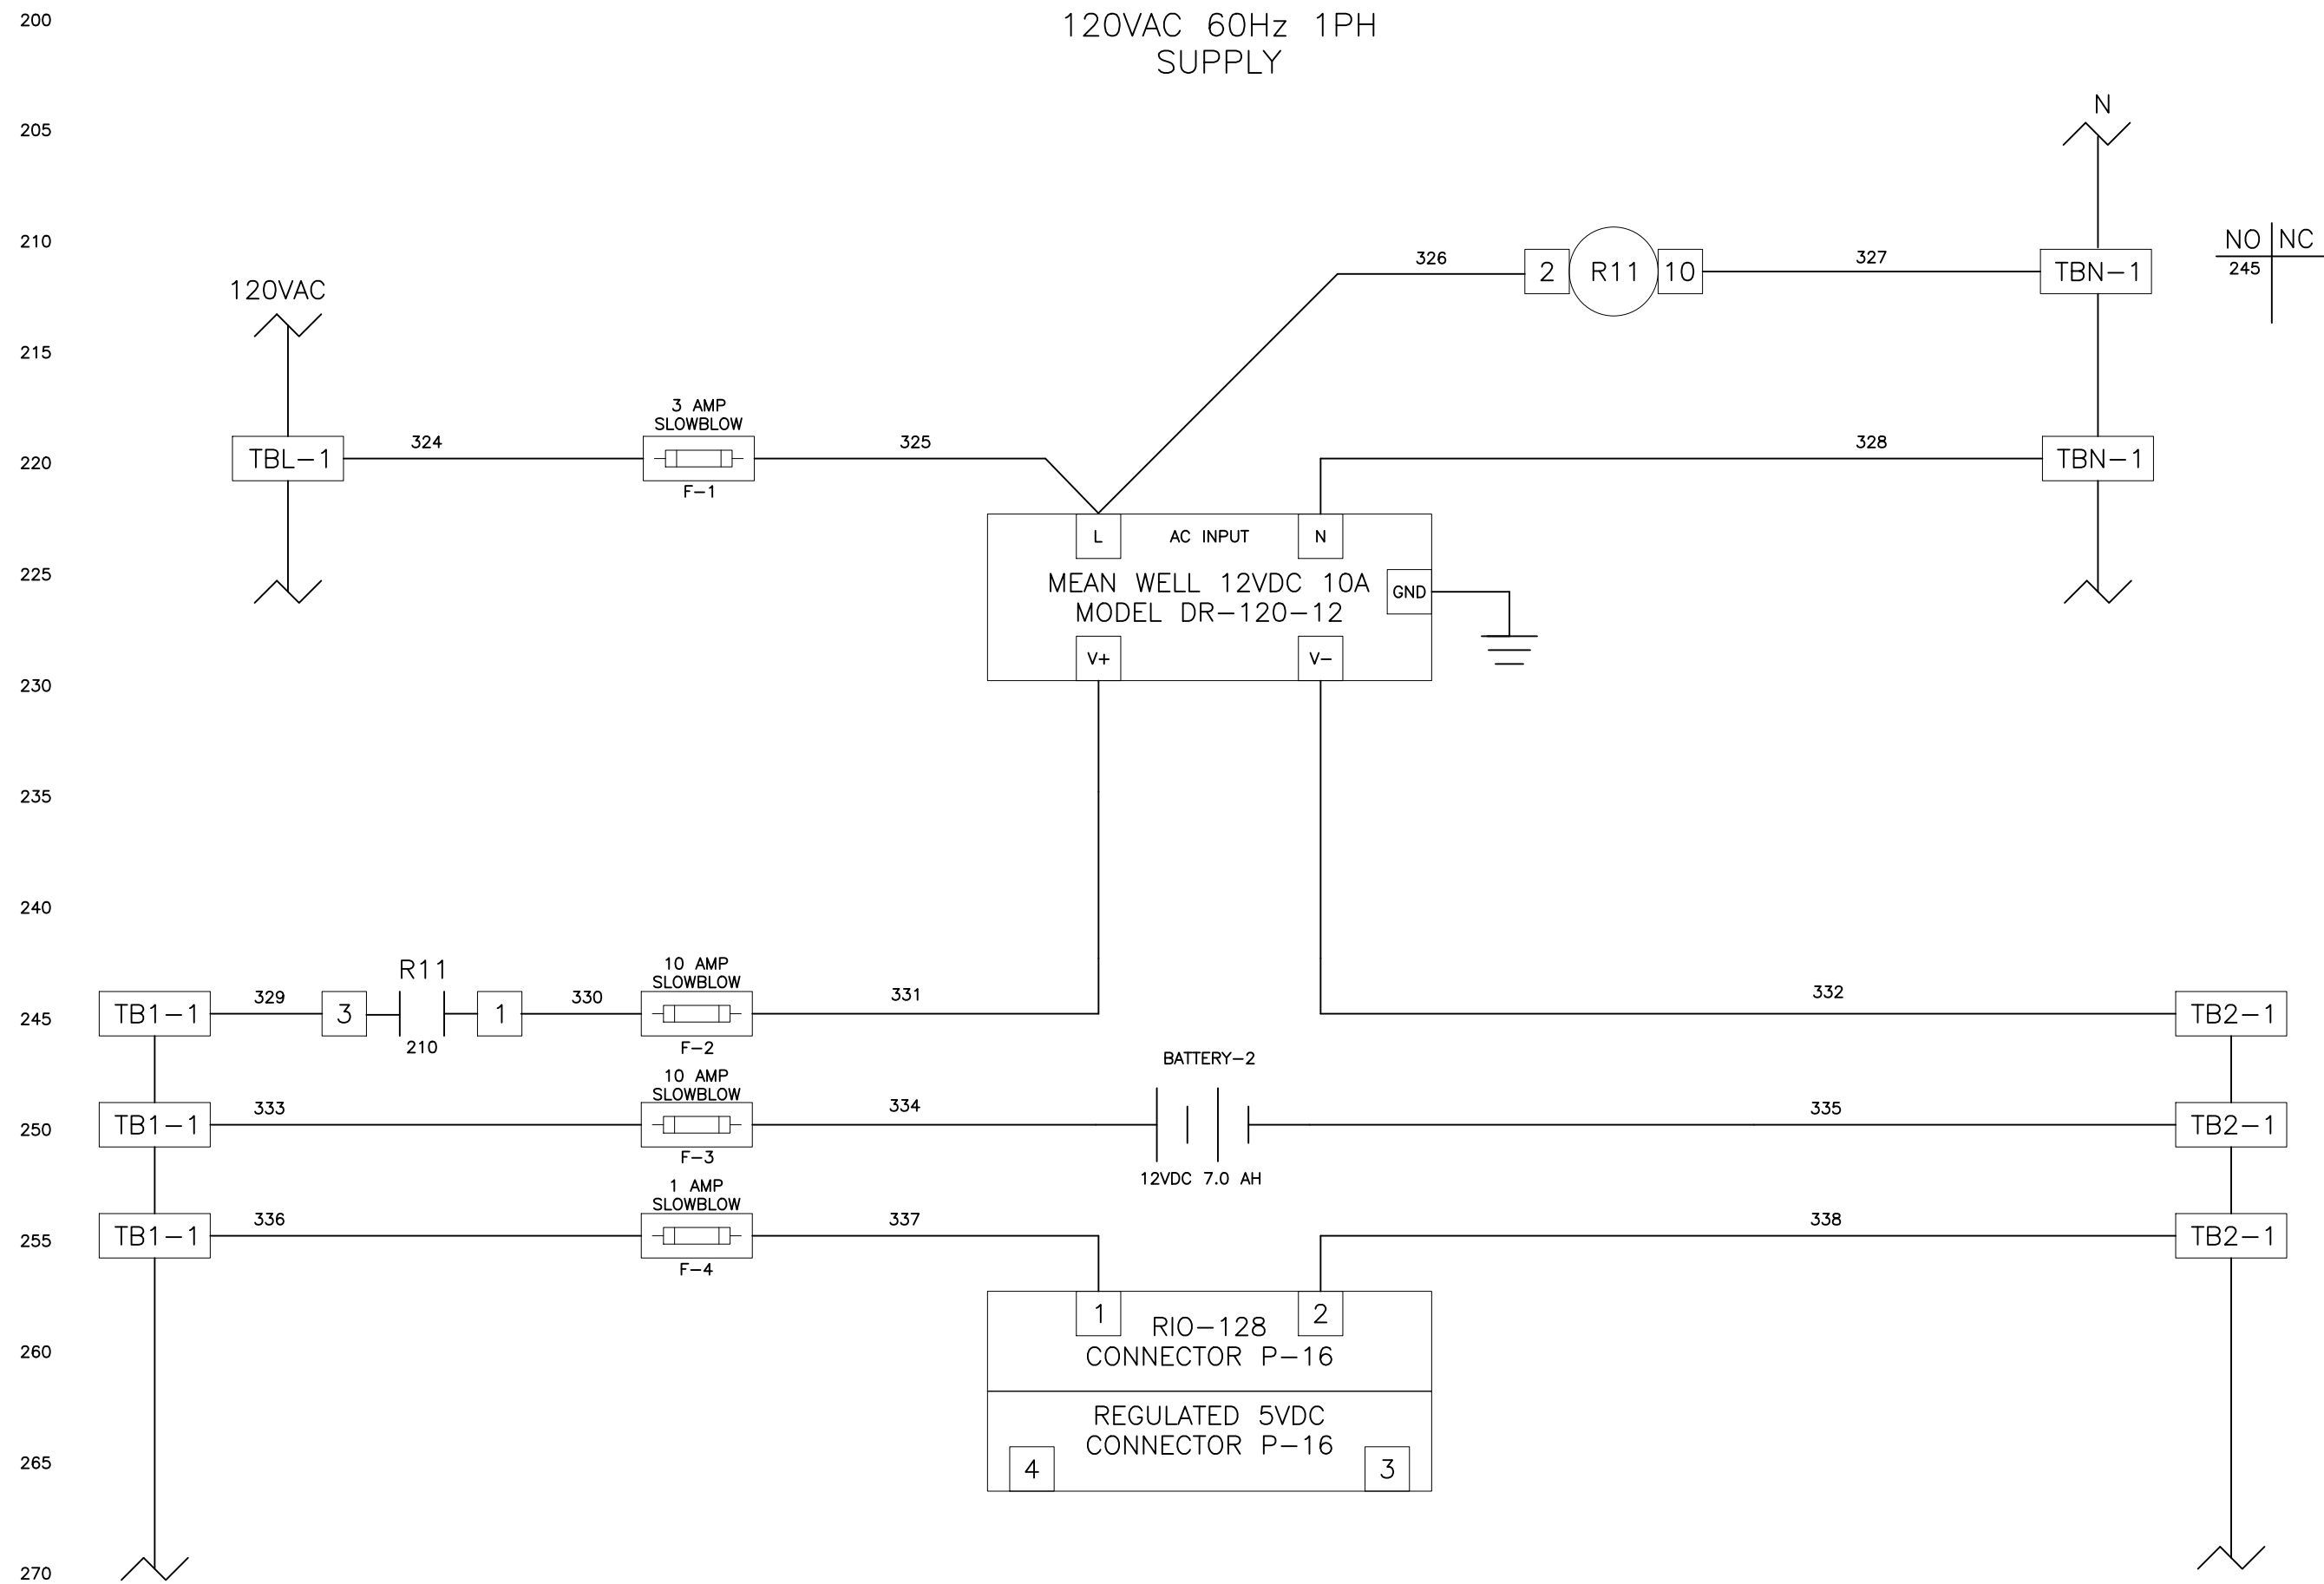CONTROL WIRE SIZE #16 UNLESS NOTED  
ANALOG WIRE #18 SHIELDED TWISTED PAIR  
AC CONTROL WIRES - RED  
NEUTRAL WIRES - WHITE  
DC+ WIRES - BLUE  
DC- WIRES - BLUE/WHITE  
POWERED FROM FIELD - YELLOW  
FIELD WIRING

NOTE:

- (1) ALL GROUNDING CONNECTIONS TO BE SINGLE POINT TO GROUND BUS ONLY.  
(2) AC AND DC BUS ARE TYPICAL TERMINAL BLOCK BUSES.  
(3) WIRES FOLLOW LEGEND UNLESS OTHERWISE MARKED.  
(4) ALL POINT CONTACTS TO BE PROTECTED BY ANTIOXIDANT COMPOUND.



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LICENSED PROFESSIONAL  
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DATE:

DATA FLOW SYSTEMS  
CONTROL PANEL  
WIRING DIAGRAMS

SHEET NUMBER


I-3



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AND LIFT STATION REPLACEMENT


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DATA FLOW SYSTEMS  
CONTROL PANEL  
WIRING DIAGRAMS

SHEET NUMBER  
I-4

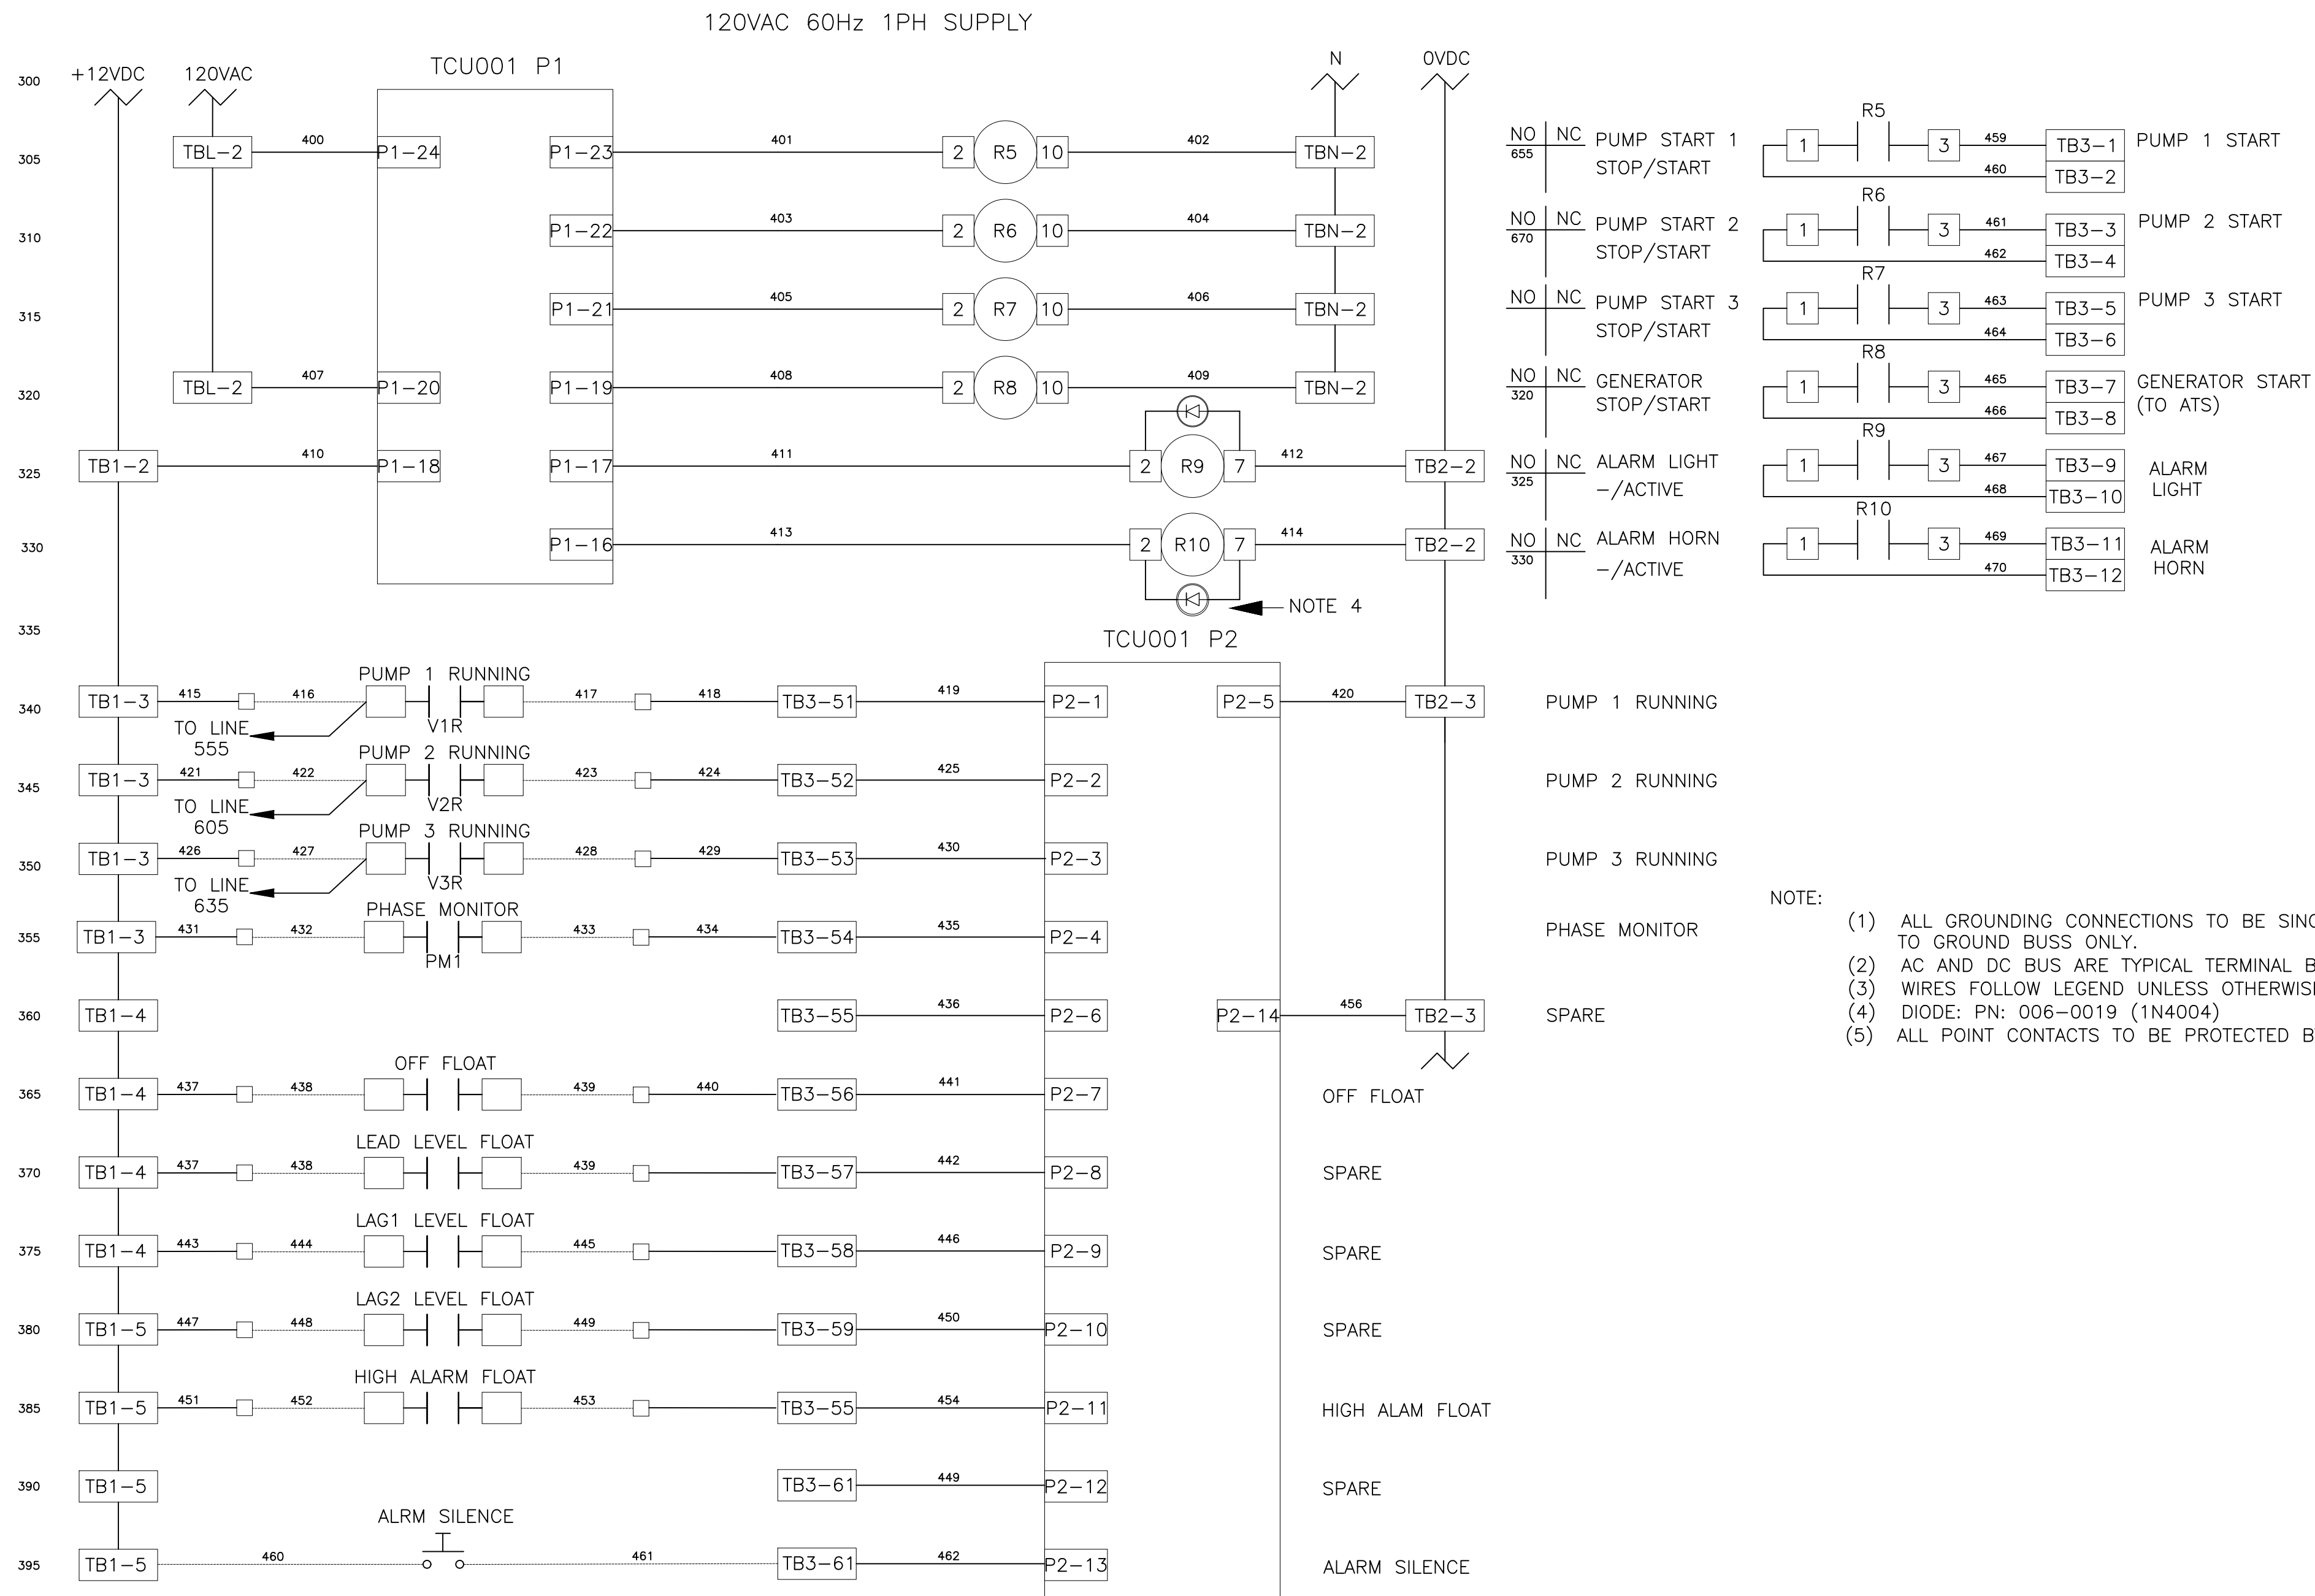

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BAYSHORE YACHT BASIN FORCE MAIN  
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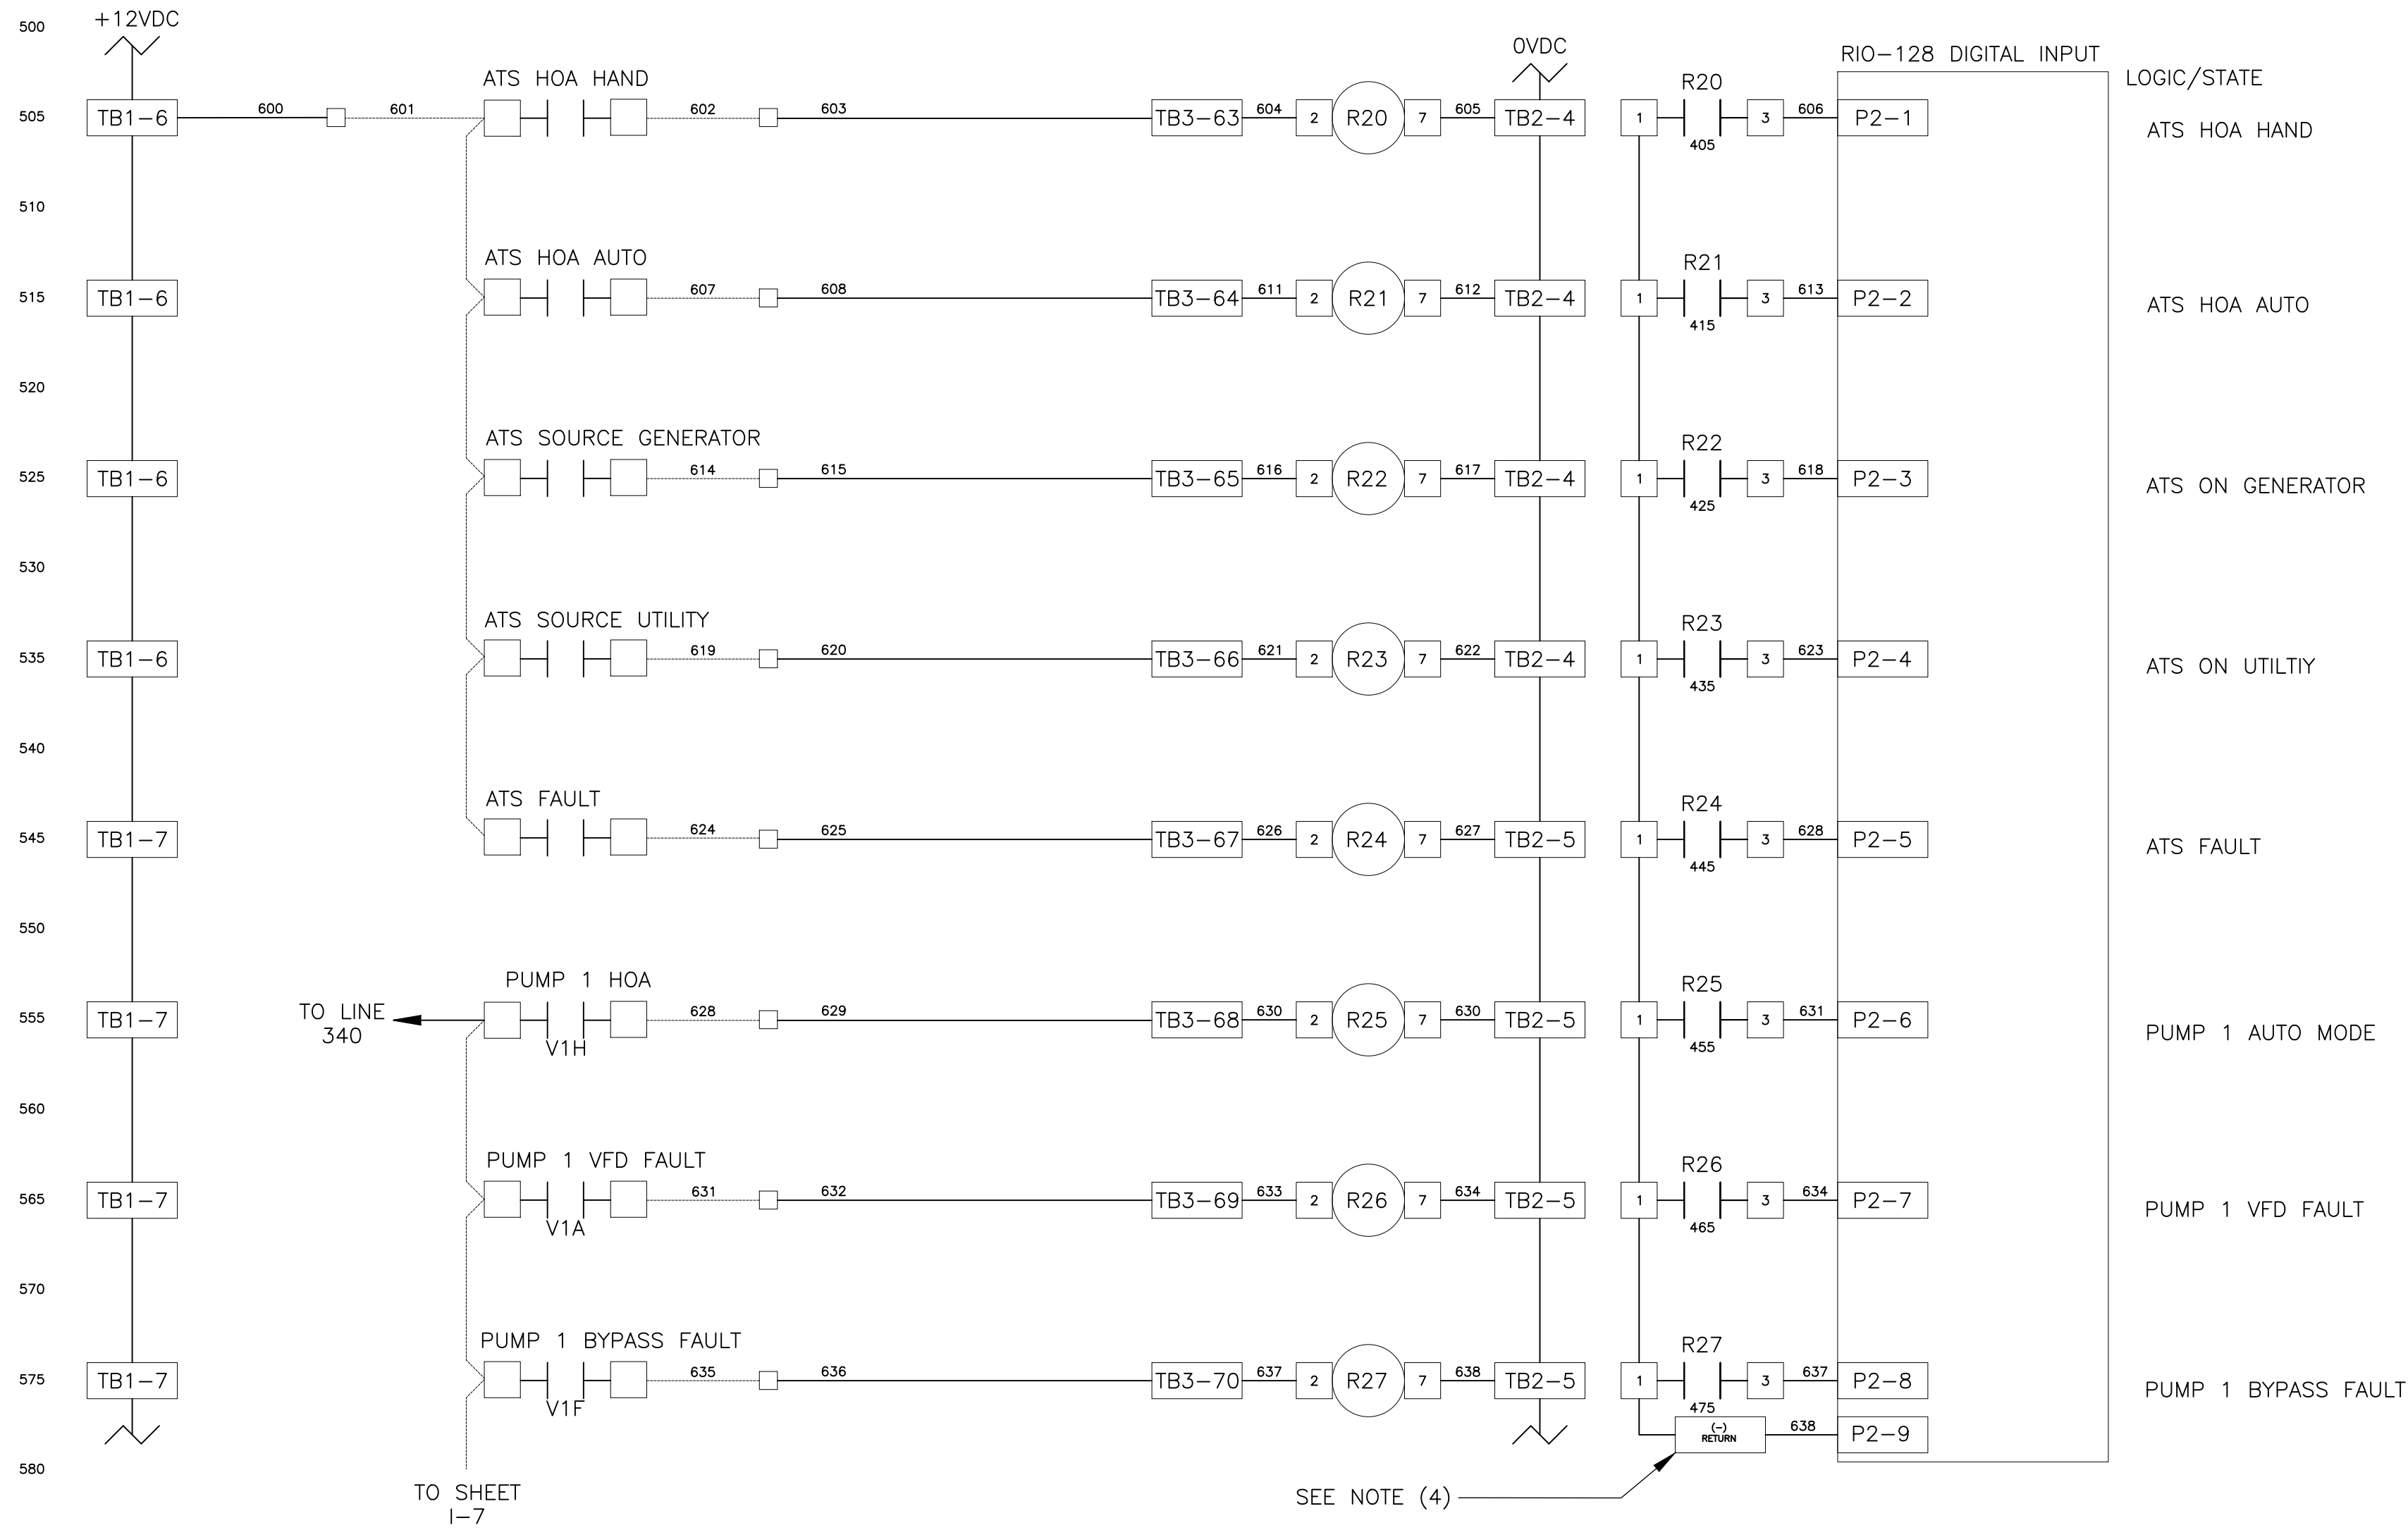
DATA FLOW SYSTEMS  
CONTROL PANEL  
WIRING DIAGRAMS

SHEET NUMBER  
I-5
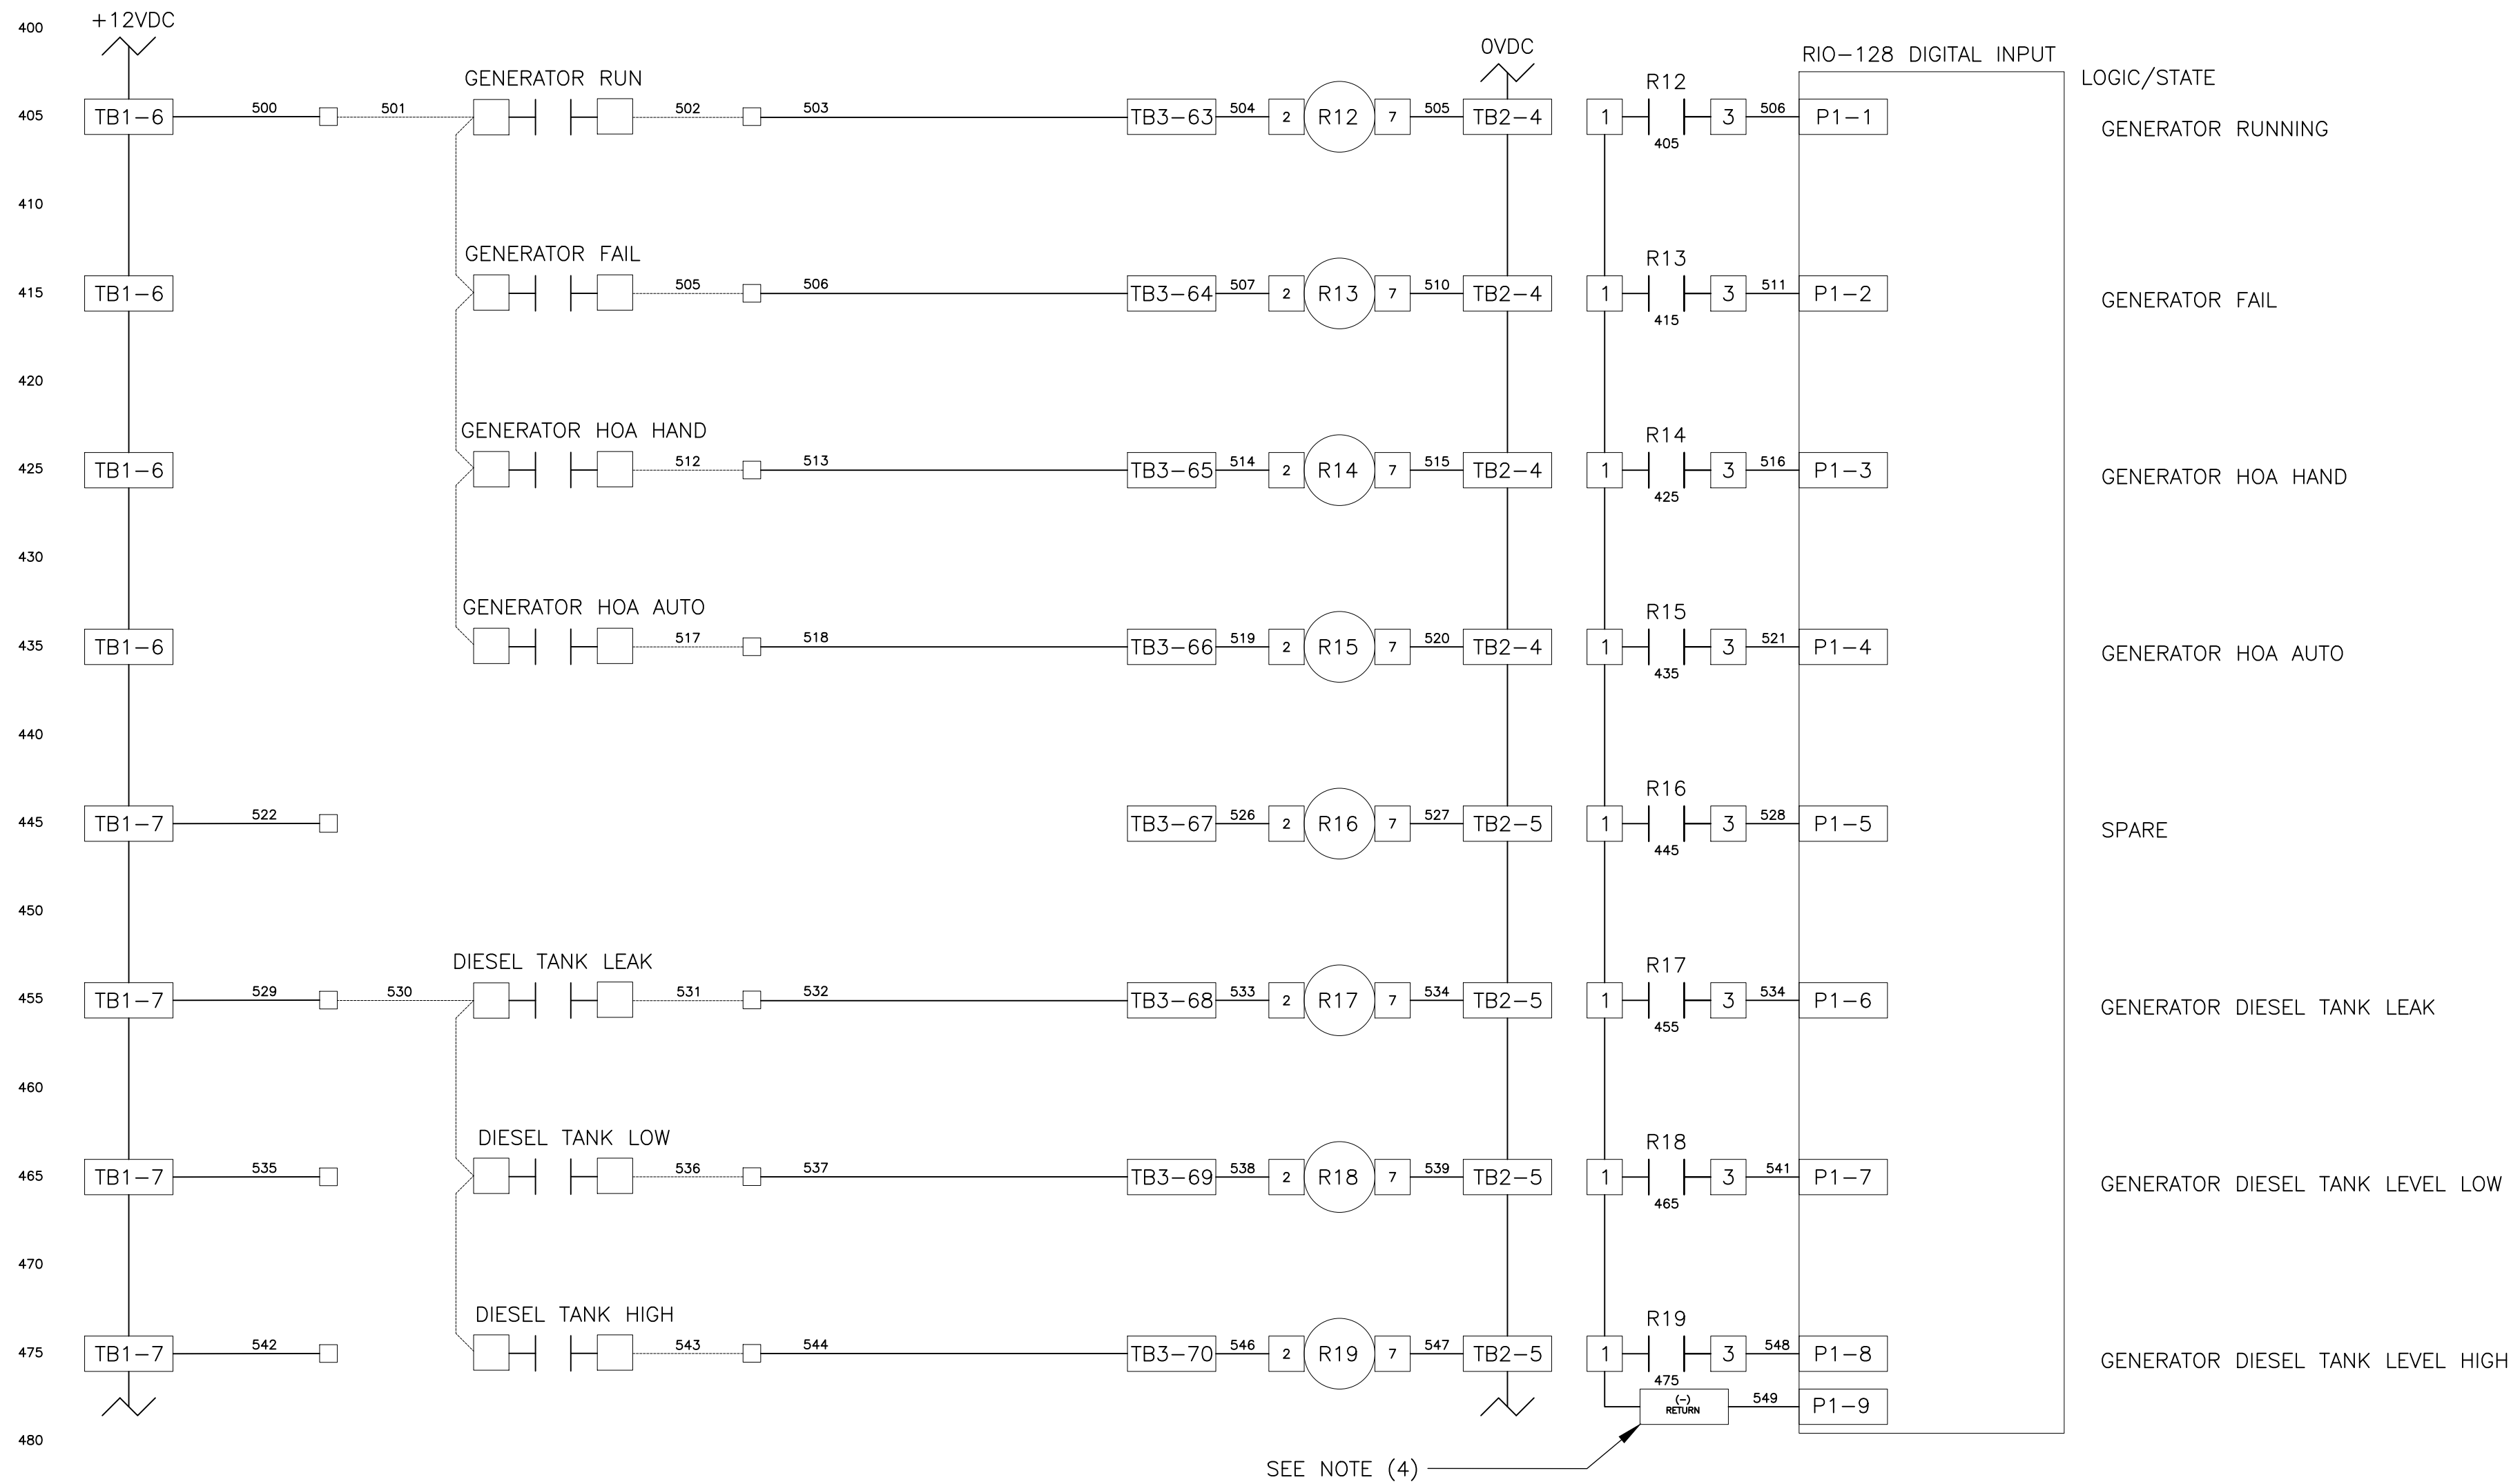
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(2) AC AND DC BUS ARE TYPICAL TERMINAL BLOCK BUSES.  
(3) WIRES FOLLOW LEGEND UNLESS OTHERWISE MARKED.  
(4) TERMINAL BLOCKS ARE FOR THE DC RETURN (-) BUS FOR THE RIO-128 DIGITAL INPUTS.  
(5) ALL POINT CONTACTS TO BE PROTECTED BY ANTIOXIDANT COMPOUND.



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BAYSHORE YACHT BASIN FORCE MAIN  
AND LIFT STATION REPLACEMENT

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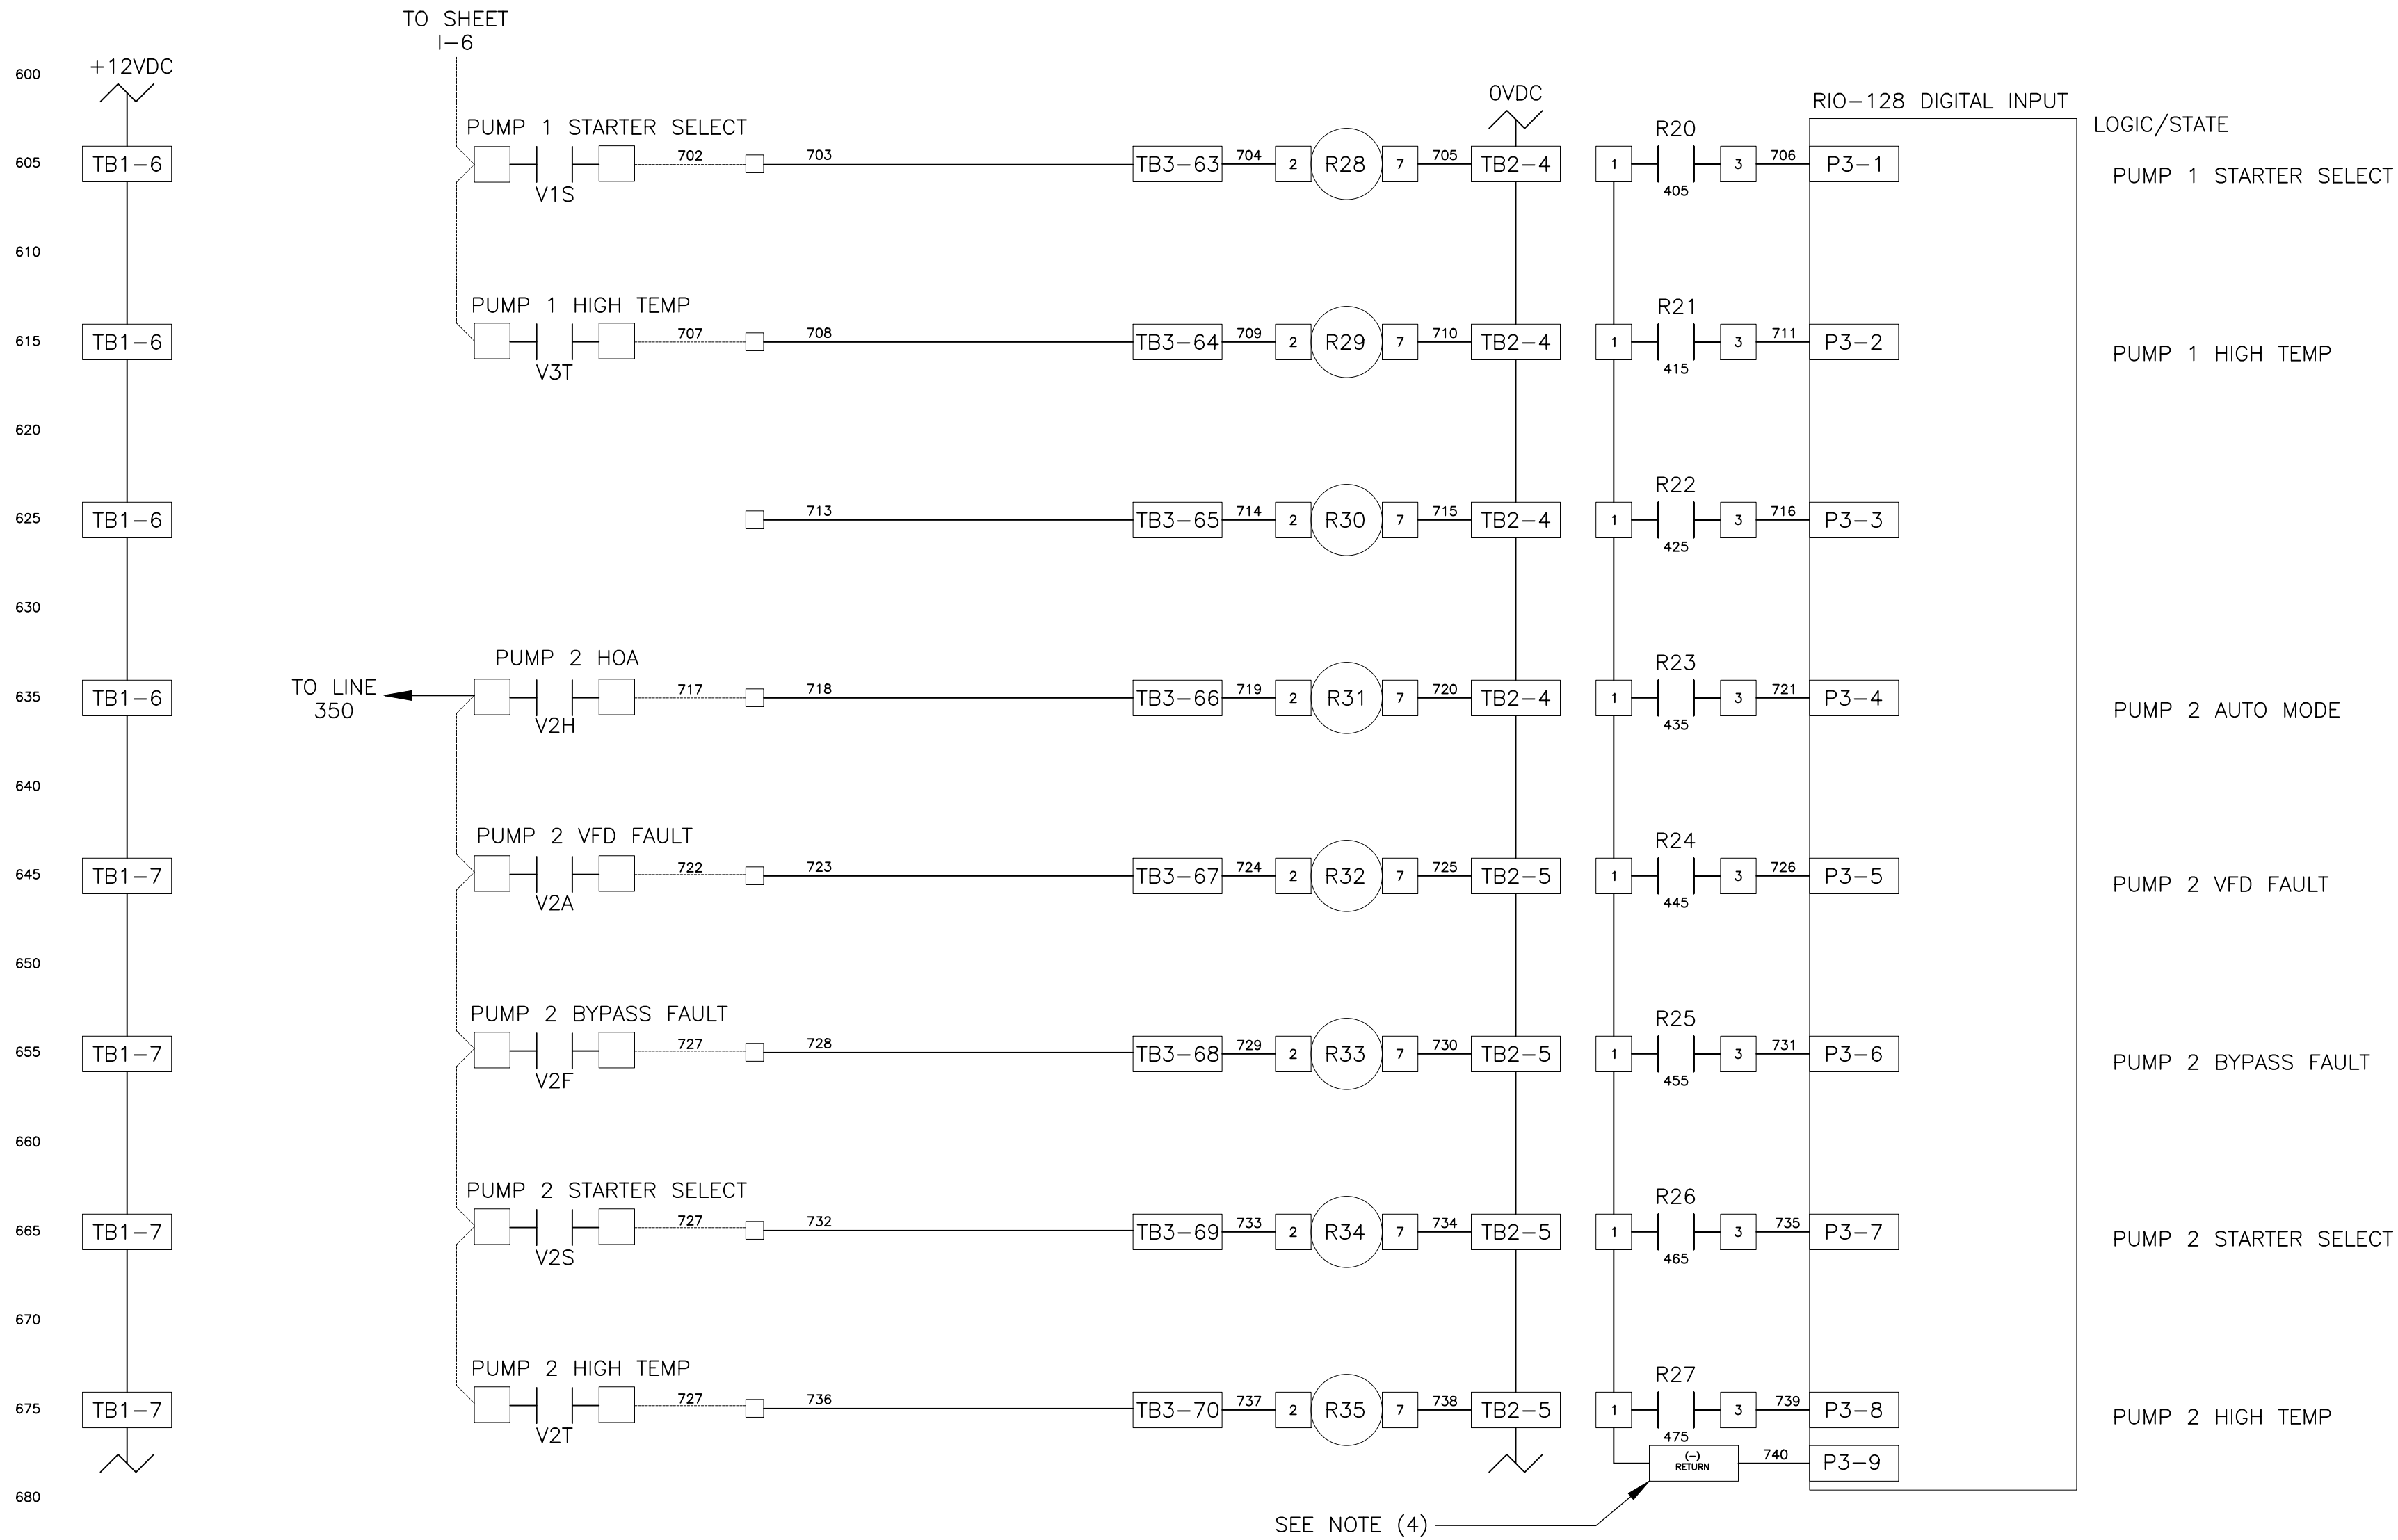
DATA FLOW SYSTEMS  
CONTROL PANEL  
WIRING DIAGRAMS

SHEET NUMBER

I-6



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WIRE LEGEND

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ANALOG WIRE #18 SHIELDED TWISTED PAIR  
AC CONTROL WIRES - RED  
NEUTRAL WIRES - WHITE  
DC+ WIRES - BLUE  
DC- WIRES - BLUE/WHITE  
POWERED FROM FIELD - YELLOW  
FIELD WIRING



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BAYSHORE YACHT BASIN FORCE MAIN  
AND LIFT STATION REPLACEMENT


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DATE:

DATA FLOW SYSTEMS  
CONTROL PANEL  
WIRING DIAGRAMS

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I-7



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WIRE LEGEND
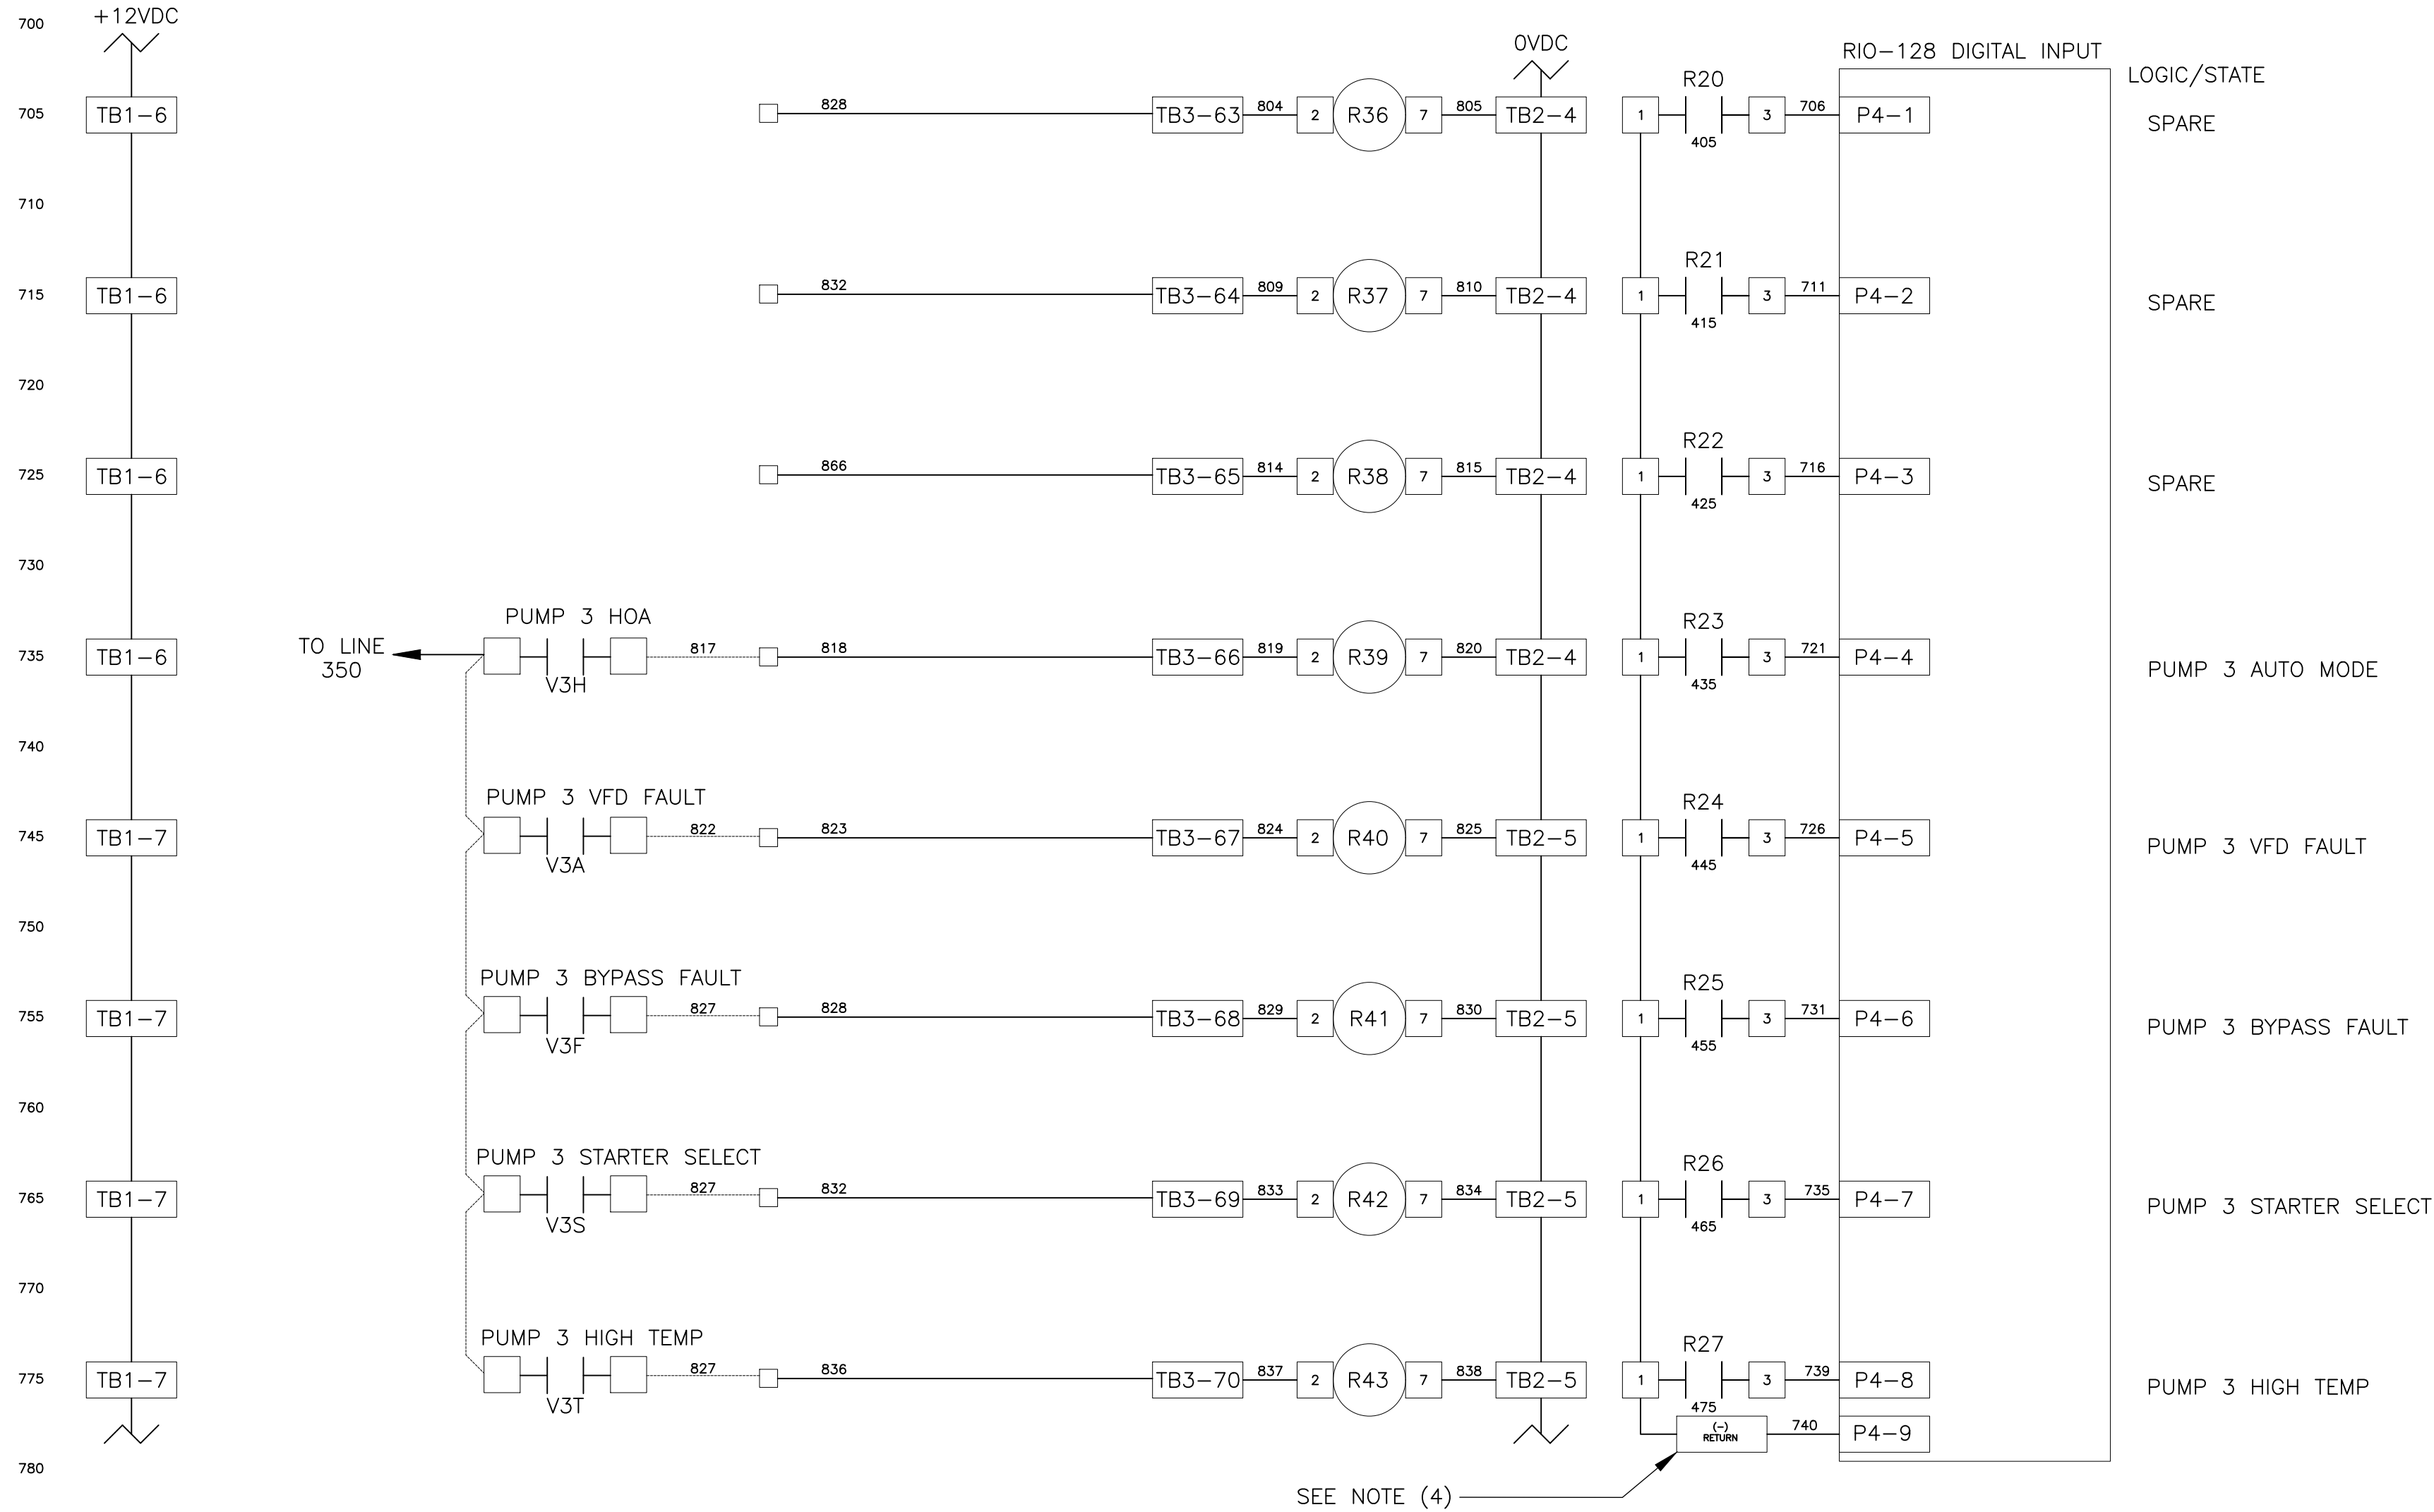
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AC CONTROL WIRES - RED  
NEUTRAL WIRES - WHITE  
DC+ WIRES - BLUE  
DC- WIRES - BLUE/WHITE  
POWERED FROM FIELD - YELLOW  
FIELD WIRING



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BAYSHORE YACHT BASIN FORCE MAIN  
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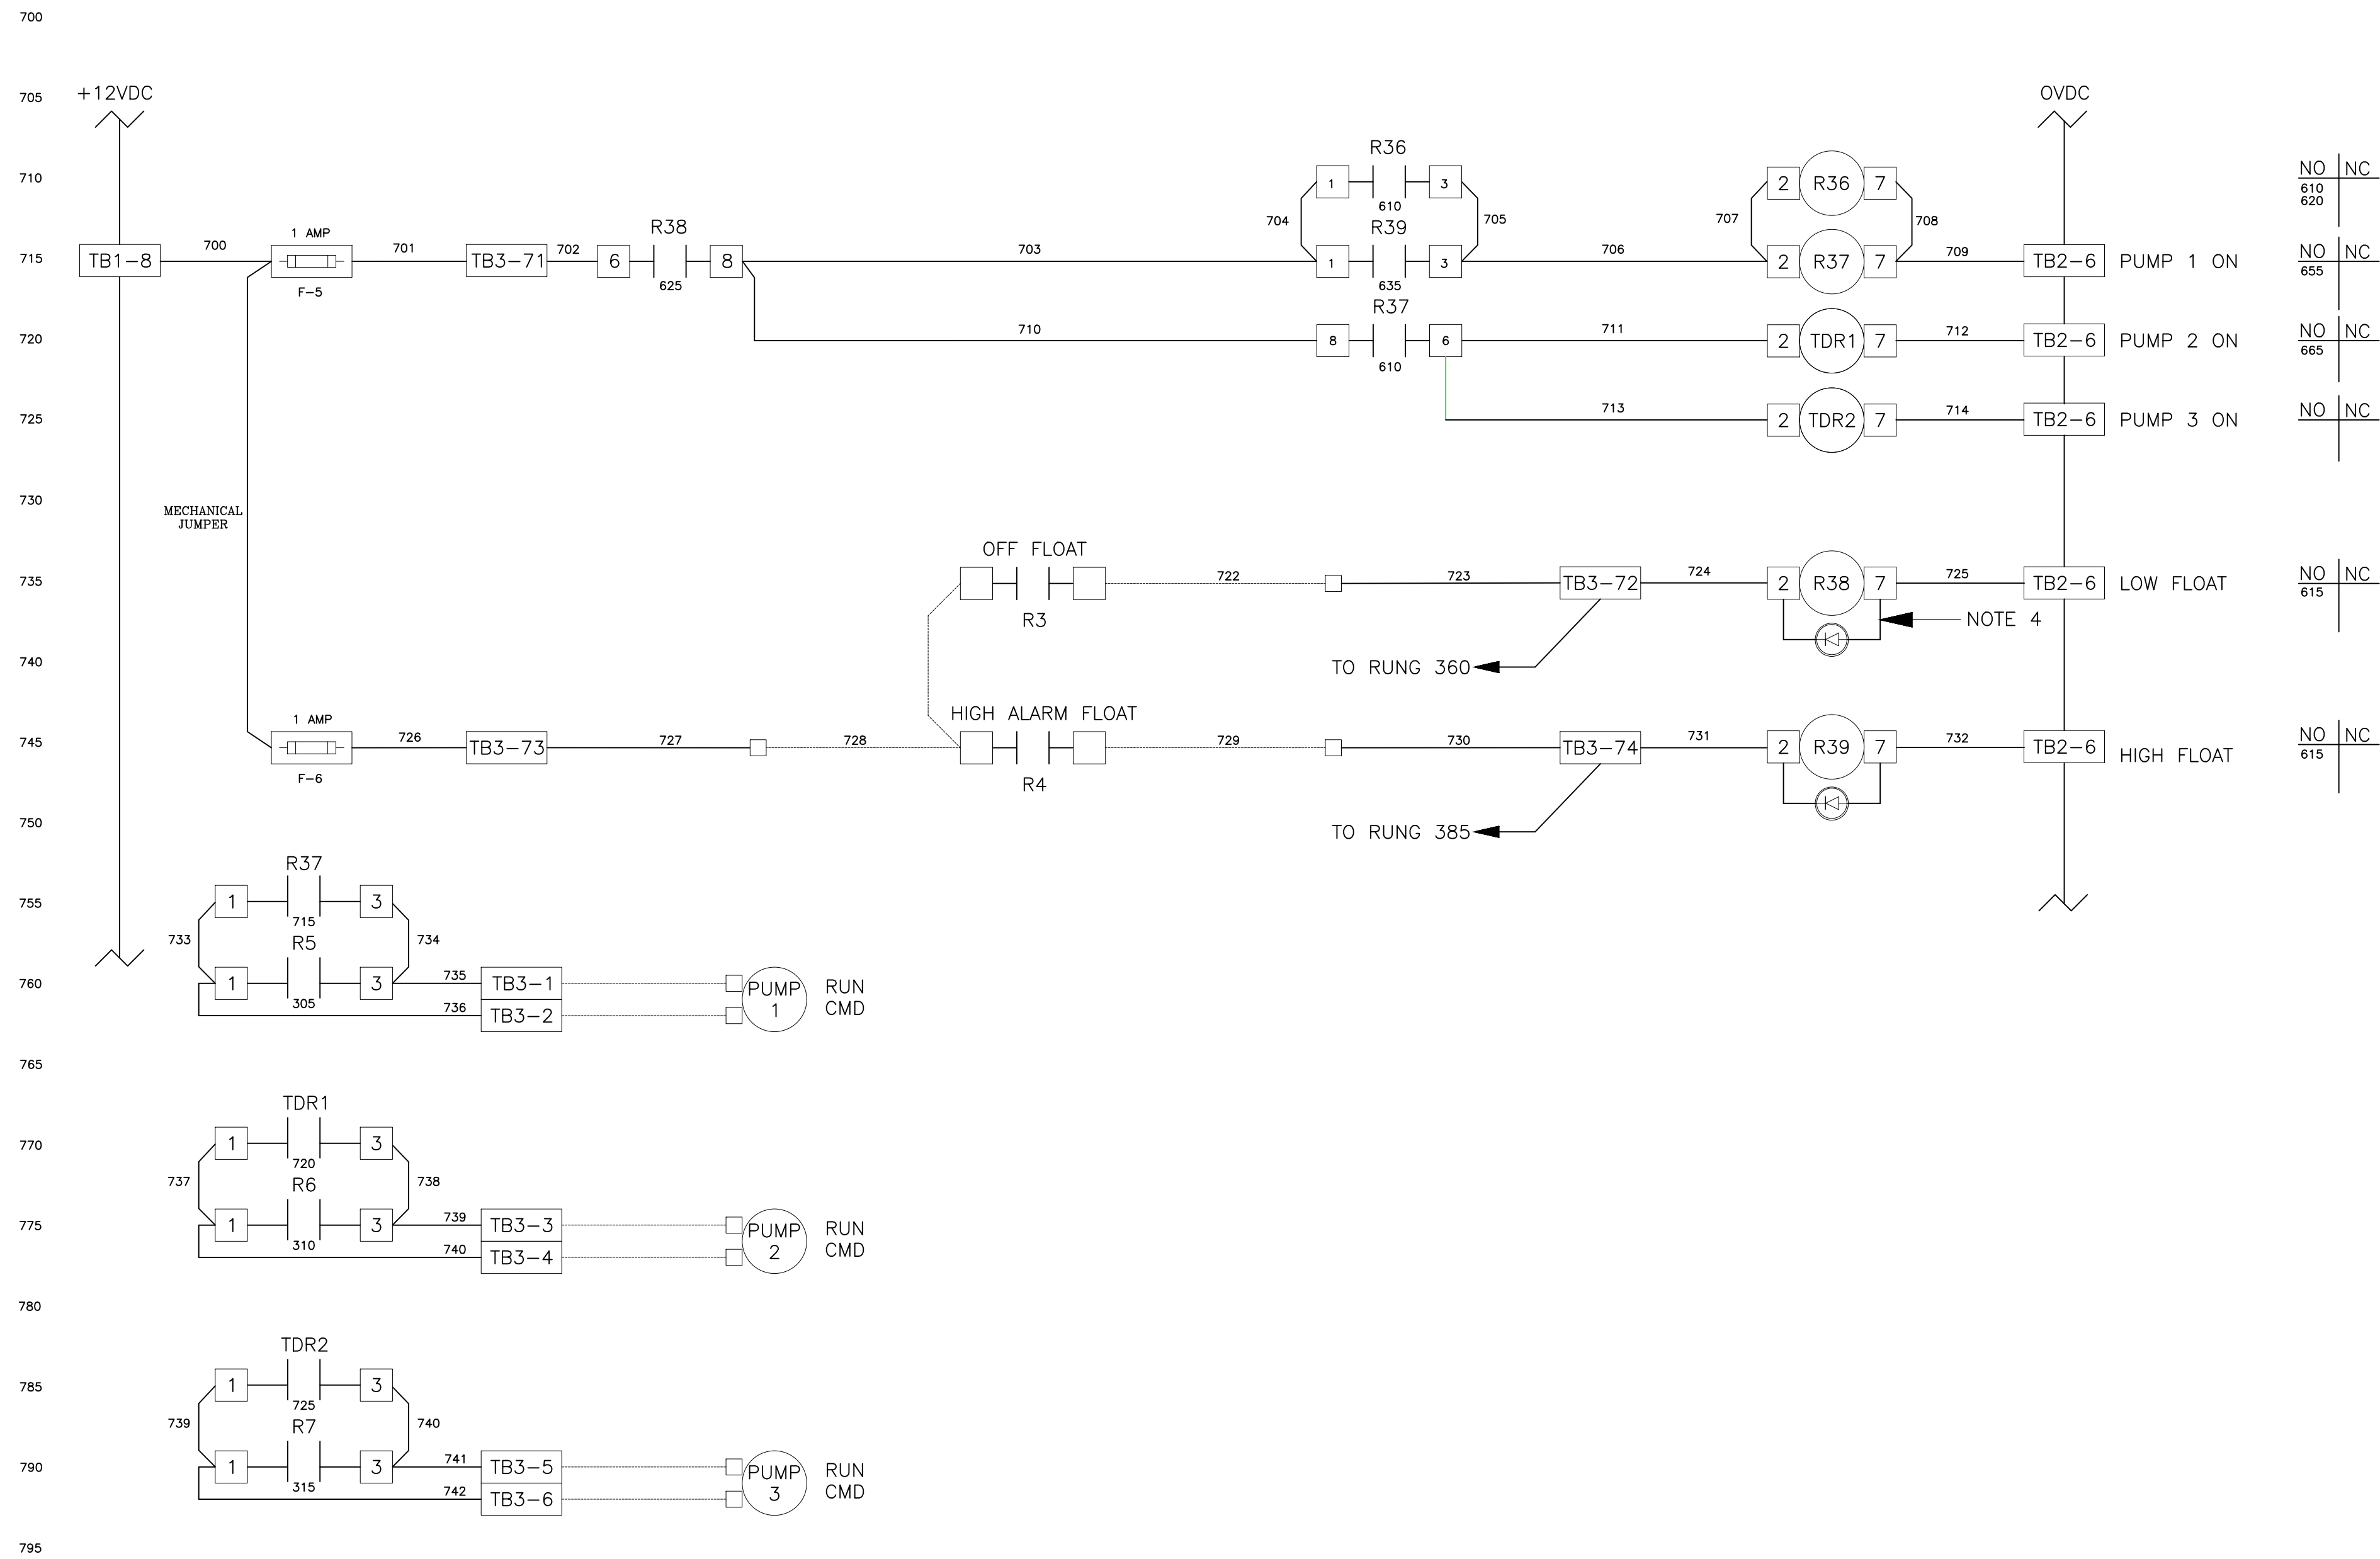
DATA FLOW SYSTEMS  
CONTROL PANEL  
WIRING DIAGRAMS

SHEET NUMBER

I-8




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BAYSHORE YACHT BASIN FORCE MAIN  
AND LIFT STATION REPLACEMENT

LICENSED PROFESSIONAL

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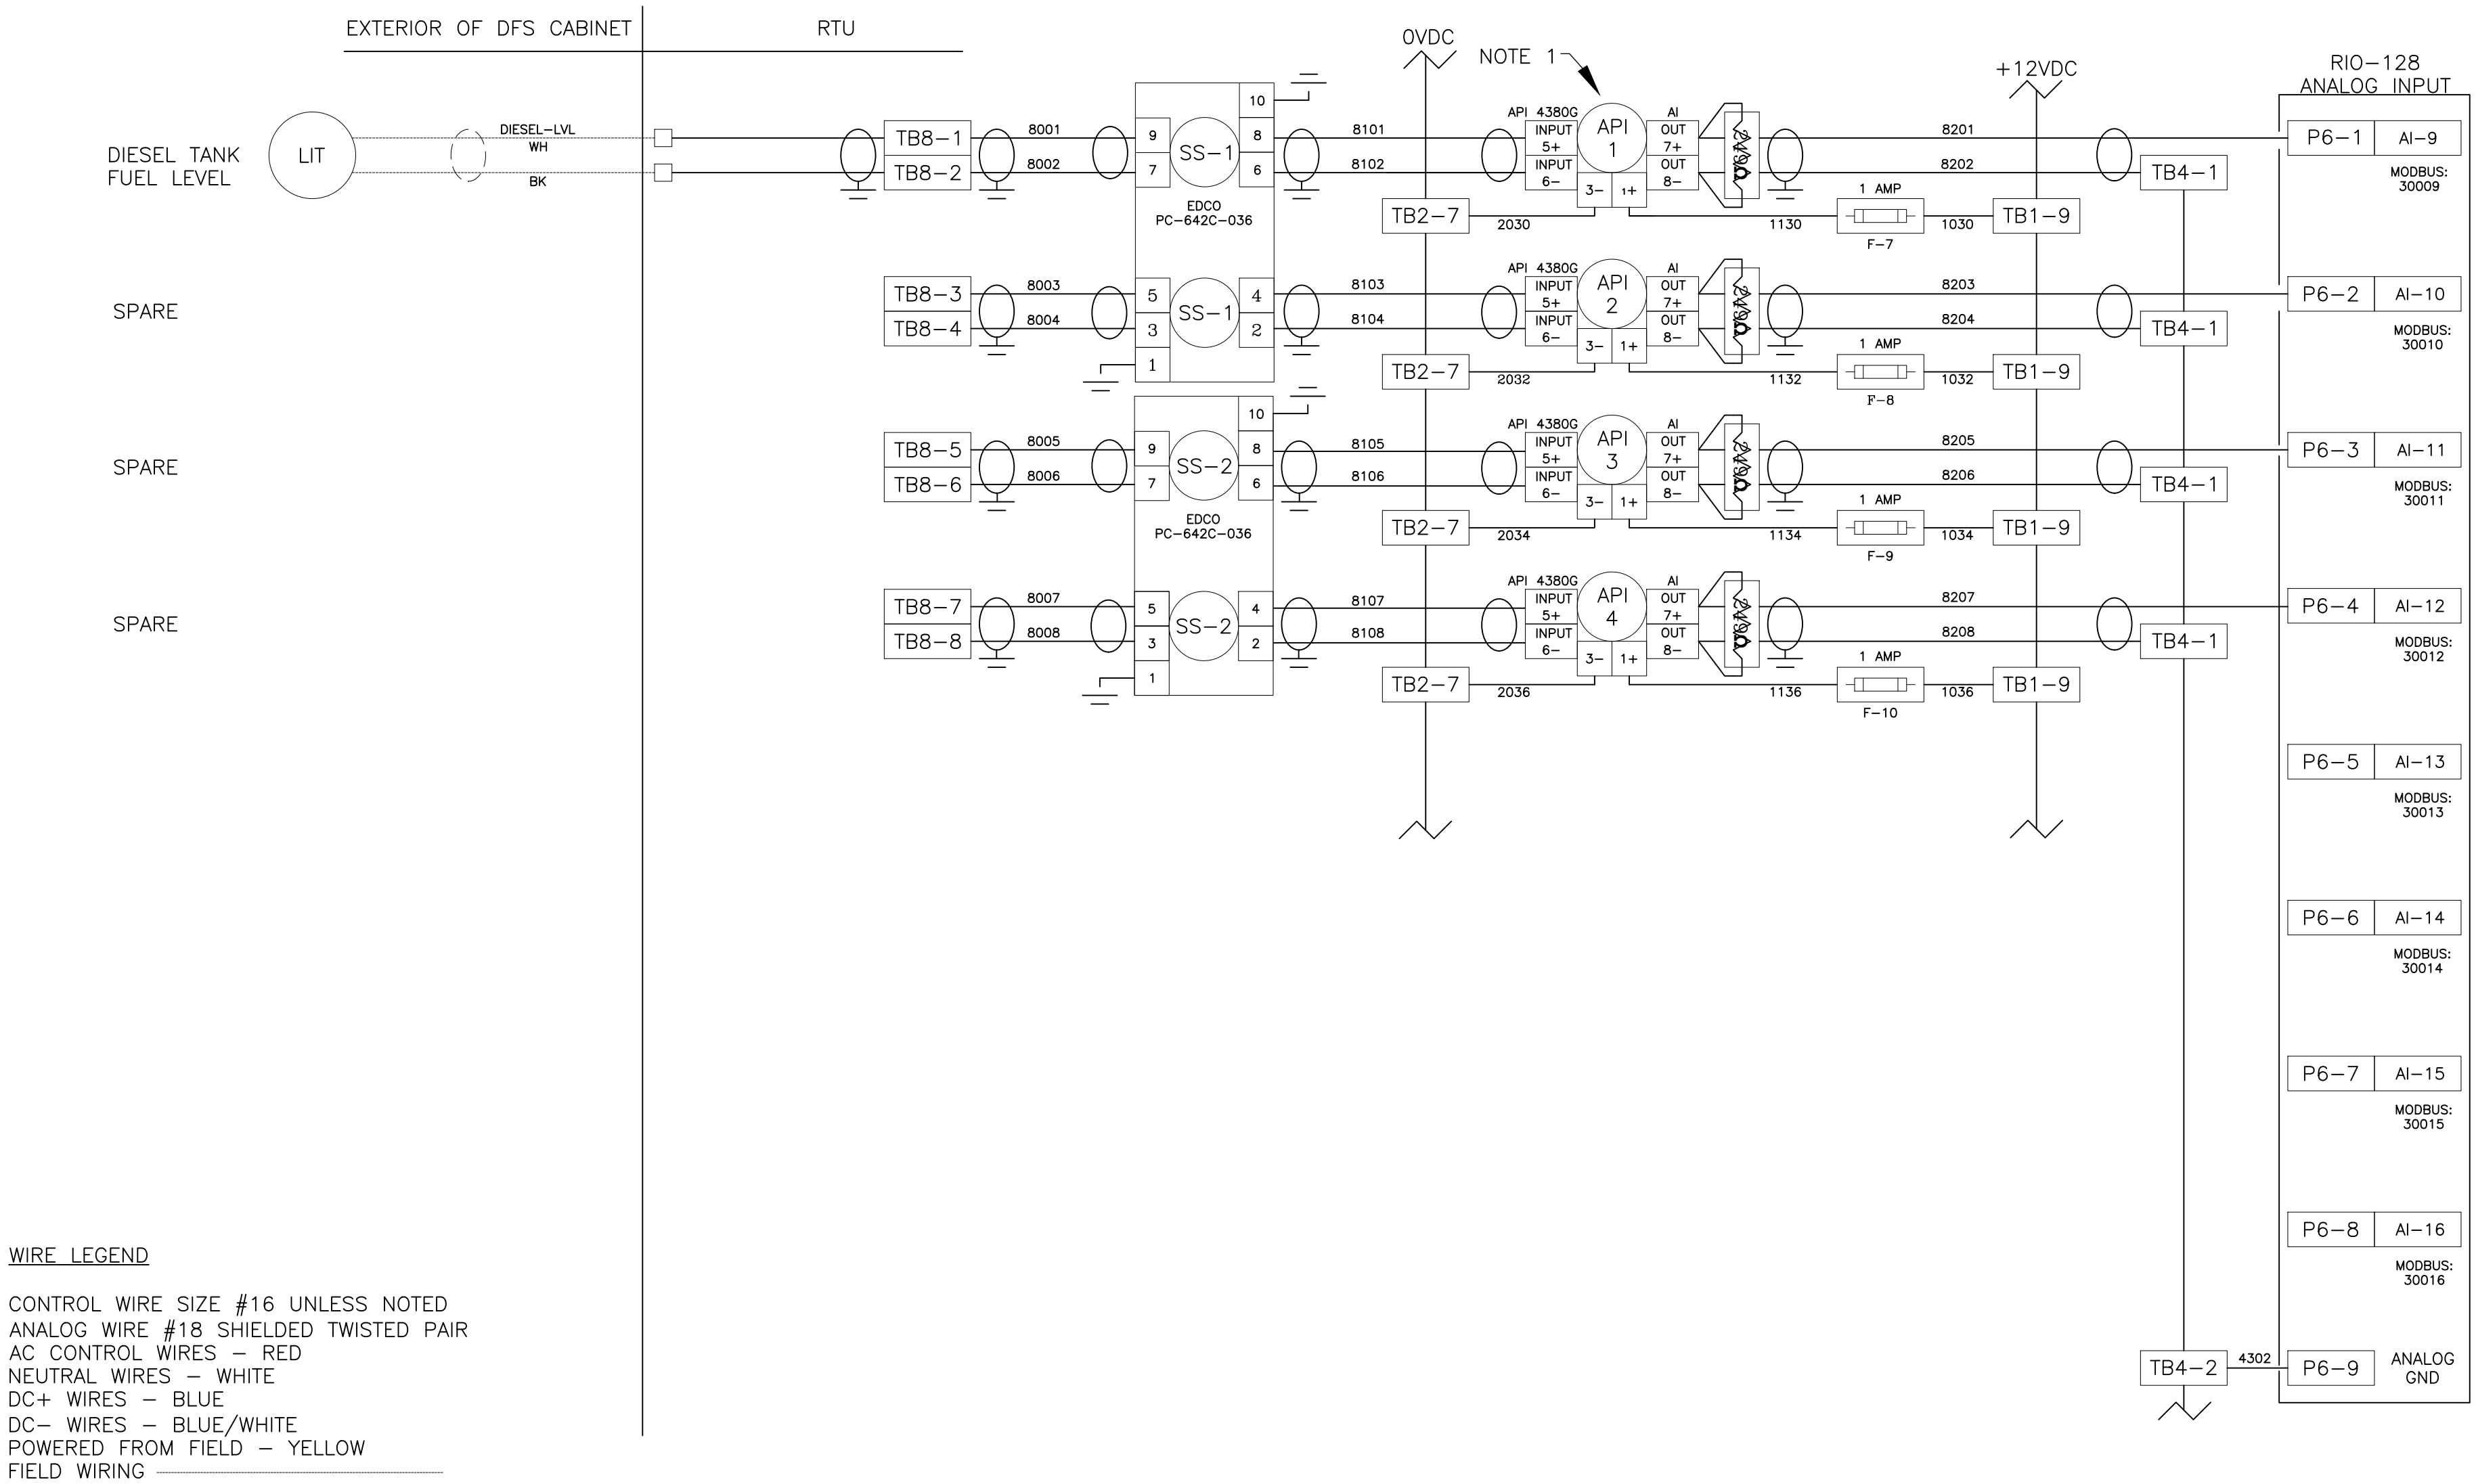
DATA FLOW SYSTEMS  
CONTROL PANEL  
WIRING DIAGRAMS

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I-10

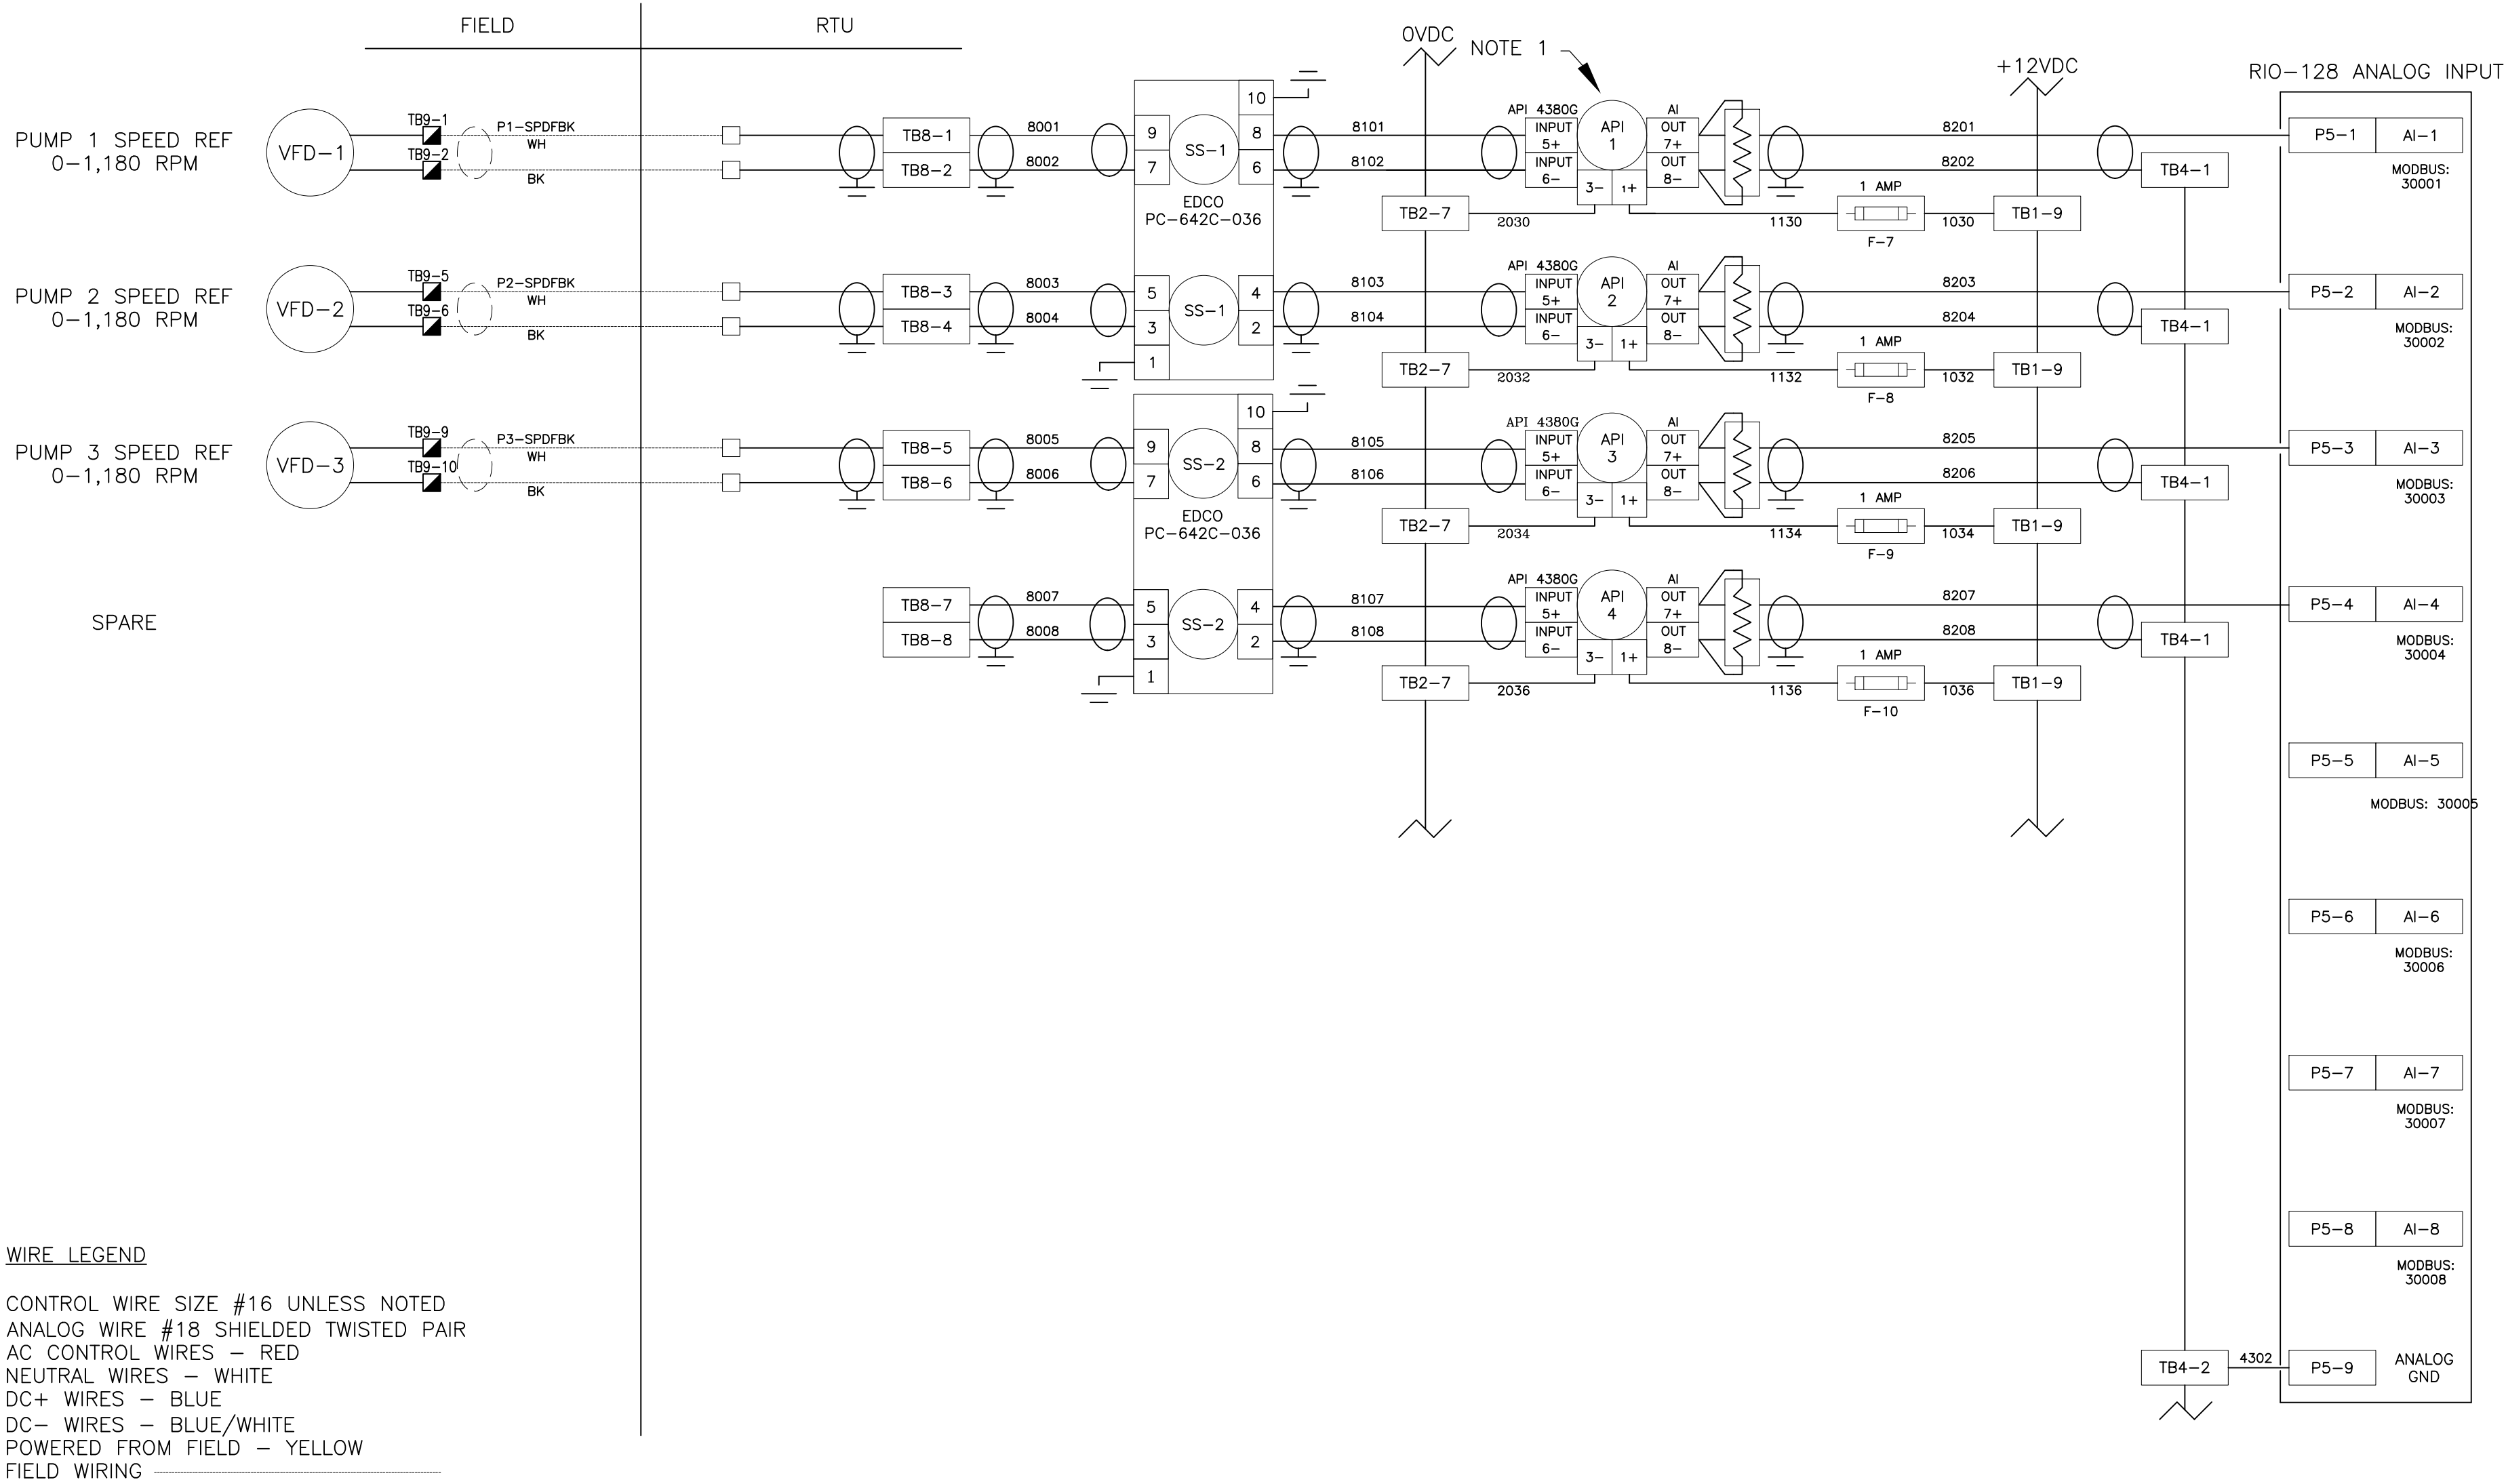

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BAYSHORE YACHT BASIN FORCE MAIN  
AND LIFT STATION REPLACEMENT

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DATA FLOW SYSTEMS  
CONTROL PANEL  
WIRING DIAGRAMS

SHEET NUMBER  
I-11



**TRICON  
ENGINEERING**  
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CONTROL WIRE SIZE #16 UNLESS NOTED  
ANALOG WIRE #18 SHIELDED TWISTED PAIR  
AC CONTROL WIRES - RED  
NEUTRAL WIRES - WHITE  
DC+ WIRES - BLUE  
DC- WIRES - BLUE/WHITE  
POWERED FROM FIELD - YELLOW  
FIELD WIRING \_\_\_\_\_

NOTE:

- (1) LOOP ISOLATORS ON ANALOG INPUTS MUST BE CORRECTLY CONFIGURED FOR 4-20mA INPUT & 4-20mA OUTPUT BEFORE INSTALLING; FAILURE TO DO SO WILL RESULT IN EQUIPMENT DAMAGE AND VOIDS FACTORY WARRANTY
- (2) DO NOT EXCEED 5.5 VOLTS ON ANALOG INPUTS.
- (3) LOOP ISOLATORS ARE RECOMMENDED FOR CIRCUIT PROTECTION.
- (4) STATIC SENSITIVE DEVICES; OBSERVE PROPER ESD PROCEDURES DURING INSTALLATION.
- (5) ALL POINT CONTACTS TO BE PROTECTED BY ANTIOXIDANT COMPOUND.



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# BAYSHORE YACHT BASIN FORCE MAIN AND LIFT STATION REPLACEMENT

LICENSED PROFESSIONAL

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# DATA FLOW SYSTEMS CONTROL PANEL WIRING DIAGRAMS


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I-12







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SEE NOTES

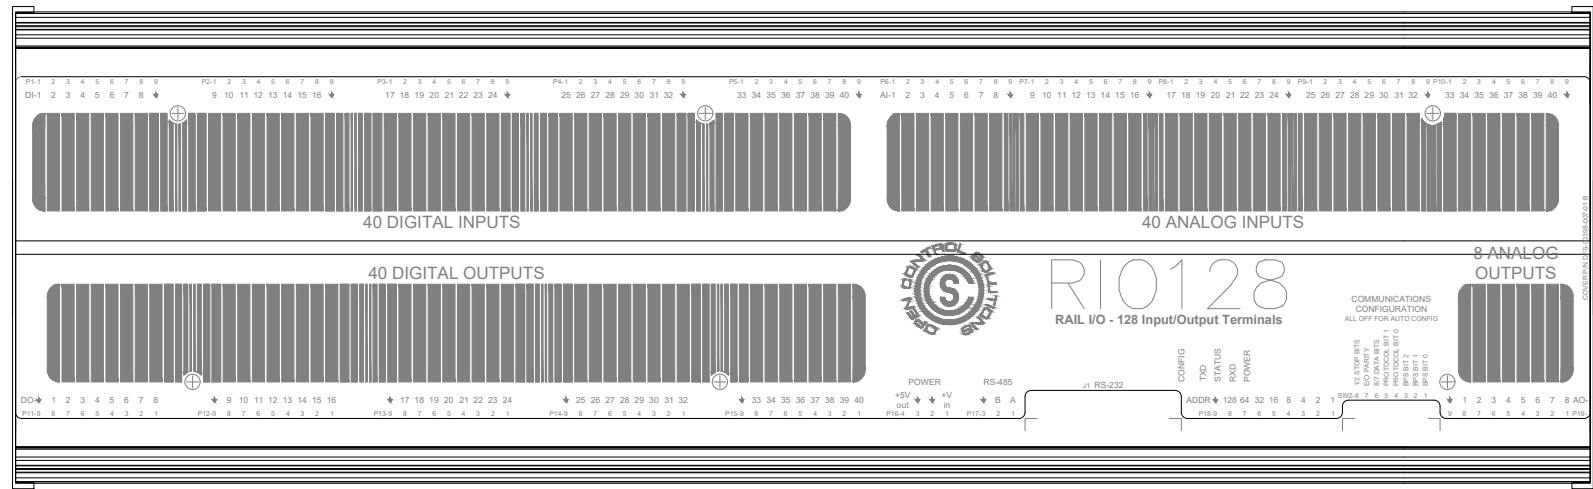

SEE NOTES

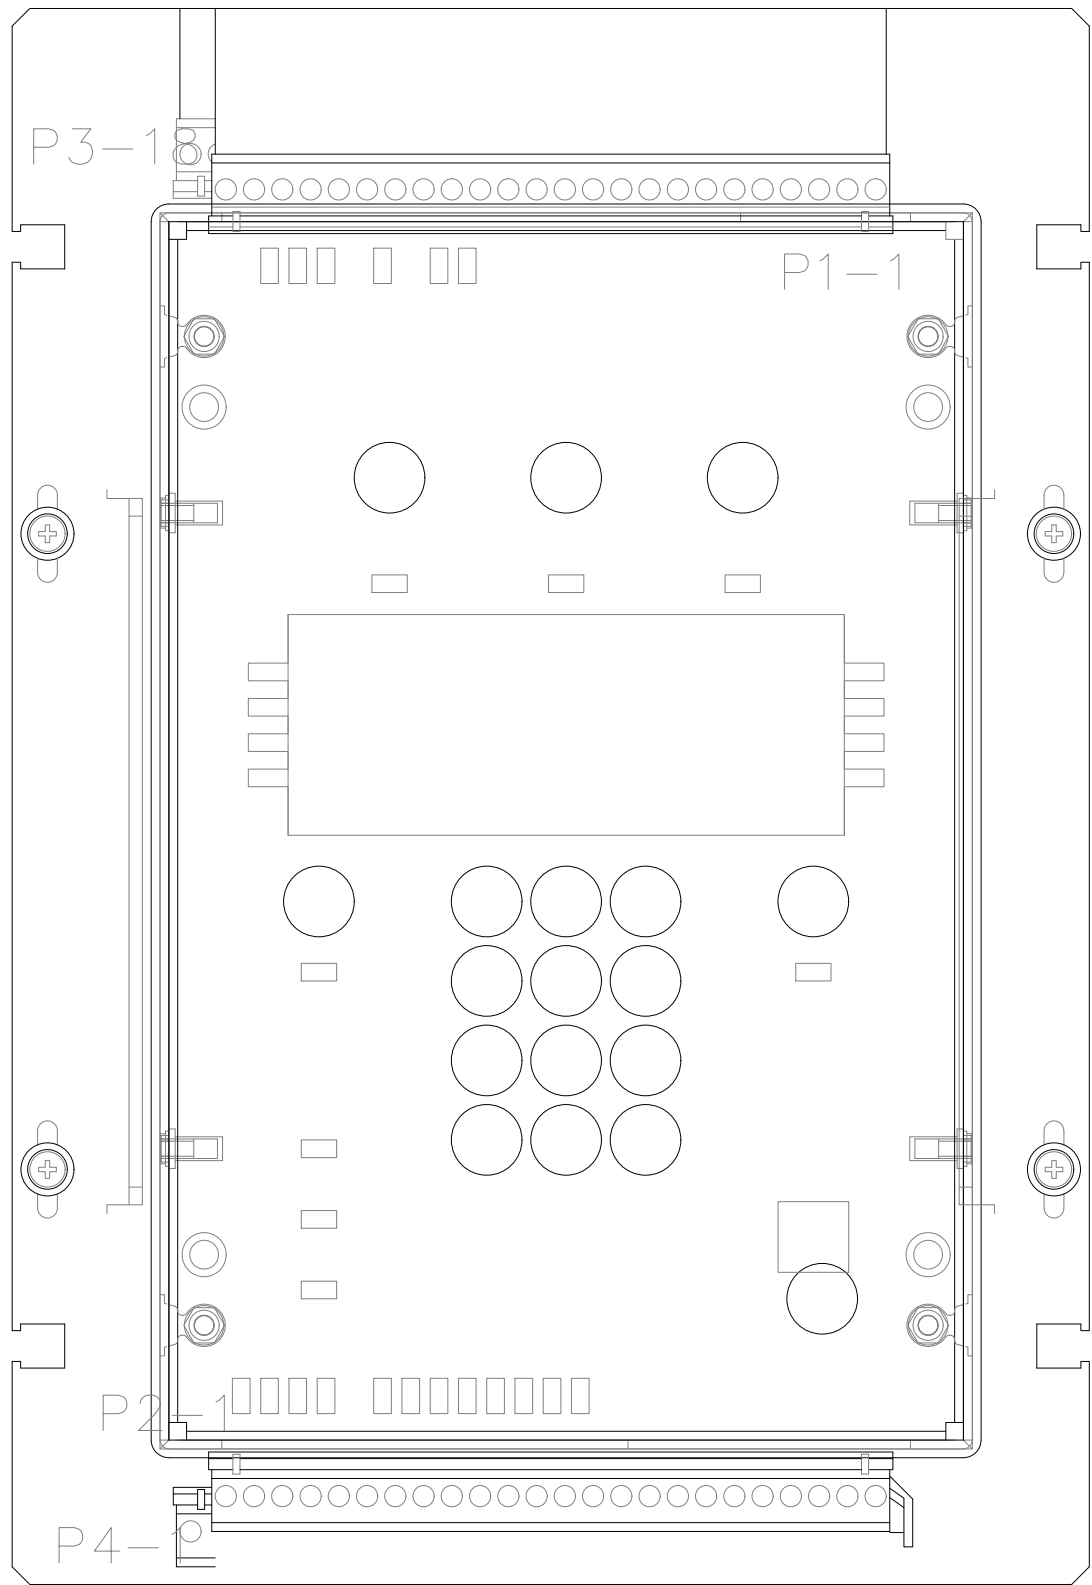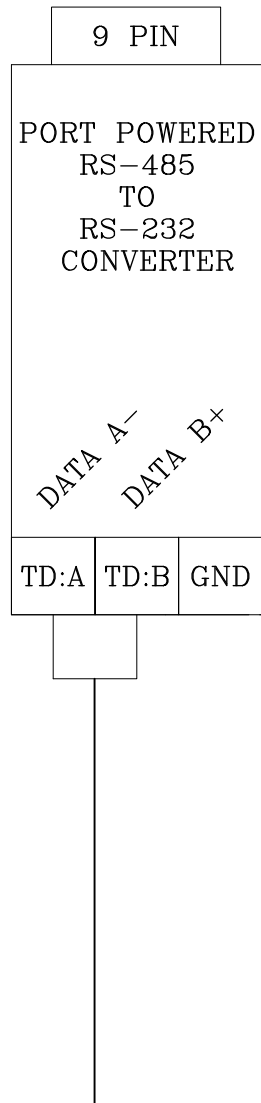- NOTE:  
(1) RIO-128 CONNECTOR J1 (RS-232) CONNECT RS-485 PORT POWERED CONNECTOR  
(2) RS-485 TERMINAL BLOCK TD:B (DATA B+) TERMINATES TO TCU CONNECTOR P4-3  
(3) RS-485 TERMINAL BLOCK TD:A (DATA A-) TERMINATES TO TCU CONNECTOR P4-4  
(4) TERMINATE THE SHIELD OF THE COMMUNICATION CABLE TO TCU CONNECTOR P4-5



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**BAYSHORE YACHT BASIN FORCE MAIN  
AND LIFT STATION REPLACEMENT**

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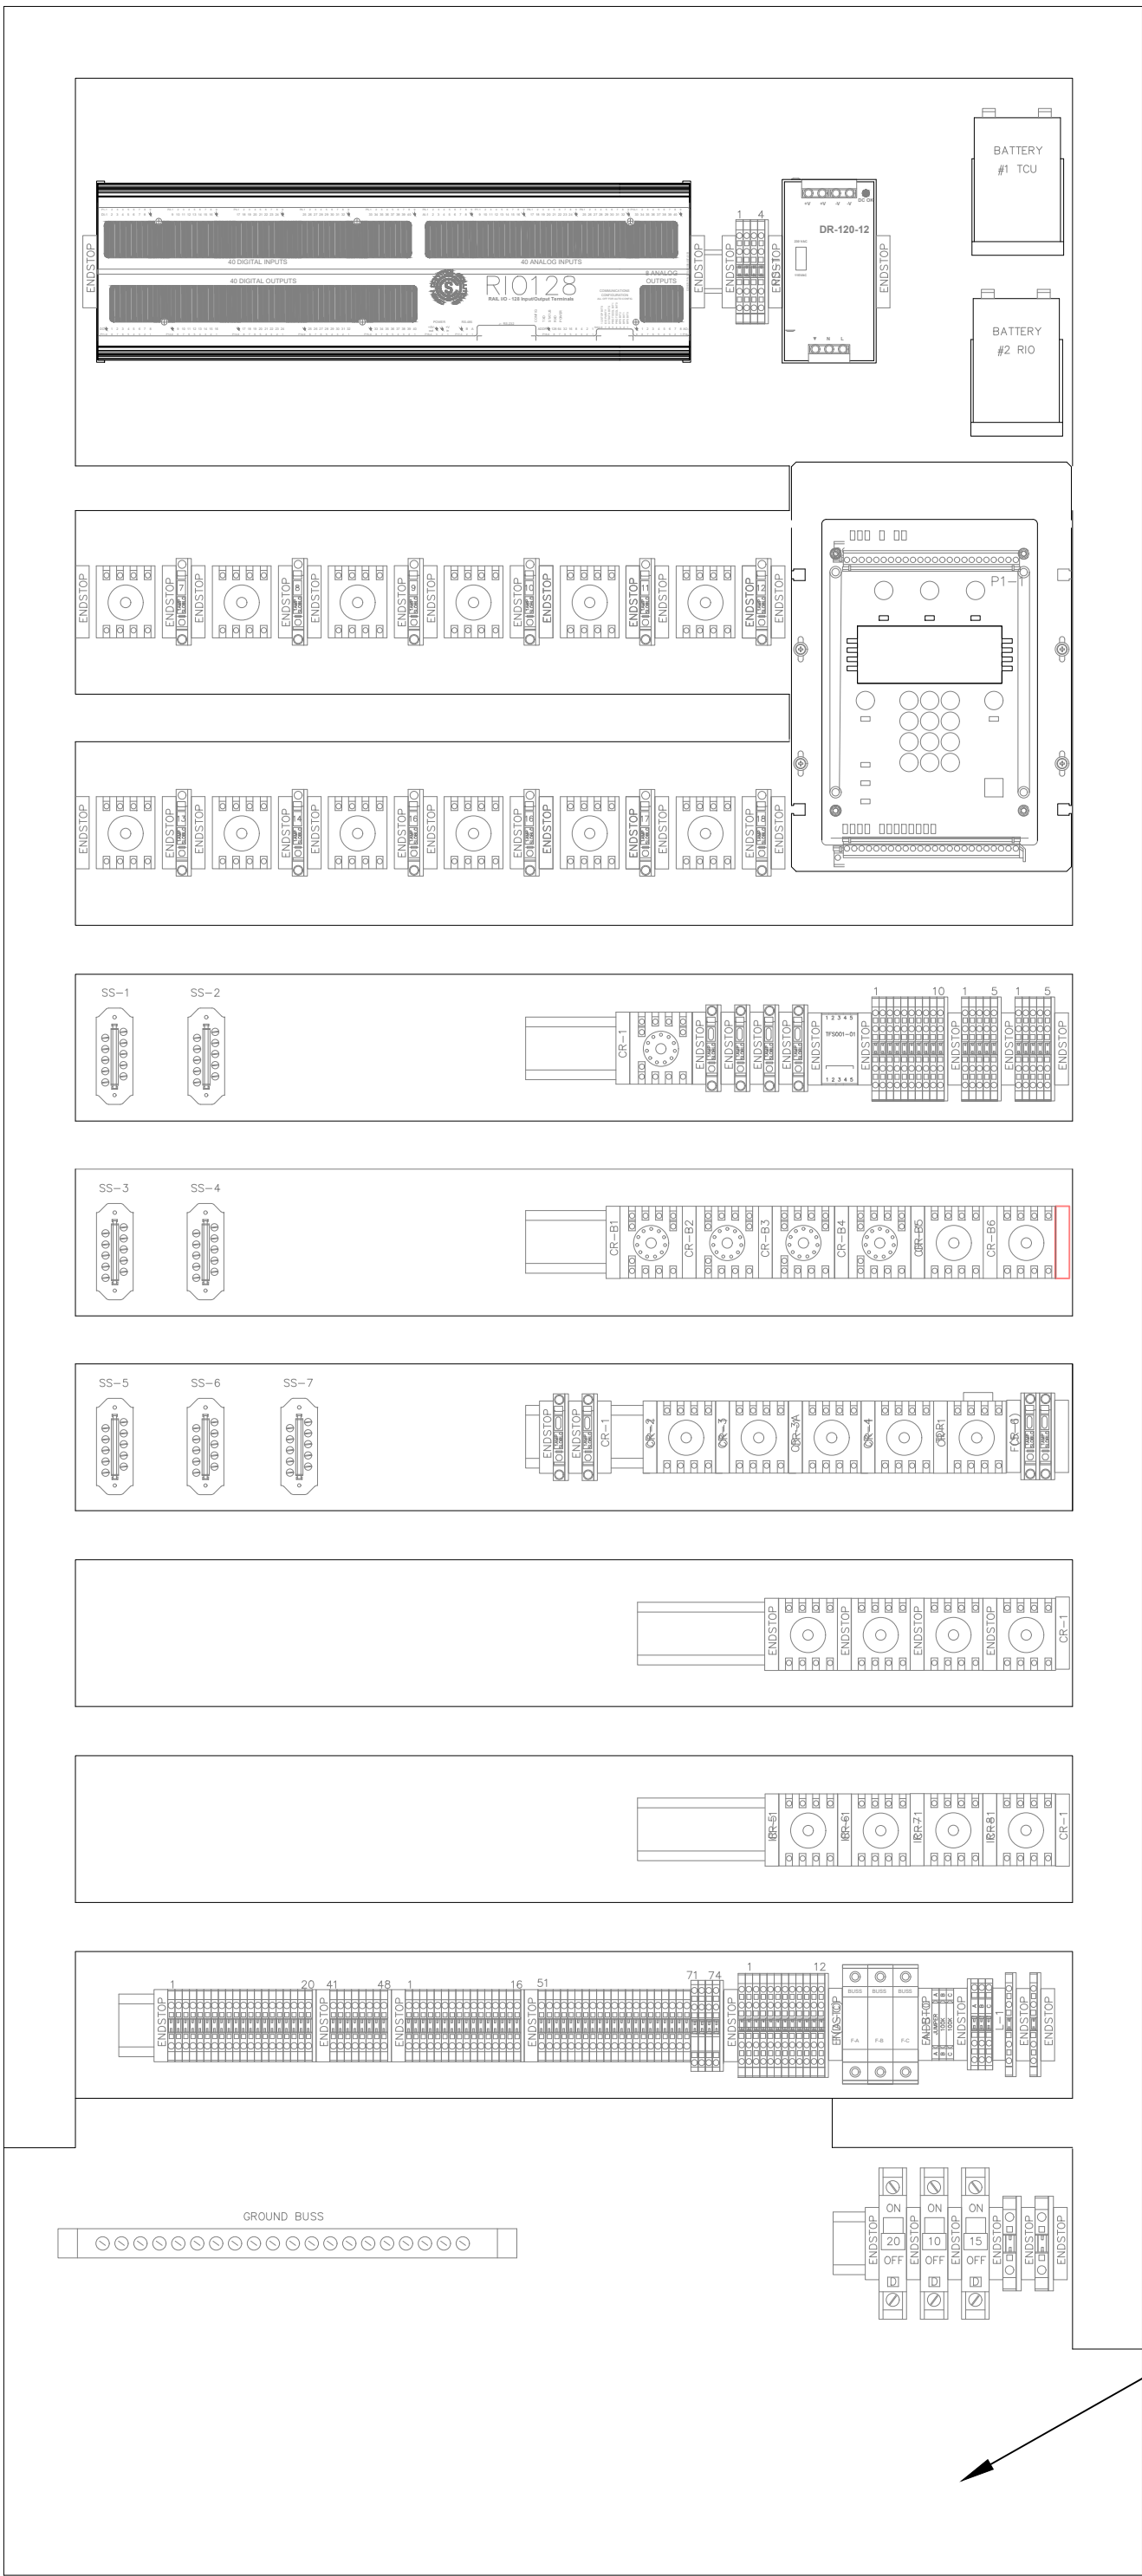
**DATA FLOW SYSTEMS  
CONTROL PANEL  
WIRING DIAGRAMS**

SHEET NUMBER

**I-14**




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TCU/VFD CABINET TO BE PROVIDED WITH RAIL PRESSURE TRANSDUCER, DFS RPT001, 120V PUMP AND REQUIRED ACCESSORIES (DFS SMALL PARTS KIT DFS-00526-008-02).

DFS TCU/VFD PANEL INTERIOR ELEVATION  
SCALE: NOT TO SCALE



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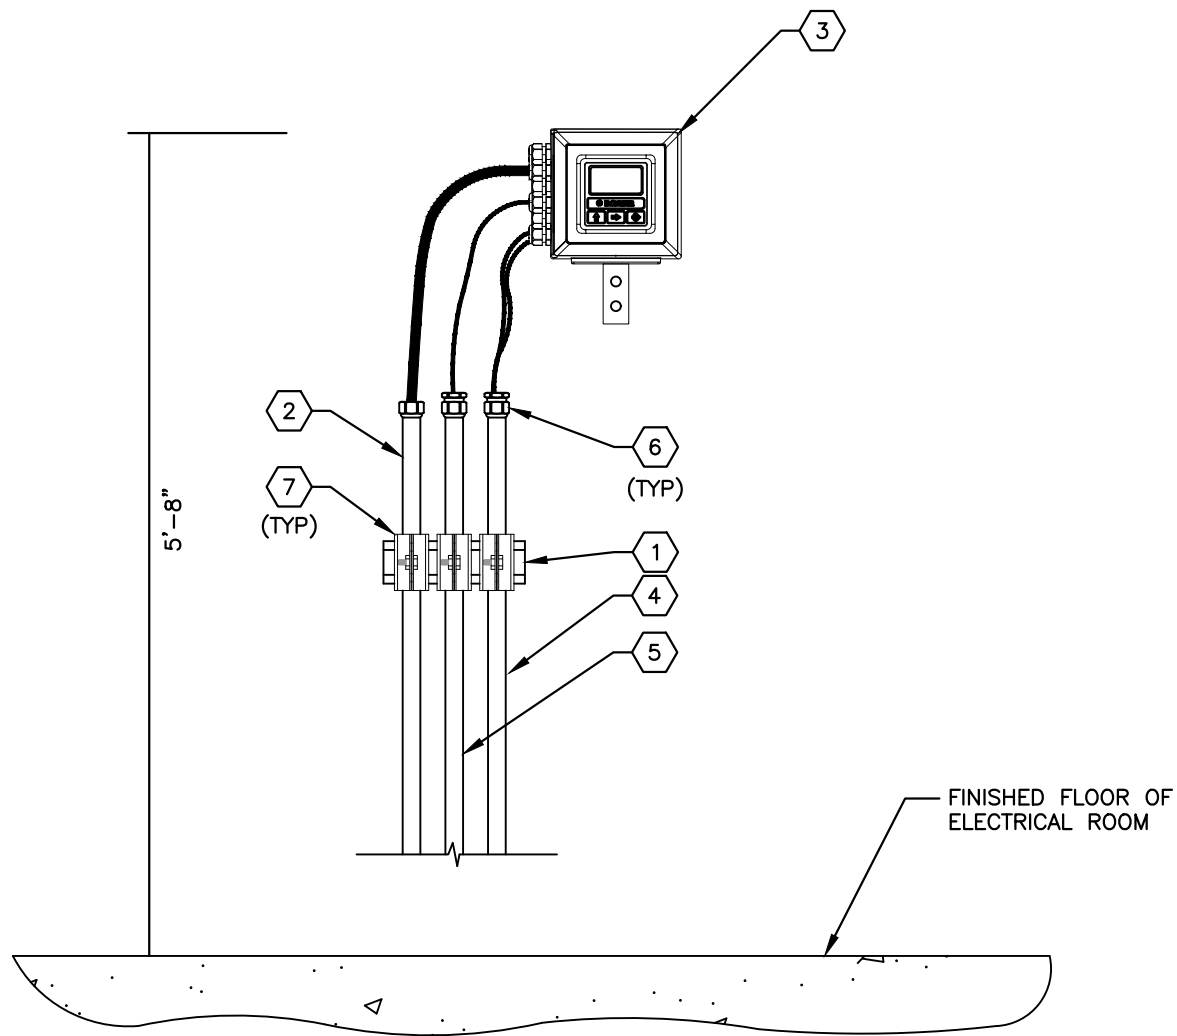
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DATA FLOW SYSTEMS  
TCU/VFD PANEL LAYOUT

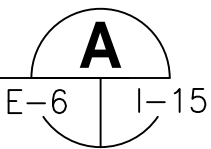SHEET NUMBER

I-15

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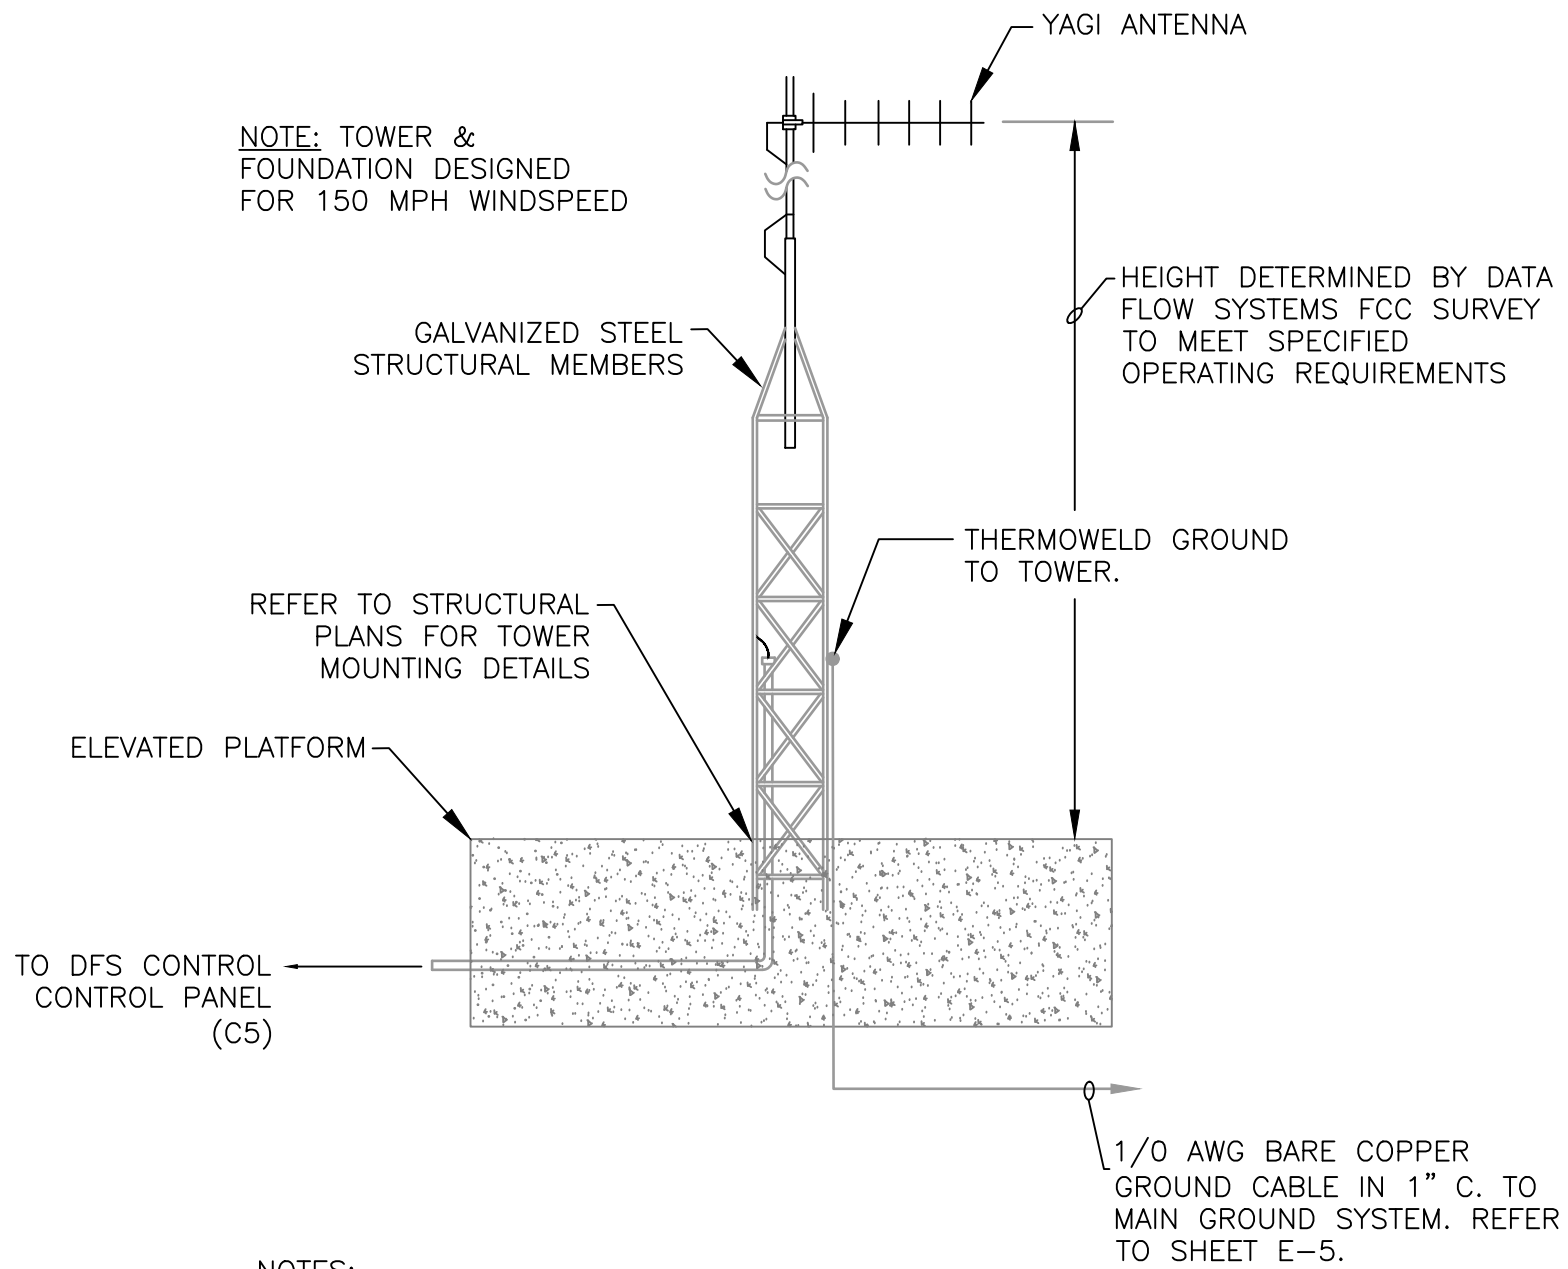
FLOW METER PANEL ELEVATION 1  
SCALE: NOT TO SCAL E-6 I-16

KEYED NOTES:

- 1 PROVIDE AND INSTALL 1-5/8" 316 STAINLESS STEEL UNISTRUT (OR EQUAL) TO FASTEN CONDUITS TO WALL.
- 2 PROVIDE AND INSTALL 2-#12 + 1-#12 GND IN 1" CONDUIT FROM PANELBOARD 'LP' TO FLOW METER CONVERTER FOR 120V POWER. PROVIDE FLEXIBLE SEALTITE CONNECTION TO FLOW METER CONVERTER. (LP-9).
- 3 PROVIDE AND INSTALL FLOW METER CONVERTER. MOUNT TO WALL OF ELECTRICAL BUILDING. REFER ALSO TO SPECIFICATIONS.
- 4 PROVIDE AND INSTALL MANUFACTURER SUPPLIED SENSOR CABLES (SIG1 AND SIG2) IN 1"C. TO FIELD SENSOR (C2).
- 5 PROVIDE AND INSTALL 2/C-#16 SHIELDED (BELDEN 8719) IN 1"C. (4-20ma FLOW METER SIGNAL) TO DFS TCU/VFD CONTROL PANEL (C1).
- 6 PROVIDE AND INSTALL CABLE GLAND ON THE END OF EACH CONDUIT. REFER ALSO TO GENERAL NOTES.
- 7 PROVIDE AND INSTALL 316 STAINLESS STEEL CONDUIT CLAMPS.

GENERAL NOTES:


1. THE FLOW METER CONVERTER SPECIFIED ACCEPTS ONLY CABLE TYPE CONNECTIONS. THE CONTRACTOR SHALL PROVIDE AND APPROPRIATE CABLE GLAND ON THE END OF EACH CONDUIT AS REQUIRED.
2. THE CONTRACTOR SHALL PROVIDE ALL GROUNDING AND BONDING AS REQUIRED BY THE FLOW CONVERTER MANUFACTURER. REFER TO THE MANUFACTURER'S SPECIFICATIONS.



NOTES:

1. THE CONTRACTOR SHALL INSTALL NEW GROUND ROD, GROUND TEST WELL AND CONNECT TO NEW GROUNDING GRID. CONTRACTOR SHALL ALSO INSTALL NEW CONDUIT AND COAXIAL CABLE.
2. THE NEW TELEMETRY SYSTEM ANTENNA SHALL BE SUPPLIED BY "DATA FLOW SYSTEMS" AND BE COMPATIBLE WITH EXISTING SYSTEMS-NO EXCEPTIONS.
3. USE COMPRESSION FITTING TO SEAL COAX CABLE INTO J-BOX.
4. J-BOX TO BE W.P. STAINLESS STEEL CONSTRUCTION-NO EXCEPTIONS.


DFS ANTENNA/TOWER DETAIL 1  
SCALE: NOT TO SCAL E-2 I-16

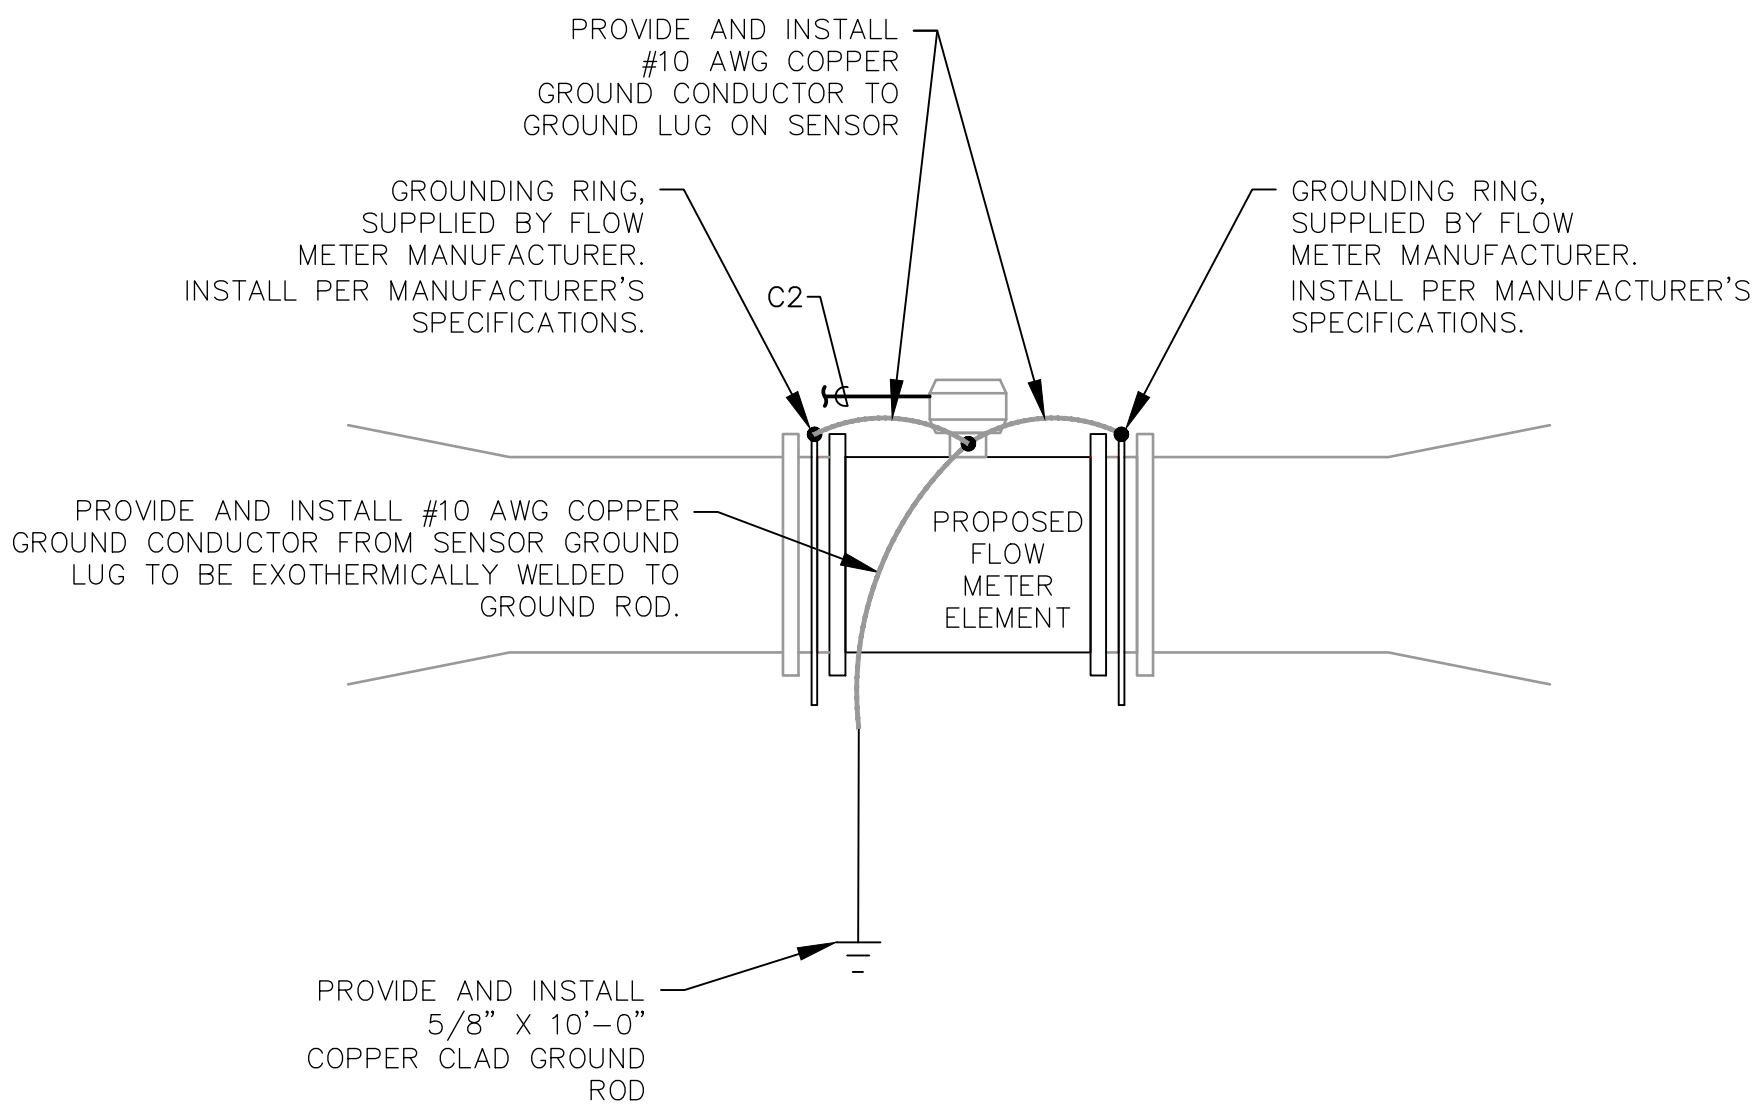

FLOW ELEMENT INSTALLATION DETAIL 2  
SCALE: NOT TO SCAL E-2 I-16

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<b>INSTRUMENTATION DETAILS</b>
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SHEET NUMBER
<b>I-16</b>