

REV. 30% CONSTRUCTION PLANS **FOR**

PARRISH COMMUNITY PARK

FORT HAMER ROAD PARRISH, FLORIDA 34219

SECTION 30, TOWNSHIP 33S, RANGE 19E

PROPERTY

BOUNDARY

COMMUNITY HIGH SCHOOL

PROJECT

FUTURE

PHASE

PROJECT TEAM

OWNER / CLIENT

CONTACT: RUSSEL P. HYATT, PSM

UTILITY CONTACTS

POTABLE WATER
MANATEE COUNTY UTILITIES

4520 66TH ST W BRADENTON, FL 34210 PHONE: (941) 792-8811 EXT. 5002 ATTEN: KATHY MCMAHON

CABLE TV

CHARTER COMMUNICATIONS 5413 SR 64 E BRADENTON, FL 34208 PHONE: (941) 748-3816 ATTN: JAMES FLEMING

ELECTRIC FLORIDA POWER AND LIGHT THE GROVE LN ENV/WP8 BLDG 8 WEST PALM BEACH, FL 33407 PHONE: (386) 586-6403

TELEPHONE FRONTIER COMMUNICATIONS 3712 W WALNUT ST TAMPA, FL 33607 PHONE: (813) 875-1014

ATTN: JOEL BRAY

ATTN: TONI CANNON

ATTEN: KATHY MCMAHON

TAMPA, FLORIDA 33619 PHONE: (813) 275-3783 ATTN: JOAN DOMNING

P.O. BOX 1310 WAUCHULA, FL 33873-1310 PHONE: 863-767-4650

PROJECT DATA

PARCEL ID 467201009 SIZE: 12.49AC ZONING: A-1 FUTURE LAND USE: P/SP-1 PARCEL ID 467200159 SIZE: 19.91AC **FUTURE LAND USE: P/SP-1**

RYAN R. HOPPE, P.E. FLA. REGISTERED ENGINEER # 79400 CA 00000696

DATE

WASTEWATER MANATEE COUNTY UTILITIES 4520 66TH ST W BRADENTON, FL 34210 PHONE: (941) 792-8811 EXT. 5002

TECO/PEOPLES GAS- SARASOTA 8416 PALM RIVER RD

PEACE RIVER ELECTRIC COOPERATIVE INC. ATTEN: PAUL ROBERTS

PROGRESS PLANS FOR REVIEW

VICINITY MAP

AUGUST 2022

Kimley» Horn (C)2022 KIMLEY-HORN AND ASSOCIATES, INC

1777 MAIN ST, SUITE 200, SARASOTA, FL 34236 PHONE: 941-379-7600 WWW.KIMLEY-HORN.COM CA 00000696

SHEET NO.	SHEET TITLE
C-000	COVER SHEET
C-100	GENERAL NOTES
C-101	AERIAL LOCATION PLAN
 C-102	SURVEY
 C-103	TREE PRESERVATION PLAN
C-104	DEMOLITION PLAN
C-200	MASTER SITE PLAN
C-201	SITE PLAN
C-202	SITE PLAN
C-203	SITE PLAN
C-204	SITE PLAN
C-300	BEST MANAGEMENT PRACTICES
C-301	BEST MANAGEMENT PRACTICES DETAILS
C-401	PAVING GRADING AND DRAINAGE PLAN
C-402	PAVING GRADING AND DRAINAGE PLAN
C-403	PAVING GRADING AND DRAINAGE PLAN
C-404	PAVING GRADING AND DRAINAGE PLAN
C-405	PAVING GRADING AND DRAINAGE PLAN
C-500	UTILITY PLAN
C-600	PAVEMENT MARKING AND SIGNAGE PLAN
C-700	MISCELLANEOUS DETAILS
C-701	MISCELLANEOUS DETAILS
C-702	GRINDER LIFT STATION DETAILS
C-703	UTILITY DETAILS
C-704	UTILITY DETAILS
E-100	ELECTRICAL GENERAL SHEET
— E-101	ELECTRICAL SPECIFICATIONS
E-200	ELECTRICAL SITE PLAN
H-101	HARDSCAPE PLAN
H-102	HARDSCAPE PLAN
H-103	HARDSCAPE PLAN
H-104	HARDSCAPE PLAN
H-201	FENCING AND FURNISHING PLAN
H-202	FENCING AND FURNISHING PLAN
H-203	FENCING AND FURNISHING PLAN
H-204	FENCING AND FURNISHING PLAN
H-301	DETAILS
H-302	DETAILS
H-303	DETAILS
H-304	PERFORMANCE PAVILION DETAILS
H-305	5-12 PLAYGROUND DETAILS
H-306	2-5 PLAYGROUND DETAILS
H-307	FITNESS COURSE DETAILS
H-308	SPLASH PAD DETAILS
L-101	LANDSCAPE PLAN
L-102	LANDSCAPE PLAN
L-103	LANDSCAPE PLAN
L-104	LANDSCAPE PLAN
L-105	LANDSCAPE SPECIFICATIONS AND CALCULATIONS
L-105 L-106	LANDSCAPE DETAILS
— L-201	IRRIGATION PLAN
— L-201 — L-202	IRRIGATION PLAN
— L-202 — L-203	IRRIGATION PLAN
— L-204 —	IRRIGATION PLAN IRRIGATION SPECIFICATIONS
1 205	
—L-205— —L-206—	IRRIGATION DETAILS

SITE DRAWING INDEX

THE SITE CONSTRUCTION STAKEOUT SHALL BE PERFORMED UNDER THE DIRECTION OF A FLORIDA REGISTERED SURVEYOR AUTOCAD FILES WILL BE FURNISHED TO AID IN THE SITE CONSTRUCTION STAKEOUT. ANY DISCREPANCIES FOUND BETWEEN AUTOCAD FILES AND SITE CONSTRUCTION PLANS SHALL BE BROUGHT TO THE ENGINEER'S ATTENTION FOR CLARIFICATION PRIOR TO THAT STAKEOUT.

> SHEET NUMBER C-000

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GENERAL CONSTRUCTION NOTES

- 1. THE CONTRACTOR AND SUBCONTRACTORS SHALL OBTAIN A COPY OF THE FLORIDA DEPARTMENT OF TRANSPORTATION "STANDARD SPECIFICATIONS FOR ROAD AND BRIDGE CONSTRUCTION" (LATEST EDITION) AND BECOME FAMILIAR WITH THE CONTENTS PRIOR TO COMMENCING WORK, AND, UNLESS OTHERWISE NOTED, ALL WORK SHALL CONFORM AS APPLICABLE TO THESE STANDARDS AND SPECIFICATIONS.
- 2. THE CONTRACTOR SHALL BE RESPONSIBLE FOR FURNISHING ALL MATERIAL AND LABOR TO CONSTRUCT THE FACILITY AS SHOWN AND DESCRIBED IN THE CONSTRUCTION DOCUMENTS IN ACCORDANCE WITH THE APPROPRIATE APPROVING AUTHORITIES, SPECIFICATIONS AND REQUIREMENTS. CONTRACTOR SHALL CLEAR AND GRUB ALL AREAS UNLESS OTHERWISE INDICATED, REMOVING TREES, STUMPS, ROOTS, MUCK, EXISTING PAVEMENT AND ALL OTHER DELETERIOUS MATERIAL.
- 3. EXISTING UTILITIES SHOWN ARE LOCATED ACCORDING TO THE INFORMATION AVAILABLE TO THE ENGINEER AT THE TIME OF THE TOPOGRAPHIC SURVEY AND HAVE NOT BEEN INDEPENDENTLY VERIFIED BY THE OWNER OR THE ENGINEER. GUARANTEE IS NOT MADE THAT ALL EXISTING UNDERGROUND UTILITIES ARE SHOWN OR THAT THE LOCATION OF THOSE SHOWN ARE ENTIRELY ACCURATE. FINDING THE ACTUAL LOCATION OF ANY EXISTING UTILITIES IS THE CONTRACTOR'S RESPONSIBILITY AND SHALL BE DONE BEFORE HE COMMENCES ANY WORK IN THE VICINITY. FURTHERMORE, THE CONTRACTOR SHALL BE FULLY RESPONSIBLE FOR ANY AND ALL DAMAGES DUE TO THE CONTRACTOR'S FAILURE TO EXACTLY LOCATE AND PRESERVE ANY AND ALL UNDERGROUND UTILITIES. THE OWNER OR ENGINEER WILL ASSUME NO LIABILITY FOR ANY DAMAGES SUSTAINED OR COST INCURRED BECAUSE OF THE OPERATIONS IN THE VICINITY OF EXISTING UTILITIES OR STRUCTURES, NOR FOR TEMPORARY BRACING AND SHORING OF SAME. IF IT IS NECESSARY TO SHORE, BRACE, SWING OR RELOCATE A UTILITY, THE UTILITY COMPANY OR DEPARTMENT AFFECTED SHALL BE CONTACTED AND THEIR PERMISSION OBTAINED REGARDING THE METHOD TO USE FOR SUCH WORK.
- 4. IT IS THE CONTRACTOR'S RESPONSIBILITY TO CONTACT THE VARIOUS UTILITY COMPANIES WHICH MAY HAVE BURIED OR AERIAL UTILITIES WITHIN OR NEAR THE CONSTRUCTION AREA BEFORE COMMENCING WORK. THE CONTRACTOR SHALL PROVIDE 48 HOURS MINIMUM NOTICE TO ALL UTILITY COMPANIES PRIOR TO BEGINNING CONSTRUCTION. A LIST OF THE UTILITY COMPANIES WHICH THE CONTRACTOR MUST CALL BEFORE COMMENCING WORK IS PROVIDED ON THE COVER SHEET OF THESE CONSTRUCTION PLANS. THIS LIST SERVES AS A GUIDE ONLY AND IS NOT INTENDED TO LIMIT THE UTILITY COMPANIES WHICH THE CONTRACTOR MAY WISH TO NOTIFY.
- 5. THE CONTRACTOR SHALL BE RESPONSIBLE FOR OBTAINING ALL REQUIRED CONSTRUCTION PERMITS AND BONDS IF REQUIRED PRIOR TO CONSTRUCTION.
- 6. THE CONTRACTOR SHALL HAVE AVAILABLE AT THE JOB SITE AT ALL TIMES ONE COPY OF THE CONSTRUCTION DOCUMENTS INCLUDING PLANS, SPECIFICATIONS, AND SPECIAL CONDITIONS AND COPIES OF ANY REQUIRED CONSTRUCTION PERMITS.
- 7. ANY DISCREPANCIES ON THE DRAWINGS SHALL BE IMMEDIATELY BROUGHT TO THE ATTENTION OF THE OWNER AND ENGINEER BEFORE COMMENCING WORK. NO FIELD CHANGES OR DEVIATIONS FROM DESIGN ARE TO BE MADE WITHOUT PRIOR APPROVAL OF THE OWNER AND NOTIFICATION TO THE ENGINEER.
- 8. ALL COPIES OF COMPACTION, CONCRETE AND OTHER REQUIRED TEST RESULTS ARE TO BE SENT TO THE OWNER AND DESIGN ENGINEER OF RECORD DIRECTLY FROM THE TESTING AGENCY.
- THE CONTRACTOR SHALL BE RESPONSIBLE FOR SUBMITTING TO THE ENGINEER A CERTIFIED RECORD SURVEY SIGNED AND SEALED BY A PROFESSIONAL LAND SURVEYOR REGISTERED IN THE STATE OF FLORIDA DEPICTING THE ACTUAL FIELD LOCATION OF ALL CONSTRUCTED IMPROVEMENTS THAT ARE REQUIRED BY THE JURISDICTIONAL AGENCIES FOR THE CERTIFICATION PROCESS. ALL SURVEY COSTS WILL BE THE CONTRACTORS RESPONSIBILITY.
- 10. THE CONTRACTOR SHALL BE RESPONSIBLE FOR DOCUMENTING AND MAINTAINING AS-BUILT INFORMATION WHICH SHALL BE RECORDED AS CONSTRUCTION PROGRESSES OR AT THE COMPLETION OF APPROPRIATE CONSTRUCTION INTERVALS AND SHALL BE RESPONSIBLE FOR PROVIDING AS-BUILT DRAWINGS TO THE OWNER FOR THE PURPOSE OF CERTIFICATION TO JURISDICTIONAL AGENCIES AS REQUIRED. ALL AS-BUILT DATA SHALL BE COLLECTED BY A STATE OF FLORIDA PROFESSIONAL LAND SURVEYOR WHOSE SERVICES ARE ENGAGED BY THE CONTRACTOR.
- 11. ANY WELLS DISCOVERED ON SITE THAT WILL HAVE NO USE MUST BE PLUGGED BY A LICENSED WELL DRILLING CONTRACTOR IN A MANNER APPROVED BY ALL JURISDICTIONAL AGENCIES. CONTRACTOR SHALL BE RESPONSIBLE FOR OBTAINING ANY WELL ABANDONMENT PERMITS REQUIRED.
- 12. ANY WELL DISCOVERED DURING EARTH MOVING OR EXCAVATION SHALL BE REPORTED TO THE APPROPRIATE JURISDICTIONAL AGENCIES WITHIN 24 HOURS AFTER DISCOVERY
- 13. THE CONTRACTOR SHALL BE RESPONSIBLE FOR VERIFYING THAT THE PROPOSED IMPROVEMENTS SHOWN ON THE PLANS DO NOT CONFLICT WITH ANY KNOWN EXISTING OR OTHER PROPOSED IMPROVEMENTS. IF ANY CONFLICTS ARE DISCOVERED, THE CONTRACTOR SHALL NOTIFY THE OWNER PRIOR TO INSTALLATION OF ANY PORTION OF THE SITE WORK THAT WOULD BE AFFECTED. FAILURE TO NOTIFY OWNER OF AN IDENTIFIABLE CONFLICT PRIOR TO PROCEEDING WITH INSTALLATION RELIEVES OWNER OF ANY OBLIGATION TO PAY FOR A RELATED CHANGE ORDER.

DEMOLITION NOTES

- 1. ALL MATERIAL REMOVED FROM THIS SITE BY THE CONTRACTOR SHALL BE DISPOSED OF BY THE CONTRACTOR IN A LEGAL MANNER.
- 2. REFER TO THE TOPOGRAPHIC SURVEY FOR ADDITIONAL DETAILS OF EXISTING STRUCTURES, ETC., LOCATED WITHIN THE PROJECT SITE. UNLESS OTHERWISE NOTED, ALL EXISTING BUILDINGS, STRUCTURES, SLABS, CONCRETE, ASPHALT, DEBRIS PILES, SIGNS, AND ALL APPURTENANCES ARE TO BE REMOVED FROM THE SITE BY THE CONTRACTOR AND PROPERLY DISPOSED OF IN A LEGAL MANNER AS PART OF THIS CONTRACT. SOME ITEMS TO BE REMOVED MAY NOT BE DEPICTED ON THE TOPOGRAPHIC SURVEY. IT IS THE CONTRACTOR'S RESPONSIBILITY TO VISIT THE SITE AND DETERMINE THE FULL EXTENT OF ITEMS TO BE REMOVED. IF ANY ITEMS ARE IN QUESTION, THE CONTRACTOR SHALL CONTACT THE OWNER PRIOR TO REMOVAL OF SAID ITEMS.
- 3. THE CONTRACTOR SHALL REFER TO THE TREE PRESERVATION PLAN FOR DEMOLITION/PRESERVATION OF EXISTING TREES. ALL TREES NOT SPECIFICALLY SHOWN TO BE PRESERVED OR RELOCATED SHALL BE PRESERVED AS A PART OF THIS CONTRACT. TREE PROTECTION FENCING SHALL BE INSTALLED PRIOR TO ANY DEMOLITION.

PAVING, GRADING AND DRAINAGE NOTES

- 1. ALL PAVING, CONSTRUCTION, MATERIALS, AND WORKMANSHIP WITHIN COUNTY'S RIGHT-OF-WAY SHALL BE IN ACCORDANCE WITH LOCAL OR COUNTY SPECIFICATIONS AND STANDARDS (LATEST EDITION) OR FDOT SPECIFICATIONS AND STANDARDS (LATEST EDITION) IF NOT COVERED BY LOCAL OR COUNTY REGULATIONS.
- 2. ALL UNPAVED AREAS IN EXISTING RIGHTS-OF-WAY DISTURBED BY CONSTRUCTION SHALL BE REGRADED AND SODDED.
- 3. TRAFFIC CONTROL ON ALL FDOT, LOCAL AND COUNTY RIGHTS-OF-WAY SHALL MEET THE REQUIREMENTS OF THE MANUAL OF UNIFORM TRAFFIC CONTROL DEVICES (U.S. DOT/FHA) AND THE REQUIREMENTS OF THE STATE AND ANY LOCAL AGENCY HAVING JURISDICTION. IN THE EVENT THAT THE CONTRACT DOCUMENTS AND THE JURISDICTIONAL AGENCY REQUIREMENTS ARE NOT IN AGREEMENT, THE MOST STRINGENT SHALL GOVERN.
- 4. THE CONTRACTOR SHALL GRADE THE SITE TO THE ELEVATIONS INDICATED AND SHALL REGRADE WASHOUTS WHERE THEY OCCUR AFTER EVERY RAINFALL UNTIL A GRASS STAND IS WELL ESTABLISHED OR ADEQUATE STABILIZATION OCCURS.
- 5. ALL OPEN AREAS WITHIN THE PROJECT SITE SHALL BE SODDED UNLESS INDICATED

OTHERWISE ON THE LANDSCAPE PLAN.

- 6. ALL AREAS INDICATED AS PAVEMENT SHALL BE CONSTRUCTED IN ACCORDANCE WITH THE TYPICAL PAVEMENT SECTIONS AS INDICATED ON THE DRAWINGS.
- WHERE EXISTING PAVEMENT IS INDICATED TO BE REMOVED AND REPLACED. THE CONTRACTOR SHALL SAW CUT A MINIMUM 2" DEEP FOR A SMOOTH AND STRAIGHT JOINT AND REPLACE THE PAVEMENT WITH THE SAME TYPE AND DEPTH OF MATERIAL AS EXISTING OR AS INDICATED.
- WHERE NEW PAVEMENT MEETS THE EXISTING PAVEMENT, THE CONTRACTOR SHALL SAW CUT THE EXISTING PAVEMENT A MINIMUM 2" DEEP FOR A SMOOTH AND STRAIGHT JOINT AND MATCH THE EXISTING PAVEMENT ELEVATION WITH THE PROPOSED PAVEMENT UNLESS OTHERWISE INDICATED.
- 9. THE CONTRACTOR SHALL INSTALL FILTER FABRIC OVER ALL DRAINAGE STRUCTURES FOR THE DURATION OF CONSTRUCTION AND UNTIL ACCEPTANCE OF THE PROJECT BY THE OWNER. ALL DRAINAGE STRUCTURES SHALL BE CLEANED OF DEBRIS AS REQUIRED DURING AND AT THE END OF CONSTRUCTION TO PROVIDE POSITIVE DRAINAGE FLOWS.
- 10. IF DEWATERING IS REQUIRED, THE CONTRACTOR SHALL OBTAIN ANY APPLICABLE REQUIRED PERMITS. THE CONTRACTOR IS TO COORDINATE WITH THE OWNER AND THE DESIGN ENGINEER PRIOR TO ANY EXCAVATION.
- 11. STRIP TOPSOIL AND ORGANIC MATTER FROM ALL AREAS OF THE SITE AS REQUIRED. IN SOME CASES TOPSOIL MAY BE STOCKPILED ON SITE FOR PLACEMENT WITHIN LANDSCAPED AREAS BUT ONLY AS DIRECTED BY THE OWNER.
- 12. FIELD DENSITY TESTS SHALL BE TAKEN AT INTERVALS IN ACCORDANCE WITH THE LOCAL JURISDICTIONAL AGENCY OR TO FDOT STANDARDS. IN THE EVENT THAT THE CONTRACT DOCUMENTS AND THE JURISDICTIONAL AGENCY REQUIREMENTS ARE NOT IN AGREEMENT, THE MOST STRINGENT SHALL GOVERN
- 13. ALL SLOPES AND AREAS DISTURBED BY CONSTRUCTION SHALL BE GRADED AS PER PLANS. THE AREAS SHALL THEN BE SODDED OR SEEDED AS SPECIFIED IN THE PLANS. FERTILIZED, MULCHED, WATERED AND MAINTAINED UNTIL HARDY GRASS GROWTH IS ESTABLISHED IN ALL AREAS. ANY AREAS DISTURBED FOR ANY REASON PRIOR TO FINAL ACCEPTANCE OF THE JOB SHALL BE CORRECTED BY THE CONTRACTOR AT NO ADDITIONAL COST TO THE OWNER. ALL EARTHEN AREAS WILL BE SODDED OR SEEDED AND MULCHED AS SHOWN ON THE LANDSCAPING PLAN.
- 14. ALL CUT OR FILL SLOPES SHALL BE 4 (HORIZONTAL):1 (VERTICAL) OR FLATTER UNLESS OTHERWISE SHOWN.
- 15. THE CONTRACTOR SHALL BE RESPONSIBLE FOR THE CONTROL OF DUST AND DIRT RISING AND SCATTERING IN THE AIR DURING CONSTRUCTION AND SHALL PROVIDE WATER SPRINKLING OR OTHER SUITABLE METHODS OF CONTROL. THE CONTRACTOR SHALL COMPLY WITH ALL GOVERNING REGULATIONS PERTAINING TO ENVIRONMENTAL PROTECTION.
- 16. THE CONTRACTOR SHALL TAKE ALL REQUIRED MEASURES TO CONTROL TURBIDITY, INCLUDING BUT NOT LIMITED TO THE INSTALLATION OF TURBIDITY BARRIERS AT ALL LOCATIONS WHERE THE POSSIBILITY OF TRANSFERRING SUSPENDED SOLIDS INTO THE RECEIVING WATER BODY EXISTS DUE TO THE PROPOSED WORK. TURBIDITY BARRIERS MUST BE MAINTAINED IN EFFECTIVE CONDITION AT ALL LOCATIONS UNTIL CONSTRUCTION IS COMPLETED AND DISTURBED SOIL AREAS ARE STABILIZED. THEREAFTER, THE CONTRACTOR MUST REMOVE THE BARRIERS. AT NO TIME SHALL THERE BE ANY OFF-SITE DISCHARGE WHICH VIOLATES THE WATER QUALITY STANDARDS IN CHAPTER 17-302, FLORIDA ADMINISTRATIVE CODE.
- 17. SOD. WHERE CALLED FOR. MUST BE INSTALLED AND MAINTAINED ON EXPOSED SLOPES WITHIN 48 HOURS OF COMPLETING FINAL GRADING, AND AT ANY OTHER TIME AS NECESSARY, TO PREVENT EROSION, SEDIMENTATION OR TURBID DISCHARGES.
- 18. THE CONTRACTOR MUST REVIEW AND MAINTAIN A COPY OF THE ENVIRONMENTAL RESOURCE PERMIT COMPLETE WITH ALL CONDITIONS, ATTACHMENTS, EXHIBITS, AND PERMIT MODIFICATIONS IN GOOD CONDITION AT THE CONSTRUCTION SITE. THE COMPLETE PERMIT MUST BE AVAILABLE FOR REVIEW UPON REQUEST BY WATER MANAGEMENT DISTRICT REPRESENTATIVES.
- 19. THE CONTRACTOR SHALL ENSURE THAT ISLAND PLANTING AREAS AND OTHER PLANTING AREAS ARE NOT COMPACTED AND DO NOT CONTAIN ROAD BASE MATERIALS. THE CONTRACTOR SHALL ALSO EXCAVATE AND REMOVE ALL UNDESIRABLE MATERIAL FROM ALL AREAS ON THE SITE TO BE PLANTED AND PROPERLY DISPOSED OF IN A LEGAL MANNER.
- 20. THE CONTRACTOR SHALL INSTALL ALL UNDERGROUND STORM WATER PIPING PER

MANUFACTURER'S RECOMMENDATIONS.

WATER AND SEWER UTILITY NOTES

- THE CONTRACTOR SHALL CONSTRUCT GRAVITY SEWER LATERALS, MANHOLES GRAVITY SEWER LINES AND DOMESTIC WATER AND FIRE PROTECTION SYSTEM AS SHOWN ON THESE PLANS. THE CONTRACTOR SHALL FURNISH ALL NECESSARY MATERIALS. EQUIPMENT, MACHINERY, TOOLS, MEANS OF TRANSPORTATION AND LABOR NECESSARY TO COMPLETE THE WORK IN FULL AND COMPLETE ACCORDANCE WITH THE SHOWN, DESCRIBED AND REASONABLY INTENDED REQUIREMENTS OF THE CONTRACT DOCUMENTS AND JURISDICTIONAL AGENCY REQUIREMENTS. IN THE EVENT THAT THE CONTRACT DOCUMENTS AND THE JURISDICTIONAL AGENCY REQUIREMENTS ARE NOT IN AGREEMENT, THE MOST STRINGENT SHALL GOVERN.
- 2. ALL EXISTING UNDERGROUND UTILITY LOCATIONS SHOWN ARE APPROXIMATE. THE CONTRACTOR SHALL COMPLY WITH ALL REQUIREMENTS FOR UTILITY LOCATION AND COORDINATION IN ACCORDANCE WITH THE NOTES CONTAINED IN THE GENERAL CONSTRUCTION SECTION OF THIS SHEET.
- 3. THE CONTRACTOR SHALL RESTORE ALL DISTURBED VEGETATION IN KIND, UNLESS SHOWN OTHERWISE.
- 4. DEFLECTION OF PIPE JOINTS AND CURVATURE OF PIPE SHALL NOT EXCEED THE MANUFACTURER'S SPECIFICATIONS. SECURELY CLOSE ALL OPEN ENDS OF PIPE AND FITTINGS WITH A WATERTIGHT PLUG WHEN WORK IS NOT IN PROGRESS. THE INTERIOR OF ALL PIPES SHALL BE CLEAN AND JOINT SURFACES WIPED CLEAN AND DRY AFTER THE PIPE HAS BEEN LOWERED INTO THE TRENCH. VALVES SHALL BE PLUMB AND LOCATED ACCORDING TO THE PLANS.
- 5. ALL PHASES OF INSTALLATION, INCLUDING UNLOADING, TRENCHING, LAYING AND BACK FILLING, SHALL BE DONE IN A FIRST CLASS WORKMANLIKE MANNER. ALL PIPE AND FITTINGS SHALL BE CAREFULLY STORED FOLLOWING MANUFACTURER'S RECOMMENDATIONS. CARE SHALL BE TAKEN TO AVOID DAMAGE TO THE COATING OR LINING IN ANY D.I. PIPE FITTINGS. ANY PIPE OR FITTING WHICH IS DAMAGED OR WHICH HAS FLAWS OR IMPERFECTIONS WHICH, IN THE OPINION OF THE ENGINEER OR OWNER, RENDERS IT UNFIT FOR USE, SHALL NOT BE USED. ANY PIPE NOT SATISFACTORY FOR USE SHALL BE CLEARLY MARKED AND IMMEDIATELY REMOVED FROM THE JOB SITE, AND SHALL BE REPLACED AT THE CONTRACTOR'S EXPENSE.
- 6. WATER FOR FIRE FIGHTING SHALL BE AVAILABLE FOR USE PRIOR TO COMBUSTIBLES BEING BROUGHT ON SITE.
- 7. ALL UTILITY AND STORM DRAIN TRENCHES LOCATED UNDER AREAS TO RECEIVE PAVING SHALL BE COMPLETELY BACK FILLED IN ACCORDANCE WITH THE GOVERNING JURISDICTIONAL AGENCY'S SPECIFICATIONS. IN THE EVENT THAT THE CONTRACT DOCUMENTS AND THE JURISDICTIONAL AGENCY REQUIREMENTS ARE NOT IN AGREEMENT, THE MOST STRINGENT SHALL GOVERN.
- 8. UNDERGROUND LINES SHALL BE SURVEYED BY A STATE OF FLORIDA PROFESSIONAL LAND SURVEYOR PRIOR TO BACK FILLING.
- 9. CONTRACTOR SHALL PERFORM, AT HIS OWN EXPENSE, ANY AND ALL TESTS REQUIRED BY THE SPECIFICATIONS AND/OR ANY AGENCY HAVING JURISDICTION. THESE TESTS MAY INCLUDE, BUT MAY NOT BE LIMITED TO, INFILTRATION AND EXFILTRATION, TELEVISION INSPECTION AND A MANDREL TEST ON GRAVITY SEWER. A COPY OF THE TEST RESULTS SHALL BE PROVIDED TO THE UTILITY PROVIDER, OWNER AND JURISDICTIONAL AGENCY AS REQUIRED.

EROSION CONTROL NOTES

- 1. THE STORM WATER POLLUTION PREVENTION PLAN ("SWPPP") IS COMPRISED OF THIS EROSION CONTROL PLAN, THE STANDARD DETAILS, THE PLAN NARRATIVE. ATTACHMENTS INCLUDED IN SPECIFICATIONS OF THE SWPPP, PLUS THE PERMIT AND ALL SUBSEQUENT REPORTS AND RELATED DOCUMENTS.
- 2. ALL CONTRACTORS AND SUBCONTRACTORS INVOLVED WITH STORM WATER POLLUTION PREVENTION SHALL OBTAIN A COPY OF THE STORM WATER POLLUTION PREVENTION PLAN AND THE STATE OF FLORIDA NATIONAL POLLUTANT DISCHARGE ELIMINATION SYSTEM GENERAL PERMIT (NPDES PERMIT) AND BECOME FAMILIAR WITH THEIR
- 3. THE CONTRACTOR SHALL IMPLEMENT BEST MANAGEMENT PRACTICES AS REQUIRED BY THE SWPPP. ADDITIONAL BEST MANAGEMENT PRACTICES SHALL BE IMPLEMENTED AS DICTATED BY CONDITIONS AT NO ADDITIONAL COST TO THE OWNER THROUGHOUT ALL PHASES OF CONSTRUCTION
- 4. BEST MANAGEMENT PRACTICES (BMP'S) AND CONTROLS SHALL CONFORM TO FEDERAL. STATE, OR LOCAL REQUIREMENTS OR MANUAL OF PRACTICE, AS APPLICABLE. THE CONTRACTOR SHALL IMPLEMENT ADDITIONAL CONTROLS AS DIRECTED BY THE PERMITTING AGENCY OR OWNER.
- 5. EROSION CONTROL PLAN MUST CLEARLY DELINEATE ALL STATE WATERS. PERMITS FOR ANY CONSTRUCTION ACTIVITY IMPACTING STATE WATERS OR REGULATED WETLANDS MUST BE MAINTAINED ON SITE AT ALL TIMES.
- 6. THE CONTRACTOR SHALL MINIMIZE CLEARING TO THE MAXIMUM EXTENT PRACTICAL OR AS REQUIRED BY THE GENERAL PERMIT.
- 7. CONTRACTOR SHALL DENOTE ON PLAN THE TEMPORARY PARKING AND STORAGE AREA WHICH SHALL ALSO BE USED AS THE EQUIPMENT MAINTENANCE AND CLEANING AREA. EMPLOYEE PARKING AREA, AND AREA FOR LOCATING PORTABLE FACILITIES, OFFICE TRAILERS, AND TOILET FACILITIES.
- 8. ALL WASH WATER (CONCRETE TRUCKS, VEHICLE CLEANING, EQUIPMENT CLEANING, ETC.) SHALL BE DETAINED AND PROPERLY TREATED OR DISPOSED.
- 9. SUFFICIENT OIL AND GREASE ABSORBING MATERIALS AND FLOTATION BOOMS SHALL BE MAINTAINED ON SITE OR READILY AVAILABLE TO CONTAIN AND CLEAN-UP FUEL OR CHEMICAL SPILLS AND LEAKS.
- 10. THE CONTRACTOR SHALL BE RESPONSIBLE FOR DUST CONTROL ON SITE. THE USE OF MOTOR OILS AND OTHER PETROLEUM BASED OR TOXIC LIQUIDS FOR DUST SUPPRESSION OPERATIONS IS PROHIBITED.
- 11. RUBBISH, TRASH, GARBAGE, LITTER, OR OTHER SUCH MATERIALS SHALL BE DEPOSITED INTO SEALED CONTAINERS. MATERIALS SHALL BE PREVENTED FROM LEAVING THE PREMISES THROUGH THE ACTION OF WIND OR STORM WATER DISCHARGE INTO DRAINAGE DITCHES OR WATERS OF THE STATE.
- 12. ALL STORM WATER POLLUTION PREVENTION MEASURES PRESENTED ON THE PLAN, SHALL BE INITIATED AS SOON AS PRACTICABLE

EROSION CONTROL NOTES (CONT.)

- CASE MORE THAN 7 DAYS WHERE CONSTRUCTION HAS TEMPORARILY CEASED.
- 14. DISTURBED PORTIONS OF THE SITE WHERE CONSTRUCTION ACTIVITY HAS PERMANENTLY STOPPED SHALL BE PERMANENTLY SEEDED. THESE AREAS SHALL BE SEEDED NO LATER THAN 7 DAYS AFTER THE LAST CONSTRUCTION ACTIVITY OCCURRED IN THESE AREAS. REFER TO SECTION 981 OF THE STANDARD SPECIFICATIONS FOR
- 15. IF THE ACTION OF VEHICLES TRAVELING OVER THE GRAVEL CONSTRUCTION ENTRANCES IS NOT SUFFICIENT TO REMOVE THE MAJORITY OF DIRT OR MUD, THEN THE USED, PROVISIONS MUST BE MADE TO INTERCEPT THE WASH WATER AND TRAP THE
- 16. ALL MATERIALS SPILLED, DROPPED, WASHED, OR TRACKED FROM VEHICLES ONTO ROADWAYS OR INTO STORM DRAINS MUST BE REMOVED AS SOON AS POSSIBLE.
- 17. THE CONTRACTOR SHALL BE RESPONSIBLE FOR REMOVING SEDIMENT IN THE DETENTION POND AND ANY SEDIMENT THAT MAY HAVE COLLECTED IN THE STORM
- 18. ON-SITE & OFF SITE SOIL STOCKPILE AND BORROW AREAS SHALL BE PROTECTED FROM EROSION AND SEDIMENTATION THROUGH IMPLEMENTATION OF BEST MANAGEMENT PRACTICES. STOCKPILE AND BORROW AREA LOCATIONS SHALL BE NOTED ON THE EROSION CONTROL PLAN AND PERMITTED IN ACCORDANCE WITH GENERAL PERMIT
- 19. SLOPES SHALL BE LEFT IN A ROUGHENED CONDITION DURING THE GRADING PHASE TO REDUCE RUNOFF VELOCITIES AND EROSION.
- 20. DUE TO GRADE CHANGES DURING THE DEVELOPMENT OF THE PROJECT, THE CONTRACTOR SHALL BE RESPONSIBLE FOR ADJUSTING THE EROSION CONTROL MEASURES (SILT FENCES, ETC.) TO PREVENT EROSION.
- 21. ALL CONSTRUCTION SHALL BE STABILIZED AT THE END OF EACH WORKING DAY, THIS INCLUDES BACK FILLING OF TRENCHES FOR UTILITY CONSTRUCTION AND PLACEMENT OF GRAVEL OR BITUMINOUS PAVING FOR ROAD CONSTRUCTION.

MAINTENANCE

ALL MEASURES STATED ON THE EROSION AND SEDIMENT CONTROL PLAN, AND IN THE

- 1. INLET PROTECTION DEVICES AND BARRIERS SHALL BE REPAIRED OR REPLACED IF THEY SHOW SIGNS OF UNDERMINING, OR DETERIORATION.
- 2. ALL SEEDED AREAS SHALL BE CHECKED REGULARLY TO SEE THAT A GOOD STAND IS MAINTAINED. AREAS SHOULD BE FERTILIZED, WATERED AND RESEEDED AS NEEDED. FOR MAINTENANCE REQUIREMENTS REFER TO SECTION 981 OF THE STANDARD SPECIFICATIONS.
- SEDIMENT SHALL BE REMOVED FROM THE SILT FENCES WHEN IT REACHES ONE-HALF THE HEIGHT OF THE SILT FENCE.
- 5. THE TEMPORARY PARKING AND STORAGE AREA SHALL BE KEPT IN GOOD CONDITION (SUITABLE FOR PARKING AND STORAGE). THIS MAY REQUIRE PERIODIC TOP DRESSING OF THE TEMPORARY PARKING AS CONDITIONS DEMAND.
- 6. OUTLET STRUCTURES IN THE SEDIMENTATION BASINS SHALL BE MAINTAINED IN OPERATIONAL CONDITIONS AT ALL TIMES. SEDIMENT SHALL BE REMOVED FROM SEDIMENT BASINS OR TRAPS WHEN THE DESIGN CAPACITY HAS BEEN REDUCED BY 55 CUBIC YARDS / ACRE.
- 7. ALL MAINTENANCE OPERATIONS SHALL BE DONE IN A TIMELY MANNER BUT IN NO

ADA NOTES

- 1. CURB RAMPS ALONG PUBLIC STREETS AND IN THE PUBLIC RIGHT-OF-WAY SHALL BE CONSTRUCTED BASED ON THE COUNTY STANDARD CONSTRUCTION DETAILS AND SPECIFICATIONS.
- 2. PRIVATE CURB RAMPS ON THE SITE (I.E. OUTSIDE PUBLIC STREET RIGHT-OF-WAY) SHALL CONFORM TO ADA STANDARDS AND SHALL HAVE A DETECTABLE WARNING SURFACE THAT IS FULL WIDTH AND FULL DEPTH OF THE CURB RAMP, NOT INCLUDING FLARES.
- STRIPING, AND PAVEMENT MARKINGS SHALL CONFORM TO ADA STANDARDS FOR ACCESSIBLE DESIGN, LATEST EDITION.
- PEDESTRIAN ROUTES (PER ADA AND FHA) EXIST TO AND FROM EVERY DOOR AND ALONG SIDEWALKS, ACCESSIBLE PARKING SPACES, ACCESS AISLES, AND ACCESSIBLE ROUTES. IN NO CASE SHALL AN ACCESSIBLE RAMP SLOPE EXCEED 1 VERTICAL TO 12 HORIZONTAL. IN NO CASE SHALL SIDEWALK CROSS SLOPE EXCEED 2.0 PERCENT. IN NO CASE SHALL LONGITUDINAL SIDEWALK SLOPE EXCEED 5.0 PERCENT. ACCESSIBLE PARKING SPACES AND ACCESS AISLES SHALL NOT EXCEED 2.0 PERCENT SLOPE IN ANY DIRECTION.

13. STABILIZATION PRACTICES SHOULD BE INITIATED AS SOON AS PRACTICAL, BUT IN NO

SEEDING AND MAINTENANCE REQUIREMENTS.

- TIRES MUST BE WASHED BEFORE THE VEHICLES ENTER A PUBLIC ROAD. IF WASHING IS SEDIMENT BEFORE IT IS CARRIED OFF THE SITE.
- SEWER DRAINAGE SYSTEMS IN CONJUNCTION WITH THE STABILIZATION OF THE SITE.
- REQUIREMENTS.

STORM WATER POLLUTION PREVENTION PLAN, SHALL BE MAINTAINED IN FULLY FUNCTIONAL CONDITION UNTIL NO LONGER REQUIRED FOR A COMPLETED PHASE OF WORK OR FINAL STABILIZATION OF THE SITE. ALL EROSION AND SEDIMENTATION CONTROL MEASURES SHALL BE CHECKED BY A QUALIFIED PERSON AT LEAST ONCE EVERY SEVEN CALENDAR DAYS AND WITHIN 24 HOURS OF THE END OF A 0.5" RAINFALL EVENT, AND CLEANED AND REPAIRED IN ACCORDANCE WITH THE FOLLOWING:

- 3. SILT FENCES SHALL BE REPAIRED TO THEIR ORIGINAL CONDITIONS IF DAMAGED.
- 4. THE CONSTRUCTION ENTRANCES SHALL BE MAINTAINED IN A CONDITION WHICH WILL PREVENT TRACKING OR FLOW OF MUD ONTO PUBLIC RIGHTS-OF-WAY. THIS MAY REQUIRE PERIODIC TOP DRESSING OF THE CONSTRUCTION ENTRANCES AS CONDITIONS DEMAND.
- CASE LATER THAN 2 CALENDAR DAYS FOLLOWING THE INSPECTION.

3. ALL ACCESSIBLE ROUTES, GENERAL SITE AND BUILDING ELEMENTS, RAMPS, CURB RAMPS,


4. BEFORE PLACING PAVEMENT, CONTRACTOR SHALL VERIFY THAT SUITABLE ACCESSIBLE


5. CONTRACTOR SHALL TAKE FIELD SLOPE MEASUREMENTS ON FINISHED SUBGRADE AND FORM BOARDS PRIOR TO PLACING PAVEMENT TO VERIFY THAT ADA SLOPE REQUIREMENTS ARE PROVIDED. CONTRACTOR SHALL CONTACT ENGINEER PRIOR TO PAVING IF ANY EXCESSIVE SLOPES ARE ENCOUNTERED. NO CONTRACTOR CHANGE ORDERS WILL BE ACCEPTED FOR ADA SLOPE COMPLIANCE ISSUES.

> GROUNDWATER / DEWATERING NOTE: THE PRESENCE OF GROUNDWATER SHOULD BE ANTICIPATED ON THIS PROJECT CONTRACTOR'S BID SHALL INCLUDE CONSIDERATION FOR THIS ISSUE. WHEN PERFORMING GRADING OPERATIONS DURING PERIODS OF WET WEATHER. PROVIDE ADEQUATE DEWATERING, DRAINAGE AND GROUND WATER MANAGEMENT TO CONTROL MOISTURE OF SOILS.

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(7)



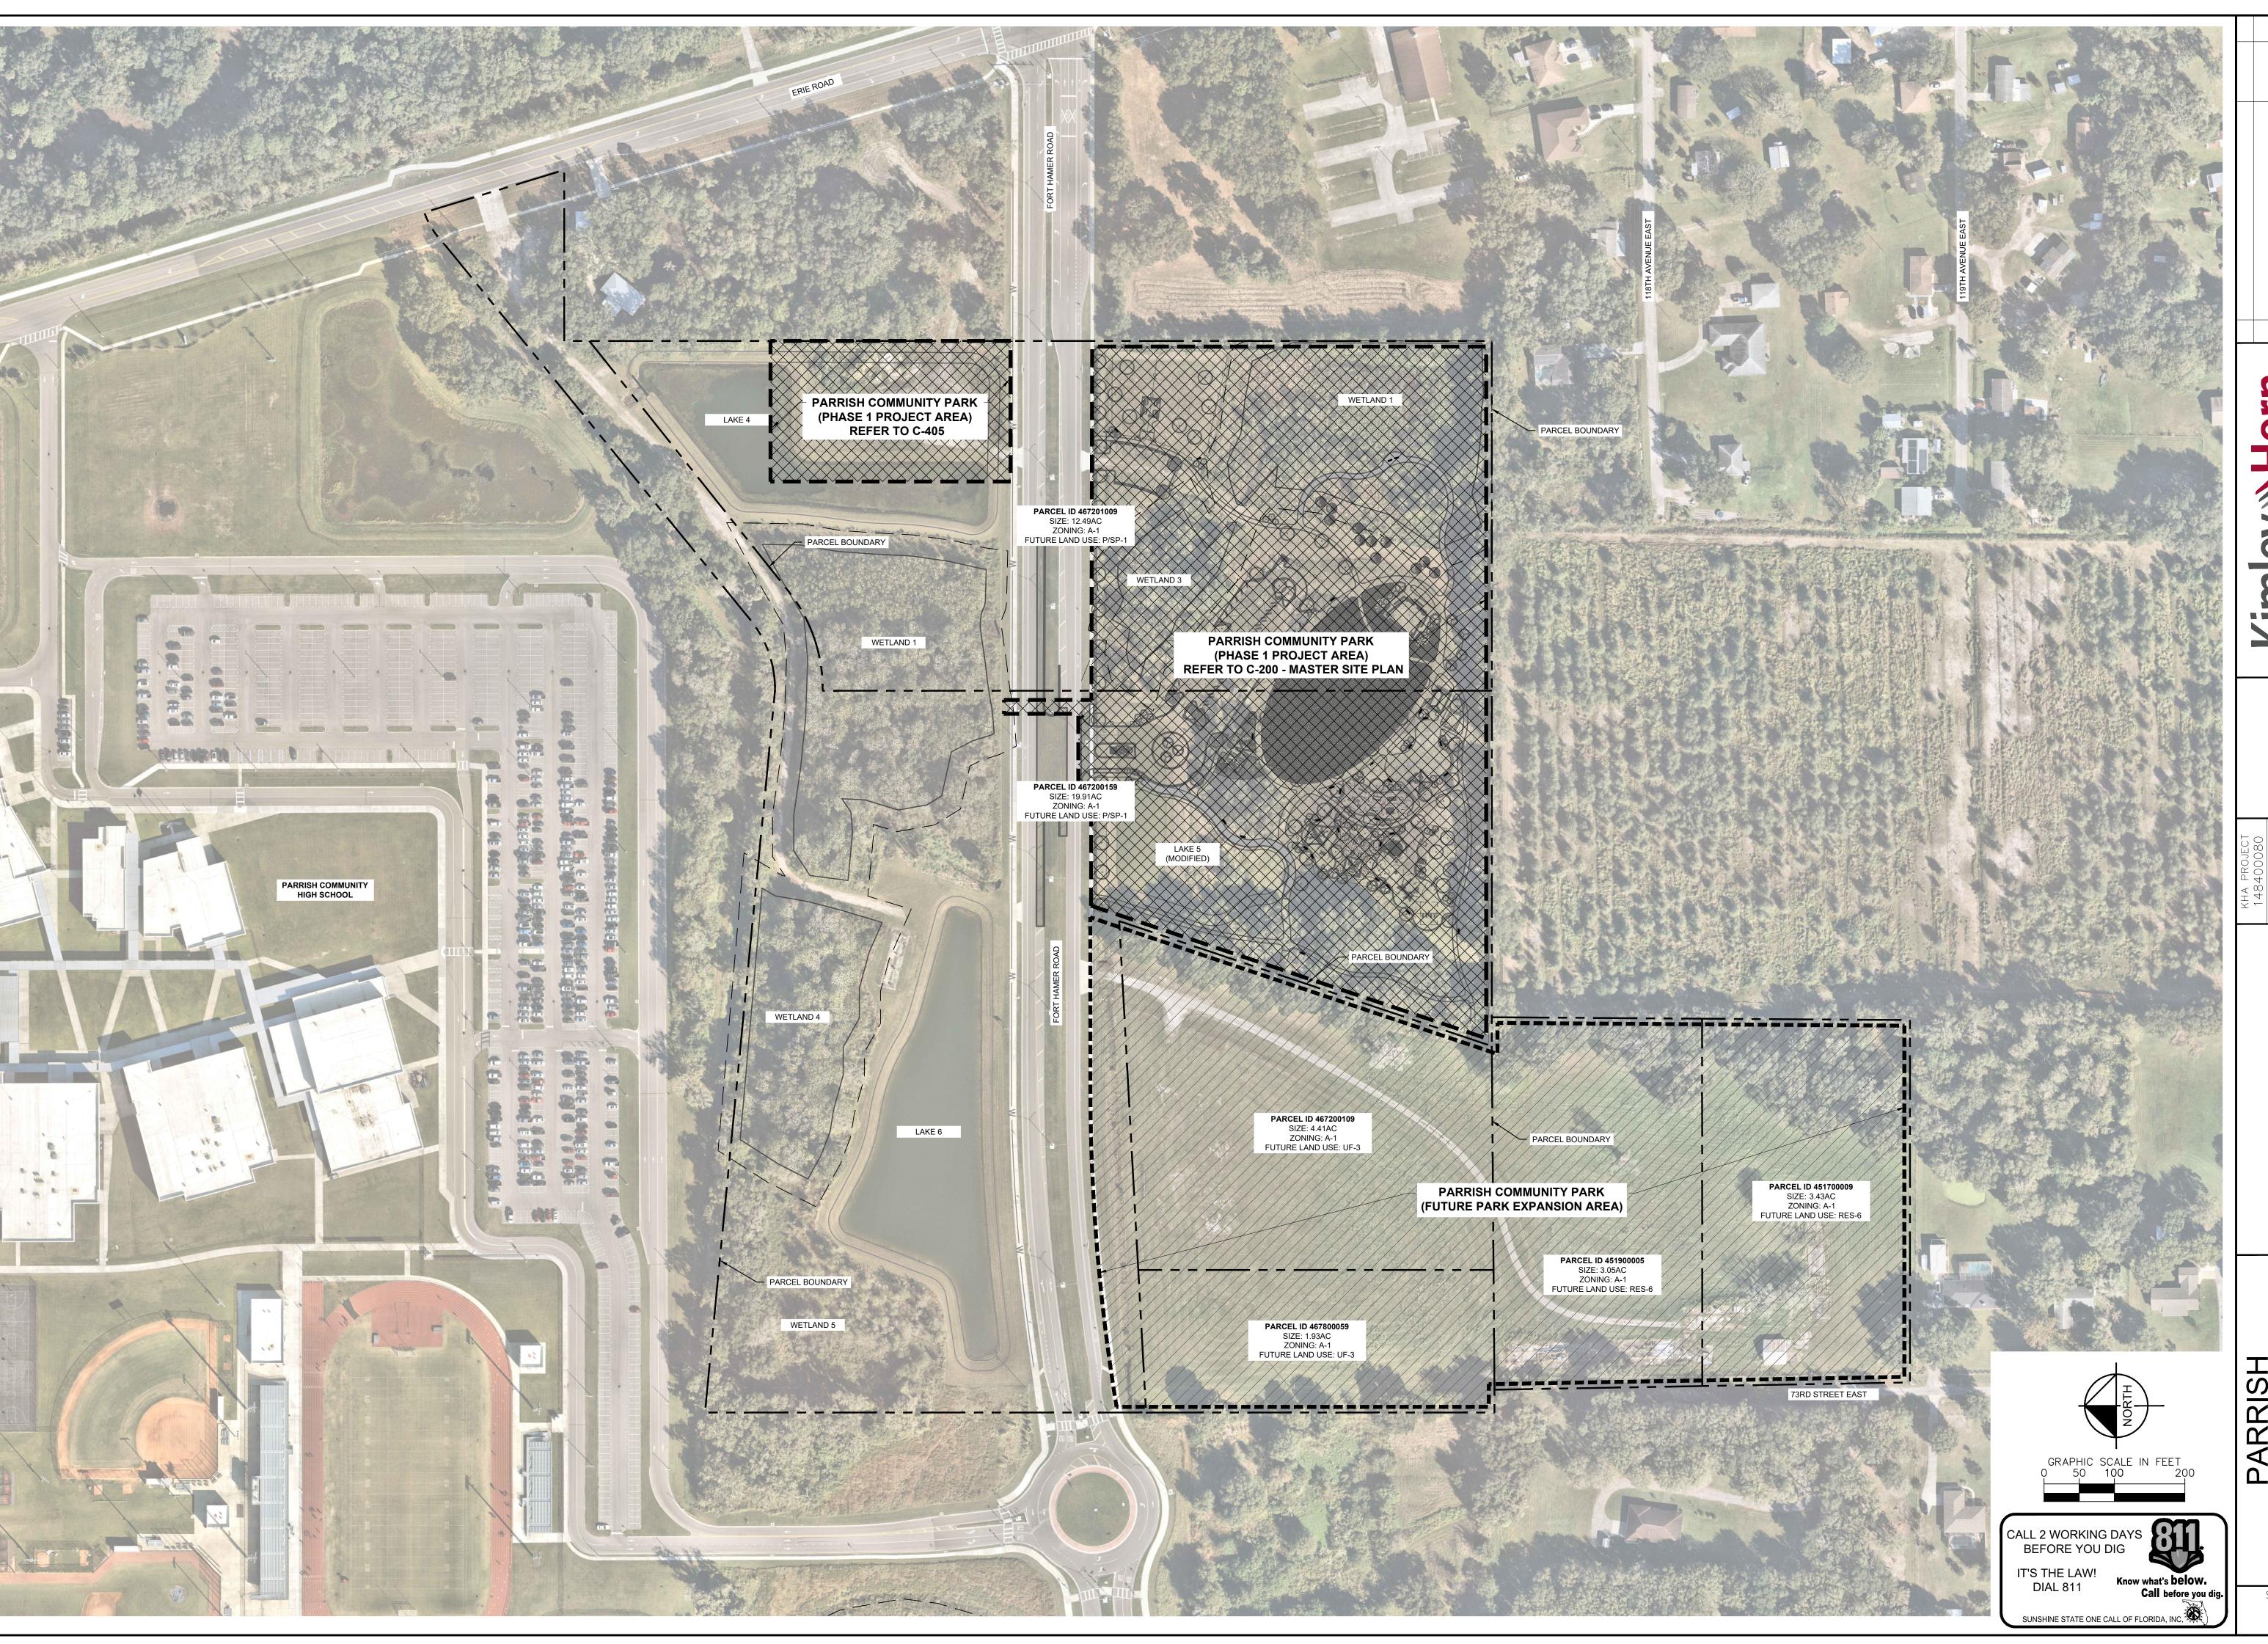

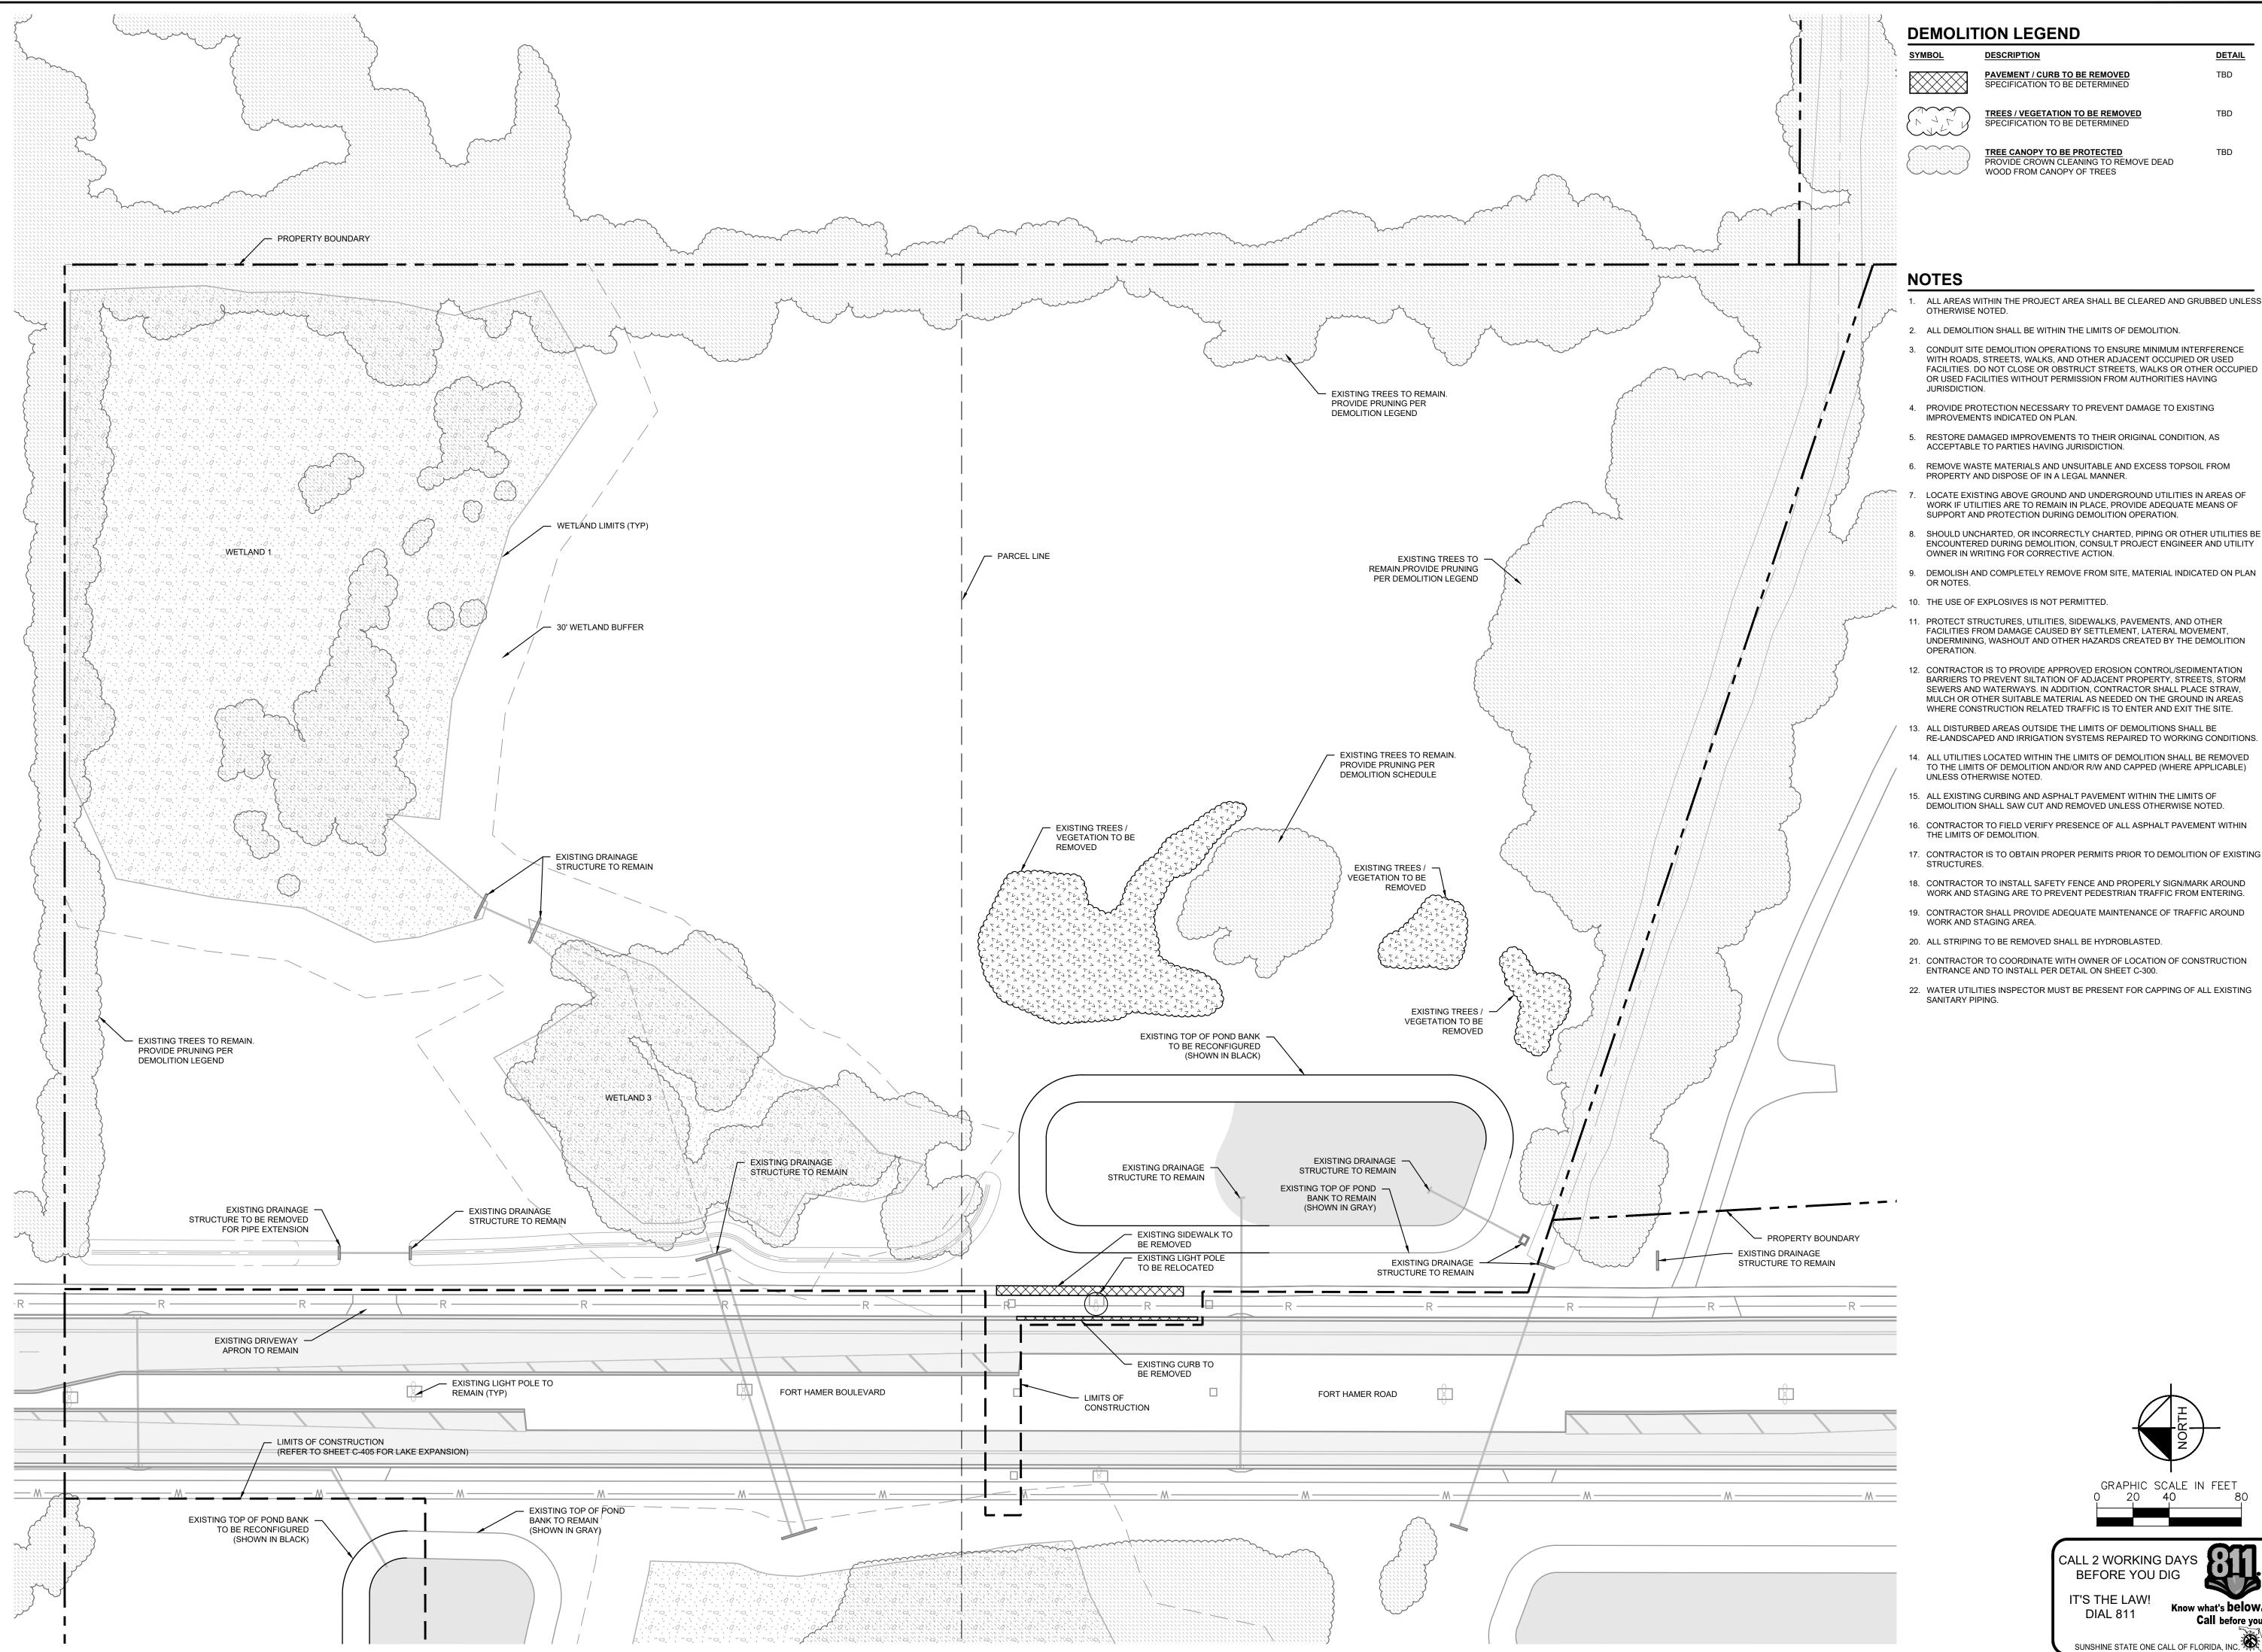SPECIFICATION TO BE DETERMINED

PROVIDE CROWN CLEANING TO REMOVE DEAD


- 1. ALL AREAS WITHIN THE PROJECT AREA SHALL BE CLEARED AND GRUBBED UNLESS
- 2. ALL DEMOLITION SHALL BE WITHIN THE LIMITS OF DEMOLITION.
- 3. CONDUIT SITE DEMOLITION OPERATIONS TO ENSURE MINIMUM INTERFERENCE WITH ROADS, STREETS, WALKS, AND OTHER ADJACENT OCCUPIED OR USED FACILITIES. DO NOT CLOSE OR OBSTRUCT STREETS, WALKS OR OTHER OCCUPIED OR USED FACILITIES WITHOUT PERMISSION FROM AUTHORITIES HAVING
- 4. PROVIDE PROTECTION NECESSARY TO PREVENT DAMAGE TO EXISTING
- 5. RESTORE DAMAGED IMPROVEMENTS TO THEIR ORIGINAL CONDITION, AS
- 6. REMOVE WASTE MATERIALS AND UNSUITABLE AND EXCESS TOPSOIL FROM PROPERTY AND DISPOSE OF IN A LEGAL MANNER.
- LOCATE EXISTING ABOVE GROUND AND UNDERGROUND UTILITIES IN AREAS OF WORK IF UTILITIES ARE TO REMAIN IN PLACE, PROVIDE ADEQUATE MEANS OF
- 8. SHOULD UNCHARTED, OR INCORRECTLY CHARTED, PIPING OR OTHER UTILITIES BE
- OWNER IN WRITING FOR CORRECTIVE ACTION.

- FACILITIES FROM DAMAGE CAUSED BY SETTLEMENT, LATERAL MOVEMENT, UNDERMINING, WASHOUT AND OTHER HAZARDS CREATED BY THE DEMOLITION
- BARRIERS TO PREVENT SILTATION OF ADJACENT PROPERTY, STREETS, STORM SEWERS AND WATERWAYS. IN ADDITION, CONTRACTOR SHALL PLACE STRAW, MULCH OR OTHER SUITABLE MATERIAL AS NEEDED ON THE GROUND IN AREAS WHERE CONSTRUCTION RELATED TRAFFIC IS TO ENTER AND EXIT THE SITE.
- 14. ALL UTILITIES LOCATED WITHIN THE LIMITS OF DEMOLITION SHALL BE REMOVED
- TO THE LIMITS OF DEMOLITION AND/OR R/W AND CAPPED (WHERE APPLICABLE)
- 15. ALL EXISTING CURBING AND ASPHALT PAVEMENT WITHIN THE LIMITS OF DEMOLITION SHALL SAW CUT AND REMOVED UNLESS OTHERWISE NOTED.
- 16. CONTRACTOR TO FIELD VERIFY PRESENCE OF ALL ASPHALT PAVEMENT WITHIN
- 17. CONTRACTOR IS TO OBTAIN PROPER PERMITS PRIOR TO DEMOLITION OF EXISTING
- 18. CONTRACTOR TO INSTALL SAFETY FENCE AND PROPERLY SIGN/MARK AROUND
- 19. CONTRACTOR SHALL PROVIDE ADEQUATE MAINTENANCE OF TRAFFIC AROUND
- 20. ALL STRIPING TO BE REMOVED SHALL BE HYDROBLASTED.
- 21. CONTRACTOR TO COORDINATE WITH OWNER OF LOCATION OF CONSTRUCTION
- 22. WATER UTILITIES INSPECTOR MUST BE PRESENT FOR CAPPING OF ALL EXISTING

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SPECIFICATION TO BE DETERMINED

PROVIDE CROWN CLEANING TO REMOVE DEAD WOOD FROM CANOPY OF TREES

- 1. ALL AREAS WITHIN THE PROJECT AREA SHALL BE CLEARED AND GRUBBED UNLESS
- 2. ALL DEMOLITION SHALL BE WITHIN THE LIMITS OF DEMOLITION.
- 3. CONDUIT SITE DEMOLITION OPERATIONS TO ENSURE MINIMUM INTERFERENCE WITH ROADS, STREETS, WALKS, AND OTHER ADJACENT OCCUPIED OR USED FACILITIES. DO NOT CLOSE OR OBSTRUCT STREETS, WALKS OR OTHER OCCUPIED OR USED FACILITIES WITHOUT PERMISSION FROM AUTHORITIES HAVING
- 4. PROVIDE PROTECTION NECESSARY TO PREVENT DAMAGE TO EXISTING
- ACCEPTABLE TO PARTIES HAVING JURISDICTION.
- PROPERTY AND DISPOSE OF IN A LEGAL MANNER.
- WORK IF UTILITIES ARE TO REMAIN IN PLACE, PROVIDE ADEQUATE MEANS OF SUPPORT AND PROTECTION DURING DEMOLITION OPERATION.
- 8. SHOULD UNCHARTED, OR INCORRECTLY CHARTED, PIPING OR OTHER UTILITIES BE ENCOUNTERED DURING DEMOLITION, CONSULT PROJECT ENGINEER AND UTILITY
- 9. DEMOLISH AND COMPLETELY REMOVE FROM SITE, MATERIAL INDICATED ON PLAN
- 11. PROTECT STRUCTURES, UTILITIES, SIDEWALKS, PAVEMENTS, AND OTHER FACILITIES FROM DAMAGE CAUSED BY SETTLEMENT, LATERAL MOVEMENT, UNDERMINING, WASHOUT AND OTHER HAZARDS CREATED BY THE DEMOLITION
- 12. CONTRACTOR IS TO PROVIDE APPROVED EROSION CONTROL/SEDIMENTATION BARRIERS TO PREVENT SILTATION OF ADJACENT PROPERTY, STREETS, STORM SEWERS AND WATERWAYS. IN ADDITION, CONTRACTOR SHALL PLACE STRAW, MULCH OR OTHER SUITABLE MATERIAL AS NEEDED ON THE GROUND IN AREAS WHERE CONSTRUCTION RELATED TRAFFIC IS TO ENTER AND EXIT THE SITE.
- 14. ALL UTILITIES LOCATED WITHIN THE LIMITS OF DEMOLITION SHALL BE REMOVED
- TO THE LIMITS OF DEMOLITION AND/OR R/W AND CAPPED (WHERE APPLICABLE)
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- 17. CONTRACTOR IS TO OBTAIN PROPER PERMITS PRIOR TO DEMOLITION OF EXISTING
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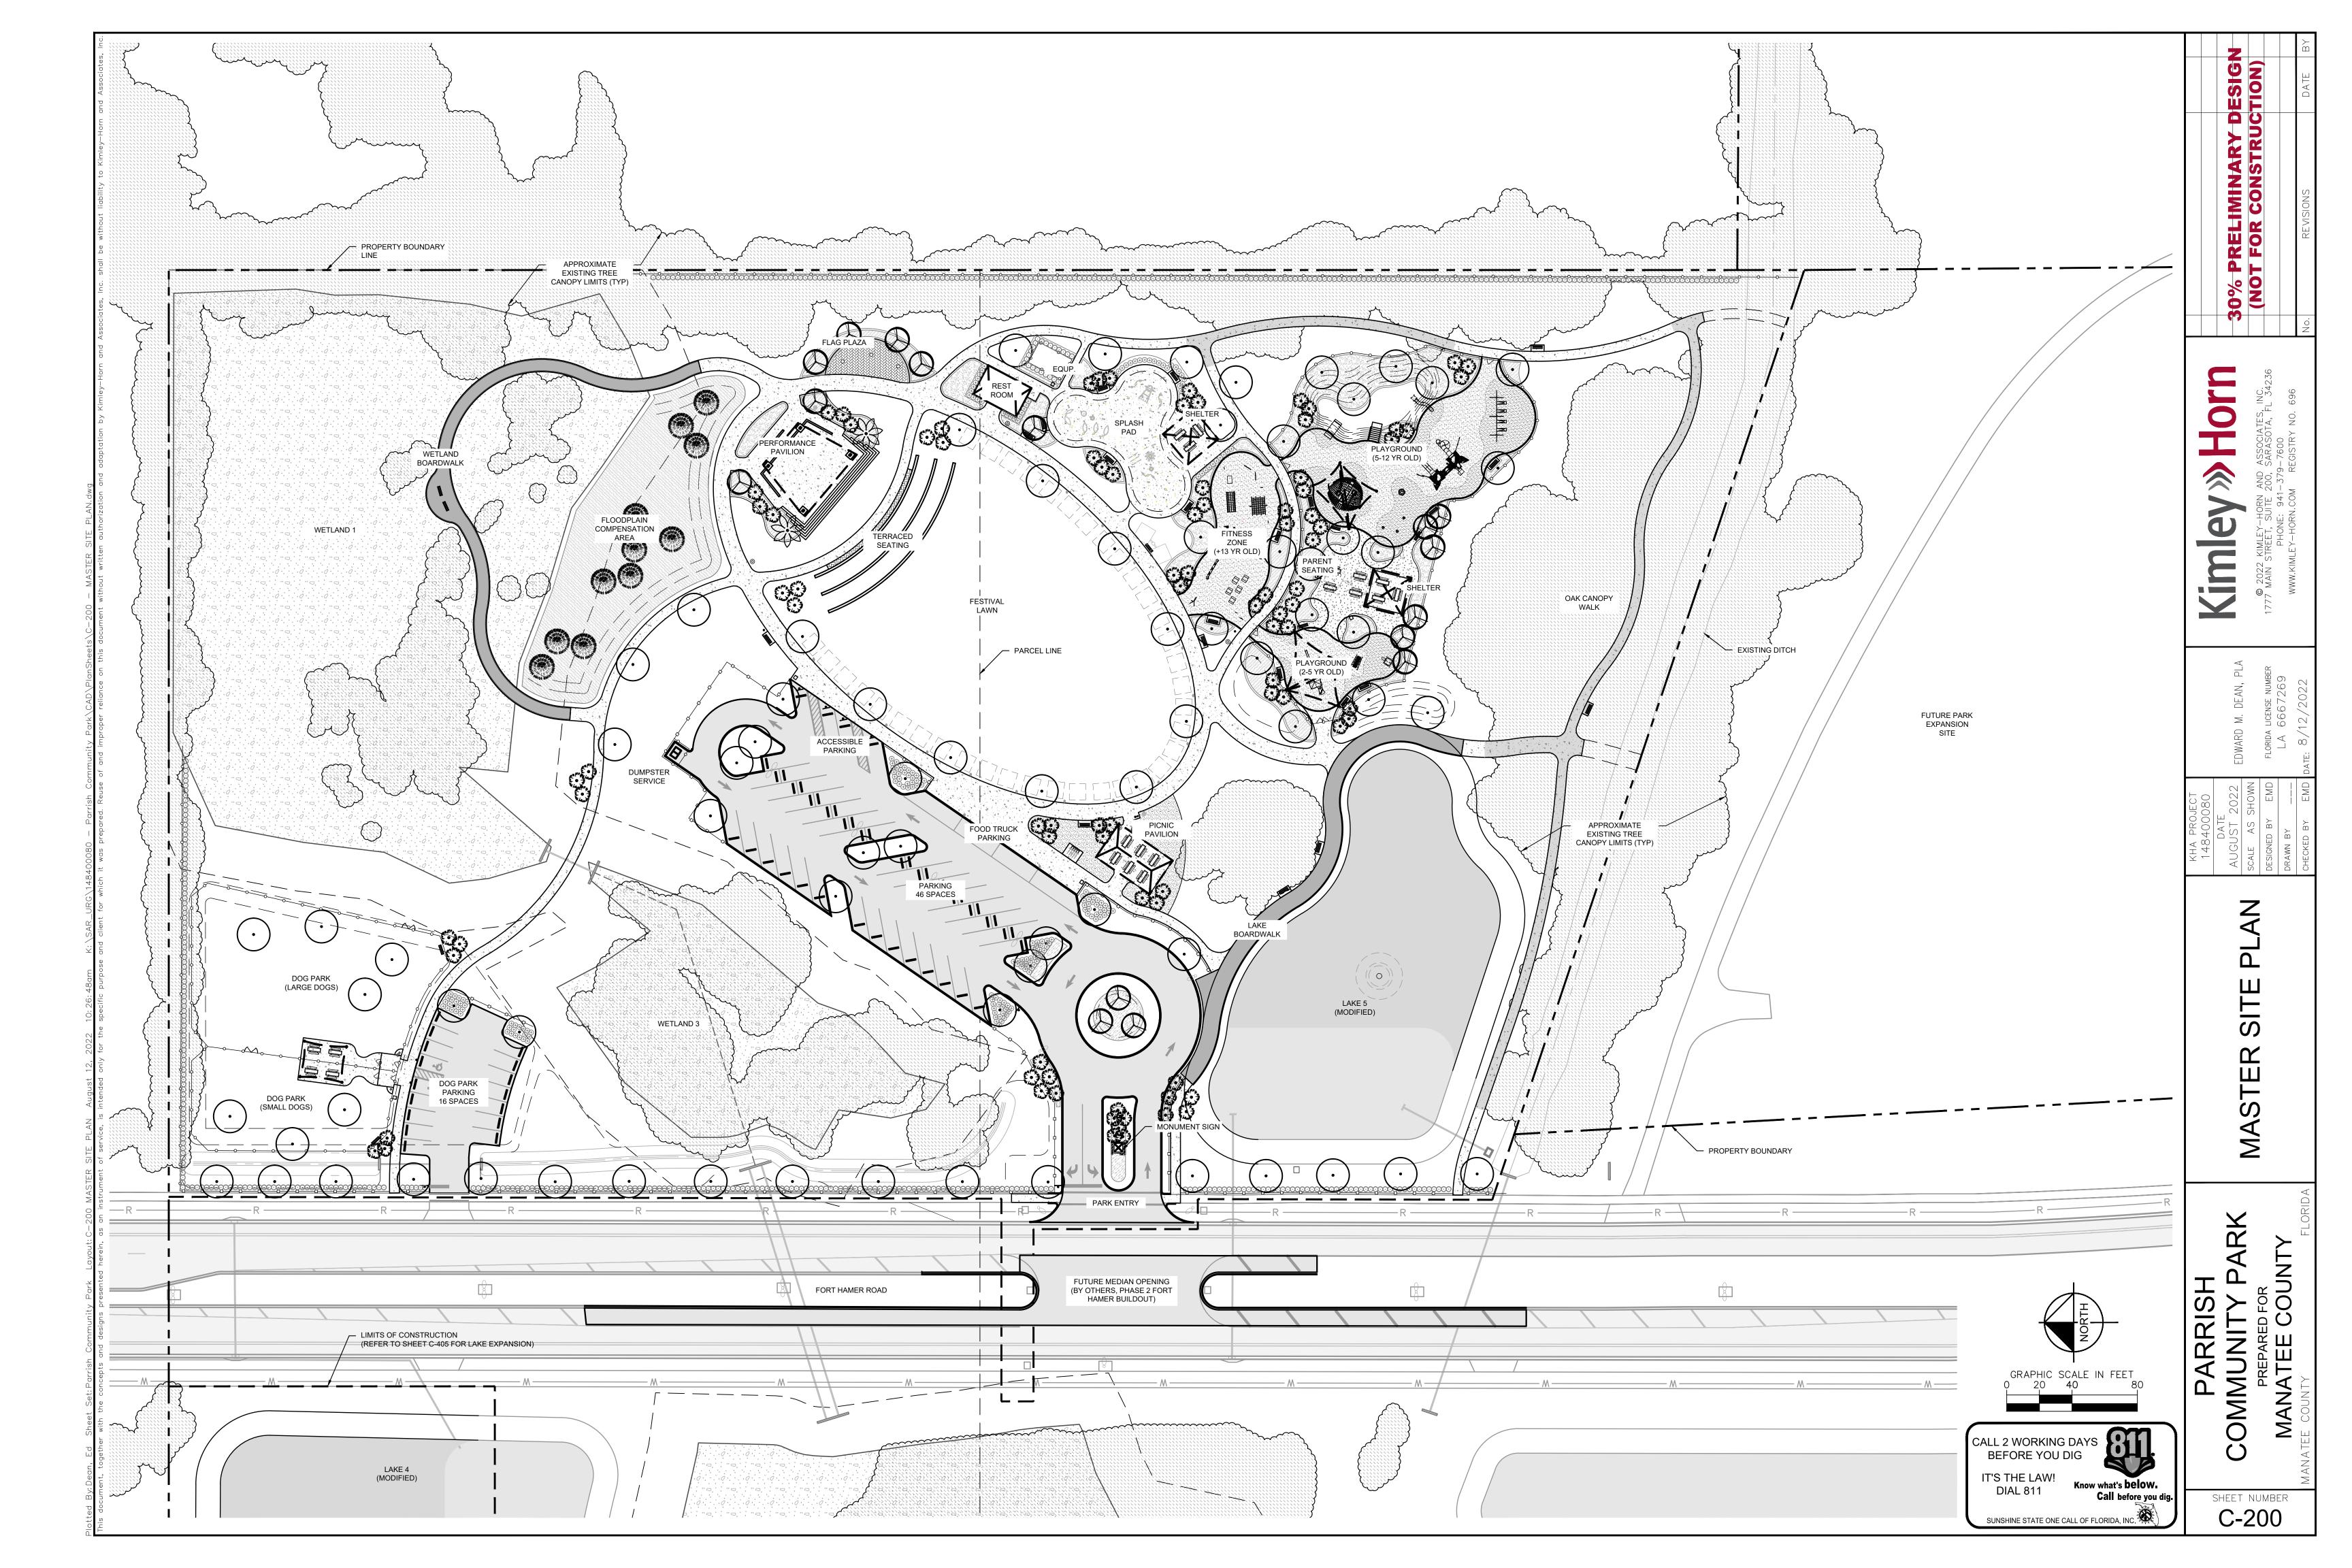
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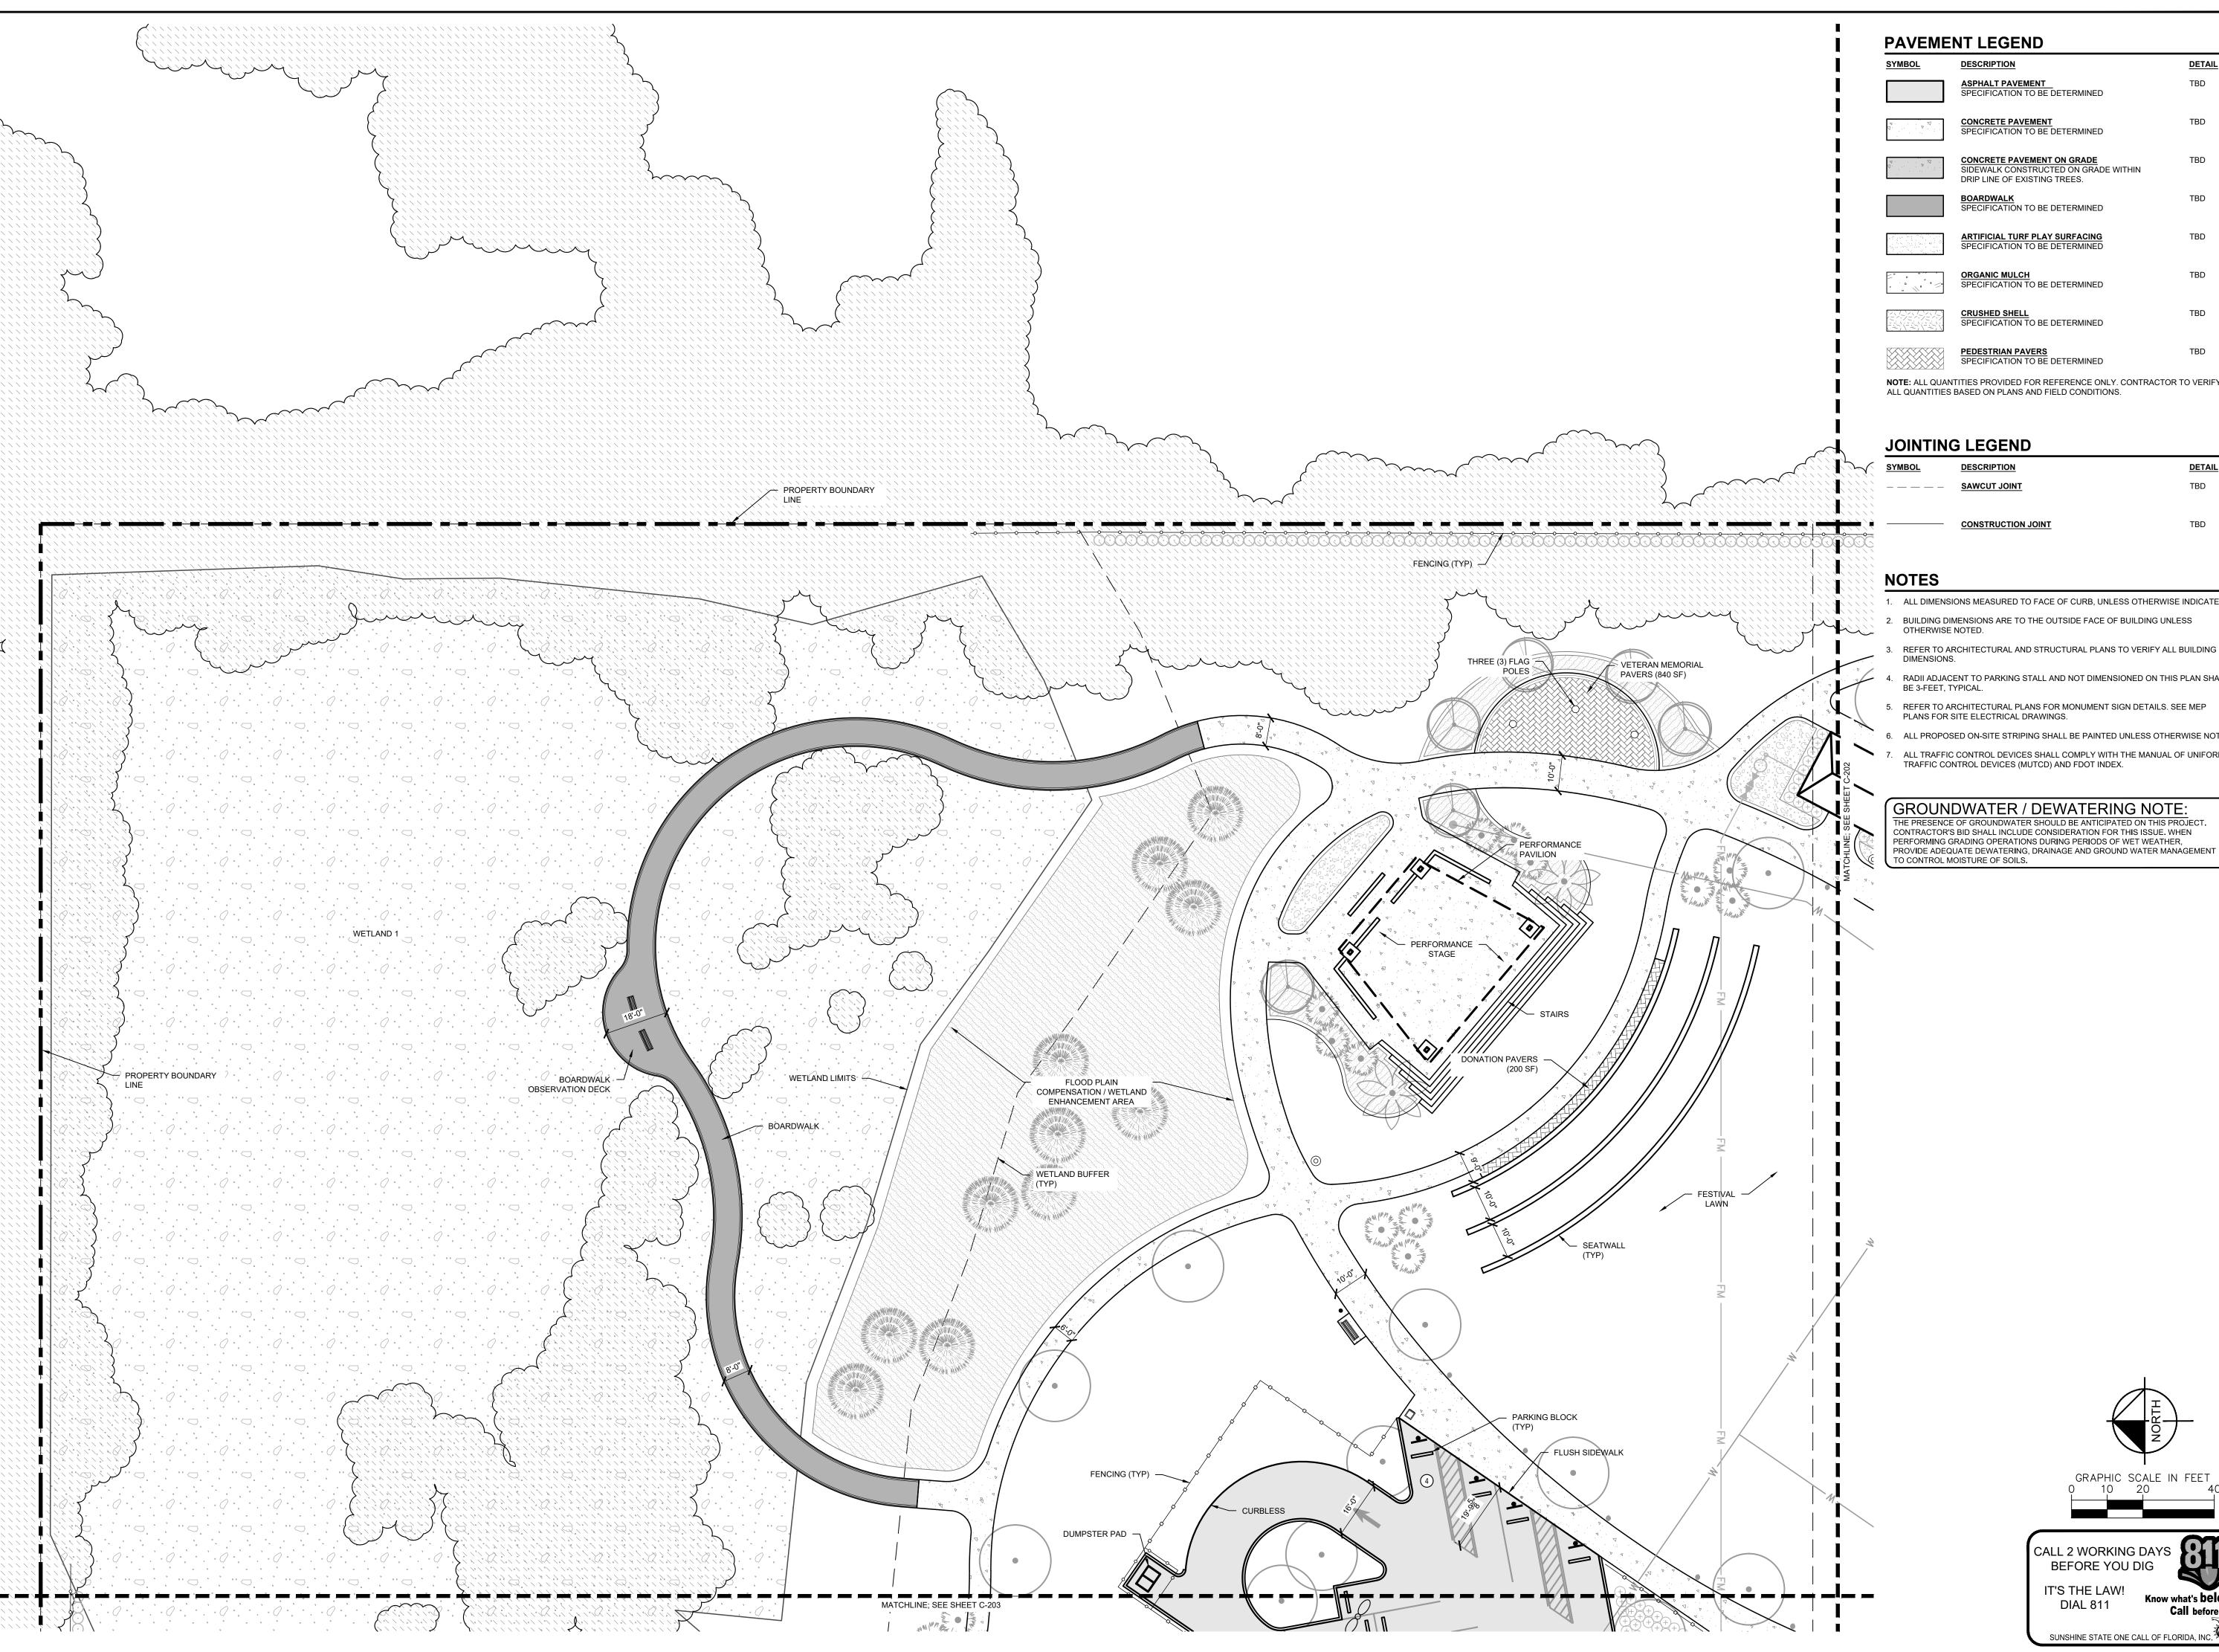
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ASPHALT PAVEMENT
SPECIFICATION TO BE DETERMINED CONCRETE PAVEMENT ON GRADE
SIDEWALK CONSTRUCTED ON GRADE WITHIN DRIP LINE OF EXISTING TREES. SPECIFICATION TO BE DETERMINED ARTIFICIAL TURF PLAY SURFACING SPECIFICATION TO BE DETERMINED TBD ORGANIC MULCH
SPECIFICATION TO BE DETERMINED TBD TBD

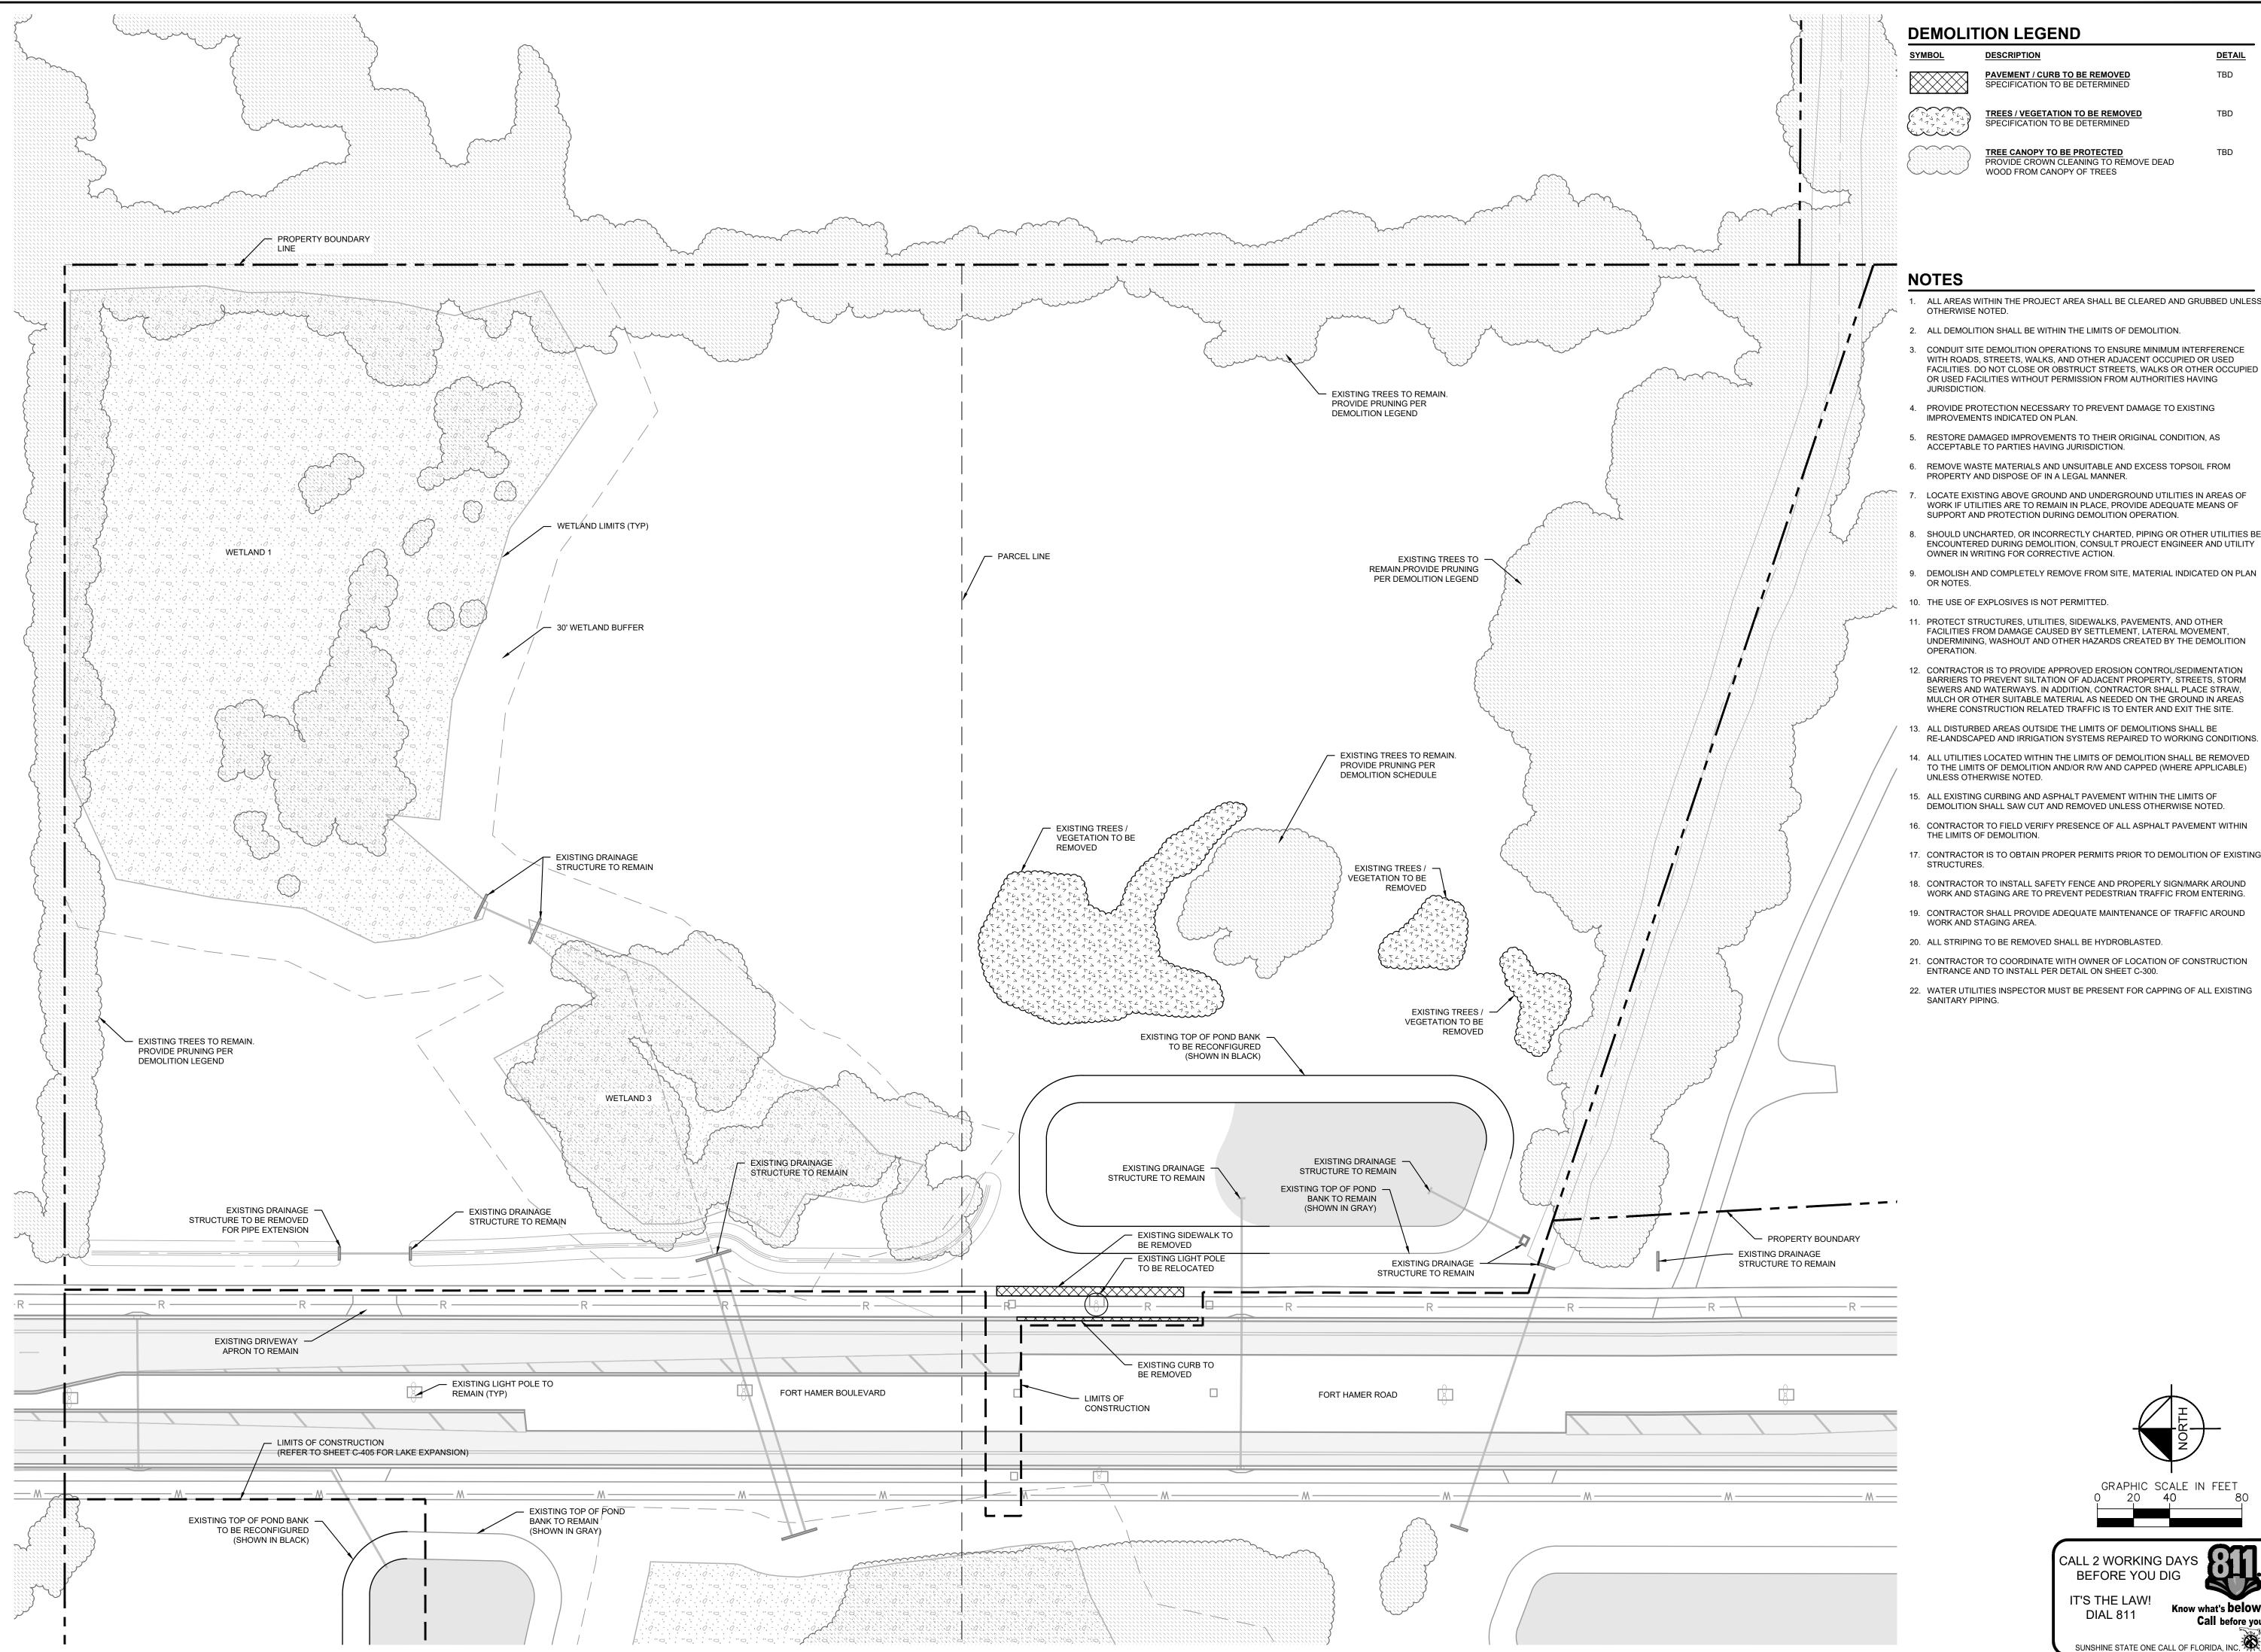TBD

NOTE: ALL QUANTITIES PROVIDED FOR REFERENCE ONLY. CONTRACTOR TO VERIFY ALL QUANTITIES BASED ON PLANS AND FIELD CONDITIONS.


SYMBOL	DESCRIPTION	DETAIL
	SAWCUT JOINT	TBD
	CONSTRUCTION JOINT	TBD

- 1. ALL DIMENSIONS MEASURED TO FACE OF CURB, UNLESS OTHERWISE INDICATED. 2. BUILDING DIMENSIONS ARE TO THE OUTSIDE FACE OF BUILDING UNLESS
- REFER TO ARCHITECTURAL AND STRUCTURAL PLANS TO VERIFY ALL BUILDING
- RADII ADJACENT TO PARKING STALL AND NOT DIMENSIONED ON THIS PLAN SHALL
- ALL PROPOSED ON-SITE STRIPING SHALL BE PAINTED UNLESS OTHERWISE NOTED.
- ALL TRAFFIC CONTROL DEVICES SHALL COMPLY WITH THE MANUAL OF UNIFORM TRAFFIC CONTROL DEVICES (MUTCD) AND FDOT INDEX.


GROUNDWATER / DEWATERING NOTE: CONTRACTOR'S BID SHALL INCLUDE CONSIDERATION FOR THIS ISSUE. WHEN PERFORMING GRADING OPERATIONS DURING PERIODS OF WET WEATHER,

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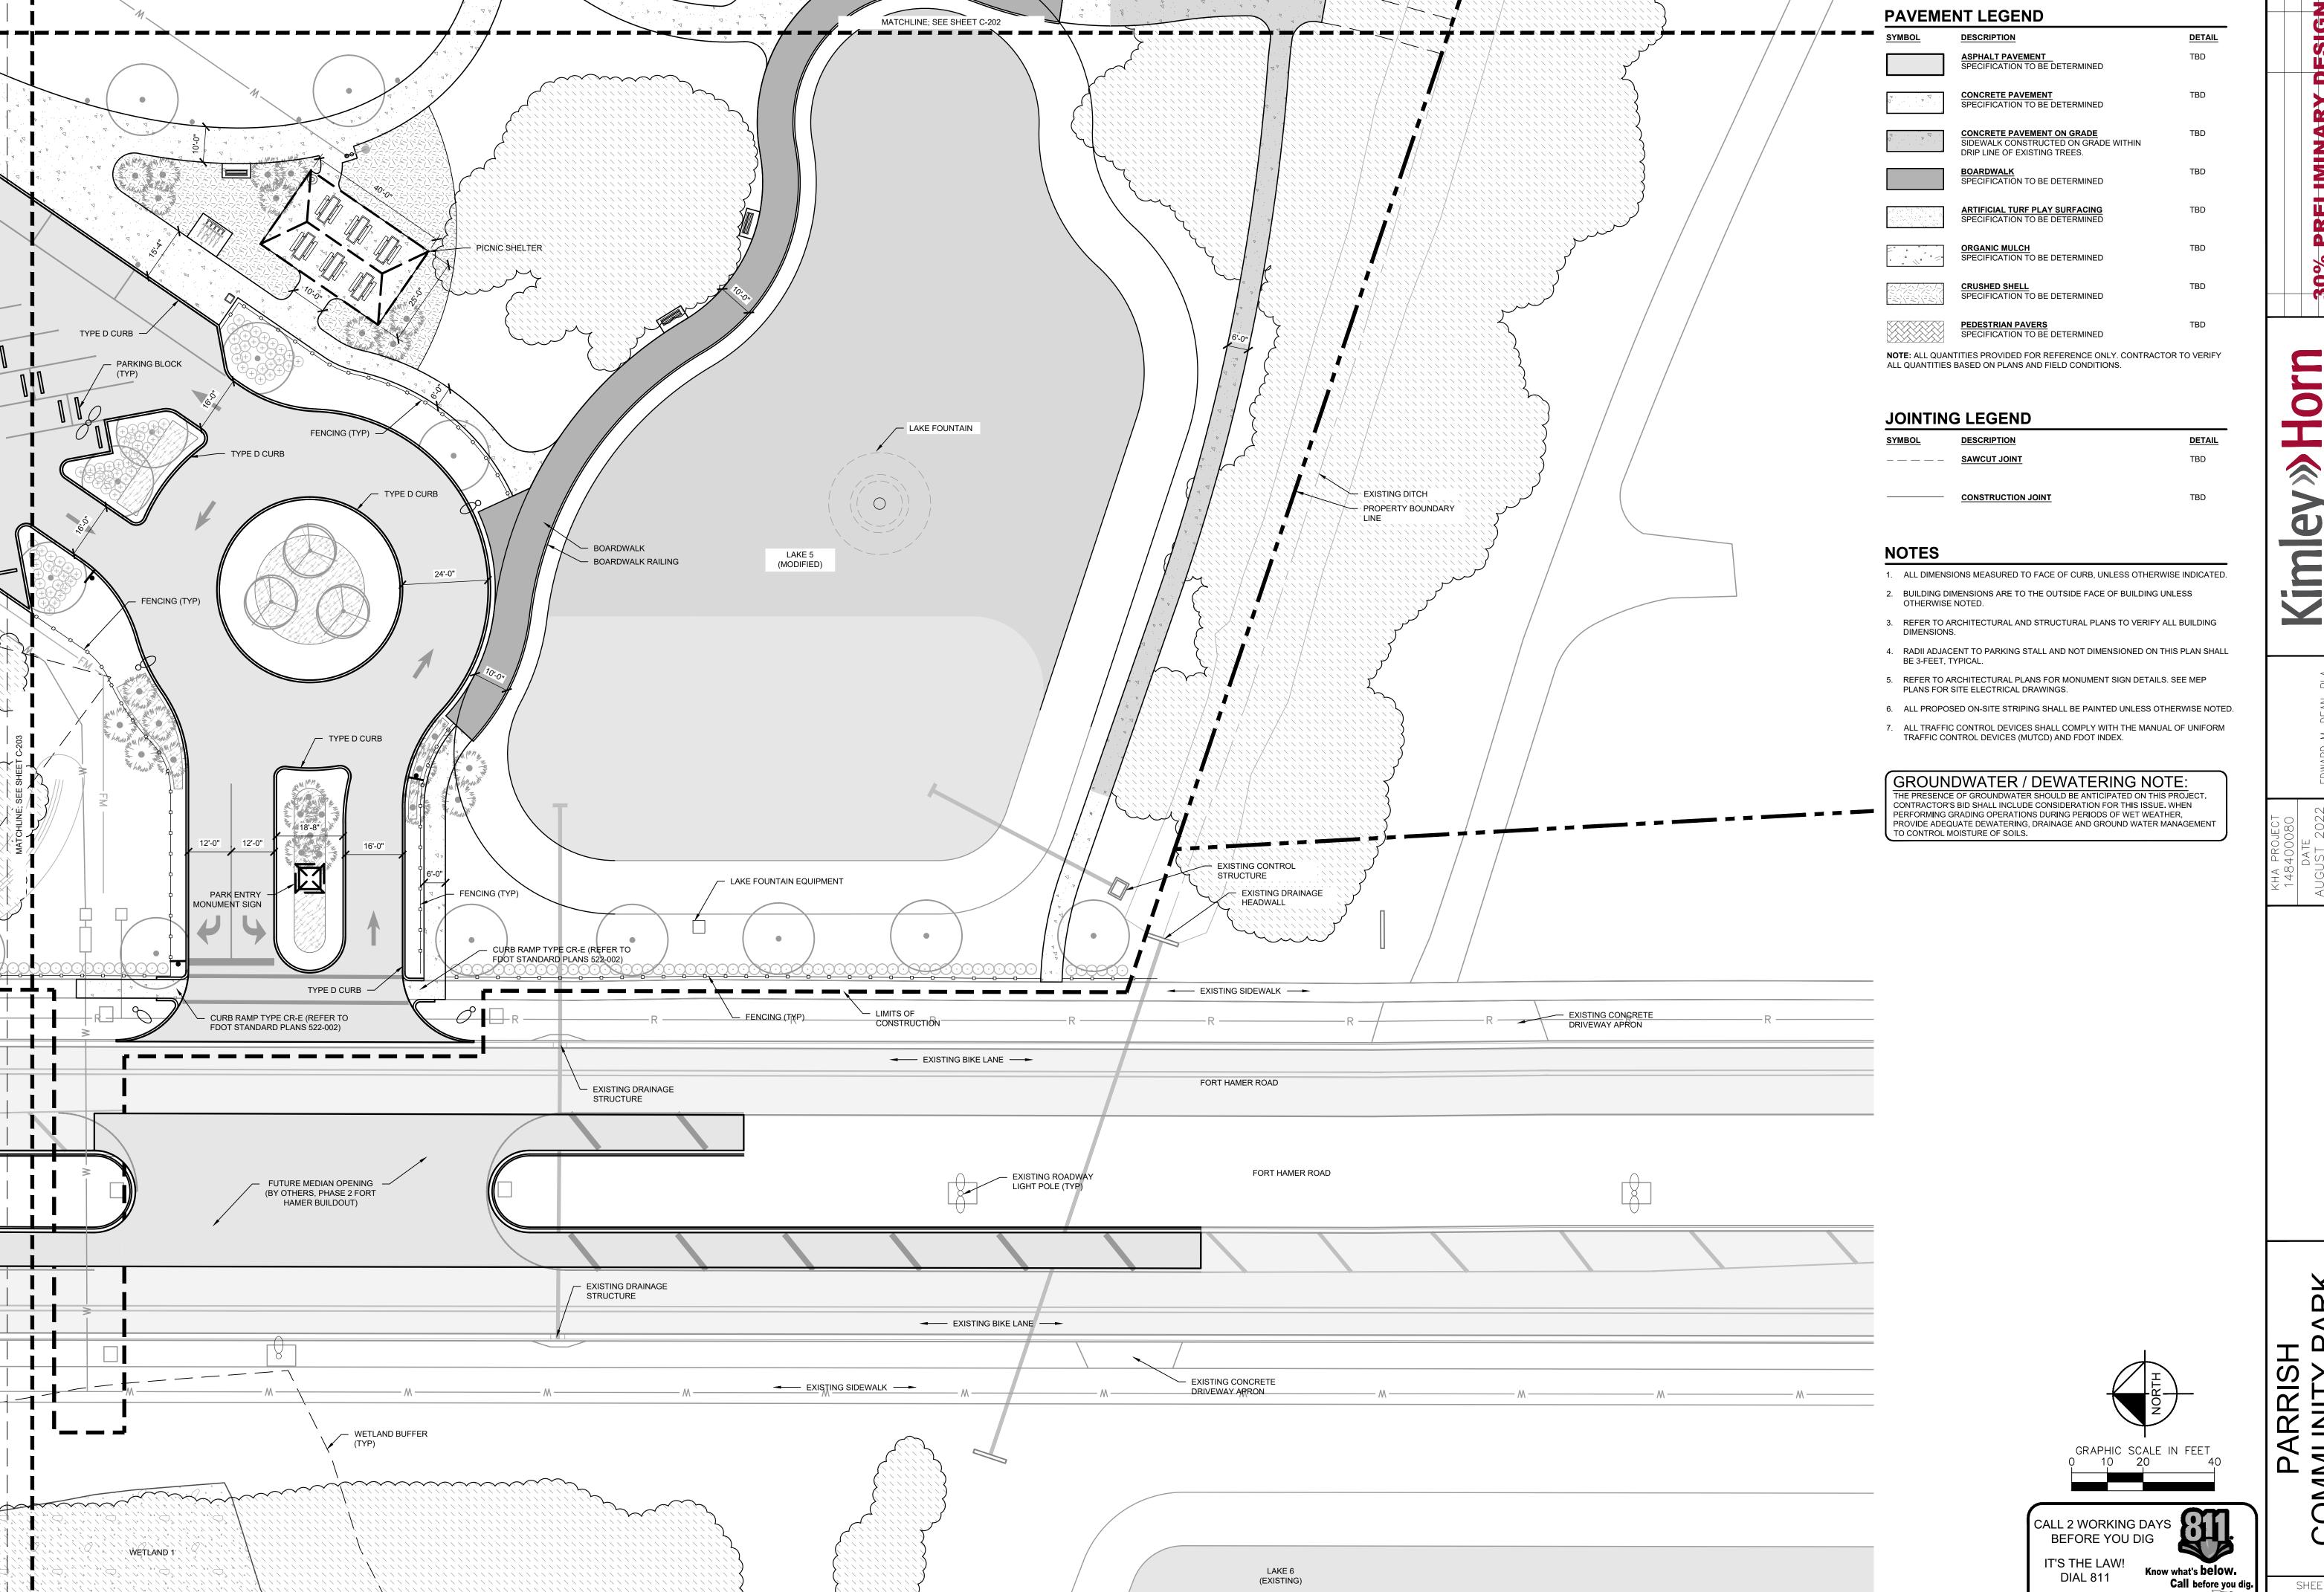


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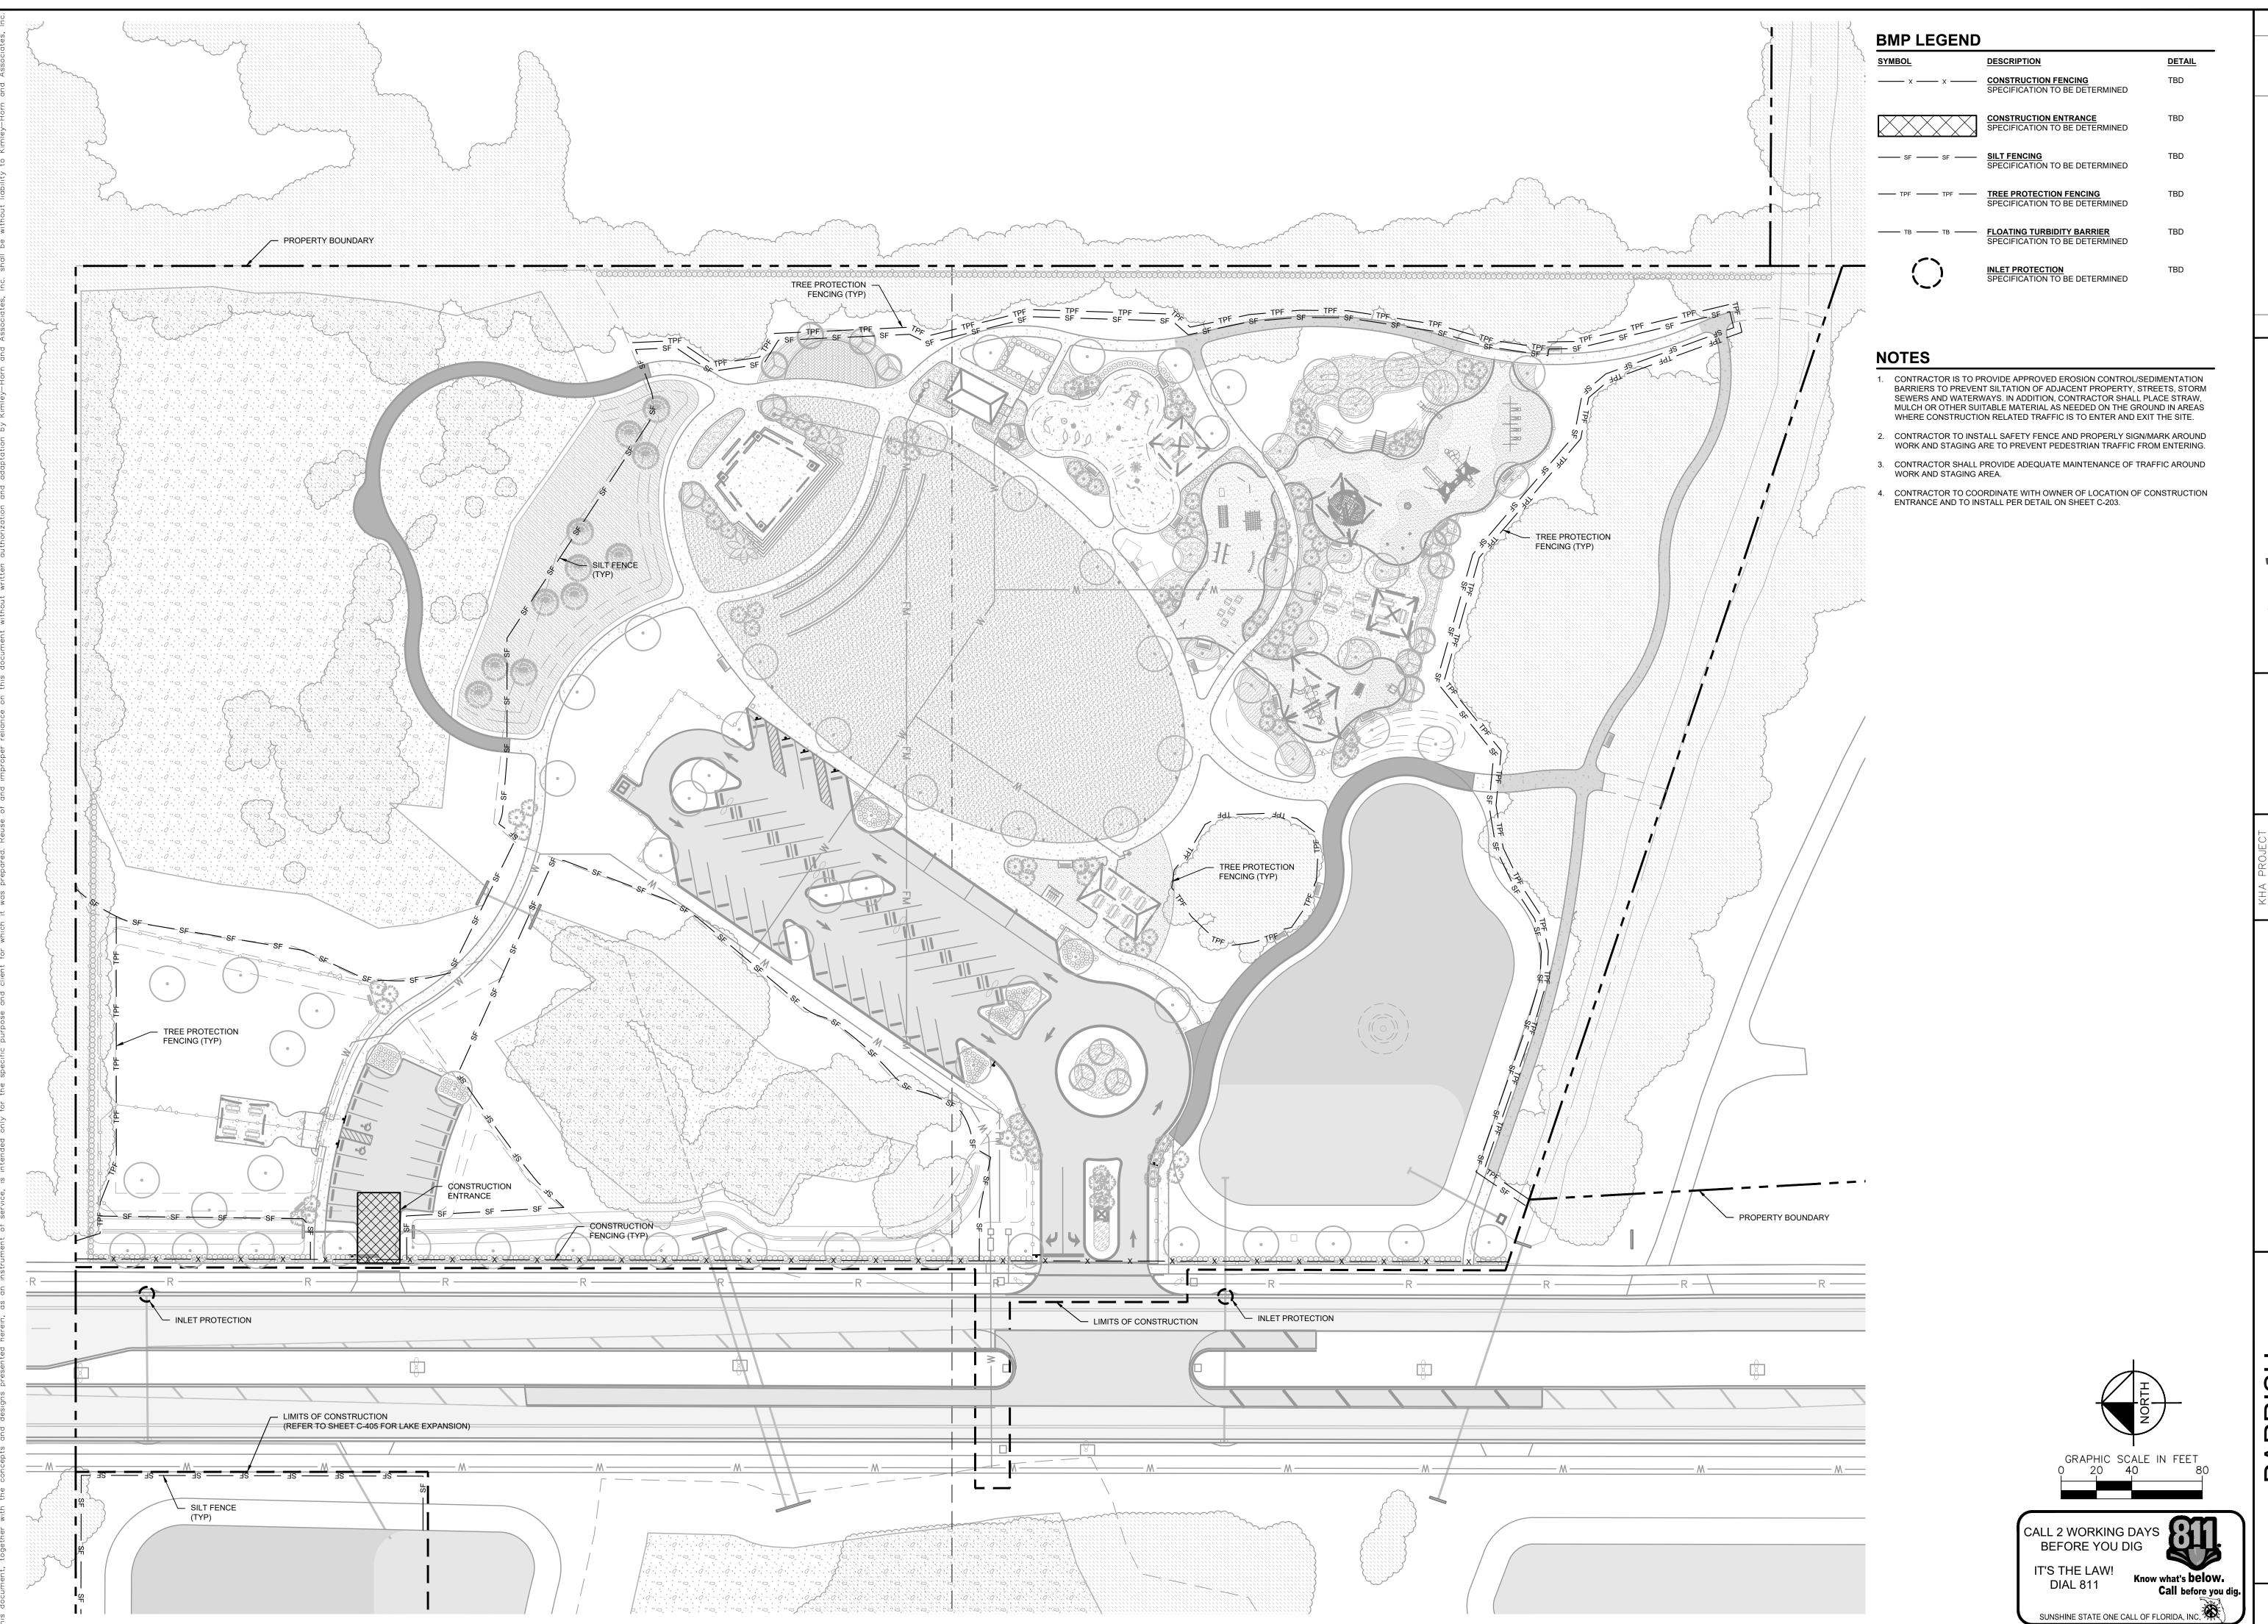

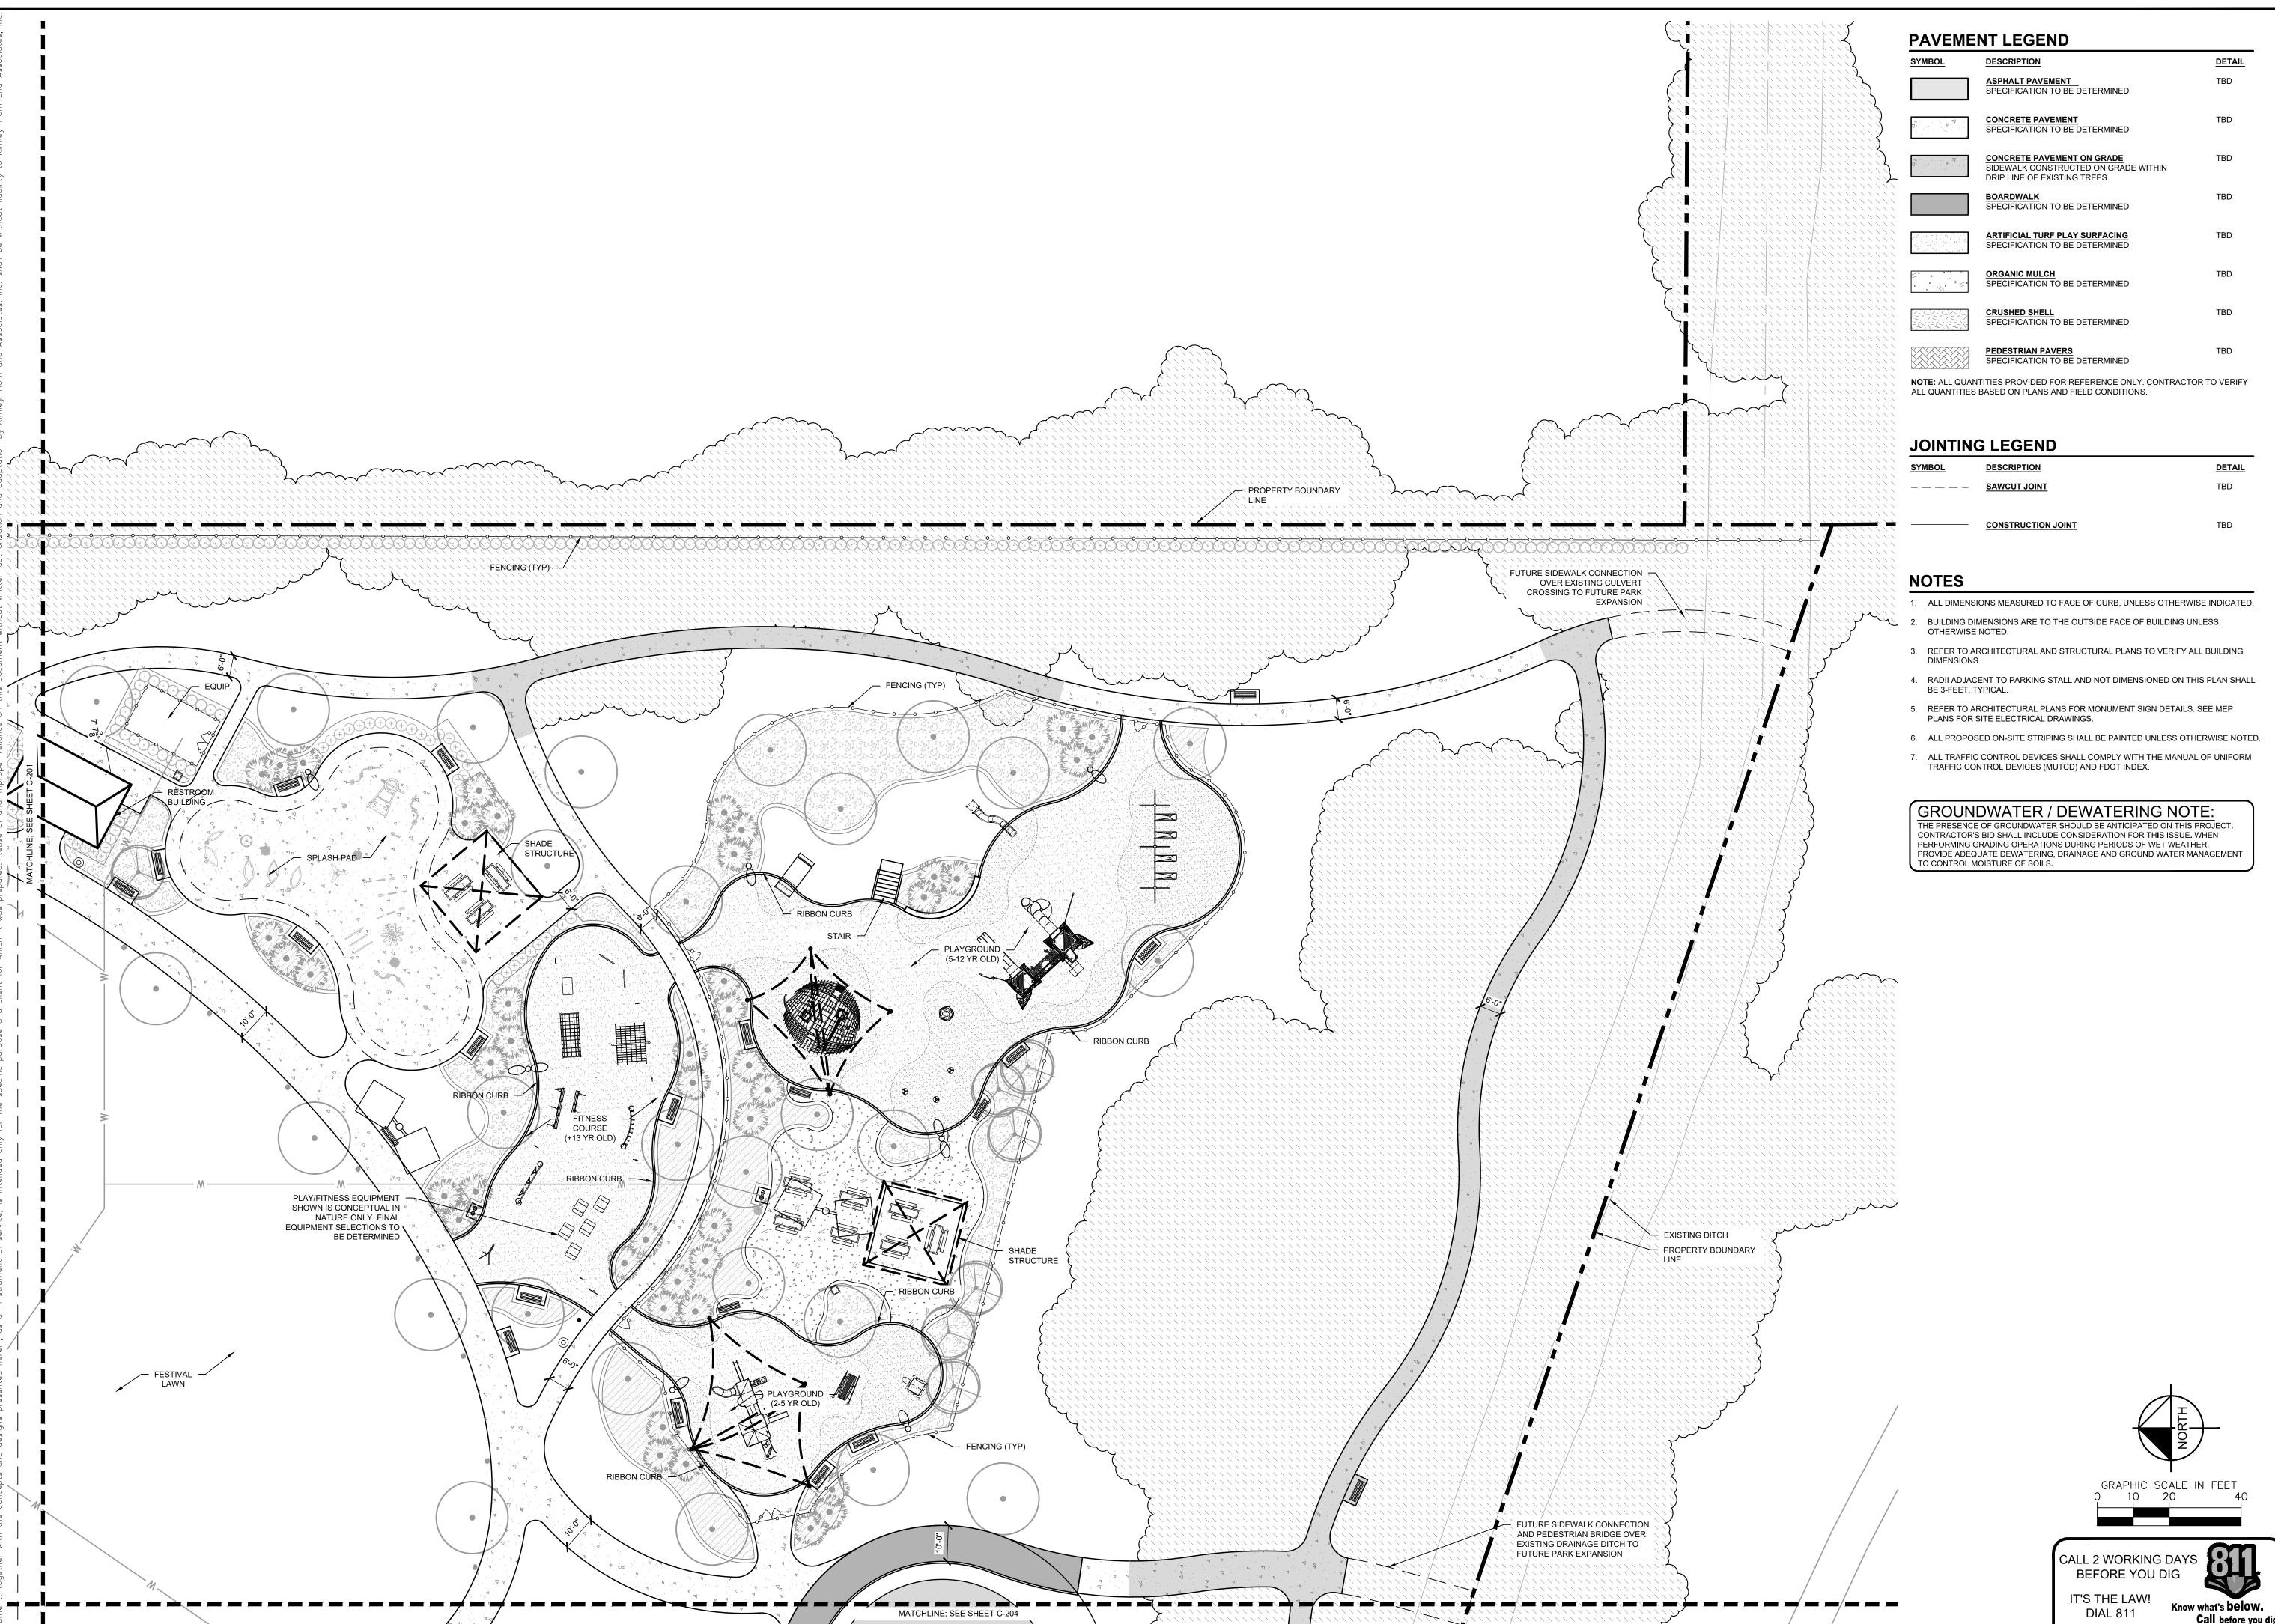
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SHEET NUMBER C-204

SUNSHINE STATE ONE CALL OF FLORIDA, INC.

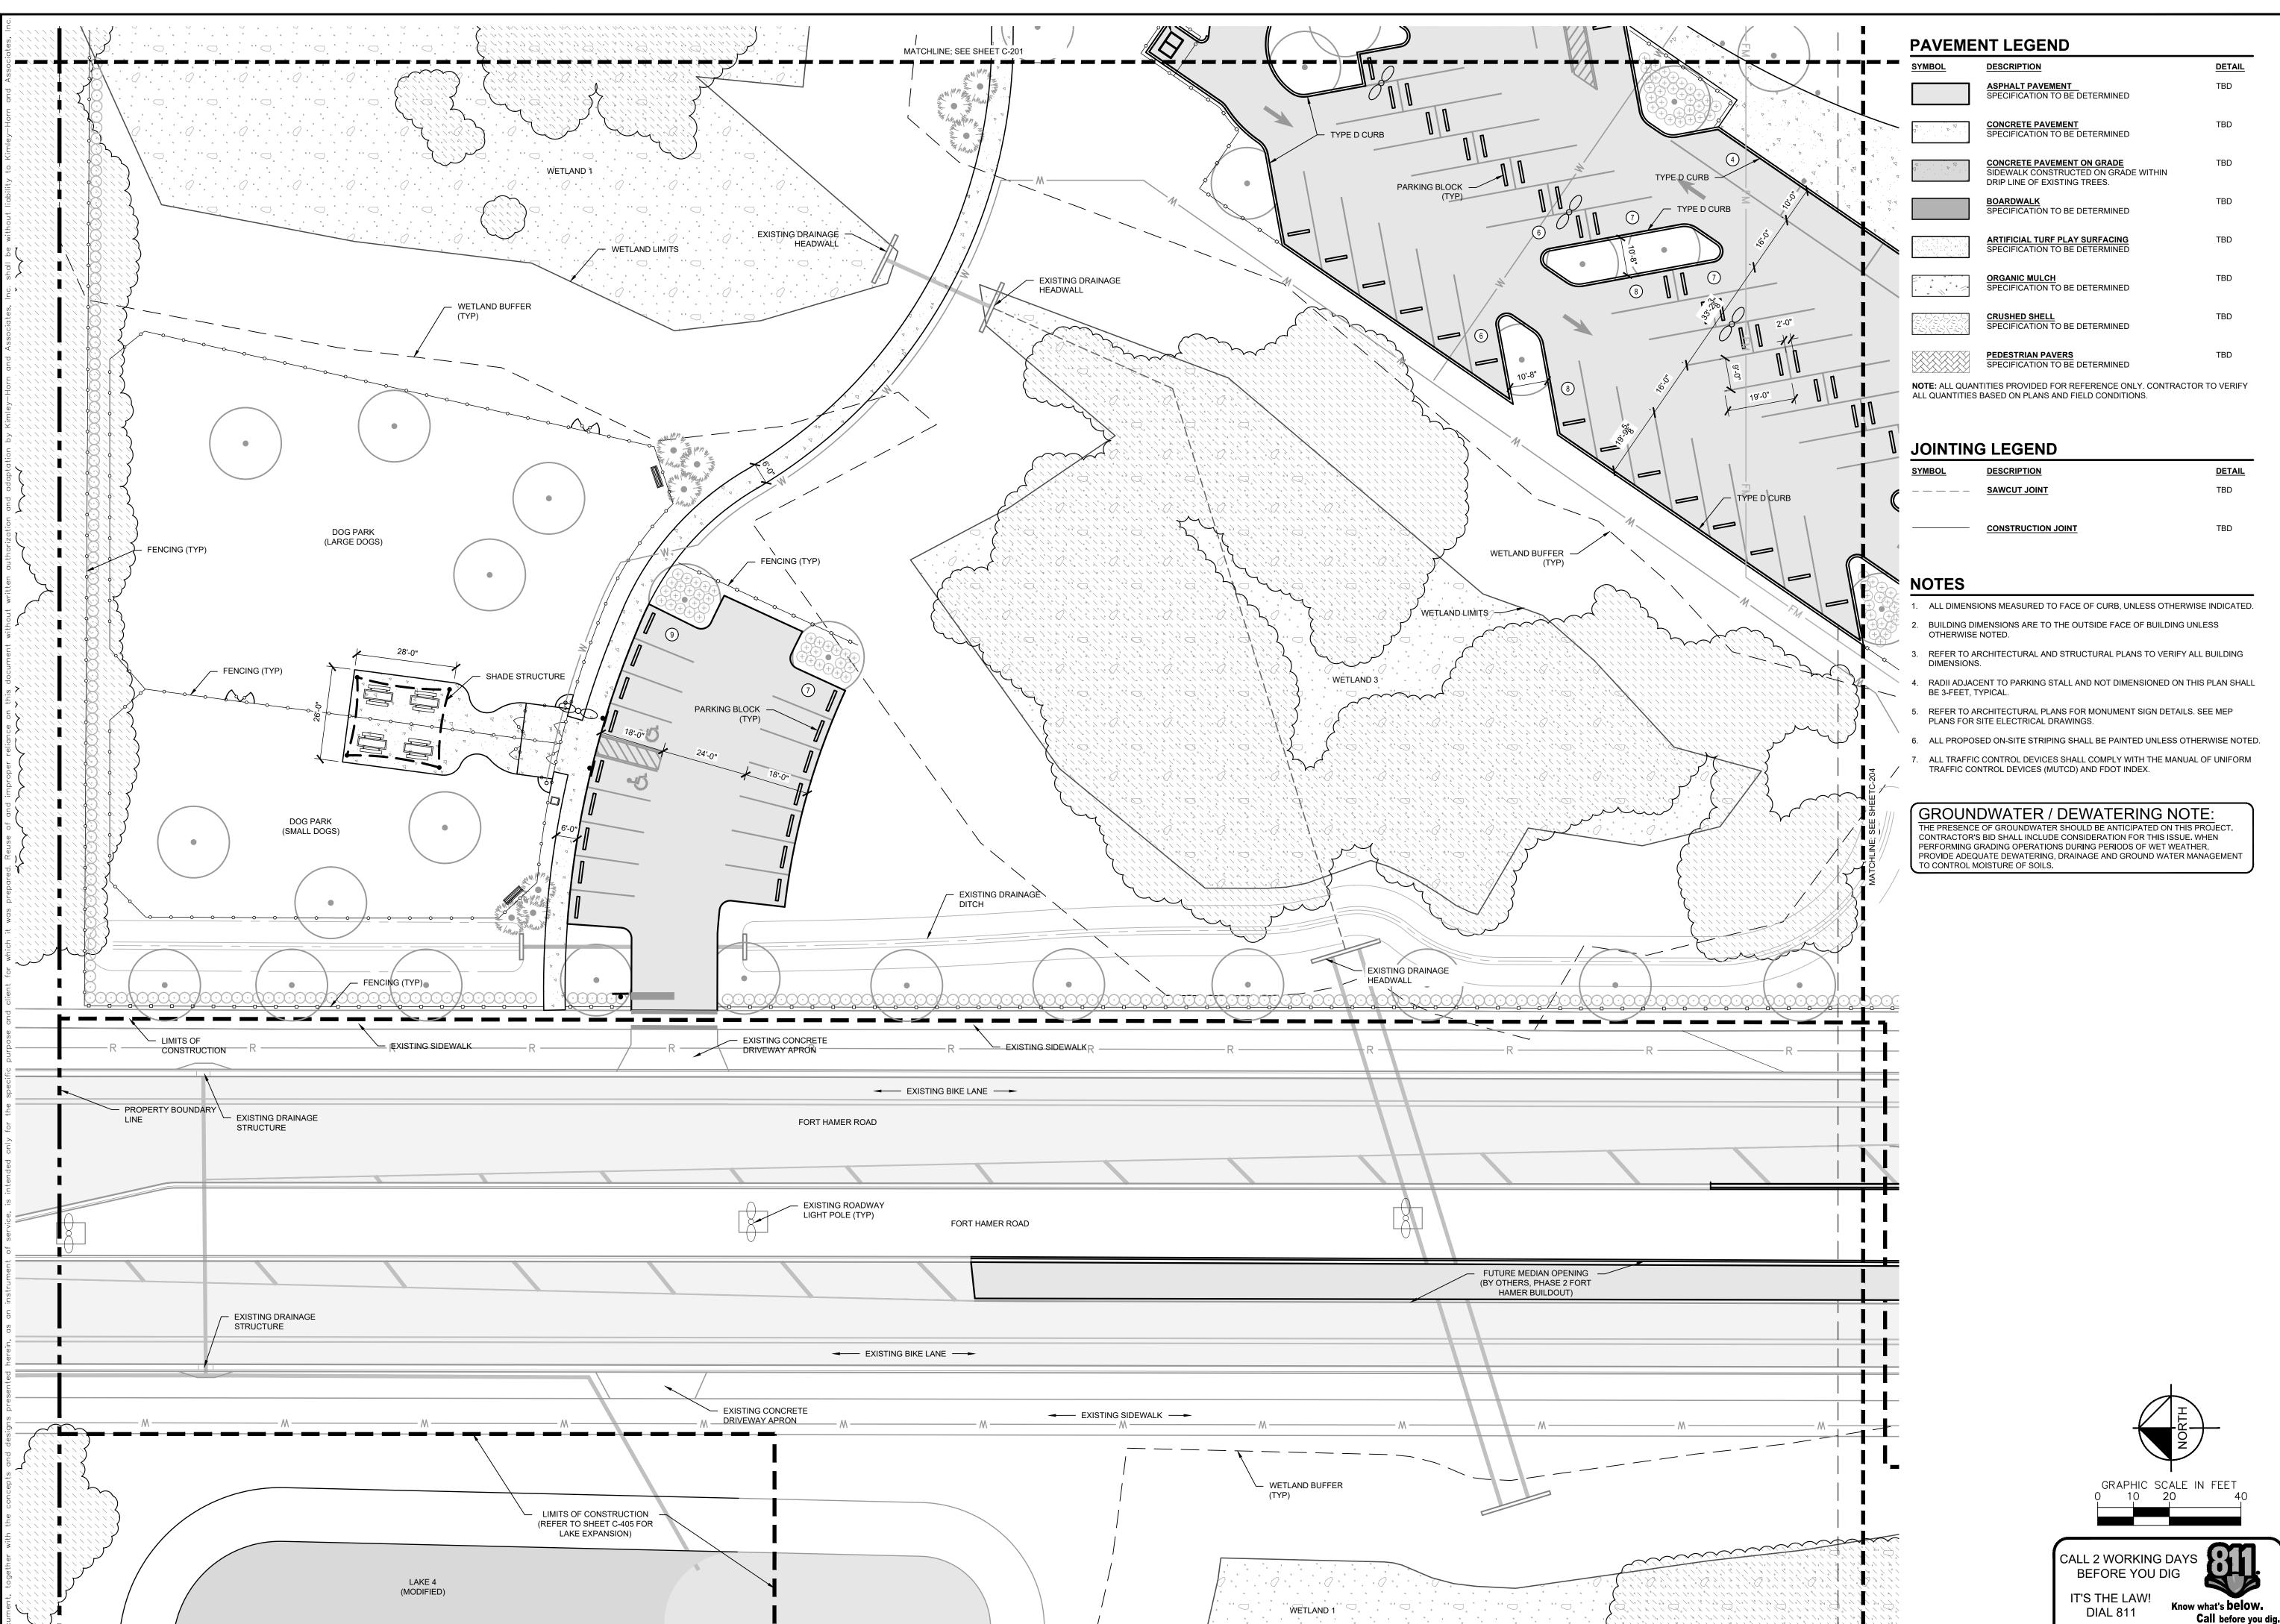

% PRELIMINARY DESIGNOT FOR CONSTRUCTION

HORN AND ASSOCIATES, INC. SUITE 200, SARASOTA, FL 34236 E: 941-379-7600 RN.COM REGISTRY NO. 696

RIDA LICENSE NUMBER
.A 6667269
8/12/2022


SCALE AS SHOWN
DESIGNED BY EMD
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ST MANAGEMENT PRACTICES

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PREPARED FOR
MANATEE COUNT



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BEST MANAGEMENT PRACTICES DETAILS


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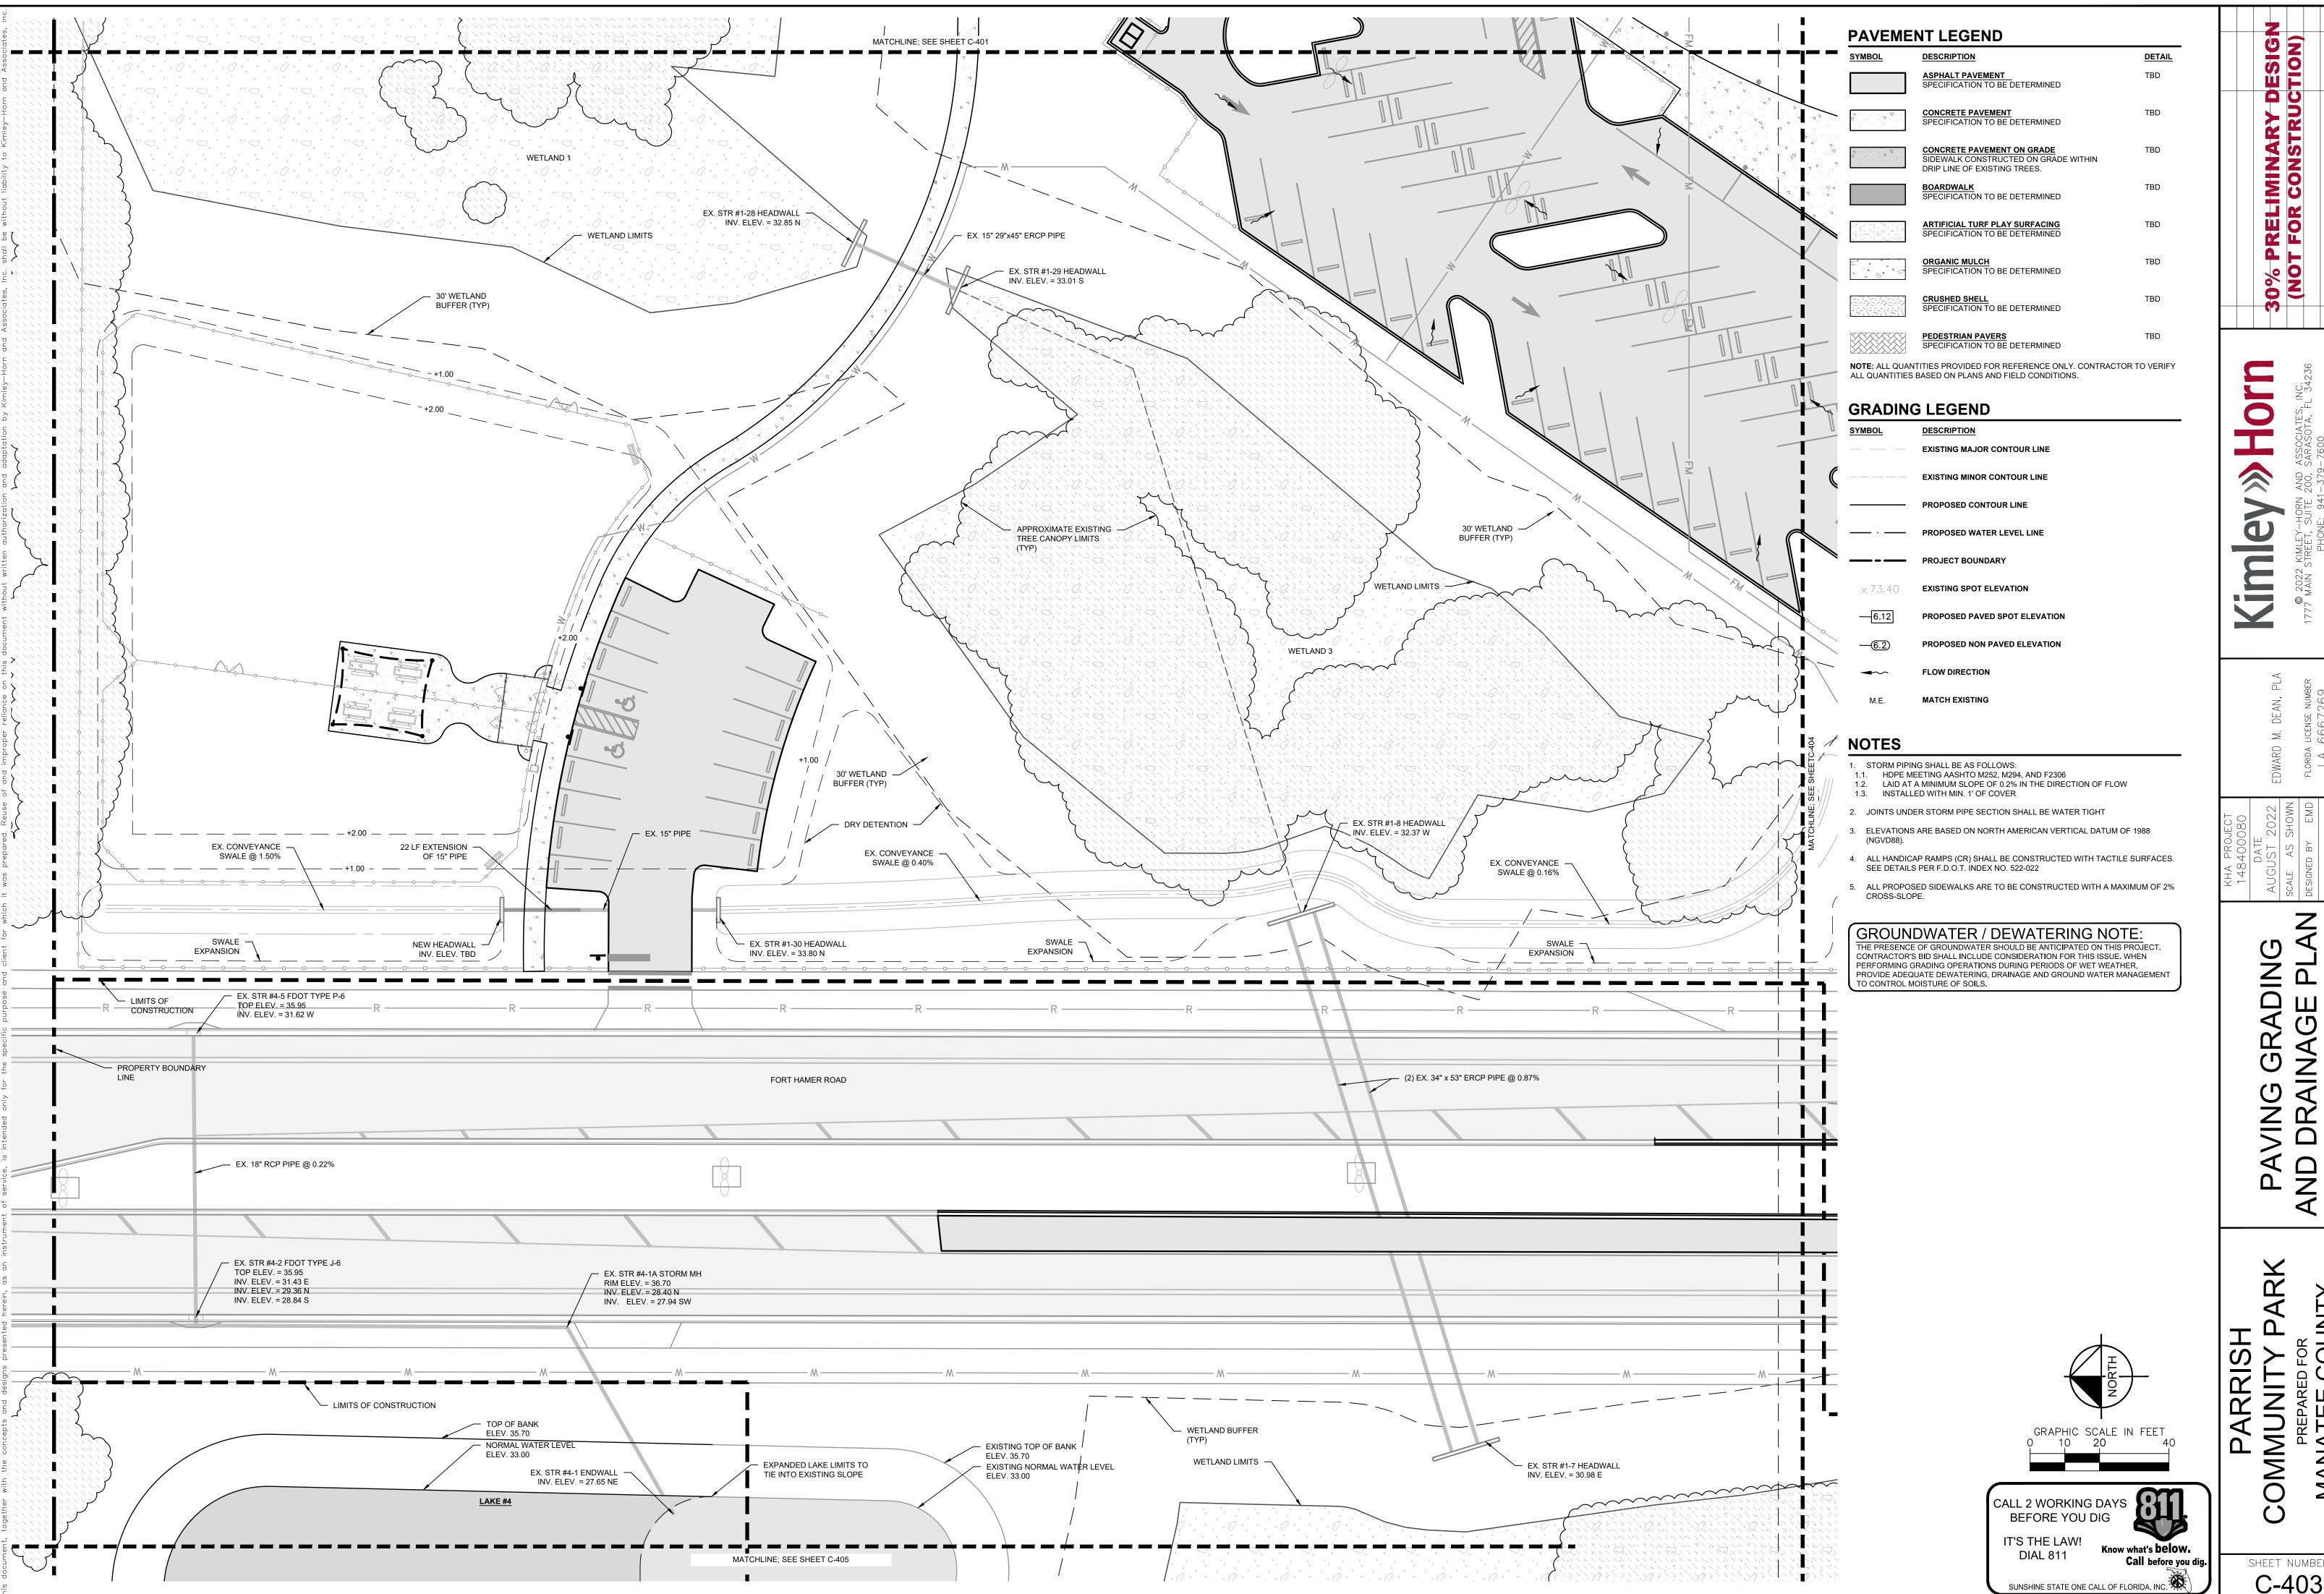
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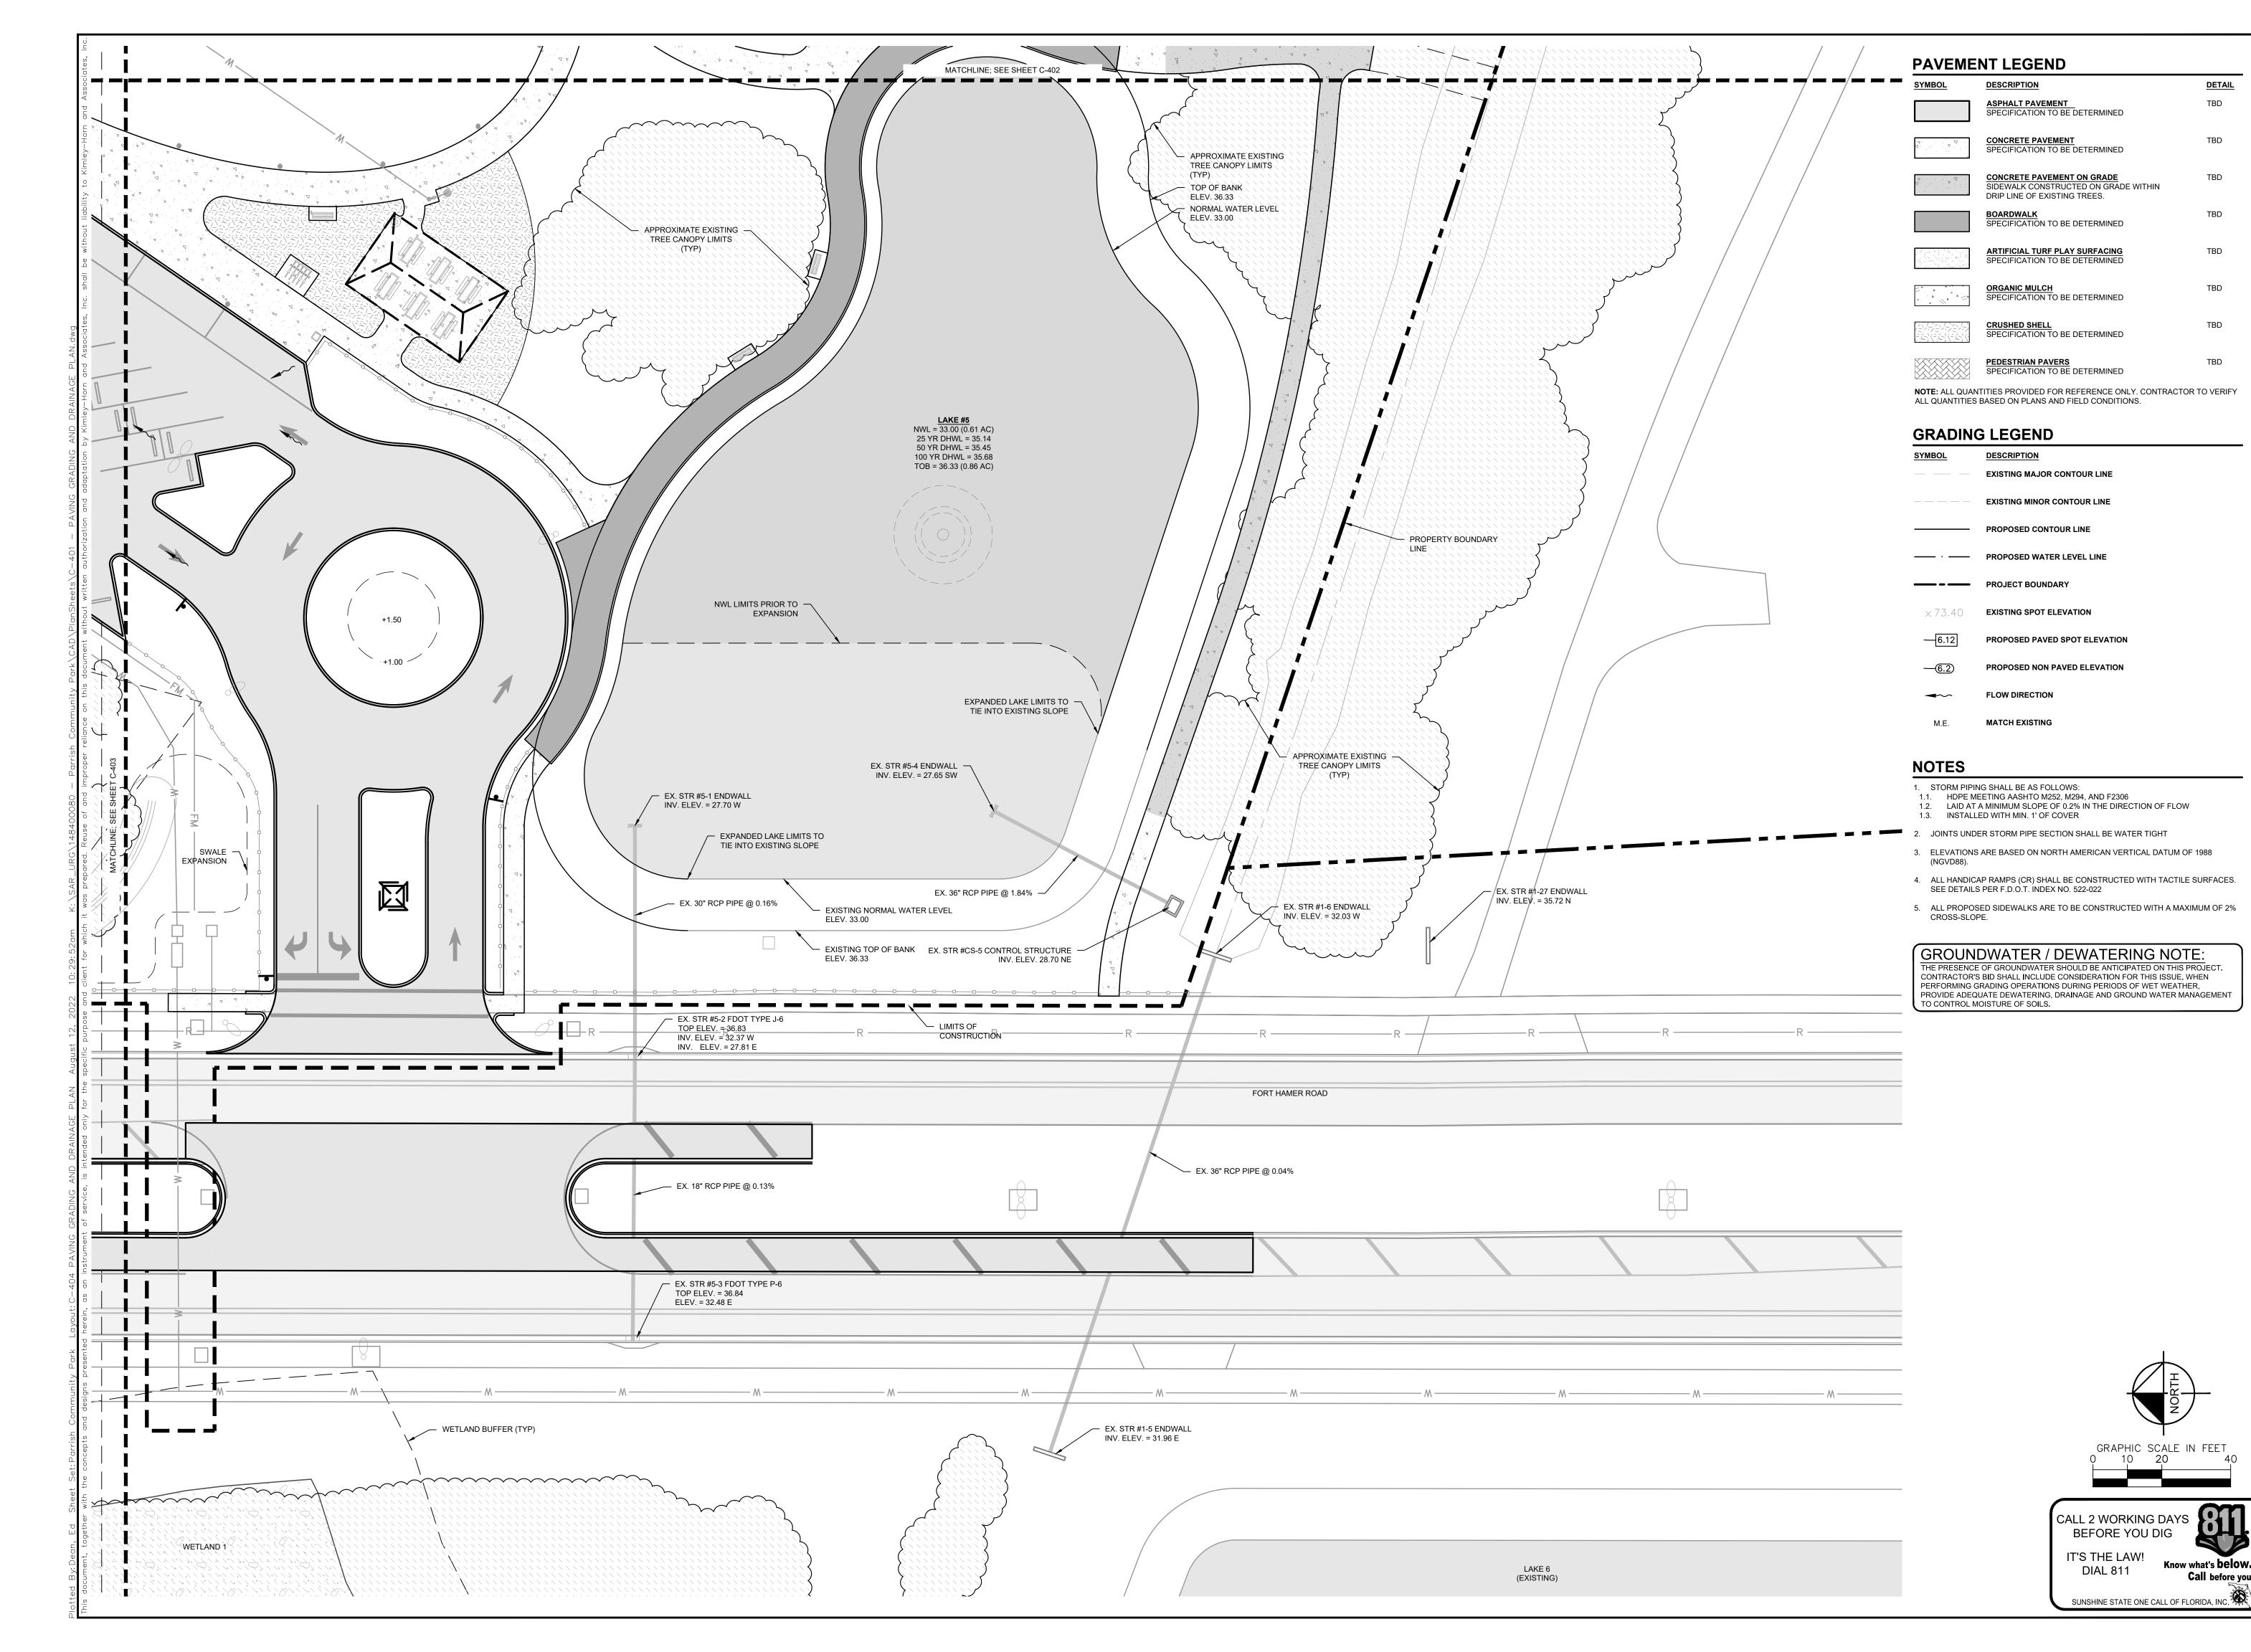
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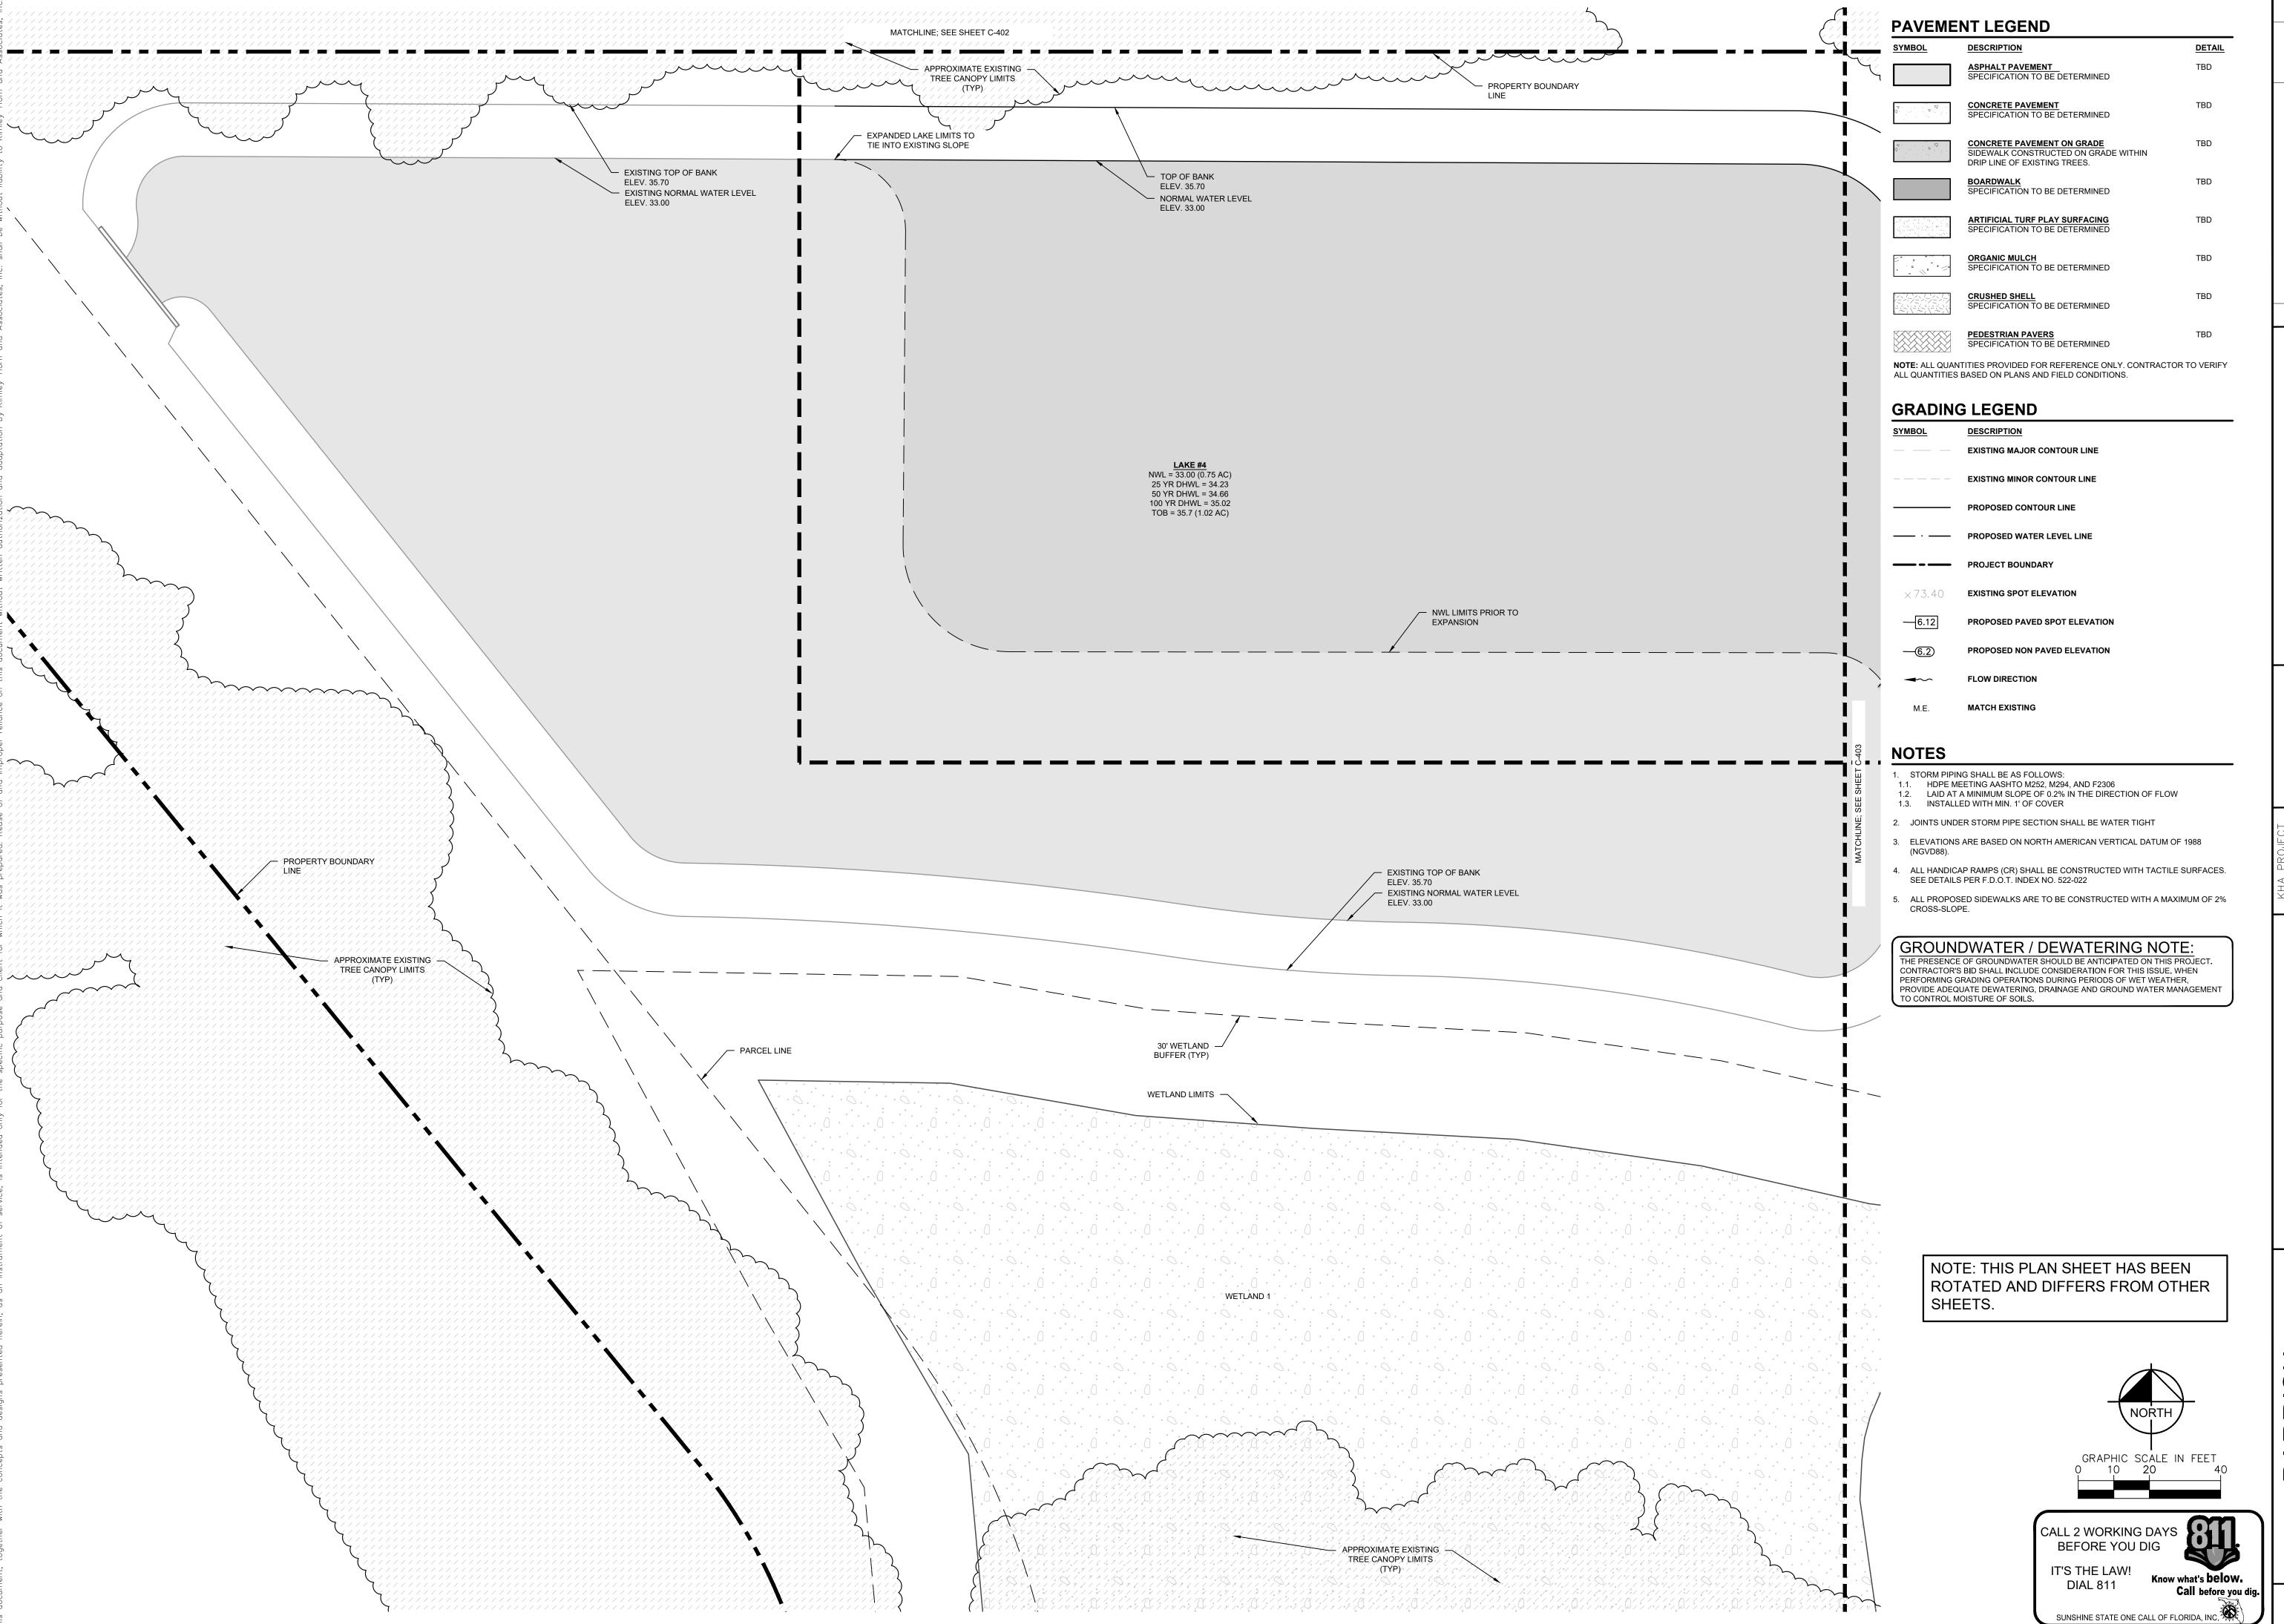
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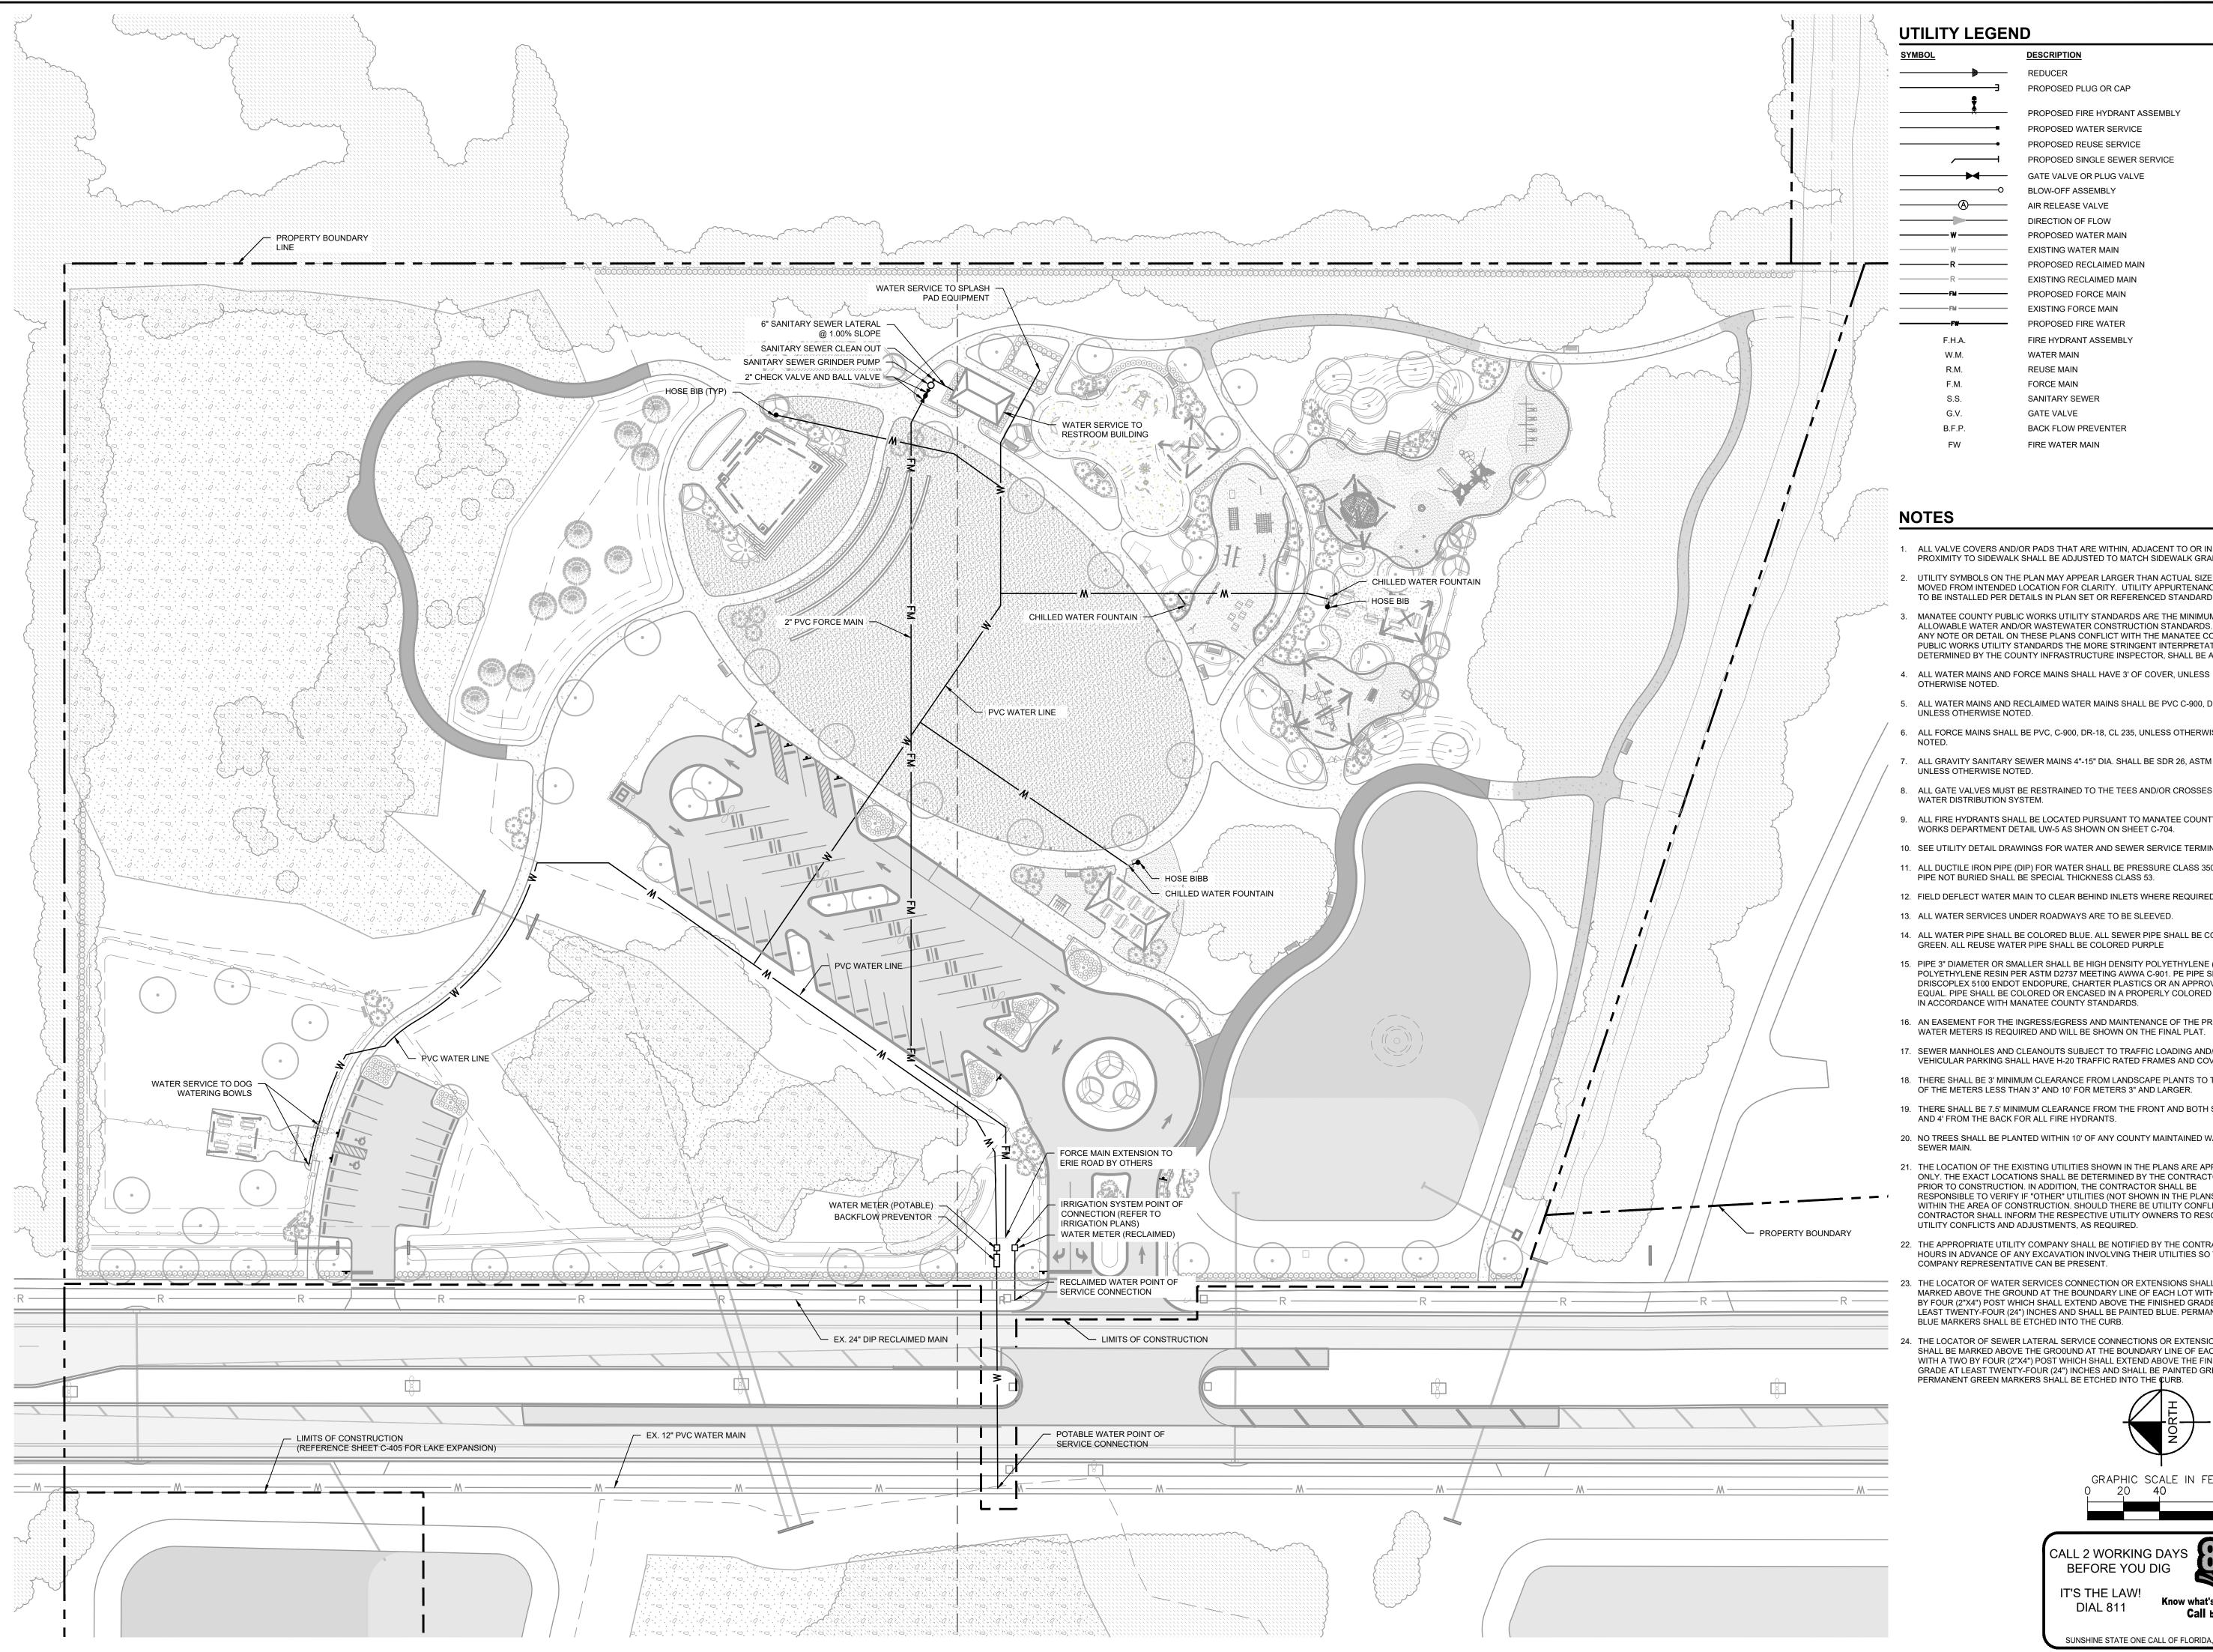
PARRISH LINOMMO
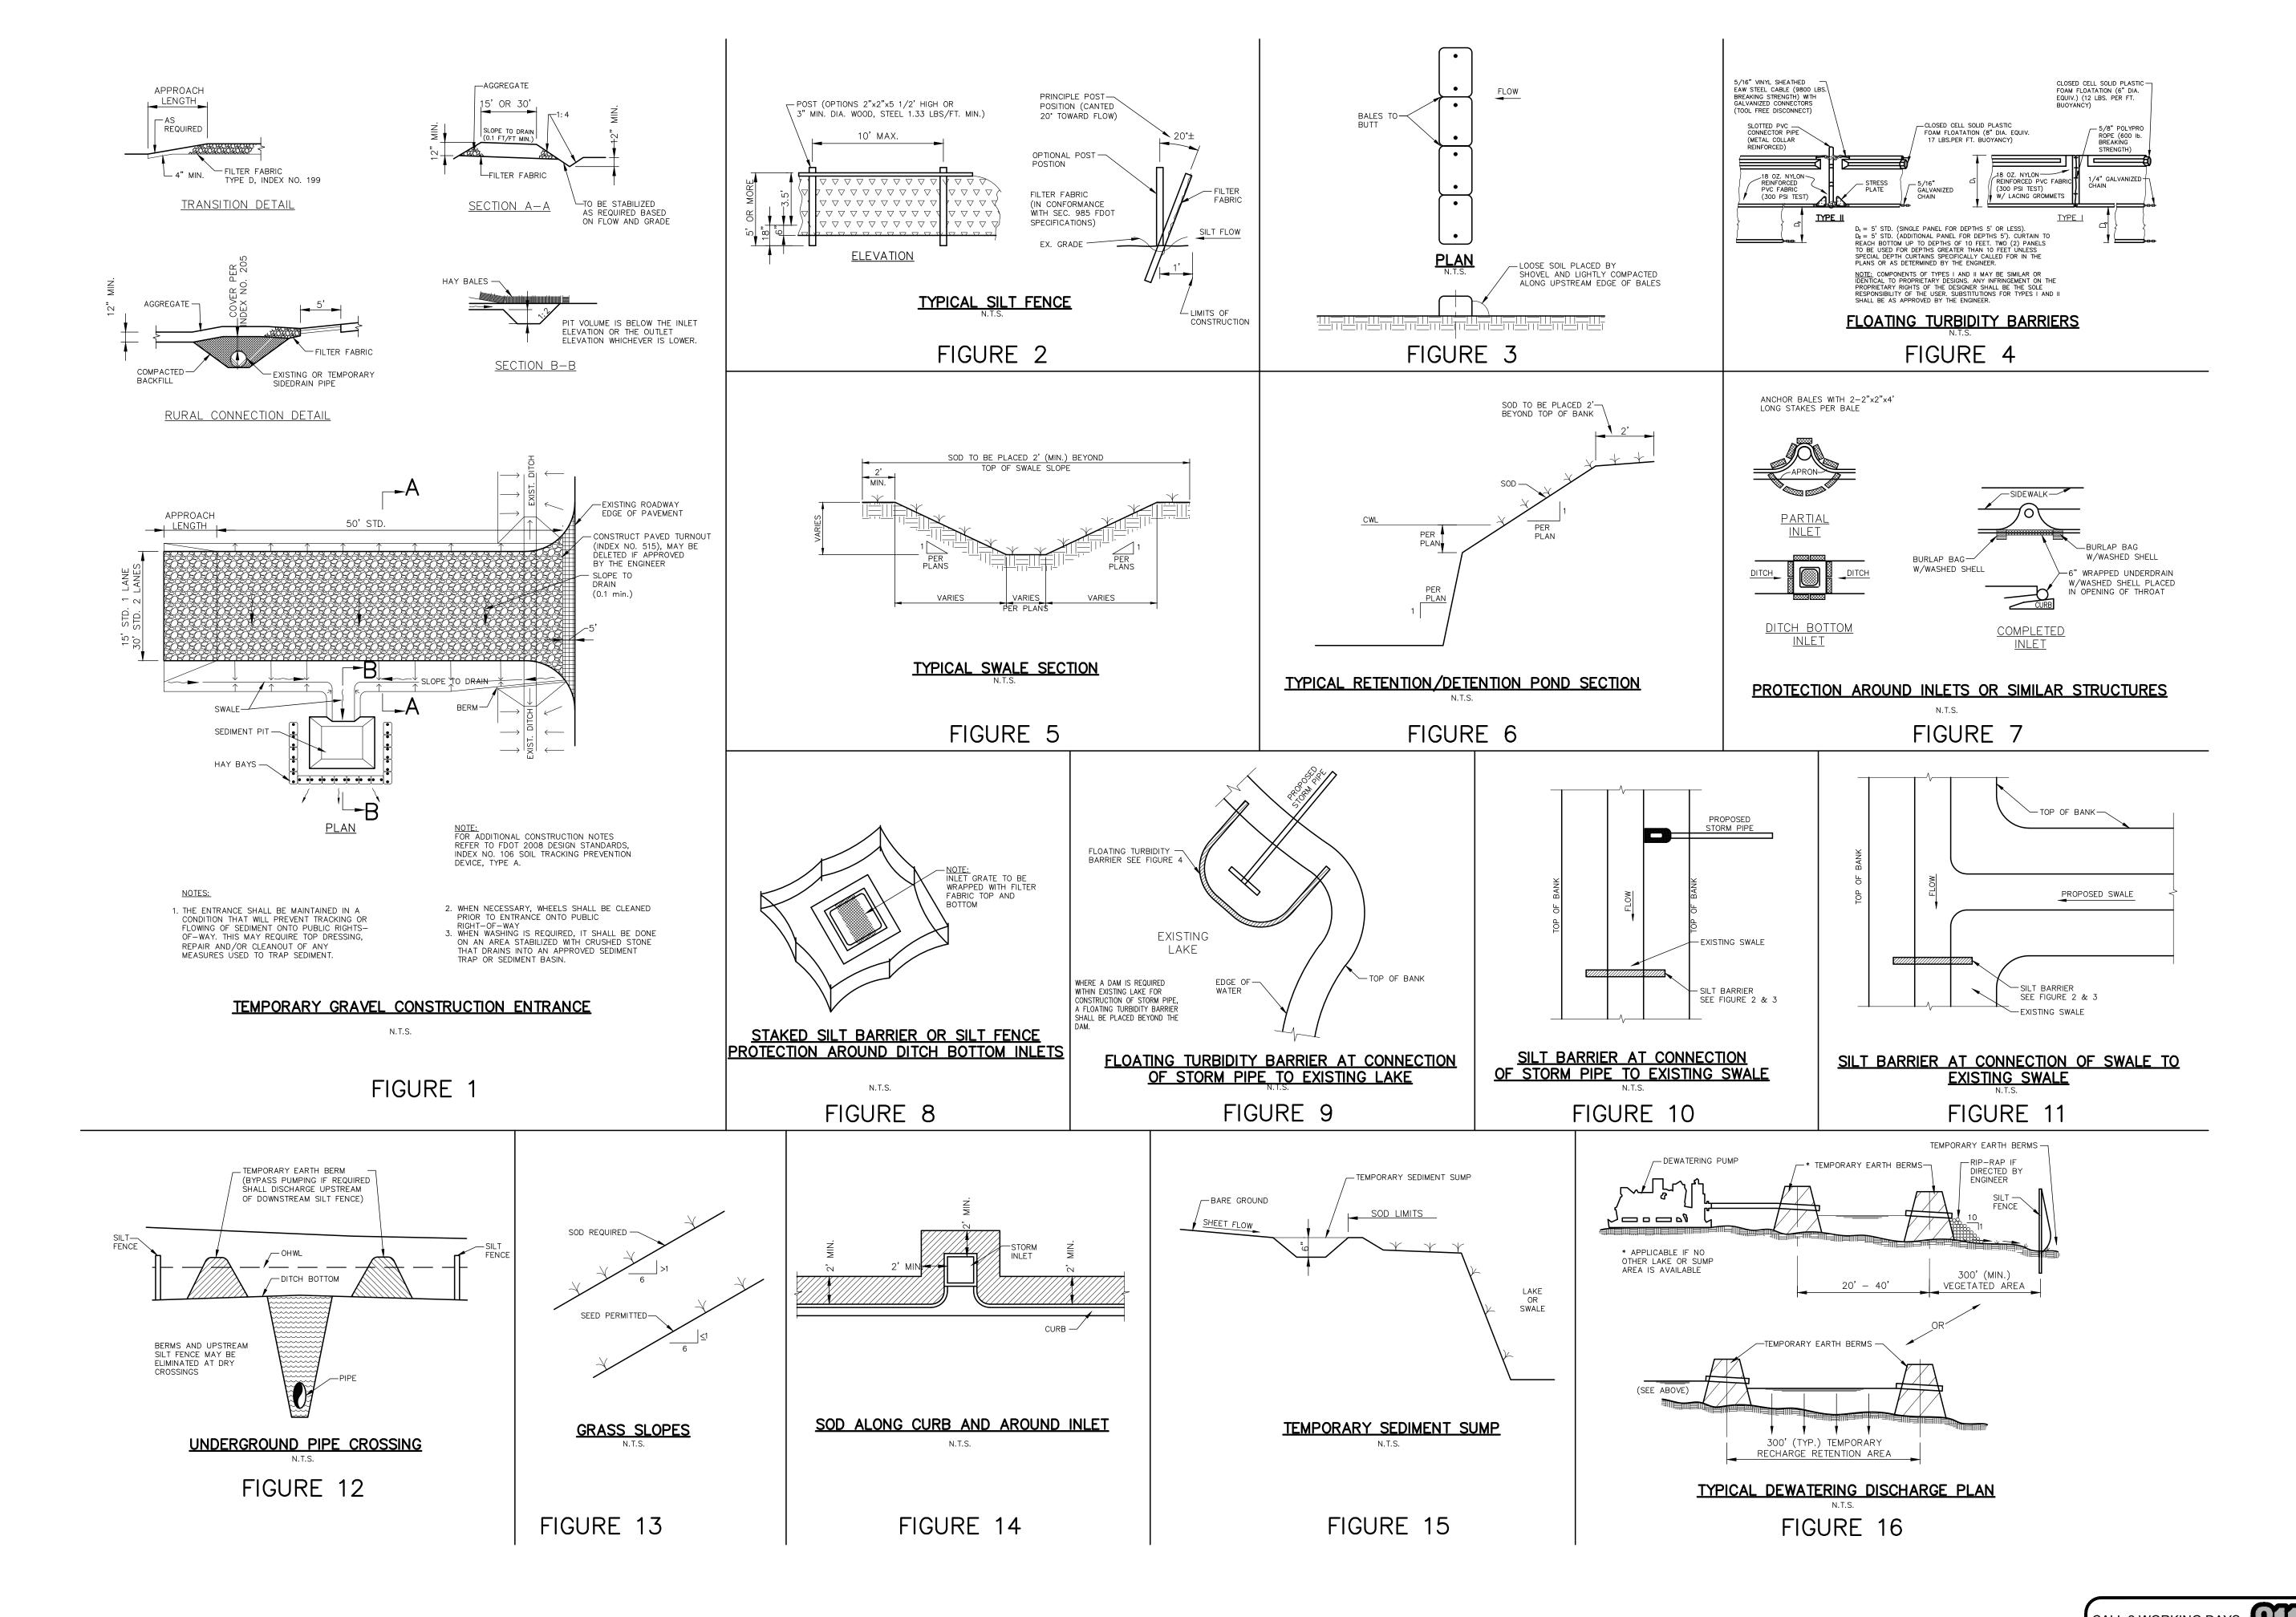
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PAVING GRADING AND DRAINAGE PLA

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DESCRIPTION REDUCER PROPOSED PLUG OR CAP

PROPOSED FIRE HYDRANT ASSEMBLY PROPOSED WATER SERVICE PROPOSED REUSE SERVICE

PROPOSED SINGLE SEWER SERVICE GATE VALVE OR PLUG VALVE

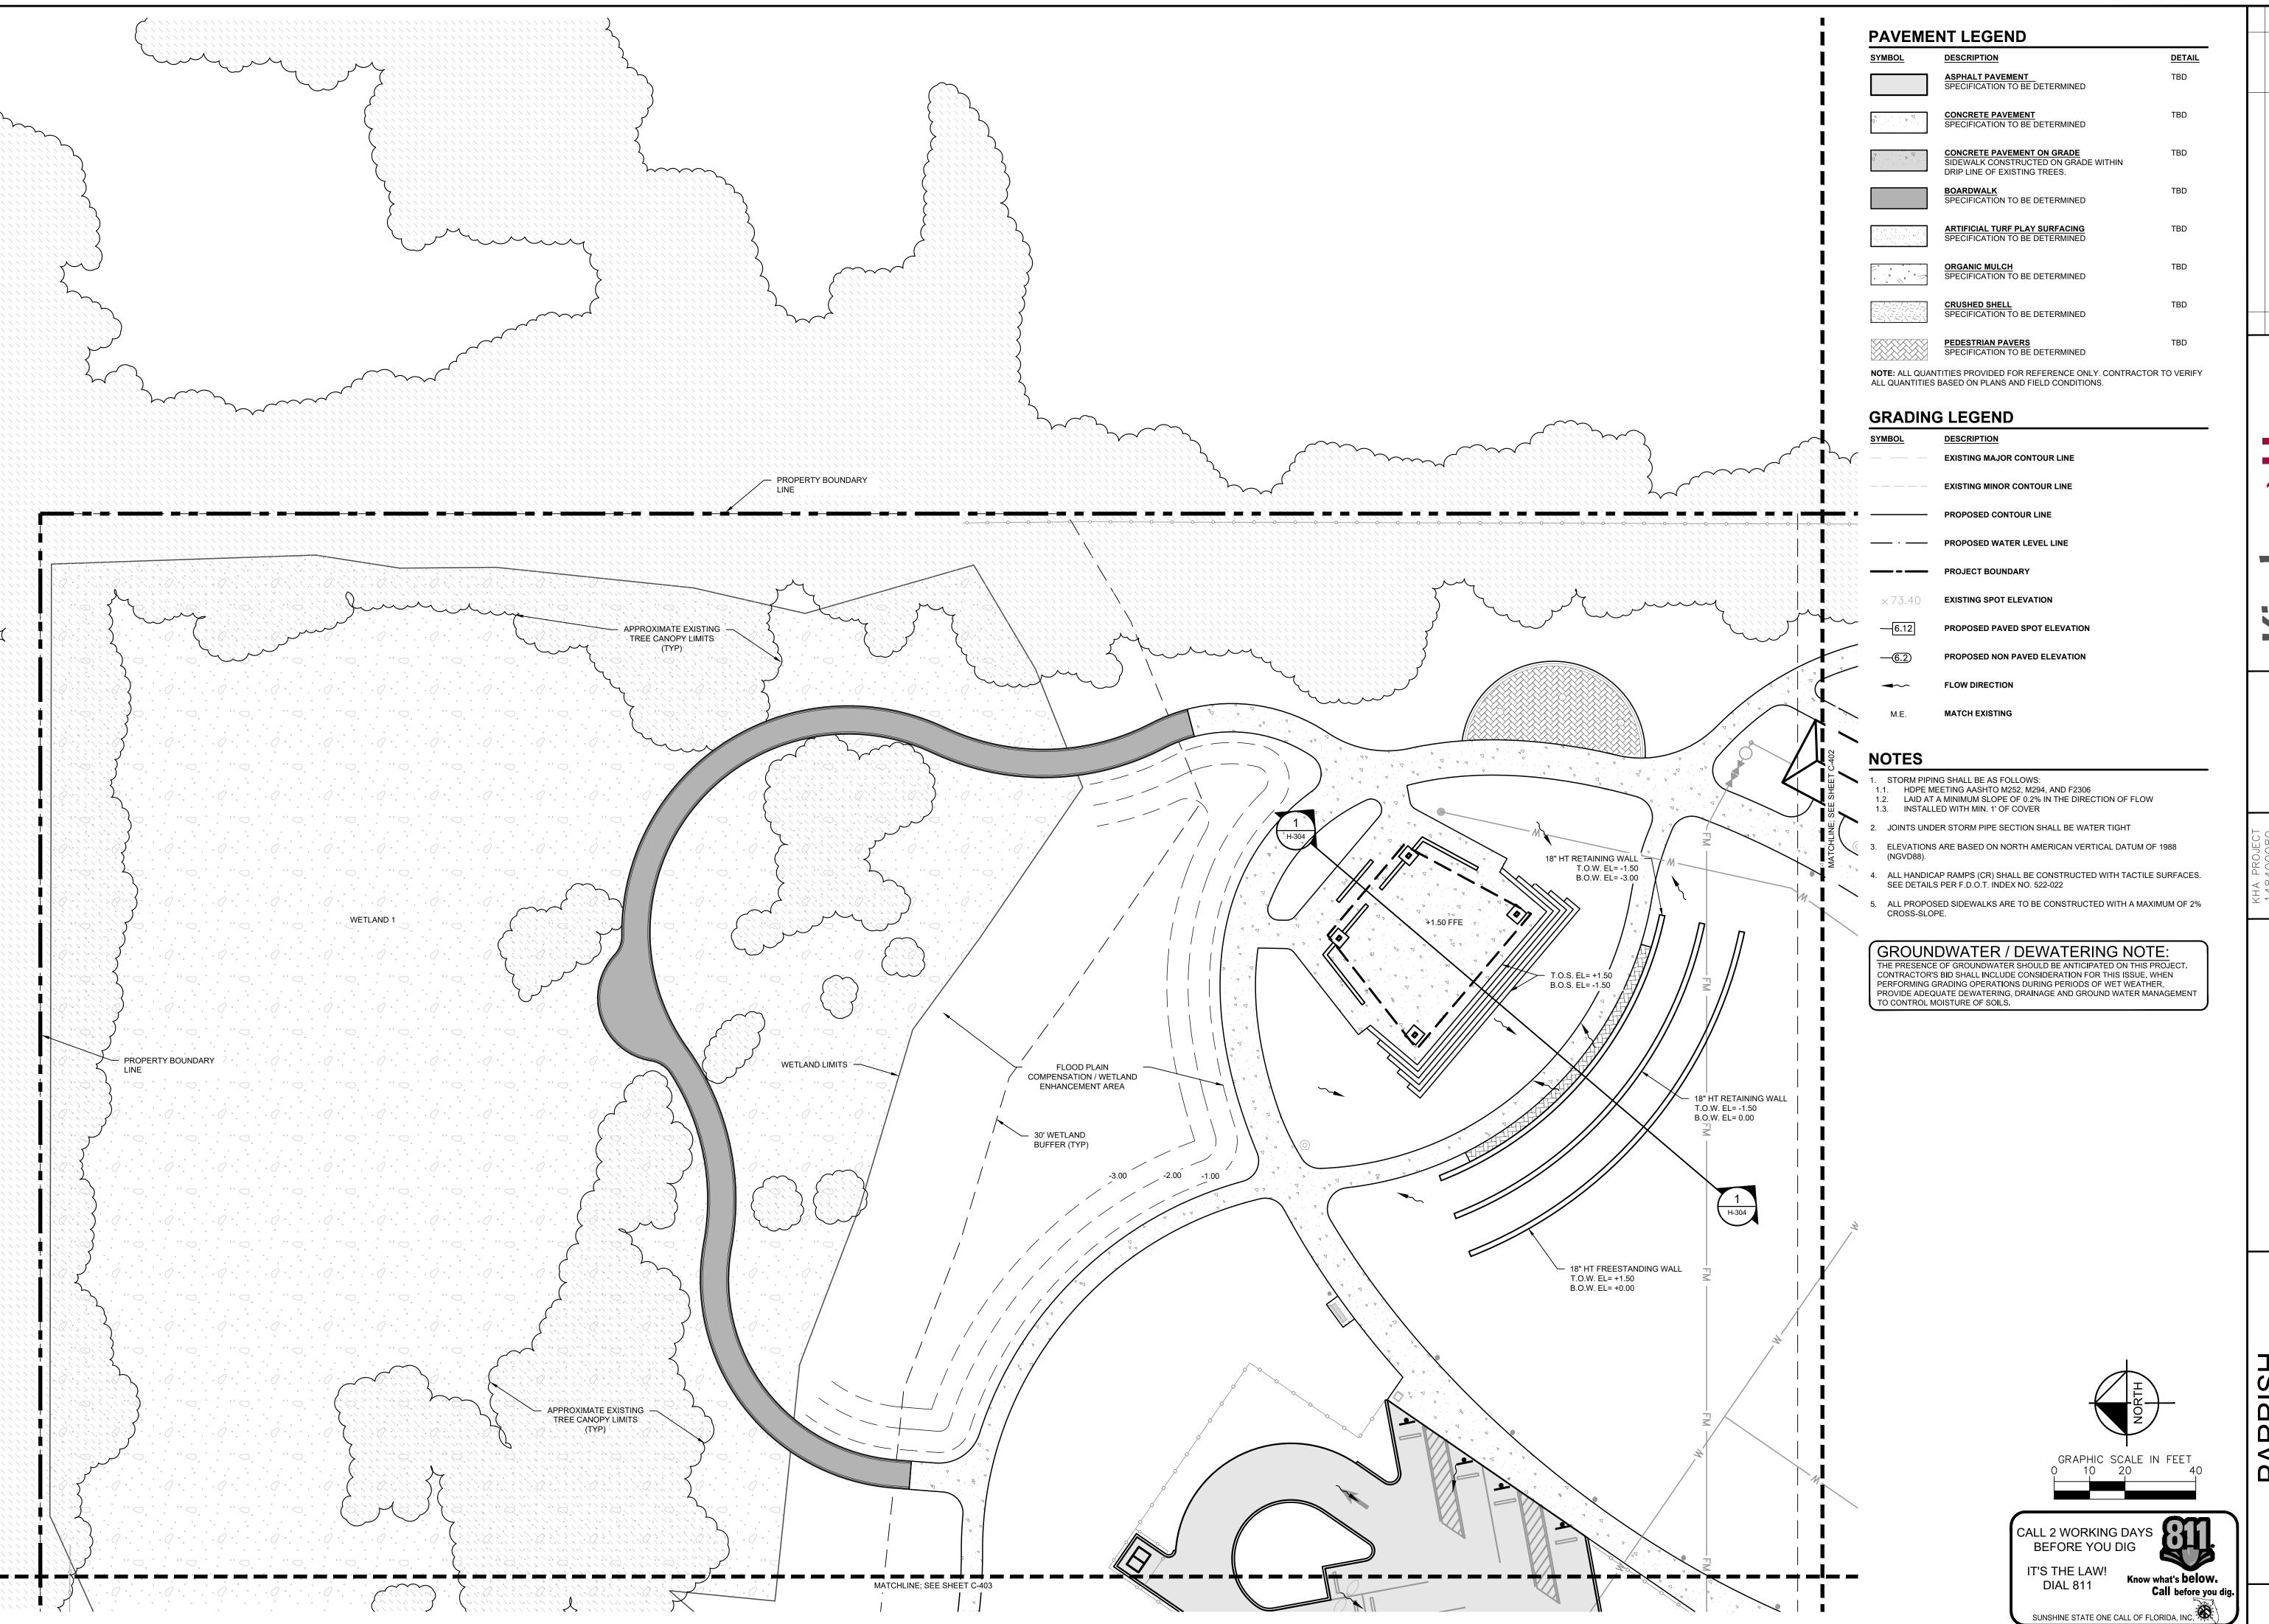AIR RELEASE VALVE


DIRECTION OF FLOW PROPOSED WATER MAIN EXISTING WATER MAIN PROPOSED RECLAIMED MAIN EXISTING RECLAIMED MAIN

PROPOSED FORCE MAIN EXISTING FORCE MAIN PROPOSED FIRE WATER FIRE HYDRANT ASSEMBLY WATER MAIN

REUSE MAIN FORCE MAIN SANITARY SEWER GATE VALVE

BACK FLOW PREVENTER FIRE WATER MAIN

- 1. ALL VALVE COVERS AND/OR PADS THAT ARE WITHIN, ADJACENT TO OR IN CLOSE PROXIMITY TO SIDEWALK SHALL BE ADJUSTED TO MATCH SIDEWALK GRADES.
- 2. UTILITY SYMBOLS ON THE PLAN MAY APPEAR LARGER THAN ACTUAL SIZE OR MOVED FROM INTENDED LOCATION FOR CLARITY. UTILITY APPURTENANCES ARE TO BE INSTALLED PER DETAILS IN PLAN SET OR REFERENCED STANDARD DETAILS.
 - MANATEE COUNTY PUBLIC WORKS UTILITY STANDARDS ARE THE MINIMUM ALLOWABLE WATER AND/OR WASTEWATER CONSTRUCTION STANDARDS. WHERE ANY NOTE OR DETAIL ON THESE PLANS CONFLICT WITH THE MANATEE COUNTY PUBLIC WORKS UTILITY STANDARDS THE MORE STRINGENT INTERPRETATION, AS DETERMINED BY THE COUNTY INFRASTRUCTURE INSPECTOR, SHALL BE APPLIED.
- 5. ALL WATER MAINS AND RECLAIMED WATER MAINS SHALL BE PVC C-900, DR-18
- 6. ALL FORCE MAINS SHALL BE PVC, C-900, DR-18, CL 235, UNLESS OTHERWISE
- 7. ALL GRAVITY SANITARY SEWER MAINS 4"-15" DIA. SHALL BE SDR 26, ASTM D 3034,
- 8. ALL GATE VALVES MUST BE RESTRAINED TO THE TEES AND/OR CROSSES IN THE
- 9. ALL FIRE HYDRANTS SHALL BE LOCATED PURSUANT TO MANATEE COUNTY PUBLIC WORKS DEPARTMENT DETAIL UW-5 AS SHOWN ON SHEET C-704.
- 10. SEE UTILITY DETAIL DRAWINGS FOR WATER AND SEWER SERVICE TERMINATIONS.
- 11. ALL DUCTILE IRON PIPE (DIP) FOR WATER SHALL BE PRESSURE CLASS 350. ALL PIPE NOT BURIED SHALL BE SPECIAL THICKNESS CLASS 53.
- 12. FIELD DEFLECT WATER MAIN TO CLEAR BEHIND INLETS WHERE REQUIRED.
- 13. ALL WATER SERVICES UNDER ROADWAYS ARE TO BE SLEEVED.
- 14. ALL WATER PIPE SHALL BE COLORED BLUE. ALL SEWER PIPE SHALL BE COLORED GREEN. ALL REUSE WATER PIPE SHALL BE COLORED PURPLE
- 15. PIPE 3" DIAMETER OR SMALLER SHALL BE HIGH DENSITY POLYETHYLENE (PE) 3408 POLYETHYLENE RESIN PER ASTM D2737 MEETING AWWA C-901. PE PIPE SHALL BE DRISCOPLEX 5100 ENDOT ENDOPURE, CHARTER PLASTICS OR AN APPROVED EQUAL. PIPE SHALL BE COLORED OR ENCASED IN A PROPERLY COLORED SLEEVE IN ACCORDANCE WITH MANATEE COUNTY STANDARDS.
- 16. AN EASEMENT FOR THE INGRESS/EGRESS AND MAINTENANCE OF THE PROPOSED WATER METERS IS REQUIRED AND WILL BE SHOWN ON THE FINAL PLAT.
- 17. SEWER MANHOLES AND CLEANOUTS SUBJECT TO TRAFFIC LOADING AND/OR VEHICULAR PARKING SHALL HAVE H-20 TRAFFIC RATED FRAMES AND COVERS.
- 18. THERE SHALL BE 3' MINIMUM CLEARANCE FROM LANDSCAPE PLANTS TO THE EDGE
- 19. THERE SHALL BE 7.5' MINIMUM CLEARANCE FROM THE FRONT AND BOTH SIDES
- 20. NO TREES SHALL BE PLANTED WITHIN 10' OF ANY COUNTY MAINTAINED WATER OR
- 21. THE LOCATION OF THE EXISTING UTILITIES SHOWN IN THE PLANS ARE APPROX. ONLY. THE EXACT LOCATIONS SHALL BE DETERMINED BY THE CONTRACTOR PRIOR TO CONSTRUCTION. IN ADDITION, THE CONTRACTOR SHALL BE RESPONSIBLE TO VERIFY IF "OTHER" UTILITIES (NOT SHOWN IN THE PLANS) EXIST WITHIN THE AREA OF CONSTRUCTION. SHOULD THERE BE UTILITY CONFLICTS, THE CONTRACTOR SHALL INFORM THE RESPECTIVE UTILITY OWNERS TO RESOLVE UTILITY CONFLICTS AND ADJUSTMENTS, AS REQUIRED.
- 22. THE APPROPRIATE UTILITY COMPANY SHALL BE NOTIFIED BY THE CONTRACTOR 48 HOURS IN ADVANCE OF ANY EXCAVATION INVOLVING THEIR UTILITIES SO THAT A COMPANY REPRESENTATIVE CAN BE PRESENT.
- 23. THE LOCATOR OF WATER SERVICES CONNECTION OR EXTENSIONS SHALL BE MARKED ABOVE THE GROUND AT THE BOUNDARY LINE OF EACH LOT WITH A TWO BY FOUR (2"X4") POST WHICH SHALL EXTEND ABOVE THE FINISHED GRADE AT LEAST TWENTY-FOUR (24") INCHES AND SHALL BE PAINTED BLUE. PERMANENT BLUE MARKERS SHALL BE ETCHED INTO THE CURB.
- 24. THE LOCATOR OF SEWER LATERAL SERVICE CONNECTIONS OR EXTENSIONS SHALL BE MARKED ABOVE THE GROOUND AT THE BOUNDARY LINE OF EACH LOT WITH A TWO BY FOUR (2"X4") POST WHICH SHALL EXTEND ABOVE THE FINISHED GRADE AT LEAST TWENTY-FOUR (24") INCHES AND SHALL BE PAINTED GREEN. PERMANENT GREEN MARKERS SHALL BE ETCHED INTO THE **C**URB.

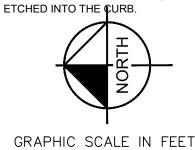


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DESCRIPTION






PAVEMENT MARKING LEGEND

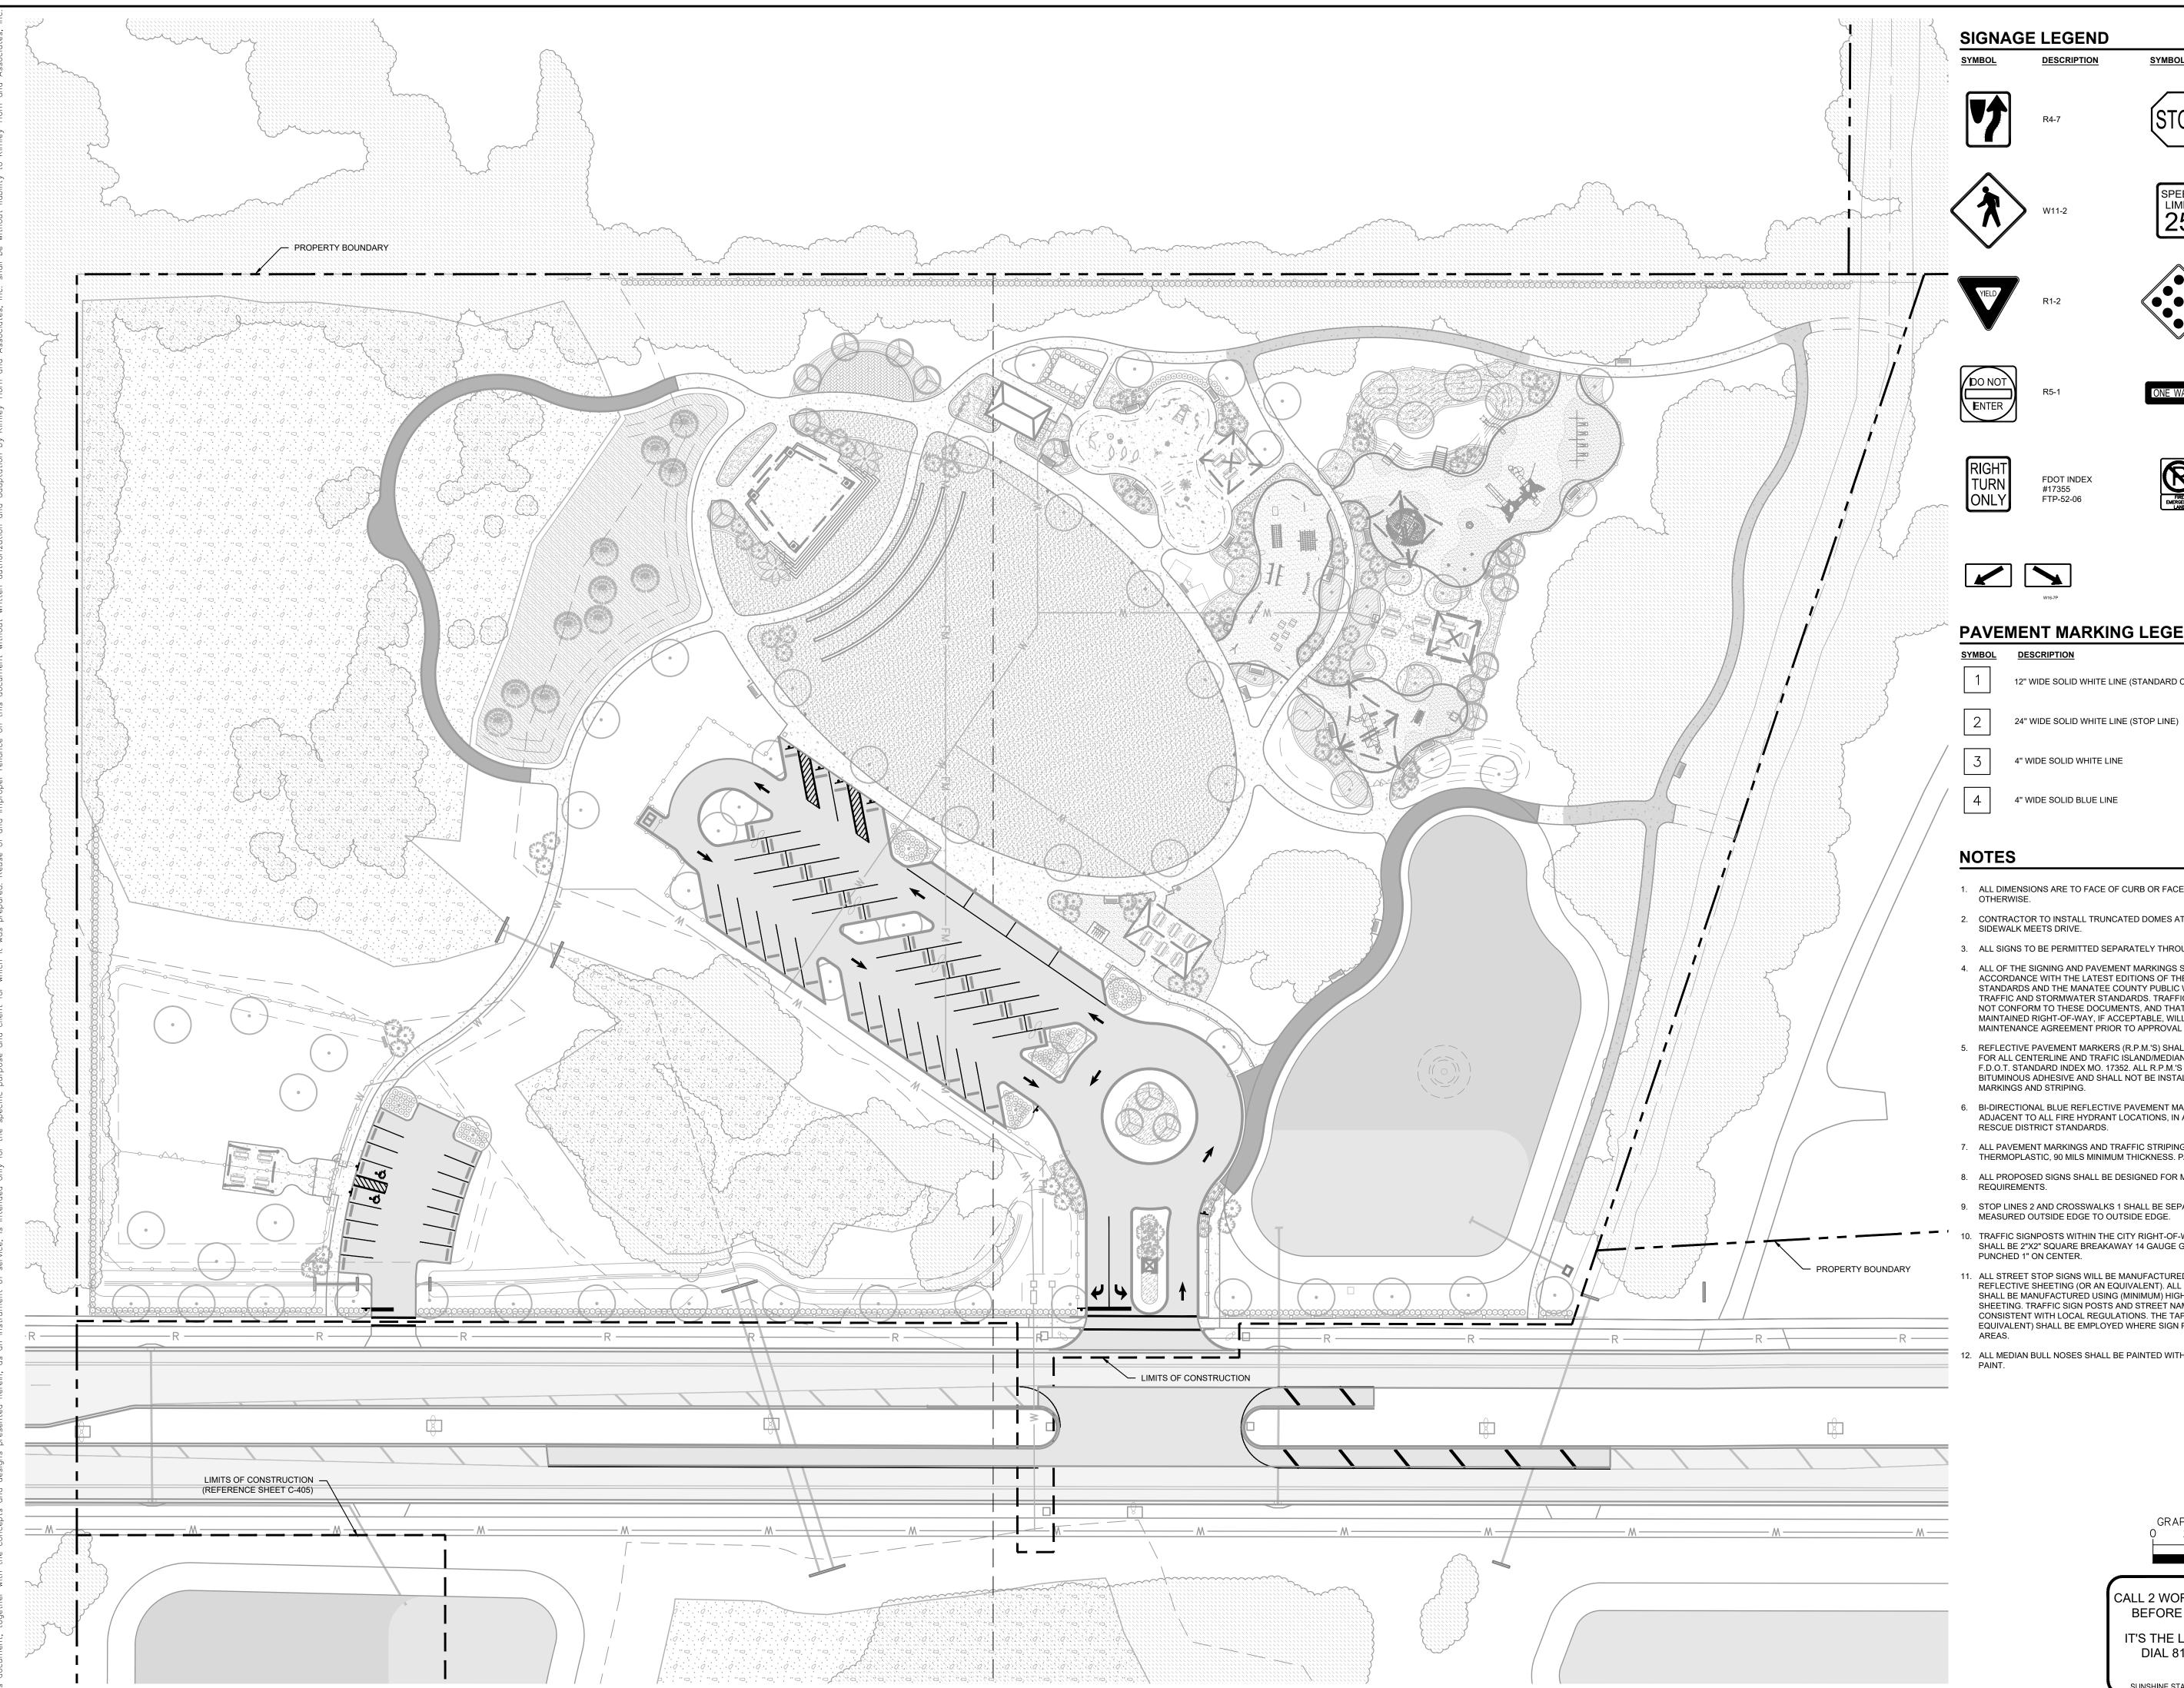12" WIDE SOLID WHITE LINE (STANDARD CROSSWALK)

4" WIDE SOLID BLUE LINE

- 2. CONTRACTOR TO INSTALL TRUNCATED DOMES AT EACH CROSSWALK WHERE
- 3. ALL SIGNS TO BE PERMITTED SEPARATELY THROUGH MANATEE COUNTY.
- 4. ALL OF THE SIGNING AND PAVEMENT MARKINGS SHALL BE PROVIDED IN ACCORDANCE WITH THE LATEST EDITIONS OF THE MUTCD, FDOT DESIGN STANDARDS AND THE MANATEE COUNTY PUBLIC WORKS DEPARTMENT HIGHWAY, TRAFFIC AND STORMWATER STANDARDS. TRAFFIC CONTROL DEVICES THAT DO NOT CONFORM TO THESE DOCUMENTS, AND THAT ARE WITHIN THE PUBLICLY MAINTAINED RIGHT-OF-WAY, IF ACCEPTABLE, WILL REQUIRE AN EXECUTED MAINTENANCE AGREEMENT PRIOR TO APPROVAL OF CONSTRUCTION PLANS.
- 5. REFLECTIVE PAVEMENT MARKERS (R.P.M.'S) SHALL BE BI-DIRECTIONAL AMBER FOR ALL CENTERLINE AND TRAFIC ISLAND/MEDIANS LOCATED IN ACCORDANCE TO F.D.O.T. STANDARD INDEX MO. 17352. ALL R.P.M.'S SHALL BE INSTALLED WITH BITUMINOUS ADHESIVE AND SHALL NOT BE INSTALLED ON THERMOPLASTIC
- 6. BI-DIRECTIONAL BLUE REFLECTIVE PAVEMENT MARKERS SHALL BE INSTALLED ADJACENT TO ALL FIRE HYDRANT LOCATIONS, IN ACCORDANCE WITH LOCAL FIRE
- 7. ALL PAVEMENT MARKINGS AND TRAFFIC STRIPING SHALL BE ALKYD THERMOPLASTIC, 90 MILS MINIMUM THICKNESS. PARKING STALLS SHALL BE PAINT.
- 8. ALL PROPOSED SIGNS SHALL BE DESIGNED FOR MANATEE COUNTY WIND
- STOP LINES 2 AND CROSSWALKS 1 SHALL BE SEPARATED BY A DISTANCE OF 48", MEASURED OUTSIDE EDGE TO OUTSIDE EDGE.
- 10. TRAFFIC SIGNPOSTS WITHIN THE CITY RIGHT-OF-WAY AND PROPERTY BOUNDARY SHALL BE 2"X2" SQUARE BREAKAWAY 14 GAUGE GALVANIZED STEEL WITH HOLES PUNCHED 1" ON CENTER.
- 11. ALL STREET STOP SIGNS WILL BE MANUFACTURED USING DIAMOND GRADE REFLECTIVE SHEETING (OR AN EQUIVALENT). ALL OTHER TRAFFIC/STREET SIGNS SHALL BE MANUFACTURED USING (MINIMUM) HIGH INTENSITY REFLECTIVE SHEETING. TRAFFIC SIGN POSTS AND STREET NAME SIGNS SHALL BE INSTALLED CONSISTENT WITH LOCAL REGULATIONS. THE TAPCO V-LOC VS1P-350 SYSTEM (OR EQUIVALENT) SHALL BE EMPLOYED WHERE SIGN POSTS ARE INSTALLED IN PAVED
- 12. ALL MEDIAN BULL NOSES SHALL BE PAINTED WITH YELLOW REFLECTORIZED

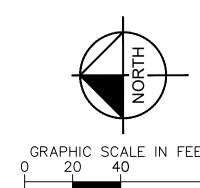

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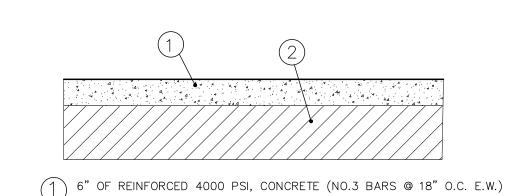
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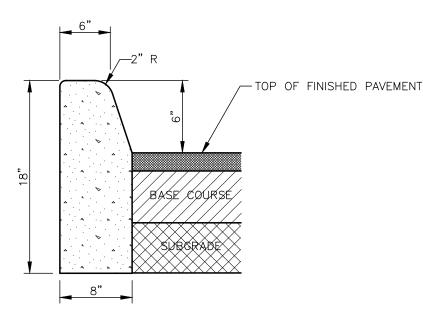
10-20 yr. Light duty parking areas flexible pavement

- 1-1/2" TYPE S ASPHALT (FDOT SECTION 331)
- (2) 6" BASE, LBR = 100 MINIMUM (FDOT SECTION 200)*
- (5) 8" TYPE B STABILIZED SUBGRADE, LBR = 40 MINIMUM (FDOT SECTION 160)


STANDARD DUTY ASPHALT





(2) 12" OF COMPACTED (98% ASTD D-1557) SUBBASE. CONCRETE PAVEMENT SECTION




TYPE "D" CURB

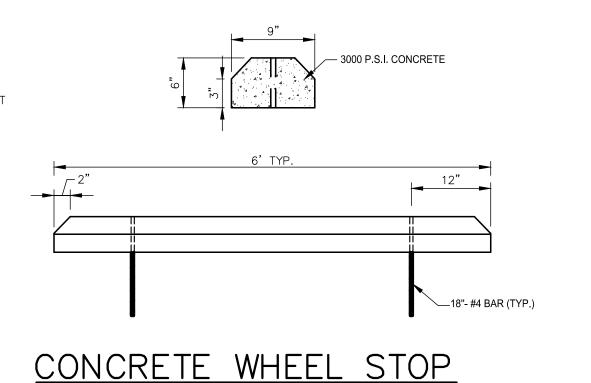


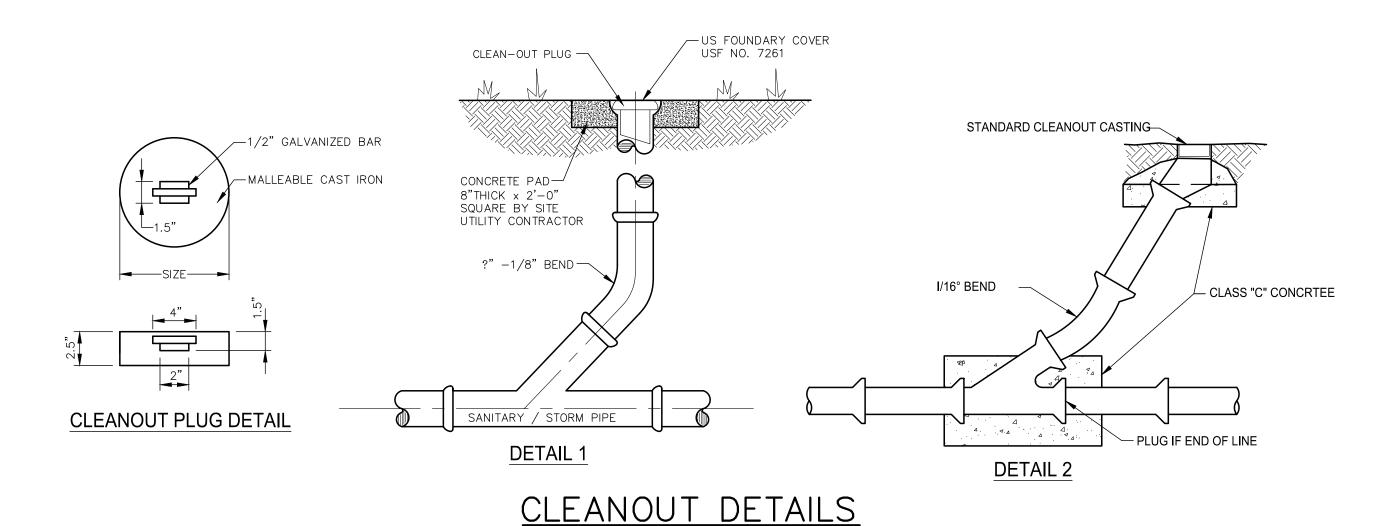

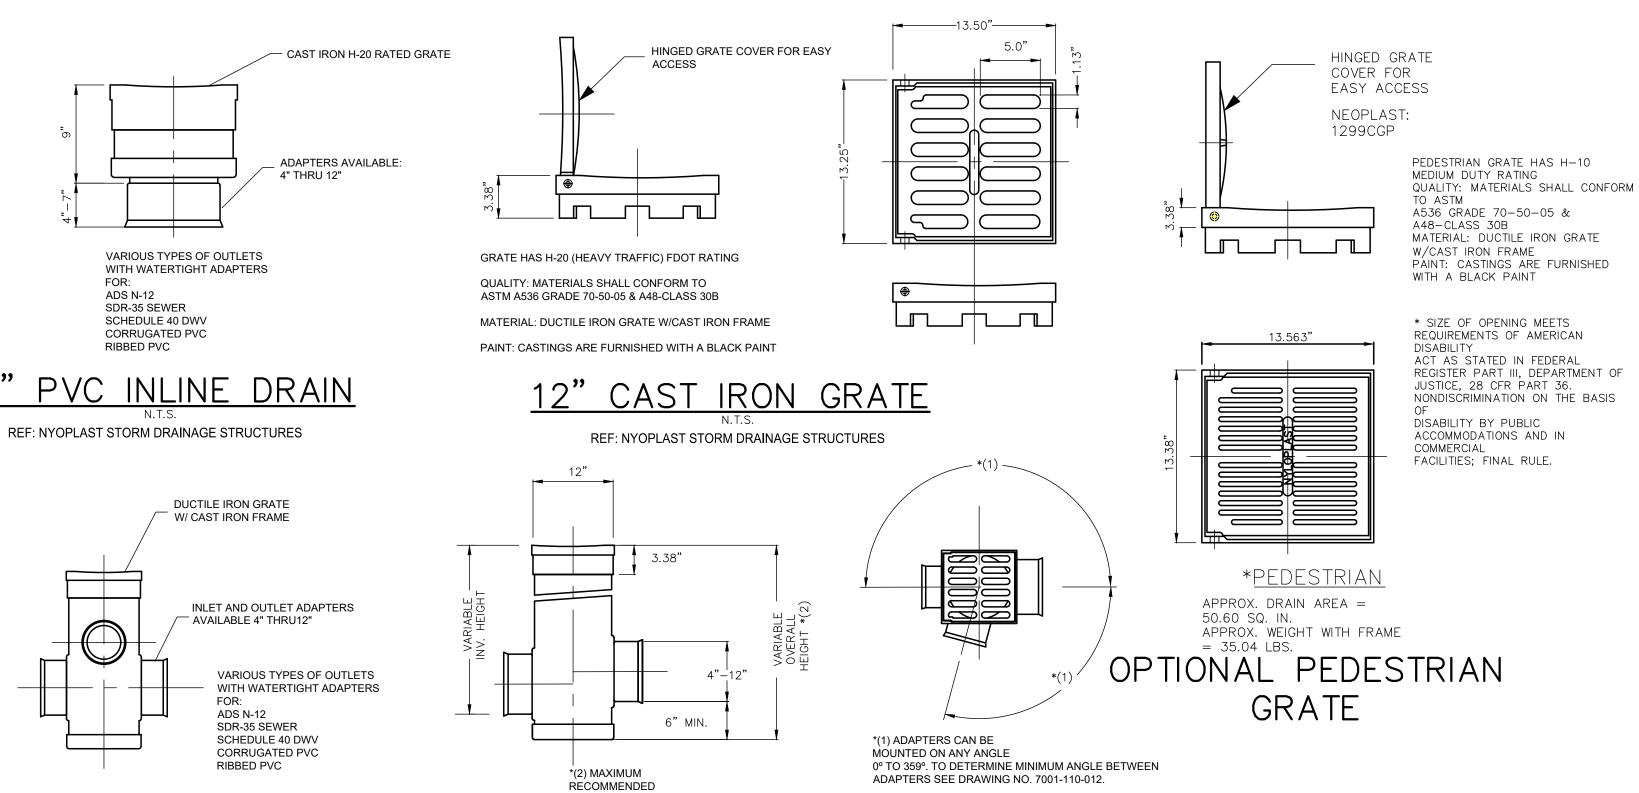


OVERALL HEIGHT 10'

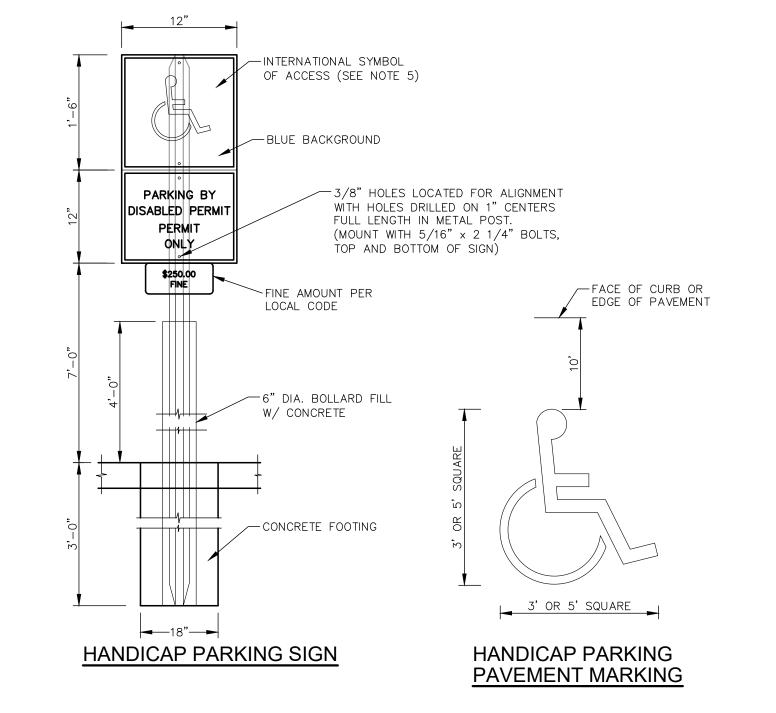

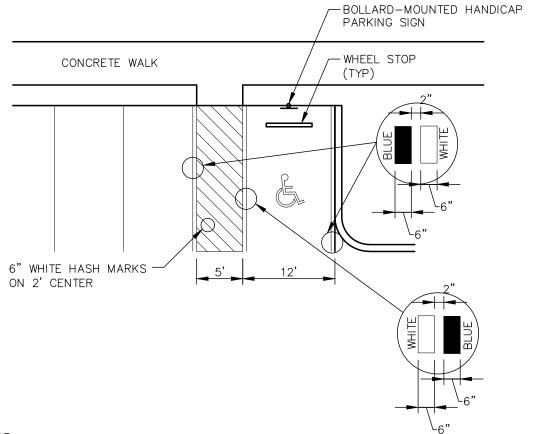

- METAL POST TO BE GALVANIZED. ALL BOLTS, NUTS, WASHERS AND SCREWS MUST BE RUSTPROOF.
 CONCRETE FOR FOOTING SHALL BE PORTLAND CEMENT AND HAVE A MINIMUM COMPRESSIVE STRENGTH OF
- 3. SIGNS WILL BE FABRICATED BY USING REFLECTING COATING IN THE SYMBOL, MESSAGE AND BORDER
- APPLIED TO A SHEET ALUMINUM BACKING (.080) IN THICKNESS. 4. MESSAGE LETTERING SHALL BE UPPER CASE (WHITE)(SERIES B) 2" HIGH IN ACCORDANCE WITH MANUAL ON
- UNIFORM TRAFFIC CONTROL DEVICES.
- 5. THE SYMBOL IS COMPOSED OF TWO ELEMENTS, A WHITE WHEELCHAIR FIGURE (WHICH SHOULD ALWAYS FACE
- RIGHT) ON A SQUARE BACKGROUND, INTERNATIONAL BLUE IN COLOR (FED. STD. 595a, COLOR #15180). 6. SIGN POST SHALL BE MIN. 2'-0" CLEAR FROM BACK OF CURB.
- 7. PARKING SPACES AND ACCESS AISLES SHALL BE LEVEL WITH SURFACE SLOPES NOT EXCEEDING 1:50 (2%) IN ALL DIRECTIONS.

HANDICAPPED PARKING/MARKING DETAIL

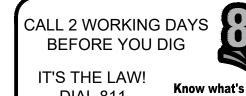


DIAL 811

Know what's **below.** Call before you dig.

SUNSHINE STATE ONE CALL OF FLORIDA, INC.


PVC YARD DRAINS

REF: NYOPLAST STORM DRAINAGE STRUCTURES

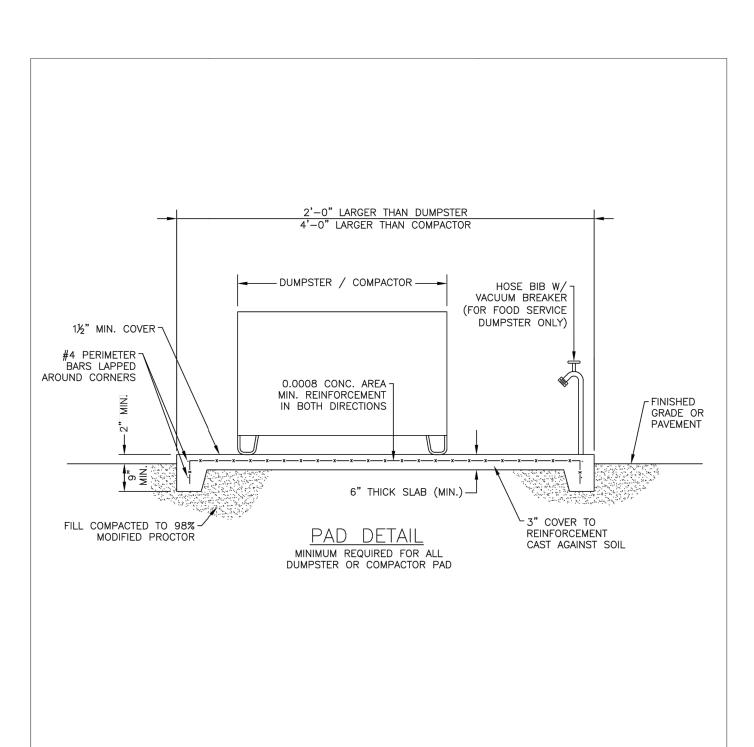

- 1. DUMPSTER PAD SHALL BE CLASS I CONCRETE W/ MIN. COMP. STRENGTH f'c= 3000 P.S.I. & MIN.
- REINFORCEMENT STRENGTH fy= 60,000 P.S.I. 2. DUMPSTER PAD SHALL BE FENCED IN ACCORDANCE WITH THE MANATEE COUNTY LAND DEVELOPMENT CODE.
- 3. ENCLOSURE SIZE TO BE A MINIMUM 10'x20' TO ACCOMMODATE RECYCLING CONTAINERS AND HAVE A MIN. TEN (10') FOOT GATE OPENING FOR EACH CONTAINER.
- 4. DISCHARGE FROM THE DUMPSTER PAD SHALL BE DIRECTED TO THE ONSITE STORMWATER MANAGEMENT SYSTEM, I.E. CATCH BASIN, SWALES, RETENTION AREA, ETC.
- 5. WHEN DUMPSTER PAD IS LOCATED ADJACENT TO PROPERTY LINE, DISCHARGE SHALL BE DIRECTED IN THE OPPOSITE DIRECTION AND SHALL NOT DISCHARGE ONTO ADJACENT PROPERTY.

		NATEE COUNTY C WORKS DEPARTMENT	COMPACTOR AND	
REV.BY	DATE		DUMPSTER PADS	US-14A
		February 25, 2020	DOMESTER TADS	

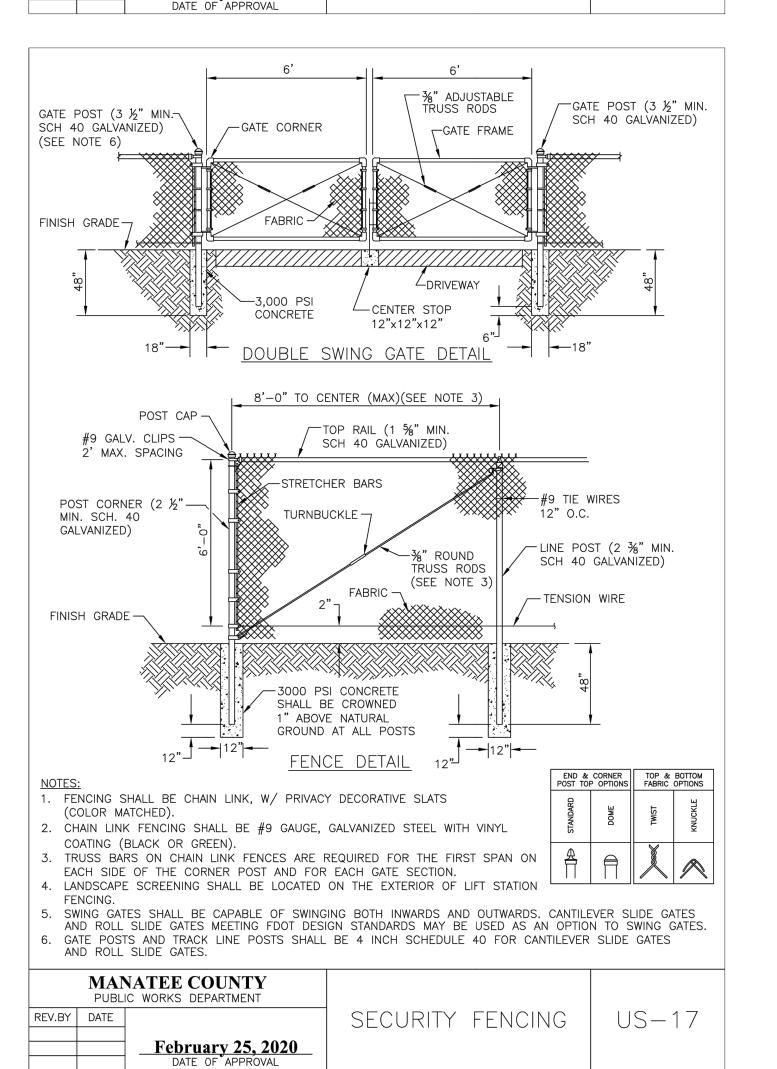



CALL 2 WORKING DAYS BEFORE YOU DIG

IT'S THE LAW! Know what's **below. DIAL 811** SUNSHINE STATE ONE CALL OF FLORIDA, INC.

Call before you dig.

SHEET NUMBER

CELLANE(DETAILS

30% (NO

OF WET WELL

SECTION VIEW

(E) LEAD PUMP ON -

3 CUBIC YARDS -

ELEVATIONS

TBD

CONCRETE BALLAST

TOP OF WET WELL

HIGH WATER ALARM

INLET INVERT

LAG PUMP ON

LEAD PUMP ON

(G) BOTTOM OF WET WELL

PUMP OFF

(F) PUMP OFF

G BOTTOM OF WET WELL

GENERAL NOTES

DESIGN CONDITIONS

MODEL FT/TDH PHASE VOLTAGE **IMPELLER** DISCHARGE

PUMPS SHALL BE OF THE SUBMERSIBLE TYPE (MANUFACTURED BY HYDROMATIC OR HOMA). EACH PUMP SHALL BE MOUNTED ON A Ø2" RAIL SYSTEM. THE RAIL SYSTEM SHALL BE SELF ENGAGING RESULTING IN A LEAKPROOF COUPLING. THE RAIL SYSTEM SHALL INCLUDE THE BASE ELBOW, DISCHARGE FLANGE ASSEMBLY, 304SS GUIDE RAILS, 316SS UPPER GUIDE BRACKET, 316SS LIFTING BAIL AND CABLE, AND A SIX-HOOK 316SS CABLE HOLDER. THE RAIL SYSTEM SHALL BE MOUNTED AND PRE-PIPED BY THE PUMP SUPPLIER.

THE PUMP VOLUTE, MOTOR AND SEAL HOUSING SHALL BE CONSTRUCTED OF CAST IRON. ALL EXTERNAL FASTENERS SHALL BE SERIES 300 STAINLESS STEEL. THE PUMP SHAFT SHALL BE CONSTRUCTED OF SERIES 416 STAINLESS STEEL.

THE IMPELLER SHALL BE OF MULTI-VANE, SEMI-OPEN CONSTRUCTION. THE IMPELLER SHALL BE STATICALLY AND HYDRAULICALLY BALANCED.

A CUTTER ASSEMBLY SHALL BE MOUNTED ON THE SUCTION SIDE OF THE PUMP WITH DIRECT DISCHARGE INTO THE PUMP IMPELLER. THE GRINDER SHALL BE CAPABLE OF GRINDING MATERIALS FOUND IN NORMAL, DOMESTIC SEWAGE. BOTH THE STATIONARY AND ROTATING CUTTERS SHALL BE CONSTRUCTED OF HARDENED STEEL.

THE MOTOR SHALL BE MOUNTED IN A SEALED, SUBMERSIBLE TYPE HOUSING. THE STATOR SHALL BE SECURELY HELD IN PLACE WITH A REMOVABLE END RING AND THREADED FASTENERS FOR EASE OF REMOVAL WITHOUT THE USE OF HEAT OR A PRESS. THE MOTOR WILL HAVE TWO HEAVY-DUTY BALL BEARINGS: ONE UPPER (RADIAL) AND ONE LOWER (THRUST), TO SUPPORT THE SHAFT. THE MOTOR SHALL BE EQUIPPED WITH A WINDING THERMOSTAT THAT IS WIRED TO SHUT THE MOTOR OFF IN CASE OF MOTOR OVERHEATING.

THE PUMP SHALL HAVE TWO MECHANICAL SEALS, MOUNTED IN TANDEM WITH AN OIL CHAMBER BETWEEN THE SEALS. THE PUMP SHALL BE EQUIPPED WITH A SEAL LEAK DETECTION PROBE AND WARNING SYSTEM BY USING A SEAL FAILURE SENSOR INSTALLED IN THE SEAL CHAMBER.

THE PUMP SUPPLIER SHALL PROVIDE THE WET WELL. THIS GLASS FIBER-REINFORCED POLYESTER BASIN SHALL BE CONSTRUCTED OF A COMMERCIAL GRADE OF GLASS FIBER AND SHALL BE PROVIDED WITH FILLET AND AN ANTI-FLOTATION RING WITH A MINIMUM DIAMETER OF THREE INCHES LARGER THAN THE BASIN DIAMETER. THE RAIL SYSTEM, INTERNAL PIPING AND DISCHARGE CONNECTIONS SHALL BE PRE-INSTALLED BY THE PUMP SUPPLIER. CONCRETE BALLAST QUANTITY USED TO SECURE THE WET WELL BASE SHALL BE AT LEAST 3 CUBIC YARDS.

HATCH COVER SHALL INCLUDE A SINGLE OR DUAL DOOR OF DIMENSIONS SPECIFIED BY THE PUMP MANUFACTURER FOR PROPER PUMP CLEARANCE. THE COVER SHALL BE MANUFACTURED BY US FABRICATION, OR EQUAL.

COVER SHALL BE ALUMINUM WITH STAINLESS STEEL FASTENERS, RATED FOR 300 PSF OR GREATER. THE

THE HATCH COVER SHALL BE 2/3 HINGED TO ALLOW FOR MAXIMUM ACCESS TO THE WET WELL. THE HATCH

THE VALVE BOX IS FIBERGLASS WITH ALUMINUM LOCKABLE COVER. STANDARD SIZE VALVE BOX IS 3' X 2 1/2' X

VALVES SHALL BE SEWAGE SWING CHECK WITH CLEAN-OUT PORTS AND BRASS GATE VALVES.

FLOATS SHALL BE ANCHOR SCIENTIFIC ROTO-FLOATS OR EQUAL.

CONTROLS

THE CONTROL PANEL SHALL BE UL508 LISTED. A NEMA 3R ENCLOSURE SHALL BE PROVIDED IN EITHER FIBERGLASS OR STAINLESS STEEL. THE PANEL SHALL INCLUDE AN ALTERNATING CONTROL SCHEME (DUPLEX AND ABOVE), MAIN CIRCUIT BREAKER, GENERATOR RECEPTACLE, HIGH LEVEL ALARM LIGHT AND HORN, ELAPSED TIME METERS, VOLTAGE OR PHASE MONITOR, SEAL FAILURE AND OVERLOAD SENSORS. THE LIGHTNING ARRESTOR SHALL BE PROVIDED BY CONTRACTOR.

ALL ELECTRICAL WORK SHALL BE IN ACCORDANCE WITH LOCAL CODES.

"QUICK DISCONNECT COUPLING" SLIDE

RAIL SYSTEM ALLOWS PUMP REMOVAL

WITHOUT ENTRY INTO WET WELL

DEPTH = CONCRETE = 4000 LBS/YD 6FT = 1.5 YDS (6000 LBS)

8FT = 2 YDS (8000 LBS)

10FT = 2.5 YDS (10000 LBS) 12FT = 3 YDS (12000 LBS)

14FT = 3.5 YDS (14000 LBS)

- ANTI-FLOTATION RING

FIBERGLASS FILLET

PUMP SUPPLIER SHALL PROVIDE SUBMERSIBLE PUMPS, SLIDE RAIL ASSEMBLIES, FIBERGLASS BASIN AND VALVE BOX, CONTROL PANEL, FLOAT SWITCHES, ALUMINUM HATCHES AND ACCESSORIES TO INSURE PROPER OPERATIONS AND WARRANTY. THE COMPLETE PACKAGE PUMPING STATION SHALL HAVE PUMP BASES. RAIL ASSEMBLIES, AND DISCHARGE PIPING ASSEMBLED BY BARNEY'S PUMPS INC. READY FOR FIELD INSTALLATION.


PUMP PACKAGE SHALL BE SUPPLIED BY BARNEY'S PUMPS INC. IN LAKELAND (863-665-8500), CORAL SPRINGS (954-346-0669), OR JACKSONVILLE (904-260-0669), FL.

ELECTRICAL DATA

INCOMING POWER: 230 V 1 Ø (CONTRACTOR TO VERIFY)


ENCLOSURE AND DEADFRONT LAYOUT (TYPICAL)

(OUTER DOOR NOT SHOWN FOR CLARITY)

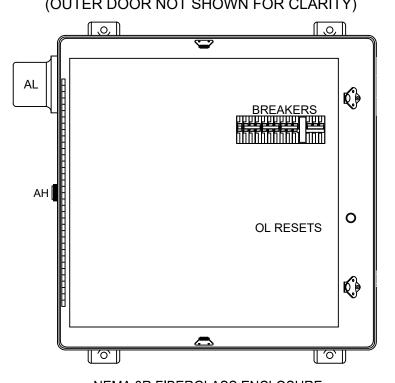


NEMA 3R FIBERGLASS ENCLOSURE

TERMINAL STRIP

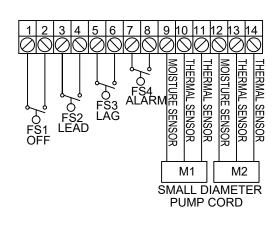


SINGLE PHASE WIRING DIAGRAM

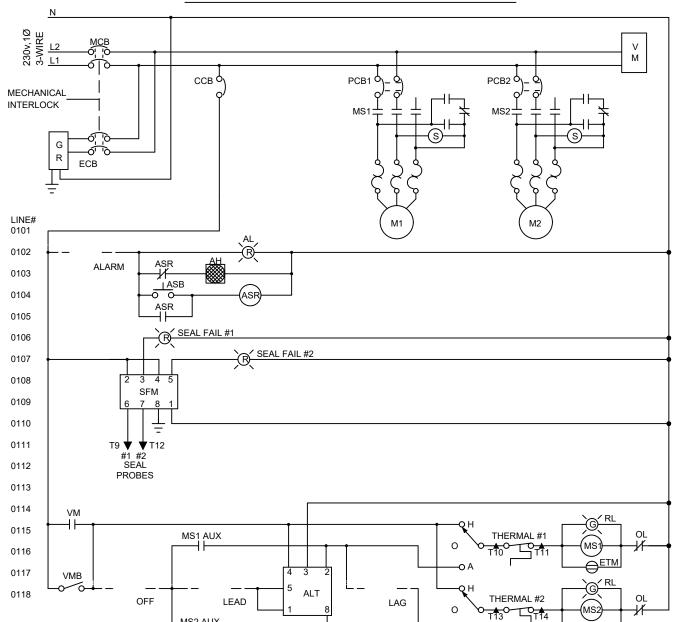

LEGEND

ENCLOSURE MAIN CIRCUIT BREAKER EMERGENCY CIRCUIT BREAKER PCB1,2 PUMP CIRCUIT BREAKER CONTROL CIRCUIT BREAKER MOTOR STARTER OVERLOAD HEATER GENERATOR RECEPTACLE **VOLT MONITOR** ELAPSED TIME METER ALTERNATOR ALARM HORN ALARM LIGHT ALARM SILENCE BUTTON HAND OFF AUTO SWITCH **VOLT MONITOR BYPASS RUN LIGHT** INDICATING LIGHT SEAL FAIL MODULE ALARM SILENCE RELAY **RUN CAPACITOR** START CAPACITOR START RELAY VOLTAGE MONITOR **VOLTAGE MONITOR BYPASS**



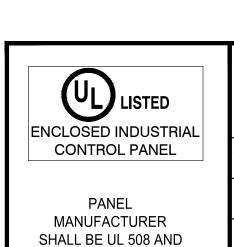

UL 698A LISTED.

BP BARNEY'S PUMPS, INC. PO BOX 3529, LAKELAND, FL 33802 PHONE: (863) 665-8500 FAX: (863) 666-3858 PROJECT USTOMER SALESPERSON GRINDER DUPLEX FIBERGLASS LIFT STATION - SINGLE PHASE DRAWN BY: DWG. # 04/04/2014 WW2GFVFM_1PH R.R.B.

CALL 2 WORKING DAYS IT'S THE LAW!

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1. CLEARANCE MAY BE REDUCED TO 6" FOR GRAVITY SEWER WHERE WATER MAIN IS DUCTILE IRON.

2. PIPE SECTIONS SHALL BE FULL-LENGTH AND SHALL BE ADJUSTED HORIZONTALLY, SO THAT THE CROSSING IS AT EACH PIPE SECTION'S MIDPOINT REGARDLESS OF THE VERTICAL CLEARANCE.

		NATEE COUNTY IC WORKS DEPARTMENT	TYDICAL NEW WATER 0.	
REV.BY	DATE		TYPICAL NEW WATER &	UG-2
			SEWER LINE CROSSING	0 0 2
		DATE OF APPROVAL		

REQUIRED LENGTH OF RESTRAINED JOINT PIPE **FOR C900-16 PVC PIPE (DR-18)**

MAIN PIPE	HOR	IZ. B	ENDS			TEES			R	EDUCER	:S	PLUGS & VALVES
SIZE	90°	45°	22.5°		S	SIZE LEN	IGTH		S	SIZE LEN	IGTH	
24	90	38	18	X24 169	X20 132	X16 90	X12 38	X10 ₆	X20 64	X16 117	X12 158	214
20	78	32	16	X20 141	X16 101	X12 53	X10 24	X8_1	X16 65	X12 115	X10 149	184
16	66	27	13	X16 111	X12 67	X10 41	X8 12		X12 64	X10 107	X8 111	151
12	52	22	10	X12 80	X10 56	X8 31	X6_1		X10 58	X8 62	X6 86	118
10	44	18	9	X10 63	X8 40	X6 ₇			X8 33	X6 61	X4 81	100
8	37	15	7	X8 49	X6 18	X4_1			X6 35	X4 60		83
6	29	12	6	X6 29	X4 1				X4 33			63
4	21	8	4	X4 12								45

- RESTRAIN 11.25° BENDS 50% OF LENGTH FOR 22.5° BENDS.
- ALL VALVES AND FITTINGS SHALL BE RESTRAINED TO THE CONNECTING SECTIONS OF PIPE.
- 3. ALL ISOLATION VALVES MUST BE PROPERLY ANCHORED OR RESTRAINED TO RESIST A 180 PSI TEST PRESSURE IN EITHER DIRECTION.
- 4. PIPE SIZES ARE GIVEN IN INCHES.
- 5. RESTRAINED PIPE LENGTHS ARE GIVEN IN FEET.
- 6. LENGTHS SHOWN ARE FOR A TEST PRESSURE OF 180 PSI.
- 7. THE RESTRAINED LENGTHS SHOWN IN THESE TABLES ARE BASED ON SOIL CLASSIFICATION SP WITH AWWA TYPE 3 TRENCH CONDITIONS, 180 PSI TEST PRESSURE, 3 FEET OF COVER AND 1.5 FACTOR OF SAFETY. ACTUAL BURY CONDITIONS MUST BE DETERMINED BY THE ENGINEER OF RECORD AND THE RESTRAINED LENGTHS MODIFIED ACCORDINGLY.
- 8. RESTRAINED LENGTHS TO BE APPLIED TO PIPELINES PER DETAIL UG-10 RESTRAINED LENGTHS
- 9. ALL RESTRAINED JOINT HARDWARE SHALL CONFORM TO 1.11.17 OF THE PUBLIC WORKS UTILITIES STANDARDS MANUAL.

10. ALL THREE "LEGS" OF TEES SHALL BE RESTRAINED PER THE STATED LENGTH IN THE TABLE.

		NATEE COUNTY IC WORKS DEPARTMENT	RESTRAINED	
REV.BY	DATE		LENGTHS FOR PVC	UG-8
		February 25, 2020	PIPE	
		DATE OF APPROVAL		

NOTES:

- BITUMINOUS PAVEMENT SHALL BE REMOVED IN CLEAN STRAIGHT LINES BY SAW CUTTING. WHERE BITUMINOUS PAVEMENT ADJOINS A TRENCH, THE EDGES ADJACENT TO THE TRENCH SHALL BE TRIMMED TO A NEAT STRAIGHT LINES BEFORE RESURFACING TO ENSURE THAT ALL AREAS TO BE RESURFACED ARE ACCESSIBLE TO ROLLERS OR TAMPERS USED TO COMPACT THE SUB-GRADE OR PAVING MATERIALS.
- USE OF TYPE A-2 AND A-3 PIPE BEDDING TO BE DETERMINED IN THE FIELD BY THE ENGINEER. PROVIDE ADEQUATE CLEARANCE TO PLACE AND COMPACT STAGE 1 BEDDING MATERIAL IN TRENCH AREA BELOW PIPE SPRINGLINE. PIPE EMBEDMENT MUST BE COMPACTED OUT TO THE TRENCH WALL OR 2.5 TIMES THE PIPE OD, WHICHEVER IS LESS.
- PIPE INSTALLATION SHALL BE IN ACCORDANCE WITH THE MANUFACTURER'S WRITTEN INSTRUCTIONS.
- ASPHALTIC CONCRETE STRUCTURE COURSE WITH PRIME COAT SHALL BE THE SAME DEPTH AND TYPE AS EXISTING OR A MINIMUM OF 1-1/4 INCH S-I, WHICHEVER IS GREATER. MILL 25' BACK FROM TRENCH CROSSING SAW CUTS. ADJUST MILLING PER INDIVIDUAL SITE TO NOT IMPACT BASE. BUTT JOINT TO EXIST ASPHALT. FINAL OVERLAY TO MATCH EXISTING WITH NO DISCERNABLE "BUMP" AT JOINT.

MILLING LIMITS THAT IMPACT INTERSECTION SHALL BE ADDRESSED ON A CASE BY CASE BASIS AND APPROVED BY

- SHEETING ORDERED LEFT IN PLACE TO BE CUT OFF 24" BELOW FINISHED GRADE OR 12" BELOW SUBGRADE. NEW BASE SHALL MATCH EXISTING; OR BE CRUSHED CONCRETE, 8" MIN. THICKNESS, LBR ≥150, WHICHEVER IS
- TEMPORARY PATCHES WILL BE INSTALLED TO PROVIDE A SMOOTH ALL WEATHER SURFACE AT ALL TIMES. PERMANENT REPLACEMENT TO BE MADE AS SOON AS POSSIBLE.
- 10. RESTORE SIGNAGE & MARKING WITH THERMOPLASTIC PER FDOT STANDARDS, LATEST EDITION. 11. TRACER WIRE NOT REQUIRED FOR GRAVITY SEWERS.

PUBLIC WORKS DEPARTMENT

February 25, 2020

REV.BY DATE

12. NOTES 5. THRU 10. ARE MINIMUM REQUIREMENTS FOR A TRENCH IN A LOCAL ROAD. REFER TO LATEST EDITION OF MANATEE COUNTY HIGHWAY AND TRAFFIC STANDARDS FOR ADDITIONAL REQUIREMENTS.


25'	-1/	4" MIN. S—I ASPHALTIC CONCRETE W. (SEE NOTE 5), BOTTOM LAYER	/ PRIME COAT R		25'
SAW CUT JOINT	18"	FULL BASE REPLACEMENT	1	8" S	AW CUT JOINT
SAW CUT JOINT	9"=	SEE NOTE 8—	9"-	SA	W CUT JOINT
EXIST. SPHALT SELECT 'ELECTRICALLY DETECTABL TAPE BETWEEN 12" & 2 SURFACE OVER PIPE. MARKED "WATER", "SEWER"	4" BELOW FINISH TAPE SHALL BE	SAW CUT JOINT SEE NOTE 7 SEE NOTE 3	EXIS	& COMPACTED Y, ASSHTO T-180	EXIST. ASPHALT
" WI SELEC	PER CLAD STEEL RE CONTINUOUS (SEE NOTE 11) ETED COMMON FILL BEDDING ENVELOPE (SEE NOTE 2)	PIPE O.D.	6" MIN. BEDDING	BACKFILLED & COMPACTO 98% DENSITY, AASHTO	

PAVEMENT SURFACE

TYPE A-1 PIPE

BEDDING (CROSSING)

UG - 12

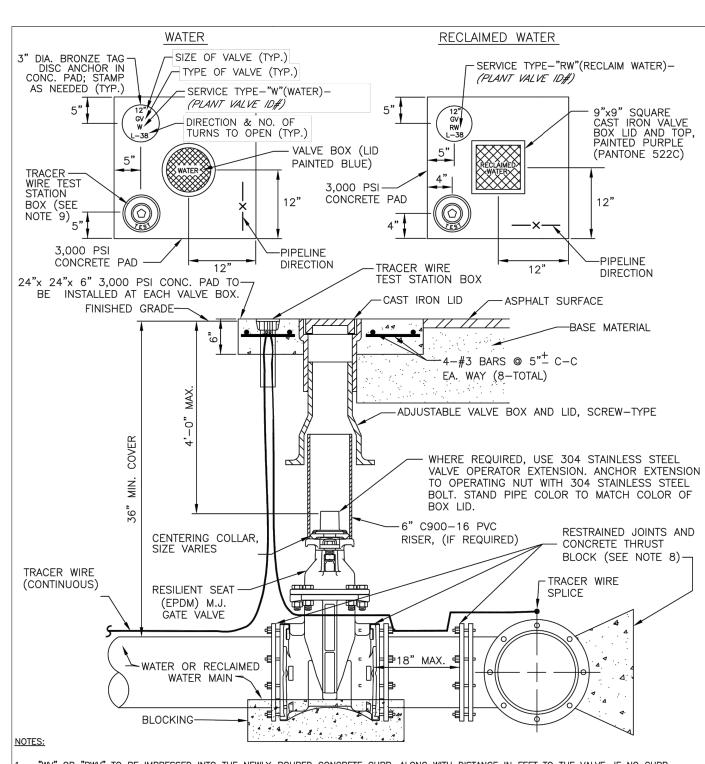

"WV" OR "RWV" TO BE IMPRESSED INTO THE NEWLY-POURED CONCRETE CURB, ALONG WITH DISTANCE IN FEET TO THE VALVE. IF NO CURB, INSTALL A BLUE DISC WITH "WV" OR PURPLE DISC WITH "RWV" USING A 1/8" x 1" GALVANIZED STEEL SCREW IN THE EDGE OF PAVEMENT WITH THE FOOTAGE FROM THE DISC TO THE VALVE. ALL EXISTING AND PROPOSED VALVE BOXES SHALL BE ADJUSTED TO FINISHED GRADES AS DETERMINED IN THE FIELD. VALVES SHALL NOT BE PLACED IN HANDICAPPED RAMPS, CURBS, OR GUTTERS. PRECAST CONCRETE PADS SHALL NOT BE USED.


ALL EXPOSED EDGES OF CONCRETE SHALL BE CHAMFERED 1/2' PIPELINE DIRECTION TO BE IMPRESSED INTO NEWLY POURED CONCRETE PAD.


February 25, 2020

- TRACER WIRE TEST STATION BOX IS NOT REQUIRED IN VALVE BOX PAD IF THE GATE VALVE IS LOCATED WITHIN 200 FEET OF A WATER SERVICE, BLOW-OFF, BACKFLOW PREVENTER OR FIRE HYDRANT THAT HAS A TRACER WIRE BOX. WHERE THRUST BLOCK NOT USED, RESTRAINED JOINTS MUST THEN EXTEND FROM TEE FULL LENGTH SPECIFIED FOR "TEES."
- USE NON-TRAFFIC RATED BOXES FOR NORMAL YARD SERVICE. WHERE VALVE WILL BE IN STREET OR PARKING UNDER VEHICLE TRAFFIC, USE TRAFFIC RATED BOXES. WHERE POSSIBLE, LOCATE TRACE WIRE TESTING STATION OUTSIDE OF TRAVEL LANE OR IN MEDIAN, CENTERED IN SEPARATE CONCRETE PAD SIMILAR TO STANDARD VALVE BOX PAD. THE RRASS TAG SHALL HAVE A "PLANT VALVE IN# WHEN VALVES ARE INSTALLED WITHIN THE COUNTY TREATMENT PLANT LIMITS. THE PLANT VALVE

LID AND TAG

		,,	DECORD DRAWINGS	I LIMITS. THE FLANT VALV
		SHOWN ON THE CONSTRUCTION PLANS AND F ION 1.11 GATE VALVES IN THE PUBLIC WORK	S UTILITY STANDARDS MANUAL FOR FURTHER DETAILS.	
111 112121			William Control of the Control of th	
		NATEE COUNTY IC WORKS DEPARTMENT		
REV.BY	DATE		GATE VALVE, BOX,	UW-2

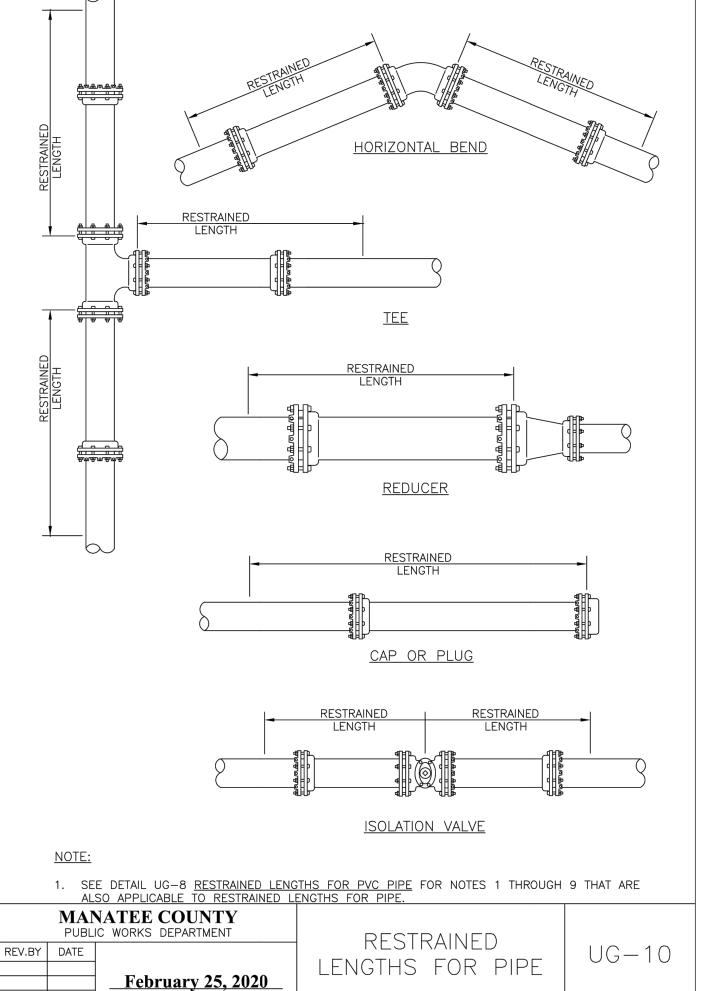

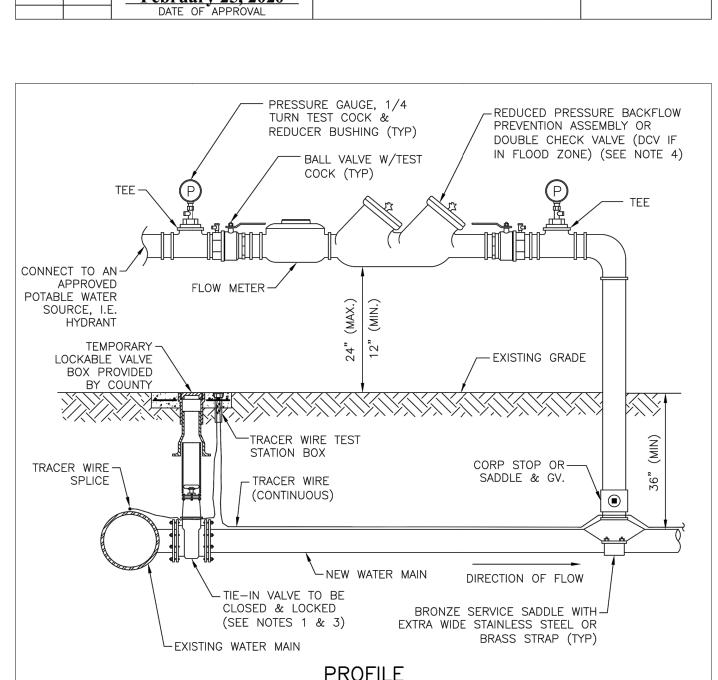

- 1. FOR TIE-IN VALVE, SEE DETAIL UW-3 FOR TAPPING SLEEVE VALVE AND UW-2 FOR GATE VALVE. . CORPORATION STOP CONNECTIONS TO WATER MAINS SHALL BE AT A SUFFICIENT DISTANCE FROM NEW TAPPING SLEEVE & VALVE (TIE-IN VALVE). ALL CORPORATION STOP TAPS SHALL BE PLACED NO CLOSER THAN 30" OR A DISTANCE EQUAL TO (1) MAIN PIPE DIAMETER PLUS (2) TAP DIAMETERS (WHICHEVER IS LARGER) FROM THE NEW TIE-IN VALVE (TAPPING VALVE & SLEEVE). SIZE-ON-SIZE TAPS ARE NOT ALLOWED. A CUT-IN TEE SHALL BE USED.
- IF THE EXISTING WATER MAIN IS LOCATED UNDER PAVEMENT OR CLOSE TO THE ROADWAY, BOTH JUMPER CORPORATION STOPS MAY CONNECT TO THE NEW WATER MAIN LOCATED OUTSIDE OF THE PAVEMENT. AN ADDITIONAL GATE VALVE SHALL BE INSTALLED AND THE VALVE MAY BE LOCATED AT THE ROW LINE. PIPING AND APPURTENANCES BETWEEN THE EXISTING MAIN AND ISOLATION VALVE AND JUMPER SHALL BE DISINFECTED BY SPRAYING OR SWABBING.
- BACKFLOW PREVENTION ASSEMBLY SHALL BE STRUCTURALLY SUPPORTED.
- THE TIE-IN VALVE SHALL REMAIN CLOSED AND THE LOCKABLE VALVE BOX SHALL BE LOCKED BY MANATEE COUNTY. THE TIE-IN VALVE SHALL REMAIN CLOSED AND LOCKED UNTIL THE NEW SYSTEM HAS BEEN CLEARED FOR USE BY THE FDEP AND ALL OTHER PERTINENT AGENCIES. AFTER CLEARANCE IS OBTAINED, THE LOCKABLE VALVE BOX SHALL BE REMOVED, RETURNED TO THE COUNTY, AND REPLACED WITH A STANDARD
- 6. IN THE EVENT THE LOCKED TIE-IN VALVE MUST BE OPENED, THE VALVE SHALL ONLY BE OPERATED BY MANATEE COUNTY PERSONNEL.
- 7 SEE DETAIL LIW-24 FOR ADDITIONAL HIMPER CONNECTION NOTES


/. SE	E DETAIL	_ UW-24 FOR ADDITIONAL JUMPER	COMMECTION NOTES.	
		NATEE COUNTY IC WORKS DEPARTMENT	TEMPORARY JUMPER	
REV.BY	DATE		CONNECTION—HYDRANT	l UW-23A
		February 25, 2020	AVAII ABI F	
		DATE OF APPROVAL	/ \	

NOTES:

- 1. USE OF TYPE A-2 AND A-3 PIPE BEDDING TO BE DETERMINED IN THE FIELD BY THE
- 2. PROVIDE ADEQUATE CLEARANCE TO PLACE AND COMPACT STAGE 1 BEDDING MATERIAL IN TRENCH AREA BELOW PIPE SPRINGLINE. PIPE EMBEDMENT MUST BE COMPACTED OUT TO
- 3. PIPE INSTALLATION SHALL BE IN ACCORDANCE WITH THE MANUFACTURER'S WRITTEN INSTRUCTIONS.

THE TRENCH WALL OR 2.5 TIMES THE PIPE OD, WHICHEVER IS LESS.

4. TRACER WIRE NOT REQUIRED FOR GRAVITY SEWERS.

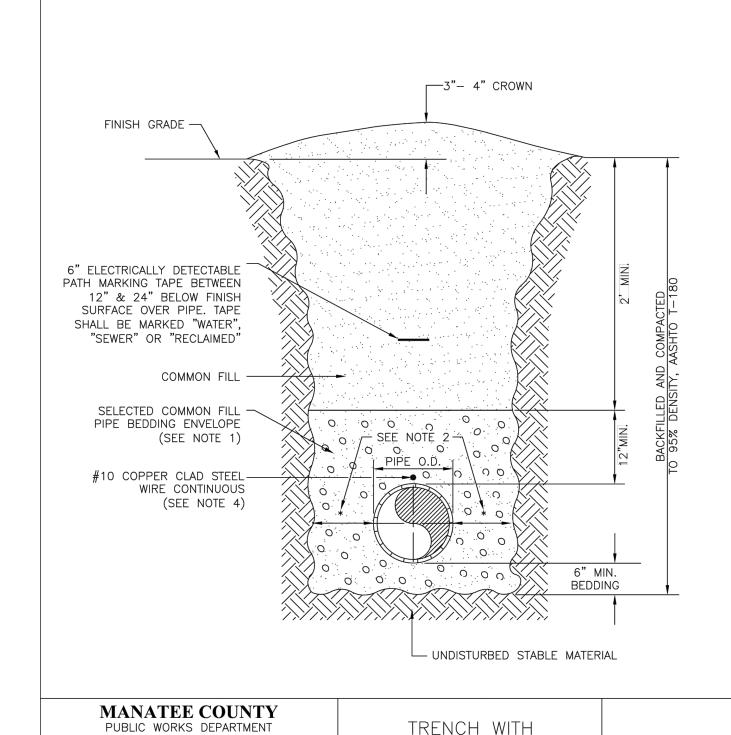

UG - 11REV.BY DATE UNIMPROVED SURFACE TYPE A—1 PIPE BEDDING **February 25, 2020**

ADJACENT TO THE EXISTING WATER MAIN;

IN THE STANDARD TEMPORARY JUMPER DETAIL UW-23A OR UW-23B.

LESS THAN 25 MILLIGRAMS PER LITER (MG/L) OF FREE CHLORINE.

AS DETERMINED BY THE ENGINEER OF RECORD OR FIRE DEPARTMENT.

LENGTH: OR

CASE-BY-CASE BASIS.

OF THE CONTRACTOR.

RECEIVED CLEARANCE FROM THE FDEP.

MANATEE COUNTY

PUBLIC WORKS DEPARTMENT

February 25, 2020

REV.BY DATE

A 2-INCH MINIMUM TEMPORARY JUMPER CONNECTION IS REQUIRED AT ALL CONNECTIONS BETWEEN

EXISTING ACTIVE POTABLE WATER MAINS AND PROPOSED NEW WATER MAIN IMPROVEMENTS WITH THE

a. PROJECTS THAT INCLUDE A PERMANENT BACKFLOW PREVENTER AT THE RIGHT-OF-WAY WHICH IS

b. PROJECTS THAT INCLUDE NEW WATER MAINS THAT ARE LESS THAN OR EQUAL TO 18 LINEAR FEET IN

c. OTHER PROPOSED CASES THAT ARE APPROVED BY MANATEE COUNTY AND THE CONSTRUCTION

DRAWINGS SPECIFICALLY STATE THAT A TEMPORARY JUMPER CONNECTION IS NOT REQUIRED.

2. A TEMPORARY JUMPER SHALL BE USED AND BE CONNECTED TO AN APPROVED POTABLE WATER SOURCE

(E.G., EXISTING FIRE HYDRANT, EXISTING MAIN, EXISTING SERVICE TAP OR TANK TRUCK, ETC.) AS SHOWN

A TEMPORARY JUMPER SHALL BE USED FOR FILLING, FLUSHING AND FOR DISINFECTION OF ANY NEW

MAIN OF ANY SIZE. THE TEMPORARY JUMPER CONNECTION SHALL BE MAINTAINED UNTIL AFTER THE

FILLING, FLUSHING, TESTING AND DISINFECTION OF THE NEW MAIN HAS BEEN SUCCESSFULLY COMPLETED

AND CLEARANCE FOR USE FROM THE FLORIDA DEPARTMENT OF ENVIRONMENTAL PROTECTION (FDEP) HAS

WATER MAINS THAT ARE LOCATED UNDER THE ROADWAY PAVEMENT SHALL BE APPROVED ON A

OTHERWISE, THE TAPPING SLEEVE, AND EXTERIOR OF THE EXISTING MAIN TO BE TAPPED, PIPING WITHIN

THE JUMPER. AND NEW PIPING SHOWN ON STANDARD TEMPORARY JUMPER DETAIL UW-23A OR UW-23B

3. THE LOCATION AND ORIENTATION OF TEMPORARY JUMPERS ASSOCIATED WITH CONNECTIONS TO EXISTING

4. PIPE AND FITTINGS USED FOR CONNECTING THE NEW PIPE TO THE EXISTING PIPE SHALL BE DISINFECTED PRIOR TO INSTALLATION IN ACCORDANCE WITH AWWA C651, LATEST EDITION. UNLESS APPROVED

5. THE JUMPER SHALL INCLUDE A FLOW METER TO ENSURE THAT THE FLOW FROM THE SUPPLY SOURCE IS

6. THE JUMPER CONNECTION SHALL ALSO BE USED TO MAINTAIN A MINIMUM PRESSURE OF 20 PSI IN THE NEW MAINS CONTINUOUSLY AFTER DISINFECTION AND UNTIL FDEP CLEARANCE LETTER IS OBTAINED.

7. ALL TEMPORARY BACKFLOW PREVENTION ASSEMBLY OR "JUMPERS" UTILIZED DURING PIPELINE

8. ALL INSTALLATION AND MAINTENANCE OF THE TEMPORARY JUMPER CONNECTION AND ASSOCIATED

9. TEMPORARY JUMPER SIZE DEPENDS ON THE SITUATION: JUMPERS LARGER THAN 2-INCHES MAY BE USED

10.PRIOR TO REMOVAL OF THE TEMPORARY JUMPER, THE NEWLY-CONSTRUCTED WATER SYSTEM SHALL HAVE

11. AFTER RECEIPT OF CLEARANCE FOR USE BY FDEP, MANATEE COUNTY, AND ALL OTHER PERTINENT

12.IF THE TEMPORARY JUMPER IS LOCATED WITHIN A STANDARD PIPE LENGTH AWAY FROM THE PROPOSED

AGENCIES, THE CONTRACTOR SHALL REMOVE THE TEMPORARY JUMPER CONNECTION AND COMPLETE THE

WATER MAIN. ALL CORPORATION STOPS LEFT-IN-PLACE ARE TO BE CLOSED AND PLUGGED WITH 2-INCH

TIE-IN AND A SINGLE STANDARD LENGTH OF PIPE IS USED FOR COMPLETING THE CONNECTION, THEN

THE COUNTY WILL PERFORM A VISUAL INSPECTION AND A SEPARATE HYDROSTATIC TEST MAY NOT BE

IF MULTIPLE LENGTHS OF PIPES ARE USED TO COMPLETE THE CONNECTION, THEN A SEPARATE

HYDROSTATIC TEST WILL BE REQUIRED. THE HYDROSTATIC TEST SHALL BE PERFORMED BETWEEN THE

TEMPORARY JUMPER

CONNECTION NOTES

PROPOSED TIE-IN VALVE AND THE FIRST DOWNSTREAM VALVE FROM THE TEMPORARY JUMPER LOCATION.

FOR FLUSHING PURPOSES OR IF PARTIAL FIRE PROTECTION IS REQUIRED DURING INITIAL CONSTRUCTION,

BACKFLOW PREVENTION ASSEMBLY, FLOW METER, FITTINGS, VALVES, ETC., SHALL BE THE RESPONSIBILITY

CONSTRUCTION MUST SHOW CERTIFICATION THAT THEY HAVE BEEN TESTED ANNUALLY AND PASSED

ACCORDING TO THE FLORIDA BUILDING CODE, PLUMBING SECTION, CHAPTER 3, SECTION 312.9.1, 312.9.2,


CHAPTER 6. SECTION 608, AND RESOLUTION R87-125. ANNUAL CERTIFICATION MUST BE VALID AT TIME


AT A CONSTANT MEASURED RATE WHILE CHLORINATING THE NEW MAIN. THE CHLORINE CONCENTRATION


SHALL BE MEASURED AT REGULAR INTERVALS TO ENSURE THAT IT IS FED AT A CONSTANT RATE OF NOT


SHALL BE DISINFECTED BY SPRAYING OR SWABBING PER SECTION 4.6 OF AWWA C651.

OF INSTALLATION AND PROVIDED TO THE MANATEE COUNTY INSPECTOR UPON REQUEST.

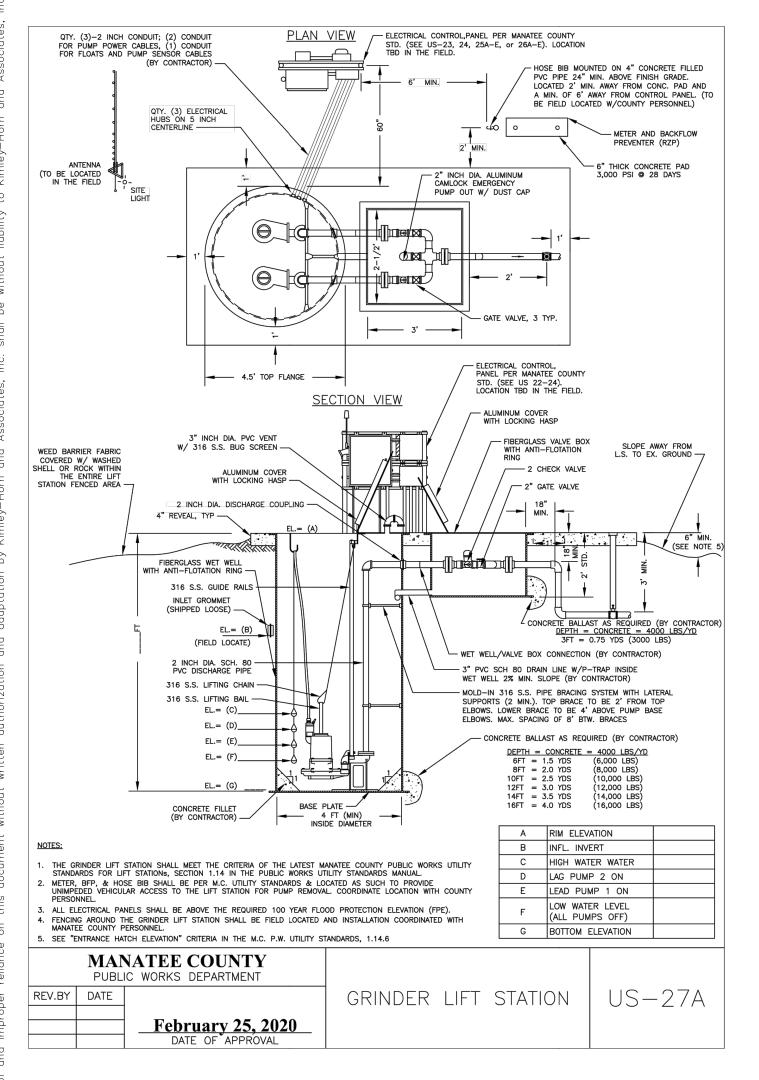

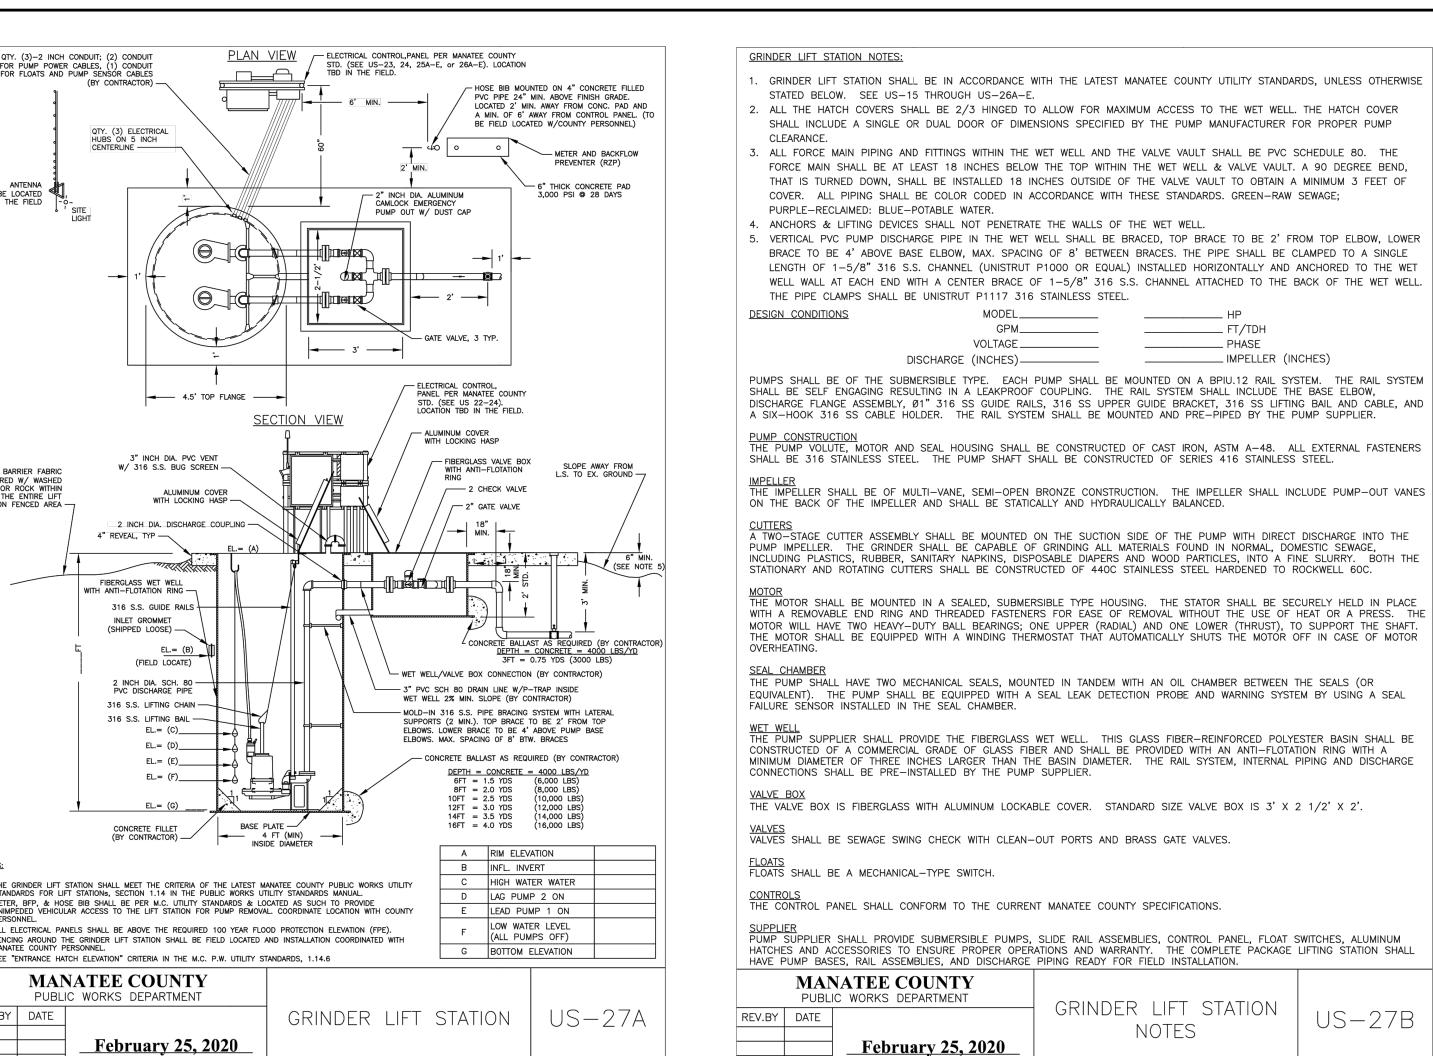

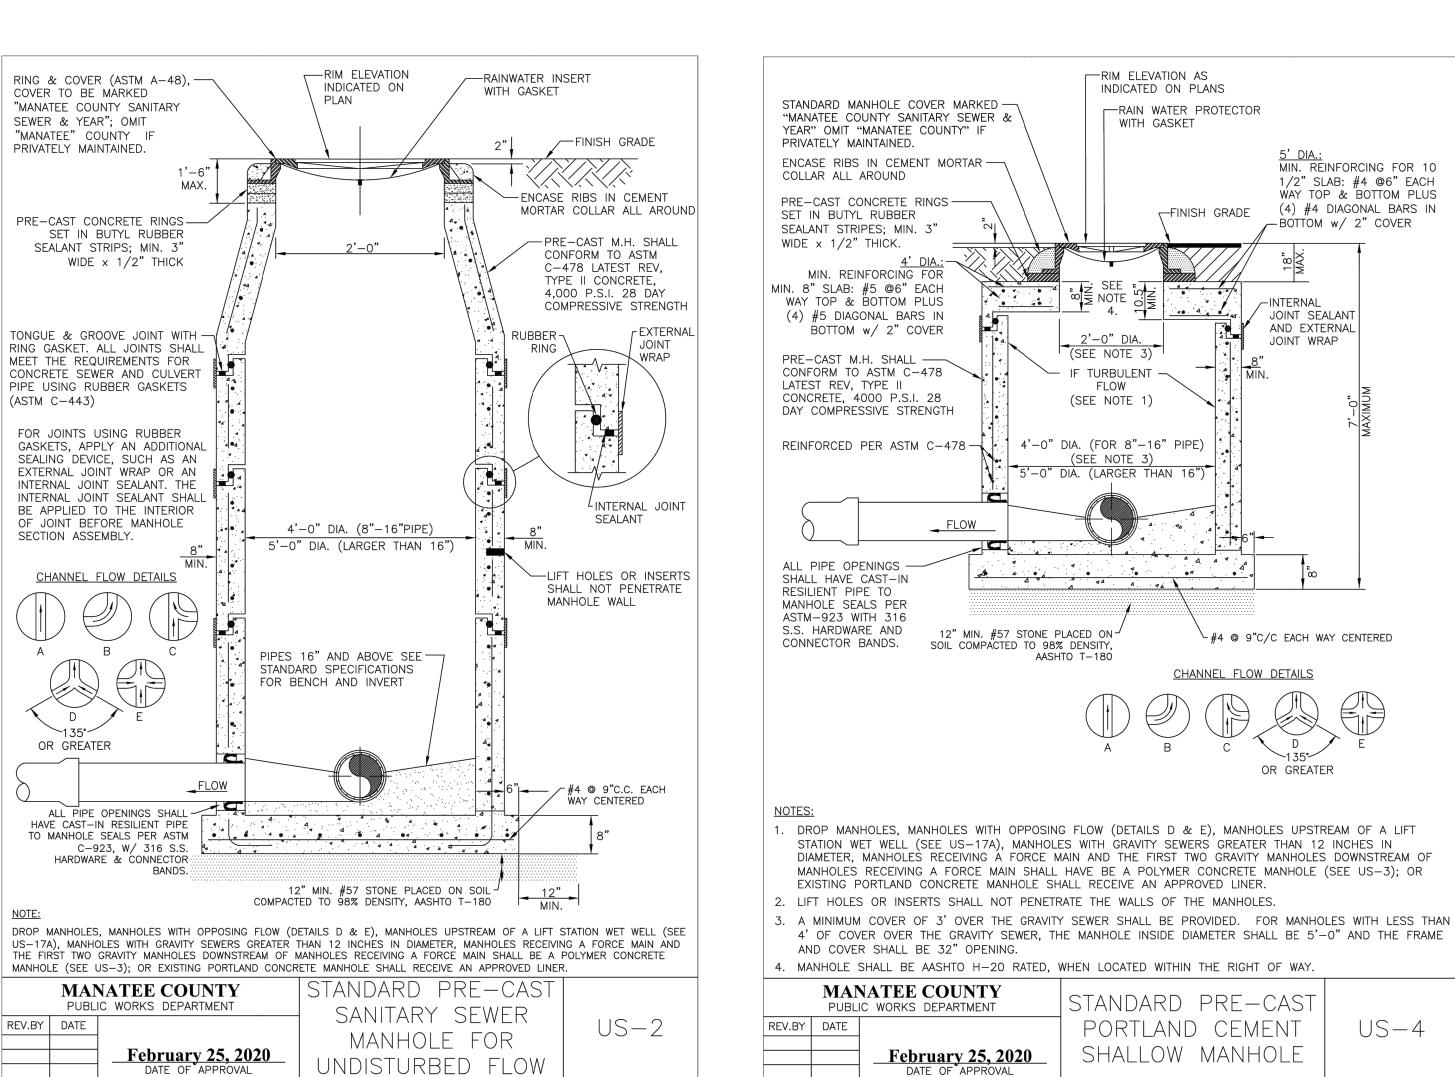

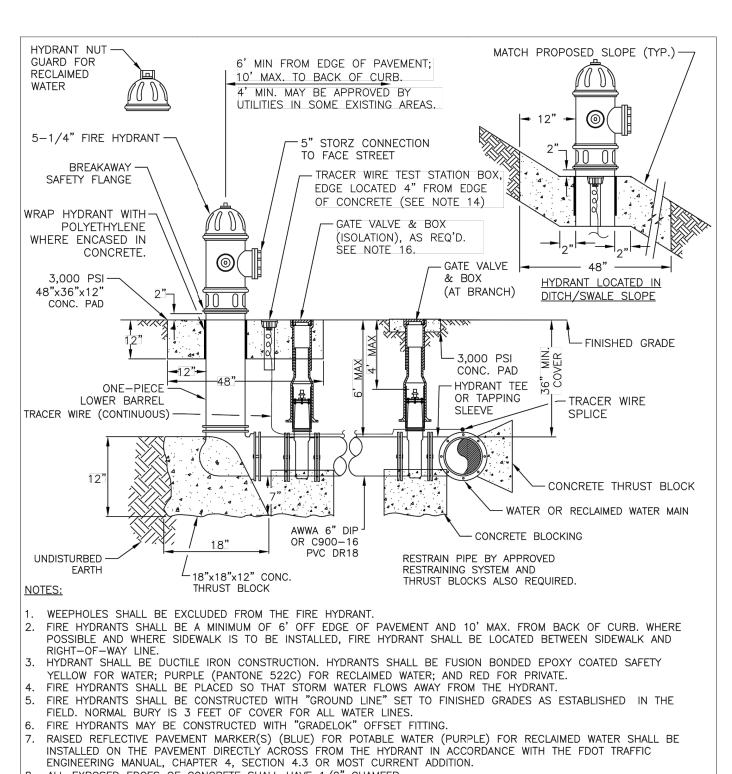

3. ALL EXPOSED EDGES OF CONCRETE SHALL HAVE 1/2" CHAMFER. . FIRE HYDRANT VALVE SHALL BE FASTENED DIRECTLY TO TEE

10. IN-LINE VALVES SHOULD BE LOCATED AT HYDRANT TEES. 11. HYDRANTS SHALL BE LOCATED ON SAME SIDE OF ROAD AS WATER OR RECLAIMED MAIN.

12. THERE MUST BE A CLEARANCE OF 7 1/2 FEET FROM FRONT AND BOTH SIDES, AND FOUR FEET TO THE REAR OF THE HYDRANT, TO ABOVE GRADE OBSTRUCTIONS INCLUDING POSTS, FENCES, TREES, ETC, PER THE FLORIDA FIRE PREVENTION CODE.

13. SEE STANDARD DETAIL UW-2 GATE VALVE, BOX, LID AND TAG. 14. SHOULD THE FIRE HYDRANT'S CONCRETE PAD OVERLAP A SIDEWALK, THE TRACER WIRE TEST STATION BOX SHALL NOT

15. IF A HYDRANT IS LOCATED ON THE SLOPE OF A DITCH OR SWALE; THE CONCRETE PAD SHALL CONFORM TO THE FINISH GRADE/SLOPE. THE CONCRETE PAD SHALL BE LEVEL 2-INCHES BEHIND & IN FRONT OF THE HYDRANT. 16. AT THÉ DISCRETION OF THE COUNTY AN ADDITIONAL ISOLATION GATE VALVE SHALL BE ADDED, WHEN A PHYSICAL

BARRIER IS PRESENT, (I.E. ROADWAY, FENCE, WALL, BERM ETC), BETWEEN THE BRANCH GATE VALVE AND THE HYDRANT. 17. SEE SECTION 1.11 HYDRANTS IN THE PUBLIC WORKS UTILITY STANDARDS MANUAL FOR FURTHER DETAILS.

			COUNTY DEPARTMENT
REV.BY	DATE		,


REV.BY DATE

February 25, 2020

US-4

FIRE HYDRANT **ASSEMBLY**

UW-5

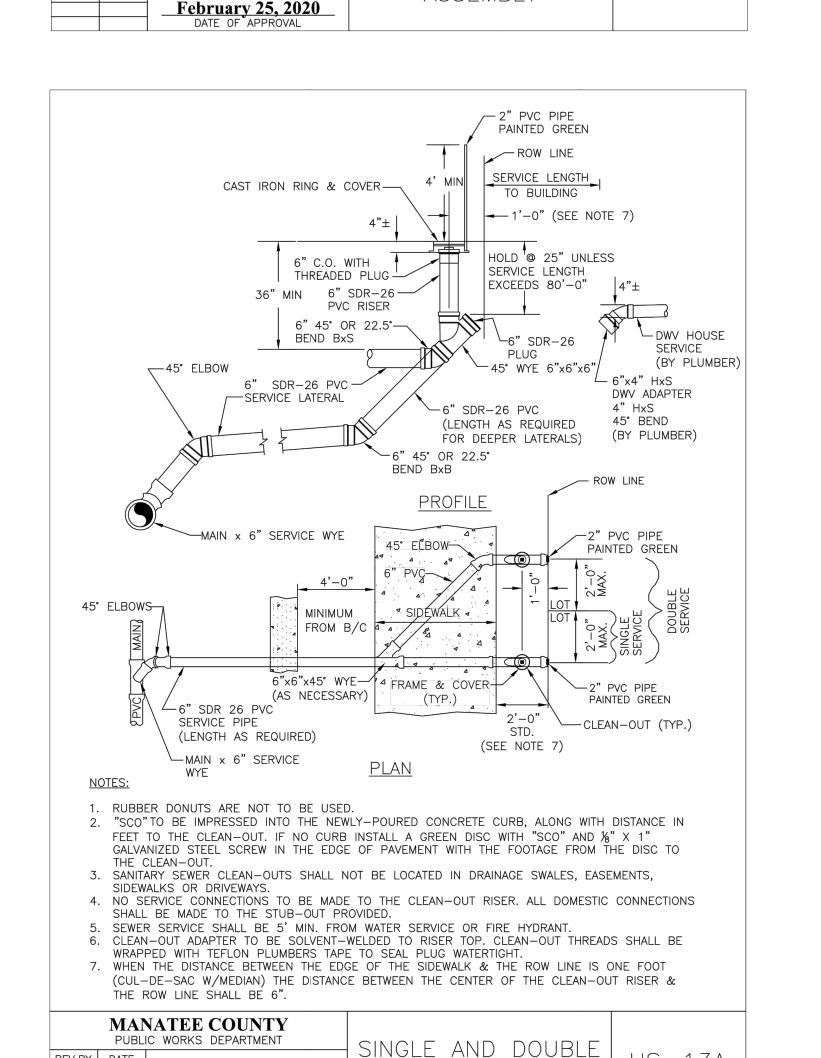



SERVICE CONNECTION

MUNI

SHEET NUMBER C-704


S

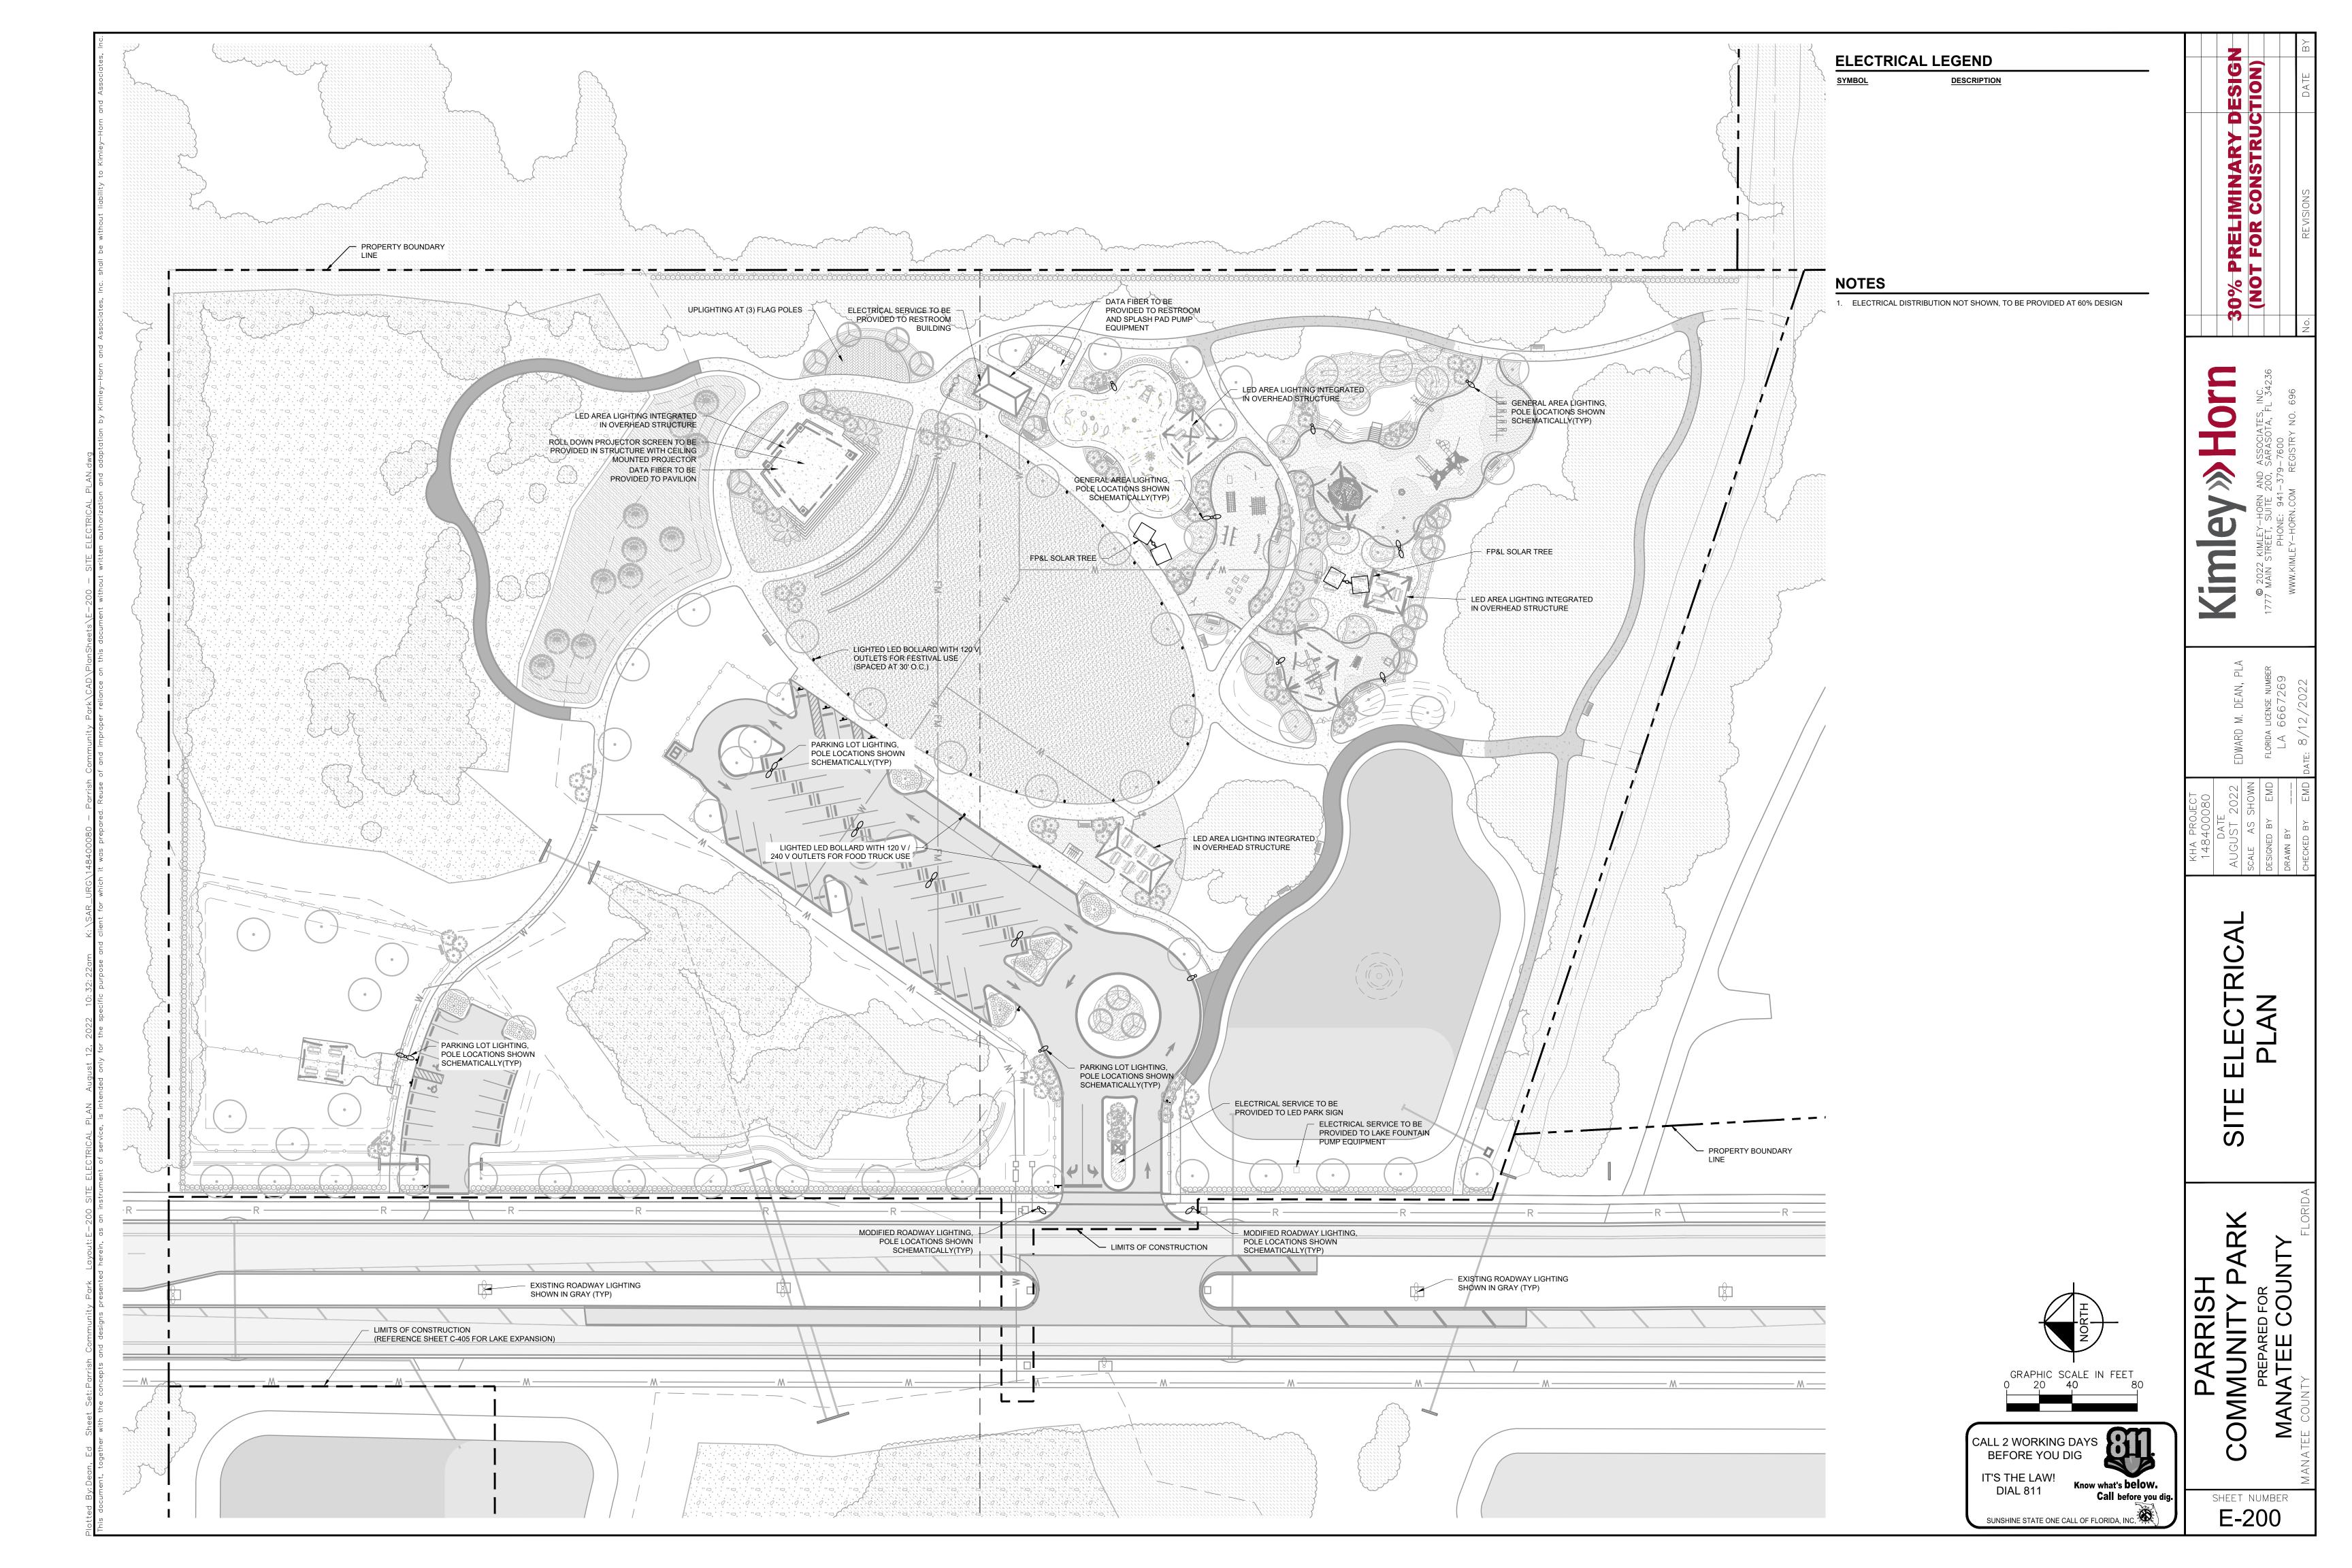

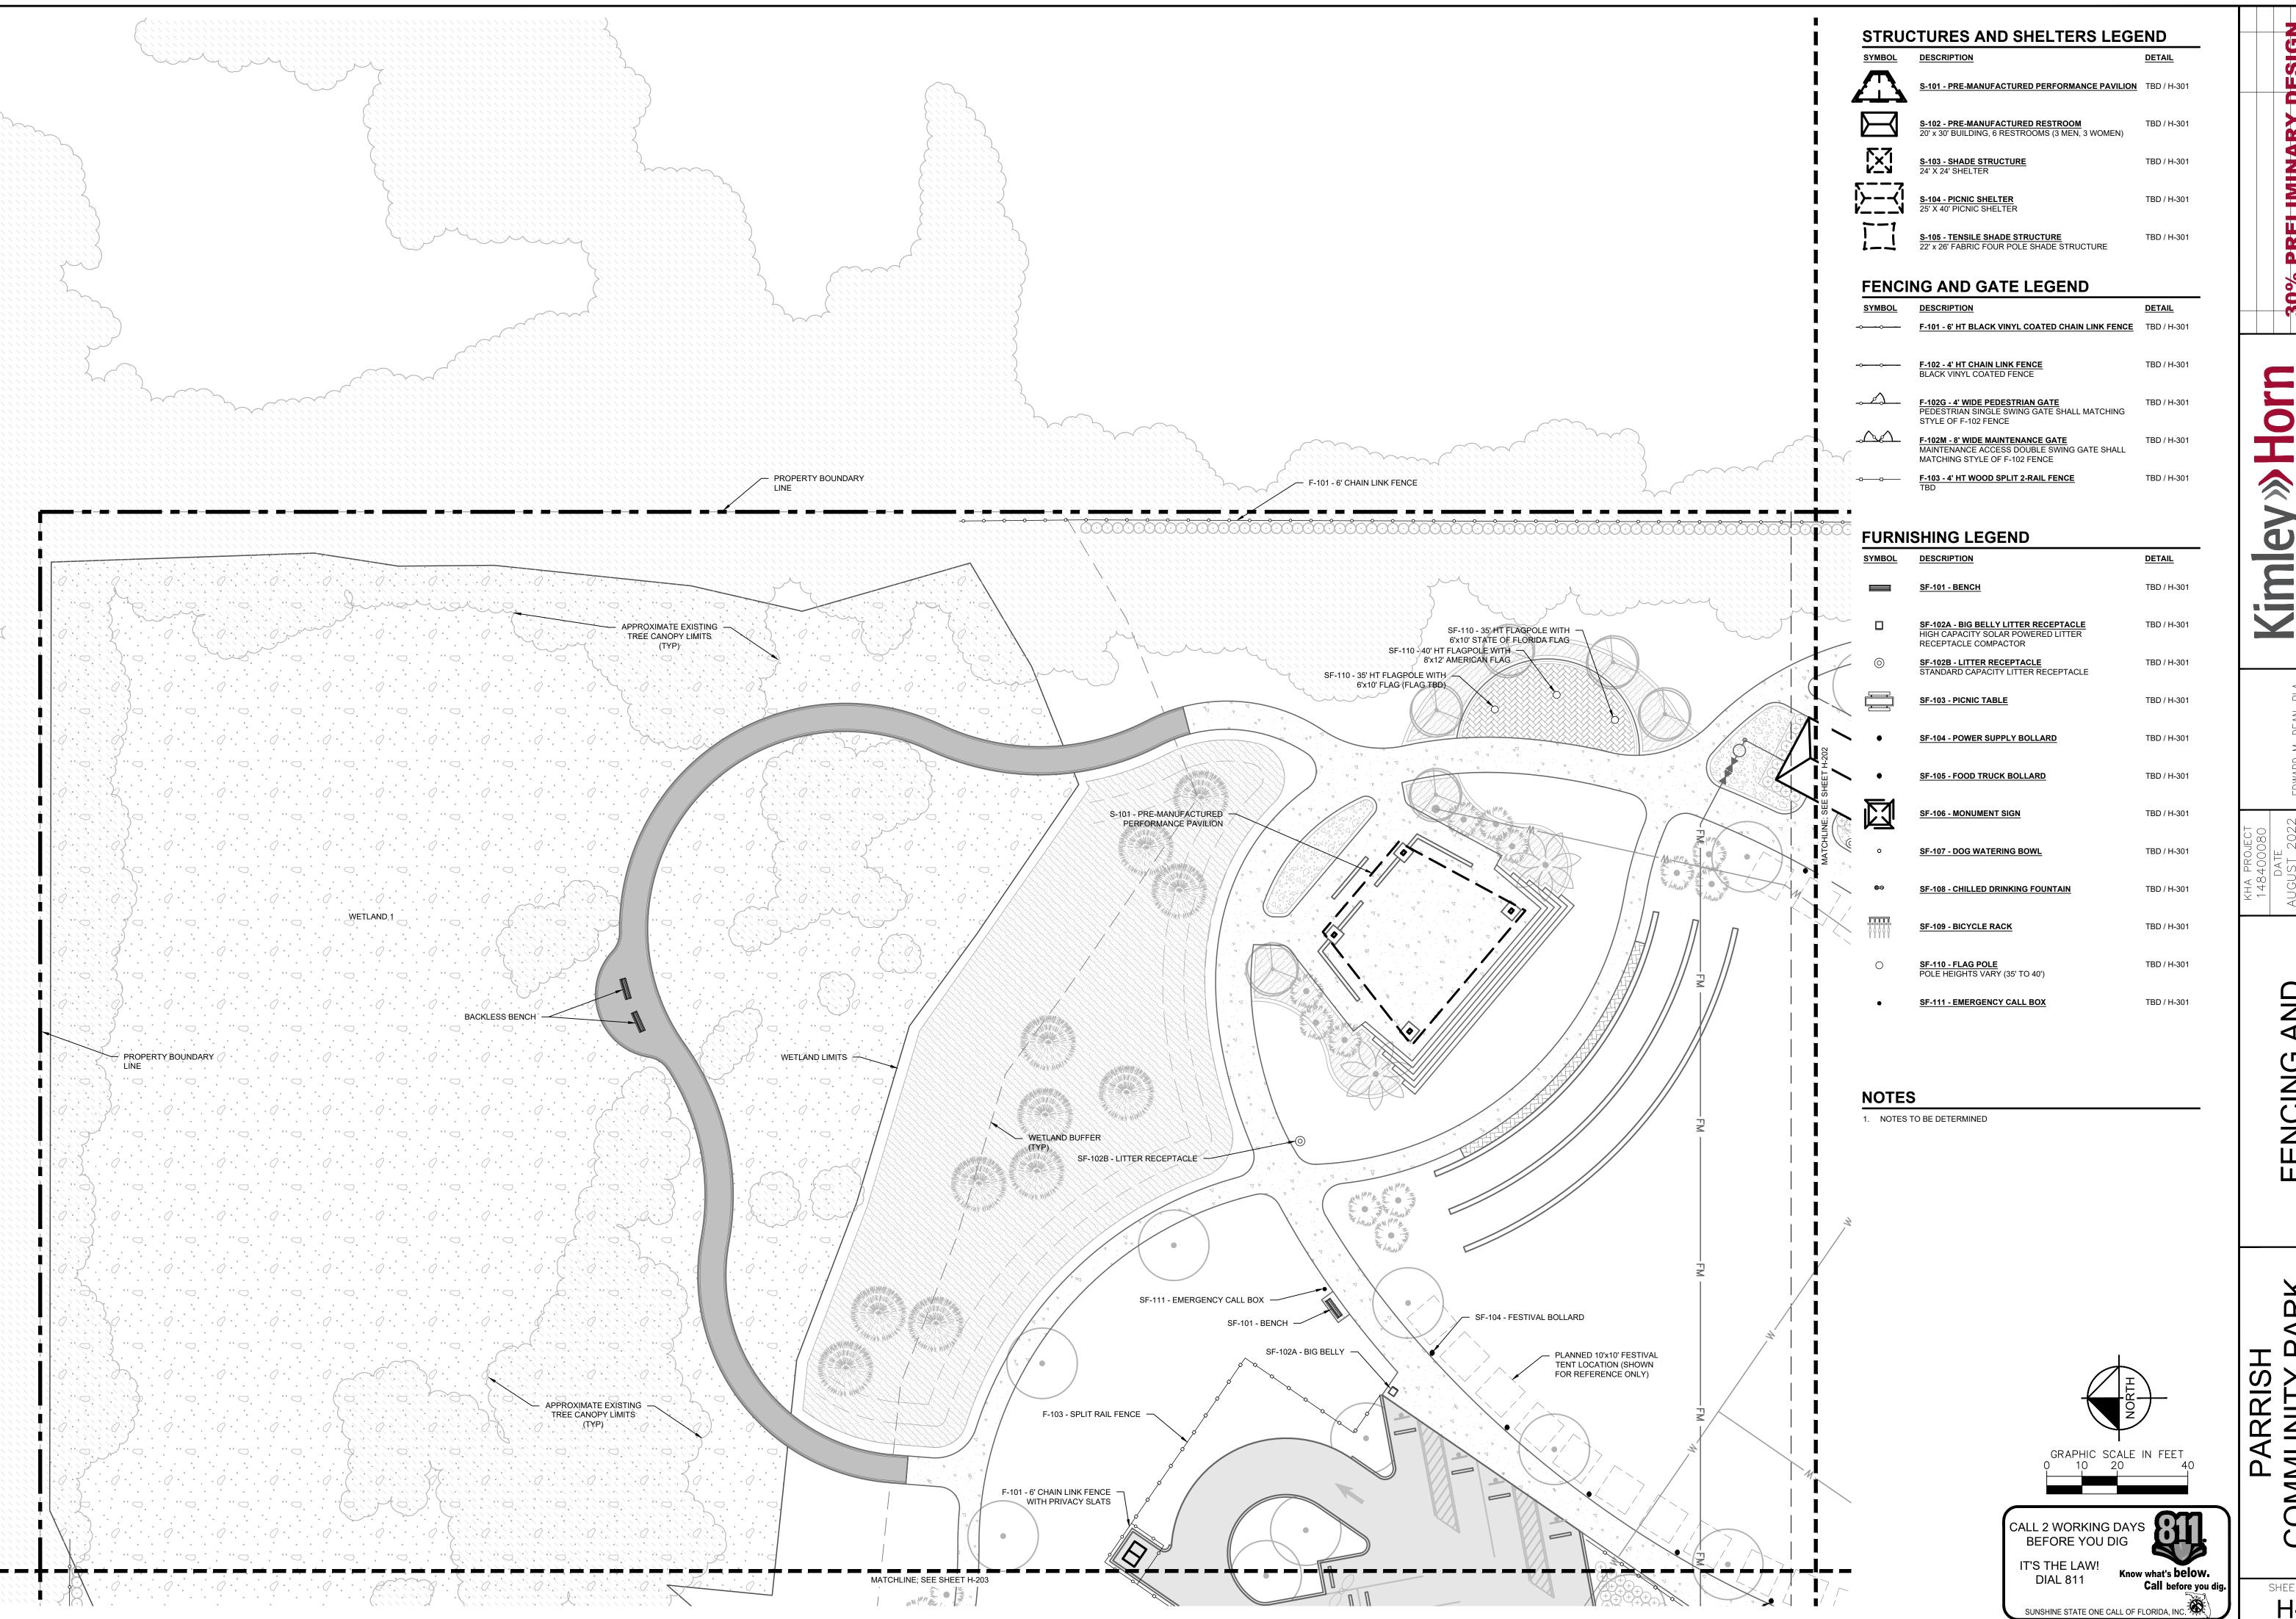


AND 3 PL/ FENCING A

LINOMMO

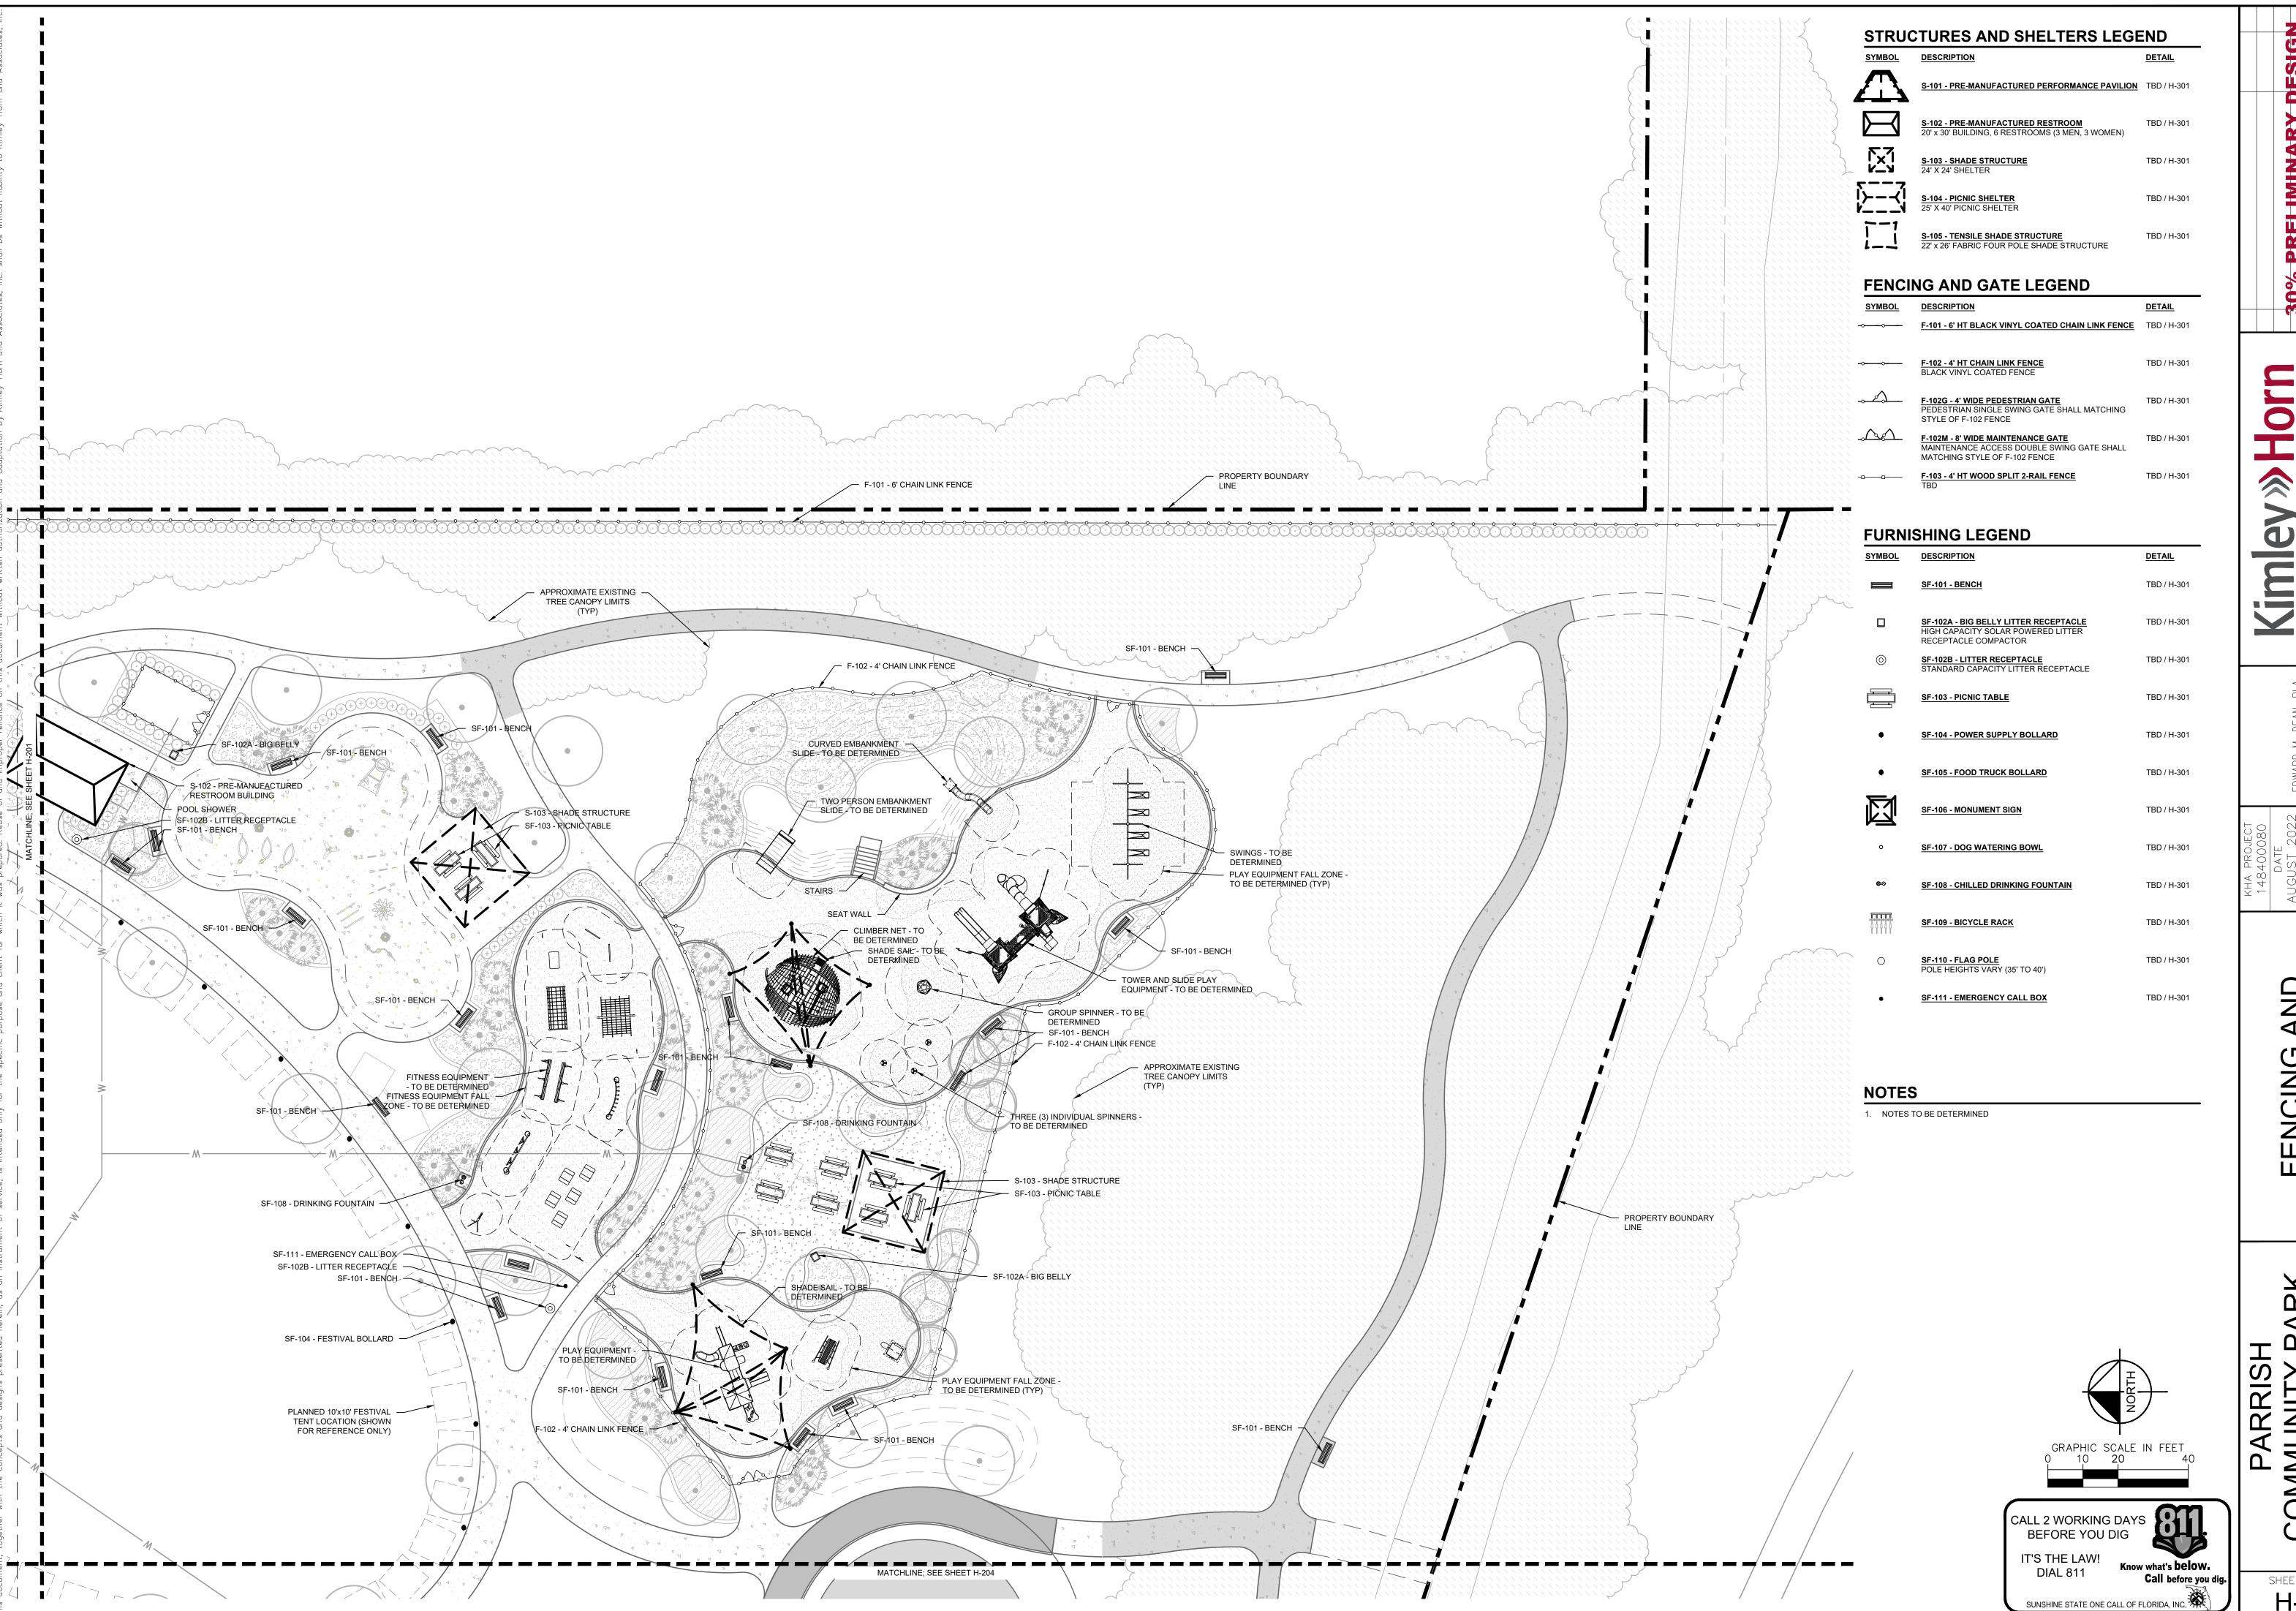


AND 3 PL/ FENCING A FURNISHING

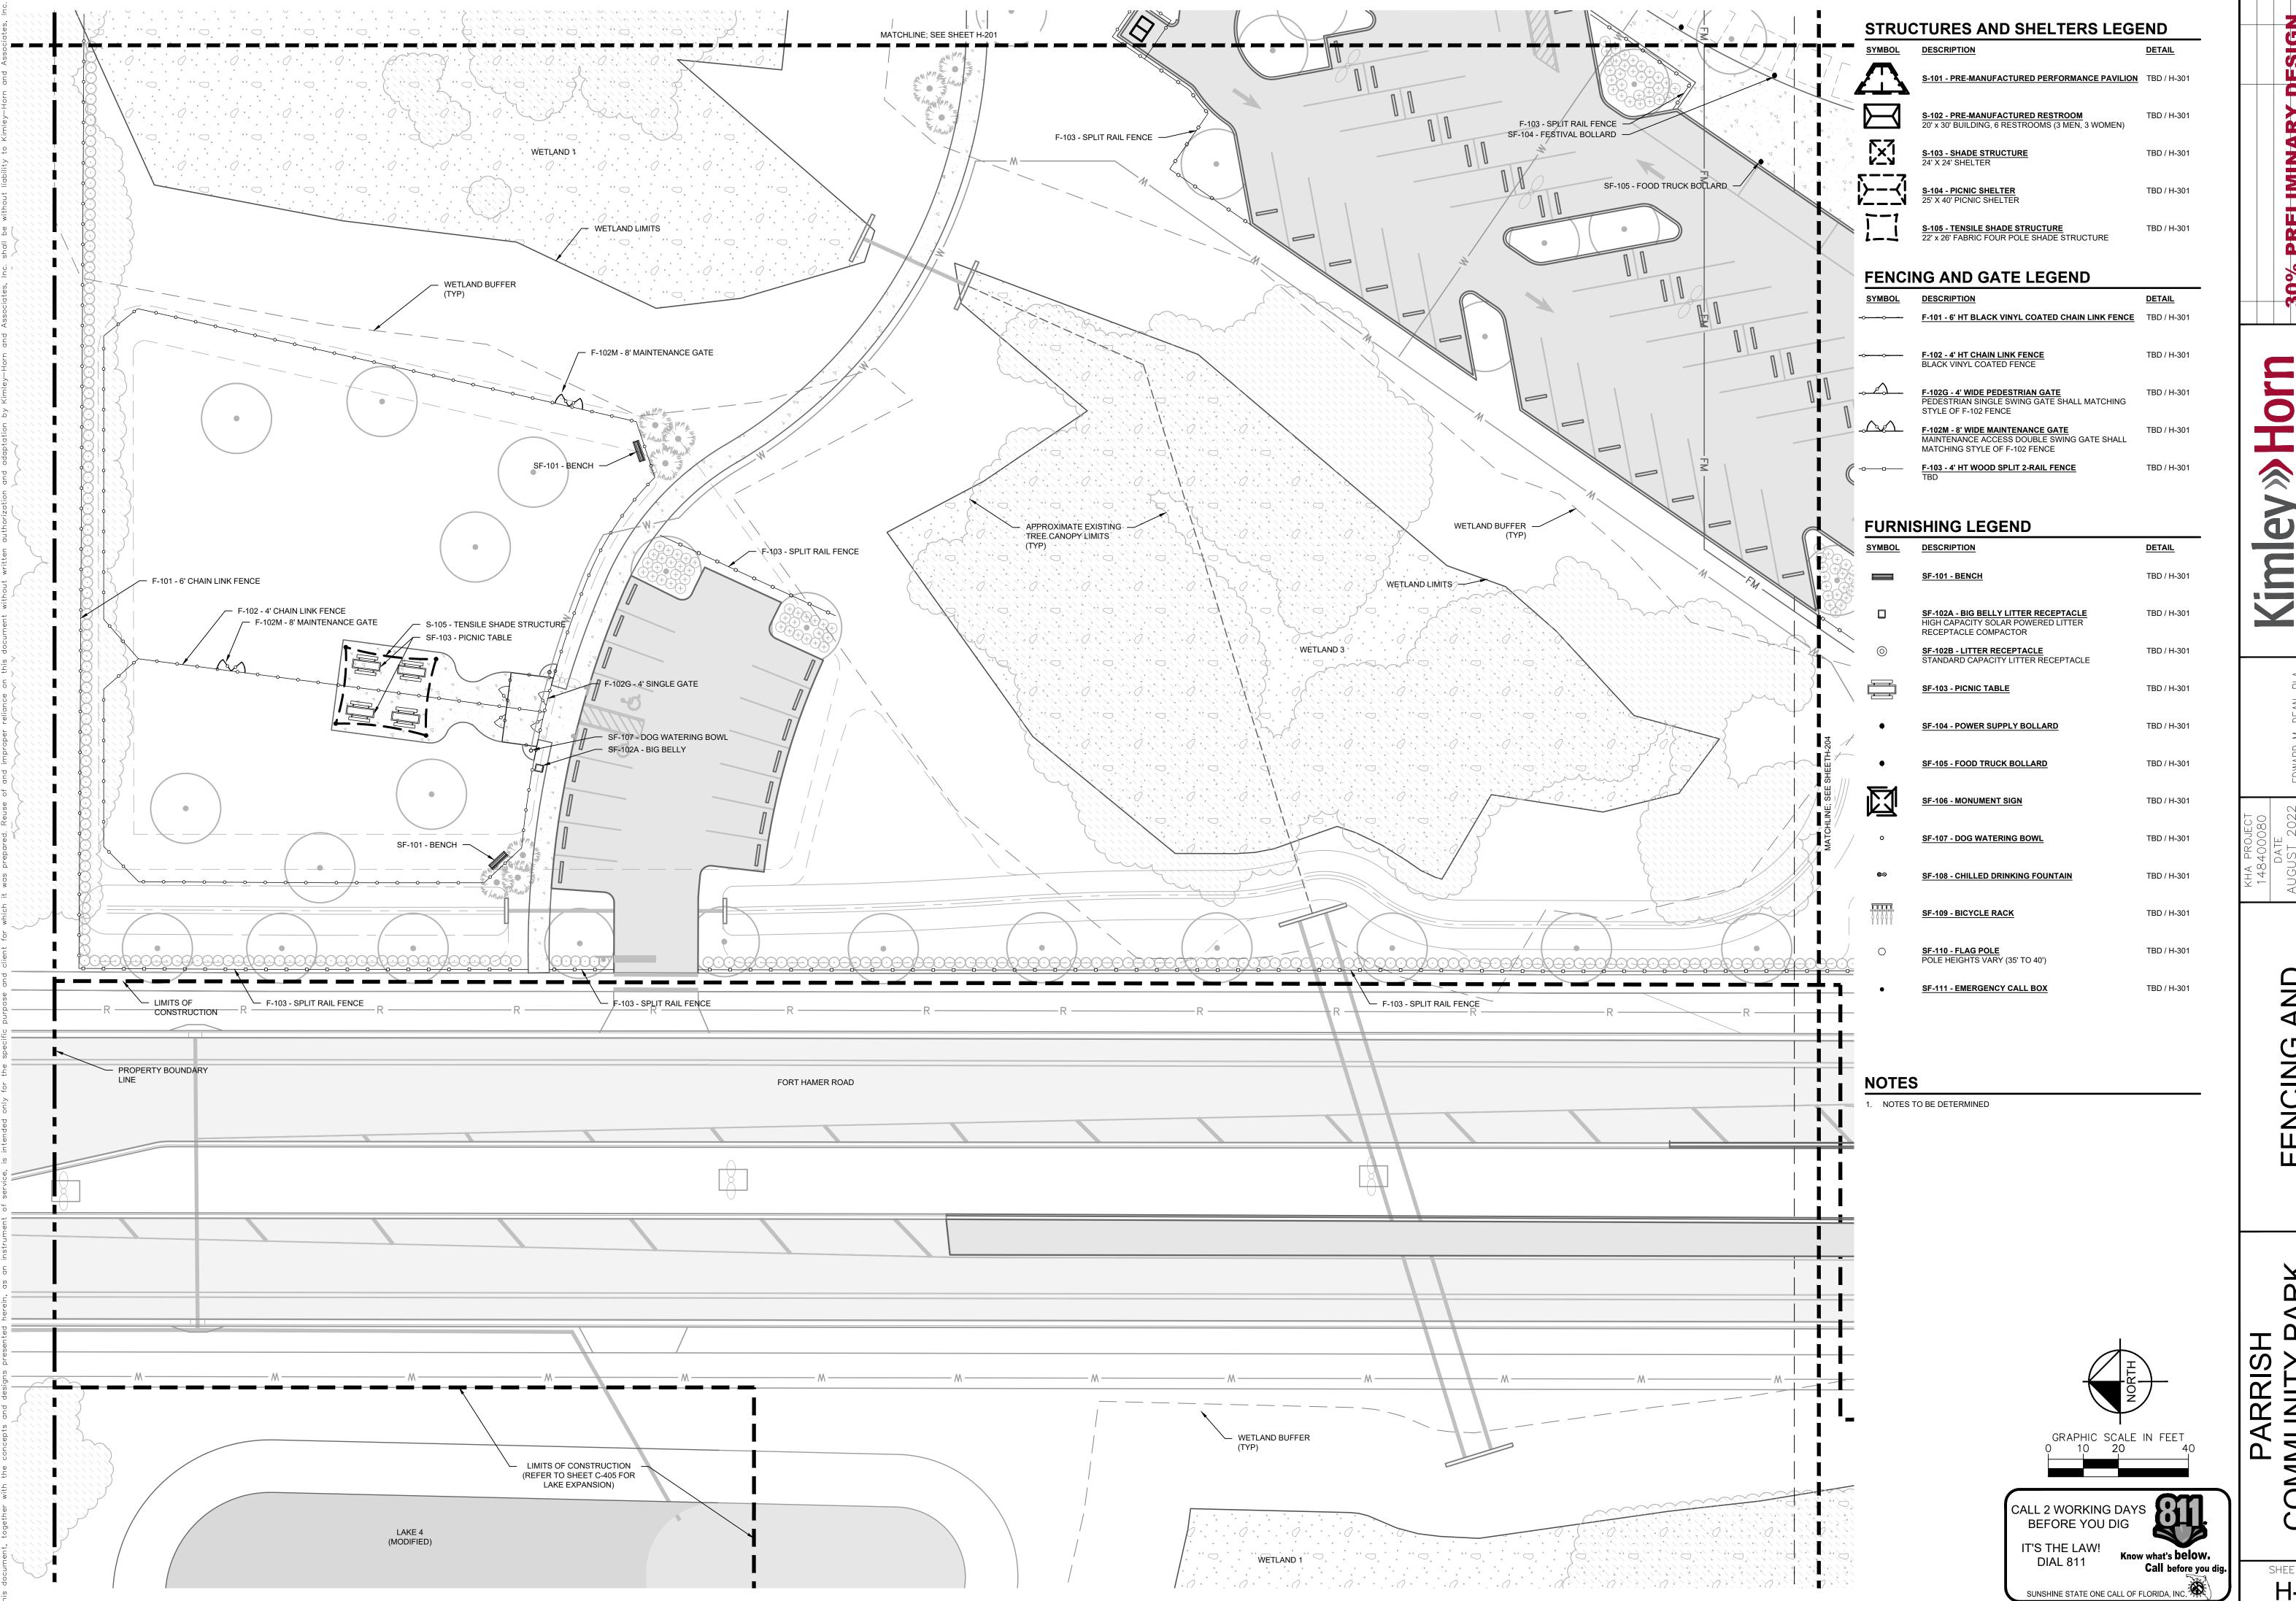


AND 3 PL/ FENCING A -URNISHING

LINOMMO

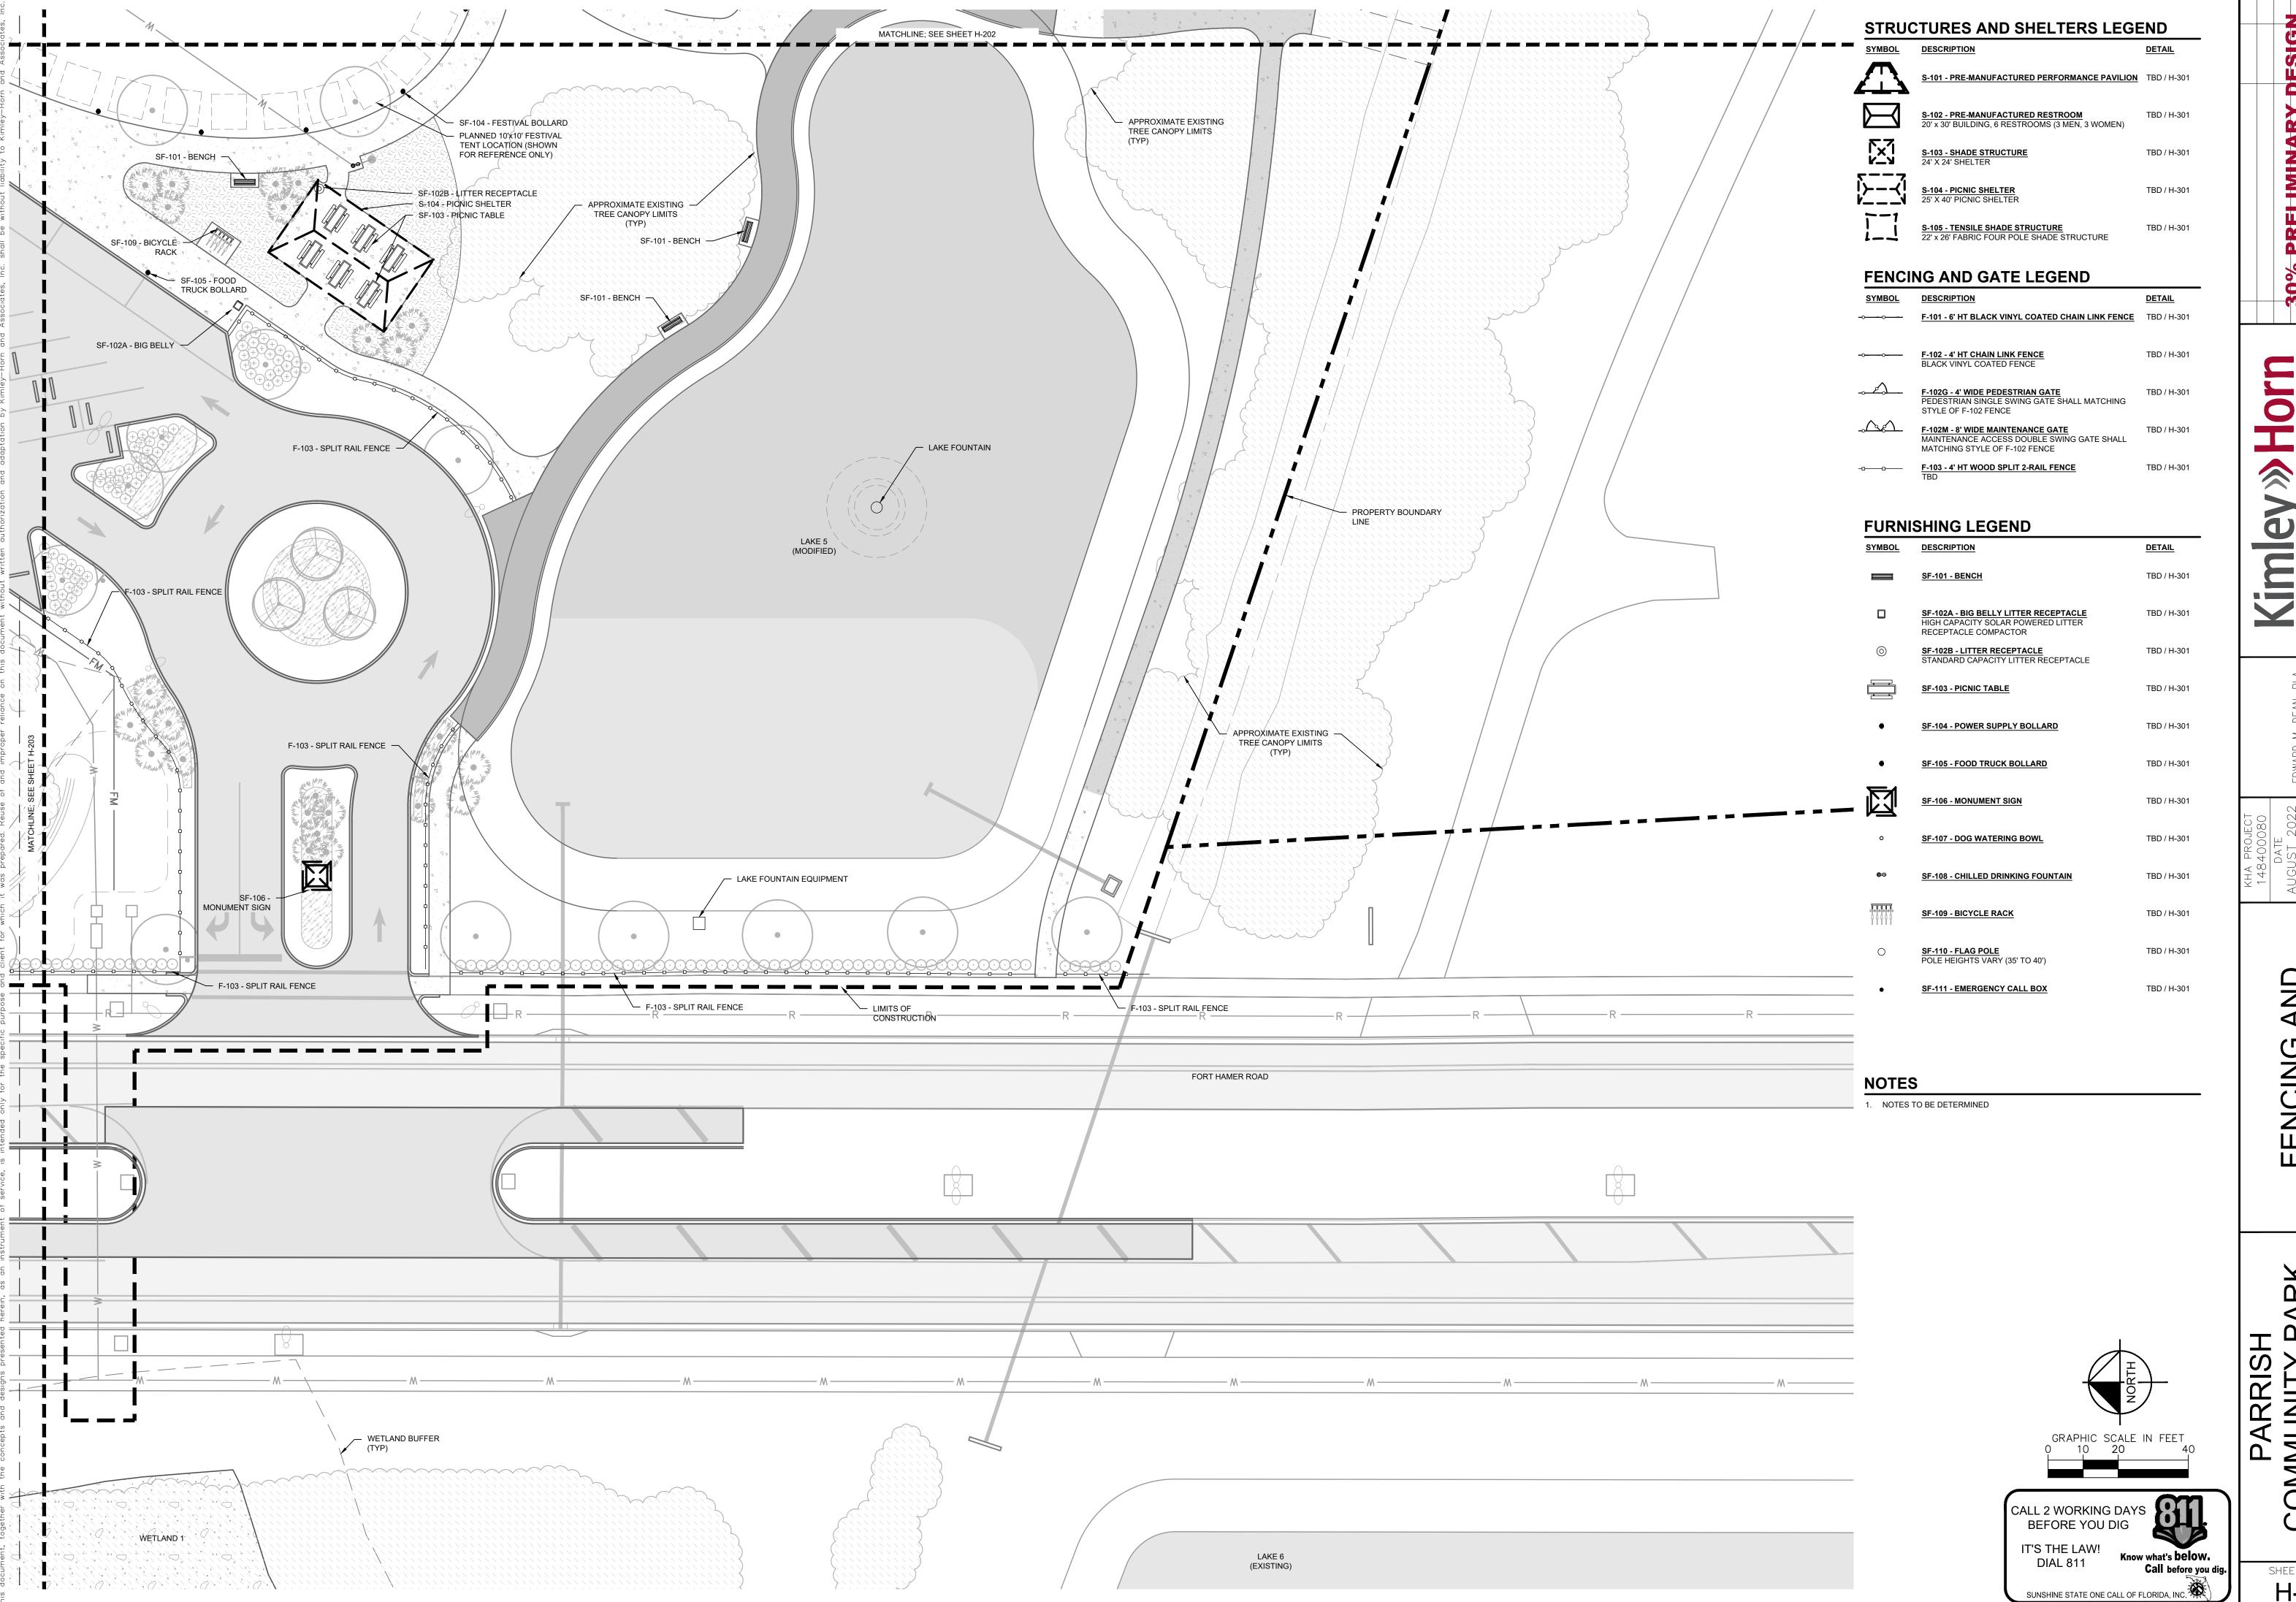

FURNISHING PL

LINOMMO

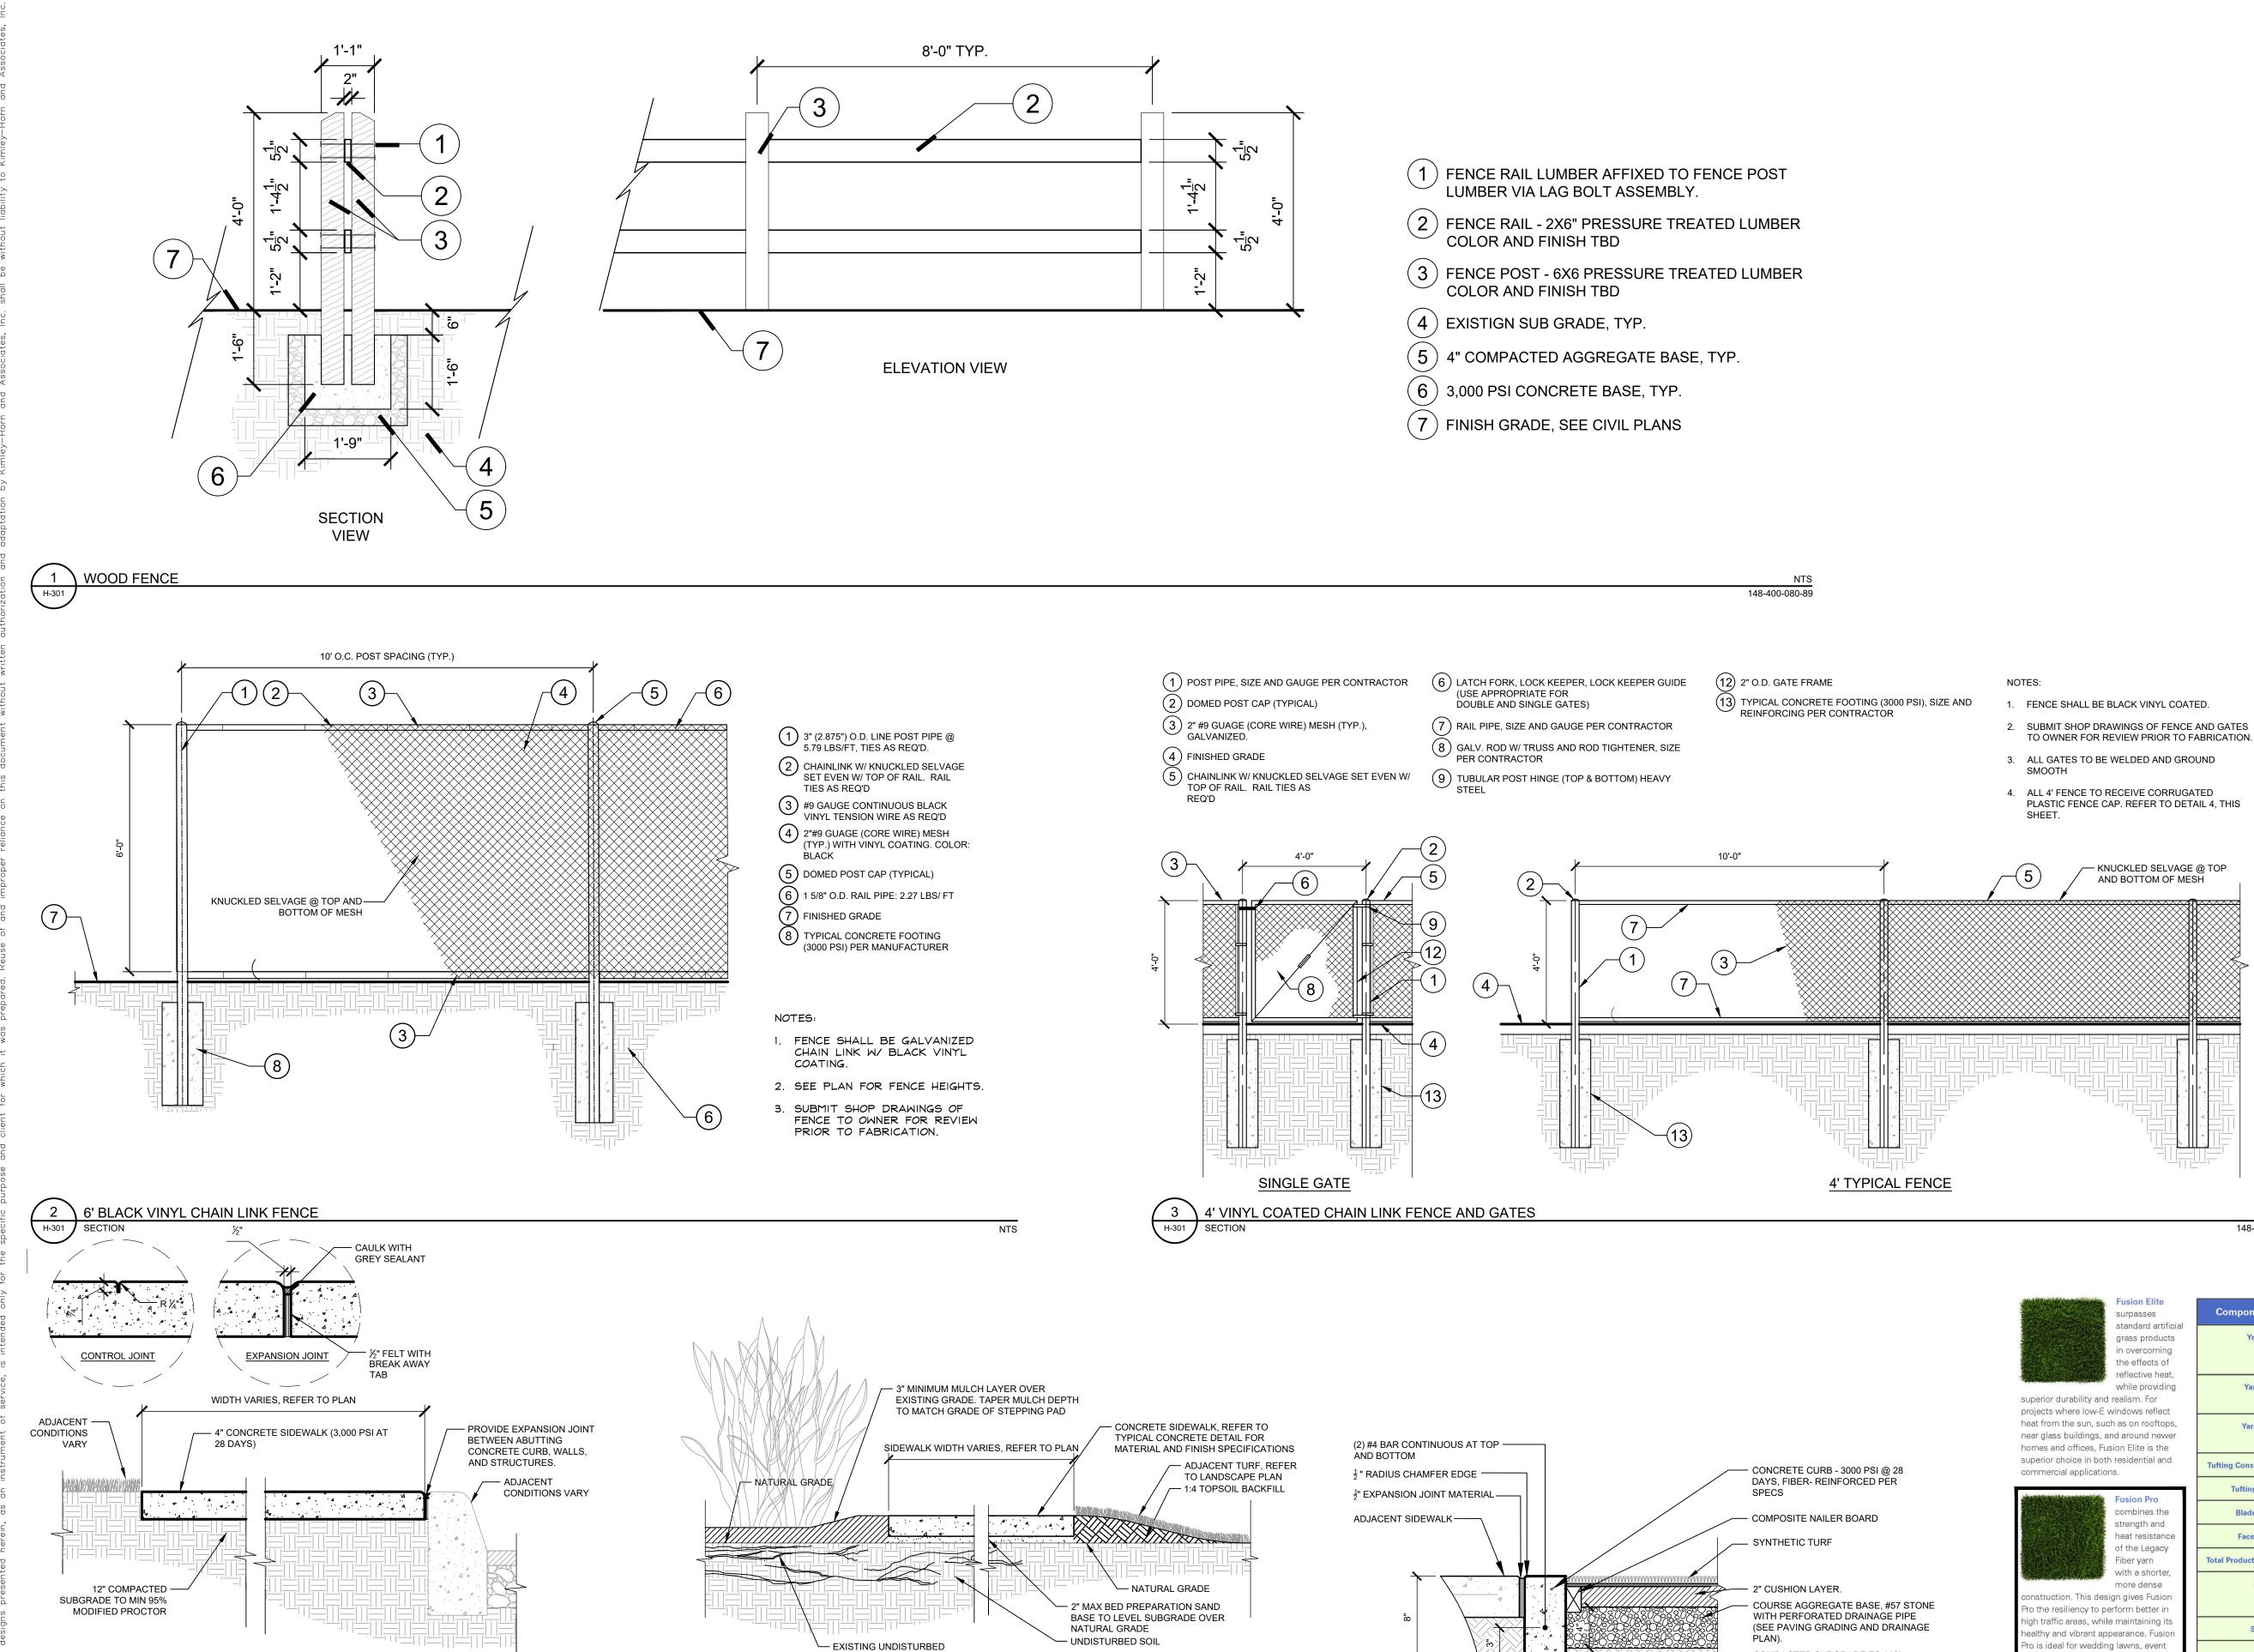

TURF EDGE CONDITION

3/4" = 1'-0" 148-400-080-28

TREE ROOTS

CONCRETE SIDEWALK ON GRADE

1. SIDEWALK PROPOSED OVER AREA EXPECTED TO CONTAIN TREE ROOTS. EXISTING TREE ROOTS NOT TO BE

LANDSCAPE BED EDGE CONDITION

DISTURBED.

1. PROVIDE CONTROL JOINTS AT 5'-0" CENTER TO CENTER ON SIDEWALKS (NOT LESS THAN 4' AND NOT GREATER

2. PROVIDE EXPANSION JOINTS WHERE SIDEWALK ABUTS CONCRETE CURBS, DRIVEWAYS AND SIMILAR

STRUCTURES AS WELL AS A MAXIMUM OF 20-0" ON CENTER ON SIDEWALKS.

THAN 10' ALONG CURVES)

3. ALL EXPOSED EDGES TO RECEIVE 1/4" CHAMFER.

4 \ TYPICAL CONCRETE SIDEWALK

standard artificia grass products he effects of eflective heat, Primary: Verde/lime/tan superior durability and realism. For projects where low-E windows reflect heat from the sun, such as on rooftops, Primary: 9200/8 near glass buildings, and around newer Secondary: 4950/9 Secondary: 4950/9 homes and offices, Fusion Elite is the superior choice in both residential and commercial applications. **Tufting Gauge** combines the strength and heat resistant Face Weight of the Legacy Fiber yarn with a shorter, more dense including BioCel™polyureth including BioCel™ polyuretha nstruction. This design gives Fusior and geotex non-woven fabr and geotex non-woven fabri Pro the resiliency to perform better in high traffic areas, while maintaining its Micromechanical bonding nealthy and vibrant appearance. Fusior Pro is ideal for wedding lawns, event centers, in front of stores, and other

COMPACTED SUBGRADE TO 98%

PER ASTM D-1557.

1. EXPANSION JOINTS @ 30' O.C., CONTROL JOINTS @ 10' O.C. MAX.

STANDARDS FOR FALL HEIGHT OF PLAYGROUND EQUIPMENT.

6 \ RIBBON CURB / ARTIFICIAL TURF PLAY SURFACE

FOR APPROVAL PRIOR TO CONSTRUCTION

DETAIL__X_

H-301

2. CURB COLOR TO BE NATURAL CONCRETE. SUBMIT ADMIXTURE AND SEALANT SAMPLES

4. BASE MAT THICKNESS TO BE COORDINATED WITH PLAYGROUND DESIGN TO MEET NPSI


3. PLAYGROUND UNDER DRAINS TO BE COORDINATED WITH PLAYGROUND DESIGN


MIN. MODIFIED PROCTOR DENSITY


SPECIFICATION: FUSION	N PRO
BLADE HEIGHT: 1 1/4"	
BACKING: THREE LAYER	R PREMIUM POLYURETHANE AND GEOTEX
NON-WOVEN FABRIC BA	ACKING
NFILL: NONE, INSTALL \	VITHOUT INFILL
NSTALLATION: REFER	TO DETAIL 6 THIS SHEET.

148-400-080-78 H-301

5

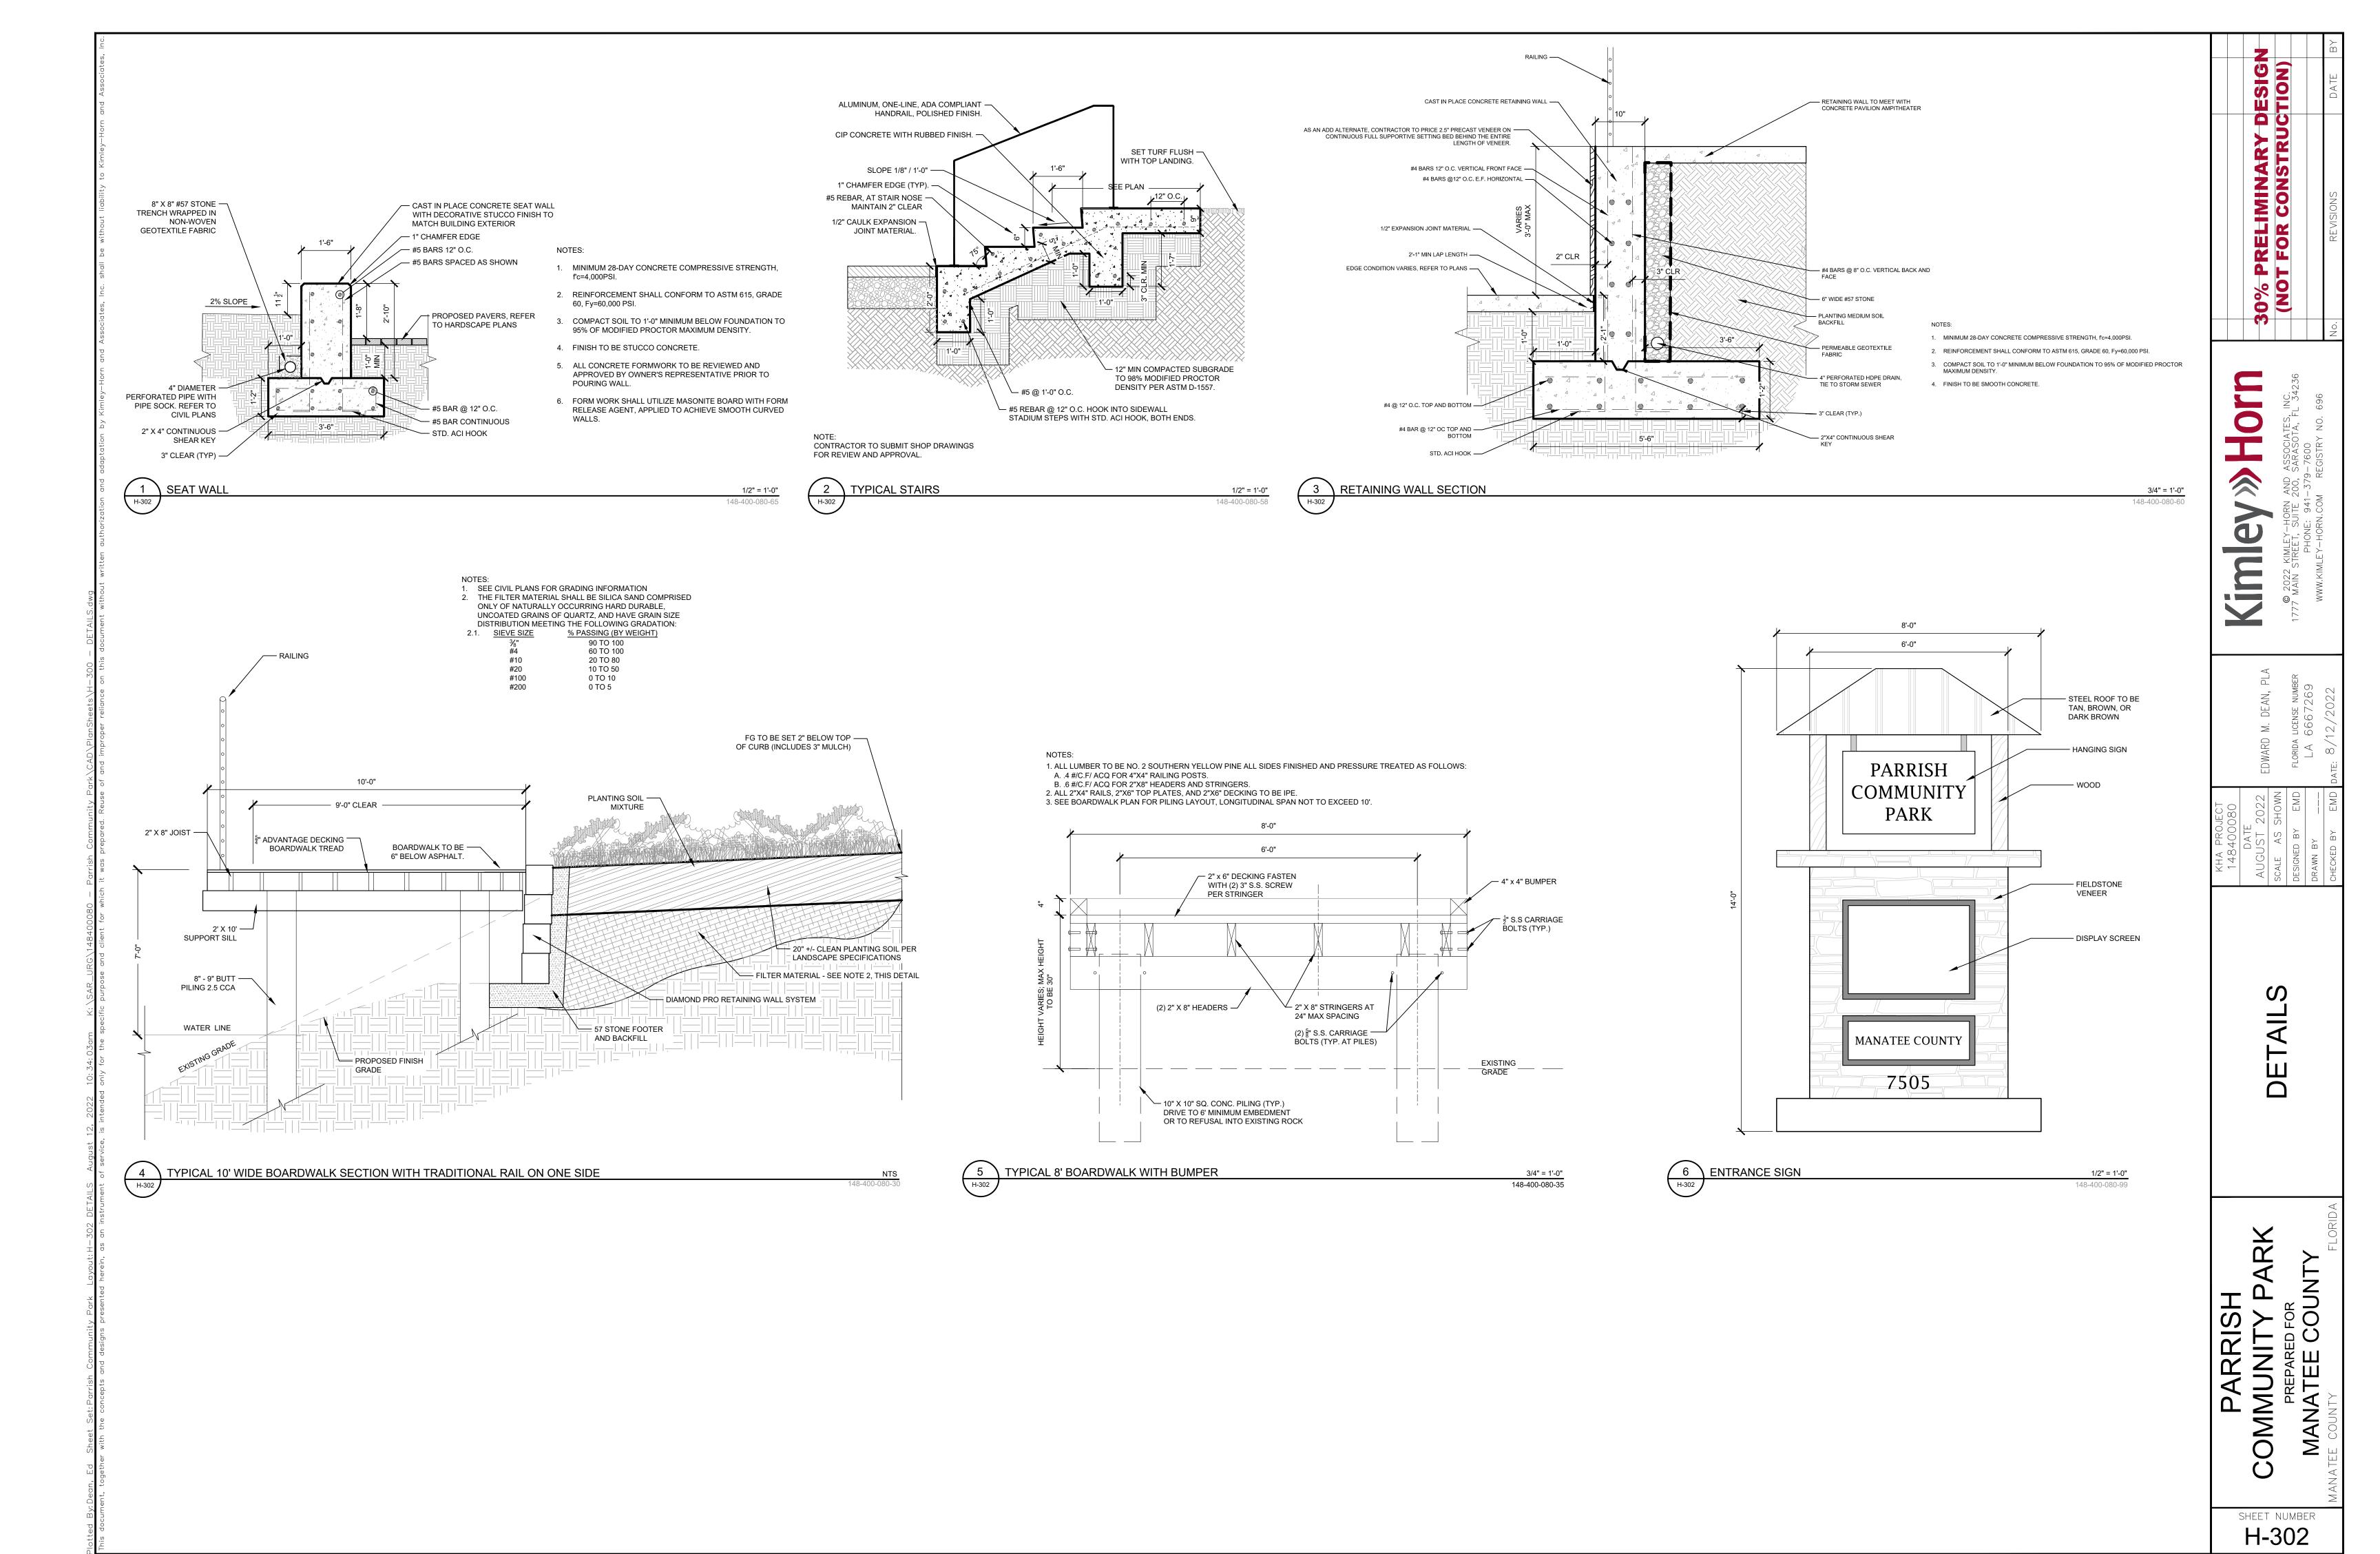

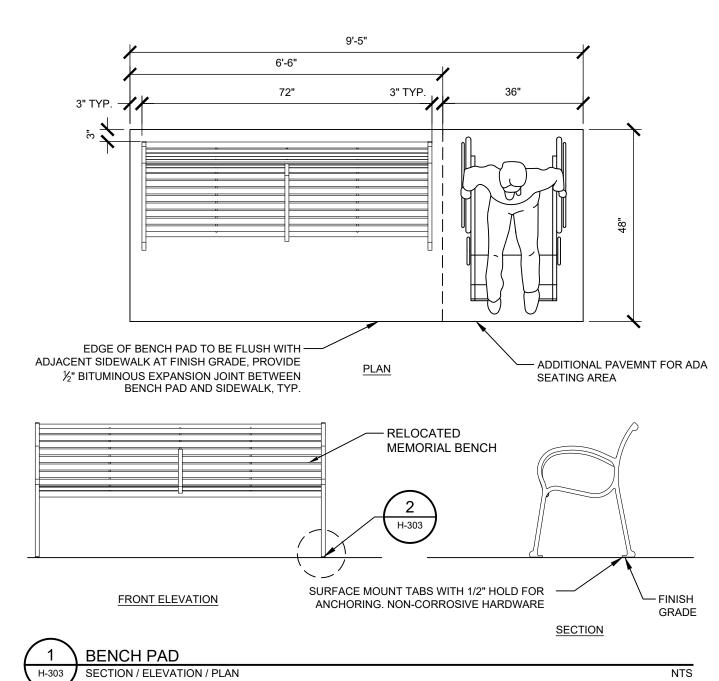

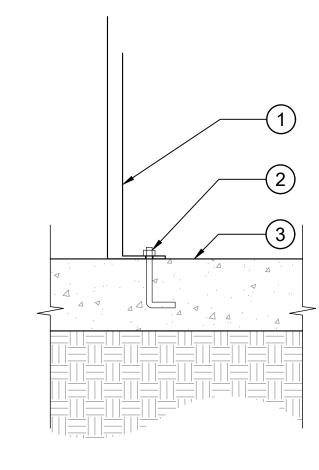

1 PROPOSED FURNISHING


(2) THREADED ANCHOR BOLT WITH TAMPER-PROOF LOCKING STAINLESS STEEL NUT. SIZE PER MANUFACTURER (3) 6" CONCRETE SIDEWALK/ PAD


1. CONTRACTOR TO SUBMIT SHOP DRAWINGS OF SURFACE MOUNTING DETAIL. 2. INSTALL PER MANUFACTURER SPECIFICATION.





MANUFACTURER: BELSON OUTDOORS (OR APPROVED EQUAL)
MODEL: E-SERIES ROUND STEEL TRASH RECEPTACLE MODEL NO: 358H-RDEP COLOR: BLUE INSTALLATION: FREE STANDING

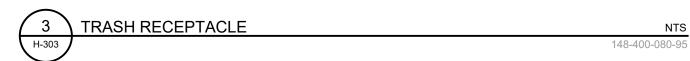

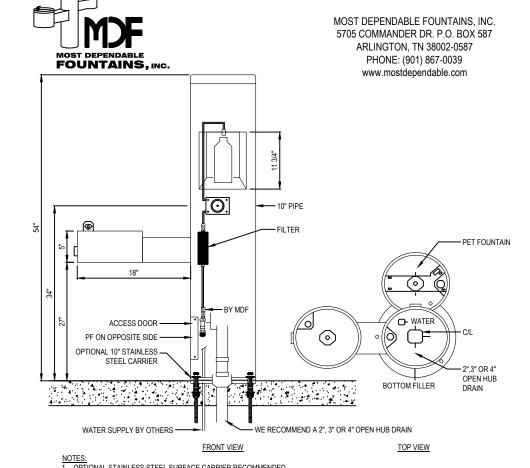

MODEL 10155SM 10155SM SHOWN WITH OPTIONAL 10" SS SURFACE CARRIER

MODEL: 10155SM
FINISH: TBD PROTECTED BY COPYRIGHT ©2022 CADDETAILS.COM LTD.

MANUFACTURER: MOST DEPENDABLE FOUNTAINS, INC MOUNT: PER MANUFACTURER SPECIFICATIONS, INCLUDE OPTIONAL 10" STAINLESS STEEL CARRIER *OR APPROVED EQUAL*

DRINKING FOUNTAIN

High Capacity Station (HC5)

Bigbelly's HC5 is a smart, solar-powered, compacting waste or recycling station. This compacting model holds 5x more than the average 30-gallon traditional waste bin and is equipped with sensors that monitor and report fullness levels and collection activity. It harvests solar power to compact waste and communicate its real-time status. The HC5's enclosed hopper (opening) design ensures total waste containment. This model maintains the durable, high quality and design integrity of all Bigbelly smart stations, and can be customized based on waste stream, options, and accessories.



COMPACTOR

Technical Specifications



POWERED

4 BIG BELLY TRASH RECEPTACLE



SENSING



Overall Machine Dimensions Height: 49.8" (1264 mm)

Width: 25" (635 mm)

Depth: 26.8" (681 mm)

Weight: 270 lbs (122 kg)

Shipping weight: 300 lbs (136.08 kg)

Bin Dimension: 24" x 20.4" x 21.65"

Waste Streams: Mixed Waste Trash, Single Stream Recycling, or Compost (with appropriate markings).

Options: Diagram to left shown with Foot Pedal.

See options and accessories on next page.

(609 mm x 518 mm x 549 mm)








Handle Height (ADA Compliant): 43.1" (1095 mm) Hopper Opening: 6" x 17" (152 mm x 432 mm) Bin Volume: 33 gallons (125 L) compacted trash; approx.150 gallons (568 L) uncompacted trash.

CONNECTION

DET

PARRISH LINOMMO

> SHEET NUMBER H-303

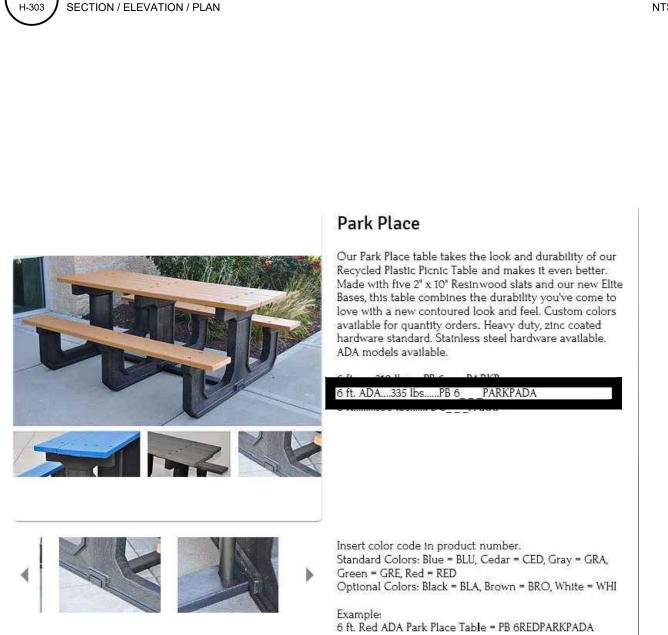



MOUNTING INFO: -Surface Elite Bolt (PB 1008JAY)


-In-Ground J-Bolt (PB 1999)


5 CITY STANDARD PICNIC TABLE

NOTE: SURFACE MOUNT PER DETAIL 2, SHEET H-303.

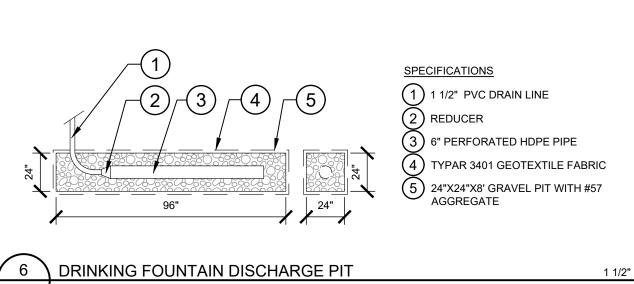


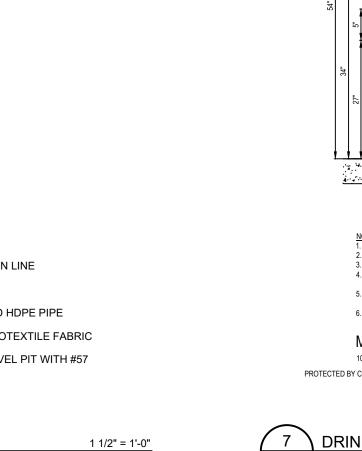

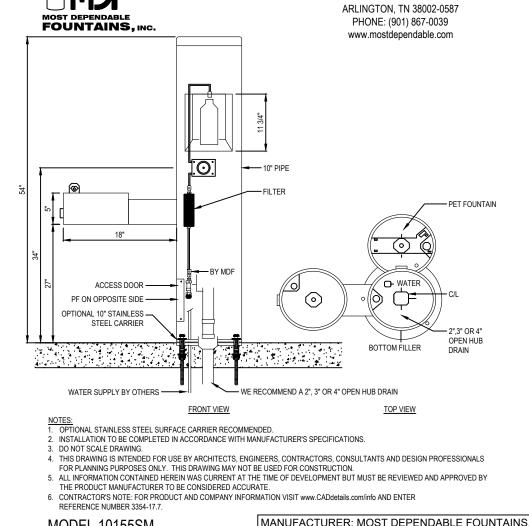


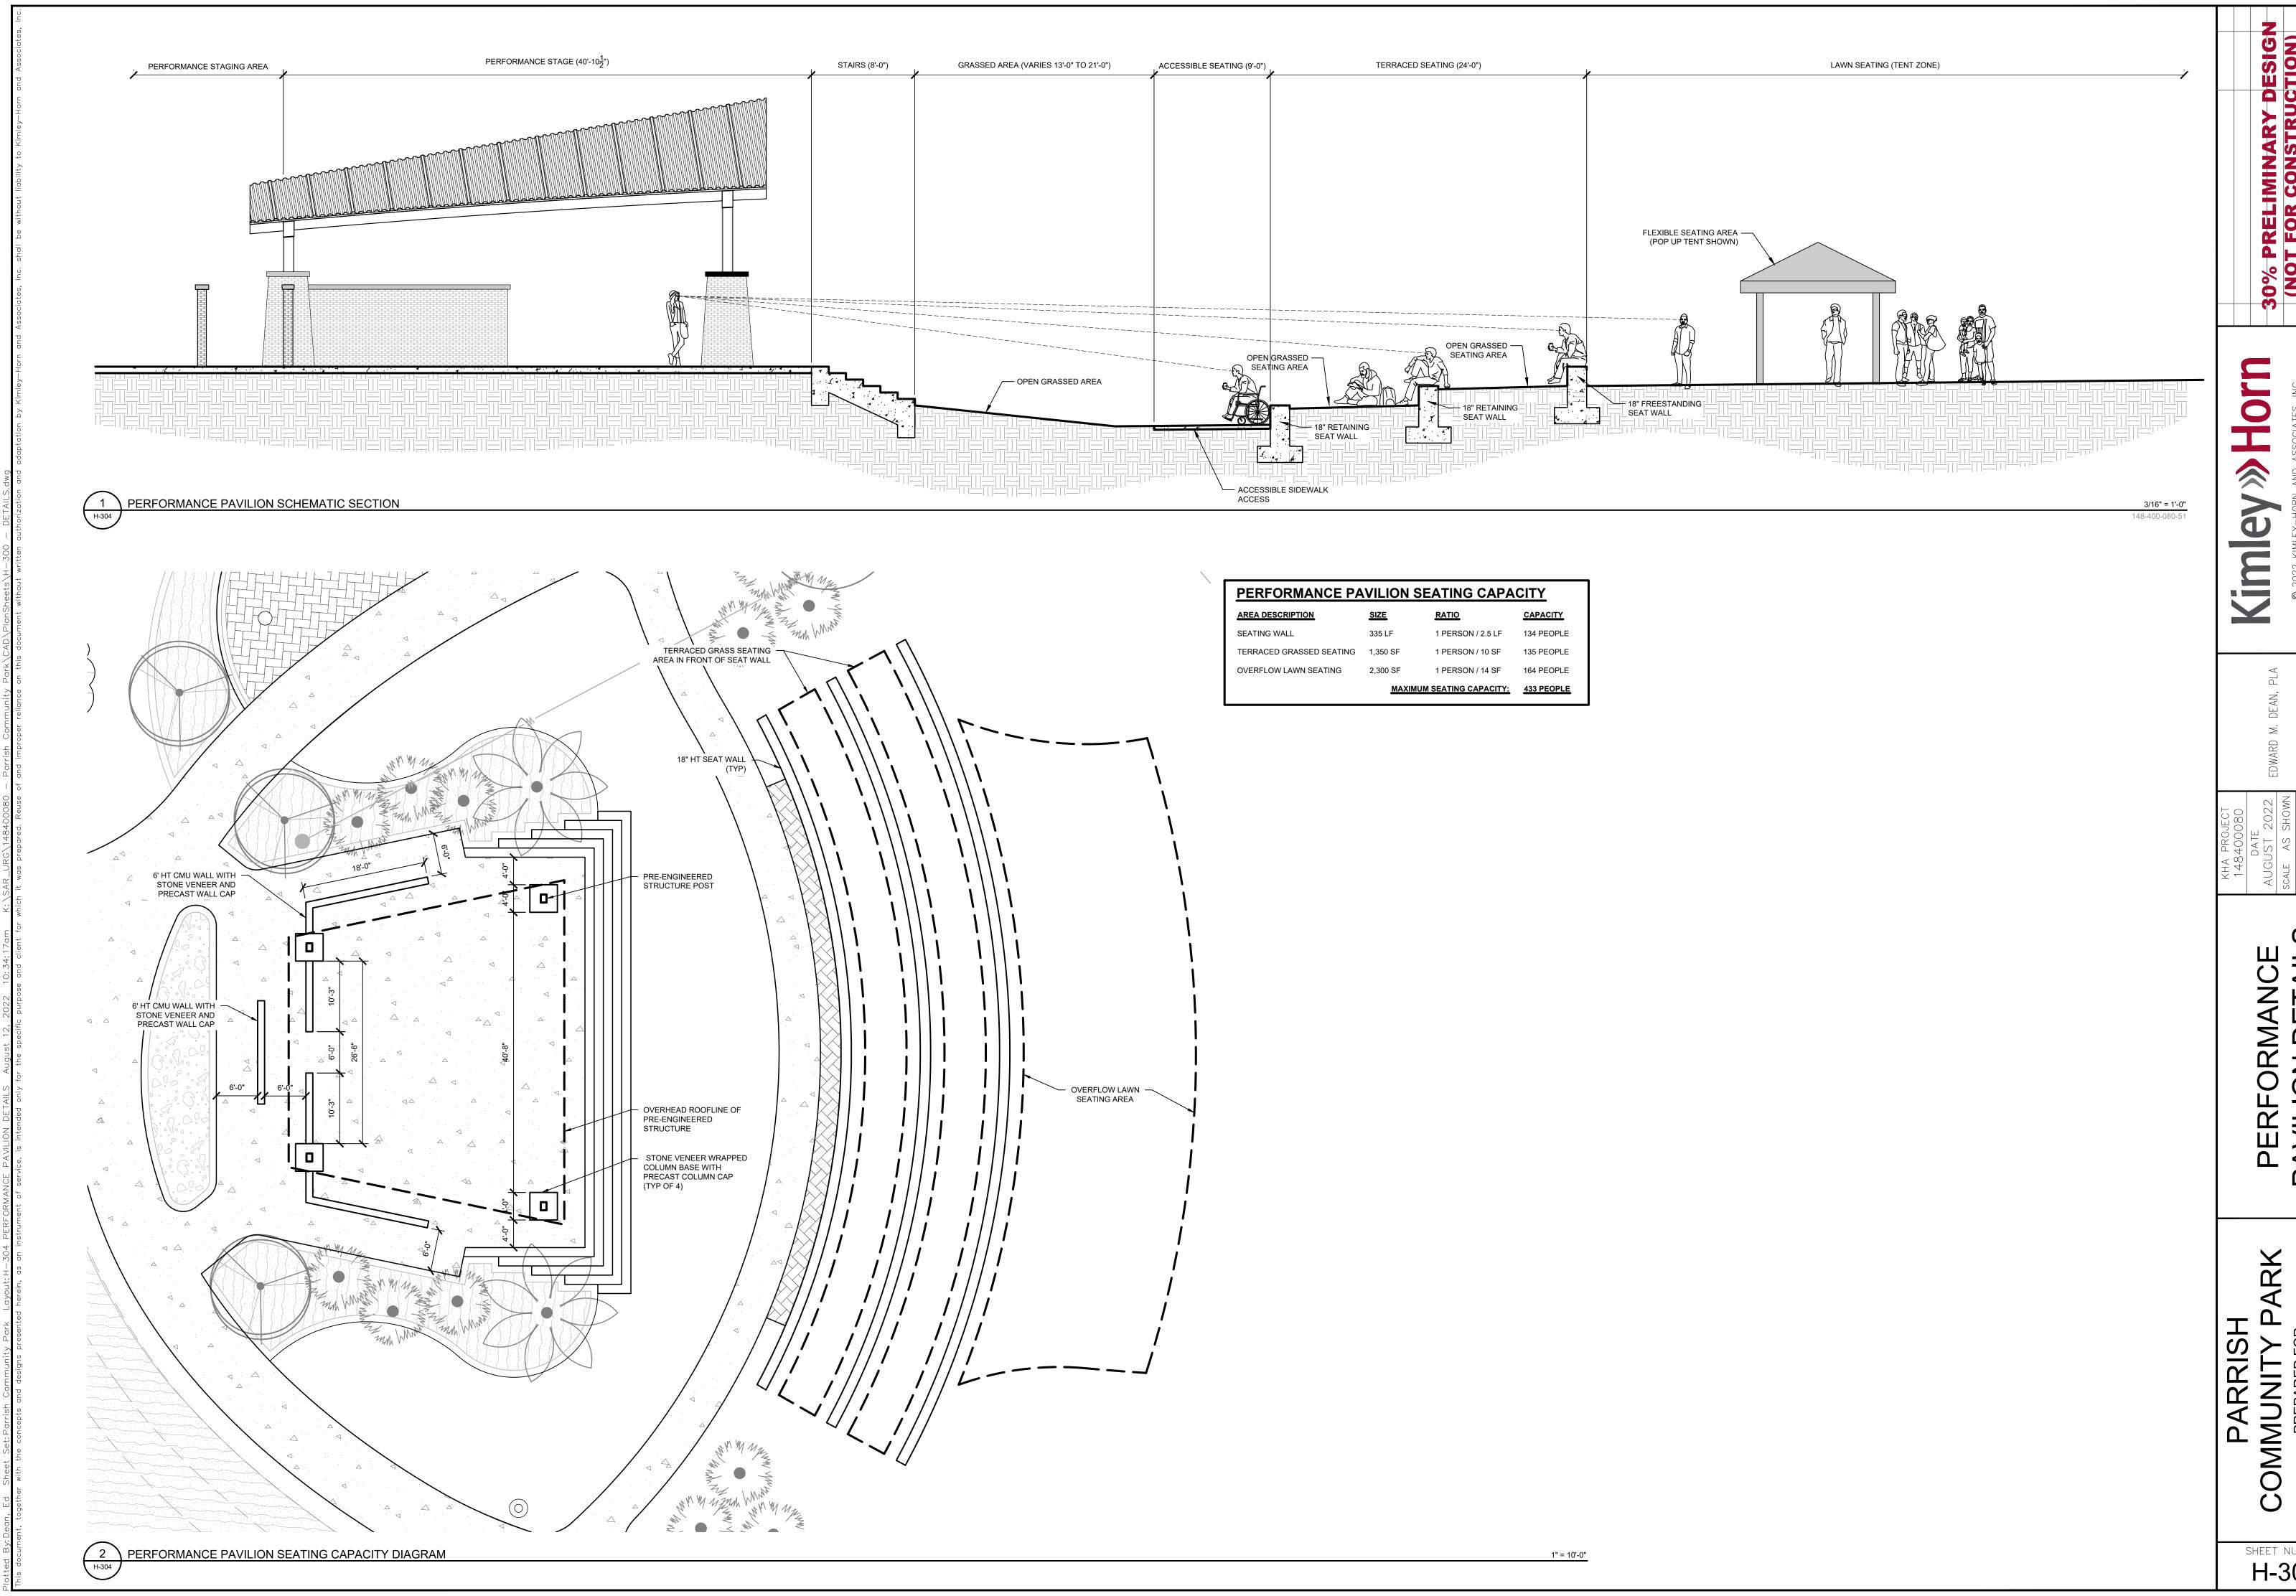

PERFORMANCE PAVILION DETAIL

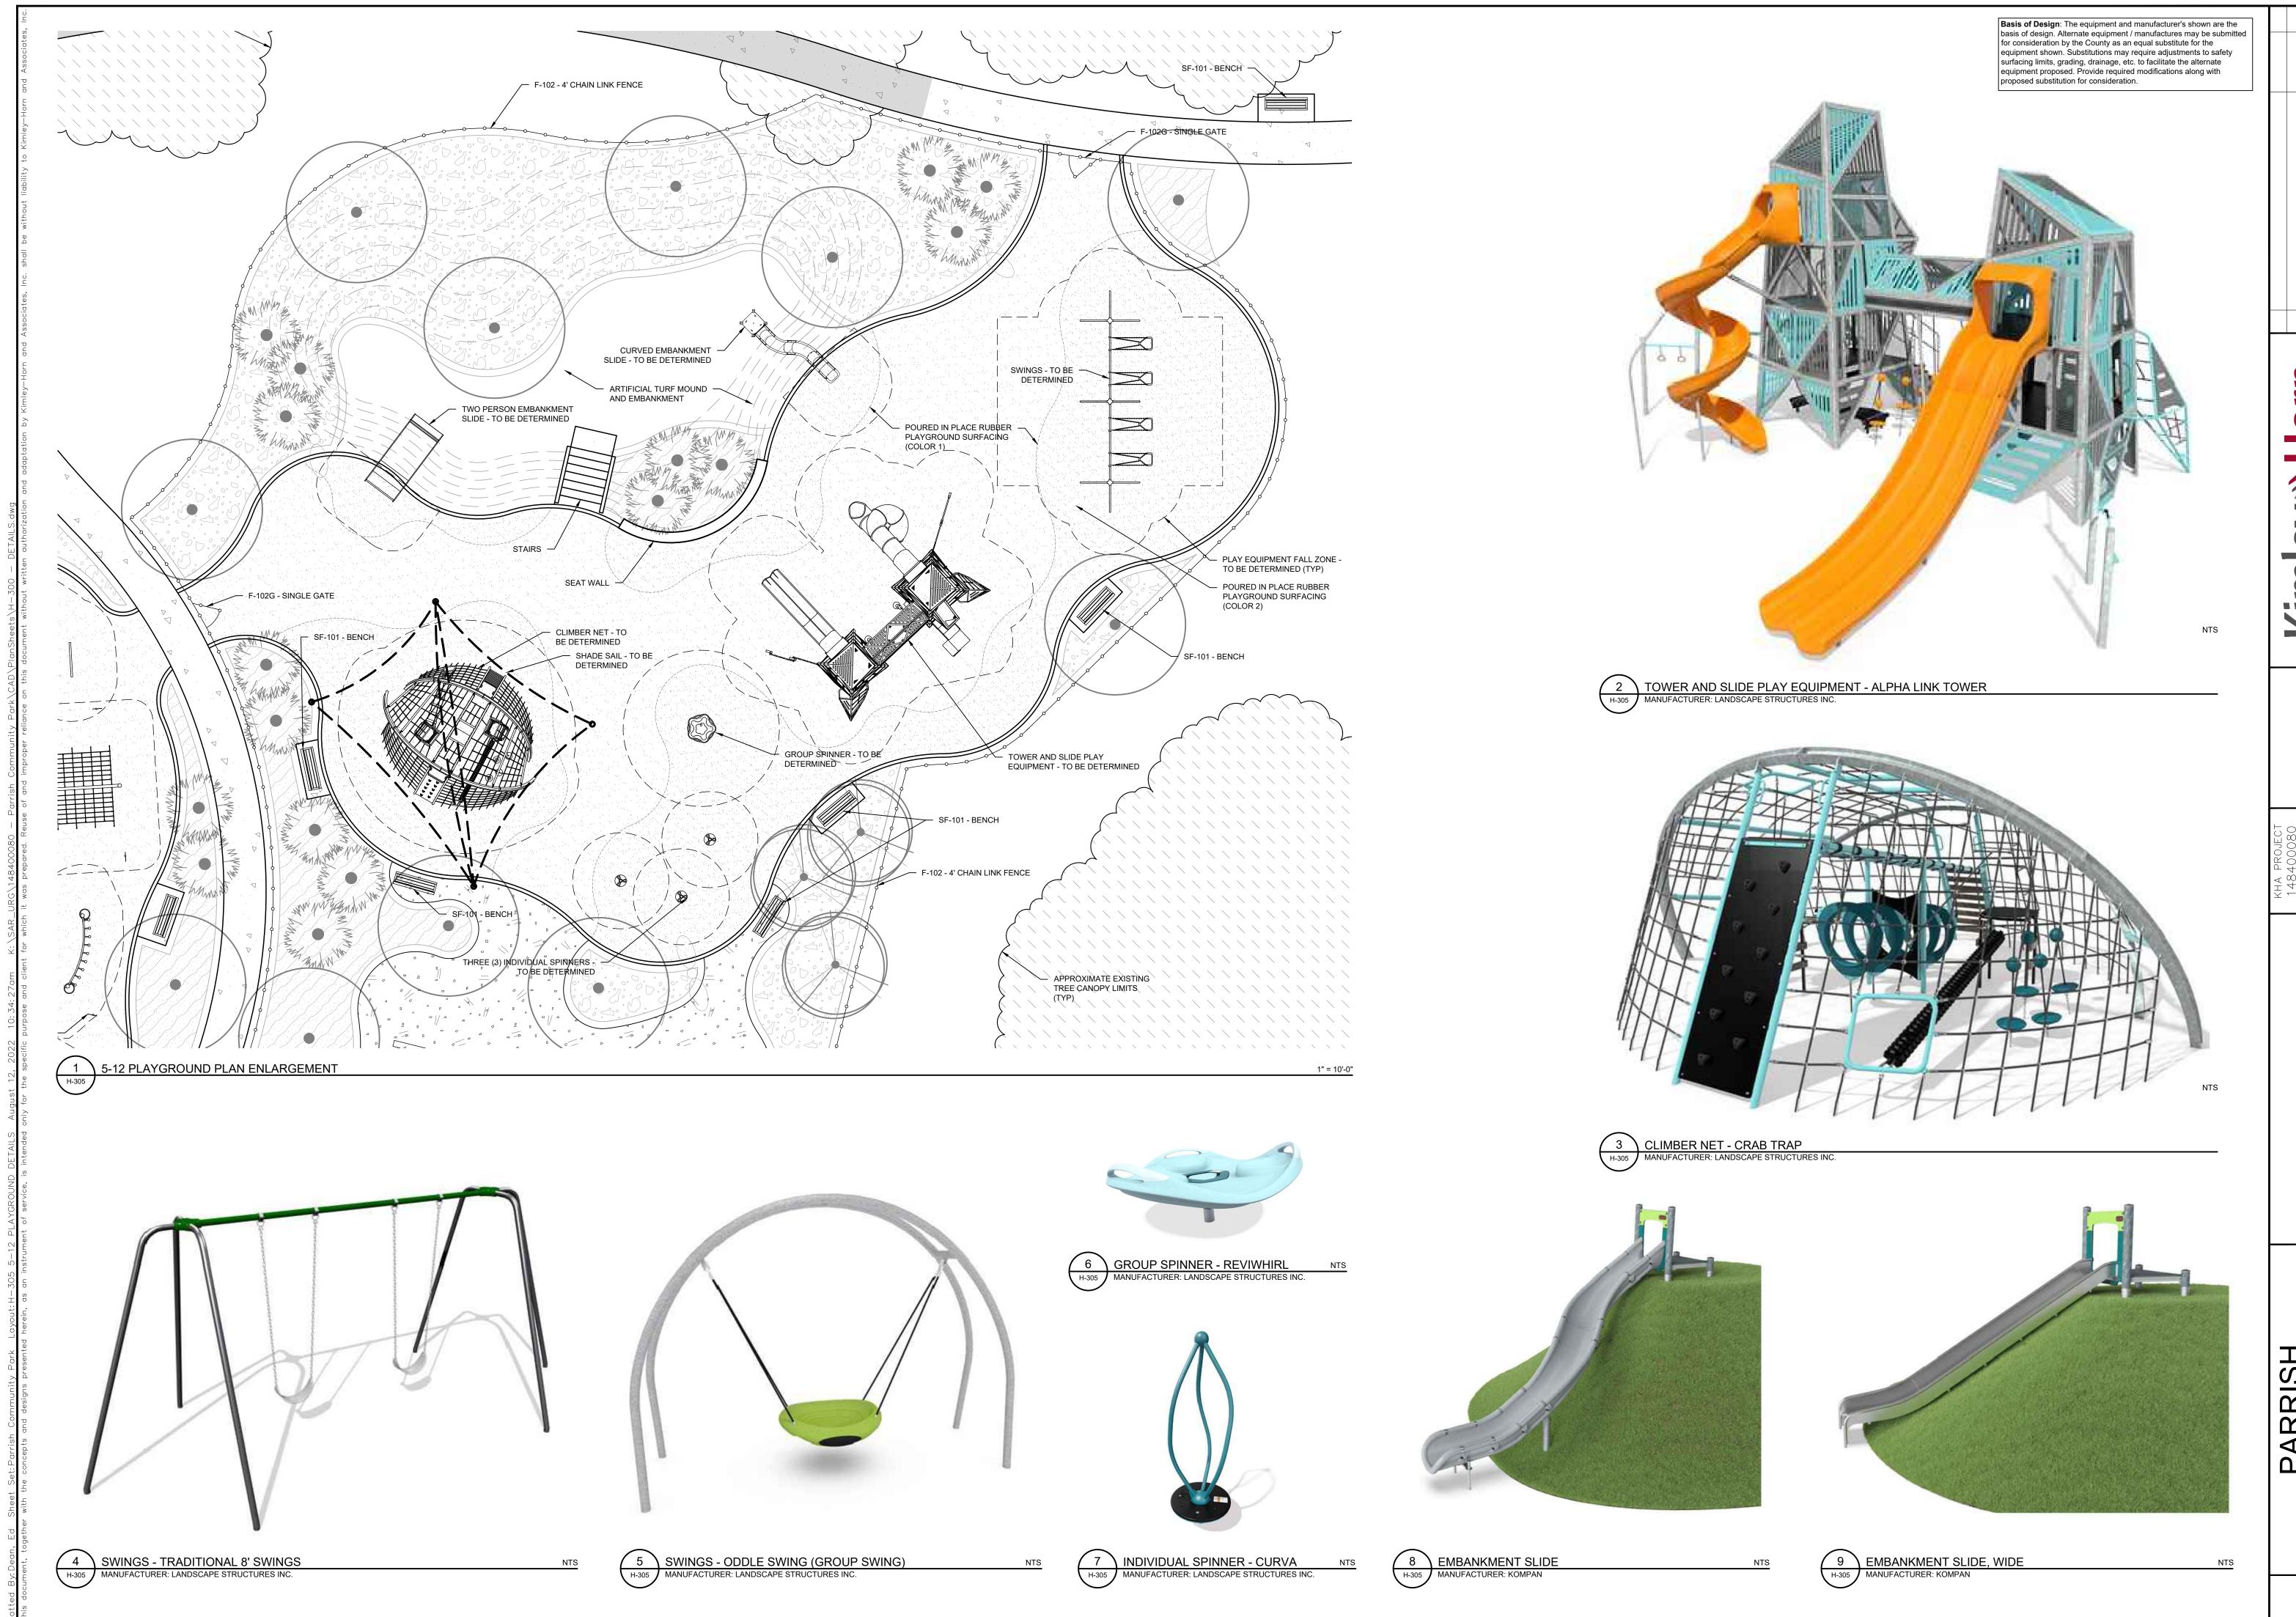

PLAYGROUND DETAILS

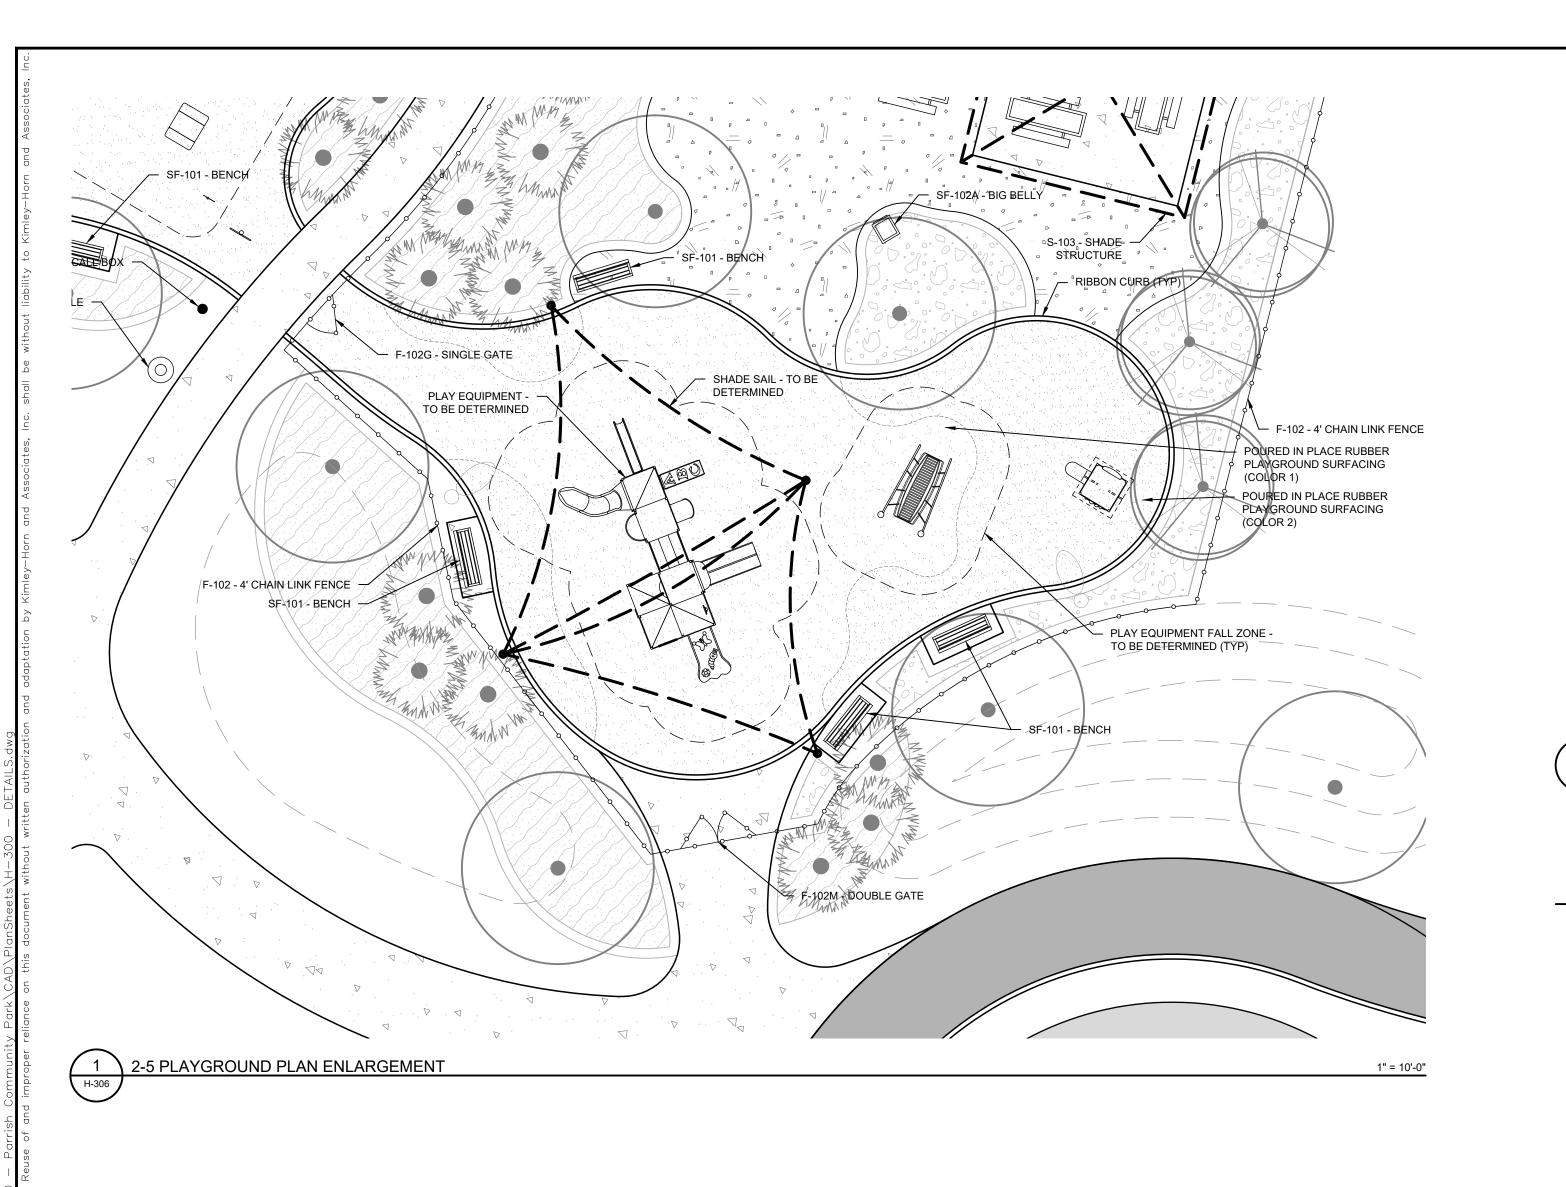



PLAY EQUIPMENT - PLAY SPACE MANUFACTURER: LANDSCAPE STRUCTURES INC.



PLAY EQUIPMENT - PLAY SPACE MANUFACTURER: LANDSCAPE STRUCTURES INC.



4 PLAY EQUIPMENT - PLAY SPACE
H-306 MANUFACTURER: LANDSCAPE STRUCTURES INC.

Basis of Design: The equipment and manufacturer's shown are the basis of design. Alternate equipment / manufactures may be submitted for consideration by the County as an equal substitute for the equipment shown. Substitutions may require adjustments to safety surfacing limits, grading, drainage, etc. to facilitate the alternate equipment proposed. Provide required modifications along with proposed substitution for consideration.


NTS


1" = 10'-0"

FITNESS COURSE DETAILS

COMMUNITY PAF
PREPARED FOR
MANATEE COUNTY

SHEET NUMBER H-307

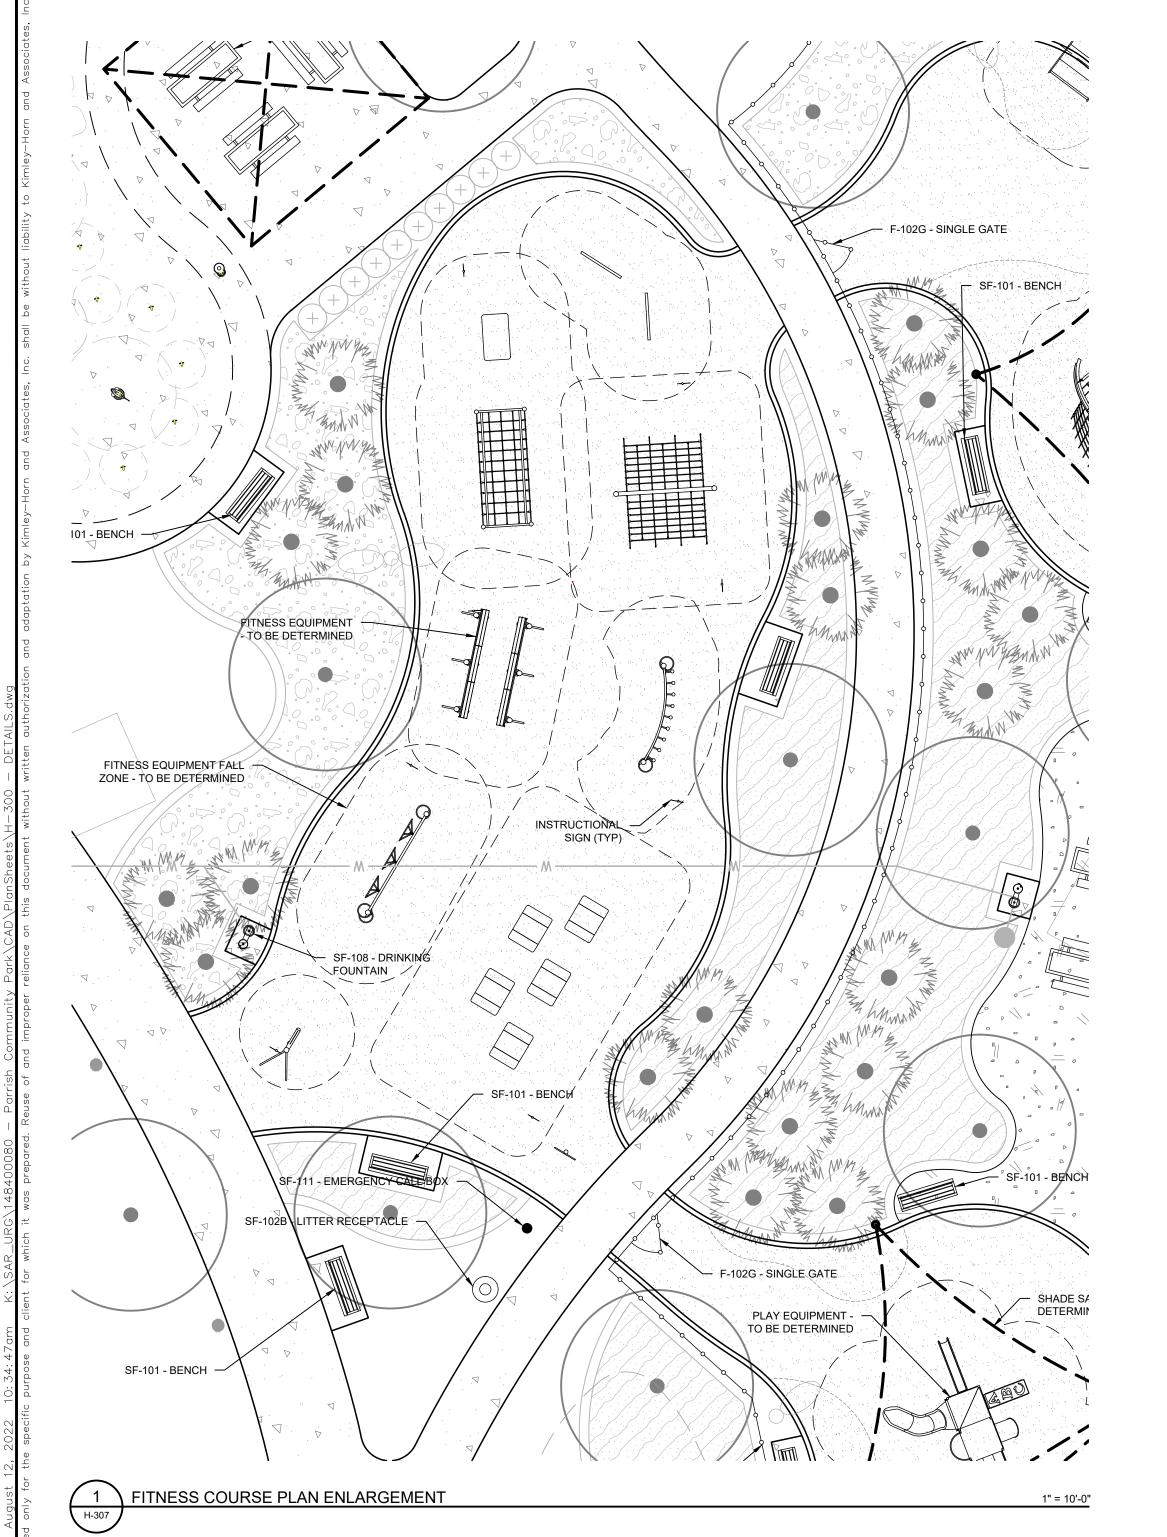

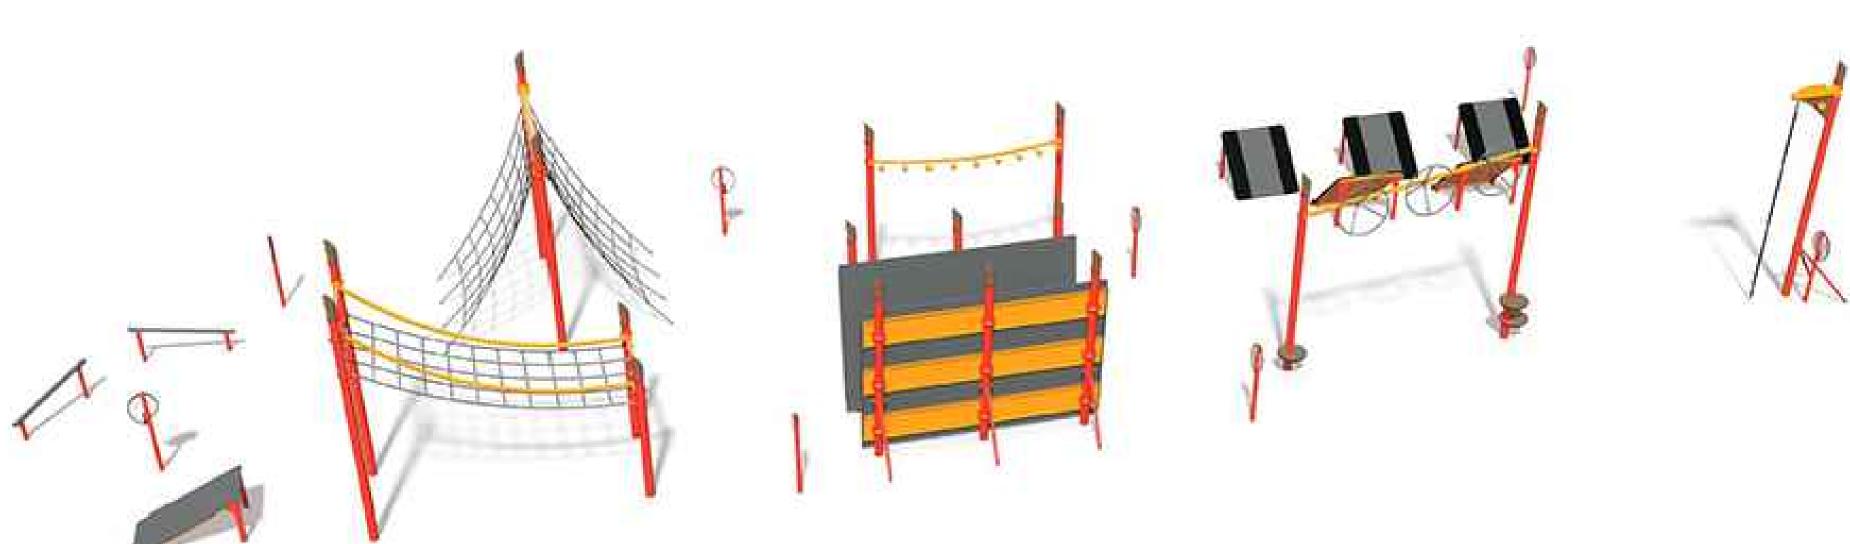

1 FITNESS COURSE EQUIPMENT - FITCORE EXTREME COURSE 4 (+13 YEARS OLD)

MANUFACTURER: LANDSCAPE STRUCTURES INC.

S

SHEET NUMBER H-308





3 SPLASH PAD EQUIPMENT - SAMPLE EQUIPMENT (TO BE DETERMINED)

MANUFACTURER: VORTEX AQUATICS OR APPROVED EQUIVALENT

— S-103 - SHADE STRUCTURE — SF-103 - PICNIC TABLE



4 SPLASH PAD EQUIPMENT - SAMPLE EQUIPMENT (TO BE DETERMINED)

MANUFACTURER: VORTEX AQUATICS OR APPROVED EQUIVALENT

INSTRUCTIONAL -1 SPLASH PAD PLAN ENLARGEMENT Basis of Design: The equipment and manufacturer's shown are the basis of design. Alternate equipment / manufactures may be submitted for consideration by the County as an equal substitute for the equipment shown. Substitutions may require the state of surfacing limits, grading, drainage, etc. to facilitate the alternate equipment proposed. Provide required modifications along with proposed substitution for consideration.

SF-101 - BENCH

FITNESS EQUIPMENT FALL ZONE - TO BE DETERMINED


FITNESS EQUIPMENT -TO BE DETERMINED

· S-102 - PRE-MANUFACTURED RESTROOM BUILDING

SF-102B - LITTER RECEPTACLE -

- POOL SHOWER

SF-101 BENCH

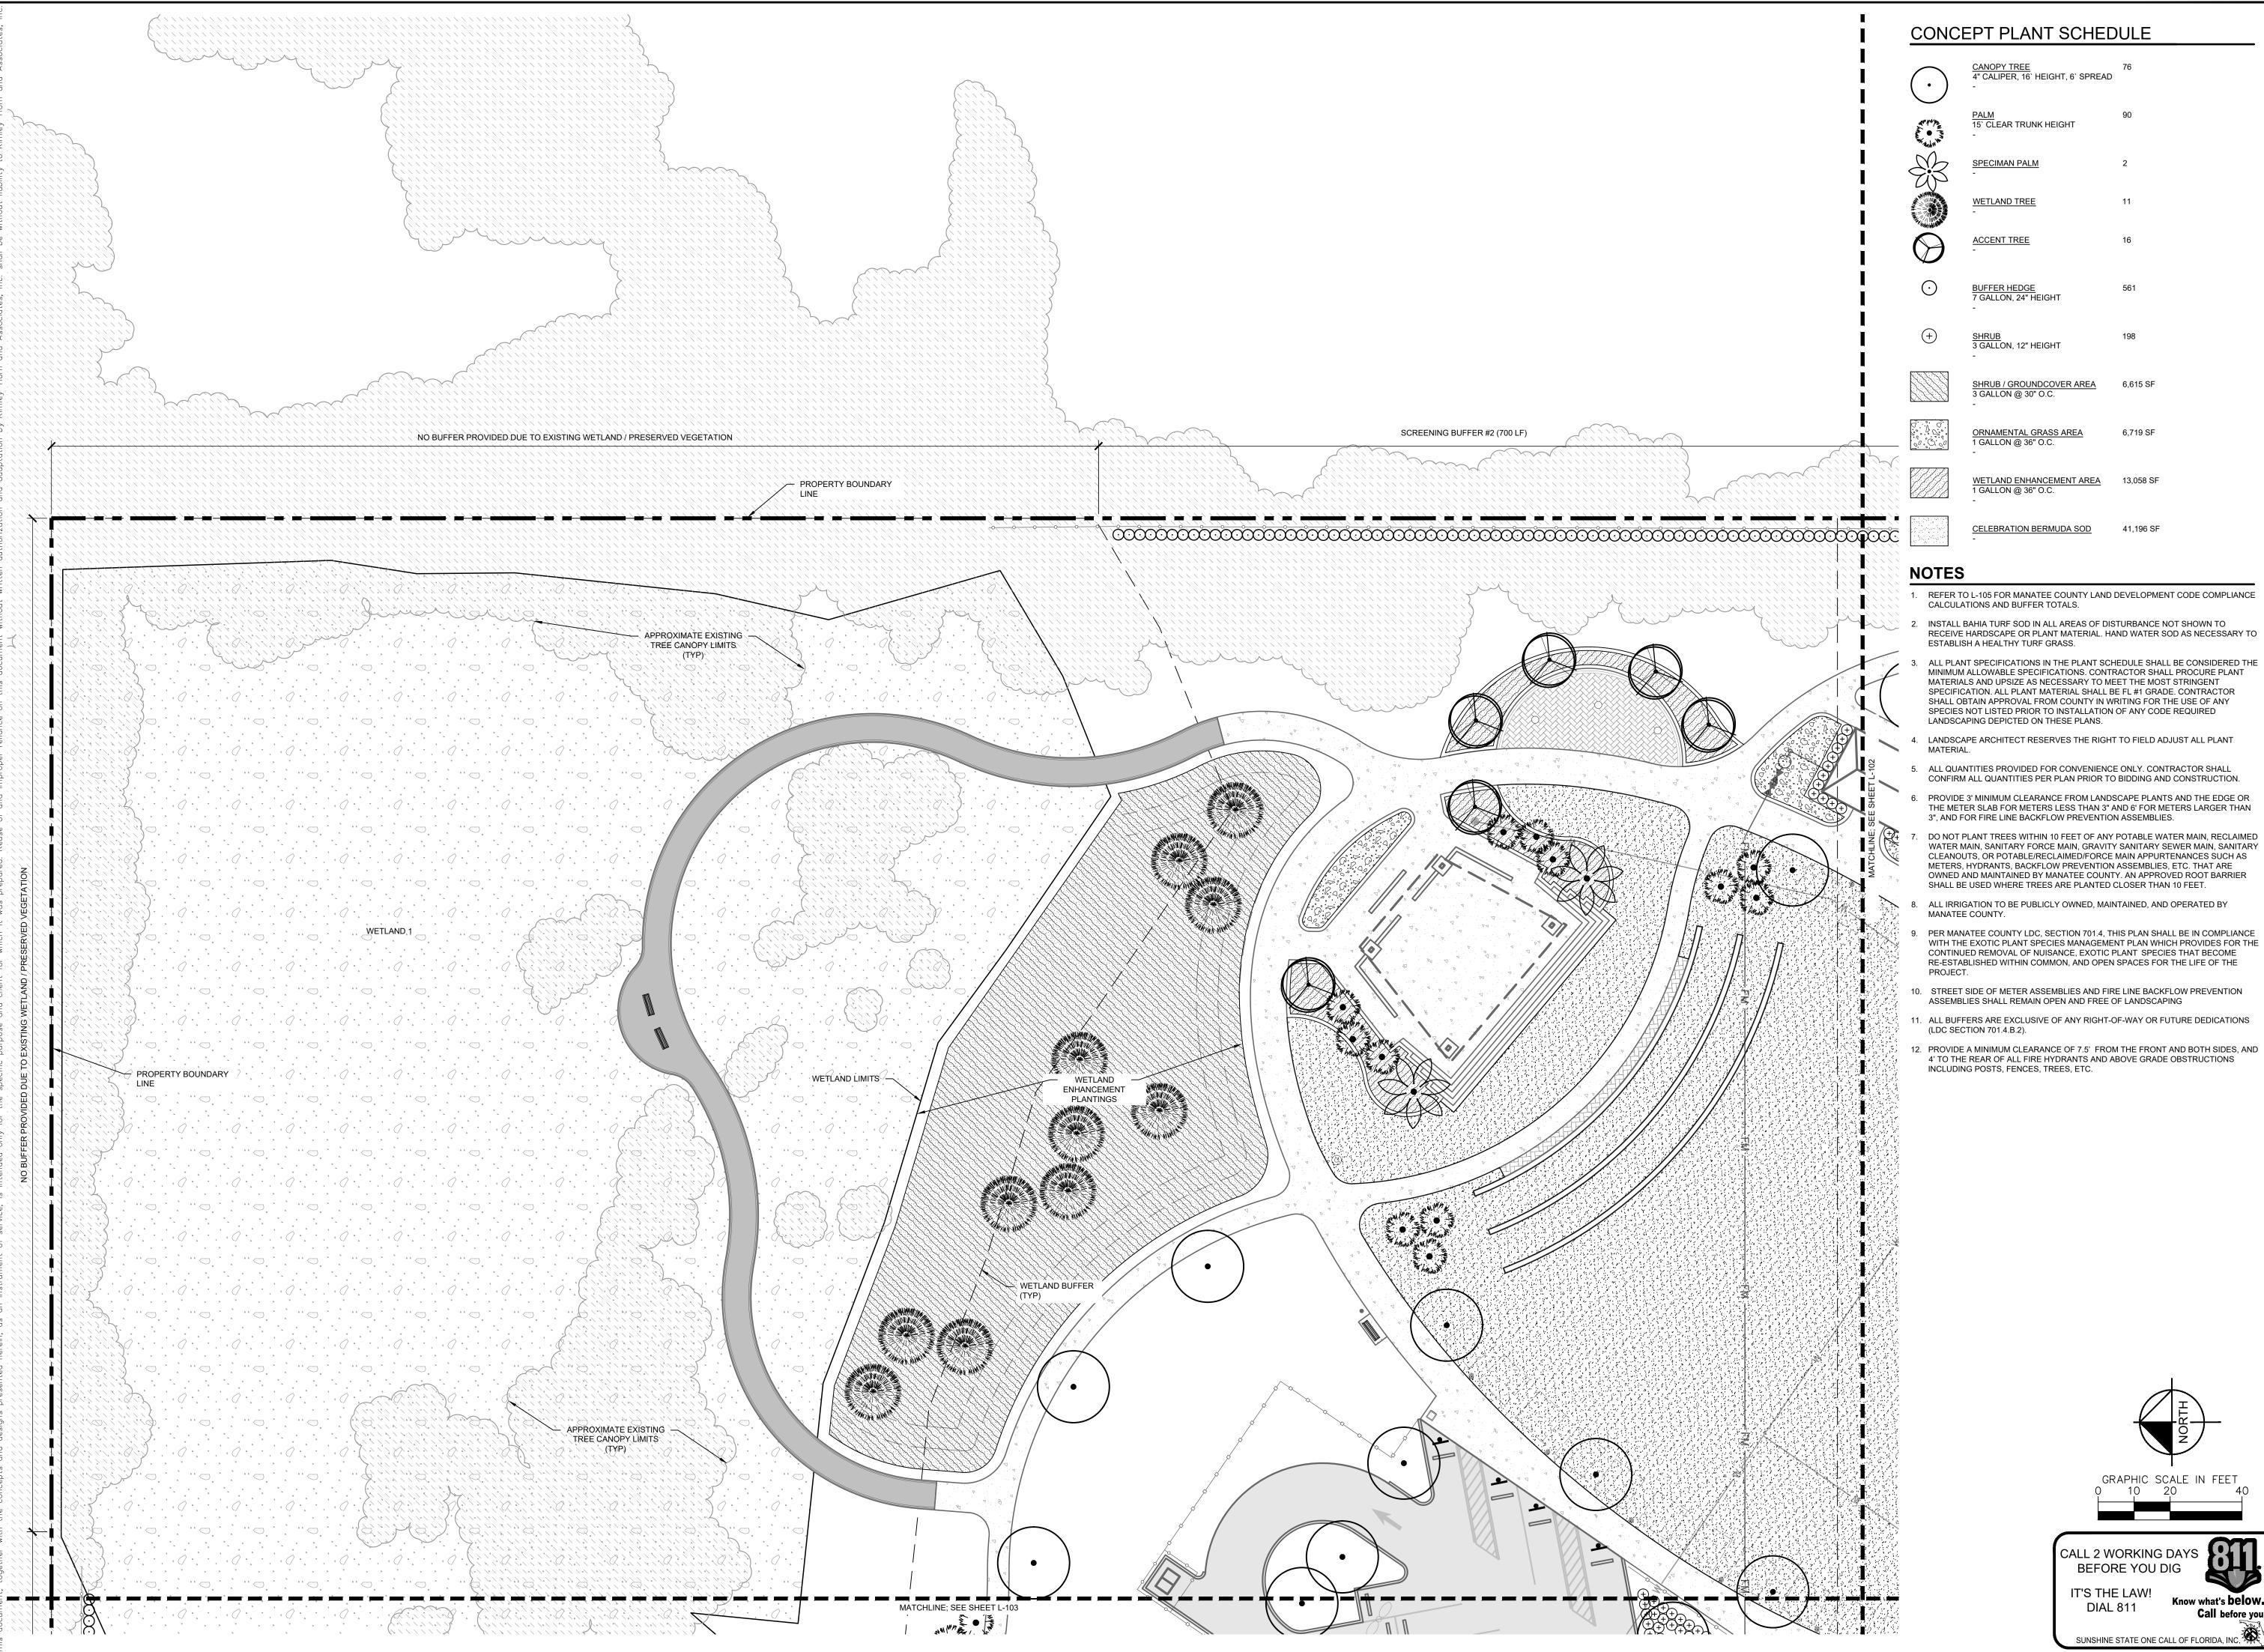

CONCEPT PLANT SCHEDULE

CANOPY TREE 4" CALIPER, 16` HEIGHT, 6` SPREAD

CELEBRATION BERMUDA SOD


- 1. REFER TO L-105 FOR MANATEE COUNTY LAND DEVELOPMENT CODE COMPLIANCE CALCULATIONS AND BUFFER TOTALS.
- INSTALL BAHIA TURF SOD IN ALL AREAS OF DISTURBANCE NOT SHOWN TO RECEIVE HARDSCAPE OR PLANT MATERIAL. HAND WATER SOD AS NECESSARY TO ESTABLISH A HEALTHY TURF GRASS.
- MINIMUM ALLOWABLE SPECIFICATIONS. CONTRACTOR SHALL PROCURE PLANT MATERIALS AND UPSIZE AS NECESSARY TO MEET THE MOST STRINGENT SPECIFICATION. ALL PLANT MATERIAL SHALL BE FL #1 GRADE. CONTRACTOR SHALL OBTAIN APPROVAL FROM COUNTY IN WRITING FOR THE USE OF ANY SPECIES NOT LISTED PRIOR TO INSTALLATION OF ANY CODE REQUIRED LANDSCAPING DEPICTED ON THESE PLANS.
- 4. LANDSCAPE ARCHITECT RESERVES THE RIGHT TO FIELD ADJUST ALL PLANT
- ALL QUANTITIES PROVIDED FOR CONVENIENCE ONLY. CONTRACTOR SHALL CONFIRM ALL QUANTITIES PER PLAN PRIOR TO BIDDING AND CONSTRUCTION.
- PROVIDE 3' MINIMUM CLEARANCE FROM LANDSCAPE PLANTS AND THE EDGE OR THE METER SLAB FOR METERS LESS THAN 3" AND 6' FOR METERS LARGER THAN 3", AND FOR FIRE LINE BACKFLOW PREVENTION ASSEMBLIES.
- DO NOT PLANT TREES WITHIN 10 FEET OF ANY POTABLE WATER MAIN, RECLAIMED WATER MAIN, SANITARY FORCE MAIN, GRAVITY SANITARY SEWER MAIN, SANITARY CLEANOUTS, OR POTABLE/RECLAIMED/FORCE MAIN APPURTENANCES SUCH AS METERS, HYDRANTS, BACKFLOW PREVENTION ASSEMBLIES, ETC. THAT ARE OWNED AND MAINTAINED BY MANATEE COUNTY. AN APPROVED ROOT BARRIER SHALL BE USED WHERE TREES ARE PLANTED CLOSER THAN 10 FEET.
- ALL IRRIGATION TO BE PUBLICLY OWNED, MAINTAINED, AND OPERATED BY
- PER MANATEE COUNTY LDC, SECTION 701.4, THIS PLAN SHALL BE IN COMPLIANCE WITH THE EXOTIC PLANT SPECIES MANAGEMENT PLAN WHICH PROVIDES FOR THE CONTINUED REMOVAL OF NUISANCE, EXOTIC PLANT SPECIES THAT BECOME RE-ESTABLISHED WITHIN COMMON, AND OPEN SPACES FOR THE LIFE OF THE
- 10. STREET SIDE OF METER ASSEMBLIES AND FIRE LINE BACKFLOW PREVENTION ASSEMBLIES SHALL REMAIN OPEN AND FREE OF LANDSCAPING
- 1. ALL BUFFERS ARE EXCLUSIVE OF ANY RIGHT-OF-WAY OR FUTURE DEDICATIONS
- 12. PROVIDE A MINIMUM CLEARANCE OF 7.5' FROM THE FRONT AND BOTH SIDES, AND 4' TO THE REAR OF ALL FIRE HYDRANTS AND ABOVE GRADE OBSTRUCTIONS

Call before you dig.

CALL 2 WORKING DAYS BEFORE YOU DIG


SUNSHINE STATE ONE CALL OF FLORIDA, INC.

IT'S THE LAW!

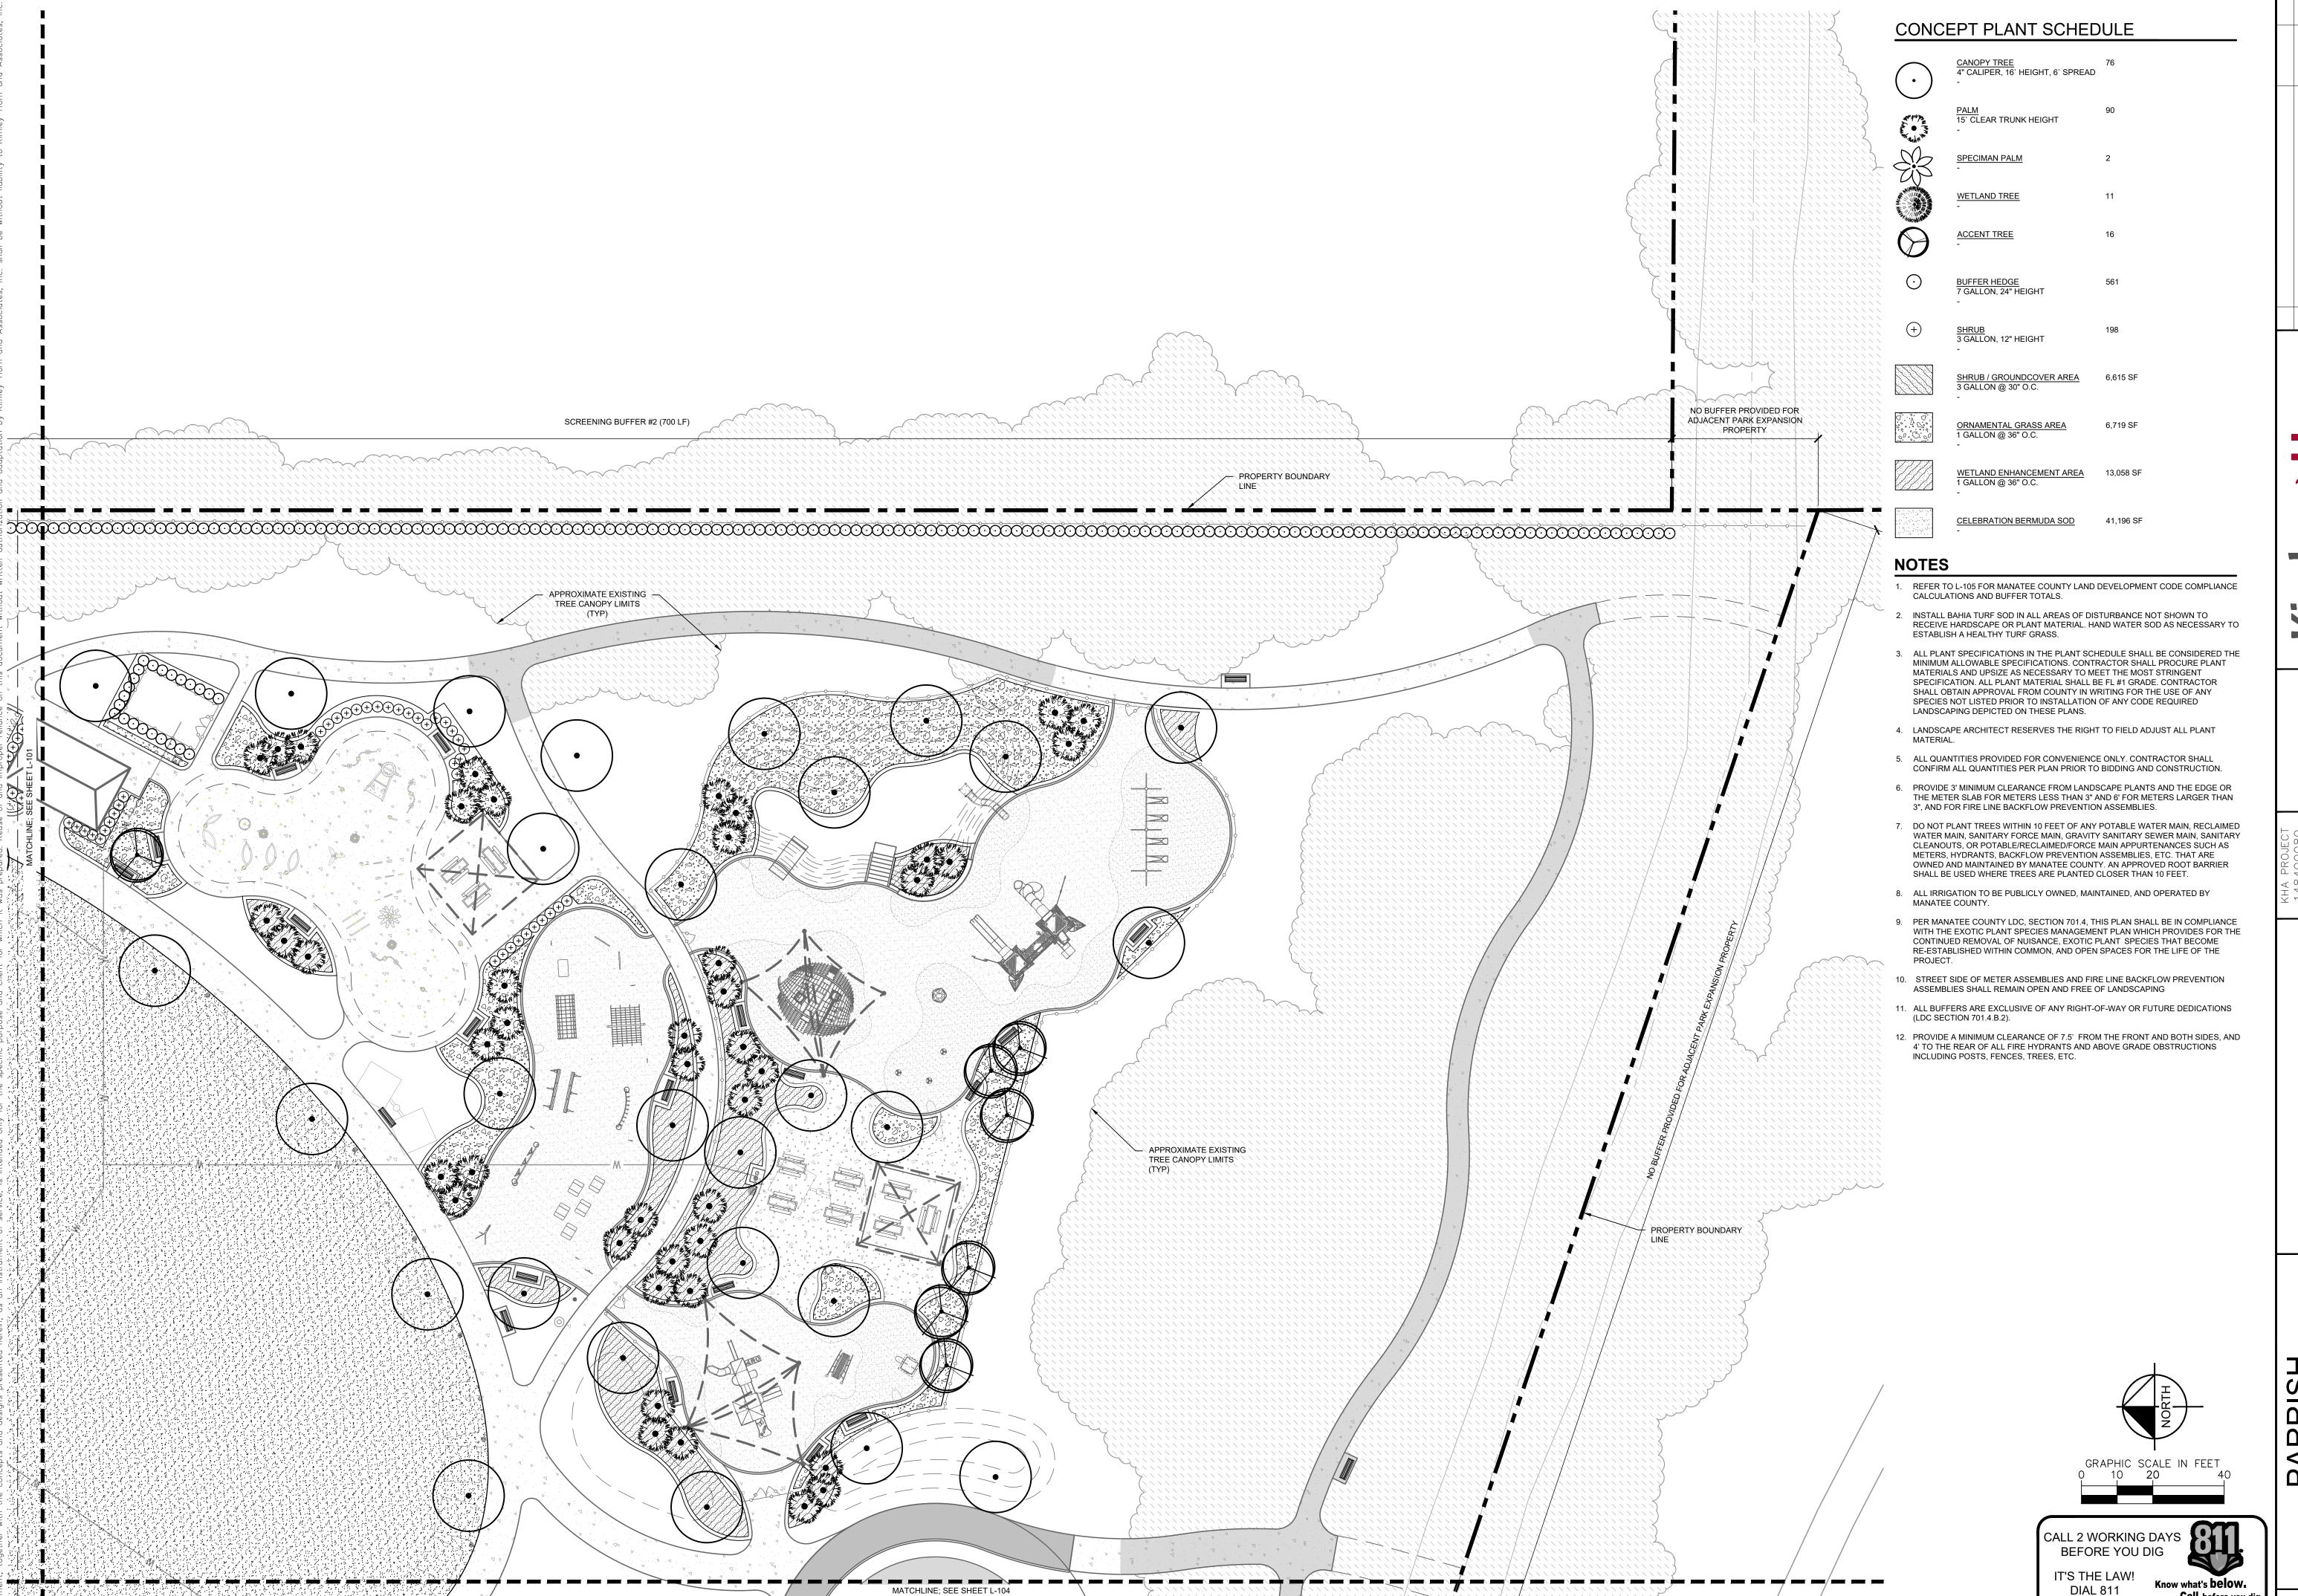

SHEET NUMBER L-102

SUNSHINE STATE ONE CALL OF FLORIDA, INC.

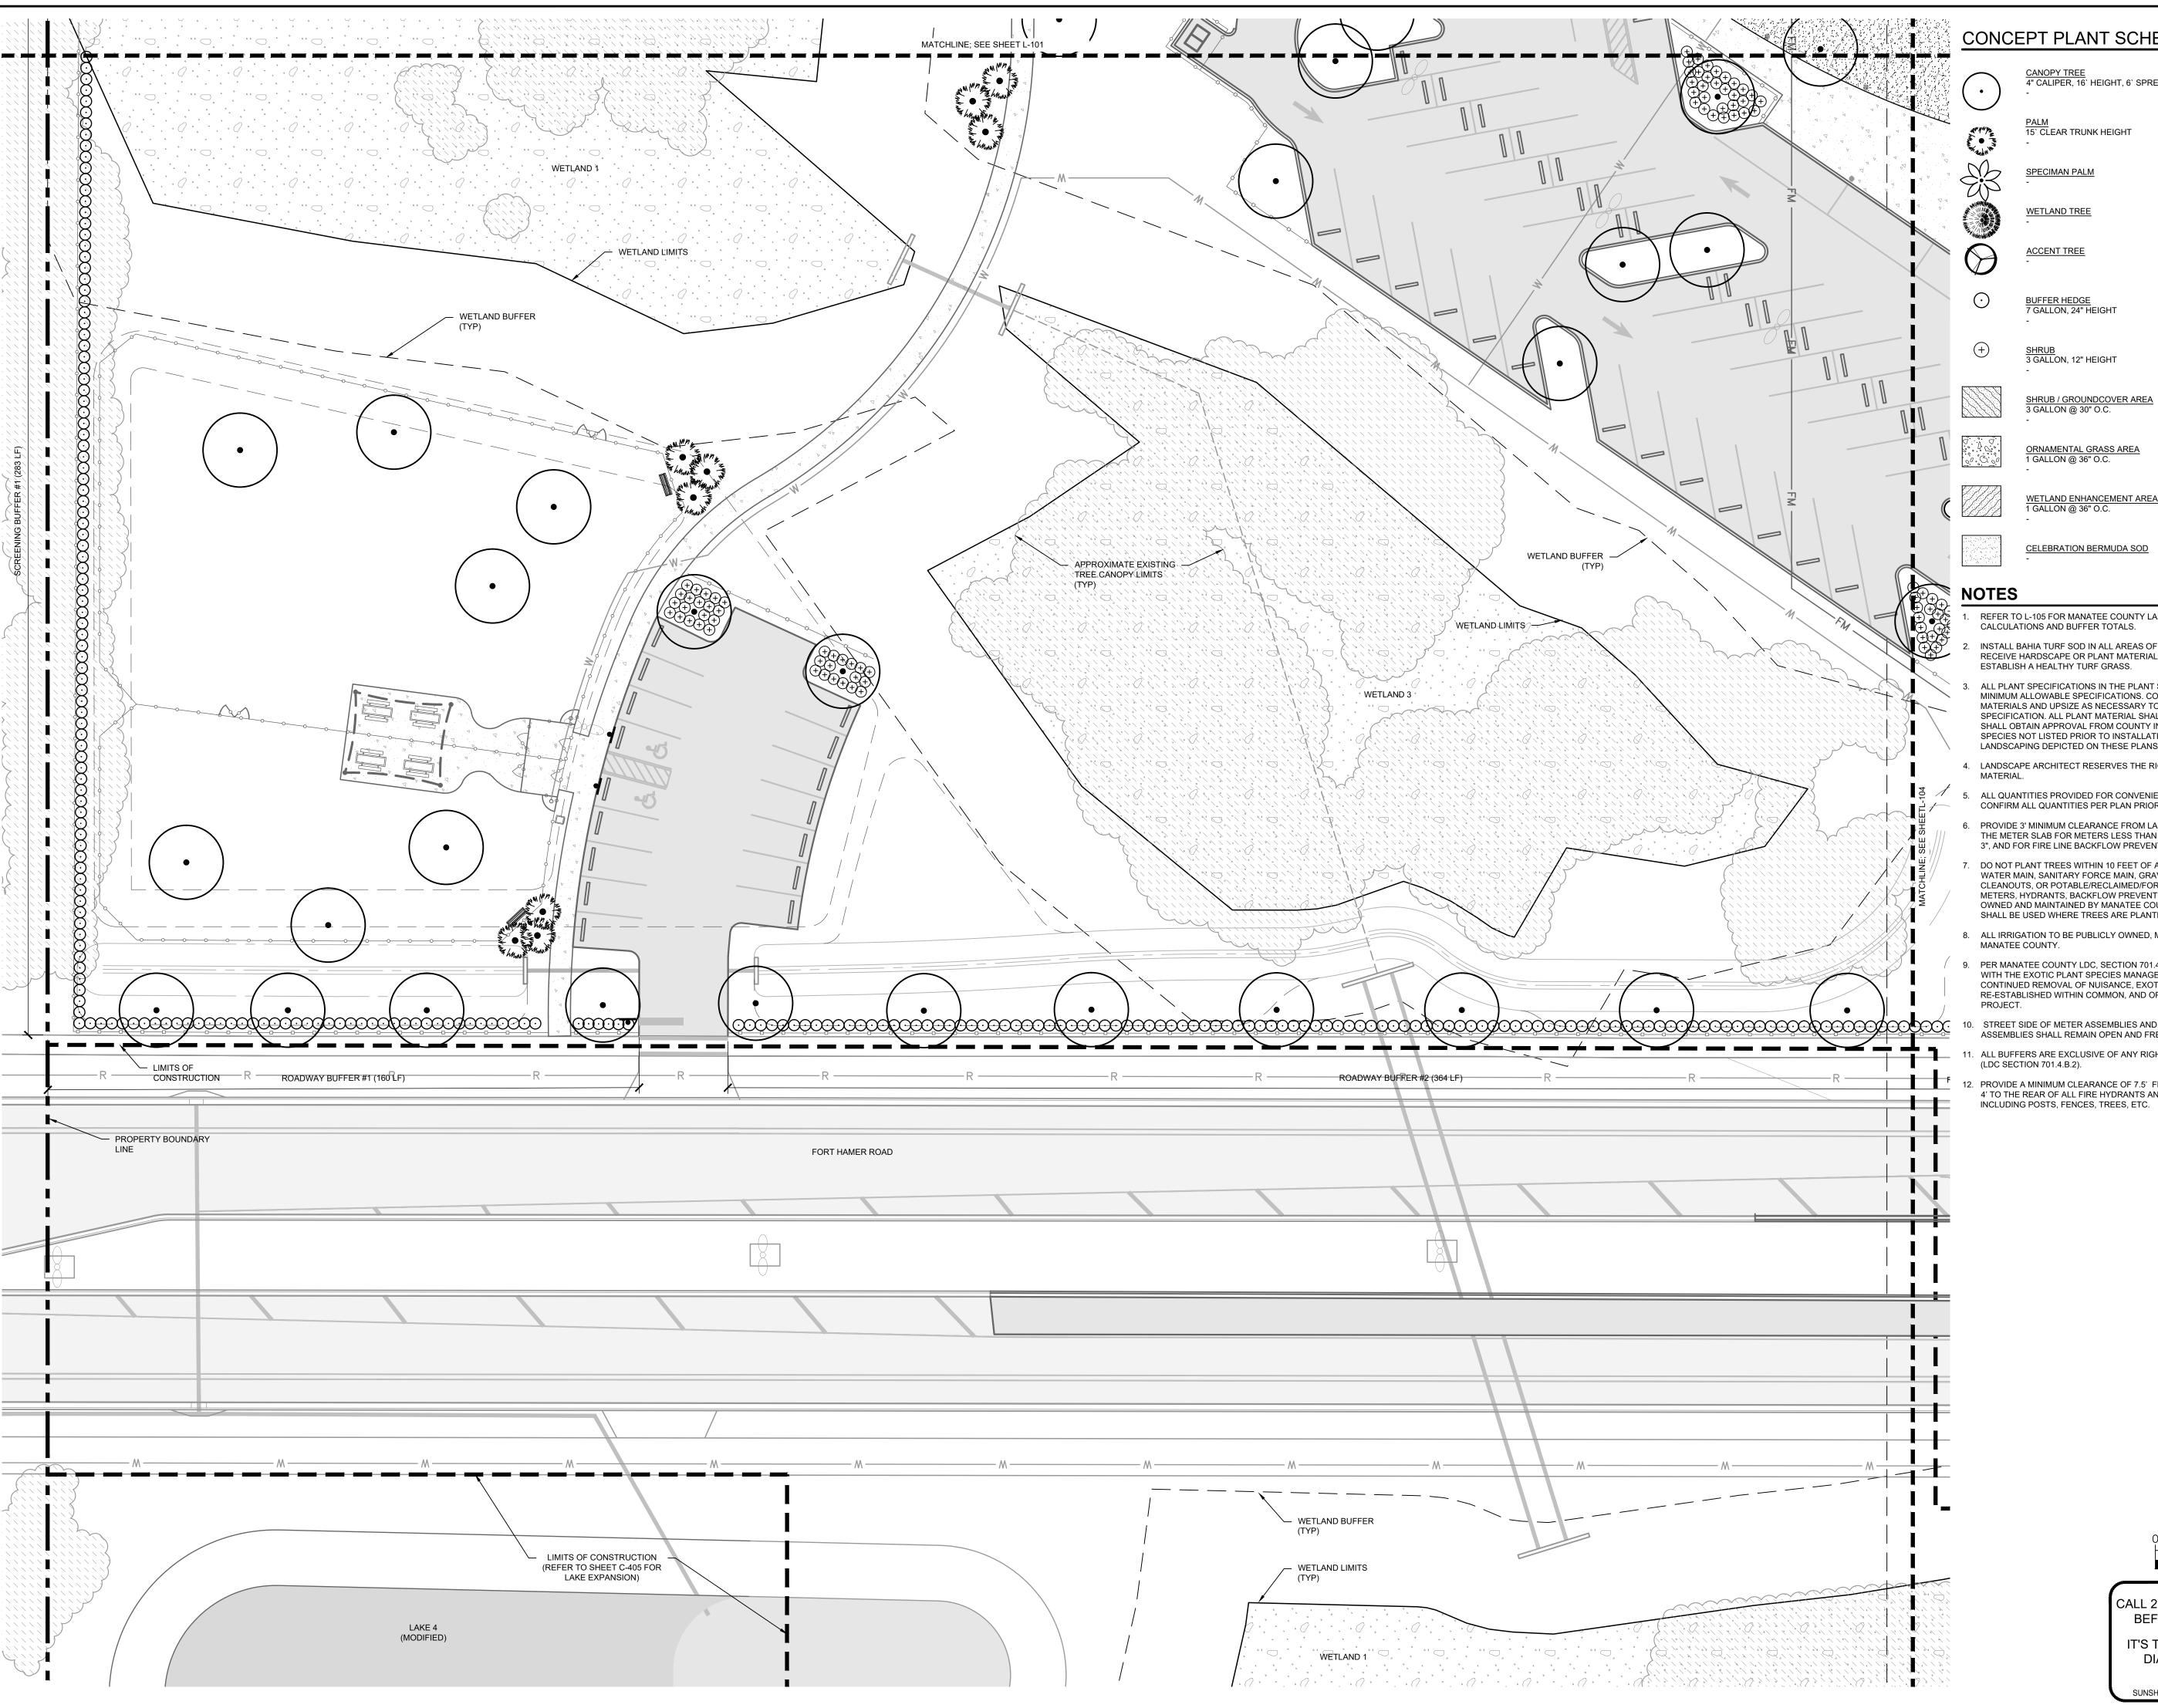

CONCEPT PLANT SCHEDULE

CANOPY TREE 4" CALIPER, 16` HEIGHT, 6` SPREAD

15` CLEAR TRUNK HEIGHT

SPECIMAN PALM

CELEBRATION BERMUDA SOD 41,196 SF

- REFER TO L-105 FOR MANATEE COUNTY LAND DEVELOPMENT CODE COMPLIANCE CALCULATIONS AND BUFFER TOTALS.
- INSTALL BAHIA TURF SOD IN ALL AREAS OF DISTURBANCE NOT SHOWN TO RECEIVE HARDSCAPE OR PLANT MATERIAL. HAND WATER SOD AS NECESSARY TO ESTABLISH A HEALTHY TURF GRASS.
- ALL PLANT SPECIFICATIONS IN THE PLANT SCHEDULE SHALL BE CONSIDERED THE MINIMUM ALLOWABLE SPECIFICATIONS. CONTRACTOR SHALL PROCURE PLANT MATERIALS AND UPSIZE AS NECESSARY TO MEET THE MOST STRINGENT SPECIFICATION. ALL PLANT MATERIAL SHALL BE FL #1 GRADE. CONTRACTOR SHALL OBTAIN APPROVAL FROM COUNTY IN WRITING FOR THE USE OF ANY SPECIES NOT LISTED PRIOR TO INSTALLATION OF ANY CODE REQUIRED LANDSCAPING DEPICTED ON THESE PLANS.
- 4. LANDSCAPE ARCHITECT RESERVES THE RIGHT TO FIELD ADJUST ALL PLANT
- 5. ALL QUANTITIES PROVIDED FOR CONVENIENCE ONLY. CONTRACTOR SHALL CONFIRM ALL QUANTITIES PER PLAN PRIOR TO BIDDING AND CONSTRUCTION.
- 6. PROVIDE 3' MINIMUM CLEARANCE FROM LANDSCAPE PLANTS AND THE EDGE OR THE METER SLAB FOR METERS LESS THAN 3" AND 6' FOR METERS LARGER THAN 3", AND FOR FIRE LINE BACKFLOW PREVENTION ASSEMBLIES.
- DO NOT PLANT TREES WITHIN 10 FEET OF ANY POTABLE WATER MAIN, RECLAIMED WATER MAIN, SANITARY FORCE MAIN, GRAVITY SANITARY SEWER MAIN, SANITARY CLEANOUTS, OR POTABLE/RECLAIMED/FORCE MAIN APPURTENANCES SUCH AS METERS, HYDRANTS, BACKFLOW PREVENTION ASSEMBLIES, ETC. THAT ARE OWNED AND MAINTAINED BY MANATEE COUNTY. AN APPROVED ROOT BARRIER SHALL BE USED WHERE TREES ARE PLANTED CLOSER THAN 10 FEET.
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GRAPHIC SCALE IN FEET

CALL 2 WORKING DAYS BEFORE YOU DIG


SUNSHINE STATE ONE CALL OF FLORIDA, INC.

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Know what's **below.** Call before you dig.

SHEET NUMBER

© 2022 7 MAIN

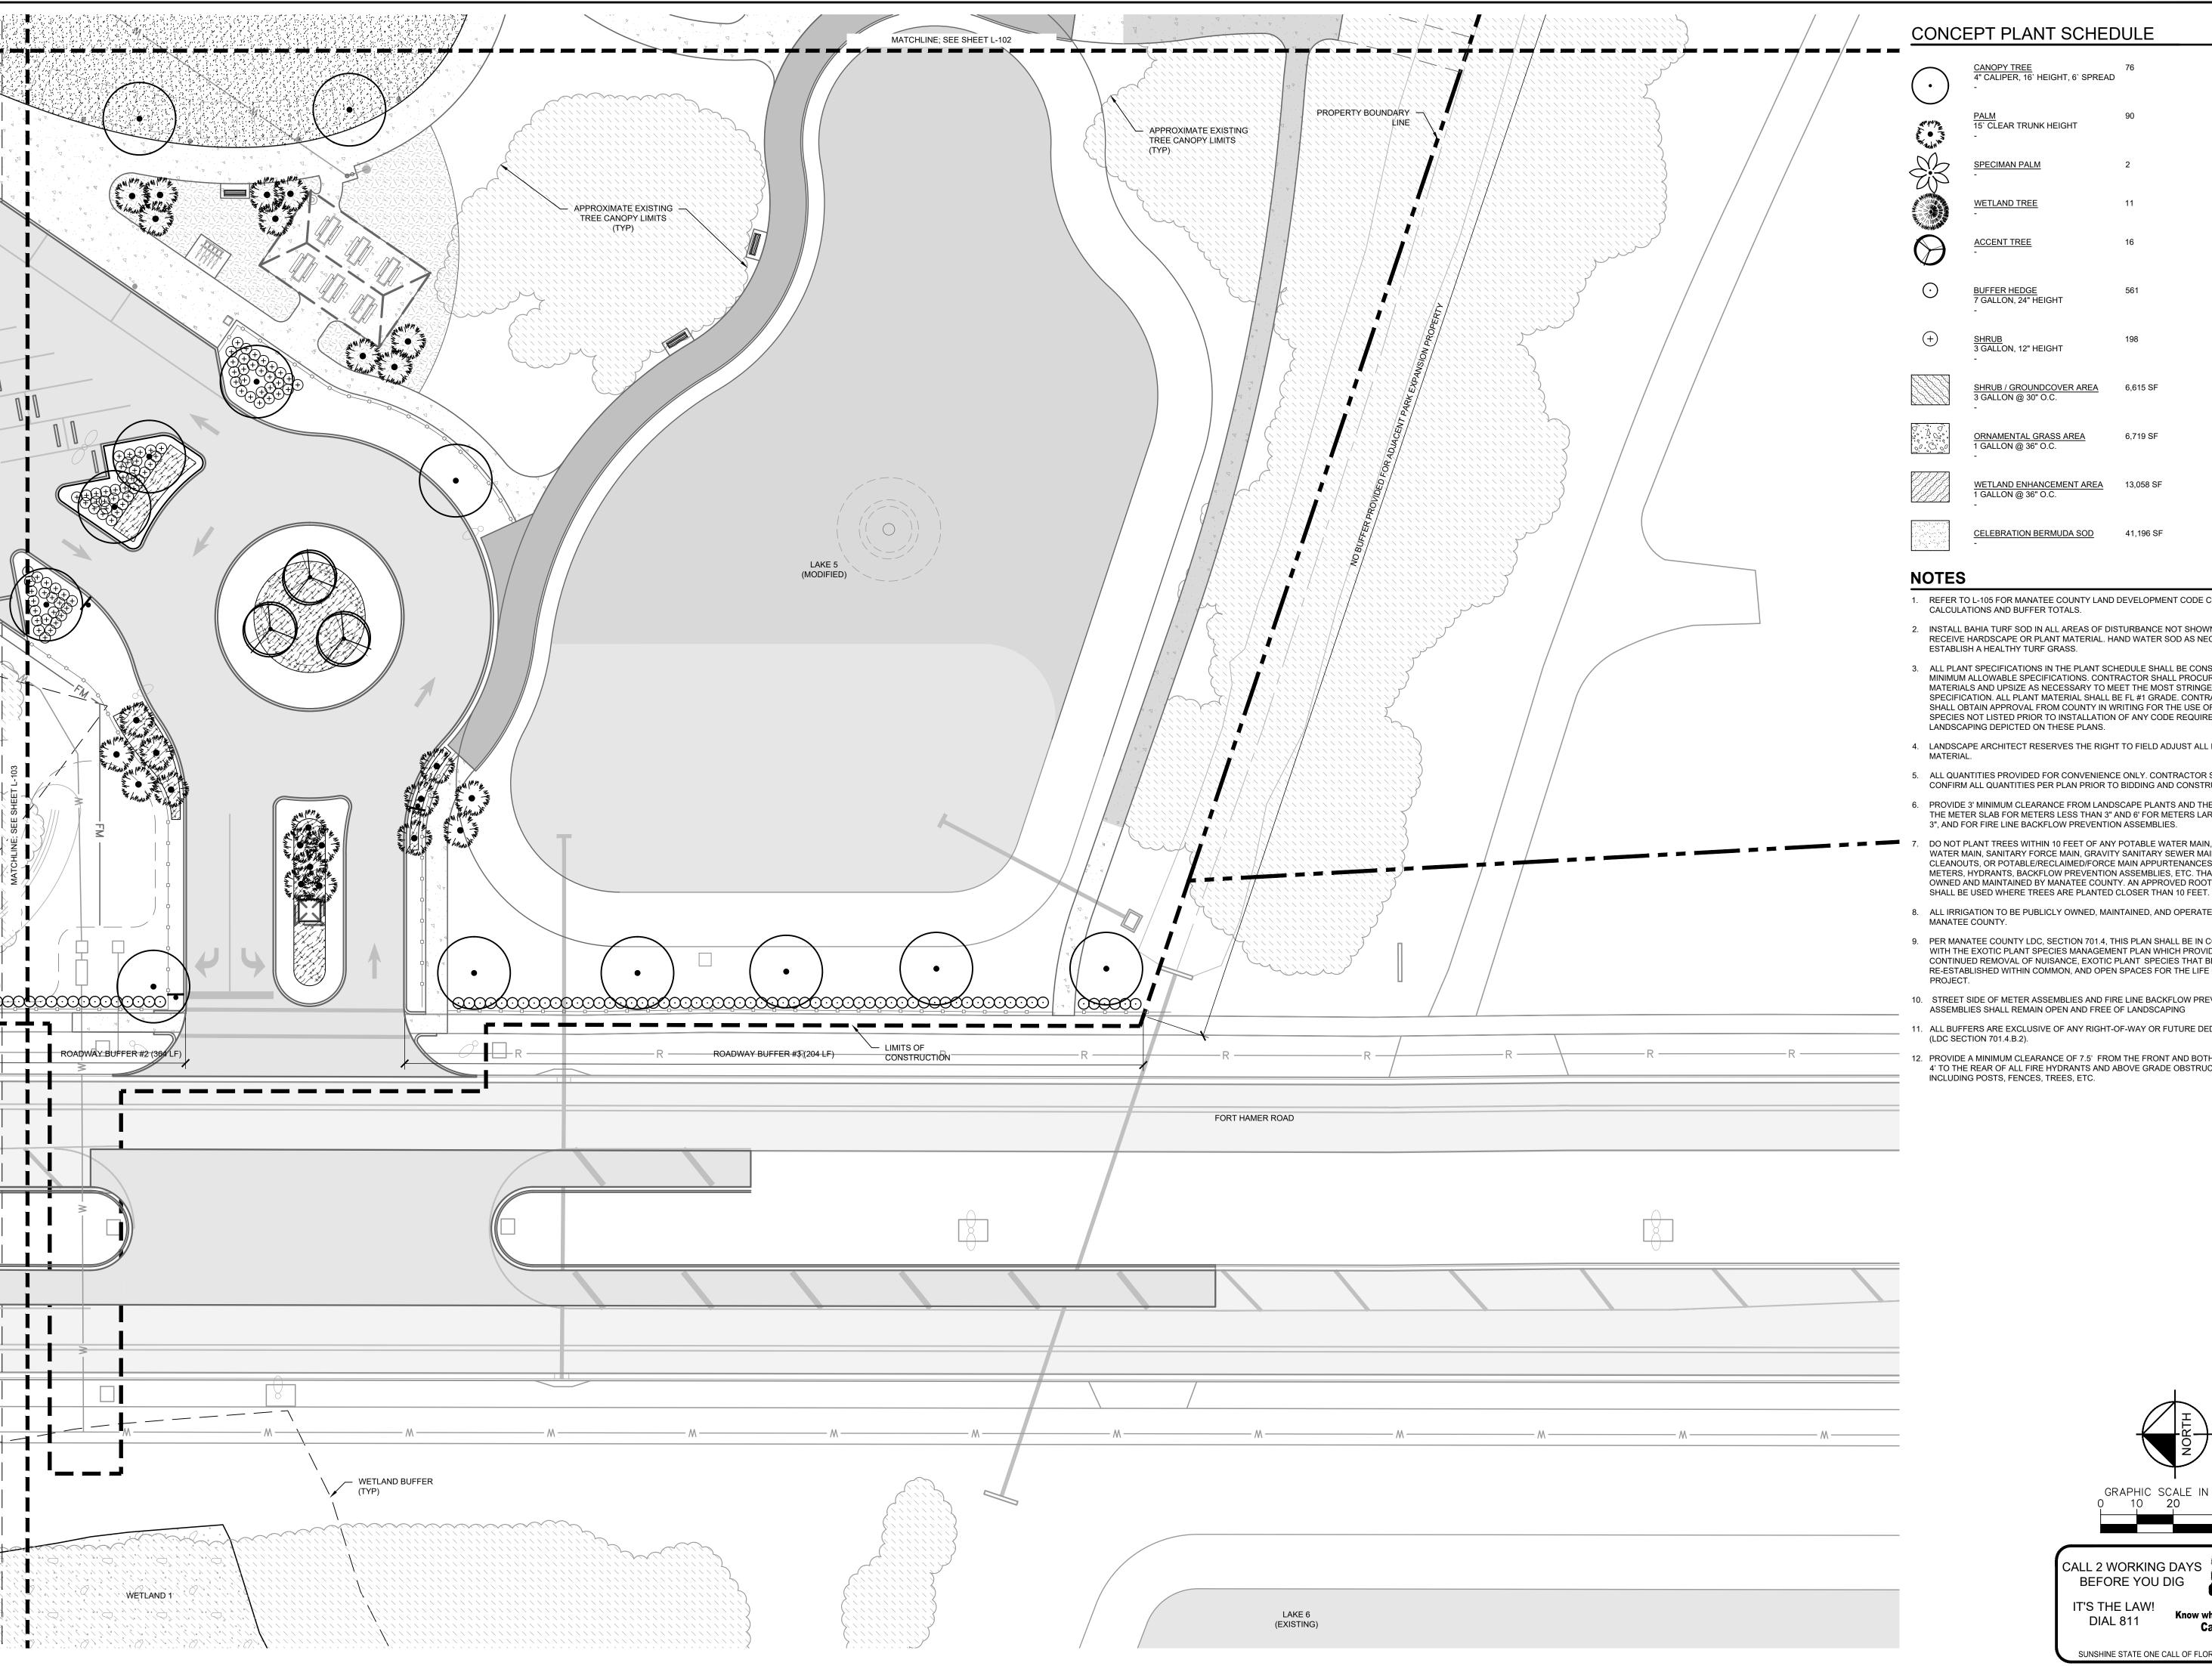

CONCEPT PLANT SCHEDULE

CANOPY TREE 4" CALIPER, 16' HEIGHT, 6' SPREAD

6,615 SF

- 1. REFER TO L-105 FOR MANATEE COUNTY LAND DEVELOPMENT CODE COMPLIANCE CALCULATIONS AND BUFFER TOTALS.
- 2. INSTALL BAHIA TURF SOD IN ALL AREAS OF DISTURBANCE NOT SHOWN TO RECEIVE HARDSCAPE OR PLANT MATERIAL. HAND WATER SOD AS NECESSARY TO ESTABLISH A HEALTHY TURF GRASS.
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- DO NOT PLANT TREES WITHIN 10 FEET OF ANY POTABLE WATER MAIN, RECLAIMED WATER MAIN, SANITARY FORCE MAIN, GRAVITY SANITARY SEWER MAIN, SANITARY CLEANOUTS, OR POTABLE/RECLAIMED/FORCE MAIN APPURTENANCES SUCH AS METERS, HYDRANTS, BACKFLOW PREVENTION ASSEMBLIES, ETC. THAT ARE OWNED AND MAINTAINED BY MANATEE COUNTY. AN APPROVED ROOT BARRIER
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CALL 2 WORKING DAYS BEFORE YOU DIG

IT'S THE LAW! Know what's **below**.

Call before you dig. SUNSHINE STATE ONE CALL OF FLORIDA, INC.

SHEET NUMBER

MMUNI

© 2022 7 MAIN

LANDSCAPE SPECIFICATIONS

1. SCOPE OF WORK

- 1.1. THE WORK CONSISTS OF: FURNISHING ALL LABOR, MATERIALS, EQUIPMENT, TOOLS, TRANSPORTATION, AND ANY OTHER APPURTENANCES NECESSARY FOR THE COMPLETION OF THIS PROJECT AS SHOWN ON THESE PLANS.
- 1.2. WORK SHALL INCLUDE MAINTENANCE AND WATERING OF ALL CONTRACT PLANTING AREAS UNTIL CERTIFICATION OF ACCEPTANCE BY THE OWNER.
- 1.3. WORK SHALL BE COORDINATED WITH OTHER TRADES TO PREVENT CONFLICTS.

2. PROTECTION OF EXISTING AND PROPOSED SITE ELEMENTS

- 2.1. PROTECT ALL EXISTING SITE ITEMS, ALREADY COMPLETED OR ESTABLISHED AND DESIGNATED TO REMAIN FROM DAMAGE BY THE CONTRACTOR UNLESS OTHERWISE SPECIFIED. ALL DAMAGE RESULTING FROM THE CONTRACTOR'S WORK SHALL BE REPAIRED OR REPLACED TO THE SATISFACTION OF THE OWNER, AT NO COST TO THE OWNER.
- 2.2. MAINTAIN ALL NECESSARY BMP DEVICES THROUGHOUT THE DURATION OF ALL CONSTRUCTION ACTIVITIES.
- 2.3. WHERE APPLICABLE, SUBMIT A DETAILED PROJECT SPECIFIC WORK ZONE TRAFFIC CONTROL PLAN IN ACCORDANCE WITH THE APPROPRIATE REGULATORY AGENCY STANDARDS UNLESS THE WORK REQUIRES NOTHING MORE THAN A DIRECT APPLICATION OF FDOT STANDARD PLANS FOR ROAD AND BRIDGE CONSTRUCTION, INDEX 102-600.
- 2.4. THE CONTRACTOR SHALL BE RESPONSIBLE FOR LOCATING ALL UTILITIES, WHETHER PUBLIC OR PRIVATE, PRIOR TO CONSTRUCTION ACTIVITIES. THE INFORMATION AND DATA SHOWN WITH RESPECT TO EXISTING UTILITIES IS APPROXIMATE. THE OWNER AND DESIGN PROFESSIONAL SHALL NOT BE RESPONSIBLE FOR THE ACCURACY AND COMPLETENESS OF ANY SUCH INFORMATION OR DATA. THE CONTRACTOR SHALL HAVE FULL RESPONSIBILITY FOR; REVIEWING AND CHECKING ALL SUCH INFORMATION AND DATA; LOCATING ALL UTILITIES PRIOR TO CONSTRUCTION; THE SAFETY AND PROTECTION THEREOF REPAIRING ANY DAMAGE RESULTING FROM THE WORK THE COST OF ALL WILL BE CONSIDERED AS HAVING BEEN INCLUDED IN THE CONTRACT PRICE. THE CONTRACTOR SHALL NOTIFY ANY AFFECTED UTILITY COMPANIES OR AGENCIES IN WRITING AT LEAST 48 HOURS PRIOR TO BEGINNING CONSTRUCTION. THE CONTRACTOR SHALL NOTIFY THE LANDSCAPE ARCHITECT IN WRITING WHEN ANY CONFLICT BETWEEN UTILITIES AND THESE PLANS EXIST PRIOR TO
- 2.5. THE CONTRACTOR SHALL BE RESPONSIBLE FOR ALL UNAUTHORIZED CUTTING OR DAMAGE TO PLANT MATERIAL EXISTING OR OTHERWISE. THIS SHALL INCLUDE COMPACTION AND SPILLING OF ANY DELETERIOUS MATERIALS WITHIN THE DRIP-LINE OF EXISTING TREES TO REMAIN. PLANT MATERIAL KILLED OR DAMAGED THAT IS MISSHAPEN AND/OR UNSIGHTLY SHALL BE REPLACED WITH LIKE SIZE AND KIND TO THE SATISFACTION OF THE OWNER OR REGULATORY AGENCY AT THE COST TO THE CONTRACTOR.
- 2.6. SEE TREE MITIGATION PLAN AND NOTES, IF APPLICABLE.

3. SUBMITTALS

3.1. SUBMIT MATERIAL SAMPLES LISTED BELOW FOR APPROVAL, ON SITE OR AS DETERMINED BY THE OWNER. UPON APPROVAL, DELIVERY OF MATERIALS MAY COMMENCE.

> MATERIAL SAMPLE SIZE

ONE (1) GALLON PLASTIC BAG MUI CH SOIL MIXTURE ONE (1) GALLON PLASTIC BAG

ONE (1) OF EACH VARIETY (OR TAGGED IN NURSERY)

3.2. SUBMIT TESTING RESULTS OF SOIL MIXTURE AS PER SECTION 6 BELOW.

4. PLANT MATERIALS

- 4.1. ALL PLANT MATERIAL SHALL CONFORM TO THE SPECIFICATIONS INDICATED ON THE DRAWINGS AND SHALL BE IN ACCORDANCE WITH GRADES AND STANDARDS FOR NURSERY PLANTS, LATEST EDITION, PUBLISHED BY THE FLORIDA DEPARTMENT OF AGRICULTURE AND CONSUMER SERVICES. ALL PLANTS SHALL BE FLORIDA GRADE NO. 1 OR BETTER AS DETERMINED BY THE FLORIDA DIVISION OF PLANT INDUSTRY. ALL MATERIALS SHALL BE SUBJECT TO APPROVAL BY THE OWNER OR OWNER'S REPRESENTATIVE. NO SUBSTITUTIONS SHALL BE MADE WITHOUT WRITTEN PERMISSION FROM THE LANDSCAPE ARCHITECT AND OWNER.
- 4.2. ALL TREE SPECIES INSTALLED SHALL BE MATCHED IN SIZE AND SHAPE UNLESS NOTED OTHERWISE
- 4.3. PLANTS SHALL BE SUBJECT TO INSPECTION AND APPROVAL AT THE PLACE OF GROWTH, UPON DELIVERY TO THE SITE, DURING PROGRESS OF THE WORK AND/OR AFTER COMPLETION. REJECTED PLANTS SHALL BE REMOVED AND REPLACED

5. DIGGING AND HANDLING

5.1. PROTECT ROOTS OR ROOT BALLS OF PLANTS AT ALL TIMES FROM SUN, DRYING WINDS, WATER AND FREEZING, AS NECESSARY UNTIL PLANTING. NO PLANT MATERIAL SHALL BE HANDLED BY STEMS.

6. SOIL MIXTURE (PLANTING MEDIUM, PLANTING MIX, TOPSOIL MIX)

- TEST EXISTING SOIL AND AMEND AS NECESSARY IN ACCORDANCE WITH THE GUIDELINES BELOW
- 6.2. SOIL MIXTURE (PLANTING MEDIUM FOR PLANT PITS) SHALL CONSIST OF TWO PARTS OF TOPSOIL AND ONE PART SAND, AS DESCRIBED BELOW. SUBMIT SAMPLES AND PH TESTING RESULTS OF SOIL MIXTURE FOR OWNER'S REPRESENTATIVE APPROVAL PRIOR TO PLANT INSTALLATION OPERATIONS COMMENCE.
- 6.3. TOPSOIL FOR USE IN PREPARING SOIL MIXTURE FOR BACKFILLING PLANT PITS SHALL BE FERTILE, FRIABLE, AND OF A LOAMY CHARACTER; REASONABLY FREE OF SUBSOIL, CLAY LUMPS, BRUSH WEEDS AND OTHER LITTER; FREE OF ROOTS, STUMPS, STONES LARGER THAN 2" IN ANY DIRECTION, AND OTHER EXTRANEOUS OR TOXIC MATTER HARMFUL TO PLANT GROWTH. IT SHALL CONTAIN THREE (3) TO FIVE (5) PERCENT DECOMPOSED ORGANIC MATTER AND HAVE A PH BETWEEN 5 5 AND 7 0
- 6.4. SAND SHALL BE COARSE, CLEAN, WELL-DRAINING, NATIVE SAND.
- 6.5. PLANT TREES IN THE EXISTING NATIVE SOIL ON SITE, UNLESS DETERMINED TO BE UNSUITABLE AT WHICH POINT THE CONTRACTOR SHALL CONTACT OWNER'S REPRESENTATIVE TO DISCUSS ALTERNATE RECOMMENDATION PRIOR TO

7. WATER

- 7.1. PROVIDE WATER NECESSARY FOR PLANTING ESTABLISHMENT AND MAINTENANCE. WATER SHALL BE OF SATISFACTORY QUALITY TO SUSTAIN ADEQUATE PLANT GROWTH AND SHALL NOT CONTAIN HARMFUL, NATURAL OR MAN-MADE ELEMENTS DETRIMENTAL TO PLANTS.
- 7.2. WATERING/IRRIGATION RESTRICTIONS MAY APPLY REFER TO PROPERTY'S JURISDICTIONAL AUTHORITY.

8. FERTILIZER

- 8.1. PROVIDE FERTILIZER APPLICATION SCHEDULE TO OWNER, AS APPLICABLE TO SOIL TYPE, PLANT INSTALLATION TYPE. AND SITE'S PROPOSED USE. SUGGESTED FERTILIZER TYPES SHALL BE ORGANIC OR OTHERWISE NATURALLY-DERIVED.
- 8.2. FERTILIZER RESTRICTIONS MAY APPLY REFER TO PROPERTY'S JURISDICTIONAL AUTHORITY.

9. MULCH

- 9.1. MOISTEN MULCH MATERIAL AT THE TIME OF APPLICATION TO PREVENT WIND DISPLACEMENT, AND APPLIED AT A MINIMUM DEPTH OF THREE (3) INCHES. CONTRACTOR SHALL CLEAR MULCH FROM WITHIN A SIX (6) INCH RADIUS AROUND TRUNK / STEM FLARE. MULCH SHALL BE "FLORIMULCH", EUCALYPTUS MULCH, OR SIMILAR SUSTAINABLY HARVESTED MULCH UNLESS SPECIFIED OTHERWISE.
- 9.2. PROVIDE A THREE (3) INCH MINIMUM LAYER OF SPECIFIED MULCH OVER THE ENTIRE AREA OF EACH PLANTING BED AND TREE RING (SIX (6) FOOT DIAMETER MINIMUM).

10. CONTAINER GROWN STOCK

- 10.1. CONTAINER GROWN PLANTS SHALL HAVE BEEN GROWN IN IT'S CONTAINER SUFFICIENTLY LONG ENOUGH FOR THE NEW FIBROUS ROOTS TO HAVE DEVELOPED SO THAT THE ROOT MASS WILL RETAIN ITS SHAPE AND HOLD TOGETHER WHEN REMOVED FROM THE CONTAINER.
- 10.2. INSUFFICIENT OR POORLY STRUCTURED ROOT SYSTEMS ARE NOT ACCEPTABLE AND WILL BE REJECTED.
- 10.3. ROOTS PLUS GROWER (RPG) PRODUCTS SHALL BE USED WHERE SPECIFIED.

11. MATERIALS LIST

11.1. ALL QUANTITIES ARE PROVIDED FOR CONVENIENCE ONLY. CONTRACTOR SHALL CONFIRM ALL QUANTITIES PER PLAN PRIOR TO BIDDING AND CONSTRUCTION.

12. FINE GRADING

- 12.1. THE CONTRACTOR SHALL BE RESPONSIBLE FOR FINE GRADING WHICH CONSISTS OF FINAL FINISHED GRADING (INCLUDING ADDITIONAL SOIL MIXTURE AS NEEDED) FOR LAWN AND PLANTING AREAS THAT HAVE BEEN ROUGH GRADED BY OTHERS. FINISH GRADE SHALL ACCOUNT FOR THICKNESS OF SOD AND/OR MULCH DEPTH.
- 12.2. ALL PLANTING AREAS SHALL BE GRADED AND MAINTAINED FOR POSITIVE DRAINAGE TO SURFACE/SUBSURFACE STORM DRAIN SYSTEMS. AREAS ADJACENT TO BUILDINGS SHALL SLOPE AWAY FROM THE BUILDINGS. REFER TO CIVIL ENGINEER'S PLANS FOR FINAL GRADES, IF APPLICABLE.

13.1. CLEAN WORK AND SURROUNDING AREAS OF ALL RUBBISH OR OBJECTIONABLE MATTER DAILY. REMOVE ALL MORTAR, CEMENT, AND TOXIC MATERIAL FROM THE SURFACE OF ALL PLANT BEDS. DO NOT MIX THESE MATERIALS WITH THE SOIL. SHOULD THE CONTRACTOR FIND SUCH SOIL CONDITIONS BENEATH THE SOIL WHICH WILL IN ANY WAY ADVERSELY AFFECT THE PLANT GROWTH, IMMEDIATELY CALL IT TO THE ATTENTION OF THE OWNER'S REPRESENTATIVE.

- 13.2. LOCATE, MAINTAIN AND PROTECT ALL UTILITIES ABOVE AND BELOW GROUND. CALL SUNSHINE STATE ONE CALL OF FLORIDA, INC. (811) TO LOCATE UTILITIES AT LEAST 48 HOURS PRIOR TO CONSTRUCTION.
- 13.3. NOTIFY LANDSCAPE ARCHITECT IN WRITING IMMEDIATELY IF CONFLICT(S) EXIST WITH PROPOSED TREE LOCATIONS AND EXISTING OVERHEAD POWER LINES IN ACCORDANCE WITH SETBACK REQUIREMENTS OF FPL'S "RIGHT TREE, RIGHT PLACE" PROGRAM. CONSULT THE UNIVERSITY OF FLORIDA'S "TREES AND POWER LINE" WEBSITE FOR TREE SIZE CATEGORIES.
- 13.4. NOTIFY LANDSCAPE ARCHITECT IN WRITING IMMEDIATELY IF CONFLICT(S) EXIST WITH PROPOSED TREE LOCATIONS AND EXISTING / PROPOSED LIGHT POLES. TREES INSTALLED IN CONFLICT WITH LIGHT POLES ARE SUBJECT TO RELOCATION AT
- 13.5. REMOVE ALL EXISTING AND IMPORTED DELETERIOUS MATERIAL AND SUB-BASE FROM ALL LANDSCAPE PLANTING AREAS TO A MINIMUM DEPTH OF 36" OR TO NATIVE SOIL. CONTRACTOR IS RESPONSIBLE TO BACKFILL THESE PLANTING AREAS TO ROUGH FINISHED GRADE AS NEEDED WITH CLEAN SOIL MIXTURE.
- 13.6. FURNISH NURSERY'S CERTIFICATE OF COMPLIANCE WITH ALL APPLICABLE REQUIREMENTS. COMPLY WITH APPLICABLE FEDERAL, STATE, COUNTY, AND LOCAL REGULATIONS GOVERNING LANDSCAPE MATERIALS AND WORK.
- 13.7. EXCAVATE ALL PLANTING PITS IN ACCORDANCE WITH LANDSCAPE DETAILS PROVIDED. TEST ALL TREE PITS WITH WATER BEFORE PLANTING TO ASSURE PROPER DRAINAGE PERCOLATION IS AVAILABLE. IF POOR DRAINAGE EXISTS, NOTIFY LANDSCAPE ARCHITECT IMMEDIATELY IN WRITING. NO ALLOWANCE WILL BE MADE FOR LOST PLANTS DUE TO IMPROPER DRAINAGE. CONTRACTOR SHALL ENSURE ELIMINATION OF ALL AIR POCKETS AROUND ROOTS.
- 13.8. SET TREES AND SHRUBS STRAIGHT AT AN ELEVATION THAT, AFTER SETTLEMENT, THE PLANT CROWN WILL STAND ONE (1) TO TWO (2) INCHES ABOVE GRADE. EACH PLANT SHALL BE SET IN THE CENTER OF THE PIT. PLANTING SOIL MIXTURE SHALL BE BACK FILLED, THOROUGHLY TAMPED AROUND THE BALL, AND SETTLED BY WATER (AFTER TAMPING).
- 13.9. DO NOT COVER TOP OF BALL WITH SOIL MIXTURE. ALL BURLAP, ROPE, WIRES, BASKETS, ETC., SHALL BE REMOVED FROM UPPER ONE THIRD (1/3) OF ROOT BALLS.
- 13.10. ALL SUCKER GROWTH AND BROKEN OR BADLY DAMAGED BRANCHES SHALL BE REMOVED WITH A CLEAN CUT IN ACCORDANCE WITH ANSI A-300

STABILITY AND MAINTAIN TREES IN A PLUMB AND UPRIGHT POSITION.

- 13.11. SHRUBS AND GROUND COVER PLANTS SHALL BE SPACED IN ACCORDANCE WITH THE DRAWINGS, LANDSCAPE DETAILS AND AS INDICATED ON THE PLANT LIST. 13.12. TREE GUYING AND BRACING SHALL BE INSTALLED BY THE CONTRACTOR IN ACCORDANCE WITH THE PLANS TO INSURE
- 13.13. FAILURE TO FOLLOW THE ABOVE PLANTING PROCEDURE SHALL MAKE THE CORRECTIVE MEASURES THE RESPONSIBILITY

14. LAWN SODDING

- 14.1. THE WORK CONSISTS OF LAWN BED PREPARATION, SOIL PREPARATION, AND SODDING NECESSARY TO PRODUCE A TURF GRASS LAWN ACCEPTABLE TO THE OWNER.
- 14.2. ALL AREAS THAT ARE TO BE SODDED SHALL BE CLEARED OF ANY ROUGH GRASS, WEEDS, AND DEBRIS TO A MINIMUM DEPTH OF THREE (3) INCHES. PROVIDE ONE (1) INCH OF TOPSOIL ACROSS ENTIRE LAWN BED AND MIX THROUGHLY INTO TOP FOUR (4) INCHES OF SOIL TO BRING THE GROUND TO AN EVEN GRADE. THE ENTIRE SURFACE SHALL BE ROLLED WITH A ROLLER WEIGHING NOT MORE THAN ONE-HUNDRED (100) POUNDS PER FOOT OF WIDTH. DURING THE ROLLING, ALL DEPRESSIONS CAUSED BY SETTLEMENT SHALL BE FILLED WITH ADDITIONAL TOPSOIL AND THE SURFACE SHALL BE REGRADED AND ROLLED UNTIL PRESENTING A SMOOTH AND EVEN FINISH TO THE REQUIRED GRADE.
- 14.3. HAND RAKE LAWN BED UNTIL ALL BUMPS AND DEPRESSIONS ARE REMOVED. WET PREPARED AREA THOROUGHLY.
- 14.4. SOD ALL AREAS THAT ARE NOT PAVED OR PLANTED AS DESIGNATED ON THE DRAWINGS WITHIN THE CONTRACT LIMITS, UNLESS SPECIFICALLY NOTED OTHERWISE.
- 14.5. THE SOD SHALL BE CERTIFIED TO MEET FLORIDA STATE PLANT BOARD SPECIFICATIONS, ABSOLUTELY TRUE TO VARIETAL TYPE, AND FREE FROM WEEDS, FUNGUS, INSECTS AND DISEASE OF ANY KIND.
- 14.6. SOD PANELS SHALL BE LAID TIGHTLY TOGETHER SO AS TO MAKE A SOLID SODDED LAWN AREA. SOD SHALL BE LAID UNIFORMLY AGAINST THE EDGES OF ALL CURBS AND OTHER HARDSCAPE ELEMENTS, PAVED AND PLANTED AREAS
- 14.7. IMMEDIATELY FOLLOWING SOD LAYING, ROLL LAWN AREAS WITH A LAWN ROLLER AND THEN THOROUGHLY IRRIGATED. 14.8 IF IN THE OPINION OF THE OWNER TOP-DRESSING IS NECESSARY AFTER ROLLING TO FILL THE VOIDS BETWEEN THE SOD
- PANELS AND TO EVEN OUT INCONSISTENCIES IN THE SOD, CLEAN SAND, AS APPROVED BY THE OWNER'S REPRESENTATIVE, SHALL BE UNIFORMLY SPREAD OVER THE ENTIRE SURFACE OF THE SOD AND THOROUGHLY WATERED IN. FERTILIZE INSTALLED SOD AS ALLOWED BY PROPERTY'S JURISDICTIONAL AUTHORITY.
- 14.9. DURING DELIVERY, PRIOR TO, AND DURING THE PLANTING OF THE LAWN AREAS, THE SOD PANELS SHALL AT ALL TIMES BE PROTECTED FROM EXCESSIVE DRYING AND UNNECESSARY EXPOSURE OF THE ROOTS TO THE SUN. ALL SOD SHALL BE STACKED SO AS NOT TO BE DAMAGED BY EXCESSIVE HEAT AND MOISTURE.
- 14.10. WITHIN THE CONTRACT LIMITS, PRODUCE AND MAINTAIN A DENSE, WELL ESTABLISHED LAWN. THE CONTRACTOR SHALL BE RESPONSIBLE FOR THE REPAIR AND RE-SODDING OF ALL ERODED, SUNKEN OR BARE SPOTS UNTIL CERTIFICATION OF ACCEPTANCE BY THE OWNER'S REPRESENTATIVE. REPAIRED SODDING SHALL BE ACCOMPLISHED AS IN THE ORIGINAL WORK (INCLUDING REGRADING IF NECESSARY).

15. CLEANUP

15.1. UPON COMPLETION OF ALL PLANTING WORK AND BEFORE FINAL ACCEPTANCE, REMOVE ALL MATERIAL, EQUIPMENT, AND DEBRIS RESULTING FROM HIS WORK. ALL PAVED AREAS SHALL BE CLEANED AND THE SITE LEFT IN A NEAT AND ACCEPTABLE CONDITION AS APPROVED BY THE OWNER'S REPRESENTATIVE.

16. PLANT MATERIAL MAINTENANCE

16.1. ALL PLANT MATERIAL SHALL BE MAINTAINED BY WATERING. CULTIVATING. SPRAYING. AND ALL OTHER OPERATIONS (SUCH AS RE-STAKING OR REPAIRING GUY SUPPORTS) AS NECESSARY TO INSURE HEALTHY AND VIGOROUS GROWING CONDITIONS BY THE CONTRACTOR UPON DELIVERING TO THE SITE AND UNTIL FINAL ACCEPTANCE OF WORK.

17. FINAL INSPECTION AND ACCEPTANCE OF WORK

- 17.1. ALL PLANT BEDS SHALL BE KEPT FREE OF NOXIOUS WEEDS UNTIL FINAL ACCEPTANCE OF WORK. PRIOR TO FINAL INSPECTION, TREAT ALL PLANTING BEDS WITH AN APPROVED PRE-EMERGENT HERBICIDE PER MANUFACTURER RECOMMENDATIONS. (AS ALLOWED BY JURISDICTIONAL AUTHORITY)
- 17.2. PROVIDE WATERING/IRRIGATION SCHEDULE FOR ALL PLANT MATERIAL TO OWNER. OBSERVE ALL APPLICABLE WATERING RESTRICTIONS AS SET FORTH BY THE PROPERTY'S JURISDICTIONAL AUTHORITY.
- 17.3. UPON COMPLETION OF ALL WORK, A FINAL INSPECTION SHALL BE PERFORMED BY THE OWNER AND/OR OWNER'S REPRESENTATIVE. ALL PLANTING, CONSTRUCTION AND ALL OTHER INCIDENTAL WORK PERTAINING TO THIS CONTRACT SHALL BE INSPECTED FOR COMPLIANCE WITH THE CONTRACT DOCUMENTS. ANY ITEMS FOUND TO NOT BE IN COMPLIANCE SHALL BE CORRECTED AT THE COST OF THE CONTRACTOR.

18. WARRANTY

- 18.1. THE LIFE AND SATISFACTORY CONDITION OF ALL PLANT MATERIAL INSTALLED BY THE LANDSCAPE CONTRACTOR SHALL BE WARRANTED BY THE CONTRACTOR FOR A MINIMUM OF ONE (1) CALENDAR YEAR COMMENCING AT THE TIME OF CERTIFICATION AND ACCEPTANCE OF THE WORK BY THE OWNER AND/OR OWNER'S REPRESENTATIVE.
- 18.2. ANY PLANT NOT FOUND IN A HEALTHY GROWING CONDITION THROUGHOUT THE WARRANTY PERIOD SHALL BE REMOVED FROM THE SITE AND REPLACED AS SOON AS WEATHER CONDITIONS PERMIT. ALL REPLACEMENTS SHALL BE PLANTS OF THE SAME KIND AND SIZE AS SPECIFIED IN THE PLANT LIST. THEY SHALL BE FURNISHED, PLANTED AND MULCHED AS SPECIFIED AT NO ADDITIONAL COST TO THE OWNER. ANY REPLACED PLANT MATERIAL SHALL BE SUBJECT TO A NEW ONE (1) YEAR WARRANTY
- 18.3. IN THE EVENT THE OWNER DOES NOT CONTRACT WITH THE CONTRACTOR FOR LANDSCAPE AND IRRIGATION MAINTENANCE, THE CONTRACTOR SHOULD VISIT THE PROJECT SITE PERIODICALLY DURING THE ONE (1) YEAR WARRANTY PERIOD TO EVALUATE MAINTENANCE PROCEDURES BEING PERFORMED BY THE OWNER CONTRACTOR SHALL NOTIFY THE OWNER IN WRITING OF MAINTENANCE PROCEDURES OR CONDITIONS WHICH THREATEN VIGOROUS AND HEALTHY PLANT

19. ABBREVIATIONS

- BALLED AND BURLAPPED BARE ROOT
- CALIPER CLEAR TRUNK
- DIAMETER AT BREAST HEIGHT FIFI D GROWN
- FTG -FULL TO GROUND GREY WOOD
- HO -HARDENED OFF OVERALL HEIGHT


ROOTS PLUS GROWER

	REQUIRED	PROVIDED
VEHICLE USE AREA	360 SF OF LANDSCAPING REQUIRED (INCLUDING 4 CANOPY	MAIN PARKING LOT
SECTION 701.3.A.2	TREES, 20 SHRUBS) PER 20 PARKING SPACES MAIN PARKING LOT INTERIOR 50 PARKING SPACES = 900 SF OF LANDSCAPING INCLUDING 10 CANOPY TREES AND 50 SHRUBS	### SF OF LANDSCAPING # CANOPY TREES ## SHRUBS DOG PARK PARKING LOT ### SF OF LANDSCAPING
	DOG PARK PARKING LOT INTERIOR 16 PARKING SPACES = 288 SF OF LANDSCAPING INCLUDING 4 CANOPY TREES AND 16 SHRUBS	# CANOPY TREES ## SHRUBS PERIMETER PARKING LOT BUFFERS
	PERIMETER PARKING LOT BUFFERS 1 TREE PER 40 LINEAR FEET WITH SHRUB ROW	1 TREE PER 40 LINEAR FEET WITH SHRUB RO
FOUNDATION LANDSCAPING	20 SF OF PLANTING / 1000SF GROSS BUILDING AREA	RESTROOM BUILDING ### SF OF LANDSCAPING
SECTION 701.3.C	RESTROOM BUILDING #,### SF / 1000 = ## X 20 = ## SF OF PLANTING	THE CLOT LANDSOALING
ROADWAY AND SCREENING BUFFERS SECTION 701.4.B.2	FORT HAMER ROADWAY BUFFER #1 - 160 LF 10' WIDTH, 2 CANOPY TREES AND 33 SHRUBS PER 100 LF 160 LF / 100 X 2 = 4 TREES REQUIRED 160 LF / 100 X 33 = 53 SHRUBS REQUIRED	FORT HAMER ROADWAY BUFFER #1 10' WIDTH ## CANOPY TREES ## SHRUBS
	FORT HAMER ROADWAY BUFFER #2 - 364 LF 10' WIDTH, 2 CANOPY TREES AND 33 SHRUBS PER 100 LF 364 LF / 100 X 2 = 8 TREES REQUIRED 364 LF / 100 X 33 = 121 SHRUBS REQUIRED	FORT HAMER ROADWAY BUFFER #2 10' WIDTH ## CANOPY TREES ## SHRUBS
	FORT HAMER ROADWAY BUFFER #3 - 204 LF 10' WIDTH, 2 CANOPY TREES AND 33 SHRUBS PER 100 LF 204 LF / 100 X 2 = 5 TREES REQUIRED 204 LF / 100 X 33 = 68 SHRUBS REQUIRED	FORT HAMER ROADWAY BUFFER #3 10' WIDTH ## CANOPY TREES ## SHRUBS
	SCREENING BUFFER #1 (REC. ABUTTING RESIDENTIAL) - 283 LF 10' WIDTH, 2-1/2 CANOPY TREES AND 33 SHRUBS PER 100 LF 283 LF / 100 X 2.5 = 8 TREES REQUIRED 283 LF / 100 X 33 = 94 SHRUBS REQUIRED	SCREENING BUFFER #1 10' WIDTH ## CANOPY TREES ## SHRUBS
	SCREENING BUFFER #2 (REC. ABUTTING RESIDENTIAL) - 700 LF 10' WIDTH, 2-1/2 CANOPY TREES AND 33 SHRUBS PER 100 LF 700 LF / 100 X 2.5 = 18 TREES REQUIRED 700 LF / 100 X 33 = 231 SHRUBS REQUIRED	SCREENING BUFFER #2 10' WIDTH ## CANOPY TREES ## SHRUBS
PLANT MATERIAL SECTION 701.8.B&C	TREES: HEIGHT: 10'(CANOPY), 6'(UNDERSTORY) 15'(PALM) CALIPER: 2.5" (CANOPY), 1.5"(UNDERSTORY) SPREAD: 4'	REFER TO PLANT SCHEDULE
	SHRUBS: SIZE: 24" HT, 3 GALLON (HEDGE), 8" HT, 1 GALLON (VUA SHRUBS)	
PALMS SECTION 701.4.A.17	NO MORE THAN 40% PALMS	# PALMS PROPOSED # / ## TOTAL = ##% PALMS
NATIVE SPECIES	AT LEAST 30% NATIVE SPECIES	277 / 693 TOTAL PLANTS = 39% NATIVE
SECTION 701.4.A.4		

LANDSCAPE CODE CALCULATIONS (PER MANATEE COUNTY LAND DEVELOPMENT CODE)

SHEET NUMBER L-105

13. PLANTING PROCEDURES

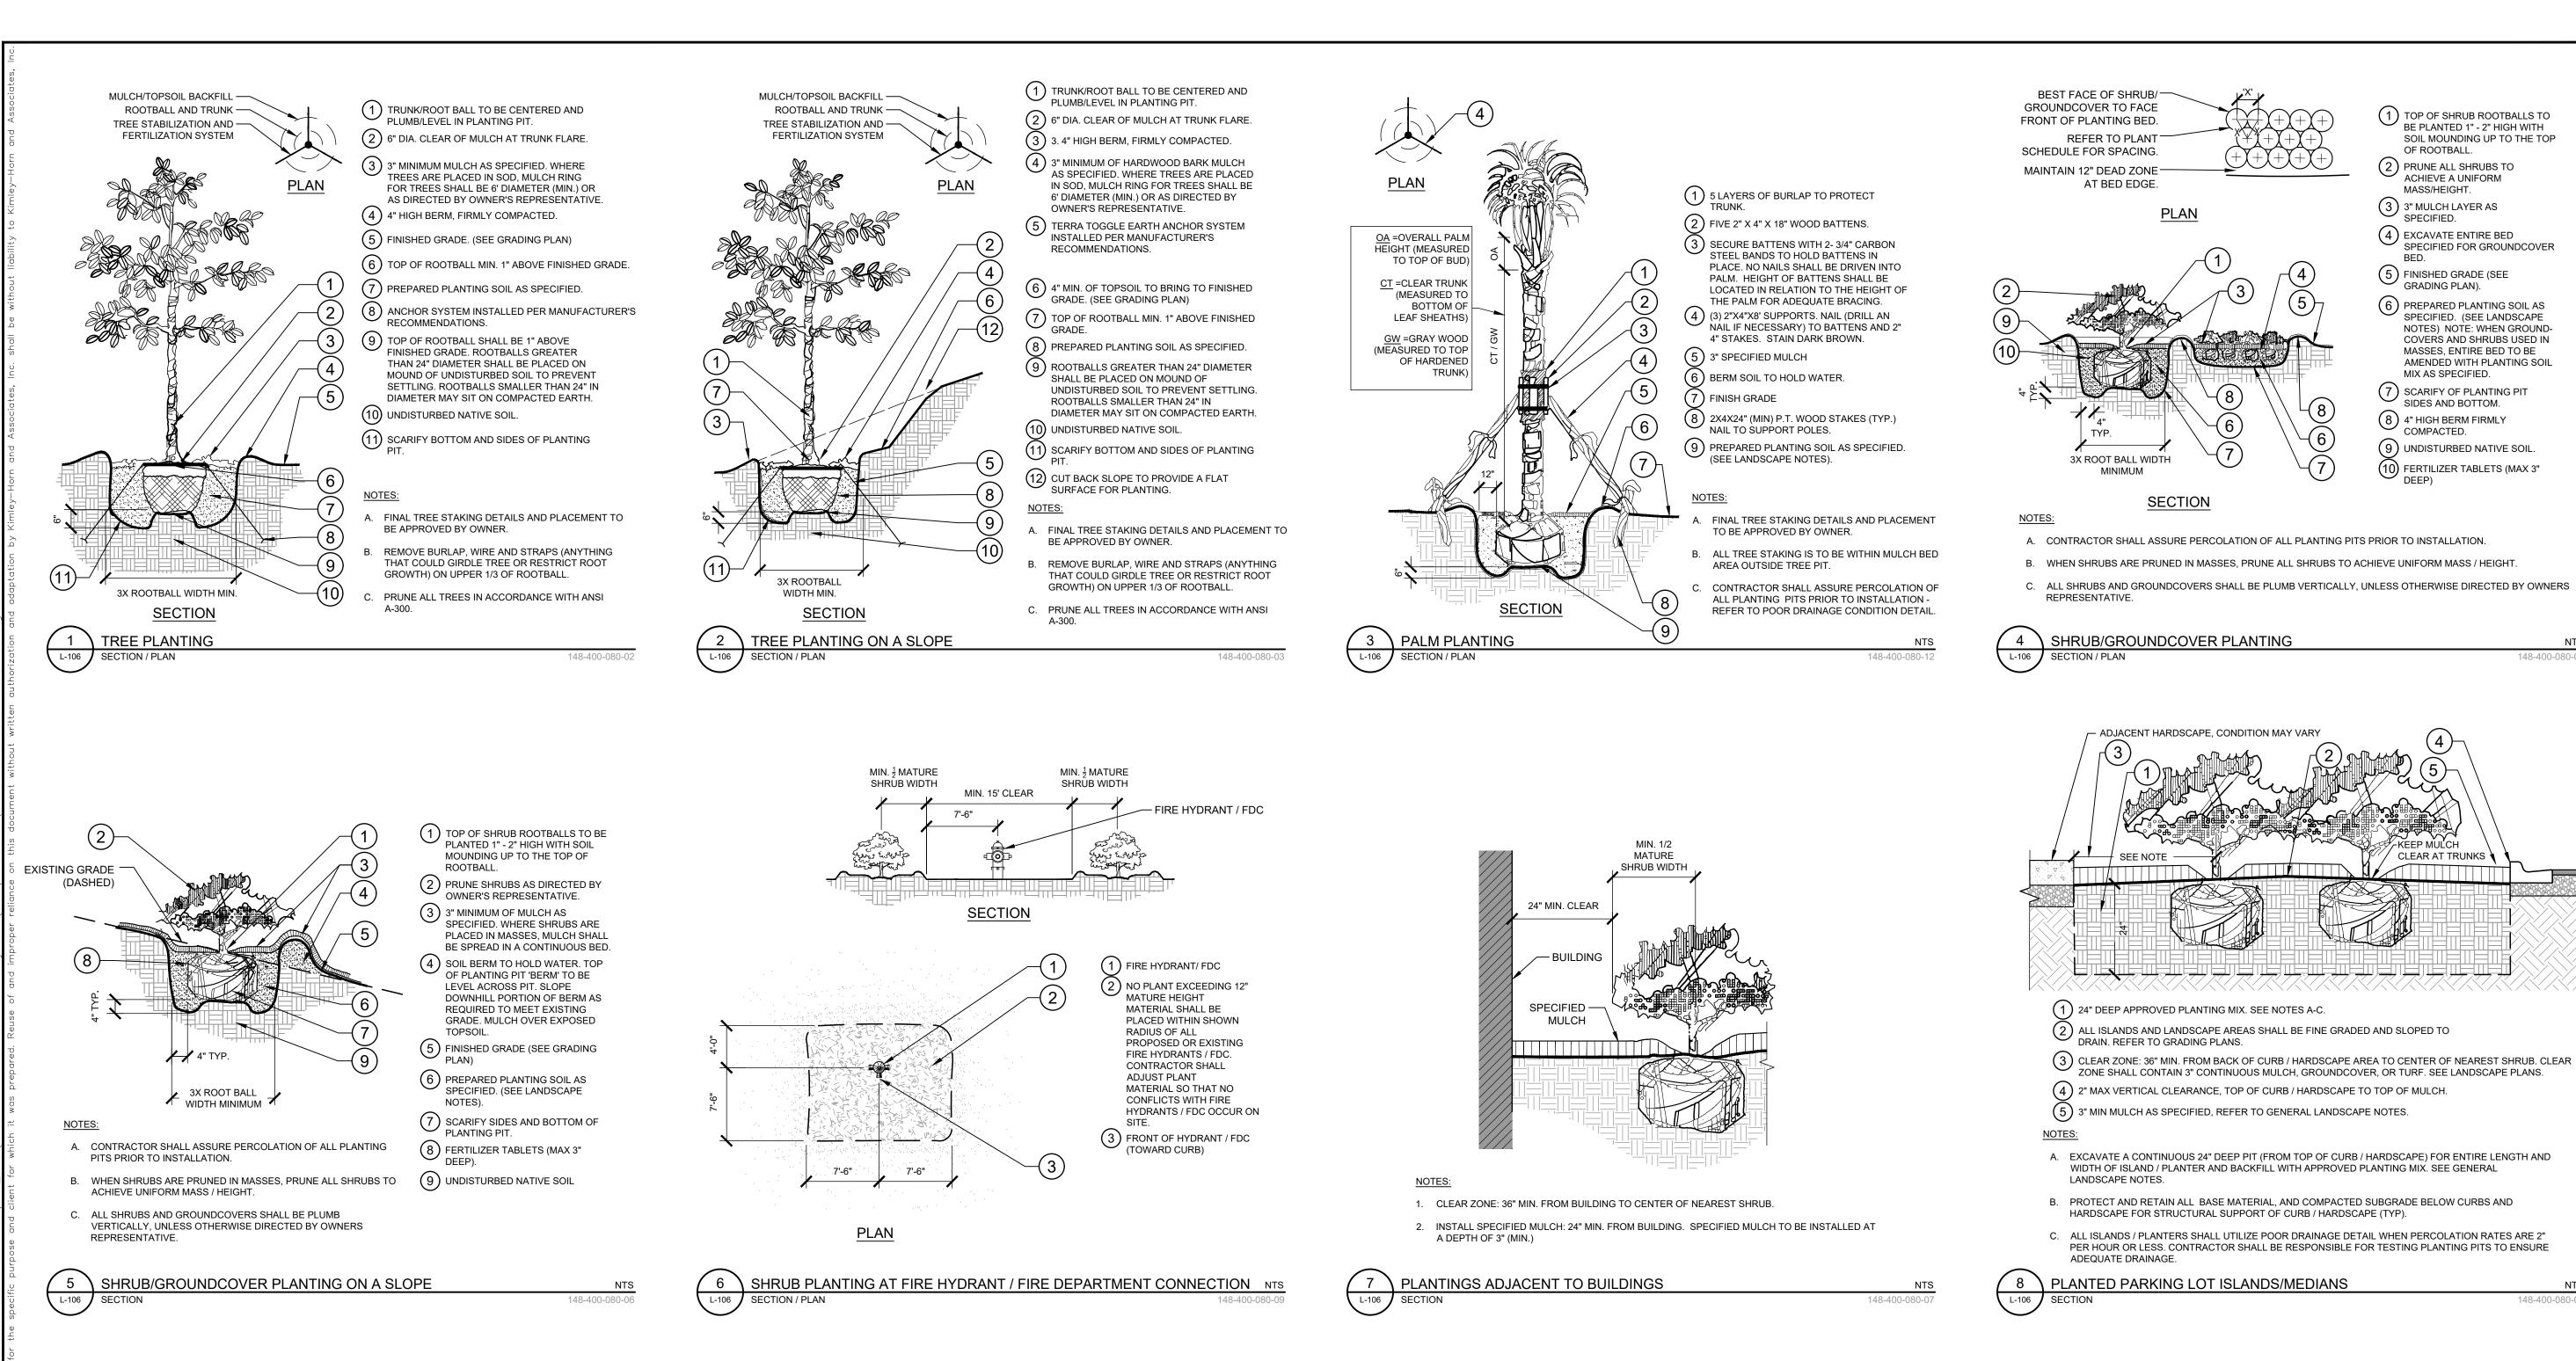

(1) FINISH GRADE (SEE GRADING PLANS).

(2) BACKFILL WITH PREPARED PLANTING

3) FILTER CLOTH, MIRAFI 500X OR BETTER.

THROUGH OCCLUDING LAYER TO WATER TABLE OR TO A DEPTH OF 7' TO ASSURE

REQUIRED DEPTH THROUGH OCCLUDING

9) SET ROOTBALL ON UNDISTURBED STABLE SUBSOIL SO THAT TOP OF ROOT BALL IS

(5) AUGURED HOLE Ø ±18" PENETRATE

(6) BACKFILL WITH 1/2" - 3/4" GRAVEL TO

SOIL MIX AS SPECIFIED.

 $(\,4\,)$ SLOPE BOTTOM TO DRAIN.

PROPER PERCOLATION.


LAYER TO ASSURE PROPER

(7) WATER TABLE. (DEPTH VARIES)

1" ABOVE FINISHED GRADE.

8) UNDISTURBED NATIVE SOIL.

PERCOLATION.

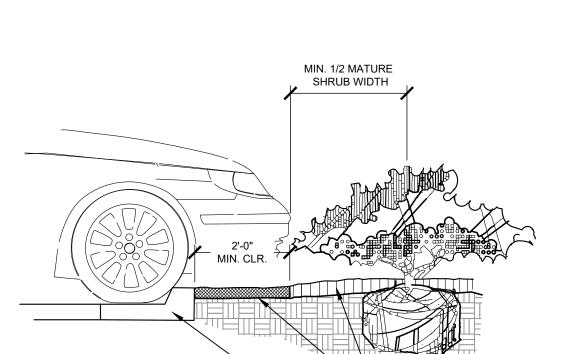

(1) INSTALL CONTINUOUS MULCH BED ADJACENT TO PARKING SPACES AS SHOWN. MULCH SHALL BE MIN. 3" DEEP. NO POP-UP IRRIGATION HEADS SHALL BE

(2) CURB / PARKING LOT EDGE.


A. THIS DETAIL SHALL BE IMPLEMENTED WHERE PERCOLATION RATES ARE 2" PER HOUR OR LOCATED WITHIN 24" OF A PARKING SPACE ON ANY SIDE. CONTRACTOR TO PERFORM PERCOLATION TEST AS REQUIRED. AND NOTIFY OWNER/LANDSCAPE ARCHITECT. C. SEE TYPICAL TREE PLANTING DETAIL THIS SHEET FOR PLANT STAKING. 9 PARKING SPACE/CURB PLANTING POOR DRAINAGE CONDITION

LIMITS OF PLANTING

3X ROOTBALL

DIAMETER

PLAN

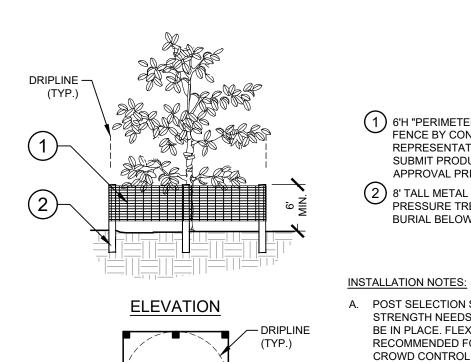

CORNER

FENCE BY CONWED PLASTICS OR OWNER'S REPRESENTATIVE APPROVED EQUAL. SUBMIT PRODUCT INFORMATION FOR APPROVAL PRIOR TO INSTALLATION. 2) 8' TALL METAL "T" POSTS OR 2" x 2" X 8' PRESSURE TREATED WOOD POSTS WITH 24" BURIAL BELOW GRADE.

1) 6'H "PERIMETER PLUS" CONSTRUCTION

PLAN

CONNECTION

A. POST SELECTION SHOULD BE BASED ON EXPECTED STRENGTH NEEDS AND THE LENGTH OF TIME FENCE WILL BE IN PLACE. FLEXIBLE FIBERGLASS ROD POSTS ARE RECOMMENDED FOR PARKS, ATHLETIC EVENTS AND CROWD CONTROL INSTALLATIONS. METAL "T" POSTS OR TREATED WOOD POSTS ARE TYPICALLY USED FOR CONSTRUCTION AND OTHER APPLICATIONS. B. POSTS SHOULD BE DRIVEN INTO THE GROUND TO A DEPTH

OF 1/3 OF THE HEIGHT OF THE POST. FOR EXAMPLE, A 6' POST SHOULD BE SET AT LEAST 2' INTO THE GROUND.


C. SPACE POSTS EVERY 6' (MIN.) TO 8' (MAX.).

D. SECURE FENCING TO POST WITH NYLON CABLE TIES

(AVAILABLE FROM CONWED PLASTICS). WOOD STRIPS MAY BE ALSO BE USED TO PROVIDE ADDITIONAL SUPPORT AND PROTECTION BETWEEN TIES AND POSTS.

> NOTE: IF WIRE TIES ARE USED, AVOID DIRECT CONTACT WITH FENCE. WIRE MAY DAMAGE FENCE OVER TIME.

TREE PROTECTION FENCING ELEVATION / PLAN

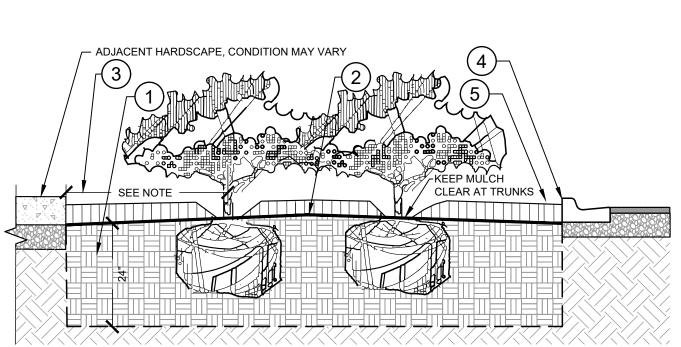

BE PLANTED 1" - 2" HIGH WITH

OF ROOTBALL.

MASS/HEIGHT.

GRADING PLAN).

MIX AS SPECIFIED.

SIDES AND BOTTOM.

COMPACTED.

SPECIFIED.

SOIL MOUNDING UP TO THE TOP

SPECIFIED FOR GROUNDCOVER

SPECIFIED. (SEE LANDSCAPE

NOTES) NOTE: WHEN GROUND-

COVERS AND SHRUBS USED IN

AMENDED WITH PLANTING SOIL

MASSES, ENTIRE BED TO BE

(3) CLEAR ZONE: 36" MIN. FROM BACK OF CURB / HARDSCAPE AREA TO CENTER OF NEAREST SHRUB. CLEAR ZONE SHALL CONTAIN 3" CONTINUOUS MULCH, GROUNDCOVER, OR TURF. SEE LANDSCAPE PLANS.

(4) 2" MAX VERTICAL CLEARANCE, TOP OF CURB / HARDSCAPE TO TOP OF MULCH.

(5) 3" MIN MULCH AS SPECIFIED, REFER TO GENERAL LANDSCAPE NOTES.

A. EXCAVATE A CONTINUOUS 24" DEEP PIT (FROM TOP OF CURB / HARDSCAPE) FOR ENTIRE LENGTH AND WIDTH OF ISLAND / PLANTER AND BACKFILL WITH APPROVED PLANTING MIX. SEE GENERAL

HARDSCAPE FOR STRUCTURAL SUPPORT OF CURB / HARDSCAPE (TYP).

C. ALL ISLANDS / PLANTERS SHALL UTILIZE POOR DRAINAGE DETAIL WHEN PERCOLATION RATES ARE 2" PER HOUR OR LESS. CONTRACTOR SHALL BE RESPONSIBLE FOR TESTING PLANTING PITS TO ENSURE