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Legend

Notes

**For Reference Only**


Revision	Description	By	Appd.	YY.MM.DD
C	Updated east buffer	ASM	SAB	2015.01.23
B	Add (2) QVs, Update Existing Tree Canopy	ATO	SAB	2013.01.09
A	Added Visibility Triangles	ASM	SAB	2012.10.19
1	ISSUED TO CLIENT	ASM	SAB	15.01.27
Issued				YY.MM.DD
File Name:	ASM MLH SAB	MLH	SAB	2012.02.03
	Dwn. Chkd. Dsgn.			YY.MM.DD

Client/Project  
Manatee County Board of County Commissioners

**Fort Hamer Park**  
Phase II  
Manatee County, Florida

Title  
**LANDSCAPE  
PLANTING PLAN**

Project No. 215610582	Scale 15 30 45 75
Drawing No. LP-101	Sheet of
	Revision 0

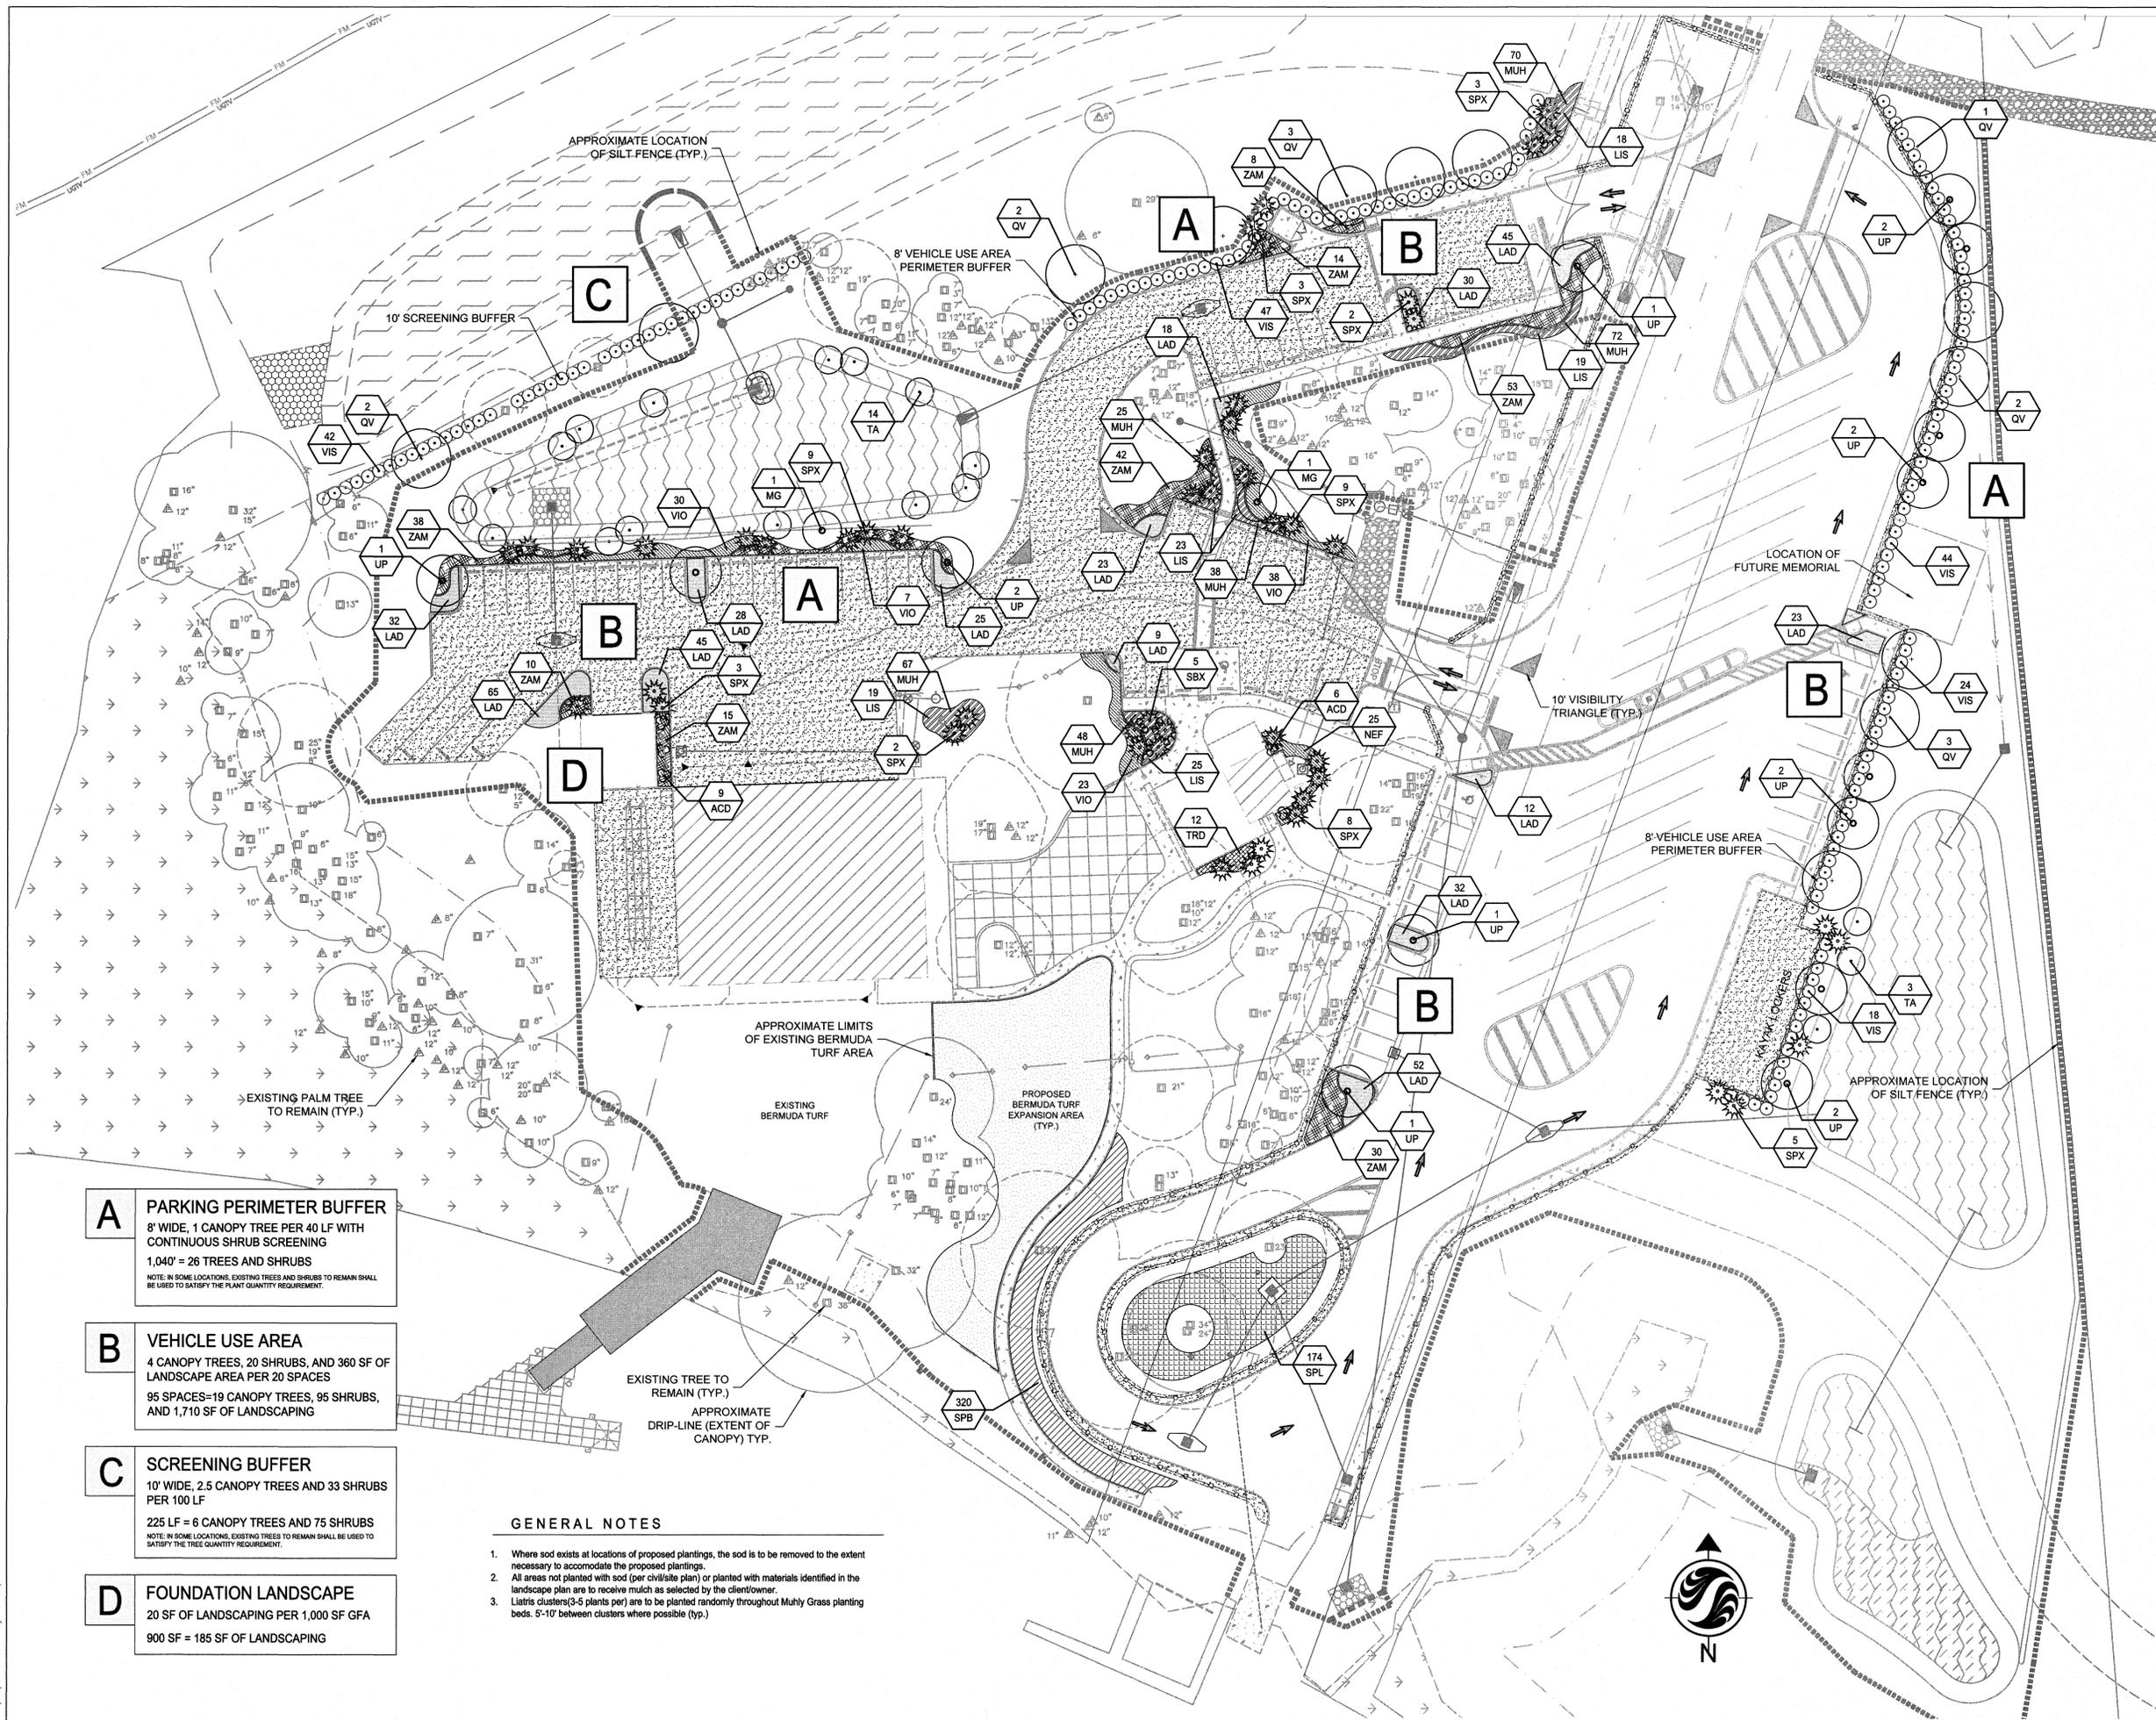

**A PARKING PERIMETER BUFFER**  
8' WIDE, 1 CANOPY TREE PER 40 LF WITH CONTINUOUS SHRUB SCREENING  
1,040' = 26 TREES AND SHRUBS  
NOTE: IN SOME LOCATIONS, EXISTING TREES AND SHRUBS TO REMAIN SHALL BE USED TO SATISFY THE PLANT QUANTITY REQUIREMENT.

**B VEHICLE USE AREA**  
4 CANOPY TREES, 20 SHRUBS, AND 360 SF OF LANDSCAPE AREA PER 20 SPACES  
95 SPACES=19 CANOPY TREES, 95 SHRUBS, AND 1,710 SF OF LANDSCAPING

**C SCREENING BUFFER**  
10' WIDE, 2.5 CANOPY TREES AND 33 SHRUBS PER 100 LF  
225 LF = 6 CANOPY TREES AND 75 SHRUBS  
NOTE: IN SOME LOCATIONS, EXISTING TREES TO REMAIN SHALL BE USED TO SATISFY THE TREE QUANTITY REQUIREMENT.

**D FOUNDATION LANDSCAPE**  
20 SF OF LANDSCAPING PER 1,000 SF GFA  
900 SF = 185 SF OF LANDSCAPING

- GENERAL NOTES**
- Where sod exists at locations of proposed plantings, the sod is to be removed to the extent necessary to accommodate the proposed plantings.
  - All areas not planted with sod (per civil/site plan) or planted with materials identified in the landscape plan are to receive mulch as selected by the client/owner.
  - Liatris clusters (3-5 plants per) are to be planted randomly throughout Muhly Grass planting beds. 5'-10' between clusters where possible (typ.)

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Revision	By	Appd.	YY.MM.DD
1	ISSUED TO CLIENT	ASM	SAB 2015.01.27
	Issued	By	Appd. YY.MM.DD
File Name:	ASM	MLH	SAB 2012.02.03
	Dwn.	Chkd.	Dsgn. YY.MM.DD



Client/Project  
Manatee County Board of County Commissioners


Fort Hamer Park  
Phase II  
Manatee County, Florida

Title  
LANDSCAPE  
PLANTING PLAN - PH-IIA

Project No. 215610582  
Scale 15 30 45 75

Drawing No. Sheet of Revision

LP-101A of 0

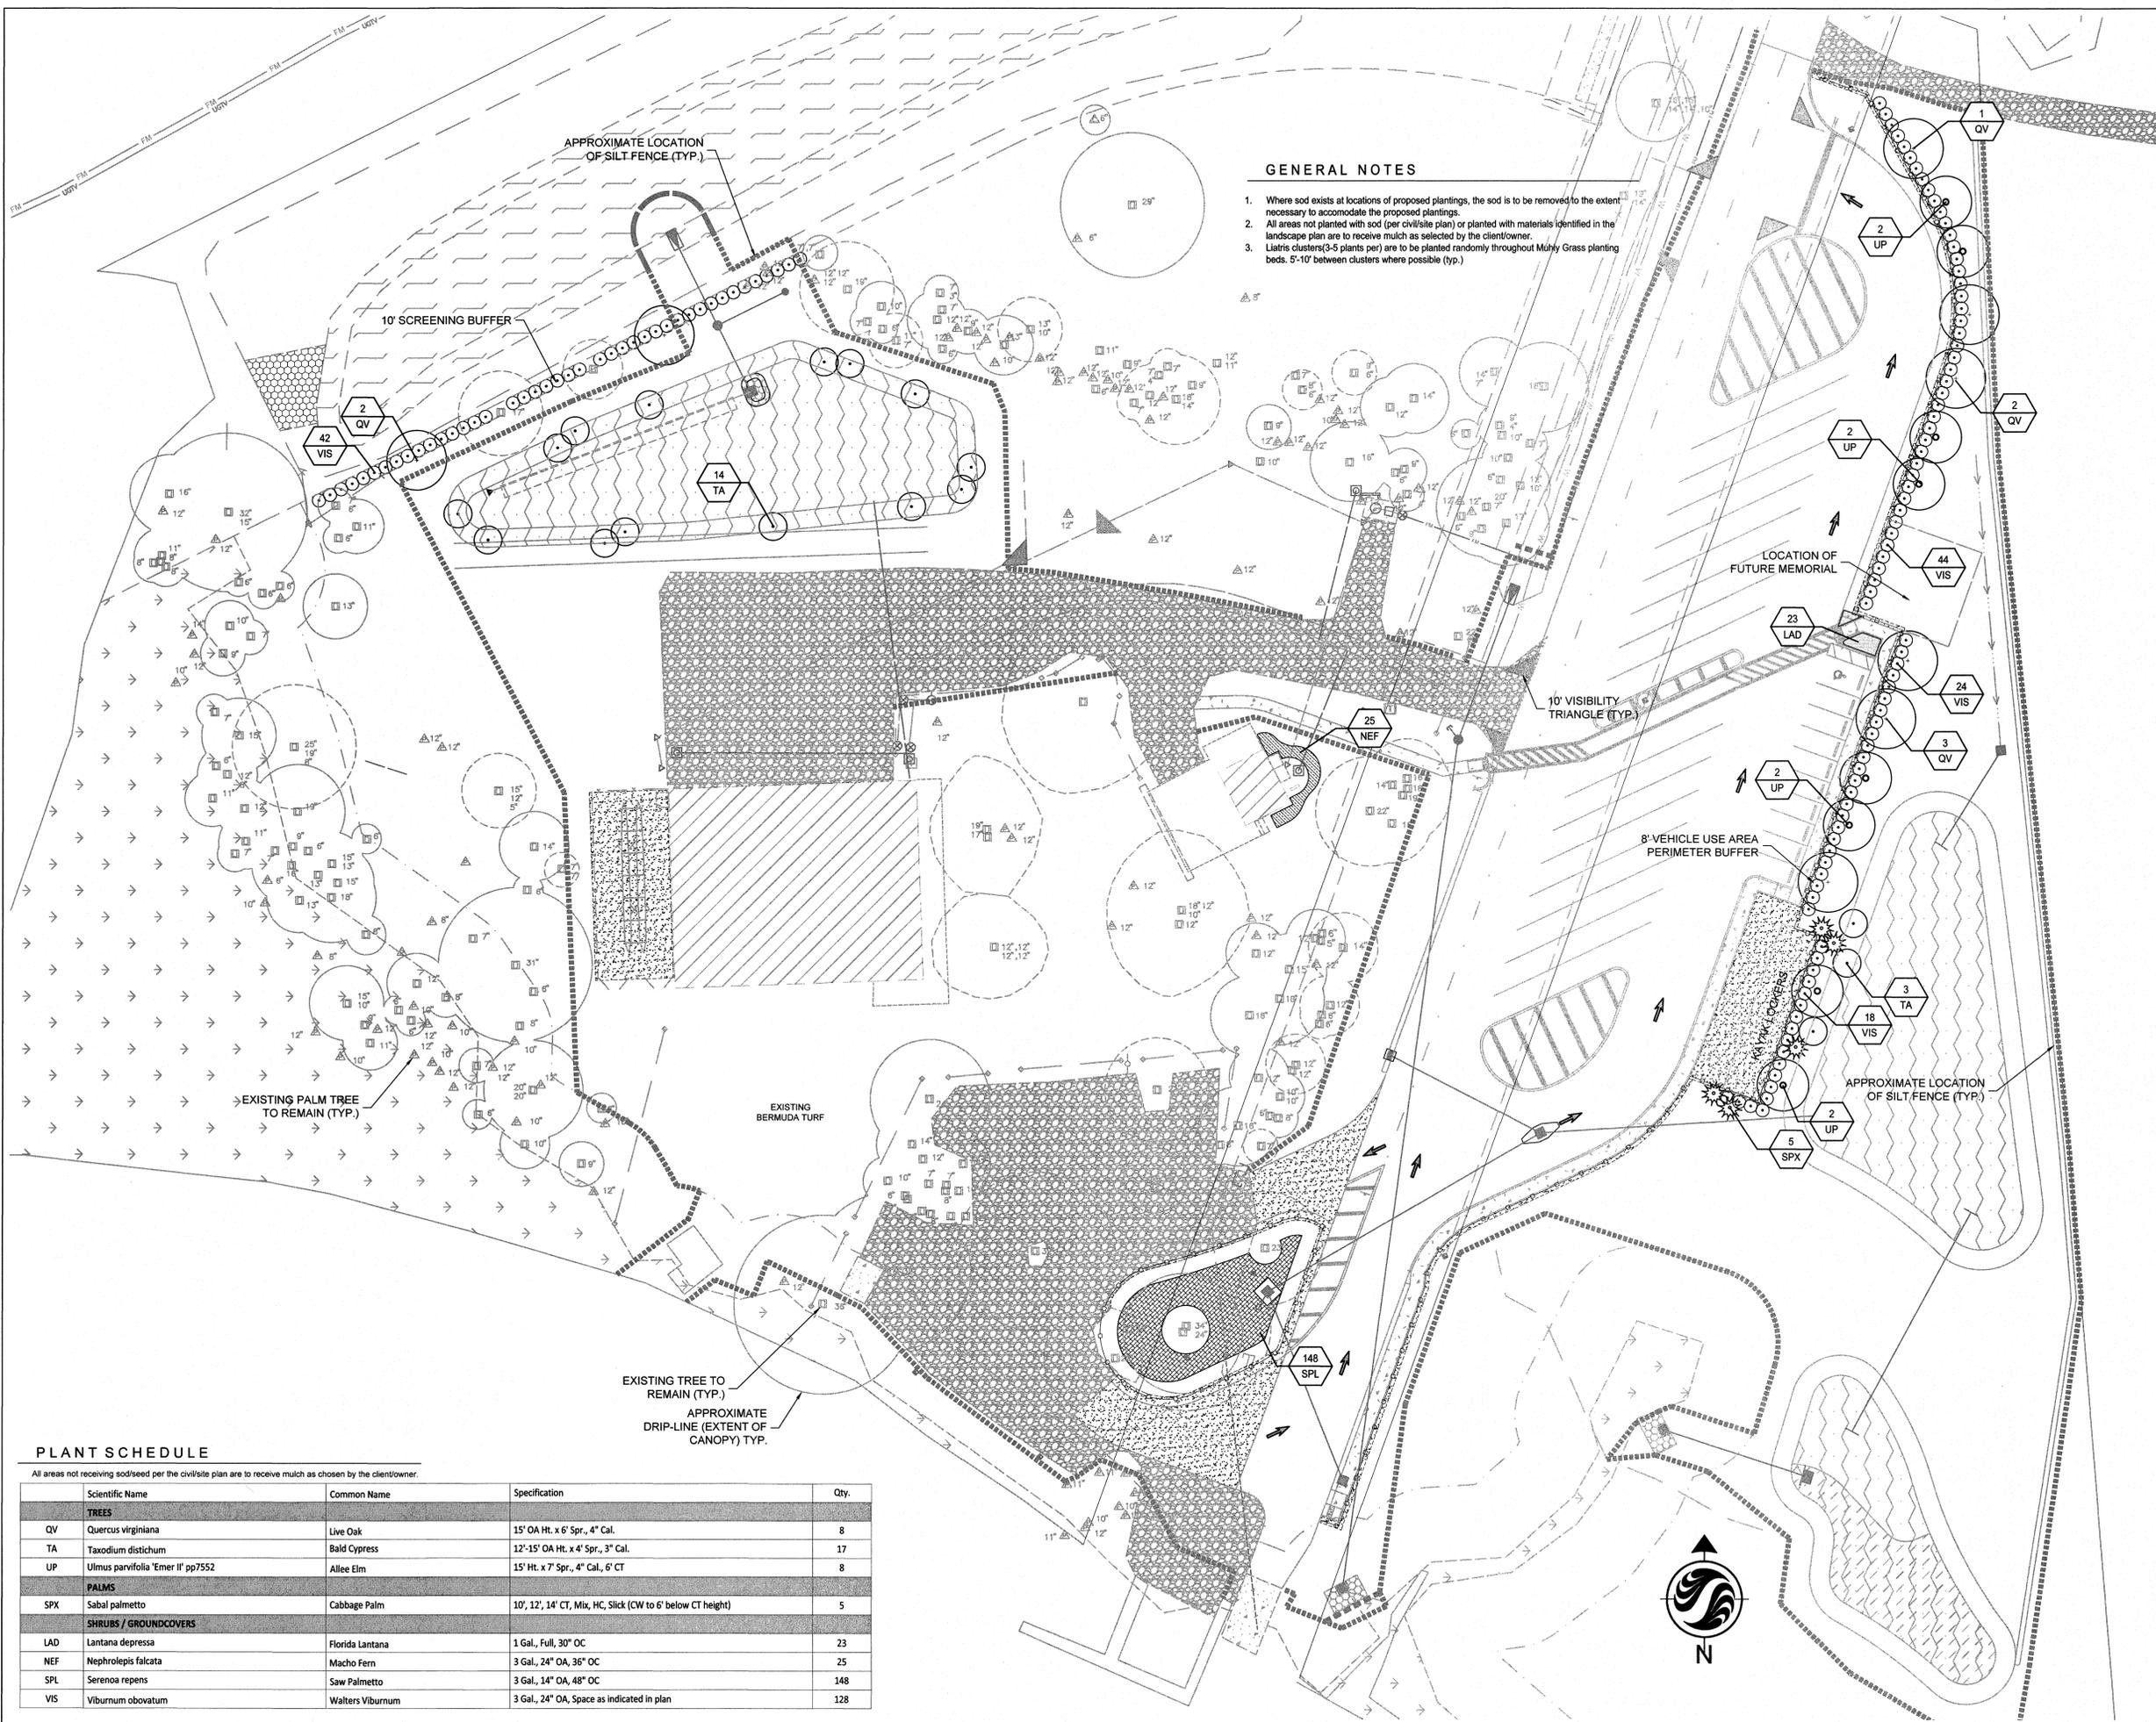

GENERAL NOTES

- Where sod exists at locations of proposed plantings, the sod is to be removed to the extent necessary to accommodate the proposed plantings.
- All areas not planted with sod (per civil/site plan) or planted with materials identified in the landscape plan are to receive mulch as selected by the client/owner.
- Liatris clusters (3-5 plants per) are to be planted randomly throughout Muhly Grass planting beds. 5'-10' between clusters where possible (typ.)

PLANT SCHEDULE

All areas not receiving sod/seed per the civil/site plan are to receive mulch as chosen by the client/owner.

Scientific Name	Common Name	Specification	Qty.
<b>TREES</b>			
QV	Quercus virginiana	15" OA Ht. x 6" Spr., 4" Cal.	8
TA	Taxodium distichum	12"-15" OA Ht. x 4" Spr., 3" Cal.	17
UP	Ulmus parvifolia 'Emer II' pp7552	15" Ht. x 7" Spr., 4" Cal., 6" CT	8
<b>PALMS</b>			
SPX	Sabal palmetto	10', 12', 14' CT, Mix, HC, Slick (CW to 6' below CT height)	5
<b>SHRUBS / GROUNDCOVERS</b>			
LAD	Lantana depressa	Florida Lantana	23
NEF	Nephrolepis falcata	Macho Fern	25
SPL	Serenoa repens	Saw Palmetto	148
VIS	Viburnum obovatum	Walters Viburnum	128

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Notes

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B	Rev	Ex	Tree	Canopy,	Barricade,	& Rem	Sch	ATO	SAB	2013.01.09	
								By	Appd.	YY.MM.DD	
1. ISSUED TO CLIENT											
								ASM	SAB	2015.01.27	
								By	Appd.	YY.MM.DD	
Issued											
File Name: ASM MLH SAB 2012.02.03											
								Dwn.	Chkd.	Dagn.	YY.MM.DD



TYPE	4"-15" DBH	16"-30" DBH	31" DBH +	TOTAL
OAK	36	10	-	46
PINE	-	-	-	-
OTHER	-	-	-	-
PALM	29	-	-	29
<b>TOTAL</b>	<b>65</b>	<b>10</b>	<b>-</b>	<b>74</b>

**TREE REMOVAL AND REPLACEMENT NOTES:**

- TREE REMOVAL INFORMATION IN THE SCHEDULE IS BASED ON A GENERAL IDENTIFICATION OF EXISTING TREES IN THE VICINITY OF THE PROPOSED AREA(S) TO BE DEVELOPED.
- HEALTHY SABAL PALMS SHOULD BE RELOCATED ON SITE WHEN AND WHERE APPLICABLE. CONTRACTOR IS TO COORDINATE THE TEMPORARY RELOCATION AND MAINTENANCE OF THE PALMS UNTIL THEY ARE PLANTED IN THEIR FINAL LOCATIONS.
- SEE NOTE #3 FOR REPLACEMENT REQUIREMENT CALCULATIONS RECOMMENDED BY THE COUNTY.
- TREE REPLACEMENT QUANTITIES:  
65 (4"-15" DBH) TREES @ 1:1 = 65, 3" CAL. CANOPY TREES  
10 (16"-30" DBH) TREES @ 2:1 = 20, 4" CAL. CANOPY TREES  
75 TREES REMOVED = 85 TREES TO BE PLANTED

**TREE CONSERVATION NOTES:**

- TREE CONSERVATION INFORMATION IDENTIFIED IN THE PLAN IS BASED ON A GENERAL IDENTIFICATION OF EXISTING TREES.
- NO GROUND DISTURBING ACTIVITIES OR VEHICLE TRAVEL SHALL OCCUR WITHIN THE TREE PROTECTION BARRICADES.
- ALL TREES SHOWN TO REMAIN WITH SILT FENCE/TREE BARRICADE RUNNING THROUGH THEIR RESPECTIVE APPROXIMATE CANOPY/DRIPLINE HAVE BEEN MITIGATED FOR IN THE TREE REMOVAL AND REPLACEMENT CALCULATIONS. EVERY ATTEMPT SHOULD BE MADE TO SAVE THESE TREES AND MINIMIZE GROUND DISTURBING IMPACTS WITHIN THE DRIPLINES NOT PROTECTED BY TREE BARRICADES UNLESS OTHERWISE INDICATED.
- LOCATE TREE BARRICADES AT THE DRIPLINE OF EXISTING TREES TO REMAIN PER THE TREE PROTECTION DETAIL PROVIDED. TREES TO REMAIN SHOULD HAVE THE TREE BARRICADE INSTALLED AT THE SILT FENCE WITHIN THE CANOPY/DRIPLINE OF THE TREE. REFER TO THE CIVIL PLAN FOR LIMITS OF GRADING.
- GRAPHIC EXAMPLES OF EXISTING TREES TO REMAIN...

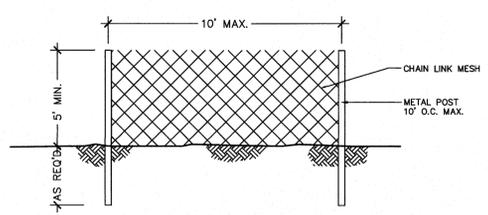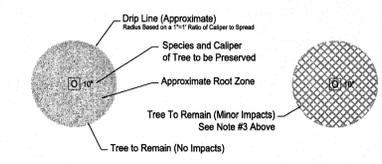

NOTE: BARRICADES TO BE INSTALLED AT THE DRIPLINE OR AS DELINEATED ON THE FINAL SITE PLAN.

Typical Tree Barricade Detail  
SCALE: 1/8" = 1'-0"

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**Legend**

**Notes**

**Revision**

Revision	By	Appd.	YY.MM.DD
1. ISSUED TO CLIENT	ASM	SAB	2015.01.27
Issued	By	Appd.	YY.MM.DD
File Name:	ASM	MLH	SAB
	Dwn.	Chkd.	Dsgn.
			2012.02.03
			YY.MM.DD




Client/Project  
**Manatee County Board of County Commissioners**

**Fort Hamer Park**  
Phase II  
Manatee County, Florida

Title  
**LANDSCAPE TREE REMOVAL / CONSERVATION PLAN PH-IIA**

Project No. 215610582  
Drawing No. Sheet of Revision

Scale 15 30 45 75  
LP-401A of 0


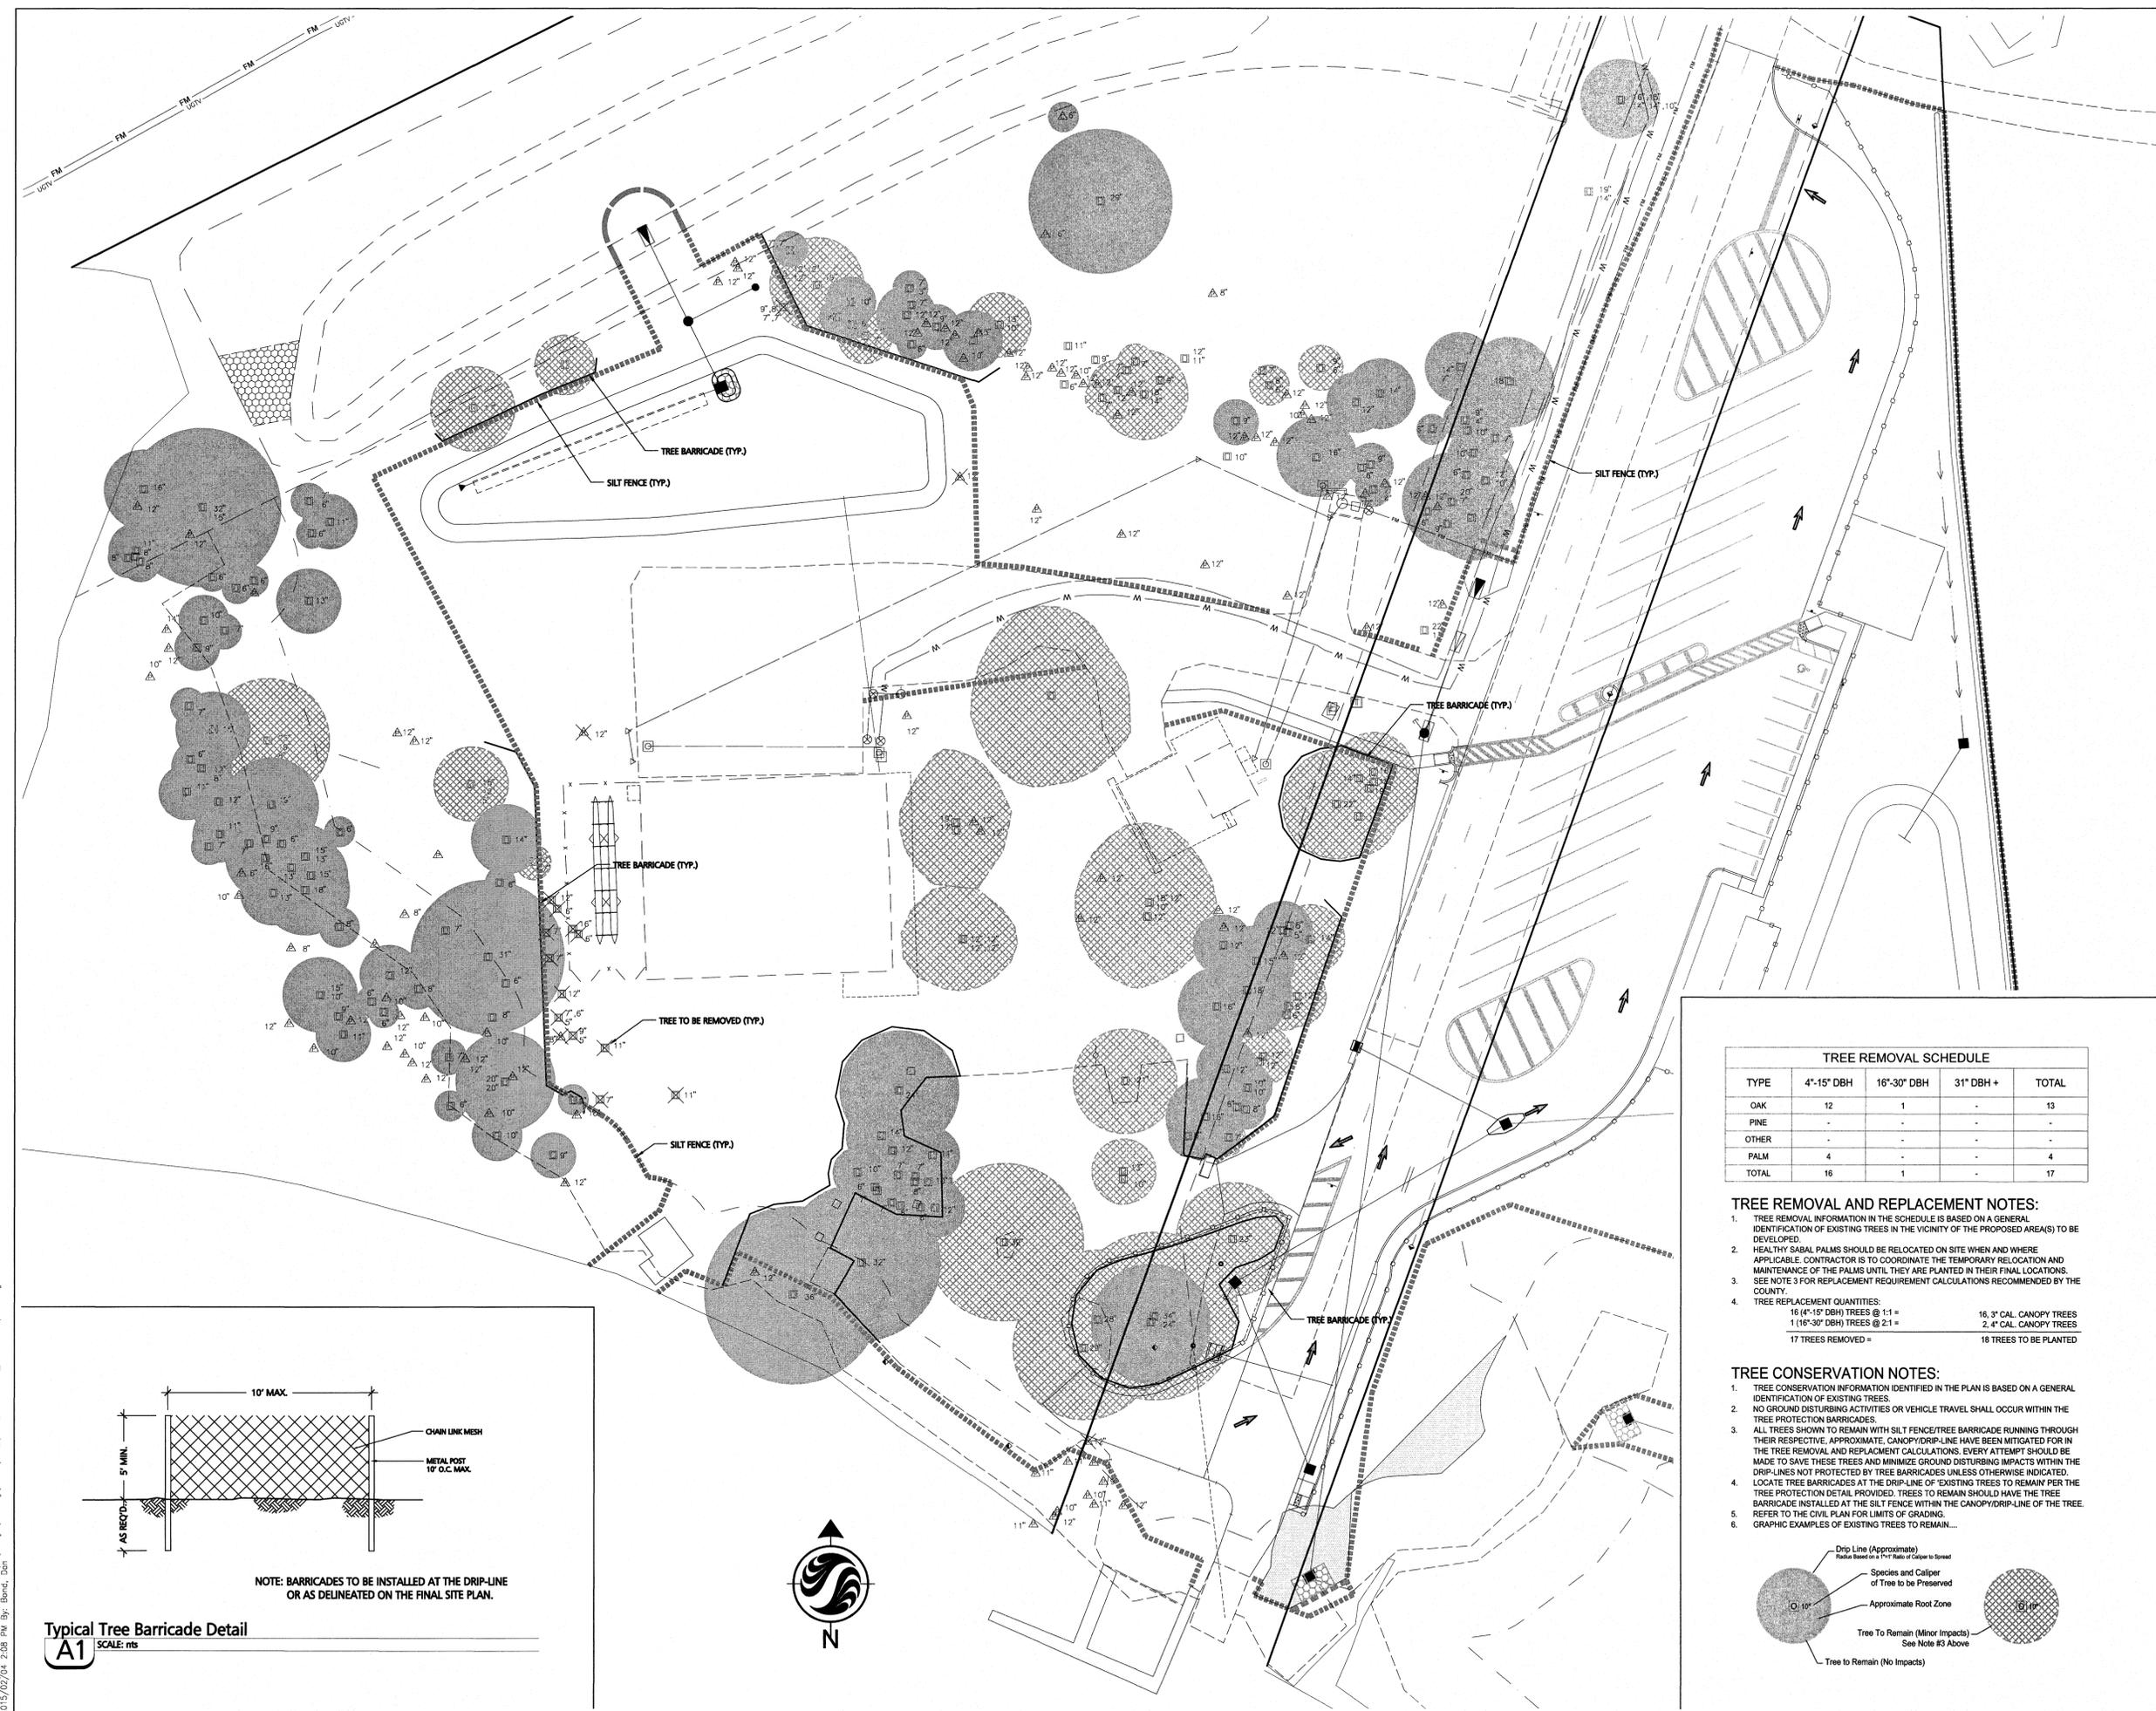


**TREE REMOVAL SCHEDULE**

TYPE	4"-15" DBH	16"-30" DBH	31" DBH +	TOTAL
OAK	12	1	-	13
PINE	-	-	-	-
OTHER	-	-	-	-
PALM	4	-	-	4
TOTAL	16	1	-	17

- TREE REMOVAL AND REPLACEMENT NOTES:**
- TREE REMOVAL INFORMATION IN THE SCHEDULE IS BASED ON A GENERAL IDENTIFICATION OF EXISTING TREES IN THE VICINITY OF THE PROPOSED AREA(S) TO BE DEVELOPED.
  - HEALTHY SABAL PALMS SHOULD BE RELOCATED ON SITE WHEN AND WHERE APPLICABLE. CONTRACTOR IS TO COORDINATE THE TEMPORARY RELOCATION AND MAINTENANCE OF THE PALMS UNTIL THEY ARE PLANTED IN THEIR FINAL LOCATIONS. SEE NOTE 3 FOR REPLACEMENT REQUIREMENT CALCULATIONS RECOMMENDED BY THE COUNTY.
  - TREE REPLACEMENT QUANTITIES:  
16 (4"-15" DBH) TREES @ 1:1 = 16, 3" CAL CANOPY TREES  
1 (16"-30" DBH) TREES @ 2:1 = 2, 4" CAL CANOPY TREES  
17 TREES REMOVED = 18 TREES TO BE PLANTED

- TREE CONSERVATION NOTES:**
- TREE CONSERVATION INFORMATION IDENTIFIED IN THE PLAN IS BASED ON A GENERAL IDENTIFICATION OF EXISTING TREES.
  - NO GROUND DISTURBING ACTIVITIES OR VEHICLE TRAVEL SHALL OCCUR WITHIN THE TREE PROTECTION BARRICADES.
  - ALL TREES SHOWN TO REMAIN WITH SILT FENCE/TREE BARRICADE RUNNING THROUGH THEIR RESPECTIVE APPROXIMATE CANOPY/DRIP-LINE HAVE BEEN MITIGATED FOR IN THE TREE REMOVAL AND REPLACEMENT CALCULATIONS. EVERY ATTEMPT SHOULD BE MADE TO SAVE THESE TREES AND MINIMIZE GROUND DISTURBING IMPACTS WITHIN THE DRIP-LINES NOT PROTECTED BY TREE BARRICADES UNLESS OTHERWISE INDICATED.
  - LOCATE TREE BARRICADES AT THE DRIP-LINE OF EXISTING TREES TO REMAIN PER THE TREE PROTECTION DETAIL PROVIDED. TREES TO REMAIN SHOULD HAVE THE TREE BARRICADE INSTALLED AT THE SILT FENCE WITHIN THE CANOPY/DRIP-LINE OF THE TREE.
  - REFER TO THE CIVIL PLAN FOR LIMITS OF GRADING.
  - GRAPHIC EXAMPLES OF EXISTING TREES TO REMAIN...

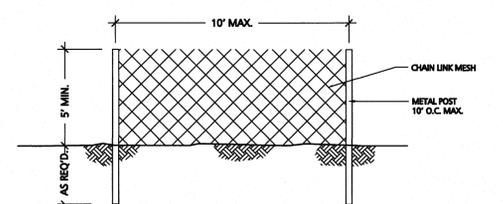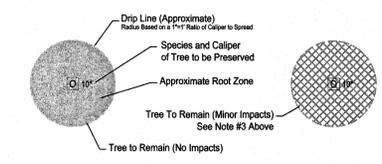

NOTE: BARRICADES TO BE INSTALLED AT THE DRIP-LINE OR AS DELINEATED ON THE FINAL SITE PLAN.


Typical Tree Barricade Detail  
SCALE: AS SHOWN




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LANDSCAPE NOTES


- CONTRACTOR SHALL FIELD VERIFY ALL INFORMATION PRIOR TO INITIATING INSTALLATION.
- CONTRACTOR SHALL NOTIFY ALL PERTINENT UTILITY COMPANIES 48 HOURS MINIMUM PRIOR TO DIGGING FOR VERIFICATION OF ALL UNDERGROUND UTILITIES. PLANS ARE PREPARED ACCORDING TO THE BEST INFORMATION AVAILABLE AT THE TIME OF PREPARING THESE DOCUMENTS.
- THE CONTRACTOR SHALL BECOME COMPLETELY FAMILIAR WITH EXISTING SITE CONDITIONS PRIOR TO BEGINNING INSTALLATION. ALL EXISTING SITE IMPROVEMENTS, PAVING, LANDSCAPE, LIGHTING, AND OTHER SITE ELEMENTS TO REMAIN SHALL BE PROTECTED FROM DAMAGE UNLESS OTHERWISE NOTED.
- UNLESS OTHERWISE NOTED, THE LIMITS OF CONSTRUCTION ARE THE CLEARING LIMITS NOTED ON THE PLANS.
- THE CONTRACTOR SHALL REPORT ANY DISCREPANCIES BETWEEN THE CONSTRUCTION DRAWINGS AND ACTUAL FIELD CONDITIONS TO THE OWNER'S REPRESENTATIVE IMMEDIATELY.
- THE CONTRACTOR SHALL COORDINATE ALL WORK WITH RELATED CONTRACTORS AND WITH THE GENERAL CONSTRUCTION OF THE PROJECT IN ORDER TO NOT IMPEDE THE PROGRESS OF WORK OF OTHERS OR THE CONTRACTOR'S OWN WORK.
- CONTRACTOR SHALL BE RESPONSIBLE TO REMOVE ALL EXISTING GROUND COVERS FOR ALL NEW PLANTING BEDS BY APPROVED MEANS PRIOR TO PLANTING INSTALLATION. CONTRACTOR SHALL BE RESPONSIBLE TO REPLACE ALL DAMAGED PORTIONS OF EXISTING PLANTINGS OR LAWN AREAS INDICATED TO REMAIN WHILE COMPLETING NEW PLANTING INSTALLATION WORK WITH SAME KIND OF PLANTS OR GRASS TO THE SATISFACTION OF THE OWNER AT NO ADDITIONAL COST.
- THE CONTRACTOR SHALL BEAR ALL COST ASSOCIATED WITH SOIL TESTING AND SOIL AMENDMENTS AS REQUIRED AS A RESULT OF THE SOIL TESTING LABORATORY'S RECOMMENDATIONS. PRIOR TO INITIATING INSTALLATION THE CONTRACTOR SHALL PROVIDE SOIL TEST FOR AT LEAST TWO ON-SITE LOCATIONS.
- ALL PLANT CONTAINER SIZES NOTED ON THE PLANT LIST/MATERIAL SCHEDULE ARE MINIMUM. INCREASE SIZE OF CONTAINERS IF NECESSARY TO CONFORM TO THE PLANT SIZE AND SPECIFICATIONS.
- EROSION CONTROL MATERIAL SHALL BE INSTALLED IN ALL SHRUB AND GROUND COVER PLANTING AREAS AS PER THE DETAILS AND/OR SPECIFICATIONS FOR ALL SLOPES THAT ARE GREATER THAN 3:1 (SLOPES 1 VERTICAL FOR EVERY 3 HORIZONTAL). SEE CIVIL ENGINEERING PLANS FOR LOCATIONS WHERE SLOPES ARE GREATER THAN 3:1.
- SHRUB AND GROUND COVER PLANTINGS ARE TYPICALLY SHOWN ON THE PLANS IN MASS PLANTING BEDS. PLANTS SHALL BE SET IN A TRIANGULAR SPACING PATTERN (STAGGERED SPACING). PLANT CENTER TO CENTER DIMENSIONS (O.C.) ARE INDICATED IN THE PLANT LIST.
- LANDSCAPE CONTRACTOR SHALL FIELD ADJUST THE LOCATION OF PLANT MATERIAL AS NECESSARY TO AVOID DAMAGE TO EXISTING TREES AND UNDERSTORY VEGETATION TO REMAIN, UNDERGROUND AND ABOVE GROUND UTILITIES AND ALL OTHER ABOVE GROUND ELEMENTS. ALL CHANGES REQUIRED SHALL BE COORDINATED WITH THE OWNER'S REPRESENTATIVE AND THE LANDSCAPE ARCHITECT PRIOR TO INITIATING ANY CHANGES.
- WHEN NECESSARY, PLANTING WITHIN THE DRIPLINE/CANOPY OF EXISTING TREES SHOULD BE DONE IN THE MOST SENSITIVE MANNER POSSIBLE IN ORDER TO AVOID ROOT DAMAGE. ALL NEW PLANTINGS WITHIN THE DRIPLINE/CANOPY SHOULD BE HAND-DUG AND FIELD ADJUSTED TO AVOID ROOTS AS NECESSARY.
- ANY SUBSTITUTIONS TO PLANT MATERIAL SIZE OR TYPE MUST BE APPROVED BY THE LANDSCAPE ARCHITECT PRIOR TO INSTALLATION. LANDSCAPE CONTRACTOR SHALL NOT MAKE ANY SUBSTITUTIONS OR ALTERATIONS TO THE LANDSCAPE PLANTING PLANS OR PLANT LIST & MATERIALS WITHOUT THE PRIOR APPROVAL OF THE LANDSCAPE ARCHITECT AND OWNER'S REPRESENTATIVE. ANY LANDSCAPE PLANTING INSTALLED THAT DOES NOT CONFORM TO THE PLANS, PLANT LIST AND SPECIFICATIONS SHALL BE REPLACED IMMEDIATELY TO THE SATISFACTION OF THE OWNER'S REPRESENTATIVE AND LANDSCAPE ARCHITECT.
- CONTRACTOR SHALL BE RESPONSIBLE FOR WATERING AS REQUIRED TO MAINTAIN AND ESTABLISH ALL PLANTING (NEW, EXISTING TO BE RELOCATED, AND EXISTING PLANTINGS TO REMAIN WHILE IRRIGATION SYSTEM IS BEING INSTALLED OR REPAIRED) TO SUPPLEMENT IRRIGATION AND RAINFALL. THE IRRIGATION SYSTEM IS DESIGNED TO MAINTAIN THE LANDSCAPE PLANTINGS AND NOT ESTABLISH THEM. THE CONTRACTOR IS RESPONSIBLE FOR WATERING IN ALL PLANTING AREAS, REGARDLESS OF THE STATUS OF EXISTING OR PROPOSED IRRIGATION SYSTEMS.
- CONTRACTOR IS RESPONSIBLE FOR MAINTAINING, IN FULL, ALL PLANTING AREAS (INCLUDING WATERING, SPRAYING, MULCHING, MOWING, FERTILIZING, AND WEEDING, ETC.) UNTIL THE JOB IS ACCEPTED.
- CONTRACTOR SHALL ASSURE DRAINAGE AND PERCOLATION OF ALL PLANTING PITS PRIOR TO INSTALLATION OF PLANT MATERIAL. CORRECT IF REQUIRED TO ASSURE PERCOLATION. CONTRACTOR IS RESPONSIBLE FOR REPLACEMENT OF ALL PLANTS LOST DUE TO INADEQUATE DRAINAGE CONDITIONS.
- CONTRACTOR SHALL CLEAN THE WORK AREAS AT THE END OF EACH WORKING DAY. LANDSCAPE RUBBISH AND DEBRIS SHALL BE COLLECTED AND DEPOSITED OR RECYCLED OFF-SITE DAILY. ALL MATERIALS, PRODUCTS, AND EQUIPMENT STORED ON-SITE SHALL BE KEPT IN AN ORGANIZED MANNER DAILY.
- CONTRACTOR SHALL RE-GRADE ALL AREAS DISTURBED BY PLANT REMOVAL, RELOCATION, AND/OR FROM INSTALLATION WORK. THE CONTRACTOR SHALL REPLACE BY EQUAL SIZE AND QUALITY ANY AND ALL EXISTING PLANT MATERIAL DISTURBED OR DAMAGED BY PLANTING REMOVAL, RELOCATION, AND/OR INSTALLATION.
- EXISTING TREES OR OTHER PLANT MATERIAL INDICATED ON THE PLANS TO BE RELOCATED SHALL BE HANDLED, CARED FOR, AND MAINTAINED AS NEW PLANTINGS. THE CONTRACTOR IS RESPONSIBLE FOR ANY REQUIRED ROOT PRUNING, WRAPPING, TREE SPACING OR BALL AND BURLAPPING, ADDITIONAL SUPPLEMENTAL HAND WATERING, IRRIGATION MISTERS INSTALLED AT THE TREE CANOPY, OR ANY OTHER SOUND HORTICULTURAL PRACTICE REQUIRED TO ENSURE THE SURVIVAL OF ALL RELOCATED PLANT MATERIAL.
- THE CONTRACTOR SHALL REFER TO THE LANDSCAPE PLANTING DETAILS, SPECIFICATIONS, PLANT LIST AND PLANS FOR FURTHER AND COMPLETE PLANTING INSTALLATION INSTRUCTIONS.
- LANDSCAPE CONTRACTOR SHALL FULLY FAMILIARIZE HIMSELF / HERSELF WITH THE PROJECT PRIOR TO BIDDING THE WORK.
- FOR SITE GRADING AND CONTOUR INFORMATION, EXISTING VEGETATION TO REMAIN, BUILDINGS AND OTHER SITE FEATURE LOCATIONS AND THE LOCATION OF ALL ABOVE AND BELOW GROUND UTILITIES SEE THE MOST CURRENT AND UP TO DATE ARCHITECTURAL, CIVIL, ELECTRICAL, STRUCTURAL AND MECHANICAL ENGINEERING DRAWINGS AS PROVIDED BY THE OWNER OR OWNER'S REPRESENTATIVE. FIELD LOCATE ALL UNDERGROUND UTILITIES, EXISTING VEGETATION TO REMAIN AND ANY OTHER OBSTRUCTIONS AND COORDINATE WITH OWNER'S REPRESENTATIVE PRIOR TO INITIATING ANY LANDSCAPE PLANTING OR IRRIGATION INSTALLATION WORK. LANDSCAPE CONTRACTOR SHALL BE RESPONSIBLE FOR REPAIRING OR REPLACING ANY DAMAGE COMMITTED TO EXISTING OR PROPOSED ELEMENTS ABOVE OR BELOW GROUND TO ITS ORIGINAL CONDITION AND TO THE SATISFACTION OF THE OWNER AND OWNER'S REPRESENTATIVE.
- LANDSCAPE CONTRACTOR SHALL FIELD STAKE THE LOCATION OF ALL PLANT MATERIAL AND EDGES OF PLANTING BEDS FOR THE REVIEW AND APPROVAL BY THE LANDSCAPE ARCHITECT PRIOR TO INITIATING ANY INSTALLATION OF THE LANDSCAPE PLANTINGS.
- LANDSCAPE CONTRACTOR SHALL COORDINATE WORK WITH THE IRRIGATION CONTRACTOR AND ALL OTHER TRADES AS REQUIRED.
- THE CONTRACTOR SHALL REQUEST INSPECTION OF THE PROJECT IN WRITING A MINIMUM OF THREE (3) DAYS PRIOR TO DESIRED INSPECTION DATE. IF ALL WORK IS SATISFACTORY AND COMPLETE IN ACCORDANCE WITH CONDITIONS OF CONTRACT DOCUMENTS, THEN THE OWNER AND LANDSCAPE ARCHITECT SHALL DECLARE THE WORK SUBSTANTIALLY COMPLETE. THE CONTRACTOR IS TO REPLACE REJECTED PLANT MATERIAL WITHIN ONE (1) WEEK OF NOTICE.
- GUYING/STAKING PRACTICES SHALL NOT PERMIT NAILS, SCREWS, WIRES, ETC., TO PENETRATE OUTER SURFACE OF THE TREE OR PALM. PLANT MATERIAL REJECTED DUE TO THIS PRACTICE SHALL BE REPLACED AT THE CONTRACTORS EXPENSE. REMOVAL OF ALL STAKING AND GUYING OF TREES AND PALMS AFTER FINAL ACCEPTANCE SHALL BE THE RESPONSIBILITY OF THE OWNER.
- ALL PLANT MATERIAL SHALL BE FLORIDA NO. 1 OR BETTER AT TIME OF INSTALLATION AND SHALL BE MAINTAINED IN THIS SAME CONDITION UNTIL FINAL ACCEPTANCE. THE CONTRACTOR GUARANTEES THE PLANT MATERIAL FOR A PERIOD OF ONE (1) YEAR FOLLOWING DATE OF SUBSTANTIAL COMPLETION.
- ALL PLANTS MUST BE HEALTHY, VIGOROUS MATERIAL, FREE OF PESTS AND DISEASE. ALL PLANT MATERIAL SHALL BE IN FULL AND STRICT ACCORDANCE TO FLORIDA NO. 1 GRADE, ACCORDING TO THE GRASSES AND STANDARDS FOR NURSERY PLANTS, PUBLISHED BY THE FLORIDA DEPARTMENT OF AGRICULTURE AND CONSUMER SERVICES. PLANT MATERIAL IN SOME INSTANCES EXCEED NO. 1 GRADE IN ORDER TO MEET THE MINIMUM REQUIREMENTS OF THIS PROJECT.

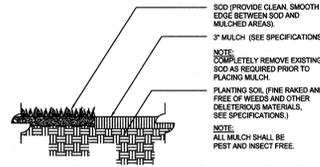


Mulch Application  
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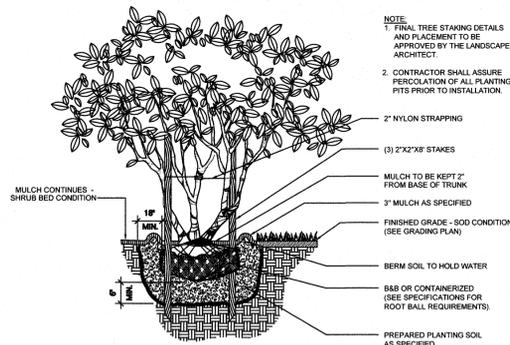
Curb at Landscape Bed Treatment  
SCALE: N.T.S.

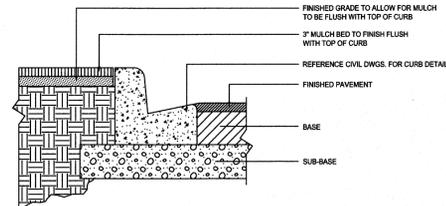

Shrub and Groundcover  
SCALE: 1/8\"/>

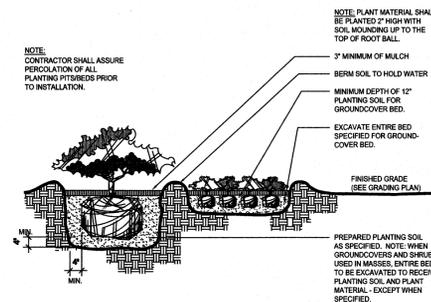

Shrub & Groundcover Spacing  
SCALE: 1/8\"/>

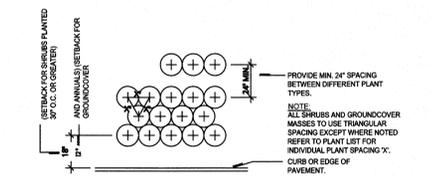

Multi-Trunk Tree  
SCALE: 1/8\"/>

PLANT SCHEDULE


NOTE: THIS PLANT LIST IS FOR REVIEW AND APPROVAL PURPOSES. PLAN TO BE APPROVED BY COUNTY AND CLIENT PRIOR TO BIDDING.

Scientific Name	Common Name	Specification	Qty.
<b>TREES</b>			
MG Magnolia grandiflora	Southern Magnolia	14'-16\"/>	
QV Quercus virginiana	Live Oak	15\"/>	
TA Taxodium distichum	Bald Cypress	12'-15\"/>	
UP Ulmus parviflora 'Emer II' pp7552	Allele Elm	15\"/>	
<b>PALMS</b>			
SBX Sabal palmetto	Cabbage Palm	12\", 14\", 16\"/>	
SPX Sabal palmetto	Cabbage Palm	10\", 12\", 14\"/>	
<b>SHRUBS / GROUNDCOVERS</b>			
ACD Acrostichum danaeifolium	Leather Fern	3 Gal., 24\"/>	
LAD Lantana depressa	Florida Lantana	1 Gal., Full, 30\"/>	
*LIS Liatris spicata	Blazing Star Liatris	1 Gal., Full, 30\"/>	
MUH Muhlenbergia capillaris	Muhly Grass	1 Gal., 12\"/>	
NEF Nephrolepis falcata	Macho Fern	3 Gal., 24\"/>	
SPB Spartina bakerii	Sand Cordgrass	1 Gal., 12\"/>	
SPL Serenoa repens	Saw Palmetto	3 Gal., 14\"/>	
TRD Tripsacum dactyloides	Fakahatchee Grass	3 Gal., 18\"/>	
VIO Viburnum obovatum 'Mrs Shillers Delight'	Mrs Shillers Delight Viburnum	3 Gal., 18\"/>	
VIS Viburnum odoratissimum	Sweet Viburnum	3 Gal., 24\"/>	
ZAM Zamia pumila	Coontie	3 Gal., 18\"/>	
<b>OTHER</b>			
SOD Cynodon transvaalensis x C. dactylon	Tifway 419 Bermudagrass	Solid Sod, Sand Grown, Laid, Rolled, Free of Weeds and Pests	5F

All areas not receiving sod/seed per the civil/site plan are to receive mulch as chosen by the client/owner.  
\*Liatris clusters (3-5 plants per) are to be planted randomly throughout Muhly Grass planting beds. 5'-10' between clusters where possible (typ.)


IRRIGATION NOTES

- ALL PROPOSED LANDSCAPING TO IRRIGATED BY A 100% AUTOMATIC SYSTEM.
- IRRIGATION SYSTEM SHALL NOT BE INSTALLED THROUGH EXISTING PLANT COMMUNITIES.
- IRRIGATION SPRINKLER ZONES TO BE SEPERATE FOR HIGH AND LOW WATER REQUIREMENT PLANT AREAS AND OPERATED ON DIFFERENT WATERING SCHEDULES.
- IRRIGATION OVERTHROW TO NON-PERVIOUS AND NATURAL AREAS TO MINIMIZED.
- A RAIN SENSOR IS TO BE INSTALLED WITH THE IRRIGATION SYSTEM CONTROLLER.
- IRRIGATION PIPING TO BE LOCATED WITHIN PLANTING OR SODE AREAS WHEREVER FEASIBLE. PIPING UNDER ROADS TO BE INSTALLED WITHIN SCHEDULE 40 PVC SLEEVE.
- ALL TREE, SHRUB, AND GROUND COVER AREAS ARE TO BE FULLY IRRIGATED WITH DRIP / MICRO IRRIGATION, LOW-VOLUME EMITTERS. ALL SOD AREAS TO BE IRRIGATED WITH ROTOR OR SPRAY HEAD SPRINKLERS SPACED TO PROVIDE 100% COVERAGE.
- A "Y" TYPE FILTER SHALL BE INSTALLED AT THE HEAD END OF LOW VOLUME LINES AND IN-LINE PRESSURE REGULATORS TO REDUCE PRESSURE NO MORE THAN 15 PSI SHALL BE UTILIZED.
- NON-POTABLE IRRIGATION LINES TO BE PURPLE IN COLOR.

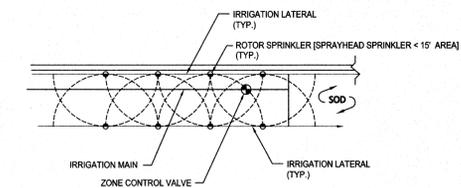


Typical Irrigation Detail  
SCALE: 1/8\"/>

Small Tree  
SCALE: 1/8\"/>

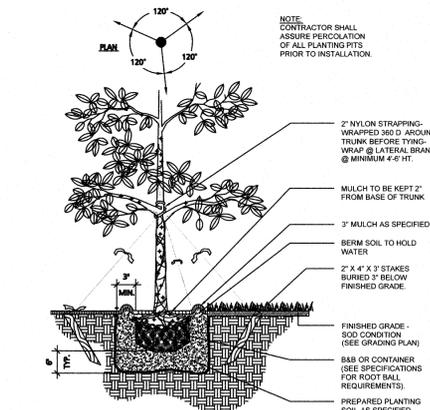

Large Tree  
SCALE: 1/8\"/>

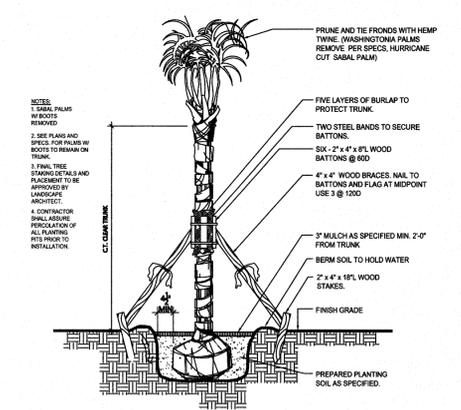

Cabbage Palm  
SCALE: N.T.S.



WilsonMiller Stantec  
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Consultants

Legend

Notes

B	Rev	Plant Schedule	ATO	SAB	2013.01.09
Revision			By	Appd.	YY.MM.DD
D					
C					
B					
1	ISSUED TO CLIENT		ASM	SAB	2015.01.27
Issued			By	Appd.	YY.MM.DD
File Name:			ASM	MLH	SAB
			Den.	Chkd.	Dagn.
					YY.MM.DD

Client/Project

Manatee County Board of County Commissioners

Fort Hamer Park  
Phase II  
Manatee County, Florida

Title

LANDSCAPE  
PLANTING NOTES & DETAILS

Project No.  
215610582

Drawing No.

Scale  
15 30 45 75

Sheet  
Revision

LP-601

of

0

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 20/05/2016 08:28:14 AM by: bano, ben



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Notes

**For Reference Only**

A	Updated per revised east buffer area	ASM	SAB	2015.01.23
B	Rev Power to Pervious Conc, Ex Tree Canopy	ATO	SAB	2013.01.09
Revision		By	Appd.	YY.MM.DD

1	ISSUED TO CLIENT	ASM	SAB	2015.01.27
Issued		By	Appd.	YY.MM.DD

File Name:	ASM	MLH	SAB	2012.02.03
	Dwn.	Chkd.	Dsgn.	YY.MM.DD




Client/Project  
Manatee County Board of County Commissioners

**Fort Hamer Park**  
Phase II  
Manatee County, Florida

Title  
**LANDSCAPE  
GROUNDCOVER / SURFACES PLAN**

Project No.	215610582	Scale	15 30 45 75
Drawing No.	LS-401	Sheet	of
		Revision	0

LS-401 of 0

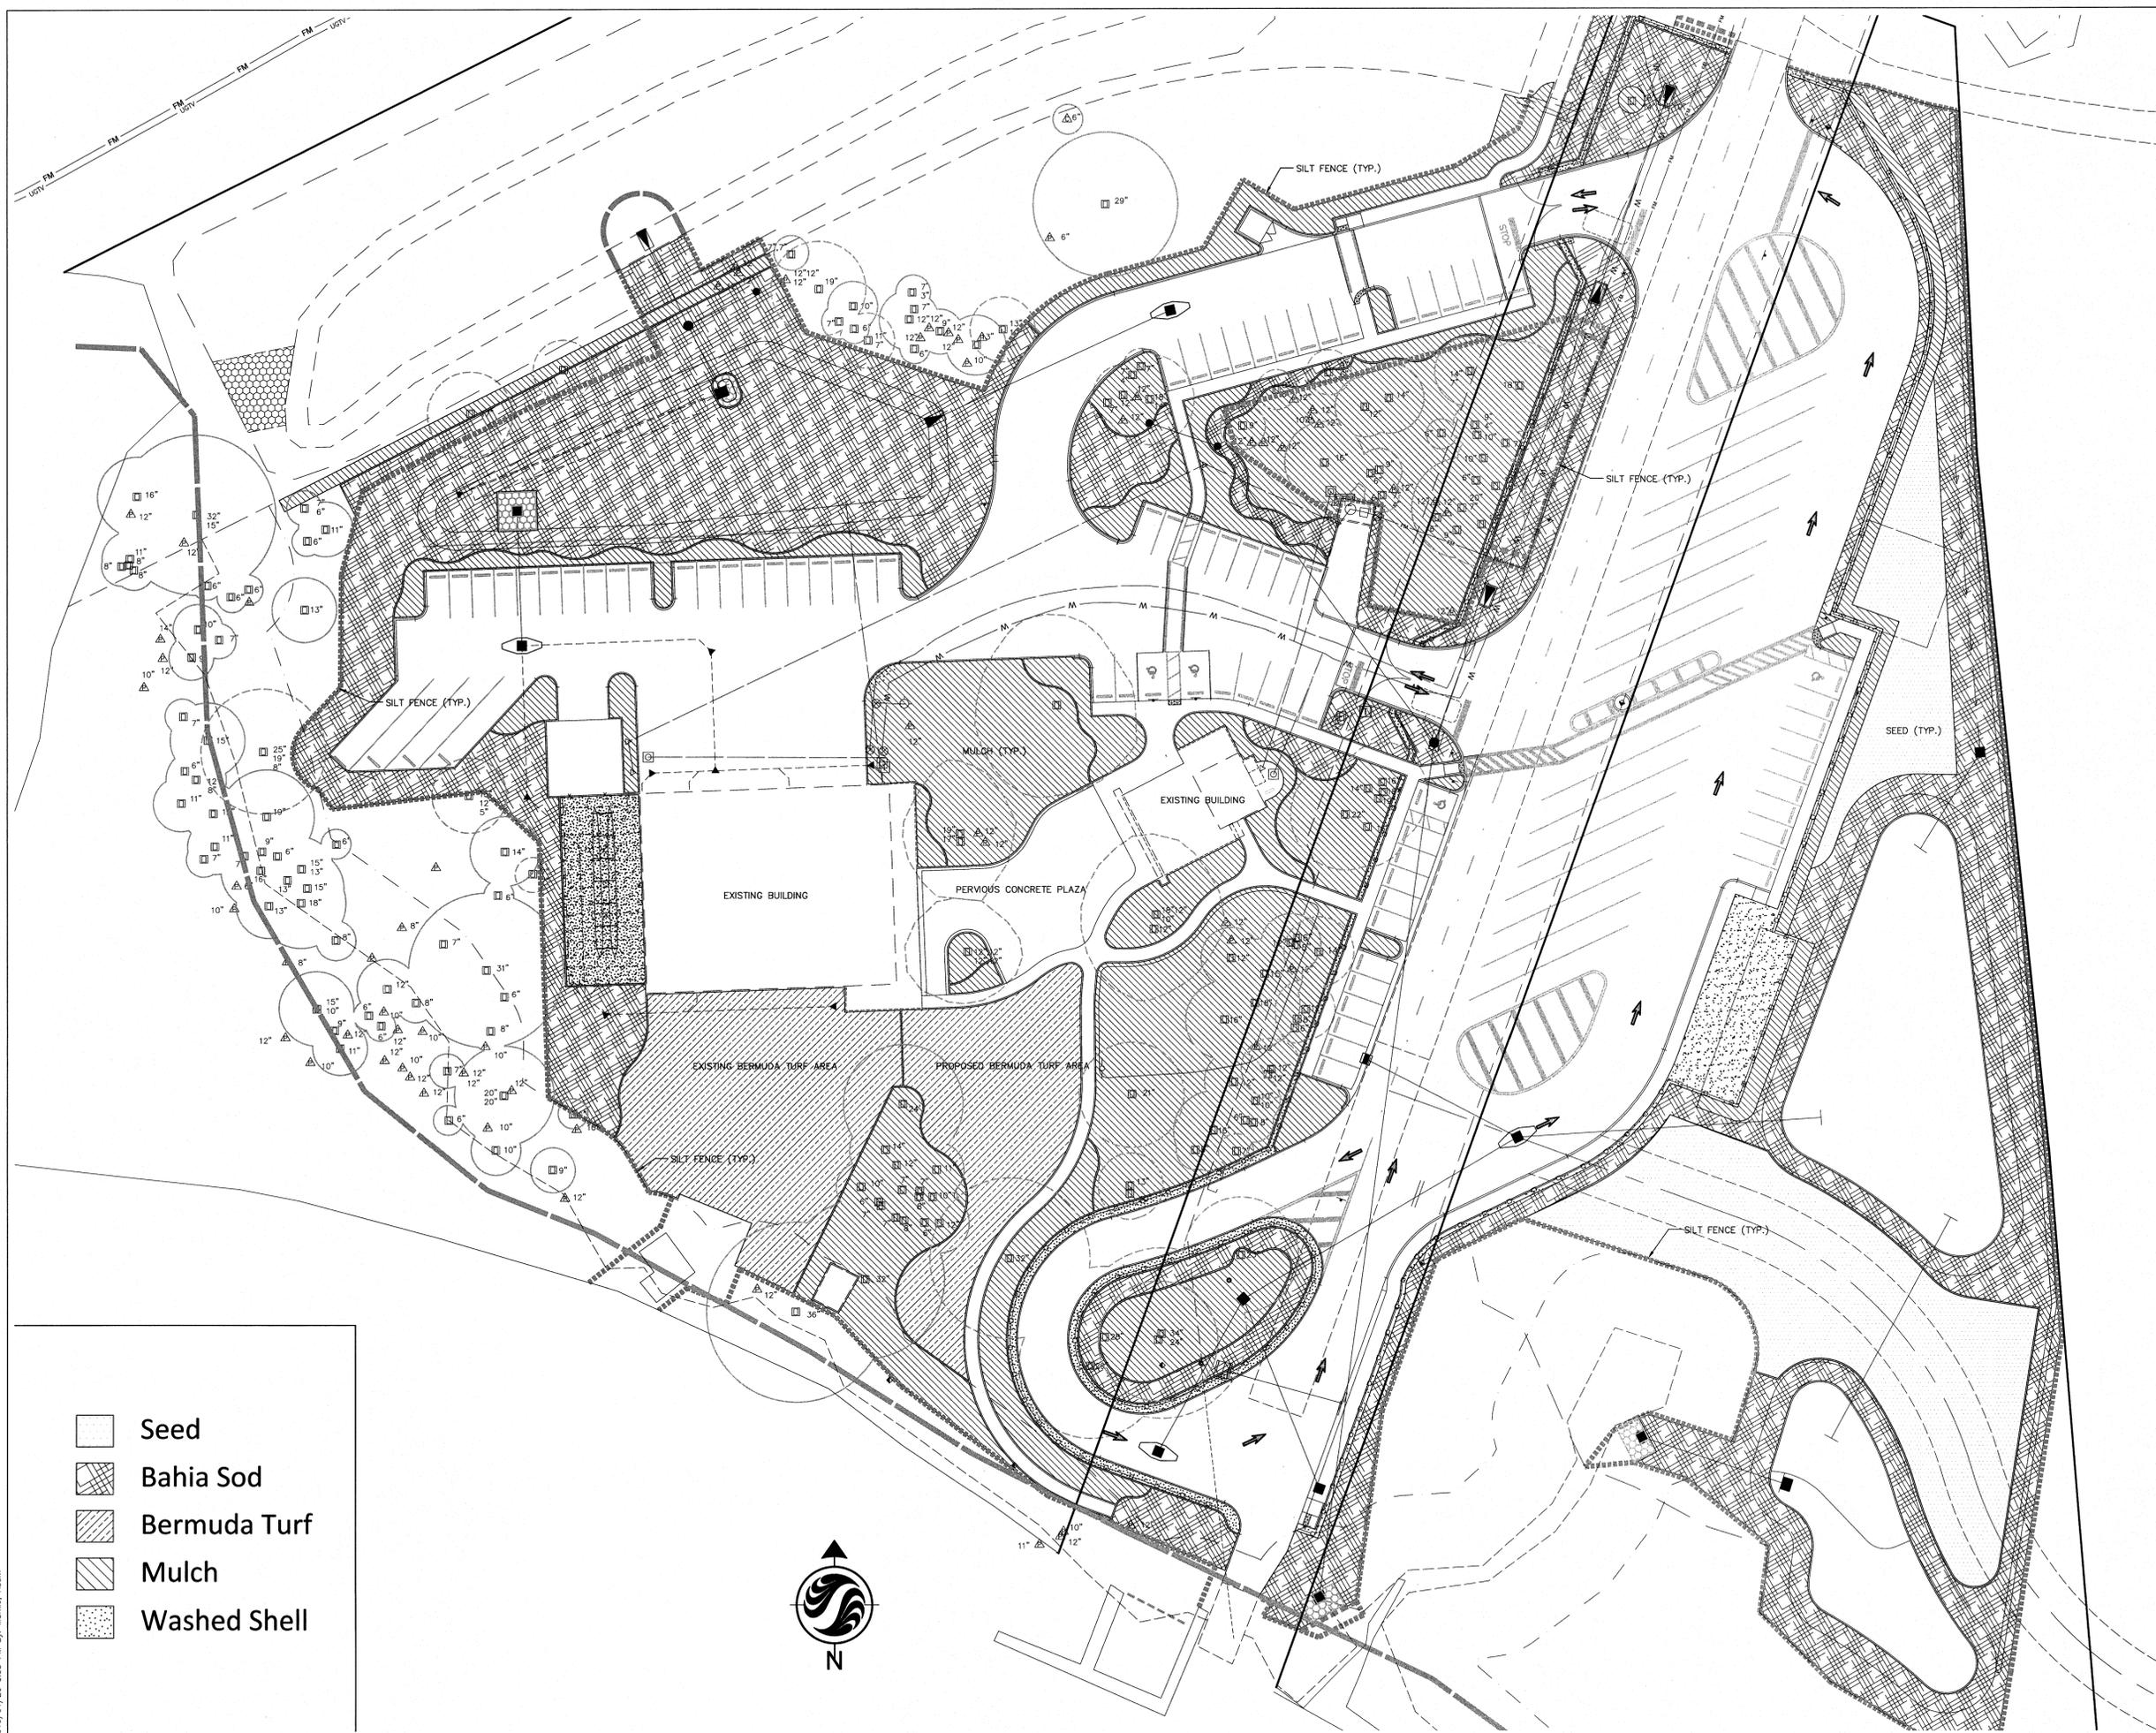

- Seed
- Bahia Sod
- Bermuda Turf
- Mulch
- Washed Shell



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2015/01/26 9:58 PM By: Worke, Adam



**WilsonMiller Stantec**  
6900 Professional Pkwy East, Suite 100  
Sarasota, Florida 34240, U.S.A.

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**Consultants**

**Legend**

**Notes**

Revision	By	Appd.	YY.MM.DD
1. ISSUED TO CLIENT	ASM	SAB	2015.01.27
Issued	By	Appd.	YY.MM.DD
File Name:	ASM	MLH	SAB 2012.02.03
	Dwn.	Chkd.	Dagn.
			YY.MM.DD




Client/Project  
Manatee County Board of County Commissioners

**Fort Hamer Park**  
Phase II  
Manatee County, Florida

Title  
**LANDSCAPE  
GROUNDCOVER / SURFACES PLAN  
PH-IIA**

Project No. 215610582	Scale 15 30 45 75
Drawing No.	Sheet of Revision

LS-401A of 0

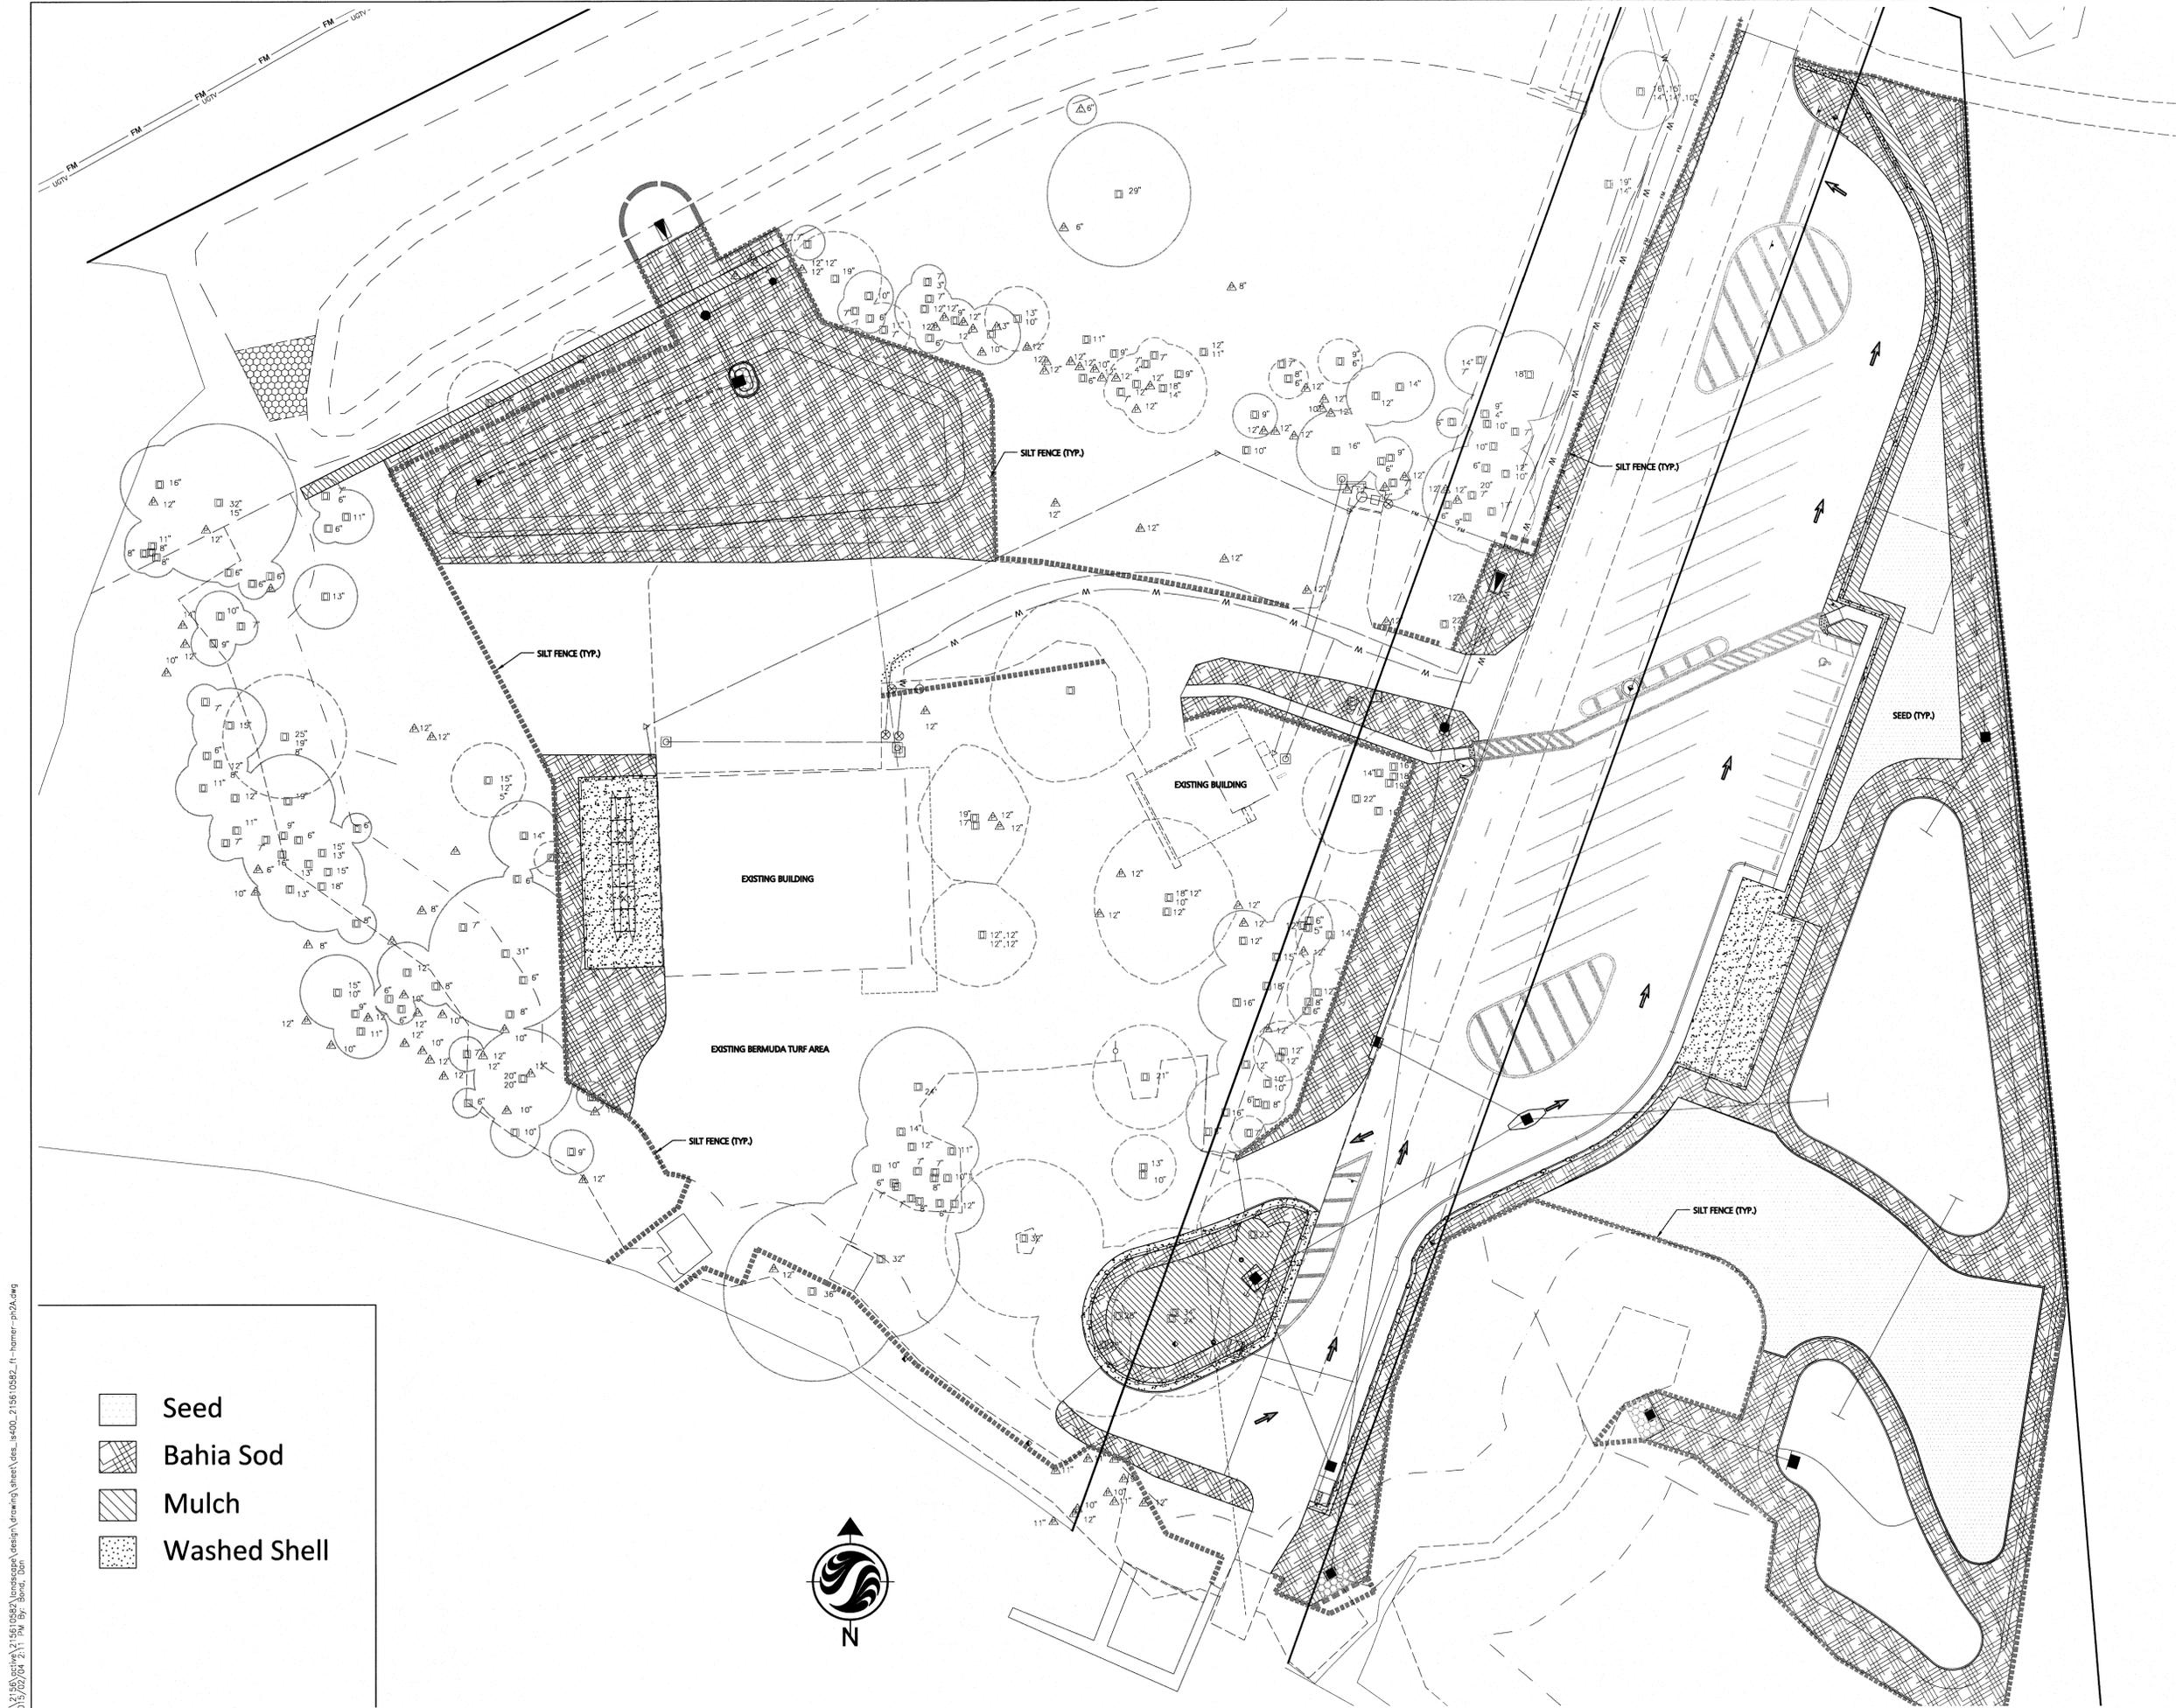

-  Seed
-  Bahia Sod
-  Mulch
-  Washed Shell



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	Dwn.	Chkd.	Dsgn.
			YY.MM.DD




Client/Project  
Manatee County Board of County Commissioners

Fort Hamer Park  
Phase II  
Manatee County, Florida

Title  
LANDSCAPE  
IRRIGATION PLAN - PH-IIA

Project No. 215610582	Scale 15 30 45 75
Drawing No.	Sheet of Revision

LI-101A of 0

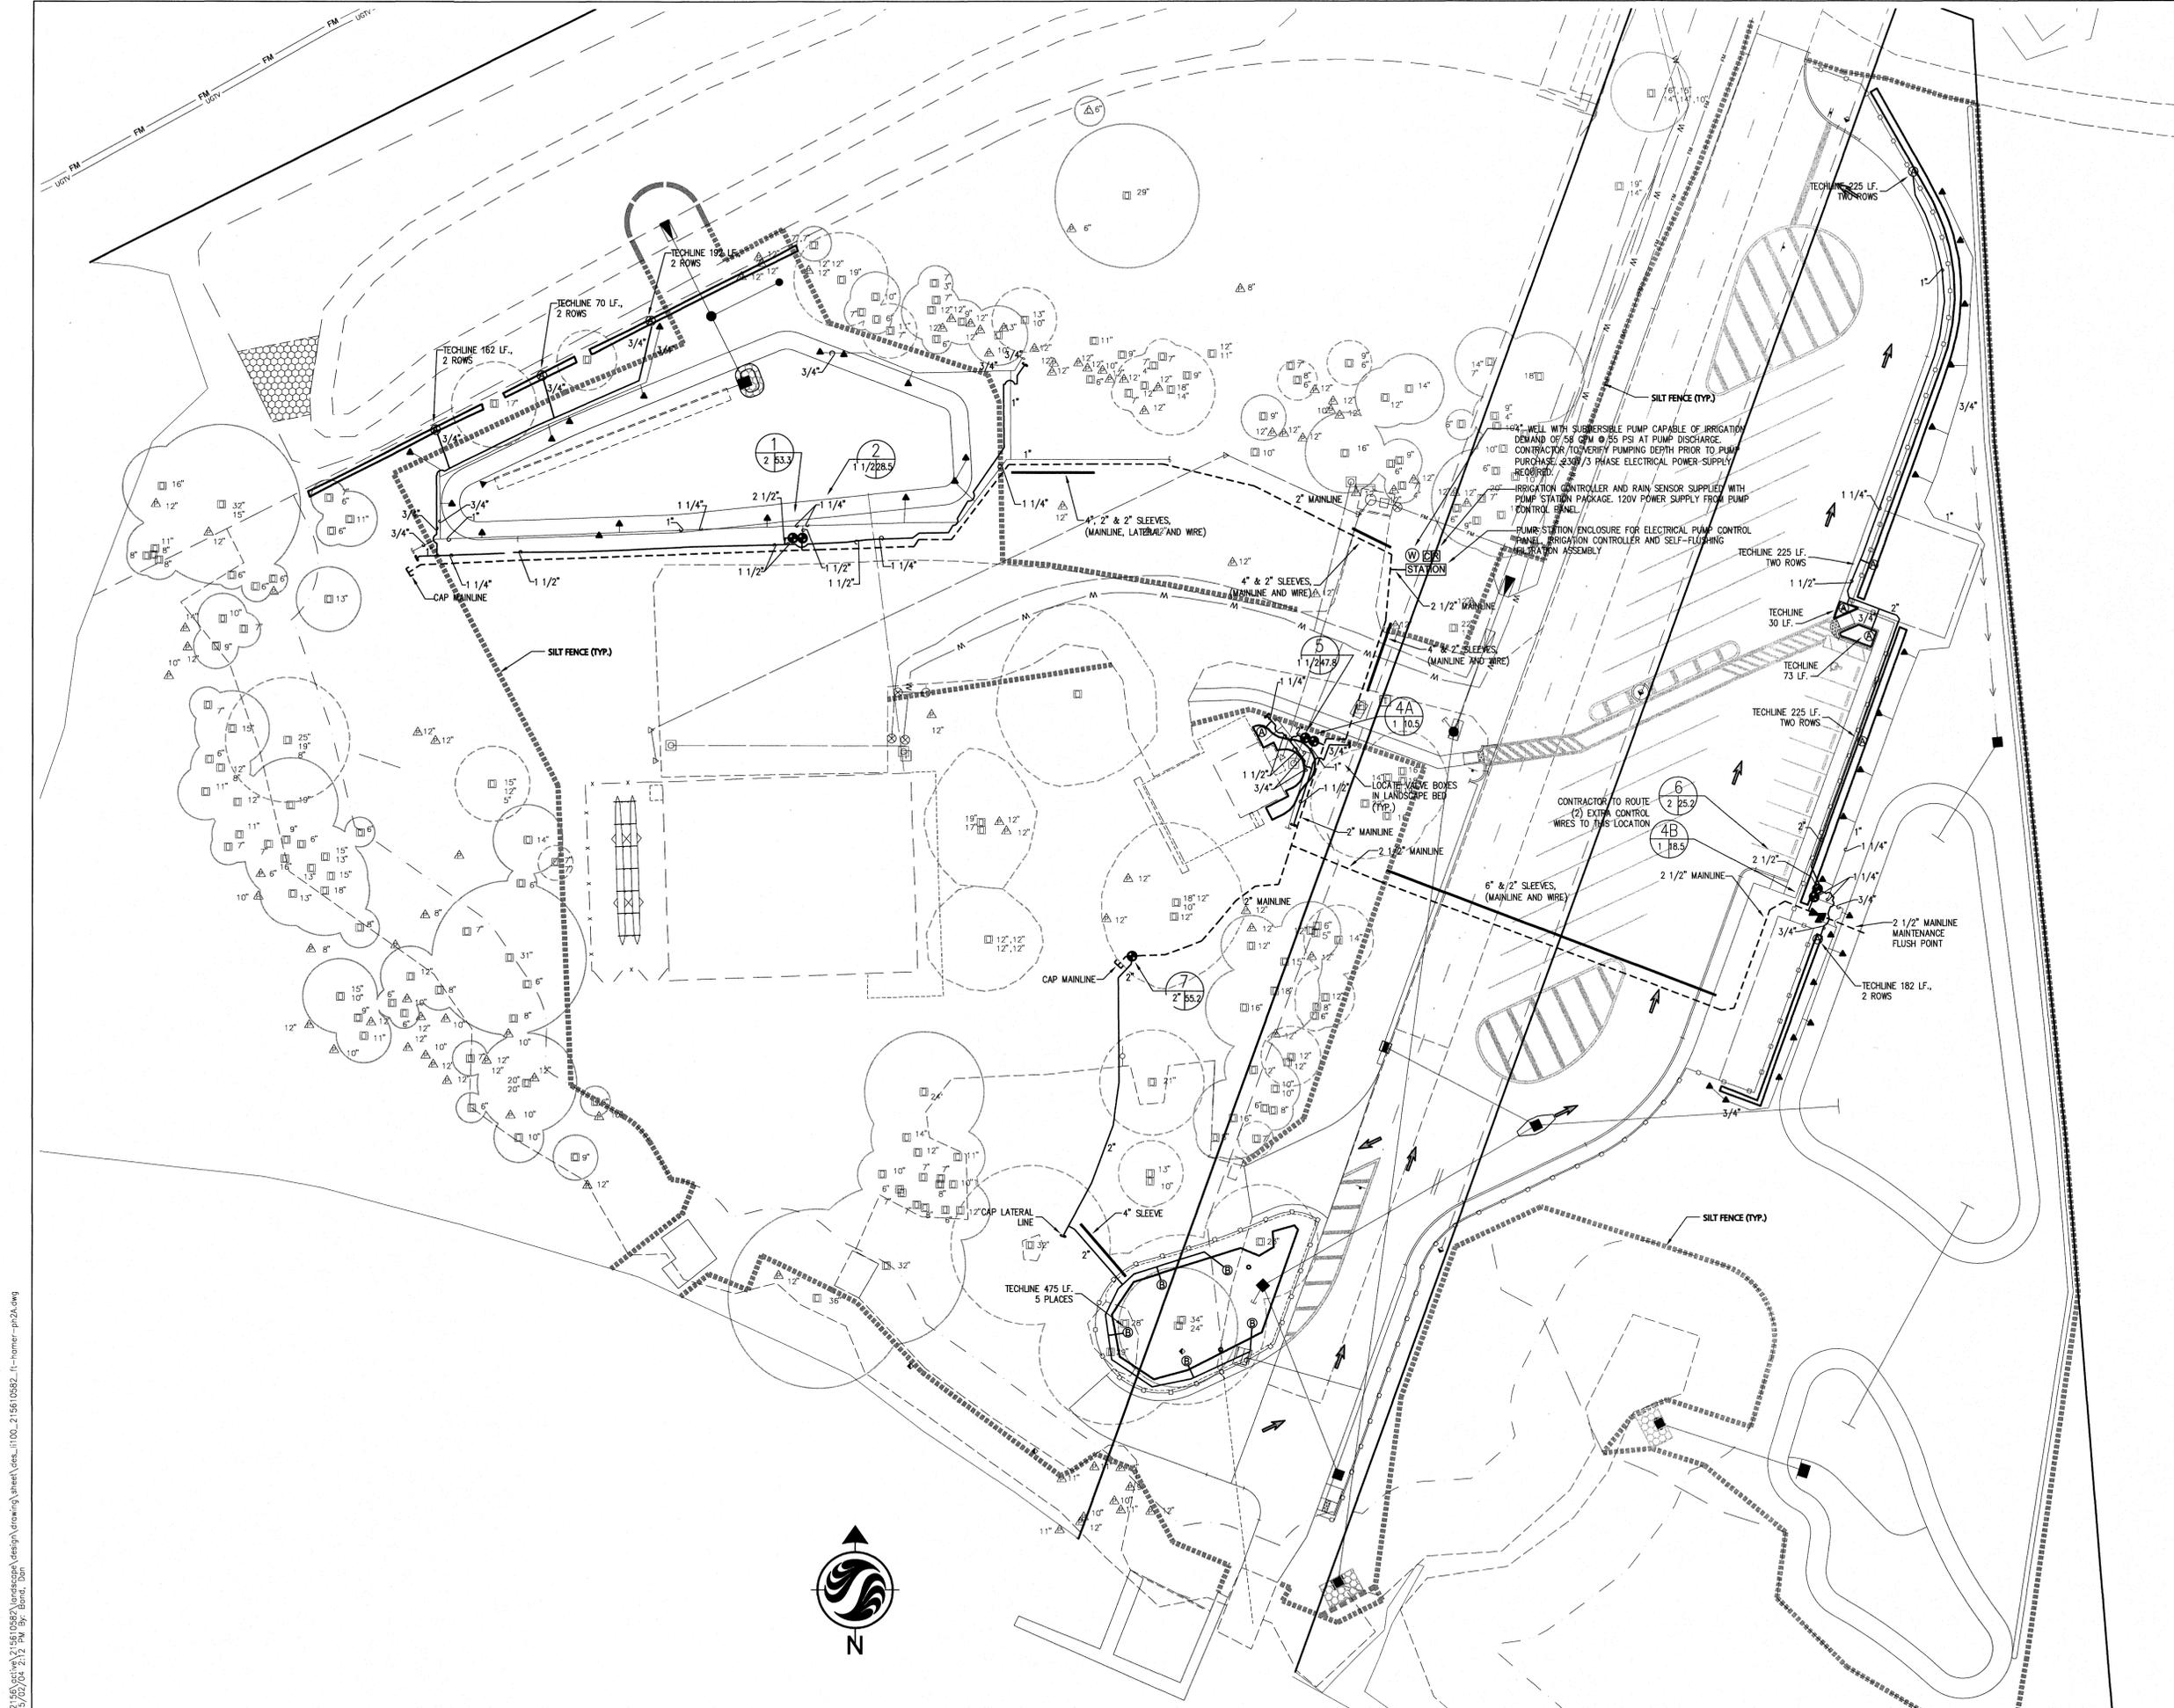

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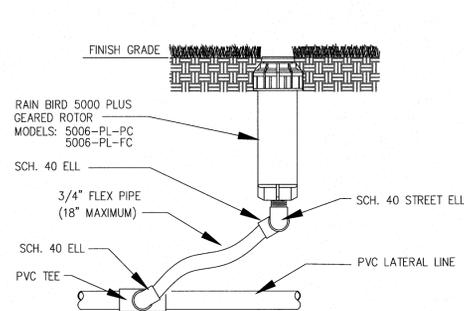
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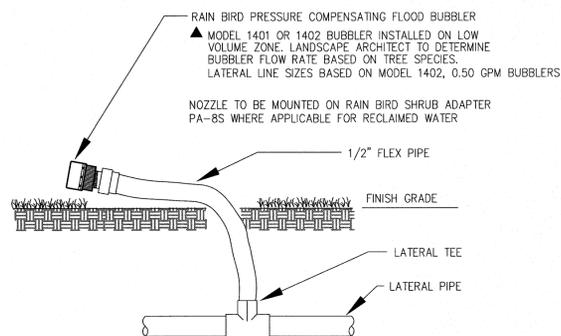
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Notes




RAIN BIRD 5000 PLUS SERIES ROTOR

NTS




RAIN BIRD 1400 SERIES BUBBLER

NTS

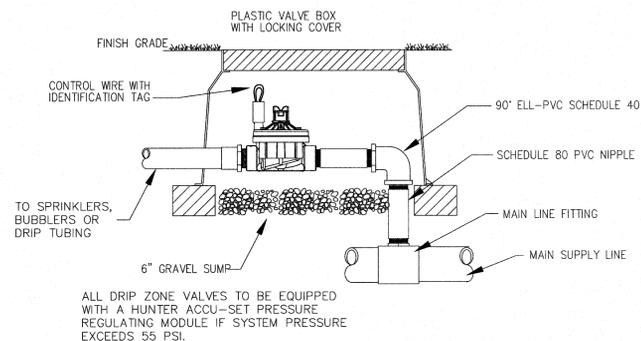


HUNTER ICV SERIES CONTROL VALVE

NTS

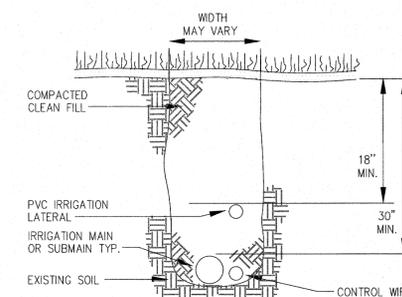

TRENCHING DETAIL

NTS

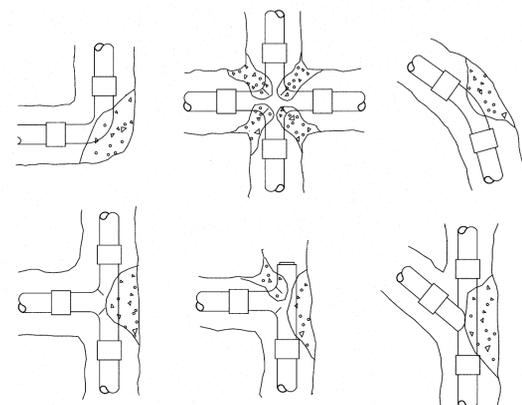


INSTALLATION NOTES

- 1. 3000 PSI CONCRETE OR BETTER IS TO BE USED FOR THRUST BLOCKS.
- 2. FOR 45/90° FITTINGS, MINIMUM OF 2 CUBIC FEET OF CONCRETE TO BE USED.
- 3. FOR 22 1/2° FITTINGS, MINIMUM OF 0.5 CUBIC FEET OF CONCRETE TO BE USED.
- 4. FOR TEES, MINIMUM OF 2 CUBIC FEET OF CONCRETE TO BE USED.

THRUST BLOCKS REQUIRED FOR IRRIGATION MAINLINE 2" AND LARGER.

THRUST BLOCK REINFORCEMENT

NTS

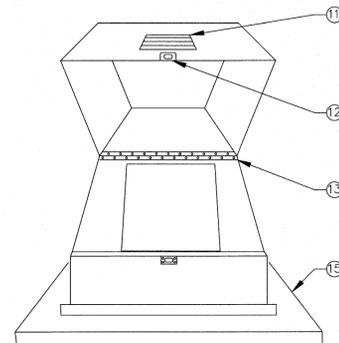

NOTE: Fiberglass Reinforced Enclosure with Forest Green Chemical & Ultraviolet Grade Gelcoat Finish. Maintain 3' clearance from all sides of pumpstation.

- 1) DISCHARGE ISOLATION VALVE
- 2) METER/ MAIN VALVE W/ PULSE OUTPUT
- 3) 2 GALLON PRESSURE TANK
- 4) ROLL GROOVE MANIFOLD
- 5) CHECK VALVE (SET IN WELL)
- 6) DISCHARGE FILTERS WITH 120 MESH W/ AUTOMATIC FLUSH CONTROLLER
- 7) 7.5 HP SUBMERSIBLE PUMP (60 GPM @ 55 PSI) SET IN WELL
- 8) 47"W X 56"L X 45"H FOREST GREEN FIBERGLASS FLIP TOP COVER
- 9) 52"W X 62"L WELDED ALUMINUM FRAME
- 10) UL LISTED CONTROL PANEL W/ VFD CONTROLS IN A FIBERGLASS ENCLOSURE WITH FAULT RESET/DETECTION VIA HUNTER CONTROLLER, LOSS OF PRIME, LOW & HIGH PRESSURE, AND TRANSIENT SURGE PROTECTION
- 11) 8" X 16" VENT (FRONT AND REAR)
- 12) STAINLESS STEEL LOCKABLE HASP
- 13) STAINLESS STEEL HINGE AND HARDWARE
- 14) HUNTER PRO-C CONTROLLER W/ HUNTER MINI CLIK
- 15) 5'W X 7'L X 4" T CONCRETE SLAB
- 16) PROPOSED 4" WELL

PUMP STATION DETAIL



NTS

NOTE: DISCHARGE PIPES & HEADER TO IRRIGATION MAIN SHALL BE SCHEDULE 40 GALVANIZED STEEL PIPE WITH GALV. ROLL GROOVE FITTINGS. PUMP DROP PIPE SHALL BE HDPE HEAT FUSED OR EQUAL AS APPROVED BY OWNER. SET PUMP 80' ON REQUIRED SIZED PIPE AS DICTATED BY PUMP OUTLET SIZE. INSTALL MOTOR CABLE SPLICE BETWEEN MOTOR AND CONTROL PANEL IN NEMA 4X JUNCTION BOX ADJACENT TO WELL IN ACCORDANCE WITH ELECTRICAL CODES. WELL DRILLER SHALL NOTIFY THE PUMP SYSTEM MANUFACTURER IN WRITING WITHIN 24 HOURS OF DEVELOPING THE WELL IF THE WELL PUMPING LEVEL IS GREATER THAN 25' BELOW FINISHED GRADE AFTER 8 HOURS OF CONTINUOUS PUMPING AT 125% OF THE DESIGN FLOW BELOW. PROVIDE MINIMUM OF 4' CLEARANCE ON ALL SIDES OF PUMP SYSTEM.

PUMP PERFORMANCE  
60 GPM @ 55 PSI  
230 VOLT 3 PHASE 30 AMP.

NAPLES ELECTRIC  
MOTOR WORKS, INC.  
2088 J&C BLVD  
NAPLES, FL 34109

MODEL # VFD-NETA-SUB-7.5-230-3

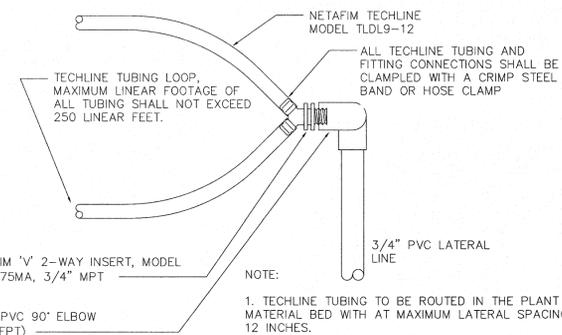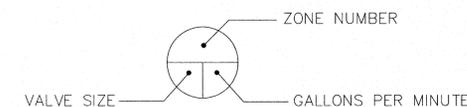

\* NOT TO EXCEED 4 GPM OR (250 LF TECHLINE) FOR EACH SUPPLY POINT

- 1. TECHLINE TUBING TO BE ROUTED IN THE PLANT MATERIAL BED WITH AT MAXIMUM LATERAL SPACING OF 12 INCHES.
- 2. TECHLINE TUBING TO BE ROUTED ALONG EACH SIDE OF PLANT MATERIAL WHERE APPLICABLE FOR HEDGE ROW PLANTING.
- 3. TECHLINE TUBING TO BE INSTALLED IN A GRID PATTERN. TECHLINE TUBING SHALL NOT BE INSTALLED IN A LONG CONTINUOUS RUN.

NETAFIM TECHLINE CONNECTION POINT 'A' END FEED HEDGE ROW

NTS

CONTROLLER SCHEDULE

ZONE	GPM	VALVE SIZE	TYPE
1	53.3	2"	DRIP
2	28.5	1 1/2"	BUBBLER
3	33.7	1 1/2"	DRIP
4A	10.5	1"	BUBBLER
4B	18.5	1"	BUBBLER
	29.0		
5	47.8	1 1/2"	DRIP
6	25.2	2"	DRIP
7	55.2	2"	DRIP
8	41.0	1 1/2"	ROTOR
9	XX	1 1/2"	ROTOR

Revision	By	Appd.	YY.MM.DD
1. ISSUED TO CLIENT	ASM	SAB	2015.01.27
Issued	By	Appd.	YY.MM.DD
File Name:	ASM	MLH	SAB
	Dwn.	Chkd.	Dsgn.
			2012.02.03
			YY.MM.DD



Client/Project

Manatee County Board of County Commissioners

Fort Hamer Park  
Phase II

Manatee County, Florida

Title

LANDSCAPE  
IRRIGATION DETAILS

Project No.  
215610582

Scale 15 30 45 75  
Sheet of

Drawing No.

Revision

LI-501

of 0



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Revision	By	Appd.	YY.MM.DD
1. ISSUED TO CLIENT	ASM	SAB	2015.01.27
Issued	By	Appd.	YY.MM.DD
File Name:	ASM	MLH	2012.02.03
	Dwn.	Chkd.	Dsgn.
			YY.MM.DD

Client/Project  
Manatee County Board of County Commissioners

Fort Hamer Park  
Phase II  
Manatee County, Florida


Title  
LANDSCAPE  
IRRIGATION DETAILS & NOTES

Project No. 215610582	Scale 15 30 45 75
Drawing No.	Sheet Revision

LI-502 of 0

NOTE:

- NETAFIM TECHLINE TUBING TO BE ROUTED IN THE PLANT MATERIAL BED WITH AT MAXIMUM LATERAL SPACING OF 12 INCHES.
- NETAFIM TECHLINE TUBING TO BE INSTALLED IN A GRID PATTERN. NETAFIM TECHLINE TUBING SHALL NOT BE INSTALLED IN A LONG CONTINUOUS RUN.
- ALL NETAFIM TECHLINE TUBING AND FITTING CONNECTIONS SHALL BE CLAMPED WITH A CRIMP STEEL BAND OR HOSE CLAMP

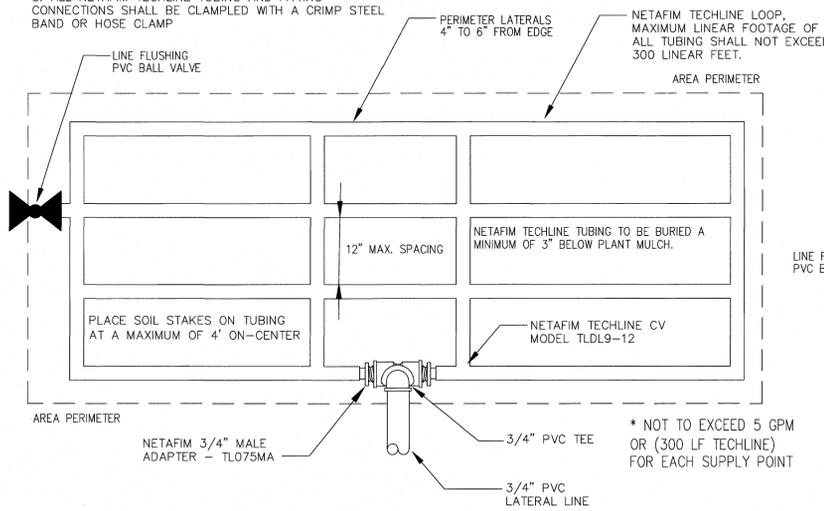


NETAFIM TECHLINE CONNECTION POINT "A"

NTS

NOTE:


- NETAFIM TECHLINE TUBING TO BE ROUTED IN THE PLANT MATERIAL BED WITH AT MAXIMUM LATERAL SPACING OF 12 INCHES.
- NETAFIM TECHLINE TUBING TO BE INSTALLED IN A GRID PATTERN. NETAFIM TECHLINE TUBING SHALL NOT BE INSTALLED IN A LONG CONTINUOUS RUN.
- ALL NETAFIM TECHLINE TUBING AND FITTING CONNECTIONS SHALL BE CLAMPED WITH A CRIMP STEEL BAND OR HOSE CLAMP

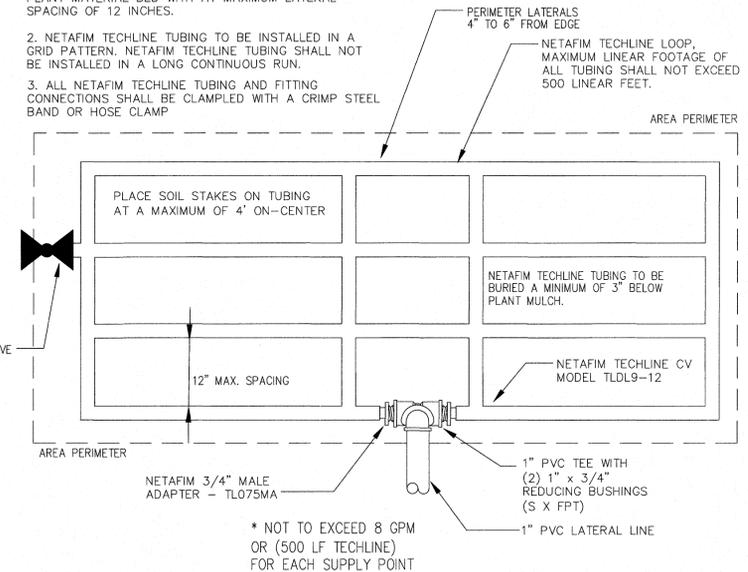

NETAFIM TECHLINE CONNECTION POINT "B"

NTS

WHEN TECHLINE REQUIRES MULTIPLE SUPPLY POINTS THE TECHLINE FROM EACH POINT SHALL BE CONNECTED UTILIZING NETAFIM INSERT FITTINGS.

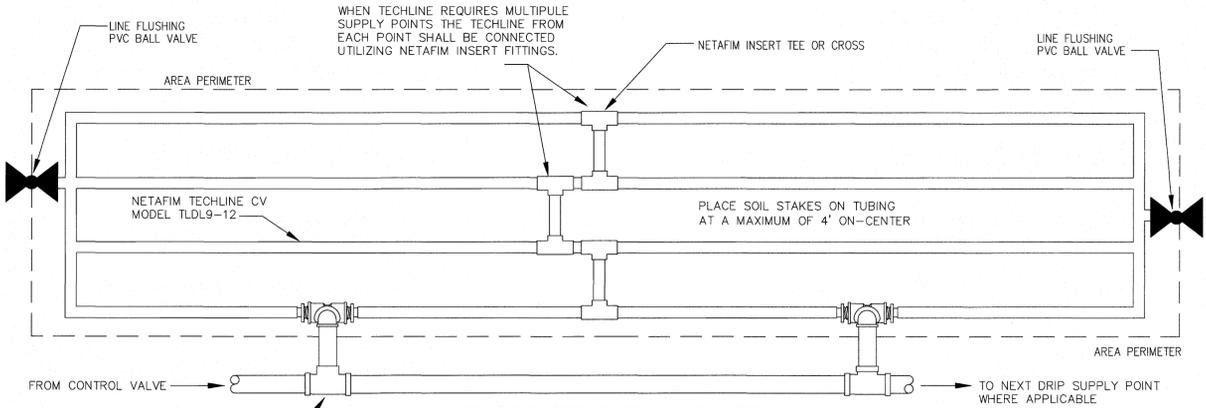

MULTIPLE TECHLINE CONNECTION SUPPLIES FROM SINGLE CONTROL VALVE

NTS

NOTE:

- NETAFIM TECHLINE TUBING TO BE ROUTED IN THE PLANT MATERIAL BED WITH AT MAXIMUM LATERAL SPACING OF 12 INCHES.
- NETAFIM TECHLINE TUBING TO BE INSTALLED IN A GRID PATTERN. NETAFIM TECHLINE TUBING SHALL NOT BE INSTALLED IN A LONG CONTINUOUS RUN.
- ALL NETAFIM TECHLINE TUBING AND FITTING CONNECTIONS SHALL BE CLAMPED WITH A CRIMP STEEL BAND OR HOSE CLAMP



IRRIGATION LEGEND

- ▲ RAIN BIRD 1400 PC SERIES BUBBLER
- ⊙ RAIN BIRD 5000 PLUS ROTOR, 5006-PL-PC-2.0 NOZZLE, 90° ADJUSTABLE
- ⊖ RAIN BIRD 5000 PLUS ROTOR, 5006-PL-PC-3.0 NOZZLE, 180° ADJUSTABLE
- RAIN BIRD 5000 PLUS ROTOR, 5006-PL-PC-6.0 NOZZLE, 360° FULL CIRCLE
- HUNTER PRO-C SERIES CONTROLLER MODEL PC-900, CONTROLLER SUPPLIED WITH PUMP STATION PACKAGE
- ▭ HUNTER MINI-CLIK RAIN SENSOR, SUPPLIED WITH PUMP STATION PACKAGE
- ⊛ HUNTER ICV SERIES ELECTRIC CONTROL VALVE
- Ⓐ NETAFIM TECHLINE SUPPLY POINT OF CONNECTION "A"
- Ⓑ NETAFIM TECHLINE SUPPLY POINT OF CONNECTION "B"
- NETAFIM TECHLINE, MODEL TLDL9-1210
- Ⓜ 4" WELL WITH SUBMERSIBLE PUMP TO MEET IRRIGATION DEMAND OF 60 GPM AT 55 PSI DISCHARGE
- ⊘ GATE VALVE PER LINE SIZE
- CLASS 200 PVC MAINLINE, SOLVENT WELD
- CLASS 200 PVC LATERAL LINE, SOLVENT WELD
- SCHEDULE 40 PVC SLEEVE

IRRIGATION NOTES

- VERIFY LOCATIONS OF ALL UNDERGROUND UTILITIES PRIOR TO INSTALLATION OF IRRIGATION SYSTEM. MAINLINE SHALL NOT BE LOCATED WITHOUT PRIOR APPROVAL OF THE PROJECT MANAGER AND THE LANDSCAPE ARCHITECT. ALL UTILITIES AND STRUCTURES MAY NOT BE SHOWN ON THESE PLANS-CONTRACTOR SHALL VERIFY.
- ALL PRESSURE MAINLINES UNDER ASPHALT PAVEMENT SHALL BE WITHIN SLEEVES AS NOTED. IRRIGATION COMMUNICATION CABLE SHALL HAVE ITS OWN SEPARATE SLEEVE. LATERAL LINES THEY SHALL BE CONTAINED WITHIN THEIR OWN SLEEVE WHERE SHOWN ON THE PLAN.
- ALL SLEEVES UTILIZED BY THE IRRIGATION CONTRACTOR, WHETHER INSTALLED BY HIM OR NOT, SHALL BE LOCATED ON THE "AS-BUILT" DRAWINGS. THE DEPTH BELOW FINISH GRADE, TO THE NEAREST FOOT OF EACH END OF EACH SLEEVE SHALL BE NOTED AT EACH SLEEVE LOCATION ON THE "AS-BUILT" DRAWINGS.
- MAINLINE AND VALVES ARE SHOWN IN SCHEMATIC FORM. LOCATE AS NOTED ON PLANS.
- LOCATE ALL VALVES A MINIMUM OF 24" FROM BACK OF CURB OR EDGE OF PAVEMENT, UNLESS NOTED OTHERWISE.
- ALL UNSIZED PIPE SHALL BE 3/4" UNLESS OTHERWISE NOTED.
- THE HEAD LAYOUT HAS BEEN DESIGNED TO PROVIDE 100% COVERAGE. ANY CHANGES MADE IN THE HEAD LAYOUT DUE TO FIELD CONDITIONS SHALL BE IN ACCORDANCE WITH THESE STANDARDS.
- SET SPRAY HEADS 3" AND ROTORS 6" IN FROM BACK OF CURB OR 12" IF PAVEMENT HAS NO CURB.
- ALL VALVES SHALL BE INSTALLED IN A CARSON VALVE BOX WITH LOCKING LID.
- IRRIGATION CONTRACTOR SHALL SECURE ANY AND ALL NECESSARY PERMITS FOR THE WORK PRIOR TO COMMENCEMENT OF HIS OPERATIONS ON-SITE. COPIES OF THE PERMITS SHALL BE SENT TO THE OWNER/GENERAL CONTRACTOR. WORK IN THE R.O.W. SHALL CONFORM TO THE STANDARDS AND SPECIFICATIONS OF LOCAL AND/OR STATE HIGHWAY JURISDICTION.
- VERIFY WELL STATION LOCATION, CONTROLLER LOCATION AND ELECTRICAL POWER LOCATION AT PROJECT SITE WITH OWNER.
- ELECTRICAL SERVICE TO THE PUMP STATION PANEL SHALL BE PROVIDED BY THE GENERAL CONTRACTOR.
- ALL 24 VAC WIRING SHALL BE OF DIRECT BURIAL COPPER WIRE AS FOLLOWS:  
CONTROL WIRES - #14-1 RED  
COMMON WIRE - #14-1 WHITE
- DURING INSTALLATION AND UPON COMPLETION OF THE IRRIGATION SYSTEM, VALVES SHALL BE WIRED TO THE CONTROLLER STATION AS PER THE IRRIGATION ZONE NUMBERS.
- INSTALLATION OF WORK SHALL BE COORDINATED WITH OTHER CONTRACTORS IN SUCH A MANNER AS TO ALLOW FOR A SPEEDY AND ORDERLY COMPLETION OF ALL WORK ON THE SITE.

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REMARKS	LOAD SERVING										LOAD SERVING										REMARKS			
	POLES AND		VOLT AMPS				WIRE				POLES AND		VOLT AMPS				WIRE							
	AMPS	AMPS	LIGHTS	POWER	LIGHTS	POWER	SIZE	NO.	NO.	SIZE	LIGHTS	POWER	LIGHTS	POWER	AMPS	AMPS	LIGHTS	POWER	SIZE	NO.		NO.	SIZE	
EX. RECEIPT	1	20/1		1260			12	1	2	12	1500													EX. H-BAYS
EX. H-BAYS	3	20/1		1500			12	3	4	12	1500													EX. H-BAYS
EX. H-BAYS	5	20/1	1500				12	5	6	12	900													EX. LIGHTS
EX. EXTERIOR LIGHTS	7	20/1		900			12	7	8	8	550													SITE LIGHTING
SITE LIGHTING	9	20/2 (*)	550				10	9	10	8	550													SITE LIGHTING
	11			550			10	11	12	12														SITE LIGHTING
SITE LIGHTING	13	20/2 (*)	370				10	13	14	12	40													SITE LIGHTING
	15						10	15	16	10														SITE LIGHTING
EXTERIOR LIGHTS	17	20/1 (*)	548				12	17	18	10	185													
EX. SPARE	19	20/1					18	20																EX. SPARE
EX. SPARE	21	20/1					21	22																EX. SPARE
EX. SPARE	23	20/1					23	24																EX. SPARE
EX. SPARE	25	20/1					25	26																EX. SPARE
EX. SPARE	27	20/1					27	28																EX. SPARE
EX. SPARE	29	20/1					29	30																EX. SPARE
EX. SPARE	31	20/1					31	32																EX. SPARE
EX. SPARE	33	20/1					33	34																EX. SPARE
EX. SPARE	35	20/1					35	36																EX. SPARE
SPD	37	30/2 (*)					37	38																EX. SPARE
	39						39	40																EX. SPARE
	41						41	42																EX. SPARE
			2968	1260	3320	0					3135	40	2411	0										

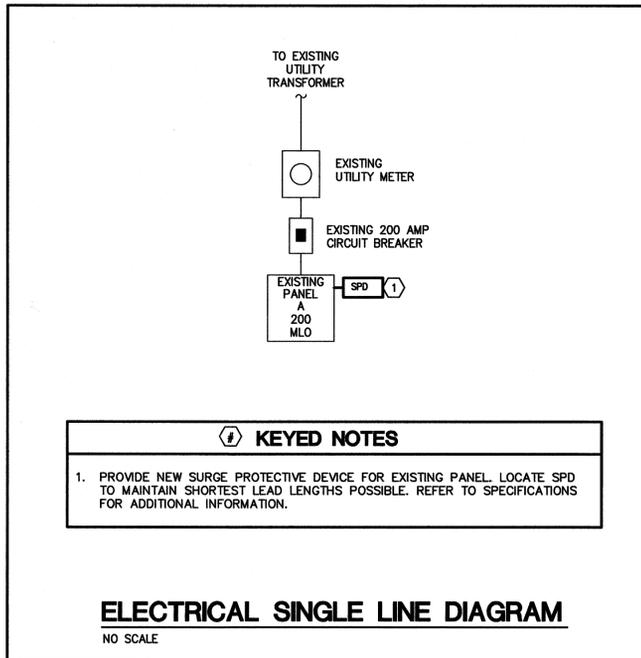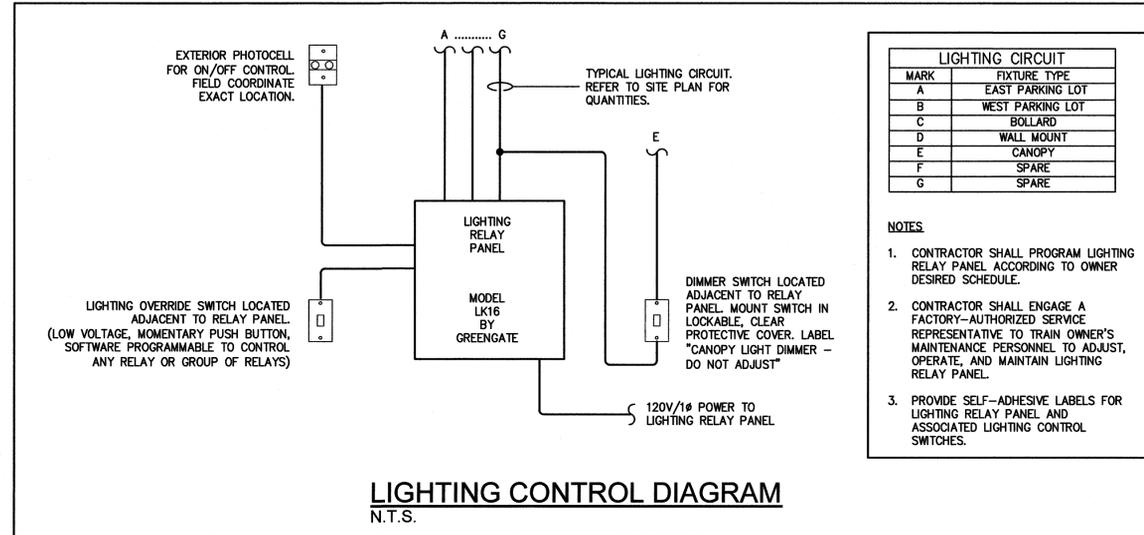CALCULATIONS	CONN. LOAD			DESIGN LOAD		
	KVA	AMPS	FACTOR	KVA	AMPS	
LIGHTING	11.8	49.3	1.25	14.8	61.6	
CONV. OUTLETS	0.0	0.0	-	0.0	0.0	
MOTORS	0.0	0.0	1	0.0	0.0	
MISC	1.3	5.4	1	1.3	5.4	
EMF	0.0	0.0	1	0.0	0.0	
KITCHEN EG	0.0	0.0	0.65	0.0	0.0	
SPARE	0.0	0.0	1	0.0	0.0	
SPACE ONLY	0.0	0.0	1	0.0	0.0	
TOTAL	13.1	54.7		16.1	67.1	

**REMARKS:**  
PROVIDE NEW TYPE WRITTEN DIRECTORY.  
PROVIDE NEW BREAKERS FOR CIRCUITS DESIGNATED WITH AN ASTERISK (\*). UTILIZE SPARE BREAKERS WHERE AVAILABLE.

**EXISTING PANEL: A**  
BREAKING: SURFACE  
VOLTS: 120/240, 1PH, 3W  
MAIN SIZE: 200 AMPS  
MAIN TYPE: MLO  
BRACING: MATCH EXISTING KAC

SM JOB #14-0520

**ELECTRICAL PANEL SCHEDULE**  
NO SCALE

- GENERAL NOTES ELECTRICAL**
- DO NOT SCALE FROM THESE DRAWINGS.
  - ALL WORK SHALL BE DONE IN STRICT ACCORDANCE WITH THE NATIONAL ELECTRICAL CODE.
  - ELECTRICAL CONTRACTOR SHALL COORDINATE WORK WITH ALL OTHER TRADES TO ASSURE PROPER CLEARANCES FOR EQUIPMENT AND TO KEEP THE JOB PROGRESSING.
  - ALL EXTERIOR WIRING DEVICES TO BE WEATHERPROOF AND SHALL BE G.F.I. TYPE.
  - CONDUIT RUNS SHOWN ARE DIAGRAMMATIC IN NATURE. CONTRACTOR IS RESPONSIBLE FOR SIZING AND LOCATING PULL BOXES PER NEC AND FOR COORDINATION WITH OTHER DISCIPLINES.
  - ALL H.L.D. AND FLUORESCENT LIGHT FIXTURES SHALL BE FURNISHED WITH INTEGRAL FUSING.
  - COORDINATE EXACT LOCATIONS OF ALL ITEMS INSTALLED ON SITE WITH CIVIL ENGINEER.
  - USE 10 AWG CU. CONDUCTORS FOR 20 AMPERE, 120 VOLT BRANCH CIRCUITS LONGER THAN 75 FEET, UNLESS OTHERWISE NOTED ON SITE PLAN. USE 10 AWG CU. CONDUCTORS FOR 20 AMPERE, 277 VOLT BRANCH CIRCUITS LONGER THAN 200 FEET, UNLESS OTHERWISE NOTED ON SITE PLAN.
  - ALL SITE LIGHTING POLES AND POLE BASES SHALL BE CAPABLE OF SUPPORTING THE ENTIRE WEIGHT AND WIND LOADS OF THE ENTIRE LIGHTING SYSTEM. SHOP DRAWINGS MUST INCLUDE DRAWINGS OF THE ENTIRE ASSEMBLY FOR EACH OF THE MOUNTING CONFIGURATIONS USED. DRAWINGS MUST BE SIGNED AND SEALED BY A FLORIDA REGISTERED STRUCTURAL ENGINEER AND DESIGNED TO THE FLORIDA BUILDING CODE WIND LOAD REQUIREMENTS FOR THE PROJECT SITE.

**ELECTRICAL SYMBOL LEGEND**

SYMBOL	DESCRIPTION	MOUNTING AND NOTES
	TYPICAL LIGHTING SYMBOL NOTES: 1. UPPER CASE LETTER DENOTES FIXTURE TYPE. SEE FIXTURE SCHEDULE 2. LOWER CASE LETTER DENOTES SWITCHED LEG 3. SHADED FIXTURE SYMBOL INDICATES EMERGENCY FIXTURE 4. 'NL' DENOTES NIGHT LIGHT CIRCUIT	
○	POLE MOUNTED LIGHT FIXTURE. REFER TO LIGHT FIXTURE SCHEDULE FOR MORE INFORMATION.	SEE FIXTURE SCHEDULE
□	WALL MOUNTED LIGHT FIXTURE. REFER TO LIGHT FIXTURE SCHEDULE FOR MORE INFORMATION.	SEE FIXTURE SCHEDULE
○	SURFACE MOUNTED LIGHT FIXTURE. REFER TO LIGHT FIXTURE SCHEDULE FOR MORE INFORMATION.	SEE FIXTURE SCHEDULE
	TYPICAL RECEPTACLE, OUTLET AND JUNCTION BOX SUFFIX LEGEND: WP = WEATHERPROOF GFI = GROUND FAULT INTERRUPTER UP = UP (CONDUIT) DN = DOWN (CONDUIT) E = EXISTING	
⊕	DUPLEX RECEPTACLE (20A, 120V).	M.H. 16" AFF U.O.N.
⊙	JUNCTION OR OUTLET BOX, 4" SQUARE BOX U.O.N.	AS NOTED
■	PANELBOARD, 120/240V., 1 PH., 3W	6"-6" AFF MIN. TO TOP
○ up	RACEWAY RISER, UP OR DOWN AS NOTED.	SEE SPECIFICATIONS
⌒	RACEWAY CONCEALED UNDER FLOOR, IN SLAB OR BELOW GRADE	SEE SPECIFICATIONS
⌒	RACEWAY CONCEALED IN WALL OR CEILING	SEE SPECIFICATIONS
⌒ L1B-1,3	HOMERUN TO PANEL, LETTERS INDICATE PANEL, NUMBERS INDICATE CIRCUITS.	SEE SPECIFICATIONS

**NOTE:**  
NOT ALL SYMBOLS SHOWN IN THIS LEGEND MAY NECESSARILY APPEAR IN THESE DOCUMENTS. ADDITIONAL SYMBOLS MAY BE DEFINED ELSEWHERE IN SPECIFIC DRAWINGS.



DRAWING PHASE: FINAL SITE PLAN

CONSTRUCTION DOCUMENTS

ISSUE DATE: 01.23.2015 EMI JOB NO. 14-0520

DRAWING REVISIONS:

REV	DATE	DESCRIPTION

**FORT HAMER PARK**  
**PHASE II**  
PART OF SECTION 17, TOWNSHIP 34 SOUTH, RANGE 19 EAST  
MANATEE COUNTY, FLORIDA

SEAL:

DRAWING TITLE:  
**ELECTRICAL LEGEND, NOTES, & PANEL SCHEDULE**





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DRAWING NUMBER:  
**E0.0**

**ELECTRICAL LEGEND, NOTES, AND PANEL SCHEDULE**  
NO SCALE

**LIGHT FIXTURE SCHEDULE**

TYPE	MANUFACTURER	CATALOG NUMBER	LAMPS		VOLTS	MOUNTING	REMARKS
			QTY	TYPE			
POLE 1	HAPCO	SSA30F6-4-BM				CONCRETE BASE	30' SQUARE STRAIGHT ALUMINUM POLE WITH .25" WALL THICKNESS AND DARK BRONZE POWDER COAT FINISH. PROVIDE POLES FOR PARKING LOT LIGHTS AS REQUIRED. PROVIDE ALL COMPONENTS FOR MOUNTING FIXTURES. REFER TO POLE BASE DETAIL FOR MORE INFORMATION.
	OR EQUAL						
POLE 2	HAPCO	SSA20F4-4-BM				CONCRETE BASE	20' SQUARE STRAIGHT ALUMINUM POLE WITH .25" WALL THICKNESS AND DARK BRONZE POWDER COAT FINISH. PROVIDE POLES FOR PARKING LOT LIGHTS AS REQUIRED. PROVIDE ALL COMPONENTS FOR MOUNTING FIXTURES. REFER TO POLE BASE DETAIL FOR MORE INFORMATION.
	OR EQUAL						
A1	LITHONIA	KAD-LED-1-63B350-40K-SR3-MVOLT-SF-DDBXD	63	LED 4000K 8998 LM 110 W	240V	4" ARM MOUNT TO 30' POLE	DIE-CAST CONTOURED ALUMINUM LED FIXTURE WITH TYPE 3 DISTRIBUTION AND DARK BRONZE FINISH. PROVIDE 4" SQUARE POLE MOUNTING ARM AND FUSING. PROVIDE SHIELDS AS NOTED ON PLAN.
	OR EQUAL						
A2	LITHONIA	KAD-LED-1-63B350-40K-SR4-MVOLT-SF-DDBXD	63	LED 4000K 8998 LM 110 W	240V	4" ARM MOUNT TO 30' POLE	DIE-CAST CONTOURED ALUMINUM LED FIXTURE WITH TYPE 4 DISTRIBUTION AND DARK BRONZE FINISH. PROVIDE 4" SQUARE POLE MOUNTING ARM AND FUSING. PROVIDE SHIELDS AS NOTED ON PLAN.
	OR EQUAL						
A3	LITHONIA	KAD-LED-1-63B350-40K-SR3-MVOLT-SF-DDBXD	63	LED 4000K 6661 LM 74 W	240V	4" ARM MOUNT TO 20' POLE	DIE-CAST CONTOURED ALUMINUM LED FIXTURE WITH TYPE 3 DISTRIBUTION AND DARK BRONZE FINISH. PROVIDE 4" SQUARE POLE MOUNTING ARM AND FUSING. PROVIDE SHIELDS AS NOTED ON PLAN.
	OR EQUAL						
B	STONELIGHT	8" SQUARE GRANADA CAP - COLOR "WHEAT"	1	LED 8 W	120V	CONCRETE BASE	CONCRETE BOLLARD WITH 8 WATT LED FIXTURE AND INTEGRAL DRIVER. PROVIDE FUSING. PROVIDE CONCRETE BASE PER MANUFACTURER'S REQUIREMENTS.
	OR EQUAL						
C	LITHONIA	KAD-LED-1-63B350-40K-SR3-MVOLT-SF-DDBXD	63	LED 4000K 6661 LM 74 W	120V	9" ARM AND BRACKET MOUNTED TO WALL AT 18' AFG	DIE-CAST CONTOURED ALUMINUM LED FIXTURE WITH TYPE 3 DISTRIBUTION AND DARK BRONZE FINISH. PROVIDE WALL BRACKET AND FUSING. PROVIDE SHIELDS AS NOTED ON PLAN.
	OR EQUAL						
D	LITHONIA	KADM-LED-1-49B350-40K-SR4-MVOLT-SF-DDBXD	49	LED 4000K 4792 LM 59 W	120V	SURFACE MOUNT TO UNDERSIDE OF CANOPY	DIE-CAST ALUMINUM OUTDOOR LED FIXTURE WITH TYPE 4 DISTRIBUTION AND DARK BRONZE FINISH. PROVIDE DIMMING DRIVER, VANDAL GUARD, AND FUSING. PROVIDE SHIELDS AS NOTED ON PLAN.
	OR EQUAL						

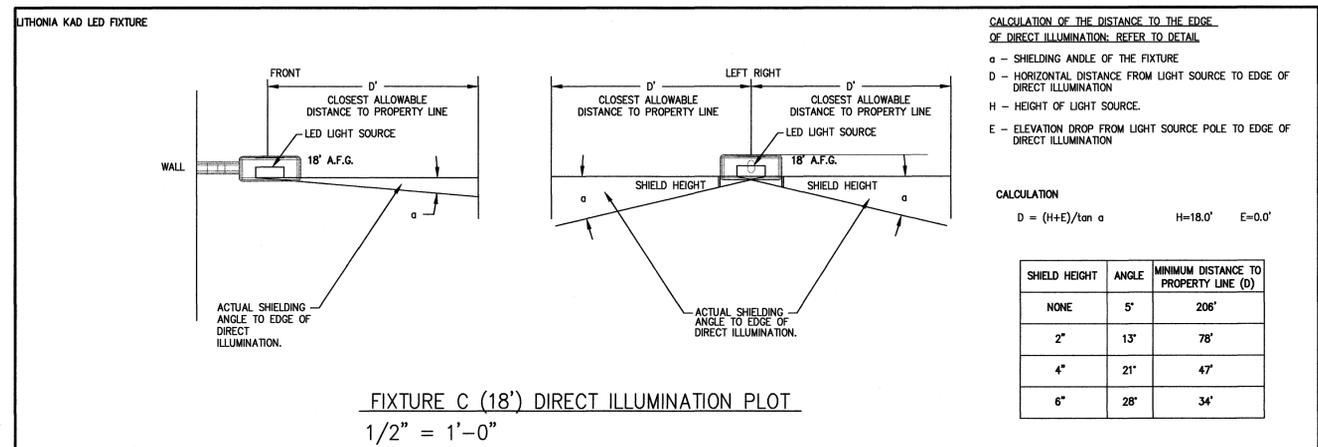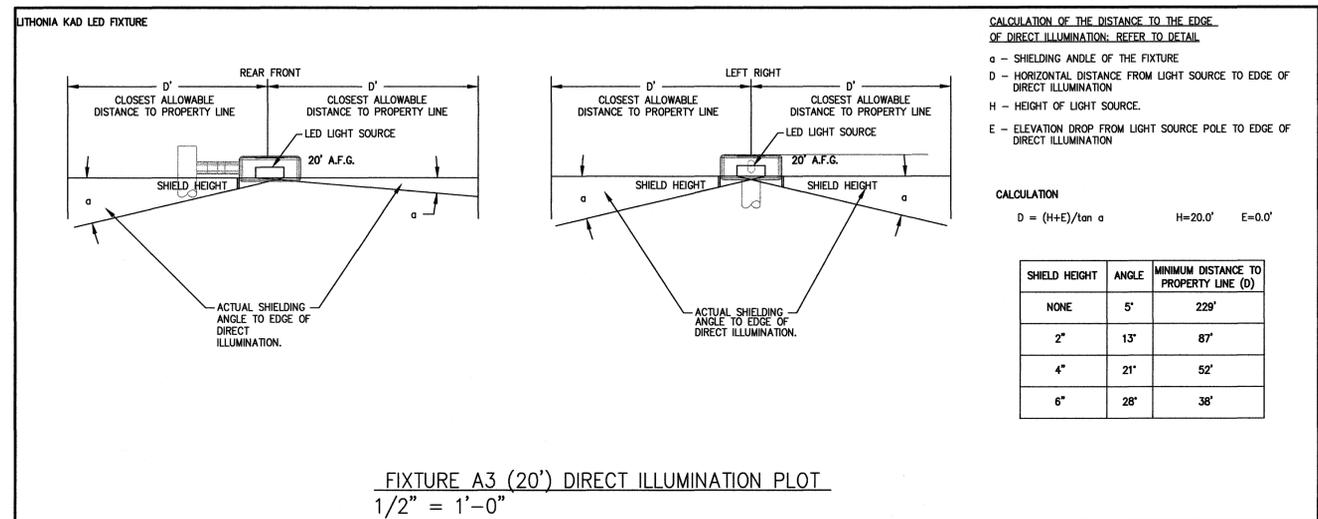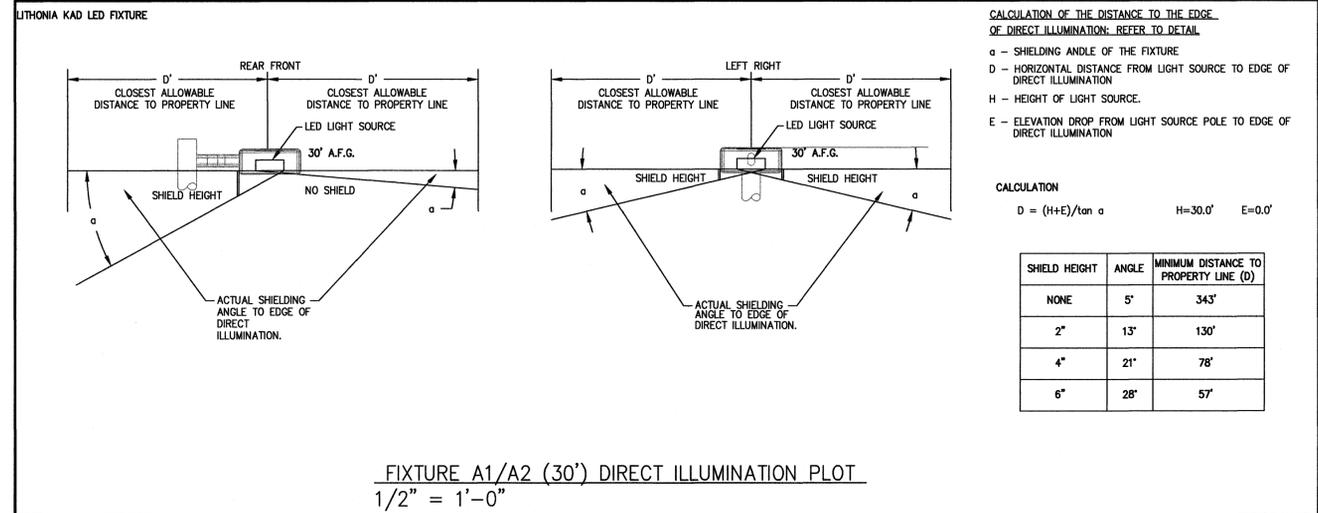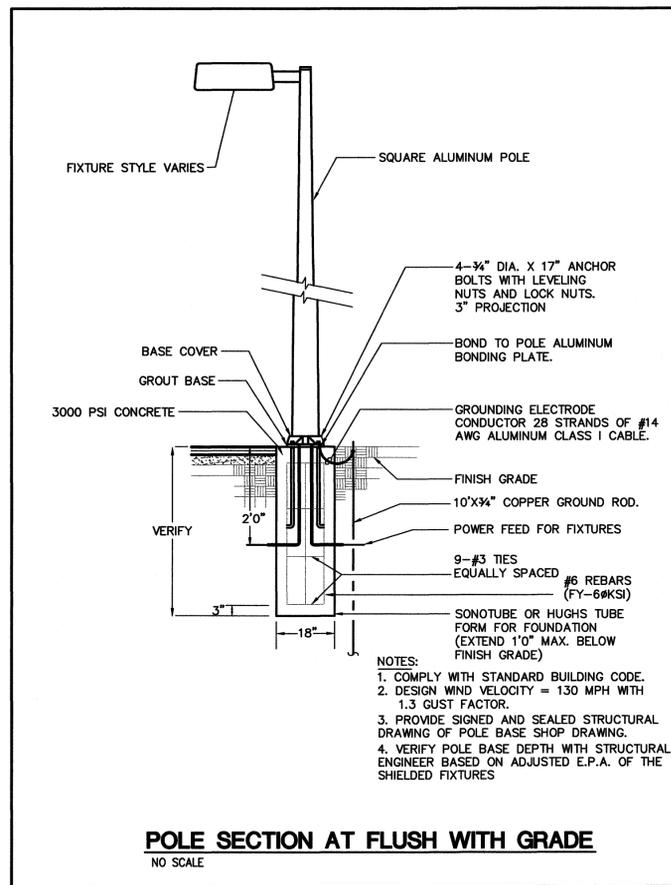

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CONSULTING ENGINEER  
STATE OF FLORIDA  
No. 12345  
Exp. 12/31/2015



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FINAL SITE PLAN

CONSTRUCTION DOCUMENTS  
ISSUE DATE: 01.23.2015    EMI JOB NO. 14-0620

DRAWING REVISIONS:  
REV    DATE    DESCRIPTION

REV	DATE	DESCRIPTION

**FORT HAMER PARK**  
**PHASE II**  
PART OF SECTION 17, TOWNSHIP 34 SOUTH, RANGE 19 EAST  
MANATEE COUNTY, FLORIDA

SEAL:


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**ELECTRICAL DETAILS**

SCALE: AS NOTED    NORTH:

DRAWING NUMBER:  
**E0.1**

**ELECTRICAL DETAILS**  
NO SCALE

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**GENERAL NOTES**

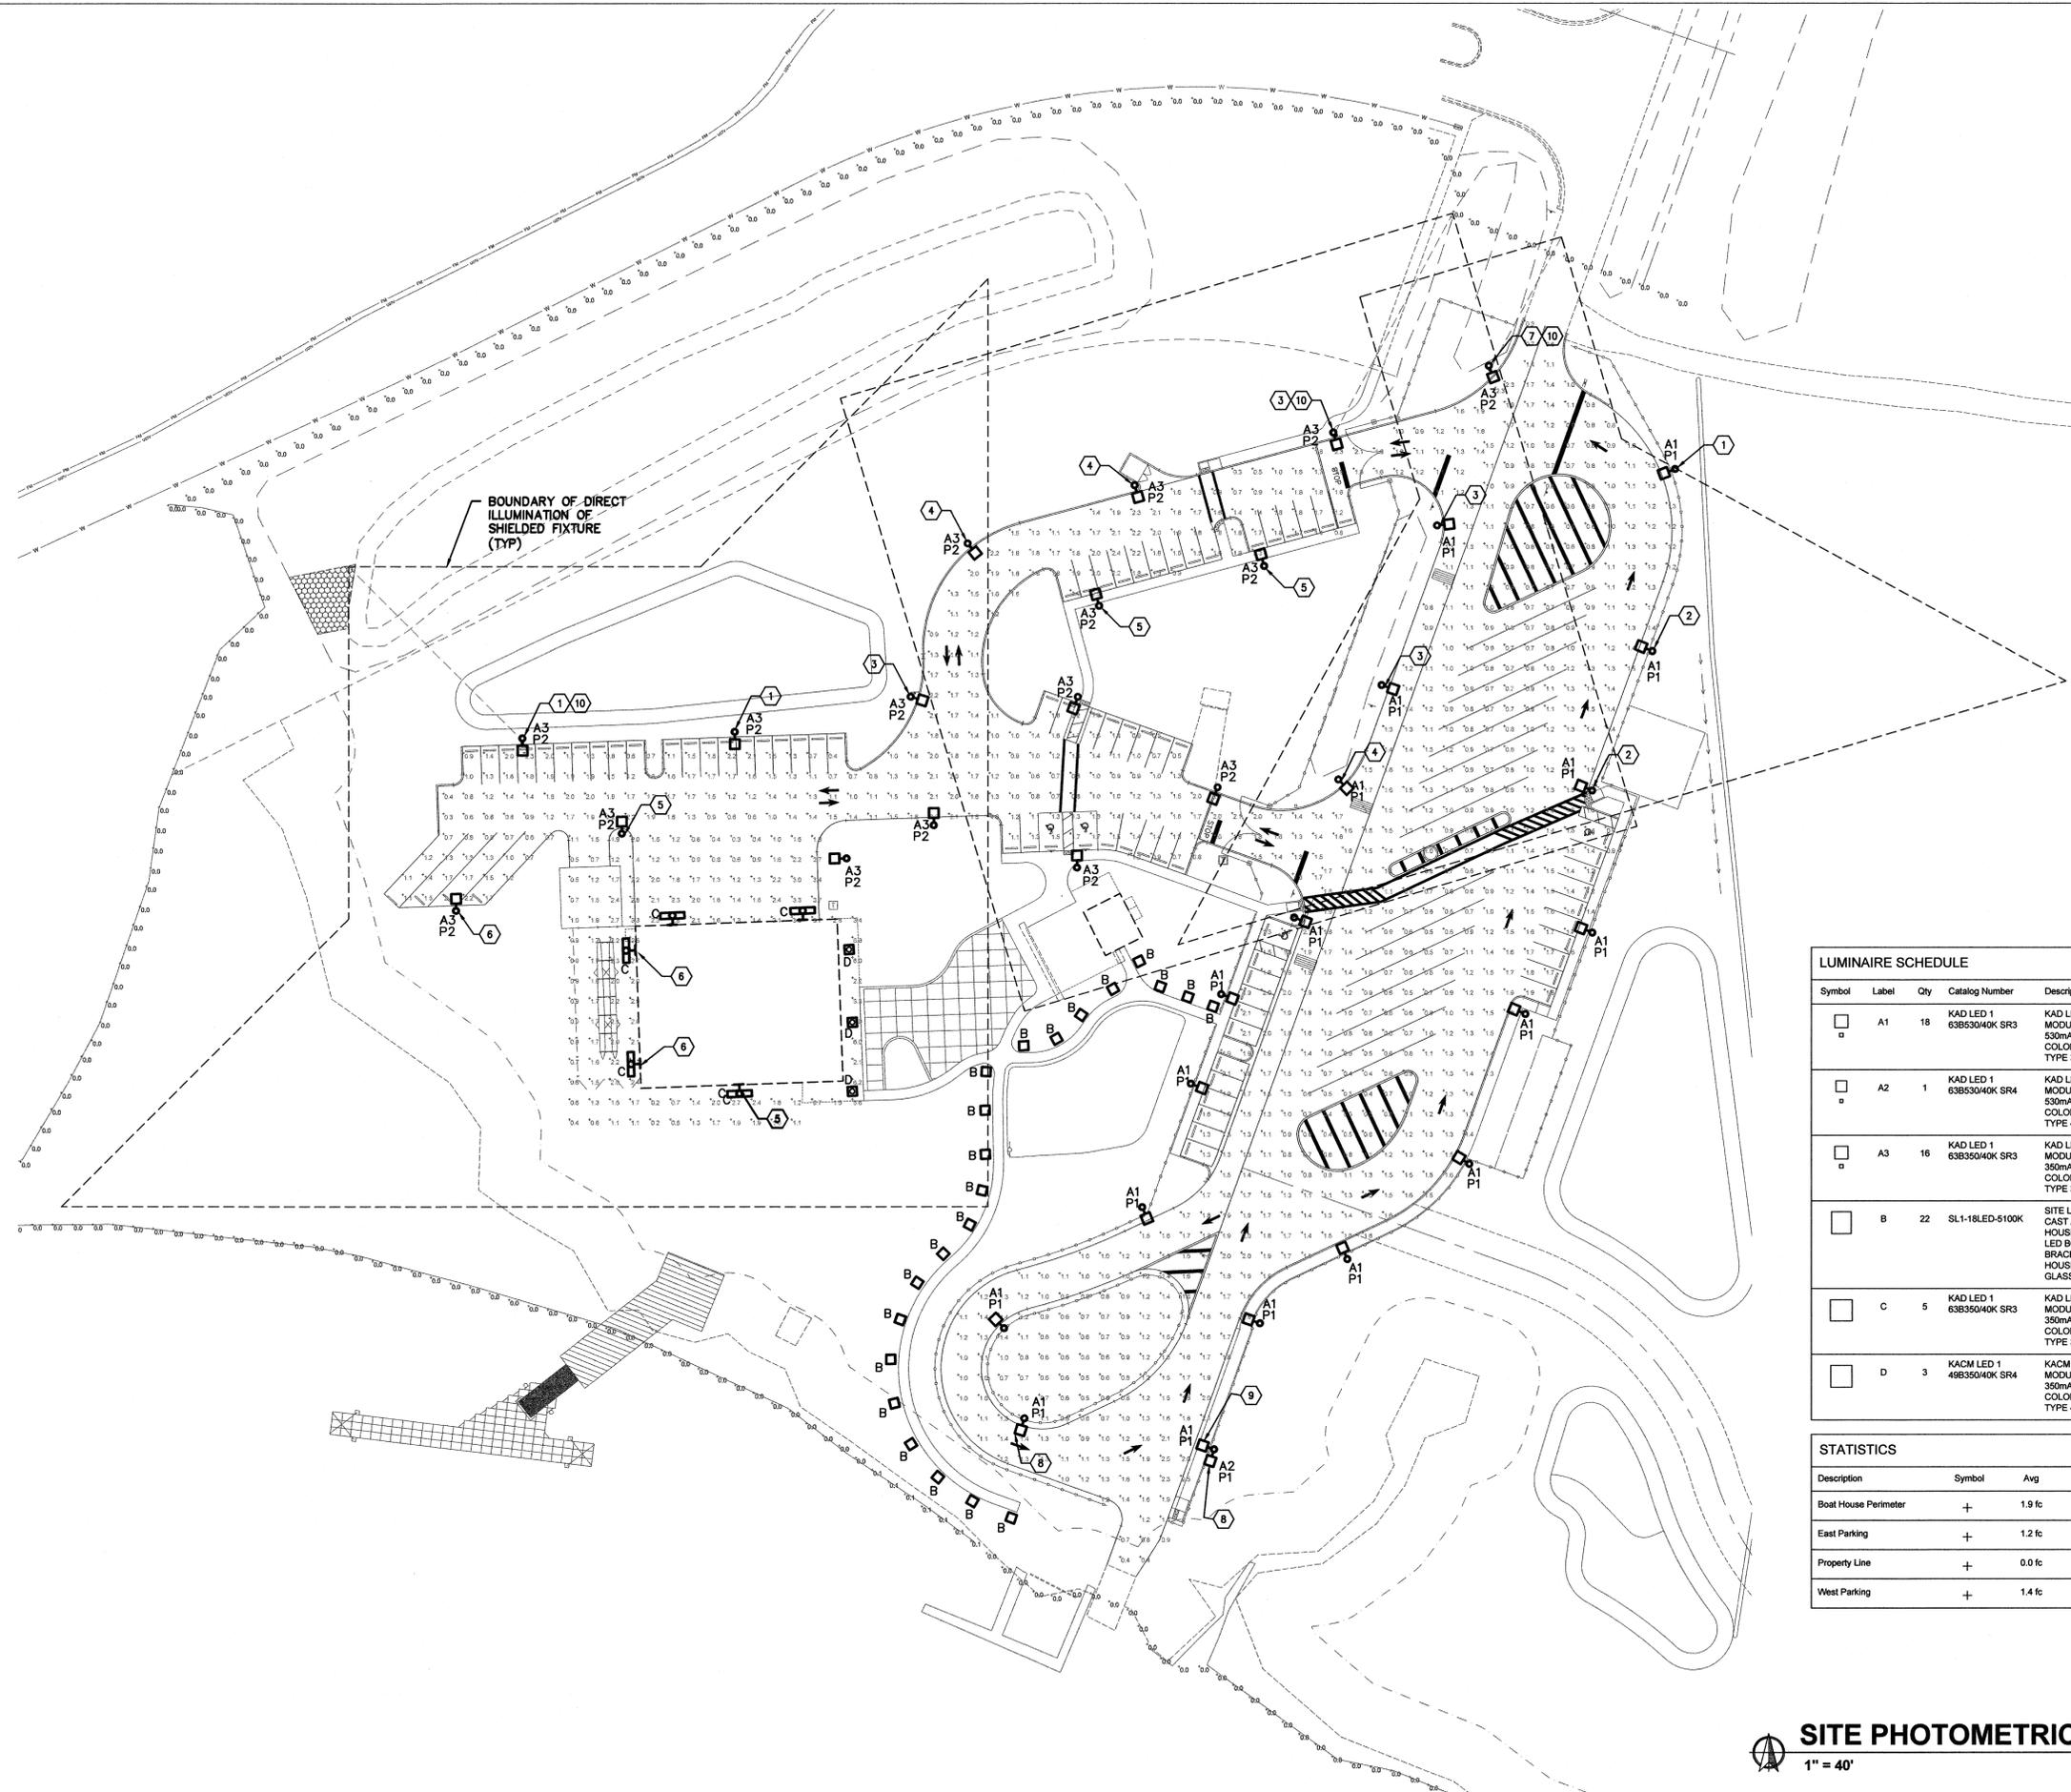1. DIRECT ILLUMINATION PLOTS SHOWN ONLY FOR WORST-CASE FIXTURES FOR CLARITY. REFER TO CALCULATION DETAILS FOR ADDITIONAL INFORMATION.
2. PROPERTY LINE LOCATION AND ROUTING BASED UPON CIVIL PLANS. REFER TO CIVIL PLANS FOR ADDITIONAL PROPERTY LINE INFORMATION.

**KEYED NOTES**

- 1 PROVIDE 2" HOUSE SIDE SHIELD AND 2" LEFT SIDE SHIELD.
- 2 PROVIDE 2" LEFT SIDE SHIELD AND 2" FRONT SIDE SHIELD.
- 3 PROVIDE 2" HOUSE SIDE SHIELD AND 2" RIGHT SIDE SHIELD.
- 4 PROVIDE 2" HOUSE SIDE SHIELD.
- 5 PROVIDE 2" FRONT SIDE SHIELD.
- 6 PROVIDE 2" RIGHT SIDE SHIELD.
- 7 PROVIDE 2" HOUSE SIDE SHIELD, 2" LEFT SIDE SHIELD, AND 2" RIGHT SIDE SHIELD.
- 8 PROVIDE 6" FRONT SIDE SHIELD.
- 10 PROVIDE 6" RIGHT SIDE SHIELD.


**LUMINAIRE SCHEDULE**

Symbol	Label	Qty	Catalog Number	Description	Lamp	File	Lumens	LLF	Watts
□	A1	18	KAD LED 1 63B53040K SR3	KAD LED WITH HLM MODULE, 63 LED's, 530mA DRIVER, 4000K COLOR TEMPERATURE, TYPE 3 LENS	ONE 110-WATT LED, DOWNLIGHTPOS.	KAD_LED_1_6 3B530_40K_S R3.ies	Absolute	0.81	110.9
□	A2	1	KAD LED 1 63B53040K SR4	KAD LED WITH HLM MODULE, 63 LED's, 530mA DRIVER, 4000K COLOR TEMPERATURE, TYPE 4 LENS	ONE 108-WATT HLM LED, DOWNLIGHTPOS.	KAD_LED_1_6 3B530_40K_S R4.ies	Absolute	0.81	108.4
□	A3	16	KAD LED 1 63B35040K SR3	KAD LED WITH HLM MODULE, 63 LED's, 350mA DRIVER, 4000K COLOR TEMPERATURE, TYPE 3 LENS	ONE 74-WATT LED, DOWNLIGHTPOS.	KAD_LED_1_6 3B350_40K_S R3.ies	Absolute	0.81	74.5
□	B	22	SL1-18LED-5100K	SITE LITEFORM LED DIE CAST ALUMINUM UPPER HOUSING AND RISER, LED BOARDS AND BRACKETS MOUNTED IN HOUSING, CLEAR FLAT GLASS LENS	18 CONSTANT CURRENT DIODES, 5100K	sl1-186k.ies	Absolute	0.81	19.6
□	C	5	KAD LED 1 63B35040K SR3	KAD LED WITH HLM MODULE, 63 LED's, 350mA DRIVER, 4000K COLOR TEMPERATURE, TYPE 3 LENS	ONE 74-WATT LED, DOWNLIGHTPOS.	KAD_LED_1_6 3B350_40K_S R3.ies	Absolute	0.81	74.5
□	D	3	KACM LED 1 49B35040K SR4	KACM LED WITH HLM MODULE, 49 LED's, 350mA DRIVER, 4000K COLOR TEMPERATURE, TYPE 4 LENS	ONE 59-WATT HLM LED, DOWNLIGHTPOS.	KACM_LED_1_49B350_40K_SR4.ies	Absolute	0.81	59.04

**STATISTICS**

Description	Symbol	Avg	Max	Min	Max/Min
Boat House Perimeter	+	1.9 fc	6.8 fc	0.2 fc	34.0:1
East Parking	+	1.2 fc	2.6 fc	0.3 fc	8.7:1
Property Line	+	0.0 fc	0.3 fc	0.0 fc	N / A
West Parking	+	1.4 fc	2.4 fc	0.3 fc	8.0:1

**SITE PHOTOMETRIC PLAN - FC VALUES AT 0' AFG**  
1" = 40'

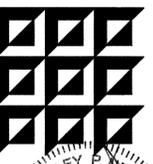

**ENGINEERING MATHEMATICS CONSULTING ENGINEERS**  
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Fax: 321-246-1112  
Email: emc@emceng.com  
www.emceng.com



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FINAL SITE PLAN  
**CONSTRUCTION DOCUMENTS**  
ISSUE DATE: 01.14.2013 EMI JOB NO. 14-0520

**DRAWING REVISIONS:**

REV	DATE	DESCRIPTION

**FORT HAMER PARK**  
**PHASE II**  
PART OF SECTION 17, TOWNSHIP 34 SOUTH, RANGE 19 EAST  
MANATEE COUNTY, FLORIDA


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**DRAWING TITLE:**  
**ELECTRICAL SITE PLAN**

**SCALE:**  
AS NOTED  
**NORTH:**  
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**DRAWING NUMBER:**  
**E1.1**

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**GENERAL NOTES**

1. DIRECT ILLUMINATION PLOTS SHOWN ONLY FOR WORST-CASE FIXTURES FOR CLARITY. REFER TO CALCULATION DETAILS FOR ADDITIONAL INFORMATION.
2. PROPERTY LINE LOCATION AND ROUTING BASED UPON CIVIL PLANS. REFER TO CIVIL PLANS FOR ADDITIONAL PROPERTY LINE INFORMATION.

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- 1 PROVIDE 2" HOUSE SIDE SHIELD AND 2" LEFT SIDE SHIELD.
- 2 PROVIDE 2" LEFT SIDE SHIELD AND 2" FRONT SIDE SHIELD.
- 3 PROVIDE 2" HOUSE SIDE SHIELD AND 2" RIGHT SIDE SHIELD.
- 4 PROVIDE 2" HOUSE SIDE SHIELD.
- 5 PROVIDE 2" FRONT SIDE SHIELD
- 6 PROVIDE 2" RIGHT SIDE SHIELD.
- 7 PROVIDE 2" HOUSE SIDE SHIELD, 2" LEFT SIDE SHIELD, AND 2" RIGHT SIDE SHIELD.
- 8 PROVIDE 6" FRONT SIDE SHIELD.
- 10 PROVIDE 6" RIGHT SIDE SHIELD.
- 10 DIRECT ILLUMINATION PLOT SHOWN FOR THIS FIXTURE.

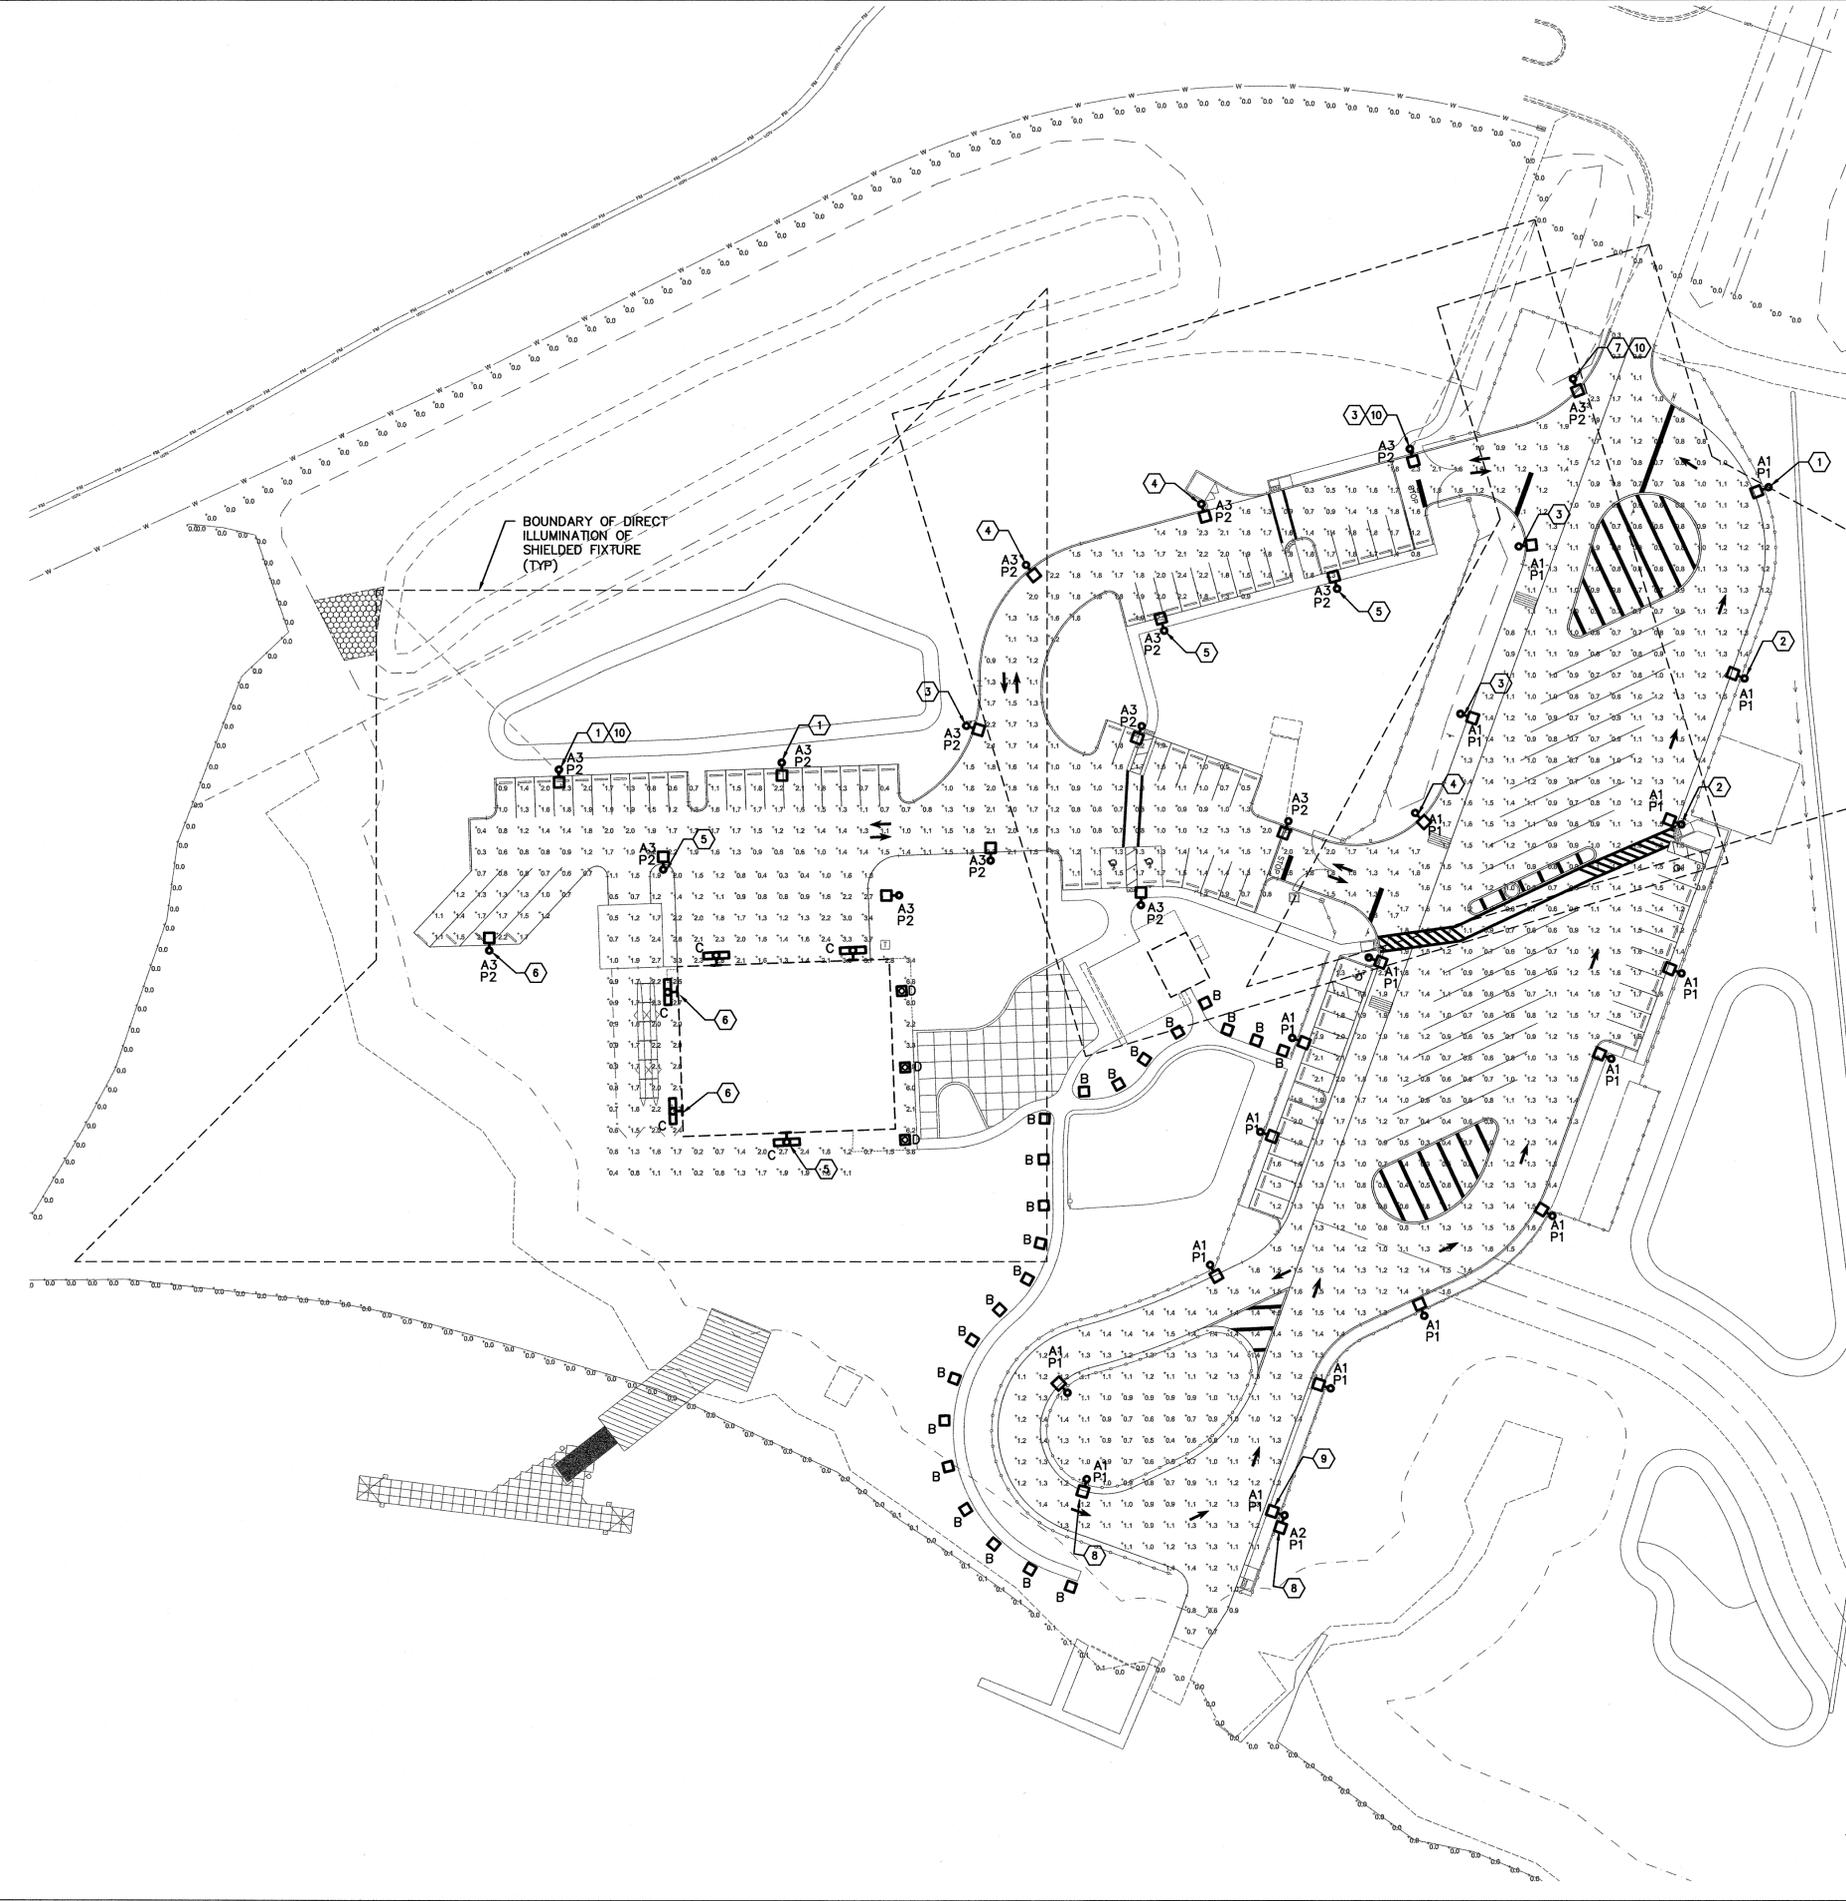**LUMINAIRE SCHEDULE**

Symbol	Label	Qty	Catalog Number	Description	Lamp	File	Lumens	LLF	Watts
□	A1	18	KAD LED 1 63B35040K SR3	KAD LED WITH HLM MODULE, 63 LED's, 530mA DRIVER, 4000K COLOR TEMPERATURE, TYPE 3 LENS	ONE 110-WATT LED, DOWNLIGHTPOS.	KAD_LED_1_6 3B350_40K_S R3.ies	Absolute	0.81	110.9
□	A2	1	KAD LED 1 63B35040K SR4	KAD LED WITH HLM MODULE, 63 LED's, 530mA DRIVER, 4000K COLOR TEMPERATURE, TYPE 4 LENS	ONE 108-WATT HLM LED, DOWNLIGHTPOS.	KAD_LED_1_6 3B350_40K_S R4.ies	Absolute	0.81	108.4
□	A3	16	KAD LED 1 63B35040K SR3	KAD LED WITH HLM MODULE, 63 LED's, 350mA DRIVER, 4000K COLOR TEMPERATURE, TYPE 3 LENS	ONE 74-WATT LED, DOWNLIGHTPOS.	KAD_LED_1_6 3B350_40K_S R3.ies	Absolute	0.81	74.5
□	B	22	SL1-18LED-5100K	SITE LITEFORM LED DIE CAST ALUMINUM UPPER HOUSING AND RISER. LED BOARDS AND BRACKETS MOUNTED IN HOUSING. CLEAR FLAT GLASS LENS	18 CONSTANT CURRENT DIODES, 5100K	sl1-18LED.ies	Absolute	0.81	19.6
□	C	5	KAD LED 1 63B35040K SR3	KAD LED WITH HLM MODULE, 63 LED's, 350mA DRIVER, 4000K COLOR TEMPERATURE, TYPE 3 LENS	ONE 74-WATT LED, DOWNLIGHTPOS.	KAD_LED_1_6 3B350_40K_S R3.ies	Absolute	0.81	74.5
□	D	3	KACM LED 1 49B35040K SR4	KACM LED WITH HLM MODULE, 49 LED's, 350mA DRIVER, 4000K COLOR TEMPERATURE, TYPE 4 LENS	ONE 59-WATT HLM LED, DOWNLIGHTPOS.	KACM_LED_1_49B350_40K_SR4.ies	Absolute	0.81	59.04

**STATISTICS**

Description	Symbol	Avg	Max	Min	Max/Min
Boat House Perimeter	+	1.9 fc	6.8 fc	0.2 fc	34.0:1
East Parking	+	1.2 fc	2.6 fc	0.3 fc	8.7:1
Property Line 5 FT AFG	+	0.0 fc	0.1 fc	0.0 fc	N/A
West Parking	+	1.4 fc	2.4 fc	0.3 fc	8.0:1

**SITE PHOTOMETRIC PLAN - FC VALUES AT 5' AFG**  
1" = 40'



ENGINEERING MATRIX CONSULTING ENGINEERS  
2825 W. STATE ROAD, SUITE 2007  
FT. WORTH, TEXAS 76107  
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FAX: 817-335-4444  
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PHASE II**  
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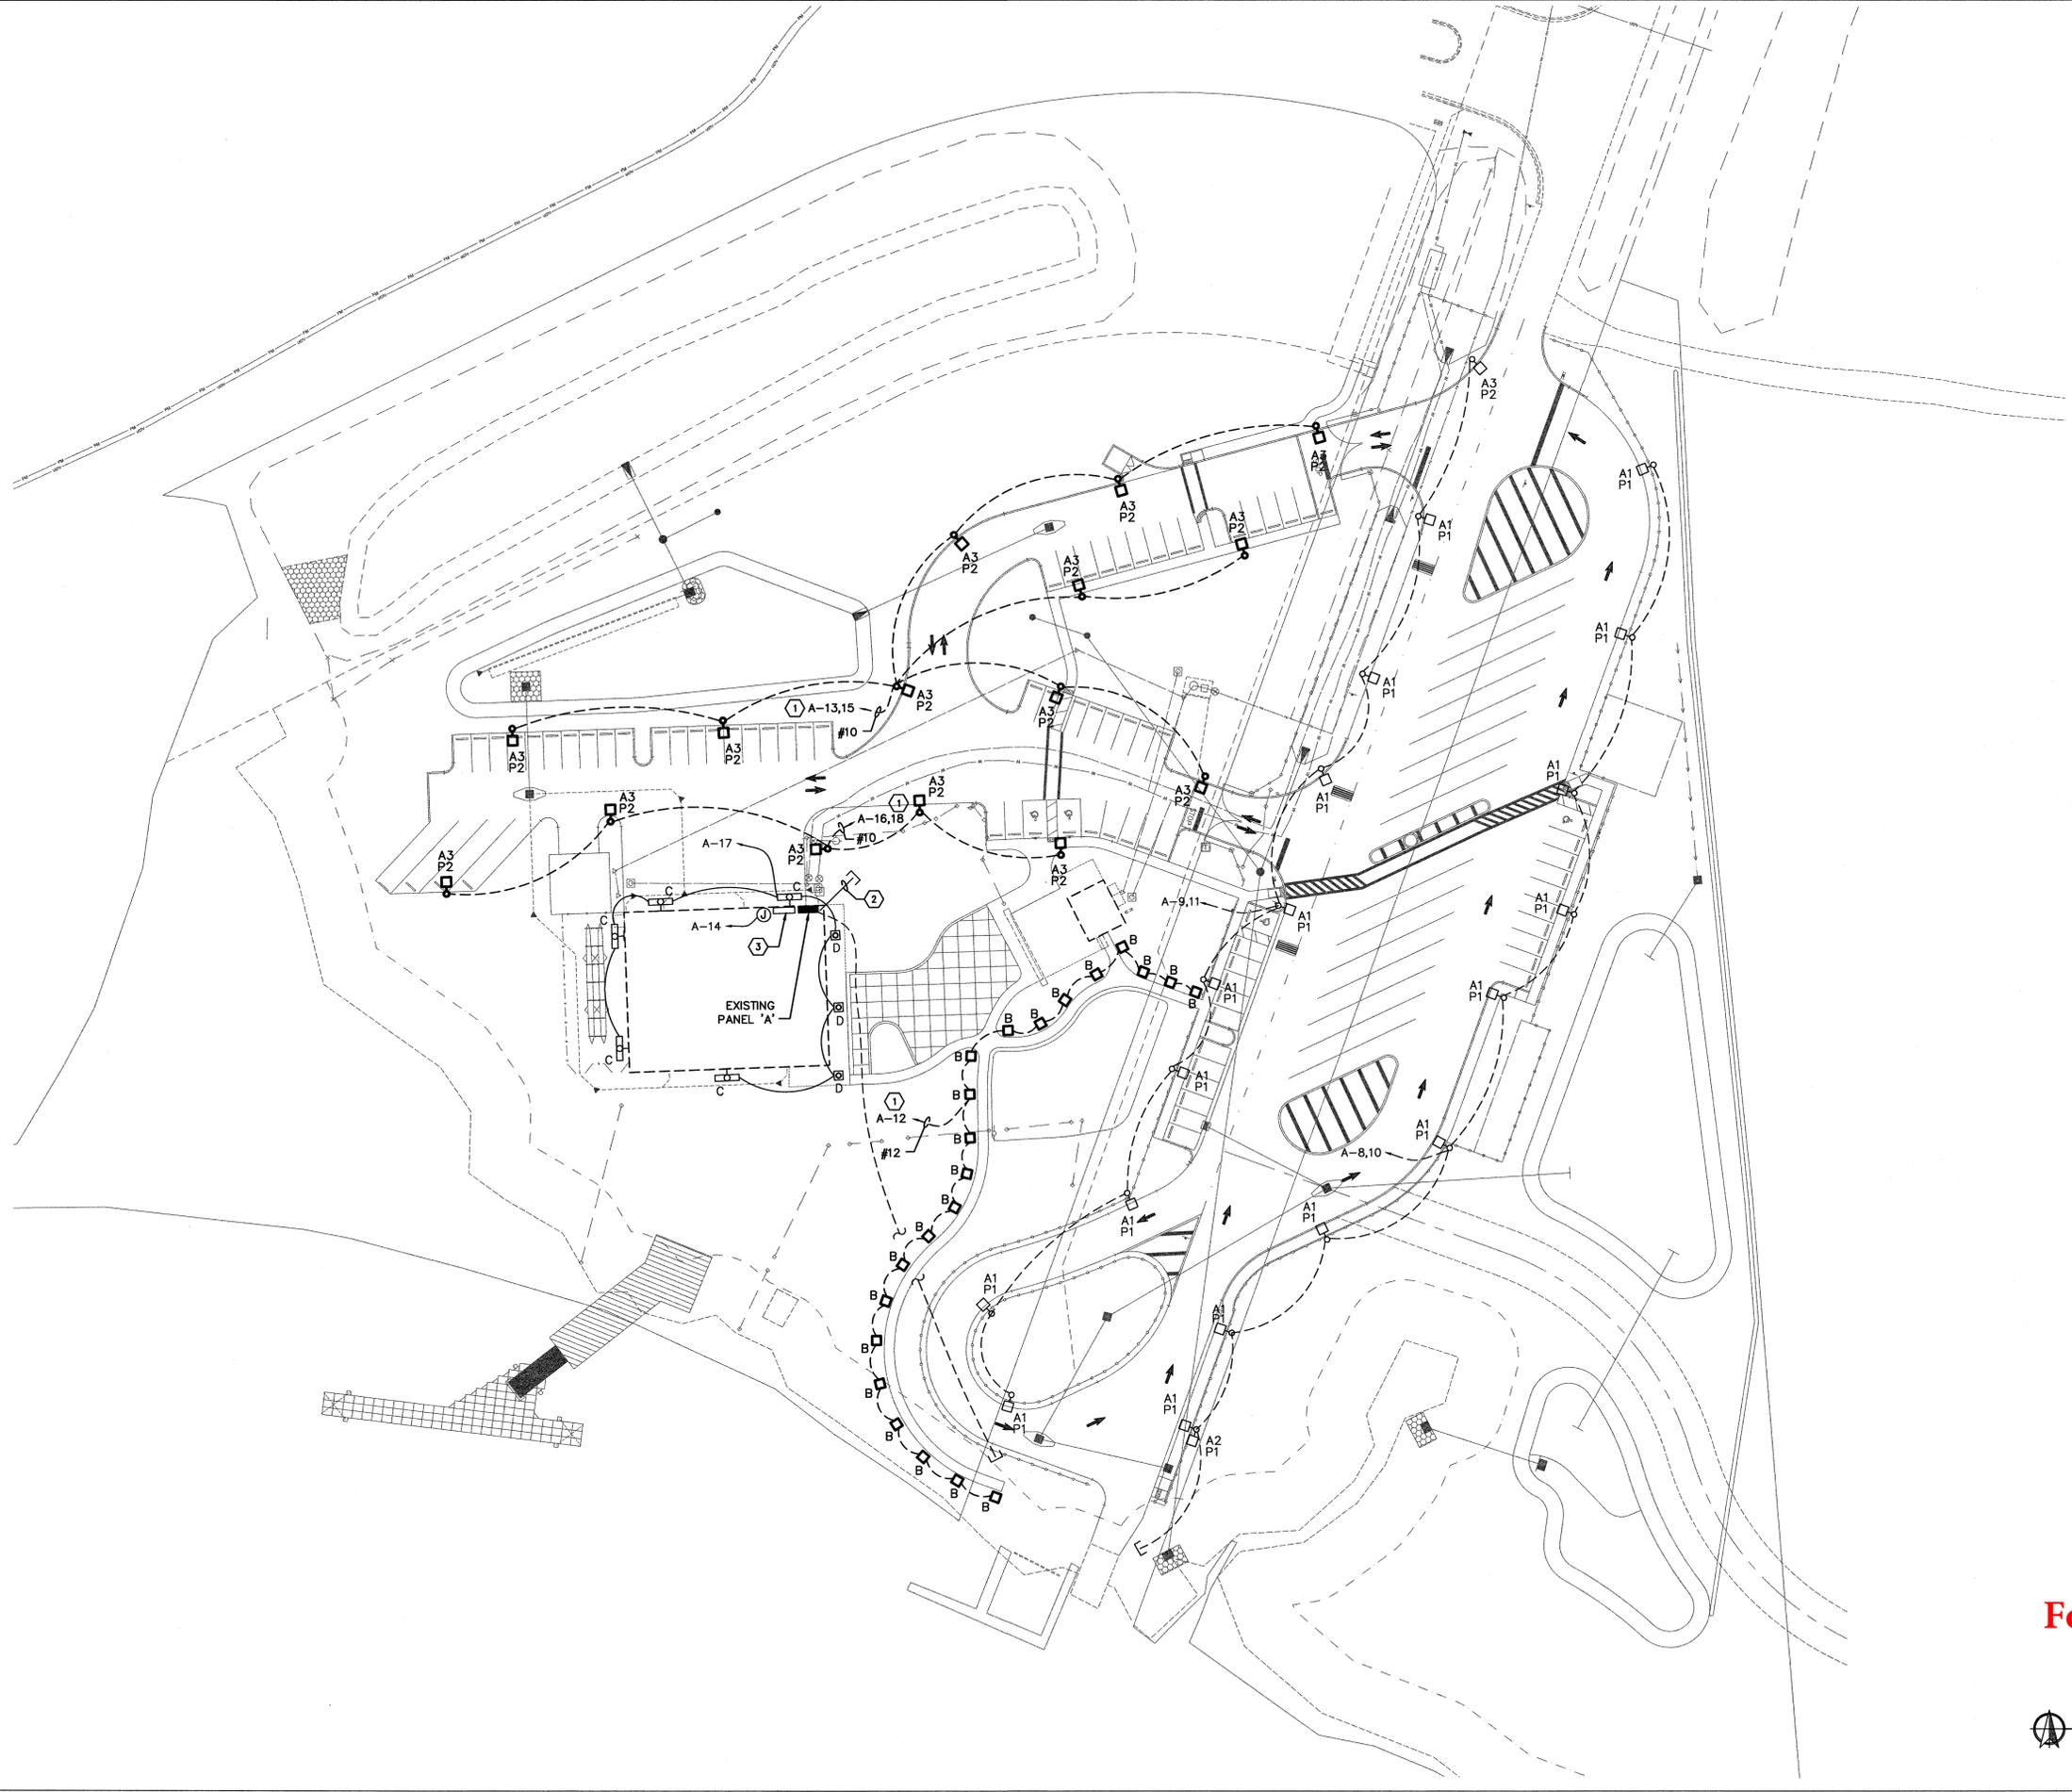
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**ELECTRICAL  
SITE PLAN**

SCALE: AS NOTED NORTH:

DRAWING NUMBER:  
**E1.2**

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**GENERAL NOTES**

- ROUTING OF CONDUIT SHOWN ON ELECTRICAL SITE PLAN IS DIAGRAMMATIC ONLY. CONTRACTOR SHALL FAMILIARIZE THEMSELVES WITH THE EXISTING CONDITIONS AND SHALL COORDINATE ALL NEW WORK AND CONDUIT ROUTING ACCORDINGLY TO AVOID CONFLICTS.
- CONTRACTOR SHALL FIELD COORDINATE LIGHT POLE LOCATIONS WITH SITE CONDITIONS, INCLUDING LANDSCAPING, TREES, SIDEWALKS, ETC. PRIOR TO ROUGH-IN. NOTIFY OWNER/ENGINEER OF ANY CONFLICTS WITH THE LIGHTING LAYOUT SHOWN.
- ANY LANDSCAPING, SIDEWALKS, ETC. DAMAGED DURING CONSTRUCTION SHALL BE REPAIRED OR REPLACED TO MATCH ITS ORIGINAL CONDITION.
- ALL SITE CONDUIT SHALL BE A MINIMUM OF 1" UNLESS OTHERWISE NOTED.
- NEW, ABOVE GROUND CONDUIT RUNS SHALL BE CONCEALED WITHIN THE EXISTING BOAT HOUSE WALLS AND/OR ABOVE SOFFITS. EXPOSED PIPING WILL NOT BE ACCEPTED UNLESS PRIOR APPROVAL FROM OWNER/ENGINEER.
- CONTRACTOR SHALL LOCATE LIGHT POLES TO MAINTAIN 5-FOOT HORIZONTAL CLEARANCE FROM UNDERGROUND UTILITIES. NOTIFY ENGINEER OF ANY DISCREPANCIES PRIOR TO ROUGH-IN FOR FURTHER PHOTOMETRIC EVALUATION AND COORDINATION.

**KEYED NOTES**

- ROUTE CIRCUIT THROUGH LIGHTING RELAY PANEL. CONTINUE CIRCUIT TO DESIGNATED SPACE IN EXISTING PANEL 'A'. REFER TO LIGHTING CONTROL DETAIL FOR ADDITIONAL INFORMATION.
- UTILIZE EXISTING, UNDERGROUND, SPARE 1" CONDUITS INSTALLED DURING PHASE I/A IMPROVEMENTS FOR NEW SITE LIGHTING CIRCUITS.
- EXISTING LIGHTING RELAY PANEL.



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 PH: 727-325-4600  
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 www.matrixinc.com  
 STATE OF FLORIDA  
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DRAWING PHASE:  
 FINAL SITE PLAN  
 CONSTRUCTION DOCUMENTS

ISSUE DATE: 01.23.2015 EMI JOB NO. 14-0520

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**FORT HAMER PARK  
 PHASE II**  
 PART OF SECTION 17, TOWNSHIP 34 SOUTH, RANGE 19 EAST  
 MANATEE COUNTY, FLORIDA

SEAL:

DRAWING TITLE:  
**ELECTRICAL  
 SITE PLAN  
 PHASE II**

SCALE: AS NOTED NORTH:

DRAWING NUMBER:  
**E1.3**

**For Reference Only**

**PHASE II  
 SITE PLAN - ELECTRICAL**  
 1" = 40'

